
CHEW PLAYGROUND FIELD IMPROVEMENTS

1800 WASHINGTON AVENUE, PHILADELPHIA, PA 19146

BID DOCUMENTS ISSUED 02/04/2022

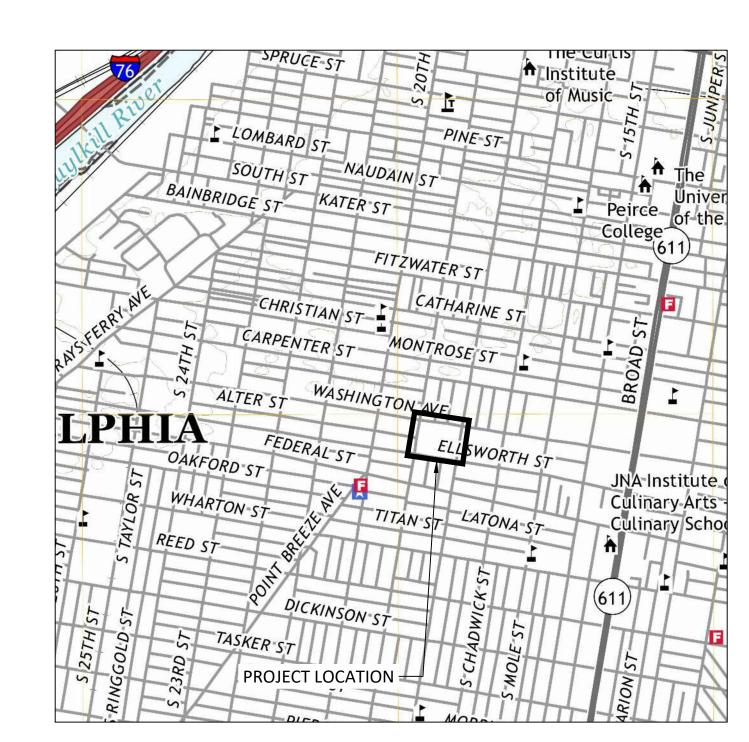

SHEET LIST C- 001 COVER SHEET 101 EXISTING CONDITIONS PLAN C- 201 DEMOLITION PLAN C- 301 EROSION AND SEDIMENT CONTROL PLAN

C- 311 EROSION AND SEDIMENT CONTROL DETAILS

C- 320 EROSION AND SEDIMENT CONTROL NOTES

C- 321 REMEDIATION PLAN

C- 322 REMEDIATION DETAILS

401 STORMWATER AND GRADING PLAN

102 PLANTING PLAN

401 SOFTBALL FIELD ENLARGEMENT AND DETAILS

101 SITE LAYOUT, MATERIALS, & FURNISHINGS PLAN

402 MULTI-SPIRT FIELD LAYOUT ENLARGEMENT

501 SITE & PLANTING DETAILS

IT SHALL BE THE CONTRACTOR'S RESPONSIBILITY TO CONDUCT ACTIVITIES IN A CLEAN, NEAT MANNER THROUGHOUT THE CONTRACT PERIOD. ALL DEBRIS GENERATED BY THE CONTRACTOR'S ACTIVITIES SHALL BE CLEANED UP AND REMOVED FROM THE PREMISES AT THE END OF EACH WORKING DAY. IF THE CONTRACTOR FAILS TO COMPLY, THE TOWNSHIP OF MIDDLETOWN HAS THE RIGHT TO HAVE THE SITE CLEANED AT THE CONTRACTOR'S EXPENSE.

ALL LOCATIONS OF EXISTING UTILITIES SHOWN ON THIS PLAN HAVE BEEN DEVELOPED FROM EXISTING UTILITY RECORDS AND/OR ABOVE GROUND EXAMINATION OF THE SITE. COMPLETENESS OR ACCURACY OF LOCATION AND DEPTH OF UNDERGROUND UTILITIES OR STRUCTURES CANNOT BE GUARANTEED. CONTRACTOR MUST VERIFY LOCATION AND DEPTH OF ALL UNDERGROUND UTILITIES AND FACILITIES BEFORE START OF WORK PER PENNSYLVANIA ACT 287 OF 1974 AS AMENDED BY ACT 199 OF 2004 OR LATER.

GENERAL NOTES

- EXISTING SITE CONDITIONS, TOPOGRAPHIC AND UTILITY INFORMATION DEPICTED HEREON HAS BEEN COMPILED FROM EXISTING INFORMATION AND FIELD MEASUREMENTS. ACTUAL CONDITIONS MAY HAVE CHANGED AND UNDOCUMENTED CONDITIONS MAY EXIST. IT IS THE RESPONSIBILITY OF THE CONTRACTOR TO VERIFY ALL EXISTING CONDITIONS AND DIMENSIONS BEFORE WORK COMMENCES. THE CONTRACTOR MUST BRING TO THE ATTENTION OF THE ENGINEER ANY DISCREPANCIES BETWEEN FIELD CONDITIONS AND DRAWINGS PRIOR TO BEGINNING WORK. FIELD CONDITION DISCREPANCIES
- UTILITIES OR OTHER STRUCTURES BEFORE STARTING WORK. MANY UNDERGROUND UTILITY LOCATIONS AS SHOWN ARE APPROXIMATE, AND INFORMATION MAY BE MISSING. THIS NOTICE IS GIVEN PER ACT 199 OF 2004 OF THE COMMONWEALTH OF PA. CONTACT PA ONE CALL SYSTEM 1-800-242-1776.
- 3. THE CONTRACTOR SHALL BE RESPONSIBLE FOR THE REMOVAL OF ANY EXCESS MATERIAL AND SHALL ENSURE THAT SITE(S) RECEIVING EXCESS MATERIAL HAVE AN APPROVED EROSION AND SEDIMENTATION CONTROL PLAN THAT COMPLIES WITH THE CONDITIONS OF CHAPTER 102 AND/OR OTHER FEDERAL, STATE, AND LOCAL REGULATIONS.
- 4. THE CONTRACTOR IS ADVISED TO BECOME THOROUGHLY FAMILIAR WITH THE PROVISIONS OF THE APPENDIX 64, EROSION CONTROL RULES AND REGULATIONS. TITLE 25. PART 1. DEPARTMENT OF ENVIRONMENTAL PROTECTION, SUBPART C. PROTECTION OF NATURAL RESOURCES, ARTICLE III, WATER RESOURCES, CHAPTER 102, EROSION CONTROL. THE CONTRACTOR SHALL COMPLY WITH THE REQUIREMENTS OF CHAPTER 102. IN THE EVENT OF CONFLICT BETWEEN THESE REQUIREMENTS AND POLLUTION CONTROL LAWS, RULES, AND REGULATIONS OF OTHER STATE, LOCAL, OR FEDERAL REGULATIONS, THE MORE RESTRICTIVE LAWS, RULES, OR REGULATIONS SHALL APPLY.
- 5. THE CONTRACTOR IS RESPONSIBLE FOR ENSURING THAT ANY MATERIAL BROUGHT ON SITE IS CLEAN FILL. FORM FP-001 MUST BE RETAINED BY THE PROPERTY OWNER FOR ANY FILL MATERIAL AFFECTED BY A SPILL OR RELEASE OF A REGULATED SUBSTANCE BUT QUALIFYING AS CLEAN FILL DUE TO ANALYTICAL TESTING.
- 6. FAILURE TO CORRECTLY INSTALL E&S BMPS, FAILURE TO PREVENT SEDIMENT-LADEN RUNOFF FROM LEAVING THE CONSTRUCTION SITE, OR FAILURE TO TAKE IMMEDIATE CORRECTIVE ACTION TO RESOLVE FAILURE OF E&S BMPS MAY RESULT IN ADMINISTRATIVE, CIVIL, AND/OR CRIMINAL PENALTIES BEING INSTITUTED BY THE DEPARTMENT AS DEFINED IN SECTION 602 OF THE PENNSYLVANIA CLEAN STREAMS LAW. THE CLEAN STREAMS LAW PROVIDES FOR UP TO \$10,000 PER DAY IN CIVIL PENALTIES, UP TO \$10,000 IN SUMMARY CRIMINAL PENALTIES, AND UP TO \$25,000 IN MISDEMEANOR CRIMINAL PENALTIES FOR EACH VIOLATION.
- 7. THE CONTRACTOR SHALL PROCURE AND PAY ALL PERMITS, LICENSES AND APPROVALS NECESSARY FOR THE EXECUTION OF THIS CONTRACT. THE CONTRACTOR SHALL COMPLY WITH ALL LAWS AND ORDINANCES RELATING TO THE PERFORMANCE OF THE WORK, THE PROTECTION OF ADJACENT PROPERTY, AND THE MAINTENANCE OF PASSAGES.
- CONTRACTOR SHALL EXERCISE CARE TO PROTECT FROM DAMAGE EXISTING WORK, EXISTING SITE IMPROVEMENTS, EXISTING VEGETATION, ABOVE AND BELOW GRADE UTILITIES, AND ALL WORK PERFORMED. ANY DAMAGE CAUSED BY THE EXECUTION OF THE WORK BY THE CONTRACTOR OR ANY OF HIS SUBCONTRACTORS SHALL BE REPLACED OR REPAIRED TO THE SATISFACTION OF THE OWNER AT NO ADDITIONAL COST TO THE OWNER OR OWNER'S REPRESENTATIVE.
- 9. IF APPLICABLE, FULLY PROTECT ALL EXISTING OR NEW TREE ROOT ZONES DURING ALL CONSTRUCTION ACTIVITIES. AT NO TIME SHALL CONSTRUCTION ACTIVITIES TAKE PLACE OR MATERIALS BE STORED WITHIN TREE DRIPLINE ZONES. UNLESS INDICATED OTHERWISE ON THE DRAWINGS, SEE TREE PROTECTION DETAILS AND SPECIFICATIONS.
- 10. THE CONTRACTOR MUST ACCESS THE PROJECT WORK AREA IN COORDINATION WITH THE OWNER. THE FACILITY WILL CONTINUE TO BE IN OPERATION DURING CONSTRUCTION. WORK MAY NOT INTERFERE WITH NORMAL OPERATIONS WITHOUT PRIOR WRITTEN APPROVAL FROM THE OWNER. MAINTAIN SAFE VEHICULAR FLOW AND PEDESTRIAN ACCESS TO AND AROUND
- 11. IT SHALL BE THE CONTRACTOR'S RESPONSIBILITY TO CONDUCT ACTIVITIES IN A CLEAN, NEAT MANNER THROUGHOUT THE CONTRACT PERIOD. ALL DEBRIS GENERATED BY THE CONTRACTOR'S ACTIVITIES SHALL BE CLEANED UP AND REMOVED FROM THE PREMISES AT THE END OF EACH WORKING DAY. IF THE CONTRACTOR FAILS TO COMPLY, THE PROJECT MANAGER HAS THE RIGHT TO HAVE THE SITE CLEANED AT THE CONTRACTOR'S EXPENSE.
- 12. ALL SECURITY WORKERS AND CONSTRUCTION MATERIALS TO BE PROVIDED BY THE CONTRACTOR AS NECESSARY. THE CONTRACTOR IS RESPONSIBLE FOR SECURING THE SITE AT ALL TIMES.
- 13. ALL WORK SHALL BE DONE IN ACCORDANCE WITH THE APPLICABLE FEDERAL, STATE, AND LOCAL CODES, AND ALL REGULATIONS APPURTENANT TO THE OCCUPATIONAL SAFETY AND HEALTH ACT OF 1970. ALL WORK SHALL BE DONE IN ACCORDANCE WITH PROJECT SPECIFICATIONS INCLUDING CURRENT APPLICABLE STANDARDS AND REQUIREMENTS. WHERE ANY STANDARDS SEEM IN CONFLICT WITH THESE DRAWINGS, NOTIFY THE PROJECT ENGINEER FOR DIRECTION PRIOR TO PROCEEDING WITH WORK.
- 14. ALL EXCAVATIONS, TRENCHING AND SHORING OPERATIONS SHALL COMPLY WITH THE REQUIREMENTS OF THE UNITED STATES DEPARTMENT OF LABOR AND OCCUPATIONAL SAFETY AND HEALTH ADMINISTRATION (OSHA) PUBLICATIONS OF THE LATEST REVISION. NO TRENCHES OR EXCAVATION SHALL BE OPEN WHILE WORK IS NOT IN PROGRESS.

PROPERTY ADDRESS:

CHEW PLAYGROUND 1800 WASHINGTON AVE PHILADELPHIA, PA 19146

PROPERTY OWNER:



PHILADELPHIA PARKS & RECREATION DEPARTMENT 1515 ARCH STREET SUITE #10 PHILADELPHIA, PA 19102



REBUILD PHILADELPHIA 1515 ARCH STREET MEZZANINE LEVEL PHILADELPHIA, PA 19107

PROJECT PARTNERS

PROJECT TITLE:

CHEW PLAYGROUND FIELD RENOVATION

CIVIL ENGINEER:

meliora 🖒 🕮 🕸
Civil, Water Resources, and Structural Engineerin
259 Morgan St., Phoenixville, PA 19460
P: 610.933.0123 www.melioradesign.com

REVISIONS:					
DATE:	ISSUE:				

BID DOCUMENTS

DRAWING TITLE: **COVER SHEET**

AND GENERAL NOTES

DRAWING NO: 02/04/2022

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C-001 RAWN BY:

ELLSWORTH LEGALLY OPEN / ON CITY PLAN 50' WIDE / 12'-26'-12' S75°19'51"E STREET — ST — EXISTING STORM SEWER LINE WATER SHUT OFF GAS SHUT OFF VENT CAP (SEWER SERVICE) [O. O'] BUILDING DIMENSION -O- CHAIN LINK FENCE UTILITY POLE CONCRETE XX" WIDE AT BHD TREE 0.00 CITY PLAN ELEVATION KEYSTONE TELEPHONE MANHOLE PECO ENERGY MANHOLE (EXELON) ELECTIC BUREAU MANHOLE STEAM GRATE/MANHOLE STORM SEWER MANHOLE WATER MANHOLE CITY MANHOLE (ELECTRIC) PHILA. GAS WORKS MANHOLE UNIDENTIFIED MANHOLE TELEPHONE (PAY) WATER & SEWER SERVICE CAPS FIRE HYDRANT HIGH PRESURE FIRE HYDRANT DRAIN OPENMOUTH INLET OPEN MOUTH GRATE INLET CATCH BASIN/GRATE INLET CITY #3 INLET CITY #2 INLET CABLE TV VAULT LIGHT STANDARD - TROLLEY WIRE SUPPORT POLE (SEPTA) UTILITY POLE/LIGHT SIGN POST TRAFFIC SIGNAL PARKING METER FILLER CAP OIL BRUSH

. TREE

SEPTA SOUTHEASTERN PA. TRANSPORTATION AUTH.

PROPERTY ADDRESS: **EXISTING CONDITIONS LEGEND:** __________ FENCE _____... EXISTING CURBLINE - — — - EXISTING MAJOR CONTOUR - — - EXISTING MINOR CONTOUR — E — EXISTING ELECTRIC LINE CHEW PLAYGROUND 1800 WASHINGTON AVE PHILADELPHIA, PA 19146 PROPERTY OWNER: PHILADELPHIA PARKS & RECREATION DEPARTMENT 1515 ARCH STREET SUITE #10 PHILADELPHIA, PA 19102 BELL TELEPHONE MANHOLE (VERIZON) PROJECT MANAGER: HIGH PRESURE FIRE SERVICE MANHOLE REBUILD PHILADELPHIA 1515 ARCH STREET SANITARY/COMBINATION SEWER MANHOLE MEZZANINE LEVEL PHILADELPHIA, PA 19107 **PROJECT PARTNERS:** PRT/PTC/SEPTA MANHOLE (SEPTA) WATER, SEWER & GAS SERVICE CAPS PROJECT TITLE:

CHEW PLAYGROUND FIELD RENOVATION

PHILADELPHIA

RECREATION

YOUR PARKS &

CIVIL ENGINEER:

meliora 🗘 🕮 🌘 Civil, Water Resources, and Structural Engineering 259 Morgan St., Phoenixville, PA 19460 P: 610.933.0123 | www.melioradesign.com

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DRAWING TITLE:

EXISTING CONDITIONS PLAN


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1 INCH = 20 FEET



CHEW PLAYGROUND 1800 WASHINGTON AVE



PHILADELPHIA PARKS & RECREATION DEPARTMENT 1515 ARCH STREET

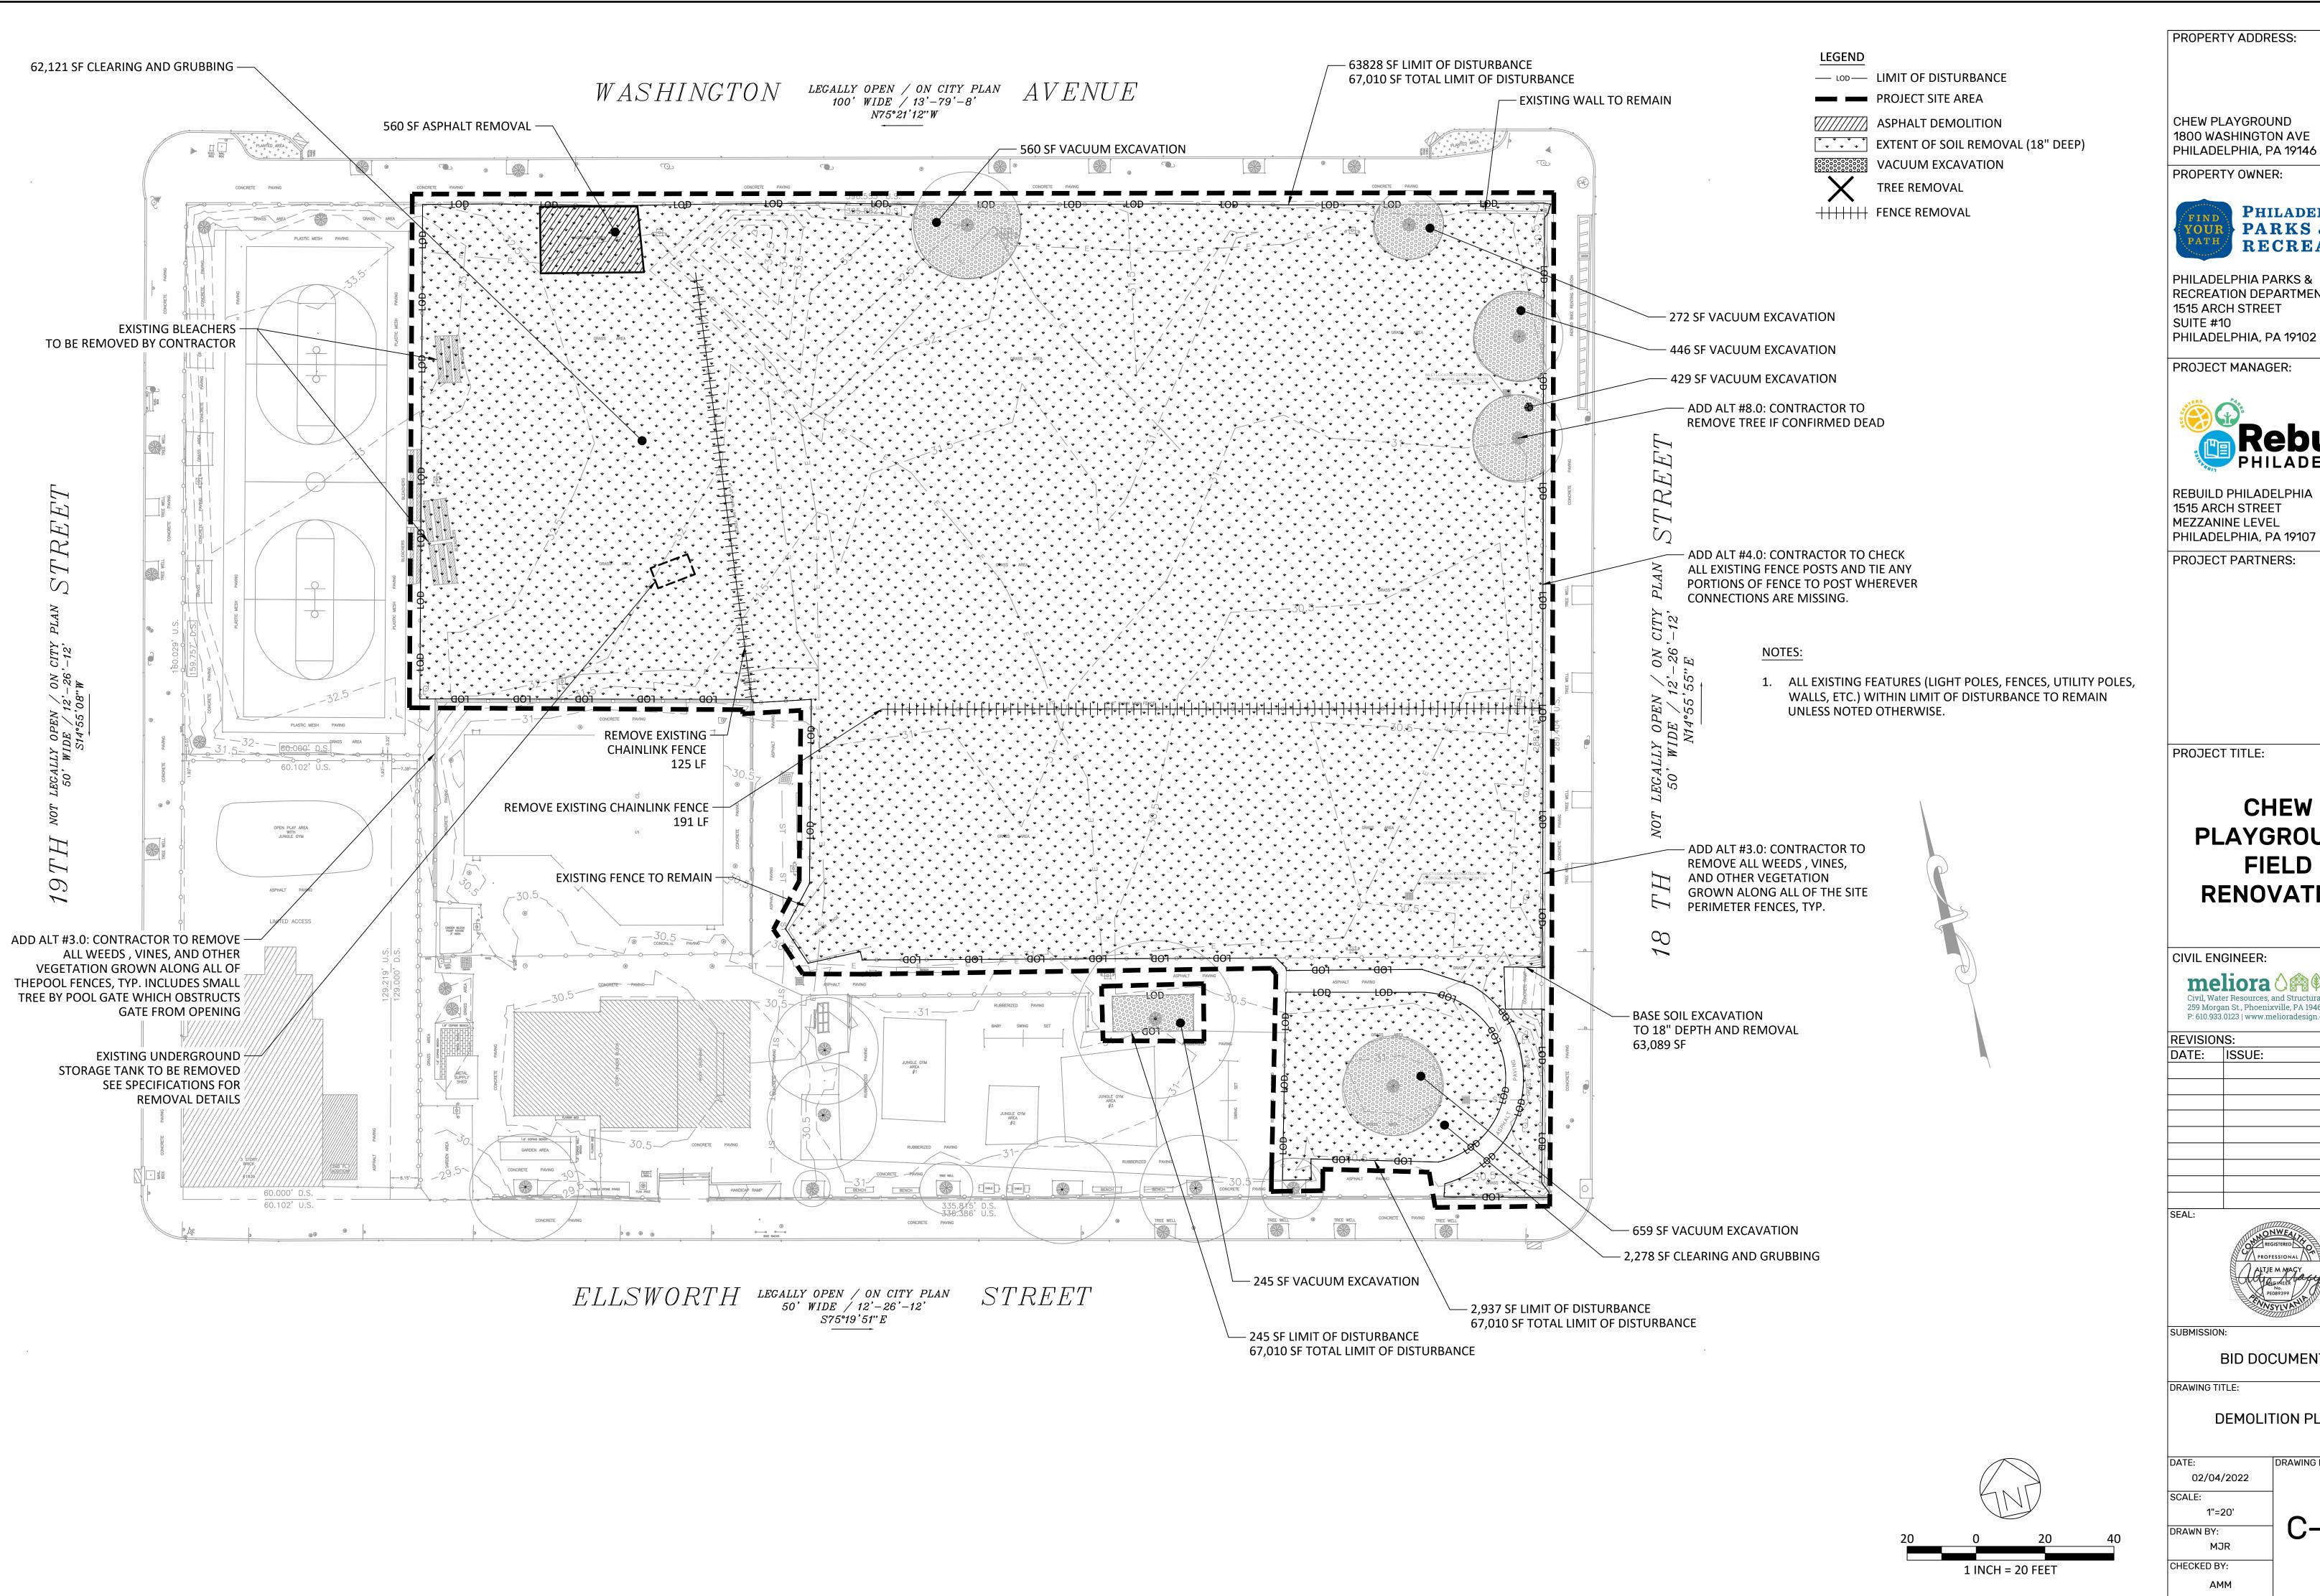

REBUILD PHILADELPHIA 1515 ARCH STREET MEZZANINE LEVEL PHILADELPHIA, PA 19107

PROJECT PARTNERS:

CHEW PLAYGROUND FIELD RENOVATION

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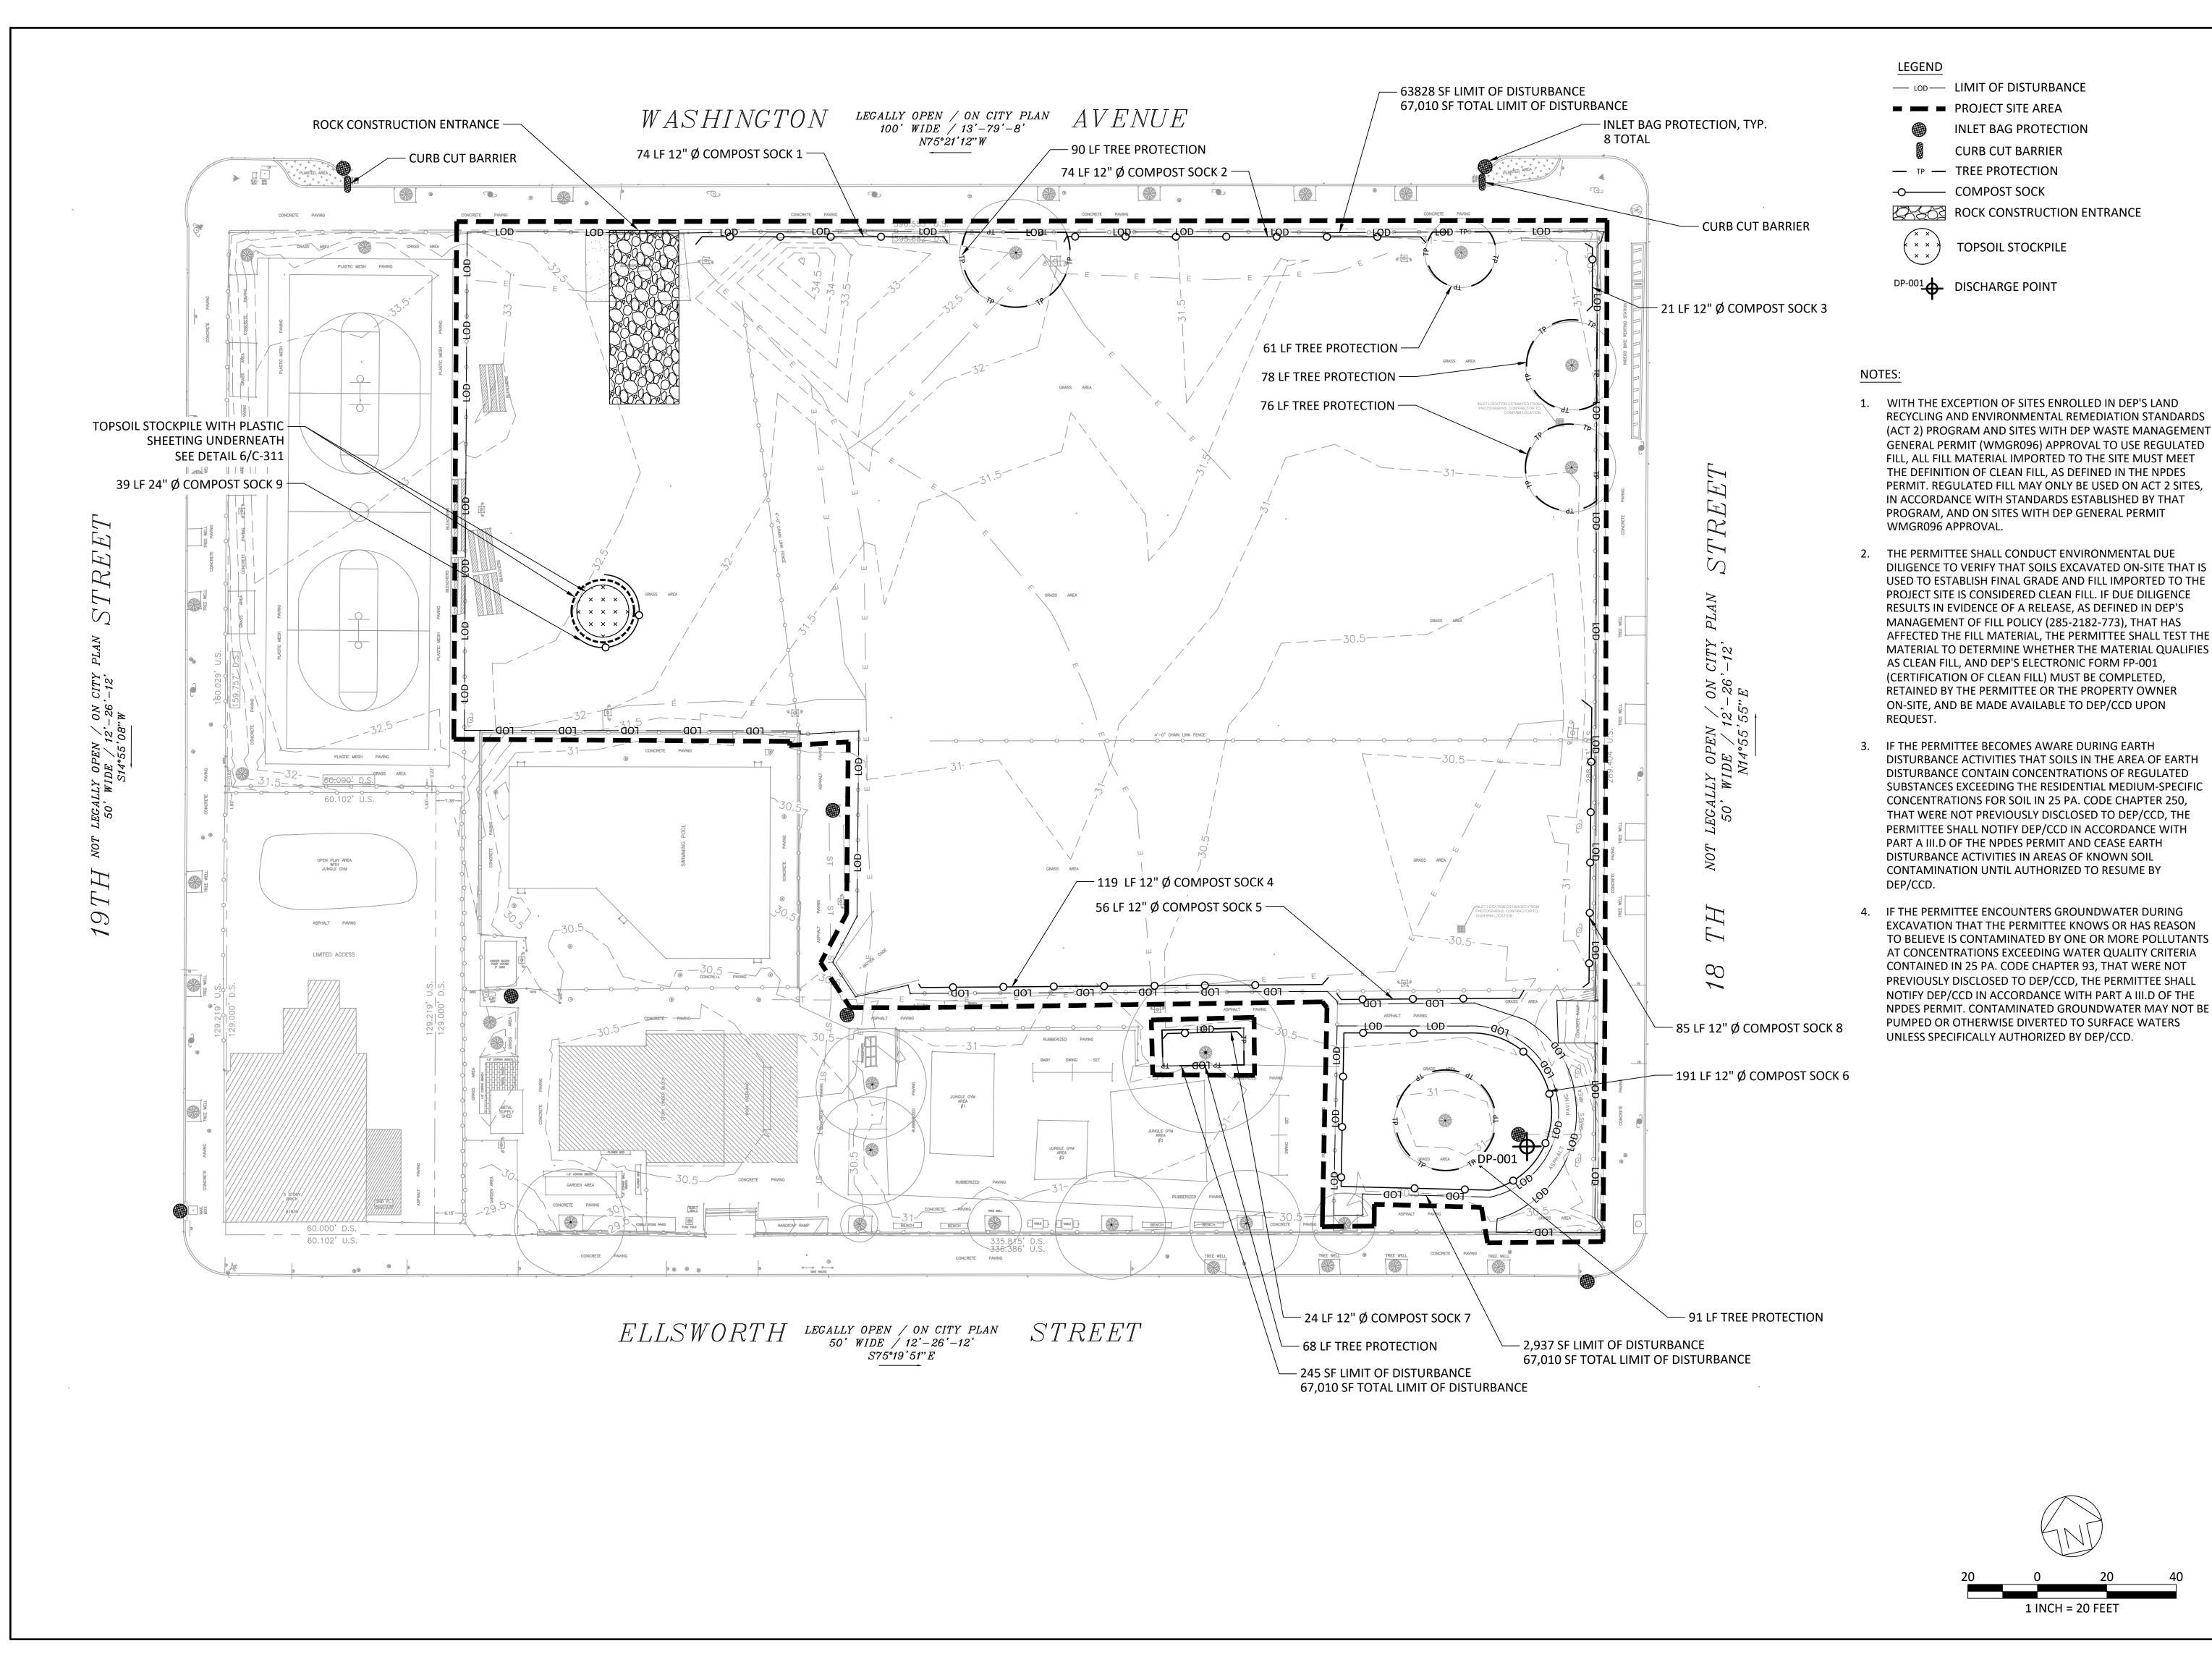


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DEMOLITION PLAN

DRAWING NO:

C-201



PROPERTY ADDRESS:

CHEW PLAYGROUND 1800 WASHINGTON AVE PHILADELPHIA, PA 19146

PROPERTY OWNER:



PHILADELPHIA PARKS & RECREATION DEPARTMENT 1515 ARCH STREET SUITE #10 PHILADELPHIA, PA 19102

PROJECT MANAGER:



REBUILD PHILADELPHIA 1515 ARCH STREET MEZZANINE LEVEL PHILADELPHIA, PA 19107

PROJECT PARTNERS:

PROJECT TITLE:

CHEW PLAYGROUND FIELD RENOVATION

CIVIL ENGINEER:

meliora 🗘 😂 🕏

Civil, Water Resources, and Structural Engineering 259 Morgan St., Phoenixville, PA 19460
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BID DOCUMENTS

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EROSION AND SEDIMENTATION CONTROL PLAN

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NOTES:

- SOCK FABRIC SHALL MEET STANDARDS OF TABLE 4.1 OF THE PA DEP EROSION CONTROL MANUAL. COMPOST SHALL MEET THE STANDARDS OF TABLE 4.2 OF THE PA DEP EROSION CONTROL MANUAL.
- 2. COMPOST FILTER SOCK SHALL BE PLACED AT EXISTING LEVEL GRADE. BOTH ENDS OF THE BARRIER SHALL BE EXTENDED AT LEAST 8 FEET UP SLOPE AT 45 DEGREES TO THE MAIN BARRIER ALIGNMENT. MAXIMUM SLOPE LENGTH ABOVE ANY BARRIER SHALL NOT EXCEED THAT SPECIFIED FOR THE SIZE OF THE SOCK AND THE SLOPE OF ITS TRIBUTARY AREA.
- 3. TRAFFIC SHALL NOT BE PERMITTED TO CROSS COMPOST FILTER SOCKS.
- 4. ACCUMULATED SEDIMENT SHALL BE REMOVED WHEN IT REACHES 1/2 THE ABOVE GROUND HEIGHT OF THE BARRIER AND DISPOSED IN THE MANNER DESCRIBED ELSEWHERE IN THE PLAN.
- 5. COMPOST FILTER SOCKS SHALL BE INSPECTED WEEKLY AND AFTER EACH RUNOFF EVENT. DAMAGED SOCKS SHALL BE REPAIRED ACCORDING TO MANUFACTURER'S SPECIFICATIONS OR REPLACED WITHIN 24 HOURS OF INSPECTION.
- 6. BIODEGRADABLE COMPOST FILTER SOCKS SHALL BE REPLACED AFTER 6 MONTHS; PHOTODEGRADABLE SOCKS AFTER 1 YEAR. POLYPROPYLENE SOCKS SHALL BE REPLACED ACCORDING TO MANUFACTURER'S RECOMMENDATIONS.
- 7. UPON STABILIZATION OF THE AREA TRIBUTARY TO THE SOCK, STAKES SHALL BE REMOVED. THE SOCK MAY BE LEFT IN PLACE AND VEGETATED OR REMOVED. IN THE LATTER CASE, THE MESH SHALL BE CUT OPEN AND THE MULCH SPREAD AS A SOIL SUPPLEMENT.
- 8. SOME OBJECTS OF CONSIDERABLE MASS (I.E CONCRETE BLOCKS, SAND BAGS, ETC.) MUST BE USED IMMEDIATELY DOWNSLOPE OF COMPOST SOCKS PLACED ON PAVED SURFACES (AT THE SAME INTERVALS AS RECOMMENDED BY THE MANUFACTURER FOR STAKES) IN ORDER TO SECURE SOCKS IN PLACE.



ELEVATION

C-311/

EXTEND FENCE TO

EDGE OF DRIPLINE

TREE PROTECTION FENCE

EXISTING TREE

CHAIN LINK FENCE; SECURE-WITH PLASTIC TIES

HAY BALES TO SURROUND TRUNK

PROTECT EXISTING GROUND

SURFACE WITHIN DRIPLINE


CHAIN LINK FENCE

PROTECTION FENCE

NTS

FREE STANDING DRIPLINE

PLAN

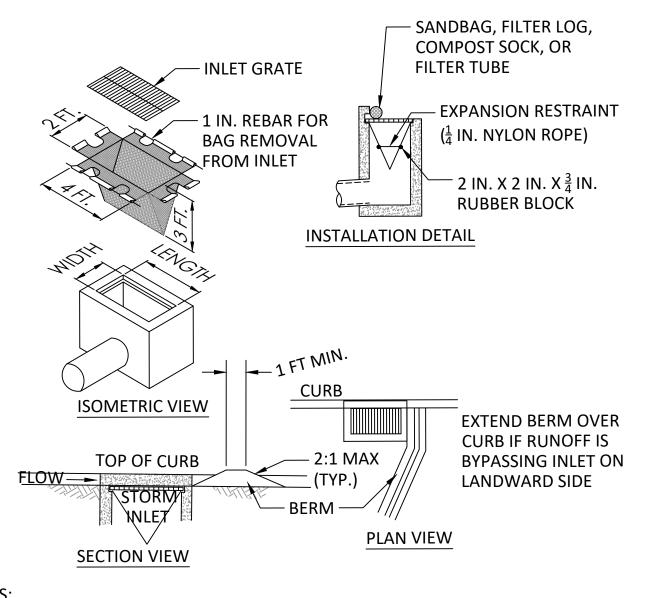


NOTES:

- 1. MAXIMUM DRAINAGE AREA = 1/2 ACRE.
- 2. INLET PROTECTION SHALL NOT BE REQUIRED FOR INLET TRIBUTARY TO SEDIMENT BASIN OR TRAP. BERMS SHALL BE REQUIRED FOR ALL INSTALLATIONS.
- 3. ROLLED EARTHEN BERM SHALL BE MAINTAINED UNTIL ROADWAY IS STONED.
 ROAD SUBBASE BERM SHALL BE MAINTAINED UNTIL ROADWAY IS PAVED. SIX INCH
 MINIMUM HEIGHT ASPHALT BERM SHALL BE MAINTAINED UNTIL ROADWAY
 SURFACE RECEIVES FINAL COAT.
- 4. AT A MINIMUM, THE FABRIC SHALL HAVE A MINIMUM GRAB TENSILE STRENGTH OF 120 LBS, A MINIMUM BURST STRENGTH OF 200 PSI, AND A MINIMUM TRAPEZOIDAL TEAR STRENGTH OF 50 LBS. FILTER BAGS SHALL BE CAPABLE OF TRAPPING ALL PARTICLES NOT PASSING A NO. 40 SIEVE.
- 5. INLET FILTER BAGS SHALL BE INSPECTED ON A WEEKLY BASIS AND AFTER EACH RUNOFF EVENT. BAGS SHALL BE EMPTIED AND RINSED OR REPLACED WHEN HALF FULL OR WHEN FLOW CAPACITY HAS BEEN REDUCED SO AS TO CAUSE FLOODING OR BYPASSING OF THE INLET. DAMAGED OR CLOGGED BAGS SHALL BE REPLACED. A SUPPLY SHALL BE MAINTAINED ON SITE FOR REPLACEMENT OF BAGS. ALL NEEDED REPAIRS SHALL BE INITIATED IMMEDIATELY AFTER THE INSPECTION. DISPOSE OF ACCUMULATED SEDIMENT AS WELL AS ALL USED BAGS ACCORDING TO THE PLAN NOTES.
- 6. DO NOT USE ON MAJOR PAVED ROADWAYS WHERE PONDING MAY CAUSE TRAFFIC HAZARDS.





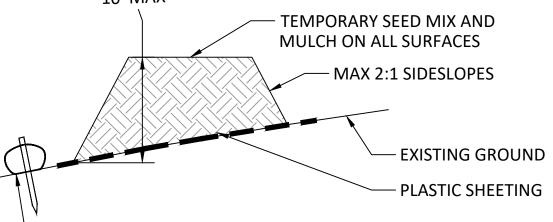

 24" Ø COMPOST SOCK ON LOW SIDE AS SHOWN ON PLAN AND AROUND BOTH ENDS OF STOCKPILE; MAINTAIN AS SPECIFIED ON DETAILS

MAINTENANCE NOTES:

- 1. TEMPORARILY STOCKPILE TOPSOIL OR EXCAVATED SOIL MATERIAL AS NEEDED AT LOCATIONS SHOWN FOR EACH PHASE OF CONSTRUCTION. EXCESS EXCAVATED MATERIAL SHALL BE PERMANENTLY REMOVED FROM THE SITE.
- 2. HEIGHT AND SIDESLOPES SHALL NOT EXCEED MAXIMUM VALUES SHOWN ON DETAIL.
- INSTALL COMPOST SOCK PRIOR TO STOCKPILING OF MATERIAL. REPLACE ANY COMPOST SOCK REMOVED FOR VEHICULAR ACCESS AFTER EACH WORK DAY.
- 4. APPLY SEED AND MULCH WHEN PILE IS NOT SUBJECT TO VEHICULAR ACCESS FOR SEVEN DAYS OR MORE.





1. REMOVE TOPSOIL PRIOR TO INSTALLATION OF ROCK CONSTRUCTION ENTRANCE. EXTEND ROCK OVER FULL WIDTH OF ENTRANCE.

* MOUNTABLE BERM USED TO PROVIDE PROPER

GEOTEXTILE

- EXISTING

GROUND

COVER FOR PIPE

2. RUNOFF SHALL BE DIVERTED FROM ROADWAY TO A SUITABLE SEDIMENT REMOVAL BMP PRIOR TO ENTERING ROCK CONSTRUCTION ENTRANCE.

PLAN VIEW

MOUNTABLE

BERM (6 IN.

MIN.)*

- EARTH FILL

AASHTO #1 PIPE AS NECESSARY

- 3. MOUNTABLE BERM SHALL BE INSTALLED WHEREVER OPTIONAL CULVERT PIPE IS USED AND PROPER PIPE COVER AS SPECIFIED BY MANUFACTURER IS NOT OTHERWISE PROVIDED. PIPE SHALL BE SIZED APPROPRIATELY FOR SIZE OF DITCH BEING CROSSED.
- 4. MAINTENANCE: ROCK CONSTRUCTION ENTRANCE THICKNESS SHALL BE CONSTANTLY MAINTAINED TO THE SPECIFIED DIMENSIONS BY ADDING ROCK. A STOCKPILE SHALL BE MAINTAINED ON SITE FOR THIS PURPOSE. ALL SEDIMENT DEPOSITED ON PAVED ROADWAYS SHALL BE REMOVED AND RETURNED TO THE CONSTRUCTION SITE IMMEDIATELY. IF EXCESSIVE AMOUNTS OF SEDIMENT ARE BEING DEPOSITED ON ROADWAY, EXTEND LENGTH OF ROCK CONSTRUCTION ENTRANCE BY 50 FOOT INCREMENTS UNTIL CONDITION IS ALLEVIATED OR INSTALL WASH RACK. WASHING THE ROADWAY OR SWEEPING THE DEPOSITS INTO ROADWAY DITCHES, SEWERS, CULVERTS, OR OTHER DRAINAGE COURSES IS NOT ACCEPTABLE.

3 ROCK CONSTRUCTION ENTRANCE
NTS



NOTE: USE CURB CUT
BARRIER AT ALL OPENINGS

12" WIDE CURB CUT AT
BOTTOM; 15" WIDE AT
TOP
FLOW

1½" THICK PLYWOOD
BOARD
SANDBAG

CURB CUT BARRIER

NTS

PROPERTY ADDRESS:

CHEW PLAYGROUND 1800 WASHINGTON AVE PHILADELPHIA, PA 19146

PROPERTY OWNER:



PHILADELPHIA PARKS &
RECREATION DEPARTMENT
1515 ARCH STREET
SUITE #10
PHILADELPHIA, PA 19102

PROJECT MANAGER:



REBUILD PHILADELPHIA
1515 ARCH STREET
MEZZANINE LEVEL
PHILADELPHIA, PA 19107

PROJECT PARTNERS:

PROJECT TITLE:


CHEW PLAYGROUND FIELD RENOVATION

CIVIL ENGINEER:

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DRAWING TITLE:

EROSION AND SEDIMENTATION CONTROL DETAILS

ATE: DRAWING NO: 02/04/2022 CALE: N.T.S.
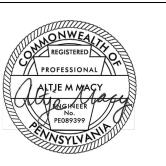
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- .. AN INDUSTRIAL WASTE PERMIT WILL BE REQUIRED SHOULD PUMPING TO CITY-OWNED INFRASTRUCTURE BECOME NECESSARY DURING CONSTRUCTION. ALL PUMPING OF WATER FROM ANY WORK AREA SHALL BE DONE ACCORDING TO THE PROCEDURE DESCRIBED IN THIS PLAN, OVER UNDISTURBED VEGETATED AREAS.
- INLET PROTECTION SHOULD BE PROVIDED FOR ALL INLETS OWNED BY PWD THAT ARE LOCATED WITHIN ONE BLOCK OF THE PROJECT SITE.
- 3. PWD IS NOT RESPONSIBLE FOR ANY CLEANING OR REPAIRS NEEDED ON CITY-OWNED INFRASTRUCTURE DUE TO FAILURE OF ANY EROSION AND SEDIMENT CONTROL PRACTICES. CONTRACTOR IS RESPONSIBLE FOR CLEANING OR REPAIRS NEEDED ON CITY-OWNED INFRASTRUCTURE DUE TO FAILURE OF ANY EROSION AND SEDIMENT CONTROL PRACTICES.
- 4. INSPECTION AND MAINTENANCE OF ALL EROSION AND SEDIMENT CONTROL BEST MANAGEMENT PRACTICES SHALL OCCUR ON A WEEKLY BASIS, BEFORE ANY ANTICIPATED PRECIPITATION EVENTS, AND AFTER ALL PRECIPITATION EVENTS.
- 5. THE MAXIMUM HEIGHT FOR STOCKPILES AREAS SHALL BE 20 FEET. THE MAXIMUM SIDE SLOPE FOR STOCKPILE AREAS SHALL NOT EXCEED 2:1.
- 6. THE ROCK CONSTRUCTION ENTRANCE THICKNESS SHALL BE CONSTANTLY MAINTAINED ON-SITE. A STOCKPILE SHALL BE MAINTAINED ON-SITE FOR THIS PURPOSE. AT THE END OF EACH CONSTRUCTION DAY, ALL SEDIMENT DEPOSITED ON PAVED ROADWAYS SHALL BE REMOVED AND RETURNED TO THE CONSTRUCTION SITE. IN NO CASE SHALL THE SEDIMENT BE WASHED, SHOVELED, OR SWEPT INTO ANY ROADSIDE DITCH, STORM SEWER, OR SURFACE WATER.
- 7. COMPOST SOCK SHOULD BE INSTALLED AT LEVEL GRADE. BOTH ENDS OF EACH COMPOST SOCK SECTION SHOULD BE EXTENDED AT LEAST 8 FEET UPSLOPE AT 45 DEGREES TO THE MAIN BARRIER ALIGNMENT. SUPPORT STAKES OR SAND BAGS SHALL BE SPACED AT A MAXIMUM OF 8 FEET. SEDIMENT MUST BE REMOVED WHEN ACCUMULATIONS REACH 1/2 THE ABOVE GROUND HEIGHT OF THE COMPOST SOCK.
- 8. ANY FENCE OR SOCK SECTION WHICH HAS BEEN UNDERMINED OR TOPPED MUST BE IMMEDIATELY REPLACED WITH A ROCK FILTER OUTLET. SEDIMENT MUST BE REMOVED WHEN ACCUMULATIONS REACH 1/3 THE HEIGHT OF THE OUTLET.
- 9. EROSION CONTROL BLANKETING SHALL BE INSTALLED ON ALL SLOPES 3H:1V OR STEEPER WITHIN 50 FEET OF A SURFACE WATER AND ON ALL OTHER DISTURBED AREAS SPECIFIED ON THE PLAN MAPS AND/OR DETAIL SHEETS.
- 10. IMMEDIATELY UPON DISCOVERING UNFORESEEN CIRCUMSTANCES POSING THE POTENTIAL FOR ACCELERATED EROSION AND/OR SEDIMENT POLLUTION, THE OPERATOR SHALL IMPLEMENT APPROPRIATE BEST MANAGEMENT PRACTICES TO MINIMIZE THE POTENTIAL FOR EROSION AND SEDIMENT POLLUTION AND NOTIFY PWD AND PA DEP.
- 11. UNTIL THE SITE IS STABILIZED, ALL E&S BMPS SHALL BE MAINTAINED PROPERLY. MAINTENANCE SHALL INCLUDE INSPECTIONS OF ALL E&S BMPS PRIOR TO ANY ANTICIPATED STORM EVENT, AFTER EACH RUNOFF EVENT AND ON A WEEKLY BASIS. ALL PREVENTATIVE AND REMEDIAL MAINTENANCE WORK, INCLUDING CLEAN OUT, REPAIR, REPLACEMENT, REGRADING, RESEEDING, REMULCHING, AND RENETTING, MUST BE PERFORMED IMMEDIATELY. IF THE E&S BMPS FAIL TO PERFORM AS EXPECTED, REPLACEMENT BMPS, OR MODIFICATIONS OF THOSE INSTALLED, WILL BE REQUIRED.
- 12. ALL EARTH DISTURBANCES, INCLUDING CLEARING AND GRUBBING, AS WELL AS CUTS AND FILLS, SHALL BE DONE IN ACCORDANCE WITH THE APPROVED E&S PLAN. A COPY OF THE APPROVED DRAWINGS MUST BE AVAILABLE AT THE PROJECT SITE AT ALL TIMES. PWD SHALL BE NOTIFIED OF ANY CHANGES TO THE APPROVED PLAN PRIOR TO IMPLEMENTATION OF THOSE CHANGES. PWD MAY REQUIRE A WRITTEN SUBMITTAL OF THOSE CHANGES FOR REVIEW AND APPROVAL AT ITS DISCRETION.
- 13. AT LEAST THREE (3) DAYS PRIOR TO STARTING ANY EARTH DISTURBANCE ACTIVITIES, OR EXPANDING INTO AN AREA PREVIOUSLY UNMARKED, THE PENNSYLVANIA ONE CALL SYSTEM INC. SHALL BE NOTIFIED AT 1-800-242-1776 FOR THE LOCATION OF EXISTING UNDERGROUND UTILITIES.
- 14. ALL EARTH DISTURBANCE ACTIVITIES SHALL PROCEED IN ACCORDANCE WITH THE SEQUENCE PROVIDED ON THE PLAN DRAWINGS. DEVIATION FROM THAT SEQUENCE MUST BE APPROVED IN WRITING BY PWD AND THE PA DEP PRIOR TO IMPLEMENTATION.
- 15. AREAS TO BE FILLED ARE TO BE CLEARED, GRUBBED, AND STRIPPED OF TOPSOIL TO REMOVE TREES, VEGETATION, ROOTS, AND OTHER OBJECTIONABLE MATERIAL.
- 16. CLEARING, GRUBBING, AND TOPSOIL STRIPPING SHALL BE LIMITED TO THOSE AREAS DESCRIBED IN EACH STAGE OF THE CONSTRUCTION SEQUENCE. GENERAL SITE CLEARING, GRUBBING, AND TOPSOIL STRIPPING MAY NOT COMMENCE IN ANY STAGE OF THE PROJECT UNTIL THE E&S BMPS SPECIFIED BY THE BMP SEQUENCE FOR THAT STAGE HAVE BEEN INSTALLED AND ARE FUNCTIONING AS DESCRIBED IN THIS E&S PLAN.
- 17. AT NO TIME SHALL CONSTRUCTION VEHICLES BE ALLOWED TO ENTER AREAS OUTSIDE THE LIMIT OF DISTURBANCE BOUNDARIES SHOWN ON THE PLAN MAPS. THESE AREAS MUST BE CLEARLY MARKED AND FENCED OFF BEFORE CLEARING AND GRUBBING OPERATIONS BEGIN.
- 18. A LOG SHOWING DATES THAT E&S BMPS WERE INSPECTED AS WELL AS ANY DEFICIENCIES FOUND AND THE DATE THEY WERE CORRECTED SHALL BE MAINTAINED ON THE SITE AND BE MADE AVAILABLE TO PWD AT THE TIME OF INSPECTION.
- 19. ALL SEDIMENT REMOVED FROM BMPS SHALL BE DISPOSED OF PER APPROVED METHODS DESCRIBED IN RECYCLING PROGRAM NOTES.
- 20. AREAS WHICH ARE TO BE TOPSOILED SHALL BE SCARIFIED TO A MINIMUM DEPTH OF THREE TO FIVE INCHES SIX TO 12 INCHES ON COMPACTED SOILS PRIOR TO PLACEMENT OF TOPSOIL. AREAS TO BE VEGETATED SHALL HAVE A MINIMUM FOUR INCHES OF TOPSOIL IN PLACE PRIOR TO SEEDING AND MULCHING. FILL OUTSLOPES SHALL HAVE A MINIMUM OF TWO INCHES OF TOPSOIL.
- 21. ALL FILLS SHALL BE COMPACTED AS REQUIRED TO REDUCE EROSION, SLIPPAGE, SETTLEMENT, SUBSIDENCE, OR OTHER RELATED PROBLEMS. FILL INTENDED TO SUPPORT BUILDINGS, STRUCTURES, AND CONDUITS, ETC. SHALL BE COMPACTED IN ACCORDANCE WITH LOCAL REQUIREMENTS OR CODES.
- 22. ALL EARTHEN FILLS SHALL BE PLACED IN COMPACTED LAYERS NOT TO EXCEED NINE INCHES IN THICKNESS.

- 23. FILL MATERIALS SHALL BE FREE OF FROZEN PARTICLES, BRUSH, ROOTS, SOD, OR OTHER FOREIGN OR OBJECTIONABLE MATERIALS THAT WOULD INTERFERE WITH OR PREVENT CONSTRUCTION OF SATISFACTORY FILLS.
- 24. FROZEN MATERIALS OR SOFT, MUCKY, OR HIGHLY COMPRESSIBLE MATERIALS SHALL NOT BE INCORPORATED INTO FILLS.
- 25. FILL SHALL NOT BE PLACED ON SATURATED OR FROZEN SURFACES.
- 26. SEEPS OR SPRINGS ENCOUNTERED DURING CONSTRUCTION SHALL BE HANDLED IN ACCORDANCE WITH THE STANDARD AND SPECIFICATION FOR SUBSURFACE DRAIN OR OTHER APPROVED METHOD.
- 27. ALL GRADED AREAS SHALL BE PERMANENTLY STABILIZED IMMEDIATELY UPON REACHING FINISHED GRADE. CUT SLOPES IN COMPETENT BEDROCK AND ROCK FILLS NEED NOT BE VEGETATED. SEEDED AREAS WITHIN 50 FEET OF A SURFACE WATER, OR AS OTHERWISE SHOWN ON THE PLAN DRAWINGS, SHALL BE BLANKETED ACCORDING TO THE STANDARDS OF THIS PLAN.
- 28. IMMEDIATELY AFTER EARTH DISTURBANCE ACTIVITIES CEASE IN ANY AREA OR SUBAREA OF THE PROJECT, THE OPERATOR SHALL STABILIZE ALL DISTURBED AREAS. DURING NON-GERMINATING MONTHS, MULCH OR PROTECTIVE BLANKETING SHALL BE APPLIED AS DESCRIBED IN THE PLAN. AREAS NOT AT FINISHED GRADE, WHICH WILL BE REACTIVATED WITHIN ONE YEAR, MAY BE STABILIZED IN ACCORDANCE WITH THE TEMPORARY STABILIZATION SPECIFICATIONS. THOSE AREAS WHICH WILL NOT BE REACTIVATED WITHIN ONE YEAR SHALL BE STABILIZED IN ACCORDANCE WITH THE PERMANENT STABILIZATION SPECIFICATIONS.
- 29. PERMANENT STABILIZATION IS DEFINED AS A MINIMUM UNIFORM, PERENNIAL 70% VEGETATIVE COVER OR OTHER PERMANENT NON-VEGETATIVE COVER WITH A DENSITY SUFFICIENT TO RESIST ACCELERATED EROSION. CUT AND FILL SLOPES SHALL BE CAPABLE OF RESISTING FAILURE DUE TO SLUMPING, SLIDING, OR OTHER MOVEMENTS.
- 30. E&S BMPS SHALL REMAIN FUNCTIONAL AS SUCH UNTIL ALL AREAS TRIBUTARY TO THEM ARE PERMANENTLY STABILIZED OR UNTIL THEY ARE REPLACED BY ANOTHER BMP APPROVED BY PWD AND PA DEP.
- 31. AFTER FINAL SITE STABILIZATION HAS BEEN ACHIEVED, TEMPORARY E&S BMPS MUST BE REMOVED OR CONVERTED TO PERMANENT POST-CONSTRUCTION STORMWATER MANAGEMENT PRACTICES. AREAS DISTURBED DURING REMOVAL OR CONVERSION OF THE E&S BMPS SHALL BE STABILIZED IMMEDIATELY. IN ORDER TO ENSURE RAPID REVEGETATION OF DISTURBED AREAS, SUCH REMOVAL/CONVERSIONS ARE TO BE DONE ONLY DURING THE GERMINATING SEASON.
- 32. SEDIMENT BASINS AND/OR TRAPS SHALL BE KEPT FREE OF ALL CONSTRUCTION WASTE, WASH WATER, AND OTHER DEBRIS HAVING POTENTIAL TO CLOG THE BASIN/TRAP OUTLET STRUCTURES AND/OR POLLUTE THE SURFACE WATERS. (WHEN APPLICABLE)
- 33. DURING CONSTRUCTION, THE SELECTED CONTRACTOR IS EXPECTED TO FOLLOW THE PCSMP APPROVED BY PWD. NO CHANGE OR DEVIATION FROM THE APPROVED PCSMP IS PERMITTED WITHOUT PRIOR APPROVAL FROM PWD.
- 34. ALL WORK ASSOCIATED WITH PWD WATER CONVEYANCE AND SEWER INFRASTRUCTURE SHALL BE DONE IN ACCORDANCE WITH THE CITY OF PHILADELPHIA WATER DEPARTMENT "WATER MAIN STANDARD DETAILS AND CORROSION CONTROL SPECIFICATIONS," 1985 EDITION, AND "STANDARD DETAILS AND STANDARD SPECIFICATIONS FOR SEWERS," 1985 EDITION.
- 35. CONTACT PWD WASTER TRANSPORT RECORDS (1101 MARKET STREET, 2ND FLOOR, PHONE: 215-685-6271) FOR ADDITIONAL APPROVALS AND PERMITS REQUIRED FOR ALL WATER SERVICES, METERS, AND CONNECTIONS TO THE EXISTING AND/OR PROPOSED PWD FACILITIES.
- 36. ALL BUILDING MATERIALS AND WASTES SHALL BE REMOVED FROM THE SITE AND RECYCLED OR DISPOSED OF IN ACCORDANCE WITH THE PA DEP SOLID WASTE MANAGEMENT REGULATIONS AT 25 PA CODE 260.1 ET SEQ., 271.1, AND 287.1 ET SEQ. NO BUILDING MATERIALS OR WASTES OR UNUSED BUILDING MATERIALS SHALL BE BE BURNED. BURIED. DUMPED. OR DISCHARGED AT THE SITE.
- 37. A DUST CONTROL PERMIT WILL BE REQUIRED WHEN COMPLETELY DEMOLISHING A BUILDING OR STRUCTURE THAT IS MORE THAN THREE STORIES, GREATER THAN FORTY FEET TALL, OR ENCOMPASSES MORE THAN TEN THOUSAND SQUARE FEET; COMPLETELY OR PARTIALLY DEMOLISHING ANY BUILDING OR STRUCTURE BY IMPLOSION; OR ENGAGING IN EARTHWORKS DEFINED AS "CLEARING, GRUBBING, OR EARTH DISTURBANCE OF ANY LAND IN EXCESS OF 5,000 SQUARE FEET."

DUST CONTROL NOTES

- 1. NOTIFY OCCUPANTS OF NEARBY PROPERTIES, IN WRITING, TEN (10) DAYS BEFORE ENGAGING IN EARTHWORKS (EXCAVATION, LAND CLEARING, OR OTHER ACTIVITY THAT WILL DISTURB MORE THAN 5,000 SQ. FT. LAND AREA), CONSTRUCTION, AND DEMOLITION ACTIVITIES
- 2. FOR EARTHWORKS, OR CONSTRUCTION/DEMOLITION INVOLVING STRUCTURES >2 STORIES IN HEIGHT WRITTEN NOTIFICATION MUST BE DISTRIBUTED TO THE OCCUPANTS OF THE THREE (3) NEAREST PROPERTIES ON EITHER SIDE OF THE WORKSITE, THE SEVEN (7) NEAREST PROPERTIES ACROSS THE STREET FROM THE WORKSITE, AND THE SEVEN (7) NEAREST PROPERTIES TO THE REAR OF THE WORKSITE.
- 3. FOR CONSTRUCTION/DEMOLITION INVOLVING STRUCTURES <2 STORIES IN HEIGHT WRITTEN NOTIFICATION TO PROPERTIES ADJACENT TO WORKSITE
- 4. CONSTRUCTION AND DEMOLITION WORK PRACTICES TO REDUCE/MINIMIZE DUST:
- 4.a. FUGITIVE DUST FROM CONSTRUCTION, DEMOLITION, AND EARTHWORKS ACTIVITIES MAY NOT BE VISIBLE AT THE POINT IT PASSES THE WORKSITE PROPERTY LINE
- 4.b. USE OF VACUUM OR SIMILAR SUCTION SYSTEMS TO CAPTURE DUST KICKED UP BY POWER TOOLS WHEN GRINDING.CUTTING
- 4.c. APPLICATION OF WATER OR APPROVED DUST SUPPRESSANT TO A WORKSITE WITH ONGOING EXCAVATION, LAND CLEARING, DEMOLITION, OR OTHER EARTH DISTURBANCE RELATED ACTIVITIES TO SUPPRESS DUST FORMATION
- 4.d. GENERAL PROHIBITION AGAINST DRY ABRASIVE BLASTING OF EXTERIOR SURFACES OPEN TO THE OUTSIDE AIR WHEN TEMPERATURE IS ABOVE FREEZING

- 4.e. COVERING AND WETTING OF STOCKPILED EARTH, SAND, GRAVEL, AND OTHER SIMILAR CONSTRUCTION MATERIALS
- 4.f. USE OF A MATERIAL CHUTE WHEN DROPPING MATERIAL OR DEBRIS MORE THAN 20 FT OUTSIDE OF THE EXTERIOR WALLS OF A BUILDING OR STRUCTURE. MATERIALS MUST BE WETTED WHEN DROPPED, AND/OR EXIT OF CHUTE MUST BE SEALED AGAINST THE TOP OF THE RECEIVING CONTAINER/DUMPSTER
- 4.g. ALL TEMPORARY PERIMETER FENCING AROUND MUST HAVE DUST CONTROL FABRIS; MUST MEASURE A MINIMUM OF 5 FT. IN HEIGHT FROM THE BOTTOM OF THE FENCING
- 4.h. A 10 MILES PER HOUR SPEED LIMIT FOR ALL EQUIPMENT AND TRUCKS TRAVELING WITHIN THE WORKSITE
- 4.i. WETTING AND SWEEPING OF ROADWAYS/ACCESS ROADS IN A WORKSITE TO PREVENT DUST FORMATION
- 4.j. VEHICLE ACCESS POINTS MUST BE EQUIPPED WUTH DUST SUPPRESSION MEASURES (I.E. WHEEL WASH SYSTEMS, RUMBLE GATES, AND/OR GRAVEL PADS

RECYCLING PROGRAM

1. THE CONTRACTOR SHALL REMOVE FROM THE SITE, RECYCLE, OR DISPOSE OF ALL BUILDING MATERIALS AND WASTES IN ACCORDANCE WITH THE DEPARTMENT'S SOLID WASTE MANAGEMENT REGULATIONS 25 PA CODE 260.1 ET SEQ., 271.1 ET SEQ., AND 287.1 ET SEQ. THE CONTRACTOR SHALL NOT ILLEGALLY BURY, DUMP OR DISCHARGE ANY BUILDING MATERIAL OR WASTES. CONSTRUCTION WASTES INCLUDE, BUT ARE NOT LIMITED TO, EXCESS SOIL MATERIALS, BUILDING MATERIAL, CONCRETE WASH WATER, SANITARY WASTES, ETC., WHICH COULD ADVERSELY IMPACT WATER QUALITY.

E&S CONTROL SEQUENCE OF BMP INSTALLATION

- 1. PRIOR TO EARTH DISTURBANCE ACTIVITIES, EROSION AND SEDIMENTATION CONTROL BMPS SHALL BE INSTALLED ACCORDING TO THIS SEQUENCE.
- 2. INSTALL TEMPORARY ROCK CONSTRUCTION ENTRANCE AS SHOWN PRIOR TO CLEARING OF THE SITE.
- 3. INSTALL CONSTRUCTION FENCE, COMPOST SOCK INLET PROTECTION AND COMPOST SOCK AS SHOWN ON THE PLAN. NO DISTURBANCE CAN TAKE PLACE OUTSIDE OF THE LIMIT OF DISTURBANCE.
- 4. AFTER FINISHED GRADING, INSTALL EROSION CONTROL BLANKET AS SHOWN ON THE PLAN.
- 5. AFTER FINAL SITE STABILIZATION HAS BEEN ACHIEVED (VEGETATIVE AREAS SHALL BE CONSIDERED PERMANENTLY STABILIZED WHEN A UNIFORM 70% VEGETATIVE COVER OF EROSION RESISTANT PERENNIAL SPECIES HAS BEEN ACHIEVED), REMOVE TEMPORARY EROSION AND SEDIMENTATION CONTROLS. AREAS DISTURBED DURING REMOVAL OF THE CONTROLS MUST ALSO BE STABILIZED IMMEDIATELY.
- 6. UPON SITE STABILIZATION, COMPOST SOCKS MAY BE REMOVED. PLACE COMPOST AS DIRECTED BY THE OWNER AND DISPOSE OF THE GEOTEXTILE SOCK.
- 7. THE CONTRACTOR SHALL TAKE APPROPRIATE MEASURES TO CONTROL DUST GENERATED FROM CONSTRUCTION ACTIVITIES. THIS MAY INCLUDE SPRINKLING/IRRIGATION, VEGETATIVE COVER, MULCHING, AND/OR INSTALLATION WIND BREAKS. SEE THE PA DEP EROSION AND SEDIMENT POLLUTION CONTROL PROGRAM MANUAL, APPENDIX H.

THE CONSTRUCTION PLANS HAVE BEEN DEVELOPED BASED ON AVAILABLE INFORMATION PROVIDED BY THE OWNER. THE PROJECT AREA INCLUDES EXISTING UTILITIES OF UNKNOWN LOCATION AND DEPTH. ACTUAL CONDITIONS MAY DIFFER FROM THE PLANS. THE CONTRACTOR IS RESPONSIBLE FOR VERIFYING ALL CONDITIONS PRIOR TO INITIATING WORK, AND FOR NOTIFYING OWNER IMMEDIATELY UPON BECOMING AWARE OF POTENTIAL CONFLICTS OR VARIATIONS IN CONDITIONS. THE CONTRACTOR IS RESPONSIBLE FOR FIELD VERIFICATION OF ALL UTILITY AND STRUCTURE LOCATIONS AND ELEVATIONS AS REQUIRED FOR CONSTRUCTION.

ALL LOCATIONS OF EXISTING UTILITIES SHOWN ON THIS PLAN HAVE BEEN DEVELOPED FROM EXISTING UTILITY RECORDS AND/OR ABOVE GROUND EXAMINATION OF THE SITE. COMPLETENESS OR ACCURACY OF LOCATION AND DEPTH OF UNDERGROUND UTILITIES OR STRUCTURES CANNOT BE GUARANTEED. CONTRACTOR MUST VERIFY LOCATION AND DEPTH OF ALL UNDERGROUND UTILITIES AND FACILITIES BEFORE START OF WORK PER PENNSYLVANIA ACT 287 OF 1974 AS AMENDED BY ACT 199 OF 2004 OR LATER.

OPERATION AND MAINTENANCE

- 1. THE CONTRACTOR IS RESPONSIBLE FOR THE OPERATION & MAINTENANCE OF ALL E&S AND STORMWATER MANAGEMENT FACILITIES DURING CONSTRUCTION. UPON FINAL APPROVAL AND ACCEPTANCE OF THE PROJECT BY OWNER WILL ASSUME RESPONSIBILITY FOR ALL LONG-TERM MAINTENANCE.
- 2. A WRITTEN MAINTENANCE REPORT MUST BE KEPT AT THE SITE DURING CONSTRUCTION. IT IS THE RESPONSIBILITY OF THE SITE CONTRACTOR TO ENSURE THAT THIS OPERATION & MAINTENANCE SCHEDULE BE MAINTAINED AND LOGGED.

PWD STANDARD SEQUENCE OF CONSTRUCTION NOTES

- 1. AT LEAST SEVEN (7) DAYS PRIOR TO ANY EARTH DISTURBANCE, THE INSPECTIONS COORDINATOR OF PWD (OFFICE: 215-685-6387) MUST BE CALLED TO SCHEDULE A PRE-CONSTRUCTION MEETING.
- AT LEAST THREE (3) DAYS PRIOR TO SMP INSTALLATION, THE INSPECTIONS COORDINATOR OF PWD (OFFICE: 215-685-6387) MUST BE CALLED TO SCHEDULE AN INSPECTION FOR EACH SMP.

- 3. ALL STONE THAT MAKES UP INFILTRATING SMPS MUST REMAIN FREE OF SEDIMENT. IF SEDIMENT ENTERS THE STONE, THE CONTRACTOR MAY BE REQUIRED TO REMOVE THE SEDIMENT AND REPLACE IT WITH CLEAN-WASHED STONE
- 4. UPON COMPLETION OF ALL EARTH DISTURBANCE ACTIVITIES AND PERMANENT STABILIZATION OF ALL DISTURBANCE AREAS, THE OWNER AND/OR OPERATOR SHALL CONTACT THE INSPECTIONS COORDINATOR OF PWD (OFFICE: 215-685-6387) FOR A FINAL INSPECTION PRIOR TO REMOVAL/CONVERSION OF THE E&S BMPS.
- 5. AS SOON AS SLOPES, CHANNELS, DITCHES, AND OTHER DISTURBED AREAS REACH FINAL GRADE, THEY MUST BE STABILIZED. CESSATION OF ACTIVITY FOR FOUR (4) DAYS OR LONGER REQUIRES TEMPORARY STABILIZATION.
- 6. THE NPDES NOTICE OF TERMINATION (N.O.T.) MUST BE SUBMITTED TO PA DEP UPON COMPLETION OF CONSTRUCTION FOR PROJECTS OVER 1 ACRE.
- WATER PUMPED FROM WORK AREAS SHOULD BE TREATED FOR SEDIMENT REMOVAL PRIOR TO DISCHARGING TO A "SURFACE WATER" WHERE APPLICABLE.

TEMPORARY STABILIZATION NOTES

- TEMPORARY STABILIZATION MUST BE PROVIDED FOR EARTH-EXPOSED AREAS WHERE EARTHWORK IS DELAYED OR STOPPED FOR A PERIOD OF 4 OR MORE DAYS, AND PERMANENT STABILIZATION MUST ULTIMATELY BE PROVIDED FOR ALL DISTURBED AREAS.
- 2. WEED-FREE HAY OR STRAW MULCH MUST BE APPLIED AT 3.0 TONS PER ACRE OR PER SEEDING (TURF AND GRASSES) SPECIFICATION. STRAW MULCH SHALL BE APPLIED IN LONG STRANDS, NOT CHOPPED OR FINELY BROKEN.
- 3. TEMPORARY SEEDING SHALL CONSIST OF SOD, A BLEND OF TURF-TYPE TALL FESCUE AND KENTUCKY BLUE GRASS (100 PERCENT BY WEIGHT) OR EQUIVALENT AND SHALL BE PLACED AT 30 LBS. PER ACRE OR 10 LBS. PER 1000 S.F.. TEMPORARY SEEDING SHALL BE APPLIED TO THOSE AREAS THAT ARE A POTENTIAL EROSION RISK AND THOSE AREAS WHERE CONSTRUCTION ACTIVITIES HAVE

PERMANENT STABILIZATION NOTES

PERMANENT STABILIZATION SHOULD BE IN ACCORDANCE WITH ALL LANDSCAPE PLANS AND SPECIFICATIONS.

- 1. VEGETATIVE SPECIES SHALL BE IN ACCORDANCE WITH THE LANDSCAPE PLANTING SCHEDULE, WHICH INCLUDES:
 - a. CANOPY TREES: PER LANDSCAPE PLANTING SCHEDULE
 - b. UNDERSTORY TREES: PER LANDSCAPE PLANTING SCHEDULE.
- c. SHRUBS: PER LANDSCAPE PLANTING SCHEDULE
- d. HERBACEOUS PERENNIALS: PER LANDSCAPE PLANTING SCHEDULE
- 2. % PURE LIVE SEED: PER THE LANDSCAPE PLANTING SCHEDULE.
- 3. SEED APPLICATION RATE: PER THE LANDSCAPE PLANTING SCHEDULE
- 4. FERTILIZER TYPE: PENDING RECOMMENDATIONS FROM SOIL-SAMPLING RESULTS PER LANDSCAPE SPECIFICATION.
- 5. FERTILIZER APPLICATION RATE: PENDING RECOMMENDATIONS FROM SOIL-SAMPLING RESULTS PER LANDSCAPE SPECIFICATION. FOLLOW STATE GUIDELINES ON APPLICATION RATES.
- 6. MULCH TYPE: ORGANIC MULCH: FREE FROM DELETERIOUS MATERIALS AND SUITABLE AS A TOP DRESSING OF TREES AND SHRUBS, PER LANDSCAPE SPECIFICATION AND DETAILS.
- 7. MULCHING RATE: APPLY 3-INCH AVERAGE THICKNESS OF ORGANIC MULCH OVER WHOLE SURFACE OF PLANTING AREA, AND FINISH LEVEL WITH ADJACENT FINISH GRADES.
- 8. LIMING RATE: PENDING RECOMMENDATIONS FROM SOIL-SAMPLING RESULTS PER LANDSCAPE SPECIFICATION. FOLLOW STATE GUIDELINES ON APPLICATION RATES.
- 9. ANCHOR MATERIAL: EROSION CONTROL FABRIC REQUIRED ON ALL SLOPES 3:1 AND GREATER,. EROSION CONTROL BLANKET TO BE BIONET SC150BN EXTENDED TERM BIODEGRADABLE EROSION CONTROL BLANKET BY NORTH AMERICAN GREEN, DISTRIBUTED BY JOBSITE PRODUCTS, INC. HARLEYSVILLE, PA, OR APPROVED EQUAL.
- 10. ANCHORING METHOD: WOODEN STAKES
- 11. RATE OF ANCHOR MATERIAL APPLICATION: OVERLAP BLANKET 6" MINIMUM AND STAPLED; WOODEN STAKES 18" OC.
- 12. TOPSOIL PLACEMENT DEPTH: 36" PLANTING SOIL, IN ACCORDANCE WITH LANDSCAPE SPECIFICATIONS
- 13. SEEDING SEASON DATES: FALL PLANTING: OCTOBER 1 TO NOVEMBER 15.

SOIL AMENDMENT	PER ACRE	PER 1,000 SQ. FT.	PER 1,000 SQ. YD.	NOTES	VEGETATIVE SPECIES	% PURE LIVE SEED	SEED APPLICATION RATE	ANCHOR MATERIAL	ANCHORING METHOD	SEEDING SEASON DATES	
PERMANENT SEEDING	PERMANENT SEEDING APPLICATION RATE										
AGRICULTURAL LIME	2 TONS	240 LB.	800 LB.	OR AS PER SOIL TEST; MAY NOT BE REQUIRED IN AGRICULTURAL FIELDS PENN		S PENNDOT FORMULA MI			WEED-FREE HAY OR STRAW MULCH MUST BE APPLIED AT 3.0 TONS PER ACRE. STRAW		MARCH 15 THRU JUNE 1 OR AUG 1 THRU OCT 15
10-20-20 FERTILIZER	680 LB.	25 LB.	140 LB.	OR AS PER SOIL TEST; MAY NOT BE REQUIRED IN AGRICULTURAL FIELDS	- B MIX	OF 97% LIVE SEED	PER 1000 S.F.	LONG ST	ALL BE APPLIED IN STRANDS, NOT DR FINELY BROKEN.		
TEMPORARY SEEDING APPLICATION RATE											
AGRICULTURAL LIME	1 TON	40 LB.	410 LB.	TYPICALLY NOT REQUIRED FOR TOPSOIL STOCKPILES	OATS (AVERE SATIVA) IN SPRING AND/OR SUMMER, AND	MINIMUM	30 LBS. PER ACRE OR 10	MULCH MUS	HAY OR STRAW T BE APPLIED AT ER ACRE. STRAW	SPRING SEEDING UP TO JUNE 15; LATE SPRING TO SUMMER SEEDING FROM JUNE 16 TO	
10-10-10 FERTILIZER	680 LB.	12.5 LB.	140 LB.	TYPICALLY NOT REQUIRED FOR TOPSOIL STOCKPILES	WINTER WHEAT IN	OF 85% LIVE SEED	LBS. PER 1000 S.F.	LONG ST	L BE APPLIED IN RANDS, NOT	AUGUST 15; LATE SUMMER AND FALL SEEDINF FROM AUGUST 16 AND LATER	

NOTES:

1. ADAPTED FROM PENN STATE, "EROSION CONTROL AND CONSERVATION PLANTINGS ON NONCROPLAND" FOR TEMPORARY SEEDING AND PENNDOT PUBLICATION 408/2020 FOR PERMANENT SEEDING.

PROPERTY ADDRESS:

CHEW PLAYGROUND 1800 WASHINGTON AVE PHILADELPHIA, PA 19146

PROPERTY OWNER:



PHILADELPHIA PARKS &
RECREATION DEPARTMENT
1515 ARCH STREET
SUITE #10
PHILADELPHIA, PA 19102

PROJECT MANAGER:



REBUILD PHILADELPHIA 1515 ARCH STREET MEZZANINE LEVEL PHILADELPHIA, PA 19107

PROJECT PARTNERS:

PROJECT TITLE:

CHEW PLAYGROUND FIELD RENOVATION

IVII ENGINEED:

REVISIONS:

DATE: ISSUE:

CIVIL ENGINEER:
meliora 🖒 🕮 🌘
Civil, Water Resources, and Structural Engineering
259 Morgan St., Phoenixville, PA 19460
P: 610.933.0123 www.melioradesign.com

PROFESSIONAL

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PEO89399

NO.
PEO89399

SUBMISSION:

BID DOCUMENTS

DRAWING TITLE:

EROSION AND SEDIMENTATION


CONTROL NOTES

DATE: DRAWING NO: 02/04/2022 SCALE: N.T.S. C-312

MJR
HECKED BY:

CHECKED BY:

AMM

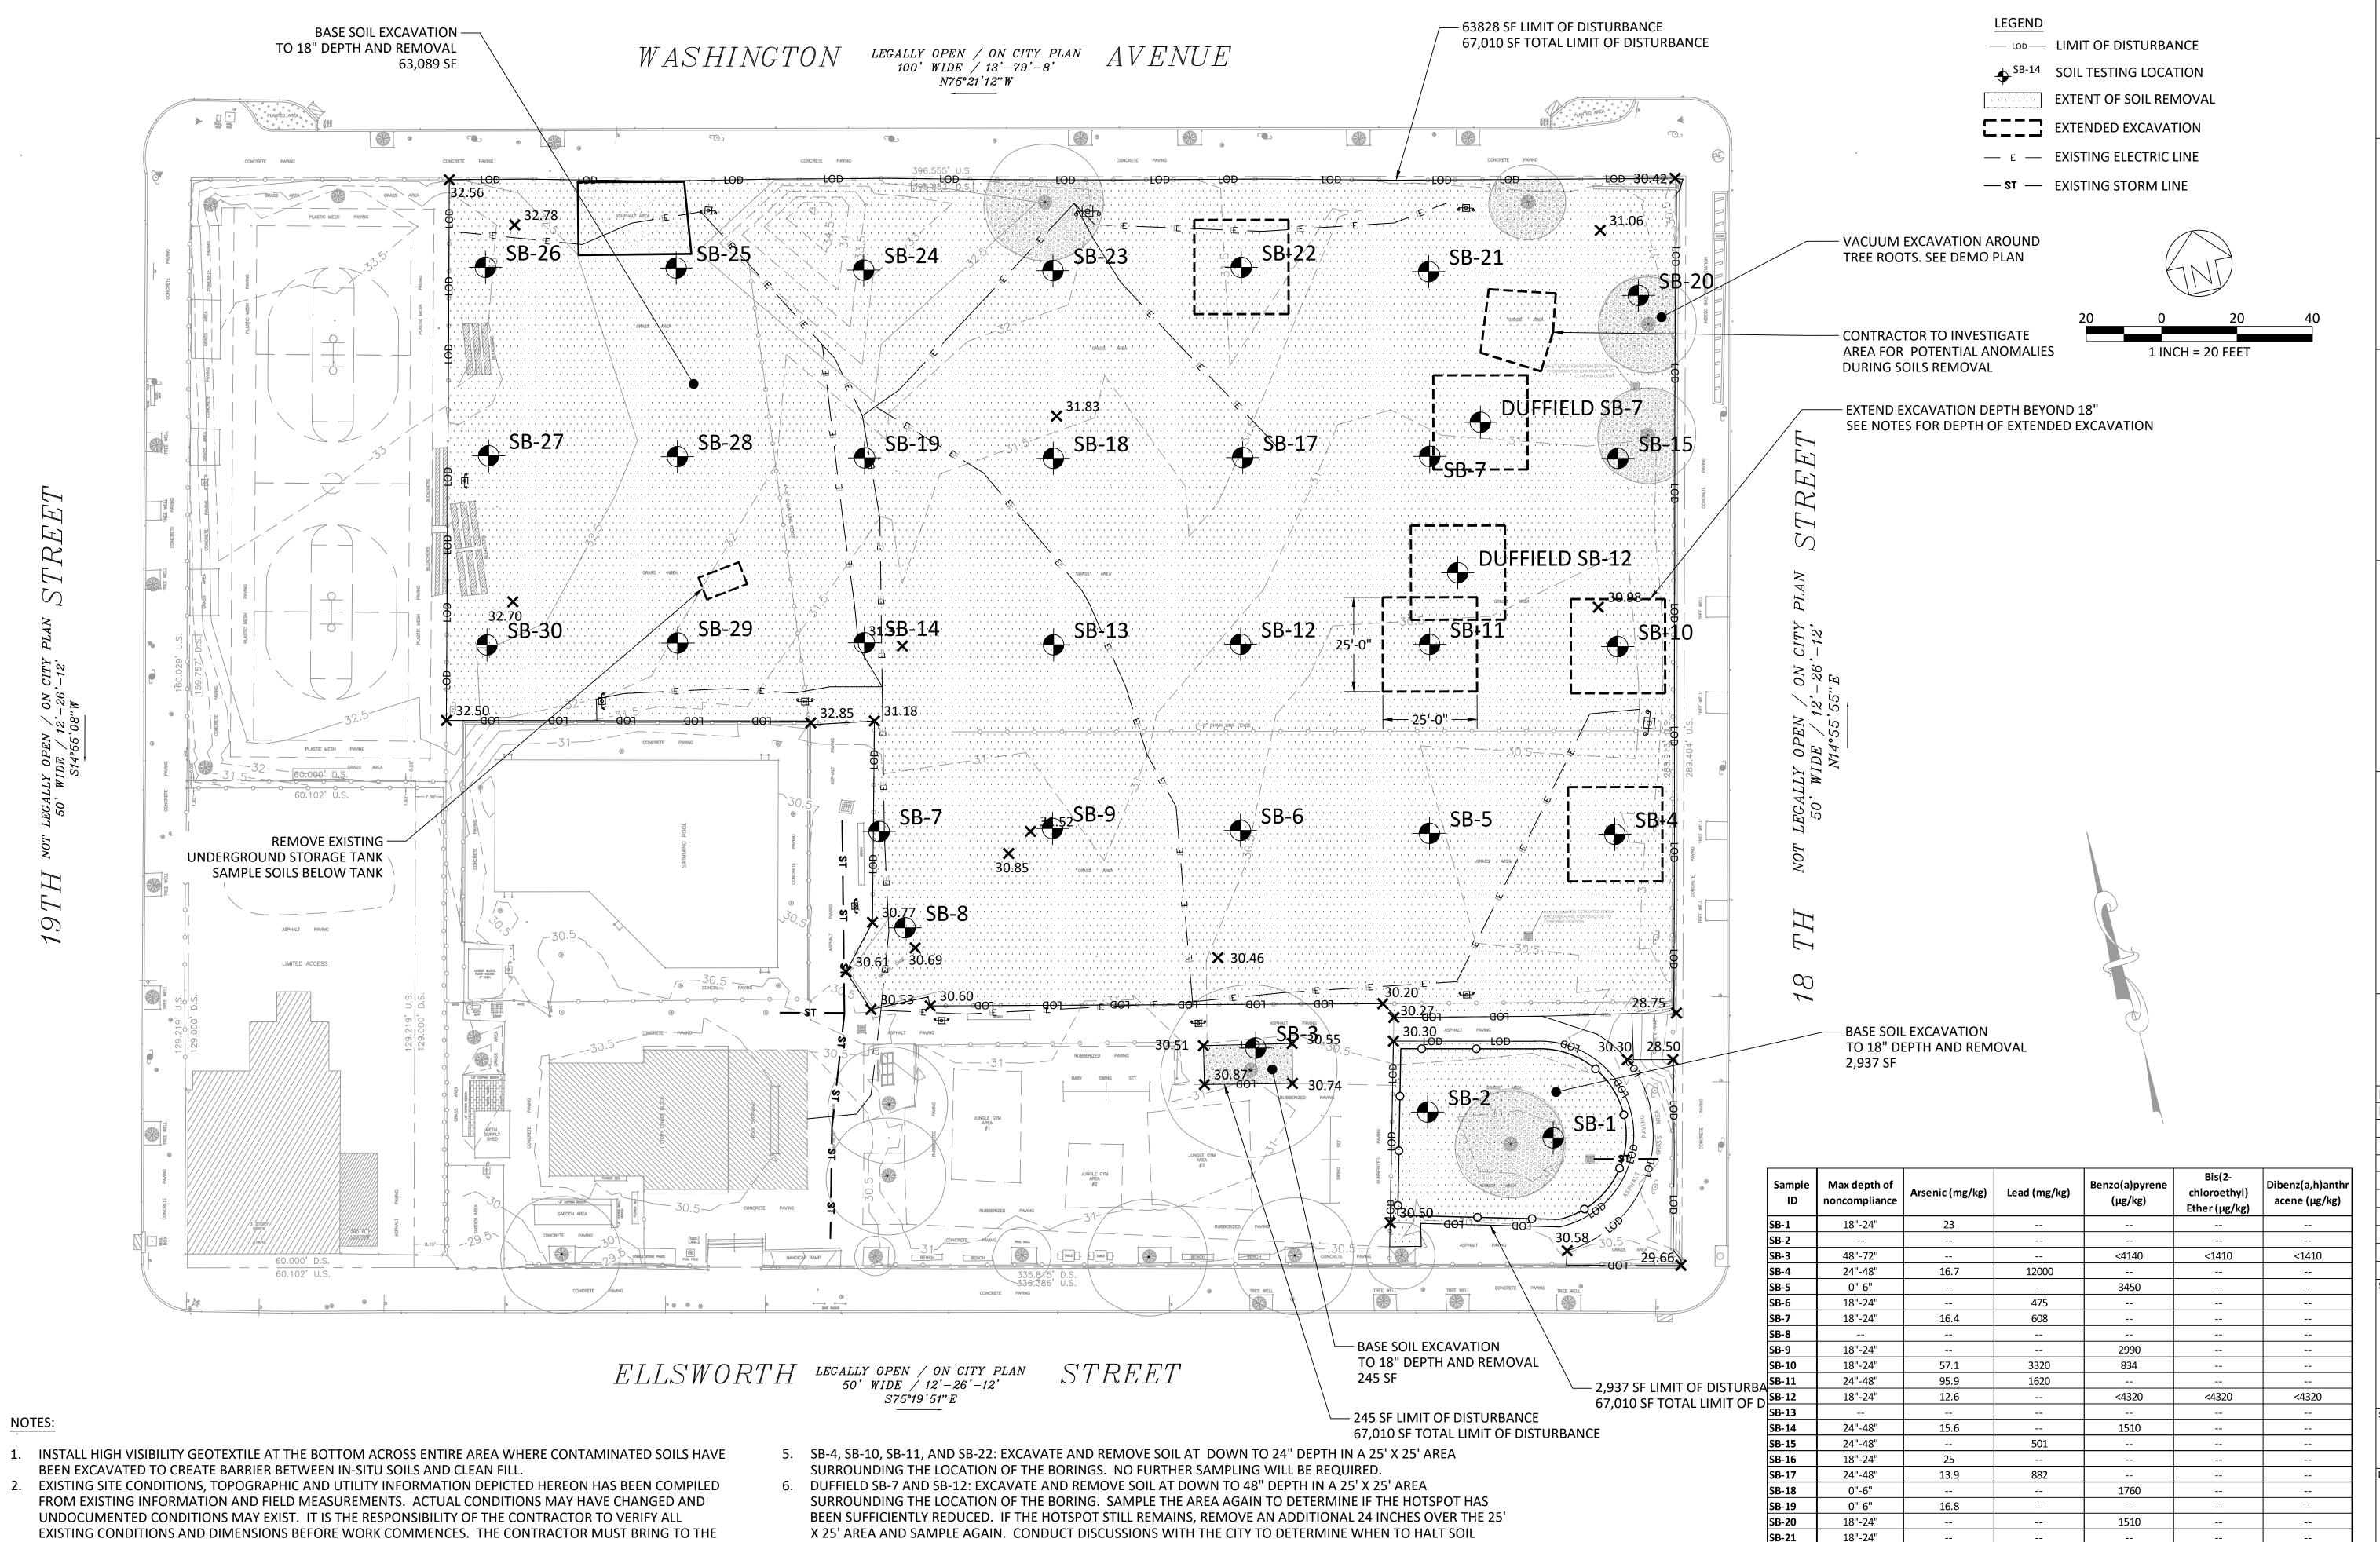

DUFFIELD SB-7: CONTRACTOR SHOULD EXCAVATE AT DOWN TO 48" DEPTH AND BE PREPARED TO EXCAVATE

ADDITIONAL SOIL NEAR THE TEST LOCATION DUE TO ELEVATED LEAD CONCENTRATIONS. CONTRACTOR TO

REMOVAL EFFORTS.

DETERMINE IF SOIL IS HAZARDOUS OR NON-HAZARDOUS.

ATTENTION OF THE ENGINEER ANY DISCREPANCIES BETWEEN FIELD CONDITIONS AND DRAWINGS PRIOR TO

BEGINNING WORK. FIELD CONDITION DISCREPANCIES SHALL NOT BE USED AS THE BASIS FOR CHANGE ORDER

ELEVATIONS OF ALL UTILITIES OR OTHER STRUCTURES BEFORE STARTING WORK. MANY UNDERGROUND UTILITY

3. THE CONTRACTOR SHALL BE RESPONSIBLE FOR VERIFYING THE EXISTENCE, EXACT LOCATIONS, SIZE AND

4. EXCAVATE BELOW ELECTRICAL CONDUITS, DEPTH UNKNOWN, AND INSTALL GEOTEXTILE BARRIER BELOW TO

LOCATIONS AS SHOWN ARE APPROXIMATE, AND INFORMATION MAY BE MISSING.

CLAIMS ONCE CONSTRUCTION ACTIVITIES HAVE COMMENCED.

ALLOW FOR FUTURE MAINTENANCE.

PROPERTY ADDRESS:

CHEW PLAYGROUND 1800 WASHINGTON AVE PHILADELPHIA, PA 19146

PROPERTY OWNER:



PHILADELPHIA PARKS & RECREATION DEPARTMENT 1515 ARCH STREET SUITE #10 PHILADELPHIA, PA 19102

PROJECT MANAGER:



REBUILD PHILADELPHIA 1515 ARCH STREET MEZZANINE LEVEL PHILADELPHIA, PA 19107

PROJECT PARTNERS:

PROJECT TITLE:

CHEW PLAYGROUND FIELD RENOVATION

CIVIL ENGINEER:

meliora 🗘 🕮 🤄 Civil, Water Resources, and Structural Engineering 259 Morgan St., Phoenixville, PA 19460 P: 610.933.0123 | www.melioradesign.com

REVISIONS:

DATE: ISSUE:

RAWN BY:

18"-24"

24"-48"

18"-24"

24"-48"

18"-24"

0"-6"

0"-6"

18"-24"

15.8

12.7

20.1

13.2

227

42.3

15.4

44.1

5140

527

936

513

1810

2660

6150

4720

1780

SB-22

SB-23

SB-24

SB-25

SB-26

SB-27

SB-28

SB-29

SB-30

SUBMISSION:

BID DOCUMENTS

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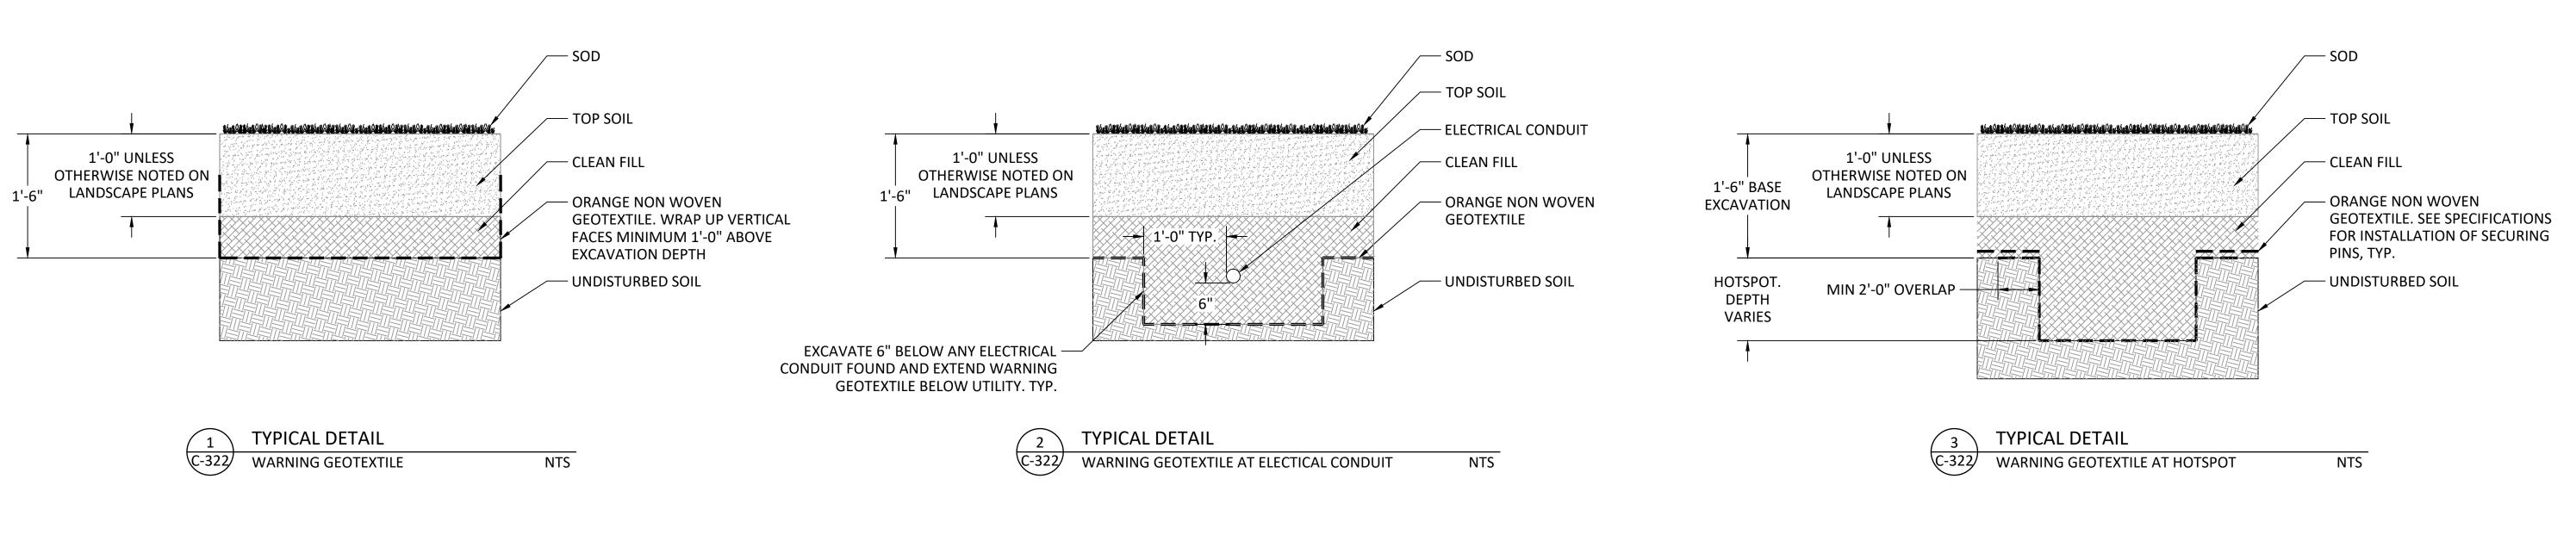
REMEDIATION PLAN

DRAWING NO: 02/04/2022

1"=20'

MJR CHECKED BY:

C-321



PROPERTY ADDRESS:

CHEW PLAYGROUND 1800 WASHINGTON AVE PHILADELPHIA, PA 19146

PROPERTY OWNER:



PHILADELPHIA PARKS &
RECREATION DEPARTMENT
1515 ARCH STREET
SUITE #10
PHILADELPHIA, PA 19102

PROJECT MANAGER:



REBUILD PHILADELPHIA 1515 ARCH STREET MEZZANINE LEVEL PHILADELPHIA, PA 19107

PROJECT PARTNERS:

PROJECT TITLE:

CHEW PLAYGROUND FIELD RENOVATION

CIVIL ENGINEER:

REVISIONS:
DATE: ISSUE:



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SUBMISSION:

BID DOCUMENTS


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REMEDIATION DETAILS

DATE: DRAWING NO: 02/04/2022 SCALE: N.T.S. DRAWN BY:

BY: C-322

CHECKED BY:

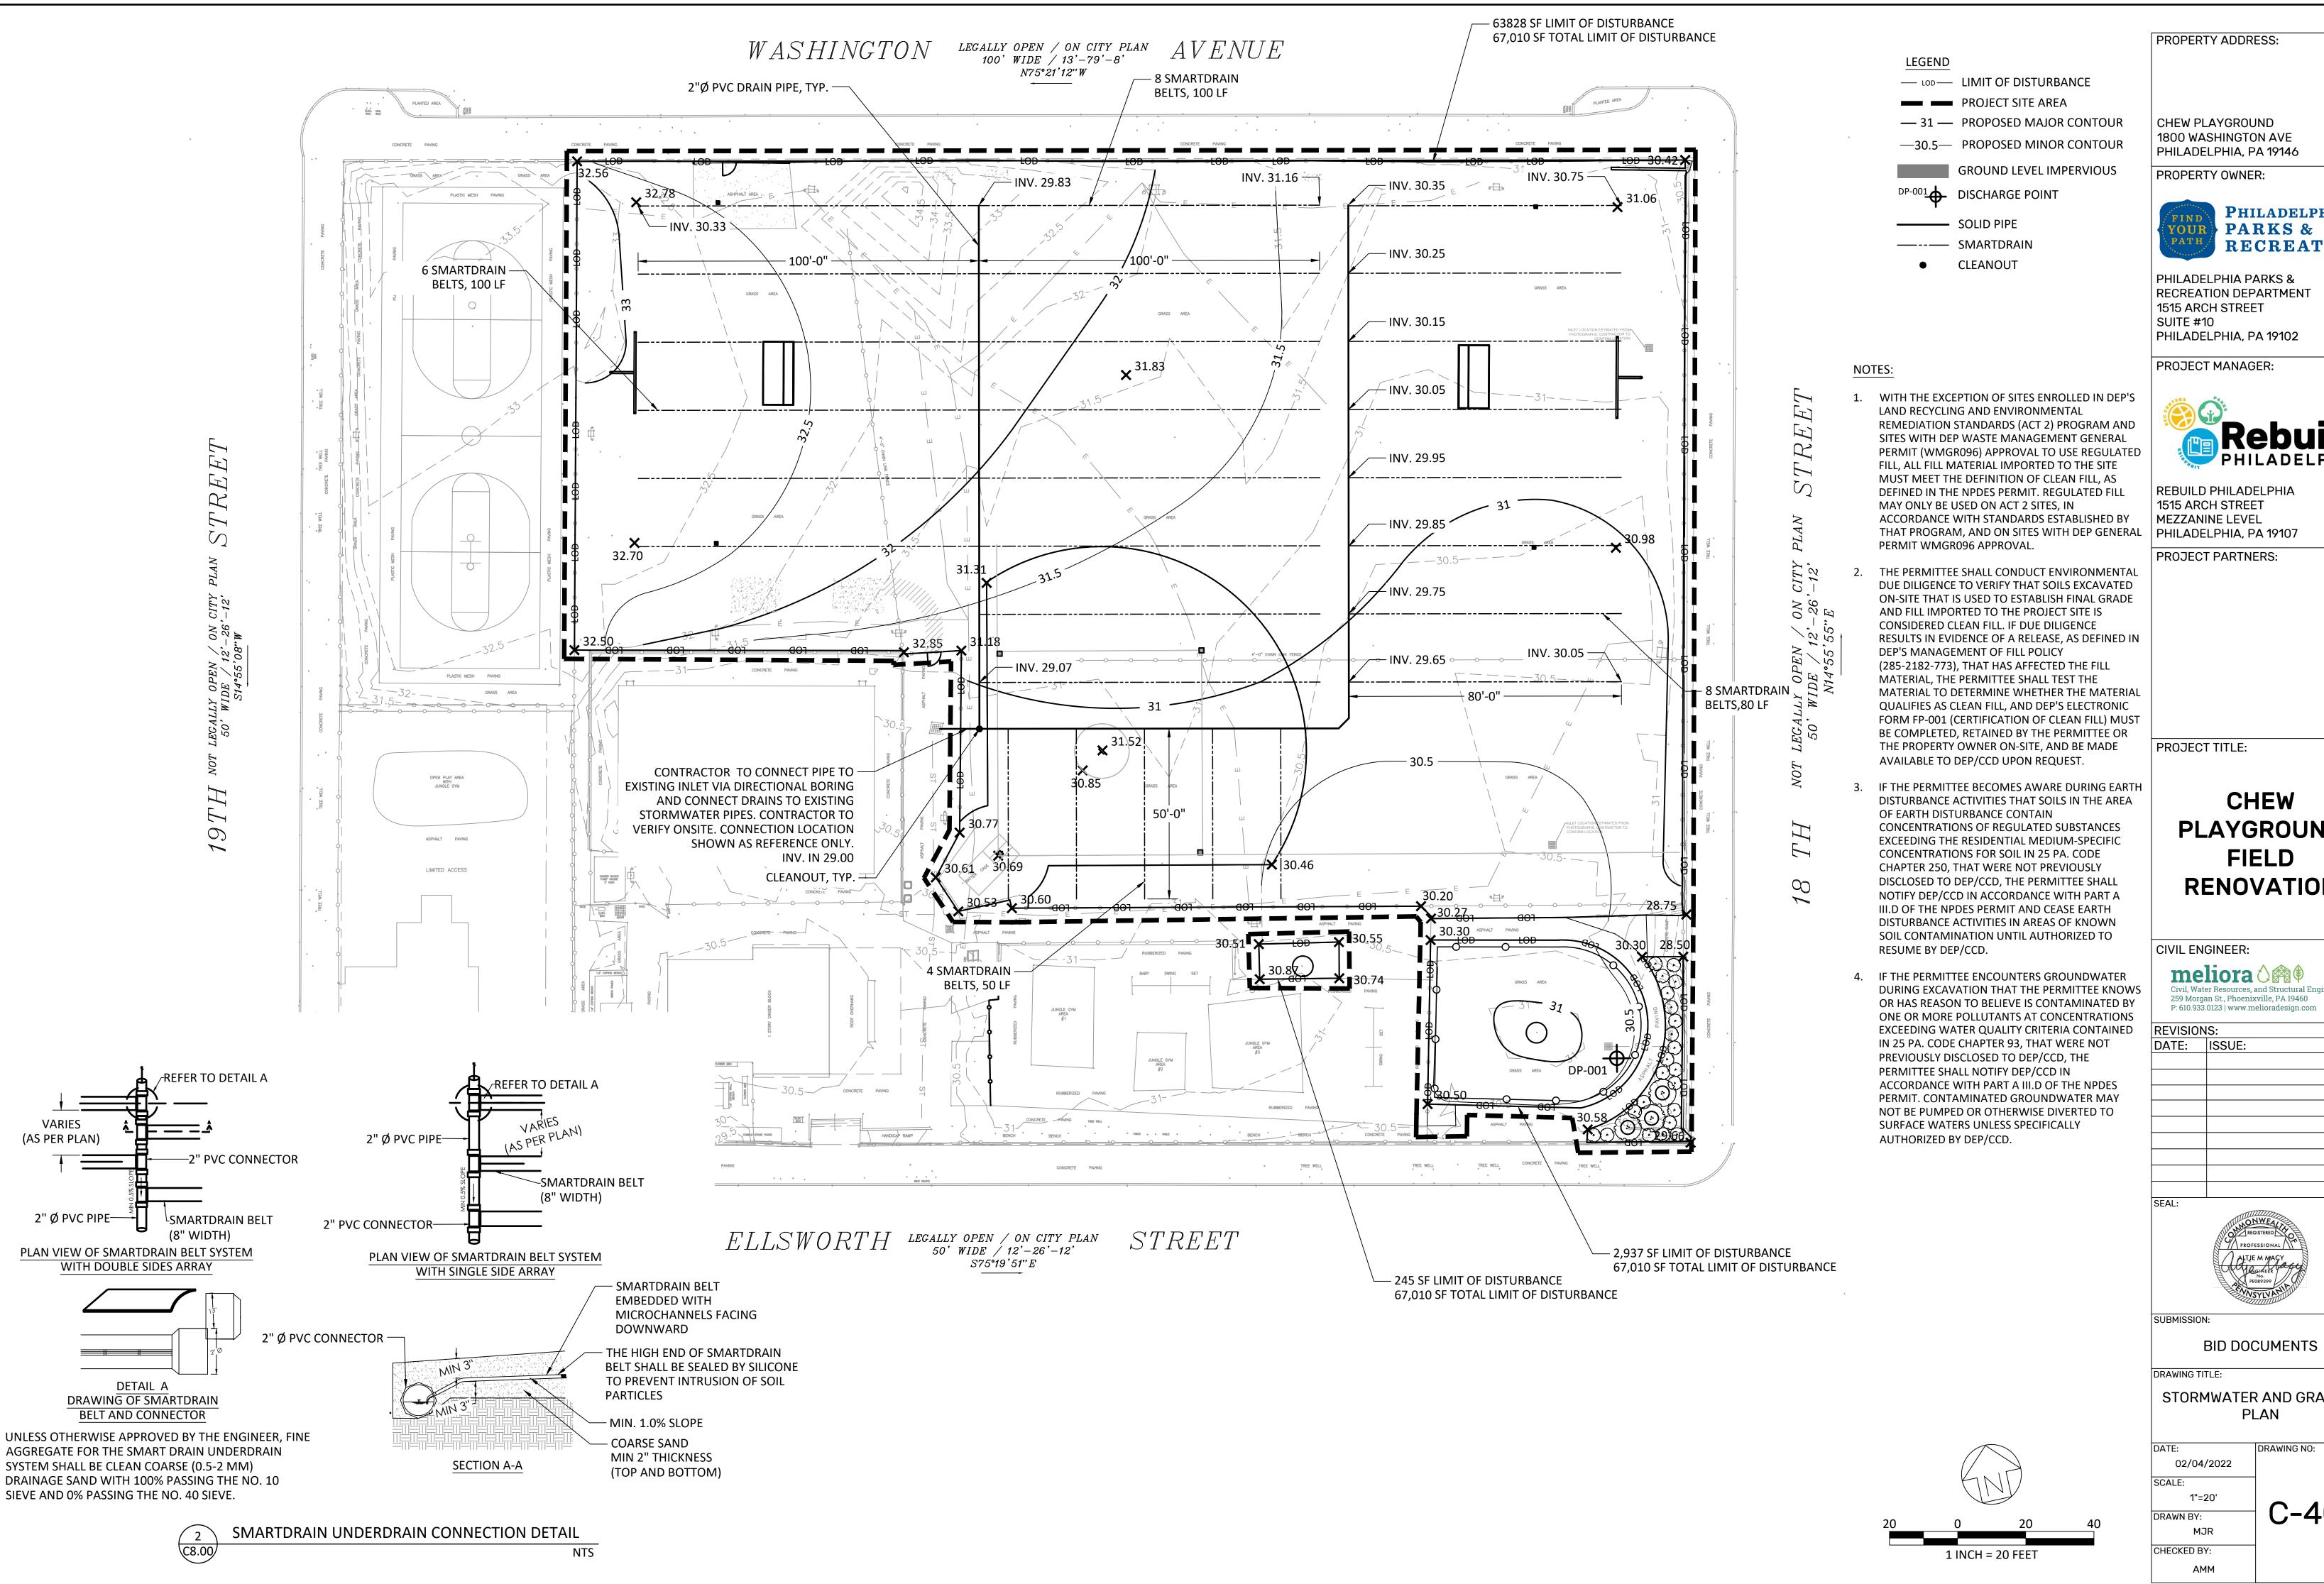

PROPERTY ADDRESS:

CHEW PLAYGROUND 1800 WASHINGTON AVE PHILADELPHIA, PA 19146



PHILADELPHIA PARKS & RECREATION DEPARTMENT 1515 ARCH STREET

PROJECT MANAGER:



REBUILD PHILADELPHIA 1515 ARCH STREET MEZZANINE LEVEL PHILADELPHIA, PA 19107

PROJECT PARTNERS:

CHEW PLAYGROUND FIELD RENOVATION



STORMWATER AND GRADING

DRAWING NO:

C-401

LEGALLY OPEN / ON CITY PLAN

100' WIDE / 13'-79'-8'

N75°21'12"W

EXISTING GATE TO

4' WIDE CHAIN LINK -

PEDESTRIAN GATE.

ADD ALTERNATE #1

REMAIN

(2) PLAYERS BENCHES

ON CONCRETE PADS

LEGALLY OPEN / ON CITY PLAN 50' WIDE / 12'-26'-12' S75°19'51"E

9 8 S

SITE LAYOUT, MATERIALS & FURNISHINGS PLAN






RECYCLING RECEPTACLE

157-32-FTO-RC

- PLANT BED,

SEE L-102

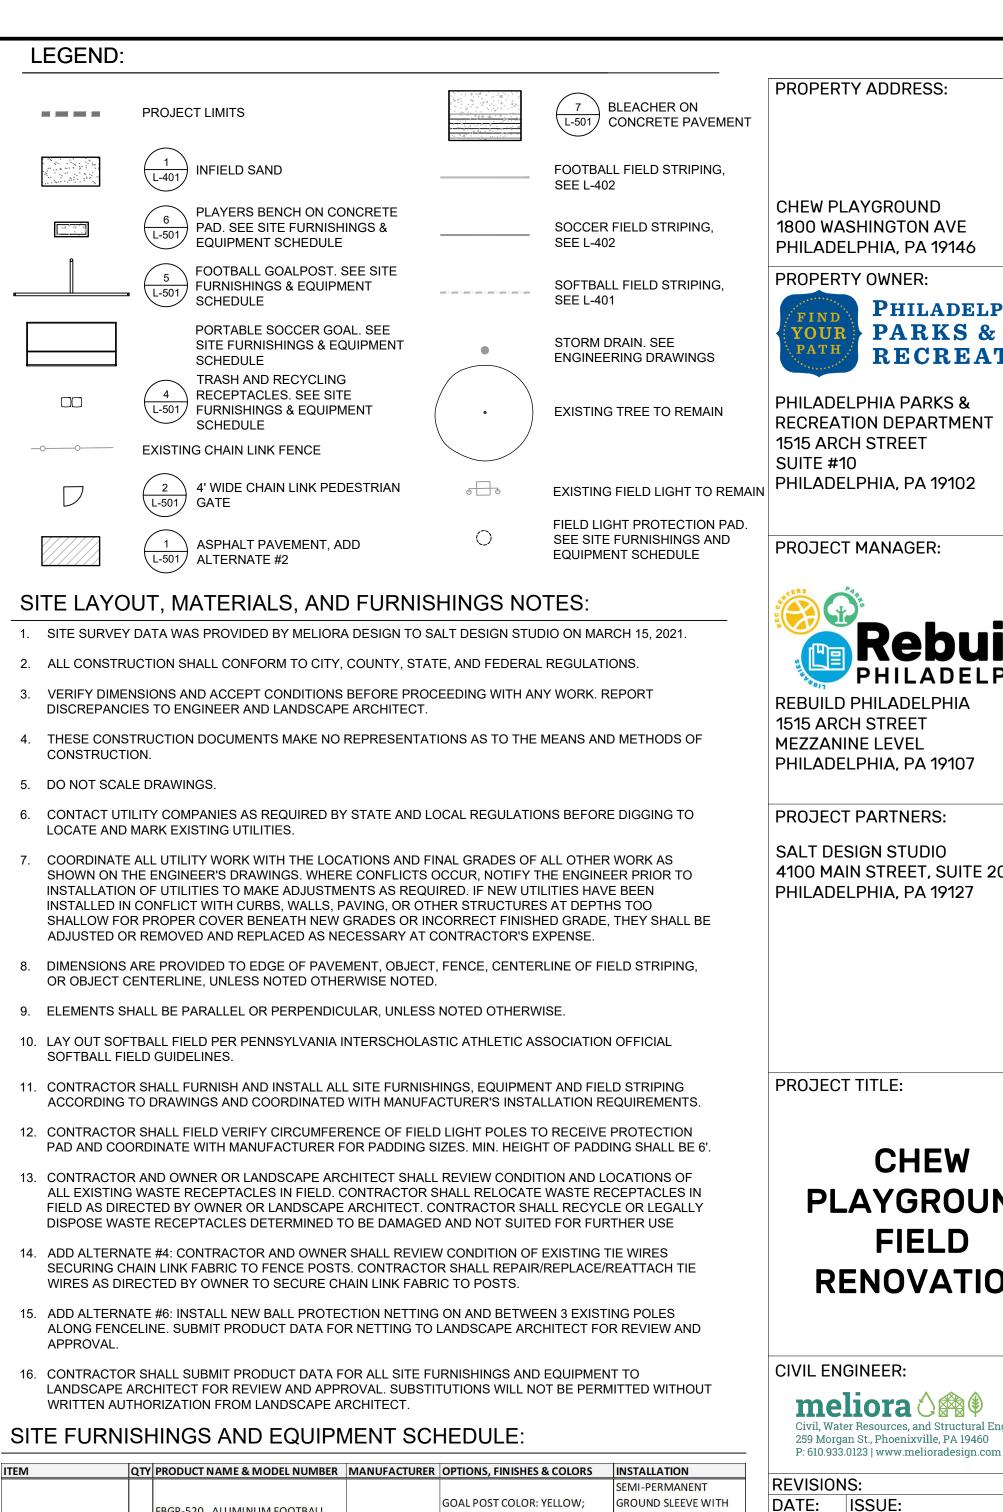

FBGP-520, ALUMINUM FOOTBALL GROUND SLEEVE HEIGHT HEIGHT ADJUSTER. FOOTBALL GOALPOST GOAL POST, HIGH SCHOOL WIDTH JAYPRO SPORTS ADJUSTER (FBGPGS-8, SOLD AS **INSTALL PER** (SOLD AS PAIR) MANUFACTURER'S INSTRUCTIONS PPP-800, 6" THICK PROTECTOR PAD PER MANUFACTURER'S **FOOTBALL GOALPOST** JAYPRO SPORTS COLOR: BLACK (SOLD AS PAIR) INSTRUCTIONS PROTECTOR PAD SEMI-PERMANENT GROUND SLEEVE WITH FOOTBALL GOALPOST HEIGHT ADJUSTER. GROUND SLEEVE HEIGHT 1 FBGPGS-8 (SOLD AS PAIR) JAYPRO SPORTS INSTALL AT FOOTBALL **ADJUSTER GOALPOSTS PER** MANUFACTURER'S INSTRUCTIONS FBPYLN, FREE STANDING PYLONS (SET END ZONE PLYLONS JAYPRO SPORTS | COLOR: ORANGE FREESTANDING CC18S, 6'-6"H X 18'-6"W X 2'B X 6'D JAYPRO SPORTS PORTABLE IN-GROUND SAS-95 FREESTANDING PORTABLE SOCCER GOAL CLASSIC CLUB GOAL (SET OF 2) **INSTALL ON GOALS PER** SOCCER GOAL WHEEL CSGWK (SET OF 2) JAYPRO SPORTS MANUFACTURER'S INSTRUCTIONS PORTABLE SOCCER GOAL SWB-454 SANDBAG ANCHOR, SADDLE-JAYPRO SPORTS MANUFACTURER STANDARD FILL WITH SAND ANCHOR BAG WITH STEEL HANDLE (SET OF 4) PER MANUFACTURER'S JAYPRO SPORTS MANUFACTURER STANDARD STYLE (15"L X 15"W X 3"H) (SET OF 3) INSTRUCTIONS HP-200 HOME PLATE - MAJOR LEAGUE PER MANUFACTURER'S HOME PLATE JAYPRO SPORTS MANUFACTURER STANDARD (1 1/2" ANCHOR) INSTRUCTIONS PER MANUFACTURER'S PR-424 24" REMOVABLE PITCHING PITCHING RUBBER JAYPRO SPORTS MANUFACTURER STANDARD NSTRUCTIONS GROMMET TABS FOR ANTI-THEFT | PER MANUFACTURER'S FIELD LIGHT 2" THICK HEXAGON PADDING RESILITE PROTECTION PAD PROTECTION; COLOR: BLACK INSTRUCTIONS S-1 EMBEDMENT PER PLAYERS BENCH BENCH 105-60D 6' BACKLESS BENCH, DOUGLAS FIR MANUFACTURER'S **DU MOR** INSTRUCTIONS PERMANENT MANUFACTURER STANDARD INSTALLATION ON RECREATION RESOURCE USA LSG 3-15 RECREATION GALVANIZED STEEL FRAME. SEE **BLEACHERS** CONCRETE FOUNDATION BLEACHER DETAIL FOR SEATING AND FOOT PLANK REQUIREMENTS PER MANUFACTURER'S **INSTRUCTIONS** 32-GALLON STEEL RECEPTACLE, **ANCHORED PER** TRASH RECEPTACLE 157-32-FTO TOP DEPOSIT; CONTAINER MANUFACTURER'S COLOR: BLACK INSTRUCTIONS 32-GALLON STEEL RECEPTACLE, **ANCHORED PER**

DU MOR

TOP DEPOSIT; RECYCLE LID;

CONTAINER COLOR: RECYCLE BLUE INSTRUCTIONS

MANUFACTURER'S

CHEW PLAYGROUND 1800 WASHINGTON AVE

PROPERTY OWNER: **PHILADELPHIA**

PARKS & RECREATION PHILADELPHIA PARKS &

RECREATION DEPARTMENT 1515 ARCH STREET



1515 ARCH STREET MEZZANINE LEVEL PHILADELPHIA, PA 19107

SALT DESIGN STUDIO 4100 MAIN STREET, SUITE 201 PHILADELPHIA, PA 19127

CHEW PLAYGROUND FIELD RENOVATION



REVISIONS:				
DATE:	ISSUE:			

SUBMISSION:

BID DOCUMENTS

SITE LAYOUT **MATERIALS & FURNISHINGS PLAN**

DATE:	DRAWING NO:
02/04/22	
SCALE:	L-101
AS NOTED	
DRAWN BY:	
SB/GA	
CHECKED BY:	
CDC	

SCALE: 1" = 20'-0"

- (2) PLAYERS BENCHES


ON CONCRETE PADS


EXISTING FIELD LIGHT WRAPPED

PAD, TYP OF (8) LOCATIONS

WITH FIELD LIGHT PROTECTION

\----

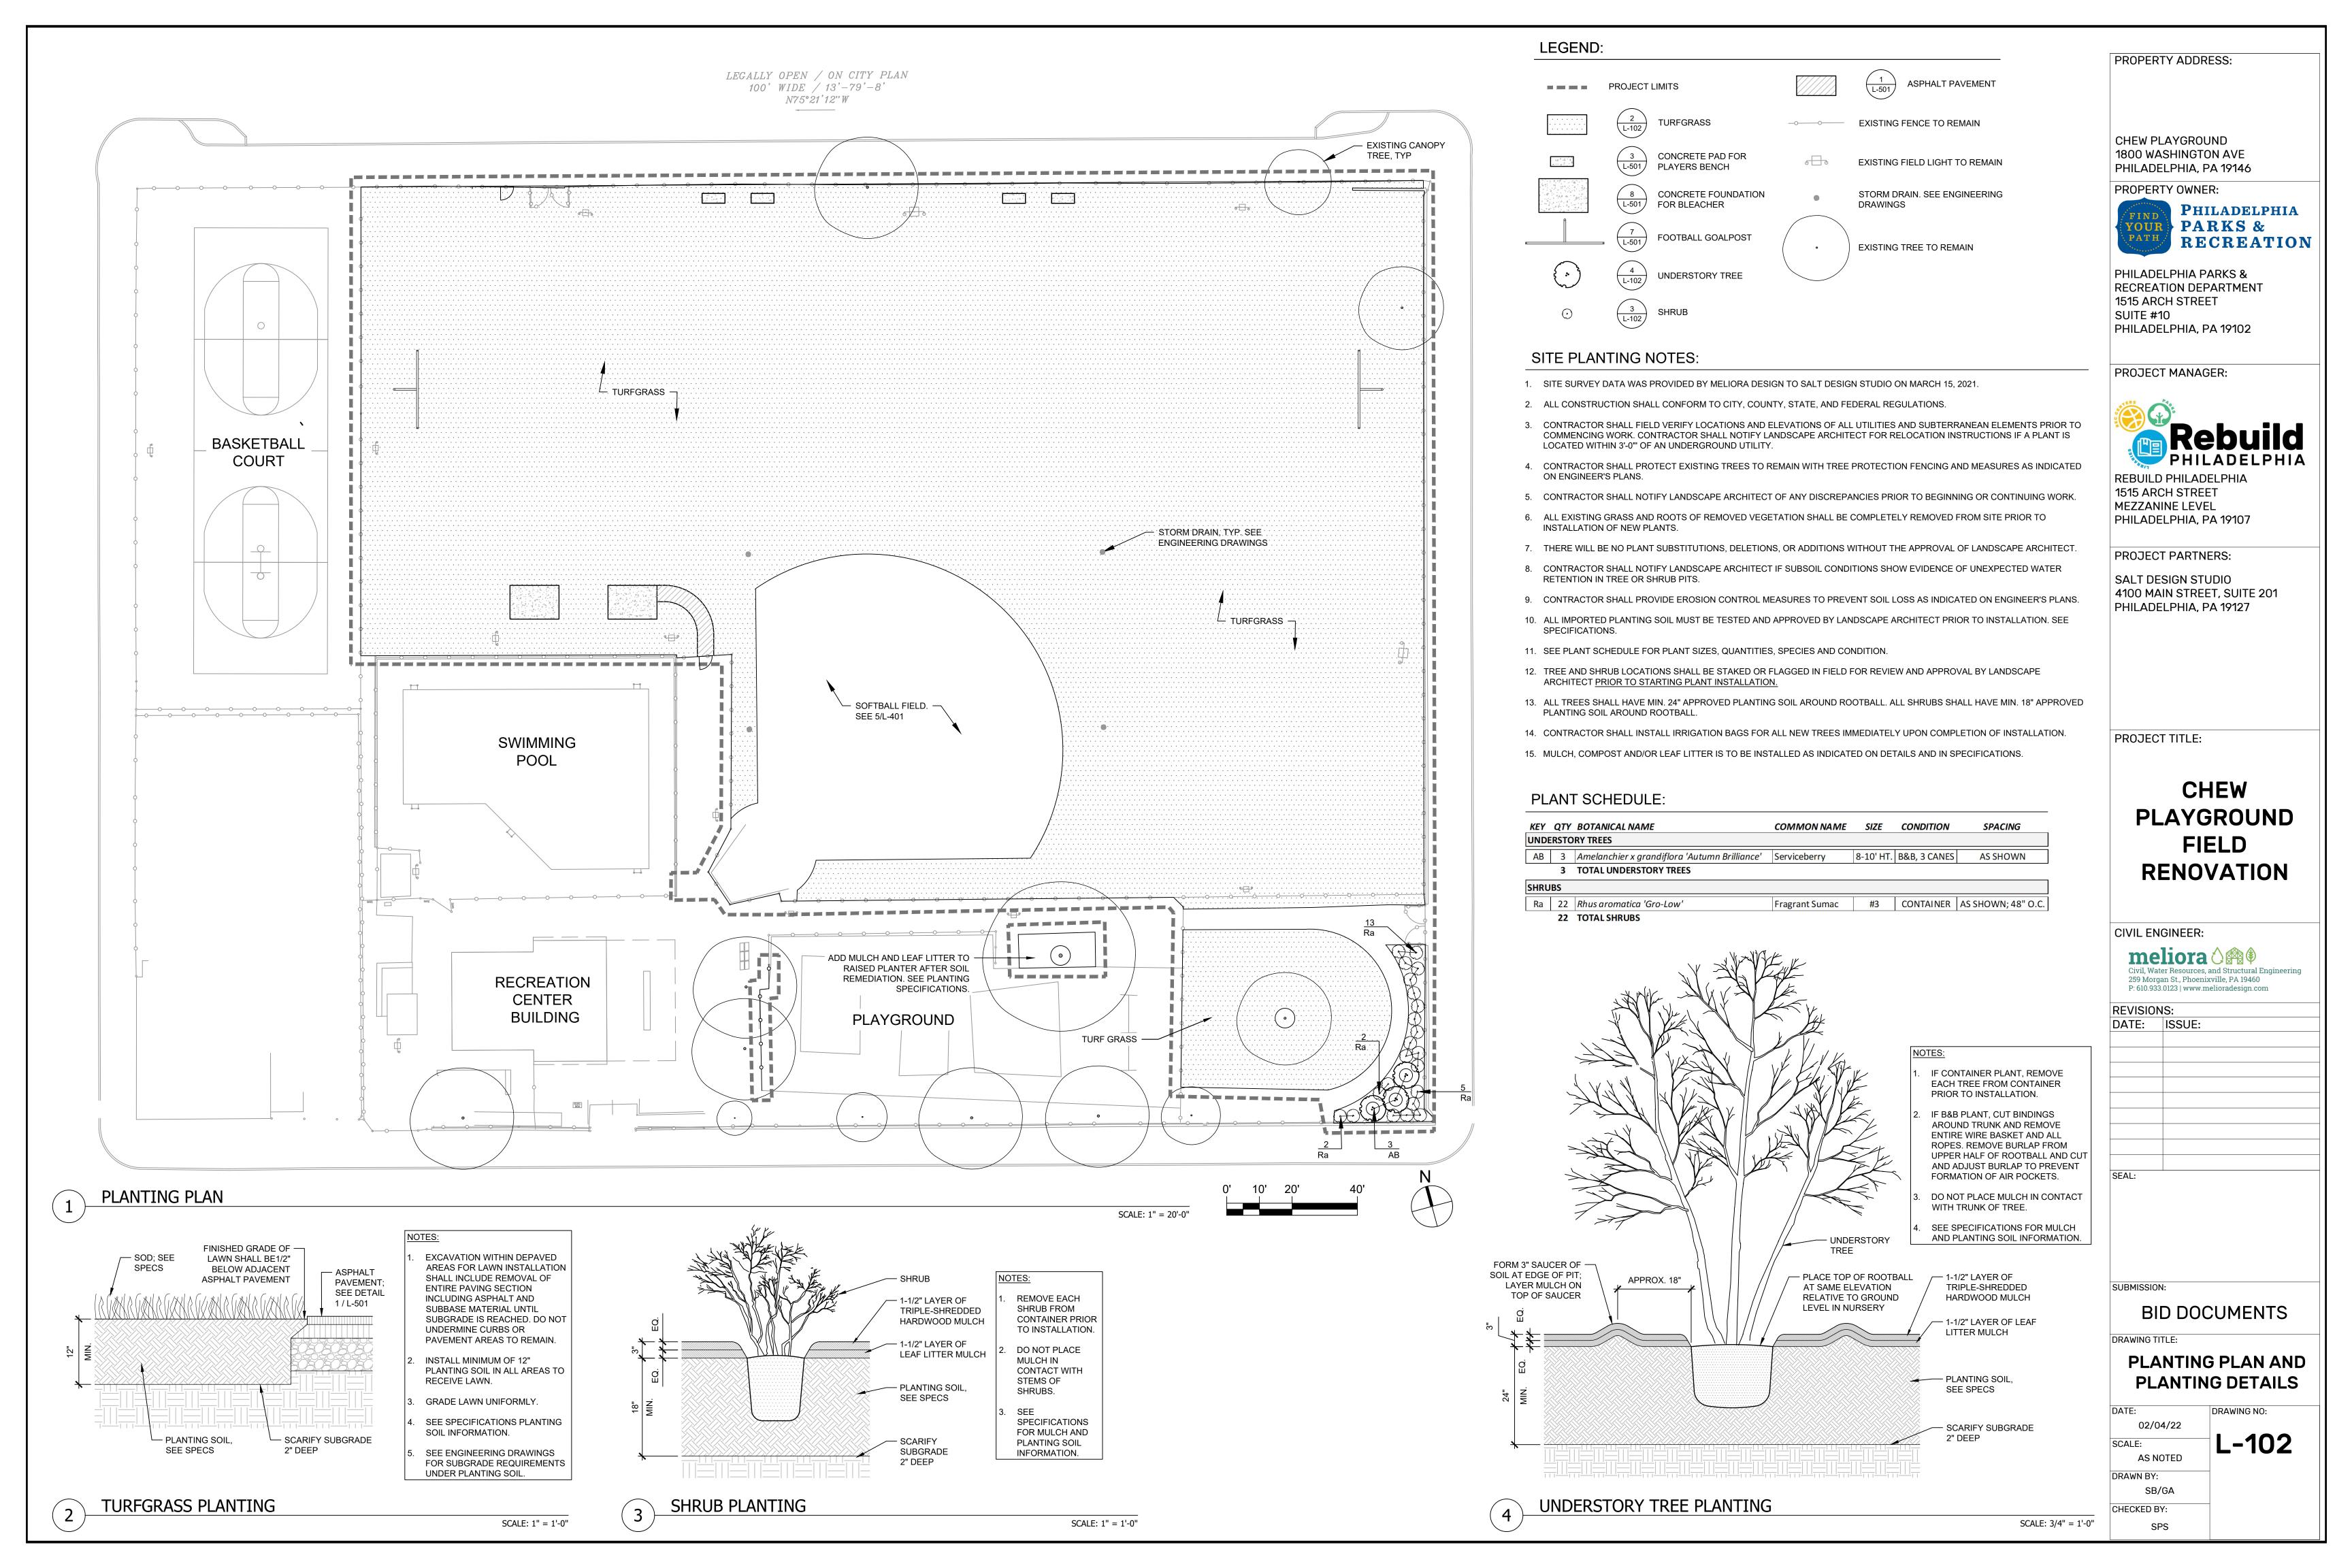

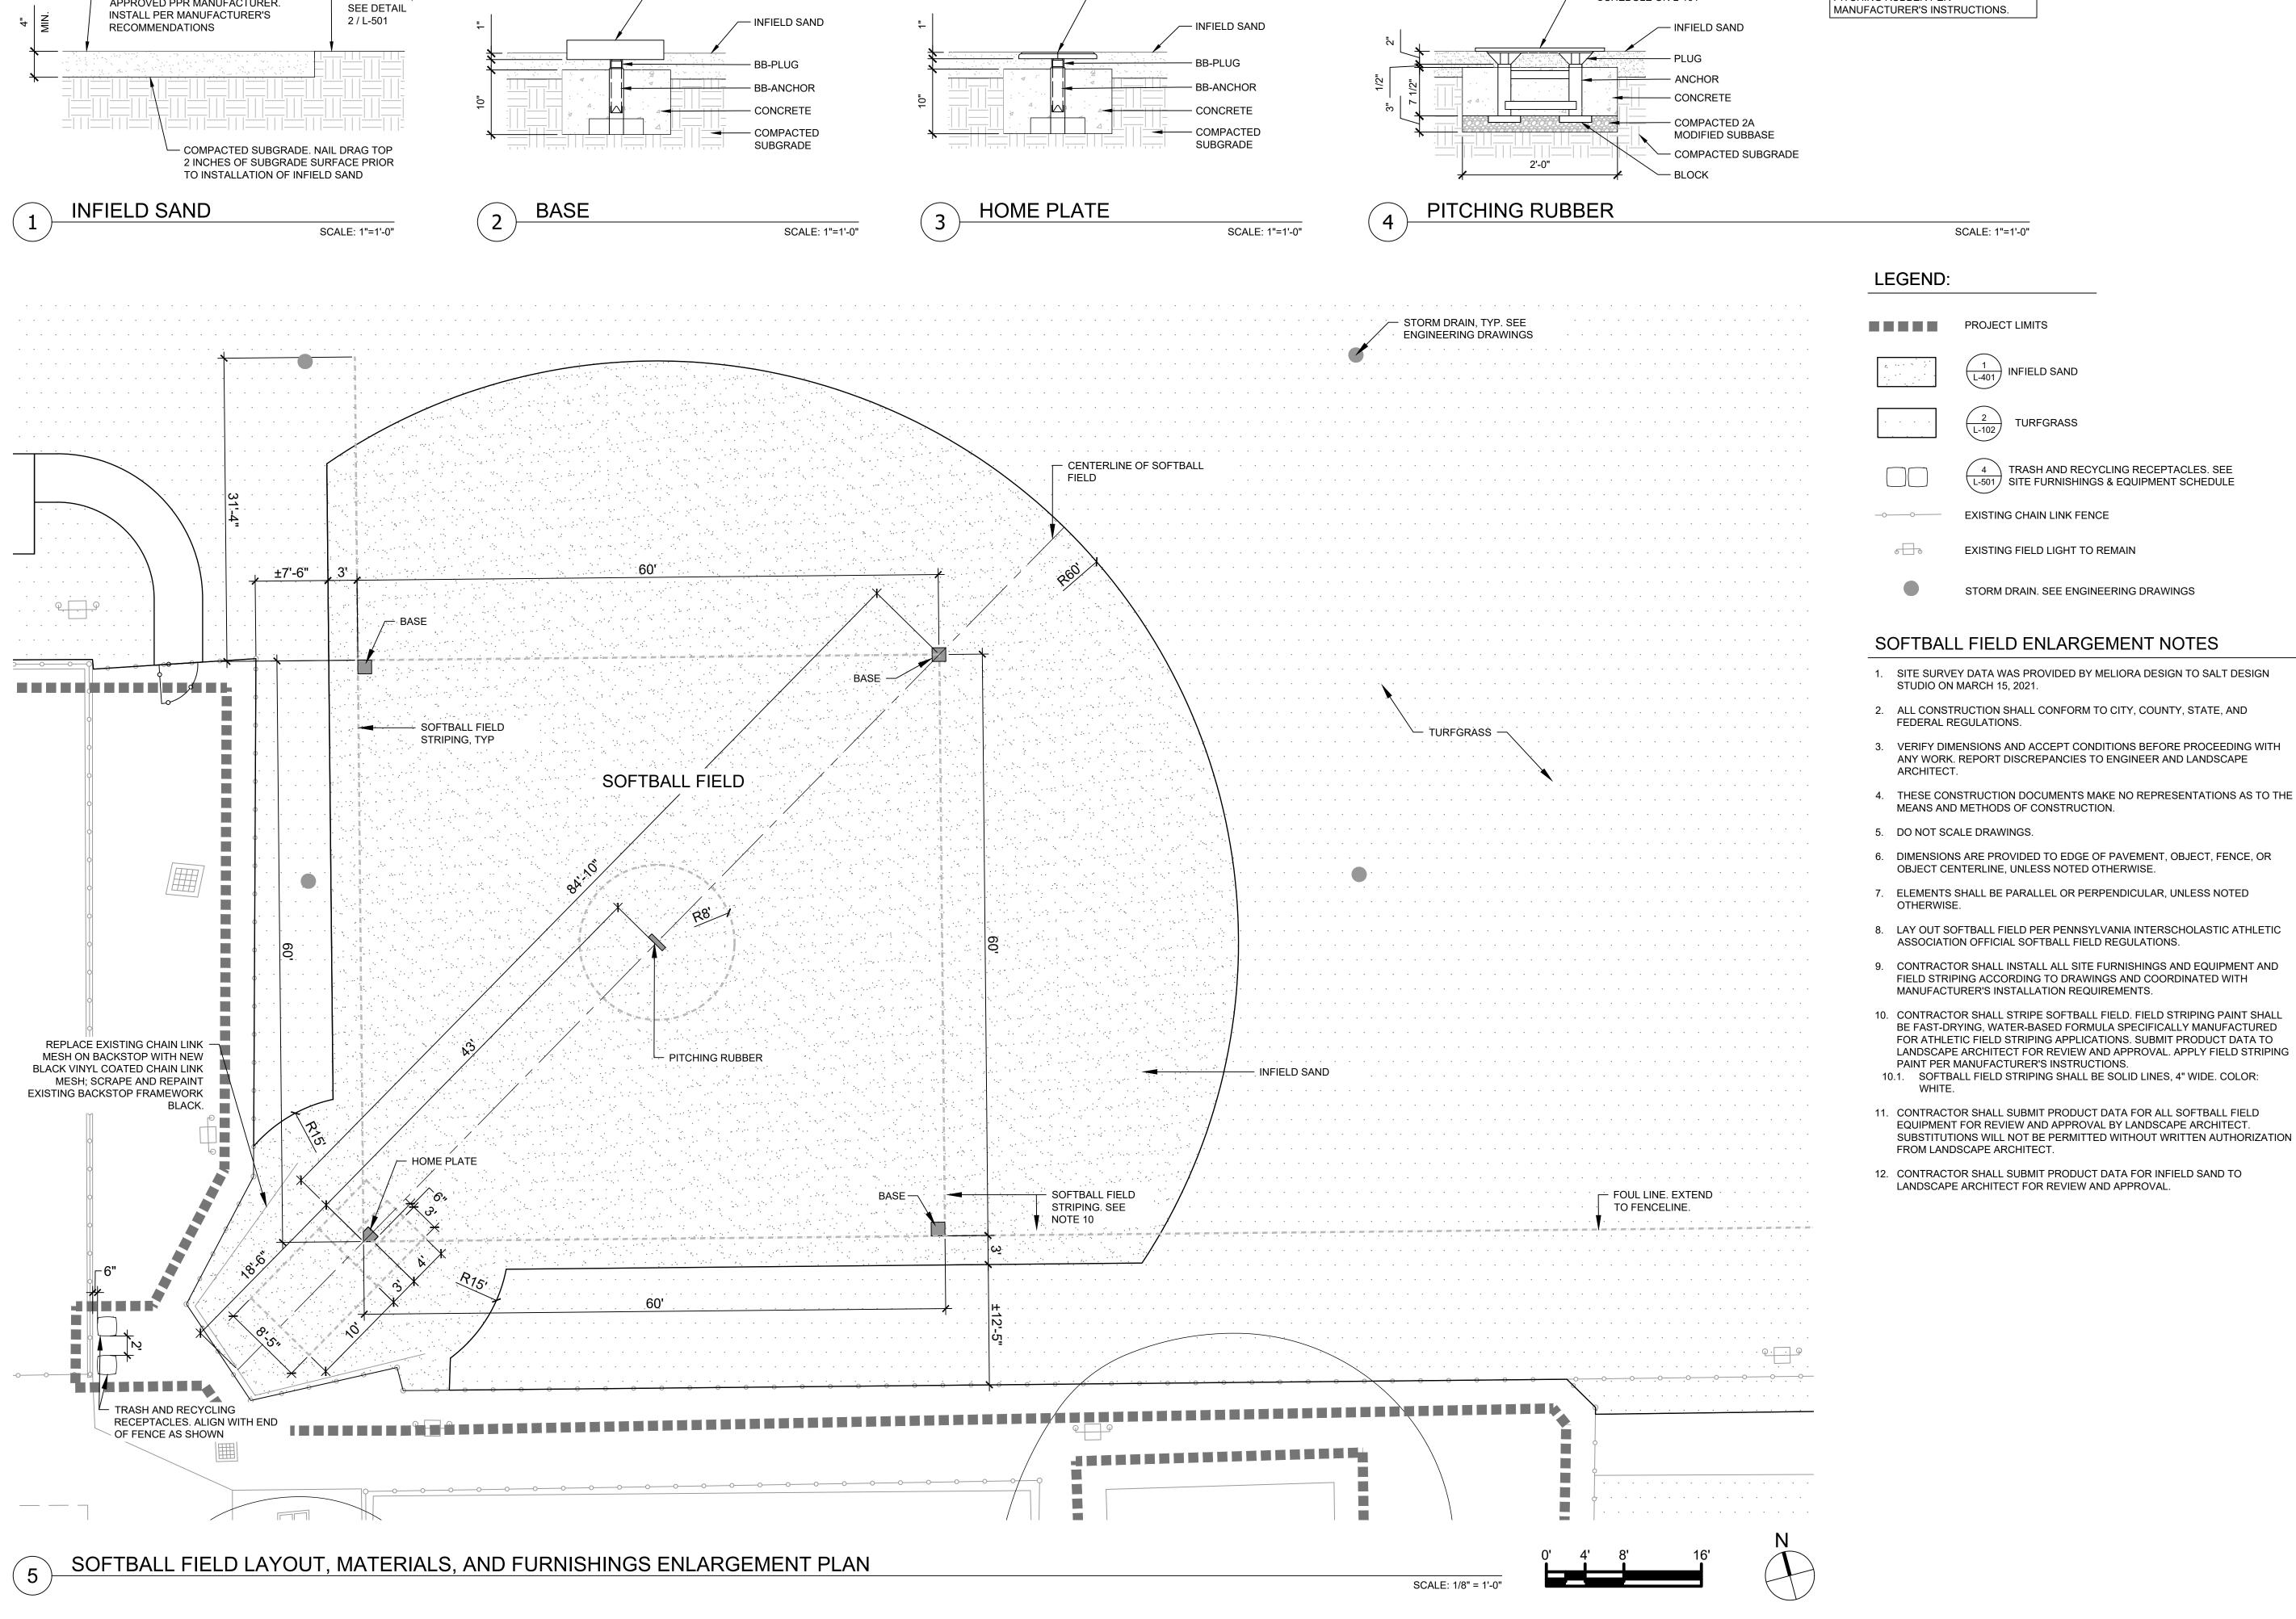

- HOME PLATE. SEE SITE FURNISHINGS

AND EQUIPMENT SCHEDULE ON L-101

— BASE. SEE SITE FURNISHINGS AND

EQUIPMENT SCHEDULE ON L-101

— INFIELD SAND: DIAMOND-TEX ORIGINAL

APPROVED PPR MANUFACTURER.

INFIELD MIX OR APPROVED EQUAL FROM

TURFGRASS;

SOFTBALL FIELD INSTALLATION NOTES: INSTALL BASES, HOME PLATE, AND PITCHING RUBBER PER MANUFACTURER'S INSTRUCTIONS.

SCALE: 1"=1'-0"

INFIELD SAND

EXISTING CHAIN LINK FENCE

EXISTING FIELD LIGHT TO REMAIN

STORM DRAIN. SEE ENGINEERING DRAWINGS

TRASH AND RECYCLING RECEPTACLES. SEE
SITE FURNISHINGS & EQUIPMENT SCHEDULE TRASH AND RECYCLING RECEPTACLES. SEE

- REMOVABLE PITCHING RUBBER. SEE

SITE FURNISHINGS AND EQUIPMENT

SCHEDULE ON L-101

CHEW PLAYGROUND 1800 WASHINGTON AVE PHILADELPHIA, PA 19146

PROPERTY ADDRESS:

PROPERTY OWNER:



PHILADELPHIA PARKS & RECREATION DEPARTMENT 1515 ARCH STREET SUITE #10 PHILADELPHIA, PA 19102

PROJECT MANAGER:



REBUILD PHILADELPHIA 1515 ARCH STREET MEZZANINE LEVEL PHILADELPHIA, PA 19107

PROJECT PARTNERS:

SALT DESIGN STUDIO 4100 MAIN STREET, SUITE 201 PHILADELPHIA, PA 19127

PROJECT TITLE:

PLAYGROUND FIELD RENOVATION

CIVIL ENGINEER:




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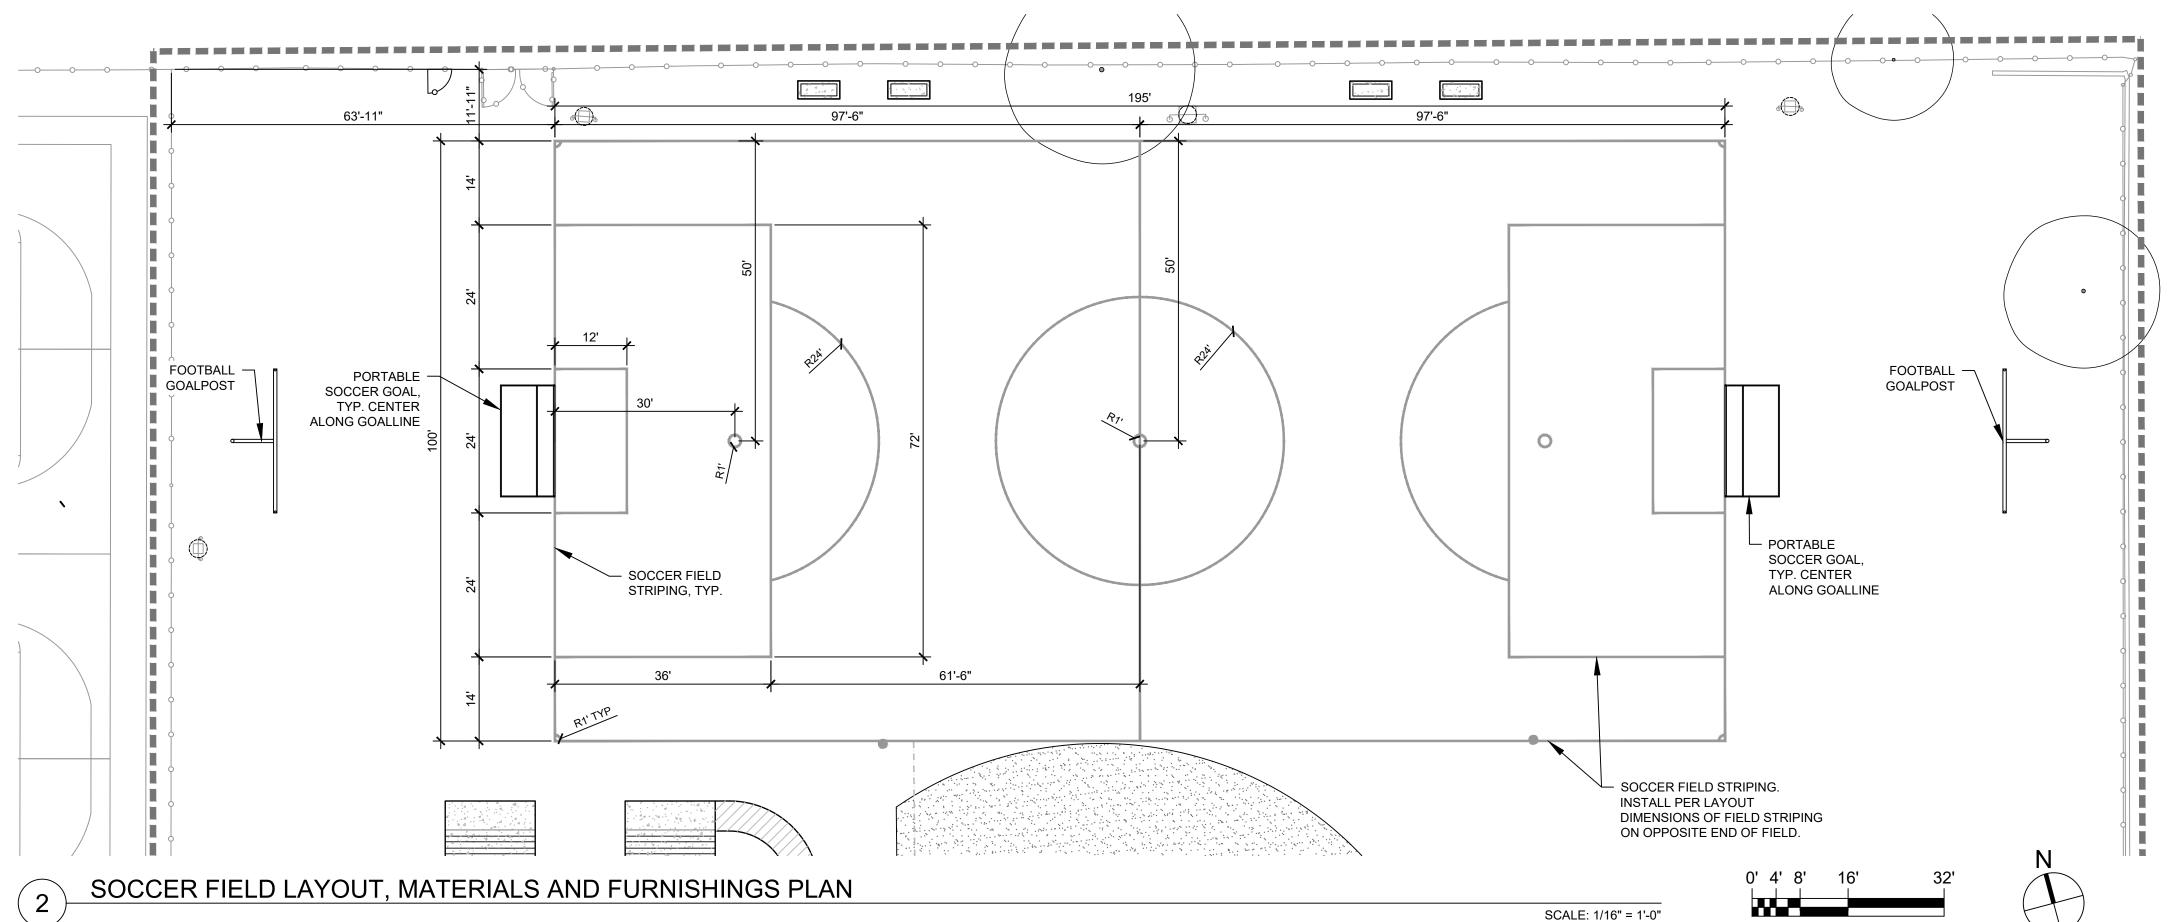
CHECKED BY

BID DOCUMENTS

SOFTBALL FIELD **ENLARGEMENT AND DETAILS**

DATE:	DRAWING NO:
02/04/22	
SCALE:	L-401
AS NOTED	
DRAWN BY:	
SB/GA	



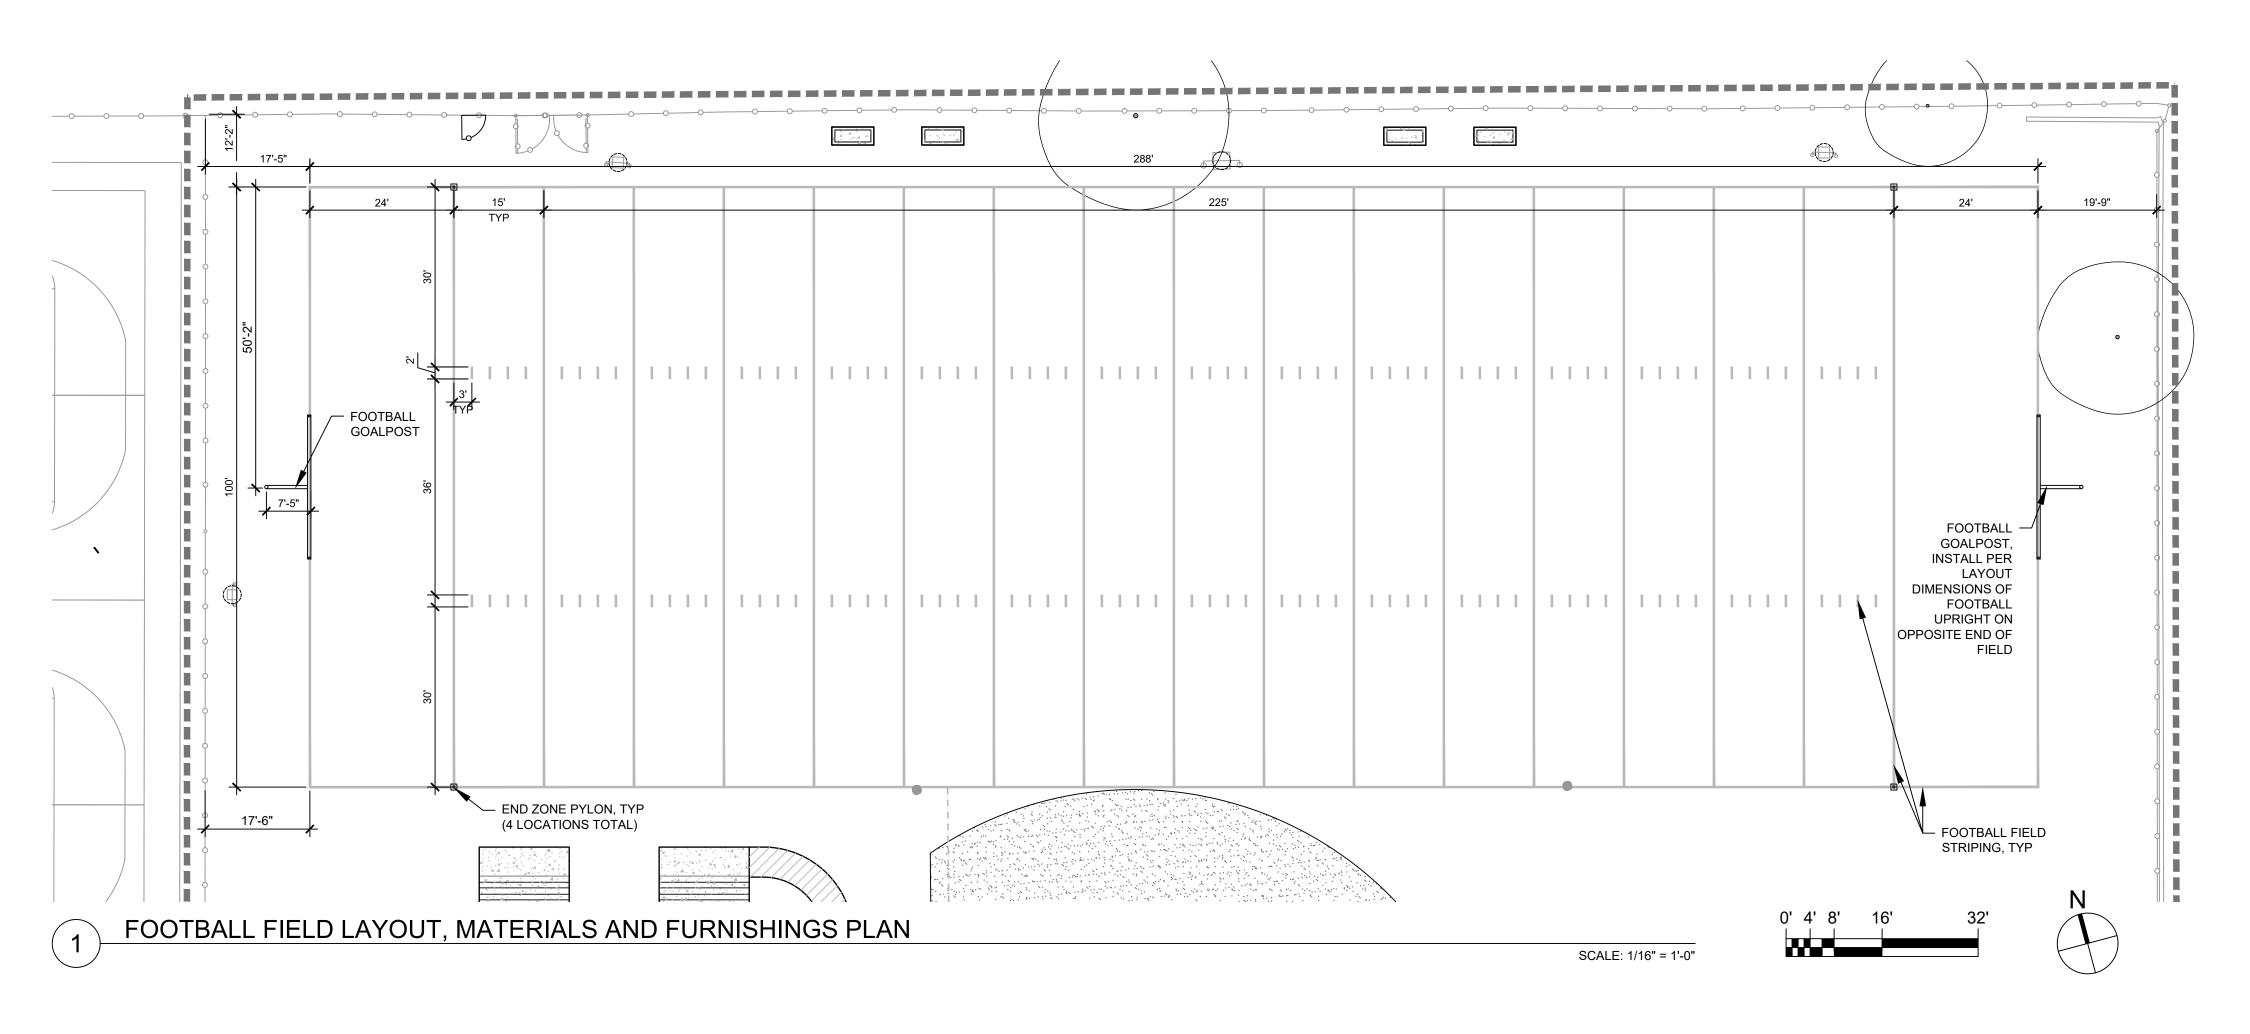

LEGEND:

PROJECT LIMITS

1 -401) INFIELD SAND

PLAYERS BENCH ON CONCRETE PAD.

SEE SITE FURNISHINGS & EQUIPMENT

SEE SITE FURNISHINGS & EQUIPMENT SCHEDULE

FOOTBALL GOAPOST, SEE SITE

5 FOOTBALL GOAPOST. SEE SITE FURNISHINGS & EQUIPMENT SCHEDULE



TRASH AND RECYCLING RECEPTACLES. SEE
SITE FURNISHINGS & EQUIPMENT SCHEDULE

EXISTING CHAIN LINK FENCE

2 4' WIDE CHAIN LINK PEDESTRIAN GATE


EXISTING FIELD LIGHT TO REMAIN
FIELD LIGHT PROTECTION PAD. SEE SITE

END ZONE PYLON. SEE SITE FURNISHINGS

FURNISHINGS & EQUIPMENT SCHEDULE

PLEACHED ON CONCRETE

& EQUIPMENT SCHEDULE

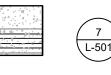

0

7 BLEACHER ON CONCRETE FOUNDATION

FOOTBALL FIELD STRIPING

SOCCER FIELD STRIPING

STORM DRAIN, SEE ENGINEERING DRAWINGS

• EXISTING TREE TO REMAIN

SOFTBALL FIELD STRIPING

SITE LAYOUT NOTES:

- SITE SURVEY DATA WAS PROVIDED BY MELIORA DESIGN TO SALT DESIGN STUDIO ON MARCH 15, 2021.
- ALL CONSTRUCTION SHALL CONFORM TO CITY, COUNTY, STATE, AND FEDERAL REGULATIONS.
- 3. VERIFY DIMENSIONS AND ACCEPT CONDITIONS BEFORE PROCEEDING WITH ANY WORK. REPORT DISCREPANCIES TO ENGINEER AND LANDSCAPE ARCHITECT.
- 4. THESE CONSTRUCTION DOCUMENTS MAKE NO REPRESENTATIONS AS TO THE MEANS
- 5. DO NOT SCALE DRAWINGS.

AND METHODS OF CONSTRUCTION.

- 6. CONTACT UTILITY COMPANIES AS REQUIRED BY STATE AND LOCAL REGULATIONS BEFORE DIGGING TO LOCATE AND MARK EXISTING UTILITIES.
- 7. COORDINATE ALL UTILITY WORK WITH THE LOCATIONS AND FINAL GRADES OF ALL OTHER WORK AS SHOWN ON THE ENGINEER'S DRAWINGS. WHERE CONFLICTS OCCUR, NOTIFY THE ENGINEER PRIOR TO INSTALLATION OF UTILITIES TO MAKE ADJUSTMENTS AS REQUIRED. IF NEW UTILITIES HAVE BEEN INSTALLED IN CONFLICT WITH CURBS, WALLS, PAVING, OR OTHER STRUCTURES AT DEPTHS TOO SHALLOW FOR PROPER COVER BENEATH NEW GRADES OR INCORRECT FINISHED GRADE, THEY SHALL BE ADJUSTED OR REMOVED AND REPLACED AS NECESSARY AT CONTRACTOR'S EXPENSE.
- 8. DIMENSIONS ARE PROVIDED TO EDGE OF PAVEMENT, OBJECT, FENCE, CENTERLINE OF FIELD STRIPING, OR OBJECT CENTERLINE, UNLESS NOTED OTHERWISE NOTED.
- 9. ELEMENTS SHALL BE PARALLEL OR PERPENDICULAR, UNLESS NOTED OTHERWISE.
- 10. LAY OUT SOCCER FIELD PER USA SOCCER FEDERATION REGULATIONS FOR "U9/U10"
- 11. CONTRACTOR SHALL FURNISH AND INSTALL ALL SITE FURNISHINGS, EQUIPMENT AND FIELD STRIPING ACCORDING TO DRAWINGS AND COORDINATED WITH MANUFACTURER'S INSTALLATION REQUIREMENTS.
- 12. CONTRACTOR SHALL FIELD VERIFY CIRCUMFERENCE OF FIELD LIGHT POLES TO RECEIVE PROTECTION PAD AND COORDINATE WITH MANUFACTURER FOR PADDING SIZES. MIN. HEIGHT OF PADDING SHALL BE 6'.
- 13. CONTRACTOR SHALL STRIPE FIELDS FOR BOTH FOOTBALL AND SOCCER. FIELD STRIPING PAINT SHALL BE FAST-DRYING, WATER-BASED FORMULA SPECIFICALLY MANUFACTURED FOR ATHLETIC FIELD STRIPING APPLICATIONS. SUBMIT PRODUCT DATA TO LANDSCAPE ARCHITECT FOR REVIEW AND APPROVAL. APPLY FIELD STRIPING PAINT PER MANUFACTURER'S INSTRUCTIONS.
- 13.1. FOOTBALL FIELD STRIPING SHALL BE SOLID LINES, 4" WIDE. COLOR: WHITE.13.2. SOCCER FIELD STRIPING SHALL BE SOLID LINES, 4" WIDE. COLOR: YELLOW.
- 14. CONTRACTOR SHALL LAY OUT FIELD STRIPING FOR REVIEW AND APPROVAL BY LANDSACPE ARCHITECT PRIOR TO INSTALLATION

PROPERTY ADDRESS:

CHEW PLAYGROUND 1800 WASHINGTON AVE PHILADELPHIA, PA 19146

PROPERTY OWNER:



PHILADELPHIA PARKS & RECREATION DEPARTMENT 1515 ARCH STREET SUITE #10 PHILADELPHIA, PA 19102

PROJECT MANAGER:



REBUILD PHILADELPHIA 1515 ARCH STREET MEZZANINE LEVEL PHILADELPHIA, PA 19107

PROJECT PARTNERS:

SALT DESIGN STUDIO 4100 MAIN STREET, SUITE 201 PHILADELPHIA, PA 19127

PROJECT TITLE:

CHEW
PLAYGROUND
FIELD
RENOVATION

CIVIL ENGINEER:

REVISIONS:			
DATE:	ISSUE:		
SEAL:			

SUBMISSION:

BID DOCUMENTS

DRAWING TITLE:

CHECKED BY:

MULTI-SPORT FIELD LAYOUT ENLARGEMENT

DATE:


02/04/22

SCALE:

AS NOTED

DRAWN BY:

SB/GA

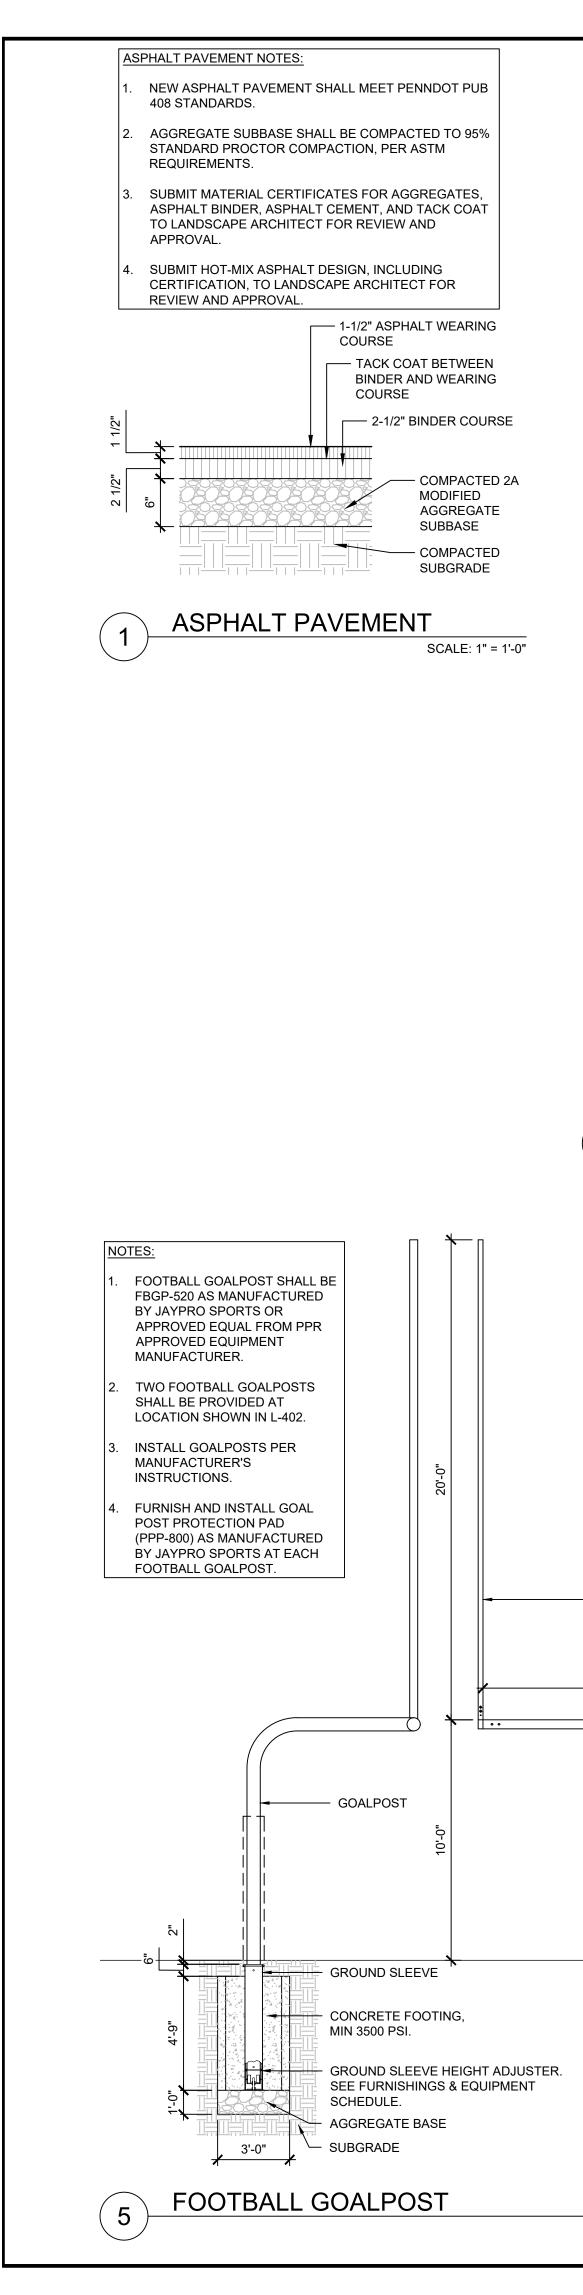

NOTES:

ADD ALTERNATE #1: FURNISH AND INSTALL 4' WIDE PEDESTRIAN GATE ALONG

ADD ALTERNATE #9: FURNISH AND INSTALL 4' WIDE PEDESTRIAN GATE LEADING TO

WASHINGTON AVENUE WHERE SHOWN ON DRAWINGS.

GATE SHALL BE FROM APPROVED PPR FENCING MANUFACTURER.

MALFUNCTION THROUGHOUT ENTIRE OPERATIONS RANGE.

BINDING. LUBRICATE HARDWARE AND OTHER MOVING PARTS.

4'-0" WIDE SINGLE GATE

- GATE

4" O.D. FOOTBALL UPRIGHT

23'-4"

BETWEEN UPRIGHTS

_ 6 🖁 O.D. GOALPOST

GOALPOST PROTECTION

SCALE: 1/4" = 1'-0"

ALL NEW FRAMING, CHAIN LINK MESH, ACCESSORIES, ETC. TO BE BLACK.

GATE HINGES SHALL PROVIDE 90-DEGREE OUTWARD SWING. ADJUST GATES TO

OPERATE SMOOTHLY, EASILY, QUIETLY, FREE OF BINDING, WARP, EXCESSIVE

DEFLECTION, DISTORTION, NONALIGNMENT, MISPLACEMENT, DISRUPTION, OR

CONTRACTOR SHALL SUBMIT PRODUCT DATA AND SHOP DRAWINGS OF CHAIN LINK

CONFIRM LATCHES ENGAGE ACCURATELY AND SECURELY WITHOUT FORCING OR

GATE PRIOR TO INSTALLATION FOR REVIEW AND APPROVAL BY LANDSCAPE ARCHITECT.

- HINGE POST

CHAIN LINK

GATE CHAIN

LINK MESH

SHALL BE **BLACK VINYL**

WITH 2" x 2"


MINIMUM

WEAVE

COATED MESH

FENCE

BLEACHERS WHERE SHOWN ON DRAWINGS.

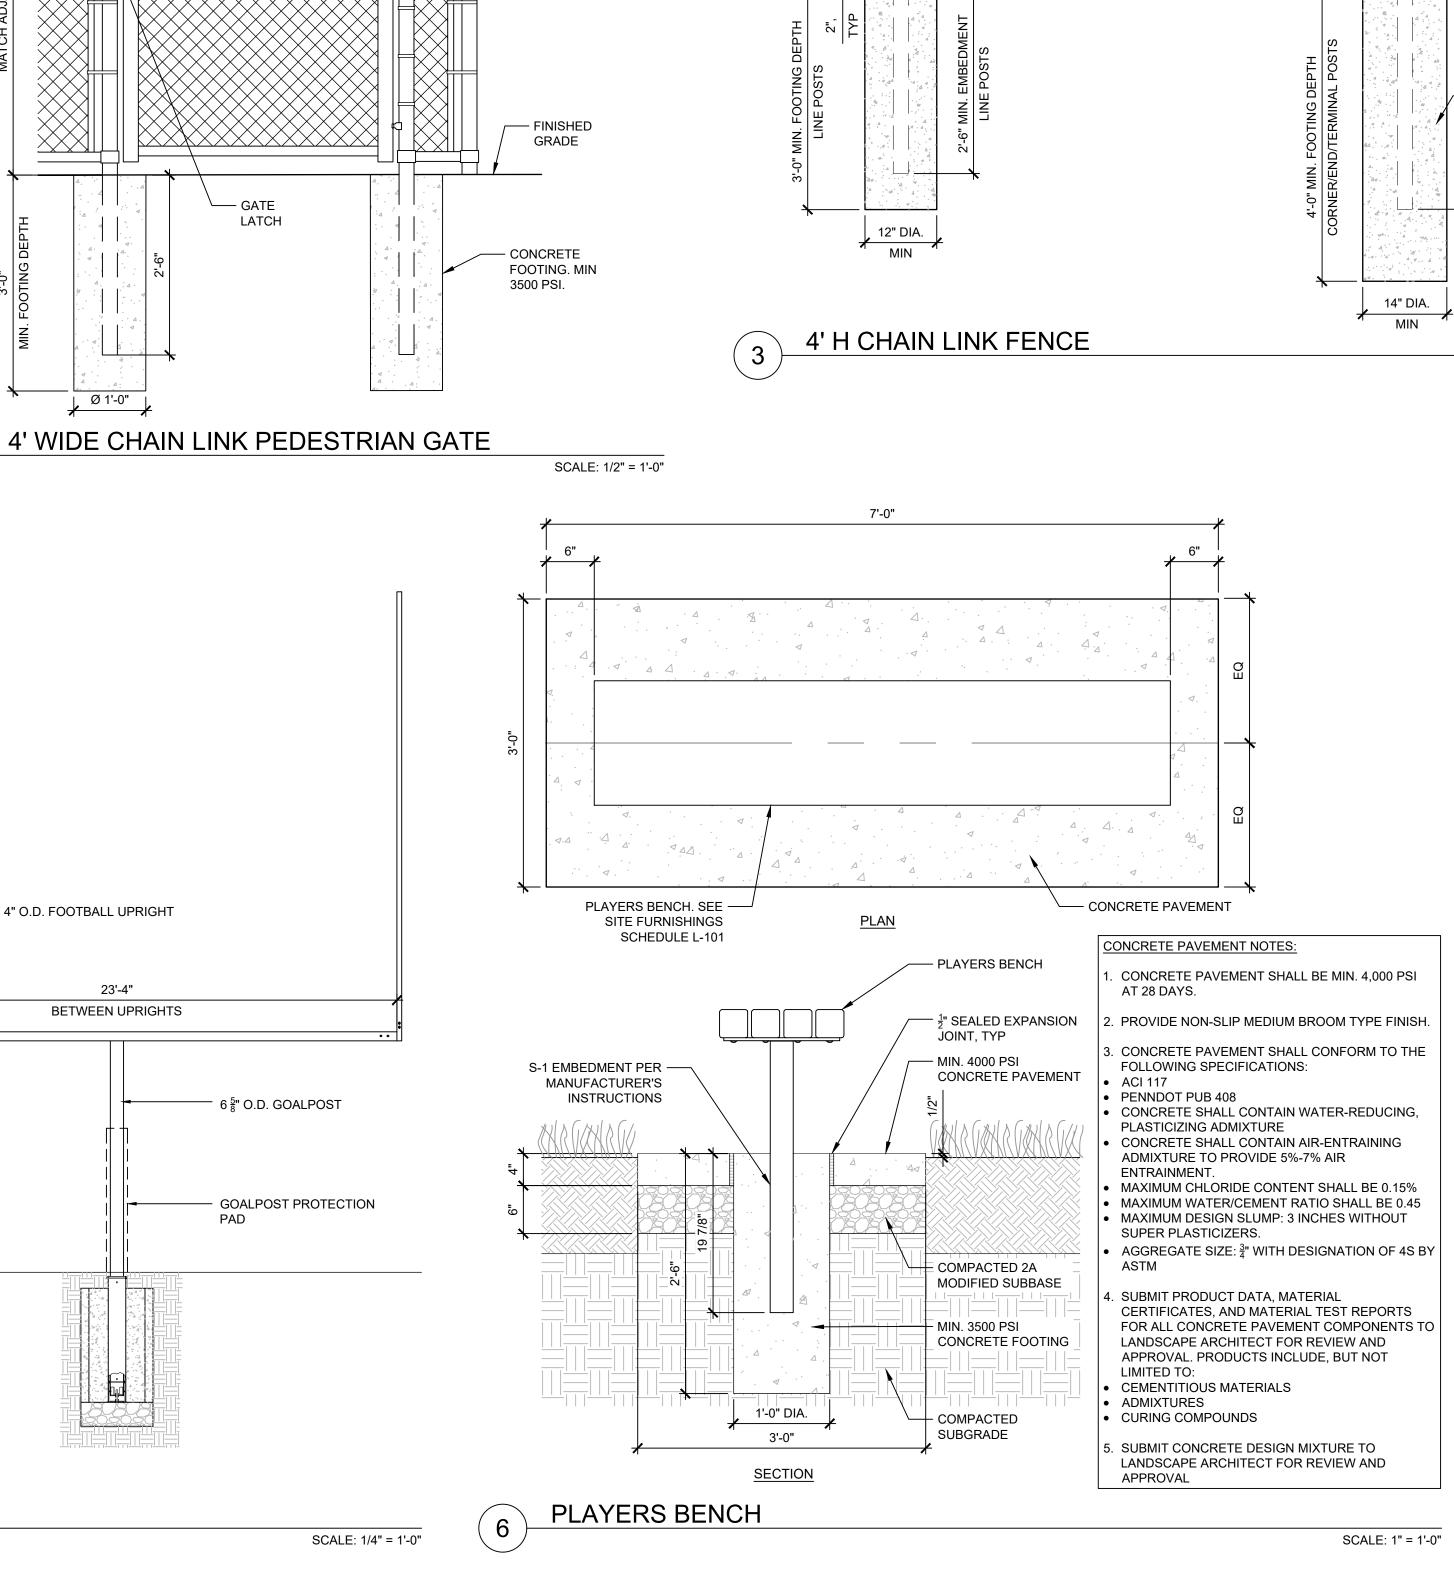

NOTES:

4.2. . .2. SUBMITTAL SHALL INCLUDE ANALYSIS OF STRUCTURAL PERFORMANCE OF FENCING AND GATE FRAMEWORKS, SIGNED AND SEALED BY A LICENSED PROFESSIONAL STRUCTURAL ENGINEER IN THE STATE OF PENNSYLVANIA. 8' MAX. BETWEEN POSTS DOMED POST CAP -· 1/4" x 3/4" STRETCHER BAR - NEW 9GA TIE WIRES ALONG 1 §" GALVANIZED -TOP AND BOTTOM RAILS; STEEL TOP RAIL 2 7 LINE POST NEW STRETCHER BAR SPACED 2'-0" O.C. BANDS; SPACE AT 14" O.C. MAX. 4" O.D. GALVANIZED STEEL END/TERMINAL/CORNER FENCE POST - CHAIN LINK MESH WITH 2" x 2" WEAVE TO MATCH ADJACENT PLAYGROUND FENCING 1 ⁵/₈" GALVANIZED STEEL BOTTOM RAIL FINISHED GRADE MIN. 3500 PSI CONCRETE FOOTING

CHAIN LINK FENCING SHALL BE FROM APPROVED PPR FENCING MANUFACTURER.

REVIEW AND APPROVAL BY LANDSCAPE ARCHITECT.

ADJACENT FENCING AND SITE ELEMENTS. ALL DIMENSIONS SHALL BE VERIFIED IN THE FIELD.

ATTACHMENTS TO OTHER WORK, ACCESSORIES, AND HARDWARE AS NEEDED.

ALL NEW FRAMING, POSTS, CHAIN LINK MESH, ACCESSORIES, ETC. SHALL BE POWDERCOATED BLACK.

CONTRACTOR SHALL VERIFY LAYOUT INFORMATION FOR CHAIN LINK FENCING AS SHOWN ON DRAWINGS IN RELATION TO

CONTRACTOR TO SUBMIT PRODUCT DATA AND SHOP DRAWINGS OF CHAIN LINK FENCING PRIOR TO INSTALLATION FOR

4.1. SHOP DRAWINGS SHALL INCLUDE PLANS, ELEVATIONS, SECTIONS, DETAILS, POST SPACING, MOUNTING/INSTALLATION,


NOTES:

RECEPTACLE MODEL 157-32 FTO MANUFACTURED BY DUMOR, INC.

TWO RECEPTACLES SHALL BE PROVIDED AT LOCATION SHOWN IN L-401 2.1. RECEPTACLES SHALL BE PLACED DIRECTLY ADJACENT TO ONE

ANOTHER, 3" APART. ONE RECEPTACLE SHALL BE COLOR: BLACK FOR TRASH DISPOSAL 2.2. ONE RECEPTACLE SHALL BE COLOR: 'RECYCLE BLUE' FOR RECYCLING.

INSTALL RECEPTACLES PER MANUFACTURER'S INSTRUCTIONS.

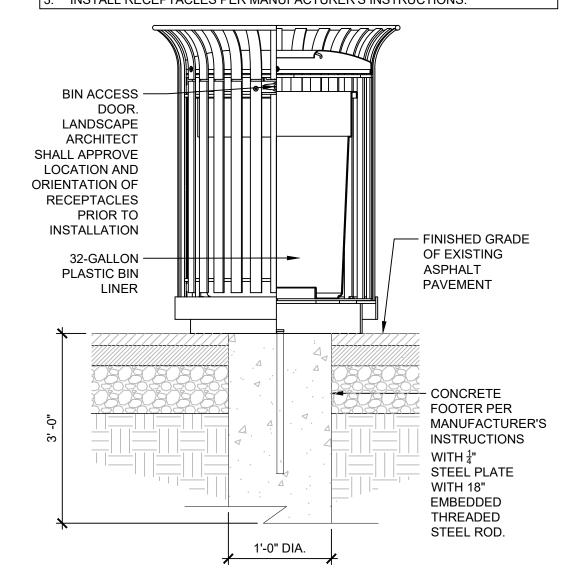

TRASH & RECYCLING RECEPTACLE SCALE: 1/2" = 1'-0"

SCALE: 3/4" = 1'-0"

NOTES: BLEACHER FRAME SHALL BE LSG 3-15 FRAME SET AS MANUFACTURED BY RECREATION RESOURCE USA. 1.1. CONTACT: KEVIN UMBREIT; P: 610-444-4402; E: KEVINU@RECREATION-RESOURCE.COM

ASSEMBLE BLEACHER FRAME AND ANCHOR TO FOUNDATION PER MANUFACTURER'S INSTRUCTIONS

CONTRACTOR SHALL FURNISH AND INSTALL SEATING AND FOOT PLANKS REQUIRED FOR COMPLETE INSTALLATION ON BLEACHER. PROCURE WOOD PLANKS LOCALLY.

3.1. SEATING PLANKS: 2X12 (NOMINAL) PRESSURE TREATED PINE.

3.2. FOOT PLANTS: 2 X10 (NOMINAL) PRESSURE TREATED PINE. 3.3. $\frac{7}{16}$ " GALVANIZED HARDWARE, INCLUDING 2 $\frac{1}{2}$ " OR 3" CARRIAGE BOLTS, LOCK WASHERS, AND HEX NUTS FOR ATTACHMENT OF PLANKS TO FRAME.

SUBMIT PRODUCT INFORMATION FOR BLEACHER TO LANDSCAPE ARCHITECT FOR REVIEW AND APPROVAL

REFER TO CONCRETE PAVEMENT NOTES IN DETAIL 6/L-501 FOR CONCRETE PAVEMENT REQUIREMENTS. ੀ WIDE X 1 ੀ DEEP SAWCUT CONTROL JOINT AT CENTER OF CONCRETE 1'-6" 6'-0" 6'-0" 1'-6" <u>PLAN</u> 6x6-W2.1xW2.1 FOOT PLANKS: 2X10 — — BLEACHER FRAME

WELDED WIRE PRESSURE-TREATED PINE, TYP FABRIC (1 ½ FINISHED GRADE SEATING PLANKS: 2X12 — CONCRETE TOP OF TURFGRASS PRESSURE-TREATED COVER) SHALL BE ½" PINE, TYP BELOW TOP OF MIN. 4000 PSI — CONCRETE SLAB CONCRETE PAVEMENT

BLEACHER ON CONCRETE PAVEMENT

PROPERTY ADDRESS:

CHEW PLAYGROUND 1800 WASHINGTON AVE PHILADELPHIA, PA 19146



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PROJECT MANAGER:



REBUILD PHILADELPHIA 1515 ARCH STREET MEZZANINE LEVEL PHILADELPHIA, PA 19107

PROJECT PARTNERS:

SALT DESIGN STUDIO 4100 MAIN STREET, SUITE 201 PHILADELPHIA, PA 19127

PROJECT TITLE:

PLAYGROUND FIELD RENOVATION

CIVIL ENGINEER:

meliora 🗘 🛱 Civil, Water Resources, and Structural Engineering 259 Morgan St., Phoenixville, PA 19460 P: 610.933.0123 | www.melioradesign.com

REVISIONS:				
DATE:	ISSUE:			
SEAL:				

SUBMISSION:

BID DOCUMENTS

DRAWING TITLE:

SCALE: 1/2" = 1'-0"

SITE DETAILS

DATE:	DRAWING NO:
02/04/22	04
SCALE:	L-501
AS NOTED	_
DRAWN BY:	
SB/GA	
CHECKED BY:	
SPS	