BETHEL BURYING GROUND

MEMORIAL PROJECT AT WECCACOE PLAYGROUND

PROJECT ADMINISTRATOR

Office of the Arts, Culture and Creative Economy City of Philadelphia, City Hall, Room 116 Philadelphia, Pennsylvania 19107 215 686 8446

ARTIST

Karyn Olivier karyn@karynolivier.com

ARCHITECT

SMP Architects 1600 Walnut Street, 2nd Floor Philadelphia, Pennsylvania 19103 215 985 4410

LANDSCAPE ARCHITECT

Ground Reconsidered 915 Spring Garden Street, Suite 403, Philadelphia, PA 19123 215 790 0727

PROJECT OWNER

Philadelphia Parks and Recreation 1515 Arch St #10 Philadelphia, Pennsylvania 19102 215 683 3600

CIVIL ENGINEER


KS Engineers, PC 530 Walnut Street, Suite 460 Philadelphia, Pennsylvania 19106 215 925 0425

ARCHAEOLOGIST

AECOM 1700 Market Street, Suite 1600, Philadelphia, Pennsylvania 19103 215 399 4300

100% CONSTRUCTION DOCUMENTS 05/10/2024

PROJECT SITE

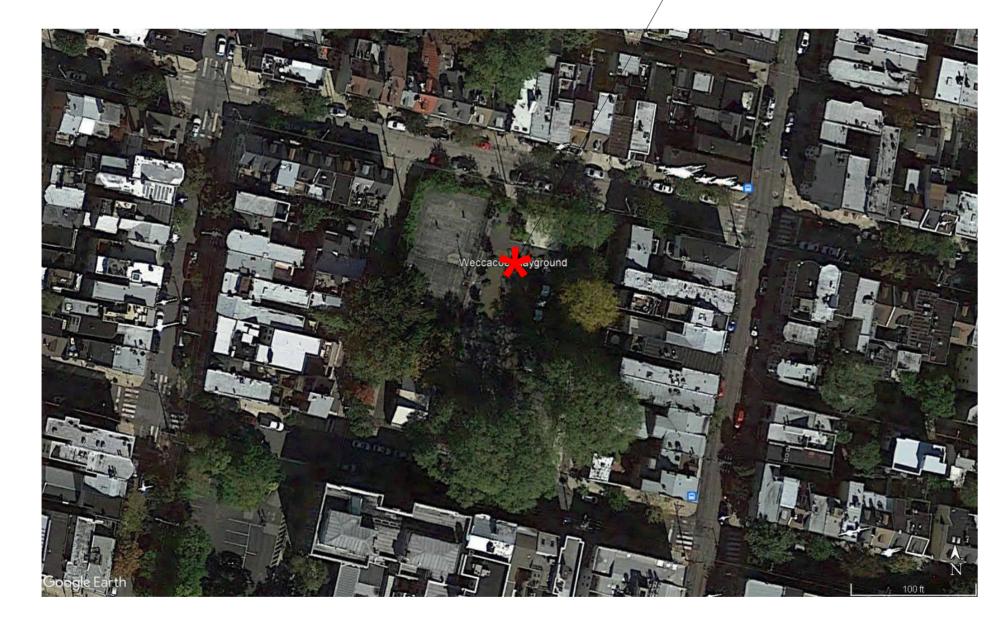



DRAWING LIST:


GENERAL				
CS	COVER SHEET			
CIVIL				
C100	EXISTING SITE PLAN			
C101	EXISTING UTILITIES PLAN			
C201	UTILITIES DEMOLITION PLAN			
C300	UTILITIES & GRADING PLAN			
CE100	EROSION AND SEDIMENT CONTROL PLAN			
CE501	EROSION AND SEDIMENT CONTROL DETAILS			
CE701	EROSION AND SEDIMENT CONTROL NOTES			
LANDSCAPE				
L101	DEMOLITION AND PROTECTION PLAN			
L201	SITE MATERIALS PLAN			
L211	SITE SECTIONS			
L212	SITE SECTIONS			
L301	LAYOUT PLAN			
L401	GRADING PLAN			
L501	PLANTING PLAN			
L502	PLANTING PLAN - BULBS			
L601	SITE DETAILS			
L602	SITE DETAILS			
L603	SITE DETAILS			
L604	SITE DETAILS			
L605	PLANTING DETAILS			
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A2.0	DETAILS - BRICK PIERS AND GATE			

PROJECT ADDRESS 400 CATHARINE STREET PHILADELPHIA, PA 19147


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s s s	SANITARY SEWER
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E	ELECTRIC CONDUIT
XXXXX	FENCE
MH)	UNKNOWN MANHOLE
T	TELEPHONE MANHOLE
<u>\$</u>	SANITARY MANHOLE
(D)	STORM MANHOLE
\circ	STORM/SANITARY MANHOLE
(Ē)	ELECTRIC MANHOLE
(W)	WATER MANHOLE
□ <i>W</i>	WATER VALVE
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_ ?	UNKNOWN VALVE
<i>V</i>	SEWER VENT
\Diamond	FIRE HYDRANT
φ / ΦΦ	UTILITY POLE/STREET LIGHT
ф.	LIGHT POLE
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() <i>U.G.S.T.</i>	UNDER GROUND STORAGE TANK
0	CITY INLET
	GRATE INLET
	OMG INLET
— P: — P: — P: —	PROPERTY LINE
	EASEMENT LINE

#### **GENERAL NOTES:**

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QUEEN STREET LEGALLY OPEN ON CITY PLAN PARKING PARKING

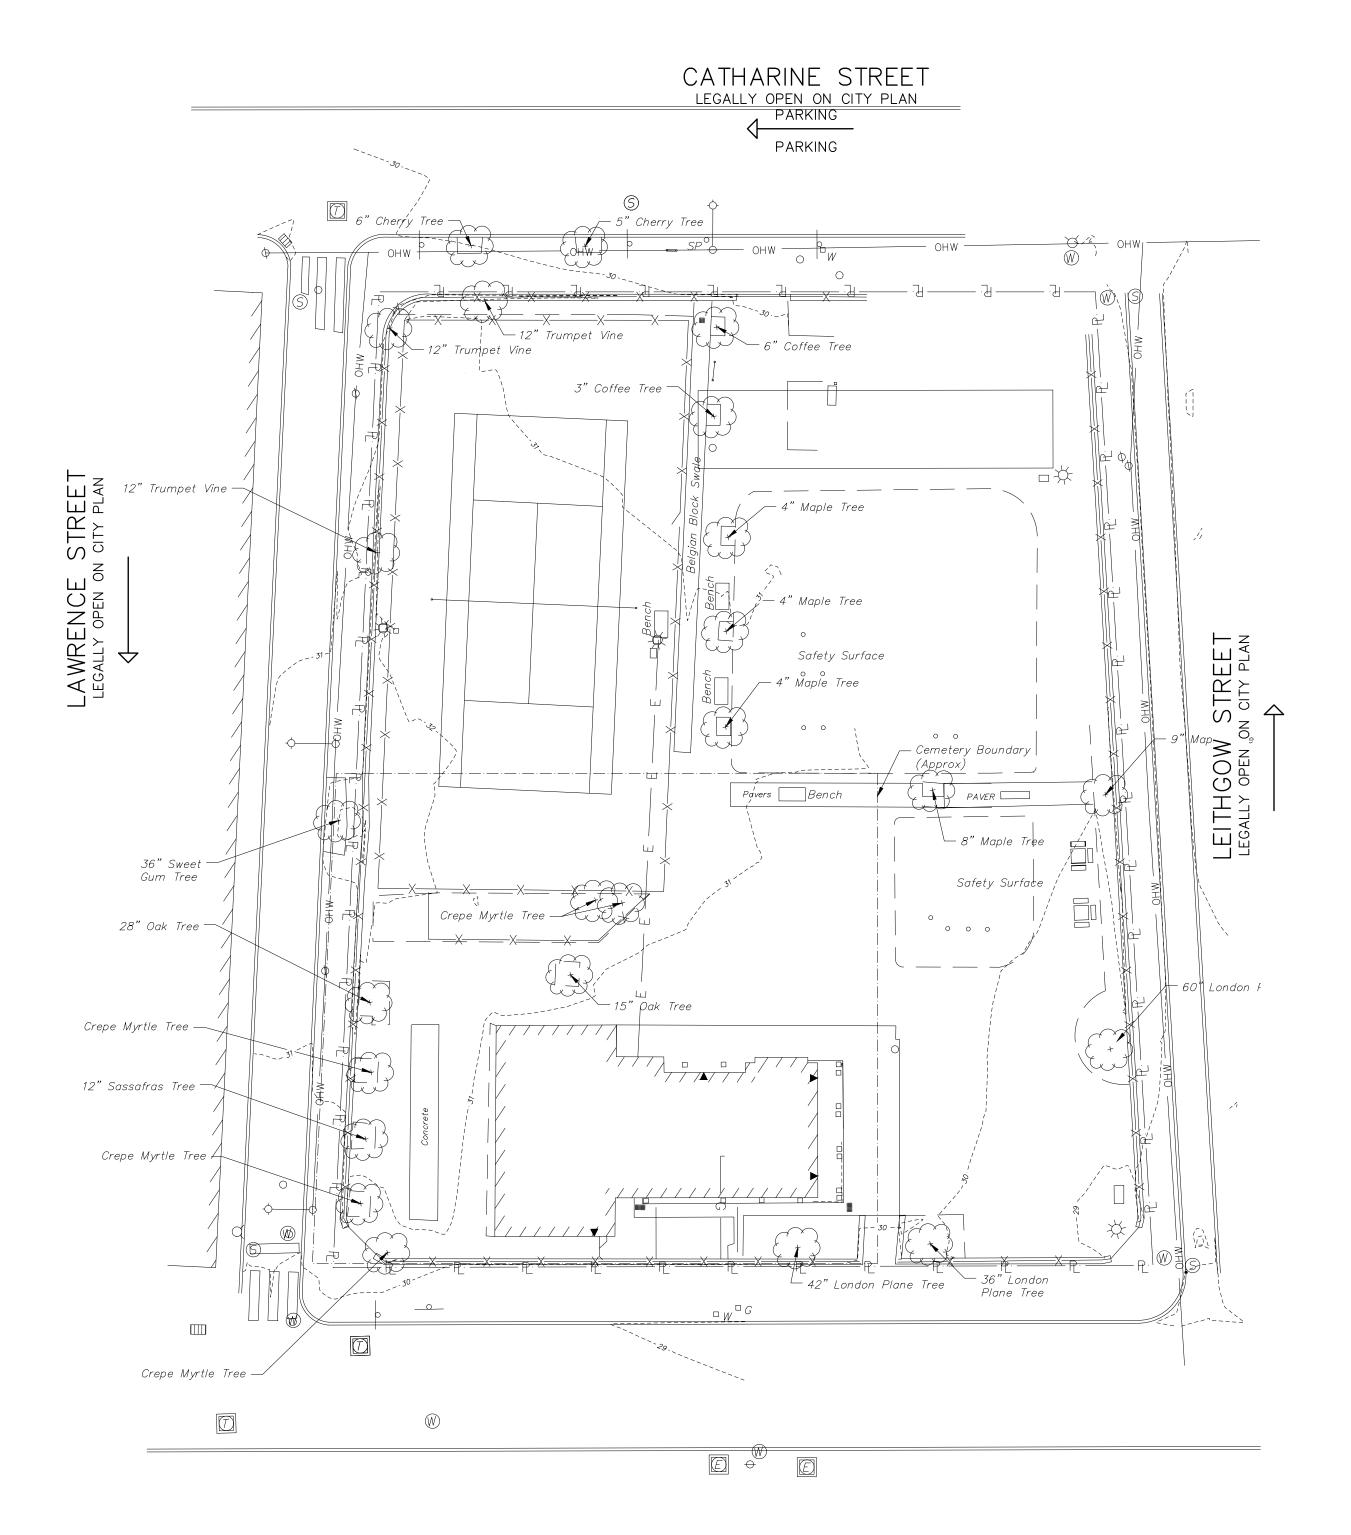

#### VICINITY MAP

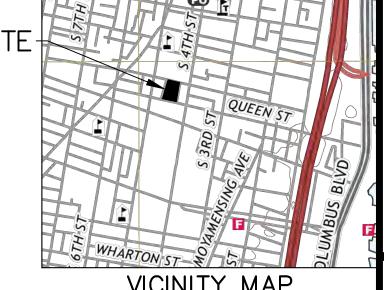1" = 1000' DELAWARE DIRECT WATERSHED FLOOD MANAGEMENT A COMBINE SEWER SERVICE

## BETHEL BURYING GROUND

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Design Team:

Karyn Olivier karyn@karynolivier.com

ARCHITECT

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#### LANDSCAPE ARCHITECT


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#### CIVIL ENGINEER

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#### ARCHAEOLOGIST

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(215) 952-4935

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(215) 731-3264

PECO-CONSTRUCTION DEPARTMENT 2301 MARKET STREET
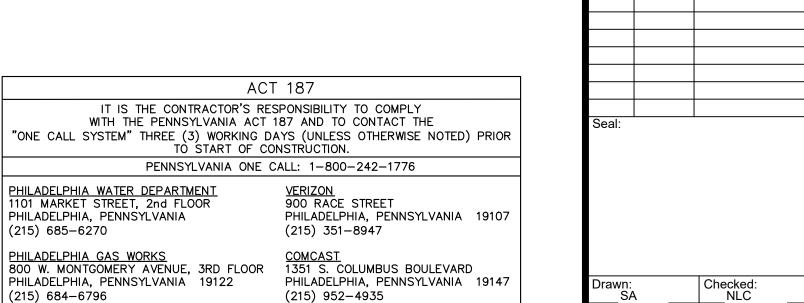
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PHILADELPHIA, PENNSYLVANIA 19103

05/10/2024

Job Number: 749

No. Date

Drawing Set: 100% CONSTRUCTION DOCUMENTS

Revisions

Drawing Title:

EXISTING SITE PLAN

Drawing Number:

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SCALE: 1" = 20'-0"

SITE LOCATION: 405-25 QUEEN ST

PHILADELPHIA, PA 19147


1401 JOHN F. KENNEDY BLVD PHILADELPHIA, PA 19102-1617

PROPERTY OWNER: CITY OF PHILADELPHIA


#### EXISTING LEGEND ////// BUILDING CONCRETE CURB MAJOR CONTOUR LINE MINOR CONTOUR LINE GAS LINE POTABLE WATER SANITARY SEWER STORM SEWER TELECOMMUNICATION CONDUIT ELECTRIC CONDUIT FENCE UNKNOWN MANHOLE TELEPHONE MANHOLE SANITARY MANHOLE STORM MANHOLE STORM/SANITARY MANHOLE ELECTRIC MANHOLE WATER MANHOLE WATER VALVE $\square$ W GAS VALVE $\Box G$ UNKNOWN VALVE SEWER VENT $\Box V$ FIRE HYDRANT UTILITY POLE/STREET LIGHT LIGHT POLE TRAFFIC LIGHT SIGN TREE UNDER GROUND STORAGE TANK (__) U.G.S.T. CITY INLET 0 GRATE INLET OMG INLET PROPERTY LINE EASEMENT LINE

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QUEEN STREET
LEGALLY OPEN ON CITY PLAN
PARKING
PARKING

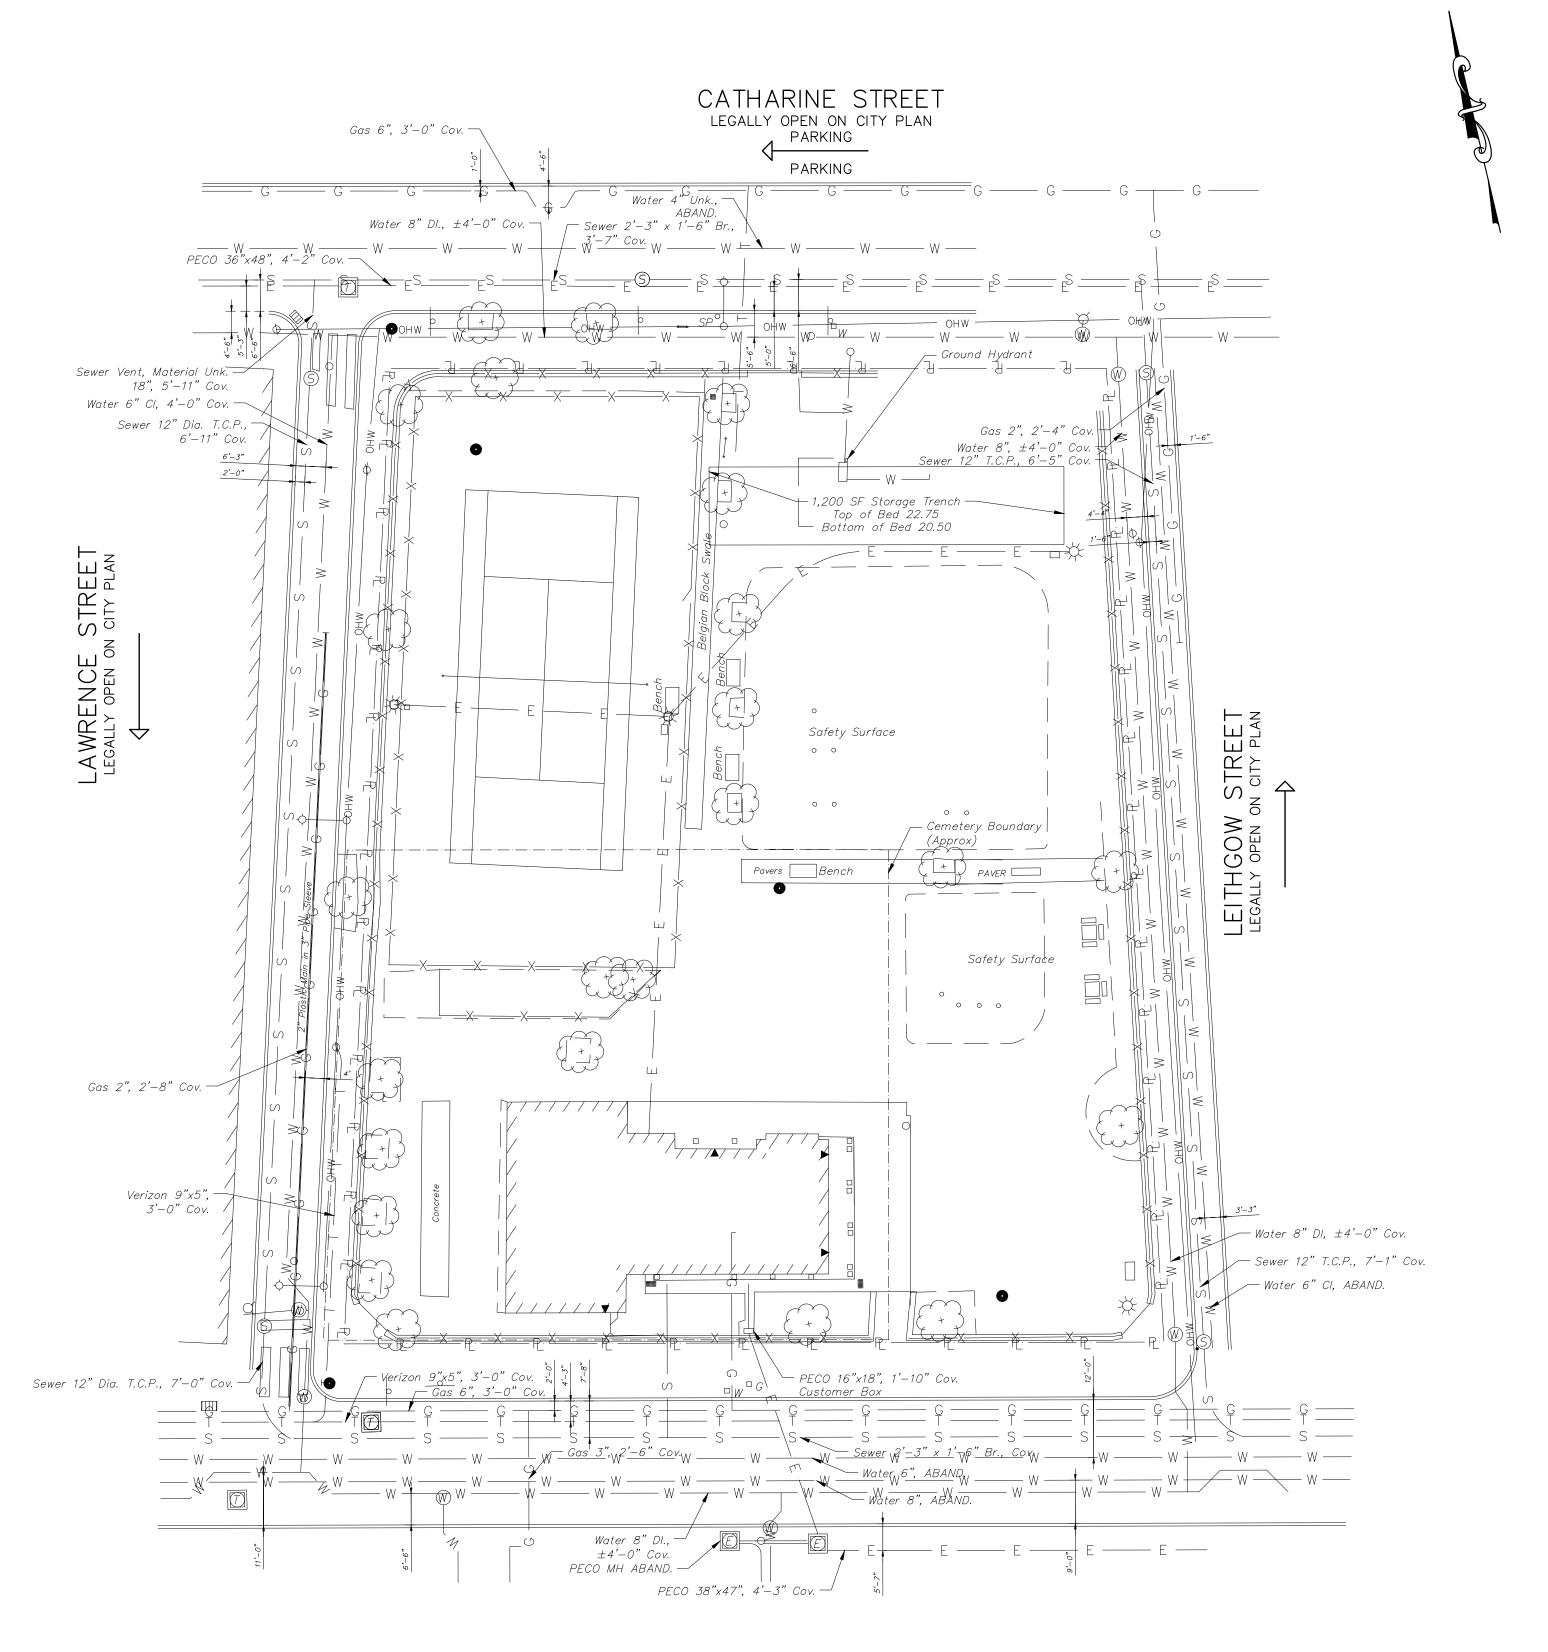

#### VICINITY MAP

1" = 1000'
DELAWARE DIRECT WATERSHED
FLOOD MANAGEMENT A
COMBINE SEWER SERVICE
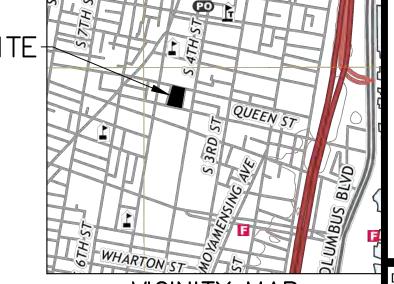
## BETHEL BURYING GROUND

## MEMORIAL PROJECT AT WECCACOE PLAYGROUND

Design Team:

Karyn Olivier karyn@karynolivier.com

ARCHITECT

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#### ARCHAEOLOGIST

AECOM 1700 Market Street, Suite 1600, Philadelphia, Pennsylvania 19103 215 399 4300

No. Date Revisions

Seal:

Seal:

Drawn: Checked: Approved: RSB

Job Number: 749

File:

Date: 05/10/201

05/10/2024

Drawing Set:
100% CONSTRUCTION DOCUMENTS

Drawing Title:

EXISTING UTILITIES PLAN

Drawing Number:

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C101

WHAT YOU DON'T KNOW CAN HURT YOU.

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PENNSYLVANIA LAW REQUIRES 3 WORKING DAYS NOTICE FOR CONSTRUCTION PHASE & 10 WORKING DAYS IN DESIGN STAGE

Pennsylvania One Call System, Inc.

1-800-242-1776

PHILADELPHIA WATER DEPARTMENT 1101 MARKET STREET, 2nd FLOOR

PHILADELPHIA GAS WORKS 800 W. MONTGOMERY AVENUE, 3RD FLOOR

PHILADELPHIA, PENNSYLVANIA 19122

PECO-CONSTRUCTION DEPARTMENT
2301 MARKET STREET
PHILADELPHIA, PENNSYLVANIA 19103

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PHILADELPHIA, PENNSYLVANIA

(215) 685-6270

(215) 684-6796

(215) 731-3264

ACT 187

<u>VERIZON</u> 900 RACE STREET

(215) 351-8947

(215) 952-4935

PHILADELPHIA, PENNSYLVANIA 19107

PHILADELPHIA, PENNSYLVANIA 19147

COMCAST 1351 S. COLUMBUS BOULEVARD

SITE LOCATION:

405-25 QUEEN S

PHILADELPHIA, PA 19147


PROPERTY OWNER: CITY OF PHILADELPHIA

IT IS THE CONTRACTOR'S RESPONSIBILITY TO COMPLY WITH THE PENNSYLVANIA ACT 187 AND TO CONTACT THE

"ONE CALL SYSTEM" THREE (3) WORKING DAYS (UNLESS OTHERWISE NOTED) PRIOR

TO START OF CONSTRUCTION.

PENNSYLVANIA ONE CALL: 1-800-242-1776

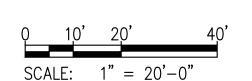


1401 JOHN F. KENNEDY BLVD PHILADELPHIA, PA 19102-1617

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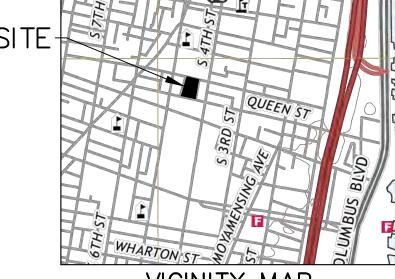
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#### CATHARINE STREET LEGALLY OPEN ON CITY PLAN PARKING PARKING



QUEEN STREET LEGALLY OPEN ON CITY PLAN PARKING PARKING

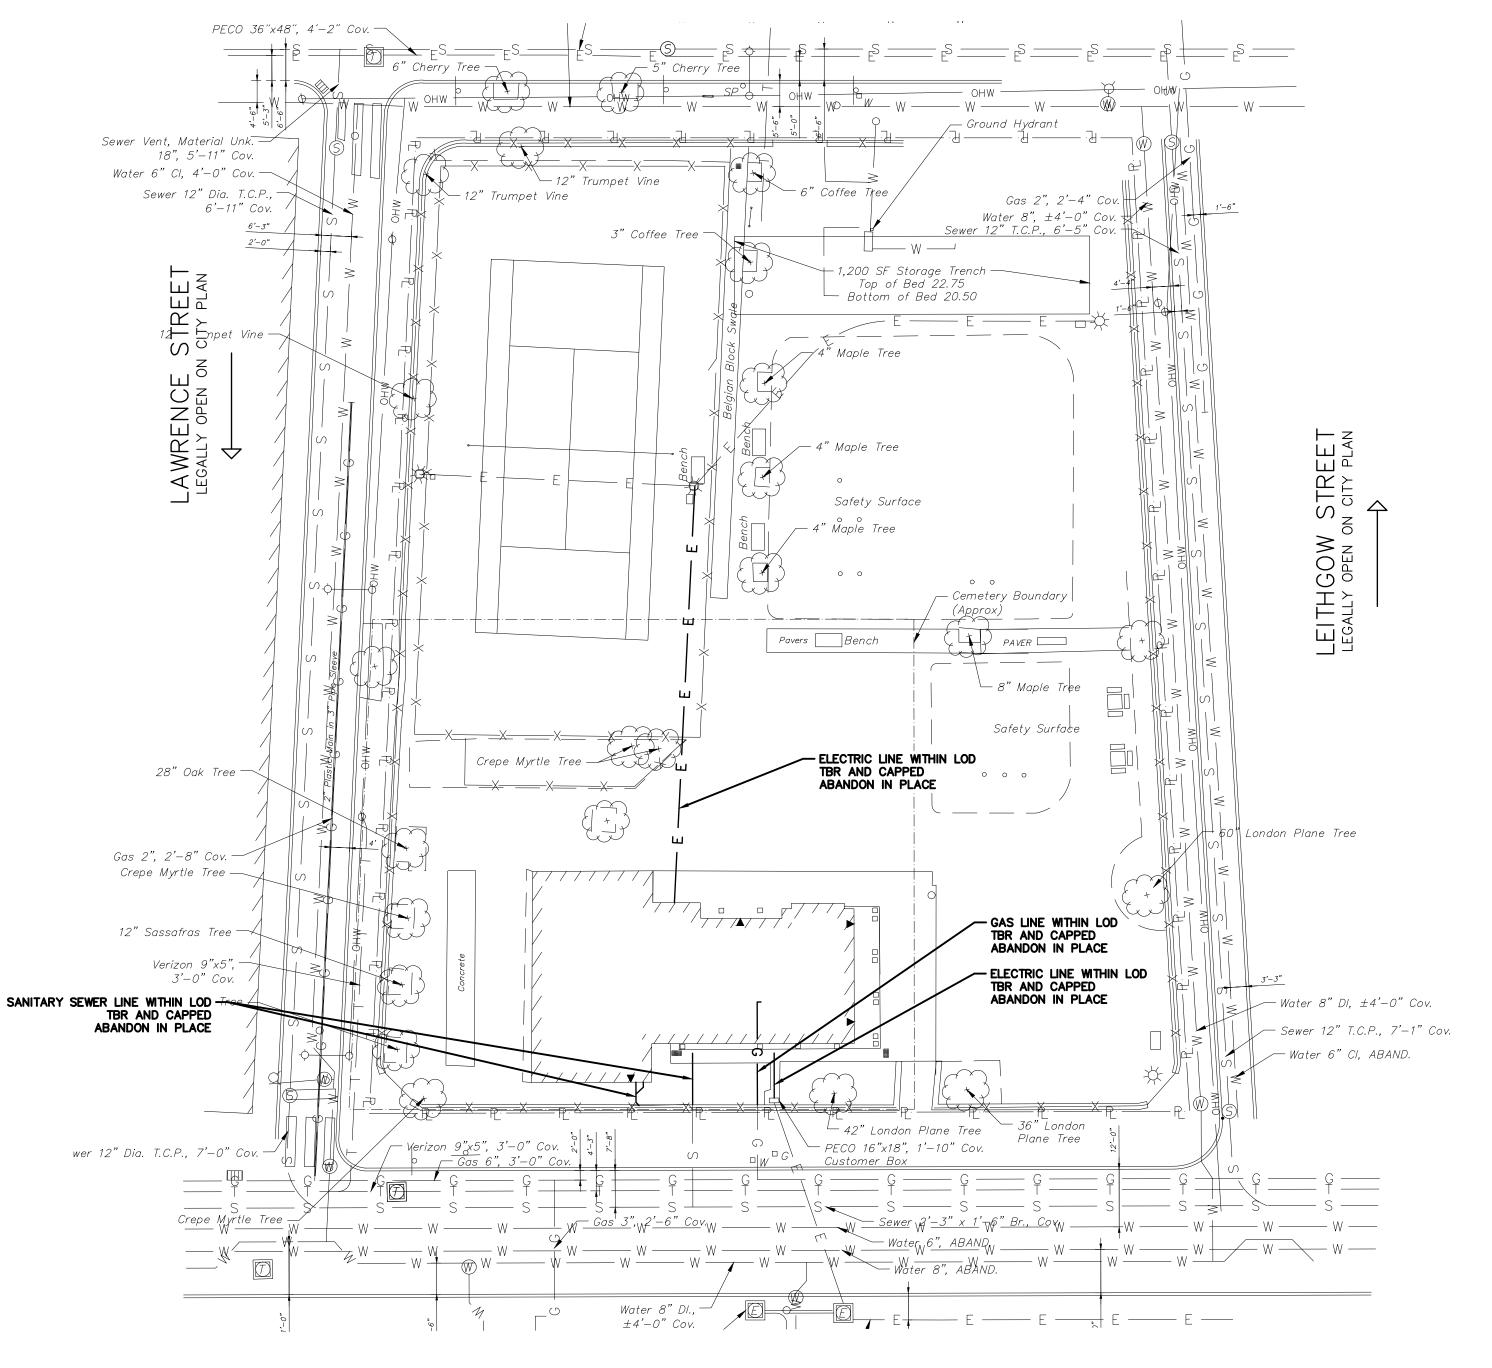

#### VICINITY MAP

1" = 1000'DELAWARE DIRECT WATERSHED FLOOD MANAGEMENT A COMBINE SEWER SERVICE

### BETHEL BURYING **GROUND**

## MEMORIAL PROJECT AT WECCACOE PLAYGROUND

Design Team:

Karyn Olivier karyn@karynolivier.com

ARCHITECT

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#### LANDSCAPE ARCHITECT

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		No.	Date	Revisions
AC1	187			
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PENNSYLVANIA ONE C	ALL: 1-800-242-1776			
PHILADELPHIA WATER DEPARTMENT 1101 MARKET STREET, 2nd FLOOR PHILADELPHIA, PENNSYLVANIA (215) 685–6270	<u>VERIZON</u> 900 RACE STREET PHILADELPHIA, PENNSYLVANIA 19107 (215) 351–8947	Seal:		
PHILADELPHIA GAS WORKS 800 W. MONTGOMERY AVENUE, 3RD FLOOR PHILADELPHIA, PENNSYLVANIA 19122 (215) 684–6796	COMCAST 1351 S. COLUMBUS BOULEVARD PHILADELPHIA, PENNSYLVANIA 19147 (215) 952-4935			

Job Number: 749

05/10/2024

Drawing Set:

100% CONSTRUCTION DOCUMENTS


Drawing Title:

UTILITIES **DEMOLITION PLAN** 

Drawing Number:

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2301 MARKET STREET
PHILADELPHIA, PENNSYLVANIA 19103

(215) 731-3264

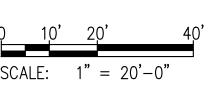
SCALE: 1" = 20' - 0"


1401 JOHN F. KENNEDY BLVD PHILADELPHIA. PA 19102-1617


SITE LOCATION: 405-25 QUEEN ST

PHILADELPHIA, PA 19147

PROPERTY OWNER: CITY OF PHILADELPHIA

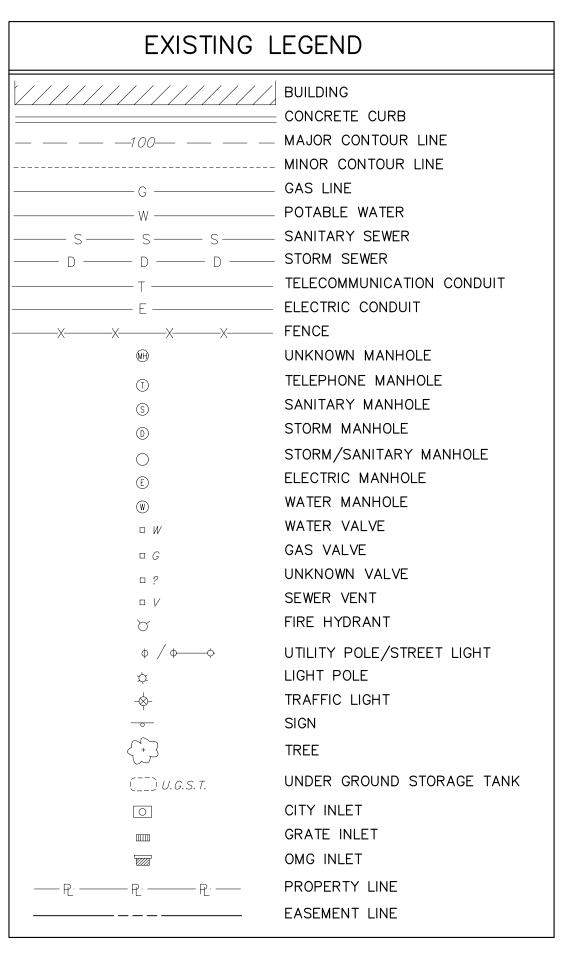

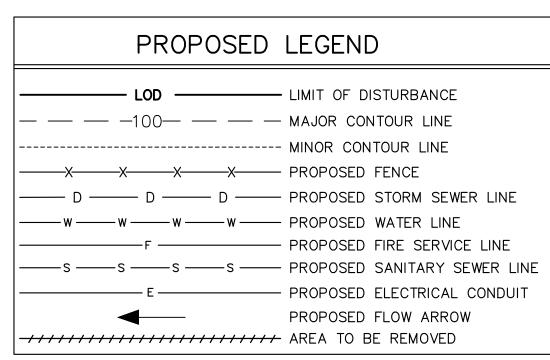

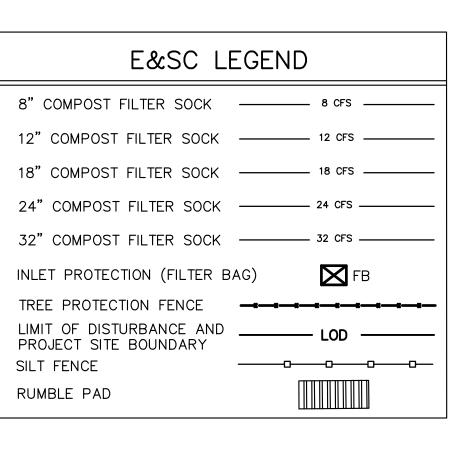

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#### NOTES:


- I. DEVELOPER/OWNER WILL COMPLY WITH ALL PHILADELPHIA REGULATIONS PERTAINING TO PROPER ABANDONMENT AND/OR REUSE OF WATER SERVICE LINES AND SEWER LATERALS. PROOF OF ABANDONMENT AND/OR DISCONTINUANCE MUST BE PROVIDED UPON REQUEST.
- 2. CITY OF PHILADELPHIA DEPARTMENT OF PUBLIC PROPERTY ARE RESPONSIBLE FOR MAINTENANCE OF WATER, SANITARY, AND STORM INFRASTRUCTURE.

#### PROJECT DESCRIPTION:

- PROJECT PROPOSES DEMOLITION OF THE EXISTING STRUCTURES, REMOVAL OF TREES, CONSTRUCTION OF ADA RAMP AND SITE IMPROVEMENT WORK.
- 2. NO CRANES ARE NECESSARY FOR CONSTRUCTION.
- 3. NO PROPOSED WATER OR SEWER CONNECTION.

#### **ELECTRICAL NOTES:**

- THE ELECTRICAL CONTRACTOR IS RESPONSIBLE FOR COORDINATING WITH PECO REGARDING THE PROPOSED UTILITY CONNECTION AND METER INSTALLATION.
- 2. ALL PROPOSED CONDUIT SIZING AND WIRING SHALL BE DETERMINED BY THE ELECTRICAL CONTRACTOR
- 3. ALL CONDUIT ROUTING SHALL BE FIELD VERIFIED BY THE ELECTRICAL CONTRACTOR

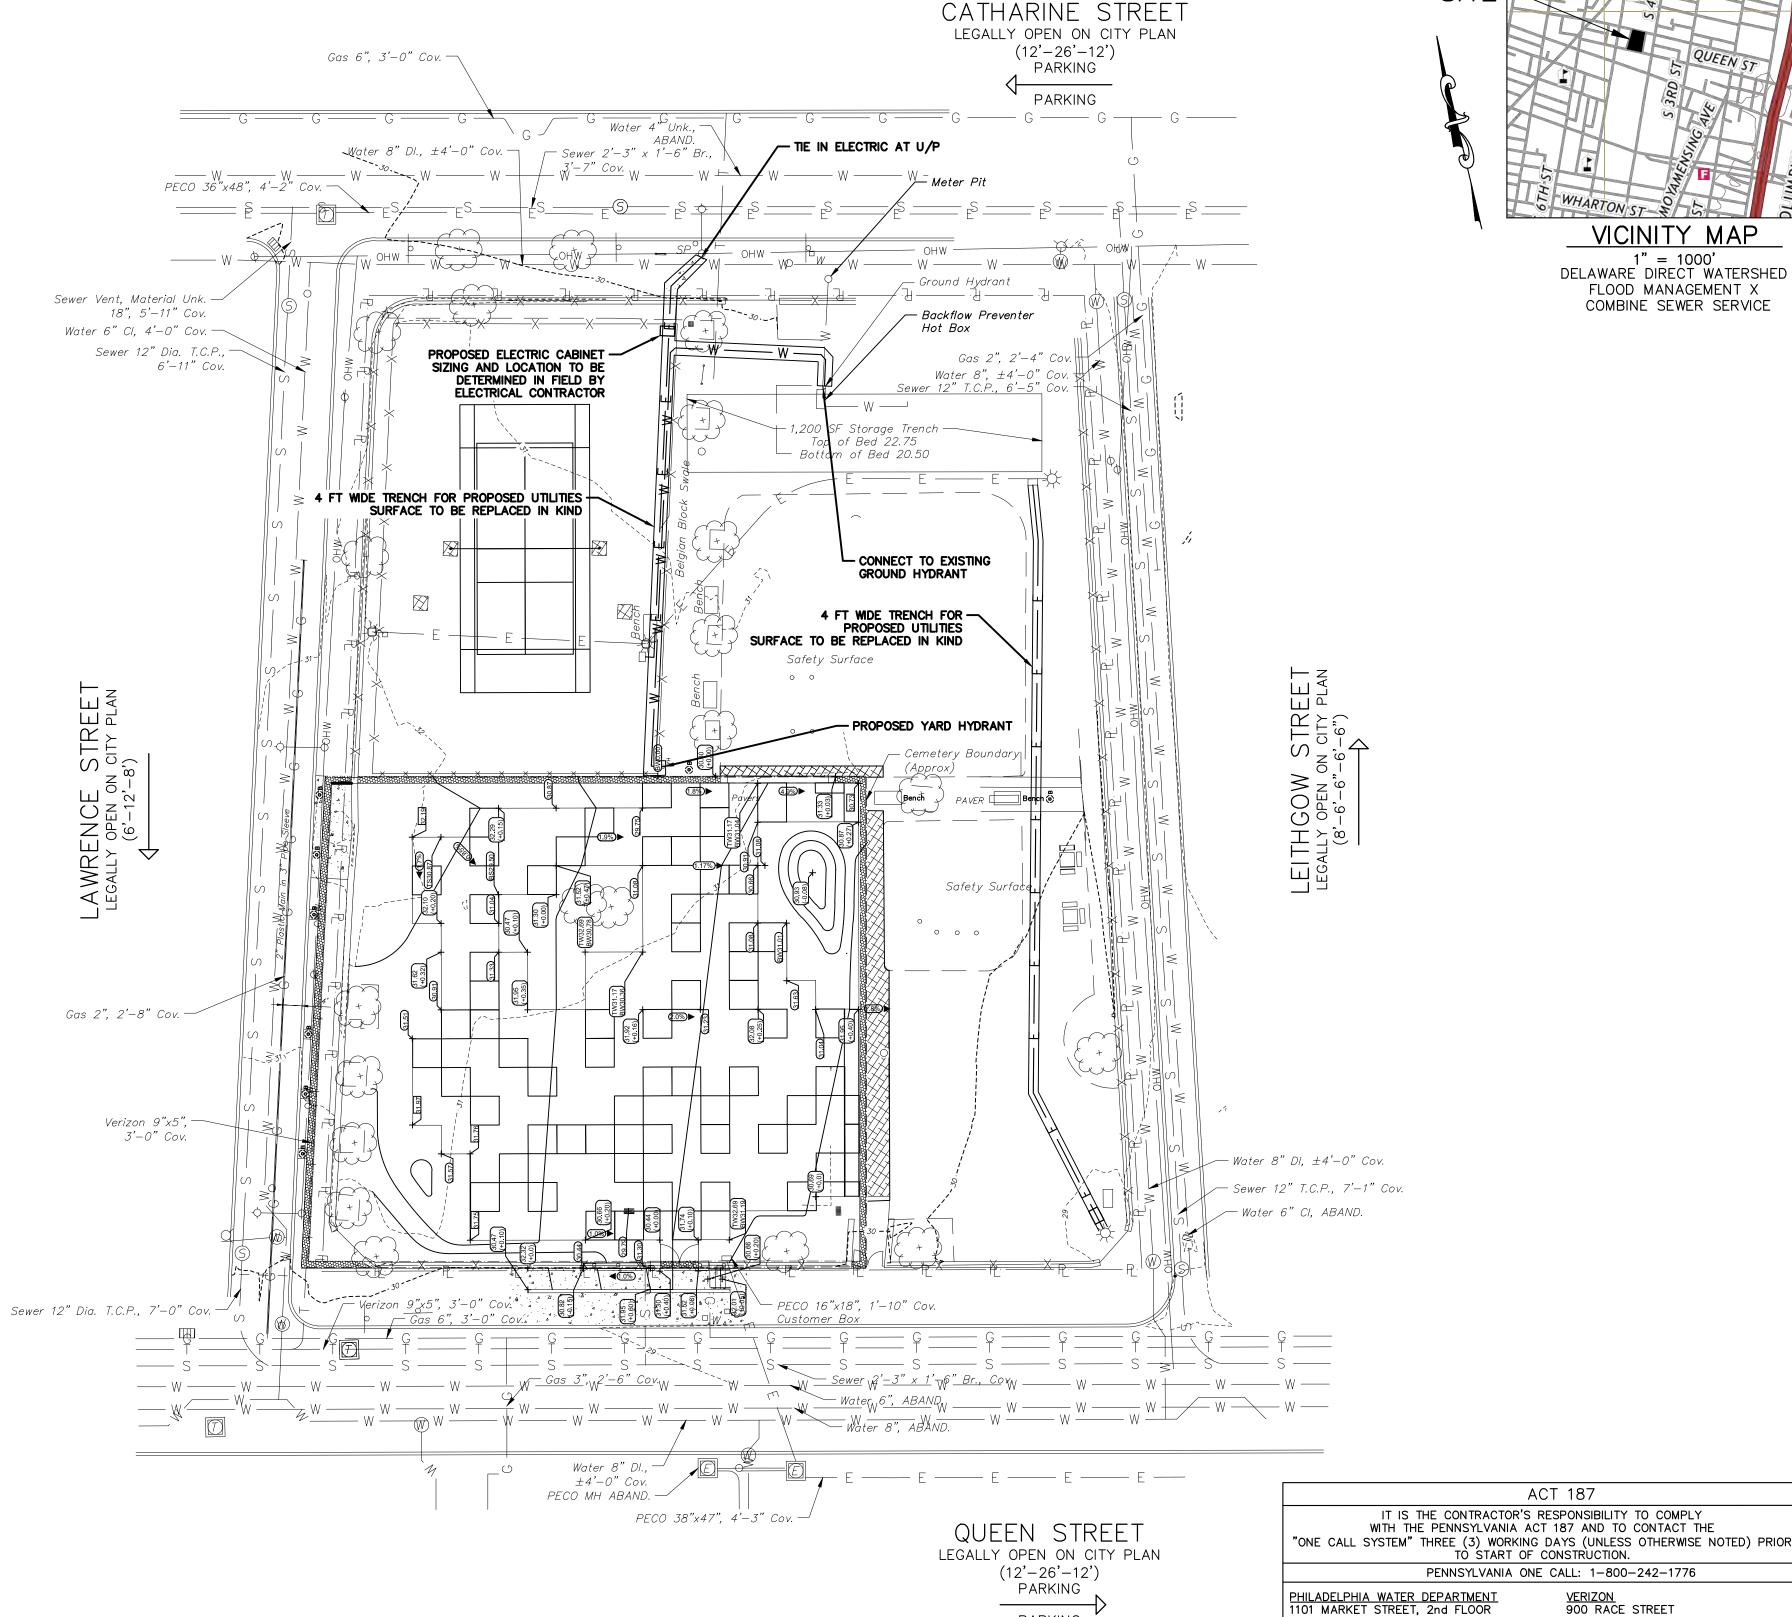



PHILADELPHIA, PENNSYLVANIA

PHILADELPHIA GAS WORKS 800 W. MONTGOMERY AVENUE, 3RD FLOOR

PHILADELPHIA, PENNSYLVANIA 19122

PECO-CONSTRUCTION DEPARTMENT 2301 MARKET STREET

PHILADELPHIA, PENNSYLVANIA 19103

(215) 685-6270

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PHILADELPHIA, PENNSYLVANIA 19107

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05/10/2024 100% CONSTRUCTION DOCUMENTS Drawing Title: UTILITIES & GRADING PLAN

Job Number: 749

No. Date

Revisions

Drawing Number:

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C300

Checked: NLC

BETHEL BURYING

AT WECCACOE

PLAYGROUND

MEMORIAL PROJECT

**GROUND** 

Design Team:

Karyn Olivier

**ARCHITECT** 

SMP Architects

215 985 4410

215 790 0727

**CIVIL ENGINEER** 

KS Engineers, PC

**ARCHAEOLOGIST** 

215 925 0425

AECOM

215 399 4300

karyn@karynolivier.com

1600 Walnut Street, 2nd Floor

LANDSCAPE ARCHITECT

530 Walnut Street, Suite 460

Philadelphia, Pennsylvania 19106

1700 Market Street, Suite 1600.

Philadelphia, Pennsylvania 19103

Ground Reconsidered

Philadelphia, Pennsylvania 19103

915 Spring Garden Street, Suite 403

Philadelphia, Pennsylvania 19123


WHAT YOU DON'T KNOW CAN HURT YOU. CALL BEFORE YOU DIG!
PENNSYLVANIA LAW REQUIRES 3 WORKING DAYS NOTICE FOR CONSTRUCTION PHASE & 10 WORKING DAYS IN DESIGN STAGE Pennsylvania One Call System, Inc.

1-800-242-1776

SCALE: 1" = 20'-0"

PWD UTILITY TRACKING: UPR-FY24-BETH-6821

PARKING

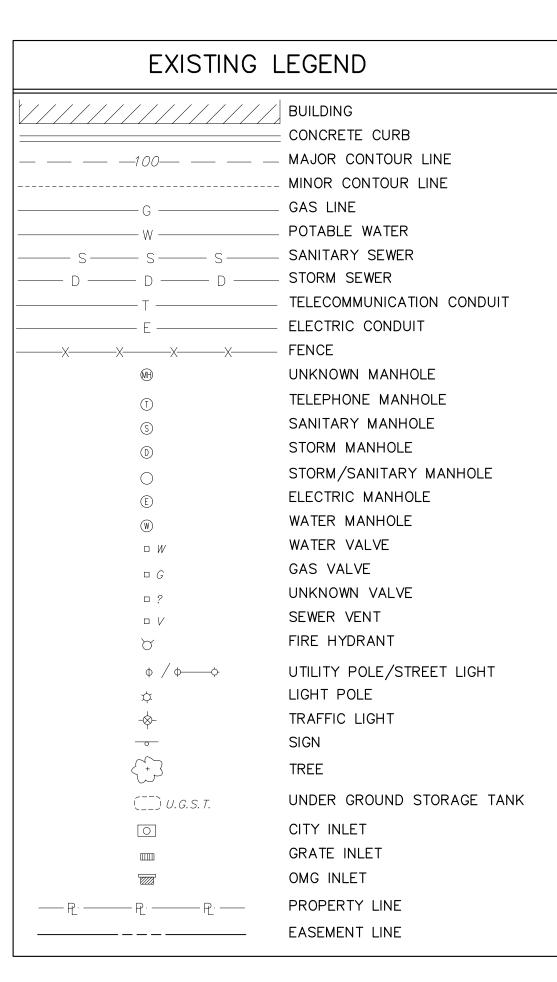

#### PROPOSED LEGEND LIMIT OF DISTURBANCE -- -100-- -- -- MAJOR CONTOUR LINE MINOR CONTOUR LINE ——— D ——— D ——— PROPOSED STORM SEWER LINE — PROPOSED FIRE SERVICE LINE ----s -----s PROPOSED SANITARY SEWER LINE - PROPOSED ELECTRICAL CONDUIT PROPOSED FLOW ARROW -////////////////////////////// AREA TO BE REMOVED

E&SC L	EGEND
8" COMPOST FILTER SOCK	8 CFS
12" COMPOST FILTER SOCK	12 CFS
18" COMPOST FILTER SOCK	18 CFS
24" COMPOST FILTER SOCK	24 CFS
32" COMPOST FILTER SOCK	32 CFS
INLET PROTECTION (FILTER B	BAG) FB
TREE PROTECTION FENCE	
LIMIT OF DISTURBANCE AND PROJECT SITE BOUNDARY	LOD
SILT FENCE	
RUMBLE PAD	


SOIL	SOIL	% OF	RUNOFF	HYDRIC	SLOPE	DEPTH	SOIL
SYMBOL	DESCRIPTION	SITE	CLASS	SOIL	RANGE		LIMITATIONS
UdB	URBAN LAND	100.00%	LOW	NO	0-8%	0"-10"	N/A

#### EROSION AND SEDIMENT CONTROL (E&SC) NOTES:

- EXISTING CONCRETE AND BITUMINOUS PAVING TO BE SAW-CUT ALONG LIMIT OF DISTURBANCE LINE WITH A CLEAN CUT LINE TO A SUFFICIENT DEPTH TO ALLOW THE REMOVAL OF PAVING WITHOUT DISTURBING THE EXISTING PAVING THAT IS TO REMAIN
- 2. THE CONTRACTOR SHALL REMOVE FROM THE SITE ALL DEBRIS, RUBBISH AND OTHER MATERIALS RESULTING FROM DEMOLITION AND SHALL SAFELY AND LEGALLY DISPOSE OF ALL THESE ITEMS IN ACCORDANCE WITH APPLICABLE LOCAL, FEDERAL, STATE AND REGULATORY AUTHORITY HAVING JURISDICTION. RECYCLING MUST BE DONE IN ACCORDANCE WITH APPLICABLE REGULATIONS. BURNING OF ANY DEMOLISHED MATERIALS ON-SITE SHALL NOT BE PERMITTED. RECYCLING OF DEMOLITION DEBRIS SHALL BE APPROVED BY THE OWNER. ALL EXISTING FILL TO BE REMOVED FROM SITE IN ACCORDANCE WITH THE PA DEP MANAGEMENT OF FILL POLICY AND REGULATIONS.
- 3. COMPOST FILTER SOCK ON PAVING TO BE WEIGHTED DOWN BY OBJECTS OF CONSIDERABLE MASS (SAND BAGS, CONCRETE BLOCK OR OTHER SUITABLE MATERIAL). COMPOST FILTER SOCK TO BE INSTALLED DOWNSTREAM OF ALL EARTH MOVING ACTIVITIES.
- 4. INLET PROTECTION IN ROADWAYS NOT TO INCLUDE STONE OR BERMS FOR ROADWAY MAINTENANCE PURPOSES.
- . MAXIMUM HEIGHT FOR STOCKPILE AREAS TO BE 20 FEET. THE MAXIMUM SIDE SLOPE FOR STOCKPILE AREAS NOT TO EXCEED 2H:1V.
- 6. RUMBLE PAD TO BE SIZED IN ACCORDANCE WITH PA DEP MINIMUM REQUIREMENTS OF 50'L X 20'W AND INSTALLED.
- 7. CONSTRUCTION, DEMOLITION AND EARTHWORK DUST CONTROL TO BE COMPLETED IN ACCORDANCE WITH THE CITY OF PHILADELPHIA DUST CONTROL REQUIREMENTS (AIR MANAGEMENT REGULATION (AMR) II. SECTION IX.) AND TO INCLUDE BUT NOT LIMITED TO:
  - a. NOTIFY OCCUPANTS OF NEARBY PROPERTIES, IN WRITING 10 DAYS BEFORE ENGAGING IN EARTHWORK, CONSTRUCTION AND DEMOLITION ACTIVITIES.
  - b. USE OF VACUUM OR SIMILAR SUCTION SYSTEMS TO CAPTURE DUST KICKED UP BY POWER TOOLS WHEN GRINDING OR CUTTING. c. APPLICATION OF WATER OR APPROVED DUST CONTROL SUPPRESSANT DURING EXCAVATION, DEMOLITION AND/OR
  - CONSTRUCTION TO SUPPRESS DUST FORMATION. d. COVERING AND WETTING OF STOCKPILES FARTH, SAND, GRAVEL AND OTHER SIMILAR CONSTRUCTION MATERIALS.
  - e. ALL PERIMETER FENCING MUST HAVE DUST CONTROL FABRIC AND MUST MEASURE A MINIMUM OF 5 FT IN HEIGHT FROM THE BOTTOM OF FENCING.
  - f. 10 MILE PER HOUR SPEED LIMIT FOR ALL EQUIPMENT AND TRUCKS TRAVELING WITHIN THE WORK SITE.
  - a. WETTING AND SWEEPING OF ROADWAYS / ACCESS ROAD IN A WORK SITE TO PREVENT DUST FORMATION.

#### **MAINTENANCE NOTES:**

- ALL MEASURES STATED ON THIS EROSION AND SEDIMENT CONTROL PLAN SHALL BE MAINTAINED IN FULLY FUNCTIONAL CONDITION UNTIL NO LONGER REQUIRED FOR A COMPLETED PHASE OF WORK OR FINAL STABILIZATION OF THE SITE. ALL EROSION AND SEDIMENTATION CONTROL MEASURES SHALL BE CHECKED BY A QUALIFIED PERSON IN ACCORDANCE WITH THE CONTRACT DOCUMENTS OR THE APPLICABLE PERMIT, WHICHEVER IS MORE STRINGENT, AND REPAIRED IN ACCORDANCE WITH THE FOLLOWING:
- 2. INLET PROTECTION DEVICES AND BARRIERS SHALL BE REPAIRED OR REPLACED IF THEY SHOW SIGNS OF UNDERMINING, OR DETERIORATION.
- 3. ALL SEEDED AREAS SHALL BE CHECKED REGULARLY TO SEE THAT A GOOD STAND IS MAINTAINED. AREAS SHOULD BE FERTILIZED, WATERED, AND RESEEDED AS NEEDED.
- 4. COMPOST FILTER SOCKS SHALL BE REPAIRED TO THEIR ORIGINAL CONDITIONS IF DAMAGED. SEDIMENT SHALL BE REMOVED WHEN IT REACHES ONE-HALF THE HEIGHT OF THE EXPOSED COMPOST FILTER
- 5. THE CONSTRUCTION ENTRANCE SHALL BE MAINTAINED IN A CONDITION WHICH WILL PREVENT TRACKING OR FLOW OF MUD ONTO PUBLIC RIGHTS-OF-WAY. THIS MAY REQUIRE PERIODIC TOP DRESSING OF THE CONSTRUCTION ENTRANCE AS CONDITIONS DEMAND.

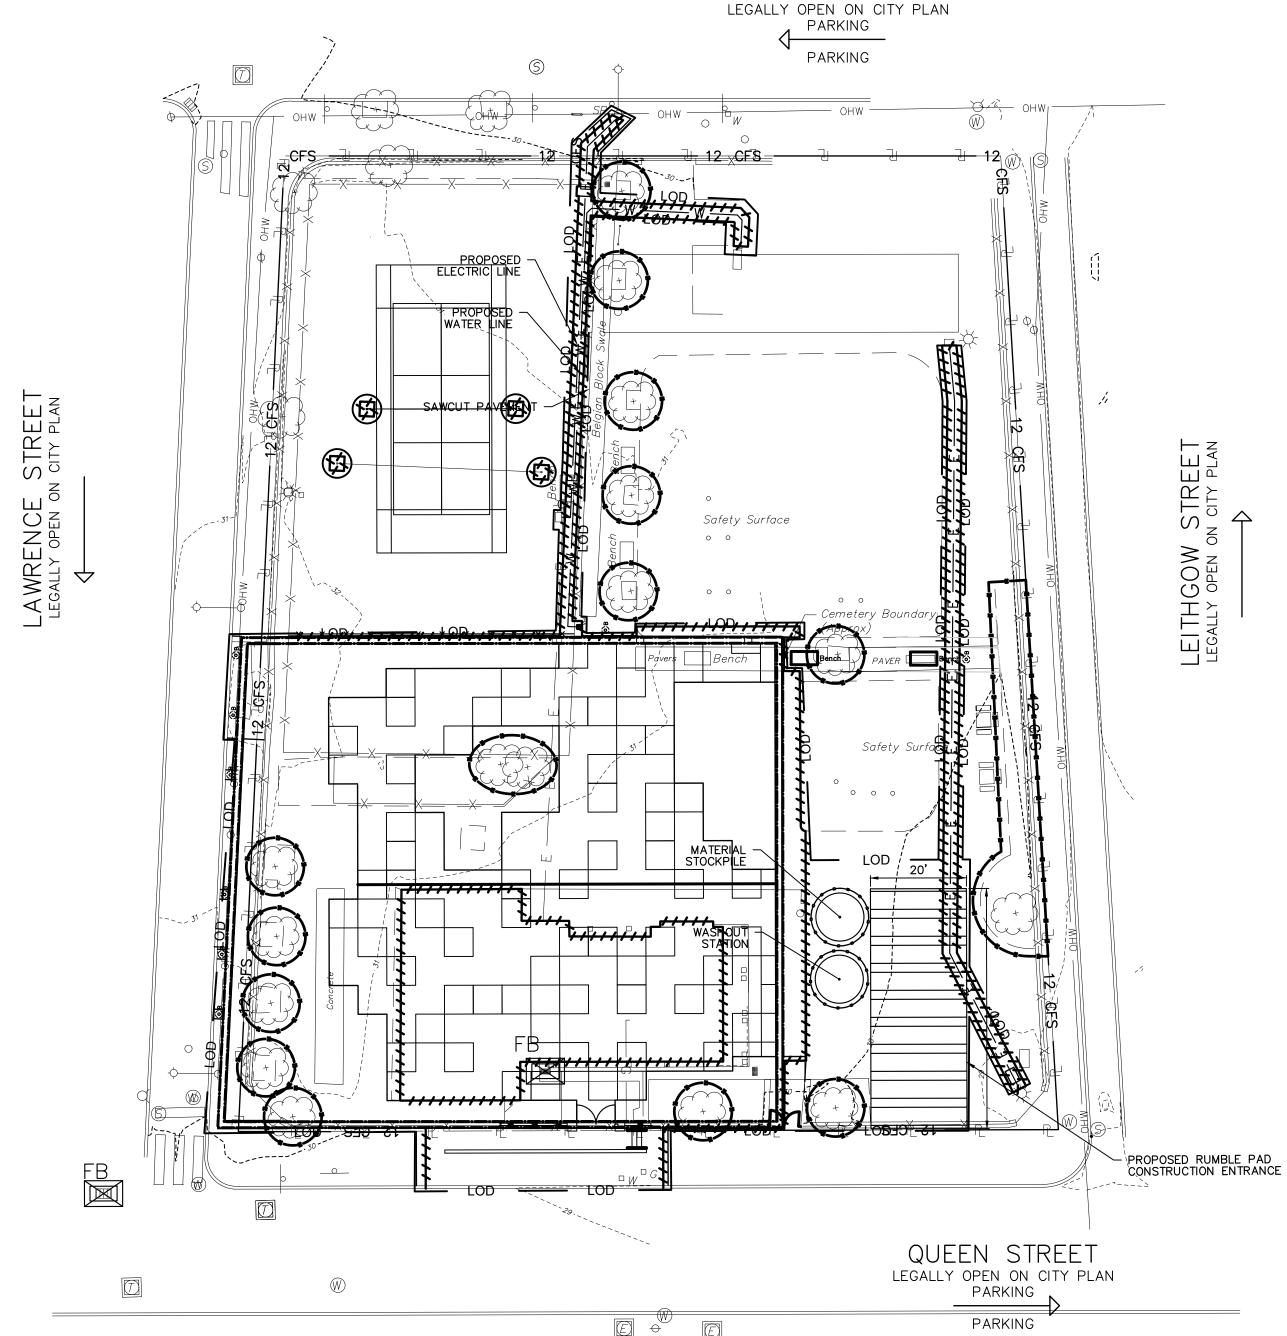


#### **GENERAL NOTES:**

- 1. ALL DIMENSIONS ARE SHOWN IN U.S. SURVEY FEET.
- 2. SURVEY INFORMATION OBTAINED FROM A FIELD SURVEY PERFORMED BY KSE ON 07/10/2023 THRU 07/21/2023. SURVEY BASED ON P.A.S.P.C.S. (SOUTH ZONE) NAD83. BEARINGS SHOWN ARE PER CITY PLAN AND DEED OF RECORD. ELEVATIONS ARE REFERENCED TO NORTH AMERICAN VERTICAL DATUM OF

CATHARINE STREET

- 3. SUBJECT TO ALL RESTRICTIONS, EASEMENTS AND/OR COVENANTS OF RECORD EITHER WRITTEN OR IMPLIED THAT MAY NOT APPEAR OF THIS PLAN.
- 4. IF BUILDINGS ARE ON THIS PLAN, BUILDING OFFSET DISTANCES SHOWN ARE FOR THE PURPOSE OF CHECKING COMPLIANCE WITH ZONING AND DEED RESTRICTIONS ONLY. NO LIABILITY WILL BE ACCEPTED IF THESE DISTANCES ARE USED FOR ANY OTHER PURPOSES.
- 5. UNDERGROUND UTILITIES AS SHOWN TAKEN FROM FIELD EVIDENCE AND PLANS AS PROVIDED BY THE VARIOUS UTILITY AUTHORITIES (PA ONE CALL SERIAL NO. 20231642217, 20231642279, 20231642344, & 20231642431). THE ACCURACY REGARDING UTILITY LOCATION AND/OR DEPTH CANNOT BE GUARANTEED AND ADDITIONAL UNDERGROUND UTILITIES NOT DEPICTED ON THIS PLAN MAY EXIST. BEFORE EXCAVATIONS ARE BEGUN, THE PENNSYLVANIA ONE CALL SYSTEM AT 1-800-242-1776 SHALL BE CONTACTED AT LEAST 3-10 DAYS PRIOR TO COMMENCEMENT OF ANY DEMOLITION OR EXCAVATION ACTIVITIES IN ACCORDANCE WITH ALL APPLICABLE LAWS, RULES AND REGULATIONS.
- 6. INFORMATION PERTAINING TO LOTS OTHER THAN THE SUBJECT PARCEL IS SHOWN FOR INFORMATIONAL PURPOSES ONLY.
- 7. SITE LIES WITHIN THE MAPPED LIMITS OF FLOOD ZONE X. AS SHOWN ON THE FEMA FLOOD INSURANCE RATE MAP COMMUNITY-PANEL NO. 4207570184H, DATED 11/18/2015 FOR THE CITY OF PHILADELPHIA.
- 8. PROJECT SITE IS NOT LOCATED IN A SPECIAL FLOOD HAZARD ZONE AND THERE ARE NO WETLANDS ON SITE. THERE ARE NO WATER COURSES OR BODIES OF WATER LOCATED WITHIN 100 FEET OF THE PROPERTY.

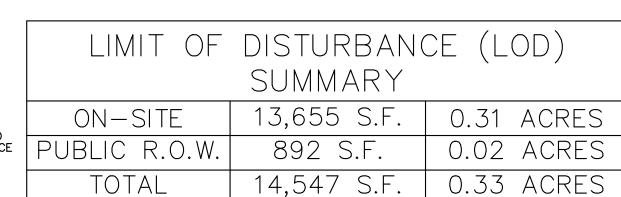

E WHARTON ST

VICINITY MAP

1" = 1000'

DELAWARE DIRECT WATERSHED

FLOOD MANAGEMENT A

COMBINE SEWER SERVICE

PA ONE CALL SERIAL NO. 20231642217, 20131642279, 20231642344, 20231642431

ACT 187 IT IS THE CONTRACTOR'S RESPONSIBILITY TO COMPLY WITH THE PENNSYLVANIA ACT 187 AND TO CONTACT THE "ONE CALL SYSTEM" THREE (3) WORKING DAYS (UNLESS OTHERWISE NOTED) PRIOR TO START OF CONSTRUCTION. PENNSYLVANIA ONE CALL: 1-800-242-1776 PHILADELPHIA WATER DEPARTMENT 1101 MARKET STREET, 2nd FLOOR <u>VERIZON</u> 900 RACE STREET PHILADELPHIA, PENNSYLVANIA PHILADELPHIA, PENNSYLVANIA 19107 (215) 685-6270 (215) 351-8947

PHILADELPHIA GAS WORKS 800 W. MONTGOMERY AVENUE, 3RD FLOOR COMCAST 1351 S. COLUMBUS BOULEVARD PHILADELPHIA, PENNSYLVANIA 19147 PHILADELPHIA, PENNSYLVANIA 19122 (215) 684-6796 (215) 952-4935

PECO-CONSTRUCTION DEPARTMENT 2301 MARKET STREET PHILADELPHIA, PENNSYLVANIA 19103 (215) 731-3264




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#### PWD TRACKING No. FY24-BETH-7618-01

SITE LOCATION: 405-25 QUEEN ST PHILADELPHIA, PA 19147

PROPERTY OWNER: CITY OF PHILADELPHIA 1401 JOHN F. KENNEDY BLVD PHILADELPHIA, PA 19102-1617



## BETHEL BURYING **GROUND**
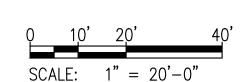
## MEMORIAL PROJECT AT WECCACOE PLAYGROUND

Design Team:

Karyn Olivier karyn@karynolivier.com

**ARCHITECT** SMP Architects 1600 Walnut Street, 2nd Floor Philadelphia, Pennsylvania 19103

LANDSCAPE ARCHITECT

215 985 4410

Ground Reconsidered 915 Spring Garden Street, Suite 403 Philadelphia, Pennsylvania 19123 215 790 0727

**CIVIL ENGINEER** KS Engineers, PC

530 Walnut Street, Suite 460 Philadelphia, Pennsylvania 19106 215 925 0425

<u>ARCHAEOLOGIST</u>

AECOM 1700 Market Street, Suite 1600. Philadelphia, Pennsylvania 19103 215 399 4300

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-	No.	Date	Revisions
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	Seal.		

Job Number: 749


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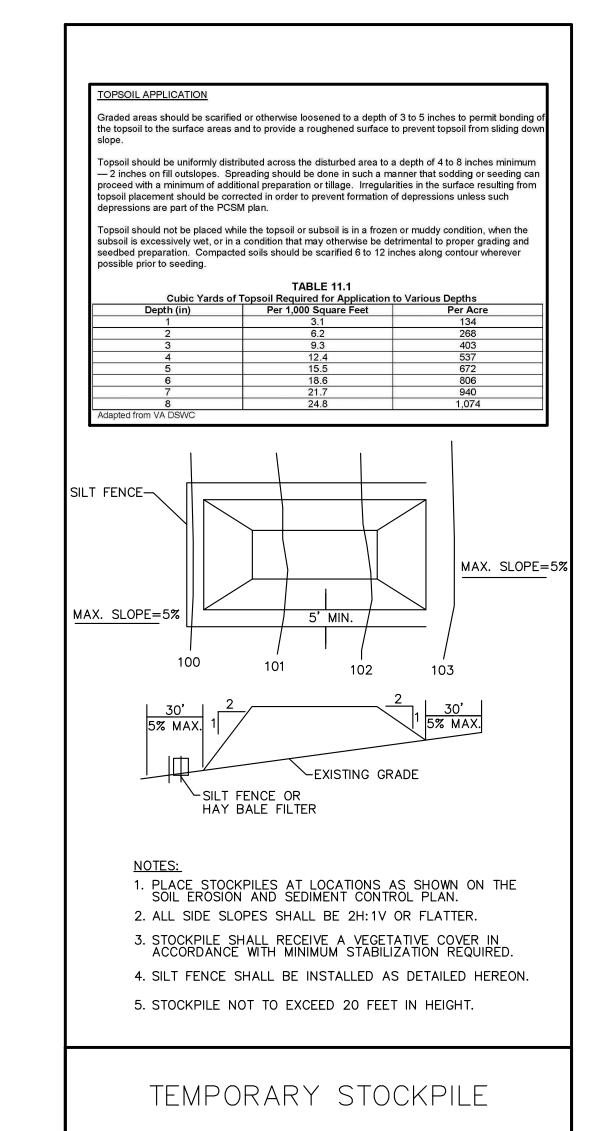
100% CONSTRUCTION DOCUMENTS


Drawing Title: **EROSION AND SEDIMENT** CONTROL PLAN


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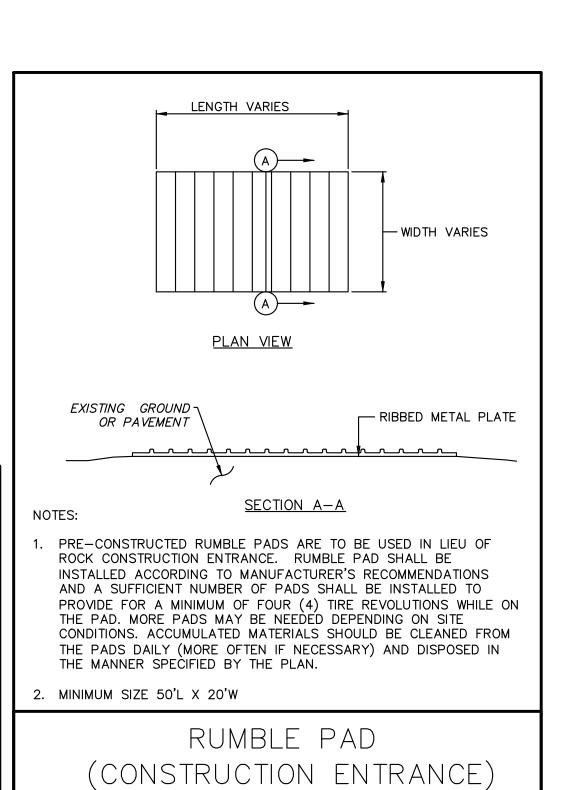
**CE100** 







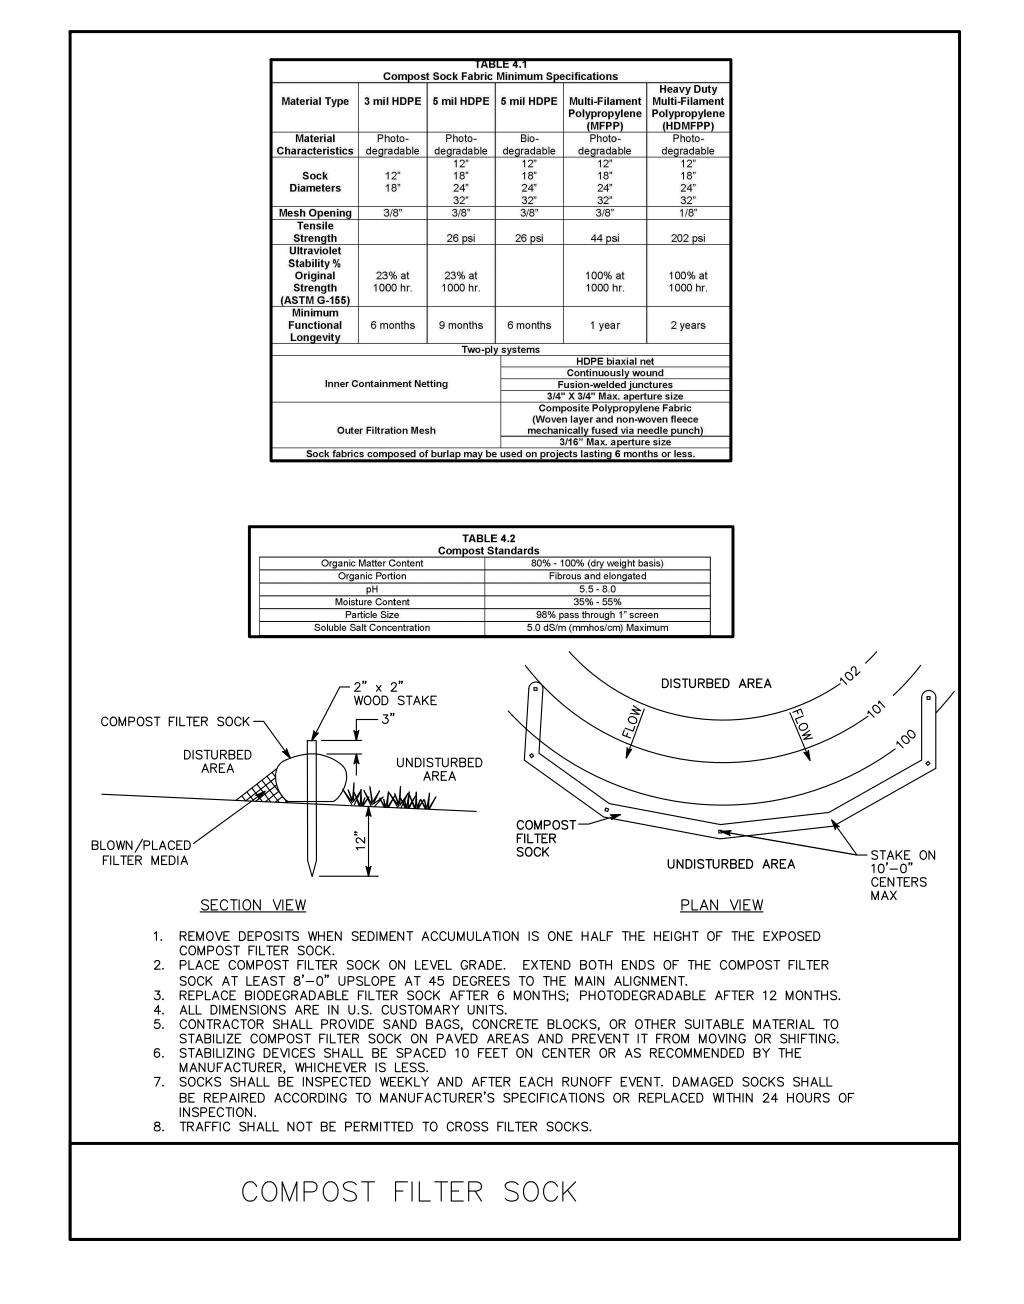

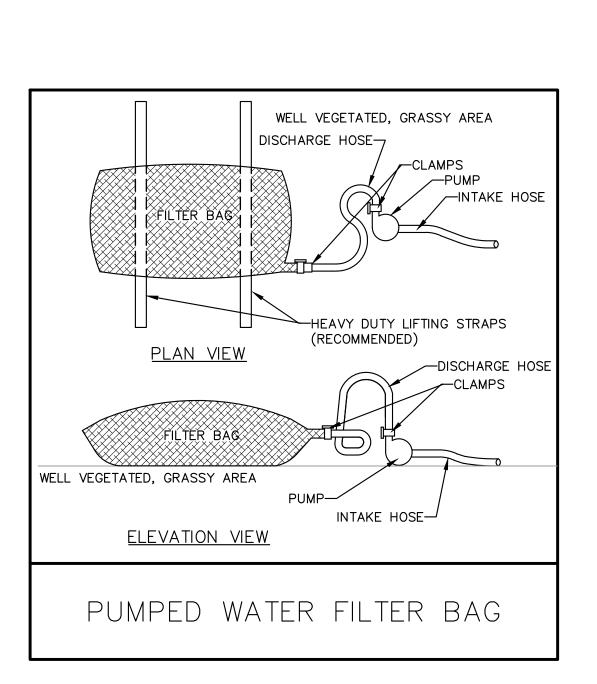

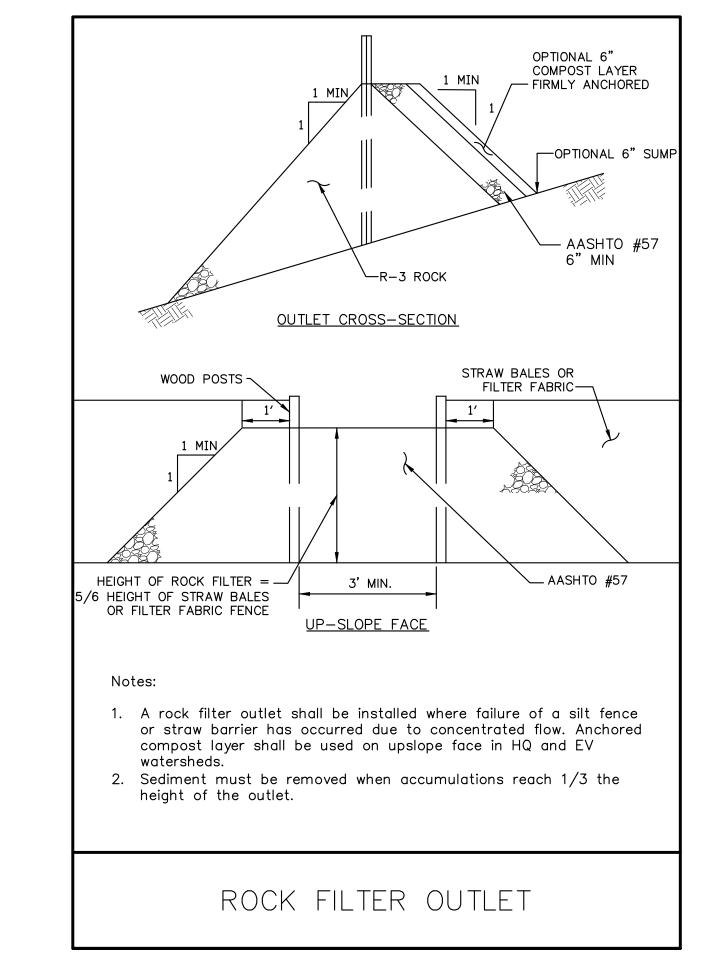

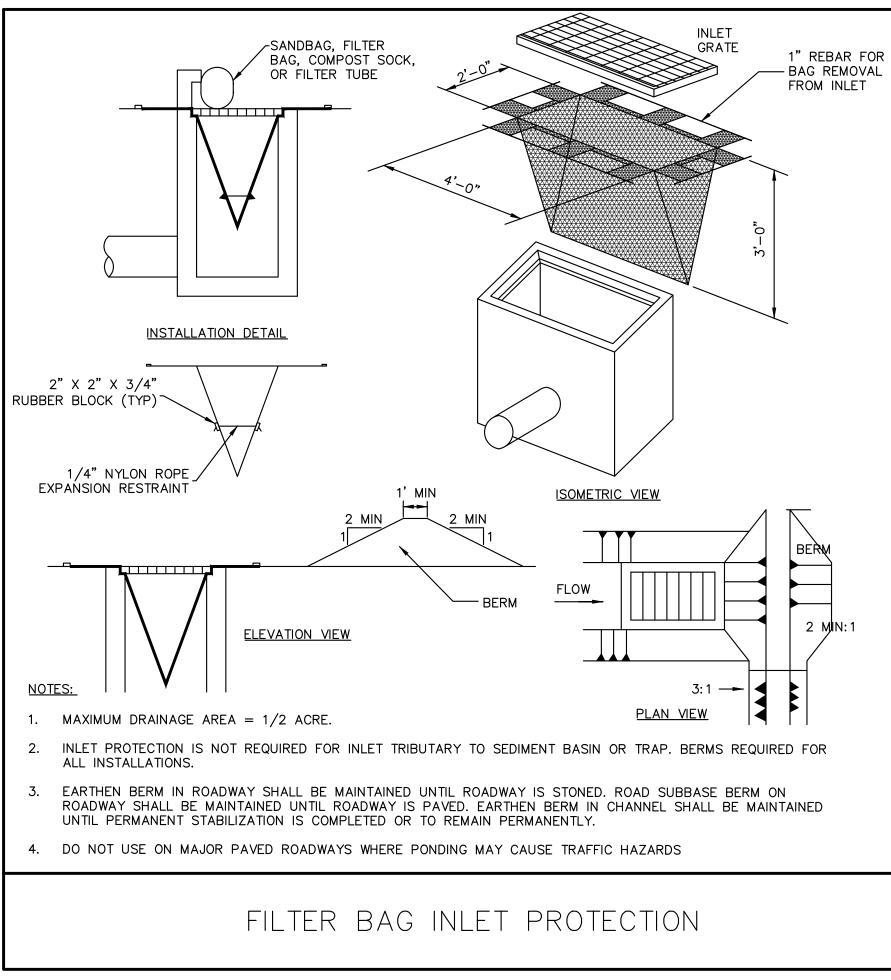

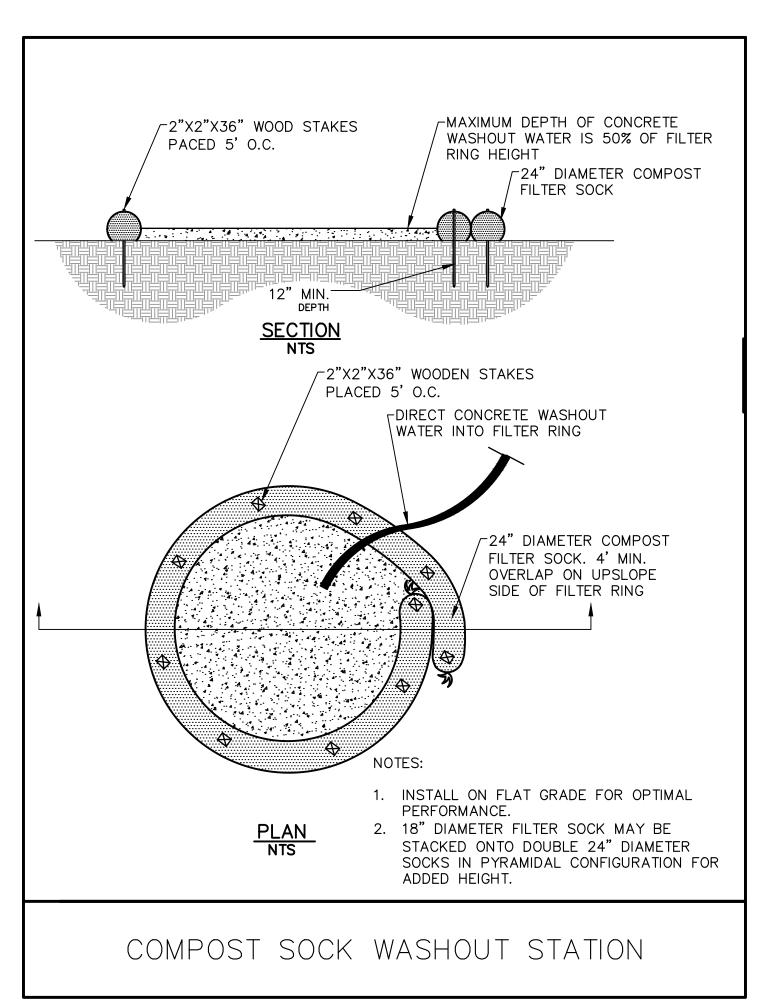

# BETHEL BURYING GROUND MEMORIAL PROJECT AT WECCACOE

PLAYGROUND

Design Team:

<u>ARTIST</u>

Karyn Olivier

ARCHITECT

karyn@karynolivier.com

SMP Architects 1600 Walnut Street, 2nd Floor Philadelphia, Pennsylvania 19103 215 985 4410

LANDSCAPE ARCHITECT

Ground Reconsidered 915 Spring Garden Street, Suite 403 Philadelphia, Pennsylvania 19123 215 790 0727

CIVIL ENGINEER

KS Engineers, PC 530 Walnut Street, Suite 460 Philadelphia, Pennsylvania 19106 215 925 0425

ARCHAEOLOGIST

AECOM 1700 Market Street, Suite 1600, Philadelphia, Pennsylvania 19103 215 399 4300

No. Date Revisions

Seal:

Drawn: Checked: Approved: RSB _____
Job Number: 749

Date:

05/10/2024

100% CONSTRUCTION DOCUMENTS

Drawing Title:

EROSION AND SEDIMENT CONTROL DETAILS

Drawing Number:

CE501

#### STANDARD EROSION AND SEDIMENT CONTROL NOTES:

- 1. AN INDUSTRIAL WASTE PERMIT WILL BE REQUIRED SHOULD PUMPING TO CITY-OWNED INFRASTRUCTURE BECOME NECESSARY DURING CONSTRUCTION. ALL PUMPING OF WATER FROM ANY WORK AREA SHALL BE DONE ACCORDING TO THE PROCEDURE DESCRIBED IN THIS PLAN, OVER UNDISTURBED VEGETATED AREAS.
- 2. INLET PROTECTION SHOULD BE PROVIDED FOR ALL INLETS OWNED BY PWD THAT ARE LOCATED WITHIN ONE BLOCK OF THE PROJECT SITE.
- 3. PWD IS NOT RESPONSIBLE FOR ANY CLEANING OR REPAIRS NEEDED ON CITY-OWNED INFRASTRUCTURE DUE TO FAILURE OF ANY EROSION AND SEDIMENT CONTROL PRACTICES. IT IS THE RESPONSIBILITY OF THE CONTRACTOR TO ENSURE THAT ALL EROSION AND SEDIMENT CONTROL PRACTICES ARE FUNCTIONING IN ACCORDANCE WITH THE APPROVED
- 4. INSPECTION AND MAINTENANCE OF ALL EROSION AND SEDIMENT CONTROL BEST MANAGEMENT PRACTICES SHALL OCCUR ON A WEEKLY BASIS, BEFORE ANY ANTICIPATED PRECIPITATION EVENTS, AND AFTER ALL PRECIPITATION EVENTS.
- 5. THE MAXIMUM HEIGHT FOR STOCKPILES AREAS SHALL BE 20 FEET. THE MAXIMUM SIDE SLOPE FOR STOCKPILE AREAS SHALL NOT EXCEED 2:1.
- 6. THE ROCK CONSTRUCTION ENTRANCE THICKNESS SHALL BE CONSTANTLY MAINTAINED ON-SITE. A STOCKPILE SHALL BE MAINTAINED ON-SITE FOR THIS PURPOSE. AT THE END OF EACH CONSTRUCTION DAY, ALL SEDIMENT DEPOSITED ON PAVED ROADWAYS SHALL BE REMOVED AND RETURNED TO THE CONSTRUCTION SITE. IN NO CASE SHALL THE SEDIMENT BE WASHED, SHOVELED, OR SWEPT INTO ANY ROADSIDE DITCH, STORM SEWER, OR SURFACE WATER.
- 7. FILTER FABRIC FENCE SHOULD BE INSTALLED AT LEVEL GRADE. BOTH ENDS OF EACH FENCE SECTION SHOULD BE EXTENDED AT LEAST 8 FEET UPSLOPE AT 45 DEGREES TO THE MAIN BARRIER ALIGNMENT. SUPPORT STAKES SHALL BE SPACED AT A MAXIMUM OF 8 FEET. SEDIMENT MUST BE REMOVED WHEN ACCUMULATIONS REACH 1/2 THE ABOVE GROUND HEIGHT OF THE FILTER FENCE.
- 8. ANY FENCE SECTION WHICH HAS BEEN UNDERMINED OR TOPPED MUST BE IMMEDIATELY REPLACED WITH A ROCK FILTER OUTLET. SEDIMENT MUST BE REMOVED WHEN ACCUMULATIONS REACH 1/3 THE HEIGHT OF THE OUTLET.
- 9. EROSION CONTROL BLANKETING SHALL BE INSTALLED ON ALL SLOPES 3H:1V OR STEEPER

ON THE PLAN MAPS AND/OR DETAIL SHEETS.

- 10. IMMEDIATELY UPON DISCOVERING UNFORESEEN CIRCUMSTANCES POSING THE POTENTIAL FOR ACCELERATED EROSION AND/OR SEDIMENT POLLUTION, THE OPERATOR SHALL IMPLEMENT APPROPRIATE BEST MANAGEMENT PRACTICES TO MINIMIZE THE POTENTIAL FOR EROSION AND SEDIMENT POLLUTION AND NOTIFY PWD AND PA DEP.
- 11. UNTIL THE SITE IS STABILIZED, ALL E&S BMP'S SHALL BE MAINTAINED PROPERLY. MAINTENANCE SHALL INCLUDE INSPECTIONS OF ALL E&S BMP'S PRIOR TO ANY ANTICIPATED STORM EVENT, AFTER EACH RUNOFF EVENT AND ON A WEEKLY BASIS. ALL PREVENTATIVE AND REMEDIAL MAINTENANCE WORK, INCLUDING CLEAN OUT, REPAIR, REPLACEMENT, REGRADING, RESEEDING, REMULCHING, AND RENETTING, MUST BE PERFORMED IMMEDIATELY. IF THE E&S BMP'S FAIL TO PERFORM AS EXPECTED, REPLACEMENT BMP'S, OR MODIFICATIONS OF THOSE INSTALLED, WILL BE REQUIRED.
- 12. ALL EARTH DISTURBANCES, INCLUDING CLEARING AND GRUBBING, AS WELL AS CUTS AND FILLS, SHALL BE DONE IN ACCORDANCE WITH THE APPROVED F&S PLAN. A COPY OF THE APPROVED DRAWINGS MUST BE AVAILABLE AT THE PROJECT SITE AT ALL TIMES. PWD SHALL BE NOTIFIED OF ANY CHANGES TO THE APPROVED PLAN PRIOR TO MPLEMENTATION OF THOSE CHANGES. PWD MAY REQUIRE A WRITTEN SUBMITTAL OF THOSE CHANGES FOR REVIEW AND APPROVAL AT ITS DISCRETION.
- 13. AT LEAST THREE (3) DAYS PRIOR TO STARTING ANY EARTH DISTURBANCE ACTIVITIES, OR EXPANDING INTO AN AREA PREVIOUSLY UNMARKED, THE PENNSYLVANIA ONE CALL SYSTEM INC. SHALL BE NOTIFIED AT 1-800-242-1776 FOR THE LOCATION OF EXISTING UNDERGROUND UTILITIES.
- 14. ALL EARTH DISTURBANCE ACTIVITIES SHALL PROCEED IN ACCORDANCE WITH THE SEQUENCE PROVIDED ON THE PLAN DRAWINGS. DEVIATION FROM THAT SEQUENCE MUST BE APPROVED IN WRITING BY PWD AND THE PA DEP PRIOR TO IMPLEMENTATION.
- 15. AREAS TO BE FILLED ARE TO BE CLEARED, GRUBBED, AND STRIPPED OF TOPSOIL TO REMOVE TREES, VEGETATION, ROOTS, AND OTHER OBJECTIONABLE MATERIAL.
- 16. CLEARING, GRUBBING, AND TOPSOIL STRIPPING SHALL BE LIMITED TO THOSE AREAS DESCRIBED IN EACH STAGE OF THE CONSTRUCTION SEQUENCE. GENERAL SITE CLEARING UNTIL THE E&S BMP'S SPECIFIED BY THE BMP'S SEQUENCE FOR THAT STAGE HAVE BEEN INSTALLED AND ARE FUNCTIONING AS DESCRIBED IN THIS E&S PLAN.
- 17. AT NO TIME SHALL CONSTRUCTION VEHICLES BE ALLOWED TO ENTER AREAS OUTSIDE THE LIMIT OF DISTURBANCE BOUNDARIES SHOWN ON THE PLAN MAPS. THESE AREAS MUST BE CLEARLY MARKED AND FENCED OFF BEFORE CLEARING AND GRUBBING OPERATIONS
- 18. A LOG SHOWING DATES THAT E&S BMP'S WERE INSPECTED AS WELL AS ANY DEFICIENCIES FOUND AND THE DATE THEY WERE CORRECTED SHALL BE MAINTAINED ON 1. STRAW MULCH MUST BE APPLIED AT 3.0 TONS PER ACRE. THE SITE AND BE MADE AVAILABLE TO PWD AT THE TIME OF INSPECTION.
- 19. ALL SEDIMENT REMOVED FROM BMP'S SHALL BE DISPOSED OF IN THE FOLLOWING MANNER: REMOVAL AND DISPOSAL TO BE AT AN OFF-SITE LOCATION IN ACCORDANCE WITH ALL LOCAL, STATE AND FEDERAL REGULATIONS.
- 20. AREAS WHICH ARE TO BE TOPSOILED SHALL BE SCARIFIED TO A MINIMUM DEPTH OF THREE TO FIVE INCHES -- SIX TO 12 INCHES ON COMPACTED SOILS -- PRIOR TO PLACEMENT OF TOPSOIL. AREAS TO BE VEGETATED SHALL HAVE A MINIMUM FOUR INCHES OF TOPSOIL IN PLACE PRIOR TO SEEDING AND MULCHING. FILL OUTSLOPES SHALL HAVE A MINIMUM OF TWO INCHES OF TOPSOIL.

- 21. ALL FILLS SHALL BE COMPACTED AS REQUIRED TO REDUCE EROSION, SLIPPAGE, SETTLEMENT, SUBSIDENCE, OR OTHER RELATED PROBLEMS. FILL INTENDED TO SUPPORT BUILDINGS, STRUCTURES, AND CONDUITS, ETC. SHALL BE COMPACTED IN ACCORDANCE WITH LOCAL REQUIREMENTS OR CODES.
- 22. ALL EARTHEN FILLS SHALL BE PLACED IN COMPACTED LAYERS NOT TO EXCEED NINE INCHES IN THICKNESS.
- 23. FILL MATERIALS SHALL BE FREE OF FROZEN PARTICLES, BRUSH, ROOTS, SOD, OR OTHER FOREIGN OR OBJECTIONABLE MATERIALS THAT WOULD INTERFERE WITH OR PREVENT CONSTRUCTION OF SATISFACTORY FILLS.
- 24. FROZEN MATERIALS OR SOFT, MUCKY, OR HIGHLY COMPRESSIBLE MATERIALS SHALL NOT BE INCORPORATED INTO FILLS.
- 25. FILL SHALL NOT BE PLACED ON SATURATED OR FROZEN SURFACES.
- 26. SEEPS OR SPRINGS ENCOUNTERED DURING CONSTRUCTION SHALL BE HANDLED IN ACCORDANCE WITH THE STANDARD AND SPECIFICATION FOR SUBSURFACE DRAIN OR OTHER APPROVED METHOD.
- 27. ALL GRADED AREAS SHALL BE PERMANENTLY STABILIZED IMMEDIATELY UPON REACHING FINISHED GRADE. CUT SLOPES IN COMPETENT BEDROCK AND ROCK FILLS NEED NOT BE VEGETATED. SEEDED AREAS WITHIN 50 FEET OF A SURFACE WATER. OR AS OTHERWISE SHOWN ON THE PLAN DRAWINGS, SHALL BE BLANKETED ACCORDING TO THE STANDARDS TEMPORARY MULCHING
- 28. IMMEDIATELY AFTER EARTH DISTURBANCE ACTIVITIES CEASE IN ANY AREA OR SUB-AREA OF THE PROJECT, THE OPERATOR SHALL STABILIZE ALL DISTURBED AREAS. DURING NON-GERMINATING MONTHS, MULCH OR PROTECTIVE BLANKETING SHALL BE APPLIED AS DESCRIBED IN THE PLAN. AREAS NOT AT FINISHED GRADE, WHICH WILL BE REACTIVATED WITHIN ONE YEAR, MAY BE STABILIZED IN ACCORDANCE WITH THE TEMPORARY STABILIZATION SPECIFICATIONS. THOSE AREAS WHICH WILL NOT BE REACTIVATED WITHIN ONE YEAR SHALL BE STABILIZED IN ACCORDANCE WITH THE PERMANENT STABILIZATION SPECIFICATIONS.
- 29. PERMANENT STABILIZATION IS DEFINED AS A MINIMUM UNIFORM, PERENNIAL 70% VEGETATIVE COVER OR OTHER PERMANENT NON-VEGETATIVE COVER WITH A DENSITY SUFFICIENT TO RESIST ACCELERATED EROSION. CUT AND FILL SLOPES SHALL BE CAPABLE OF RESISTING FAILURE DUE TO SLUMPING. SLIDING. OR OTHER MOVEMENTS.
- WITHIN 50 FEET OF A SURFACE WATER AND ON ALL OTHER DISTURBED AREAS SPECIFIED 30. E&S BMP'S SHALL REMAIN FUNCTIONAL AS SUCH UNTIL ALL AREAS TRIBUTARY TO THEM ARE PERMANENTLY STABILIZED OR UNTIL THEY ARE REPLACED BY ANOTHER BMP'S APPROVED BY PWD AND PA DEP.
  - MANAGEMENT PRACTICES. AREAS DISTURBED DURING REMOVAL OR CONVERSION OF THE F&S BMP'S SHALL BE STABILIZED IMMEDIATELY. IN ORDER TO ENSURE RAPID REVEGETATION OF DISTURBED AREAS, SUCH REMOVAL/CONVERSIONS ARE TO BE DONE ONLY DURING THE GERMINATING SEASON.
  - 32. SEDIMENT BASINS AND/OR TRAPS SHALL BE KEPT FREE OF ALL CONSTRUCTION WASTE. WASH WATER, AND OTHER DEBRIS HAVING POTENTIAL TO CLOG THE BASIN/TRAP OUTLET STRUCTURES AND/OR POLLUTE THE SURFACE WATERS. (WHEN APPLICABLE)
  - 33. DURING CONSTRUCTION, THE SELECTED CONTRACTOR IS EXPECTED TO FOLLOW THE PCSMP APPROVED BY PWD (WHERE APPLICABLE). NO CHANGE OR DEVIATION FROM THE APPROVED PCSMP IS PERMITTED WITHOUT PRIOR APPROVAL FROM PWD.
  - 34. ALL WORK ASSOCIATED WITH PWD WATER CONVEYANCE AND SEWER INFRASTRUCTURE SHALL BE DONE IN ACCORDANCE WITH THE CITY OF PHILADELPHIA WATER DEPARTMENT "WATER MAIN STANDARD DETAILS AND CORROSION CONTROL SPECIFICATIONS", 1985 EDITION, AND "STANDARD DETAILS AND STANDARD SPECIFICATIONS FOR SEWERS", 1985 **FDITION**
  - 35. CONTACT PWD WATER TRANSPORT RECORDS (1101 MARKET STREET, 2ND FLOOR, PHONE: 215-685-6271) FOR ADDITIONAL APPROVALS AND PERMITS REQUIRED FOR ALL WATER SERVICES, METERS, AND CONNECTIONS TO THE EXISTING AND/OR PROPOSED PWD FACILITIES.
  - 36. ALL BUILDING MATERIALS AND WASTES SHALL BE REMOVED FROM THE SITE AND RECYCLED OR DISPOSED OF IN ACCORDANCE WITH THE PADEP'S SOLID WASTE MANAGEMENT REGULATIONS AT 25 PA CODE 260.1 ET SEQ., 271.1 AND 287.1 ET SEQ. NO BUILDING MATERIALS OR WASTES OR UNUSED BUILDING MATERIALS SHALL BE BURNED, BURIED, DUMPED, OR DISCHARGED AT THE SITE.
- GRUBBING, AND TOPSOIL STRIPPING MAY NOT COMMENCE IN ANY STAGE OF THE PROJECT 37. A DUST CONTROL PERMIT WILL BE REQUIRED WHEN COMPLETELY DEMOLISHING A BUILDING 7 OR STRUCTURE THAT IS MORE THAN THREE (3) STORIES, GREATER THAN FORTY (40) FEET TALL, OR ENCOMPASSES MORE THAN TEN THOUSAND (10,000) SQUARE FEET: COMPLETELY OR PARTIALLY DEMOLISHING ANY BUILDING OR STRUCTURE BY IMPLOSION; OR ENGAGING IN EARTHWORKS, DEFINED AS "CLEAING, GRUBBING, OR EARTH DISTURBANCE OF ANY LAND EXCESS OF 5,000 SQUARE FEET."
  - SITE STABILIZATION METHODS (TEMPORARY & PERMANENT STABILIZATION)

  - MULCH WITH MULCH CONTROL NETTING OR EROSION CONTROL BLANKETS MUST BE INSTALLED ON ALL SLOPES GREATER THAN 3:1.
  - 3. STRAW MULCH SHALL BE APPLIED IN LONG STRANDS, NOT CHOPPED OR FINELY MAINTENANCE PROGRAM

#### TEMPORARY SEEDING

MULCHED:

1. THE FOLLOWING SURFACES OF THE SITE SHALL BE TEMPORARILY SEEDED AND

- A. THE SURFACE OF TOPSOIL STOCKPILES. B. THE SURFACE OF EXPOSED EARTH AREAS THAT WILL BE EXPOSED WITHOUT CONSTRUCTION ACTIVITY THEREON.
- SEEDING SHALL OCCUR IMMEDIATELY AFTER ESTABLISHMENT OF THE TOPSOIL STOCKPILES OR ROUGH GRADED AREAS. THE FOLLOWING SHALL BE PLANTED: A. 40 LBS. / ACRE ANNUAL RYE GRASS - COMMON, 100% P.L.S.
- PREPARE AREAS TO BE SEEDED AS FOLLOWS: A. REMOVE ALL DEBRIS, INCLUDING LARGE STONES. APPLY LIME AT A RATE OF 3 TONS PER ACRE AND FERTILIZER AT THE RATE OF 50-50-50 PER ACRE AND
- WORK INTO SOIL. B. SOW SEED AT THE INDICATED RATE. DIVIDE SEED INTO TWO EQUAL LOTS. SOW ONE LOT IN ONE DIRECTION. SOW SECOND LOT AT RIGHT ANGLE TO FIRST. RAKE SEEDED AREA SLIGHTLY. ROLL SURFACE LIGHTLY TO FIRM SOIL
- 4. PLACE CLEAN DRY STRAW OR HAY MULCH WITHIN 48 HOURS AFTER SEEDING. PLACE AT THE RATE OF 3 TONS PER ACRE.
- SEEDING DATES SHALL BE BETWEEN MARCH 1 AND NOVEMBER 15.

- MULCH PROPOSED LANDSCAPE AREAS OR TOPSOIL STOCKPILES IF EARTHWORK IS COMPLETED OUTSIDE OF THE RECOMMENDED PLANTING SEASONS FOR TEMPORARY SEEDING OR DUE TO UNFAVORABLE WEATHER CONDITIONS.
- MULCH SHALL BE APPLIED IMMEDIATELY FOLLOWING THE ESTABLISHMENT OF THE TOPSOIL STOCKPILE OR ROUGH GRADING.
- MULCH WITH SUITABLE FIBROUS GROUND, SHREDDED AGED HARDWOOD, PINE WOOD BARK OR STRAW, UNIFORMLY AND CONTINUOUSLY TO A LOOSE DEPTH OF 3 INCHES MINIMUM. ANCHOR AS REQUIRED.
- PROPERLY MAINTAIN MULCHED AREAS UNTIL PERMANENT STABILIZATION MEASURES ARE COMPLETE. REAPPLY MULCH MATERIALS WHICH BECOME DISLODGED AS INITIAL OR MODIFIED RATES AS NECESSARY. IF A SLOPE FAILURE OCCURS WHICH REQUIRES REDRESSING, EXCAVATION, OR THE ESTABLISHMENT OF A NEW SLOPE, REPLACE MULCH AS NECESSARY.

#### PERMANENT SEEDING

- PERMANENT SEEDING SHALL OCCUR IMMEDIATELY AFTER THE FINAL GRADING IS COMPLETED. THE FOLLOWING SEED SHALL BE PLACED UNLESS OTHERWISE SPECIFIED ON THE PLANS OR DIRECTED IN THE FIELD. THE FOLLOWING SEED MIX SHALL BE USED:
- B. 3% RED TOP C. 20% CHAMPION PERENNIAL RYE GRASS QUANTITIES ARE OF PURE LIVE SEED (P.L.S.) SPREAD AT A RATE OF 63 LBS. PER ACRE.
- REMOVE ALL DEBRIS, INCLUDING LARGE STONES. TILL SOIL TO A DEPTH OF FOUR INCHES TO SIX INCHES. APPLY LIME AT A RATE OF 4 TONS PER ACRE. APPLY COMMERCIAL 10-20-20 FERTILIZER AT A RATE OF 930 LBS. PER ACRE. WORK
- SEED ONLY AT THE FOLLOWING TIMES:

FERTILIZER INTO TOP INCH OF SOIL.

A. 40% PENNLAWN FINE FESCUE

- A. SPRING: MARCH 1 TO APRIL 30 B. LATE SUMMER/EARLY FALL: AUGUST 15 TO NOVEMBER 15
- DIVIDE SEED INTO TWO EQUAL LOTS. SOW ONE LOT IN ONE DIRECTION. SOW SECOND LOT AT RIGHT ANGLE TO FIRST LOT. RAKE SEEDED AREA SLIGHTLY. ROLL SURFACE LIGHTLY
- MULCH SEEDED AREAS WITH STRAW OR HAY AT THE RATE OF 3 TONS PER ACRE. ANCHOR MULCH. COMPLY WITH THE REQUIREMENTS OF SECTION 805 - MULCHING, PENNDOT PUBLICATION 408. ANCHOR MULCH AS SPECIFIED.
- MULCHING SHALL BE DONE AT THE MINIMUM RATE OF 3 TONS PER ACRE WITH SALT HAY, HAY OR STRAW MULCHES. PLACE MULCH IMMEDIATELY AFTER SEEDING OR WITHIN 48 8. ROUGH GRADE SUBBASE TO REQUIRED DEPTHS. HOURS AFTER SEEDING IS COMPLETED. PROPERLY MAINTAIN MULCHED AREAS UNTIL THE ENTIRE PROJECT HAS BEEN COMPLETED. PROMPTLY REAPPLY MULCH MATERIALS WHICH BECOME DISLODGED OR LOST DUE TO WIND, RAIN, OR OTHER CAUSES AT INITIAL RATES
- LIQUID MULCH BINDERS MAY BE USED TO ANCHOR SALT HAY, HAY OR STRAW MULCHES. A. APPLICATIONS SHOULD BE HEAVIER AT EDGES WHERE WIND CATCHES THE MULCH IN VALLEYS AND AT CRESTS OF BANKS. REMAINDER OF AREAS SHOULD BE UNIFORM IN
- B. USE ONE OF THE FOLLOWING: EMULSIFIED ASPHALT. CLASS E-1 OR E-6. APPLY 31 GALLONS PER 1,000 SOLIARE YARDS ON SLOPES LESS THAN 8 FEET HIGH ON SLOPES 8 FEET HIGH OR MORE, USE 58 GALLONS PER 1,000 SQUARE YARDS. CUTBACK ASPHALT. CLASS RC-250. APPLY 31 GALLONS PER 1.000 SQUARE YARDS ON FLAT AREAS AND ON SLOPES LESS THAN 8 FEET HIGH. ON SLOPES 8 FEET HIGH. OR MORE, USE 58 GALLONS PER 1,000 SQUARE YARDS. NON-ASPHALTIC EMULSION -NATURAL VEGETABLE GUM BLENDED WITH GELLING AND HARDENING AGENTS (TERRA TACK, AR) AS MANUFACTURED BY GRASS GROWERS COMPANY OR EQUAL. APPLY 25

  13. AS SOON AS SLOPES, CHANNELS, DITCHES, AND OTHER DISTURBED AREAS REACH FINAL LBS. PER 1,000 SQUARE YARDS.

THE CONTRACTOR WILL BE RESPONSIBLE FOR THE PROPER CONSTRUCTION STABILIZATION. AND MAINTENANCE OF ALL TEMPORARY EROSION AND SEDIMENTATION CONTROL MEASURES AND RELATED ITEMS INCLUDED WITHIN THIS PLAN. THE CONTRACTOR WILL ALSO BE RESPONSIBLE FOR THE PROPER CONSTRUCTION AND STABILIZATION OF PERMANENT CONTROL MEASURES AND RELATED ITEMS INCLUDED WITHIN THIS PLAN.

- 2. THE OWNER WILL BE RESPONSIBLE FOR THE MAINTENANCE OF ALL PERMANENT CONTROL
- 3. UNTIL THE SITE IS STABILIZED, ALL EROSION AND SEDIMENT BMP'S MUST BE MAINTAINED PROPERLY. MAINTENANCE MUST INCLUDE INSPECTIONS OF ALL EROSION AND SEDIMENT CONTROL BMP'S AFTER EACH RUNOFF EVENT AND ON A WEEKLY BASIS. ALL PREVENTATIVE AND REMEDIAL MAINTENANCE WORK, INCLUDING CLEAN OUT, REPAIR REPLACEMENT, REGRADING, RESEEDING, REMULCHING, AND RENETTING, MUST BE DONE IMMEDIATELY. IF EROSION AND SEDIMENT CONTROL BMP'S FAIL TO PERFORM AS EXPECTED, REPLACEMENT BMP'S, OR MODIFICATIONS TO THOSE INSTALLED WILL BE
- 4. SEDIMENT REMOVED FROM BMP'S SHALL BE DISPOSED OF AT AN OFF-SITE LOCATION IN ACCORDANCE WITH ALL LOCAL, STATE AND FEDERAL REGULATIONS.
- 5. SOIL SEDIMENT REMOVED FROM SILT FENCE DURING REGULAR MAINTENANCE WILL BE INCORPORATED BACK INTO THE EARTHWORK AS FILL ON THE SITE. SOIL SEDIMENT MATERIAL SHALL BE DISTRIBUTED ON-SITE WITHOUT CHANGING DRAINAGE PATTERNS DURING A SPECIFIC CONSTRUCTION STAGE. SILT FENCE INSTALLED ON THE PROJECT SITE SHALL BE MAINTAINED AS FOLLOWS:
  - A. THE FENCE CONDITION WILL BE INSPECTED ONCE A WEEK OR AFTER EVERY STORM EVENT, WHICHEVER COMES FIRST. ANY NECESSARY REPAIRS WILL BE MADE IMMEDIATELY.
  - B. ACCUMULATED SEDIMENTS WILL BE REMOVED AS REQUIRED TO KEEP THE FENCE FUNCTIONAL. DEPOSITS WILL BE REMOVED WHERE ACCUMULATIONS REACH ONE-HALF THE ABOVE-GROUND HEIGHT OF THE FENCE

C. UNDERCUTTING OR EROSION OF THE TOE ANCHOR WILL BE REPLACED IMMEDIATELY

- WITH ROCK FILTER OUTLETS. D. ANY MANUFACTURER'S RECOMMENDATIONS WILL BE ADHERED TO WHEN REPLACING FILTER FABRIC FENCE DUE TO WEATHERING.
- 6. AT THE END OF EACH CONSTRUCTION DAY, ANY SEDIMENT DEPOSITED ON PUBLIC ROADWAYS, WILL BE REMOVED AND RETURNED TO THE CONSTRUCTION SITE. WASHING OF THE ROADWAY WITH WATER WILL NOT BE PERMITTED.
- A. SEDIMENT MUST BE REMOVED FROM STORM WATER INLET PROTECTION AFTER EACH

#### **CONSTRUCTION SEQUENCE:**

RUNOFF EVENT.

- 1. AT LEAST 7 DAYS PRIOR TO STARTING ANY EARTH DISTURBANCE THE INSPECTIONS COORDINATOR OF PWD (OFFICE 215-685-6387), MUST BE CALLED TO SCHEDULE A PRECONSTRUCTION MEETING.
- 2. AT LEAST 3 DAYS BEFORE STARTING ANY EARTH DISTURBANCE ACTIVITIES, ALL CONTRACTORS INVOLVED IN THOSE ACTIVITIES SHALL NOTIFY THE PENNSYLVANIA ONE CALL SYSTEM INCORPORATED AT 1-800-242-1776 FOR BURIED UTILITY LOCATIONS.
- 3. CONSTRUCTION FENCE TO BE INSTALLED AROUND THE PERIMETER OF THE WORK AREA. THE CONTRACTOR SHALL COORDINATE THE LOCATION OF THE FENCE WITH THE OWNER AND/OR ENGINEER. CONSTRUCTION FENCE LOCATION SHALL BE INSTALLED TO PROTECT
- THE PUBLIC FROM LAND DISTURBANCE ACTIVITIES AND TO MAINTAIN PEDESTRIAN ACCESS. INSTALL COMPOST FILTER SOCK DOWNHILL FROM ALL EARTH MOVING ACTIVITIES AND AS SHOWN ON THE PLAN. ALTHOUGH OFF SITE AREAS ARE PAVED, COMPOST FILTER SOCK OR OTHER EROSION CONTROL PRACTICES SHALL BE INSTALLED AROUND THE PERIMETER
- 5. INSTALL INLET PROTECTION AS SHOWN ON THE PLAN AND ANY INLETS WITHIN ONE BLOCK OF PROJECT SITE. EXISTING INLETS SHALL BE PROTECTED THROUGHOUT THE DURATION OF THE CONSTRUCTION.
- 6. INSTALL CONSTRUCTION ENTRANCE AS SHOWN AND IN ACCORDANCE WITH THE CONSTRUCTION ENTRANCE DETAIL.
- 7. CLEAR AND GRUB SITE, DEMOLISH EXISTING PAVING, CURBING, AND FENCING AS REQUIRED. SAWCUT PAVED AREAS AS NEEDED TO MINIMIZE EARTH DISTURBANCE. EXCAVATE TRENCHES FOR PROPOSED SEWER CONNECTIONS. DEMOLISHED MATERIAL SHALL BE REMOVED FROM THE SITE AND DISCARDED IN ACCORDANCE WITH APPLICABLE CITY, STATE, AND FEDERAL REGULATIONS.

OF THE WORK AREA AS SHOWN ON THE PLAN.

- INSTALL PROPOSED SITE IMPROVEMENTS, INCLUDING PLAY SURFACE, PLAY EQUIPMENT, MINI PITCH, RAMPS, AND BENCHES.
- 10. TOPSOIL AND SEED GRASSED AREAS. INSTALL PLANTS AND TREES.
- 11. SWEEP PAVED AREAS DAILY TO PREVENT TRACKING OF SOIL OFF-SITE.
- 12. UPON COMPLETION OF ALL EARTH DISTURBANCE ACTIVITIES AND PERMANENT STABILIZATION OF ALL DISTURBED AREAS. THE OWNER AND/OR OPERATOR SHALL CONTACT INSPECTIONS COORDINATOR OF PWD (OFFICE: 215-685-6387) FOR A FINAL INSPECTION PRIOR TO REMOVAL OF THE E&SC BMPS. AS SOON AS SLOPES, CHANNEL DITCHES AND OTHER DISTURBED AREAS REACH FINAL GRADE, THEY MUST BE STABILIZED. CESSATION OF ACTIVITY FOR FOUR (4) DAYS OR LONGER REQUIRES TEMPORARY STABILIZATION.
- GRADE, THEY MUST BE STABILIZED. CESSATION OF ACTIVITY FOR FOUR (4) DAYS OR LONGER REQUIRES TEMPORARY STABILIZATION.
- 14. REMOVE SOIL EROSION MEASURES AFTER SITE HAS BEEN INSPECTED AND STABILIZED.

## BETHEL BURYING **GROUND**

### **MEMORIAL PROJECT** AT WECCACOE **PLAYGROUND**

Design Team:

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#### **CIVIL ENGINEER**

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#### **ARCHAEOLOGIST**

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No.	Date	Revisions
Seal·		

wn: _SA	Checked: NLC	Approved: RSB	
Number: 749			
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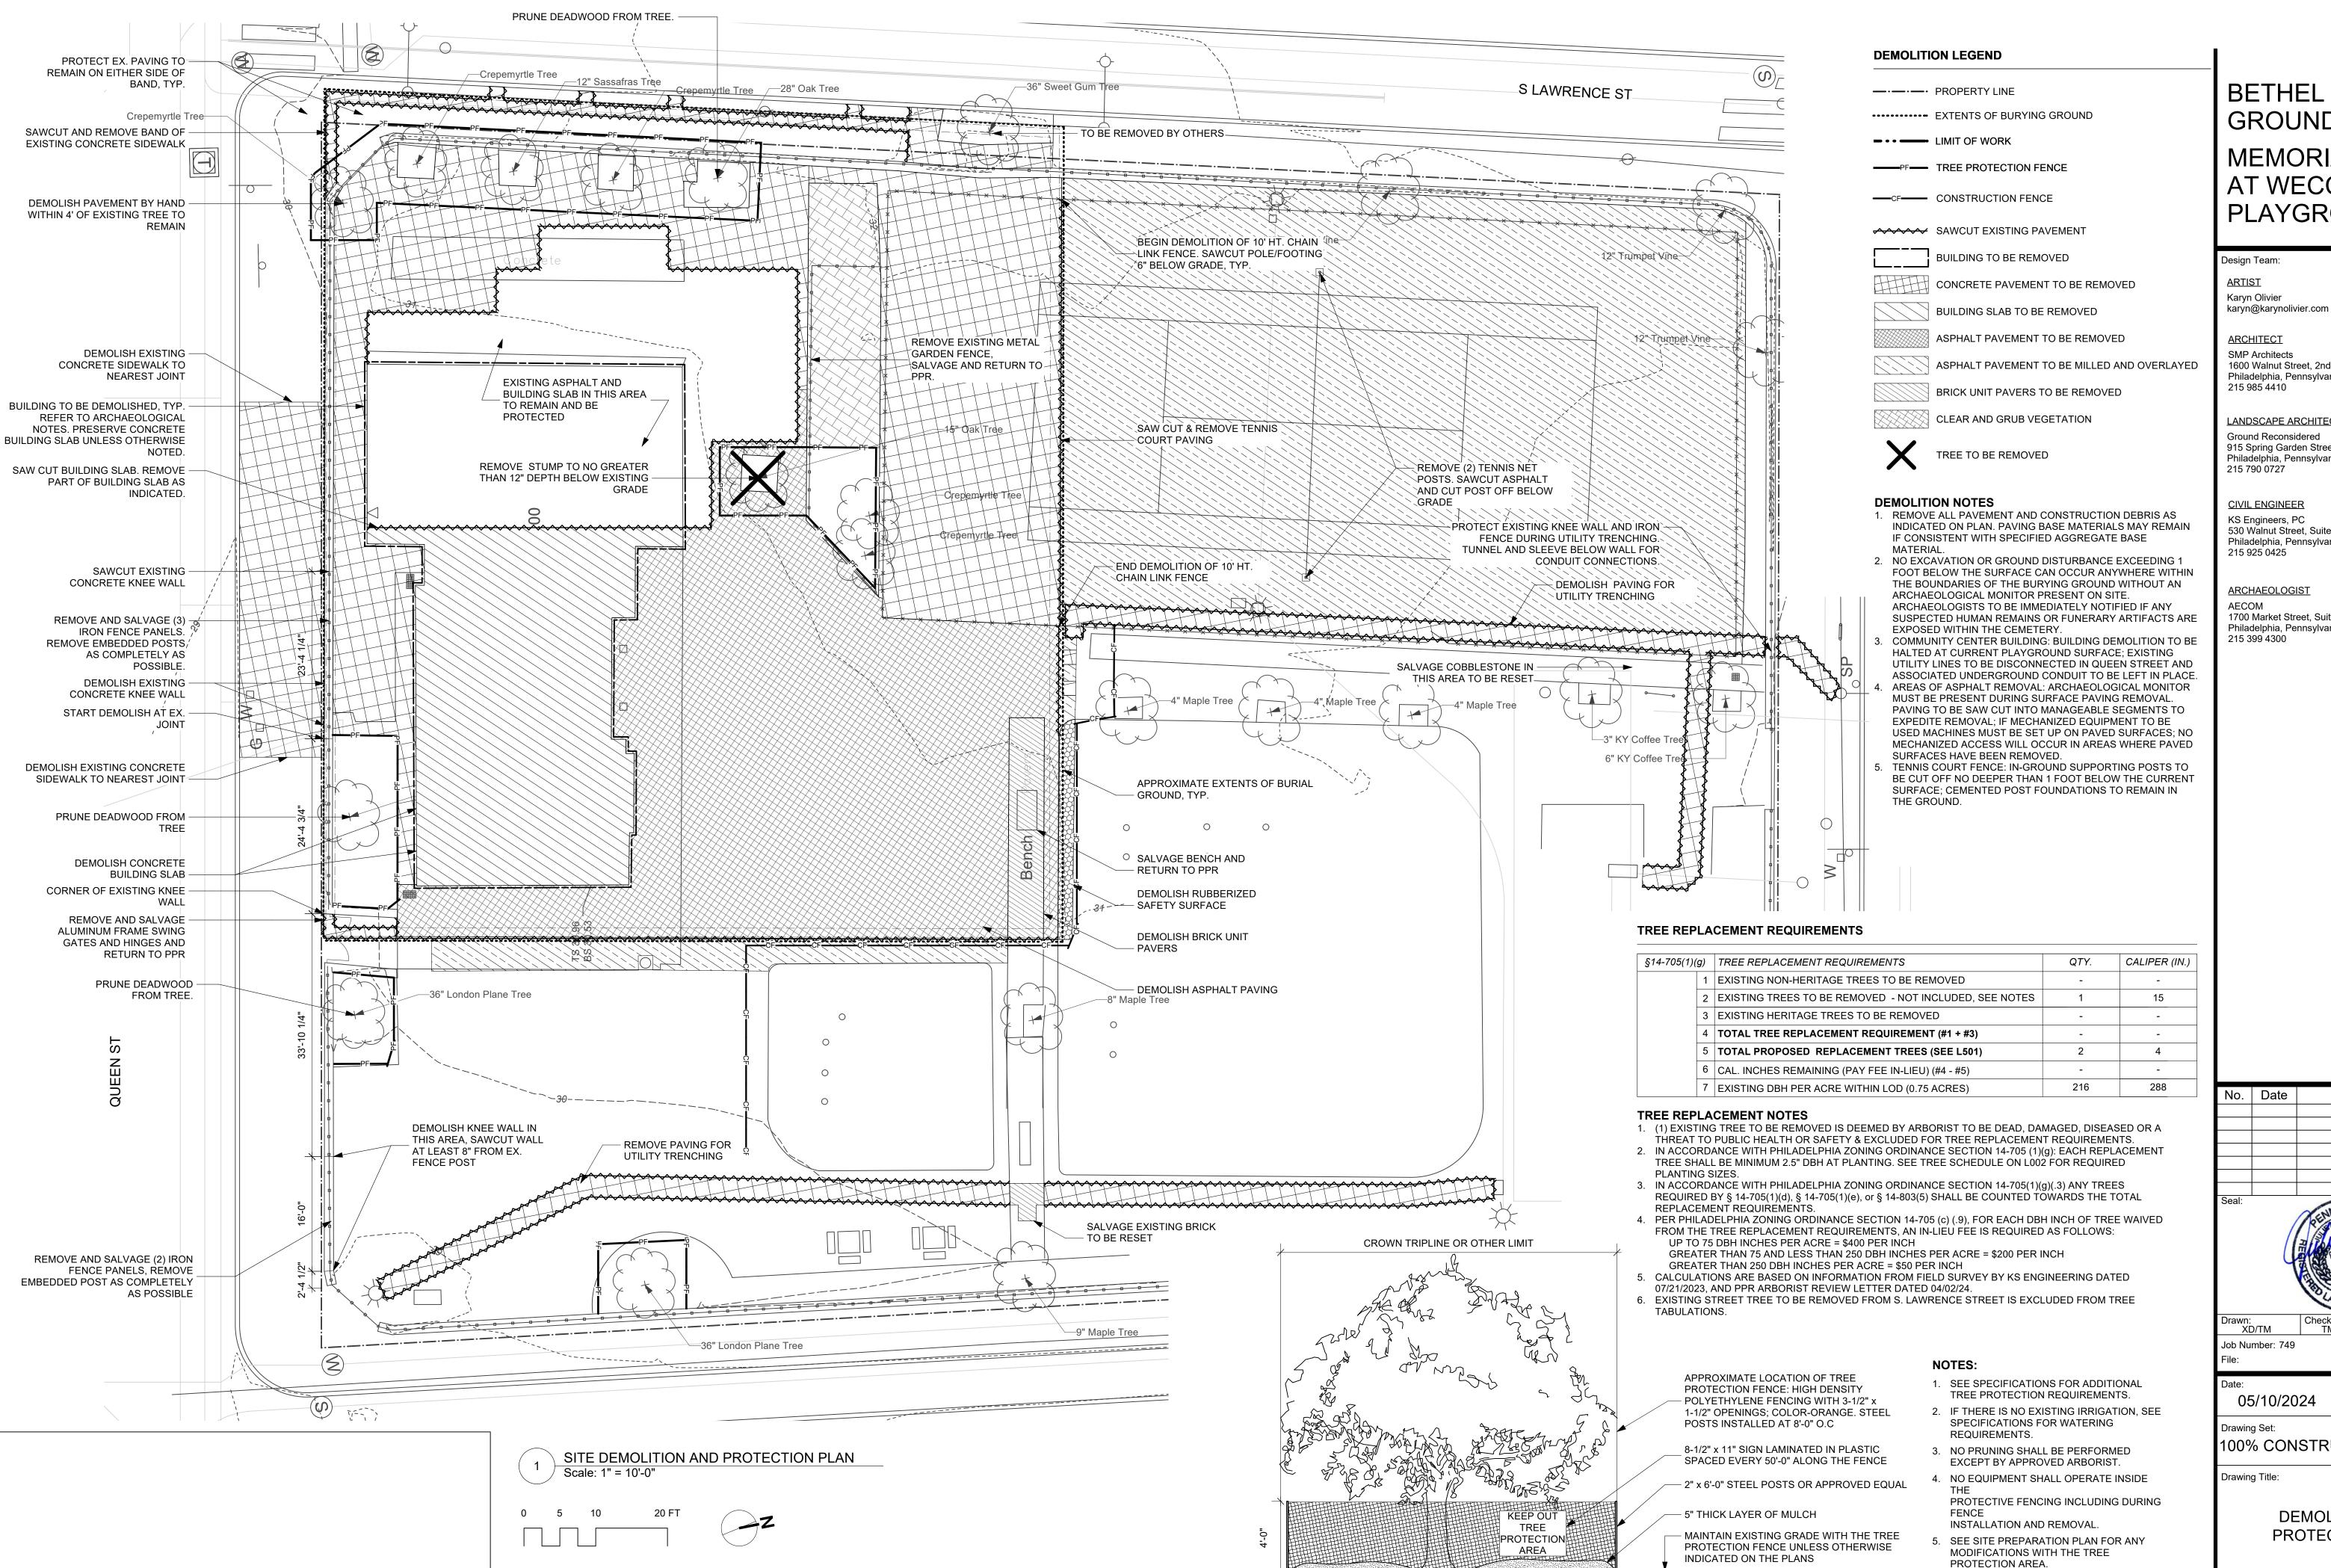
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Drawing Title:

**IEROSION AND SEDIMENT CONTROL NOTES** 

Drawing Number:



TREE PROTECTION FENCE DETAIL

Scale: 1/4" = 1'-0"

### BETHEL BURYING GROUND

### MEMORIAL PROJECT AT WECCACOE **PLAYGROUND**

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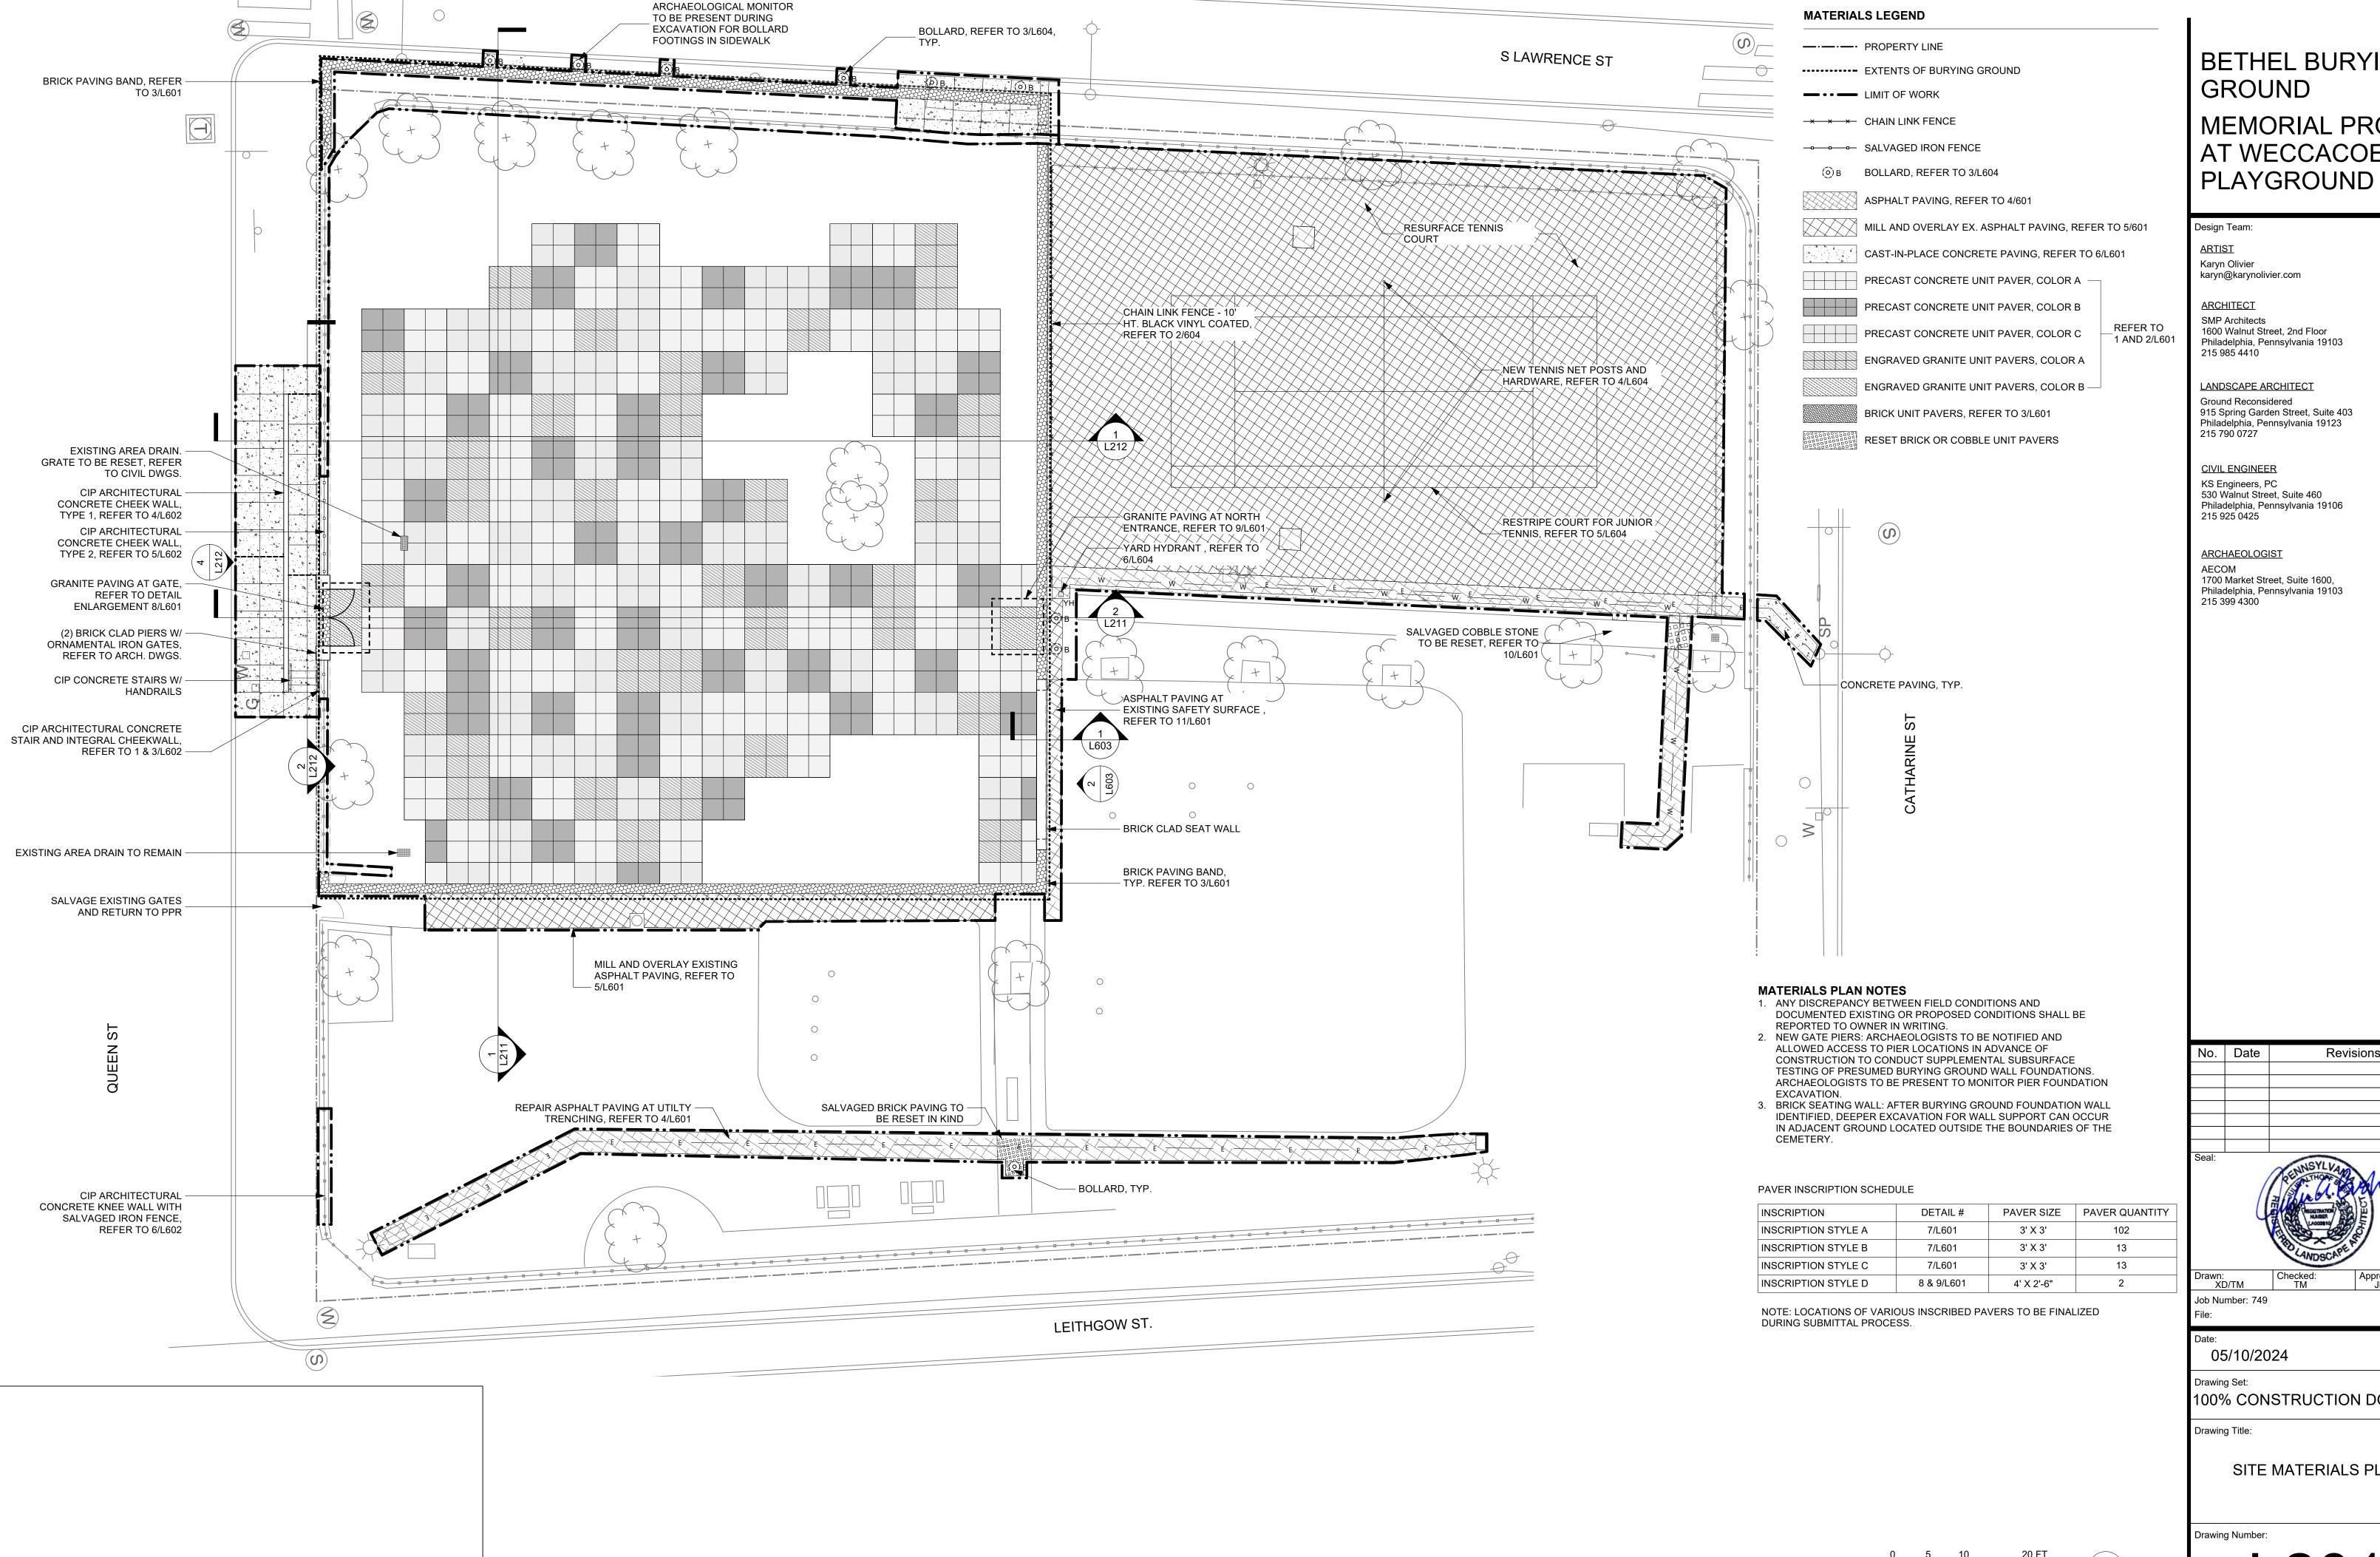
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Job Number: 749

05/10/2024

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**DEMOLITION AND** PROTECTION PLAN




BETHEL BURYING

## MEMORIAL PROJECT AT WECCACOE


Revisions

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SITE MATERIALS PLAN

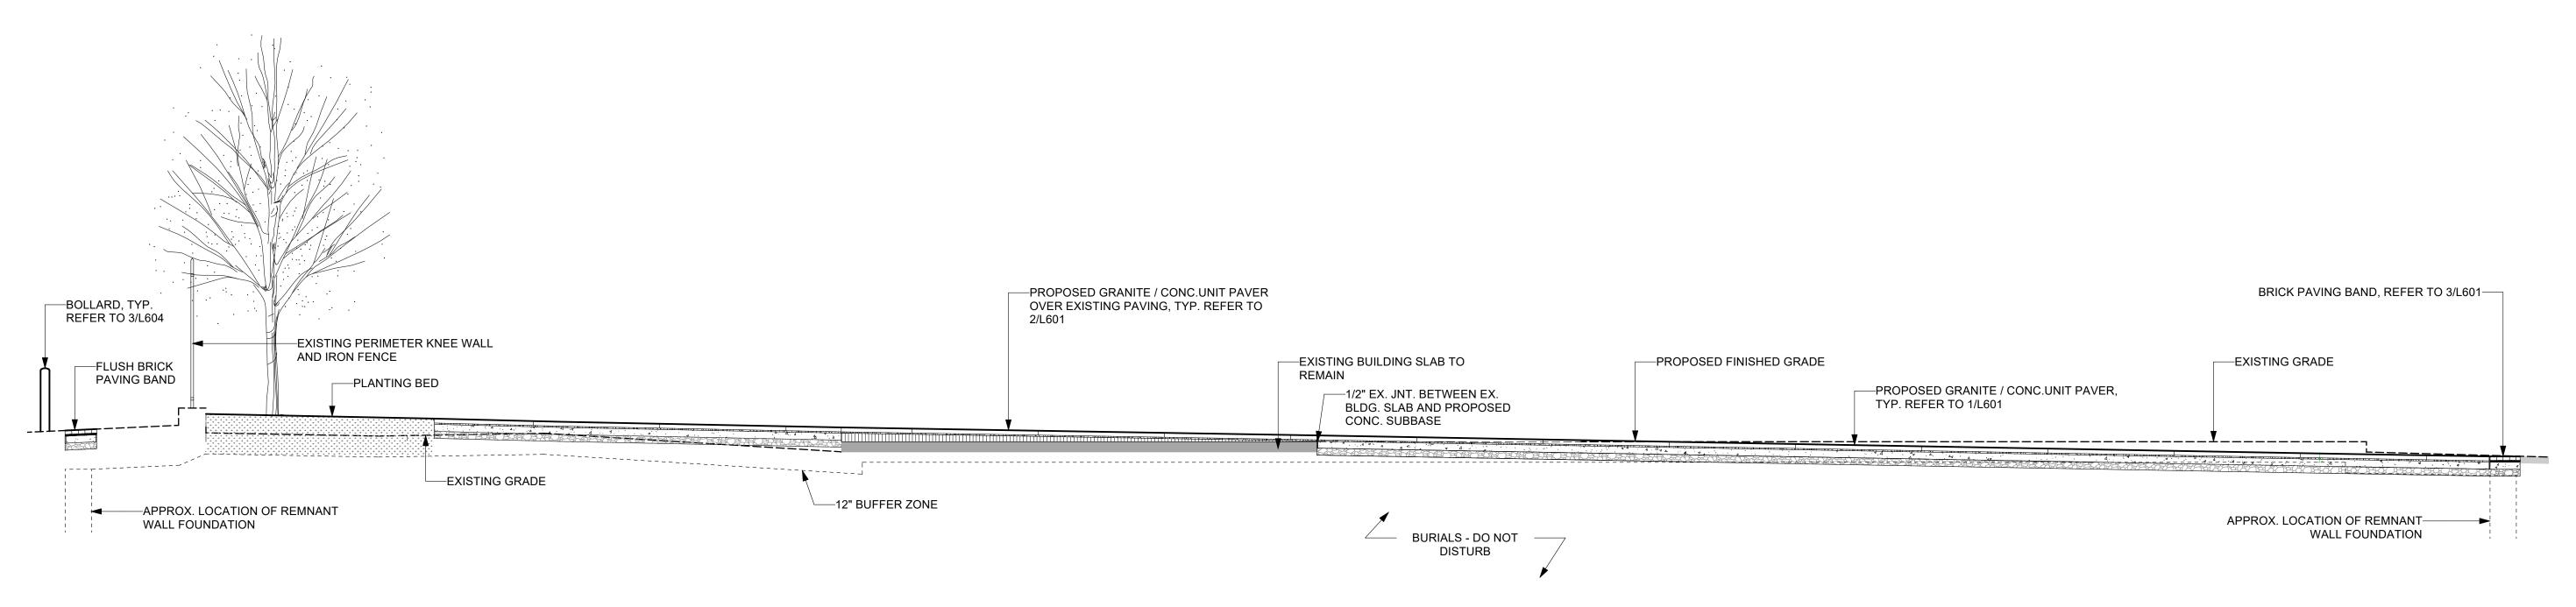

1 Grading Study 6 - E/W Site Section
L211 Scale: 1/4" = 1'-0"

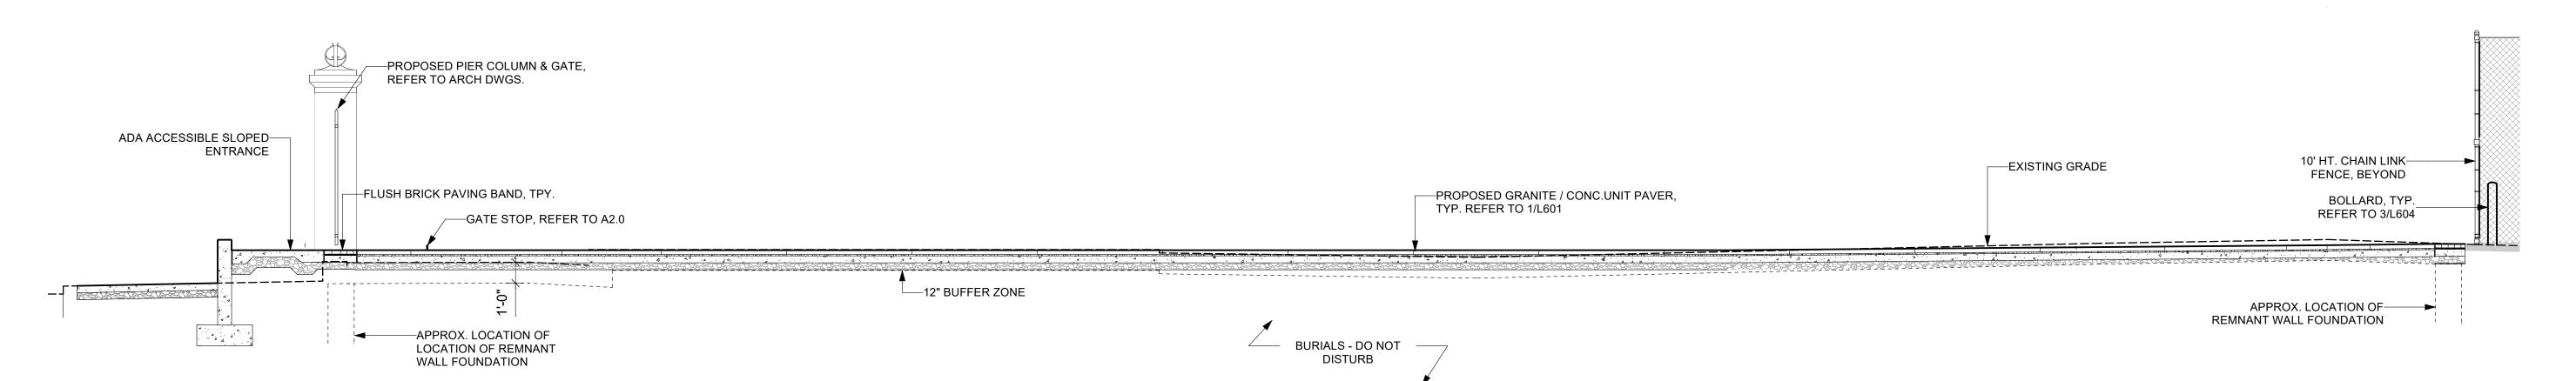

# BETHEL BURYING GROUND MEMORIAL PROJECT AT WECCACOE PLAYGROUND

Design Team:

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| Checked: Approve

Job Number: 749 File:

Date: 05/10/2024

05/10/2024

Drawing Set:
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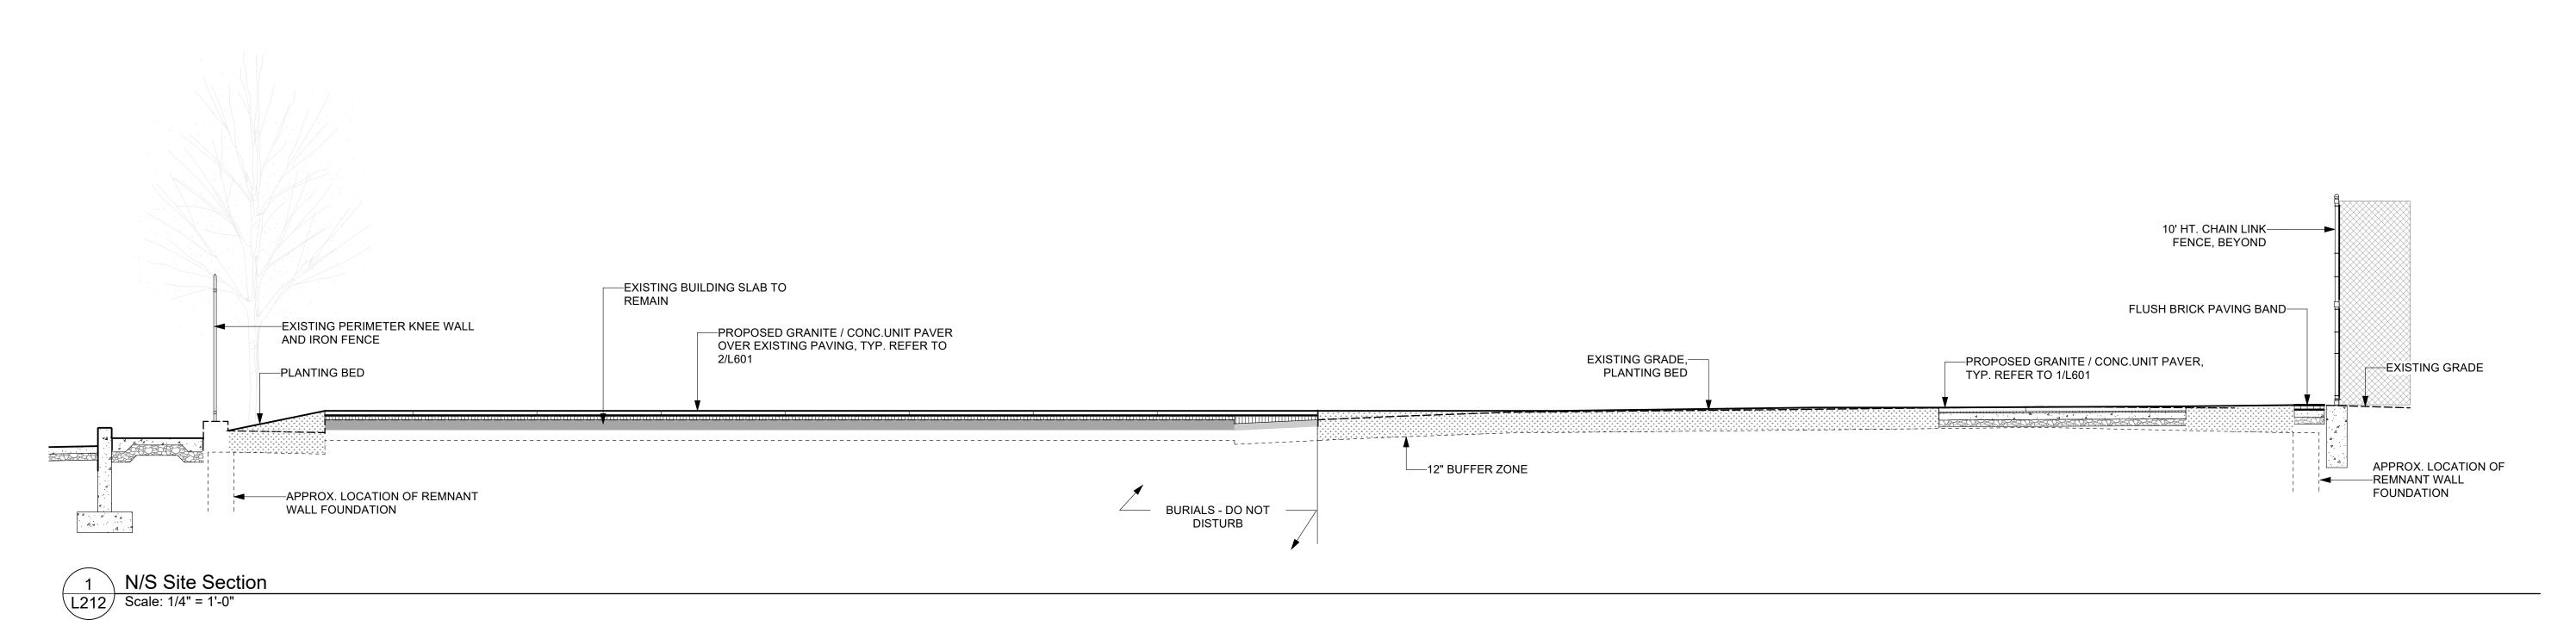
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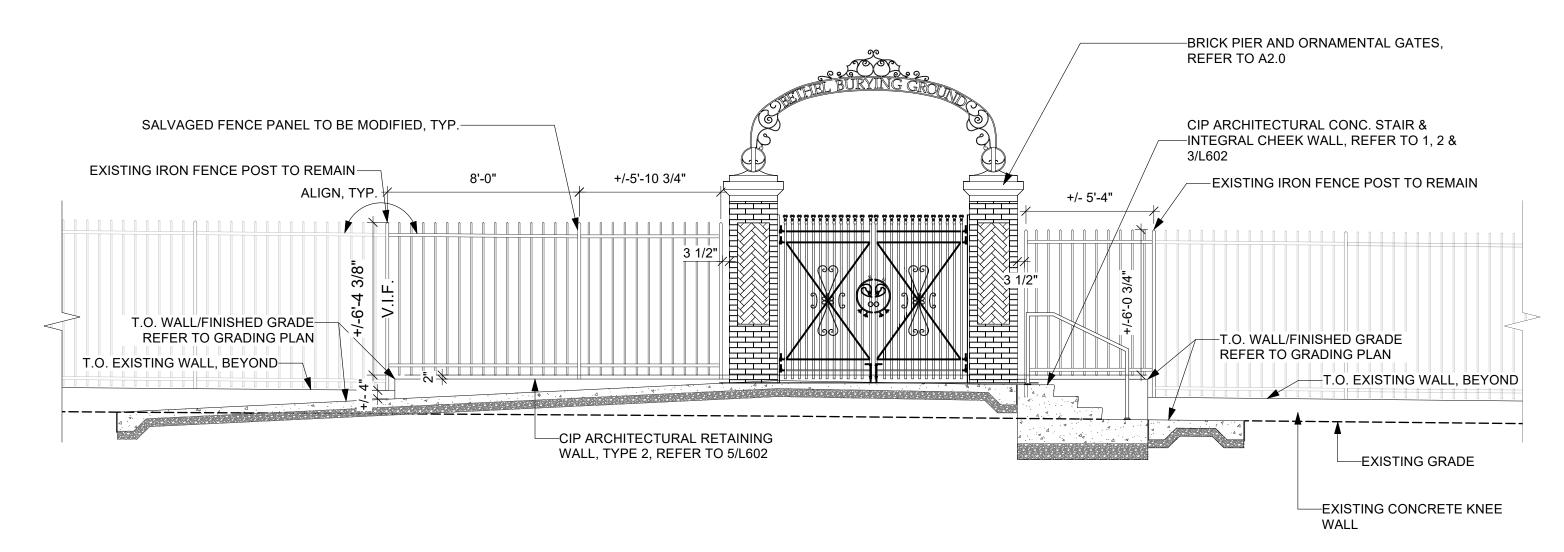
SITE SECTIONS

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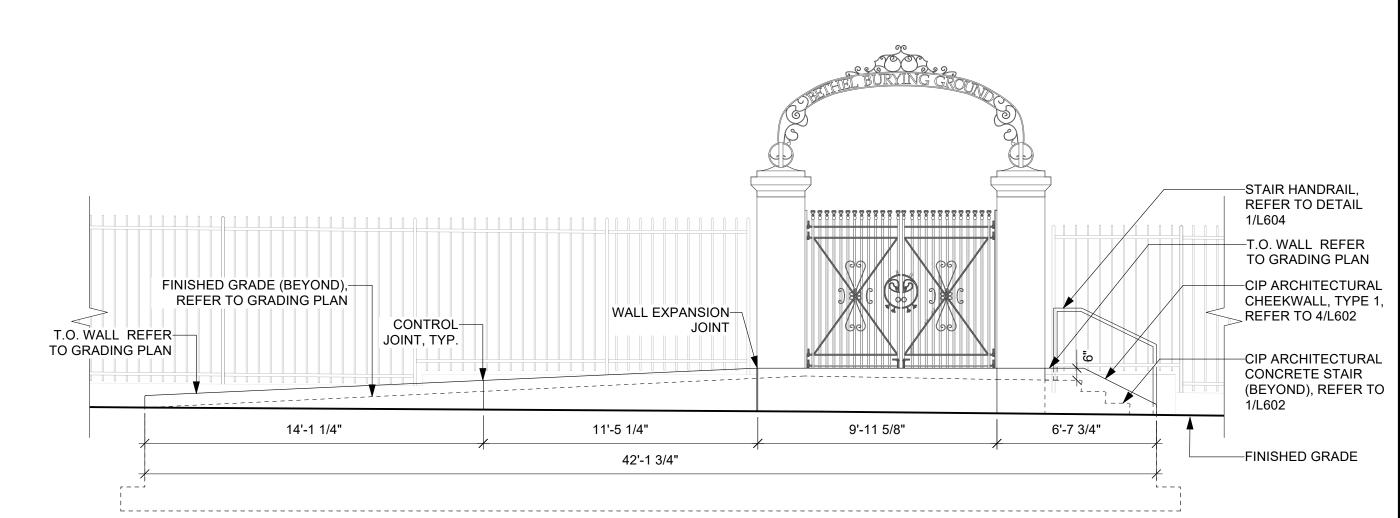
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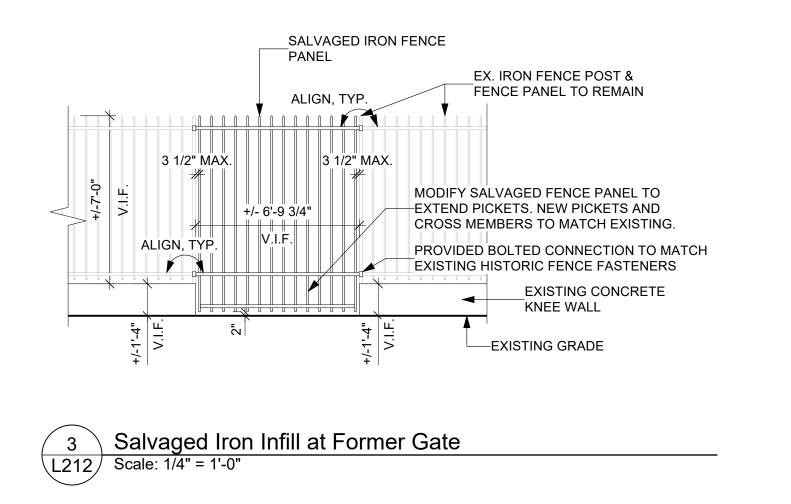




2 Section/Elevation at Ceremonial Gates
L212 Scale: 1/4" = 1'-0"



4 ELEVATION OF CIP ARCHITECTURAL CHEEKWALL
L212 Scale: 1/4" = 1'-0"



BETHEL BURYING
GROUND
MEMORIAL PROJECT
AT WECCACOE
PLAYGROUND

Design Team:

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Seal:

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Job Number: 749

)ate:

05/10/2024


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Drawing Title:

SITE SECTIONS

Drawing Number:

L212

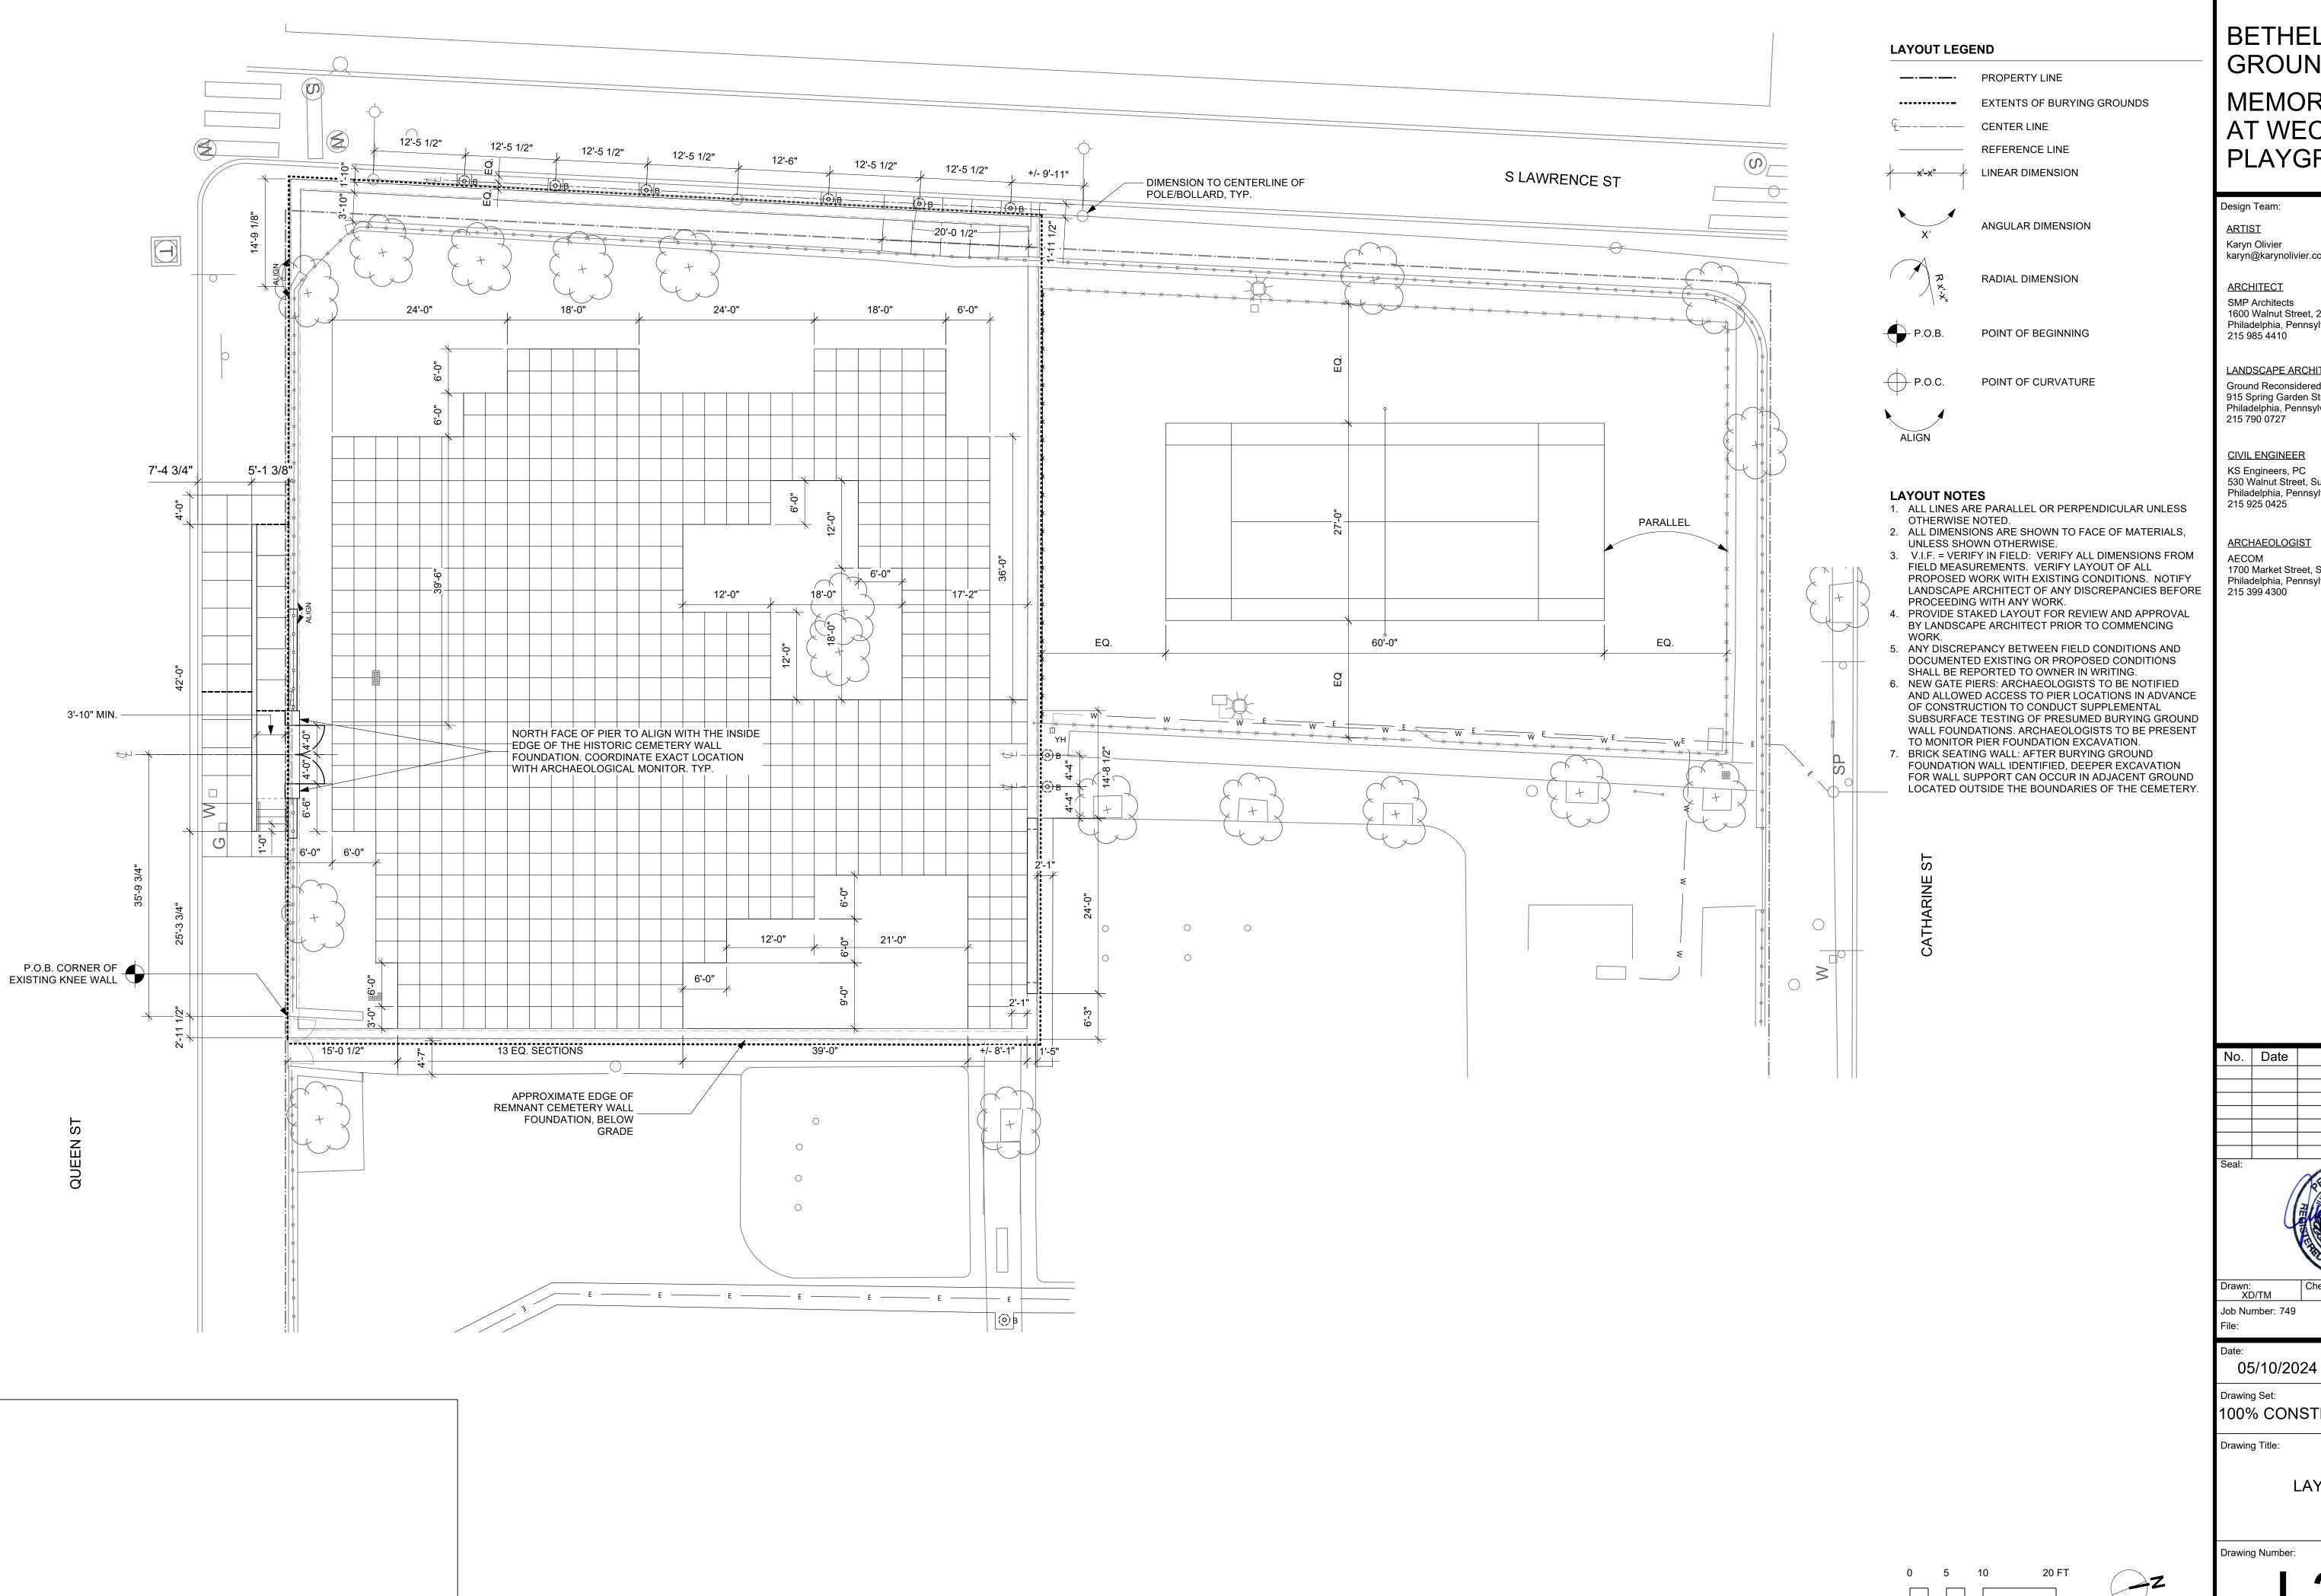

BETHEL BURYING GROUND

MEMORIAL PROJECT AT WECCACOE PLAYGROUND

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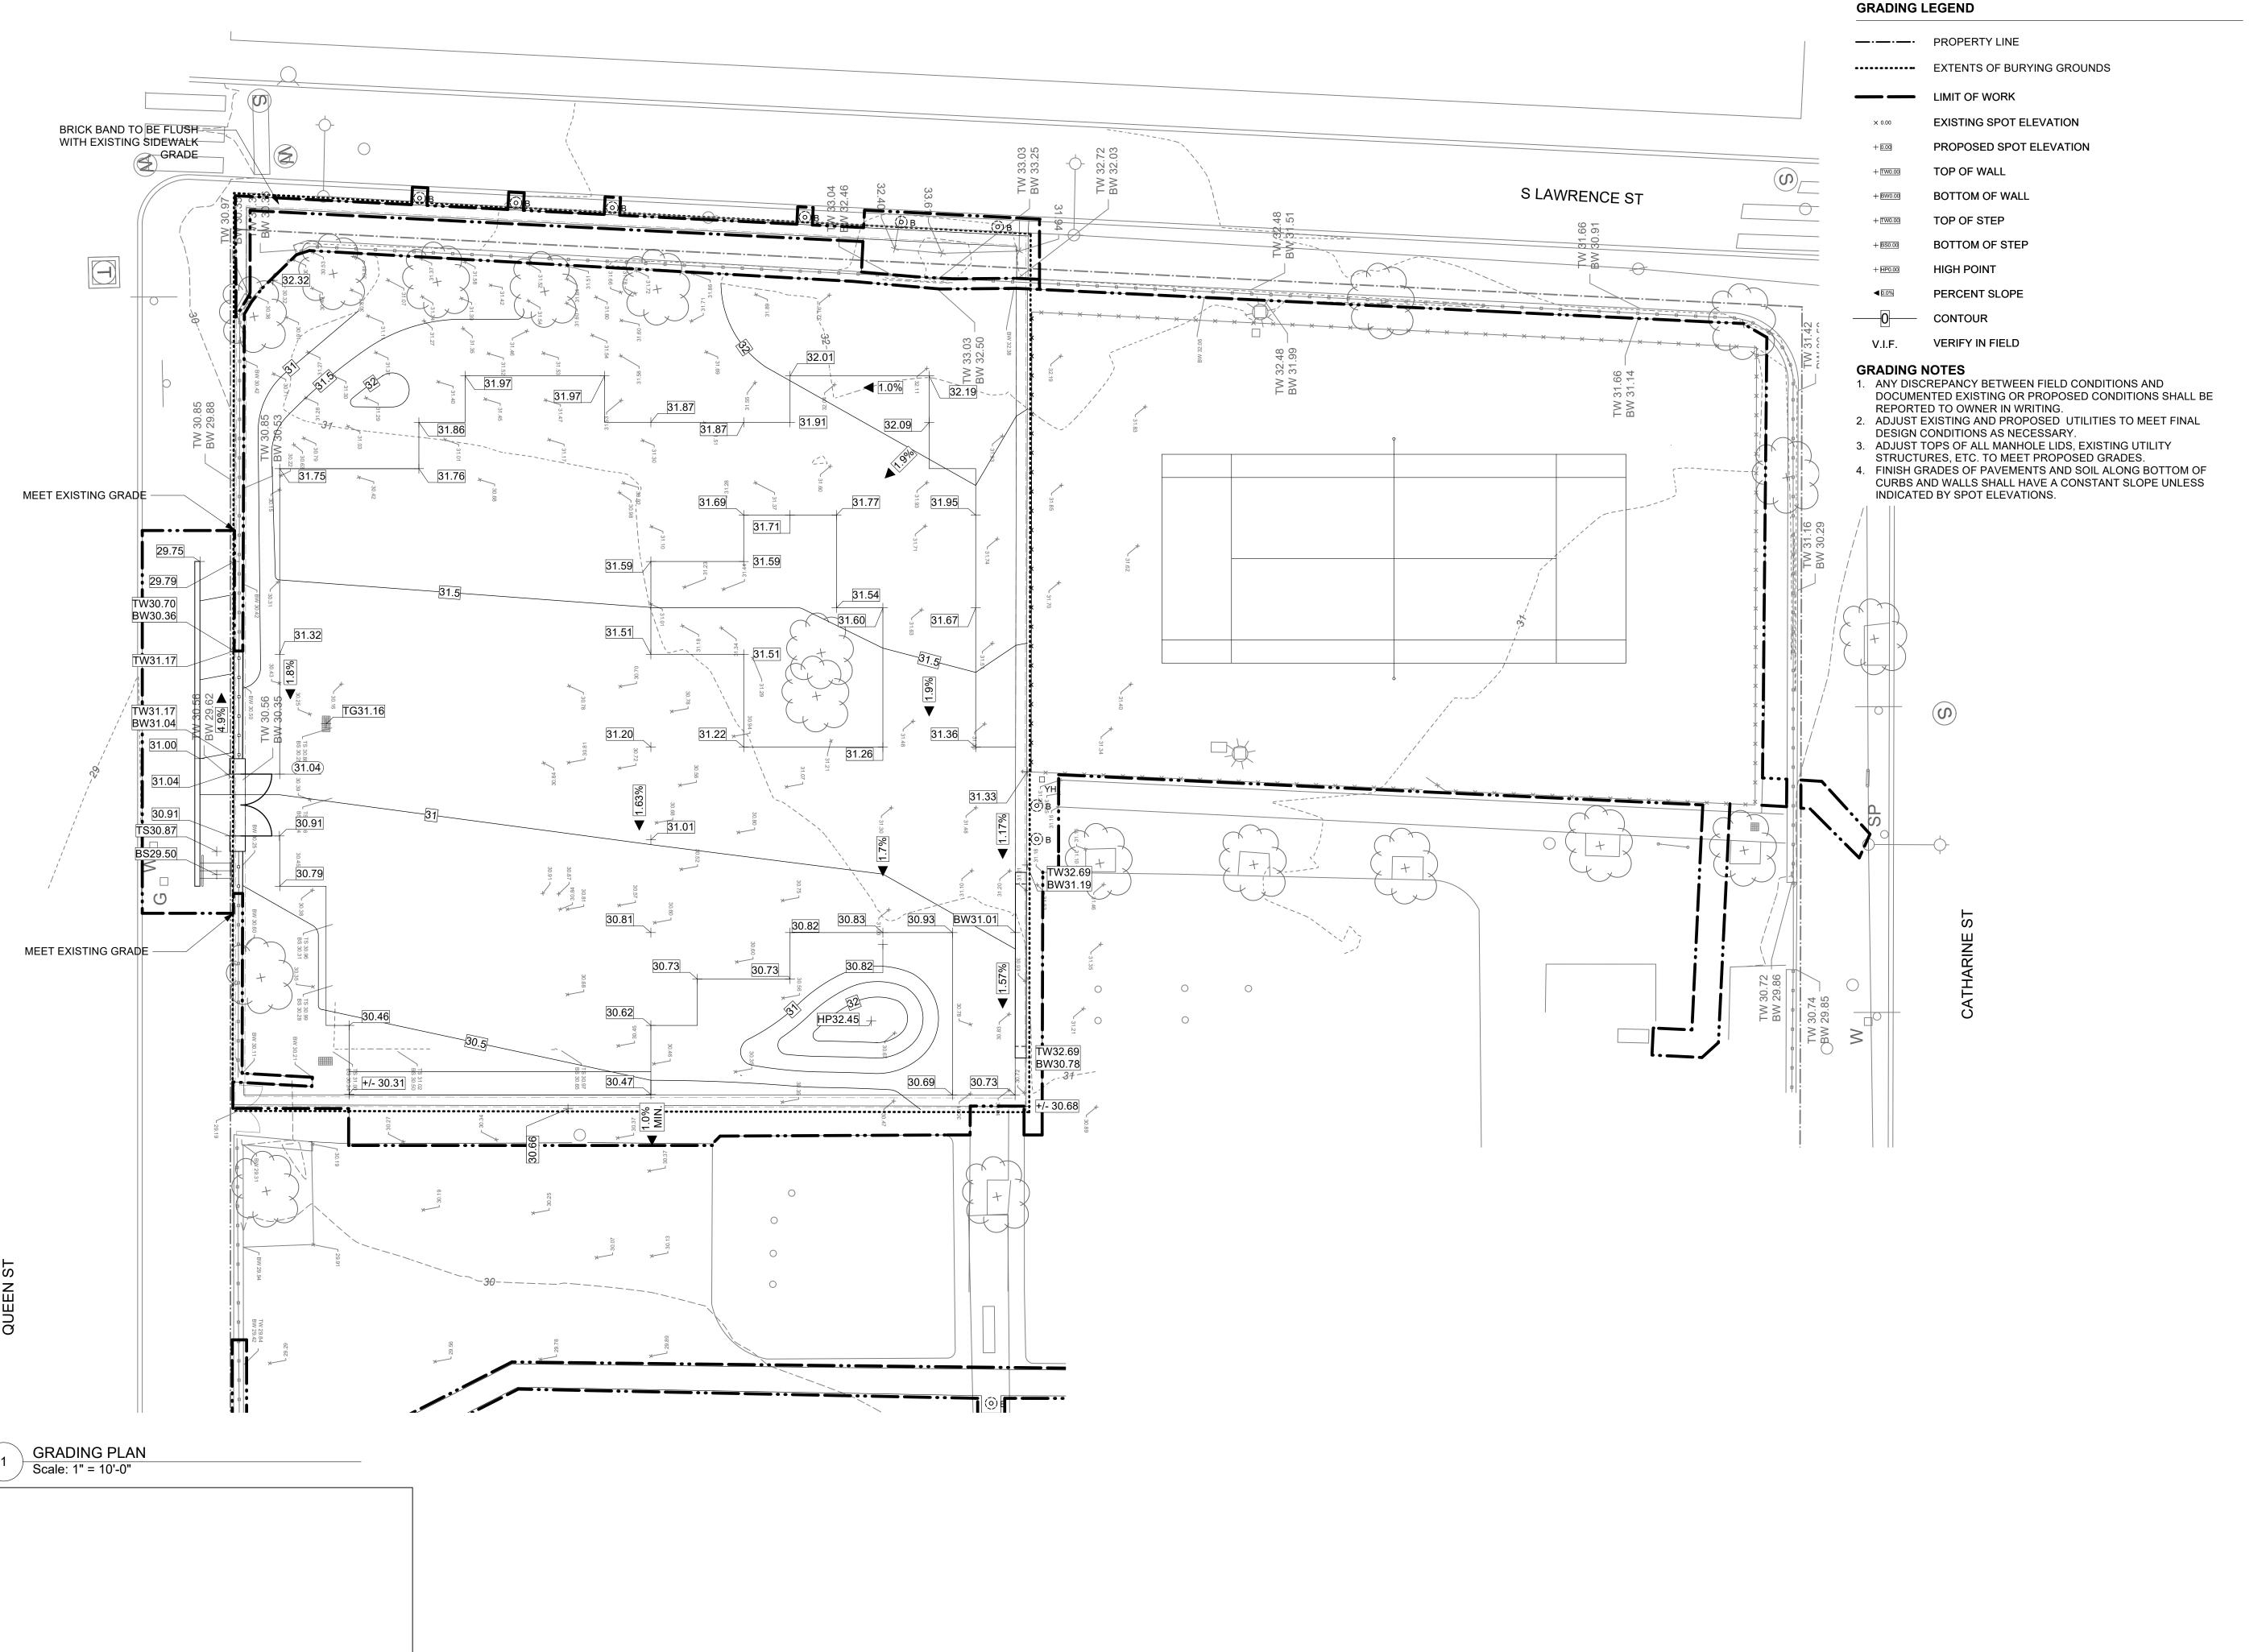
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Revisions

100% CONSTRUCTION DOCUMENTS

LAYOUT PLAN



BETHEL BURYING GROUND

## MEMORIAL PROJECT AT WECCACOE PLAYGROUND

Design Team: <u>ARTIST</u>

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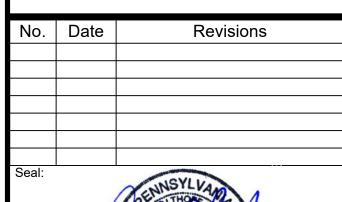
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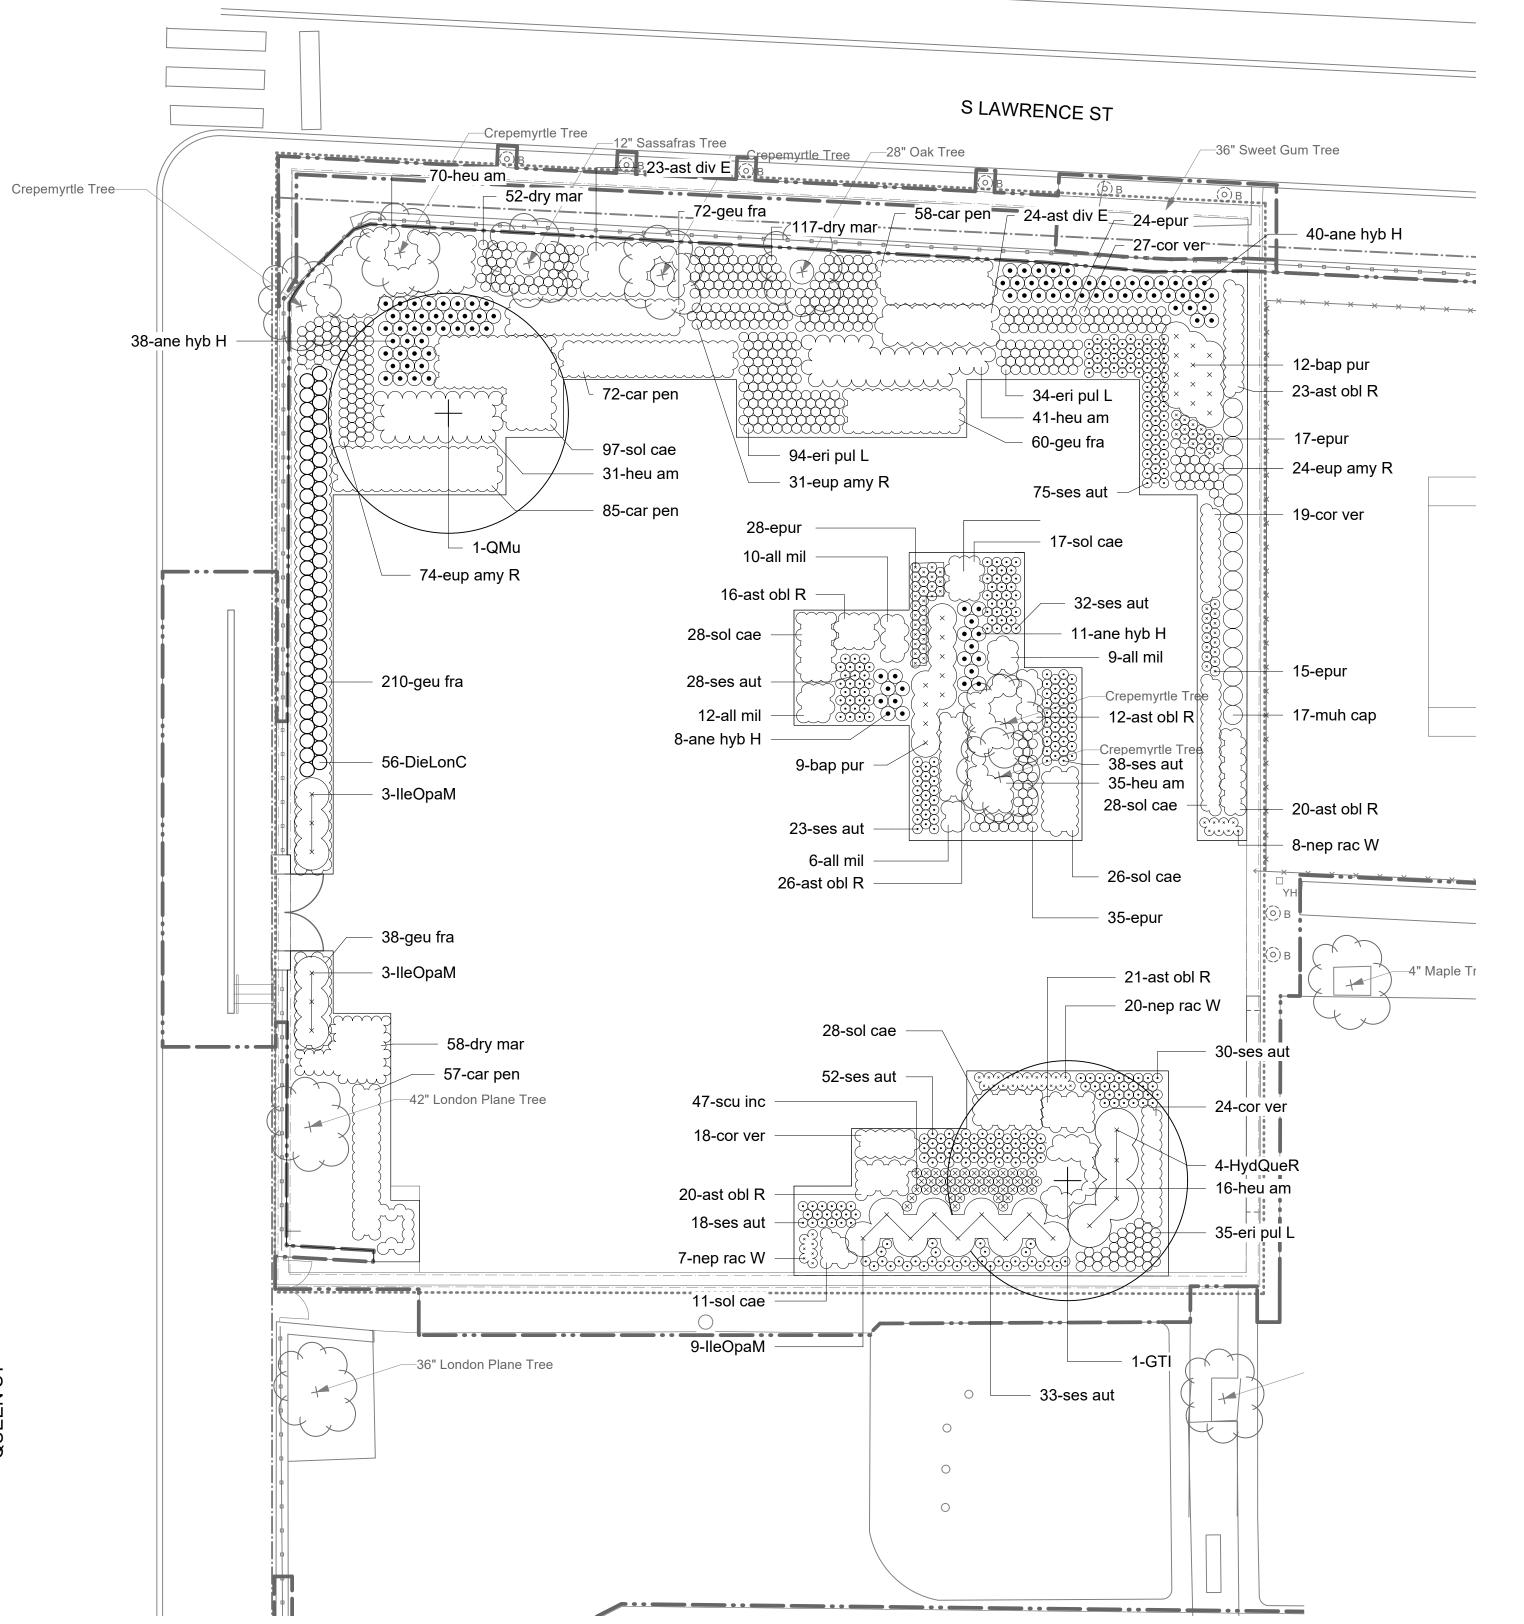


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Drawing Title:

**GRADING PLAN** 



PLANTING LEGEND

----- PROPERTY LINE

LIMIT OF WORK

•••••• EXTENTS OF BURYING GROUNDS

+

PROPOSED CANOPY TREE

EXISTING TREE TO REMAIN AND BE PROTECTED

PROPOSED SHRUB PLANTING, TYP.

PROPOSED PERENNIAL PLANTING, TYP.

#### **PLANTING NOTES**

EXCAVATION.

1. REFER TO SPECIFICATION SECTION 329300, PLANTS FOR

ADDITIONAL REQUIREMENTS.

2. EXCAVATE FOR PLANTING ONLY AS DEEP AS NECESSARY TO FIT THE ROOT MASS OF THE CONTAINER PLANT. ARCHAEOLOGICAL MONITOR TO BE NOTIFIED TO REVIEW ANY PLANTS THAT WILL REQUIRE DEEPER THAN 12" EXCAVATION. NOTIFY ARCHAEOLOGIST IMMEDIATELY IF YELLOW SOIL IS ENCOUNTERED DURING

#### PLANT SCHEDULE

Qty	ld	Botanical Name	Common Name	Size	Spacing	Notes
Trees						
1	QMu	Quercus muehlenbergii	Chinkapin Oak	2" Cal.	As Shown	Specimen Quality, B&B
1	GTI	Gleditsia triacanthos 'Christie'	Halka Honeylocust	2" Cal.	As Shown	Specimen Quality, B&B
Shrub	s	·	-		<u>.</u>	
57	DieLonC	Diervilla Ionicera 'Copper'	Bush Honeysuckle	#1	18" o.c.	Container
4	HydQueR	Hydrangea quercifolia 'Ruby Slipper'	Ruby Slippers Oak Leaf Hydrangea	#3	As Shown	Container
15	lleOpaM	llex opaca 'Maryland Dwarf'	Maryland Dwarf American Holly	#3	As Shown	Container
Ornan	nental Grass	ses				
273	car pen	Carex pensylvanica	Pennsylvania Sedge	#32	12" o.c.	Plug
18	muh cap	Muhlenbergia capillaris	Muhly Grass	#1	24" o.c.	
330	ses aut	Sesleria autumnalis	Autumn Moor Grass	#1	12" o.c.	
Peren	nials					
38	all mil	Allium 'Millennium'	Millennium Allium	#SP4	12" o.c.	
1	ane can	Anemone canadensis	Meadow Anemone	#SP4	18" o.c.	
98	ane hyb H	Anemone x hybrida 'Honorine Jobert'	Honorine Jobert Anemone	#SP4	18" o.c.	
48	ast div E	Aster divaricatus 'Eastern Star'	Eastern Star Wood Aster	#50	18" o.c.	Plug
139	ast obl R	Aster oblongifolius 'Raydon's Favorite'	Raydon's Favorite Aromatic Aster	#50	12" o.c.	Plug
22	bap pur	Baptisia 'Purple Smoke'	Purple Smoke False Indigo	#1	18" o.c.	
89	cor ver	Coreopsis verticillata	Thread-leaf Coreopsis	#SP4	12" o.c.	
119	epur	Echinacea purpurea	Purple Coneflower	#50	12" o.c.	Plug
164	eri pul L	Erigeron pulchellus var. pulchellus 'Lynn	Robin's Plantain	#32	12" o.c.	Plug
130	eup amy R	Euphorbia amygdaloides var. robbiae	Wood Spurge	#SP4	12" o.c.	
381	geu fra	Geum fragaroides	Barren Strawberry	#32	12" o.c.	Plug
194	heu am	Heuchera americana 'Dale's Strain'	Coral Bells	#SP4	18" o.c.	
36	nep rac W	Nepeta racemosa 'Walker's Low'	Walker's Low Catmint	#SP4	12" o.c.	
48	scu inc	Scutellaria incana	Downy Skullcap	#50	12" o.c.	
236	sol cae	Solidago caesia	Bluestem Goldenrod	#50	12" o.c.	Plug
Ferns					·	
456	dry mar	Dryopteris marginalis	Marginal Shield Fern	#32	12" o.c.	Plug

BETHEL BURYING GROUND

MEMORIAL PROJECT AT WECCACOE PLAYGROUND

Design Team:

<u>ARTIST</u> Karyn Olivier karyn@karynolivier.com

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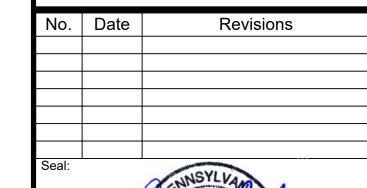
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Drawn:
XD/TM

Checked:
TM

Approved
JB

Job Number: 749 File:

Date: 05/10/2024

05/10/2024


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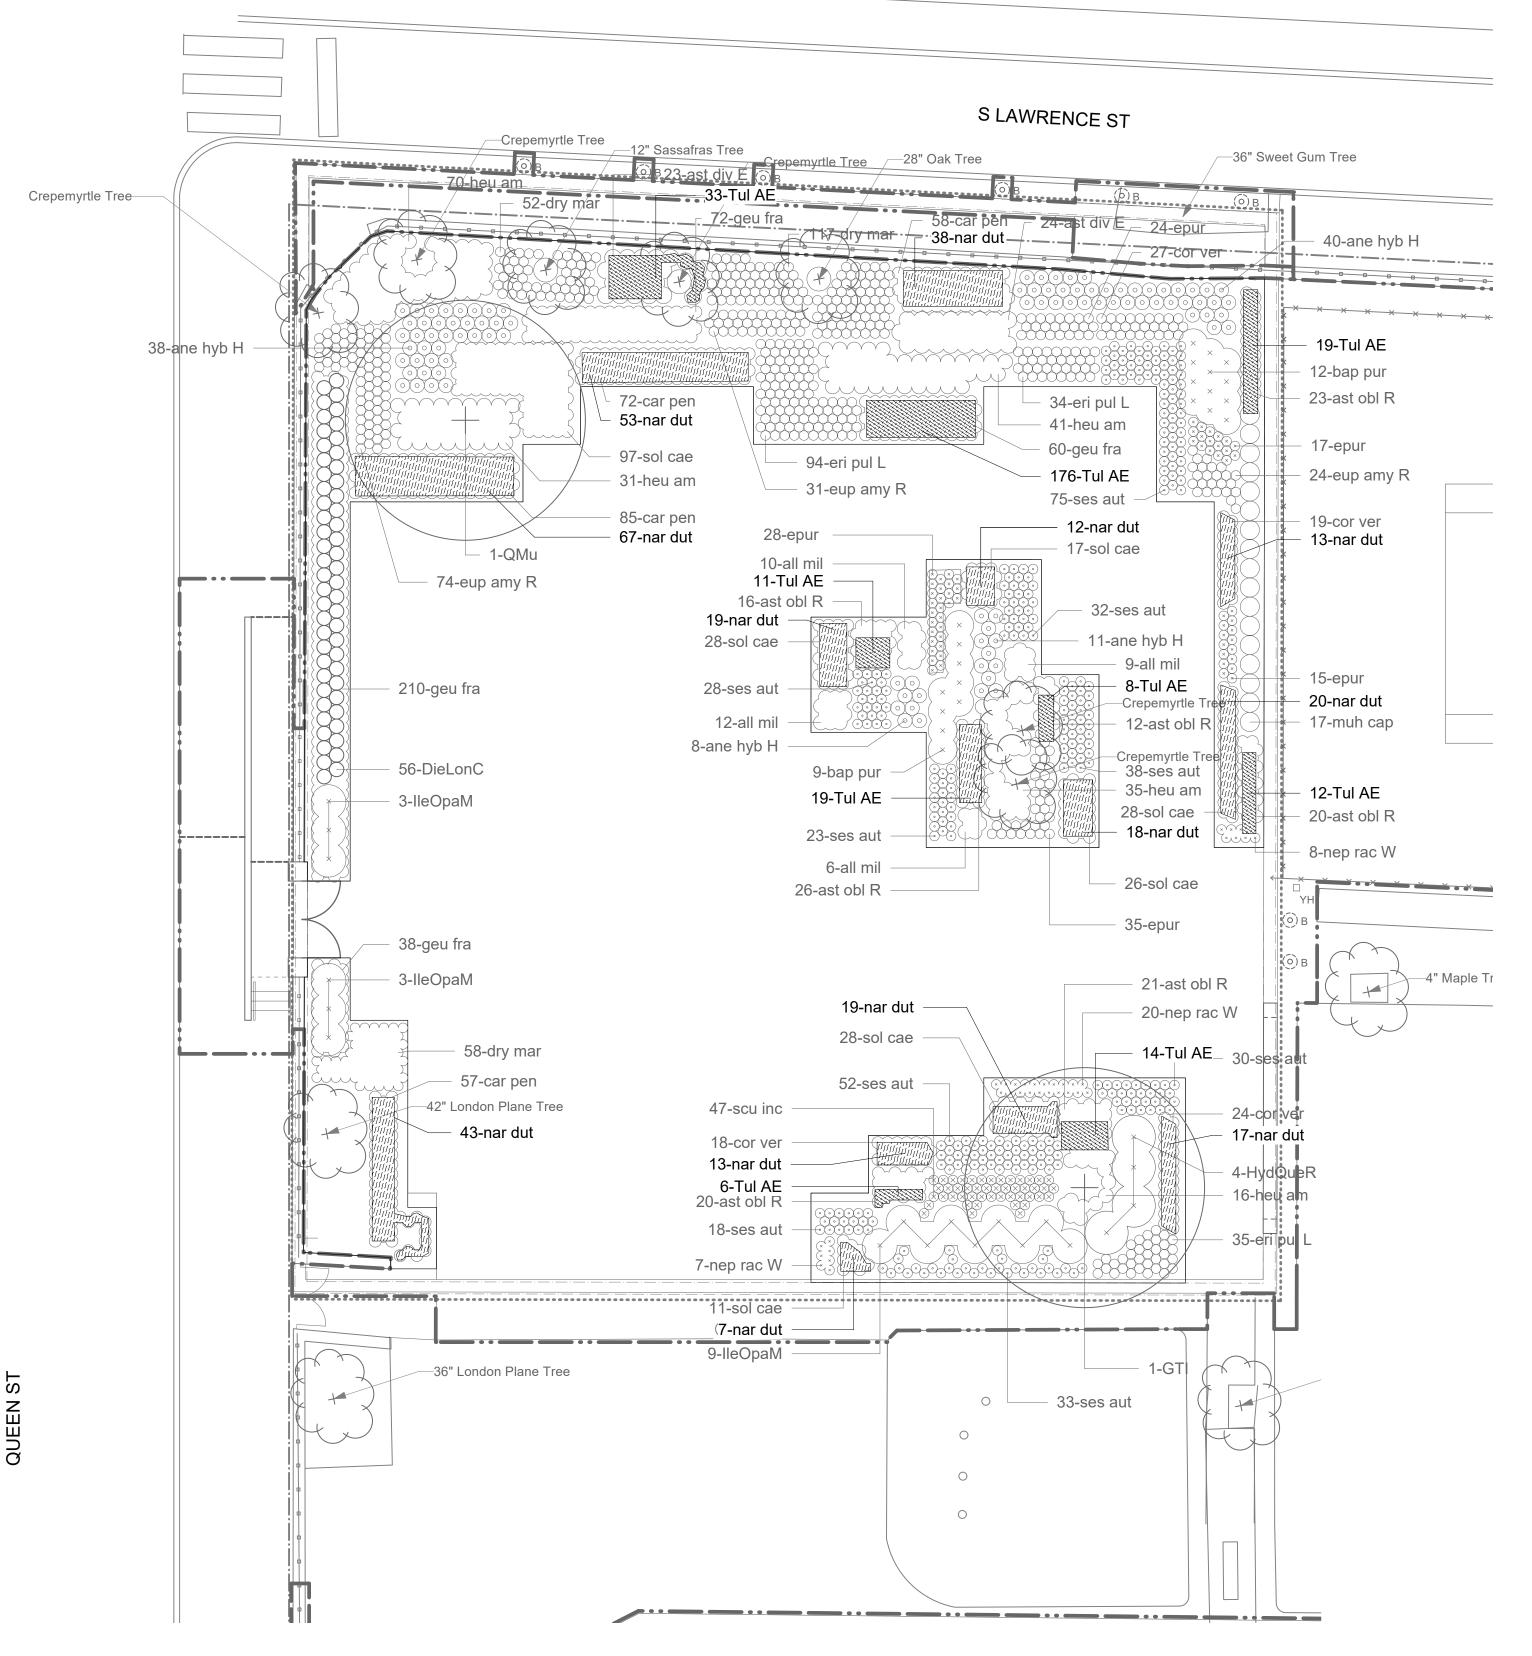
Drawing Title:

PLANTING PLAN

Drawing Number:

L501



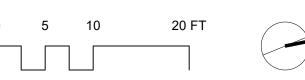

BULB PLANTING PLAN
Scale: 1" = 10'-0"

#### PLANTING LEGEND

PROPOSED BULB PLANTING, TYP.


#### **PLANTING NOTES**

#### 1. REFER TO SPECIFICATION SECTION 329300, PLANTS FOR

ADDITIONAL REQUIREMENTS. 2. EXCAVATE FOR PLANTING ONLY AS DEEP AS NECESSARY TO FIT THE ROOT MASS OF THE CONTAINER PLANT. ARCHAEOLOGICAL MONITOR TO BE NOTIFIED TO REVIEW ANY PLANTS THAT WILL REQUIRE DEEPER THAN 12" EXCAVATION. NOTIFY ARCHAEOLOGIST IMMEDIATELY IF YELLOW SOIL IS ENCOUNTERED DURING EXCAVATION.


#### PLANT SCHEDULE

Qty	ld	Botanical Name	Common Name	Size	Spacing	Notes
Bulbs						
340	nar dut	Narcissus 'Dutch Master'	Dutch Master Daffodil	Top size	12" o.c.	
298	Tul AE	Tulipa 'Apeldoorn Elite	Darwin Hybrid Tulip	Top size	12" o.c.	

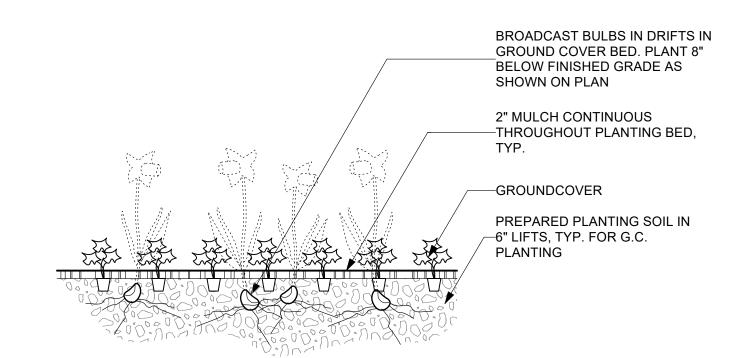

BULB AND GROUNDCOVER PLANTING DETAIL

Scale: 1/2" = 1'-0"

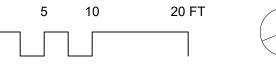

## BETHEL BURYING GROUND MEMORIAL PROJECT AT WECCACOE

PLAYGROUND

Design Team: <u>ARTIST</u>

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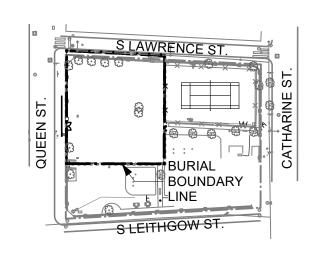
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No.	Date	Revisions
Seal:		

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Job Number: 749

05/10/2024


Drawing Set:

100% CONSTRUCTION DOCUMENTS

Drawing Title:

PLANTING PLAN - BULBS



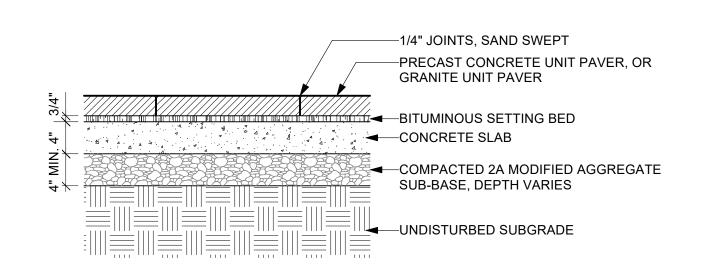

PRECAST CONCRETE OR GRANITE UNIT PAVING, TYP L601 | Scale: 1" = 1'-0"

-1.5" ASPHALT

—2" ASPHALT

BINDER COURSE

6" COMPACTED


L601 Scale: 1" = 1'-0"

ASPHALT PAVING, TYP.


AGGREGATE BASE

WEARING COURSE

PREPARED SUBGRADE

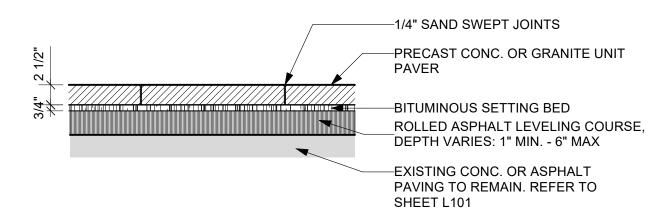


UNIT PAVING OVER EXISTING PAVING TO REMAIN L601 Scale: 1" = 1'-0"

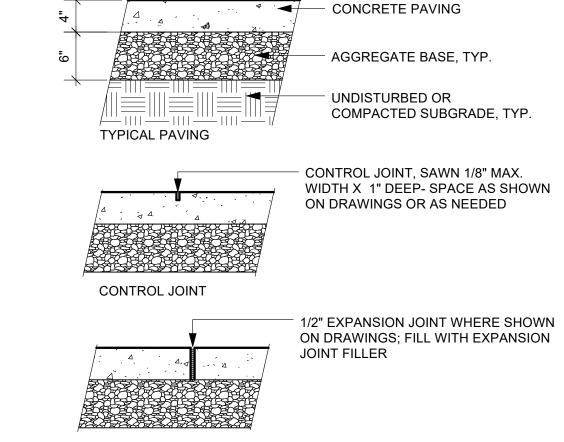

CONCRETE PAVING, TYP.

Scale: 1" = 1'-0"

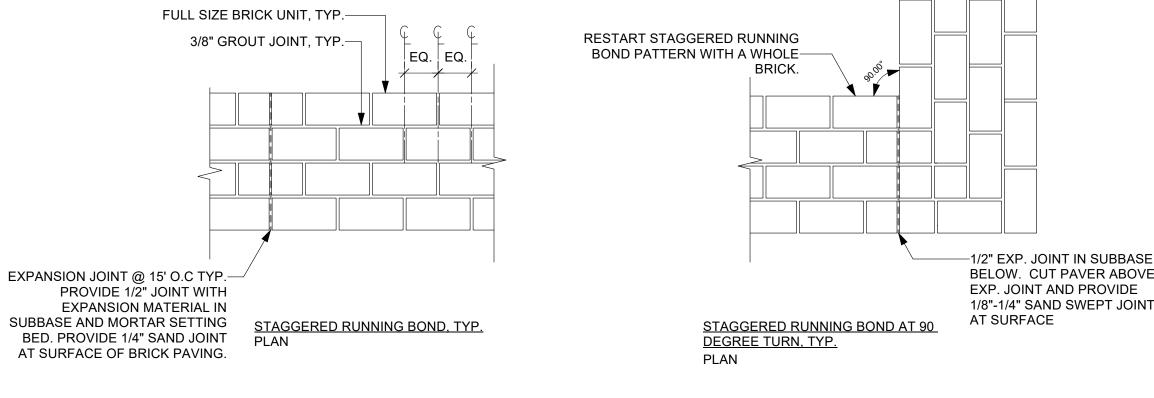

-3/8" GROUT JOINT, TYP.

BRICK UNIT PAVER, TYP.

EXPANSION JOINT, TYP.


-4" THICK


-1" MORTAR SETTING BED


-CONCRETE SLAB, 4" THICK

COMPACTED AGGREGATE BASE,

—FINISHED GRADE - REFER TO L201

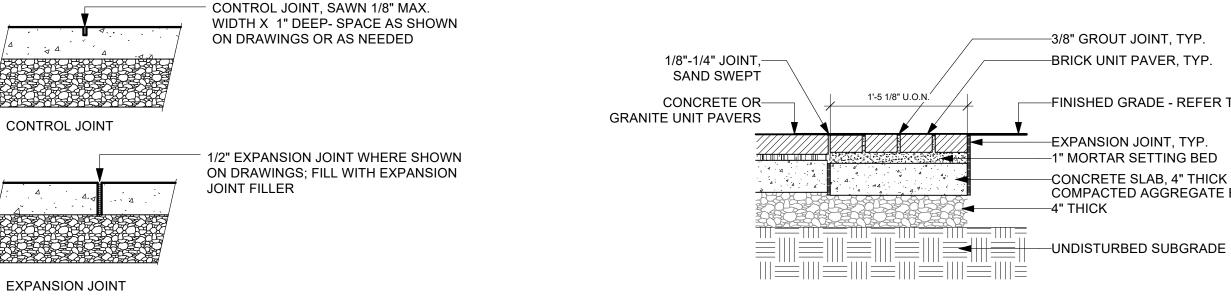

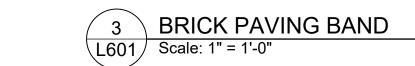


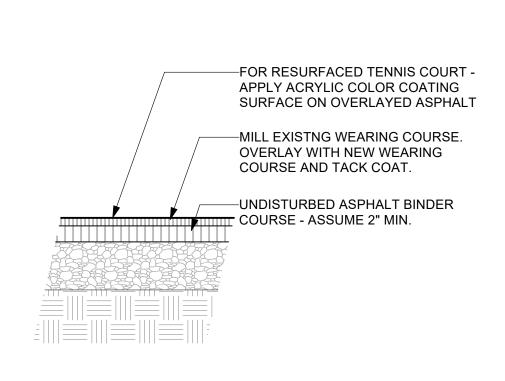







INSCRIPTION STYLE	SPECIFICATION NOTES
INSCRIPTION STYLE A	INCISED SAND-BLAST LETTERING 1/16"-1/8" DEEP, TYP. LETTERING FINISH: MEDIUM DARK GREY SHADOW.
INSCRIPTION STYLE B	INCISED SAND-BLAST LETTERING, DEPTH TO BE AS SHALLOW AS POSSIBLE WITHOUT LOSING LEGIBILITY, TYP. LETTERING FINISH: NO COLORIZATION
INSCRIPTION STYLE C	RAISED LETTERING, 1/32" - 1/16" PROTRUSION LETTERING FINISH: DIAMOND 8

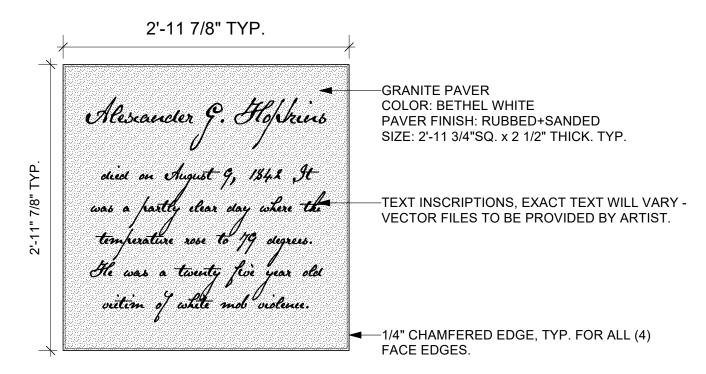





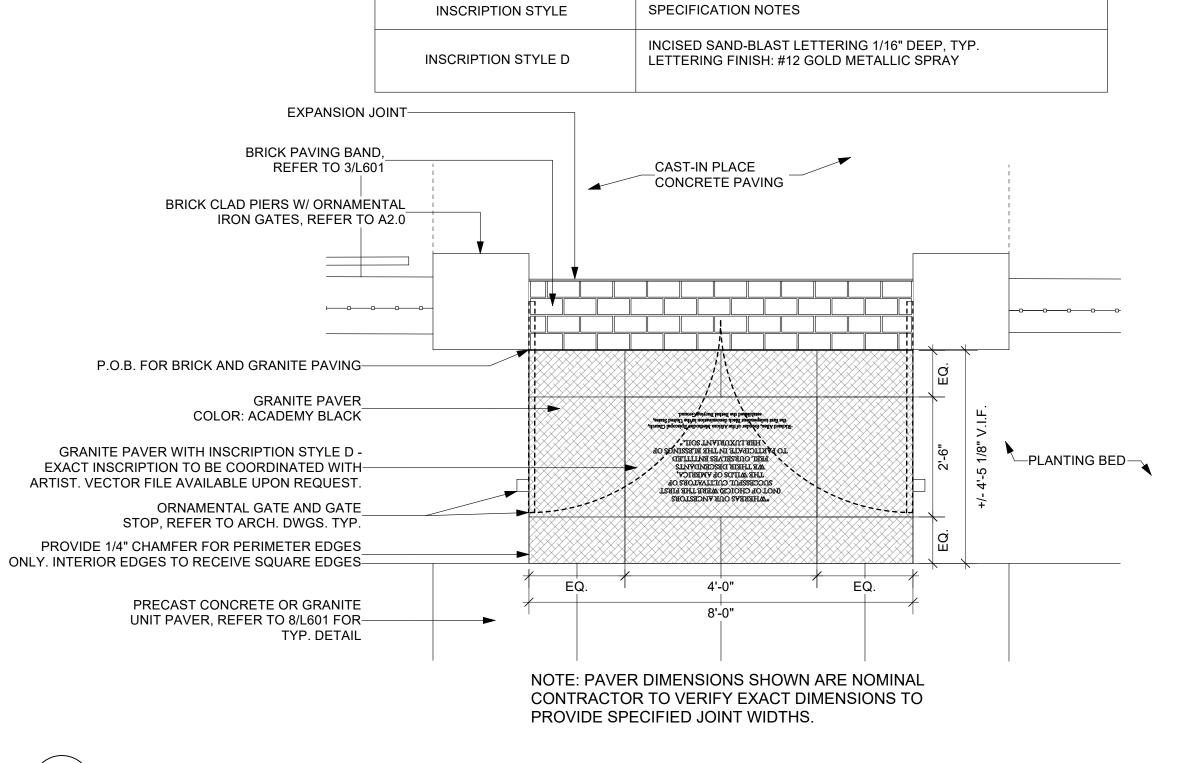




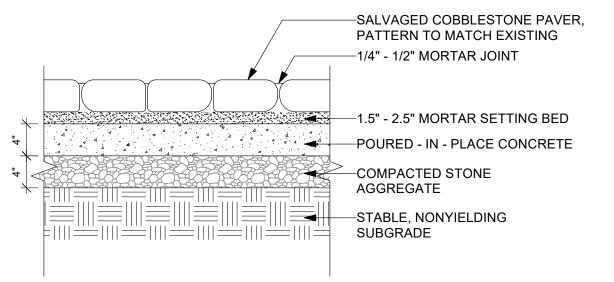

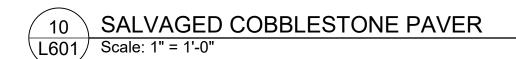

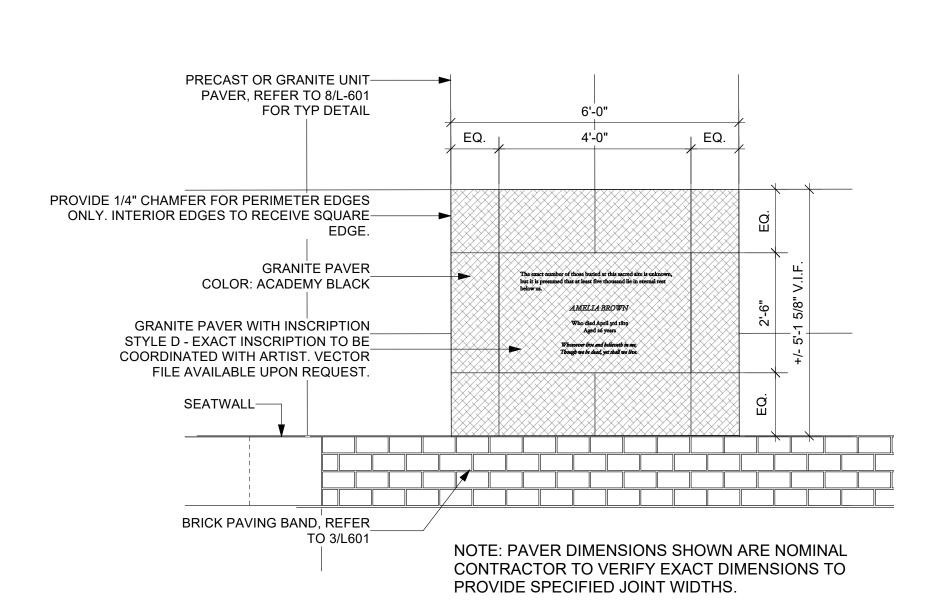



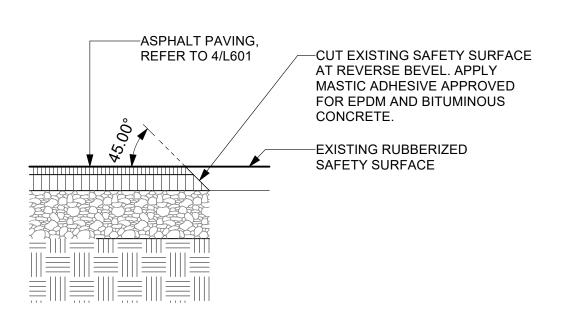



BETHEL BURYING GROUND MEMORIAL PROJECT AT WECCACOE **PLAYGROUND** 

Design Team: <u>ARTIST</u> Karyn Olivier karyn@karynolivier.com

> <u>ARCHITECT</u> SMP Architects 1600 Walnut Street, 2nd Floor Philadelphia, Pennsylvania 19103 215 985 4410

LANDSCAPE ARCHITECT Ground Reconsidered 915 Spring Garden Street, Suite 403 Philadelphia, Pennsylvania 19123 215 790 0727

**CIVIL ENGINEER** KS Engineers, PC 530 Walnut Street, Suite 460 Philadelphia, Pennsylvania 19106 215 925 0425

**ARCHAEOLOGIST** AECOM 1700 Market Street, Suite 1600, Philadelphia, Pennsylvania 19103 215 399 4300

No. Date Revisions

XD/TM Job Number: 749


05/10/2024


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Drawing Title:


SITE DETAILS


Drawing Number:



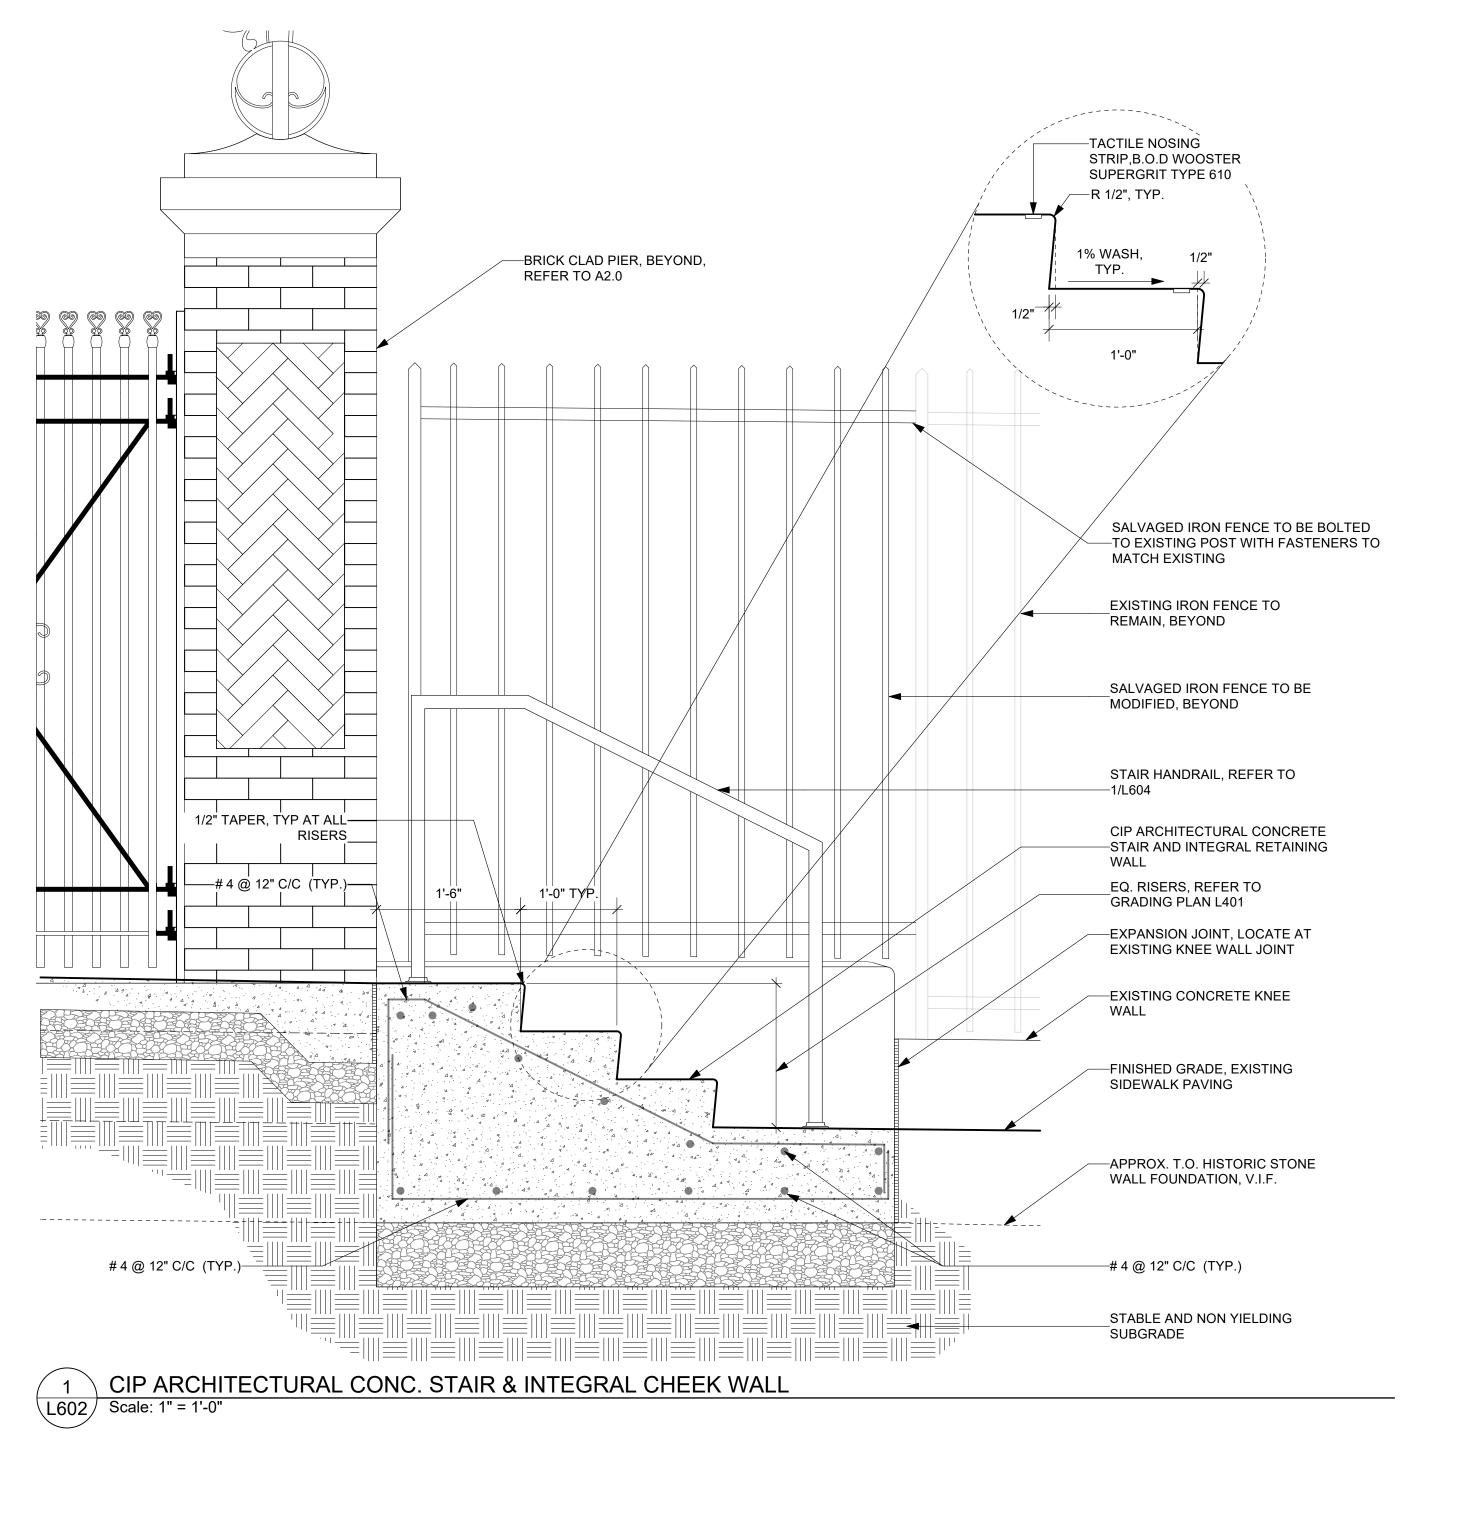

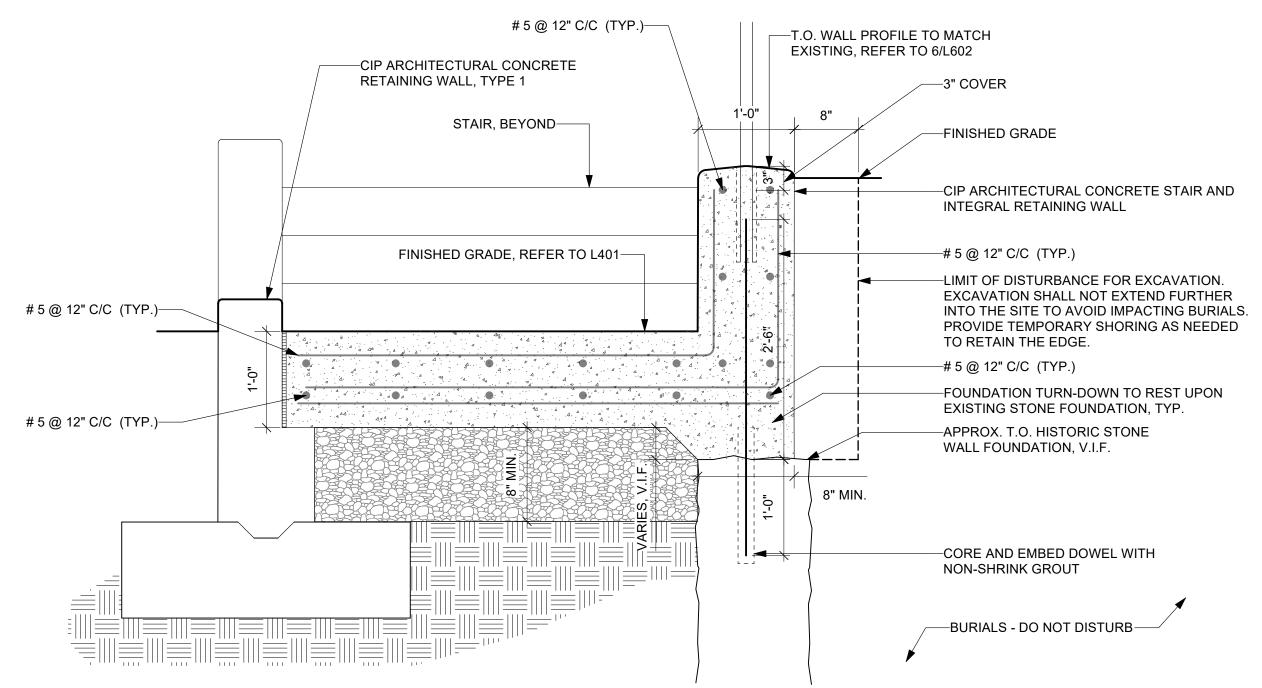CIP ARCHITECTURAL CONCRETE STAIR & INTEGRAL RETAINING WALL

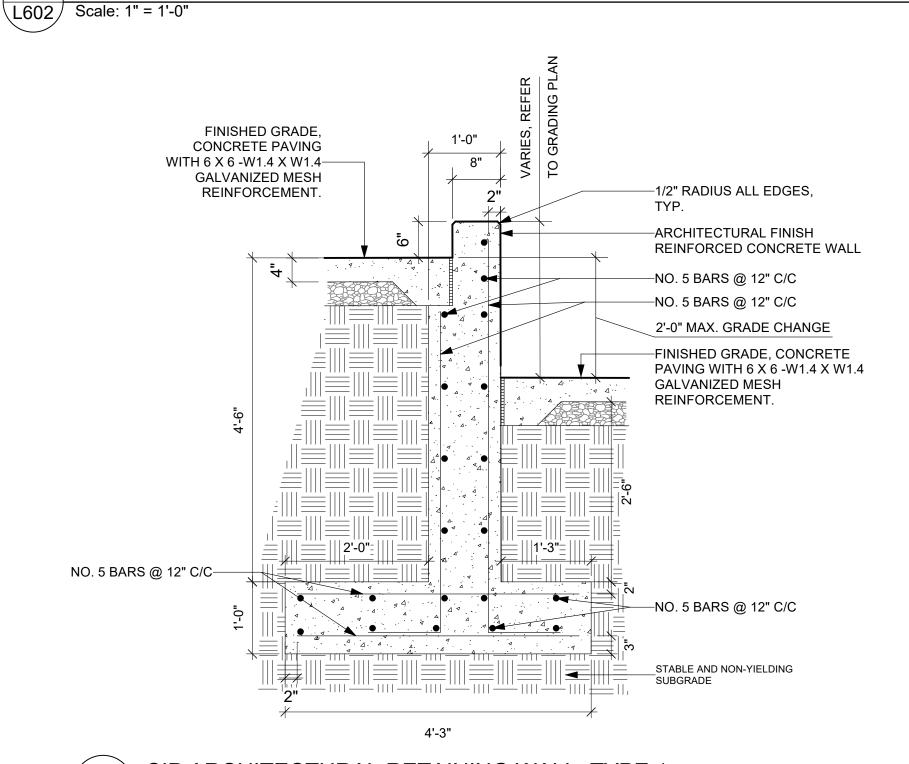

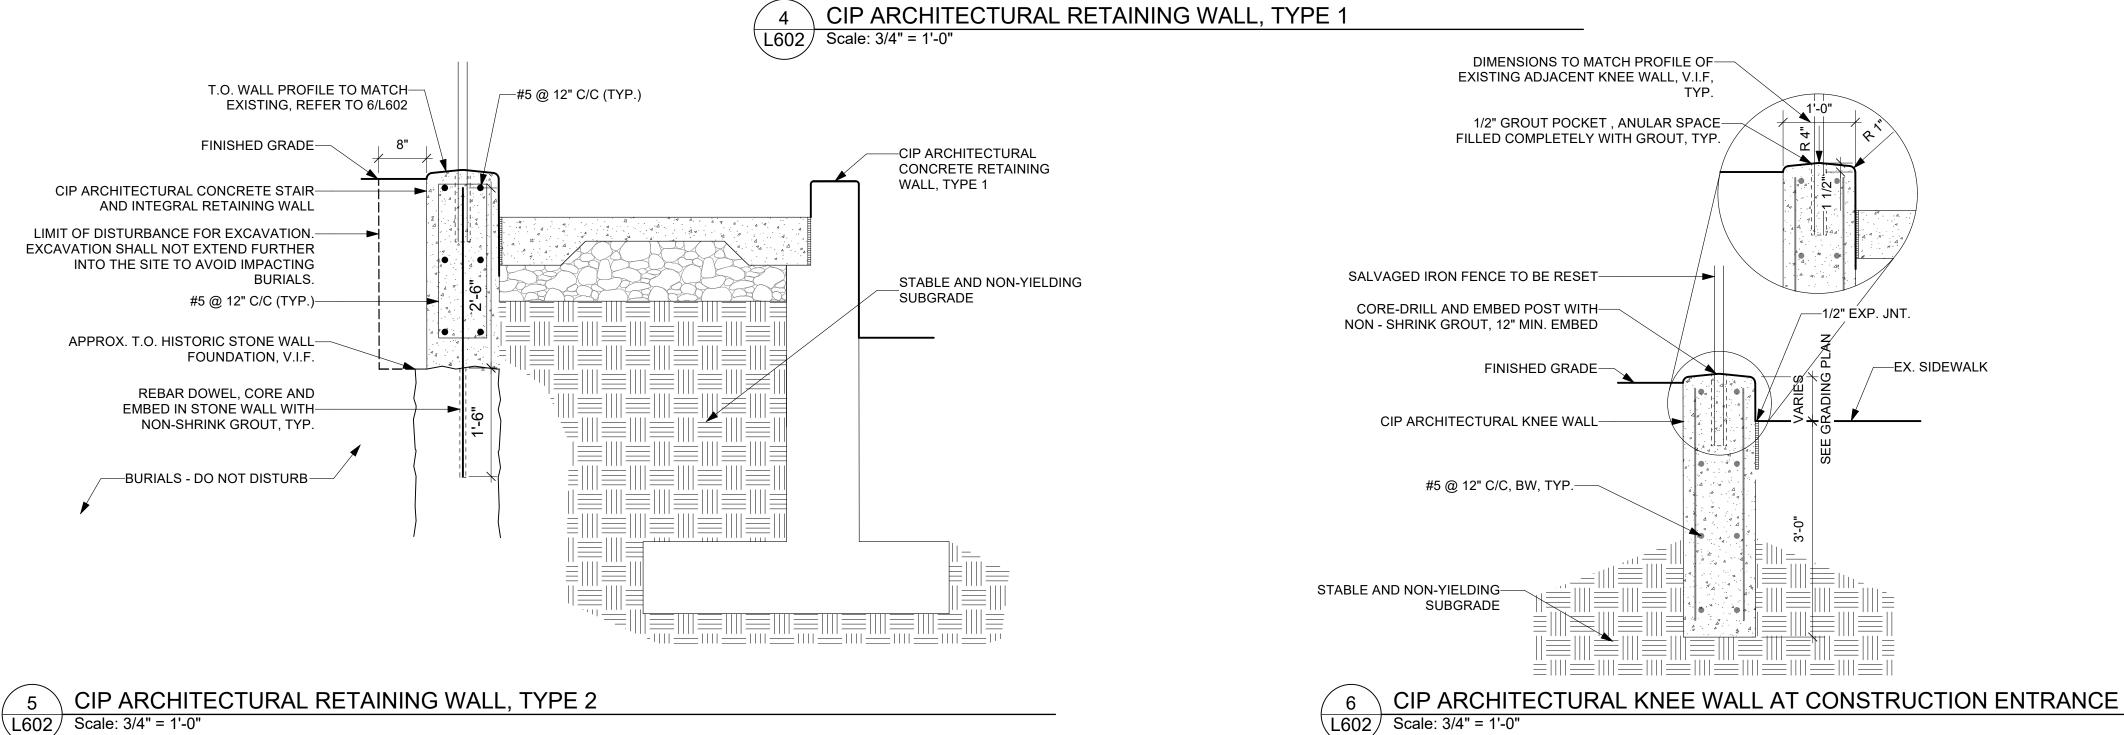

BETHEL BURYING GROUND

MEMORIAL PROJECT AT WECCACOE PLAYGROUND

Design Team: <u>ARTIST</u>

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**ARCHITECT** 

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LANDSCAPE ARCHITECT


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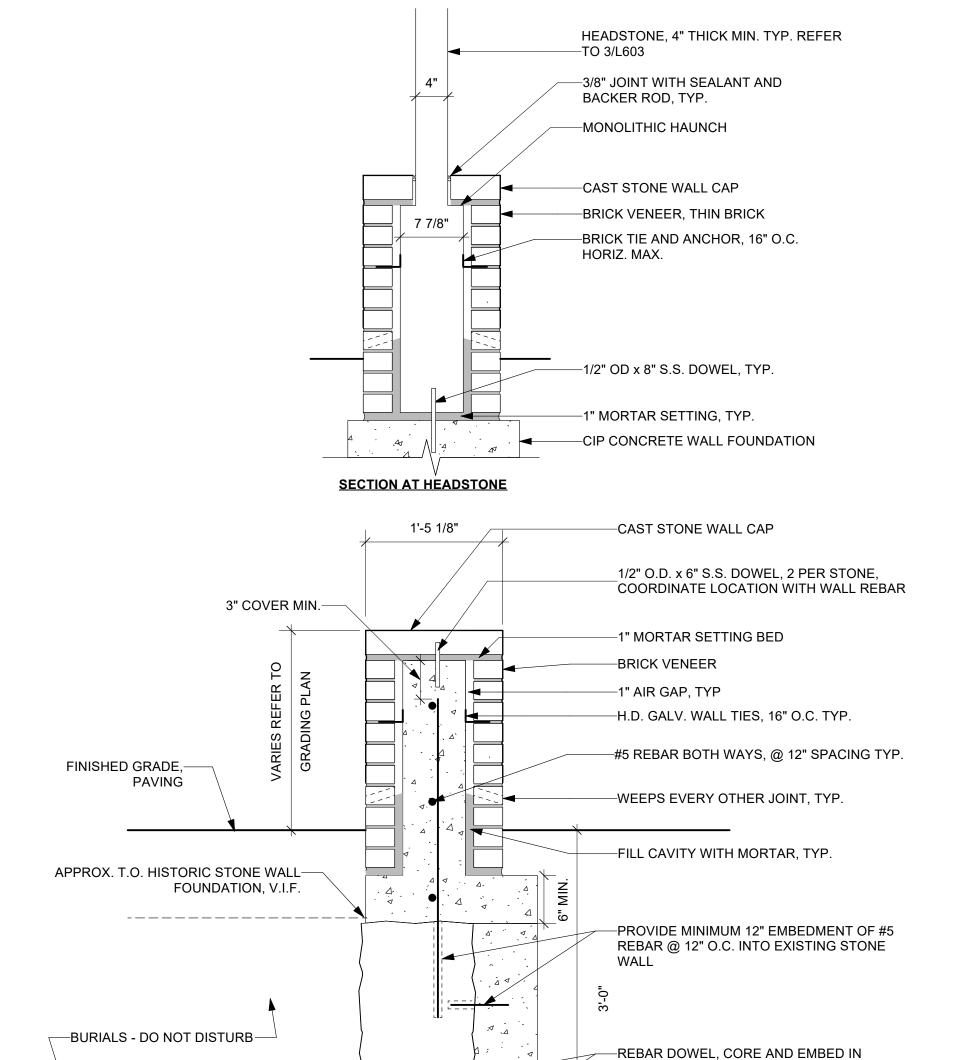
Drawing Set:

100% CONSTRUCTION DOCUMENT

Drawing Title:

SITE DETAILS


Drawing Number:

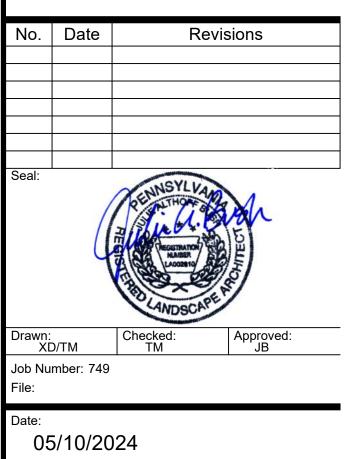

**SECTION - TYPICAL** 


STONE WALL WITH NON-SHRINK GROUT,

1 BRICK CLAD SEATWALL
L603 Scale: 1" = 1'-0"

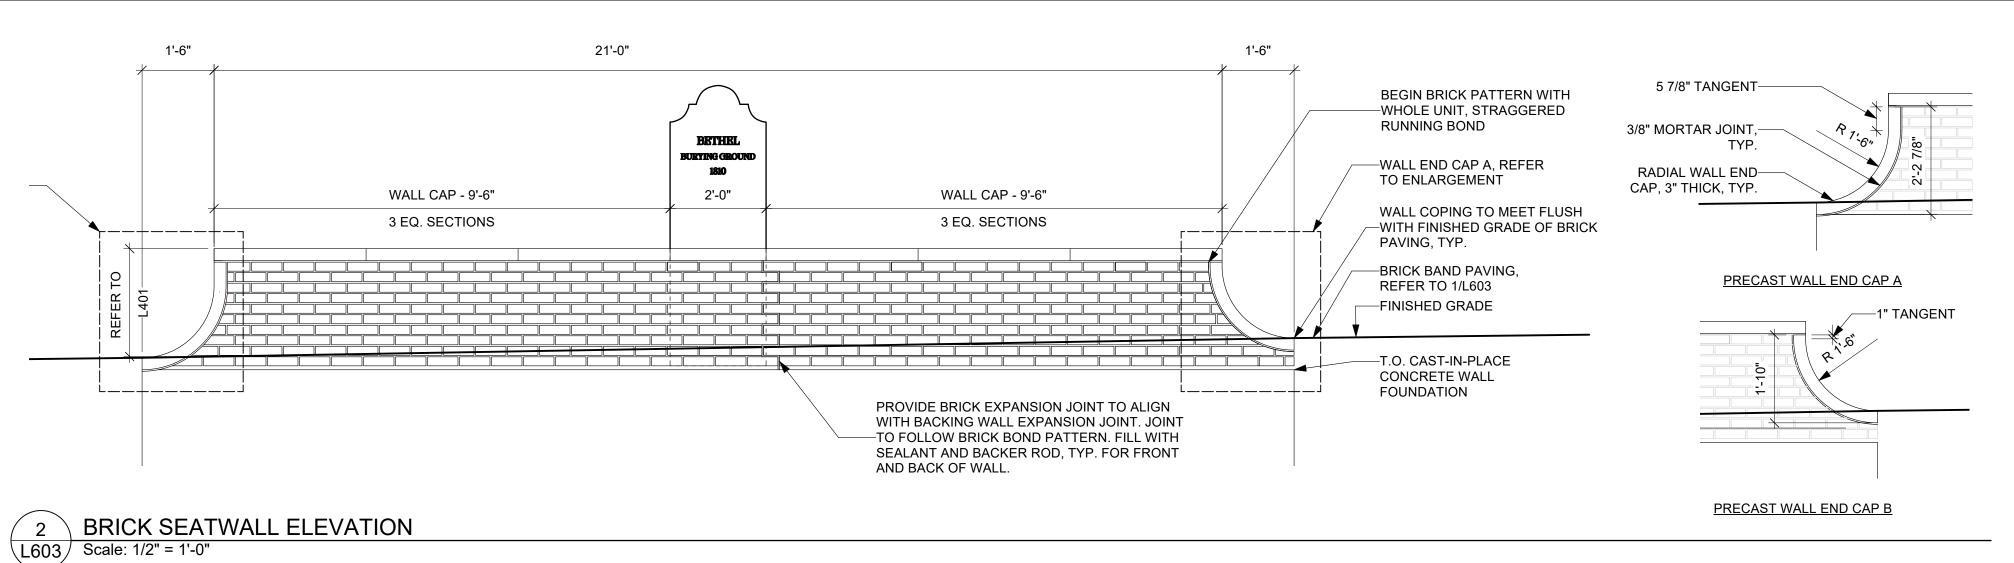


2'-0" 2 1/8" R4 1/2", TYP. -EASED EDGE, TYP. FOR ALL EDGES BETHEL -ENGRAVED GRAPHICS WITH SHADOWING, TO BE COORDINATED WITH ARTIST. VECTOR FILE WILL BE BURYING GROUND PROVIDED UPON REQUEST 1810 -3/8" JOINT WITH SEALANT AND BACKER ROD, TYP. -MARBLE SLAB, 3" THICK —CAST STONE CAP, TYP. —CIP CONCRETE BACKING WALL TOP OF SEATWALL CAP, REFER TO 2/L603 -1/2" OD x 6" S.S. DOWEL, (3) DOWELS EACH SIDE, TYP. -MONOLITHIC HAUNCH BASE OF HEADSTONE SET WITHIN WALL, TYP. BASE OF HEADSTONE SET WITHIN —1" MORTAR SETTING, TYP. WALL, TYP. EXPANSION JOINT IN CIP BACKING FRONT FACE **BACK FACE** -1/2" OD x 8" S.S. DOWEL, (2)



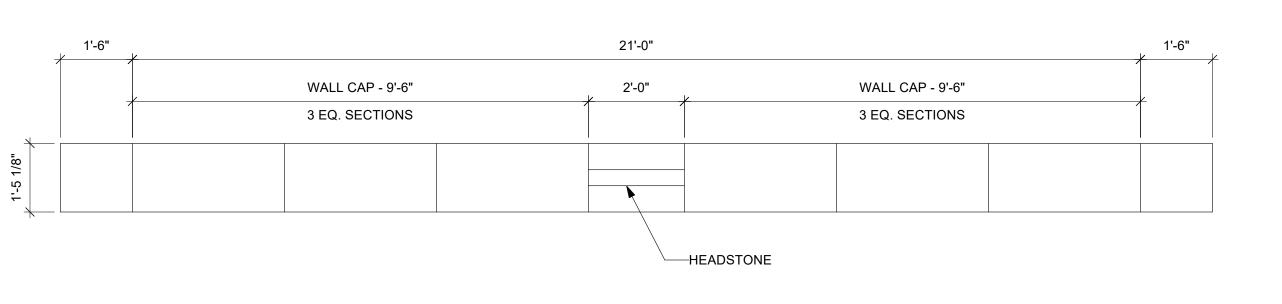

VERTICAL DOWELS IN BOTTOM OF

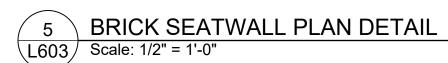

## BETHEL BURYING GROUND

## MEMORIAL PROJECT AT WECCACOE PLAYGROUND

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No. Date Revisions

Seal:

Drawn:
XD/TM
Checked:
TM
Approved:
JB
Job Number: 749

vate:

05/10/2024

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100% CONSTRUCTION DOCUMENTS


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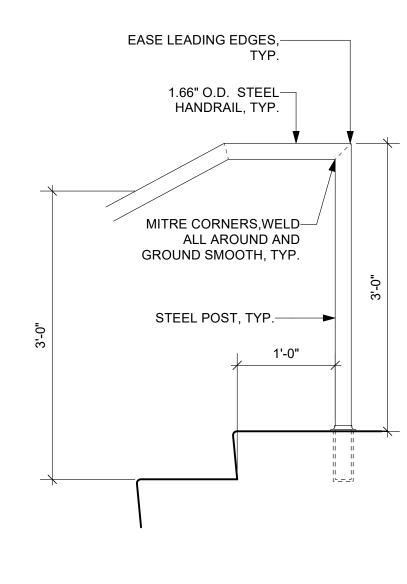
SITE DETAILS

Drawing Number:


L603

NOTES: 1.HANDRAILS AND POSTS TO BE 1-1/4" SCHEDULE 40 (1.66" O.D.) STEEL - SEE SPECIFICATIONS FOR ADDITIONAL INFORMATION. 2.HANDRAILS AND POSTS TO BE SHOP PAINTED TO MATCH GATES.



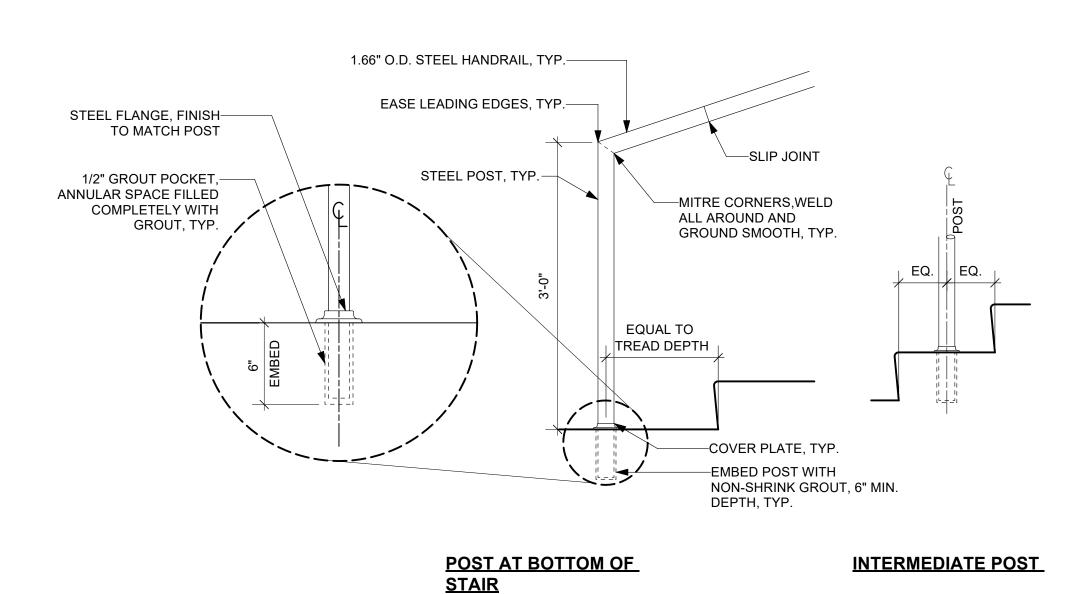



**POST AT TOP OF STAIR** 

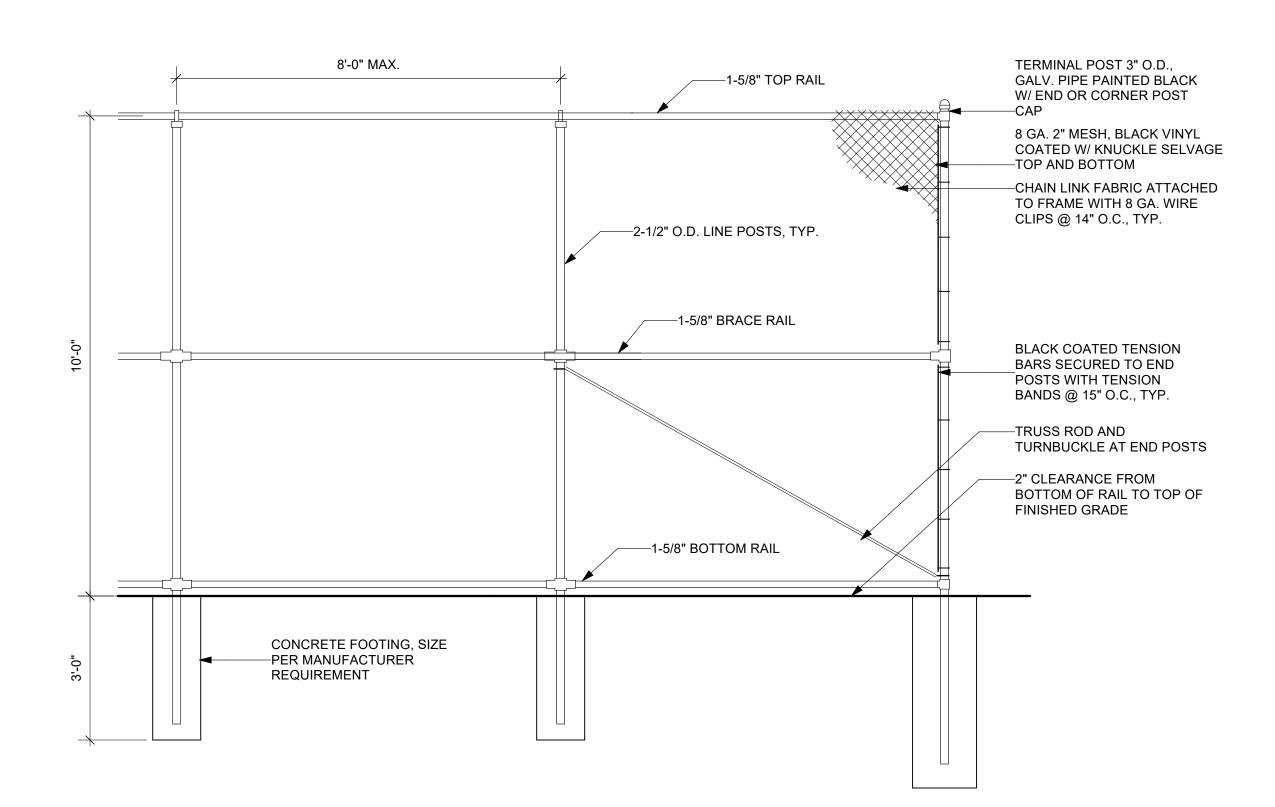






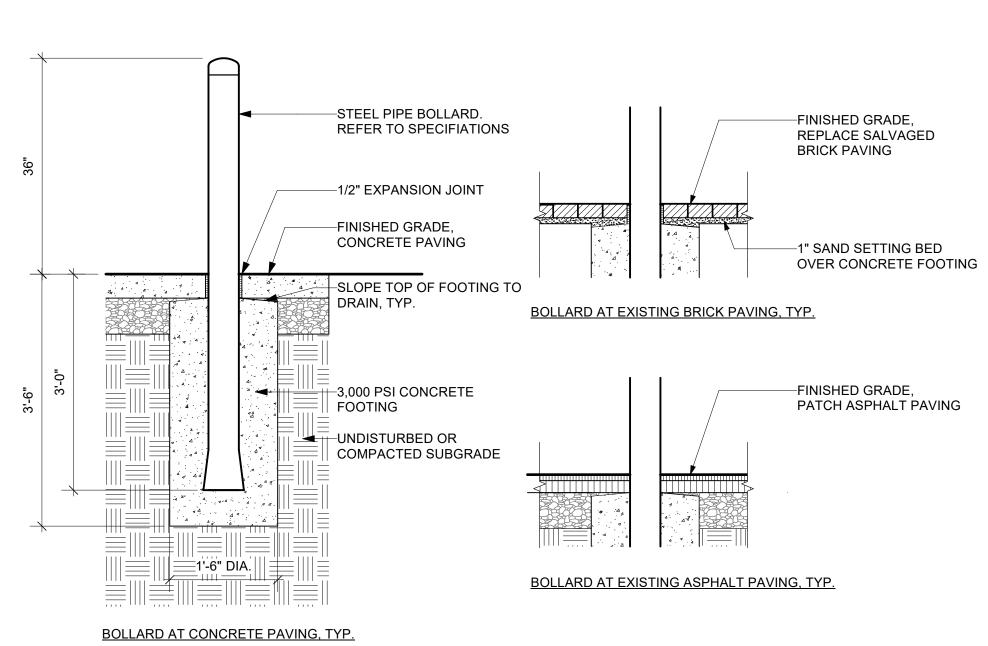


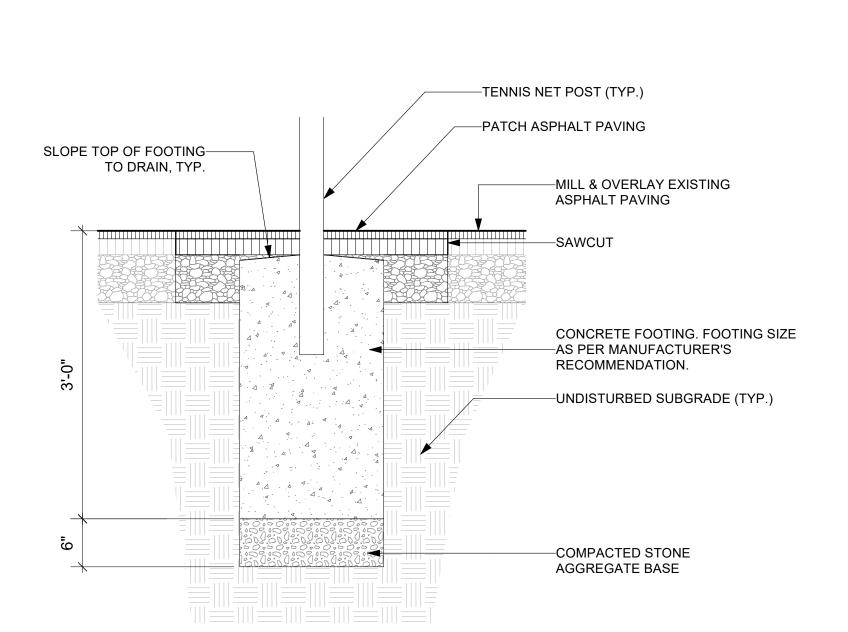


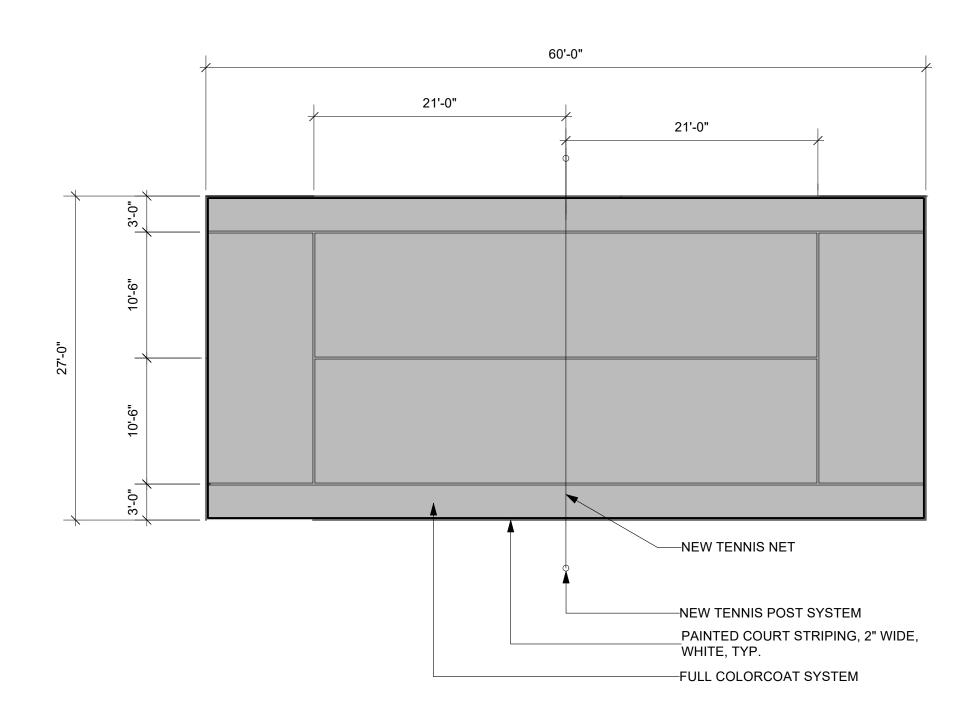



TENNIS NET POST, TYP. L604 Scale: 1" = 1'-0"

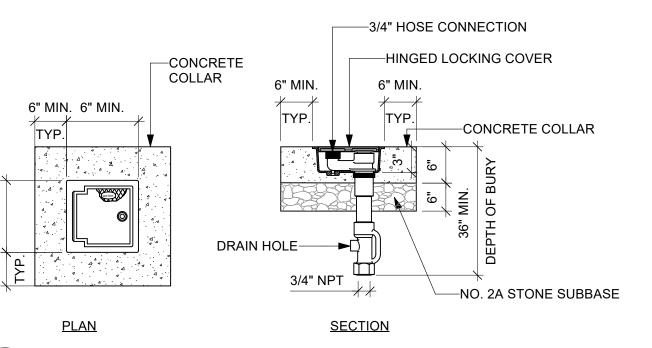

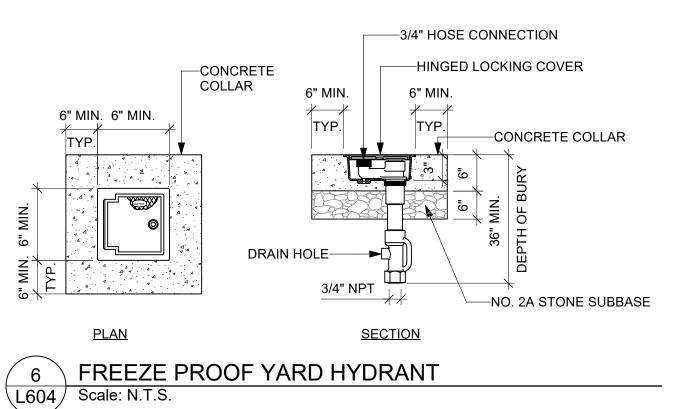

JUNIOR TENNIS COURT STRIPING, TYP. 5 JUNIOR TEN L604 Scale: 1/8" = 1'-0"

## BETHEL BURYING GROUND MEMORIAL PROJECT AT WECCACOE PLAYGROUND

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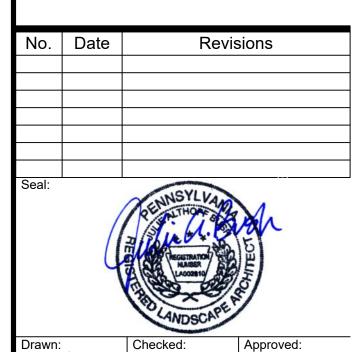
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XD/TM Job Number: 749


05/10/2024

Drawing Set: 100% CONSTRUCTION DOCUMENTS


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SITE DETAILS


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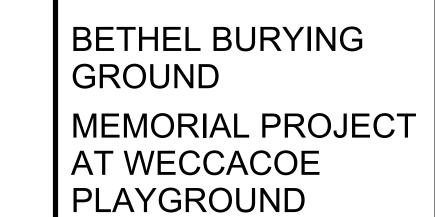




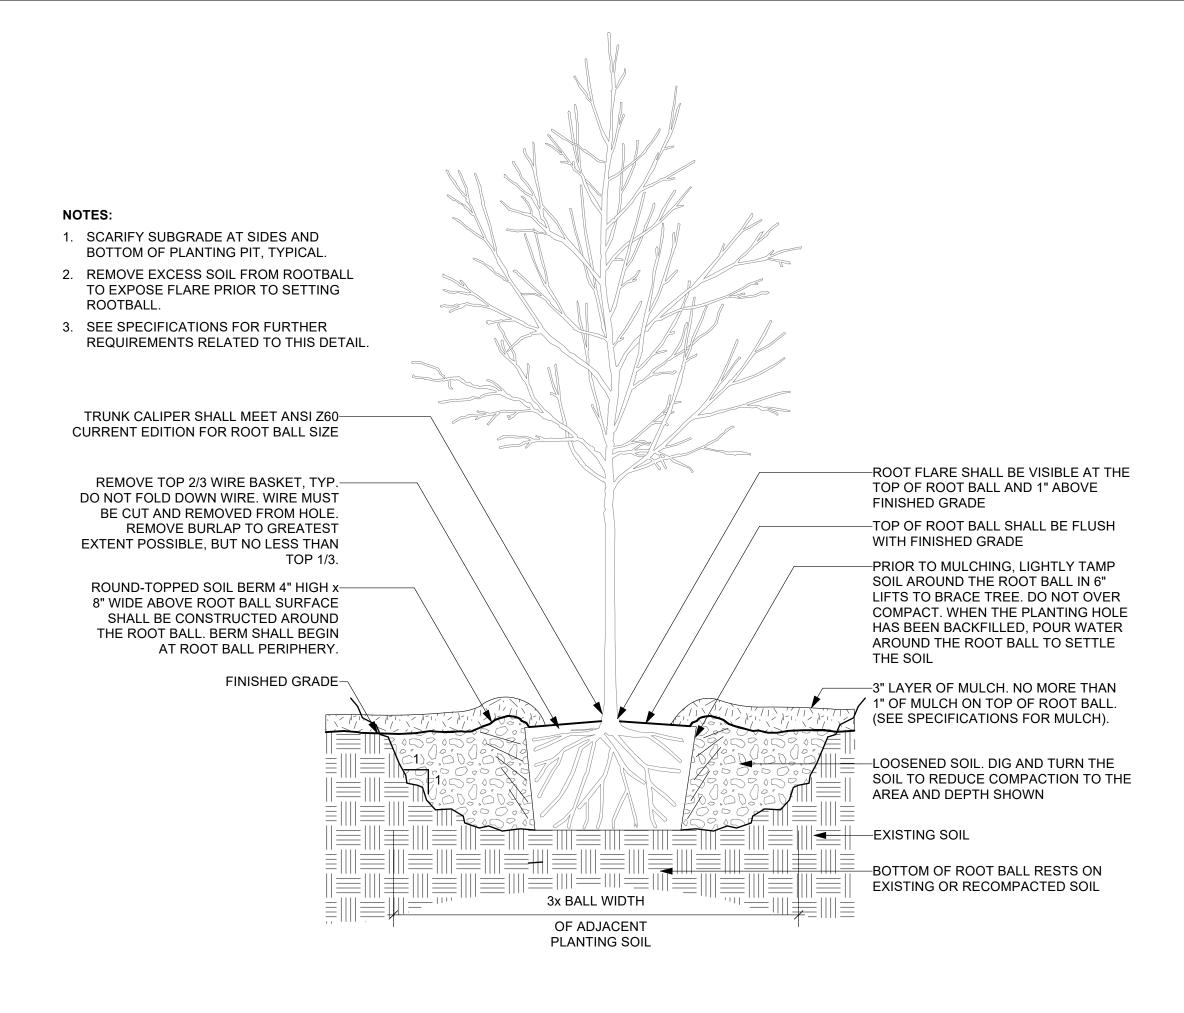



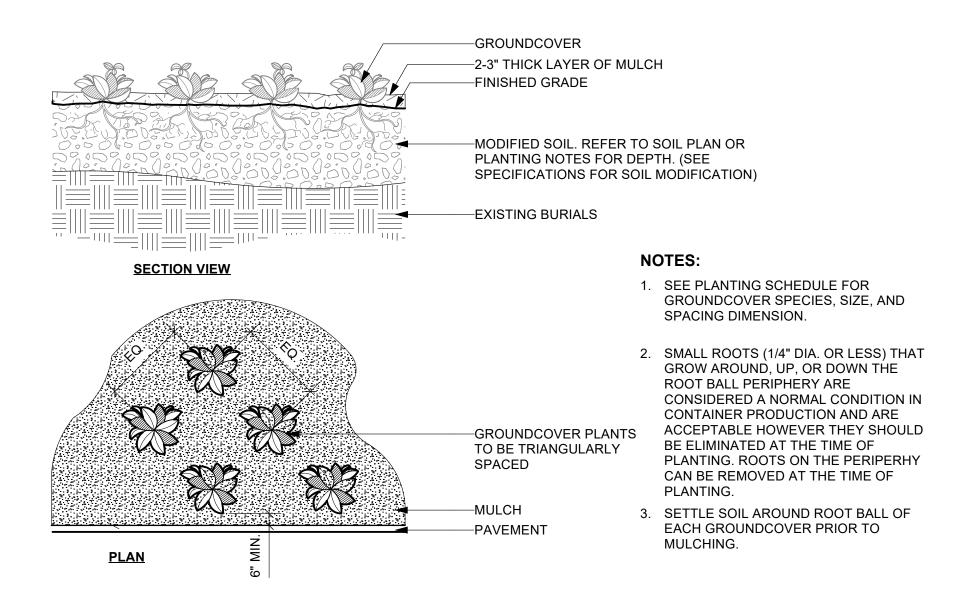

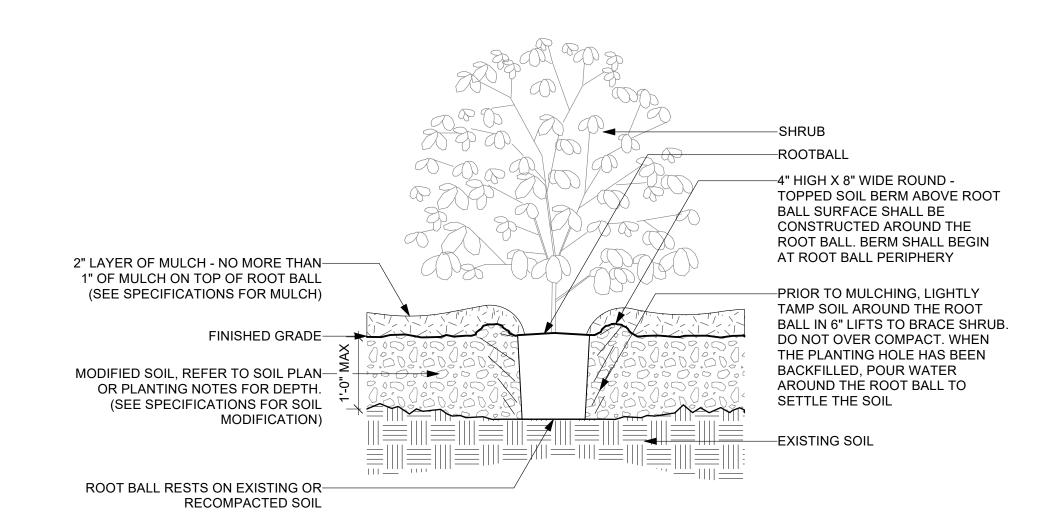

Design Team:

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No. Date Revisions

awn: Checked: Approved: JB

Job Number: 749 File:

Date: 05/40/2024

05/10/2024


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Drawing Title:

PLANTING DETAILS

100% CONSTRUCTION DOCUMENTS

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1 PLAN - BRICK PIER GATE

A2.0 1" 1'-0"
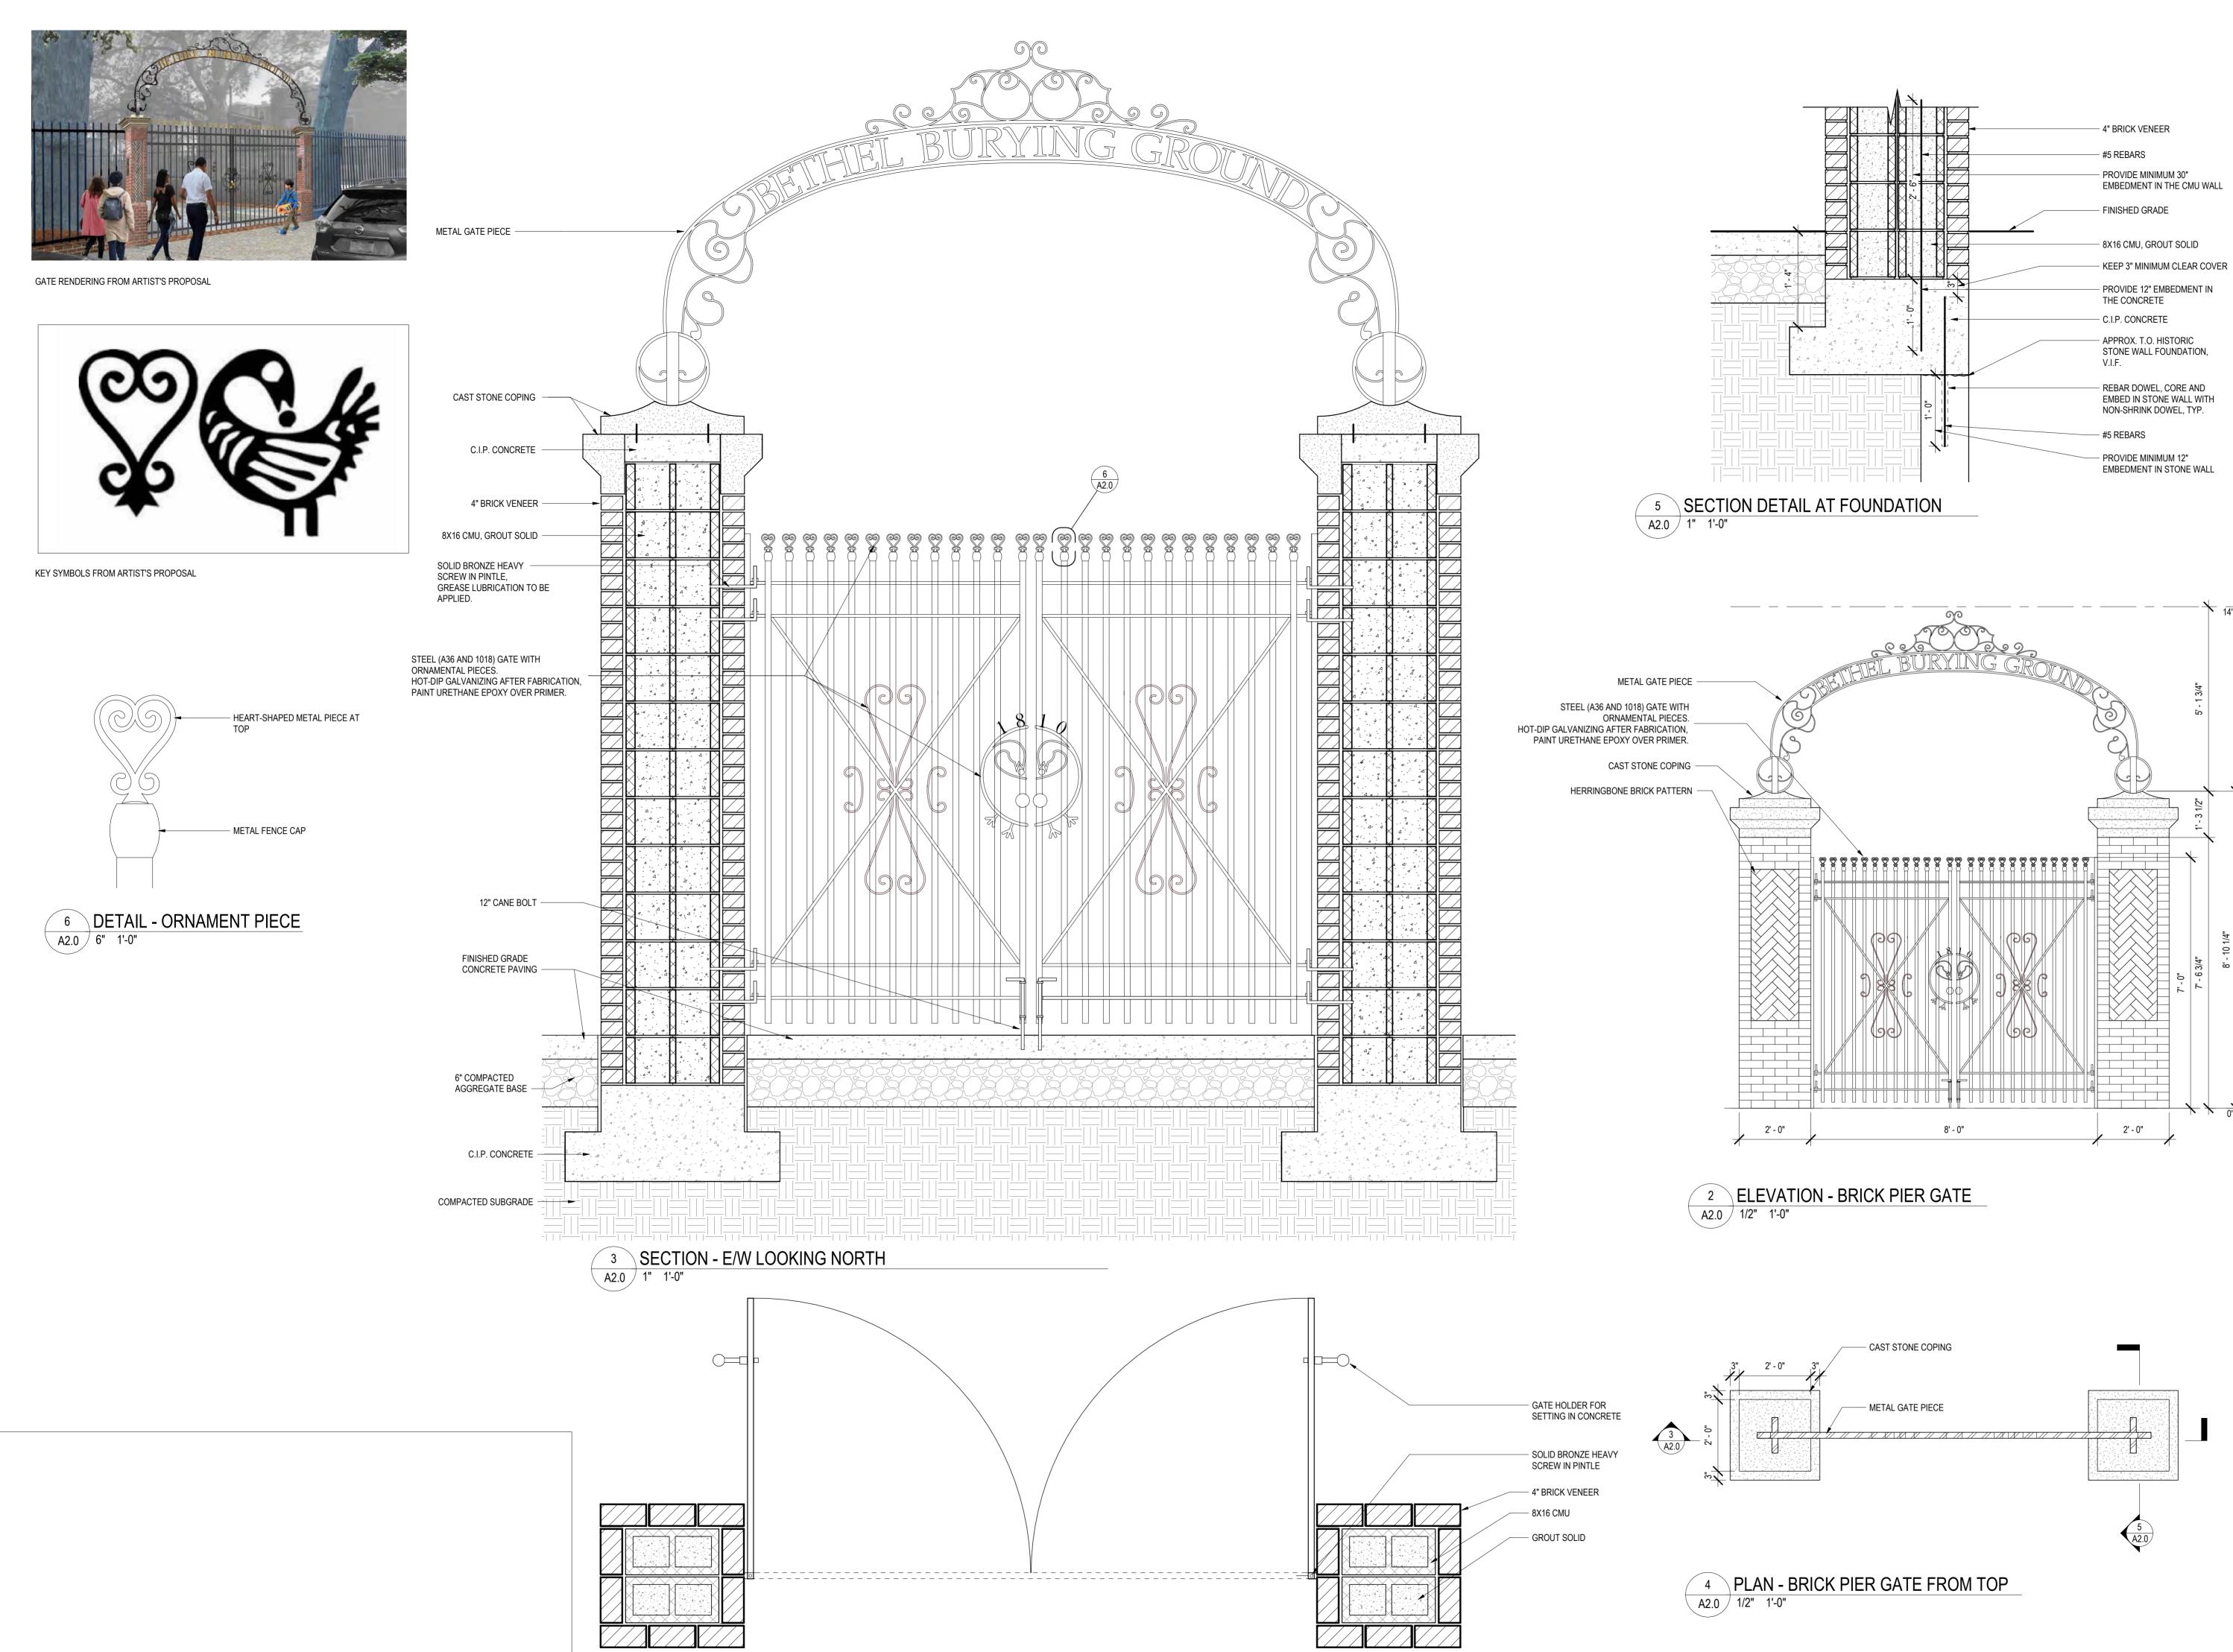
## BETHEL BURYING GROUND MEMORIAL PROJECT AT WECCACOE PLAYGROUND

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No.	Date	Revisions
0 1		

05/10/2024

100% CONSTRUCTION DOCUMENTS

Drawing Title:

DETAILS - BRICK PIERS AND GATE