





CLIENT: PHILADELPHIA PARKS & RECREATION
Rebuild PHILADELPHIA
PROJECT NAME & ADDRESS: ZIEHLER PLAYGROUND & RECREATION CENTER
200-64 E. OLNEY AVENUE PHILADELPHIA, PA 19120
PROJECT NUMBER: 16640E-01-02
PRIME CONSULTANT / LANDSCAPE ARCHITECTURE:
SALT DESIGN STUDIO LANDSCAPE ARCHITECTURE PLANNING & URBAN DESIGN
161 LEVERINGTON AVE, SUITE 1005 PHILADELPHIA, PA 19127 www.saltdesignstudio.com
CIVIL ENGINEERING: MELIORA DESIGN 259 MORGAN STREET PHOENIXVILLE, PA 19460 www.melioradesign.com
ARCHITECTURE: IAN SMITH DESIGN GROUP 322 E. THOMPSON STREET PHILADELPHIA, PA 19125
WWW.is-dg.com
www.millerdesigngrouplighting.com MEP DESIGN: MARK ULRICK ENGINEERS, INC. 622 COOPER STREET, #200
CAMDEN, NJ 08102 www.markulrick.com structural engineering: D'HUY ENGINEERING, INC.
1 EAST BROAD STREET, SUITE 310 BETHLEHEM, PA 18018 www.dhuy.com
BIDDING
SEAL:
PAVING DETAILS
REV DATE DESCRIPTION
SCALE: AS NOTED
DATE: 08/15/2022 CHECKED BY: SPS SHEET NUMBER:
L-501
SALT DESIGN STUDIO FILE NO.: 2003

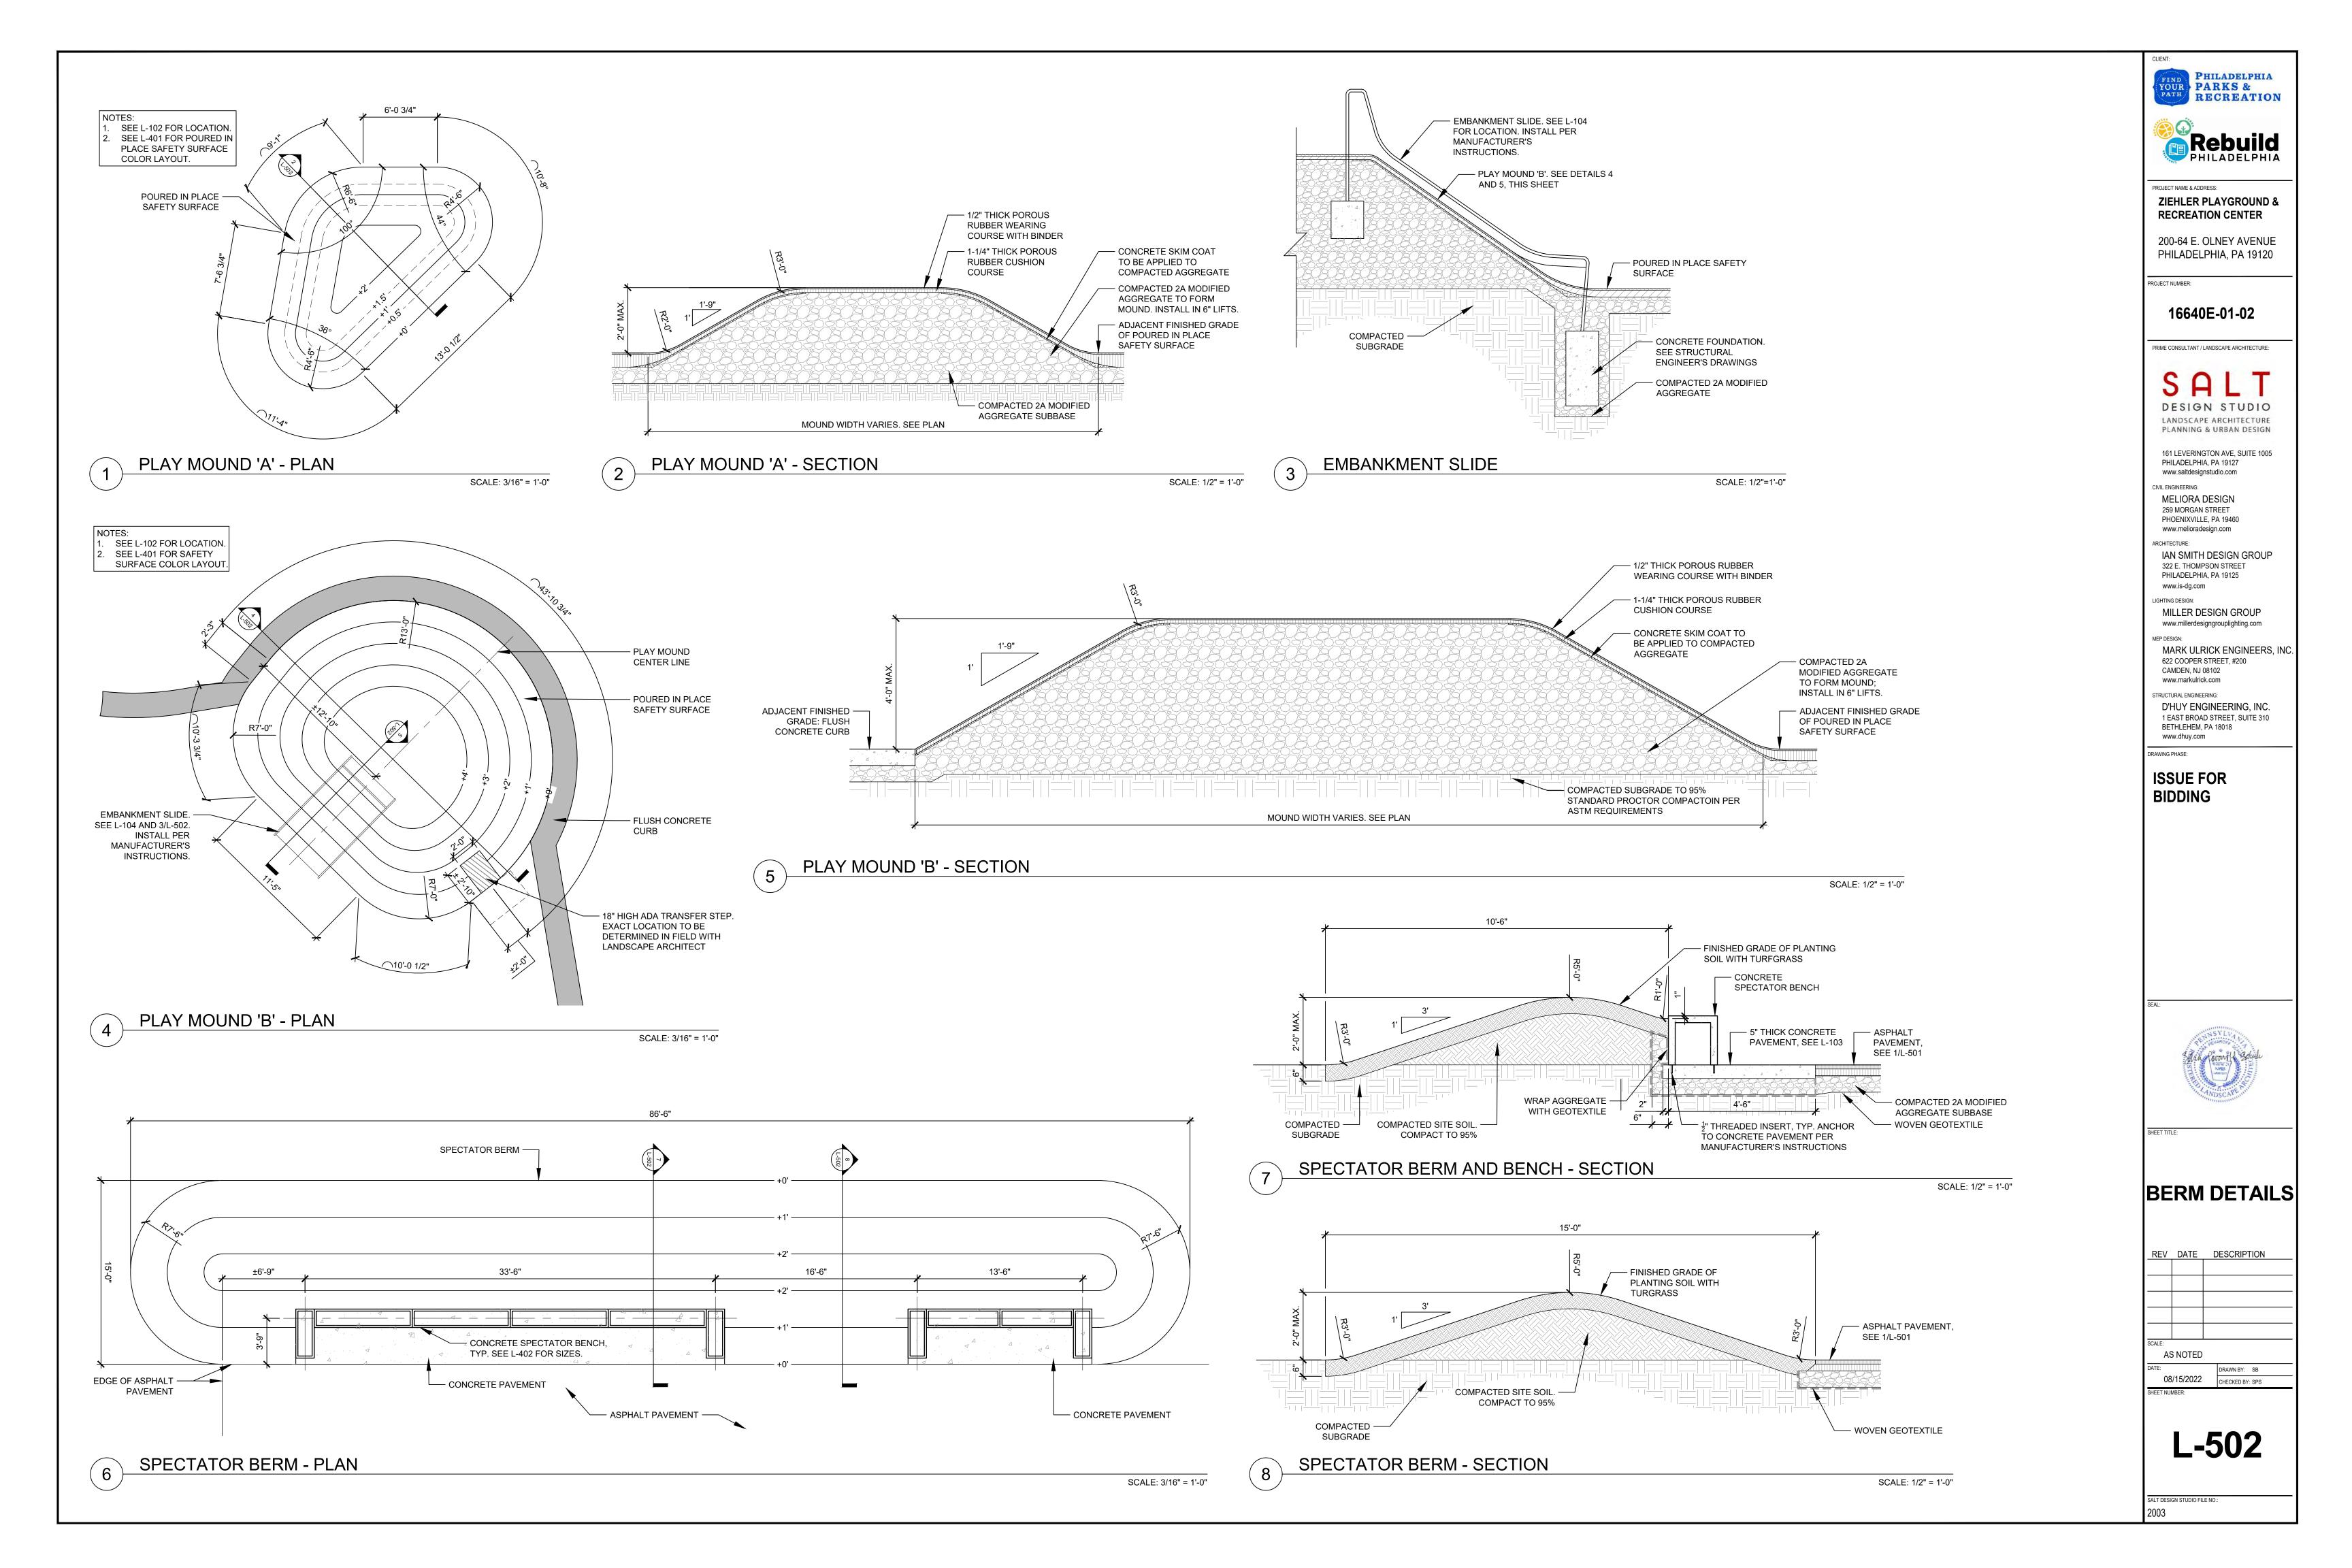


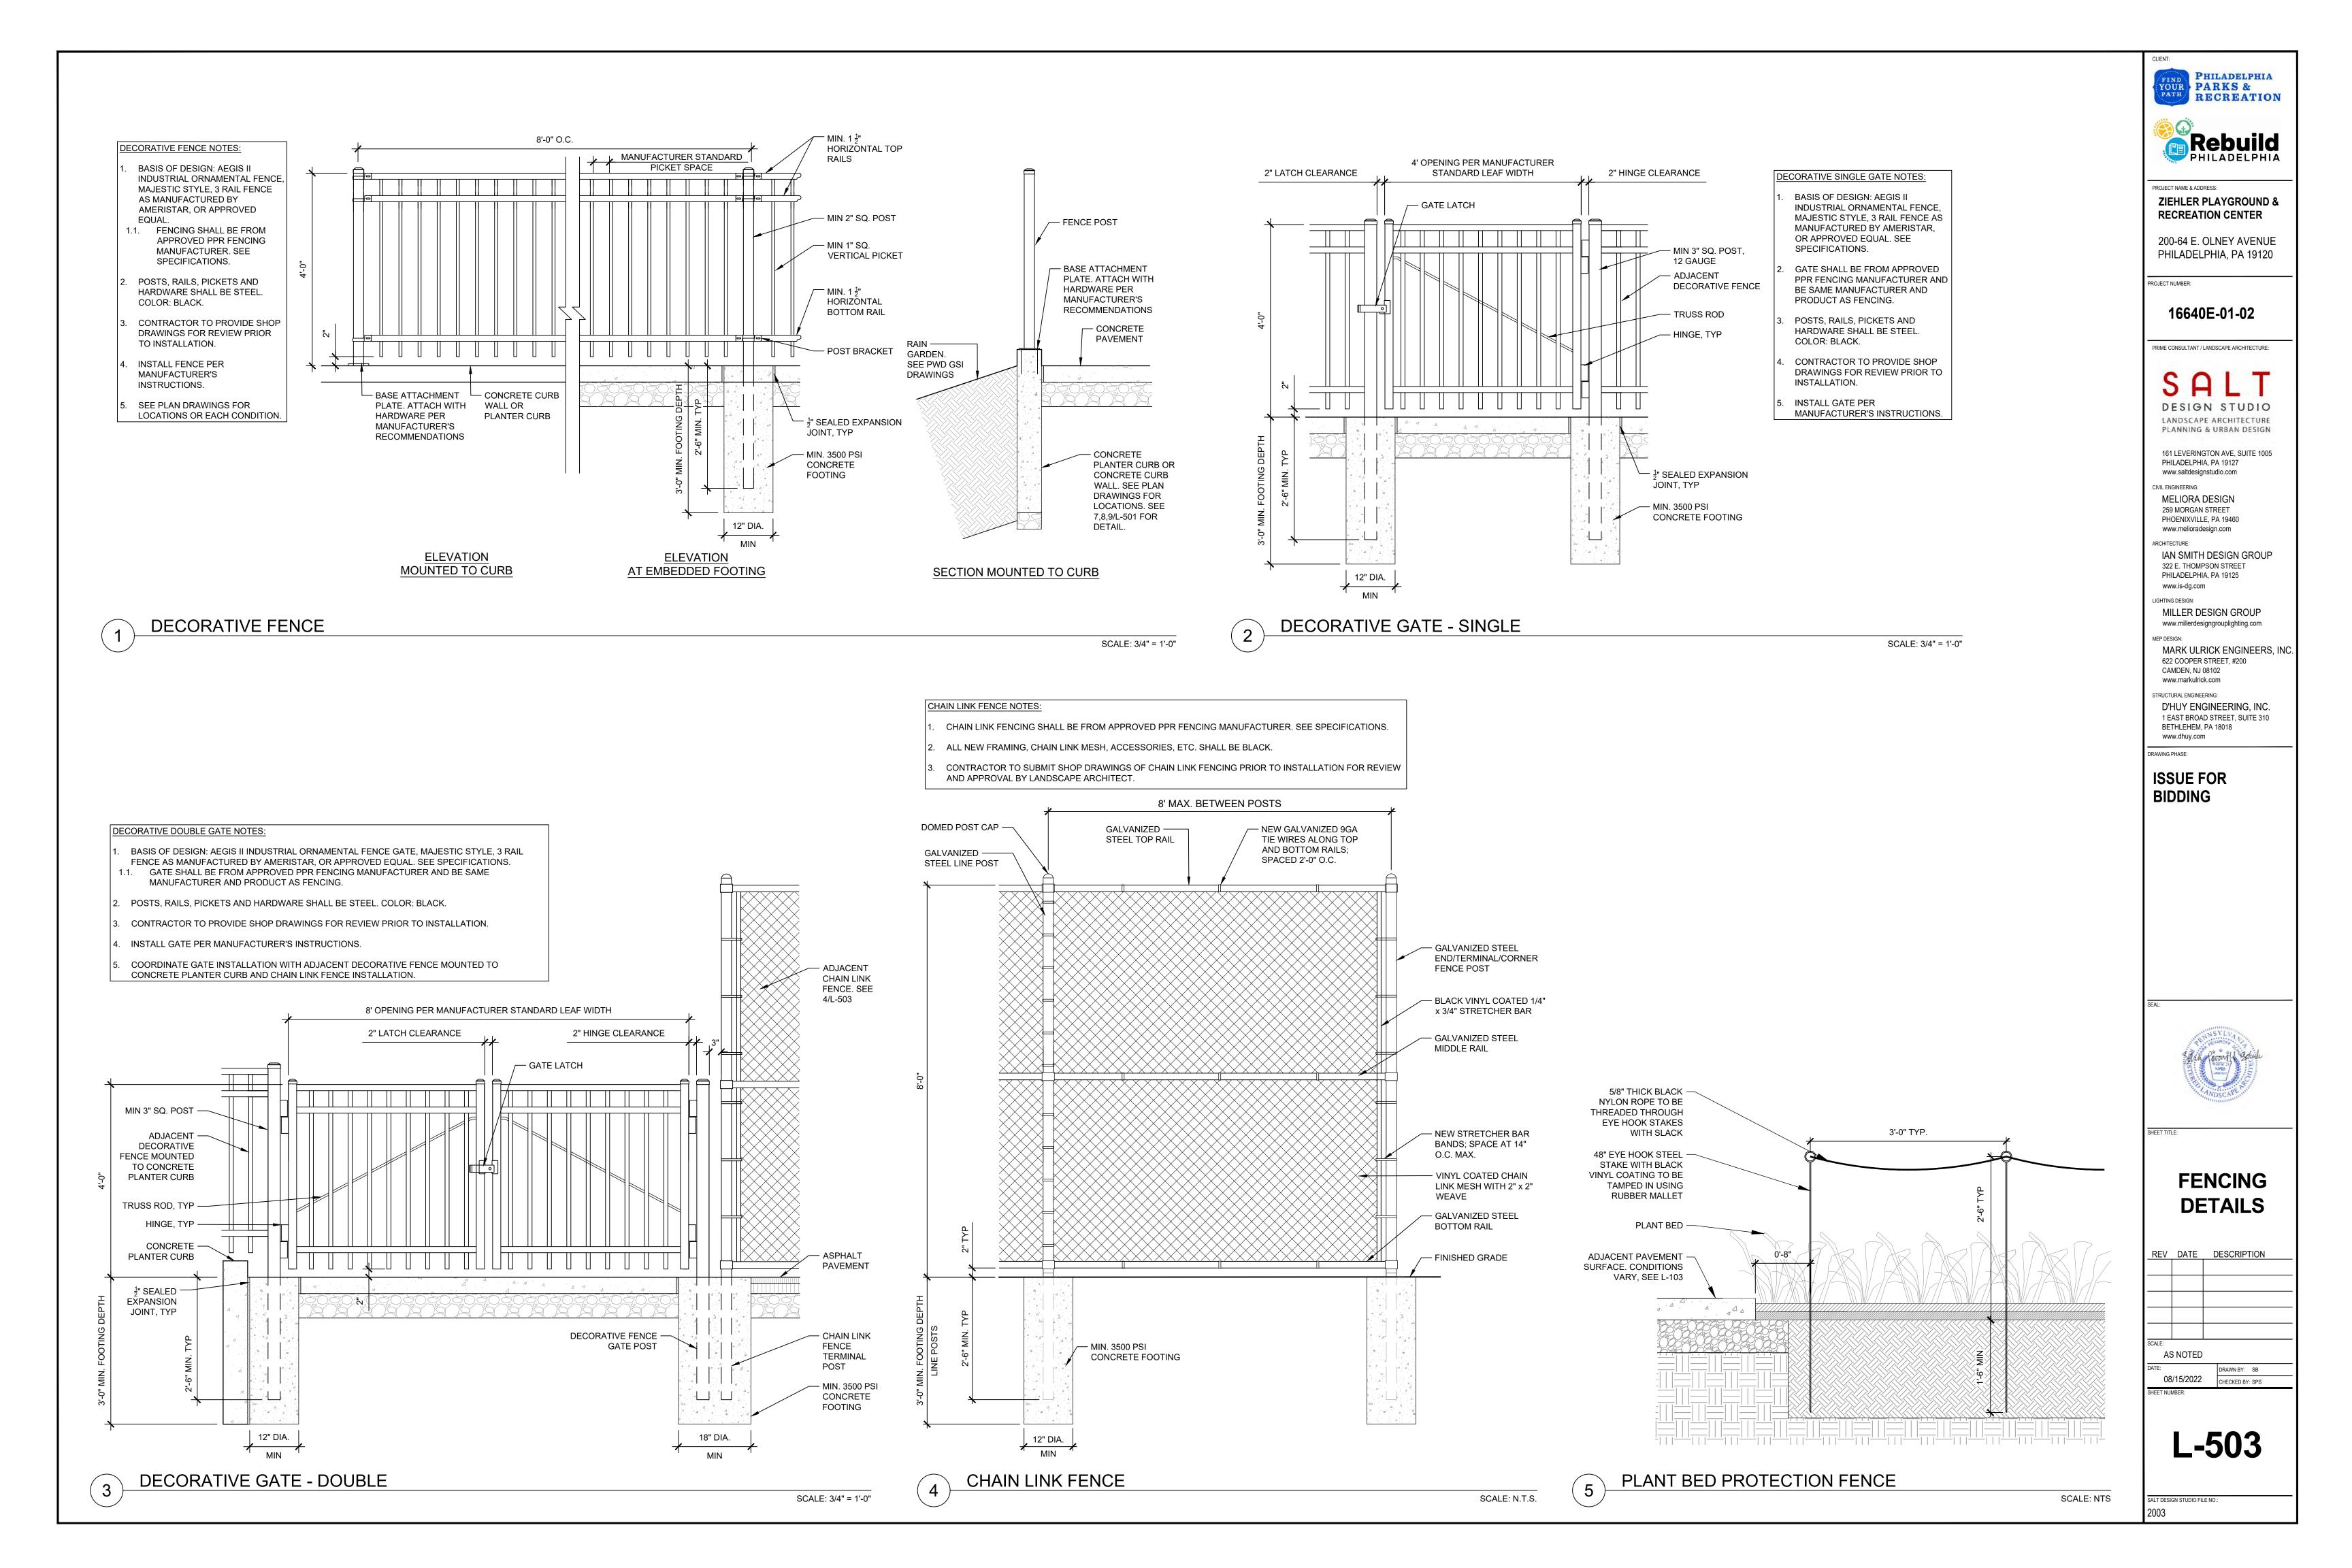

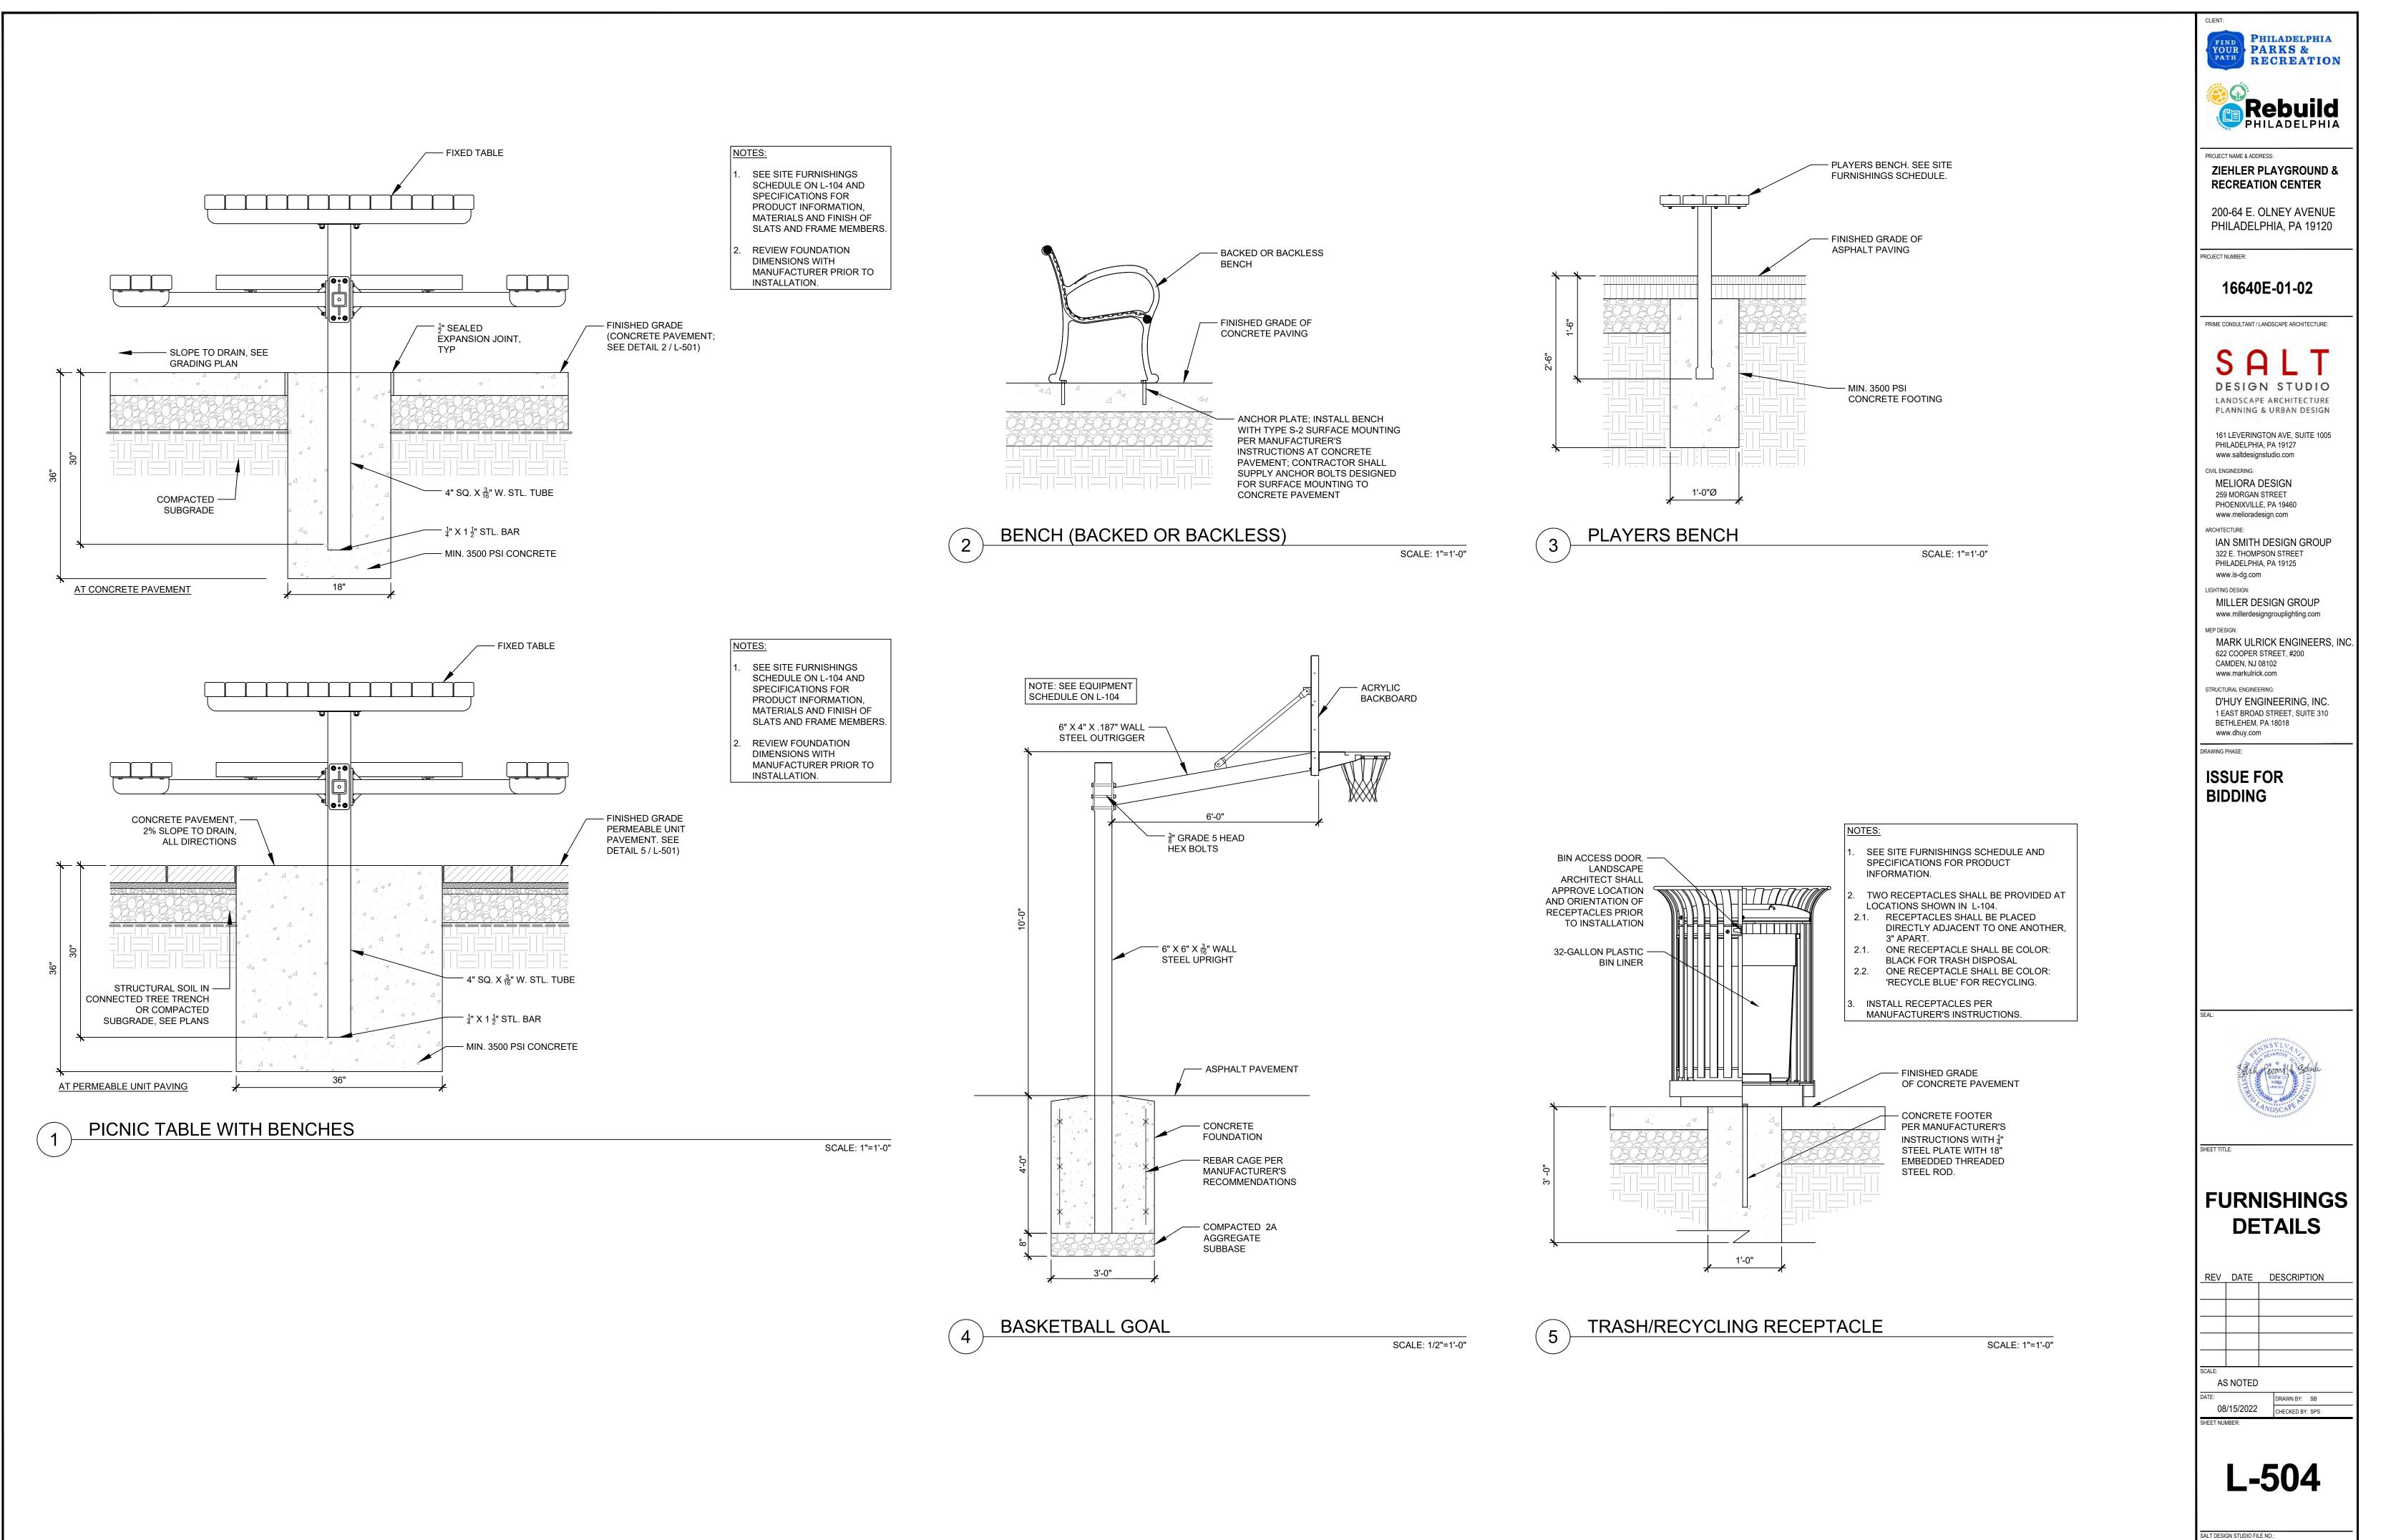

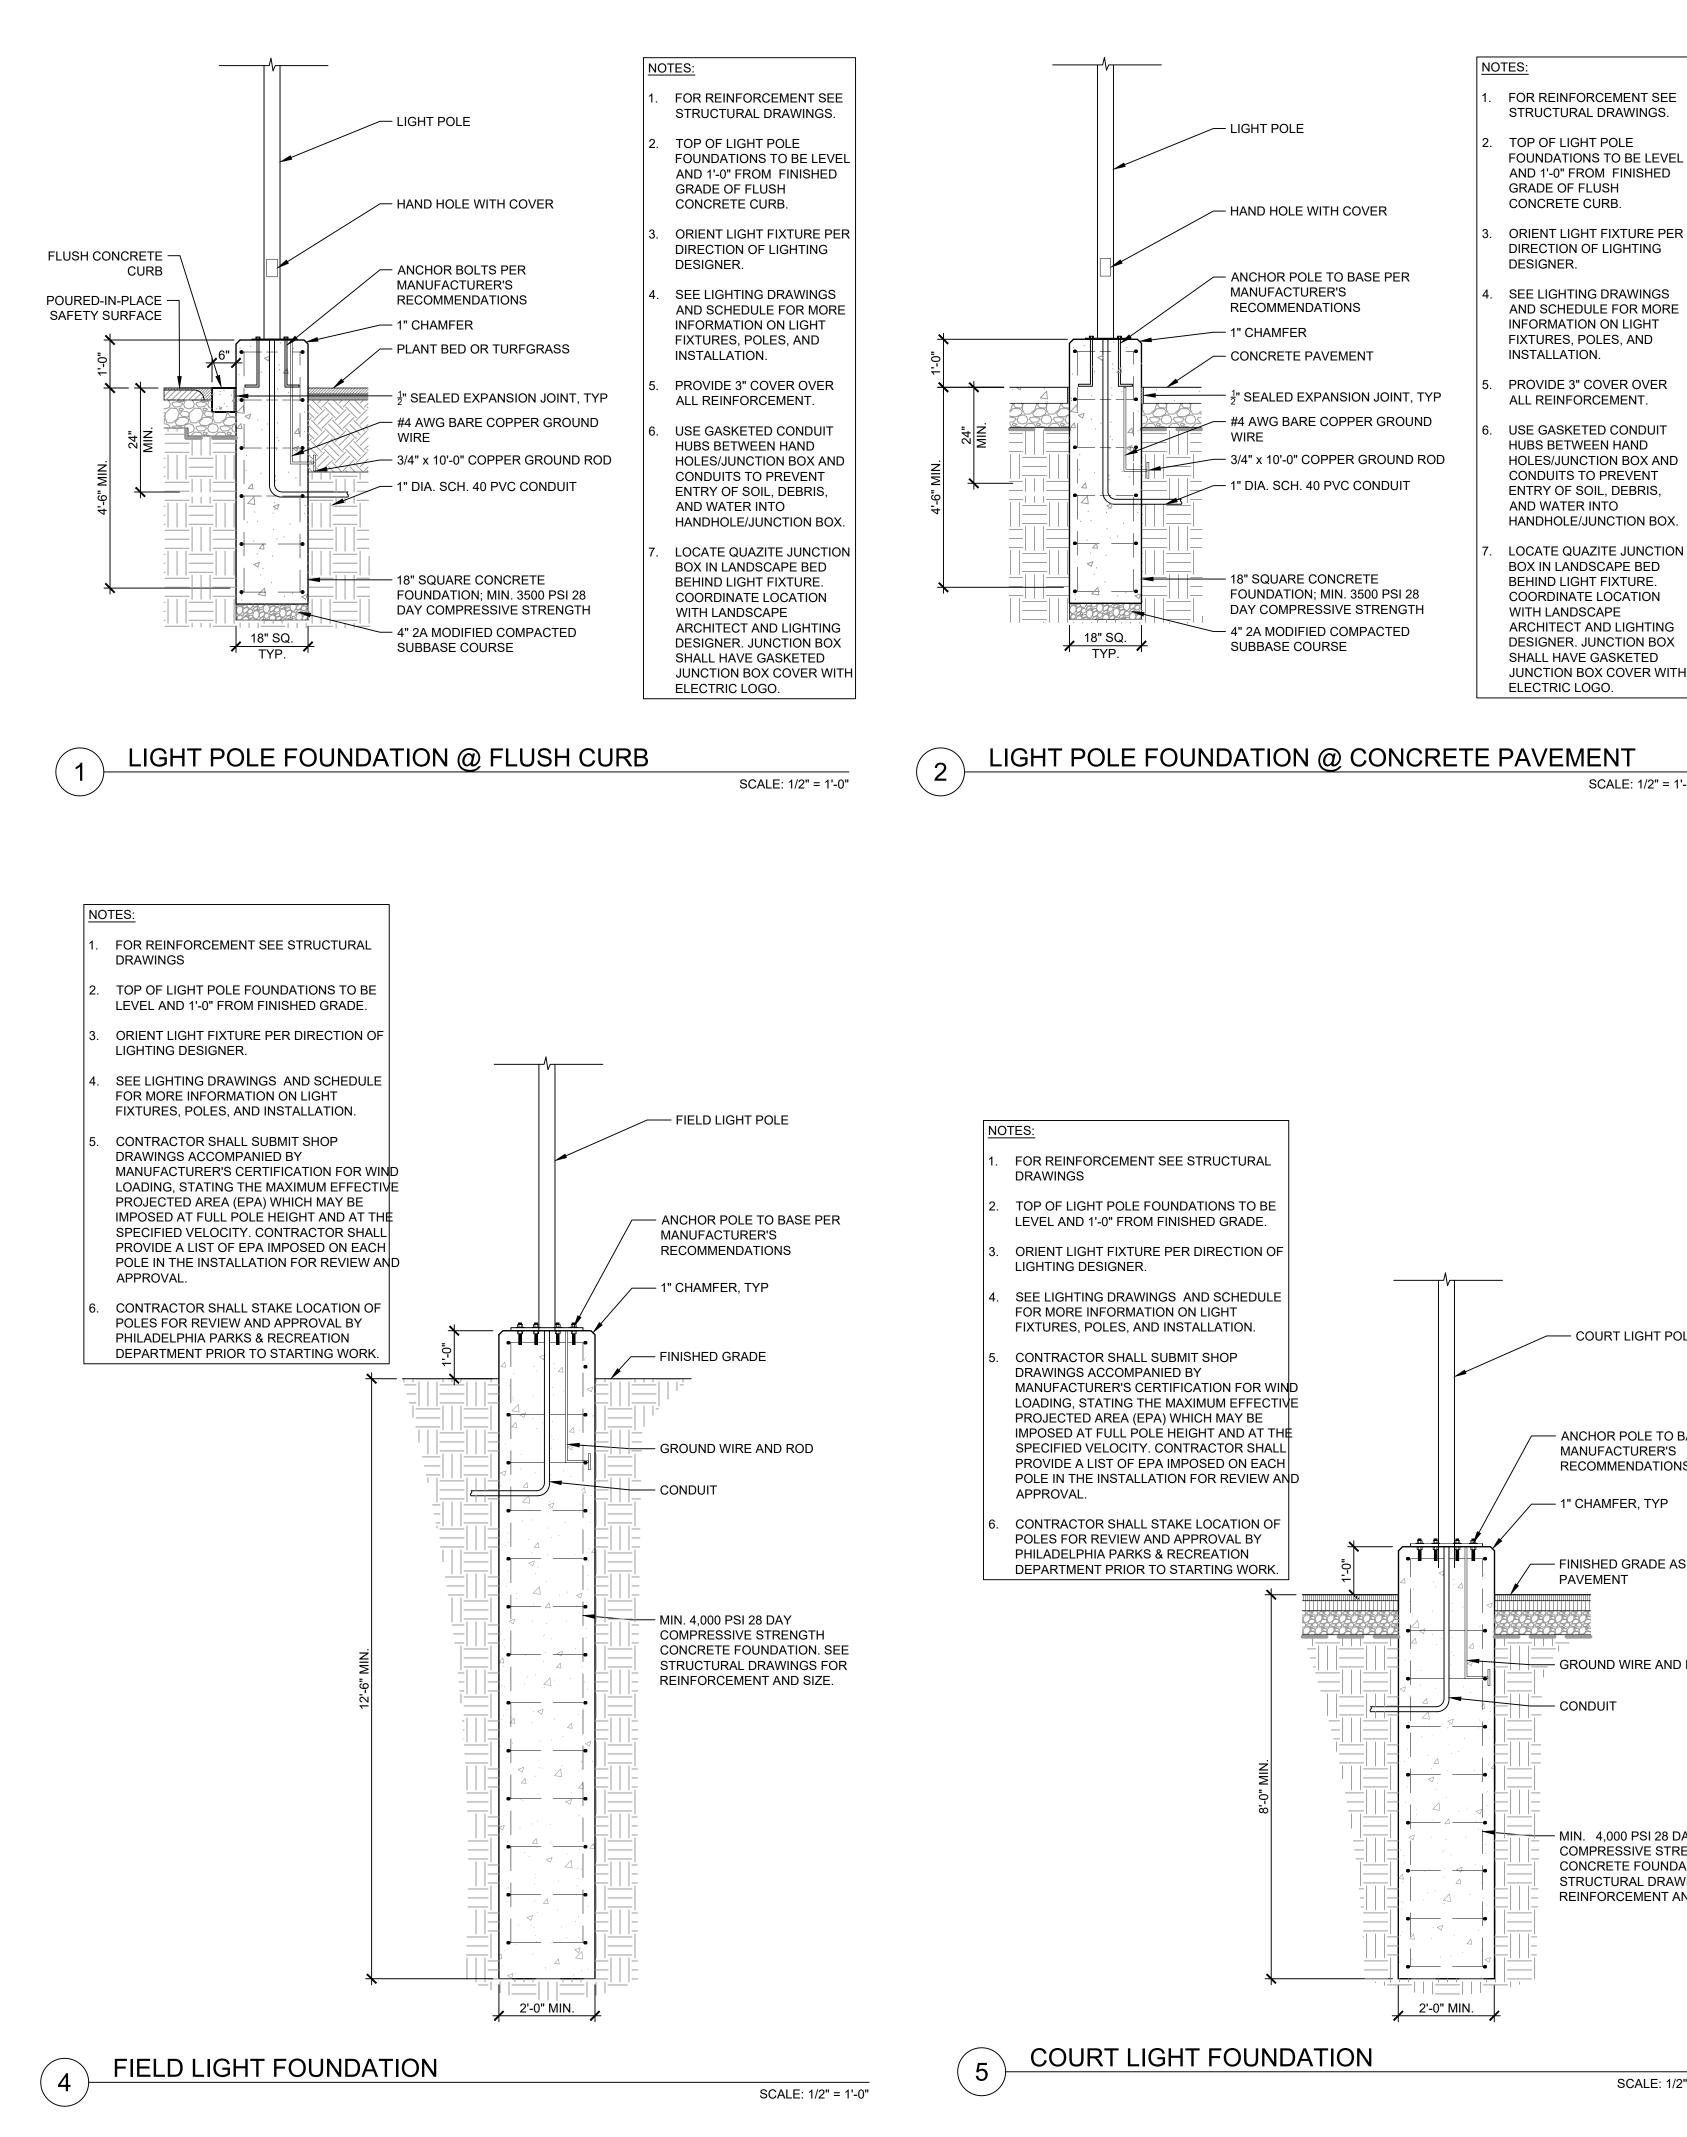

SCALE: 1/2" = 1'-0"

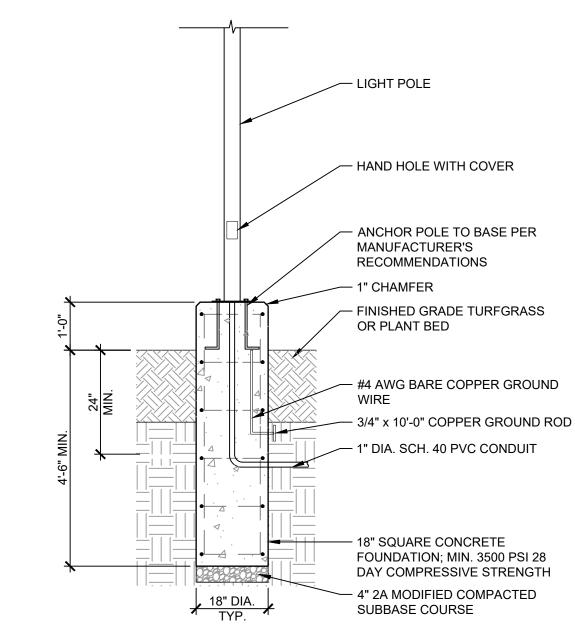

LIGHT POLE FOUNDATION @ PLANT BED 3

- COURT LIGHT POLE - ANCHOR POLE TO BASE PER MANUFACTURER'S RECOMMENDATIONS — 1" CHAMFER, TYP - GROUND WIRE AND ROD – MIN. 4,000 PSI 28 DAY COMPRESSIVE STRENGTH CONCRETE FOUNDATION. SEE STRUCTURAL DRAWINGS FOR REINFORCEMENT AND SIZE.

SCALE: 1/2" = 1'-0"

<u>NO</u>	TES:
1.	FOR REINFORCEMENT SEE STRUCTURAL DRAWINGS.
2.	TOP OF LIGHT POLE FOUNDATIONS TO BE LEVEL AND 1'-0" FROM FINISHED GRADE OF FLUSH CONCRETE CURB.
3.	ORIENT LIGHT FIXTURE PER DIRECTION OF LIGHTING DESIGNER.
4.	SEE LIGHTING DRAWINGS AND SCHEDULE FOR MORE INFORMATION ON LIGHT FIXTURES, POLES, AND INSTALLATION.
5.	PROVIDE 3" COVER OVER ALL REINFORCEMENT.
6.	USE GASKETED CONDUIT HUBS BETWEEN HAND HOLES/JUNCTION BOX AND CONDUITS TO PREVENT ENTRY OF SOIL, DEBRIS, AND WATER INTO HANDHOLE/JUNCTION BOX.
7.	LOCATE QUAZITE JUNCTION BOX IN LANDSCAPE BED BEHIND LIGHT FIXTURE. COORDINATE LOCATION WITH LANDSCAPE ARCHITECT AND LIGHTING

SCALE: 1/2" = 1'-0"

DESIGNER. JUNCTION BOX


JUNCTION BOX COVER WITH

SHALL HAVE GASKETED

ELECTRIC LOGO.

CLIENT: PHILADELPHIA PARKS & PATH RECREATION
PROJECT NAME & ADDRESS: ZIEHLER PLAYGROUND & RECREATION CENTER
200-64 E. OLNEY AVENUE PHILADELPHIA, PA 19120
PROJECT NUMBER:
16640E-01-02
PRIME CONSULTANT / LANDSCAPE ARCHITECTURE:
SALT DESIGN STUDIO LANDSCAPE ARCHITECTURE PLANNING & URBAN DESIGN
161 LEVERINGTON AVE, SUITE 1005 PHILADELPHIA, PA 19127 www.saltdesignstudio.com civil Engineering:
MELIORA DESIGN 259 MORGAN STREET PHOENIXVILLE, PA 19460 www.melioradesign.com
ARCHITECTURE: IAN SMITH DESIGN GROUP 322 E. THOMPSON STREET PHILADELPHIA, PA 19125 www.is-dg.com
LIGHTING DESIGN: MILLER DESIGN GROUP www.millerdesigngrouplighting.com
MARK ULRICK ENGINEERS, INC. 622 COOPER STREET, #200 CAMDEN, NJ 08102 www.markulrick.com
STRUCTURAL ENGINEERING: D'HUY ENGINEERING, INC. 1 EAST BROAD STREET, SUITE 310 BETHLEHEM, PA 18018 www.dhuy.com
DRAWING PHASE:
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2003

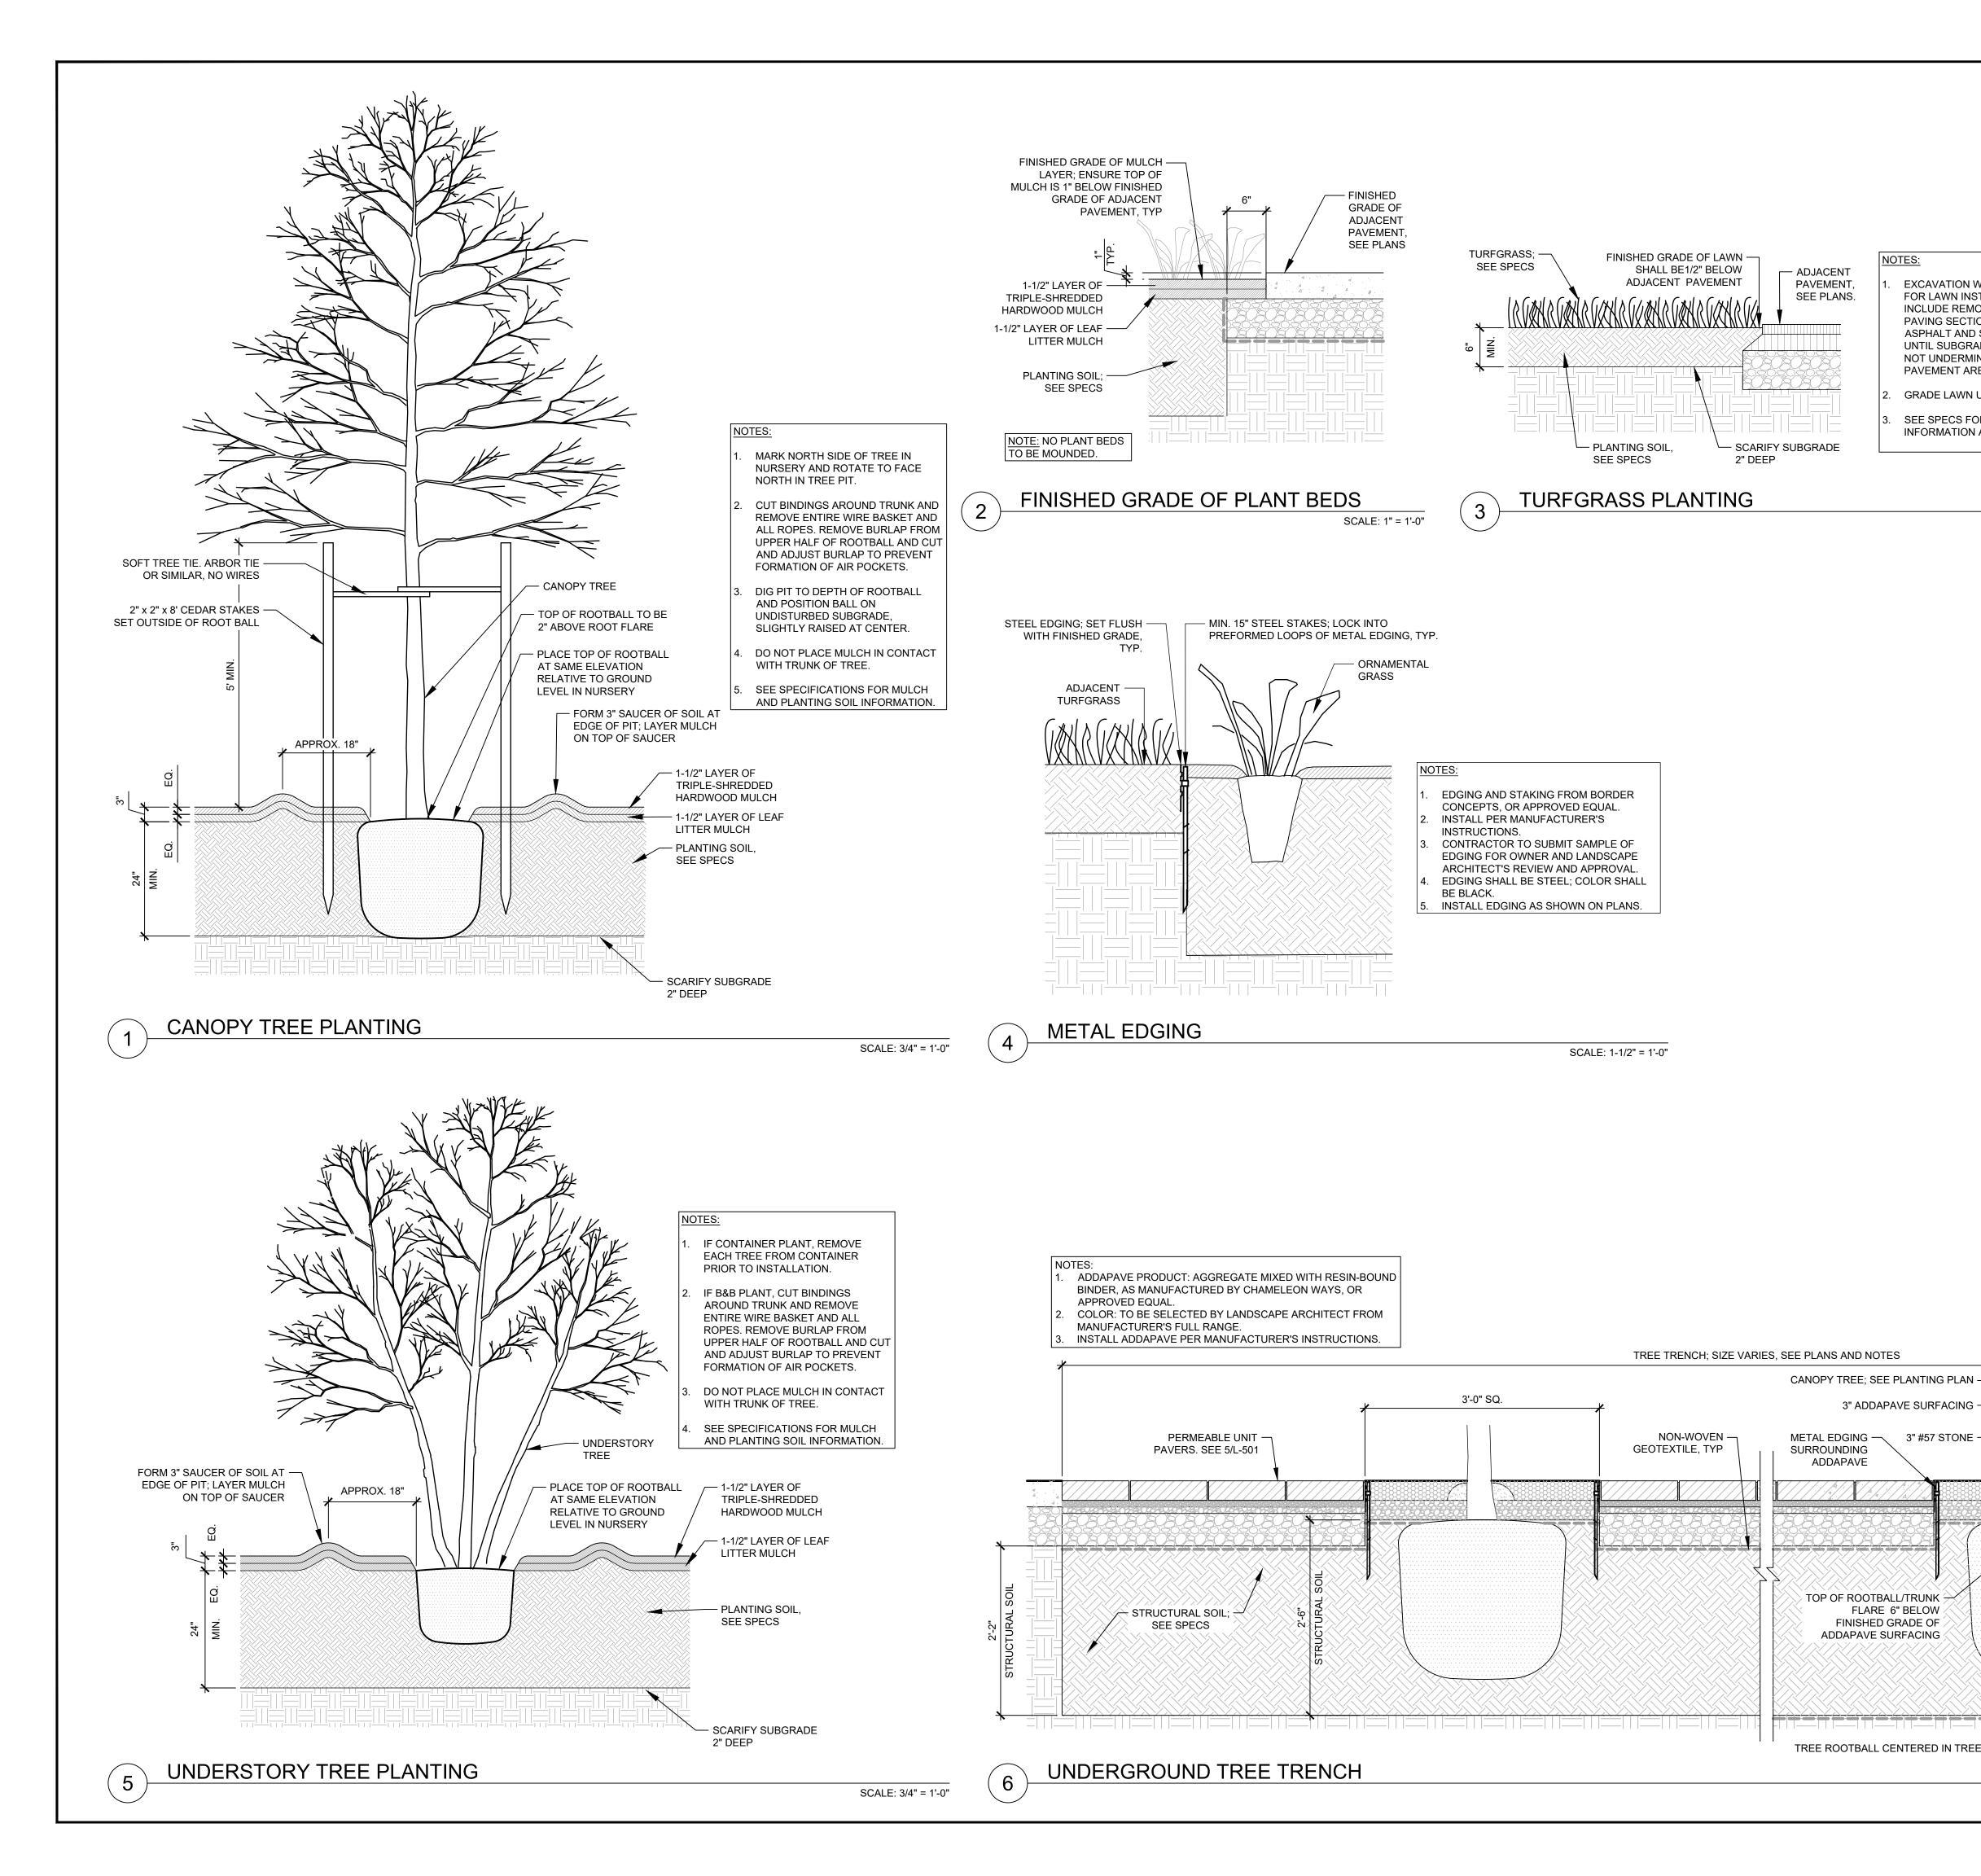

EXCAVATION WITHIN DEPAVED AREAS FOR LAWN INSTALLATION SHALL INCLUDE REMOVAL OF ENTIRE PAVING SECTION INCLUDING ASPHALT AND SUBBASE MATERIAL UNTIL SUBGRADE IS REACHED. DO NOT UNDERMINE CURBS OR PAVEMENT AREAS TO REMAIN.


GRADE LAWN UNIFORMLY.

SEE SPECS FOR PLANTING SOIL INFORMATION AND SEED MIX.

SCALE: 1" = 1'-0"

PHILADELPHIA PARKS & RECREATION Rebuild PROJECT NAME & ADDRESS: ZIEHLER PLAYGROUND & **RECREATION CENTER** 200-64 E. OLNEY AVENUE PHILADELPHIA, PA 19120 ROJECT NUMBER: 16640E-01-02 PRIME CONSULTANT / LANDSCAPE ARCHITECTURE: SAL DESIGN STUDIO LANDSCAPE ARCHITECTURE PLANNING & URBAN DESIGN 161 LEVERINGTON AVE, SUITE 1005 PHILADELPHIA, PA 19127 www.saltdesignstudio.com CIVIL ENGINEERING: MELIORA DESIGN 259 MORGAN STREET PHOENIXVILLE, PA 19460 www.melioradesign.com ARCHITECTURE: IAN SMITH DESIGN GROUP 322 E. THOMPSON STREET PHILADELPHIA, PA 19125 www.is-dg.com IGHTING DESIGN: MILLER DESIGN GROUP www.millerdesigngrouplighting.com MEP DESIGN: MARK ULRICK ENGINEERS, INC. 622 COOPER STREET, #200 CAMDEN, NJ 08102 www.markulrick.com STRUCTURAL ENGINEERING: D'HUY ENGINEERING, INC. 1 EAST BROAD STREET, SUITE 310 BETHLEHEM, PA 18018 www.dhuy.com RAWING PHASE: **ISSUE FOR** BIDDING

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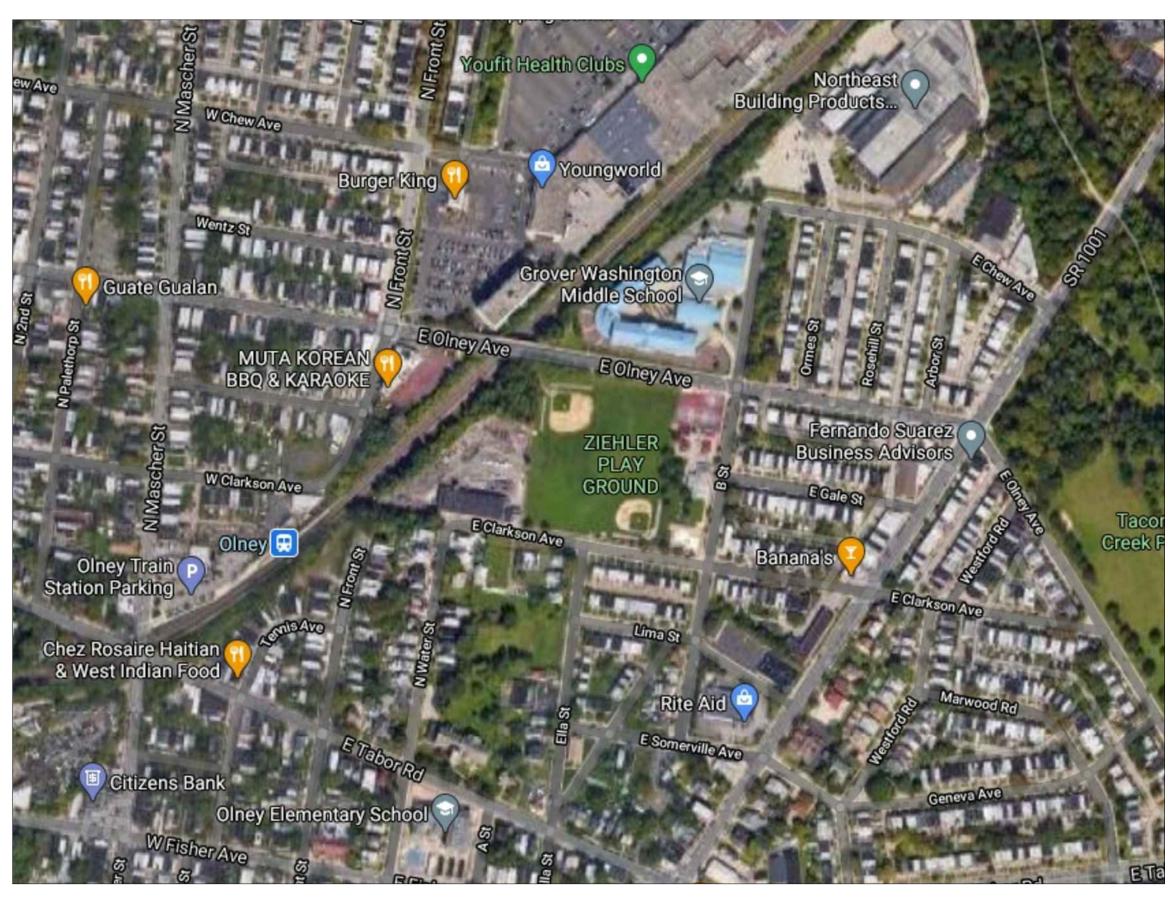
SHEET INDEX		
SHEET NO.	TITLE	
T-1	PWD INDEX SHEET	
G-1	STORMWATER AND GRADING PLAN	
G-2	STORMWATER PROFILES - SHEET 1	
G-3	STORMWATER PROFILES - SHEET 2	
G-4	STORMWATER PROFILES - SHEET 3	
G-5	STORMWATER PROFILES - SHEET 4	
G-6	STORMWATER DETAILS - SHEET 1	
G-7	STORMWATER DETAILS - SHEET 2	
G-8	STORMWATER DETAILS - SHEET 3	
G-9	STORMWATER NOTES	
L-1	LANDSCAPE PLAN	
L-2	LANDSCAPE DETAILS	

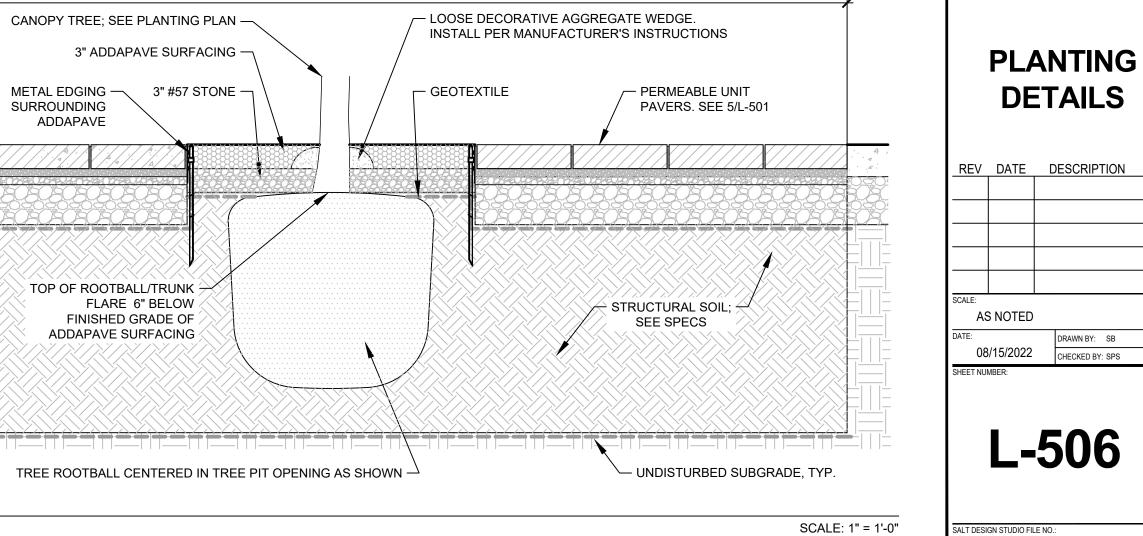GENERAL NOTES:

- ALL DISTANCES SHOWN ARE IN DISTRICT STANDARD MEASUREMENT. PAYMENT FOR ALL WORK WILL BE BASED UPON THAT STANDARD. THE LOCATIONS AND ELEVATIONS OF THE EXISTING UTILITIES ARE APPROXIMATE.
- THE ELEVATIONS OF THE EXISTING UTILITIES MUST BE FIELD CHECKED DURING CONSTRUCTION.
- ALL SIDEWALK AND CURBING TO BE REPLACED IN KIND ALONG FULL LIMITS OF CONSTRUCTION TO NEXT EXISTING JOINT OR AS DIRECTED BY PWD.
- WELDED PIPE BOOT SEAL MUST BE INSTALLED AT ANY POINT WHERE A PIPE PENETRATES AN IMPERMEABLE GEOMEMBRANE LINER.
- SUFFICIENT EROSION AND SEDIMENTATION CONTROL MEASURES WILL BE INSTALLED AND MAINTAINED BY THE CONTRACTOR AS TO PREVENT STANDING WATER OR SEDIMENTATION OF STORMWATER SYSTEMS. SYSTEMS DETERMINED BY PWD TO BE INADEQUATELY PROTECTED AND THEREBY COMPROMISED WILL BE REPLACED TO THE EXTENT REQUIRED BY PWD (UP TO AND INCLUDING FULL REPLACEMENT) AT NO ADDITIONAL COST TO PWD.
- ORIFICE SHOULD NOT BE DRILLED PRIOR TO AUTHORIZATION BY PWD. PWD WILL REVIEW THE RESULTS OF THE DOUBLE RING INFILTROMETER TESTS CONDUCTED
- AFTER SMP EXCAVATION AND WILL CONFIRM ORIFICE DIMENSIONS. EROSION CONTROL MATTING SHALL BE PLACE OVER ALL SOIL SURFACES NOT
- STABILIZED BY PLANTING.

CITY OF PHILADELPHIA PHILADELPHIA WATER — DEPARTMENT —


DRAWINGS FOR: GREEN STORMWATER INFRASTRUCTURE DESIGN PROJECT ZIEHLER PLAYGROUND AND RECREATION CENTER PWD WORK NO. S-50329-G



SOURCE: GOOGLE MAPS IMAGERY MAP SCALE: 1" = 300'



PWD TRACKING NUMBER: FY21-ZIEH-6284-01

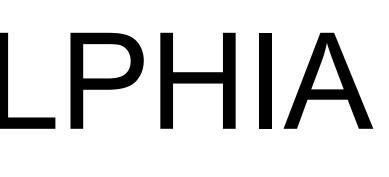





 $\Box W$

GREEN STORMWATER INFRASTRUCTURE PROJECT


PHILADELPHIA	
WATER DEPARTMENT	INDEX SHEET
PHILADELPHIA PARKS & RECREATION	ZIEHLER PLAYGROUND R
Rebuild	
PHILADELPHIA	
SALT	APPROVED And Land DEPUTY COMMISSIONER, PLANNING & ENVIRONMENTAL SERVICES
DESIGN STUDIO LANDSCAPE ARCHITECTURE PLANNING & URBAN DESIGN	APPROVED
meliora 🏠 🏟 🌒	WORK NO. S-50329-G
Civil, Water Resources, and Structural Engineering 259 Morgan St., Phoenixville, PA 19460 P: 610.933.0123 www.melioradesign.com	SHEET NO. T-1 OF 12 SHEETS

ISSUE FOR BIDDING 08-15-2022

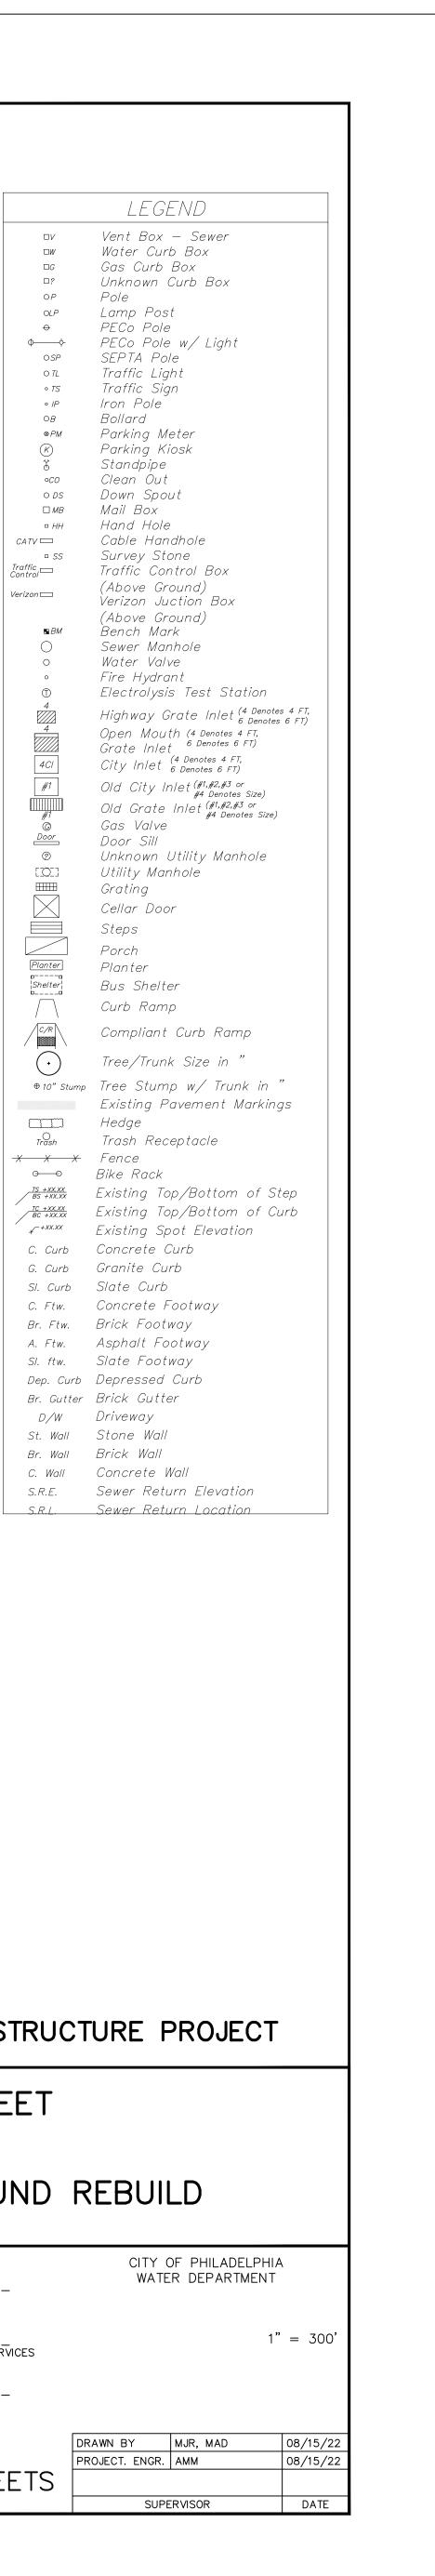


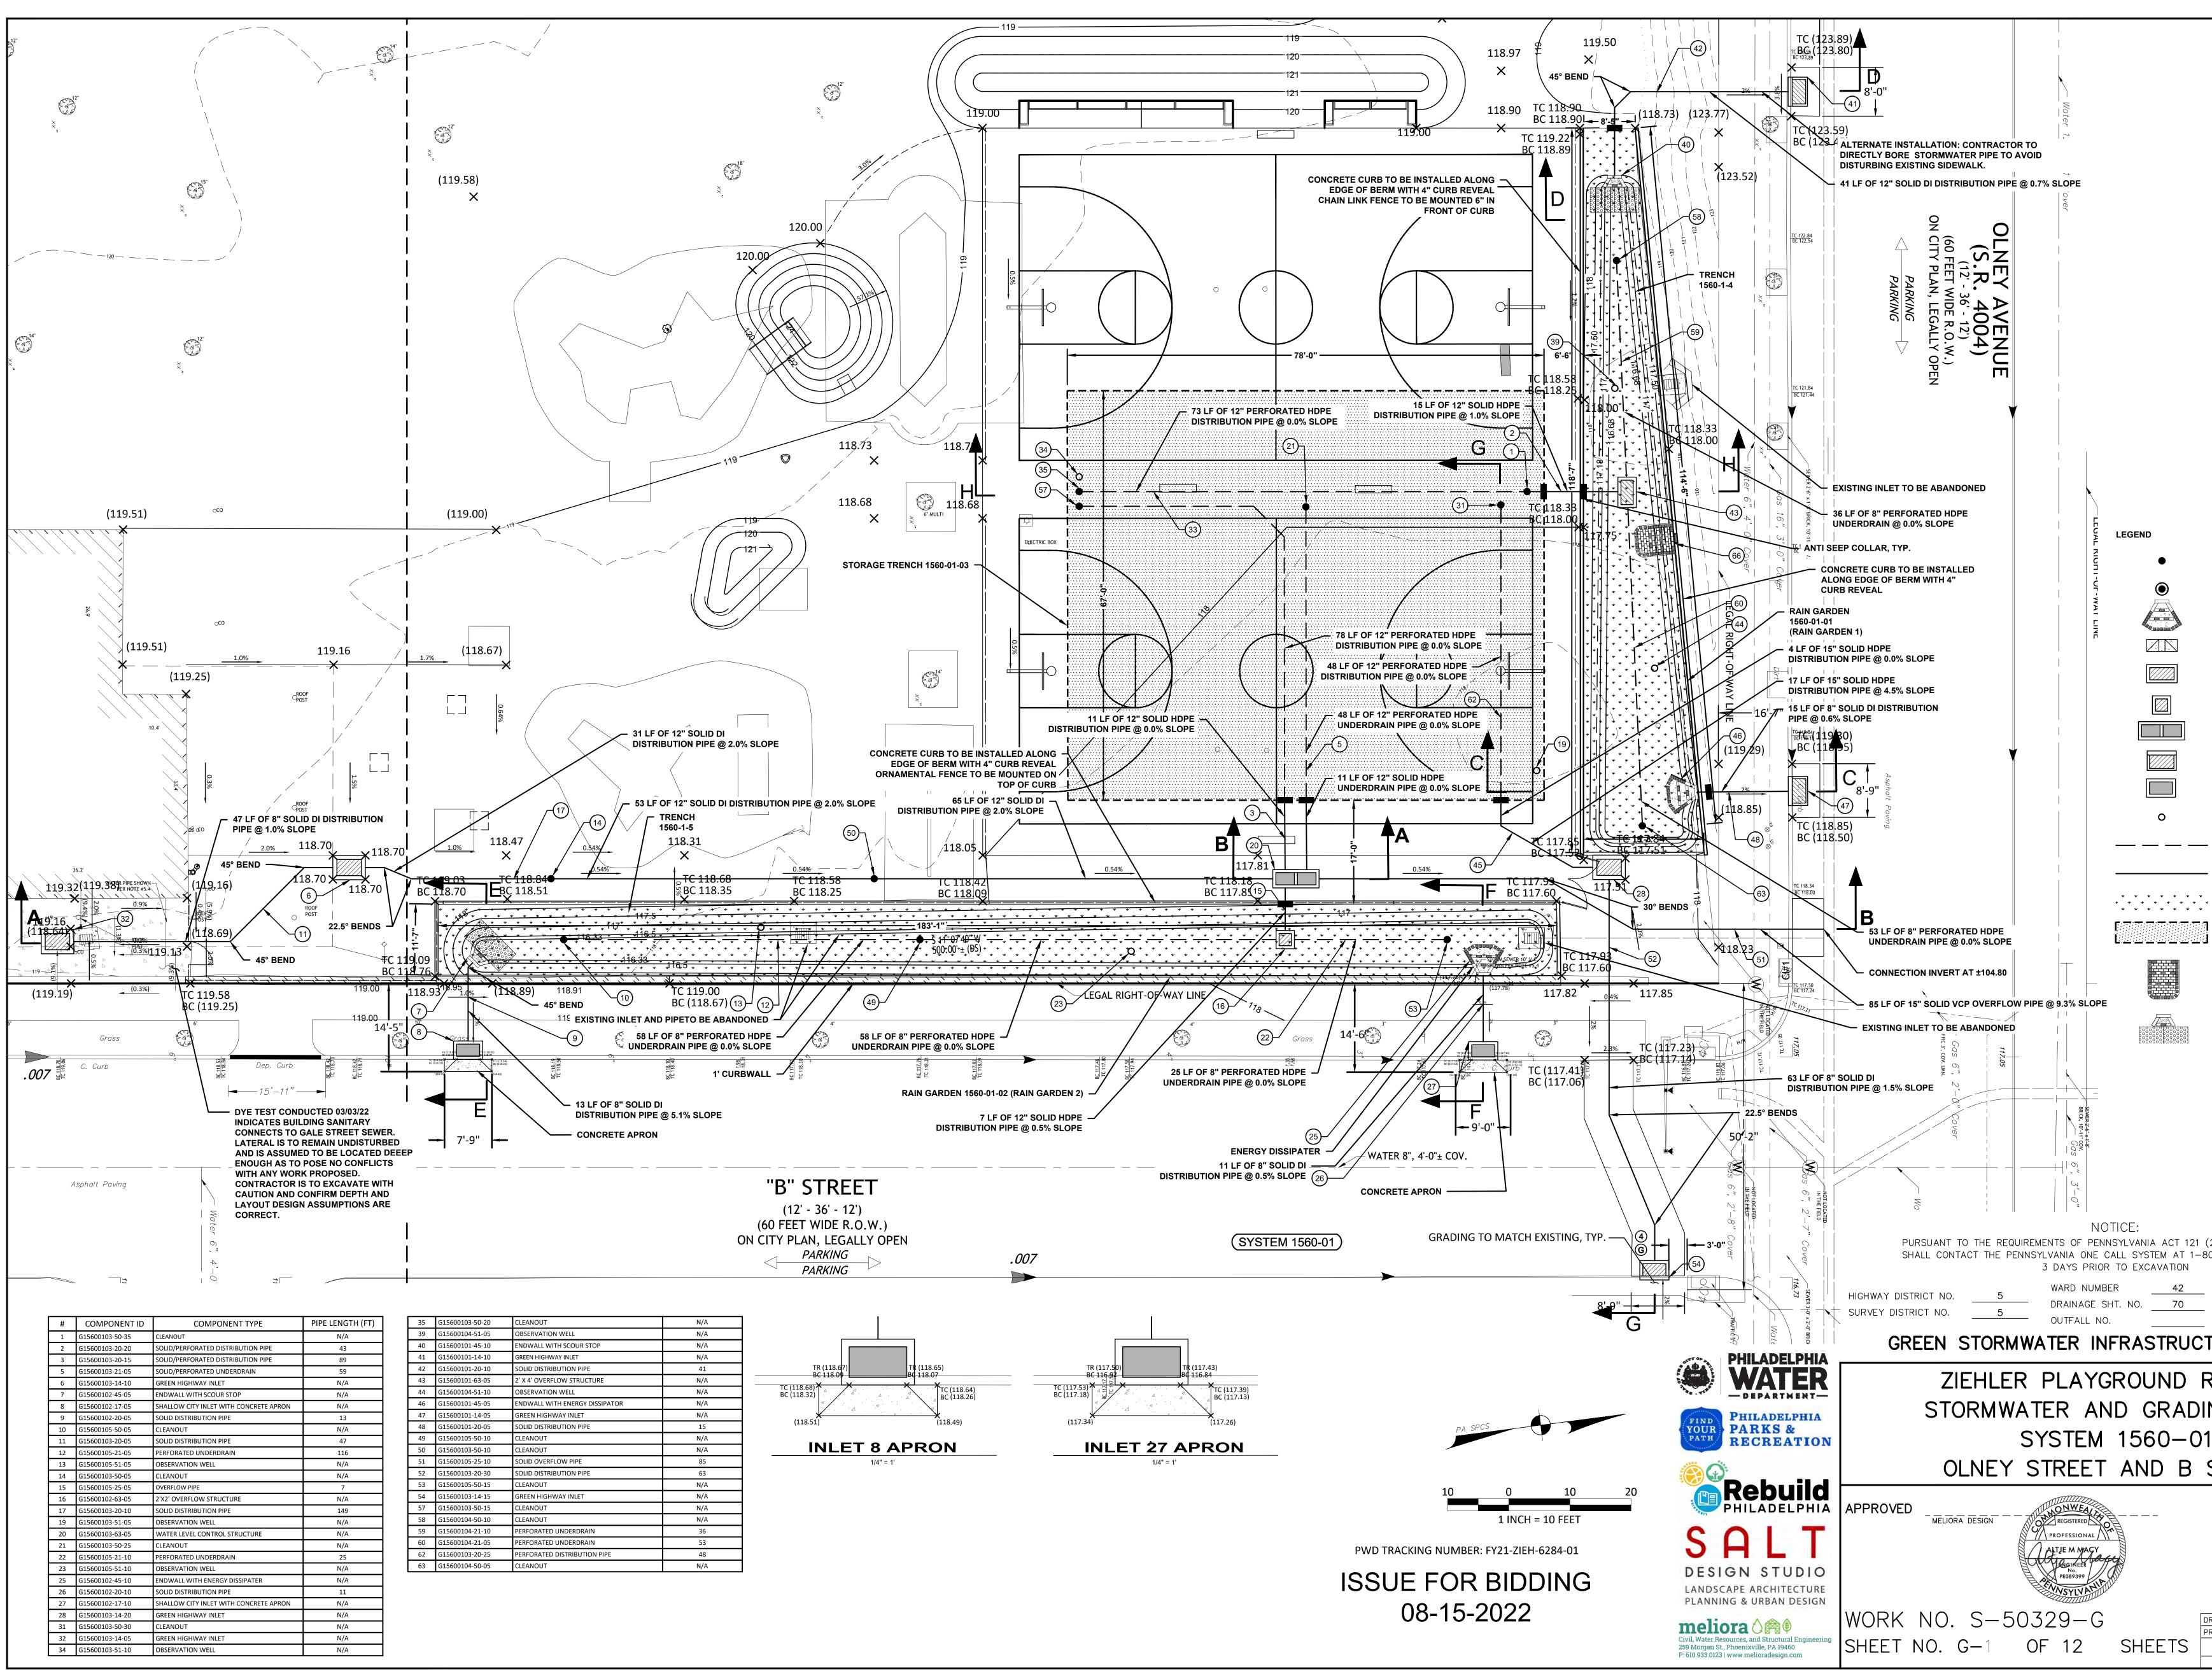


	CLEANOUT	
	END WALL WITH ENERGY DIS	SIPATER
	CONCRETE APRON	
	2' x 4' INLET	
	2' x 2' INLET	
	WATER LEVEL CONTROL	
	GREEN HIGHWAY GRATE INL	ET
	SHALLOW GREEN CITY INLET	r
	OBSERVATION WELL	
-	PERFORATED HDPE PIPE	
-	SOLID PIPE	
7	RAIN GARDEN	
	STORMWATER TRENCH	
	CURB CUT ENERGY DISSIPAT	OR
	ENERGY DISSIPATER WITH SCOUR STOP	
	008), THE CONTRACTOR —242—1776, AT LEAST	
	PA ONE CALL <u>201919</u> 3	32559
Τι	JRE PROJECT	
R	EBUILD	
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1		
S	TREET	
	CITY OF PHILADELPHIA WATER DEPARTMENT SCALES:	
	PLAN PROFILE VERT. HORIZ.	1"=10' 1"=10' 1"=5'
		1/4"=4'
	WN BY MJR, MAD JECT. ENGR. AMM	08/15/22 08/15/22
	SUPERVISOR	DATE

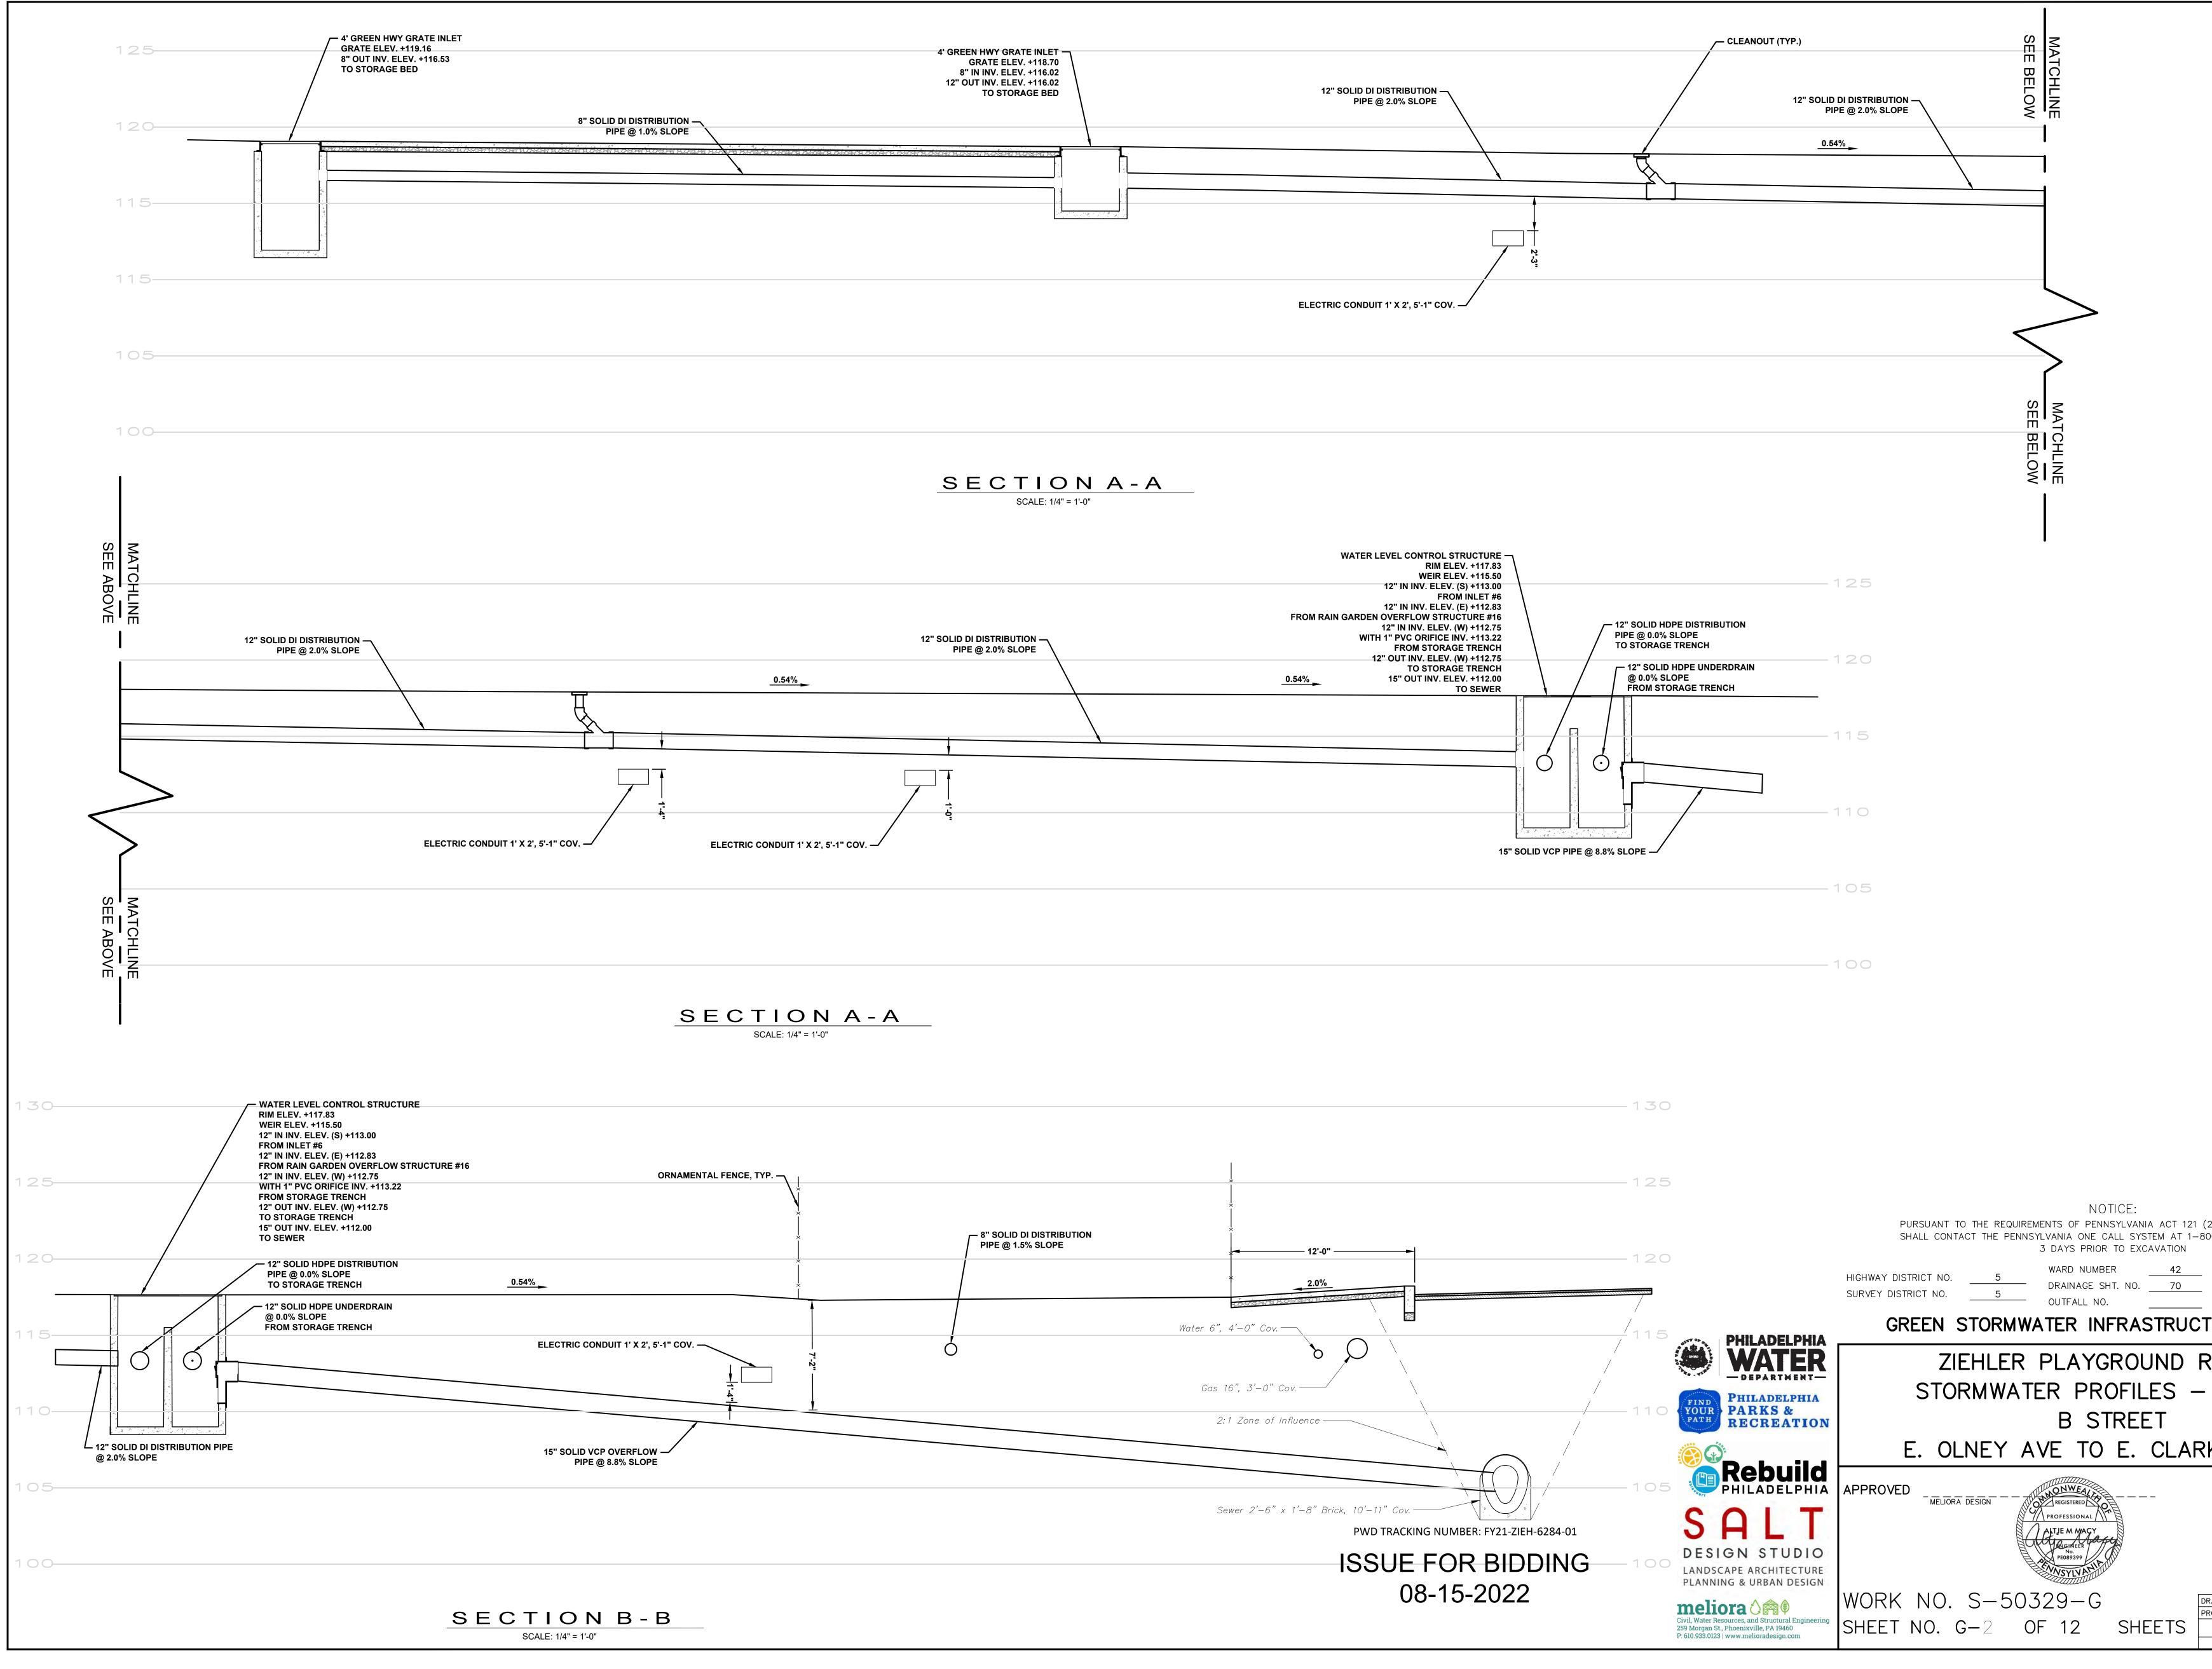

(2008), THE 300-242-177		
PA ONE	CALL <u>2019</u>	91932559
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RKSON	AVE	
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CITY (WATE PLAN PROFILE SECTION	DF PHILADELF R DEPARTME SCALES: VERT. HORIZ.	NT 1"=10' 1"=10' 1"=5' 1/4"=4'
CITY (WATE PLAN PROFILE SECTION DRAWN BY	DF PHILADELF R DEPARTME SCALES: VERT. HORIZ.	NT 1"=10' 1"=5' 1/4"=4' 08/15/22
CITY (WATE PLAN PROFILE SECTION DRAWN BY PROJECT. ENGR.	DF PHILADELF R DEPARTME SCALES: VERT. HORIZ.	NT 1"=10' 1"=5' 1/4"=4' 08/15/22

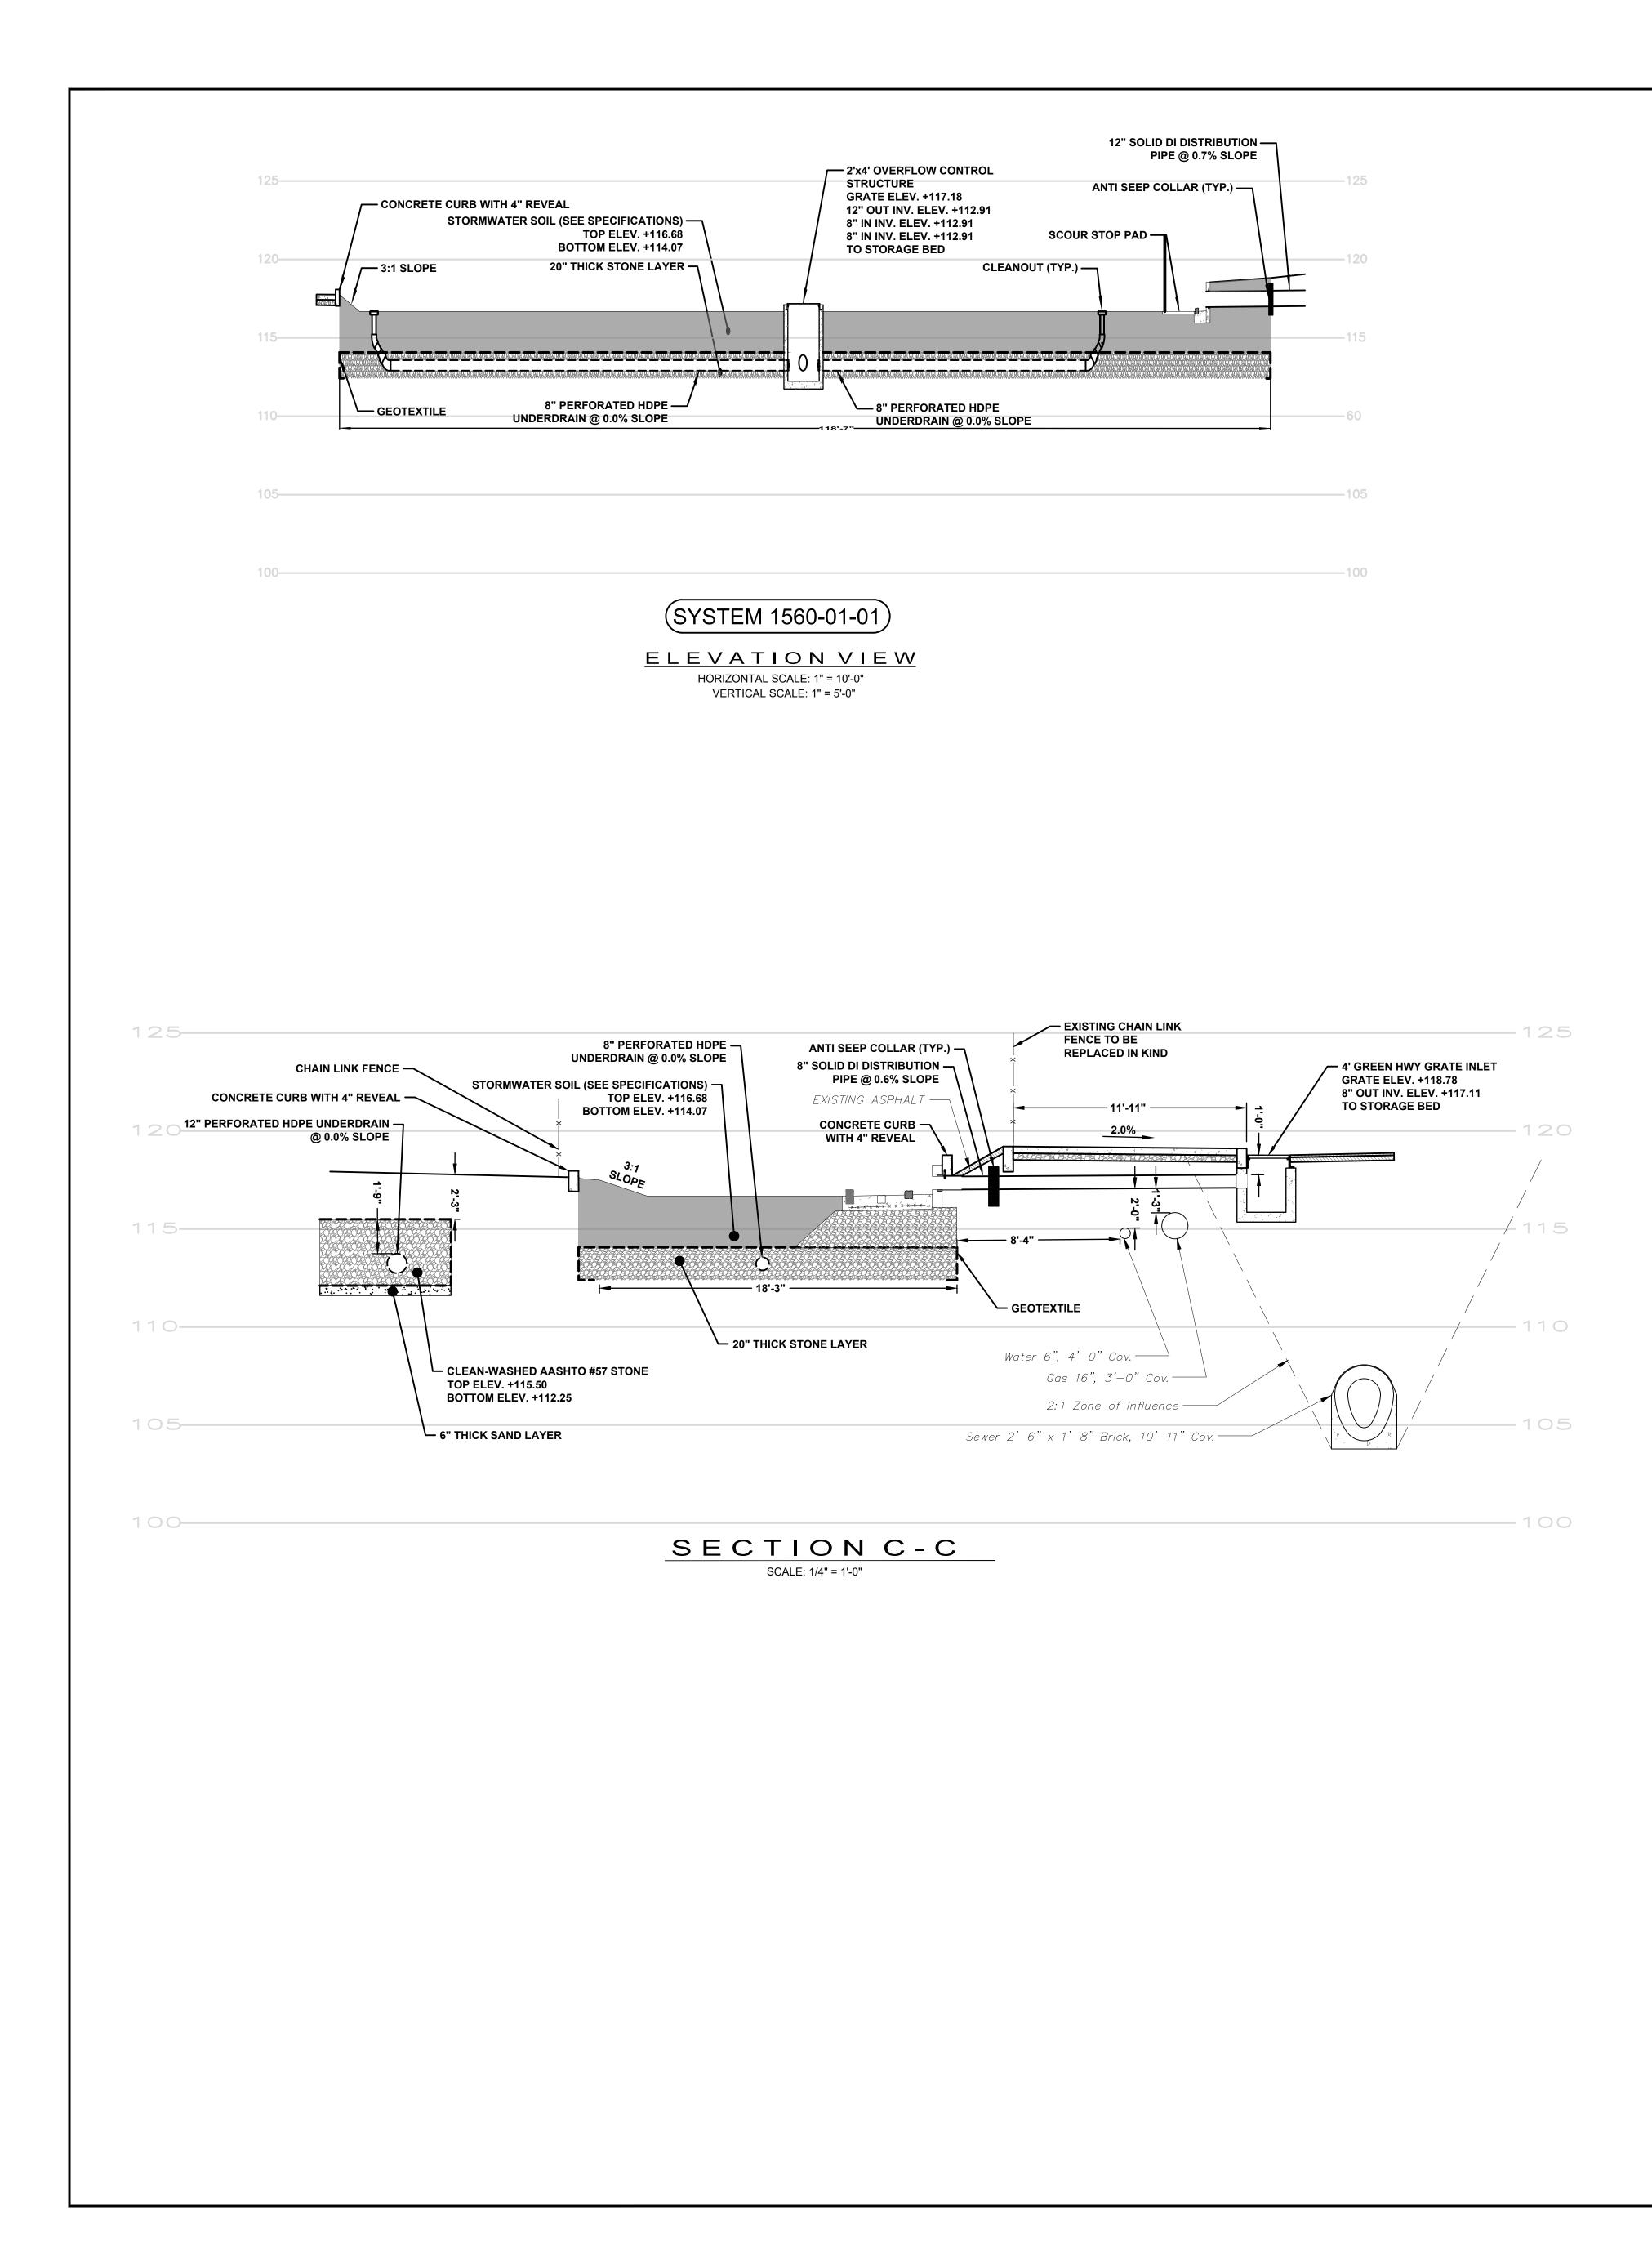

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EXISTING CHAIN LINK —

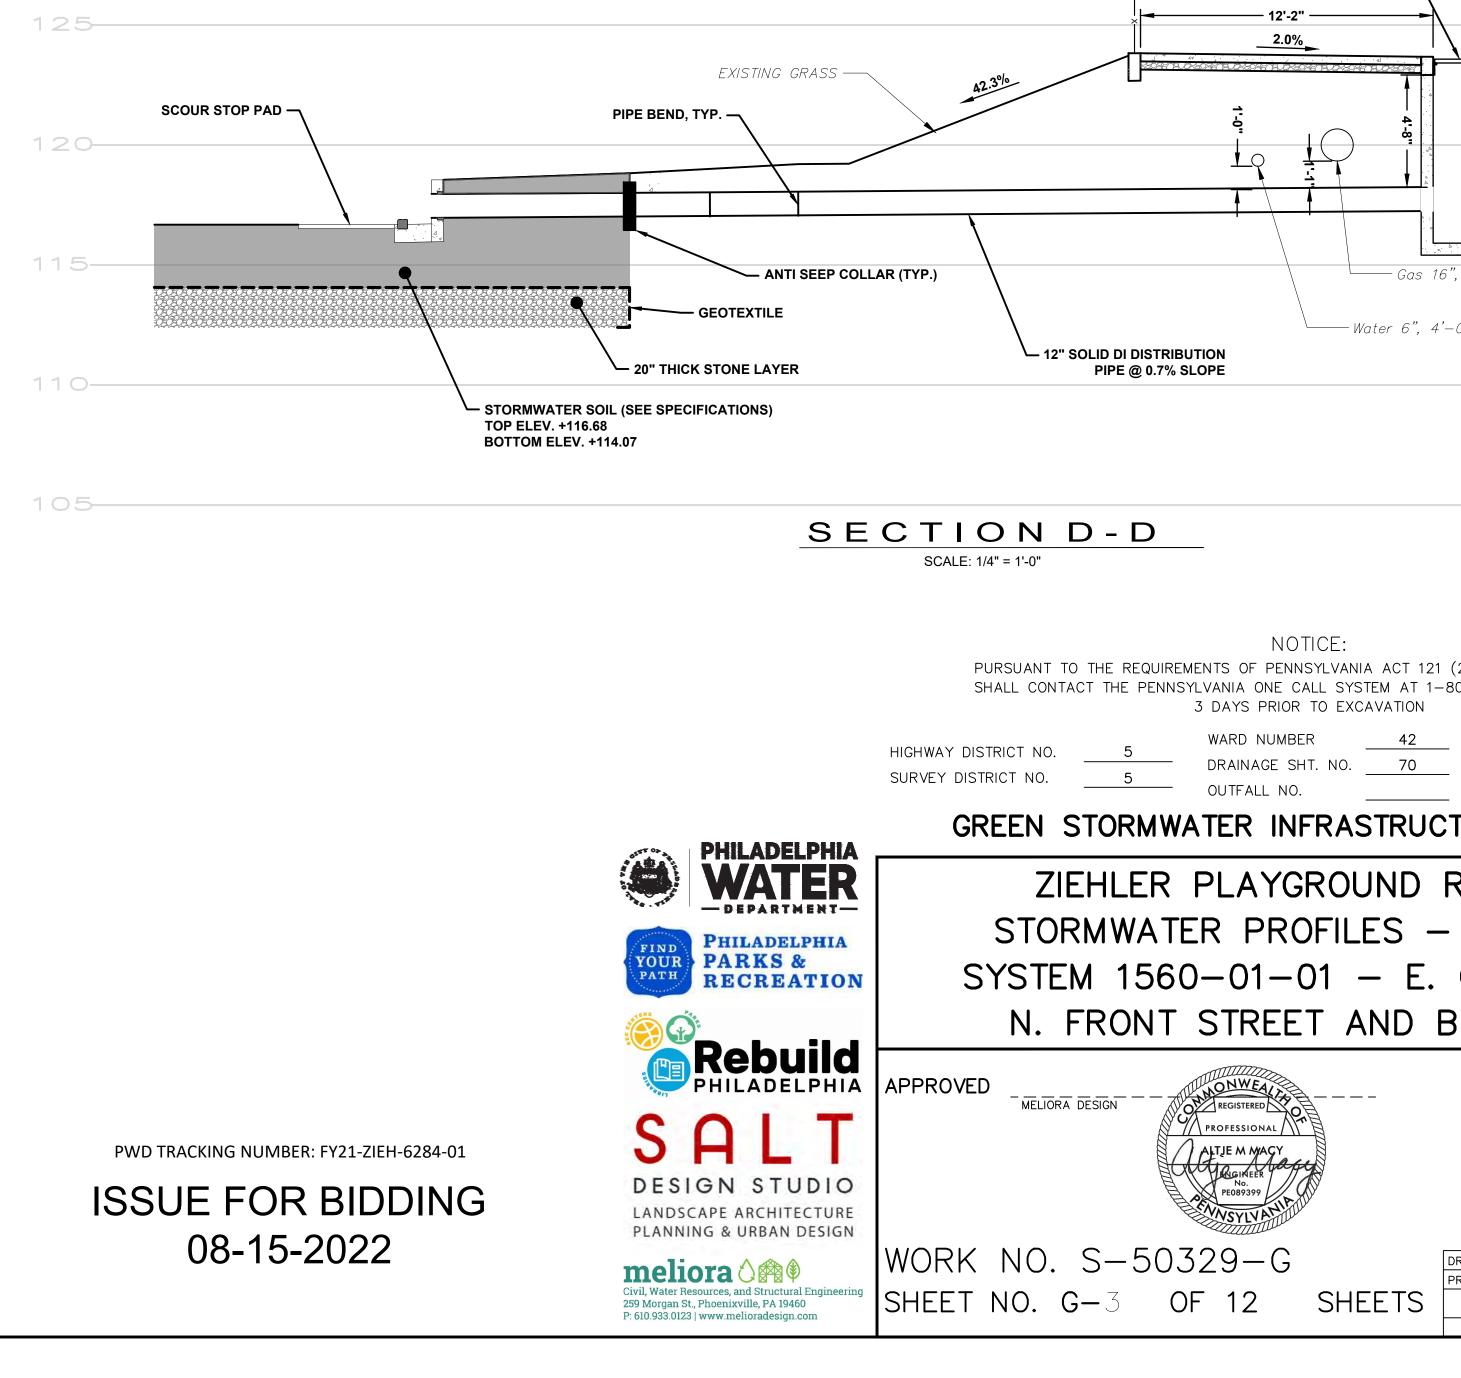REPLACED IN KIND

FENCE TO BE


4' GREEN HWY GRATE INLET —

12" OUT INV. ELEV. +117.25

GRATE ELEV. +123.62

TO STORAGE BED


<u>, 3'-0" Cov.</u> 115	
-0" Cov.	
105	
(2008), THE CONTRACTOR 300—242—1776, AT LEAST	
pa one call <u>2019193</u> TURE PROJECT	32559
SHEET 2	
OLNEY AVE	
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CITY OF PHILADELPHIA WATER DEPARTMENT SCALES:	
SCALES: PLAN PROFILE VERT.	1"=10' 1"=10'
HORIZ.	1"=5' 1/4"=4'
DRAWN BY MJR, MAD PROJECT. ENGR. AMM	08/15/22 08/15/22
SUPERVISOR	DATE

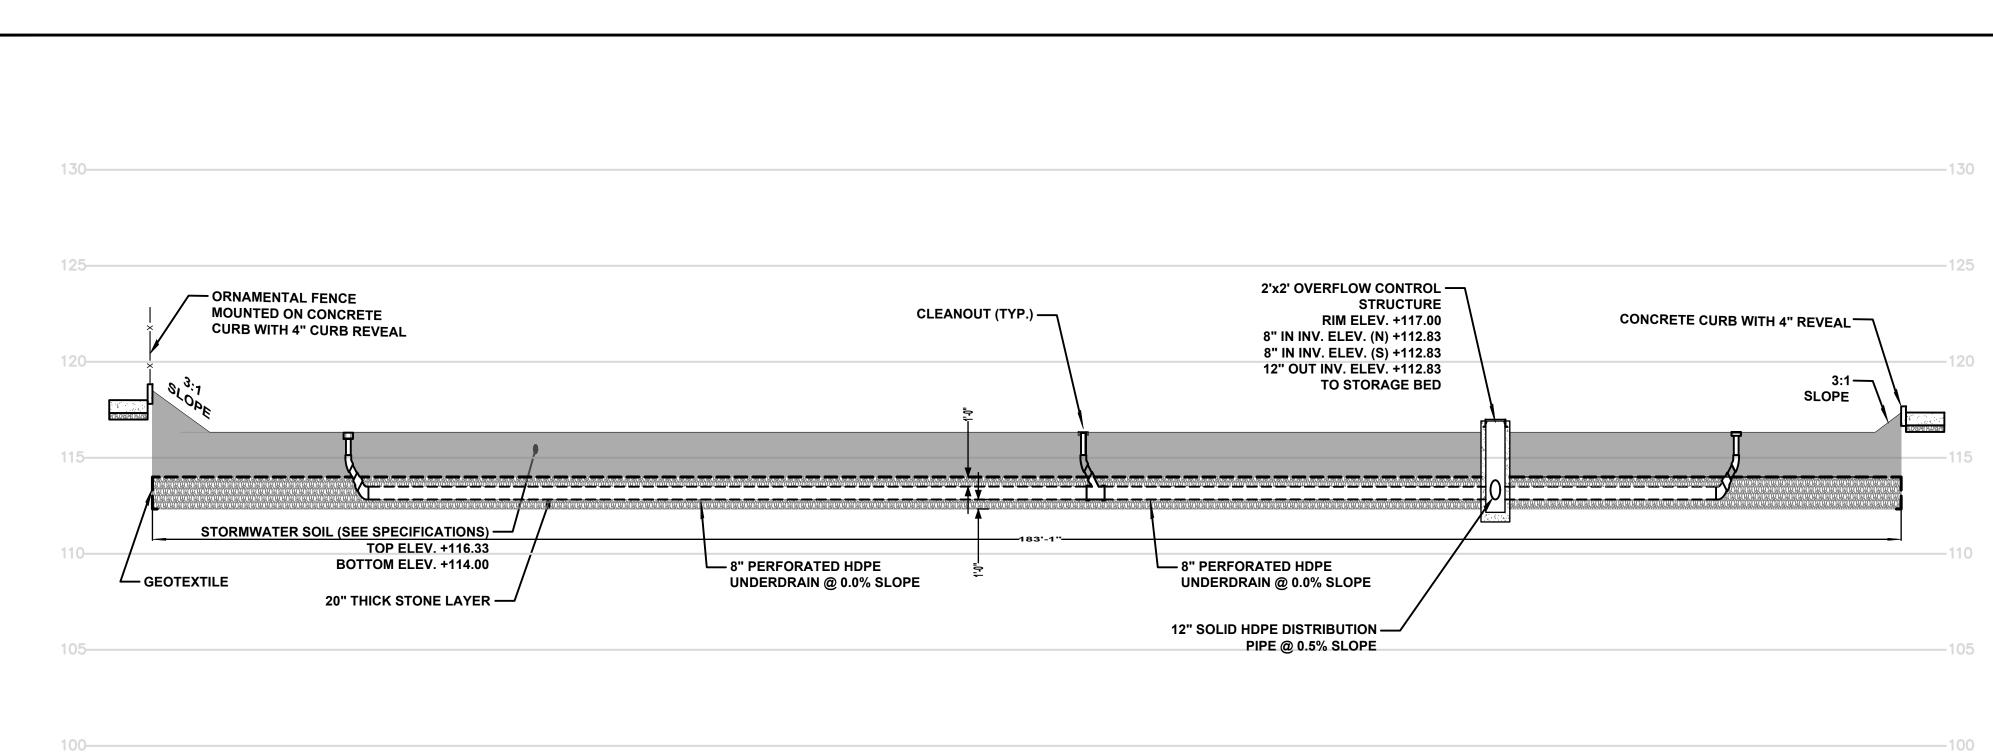

(SYSTEM 1560-01-02)

ELEVATION VIEW HORIZONTAL SCALE: 1" = 10'-0" VERTICAL SCALE: 1" = 5'-0"

PWD TRACKING NUMBER: FY21-ZIEH-6284-01 **ISSUE FOR BIDDING** 08-15-2022

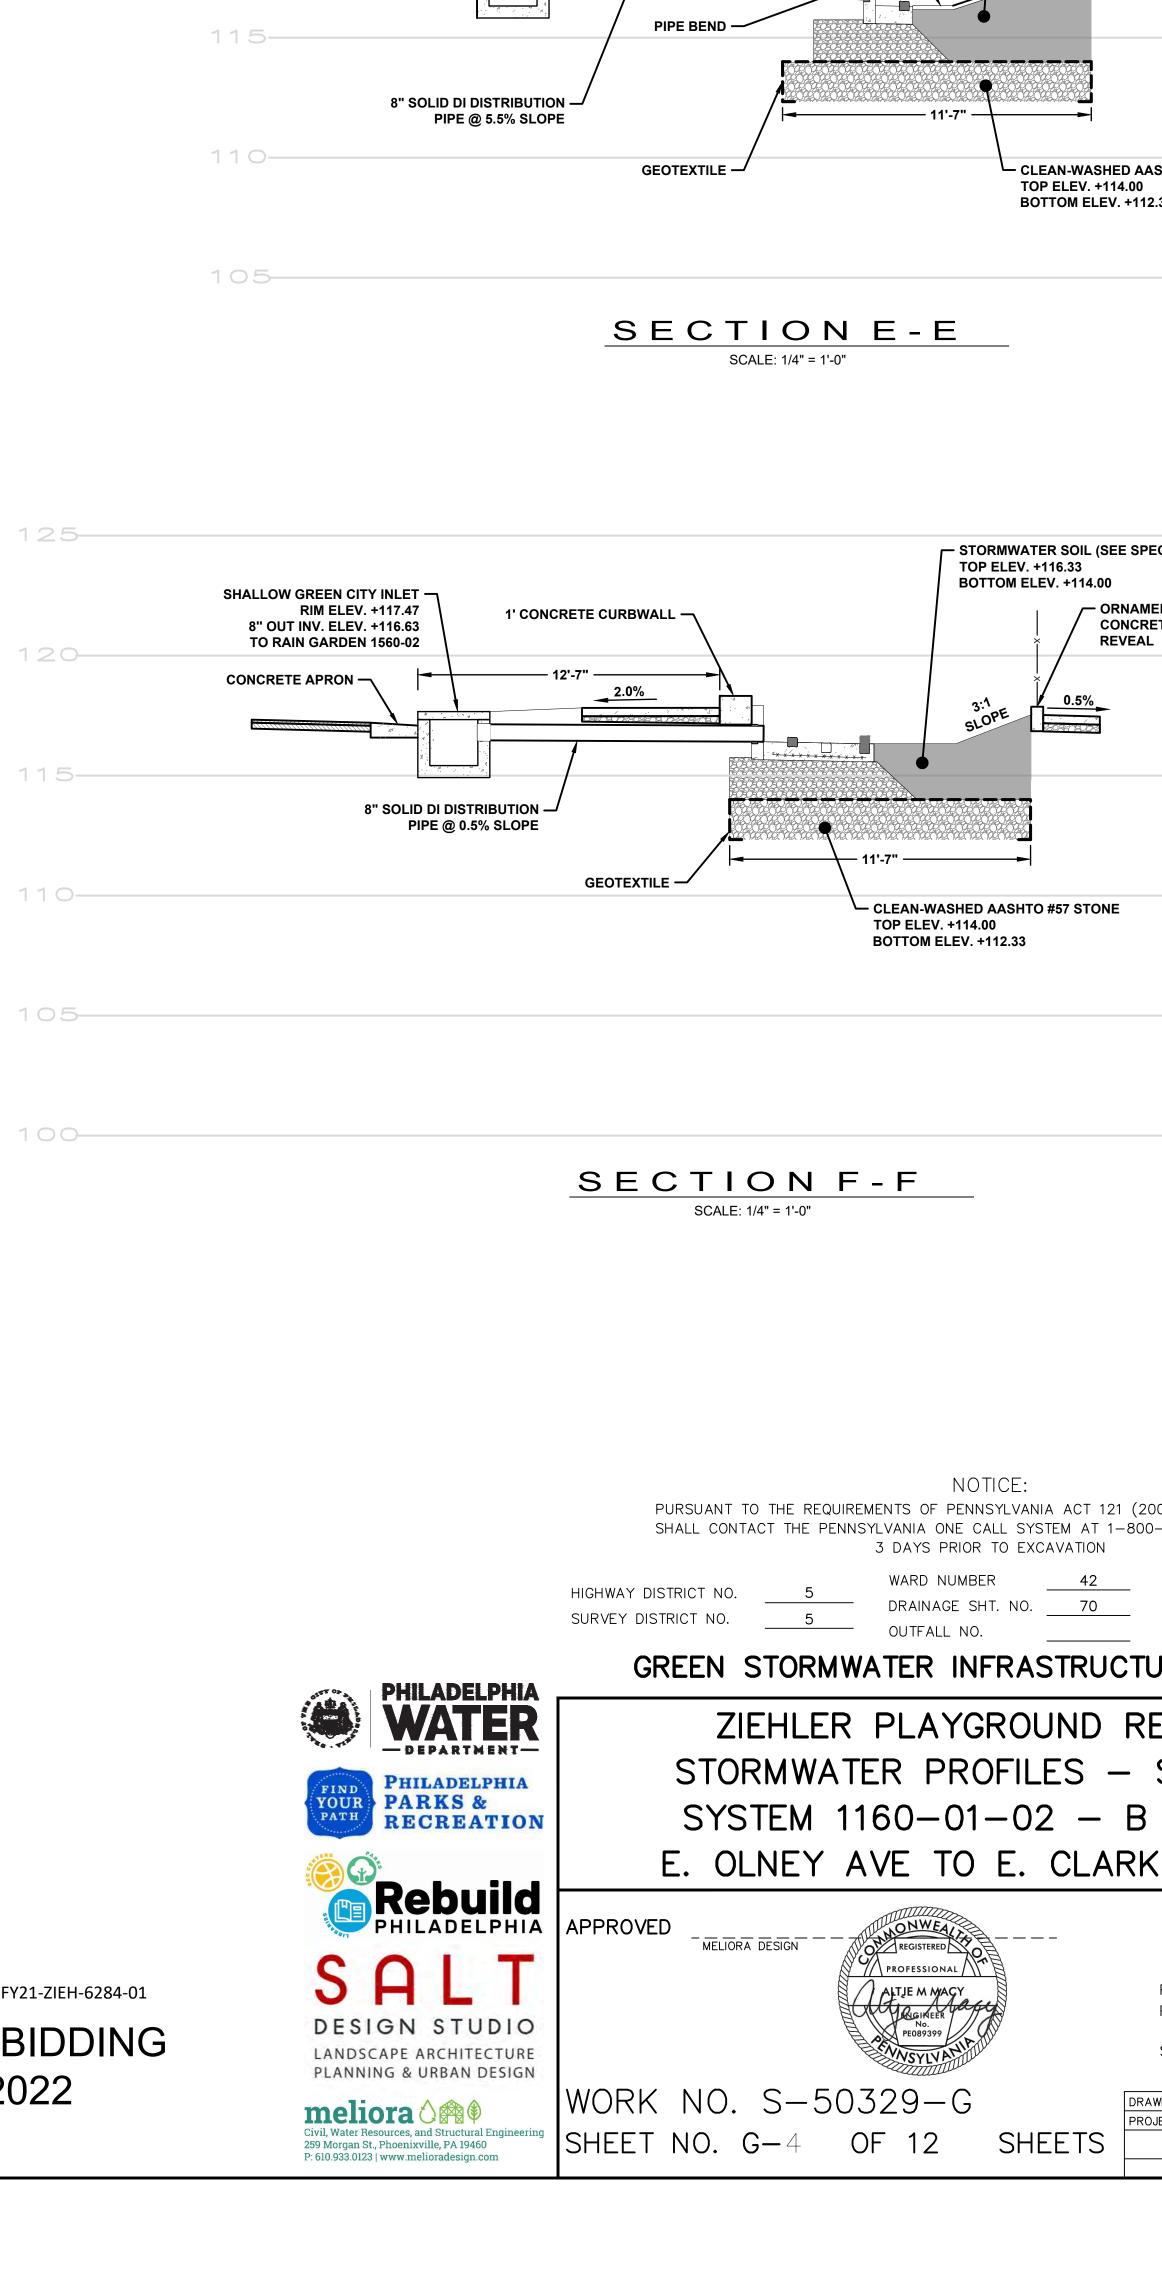

SCOUR STOP PAD -

3:1 SLOPE

1' CONCRETE CURBWALL

12'-6" —

130-

125—

SHALLOW GREEN CITY INLET


8" OUT INV. ELEV. +117.24


TO RAIN GARDEN 1560-02

 $1 2 \circ -$ concrete apron -


RIM ELEV. +118.66

		—130)
	SOIL (SEE SPECIFICA	TIONS)	
TOP ELEV. +116 BOTTOM ELEV.		—125)
		FENCE MOUNT IRB WITH 4" CU	
	REVEAL	— 120)
3:1 SLOPE	0.5%		
7.07.07.07.07.07.		-115	
	D AASHTO #57 STONE	110	
TOP ELEV. +114 BOTTOM ELEV.			
_			
		105	
MWATER SOIL (SEE LEV. +116.33 OM ELEV. +114.00	SPECIFICATIONS)	—125	
	NAMENTAL FENCE MO NCRETE CURB WITH 4		
	/EAL	—120)
E 0.5%			
		— 115	
ASHTO #57 STONE		— 110	
2.33			
		-105	
		— 1 O C)
CE:			
YLVANIA ACT 121 L SYSTEM AT 1-	(2008), THE CON ⁻ 800—242—1776, A		
O EXCAVATION 42	_		
NO. 70	_ PA_ONE_CALL	20191932	2559
RASTRUC	TURE PRO	OJECT	
ROUND	REBUILD		
FILES -	- SHEET	3	
-02 —	B STREE	ΞT	
E. CLAF	RKSON A	AVE	
		HILADELPHIA EPARTMENT	
	SCA PLAN	ALES:	1"=10'
	PROFILE VI H	ERT. ORIZ.	1"=10' 1"=5'
	SECTION	1,	/4"=4'
		· · · - · · · · · · · · · · · · · · · ·	<u> </u>
SHEETS	DRAWN BY MJR, PROJECT. ENGR. AMM		8/15/22 8/15/22

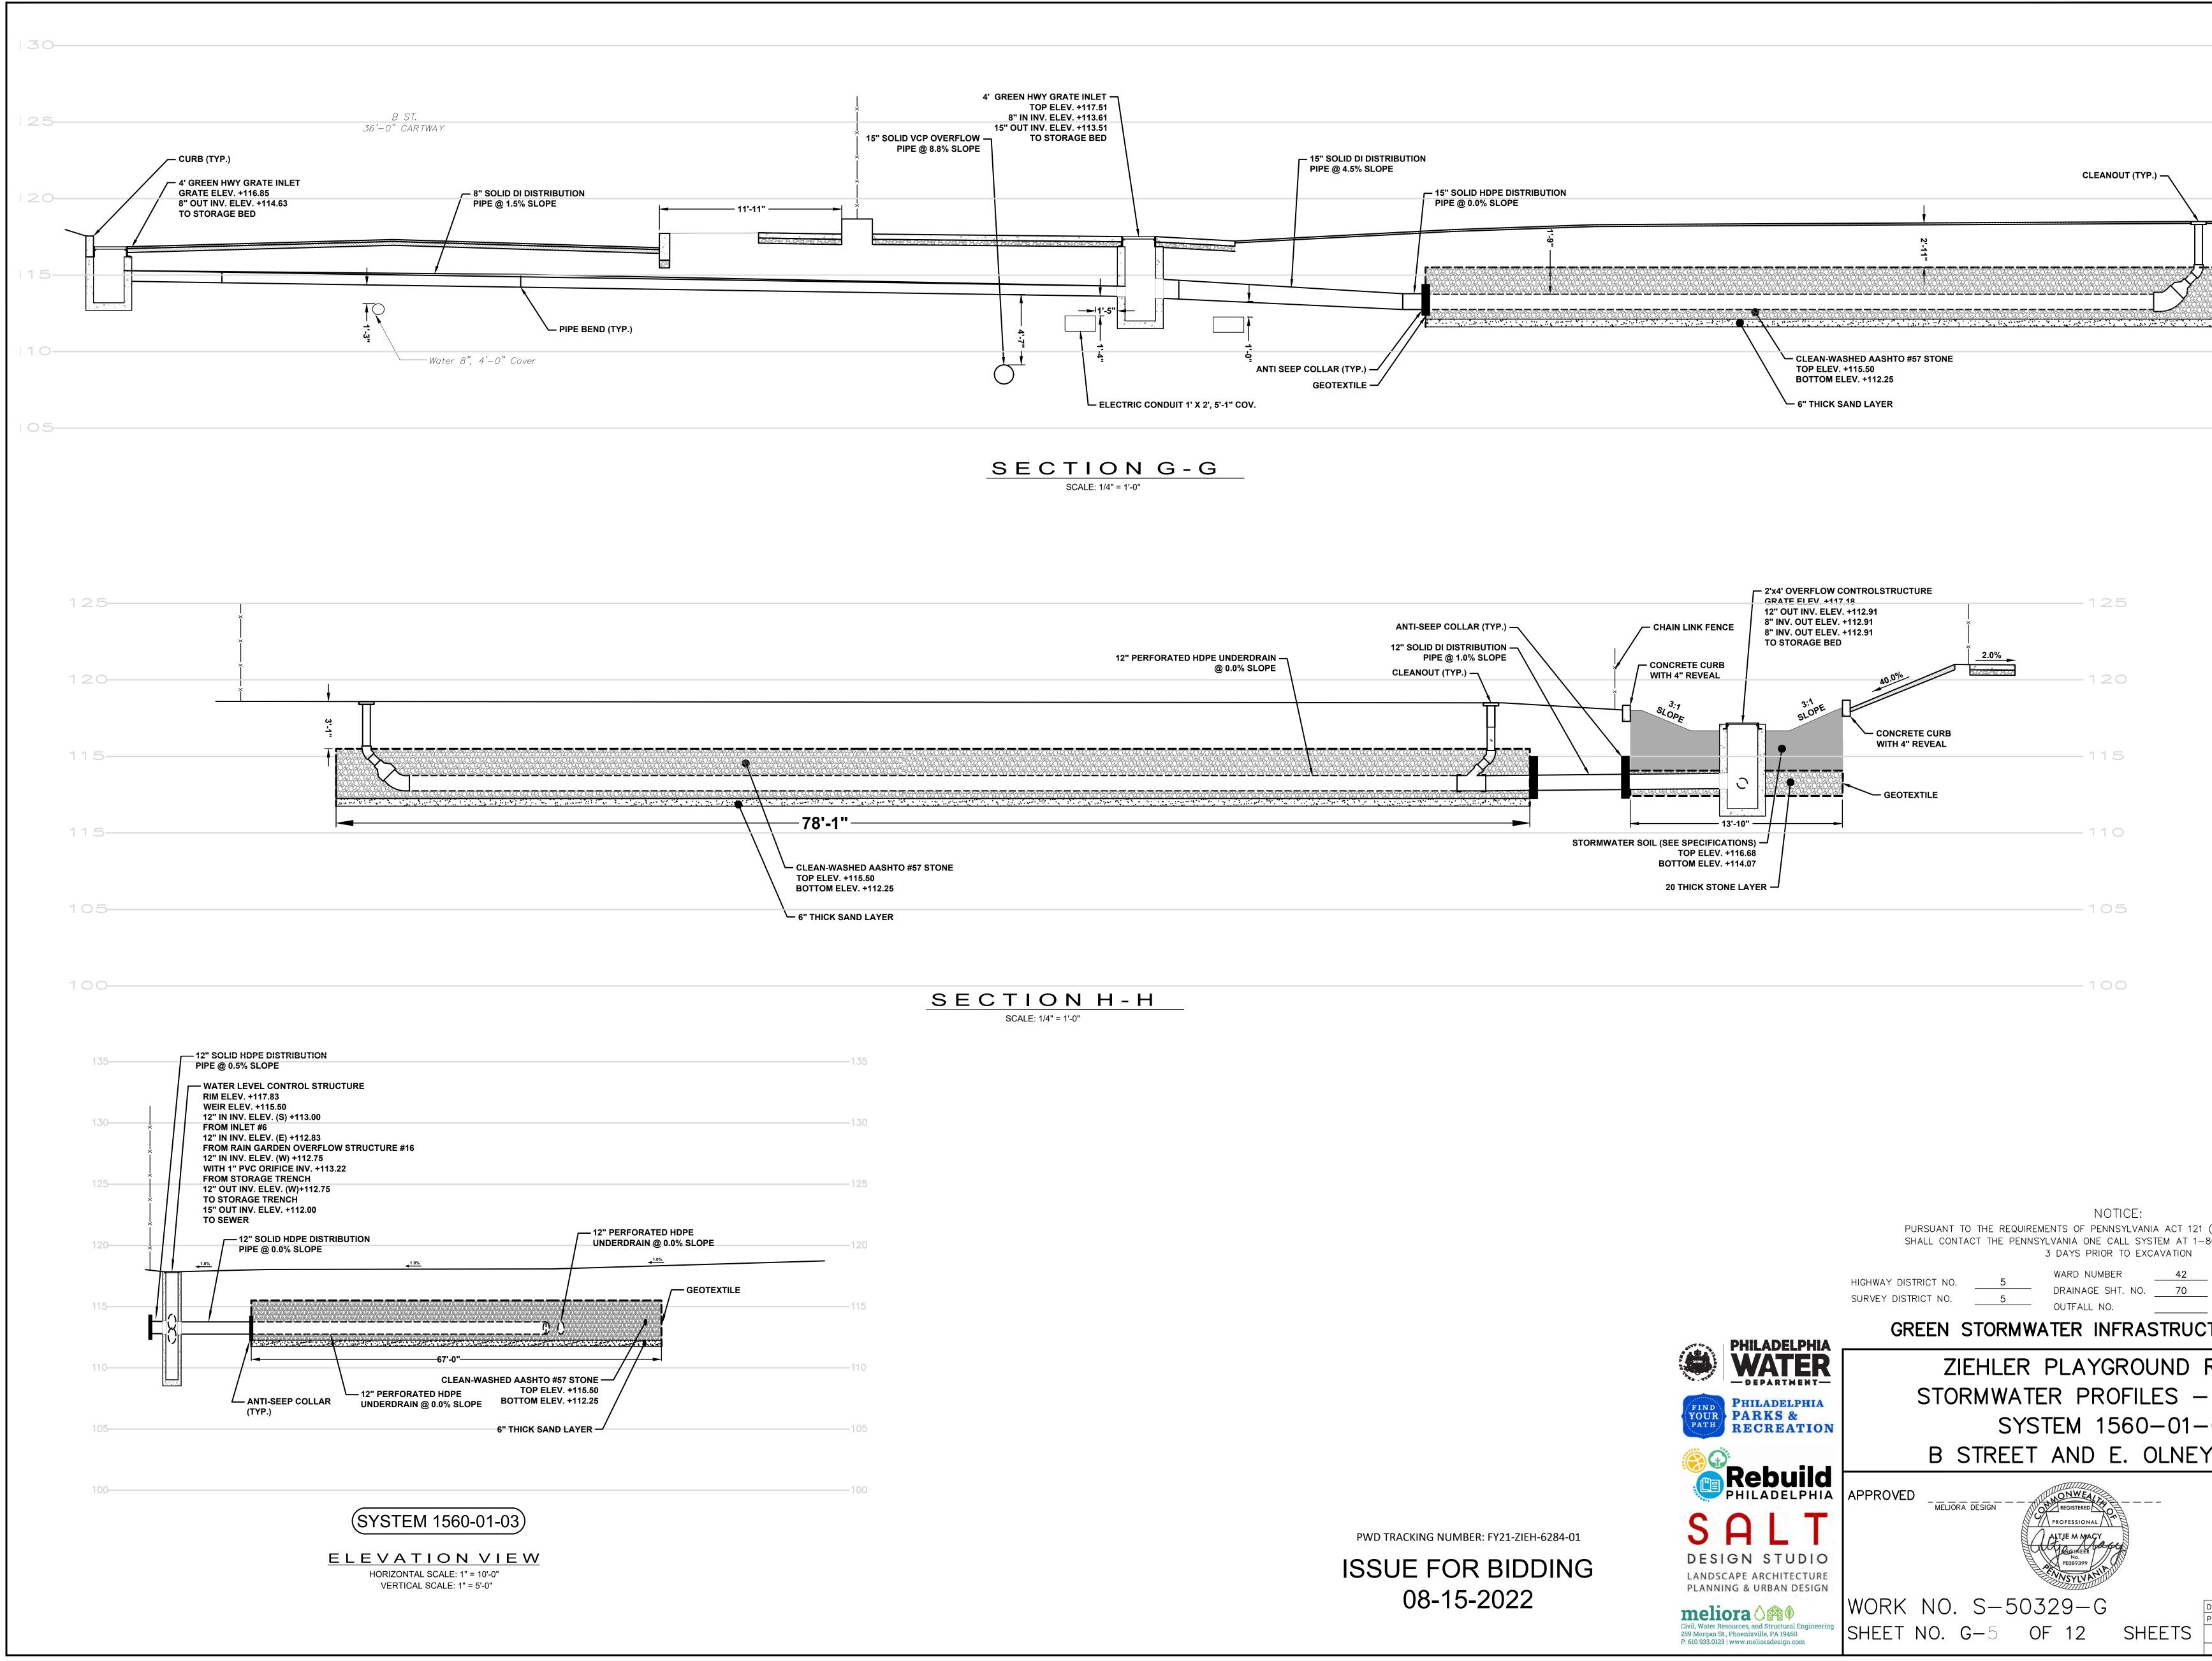

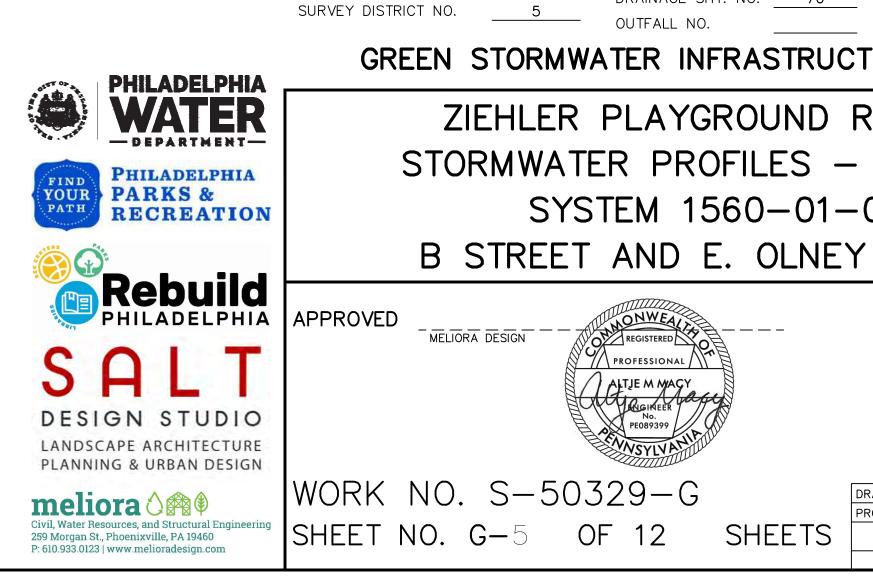

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(2008), THE CONTRAC	
800—242—1776, AT LE	AST
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REBUILD	
SHEET 4	1
03 STREET	
CITY OF PHILAI WATER DEPAR	DELPHIA RTMENT
SCALES	:
PLAN PROFILE VERT. HORIZ	
SECTION	1/4"=4'
DRAWN BY MJR, MAD PROJECT. ENGR. AMM	08/15/22 08/15/22
SUPERVISOR	DATE

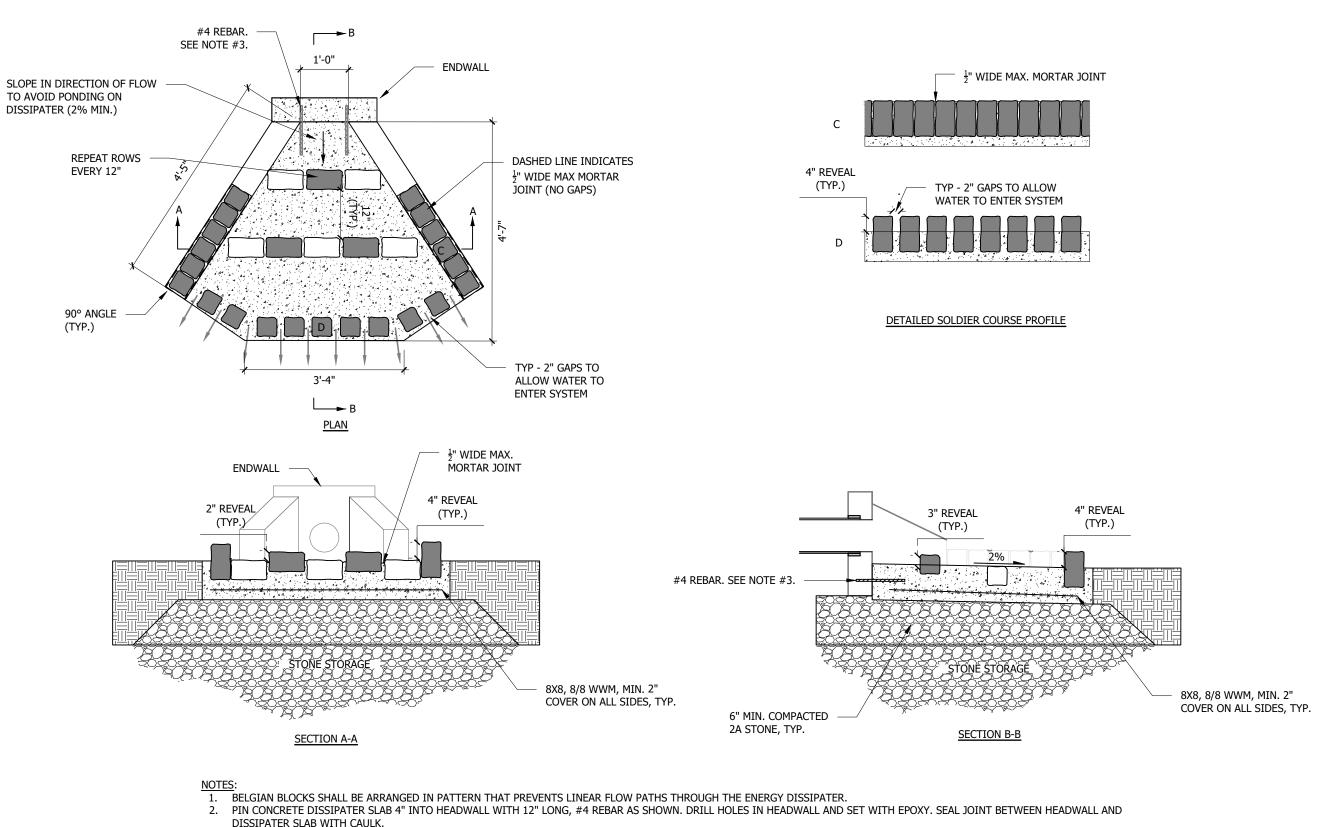

3. UPON COMPLETION, SLOPES/ELEVATIONS MUST ALLOW POSITIVE DRAINAGE INTO SYSTEM WITH NO STANDING WATER ON DISSIPATER. 4. ALL BLOCKS SHOWN IN GRAY ARE RAISED AND BLOCKS SHOWN IN WHITE ARE FLUSH WITH CONCRETE. 5. STONE MUST BE UNIFORMLY GRADED, CRUSHED, CLEAN-WASHED STONE. PWD DEFINES "CLEAN-WASHED" AS HAVING LESS THAN 0.5% WASH LOSS, BY MASS, WHEN TESTED PER THE AASHTO T-11 WASH LOSS TEST. AASHTO NO. 3 AND NO. 57 STONE CAN MEET THIS SPECIFICATION.

> ENDWALL ENERGY DISSIPATER 1/2" = 1'-0"


> > THREADED PVC END PLUG WITH NUT


NOTES: 1. TO BE SET IN PWD INLET WITH RECESSED CONTROL STRUCTURE. 2. ORIFICE SHOULD NOT BE DRILLED.


UNDERDRAIN CAP 3" = 1'-0"


ISSUE FO 08-

2'x4' AND 2'x2' OVERFLO 3/4" = 1'-0"

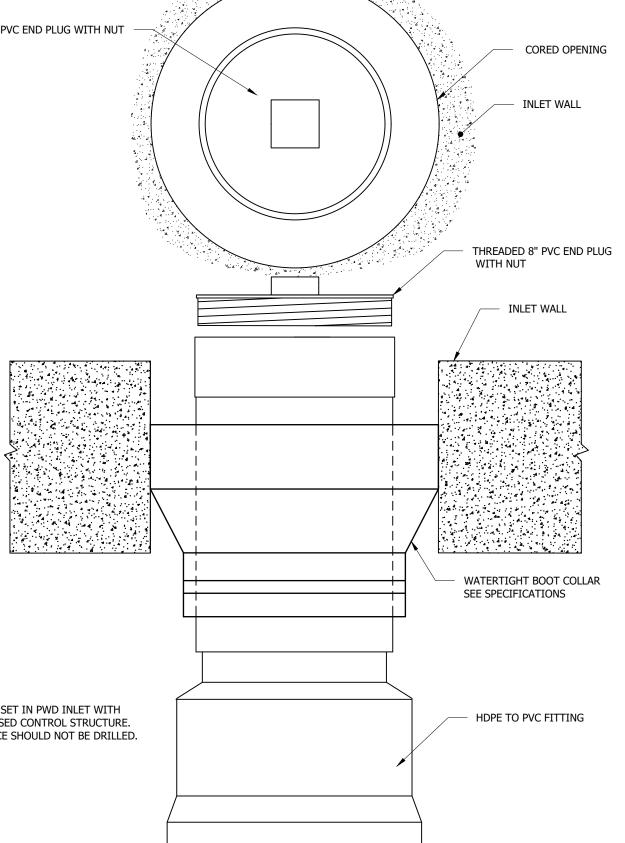

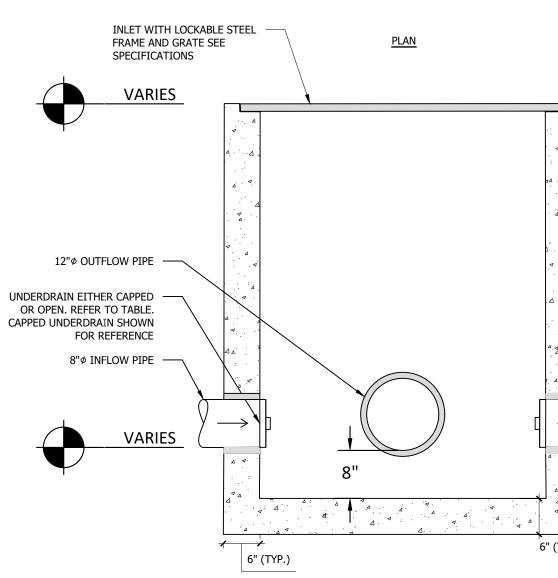

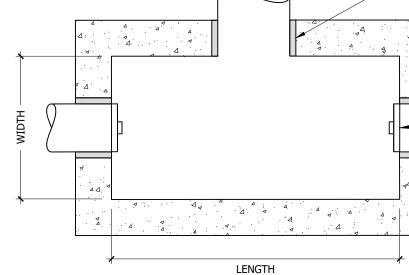

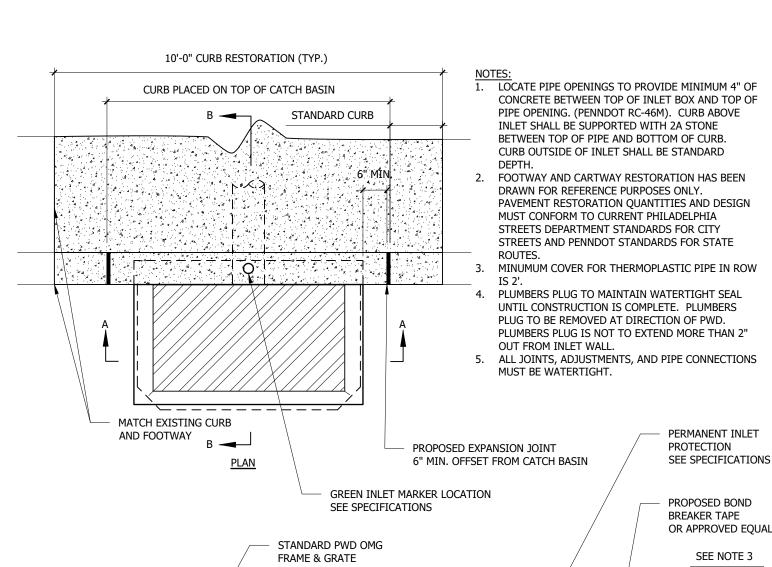

 6" MIN 6" MIN COTIVAL AND CARTWAY RESTORATION HAS BEEN DRAWN FOR REFERENCE PURPOSES ONLY. PAVEMENT RESTORATION QUANTITIES AND DESIGN MUST CONFORM TO CURRENT PHILADELPHIA STREETS DEPARTMENT STANDARDS FOR CITY STREETS AND PENNDOT STANDARDS FOR STATE ROUTES. MINUMUM COVER FOR THERMOPLASTIC PIPE IN ROW 	MODIFIED PWD 6-FOOT CONCRETE INLET BOX (SEE NOTE 4) 12"¢ DISTRIBUTION
 IS 2'. PLUMBERS PLUG TO MAINTAIN WATERTIGHT SEAL UNTIL CONSTRUCTION IS COMPLETE. PLUMBERS PLUG TO BE REMOVED A UNTIL CONSTRUCTION IS COMPLETE. PLUMBERS PLUG TO BE REMOVED A DIFECTION OF PWD. PLUMBERS PLUG IS NOT TO EXTEND MORE THAN 2" OUT FROM INLET WALL. ALL JOINTS, ADJUSTMENTS, AND PIPE CONNECTIONS MUST BE WATERTIGHT. 	PIPE #15 MODIFIED PWD PRECAST CONCRETE TOP SLAB (SEE NOTE 5)
<figure><section-header></section-header></figure>	
Image: section of the section of th	NOTES: 1 SEE PLANS FOR PIPE MATERIALS, INVERT ELEVATIONS, AND ORIENTATION. 2. SEE PLANS FOR STRUCTURE COVER AND TOP OF WEIR ELEVATIONS. 3. SEE PLANS FOR STRUCTURE COVER AND TOP OF WEIR ELEVATIONS. 3. ELE DAINS FOR STRUCTURE COVER AND TOP OF WEIR ELEVATIONS. 3. ALL JOINTS, ADJUSTMENTS, AND PIPE CONNECTIONS MUST REWATERTIGHT. 9. PWD 6' INLET BOY WITH WEIR WAUL ADDED, NO TRAP. 3. PWD 0' INLET TOP SLAB WITH OUTER DIMENSIONS TO MATCH BOX WITHOUT RISER, TWO CLEAN OUTS, AND NO CURB NOSING. WATEER LEEVEL CONTROL STRUCTURE
A A COMPONENT NO. ELEV. (FT) ELEV. A A A A A A A A A A	ERDRAIN UNDERDRAIN CULVERT OUT OUT OUT OUT OUT OUT IENGTH WIDTH 112.83 8.00 NO 112.83 12 24" 24" 24" 12" IENGTH IENGTH WIDTH III.12.83 12 24" 2
2'x4' AND 2'x2' OVERFLOW STRUCTURE 34" = 1-0" PWD TRACKING NUMBER: FY21-ZIEH-6284-01 ISSUE FOR BIDDING 08-15-2022	Image: State Stat

2'-7 [⊉] /	
1 LADDER PWD), TYP.	
UT	
12"¢ UNDERDRAIN PIPE #29	
PVC PIPE CAP WITH THREADED PLUG. DRILL 1" SLOW RELEASE ORIFICE. INVERT: 113.22	
PWD STANDARD TRAP	
15"¢ VCP OUTFLOW PIPE #51	
112.00	
109.00	
Ŧ	
Т	
RE	
21 (2008), THE CONTRACTOR 1-800-242-1776, AT LEAST	
PA ONE CALL <u>201919</u> .	32559
CTURE PROJECT	
REBUILD - SHEET 1	
CITY OF PHILADELPHIA WATER DEPARTMENT SCALES:	N .
PLAN PROFILE VERT.	1"=10' 1"=10'
HORIZ. SECTION	1"=5' 1/4"=4'
DRAWN BY MJR, MAD PROJECT. ENGR. AMM	08/15/22 08/15/22
SUPERVISOR	DATE

15"ø VCP OUTFLOW PIPE #51

▲ △

1550

12"ø UNDERDRAIN — PIPE #29


- 6'-2<u>3</u>" -


₫. _____

12"¢ DISTRIBUTION PIPE #3

 \rightarrow


12"Ø DISTRIBUTION _____ PIPE #17

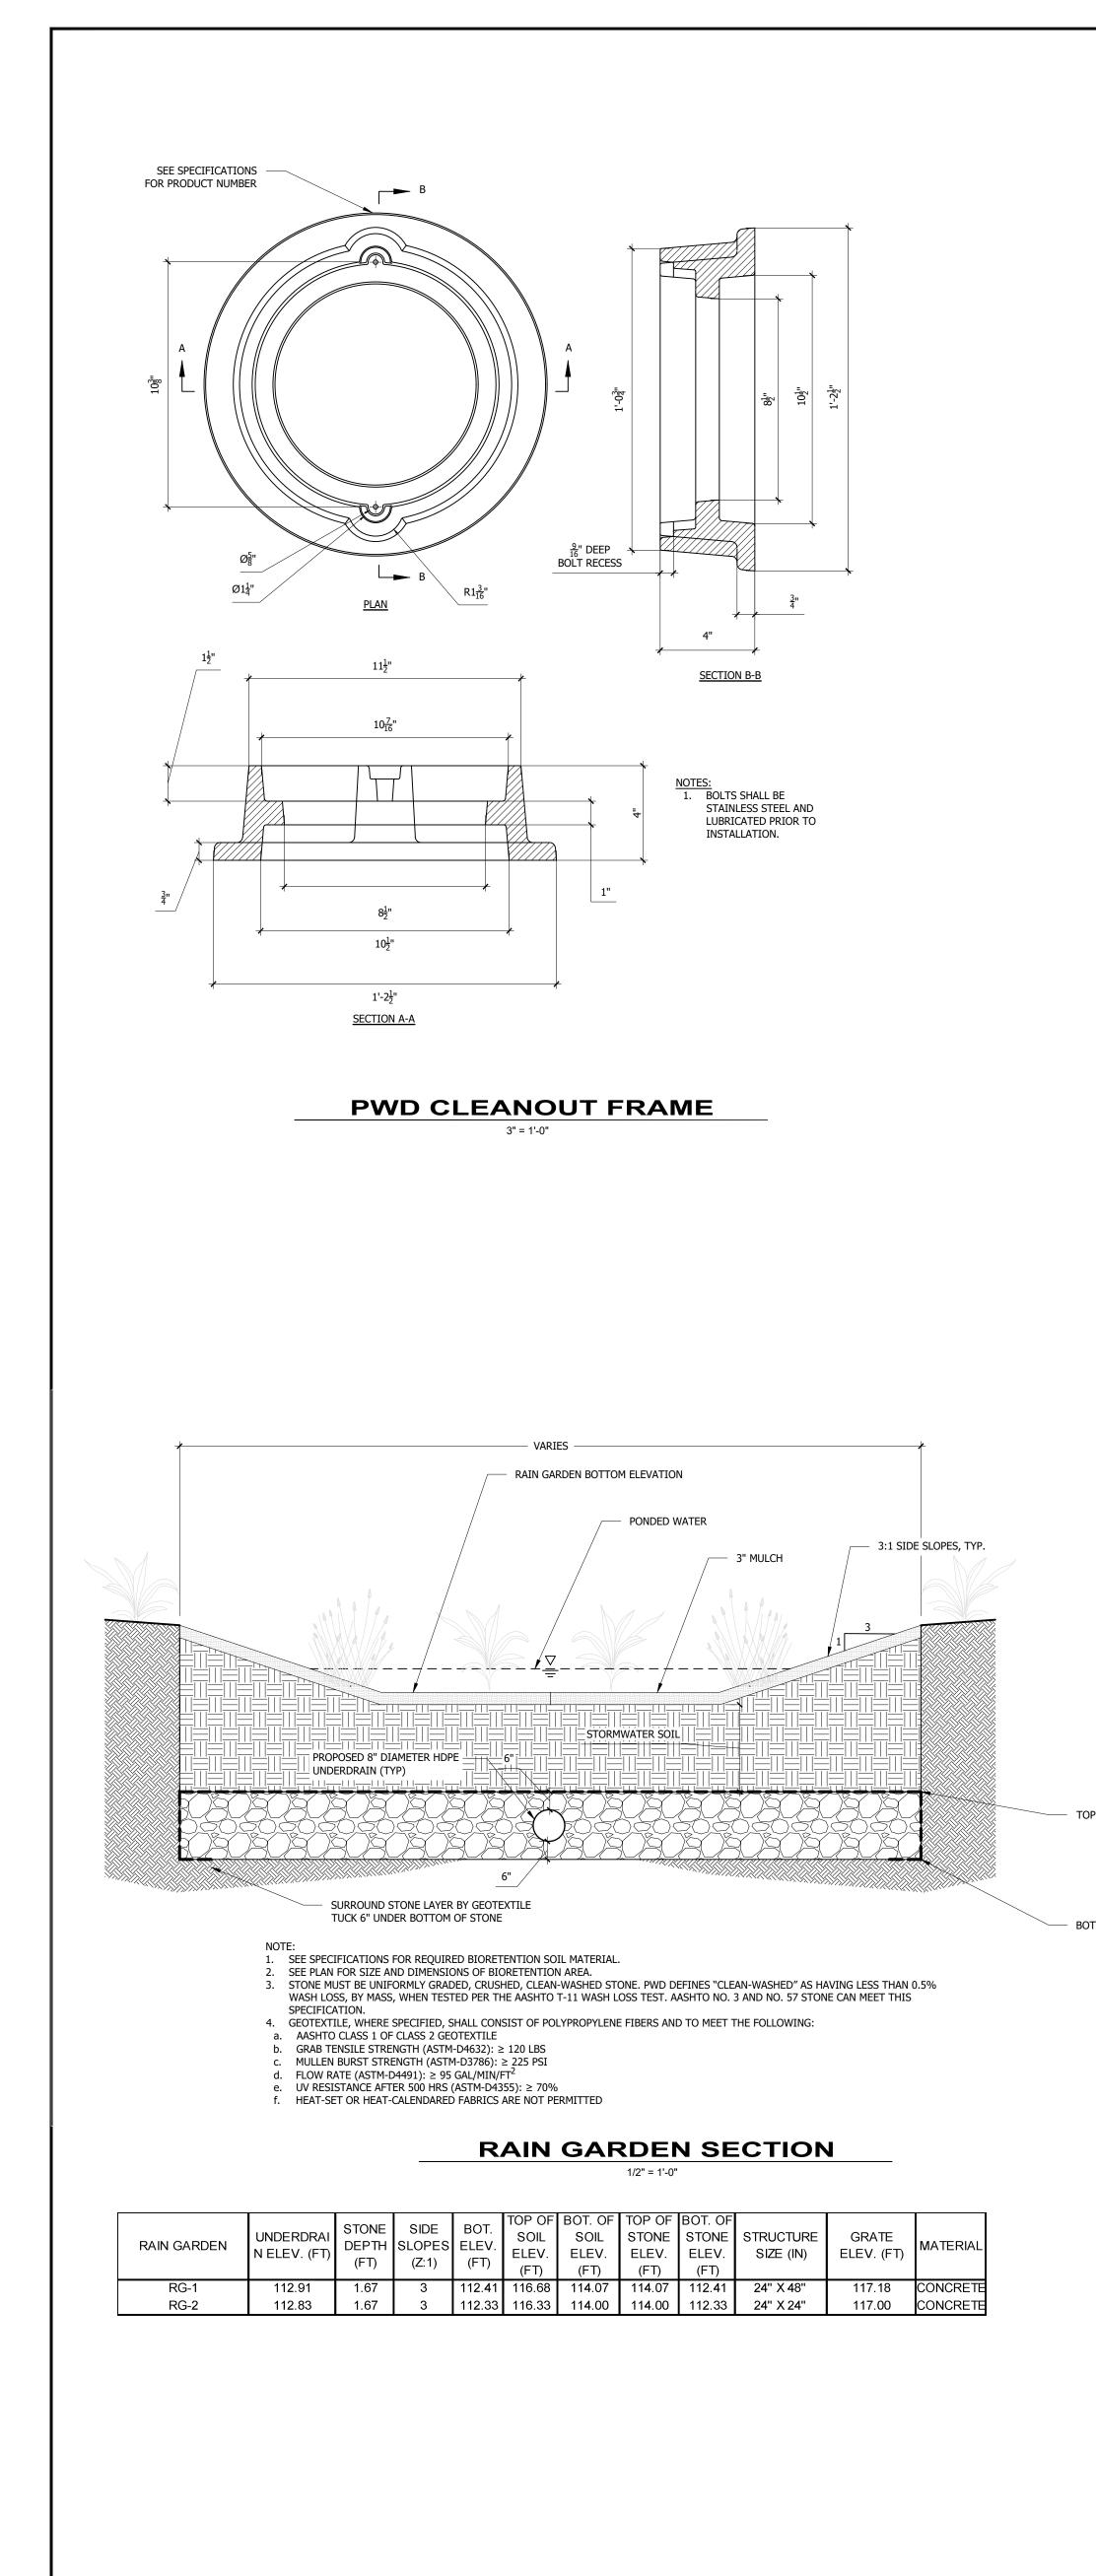

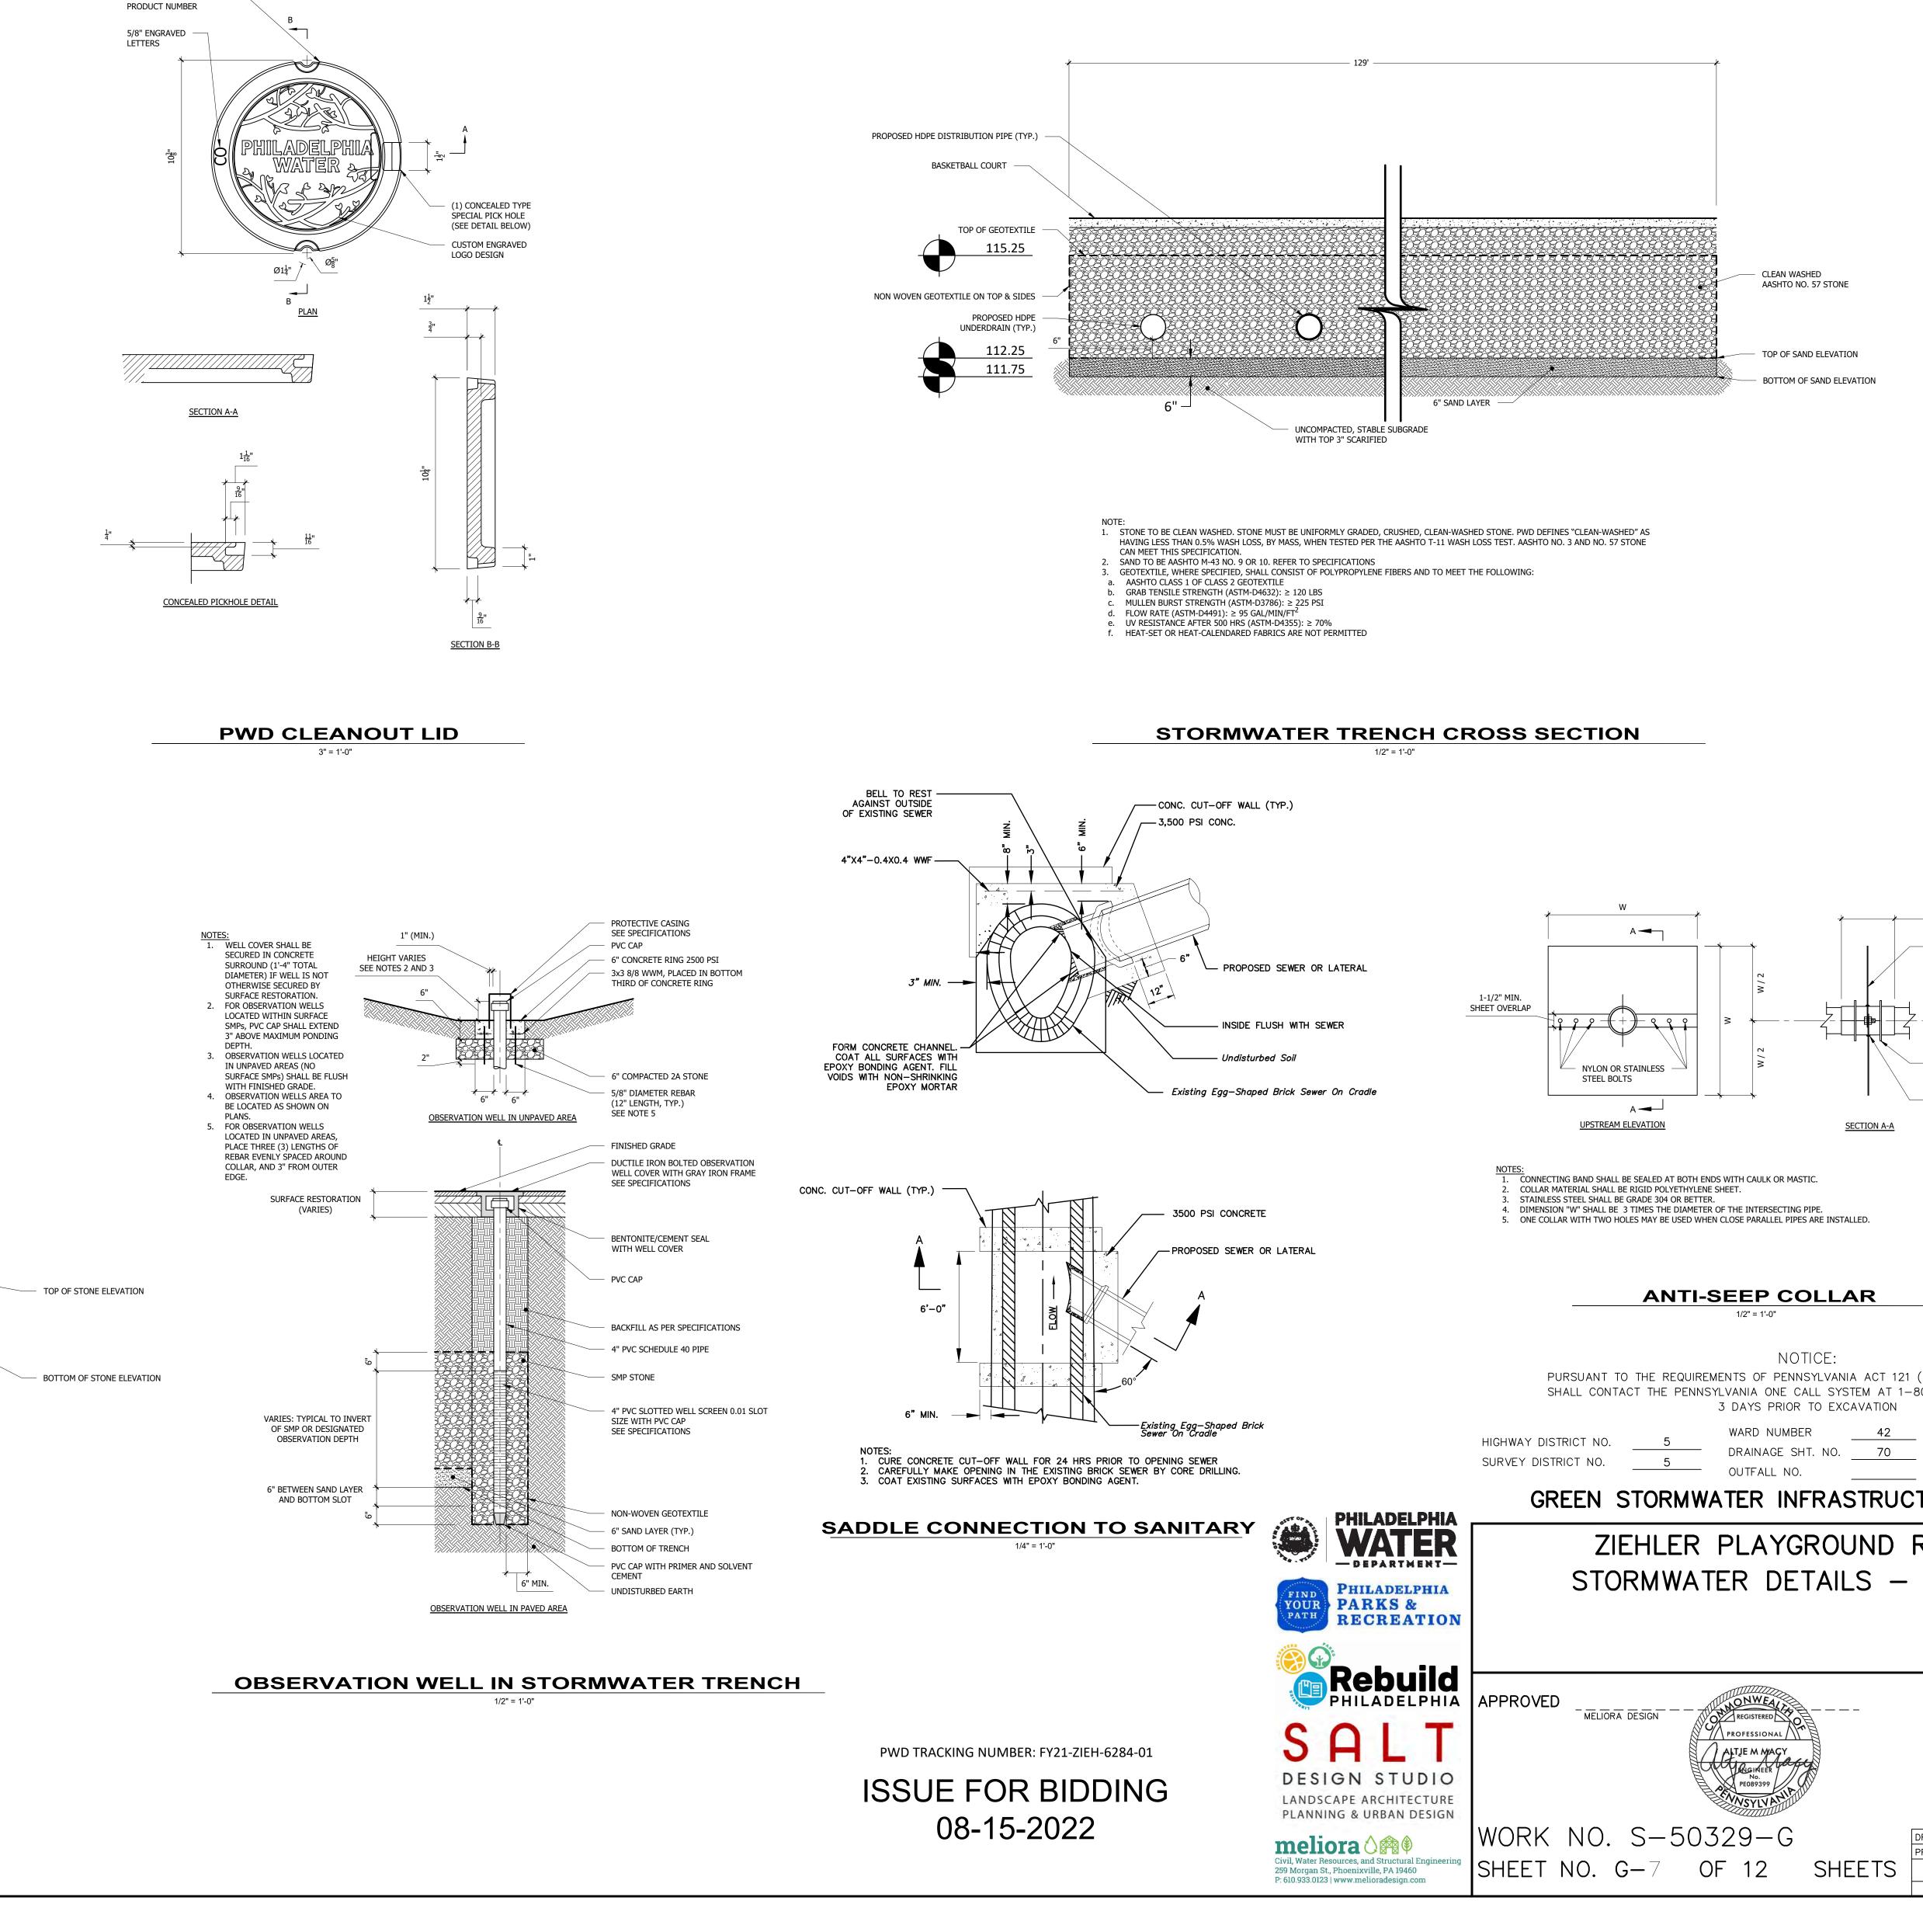

SEE SPECIFICATIONS FOR

CONNECTING BAND	
 — 1/4" THICK HIGH DENSITY POLYETHYLENE COLLAR 	
 — 1/2" WIDE STAINLESS STEEL CLAMP (EACH SIDE) 	
 CONTINUOUS PLASTIC WELD (EACH SIDE) 	
(2008), THE CONTRACTOR	
300–242–1776, AT LEAST	
PA ONE CALL <u>201919</u> 3	32559
TURE PROJECT	
REBUILD	
SHEET 2	
CITY OF PHILADELPHIA WATER DEPARTMENT SCALES:	
PLAN PROFILE VERT.	1"=10' 1"=10'
HORIZ. SECTION	1"=5' 1/4"=4'
DRAWN BY MJR, MAD PROJECT. ENGR. AMM	08/15/22 08/15/22
SUPERVISOR	DATE

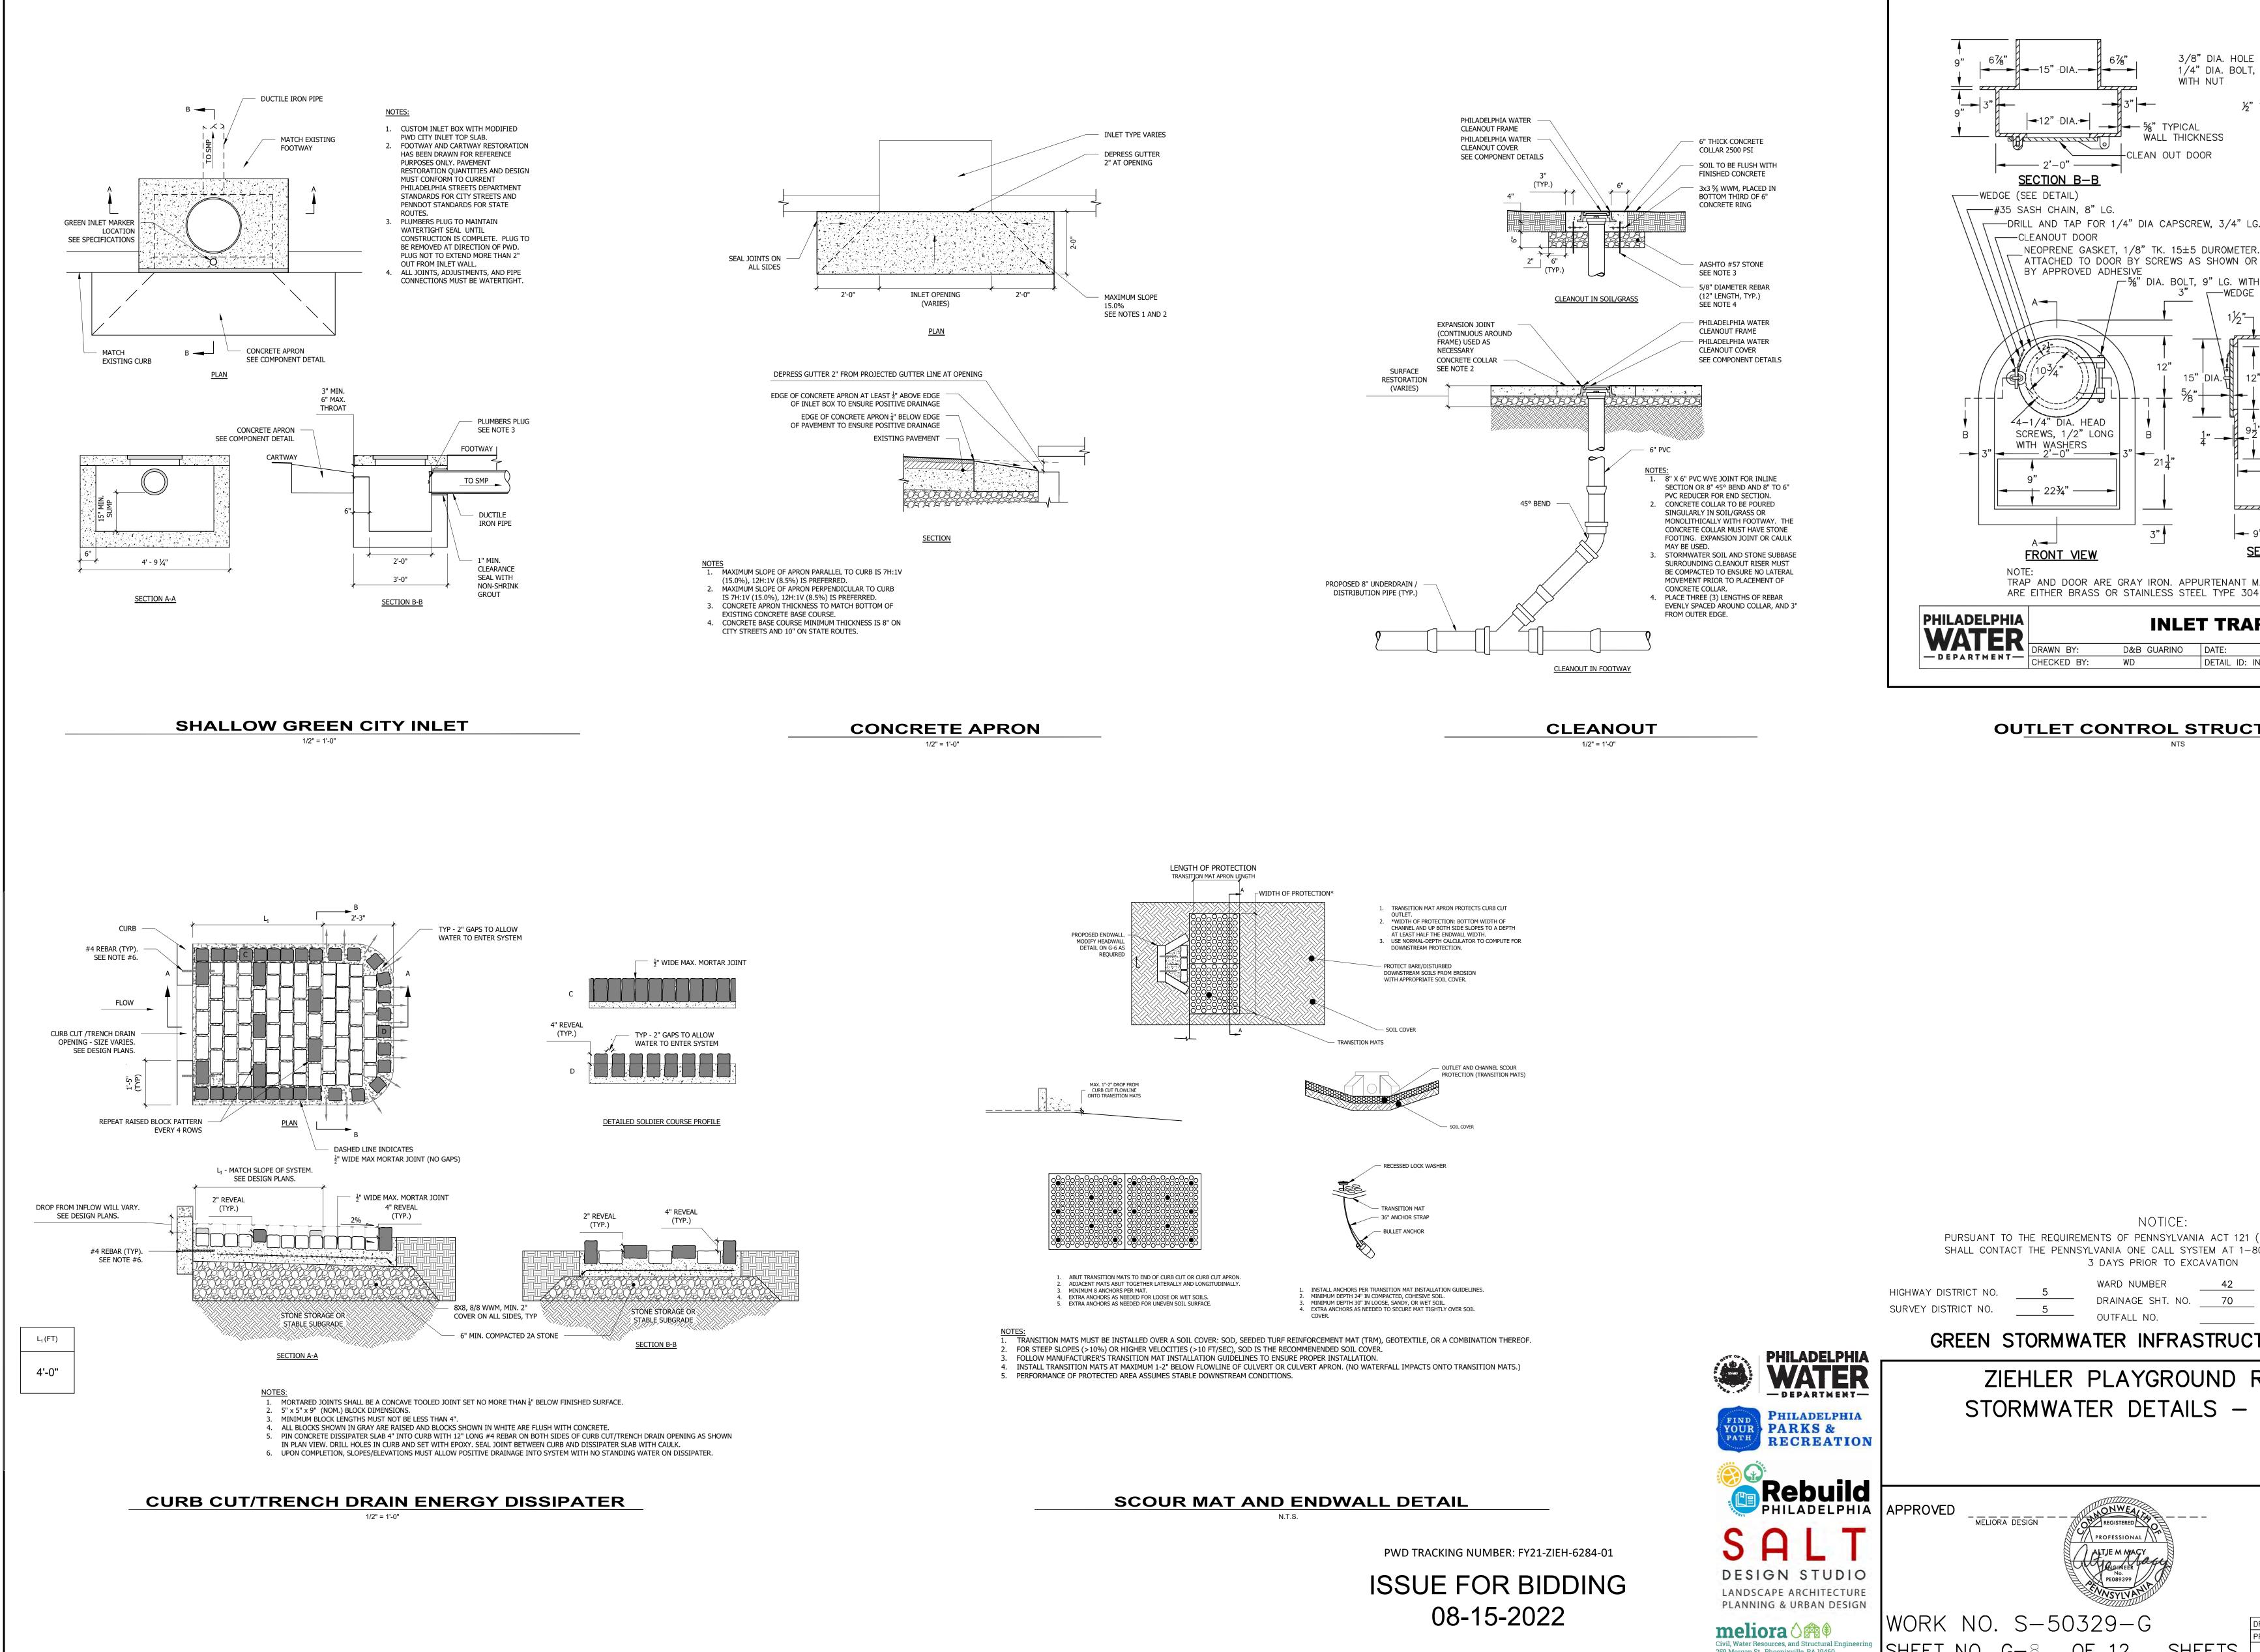



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The NUT $3^{"}$ $2^{"}$ $15^{"}$	
P JAN. 2019 INLET-08 REV.: 0	
TURE TRAP	
(2008), THE CONTRACTOR 800—242—1776, AT LEAST -	
PA ONE CALL <u>2019193</u> TURE PROJECT	32559
REBUILD SHEET 3	
CITY OF PHILADELPHIA WATER DEPARTMENT SCALES: PLAN PROFILE VERT. HORIZ. SECTION	1"=10' 1"=10' 1"=5' 1/4"=4'
DRAWN BY MJR, MAD PROJECT. ENGR. AMM	08/15/22 08/15/22
SUPERVISOR	DATE

GREEN STORMWATER INFRASTRUCTURE NOTES

- 1. THE CONTRACTOR PERFORMING THE GREEN STORMWATER INFRASTRUCTURE INSTALLATION MUST BE PREQUALIFIED BY THE PHILADELPHIA WATER DEPARTMENT (PWD). CONTACT MR. BRIAN MOHL OF THE PROJECTS MANAGEMENT UNIT AT (215) 685-6339.
- 2. THE APPROVED WORK SHALL BE DONE IN THE PRESENCE OF A PWD INSPECTOR.
- 3. THE CONTRACTOR PERFORMING THIS WORK IS TO NOTIFY THE PWD CONSTRUCTION DIVISION, 1101 MARKET STREET, 2nd FLOOR, PHONE (215) 685-6345, AT LEAST 7 DAYS IN ADVANCE FOR ASSIGNMENT OF AN INSPECTOR TO THE JOB.
- 4. THE CONTRACTOR MUST PROVIDE OFFICE SPACE FOR USE BY THE PWD INSPECTOR **DURING CONSTRUCTION.**
- 5. APPROVAL OF THESE PLANS BY THE WATER DEPARTMENT IS STRICTLY LIMITED TO THE DESIGN OF GREEN STORMWATER INFRASTRUCTURE SHOWN WITHIN THE LIMITS OF THE CITY OF PHILADELPHIA PUBLIC RIGHT OF WAY.
- 6. CONTACT MR. ERIK SMITH, PWD-WATER TRANSPORT RECORDS, 1101 MARKET STREET. 2ND FLOOR, PHONE (215) 685-6270, FOR ADDITIONAL APPROVALS AND PERMITS REQUIRED FOR ALL SEWER CONNECTIONS TO EXISTING AND/OR PROPOSED PWD FACILITIES.
- 7. FIELD-FABRICATED WYE BRANCHES AND BENDS ARE NOT PERMITTED. 8. A LIST OF ALL MATERIALS AND SUPPLIERS MUST BE SUBMITTED TO THE PWD
- CONSTRUCTION BRANCH FOR APPROVAL. 9. THE CONTRACTOR OR ENGINEER IS RESPONSIBLE FOR OBTAINING ALL ADDITIONAL PERMITS AND APPROVALS FROM ALL AFFECTED CITY AGENCIES AND UTILITIES.
- 10. PRIOR TO OBTAINING A BUILDING PERMIT, THE CONTRACTOR IS REQUIRED TO OBTAIN PWD STORMWATER MANAGEMENT APPROVAL, AND SEWAGE FACILITIES PLANNING (ACT 537) APPROVAL.
- 11. ANY CHANGE TO, OR DEVIATION FROM, THE FINAL APPROVED DESIGN PLANS DURING CONSTRUCTION MUST BE APPROVED BY THE ASSIGNED PWD-CONSTRUCTION DIVISION ENGINEER AND BY THE PWD DESIGN PROJECT ENGINEER.
- 12. PWD RESERVES THE RIGHT TO REQUEST ADDITIONAL BORINGS DURING CONSTRUCTION SHOULD THE SOIL EXCAVATED IN THAT AREA APPEAR TO BE UNSUITABLE.
- 13. ANY TRENCH WHERE THE CUT IS DEEPER THAN 10 FEET WILL REQUIRE A DETAILED SHORING PLAN PREPARED BY A REGISTERED PROFESSIONAL ENGINEER TO BE SUBMITTED TO PWD FOR APPROVAL BEFORE WORK CAN BEGIN.
- 14. PLACE AND COMPACT BACKFILL IN ACCORDANCE WITH THE STANDARD SPECIFICATIONS FOR EXCAVATION, REFILLING, GRADING, LANDSCAPING AND **REPAVING.**
- 15. ALL SIDEWALK AND CURBING TO BE REPLACED IN KIND ALONG FULL LIMITS OF CONSTRUCTION TO NEXT EXISTING JOINT OR AS DIRECTED BY PWD.
- 16. MAINTAIN AND PROTECT EXISTING INLETS. SHOULD THE EXISTING INLETS BE IN ANY WAY DAMAGED DURING CONSTUCTION, THESE SHOULD BE REPAIRED TO THE SATISFACTION OF THE PWD INSPECTOR OR REPLACED PER PWD STANDARDS.
- 17. CONTRACTOR MUST COMPLY WITH EROSION AND SEDIMENT CONTROL REQUIREMENTS DURING CONSTRUCTION. SEE PWD REGULATION 501.3 AND 600.4, PHILA CODE S. 13-603, AND 25 PA CODE CHAPTER 102.
- 18. SUFFICIENT EROSION AND SEDIMENTATION CONTROL MEASURES WILL BE INSTALLED AND MAINTAINED BY THE CONTRACTOR AS TO PREVENT STANDING WATER OR SEDIMENTATION OF STORMWATER SYSTEMS. GREEN STORMWATER INFRASTRUCTURE SYSTEMS DETERMINED BY PWD TO BE INADEQUATELY PROTECTED AND THEREBY COMPROMISED WILL BE REPLACED TO THE EXTENT REQUIRED BY PWD (UP TO AND INCLUDING FULL REPLACEMENT) AT NO ADDITIONAL COST TO PWD.
- 19. CONTRACTOR IS REQUIRED TO UNDERTAKE NECESSARY MEASURES TO PREVENT SEDIMENT FROM LEAVING THE WORK SITE, TO PREVENT EROSIVE CONDITIONS, AND TO SUPPRESS DUST ON THE SITE AND SURROUNDING AREAS. CONTRACTOR MUST COVER AND SURROUND STOCKPILES WITH EROSION CONTROL MEASURES TO ENSURE SEDIMENT DOES NOT MIGRATE INTO THE PUBLIC ROW OR ENTER THE PUBLIC SEWER. IF CONTRACTOR IS HAND DIGGING OR EXCAVATING, CONTRACTOR MUST SWEEP WORK SITE AT THE END OF EACH WORK DAY. THE CITY MAY REQUIRE THE CONTRACTOR / OWNER TO CLEAN CITY-OWNED INLETS AND SYSTEMS AFFECTED BY NONCOMPLIANT OR FAILED E&S CONTROLS.
- 20. CONTRACTOR MUST INSTALL INLET PROTECTION MEASURES AT ALL INLETS ADJACENT TO OR WITHIN THE WORK AREA. INLET PROTECTION MEASURES MUST BE INSPECTED DAILY TO ENSURE PROPER PLACEMENT, AND MAINTAINED, POSITIONED OR REPLACED AS NEEDED TO ENSURE PROPER FUNCTION AND TO PREVENT FLOODING. REFER TO PWD GUIDANCE FOR APPROPRIATE MATERIALS AND PROTECTION METHODS FOR OPEN-MOUTH INLETS, HIGHWAY GRATE INLETS. TRENCH DRAINS AND CURB-CUT INLETS.
- 21. CONTRACTOR MUST OBTAIN PERMISSION FROM THE STREETS DEPARTMENT TO STORE ANY MATERIALS ON THE STREET.
- 22. ORIFICE SHOULD NOT BE DRILLED PRIOR TO AUTHORIZATION BY PWD. PWD WILL REVIEW THE RESULTS OF THE DOUBLE RING INFILTROMETER TESTS CONDUCTED AFTER SMP EXCAVATION AND WILL CONFIRM ORIFICE DIMENSIONS.
- 23. EROSION CONTROL MATTING SHALL BE PLACED OVER ALL SOIL SURFACES NOT STABILIZED BY PLANTING.
- 24. ALL HDPE PIPES MUST MEET THE SPECIFICATIONS OF AASHTO M252, TYPE S OR AASHTO M294, TYPE S.




PHILADELPHIA

WATER

— DEPARTMENT—

PHILADELPHIA

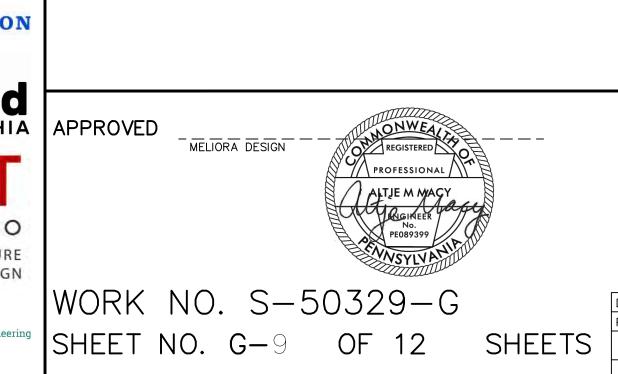


ZIEHLER PLAYGROUND STORMWATER NOTE

SURVEY DISTRICT NO. <u>5</u> OUTFALL NO. GREEN STORMWATER INFRASTRUC


SHALL CONTACT THE PENNSYLVANIA ONE CALL SYSTEM AT 1-8 3 DAYS PRIOR TO EXCAVATION HIGHWAY DISTRICT NO. 5 WARD NUMBER DRAINAGE SHT. NO. ______

NOTICE: PURSUANT TO THE REQUIREMENTS OF PENNSYLVANIA ACT 121


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DRAWN BY	MJR, MAD	08/15/22
PROJECT. ENGR.	АММ	08/15/22
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DRAWN BY MJR, MAD 08/15/22 PROJECT. ENGR. AMM 08/15/22	
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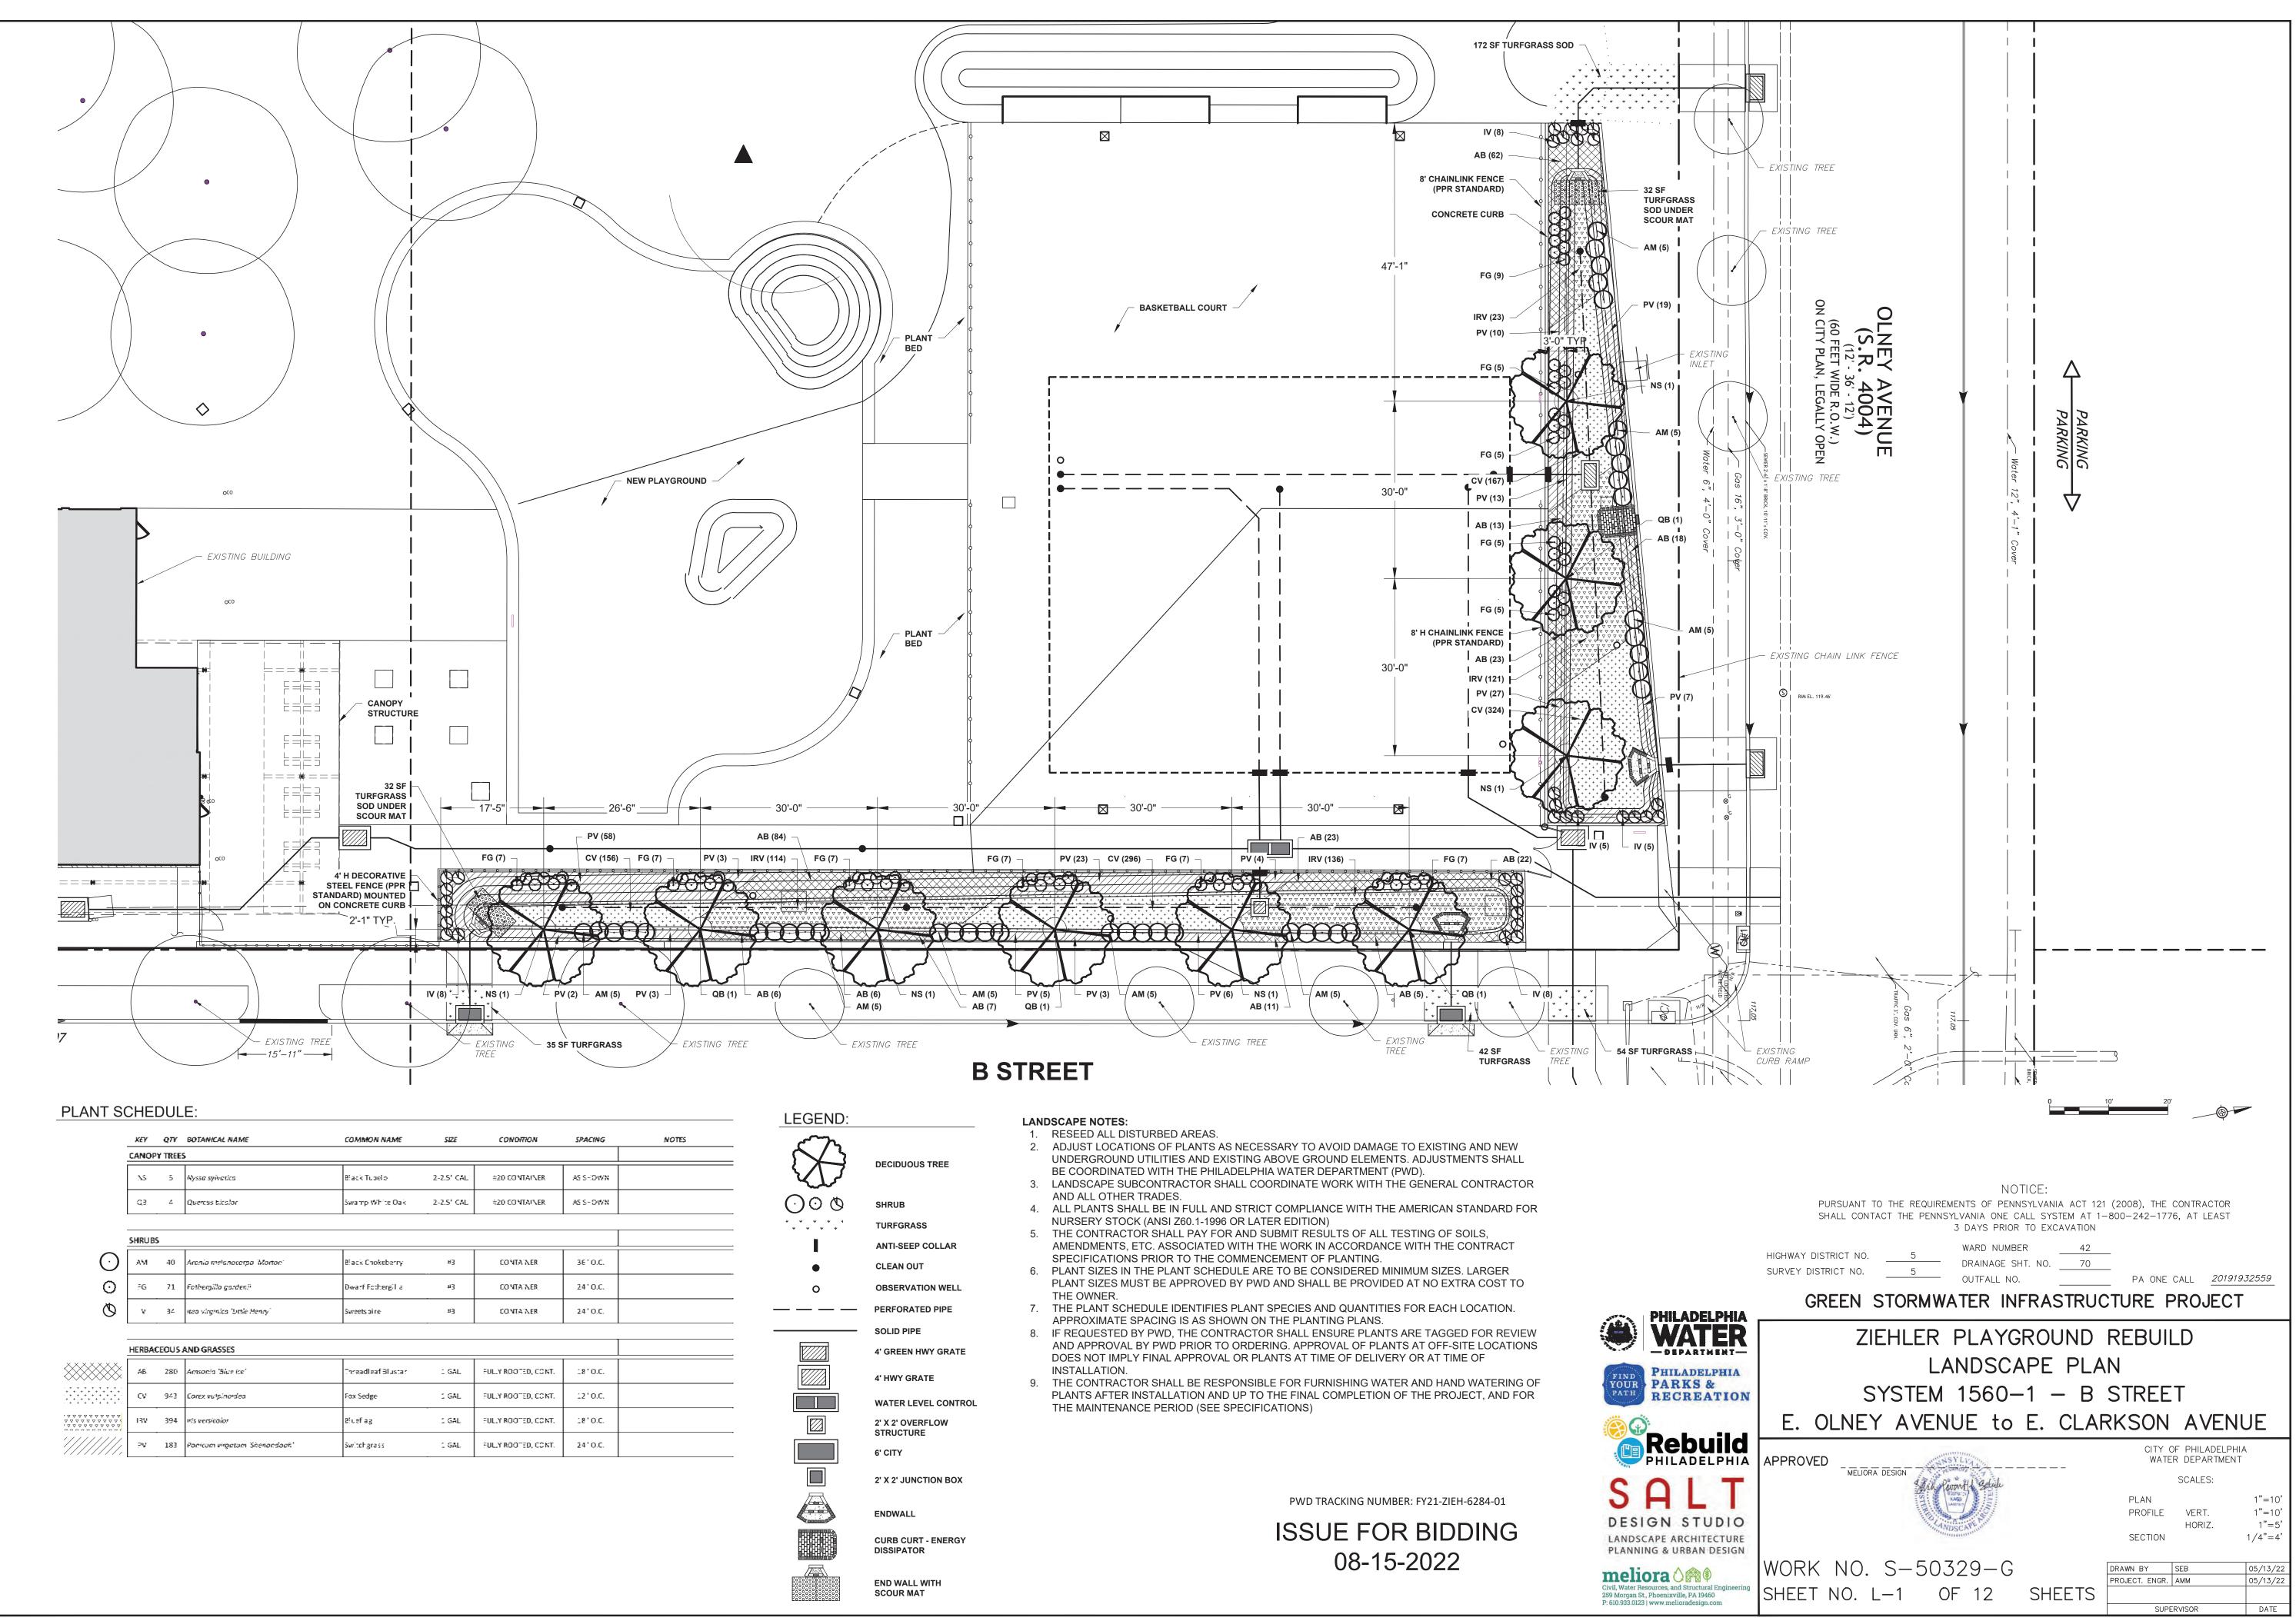


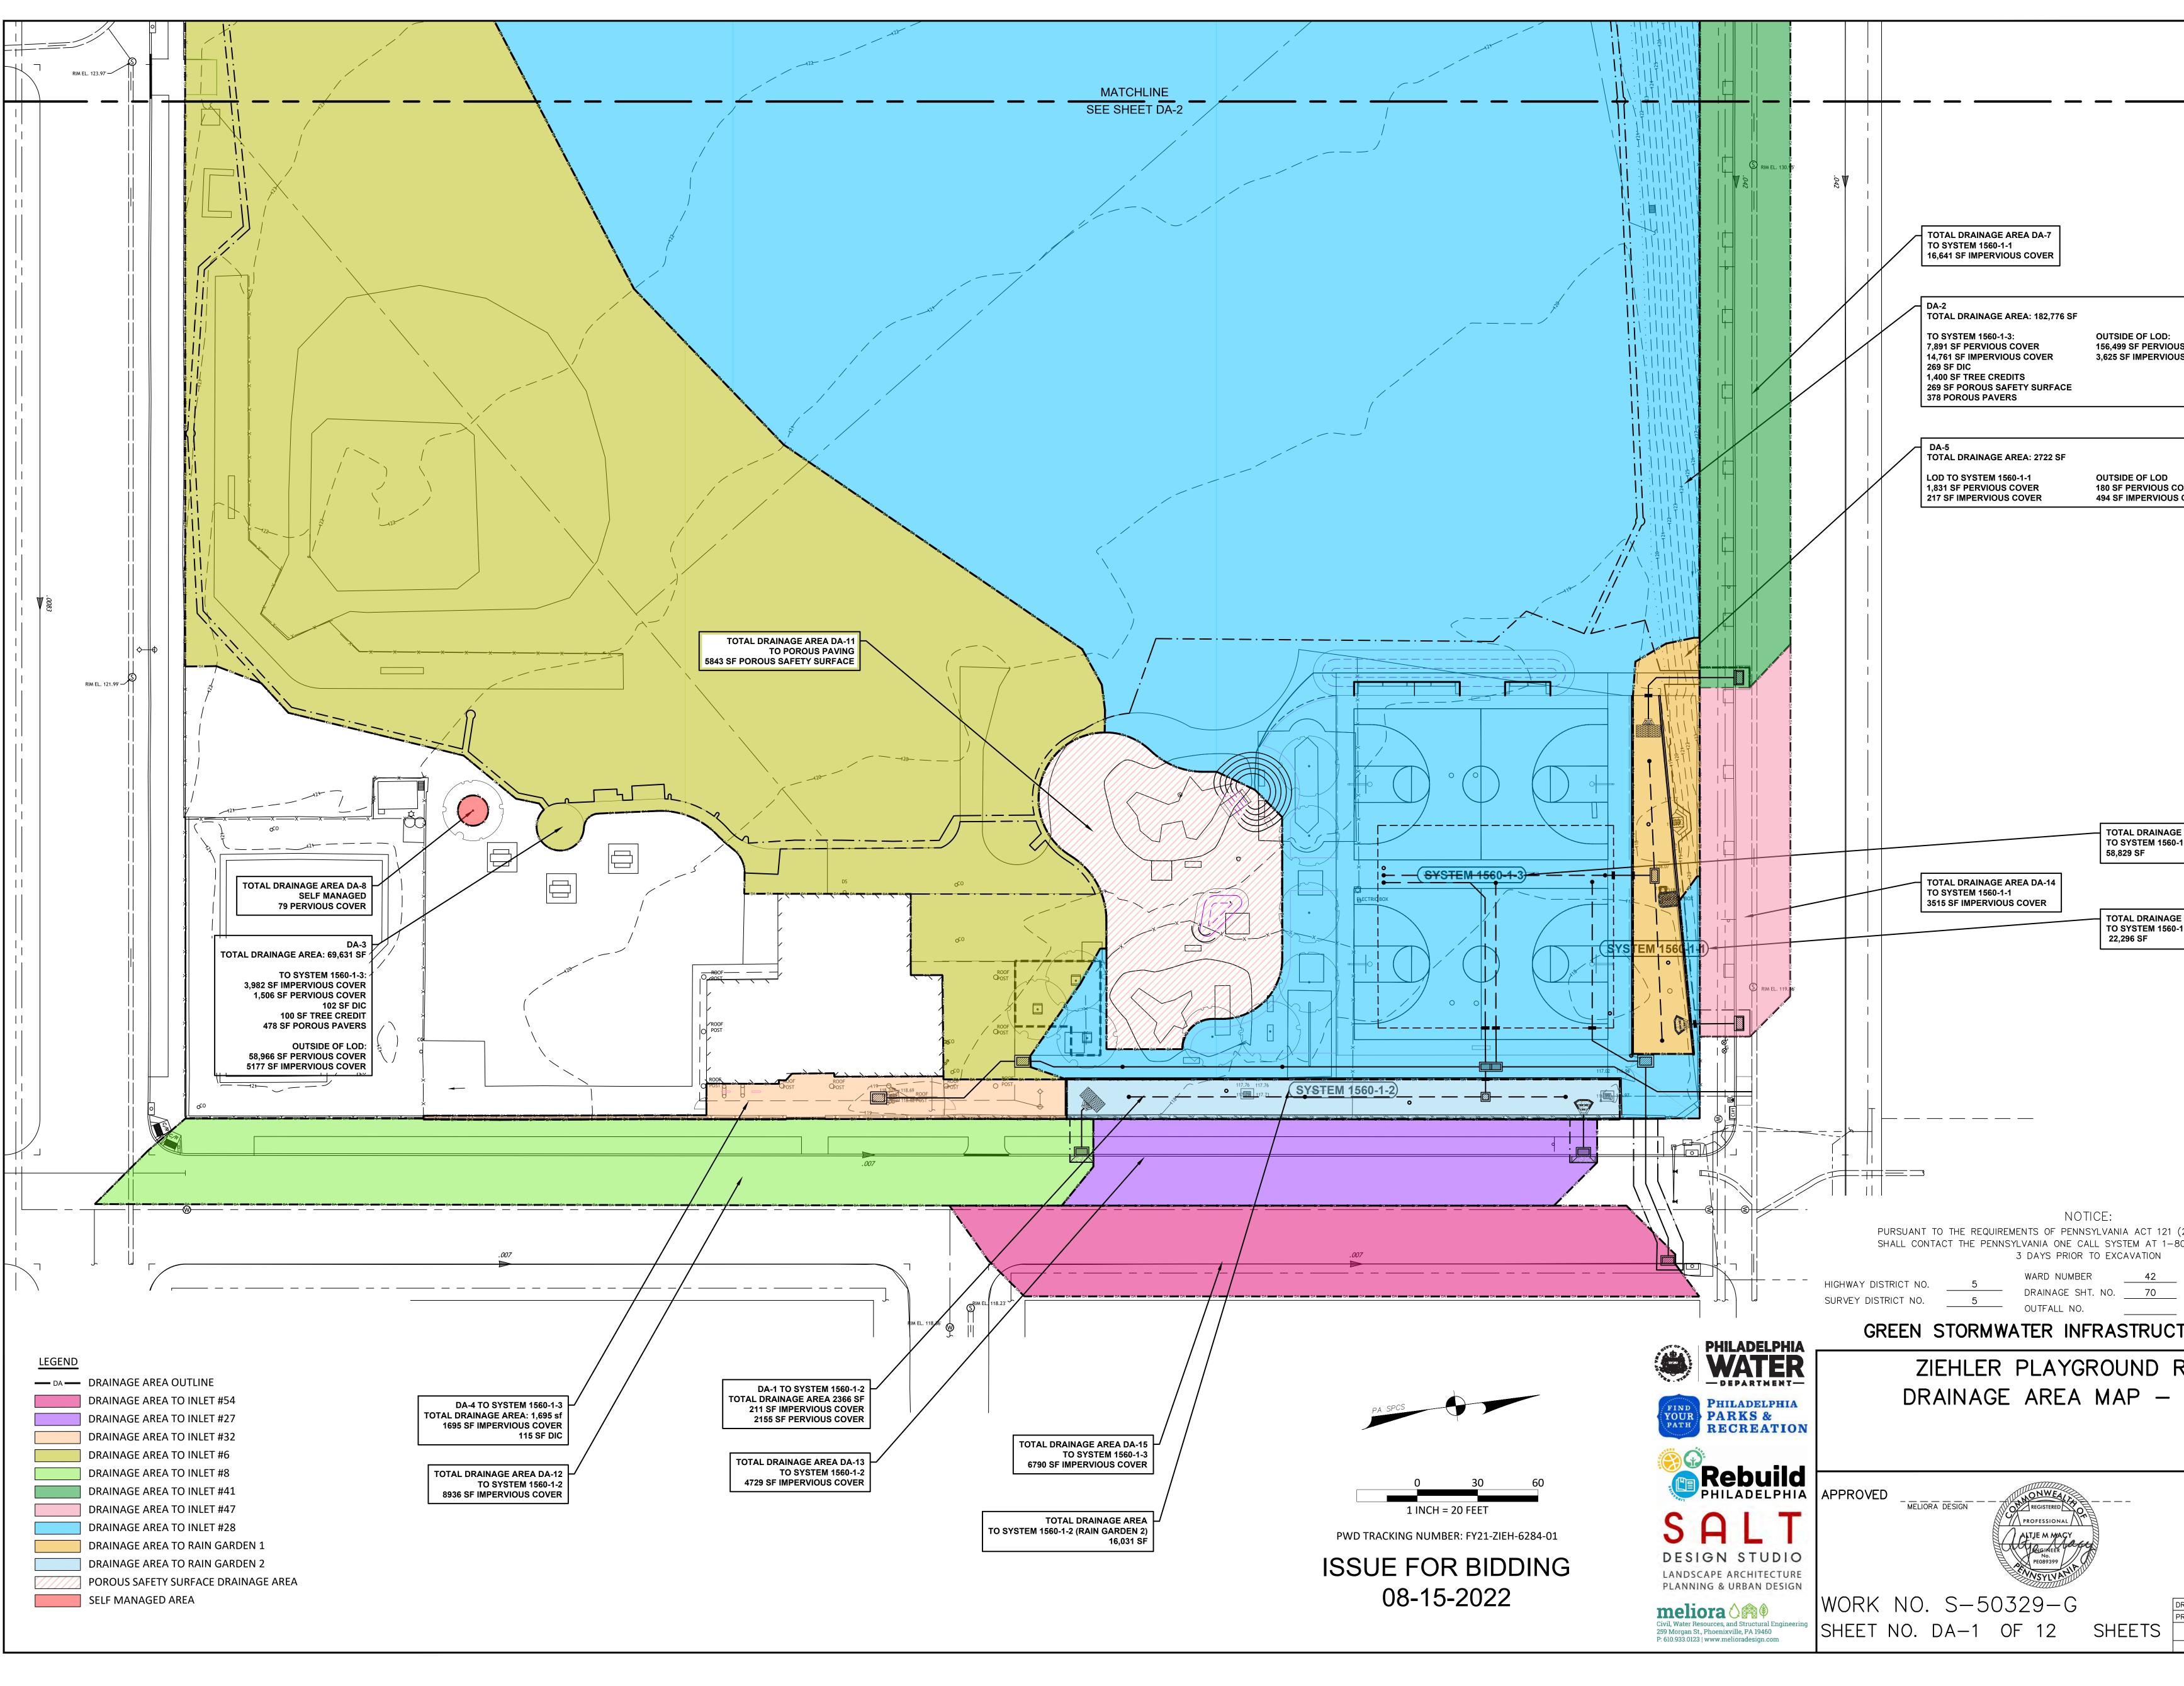
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DRAINAGE AREA TO INLET #28
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DRAINAGE AREA TO RAIN GARDEN 2
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SELF MANAGED AREA




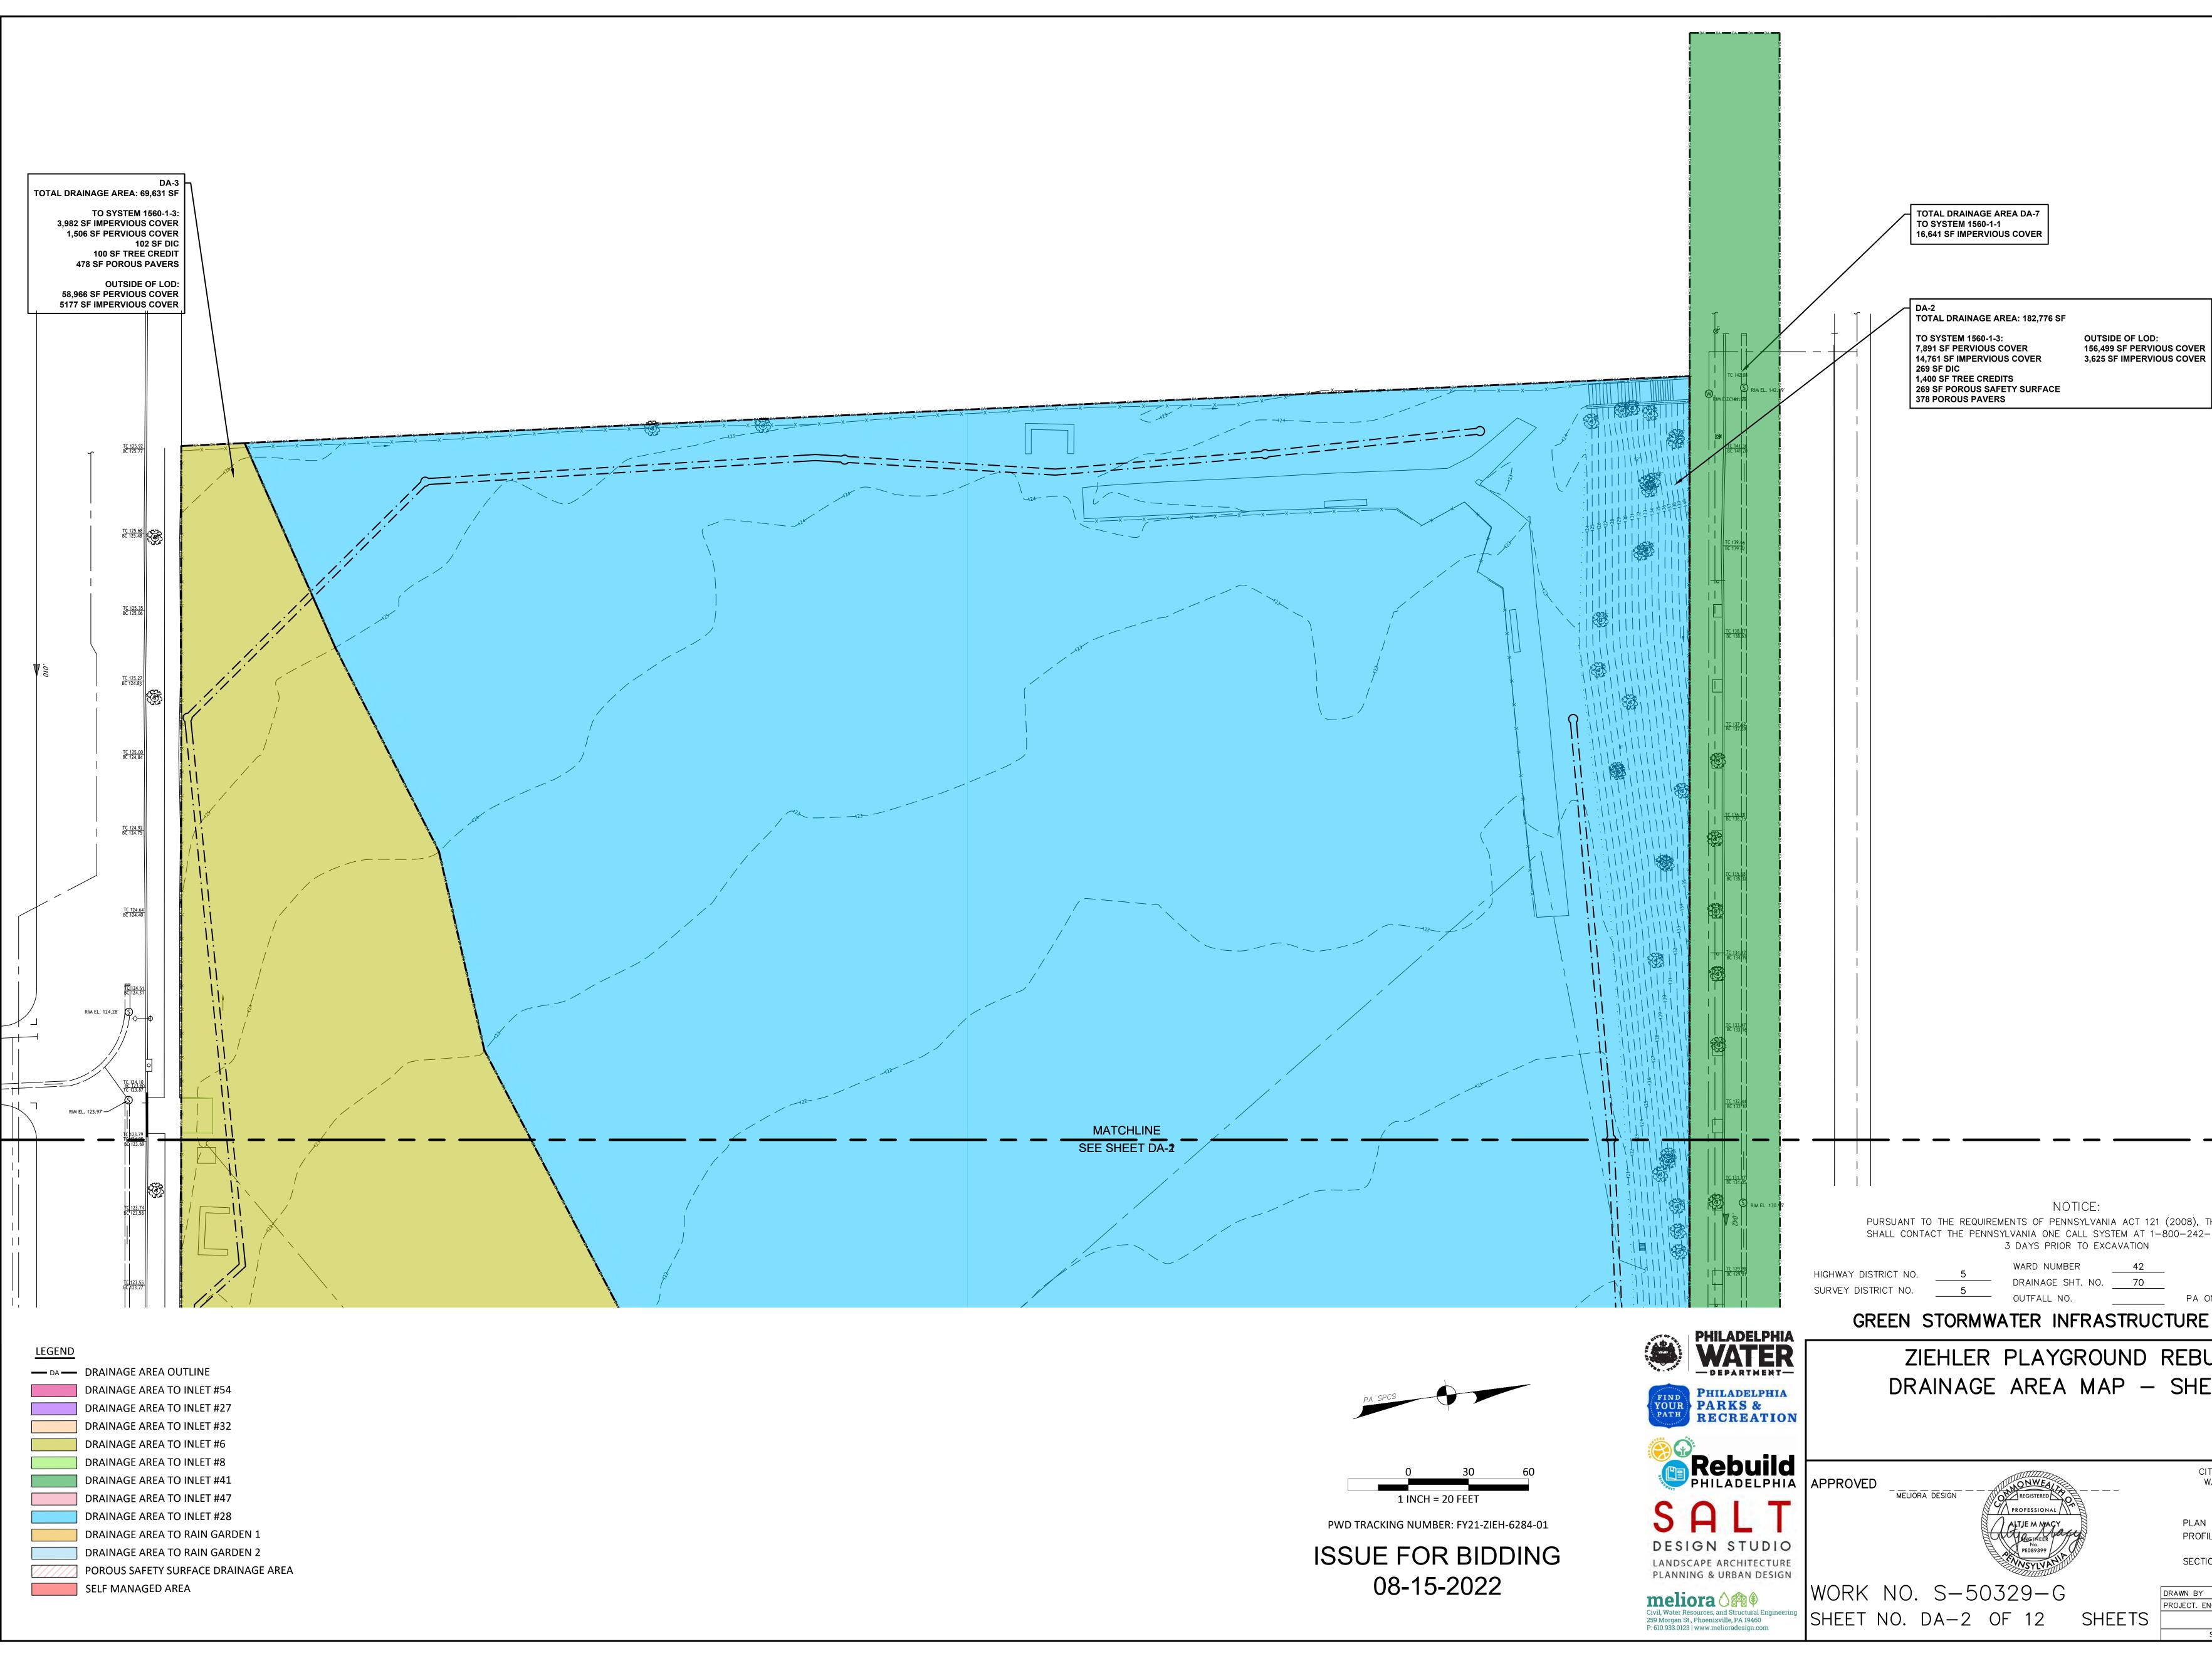

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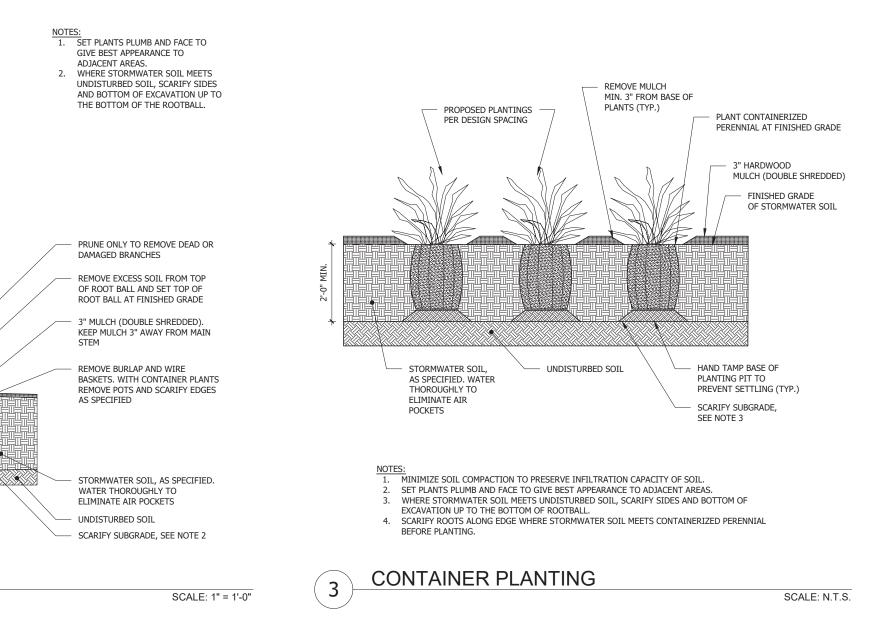


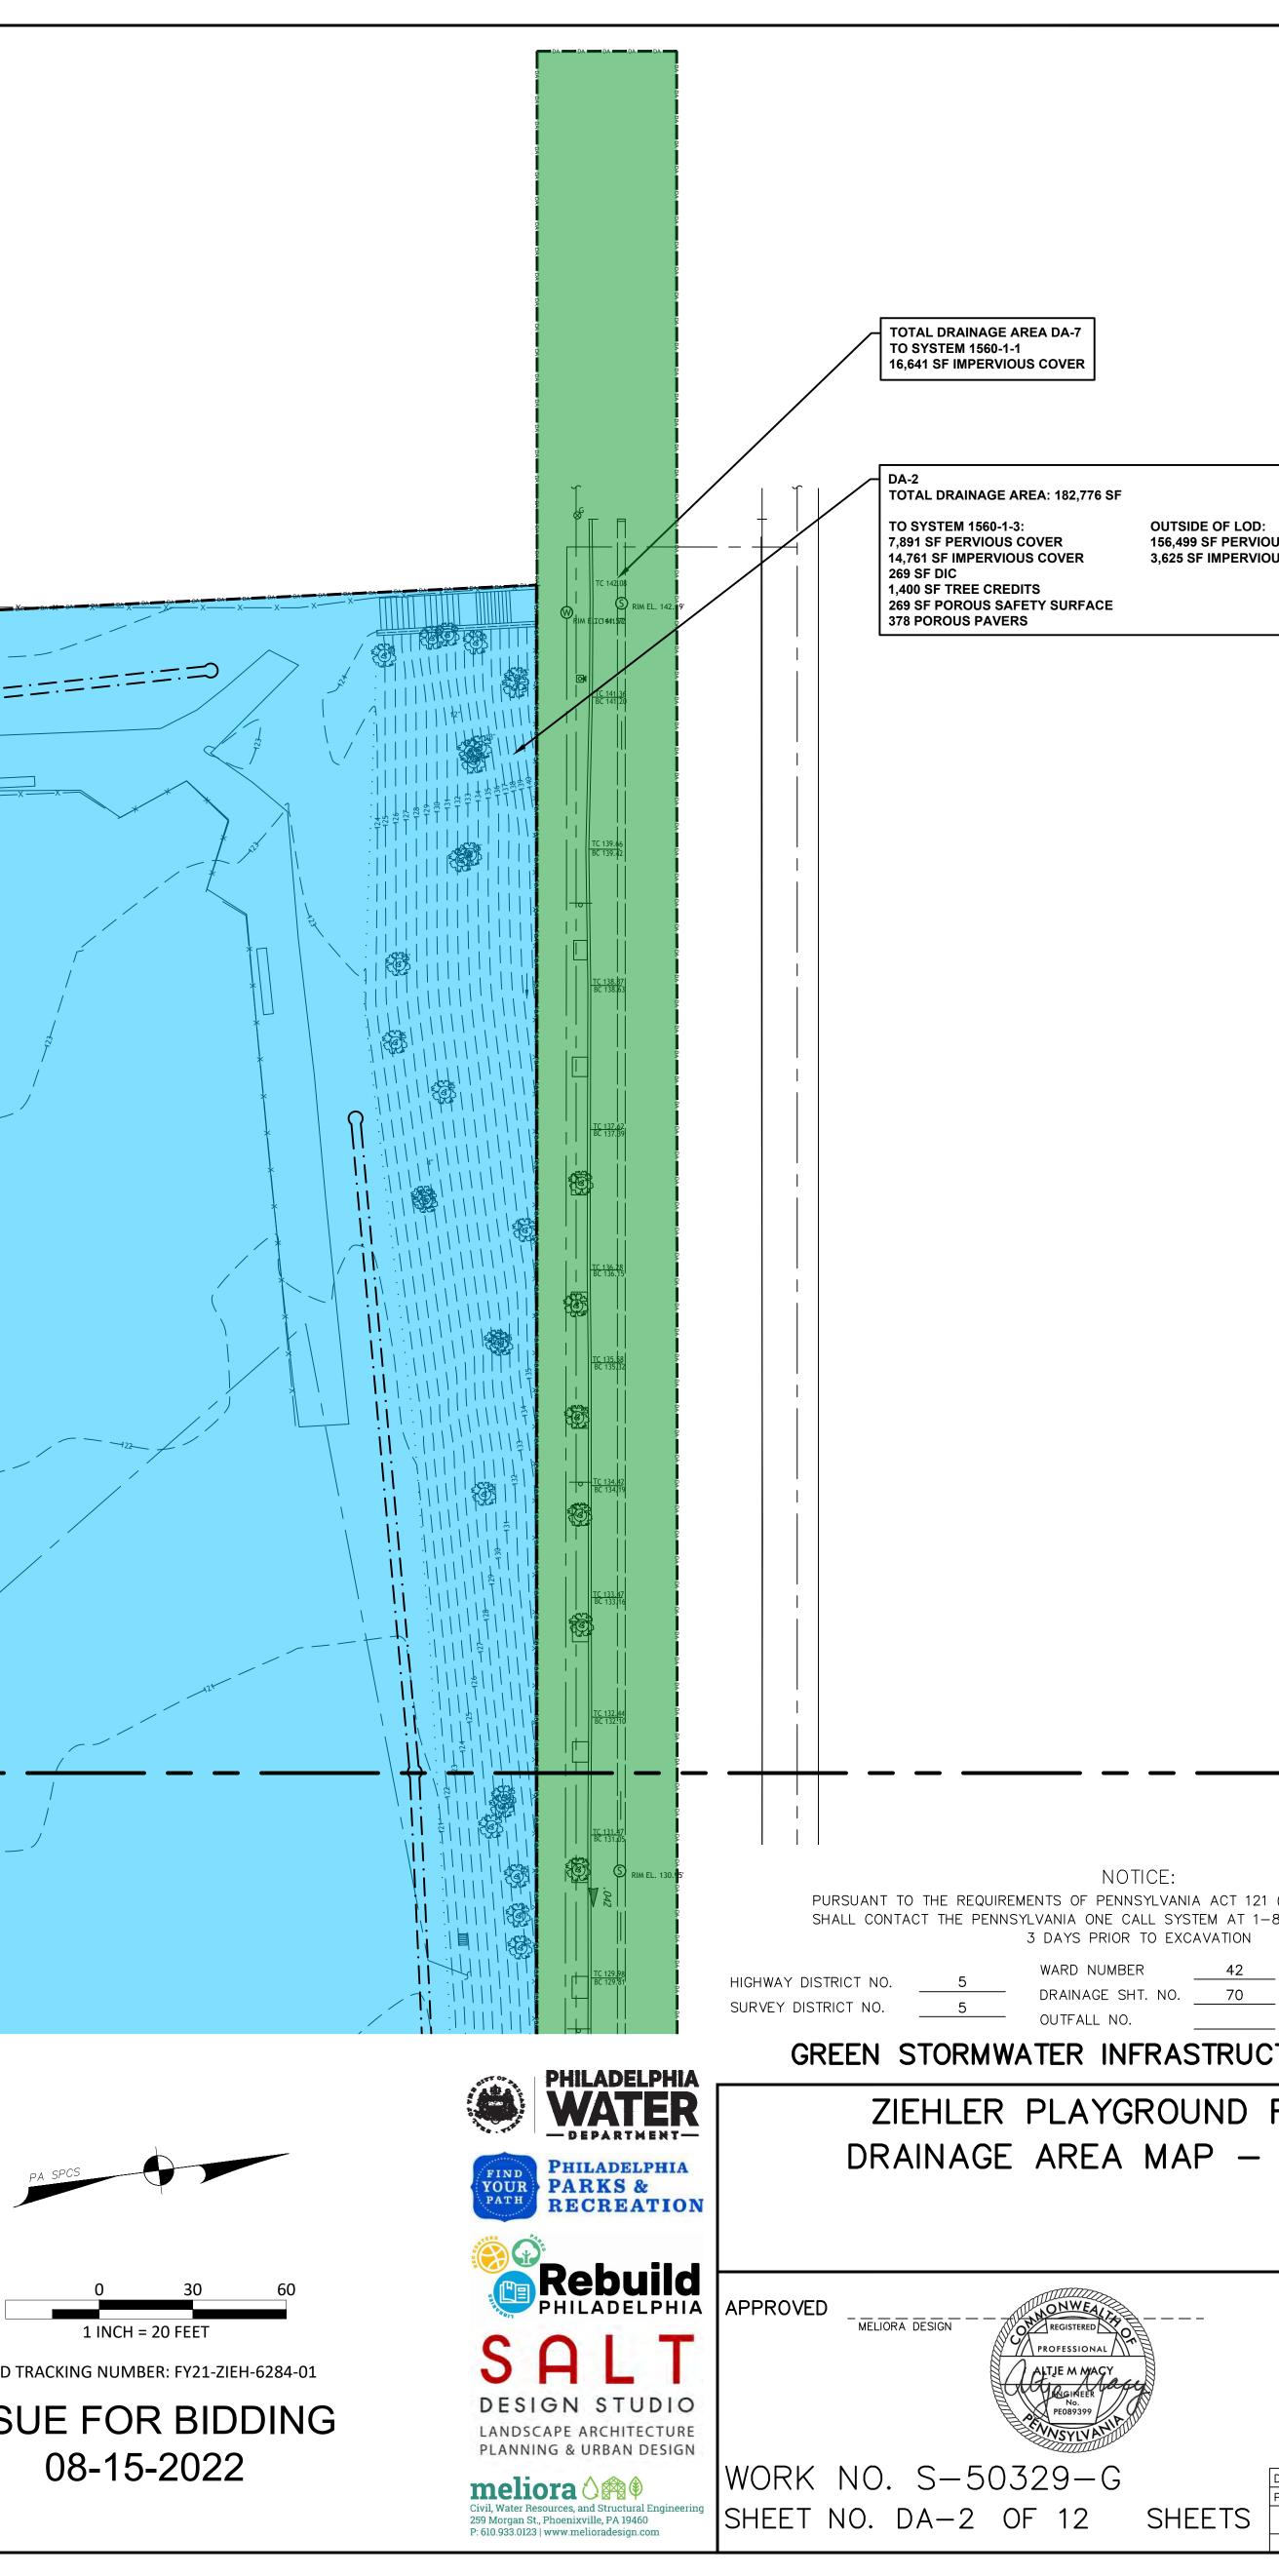

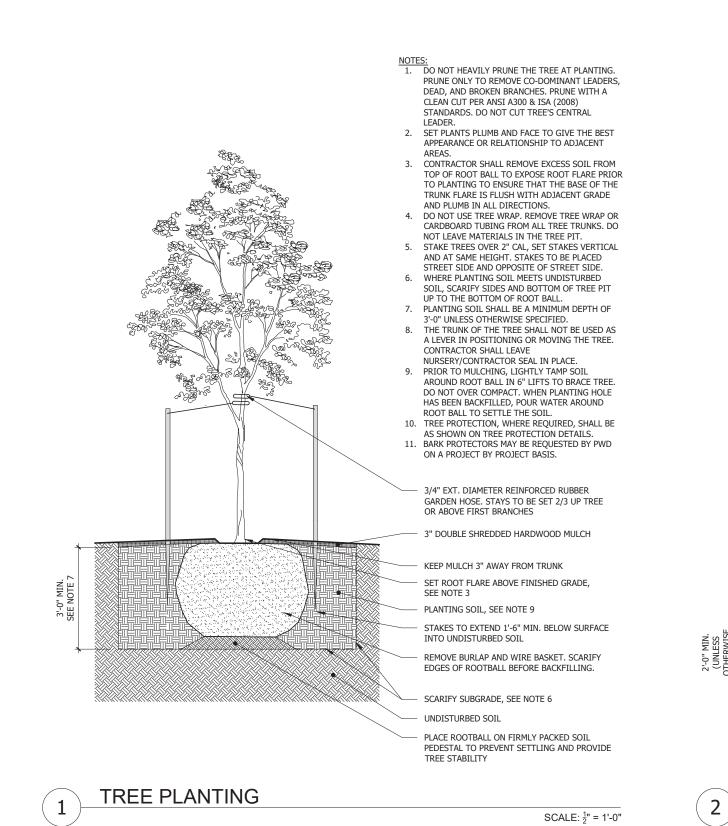

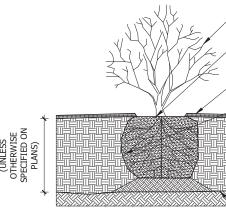2 SHRUB PLANTING


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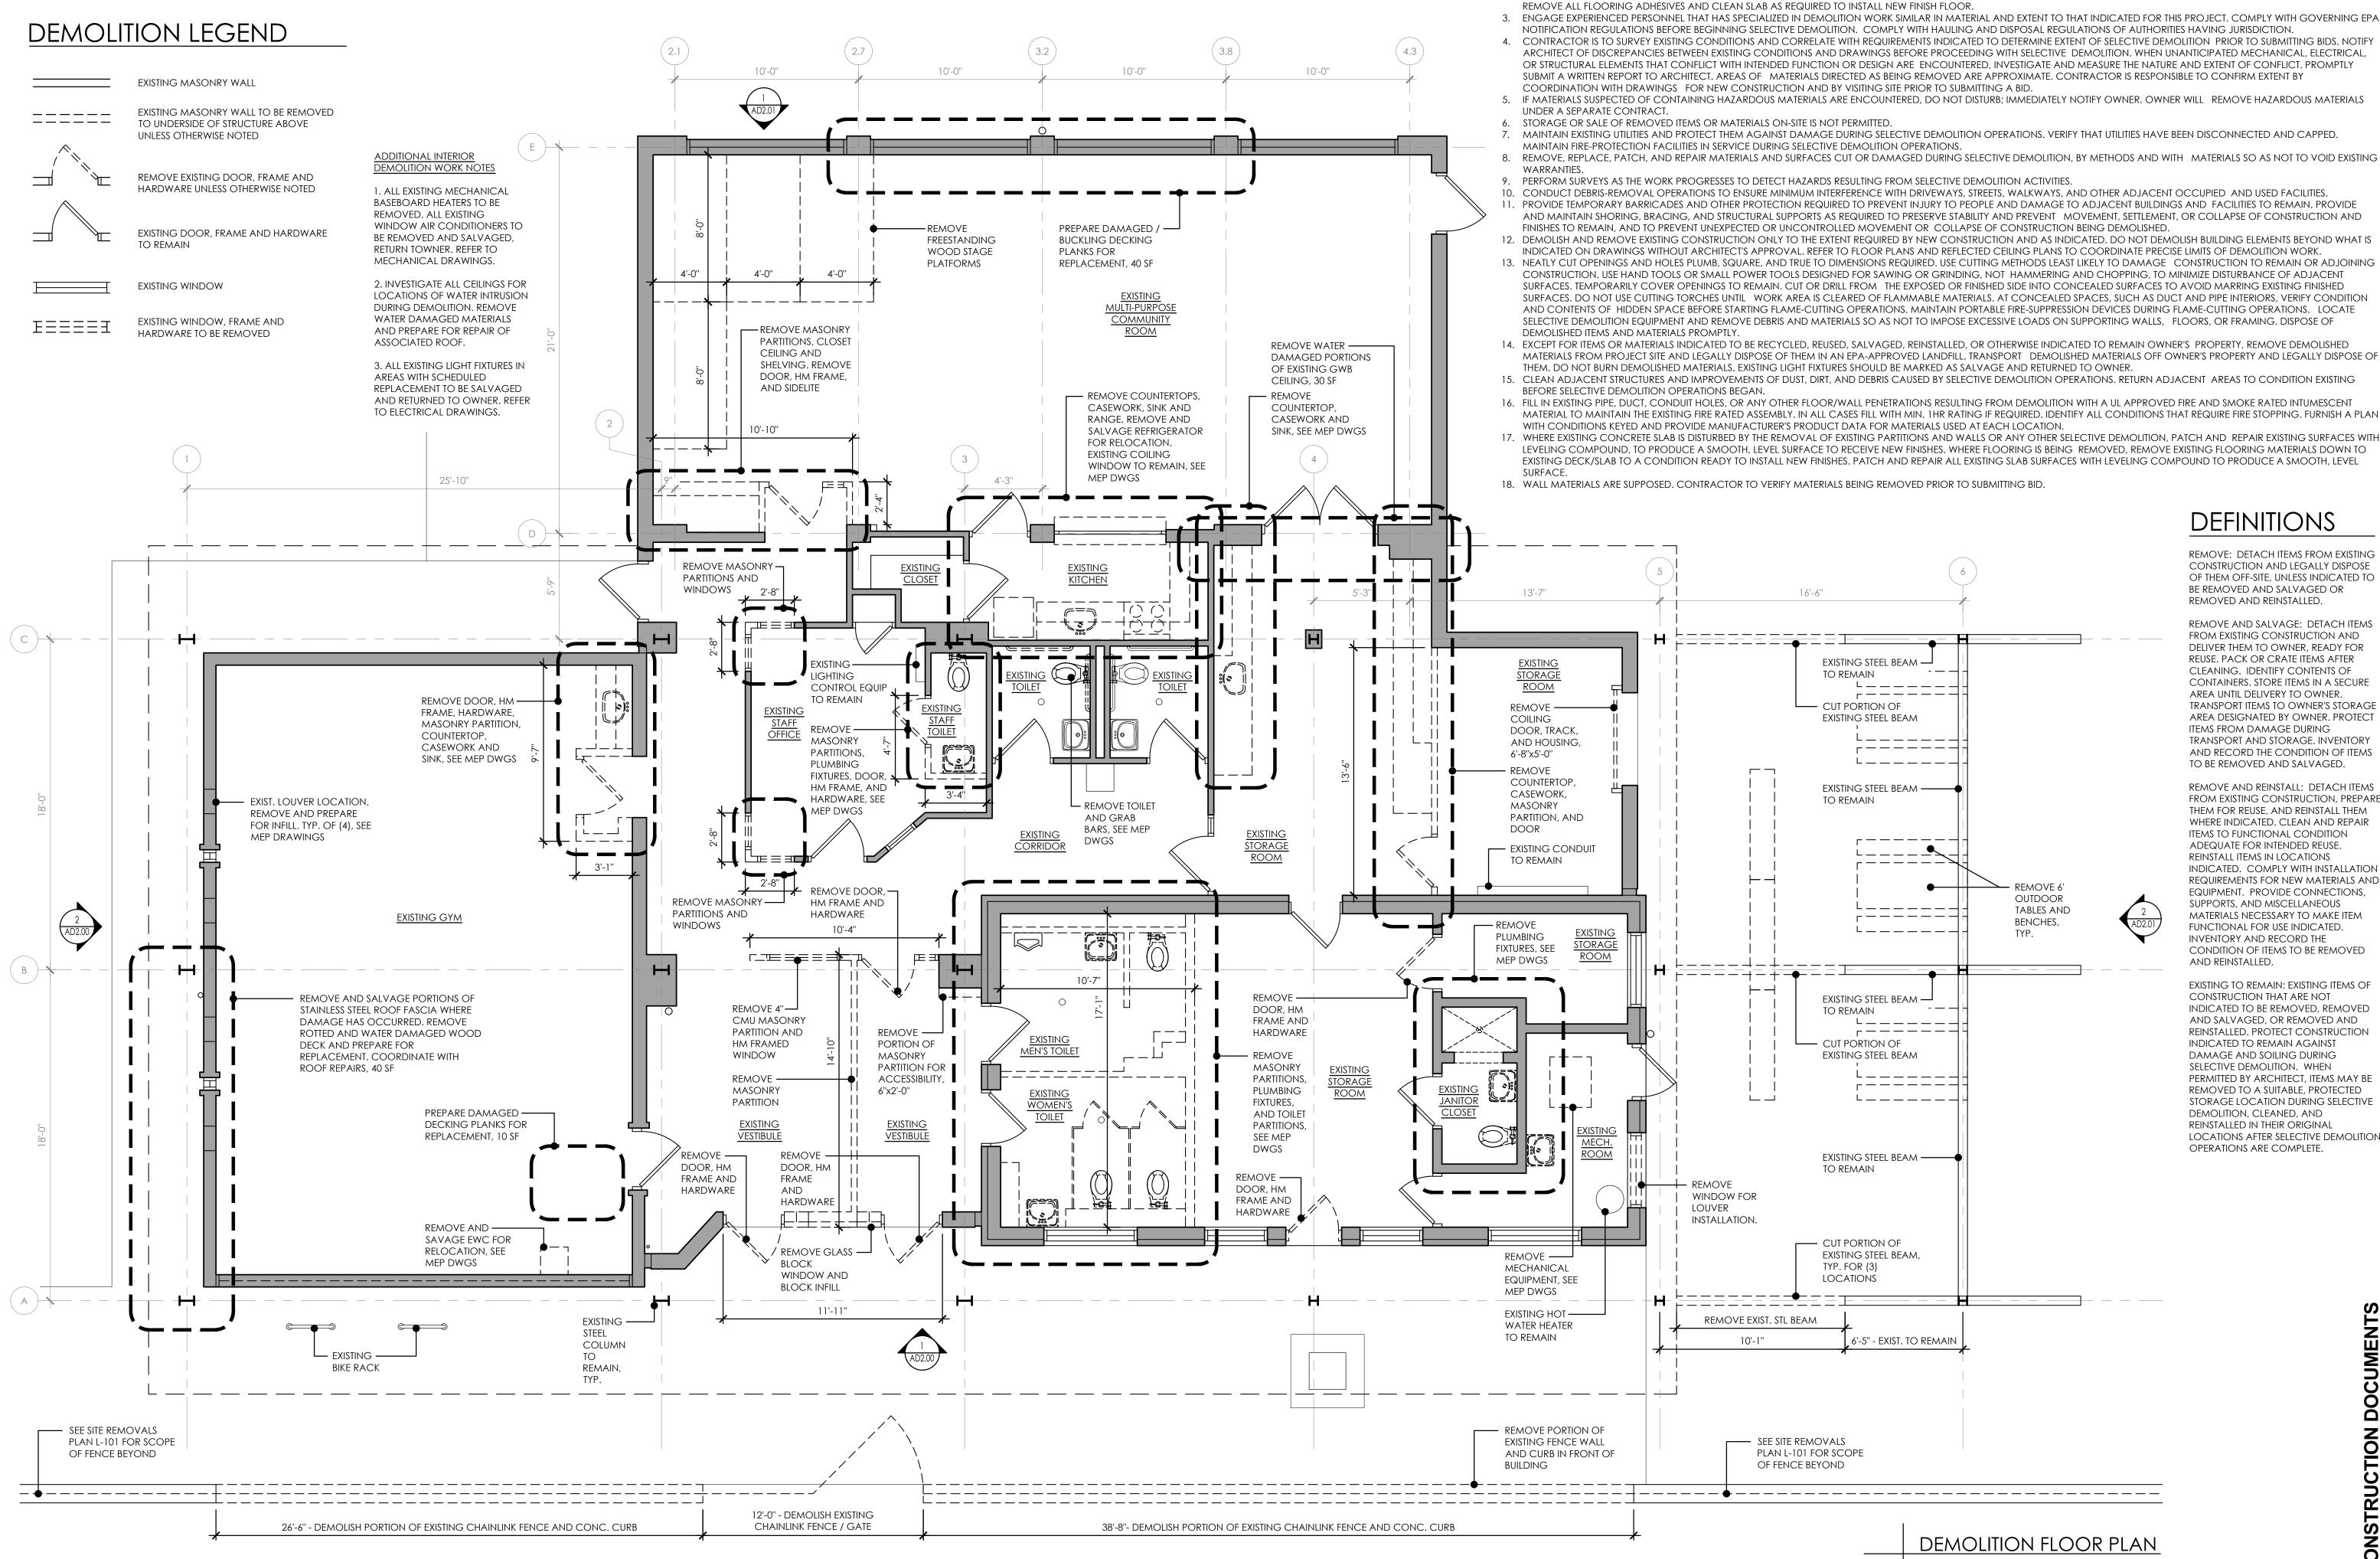




PWD TRACKING NUMBER: FY21-ZIEH-6284-01 **ISSUE FOR BIDDING** 08-15-2022

	NOTICE:		
	PURSUANT TO THE REQUIREMENTS OF PENNSYLVANIA ACT 12' SHALL CONTACT THE PENNSYLVANIA ONE CALL SYSTEM AT 1- 3 DAYS PRIOR TO EXCAVATION HIGHWAY DISTRICT NO. 5 SURVEY DISTRICT NO. 5 OUTFALL NO. 5		032559
HILADELPHIA	GREEN STORMWATER INFRASTRUC		,
HILADELPHIA	ZIEHLER PLAYGROUND LANDSCAPE DETA		
PARKS & LECREATION	SYSTEM 1560-1 - B E. OLNEY AVENUE to E. CLAF		UE
Rebuild		CITY OF PHILADELPHI WATER DEPARTMENT SCALES:	
N STUDIO PE ARCHITECTURE & URBAN DESIGN	Min Purrit Stude	PLAN PROFILE VERT. HORIZ. SECTION	1"=10' 1"=10' 1"=5' 1/4"=4'
ces, and Structural Engineering benixville, PA 19460 ww.melioradesign.com	WORK NO. S-50329-G SHEET NO. L-2 OF 12 SHEETS	DRAWN BY SEB PROJECT. ENGR. AMM SUPERVISOR	05/13/22 05/13/22 DATE



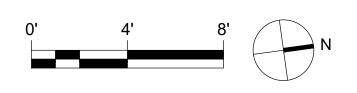



1. SUBCONTRACTORS MUST REVIEW ALL DRAWINGS OF NEW & EXISTING WORK COORDINATE DEMOLITION SCOPE PRIOR TO SUBMITTING BIDS. SEE DRAWINGS FOR MORE INFORMATION. 2. THIS IS A SELECTIVE RENOVATION. ALL FINISHES, FLOORING, CEILINGS, LIGHTS, INTERIOR PARTITIONS, ELECTRICAL DEVICES, PLUMBING FIXTURES, ETC. ARE TO BE REMOVED TO STRUCTURE AS INDICATED ON PLANS UNLESS NOTED OTHERWISE, SEE STRUCTURAL DRAWINGS, COORDINATE ALL DEMOLITION WITH DRAWINGS OF NEW CONSTRUCTION TO IDENTIFY SCOPE OF REMOVAL.



ZIEHLER PLAYGROUND & **RECREATION CENTER**

ROJECT NAME & ADDRESS:

OJECT NUMBER:

200-64 E. OLNEY AVENUE PHILADELPHIA, PA 19120

16640E-01-02

RIME CONSULTANT / LANDSCAPE ARCHITECTURE:



161 LEVERINGTON AVE, SUITE 1005 PHILADELPHIA, PA 19127 www.saltdesignstudio.com

VIL ENGINEERING: MELIORA DESIGN 259 MORGAN STREET PHOENIXVILLE, PA 19460 www.melioradesign.com

ARCHITECTURE: IAN SMITH DESIGN GROUP 322 E. THOMPSON STREET PHILADELPHIA, PA 19125 www.is-dg.com

GHTING DESIGN: MILLER DESIGN GROUP www.millerdesigngrouplighting.com

EP DESIGN: MARK ULRICK ENGINEERS, INC 622 COOPER STREET, #200 CAMDEN, NJ 08102 www.markulrick.com

TRUCTURAL ENGINEERING D'HUY ENGINEERING, INC 1 EAST BROAD STREET, SUITE 310 BETHLEHEM, PA 18018 www.dhuy.com

EDAR

WING PHASE:

ISSUE FOR BIDDING

REMOVE AND REINSTALL: DETACH ITEMS FROM EXISTING CONSTRUCTION, PREPARE THEM FOR REUSE, AND REINSTALL THEM WHERE INDICATED. CLEAN AND REPAIR ITEMS TO FUNCTIONAL CONDITION ADEQUATE FOR INTENDED REUSE. REINSTALL ITEMS IN LOCATIONS INDICATED. COMPLY WITH INSTALLATION REQUIREMENTS FOR NEW MATERIALS AND EQUIPMENT. PROVIDE CONNECTIONS, SUPPORTS, AND MISCELLANEOUS MATERIALS NECESSARY TO MAKE ITEM FUNCTIONAL FOR USE INDICATED. INVENTORY AND RECORD THE CONDITION OF ITEMS TO BE REMOVED AND REINSTALLED.

DEFINITIONS

REMOVE: DETACH ITEMS FROM EXISTING

OF THEM OFF-SITE, UNLESS INDICATED TO

REMOVE AND SALVAGE: DETACH ITEMS FROM EXISTING CONSTRUCTION AND

DELIVER THEM TO OWNER, READY FOR

CONTAINERS. STORE ITEMS IN A SECURE

TRANSPORT ITEMS TO OWNER'S STORAGE

AREA DESIGNATED BY OWNER. PROTECT

TRANSPORT AND STORAGE. INVENTORY

AND RECORD THE CONDITION OF ITEMS

REUSE. PACK OR CRATE ITEMS AFTER

CLEANING. IDENTIFY CONTENTS OF

AREA UNTIL DELIVERY TO OWNER.

ITEMS FROM DAMAGE DURING

TO BE REMOVED AND SALVAGED.

CONSTRUCTION AND LEGALLY DISPOSE

BE REMOVED AND SALVAGED OR

REMOVED AND REINSTALLED.

CONSTRUCTION THAT ARE NOT INDICATED TO BE REMOVED, REMOVED AND SALVAGED, OR REMOVED AND REINSTALLED. PROTECT CONSTRUCTION INDICATED TO REMAIN AGAINST DAMAGE AND SOILING DURING SELECTIVE DEMOLITION. WHEN PERMITTED BY ARCHITECT, ITEMS MAY BE REMOVED TO A SUITABLE, PROTECTED STORAGE LOCATION DURING SELECTIVE DEMOLITION, CLEANED, AND REINSTALLED IN THEIR ORIGINAL LOCATIONS AFTER SELECTIVE DEMOLITION

OPERATIONS ARE COMPLETE.


EXISTING TO REMAIN: EXISTING ITEMS OF


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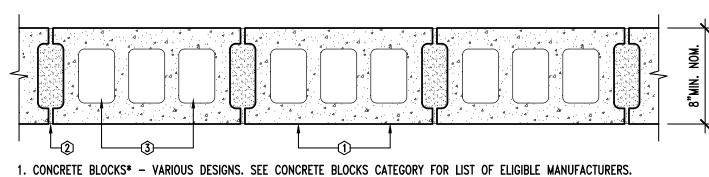
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(P1) NON-RATED NON-BEARING EXTERIOR INFILL




2. MORTAR - BLOCKS LAID IN FULL BED OF MORTAR, NOM. 3/8" THICK, OF NOT LESS THAN 2-1/4 AND NOT MORE THAN 3-1/2 PARTS OF CLEAN SHARP SAND TO 1 PART PORTLAND CEMENT (PROPORTION BY VOLUME) AND NOT MORE THAN 50 PERCENT HYDRATED LIME (BY CEMENT VOLUME). VERTICAL JOINTS STAGGERED.

3. LOOSE MASONRY FILL - IF ALL CORE SPACES ARE FILLED WITH LOOSE DRY EXPANDED SLAG, EXPANDED CLAY OR SHALE (ROTARY KILN PROCESS), WATER REPELLANT VERMICULITE MASONRY FILL INSULATION, OR SILICONE TREATED PERLITE LOOSE FILL INSULATION ADD 2HR TO CLASSIFICATION.

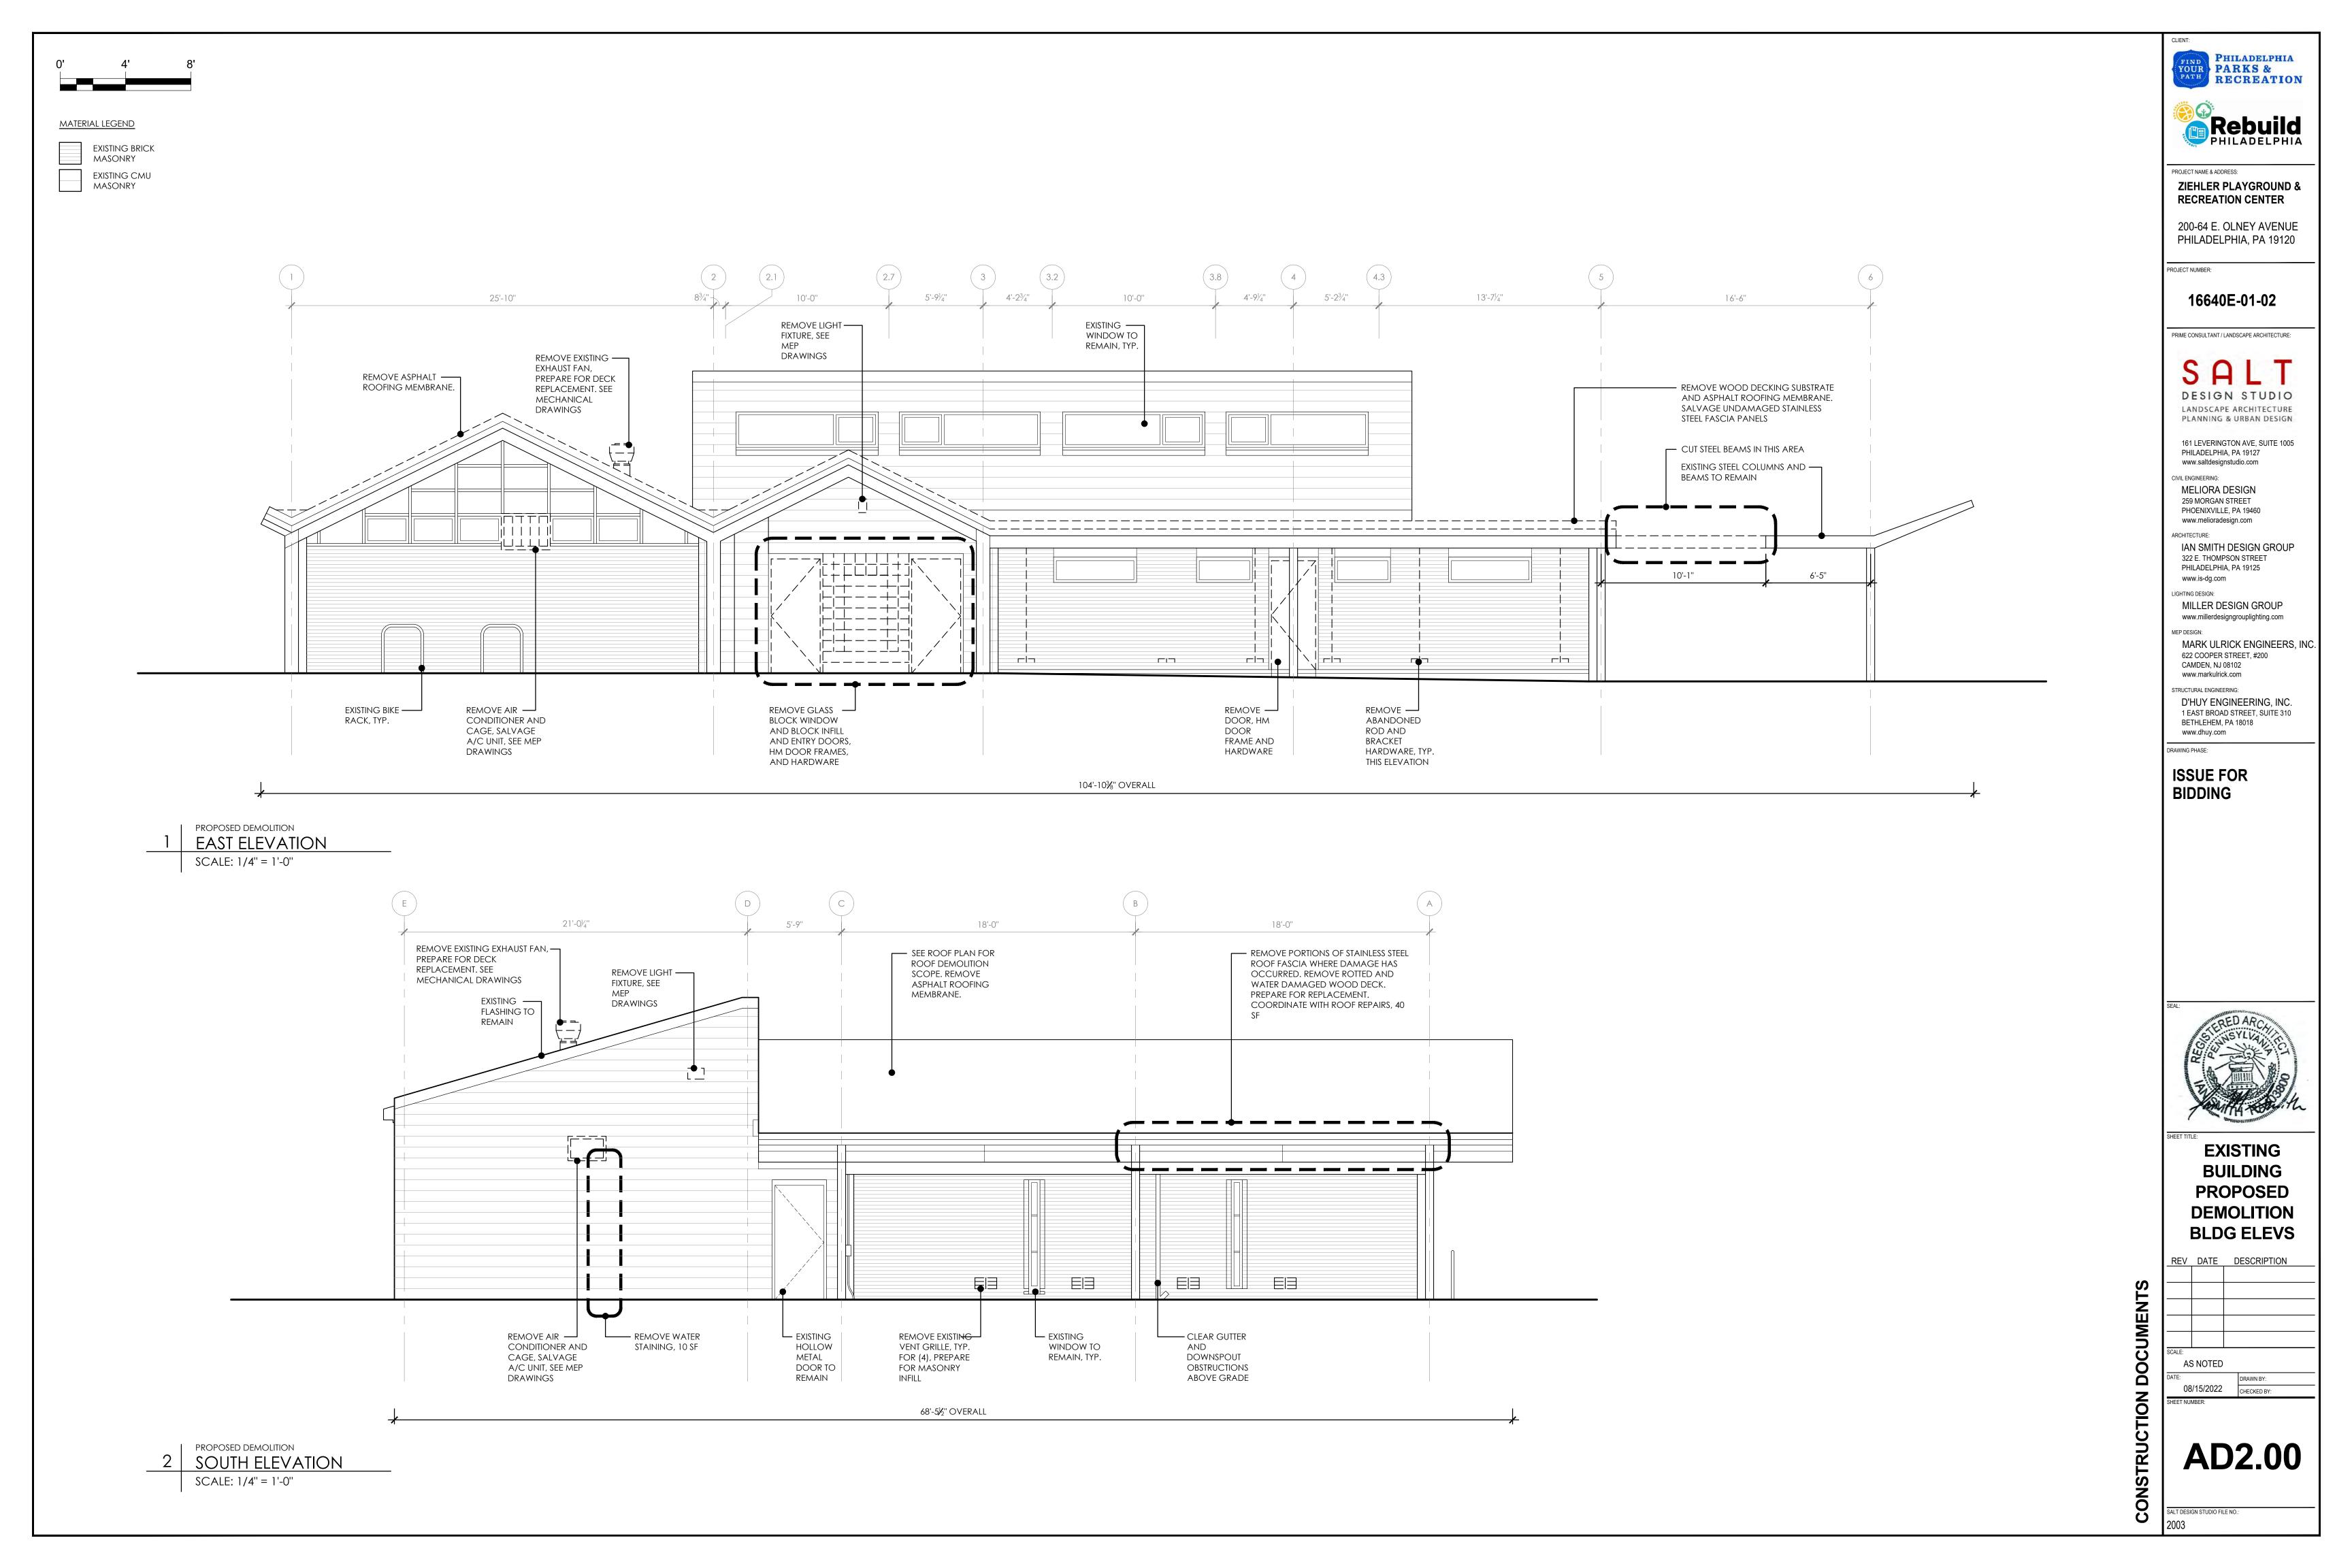
4. FULLY GROUTED, REINFORCED WITH VERTICAL #4 @ 16 O.C. HORIZONTAL GAGE 9 JOINT REINFORCED @ 16" (TYP).

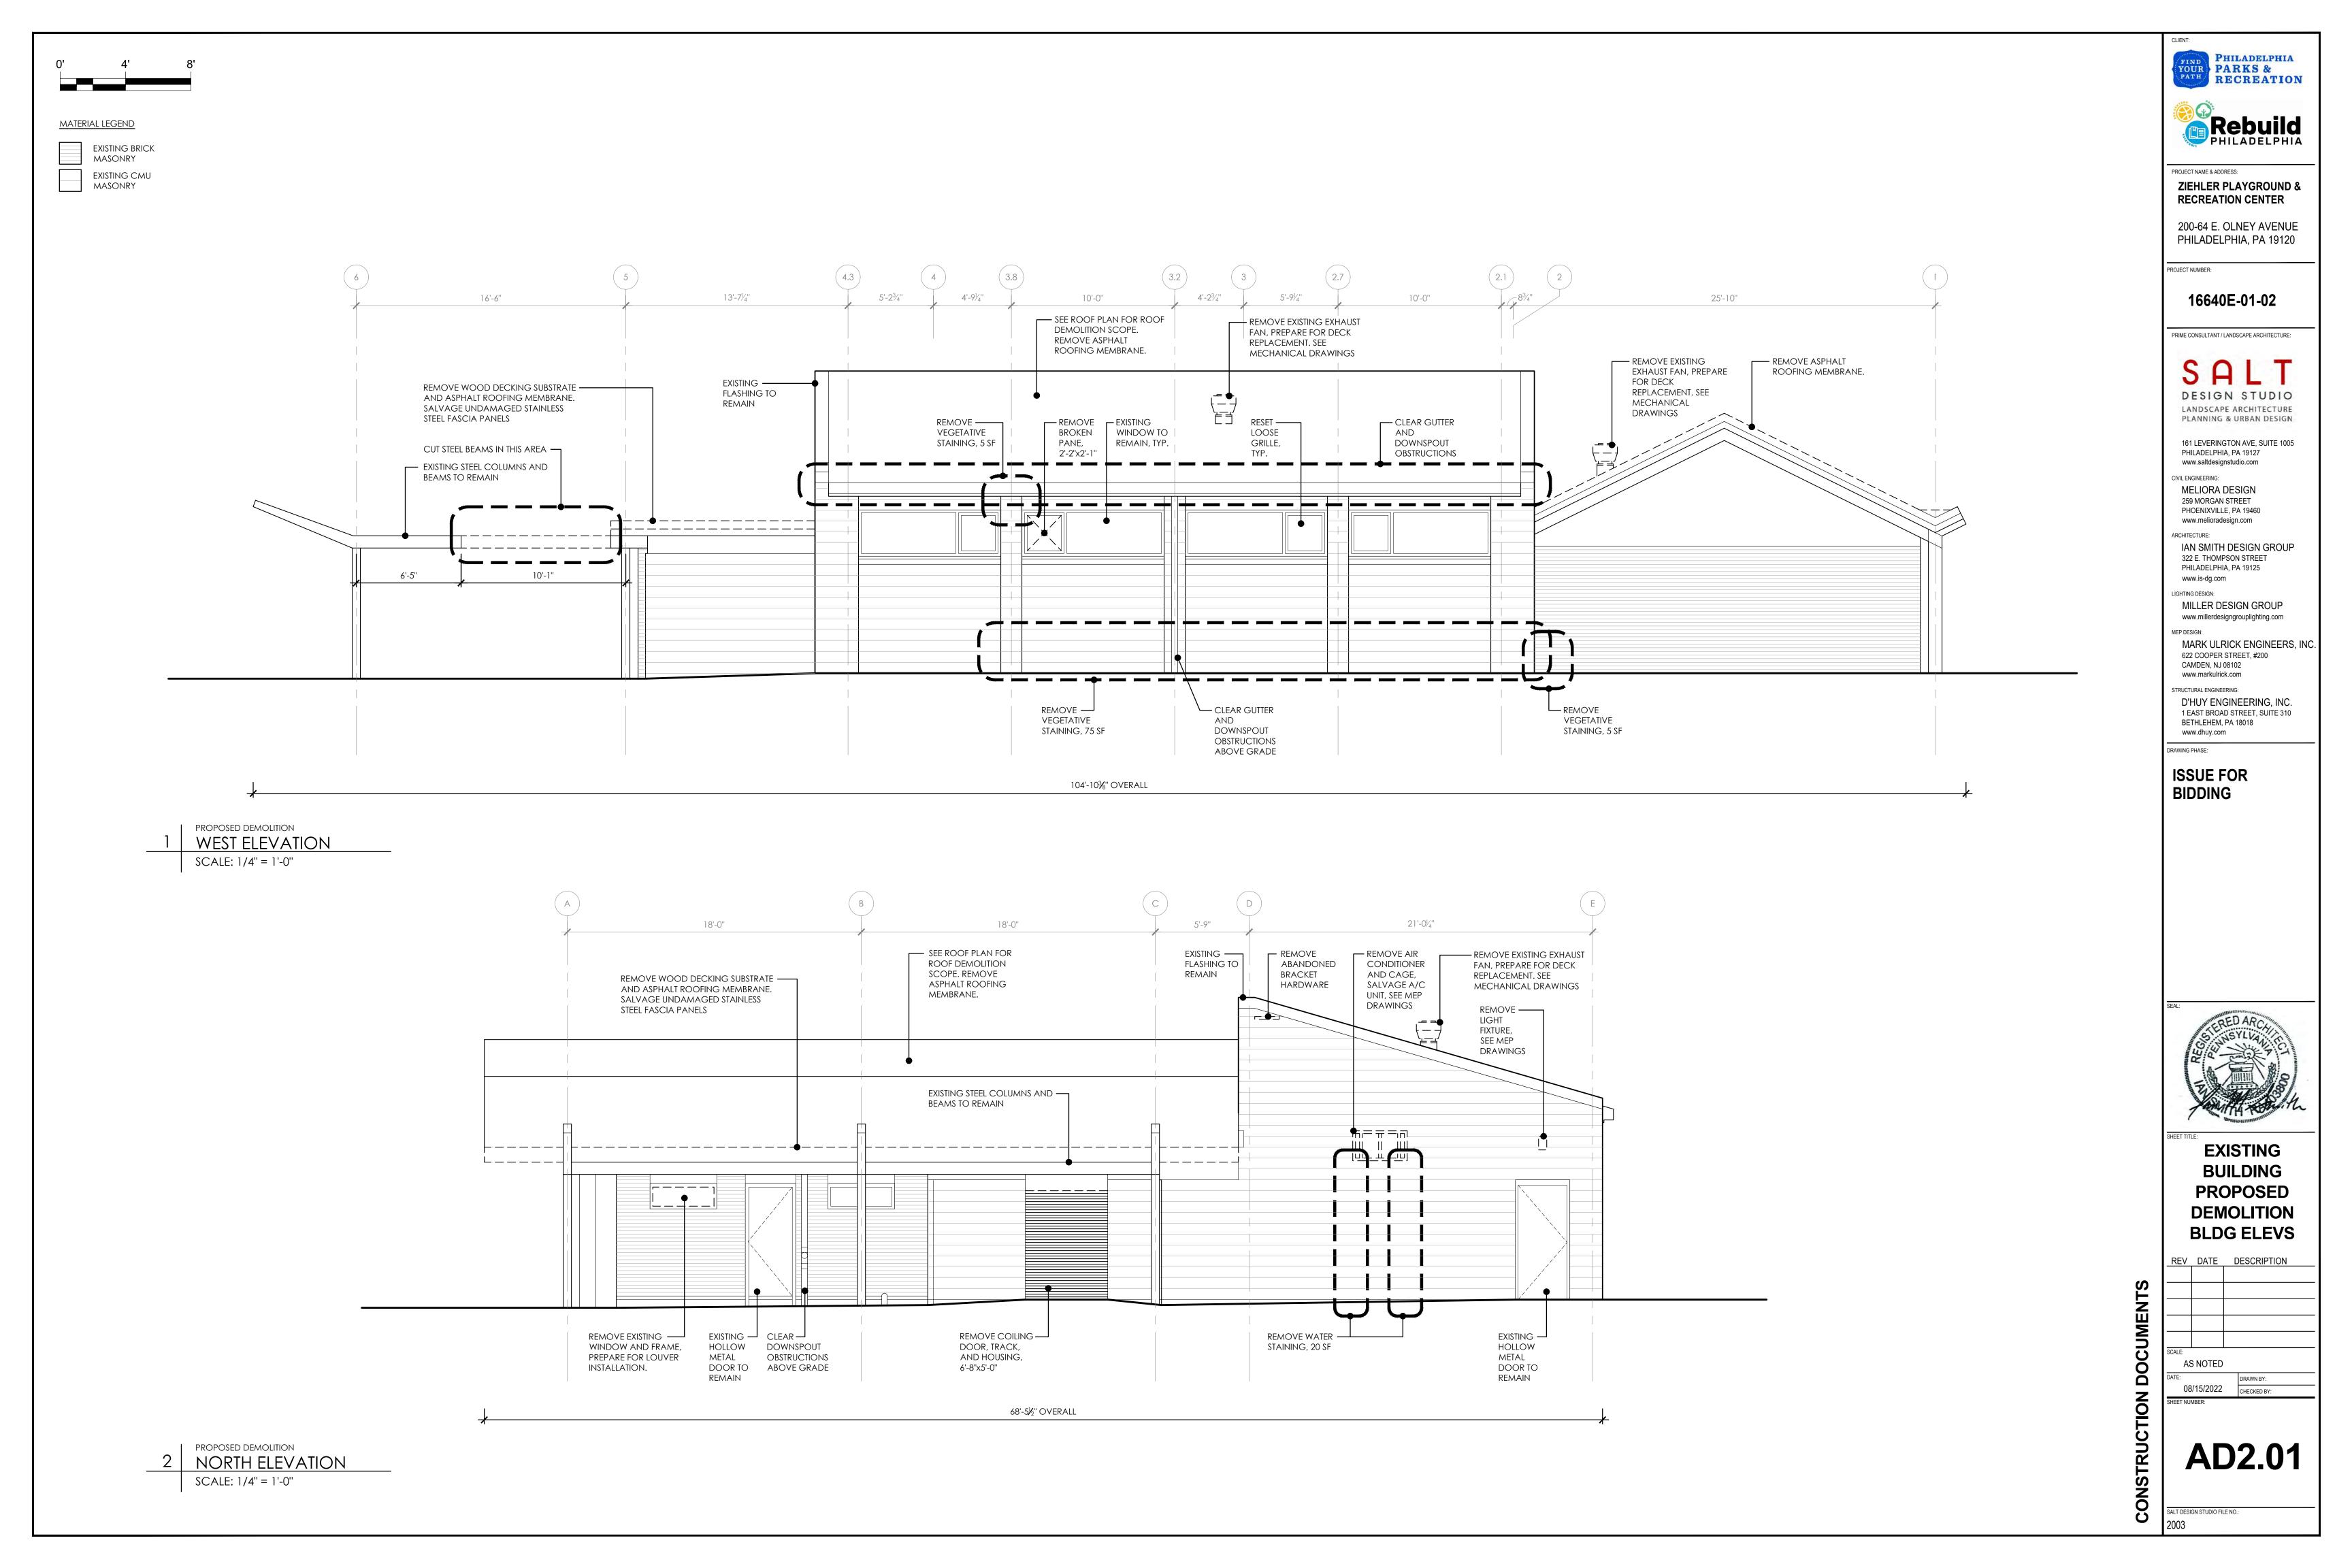5. FINISH - PAINT BOTH SIDES. PROVIDE WATERPROOFING SEALER ON EXTERIOR FACE.

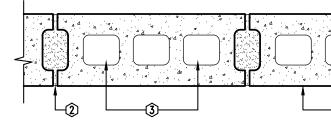

1. CONCRETE BLOCKS* - VARIOUS DESIGNS. SEE CONCRETE BLOCKS CATEGORY FOR LIST OF ELIGIBLE MANUFACTURERS. 2. MORTAR - BLOCKS LAID IN FULL BED OF MORTAR, NOM. 3/8" THICK, OF NOT LESS THAN 2-1/4 AND NOT MORE THAN 3-1/2 PARTS OF CLEAN SHARP SAND TO 1 PART PORTLAND CEMENT (PROPORTION BY VOLUME) AND NOT MORE THAN 50 PERCENT HYDRATED LIME (BY CEMENT VOLUME). VERTICAL JOINTS STAGGERED. 3. LOOSE MASONRY FILL - IF ALL CORE SPACES ARE FILLED WITH LOOSE DRY EXPANDED SLAG, EXPANDED CLAY OR SHALE (ROTARY KILN PROCESS), WATER REPELLANT VERMICULITE MASONRY FILL INSULATION, OR SILICONE TREATED PERLITE LOOSE FILL INSULATION ADD 2HR TO CLASSIFICATION.

4. FULLY GROUTED, REINFORCED WITH VERTICAL #4 @ 16 O.C. HORIZONTAL GAGE 9 JOINT REINFORCED @ 16" (TYP). 5. FINISH – PAINT BOTH SIDES (EXCLUDING WALLS FACING STORAGE AREAS)

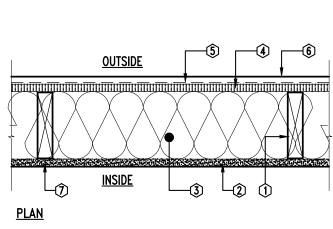

(P3) NON-RATED NON-BEARING

EXTERIOR INFILL

1. WOOD STUDS - 2" X 6" WOOD STUDS AT 16" WITH DOUBLE TOP PLATES, SINGLE BOTTOM PLATE.

2. GYPSUM BOARD - INTERIOR SIDE COVERED WITH 5/8" IMPACT RESISTANT GYPSUM WALLBOARD, 4' WIDE, APPLIED VERTICALLY WITH ALL JOINTS OVER FRAMING OR BLOCKING AND FASTENED WITH 2 1/2" TYPE S DRYWALL SCREWS, SPACED 12" ON CENTER.


3. BATTS AND BLANKETS* - R-21 MINERAL FIBER INSULATION INSTALLED IN STUD CAVITY.


4. SHEATHING - EXTERIOR SIDE TO BE 5/8" EXTERIOR GRADE APPLICATION WATER RESISTANT GYPSUM CORE, 4' WIDE, APPLIED VERTICALLY WITH ALL JOINTS OVER FRAMING OR BLOCKING AND FASTENED WITH 2 1/4" TYPE S DRYWALL SCREWS, SPACED 12" ON CENTER.


5. VAPOR RETARDER, WATER BARRIER OR WEATHER RESISTIVE BARRIER.

6. FINISH - PAINT INTERIOR GYPSUM FACE. PROVIDE IMPACT RESISTANT METAL PANEL SYSTEM ON EXTERIOR FACE.

7. JOINT TAPE AND COMPOUND - JOINTS TO BE COVERED WITH TAPE AND JOINT COMPOUND. LEVEL 4 FINISH.

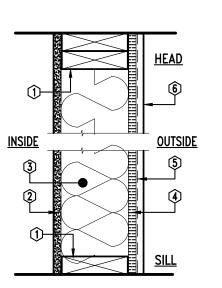

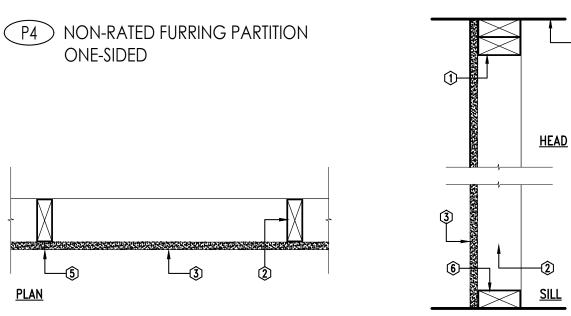

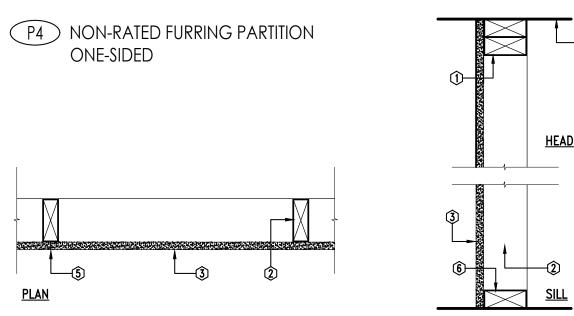

1. FLOOR WOOD STUD PLATES AND CEILING DOUBLE PLATES - ATTACHED TO FLOOR AND CEILING WITH FASTENERS 24 IN. OC MAX.

3. GYPSUM BOARD - 1 LAYER, 1/2 IN. THICK GYPSUM PANELS WITH BEVELED, SQUARE OR TAPERED EDGES, APPLIED VERTICALLY OR HORIZONTALLY. VERTICAL JOINTS CENTERED OVER STUDS AND STAGGERED ONE STUD CAVITY ON OPPOSITE SIDES OF STUDS. HORIZONTAL JOINTS NEED NOT BE BACKED BY STEEL FRAMING. HORIZONTAL EDGE JOINTS AND HORIZONTAL BUTT JOINTS ON OPPOSITE SIDES OF STUDS NEED NOT BE STAGGERED. EXTEND STUDS AND GWB ON BOTH SIDES TO STRUCTURE. SCRIBE GWB TO STRUCTURE AND FIRE CAULK, AS REQUIRED FOR DETERMINED FIRE RATING.

5. JOINT TAPE AND COMPOUND - VINYL OR CASEIN, DRY OR PREMIXED JOINT COMPOUND APPLIED IN TWO COATS TO JOINTS AND SCREW HEADS OF OUTER LAYERS. PAPER TAPES, NOM 2 IN. WIDE, EMBEDDED IN FIRST LAYER OF COMPOUND OVER ALL JOINTS OF OUTER LAYER PANELS. PAPER TAPE AND JOINT COMPOUND MAY BE OMITTED WHEN GYPSUM PANELS ARE SUPPLIED WITH A SQUARE EDGE.

6. SCHEDULED CEILING

2. WOOD STUDS - 2"x4", MIN. SPACING 16" O.C.

4. FASTENERS - (NOT SHOWN) - 1 IN. LONG TYPE S OR S-12 STEEL SCREWS USED TO ATTACH PANELS TO STUDS (ITEM 2), SPACED 8 IN. OC WHEN PANELS ARE APPLIED HORIZONTALLY, OR 8 IN. OC ALONG VERTICAL AND BOTTOM EDGES AND 12 IN. OC IN THE FIELD WHEN PANELS ARE APPLIED VERTICALLY.

