

CONSTRUCTION DOCUMENTS 100% - 05/09/2025

CITY OF PHILADELPHIA
PHILADELPHIA PARKS & RECREATION

MAYOR - CHERELLE PARKER

MANAGING DIRECTOR - ADAM K. THIEL

COMMISSIONER - PHILADELPHIA PARKS AND RECREATION - SUSAN SLAWSON

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WEST MILL CREEK PLAYGROUND AREAS E & G

5100 Parrish St. Philadelphia, PA 19139

OLIN

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Playground Design: Studio Ludo 4800 Springfield Ave Philadelphia, PA 19143 (215) 454-6780

Civil Engineering: Sci Tek 1880 John F Kennedy Blvd #600, Philadelphia, PA 19103 (267) 314-5385

Structural:
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190 Brodhead Road, Suite 120,
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(484) 895-3131

MEP: Mark Ulrick 30 N. 41ST SUITE 500 Philadelphia, PA 19104 (856) 320-8100

. Date Description

07/31/2024 SCHEMATIC DESIGN 100%

3 05/09/2025 CONSTRUCTION DOCUMENTS 100%



COVER SHEET

Scale:
Date: 05/09/2
Drawn:
Checked:
Project No: 2

G000



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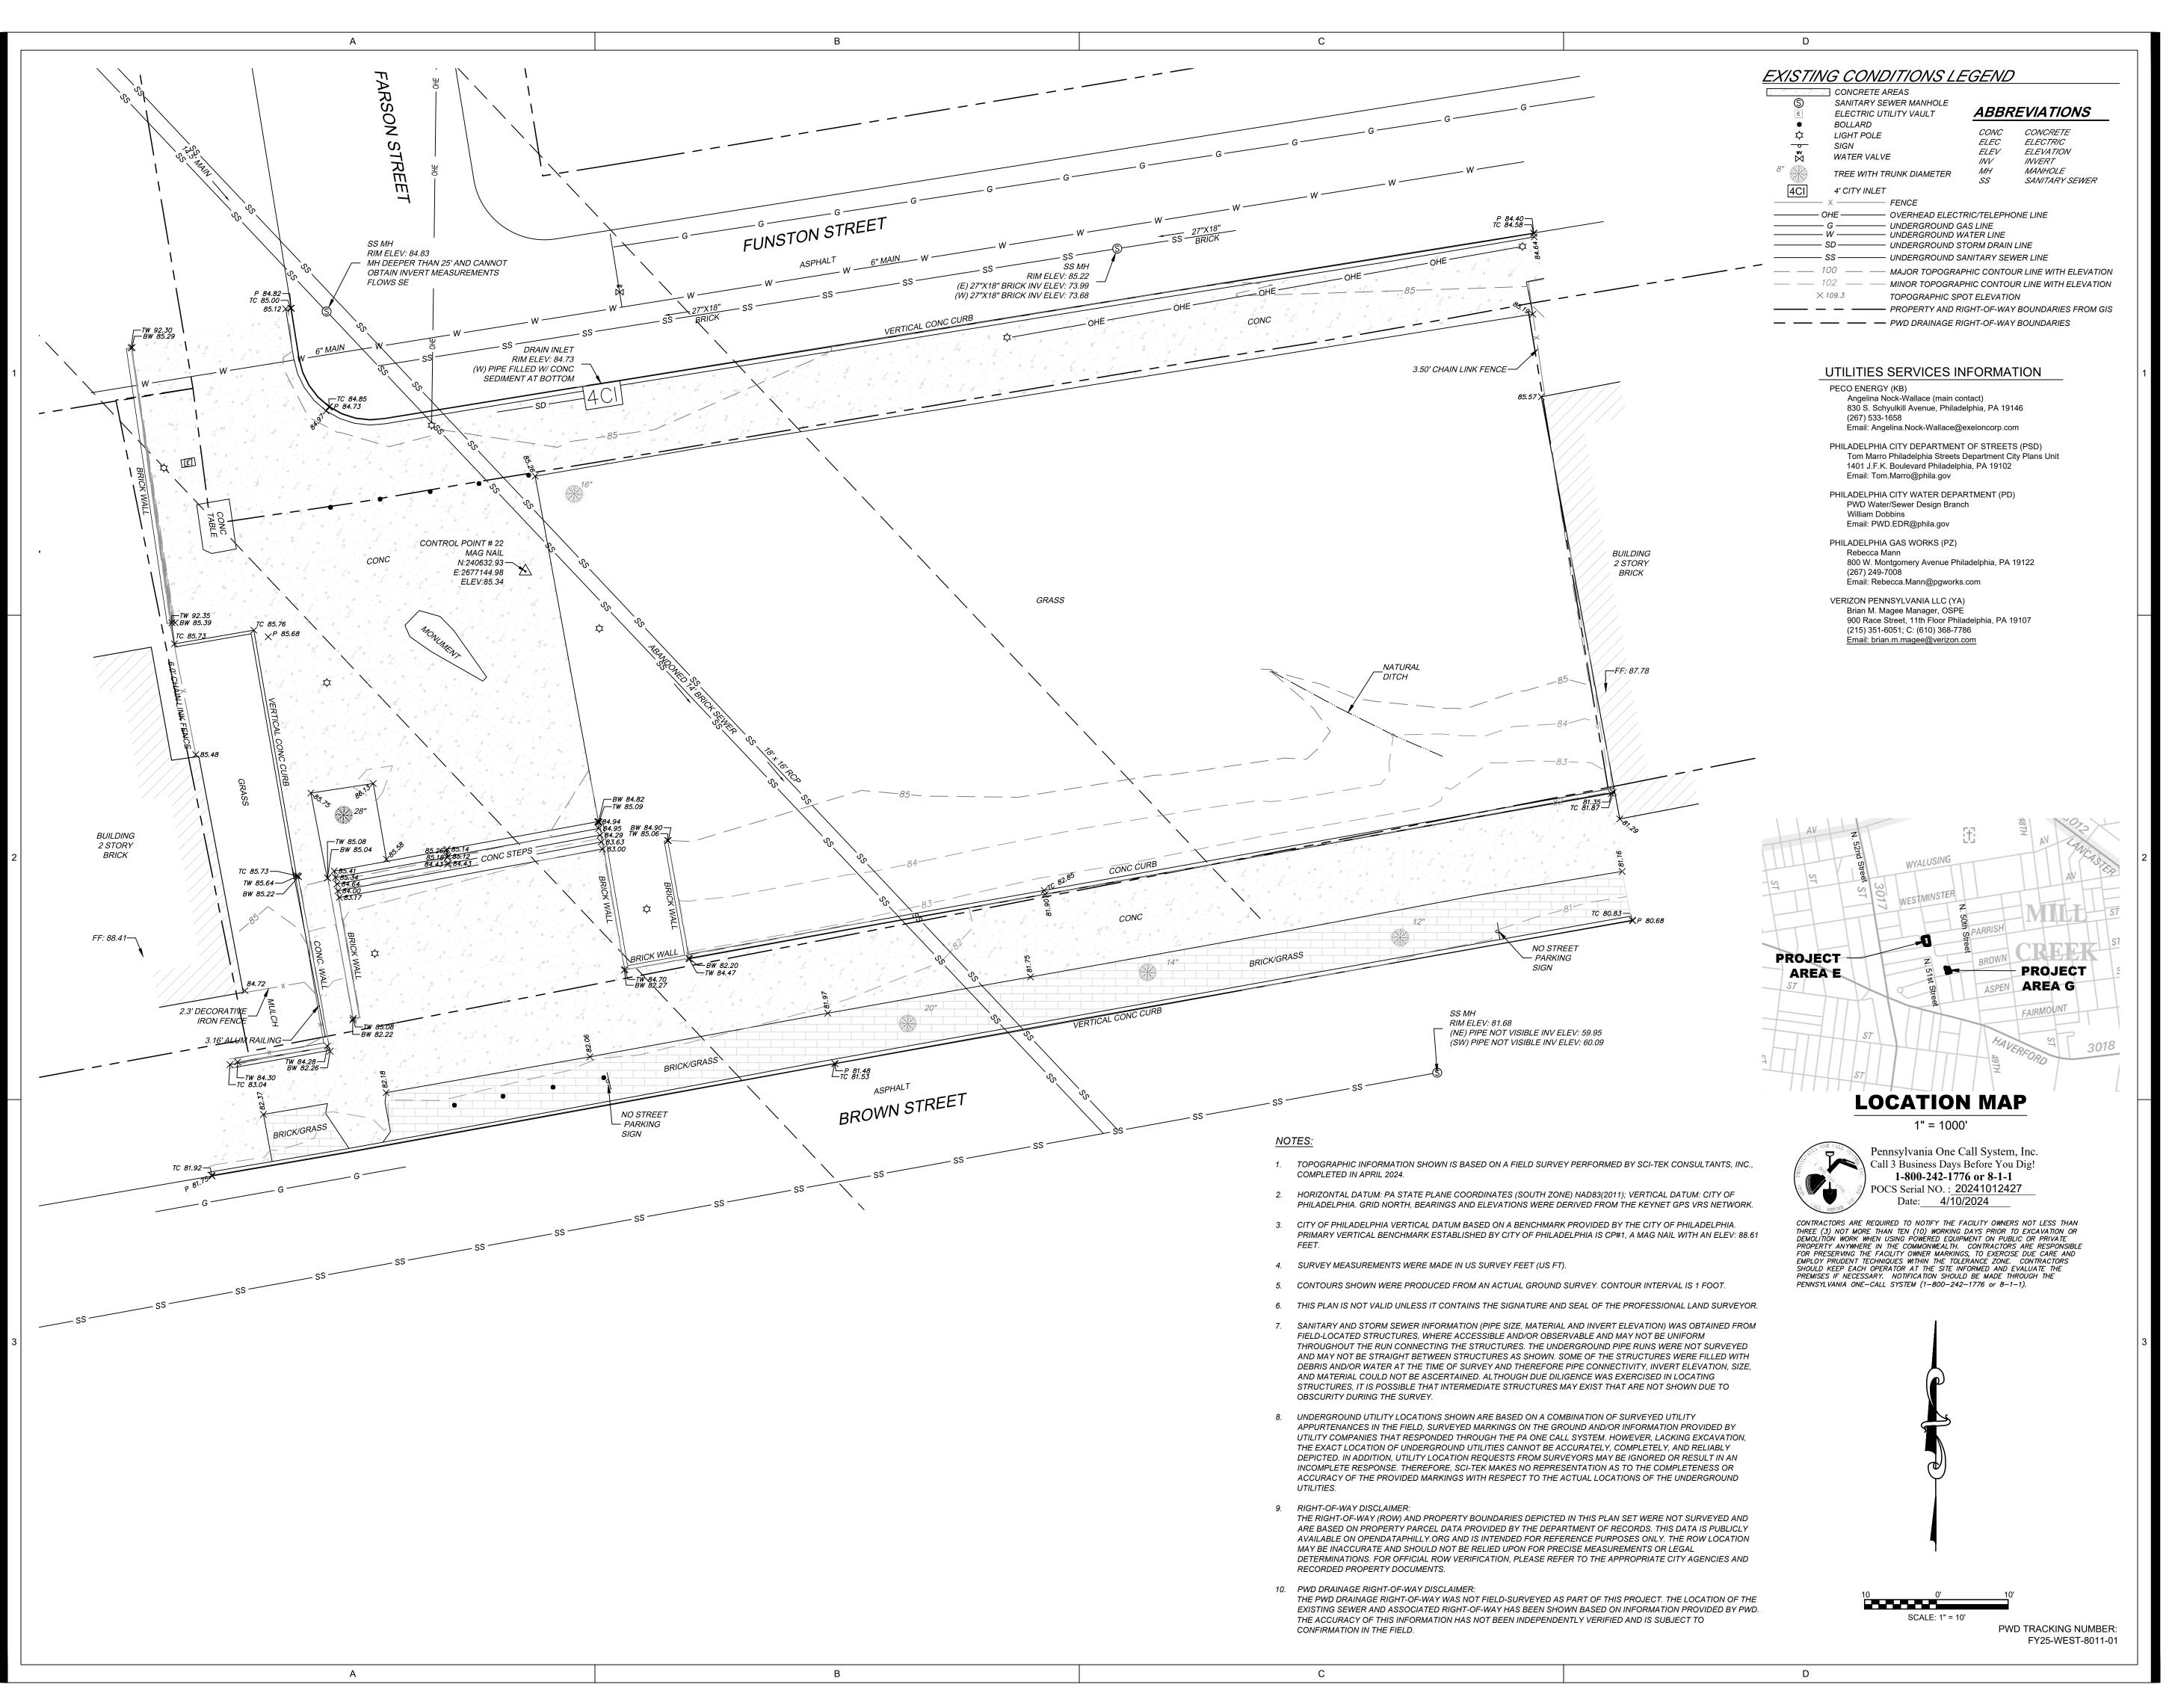
No. Date Description

07/31/2024 DESIGN DEVELOPMENT 100% 10/25/2024 DESIGN DEVELOPMENT 100% 3/19/2025 PWD COMMENTS

Existing Conditions Plan (Area E)

C-101

Date:
Drawn: T.S.W
Checked: J.B.
Project No.: 2409



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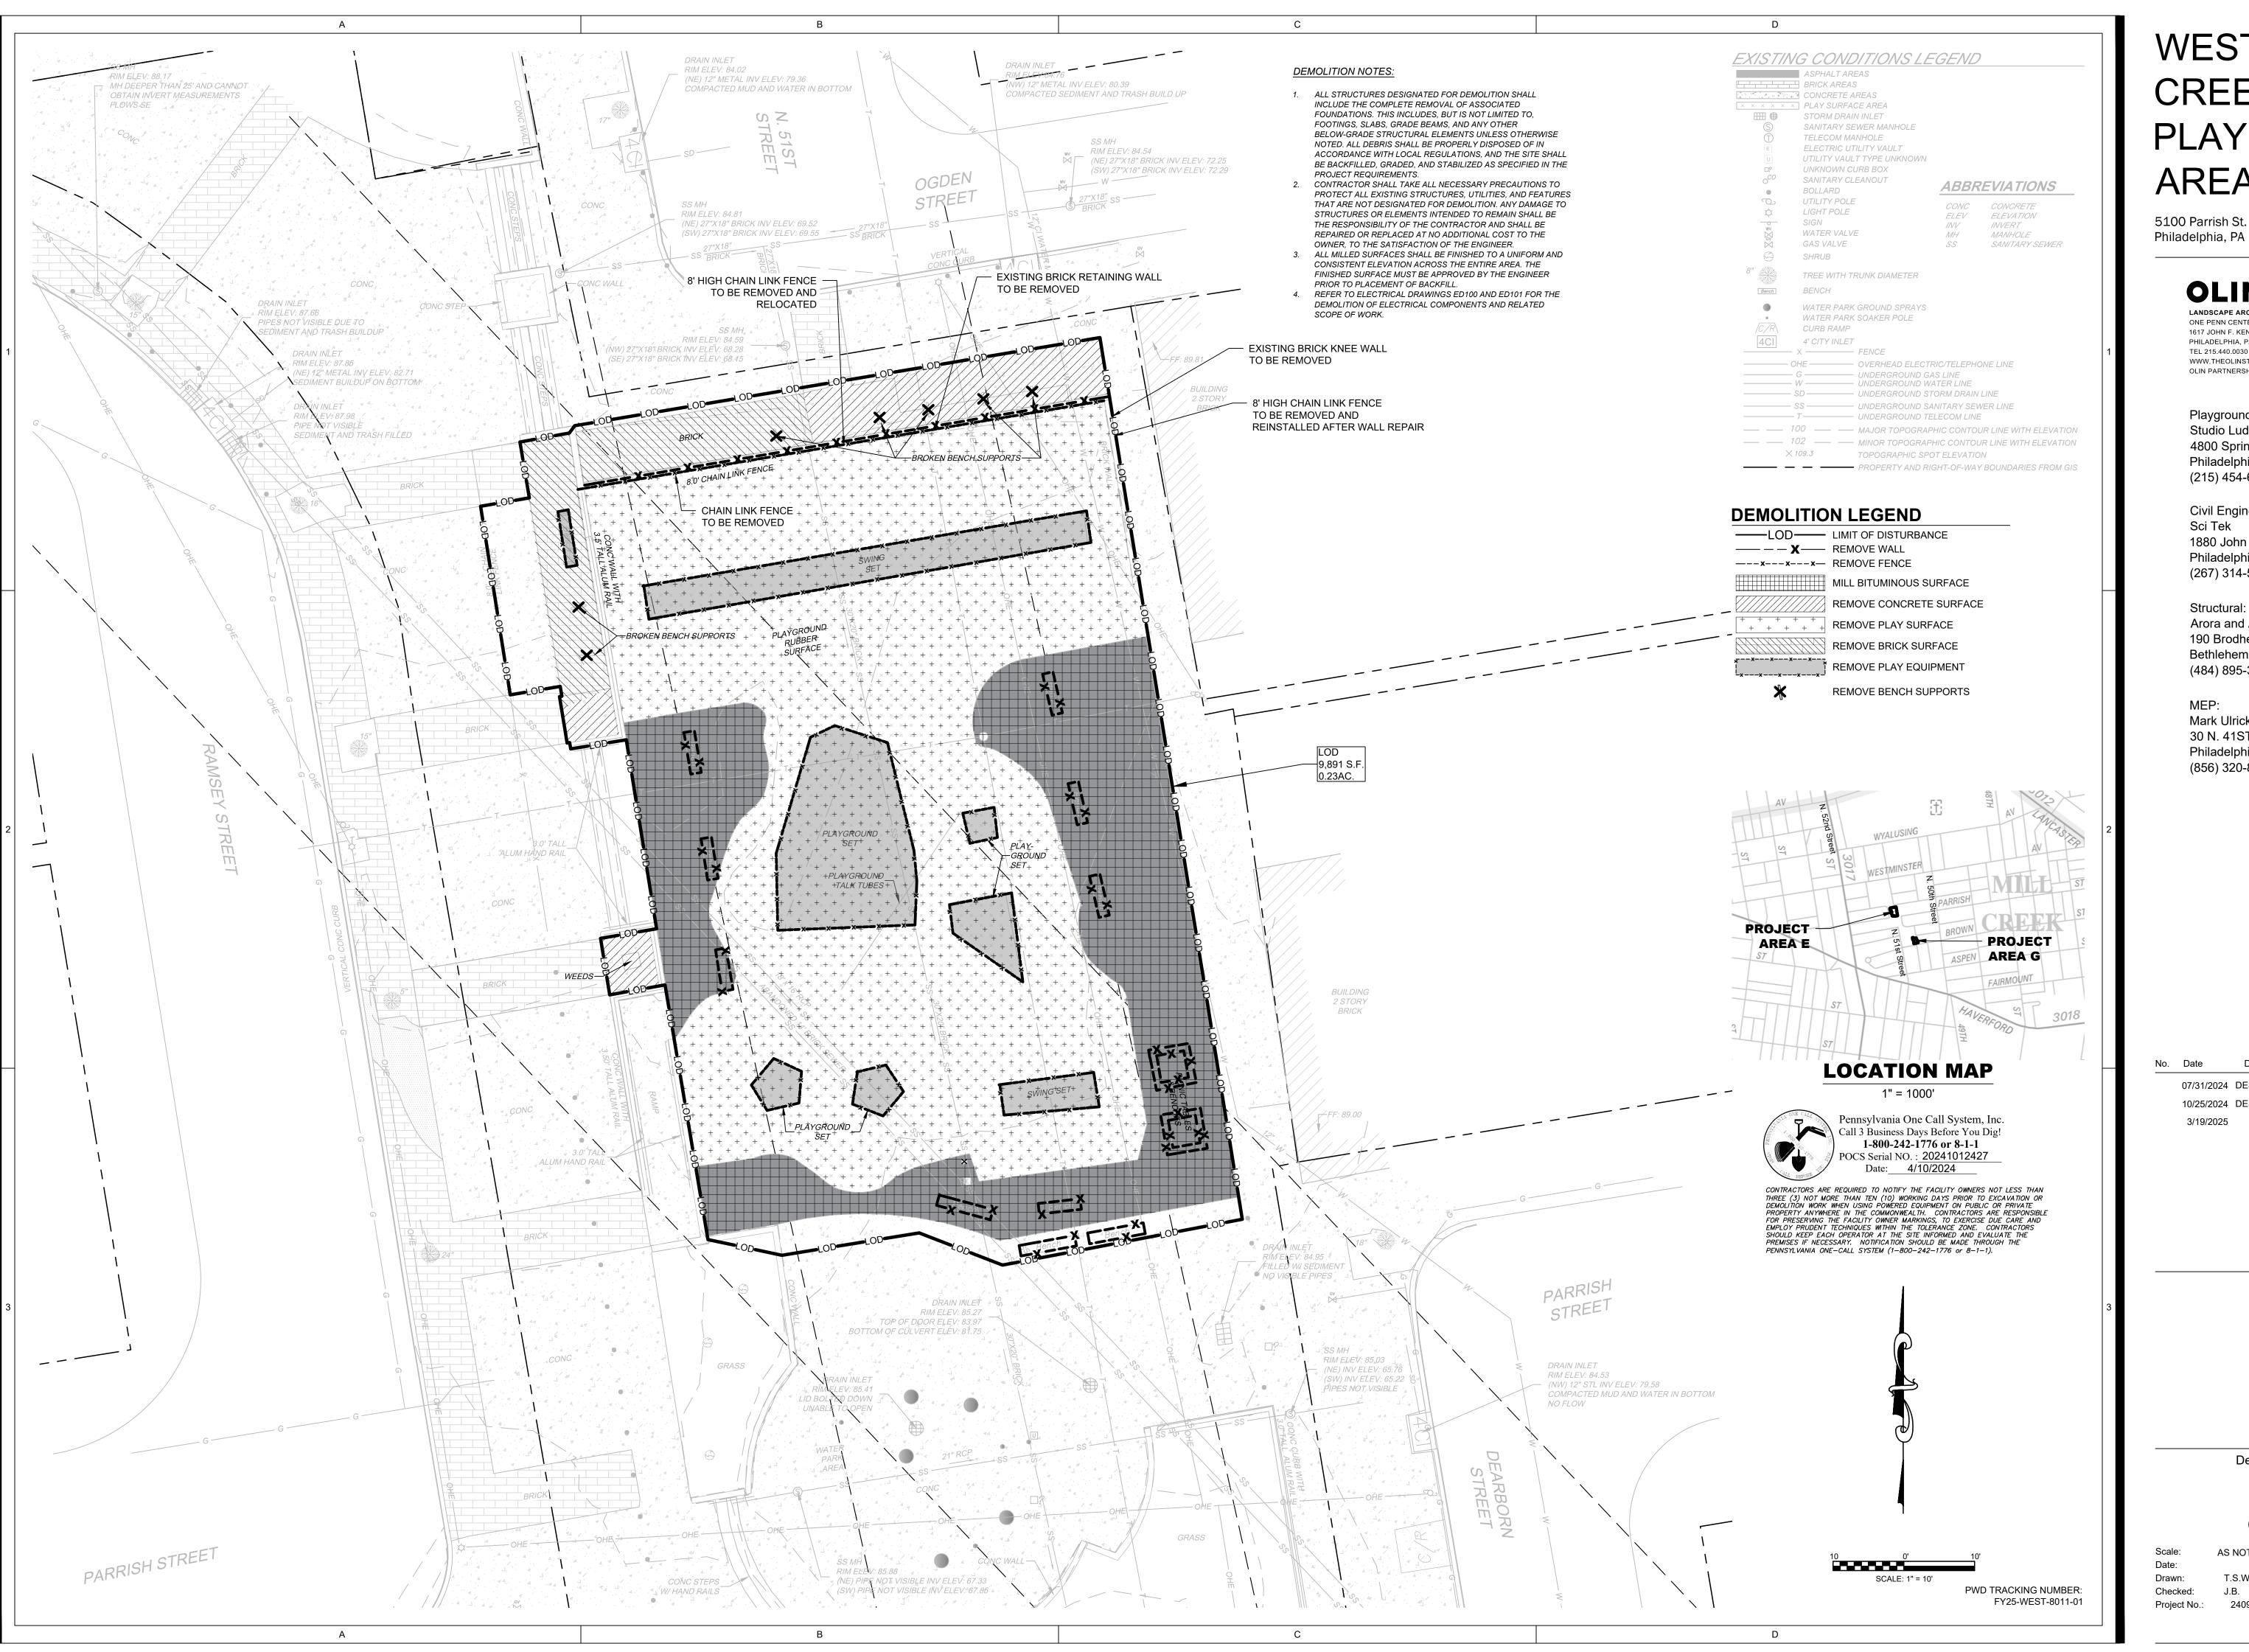
No. Date Description

07/31/2024 DESIGN DEVELOPMENT 100%10/25/2024 DESIGN DEVELOPMENT 100%3/19/2025 PWD COMMENTS

Existing Conditions Plan (Area G)

C-102

Date:
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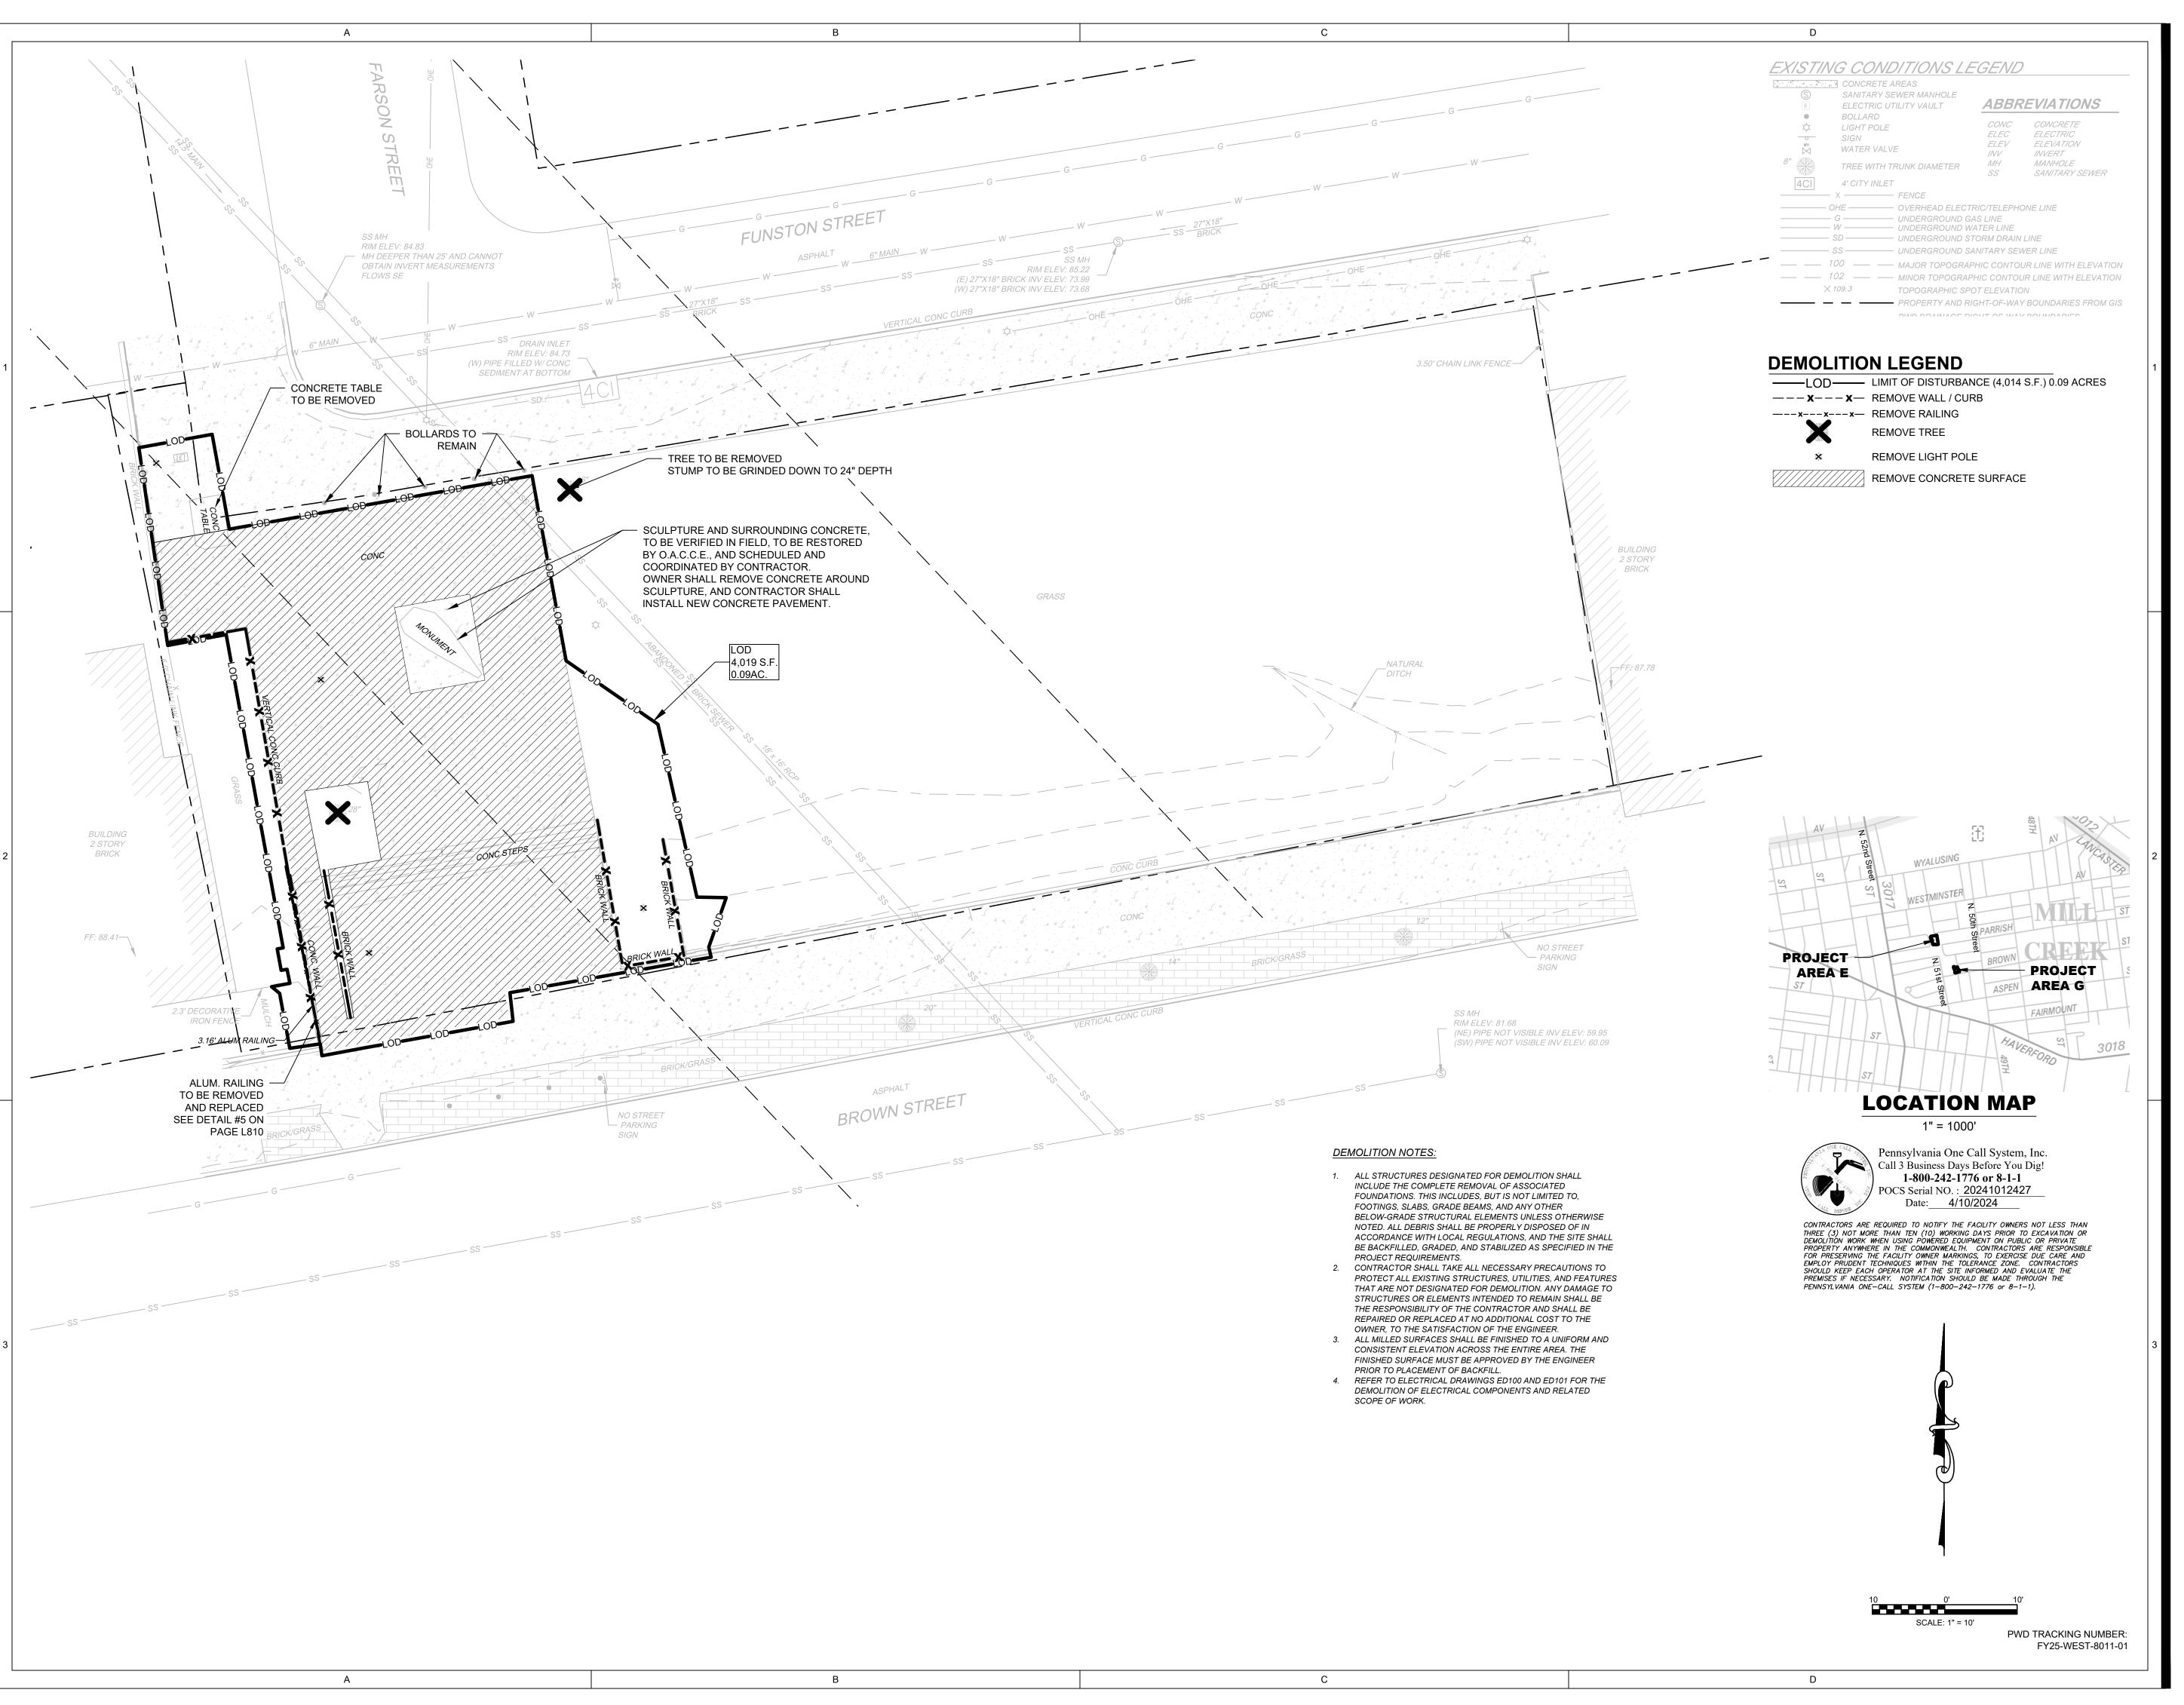
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07/31/2024 DESIGN DEVELOPMENT 100% 10/25/2024 DESIGN DEVELOPMENT 100% PWD COMMENTS

> **Demolition Plan** (Area E)

> > C-201

T.S.W



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 07/31/2024
 DESIGN DEVELOPMENT 100%

 10/25/2024
 DESIGN DEVELOPMENT 100%

 3/19/2025
 PWD COMMENTS

Demolition Plan (Area G)

C-202


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Drawn: T.S.W

Checked: J.B.

Project No.: 2409



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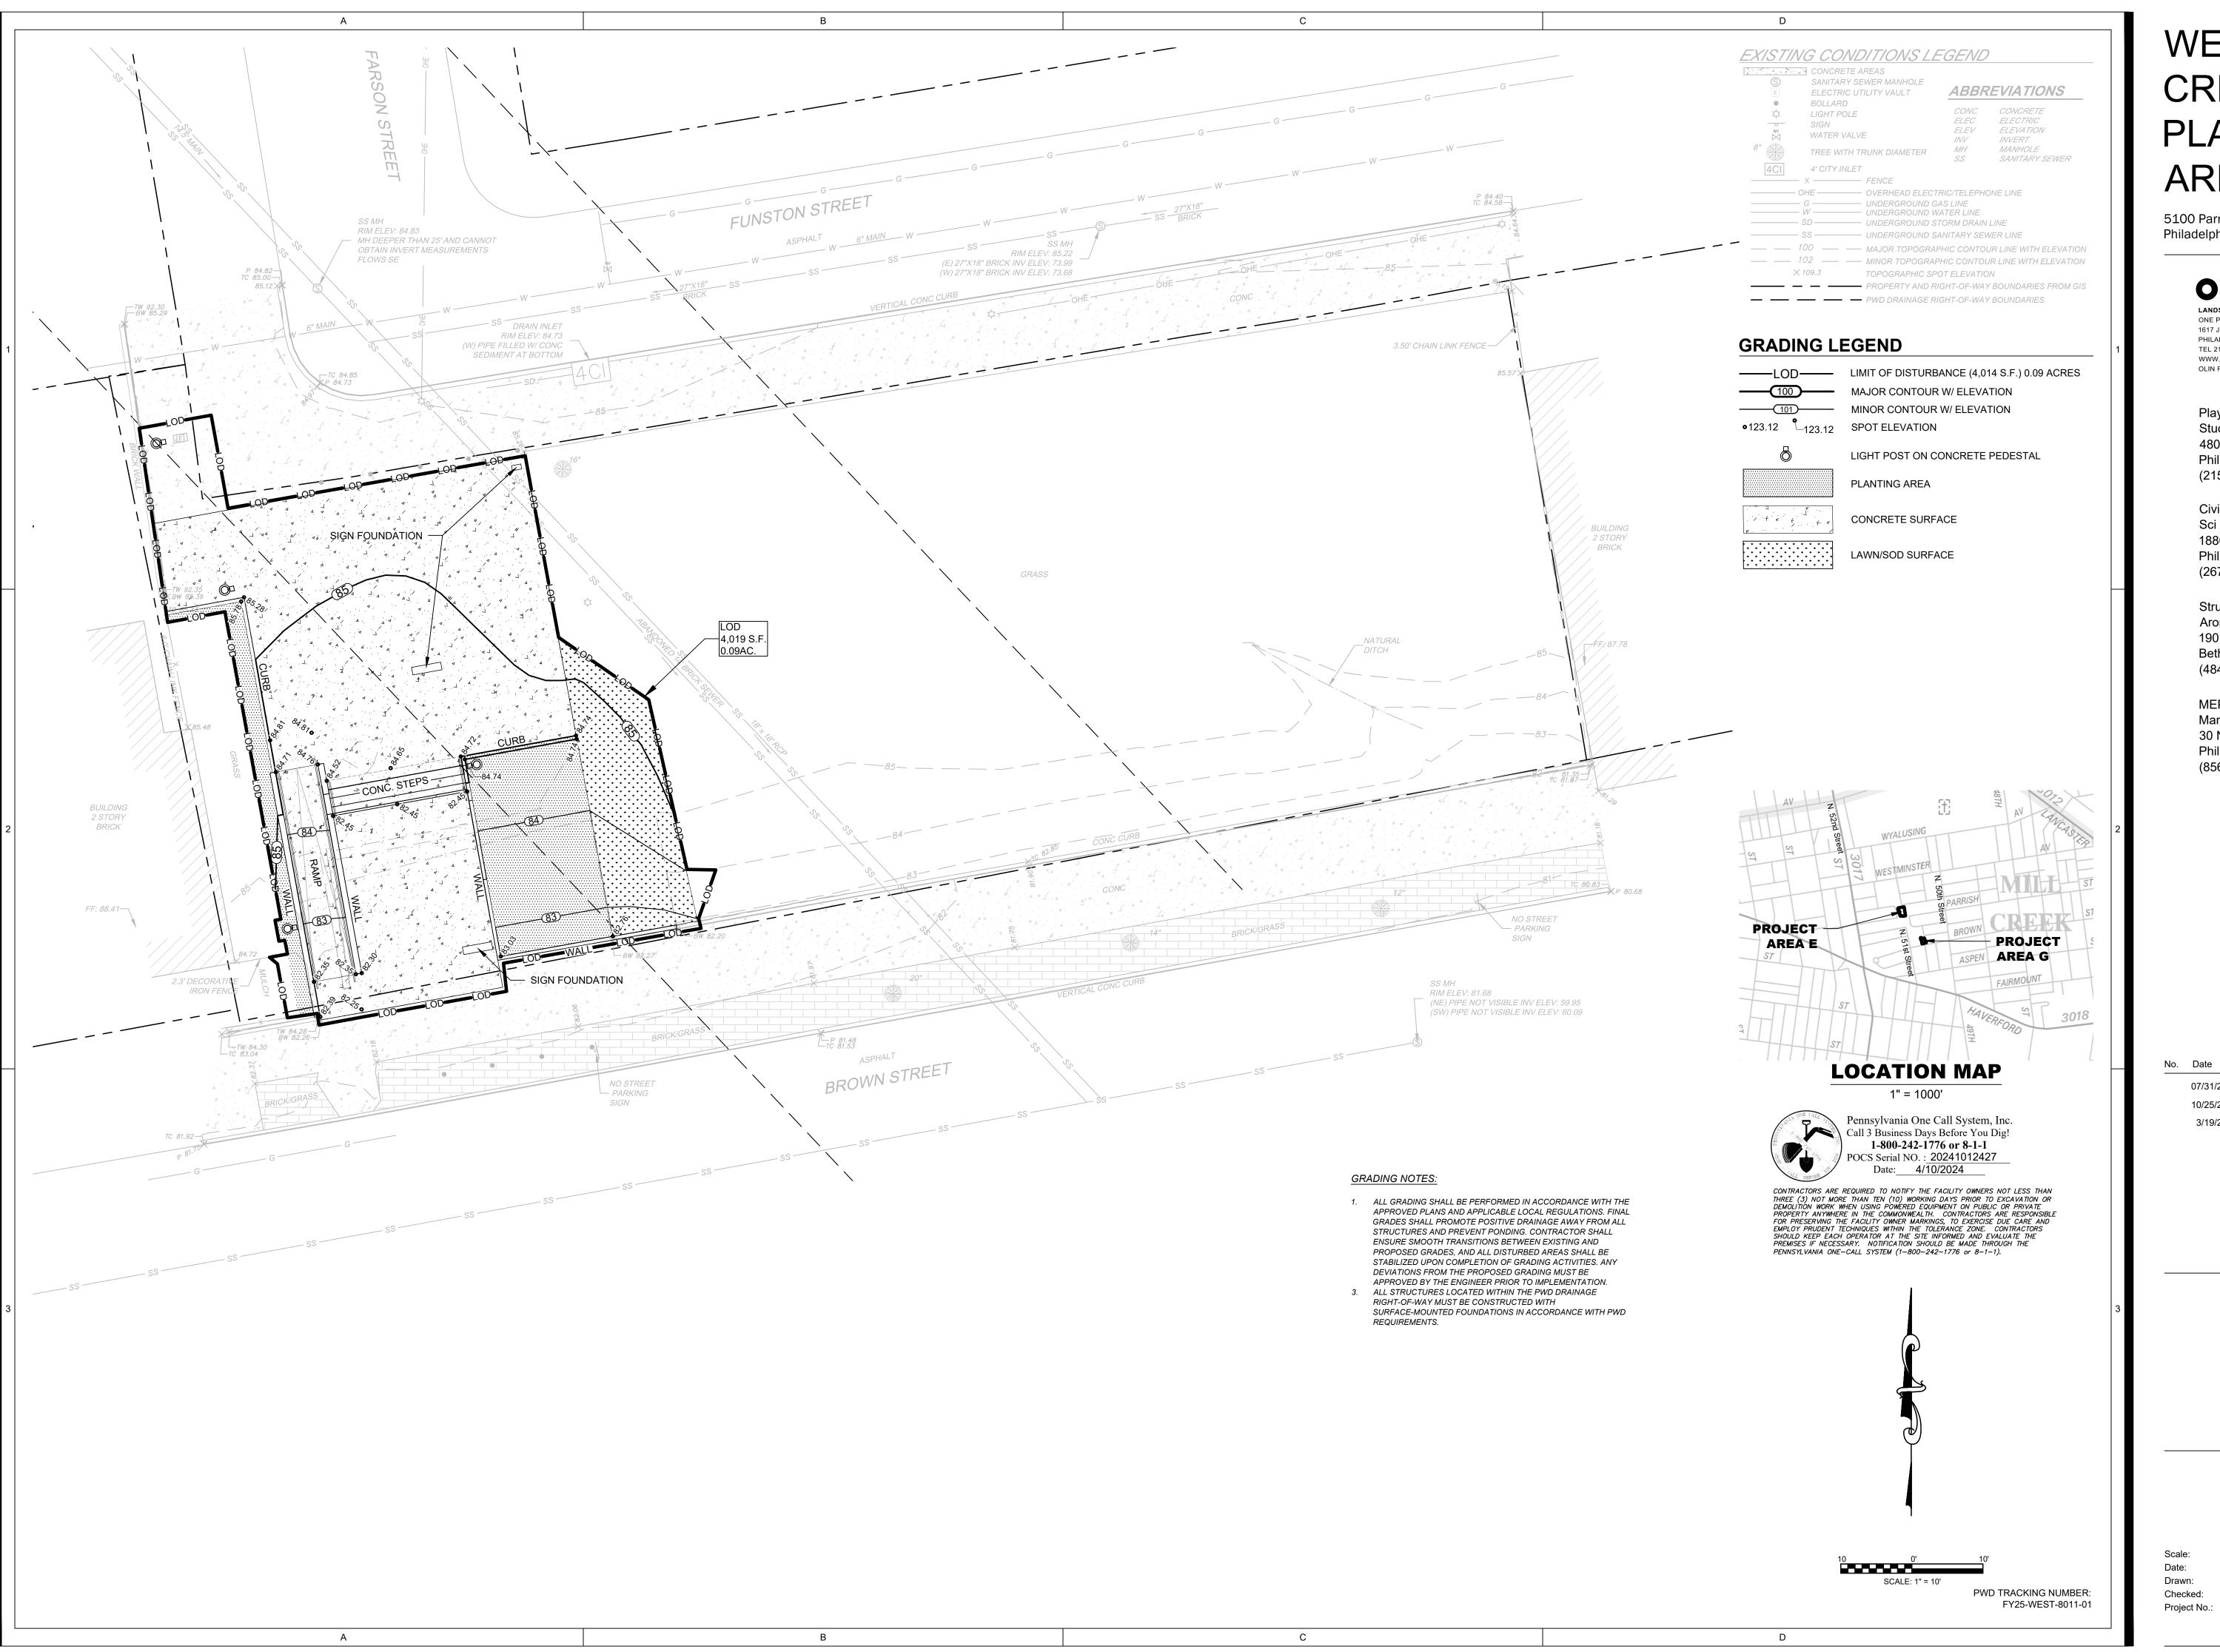
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07/31/2024 DESIGN DEVELOPMENT 100% 10/25/2024 DESIGN DEVELOPMENT 100% PWD COMMENTS 3/19/2025
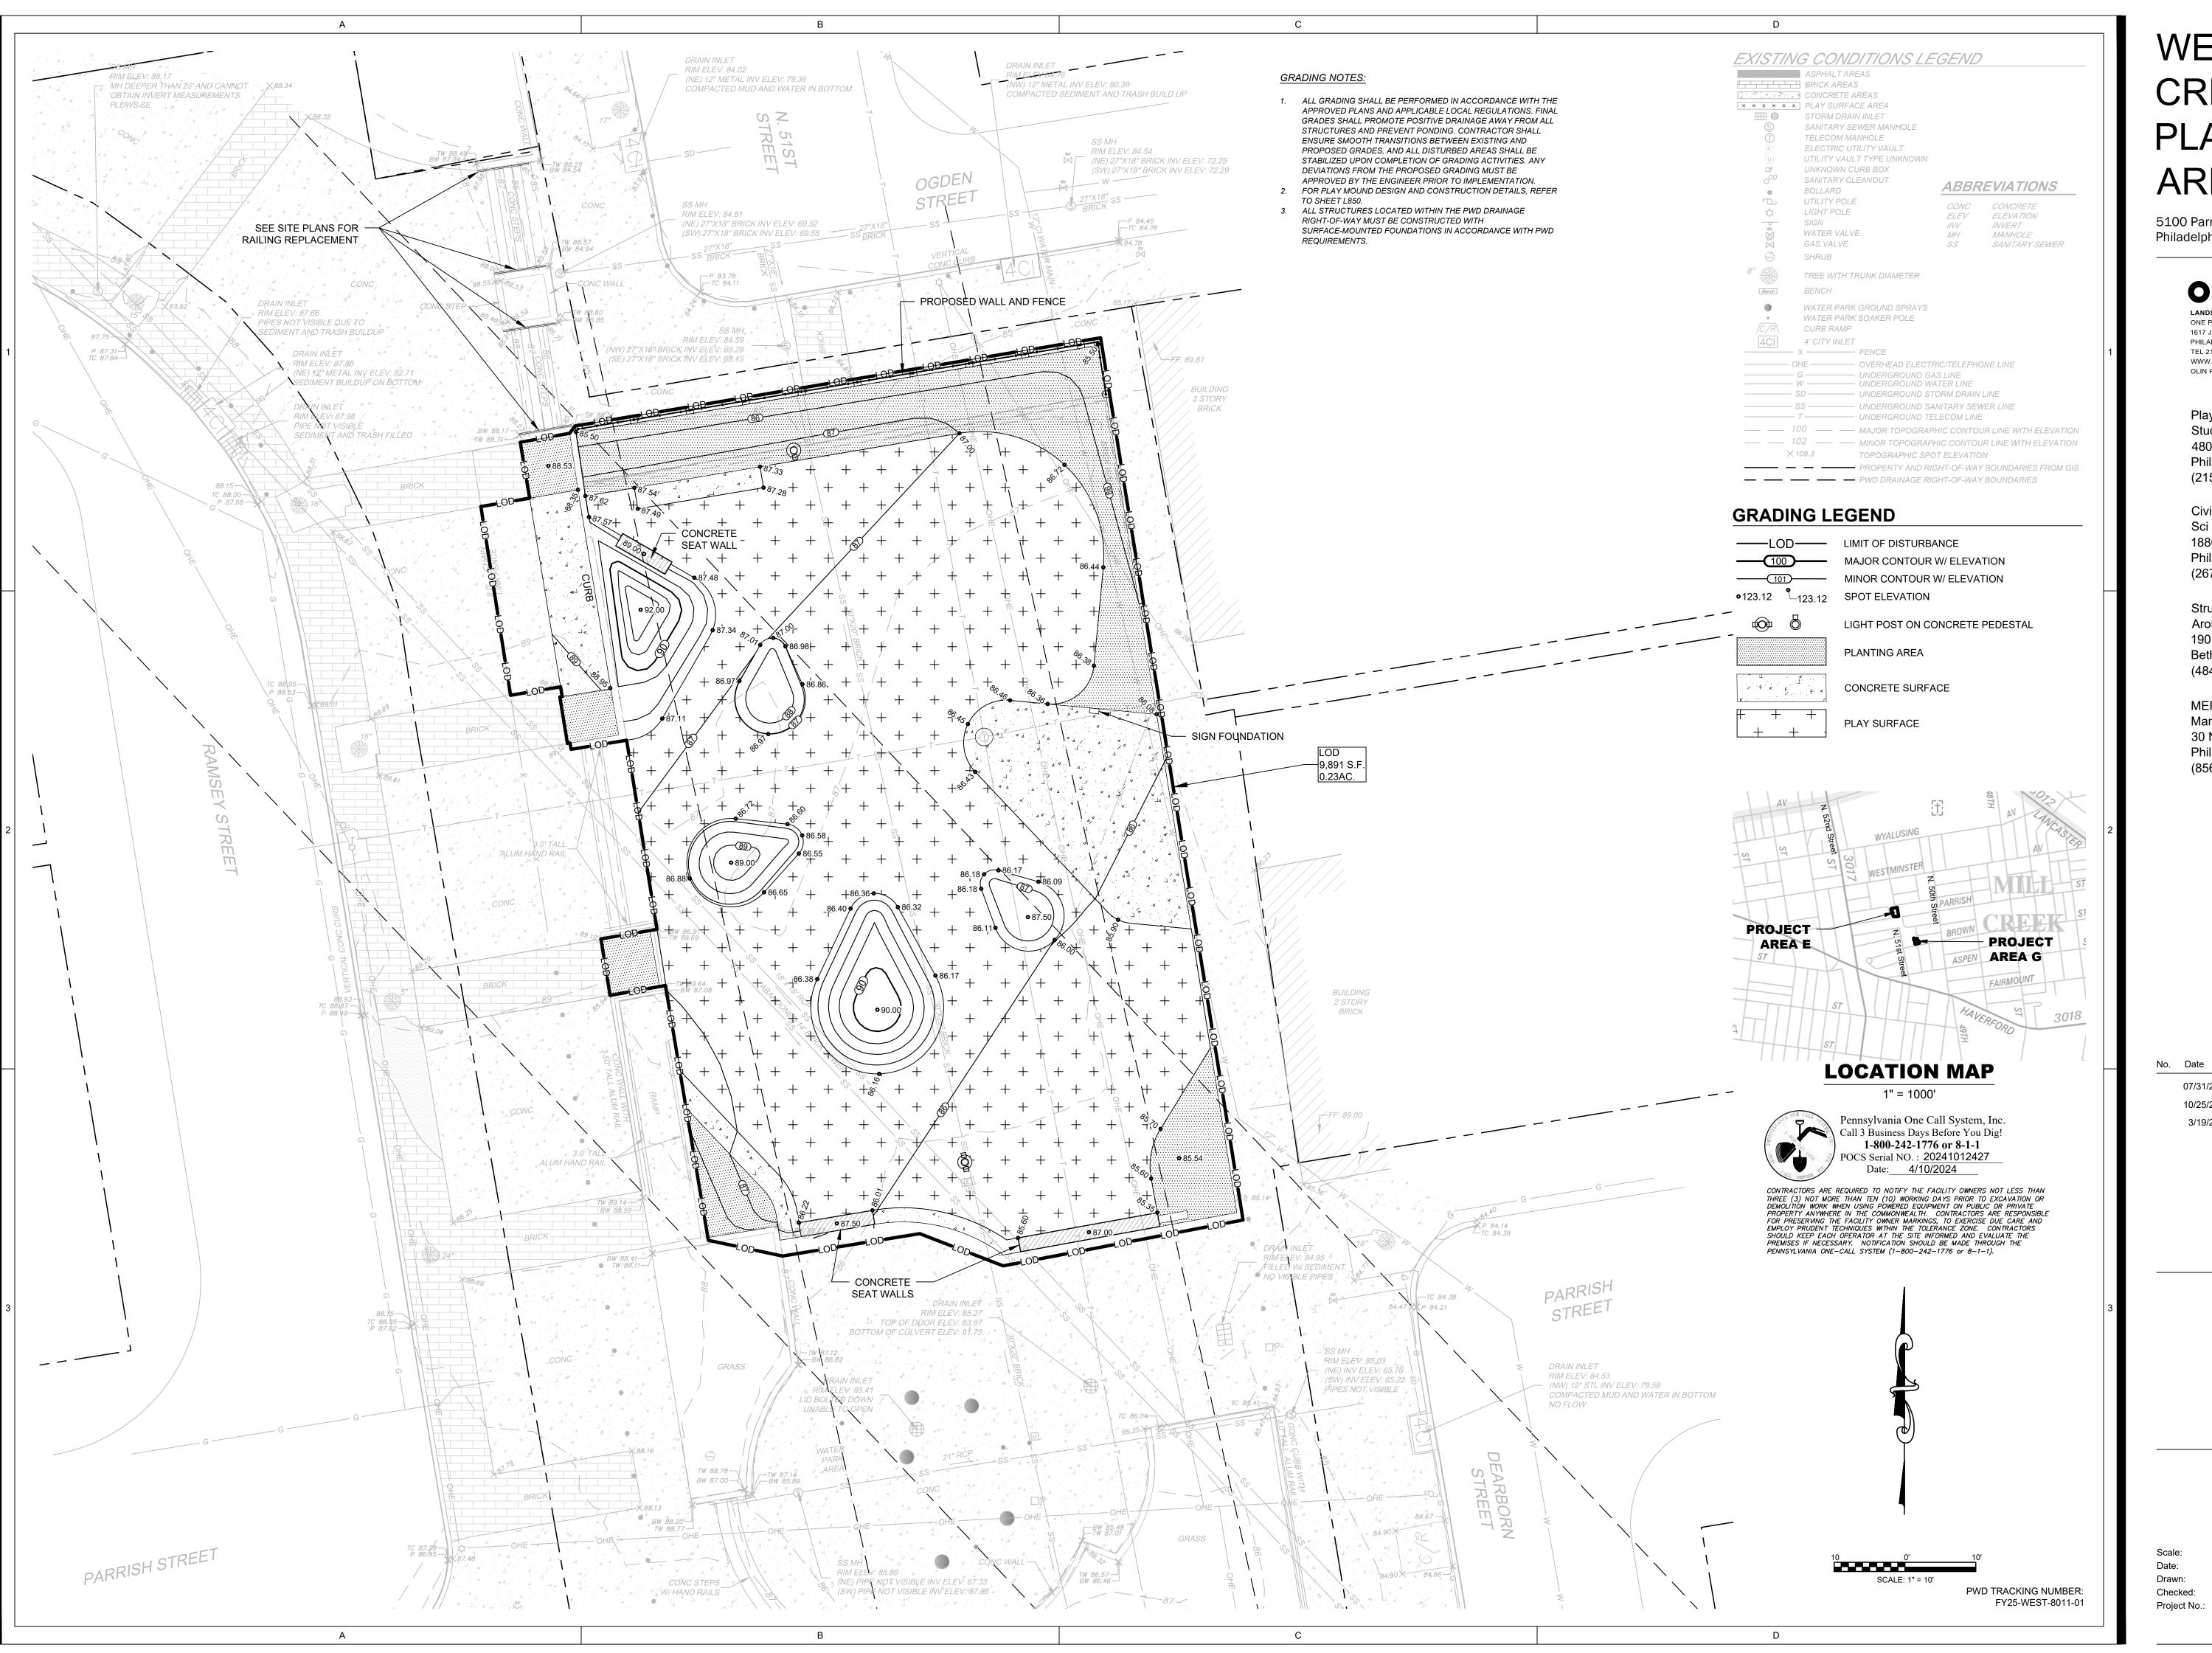
> Grading Plan (Area E)

C-301

T.S.W



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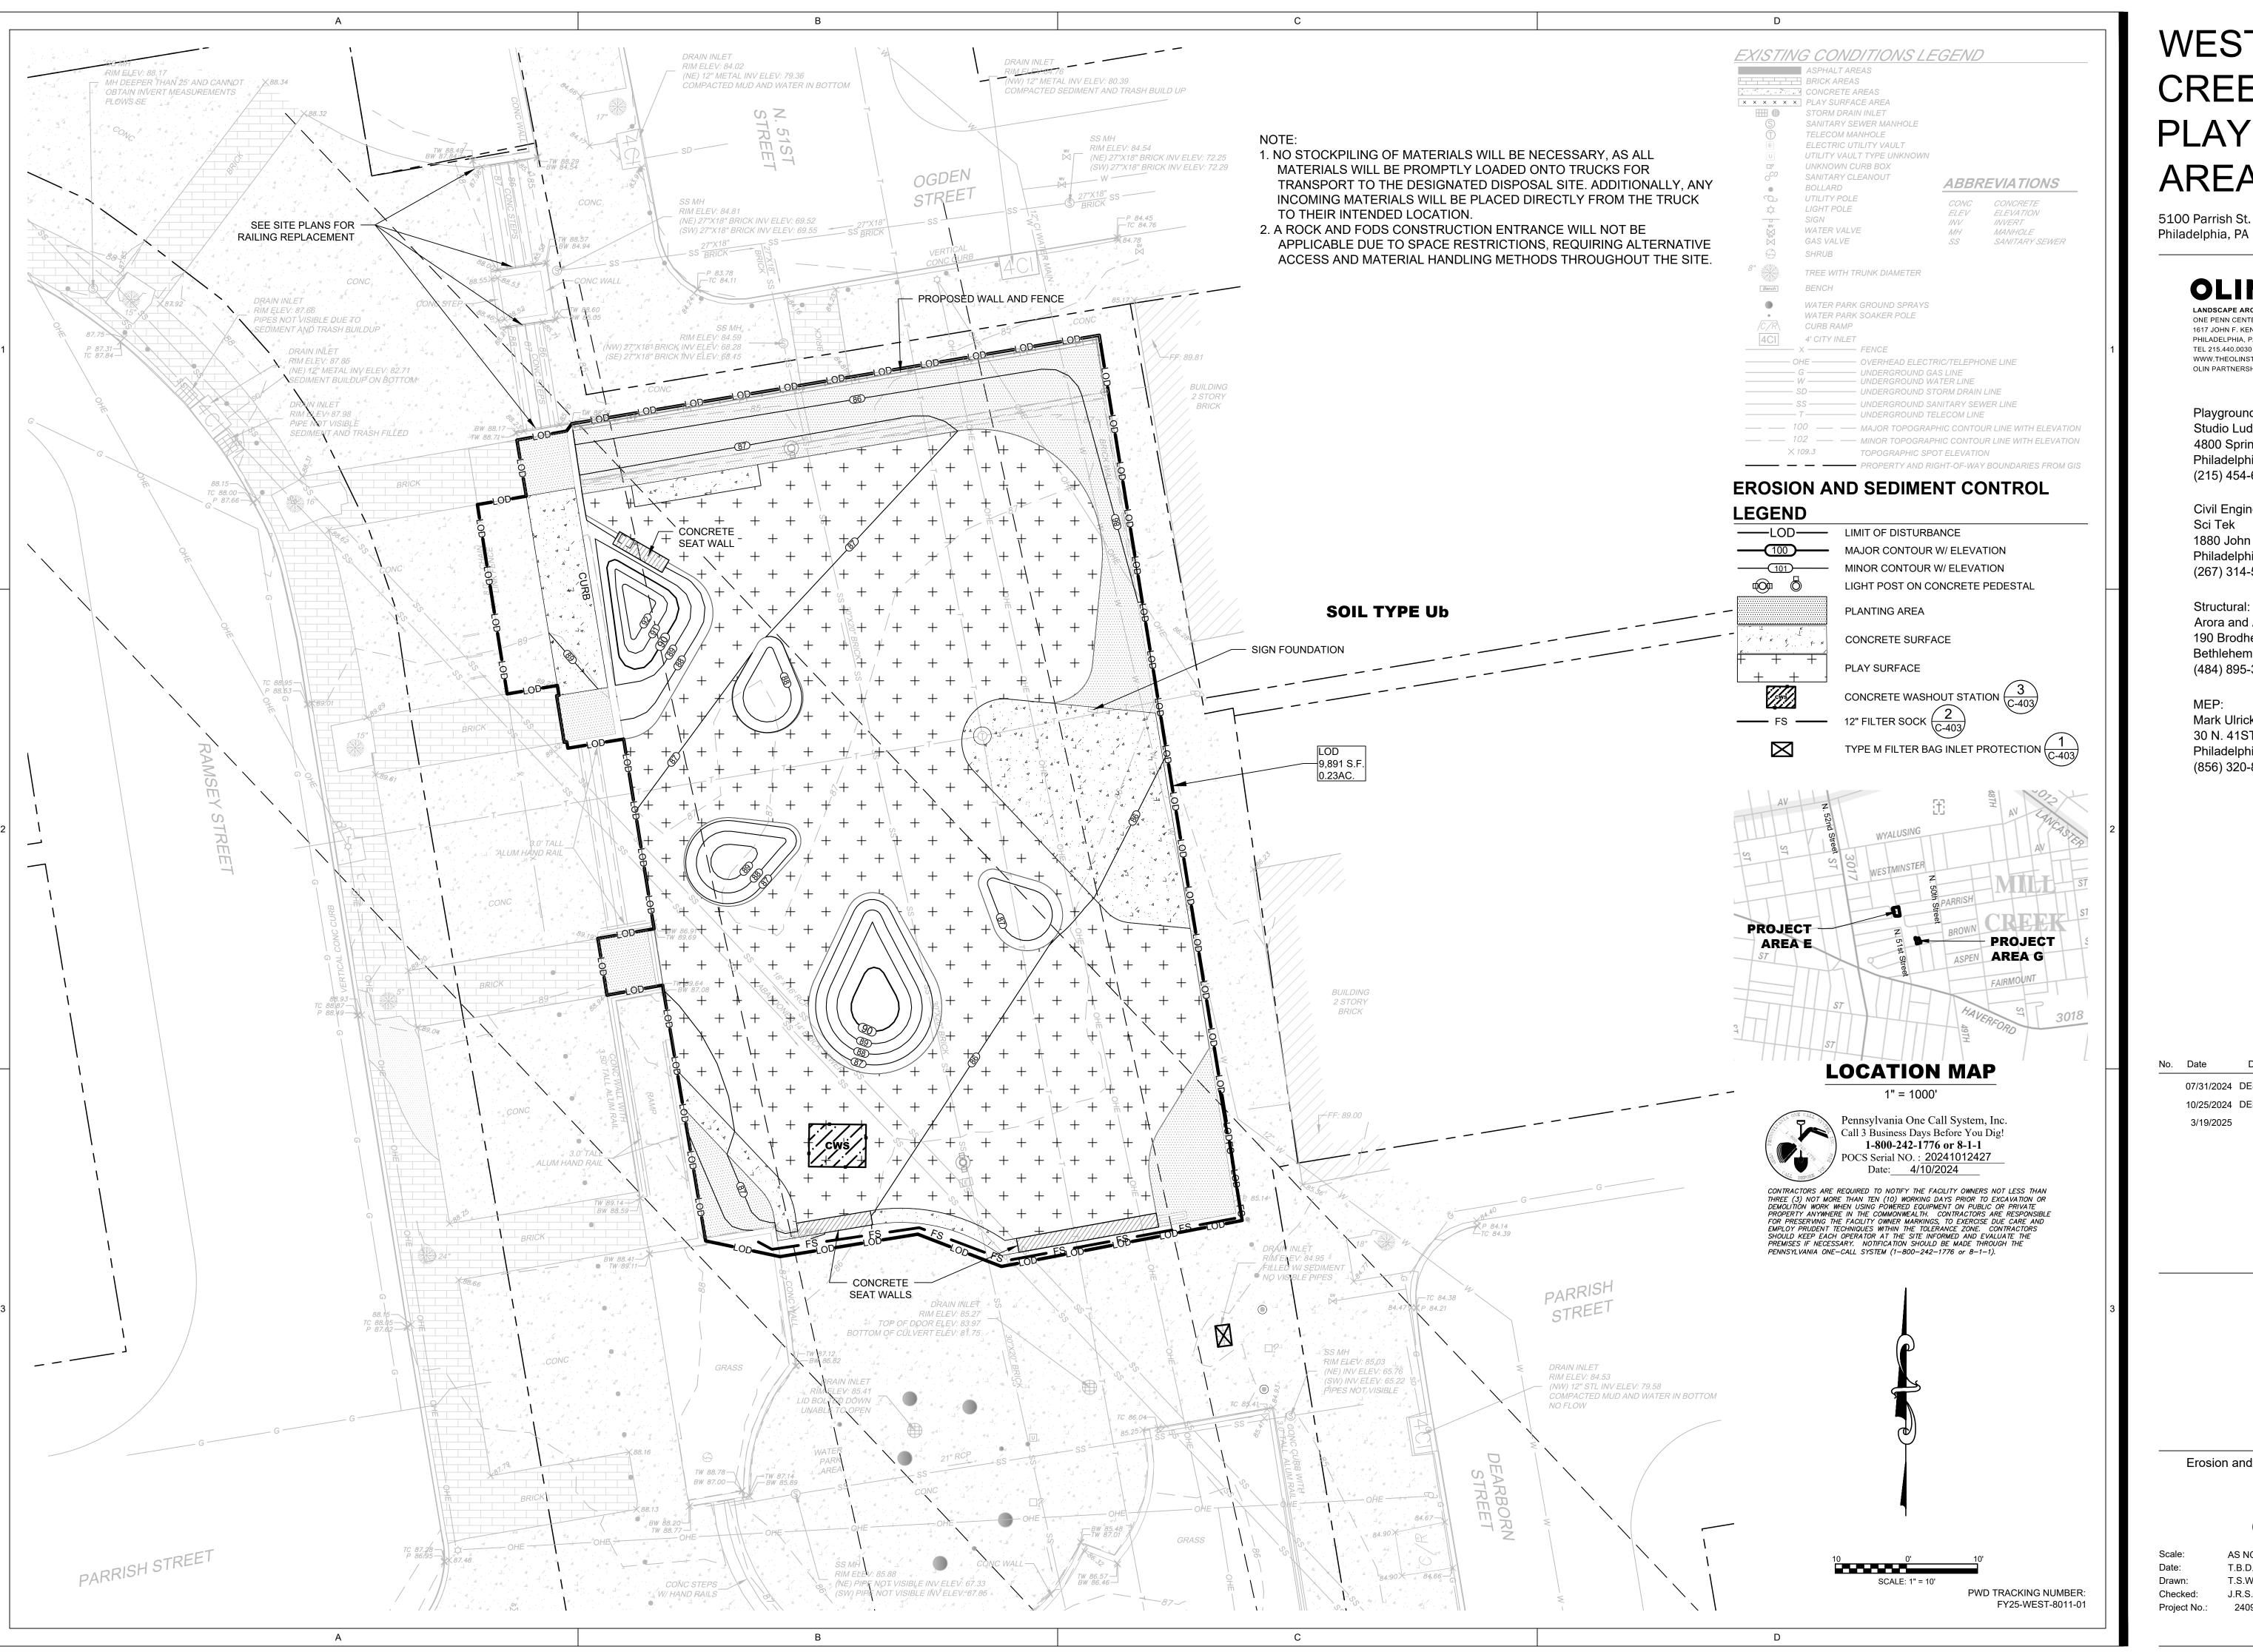
Description

07/31/2024 DESIGN DEVELOPMENT 100% 10/25/2024 DESIGN DEVELOPMENT 100% PWD COMMENTS

> Grading Plan (Area G)

C-302

T.S.W Checked: Project No.:



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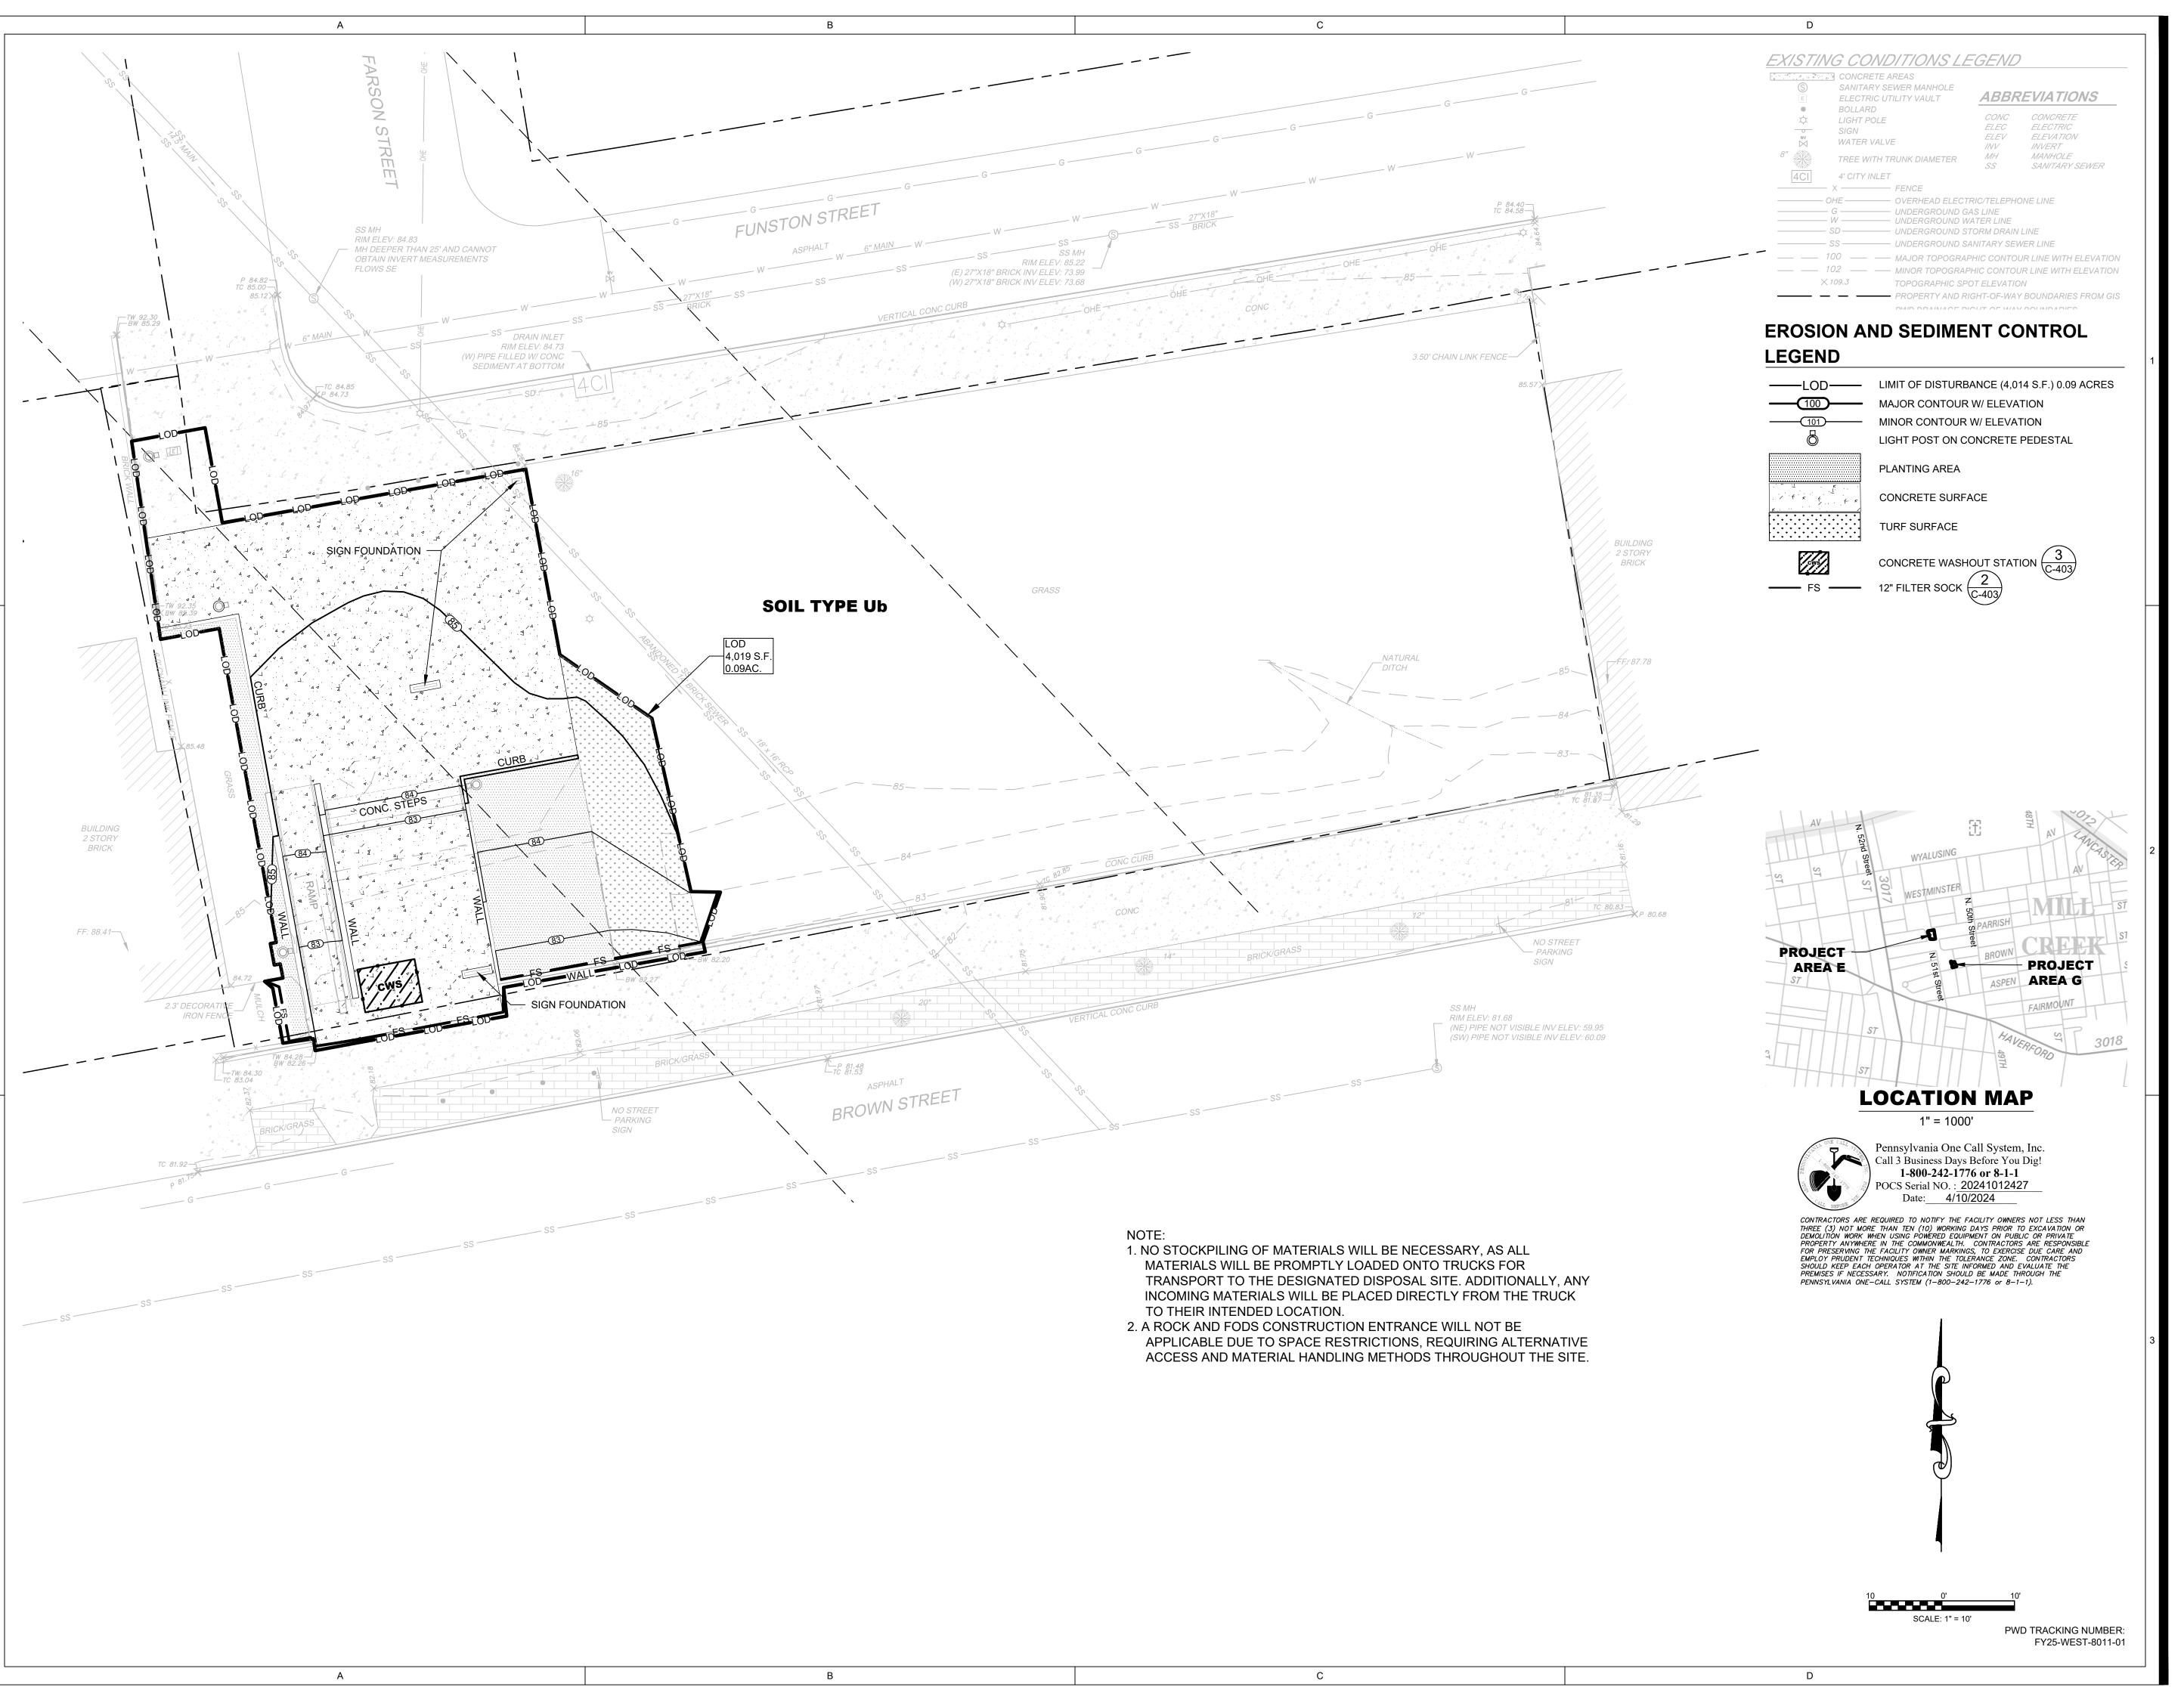
Description

07/31/2024 DESIGN DEVELOPMENT 100% 10/25/2024 DESIGN DEVELOPMENT 100% 3/19/2025 PWD COMMENTS

Erosion and Sediment Control Plan (Area E)

C-401

AS NOTED T.B.D. T.S.W J.R.S. 2409



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No. Date Description

 07/31/2024
 DESIGN DEVELOPMENT 100%

 10/25/2024
 DESIGN DEVELOPMENT 100%

 3/19/2025
 PWD COMMENTS

Erosion and Sediment Control Plan (Area G)

C-402

Scale: AS NOTED

Date: T.B.D.

Drawn: T.S.W

Checked: J.R.S.

Project No.: 2409

NOTES:

MAXIMUM DRAINAGE AREA = 1/2 ACRE.

C-401 SCALE: N.T.S.

INLET PROTECTION SHALL NOT BE REQUIRED FOR INLET TRIBUTARY TO SEDIMENT BASIN OR TRAP. BERMS SHALL BE REQUIRED FOR ALL INSTALLATIONS.

ROLLED EARTHEN BERM IN ROADWAY SHALL BE MAINTAINED UNTIL ROADWAY IS STONED. ROAD SUBBASE BERM ON ROADWAY SHALL BE MAINTAINED UNTIL ROADWAY IS PAVED. EARTHEN BERM IN CHANNEL SHALL BE MAINTAINED UNTIL PERMANENT STABILIZATION IS COMPLETED OR REMAIN PERMANENTLY.

AT A MINIMUM, THE FABRIC SHALL HAVE A MINIMUM GRAB TENSILE STRENGTH OF 120 LBS., A MINIMUM BURST STRENGTH OF 200 PSI, AND A MINIMUM TRAPEZOIDAL TEAR STRENGTH OF 50 LBS. FILTER BAGS SHALL BE CAPABLE OF TRAPPING ALL PARTICLES NOT PASSING A NO. 40

INLET FILTER BAGS SHALL BE INSPECTED ON A WEEKLY BASIS AND AFTER EACH RUNOFF EVENT. BAGS SHALL BE EMPTIED AND RINSED OR REPLACED WHEN HALF FULL OR WHEN FLOW CAPACITY HAS BEEN REDUCED SO AS TO CAUSE FLOODING OR BYPASSING OF THE INLET. DAMAGED OR CLOGGED BAGS SHALL BE REPLACED. A SUPPLY SHALL BE MAINTAINED ON SITE FOR REPLACEMENT OF BAGS. ALL NEEDED REPAIRS SHALL BE INITIATED IMMEDIATELY AFTER THE INSPECTION. DISPOSE ACCUMULATED SEDIMENT AS WELL AS ALL USED BAGS ACCORDING

DO NOT USE ON MAJOR PAVED ROADWAYS WHERE PONDING MAY CAUSE TRAFFIC HAZARDS.

STANDARD CONSTRUCTION DETAIL #4-16 FILTER BAG INLET PROTECTION - TYPE M INLET NOT TO SCALE

TYPE M FILTER BAG INLET PROTECTION

DEP Standard Construction Drawings

COMPOST FILTER SOCK-─2 IN. x 2 IN. WOODEN STAKES BLOWN/PLACED FILTÉR MEDIA— UNDISTURBED AREA DISTURBED AREA DISTURBED AREA CONTOURS -2 IN. x 2 IN. WOODEN STAKES UNDISTURBED AREA FILTER SOCK-PLACED 10 FT ON CENTER PLAN VIEW

NOTES:

SOCK FABRIC SHALL MEET STANDARDS OF TABLE 4.1 OF THE PA DEP EROSION CONTROL MANUAL. COMPOST SHALL MEET THE STANDARDS OF TABLE 4.2 OF THE PA DEP EROSION

COMPOST FILTER SOCK SHALL BE PLACED AT EXISTING LEVEL GRADE. BOTH ENDS OF THE BARRIER SHALL BE EXTENDED AT LEAST 8 FEET UP SLOPE AT 45 DEGREES TO THE MAIN BARRIER ALIGNMENT. MAXIMUM SLOPE LENGTH ABOVE ANY BARRIER SHALL NOT EXCEED THAT SPECIFIED FOR THE SIZE OF THE SOCK AND THE SLOPE OF ITS TRIBUTARY AREA.

TRAFFIC SHALL NOT BE PERMITTED TO CROSS COMPOST FILTER SOCKS.

ACCUMULATED SEDIMENT SHALL BE REMOVED WHEN IT REACHES 1/2 THE ABOVE GROUND HEIGHT OF THE BARRIER AND DISPOSED IN THE MANNER DESCRIBÉD ELSEWHERE IN THE PLAN. COMPOST FILTER SOCKS SHALL BE INSPECTED WEEKLY AND AFTER EACH RUNOFF EVENT. DAMAGED SOCKS SHALL BE REPAIRED ACCORDING TO MANUFACTURER'S SPECIFICATIONS OR REPLACED WITHIN 24 HOURS OF INSPECTION.

BIODEGRADABLE COMPOST FILTER SOCKS SHALL BE REPLACED AFTER 6 MONTHS; PHOTODEGRADABLE SOCKS AFTER 1 YEAR. POLYPROPYLENE SOCKS SHALL BE REPLACED ACCORDING TO MANUFACTURER'S RECOMMENDATIONS.


UPON STABILIZATION OF THE AREA TRIBUTARY TO THE SOCK, STAKES SHALL BE REMOVED. THE SOCK MAY BE LEFT IN PLACE AND VEGETATED OR REMOVED. IN THE LATTER CASE, THE MESH SHALL BE CUT OPEN AND THE MULCH SPREAD AS A SOIL SUPPLEMENT.

STANDARD CONSTRUCTION DETAIL #4-1 COMPOST FILTER SOCK

NOT TO SCALE

COMPOST FILTER SOCK

SCALE: N.T.S. DEP Standard Construction Drawings

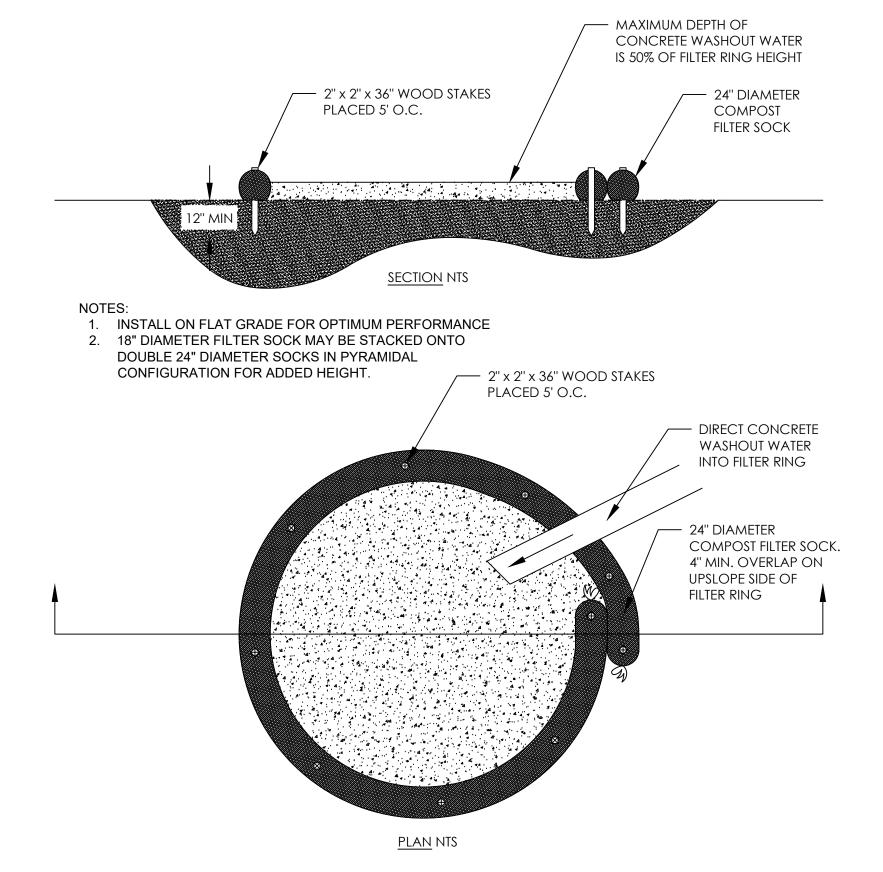

A suitable impervious geomembrane shall be placed at the location of the washout prior to installing the socks.



WEST MILL CREEK PLAYGROUND AREAS E & G

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No. Date Description

> 07/31/2024 DESIGN DEVELOPMENT 100% 10/25/2024 DESIGN DEVELOPMENT 100% PWD COMMENTS

Erosion and Sediment Control Details

T.S.W Checked:

PWD TRACKING NUMBER: FY25-WEST-8011-01

REFERENCE SOURCE:

PENNSYLVANIA DEPARTMENT OF ENVIRONMENTAL PROTECTION (DEPARTMENT), "EROSION AND SEDIMENT POLLUTION CONTROL PROGRAM MANUAL" ISSUED MARCH 2012, WITH SUBSEQUENT CORRECTIONS AND ADDITIONS.

THE FOLLOWING E&S BEST MANAGEMENT PRACTICES (BMPS) WILL FUNCTION TO CONTROL RUNOFF AND PROVIDE SEDIMENT REMOVAL DURING DEVELOPMENT AT THE SUBJECT SITE AND CONSTRUCTION OF THE ASSOCIATED STORMWATER FACILITIES. THESE BMPS ARE:

- ROCK OR FODS CONSTRUCTION ENTRANCE,
- COMPOST FILTER SOCK,
- FILTER BAG INLET PROTECTION,
 CONCRETE WASHOUT STATION,

COMPOST FILTER SOCK:

FILTER SOCK IS USED TO CONTROL RUNOFF FROM DISTURBED AREAS WHEN THE RUNOFF IS IN THE FORM OF SHEET FLOW AND THE DISCHARGE IS TO A STABLE AREA. THIS BEST MANAGEMENT PRACTICE (BMP) IS ABACT (ANTIDEGRADATION BEST AVAILABLE COMBINATION OF TECHNOLOGIES) FOR HIGH QUALITY (HQ) AND EXCEPTIONAL VALUE (EV) WATERSHEDS. FILTER SOCK CONSISTS OF A BIODEGRADABLE OR PHOTODEGRADABLE MESH TUBE FILLED WITH A COARSE COMPOST FILTER MEDIA THAT MEETS CERTAIN PERFORMANCE CRITERIA (E.G., HYDRAULIC FLOW THROUGH RATE, TOTAL SOLIDS REMOVAL EFFICIENCY, TOTAL SUSPENDED SOLIDS REMOVAL EFFICIENCY, TURBIDITY REDUCTION, NUTRIENT REMOVAL EFFICIENCY, METALS REMOVAL EFFICIENCY, AND MOTOR OIL REMOVAL EFFICIENCY).

DESIGN CRITERIA:

- THE SEDIMENTATION REMOVAL PROCESS ASSOCIATED WITH FILTER SOCK INVOLVES BOTH FILTERING AND DEPOSITION FROM SETTLING. THIS IS DIFFERENT THAN OTHER METHODS USING ONLY PONDING FOR DEPOSITION OF SEDIMENT. PONDING OCCURS WHEN WATER FLOWING TO THE SOCK ACCUMULATES FASTER THAN IT CAN FLOW THROUGH THE SOCK.
- LEVEL CONTOUR: PLACE FILTER SOCK ON LEVEL CONTOURS TO ASSIST IN DISSIPATING FLOW INTO SHEET FLOW RATHER THAN CONCENTRATED FLOWS. DO NOT CONSTRUCT SOCK SUCH THAT IT CONCENTRATES RUNOFF OR CHANNEL WATER. SHEET FLOW OF WATER SHOULD BE PERPENDICULAR TO THE SOCK AT IMPACT AND RELATIVELY UNCONCENTRATED.
- FLAT SLOPES: WHEN POSSIBLE, PLACE SOCK AT A FIVE (5) FEET OR GREATER
 DISTANCE AWAY FROM THE TOE OF SLOPE IN ORDER FOR THE WATER COMING FROM
 THE SLOPE TO MAXIMIZE SPACE AVAILABLE FOR SEDIMENT DEPOSIT.
- FLOW AROUND ENDS: IN ORDER TO PREVENT WATER FLOWING AROUND THE ENDS
 OF FILTER SOCK, THE ENDS OF THE SOCK MUST BE CONSTRUCTED POINTING
 UPSLOPE SO THE ENDS ARE AT A HIGHER ELEVATION. BE SURE TO STAKE THE ENDS
 OF THE SOCK TO PREVENT MOVEMENT DURING HIGH FLOW EVENTS.
- RATIO OF SLOPE LENGTH TO FILTER SOCK SIZE: THE SIZE (DIAMETER) OF THE SILT SOCK IS DEPENDENT ON THE SLOPE OF THE GROUND AND THE SLOPE LENGTH ABOVE THE SOCK. FIGURE 4.2 (MAXIMUM PERMISSIBLE SLOPE LENGTH ABOVE COMPOST FILTER SOCKS) IN THE DEPARTMENT'S "EROSION AND SEDIMENT POLLUTION CONTROL PROGRAM MANUAL" (MARCH 2012) SHALL BE USED TO SELECT SOCK DIAMETER.

MATERIALS:

COMPOSTED PRODUCTS: COMPOST USED FOR FILTER SOCK SHALL BE WEED FREE AND DERIVED FROM A WELL-DECOMPOSED SOURCE OF ORGANIC MATERIAL. THE COMPOST SHALL BE PRODUCED USING AN AEROBIC COMPOSTING PROCESS MEETING CFR 503 REGULATIONS, INCLUDING TIME AND TEMPERATURE DATA INDICATING EFFECTIVE WEED SEED, PATHOGEN AND INSECT LARVAE KILL.

THE COMPOST SHALL BE FREE OF ANY REFUSE, CONTAMINANTS OR OTHER MATERIALS TOXIC TO PLANT GROWTH. NON-COMPOSTED PRODUCTS WILL NOT BE ACCEPTED. TEST METHODS FOR THE ITEMS BELOW SHOULD FOLLOW USCC TMECC GUIDELINES FOR LABORATORY PROCEDURES:

- a. PH 5.0 8.0 IN ACCORDANCE WITH TMECC 04.11-A, "ELECTROMETRIC PH DETERMINATIONS FOR COMPOST,"
- b. PARTICLE SIZE 99% PASSING A 2" SIEVE AND A MINIMUM OF 60% GREATER THAN THE 3/8" SIEVE, IN ACCORDANCE WITH TMECC 02.02-B, "SAMPLE SIEVING FOR AGGREGATE SIZE CLASSIFICATION." (NOTE IN THE FIELD, PRODUCT COMMONLY IS BETWEEN 1/2" AND 2" PARTICLE SIZE.),
- MOISTURE CONTENT OF LESS THAN 60 PERCENT IN ACCORDANCE WITH STANDARDIZED TEST METHODS FOR MOISTURE DETERMINATION,
- d. MATERIAL SHALL BE RELATIVELY FREE (<1 PERCENT BY DRY WEIGHT) OF

INERT OR FOREIGN MAN-MADE MATERIALS, AND

 A SAMPLE SHALL BE SUBMITTED TO THE ENGINEER FOR APPROVAL PRIOR TO BEING USED AND MUST COMPLY WITH ALL LOCAL, STATE AND FEDERAL REGULATIONS.

INSTALLATION:

- DISPERSING FLOW: SHEET FLOW AND RUNOFF SHOULD NOT EXCEED HEIGHT OF THE SOCK CAPACITY IN MOST STORM EVENTS. IF OVERFLOW OF THE SOCK IS A POSSIBILITY, LARGER SOCK SHOULD BE CONSTRUCTED, OR OTHER POSSIBLE SEDIMENT CONTROL TOOLS MAY BE USED. ALTERNATIVELY, A SECOND SET OF SOCK MAY BE CONSTRUCTED OR USED IN COMBINATION WITH COMPOST BLANKETS TO PREVENT SEDIMENT FROM MOVING.
- STAKES SHALL BE INSTALLED / DRIVEN THROUGH THE MIDDLE OF THE FILTER SOCK ON 10-FOOT CENTERS USING 2" x 2" x 3' WOODEN STAKES.

- IN THE EVENT THAT STAKING IS NOT POSSIBLE (SUCH AS ON ASPHALT OR CONCRETE SURFACES), HEAVY CONCRETE BLOCKS SHALL BE USED BEHIND THE SILT SOCK TO HELP STABILIZE DURING RAINFALL RUNOFF EVENTS. STAKING DEPTH FOR SAND AND SILT LOAM SOILS SHALL BE 12 INCHES AND 8 INCHES FOR CLAY SOILS.
- LOOSE COMPOST MAY BE BACKFILLED ALONG THE UPSLOPE SIDE OF THE FILTER SOCK, FILLING THE SEAM BETWEEN THE SOIL SURFACE AND THE DEVICE, IMPROVING FILTRATION AND SEDIMENT RETENTION.
- FILTER SOCK IS NOT TO BE USED IN PERENNIAL, INTERMITTENT OR EPHEMERAL STREAMS

INSPECTION AND MAINTENANCE:

- FILTER SOCK WILL BE INSPECTED WEEKLY AND AFTER EVERY PRECIPITATION EVENT.
 ANY NECESSARY REPAIRS WILL BE MADE WITHIN 24 HOURS OF INSPECTION.
- ACCUMULATED SEDIMENTS WILL BE REMOVED AS REQUIRED TO KEEP THE SOCK
 FUNCTIONAL. IN ALL CASES, DEPOSITS WILL BE REMOVED WHEN ACCUMULATIONS
 REACH 1/2 THE ABOVEGROUND HEIGHT OF THE SOCK.
- SEDIMENT ACCUMULATED BEHIND THE SOCK WILL BE PLACED IN A TEMPORARY STOCKPILE AREA LOCATED UPSLOPE AND BEHIND A BARRIER OR SEDIMENT REMOVAL STRUCTURE. ALL SEDIMENT REMOVED FROM BEHIND THE FILTER SOCK WILL BE IMMEDIATELY HAULED TO THE ABOVE REFERENCED BARRIER OR SEDIMENT REMOVAL STRUCTURE.
- ONCE THE SEDIMENT (REMOVED FROM BEHIND THE SOCK) HAS DRIED, IT SHALL BE SPREAD AND SEEDED ACCORDING TO THE APPROVED SEEDING AND MULCHING SPECIFICATIONS OUTLINED ELSEWHERE IN THESE E&S NOTES.
- ALL SEDIMENT REMOVED FROM BEHIND THE SOCK, THAT WILL NOT BE PLACED ON-SITE, WILL BE DISPOSED IN A DEPARTMENT-APPROVED LANDFILL OR A COUNTY CONSERVATION DISTRICT APPROVED SOIL / ROCK DISPOSAL AREA.
- BIODEGRADABLE FILTER SOCK SHALL BE REPLACED AFTER SIX (6) MONTHS AND PHOTODEGRADABLE SILT SOCKS REPLACED AFTER ONE (1) YEAR.

VEGETATION:

 FOR PERMANENT AREAS, SEEDED FILTER SOCK ALLOWS VEGETATION TO BE ESTABLISHED DIRECTLY IN THE SOCK AND IMMEDIATELY IN FRONT AND BACK OF THE SOCK AT A DISTANCE OF FIVE (5) FEET. VEGETATION ON AND AROUND THE SOCK WILL ASSIST IN SLOWING DOWN WATER FOR FILTRATION. THE OPTION OF ADDING VEGETATION WILL BE AT THE DISCRETION OF THE ENGINEER. NO OTHER SOIL AMENDMENTS OR FERTILIZER ARE REQUIRED FOR VEGETATION ESTABLISHMENT.

CONCRETE WASHOUT STATION:

CONCRETE WASHOUT WATER IS A SLURRY CONTAINING TOXIC METALS THAT IS CAUSTIC AND CORROSIVE. IF CONCRETE WASHOUT WATER IS SPILLED ONTO THE GROUND, IT CAN RUN OFF THE CONSTRUCTION SITE AND ENTER STORM DRAINS OR SURFACE WATERS, CONCRETE WASHOUT WATER CAN ALSO PERCOLATE THROUGH THE SOIL AND ALTER SOIL CHEMISTRY AND CONTAMINATE GROUNDWATER. THE BMP OBJECTIVE FOR CONCRETE WASHOUT WATER IS TO COLLECT AND RETAIN ALL THE WASHOUT WATER AND SOLIDS IN A LEAK-PROOF CONTAINER.

FOR PROJECTS ON WHICH CONCRETE WILL BE POURED OR OTHERWISE FORMED ON-SITE, A WASHOUT FACILITY MUST BE PROVIDED FOR THE CLEANING OF CHUTES, MIXERS, AND HOPPERS OF THE DELIVERY VEHICLES. DIFFERENT TYPES OF WASHOUT STRUCTURES ARE AVAILABLE FOR COLLECTING AND RETAINING WASHOUT WATER. A PORTABLE PREFABRICATED VINYL WASHOUT CONTAINER (OR APPROVED EQUAL) WILL BE USED AT THE SUBJECT SITE.

CONCRETE WASH WATER SHALL BE HANDLED IN THE MANNER DESCRIBED ON THE PLAN DRAWINGS. IN NO CASE SHALL IT BE ALLOWED TO ENTER ANY SURFACE WATERS OR GROUNDWATER SYSTEMS.

THE VINYL CONCRETE WASHOUT CONTAINER SHALL BE INSTALLED AT A LOCATION CONVENIENT TO THE LOCATION WHERE CONCRETE IS BEING POURED. A TYPICAL LOCATION FOR THE VINYL CONCRETE WASHOUT CONTAINER IS SHOWN ON THE E&S DRAWING. A VINYL CONCRETE WASHOUT CONTAINER DETAIL IS SHOWN ON THE E&S DETAIL SHEET.

INSTALLATION:

- PRE-FABRICATED VINYL WASHOUT CONTAINERS SHALL BE INSTALLED PER THE MANUFACTURER'S RECOMMENDATION.
- POSITION THE CONTAINER ON A FLAT GRADE (I.E., SLOPES NOT EXCEEDING 2 PERCENT) AT A LOCATION BEST SUITED FOR THE CONSTRUCTION PROJECT.
- THE WASHOUT CONTAINER SHALL NOT BE PLACED WITHIN 50 FEET OF STORM DRAINS, OPEN DITCHES, OR WATERBODIES.
- IF HEAVY RAINS ARE ANTICIPATED, THE WASHOUT CONTAINER SHALL BE COVERED TO AVOID OVERFLOW DURING THE STORM.

INSPECTION AND MAINTENANCE:

- THE CONCRETE WASHOUT SHALL BE INSPECTED DAILY AND AFTER EVERY RAINFALL EVENT TO CHECK FOR LEAKS OR DAMAGE TO THE CONTAINER BY CONSTRUCTION ACTIVITIES. A DAMAGED CONTAINER SHALL BE REMOVED AND REPLACED IMMEDIATELY.
- DURING DAILY INSPECTION, DETERMINE IF THE FILTER BAG IN THE VINYL CONTAINER
 IS FULL AND IN NEED OF REPLACEMENT.
- INSERT A NEW, EMPTY FILTER BAG INSIDE THE VINYL CONTAINER. WHEN THE VINYL CONTAINER IS FILLED WITH FILTERED WATER, ALLOW THE WATER TO EITHER EVAPORATE OR TREAT THE WATER WITH WATER GELLING GRANULES, ALLOW THE WATER TO GEL, AND THEN REMOVE THE BAG WITH THE GELLED WATER FOR PROPER DISPOSAL.

CONCRETE SOLIDS, THE FILTER BAG, AND GELLED WATER SHALL BE PROPERLY DISPOSED DEPARTMENT APPROVED LANDFILL OR LOCAL CONSERVATION DISTRICT APPROVED SOIL / ROCK DISPOSAL AREA.

GENERAL E&S MAINTENANCE

IN ADDITION TO THE REQUIREMENTS FOR THE FREQUENCY OF INSPECTIONS INDICATED IN THE ABOVE SUBSECTIONS, INSPECTIONS OF ALL EROSION AND SEDIMENTATION CONTROL FACILITIES AND EQUIPMENT SHALL OCCUR AT LEAST WEEKLY AND AFTER EACH RAINFALL EVENT.

TO PERFORM AS DESIGNED, THE TEMPORARY AND PERMANENT EROSION AND SEDIMENT CONTROL DEVICES ARE TO BE MAINTAINED IN A SATISFACTORY CONDITION.

MAINTENANCE SHALL BE PERFORMED AS SPECIFIED IN THE PLANS, REPORTS, AND AS DIRECTED BY THE APPROPRIATE REGULATING AGENCIES.

AN EROSION AND SEDIMENT CONTROL INSPECTION LOG WILL BE COMPLETED (AND MAINTAINED ON-SITE) FOR EACH INSPECTION CONDUCTED AT THE PROJECT DURING THE CONSTRUCTION PHASE. THE INSPECTION LOG WILL DOCUMENT EACH INSPECTION AND ALL E&S BMP REPAIR, OR REPLACEMENT AND MAINTENANCE ACTIVITIES. OTHER INFORMATION CONTAINED ON THE INSPECTION LOG WILL INCLUDE, DATE AND TIME OF THE INSPECTION, INSPECTION NUMBER, INSPECTOR NAME, TITLE, AND SIGNATURE OF THE INSPECTOR.

RESPONSIBILITY FOR FILL MATERIALS

THE CONTRACTOR SELECTED FOR CONSTRUCTION SHALL BE RESPONSIBLE TO PERFORM ENVIRONMENTAL DUE DILIGENCE AND DETERMINE THAT ALL FILL MATERIAL IMPORTED TO THE SITE OR EXPORTED FROM THE SITE MEETS THE DEPARTMENT OF ENVIRONMENTAL PROTECTION'S DEFINITION OF CLEAN FILL. CLEAN FILL IS DEFINED AS UNCONTAMINATED, NONWATER-SOLUBLE, NONDECOMPOSTABLE, INERT SOLID MATERIAL. THE TERM INCLUDES SOIL, ROCK, STONE, DREDGED MATERIAL, USED ASPHALT, AND BRICK, BLOCK OR CONCRETE FROM CONSTRUCTION AND DEMOLITION ACTIVITIES THAT IS SEPARATE FROM OTHER WASTE AND RECOGNIZABLE AS SUCH. THE TERM DOES NOT INCLUDE MATERIALS PLACED IN OR ON THE WATERS OF THE COMMONWEALTH UNLESS OTHERWISE AUTHORIZED. ENVIRONMENTAL DUE DILIGENCE IS DEFINED AS INVESTIGATIVE TECHNIQUES, INCLUDING, BUT NOT LIMITED TO, VISUAL PROPERTY INSPECTIONS, ELECTRONIC DATA BASE SEARCHES, REVIEW OF OWNERSHIP AND USE HISTORY OF PROPERTY, SANBORN MAPS, ENVIRONMENTAL QUESTIONNAIRES, TRANSACTION SCREENS, ANALYTICAL TESTING, ENVIRONMENTAL ASSESSMENTS OR AUDITS.

E&S PLAN / PCSM PLAN CONSISTENCY

THE DIMENSIONS AND ELEVATIONS SHOWN ON THE E&S DRAWINGS ARE CONSISTENT WITH THOSE USED IN THE POST-CONSTRUCTION STORMWATER MANAGEMENT PLAN (PCSM).

IF A CONFLICT IS FOUND BETWEEN DIFFERENT PORTIONS OF THE CONTRACT DOCUMENTS, THE CONTRACTOR SHALL NOTIFY THE DESIGN ENGINEER IMMEDIATELY. CONTINUED CONSTRUCTION OF THE AREA IN CONFLICT SHALL BE AT THE CONTRACTOR'S OWN RISK UNTIL THE CONFLICT IS RESOLVED BY THE DESIGN ENGINEER.

THERE ARE NO STREAMS WITHIN THE LIMITS OF DISTURBANCE AND, AS WILL BE DISCUSSED BELOW, THERE ARE NO EXISTING OR PROPOSED RIPARIAN BUFFERS WITHIN THE LIMITS OF DISTURBANCE. THE NEAREST PERENNIAL STREAM IS LOCATED 1.62 MLES AWAY.

MINIMIZE EXTENT AND DURATION OF EARTH DISTURBANCE

THE EROSION AND SEDIMENT CONTROL PLAN MINIMIZES THE EXTENT OF EARTH DISTURBANCE (LAND CLEARING AND GRADING) TO THE MAXIMUM EXTENT POSSIBLE SINCE ONLY THE SMALLEST FOOTPRINT NECESSARY TO ACCOMPLISH THE GOALS OF THE FACILITY WILL BE DISTURBED. ALSO (TO THE EXTENT PRACTICABLE) THE EXISTING VEGETATION (SENSITIVE RESOURCES SUCH AS THE TREES ON THE PROJECT PROPERTY) WILL BE PROTECTED. THE PROJECT WILL BE COMPLETED AS QUICKLY AS POSSIBLE (I.E., DURATION OF THE PROJECT MINIMIZED), AND ONLY THOSE AREAS NECESSARY FOR BUILDING CONSTRUCTION AND SITE ACCESS (AND ASSOCIATED STORMWATER CONTROLS) WILL BE DISTURBED. ANTICIPATED DURATION OF THE CONSTRUCTION IS APPROXIMATELY TWELVE (12) MONTHS.

MAXIMIZE PROTECTION OF EXISTING DRAINAGE FEATURES AND VEGETATION

THERE ARE NO NATURAL DRAINAGE FEATURES ON THE SUBJECT SITE. DRAINAGE FROM THE PROJECT AREA IS COLLECTED IN THE EXISTING COMBINED SEWER SYSTEM VIA EXISTING CATCH BASINS AND DISCHARGED TO THE LOCAL SANITARY AUTHORITY'S (ALCOSAN) TREATMENT PLANT ALONG THE ALLEGHENY RIVER. THE PRINCIPAL DRAINAGE FEATURE IN THE GENERAL VICINITY OF THE PROPOSED DEVELOPMENT IS THE ALLEGHENY RIVER, LOCATED APPROXIMATELY 1.67 MILES TO THE NORTH OF THE PROJECT SITE.

THE PROJECT SITE IS SITUATED IN AN URBAN SETTING AND THERE ARE NO SENSITIVE ENVIRONMENTAL RESOURCES / FEATURES ON THE PROPERTY. THERE ARE A FEW TREES ON THE SITE THAT WILL BE DISTURBED AS A RESULT OF THE RENOVATION WORK, BUT THE EXISTING TREES ARE NOT CONSIDERED WOODLANDS. ADDITIONALLY, TREES WILL BE PLANTED AS PART OF PLANNED LANDSCAPING FOR THE FINISHED SITE. NO UNNECESSARY DISTURBANCE OF TREES IS PLANNED AND ONLY THOSE TREES NECESSARY FOR SUCCESSFUL COMPLETION OF THE RENOVATION PROJECT WILL BE IMPACTED. THE ONLY SIGNIFICANT TYPE OF VEGETATION THAT WILL BE AFFECTED BY THE PROPOSED RENOVATION PROJECT IS THE NATURAL GRASS SURFACE (TURF) THAT CURRENTLY COVERS THE FIELD SITUATED WHERE THE MAJORITY OF THE PROPOSED PARKING LOT WILL BE LOCATED.

WHERE INSTALLATION OF POST-CONSTRUCTION STORMWATER MANAGEMENT CONTROLS AND EROSION AND SEDIMENTATION CONTROLS ARE NECESSARY, EXISTING VEGETATION WILL BE PROTECTED TO THE MAXIMUM EXTENT PRACTICABLE.

MINIMIZE SOIL COMPACTION

TO MINIMIZE SOIL COMPACTION, THE EQUIPMENT USED FOR CONSTRUCTION WILL BE TAILORED TO THE SIZE OF THE JOB. NO UNNECESSARILY LARGE / HEAVY EQUIPMENT WILL BE USED, AND CONSTRUCTION SEQUENCING WILL BE SUCH THAT UNNECESSARY PASSES OF THE EQUIPMENT OVER THE GROUND SURFACE WILL BE MINIMIZED.

RIPARIAN FOREST BUFFERS

THERE ARE NO STREAMS OR NATURAL DRAINAGE WAYS IN THE IMMEDIATE VICINITY OF PROJECT SITE. DRAINAGE FROM THE AREA IS COLLECTED IN THE EXISTING COMBINED SEWER SYSTEM VIA EXISTING CATCH BASINS AND DISCHARGES TO THE ALLEGHENY RIVER.

THE PRINCIPAL DRAINAGE FEATURE IN THE GENERAL VICINITY OF THE PROPOSED DEVELOPMENT IS THE ALLEGHENY RIVER LOCATED APPROXIMATELY 1.5 MILES TO THE NORTH OF THE PROJECT SITE.

SINCE THE PROPOSED SITE CONSTRUCTION IS NOT WITHIN A RIPARIAN BUFFER, THE REQUIREMENT TO REQUEST A WAIVER FOR CONSTRUCTION ACTIVITY WITHIN A RIPARIAN BUFFER IS NOT APPLICABLE. LIKEWISE, THE REQUIREMENT TO SHOW AREAS PROPOSED TO BE WAIVED FROM RIPARIAN BUFFER OBLIGATIONS ON THE PLAN DRAWINGS IS ALSO NOT APPLICABLE

DESCRIPTION OF POST CONSTRUCTION STORMWATER BMPS

NO OTHER MEASURES OR CONTROLS ARE PROPOSED THAT PREVENT OR MINIMIZE GENERATION OF INCREASED STORMWATER RUNOFF.

REFER TO THE STORMWATER MANAGEMENT PLAN FOR LOCATIONS OF THE PROPOSED STRUCTURAL STORMWATER BMPS.

LANDSCAPE RESTORATION: LANDSCAPE RESTORATION IS USED FOR ACTIVELY SUSTAINABLE LANDSCAPING PRACTICES THAT ARE IMPLEMENTED OUTSIDE OF RIPARIAN OR OTHER SPECIALLY PROTECTED BUFFER AREAS AND INCLUDES RESTORATION OF FOREST (REFORESTATION) AND / OR MEADOW AND THE CONVERSION OF TURF TO MEADOW.

AREAS LOCATED AROUND THE PROPOSED BUILDING WILL RESTORED AND REPLANTED WITH LANDSCAPING INCLUDING A VARIETY OF SHRUBS, PERENNIALS, ORNAMENTAL GRASSES, BULBS AND GROUNDCOVER. THE AREA OF POST-DEVELOPMENT PERVIOUS COVER IS 13,900 SQUARE FEET (0.32 ACRES).

OTHER STRUCTURAL OR NON-STRUCTURAL BMPS

NO OTHER STRUCTURAL OR NON-STRUCTURAL STORMWATER BMPS ARE NECESSARY TO PREVENT OR MINIMIZE CHANGES IN STORMWATER RUNOFF.

RECYCLING AND DISPOSAL OF MATERIALS

ALL EXCAVATED MATERIALS RESULTING FROM CONSTRUCTION ACTIVITIES AT THE PROJECT SITE AND ACCUMULATED SEDIMENT THAT WILL NOT BE USED ON SITE SHALL BE REMOVED TO A DEPARTMENT AND/OR COUNTY CONSERVATION DISTRICT APPROVED LANDFILL OR SOIL/ROCK DISPOSAL AREA. LIKEWISE, ALL SOIL/FILL MATERIAL THAT ORIGINATES FROM OFF-SITE AREAS SHALL BE APPROVED BY THE DEPARTMENT AND/OR THE COUNTY CONSERVATION DISTRICT.

THE CONTRACTOR SHALL DISPOSE OF ALL EXCESS BUILDING MATERIALS AND WASTES IN ACCORDANCE WITH DEPARTMENT SOLID WASTE MANAGEMENT REGULATIONS AT 25 PA. CODE 260.1 ET SEQ., 271.1 ET SEQ., AND 287.19 ET SEQ. THE CONTRACTOR SHALL NOT ILLEGALLY BURY, DUMP OR DISCHARGE ANY BUILDING MATERIAL OR WASTES AT THE SITE.

REGARDING ANTICIPATED CONSTRUCTION WASTE, ANY CONSTRUCTION DEBRIS (OR DEBRIS RESULTING FROM DEMOLITION OF EXISTING FACILITIES) SUCH AS SCRAP WOOD AND METAL, NAILS, BROKEN CONCRETE, ASPHALT, BRICK, PVC OR METAL PIPE, ETC., WILL BE REMOVED FROM THE SITE AND DISPOSED OF AT A DEPARTMENT AND/OR COUNTY CONSERVATION DISTRICT APPROVED LANDFILL OR SOIL/ROCK DISPOSAL SITE.

WEST MILL CREEK PLAYGROUND AREAS E & G

5100 Parrish St. Philadelphia, PA 19139

OLIN

LANDSCAPE ARCHITECTURE / URBAN DESIGN / PLANNING
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Structural:

No. Date Description

 07/31/2024
 DESIGN DEVELOPMENT 100%

 10/25/2024
 DESIGN DEVELOPMENT 100%

 3/19/2025
 PWD COMMENTS

Erosion and Sediment Control Notes (1 of 2)

C-40

Scale: AS NOTED
Date: T.B.D.
Drawn: T.S.W
Checked: J.R.S.
Project No.: 2409

PWD TRACKING NUMBER:

FY25-WEST-8011-01

В

- AT LEAST SEVEN (7) DAYS PRIOR TO STARTING ANY EARTH DISTURBANCE ACTIVITIES, INCLUDING CLEARING AND GRUBBING, THE OWNER AND/OR OPERATOR SHALL INVITE ALL CONTRACTORS, THE LANDOWNER, APPROPRIATE MUNICIPAL OFFICIALS, THE E&S PLAN PREPARER, THE PCSM PLAN PREPARER, THE LICENSED PROFESSIONAL RESPONSIBLE FOR OVERSIGHT OF CRITICAL STAGES OF IMPLEMENTATION OF THE PCSM PLAN, AND A REPRESENTATIVE FROM THE LOCAL CONSERVATION DISTRICT TO AN ON-SITE PRECONSTRUCTION MEETING.
- 3) AT LEAST 3 DAYS PRIOR TO STARTING ANY EARTH DISTURBANCE ACTIVITIES, OR EXPANDING INTO AN AREA PREVIOUSLY UNMARKED, THE PENNSYLVANIA ONE CALL SYSTEM INC. SHALL BE NOTIFIED AT 1-800-242-1776 FOR THE LOCATION OF EXISTING UNDERGROUND UTILITIES.
- 4) ALL EARTH DISTURBANCE ACTIVITIES SHALL PROCEED IN ACCORDANCE WITH THE SEQUENCE PROVIDED ON THE PLAN DRAWINGS. DEVIATION FROM THAT SEQUENCE MUST BE APPROVED IN WRITING FROM THE LOCAL CONSERVATION DISTRICT OR BY THE DEPARTMENT PRIOR TO IMPLEMENTATION.
- 5) AREAS TO BE FILLED ARE TO BE CLEARED, GRUBBED, AND STRIPPED OF TOPSOIL TO REMOVE TREES, VEGETATION, ROOTS AND OTHER OBJECTIONABLE MATERIAL.
- CLEARING, GRUBBING, AND TOPSOIL STRIPPING SHALL BE LIMITED TO THOSE AREAS DESCRIBED IN EACH STAGE OF THE CONSTRUCTION SEQUENCE. GENERAL SITE CLEARING, GRUBBING AND TOPSOIL STRIPPING MAY NOT COMMENCE IN ANY STAGE OR PHASE OF THE PROJECT UNTIL THE E&S BMPS SPECIFIED BY THE BMP SEQUENCE FOR THAT STAGE OR PHASE HAVE BEEN INSTALLED AND ARE FUNCTIONING AS DESCRIBED IN THIS E&S PLAN.
- 7) AT NO TIME SHALL CONSTRUCTION VEHICLES BE ALLOWED TO ENTER AREAS OUTSIDE THE LIMIT OF DISTURBANCE BOUNDARIES SHOWN ON THE PLAN MAPS. THESE AREAS MUST BE CLEARLY MARKED AND FENCED OFF BEFORE CLEARING AND GRUBBING OPERATIONS BEGIN.
- 8) TOPSOIL REQUIRED FOR THE ESTABLISHMENT OF VEGETATION SHALL BE STOCKPILED AT THE LOCATION(S) SHOWN ON THE PLAN MAPS(S) IN THE AMOUNT NECESSARY TO COMPLETE THE FINISH GRADING OF ALL EXPOSED AREAS THAT ARE TO BE STABILIZED BY VEGETATION. EACH STOCKPILE SHALL BE PROTECTED IN THE MANNER SHOWN ON THE PLAN DRAWINGS. STOCKPILE HEIGHTS SHALL NOT EXCEED 35 FEET. STOCKPILE SLOPES SHALL BE 2H:1V OR FLATTER.
- 9) IMMEDIATELY UPON DISCOVERING UNFORESEEN CIRCUMSTANCES POSING THE POTENTIAL FOR ACCELERATED EROSION AND / OR SEDIMENT POLLUTION, THE OPERATOR SHALL IMPLEMENT APPROPRIATE BEST MANAGEMENT PRACTICES TO MINIMIZE THE POTENTIAL FOR EROSION AND SEDIMENT POLLUTION AND NOTIFY THE LOCAL CONSERVATION DISTRICT AND / OR THE REGIONAL OFFICE OF THE DEPARTMENT.
- ALL BUILDING MATERIALS AND WASTES SHALL BE REMOVED FROM THE SITE AND RECYCLED OR DISPOSED OF IN ACCORDANCE WITH THE DEPARTMENT'S SOLID WASTE MANAGEMENT REGULATIONS AT 25 PA. CODE 260.1 ET SEQ., 271.1, AND 287.1 ET. SEQ. NO BUILDING MATERIALS OR WASTES OR UNUSED BUILDING MATERIALS SHALL BE BURNED, BURIED, DUMPED, OR DISCHARGED AT THE SITE.
- 11) ALL OFF-SITE WASTE AND BORROW AREAS MUST HAVE AN E&S PLAN APPROVED BY THE LOCAL CONSERVATION DISTRICT OR THE DEPARTMENT FULLY IMPLEMENTED PRIOR TO BEING ACTIVATED.
- 12) THE CONTRACTOR IS RESPONSIBLE FOR ENSURING THAT ANY MATERIAL BROUGHT ON SITE IS CLEAN FILL. FORM FP-001 MUST BE RETAINED BY THE PROPERTY OWNER FOR ANY FILL MATERIAL AFFECTED BY A SPILL OR RELEASE OF A REGULATED SUBSTANCE BUT QUALIFYING AS CLEAN FILL DUE TO ANALYTICAL TESTING.
- 13) ALL PUMPING OF WATER FROM ANY WORK AREA SHALL BE DONE ACCORDING TO THE PROCEDURE DESCRIBED IN THIS PLAN, OVER UNDISTURBED VEGETATED AREAS.
- 14) VEHICLES AND EQUIPMENT MAY NEITHER ENTER DIRECTLY NOR EXIT DIRECTLY FROM LOTS ONTO LOCAL ROADS.
- 15) UNTIL THE SITE IS STABILIZED, ALL EROSION AND SEDIMENT BMPS SHALL BE MAINTAINED PROPERLY. MAINTENANCE SHALL INCLUDE INSPECTIONS OF ALL EROSION AND SEDIMENT BMPS AFTER EACH RUNOFF EVENT AND ON A WEEKLY BASIS. ALL PREVENTATIVE AND REMEDIAL MAINTENANCE WORK, INCLUDING CLEAN OUT, REPAIR, REPLACEMENT, REGRADING, RESEEDING, REMULCHING AND RENETTING MUST BE PERFORMED IMMEDIATELY. IF THE E&S BMPS FAIL TO PERFORM AS EXPECTED, REPLACEMENT BMPS, OR MODIFICATIONS OF THOSE INSTALLED WILL BE REQUIRED.
- 16) A LOG SHOWING DATES THAT E&S BMPS WERE INSPECTED AS WELL AS ANY DEFICIENCIES FOUND AND THE DATE THEY WERE CORRECTED SHALL BE MAINTAINED ON THE SITE AND BE MADE AVAILABLE TO REGULATORY AGENCY OFFICIALS AT THE TIME OF INSPECTION.
- 17) SEDIMENT TRACKED ONTO ANY PUBLIC ROADWAY OR SIDEWALK SHALL BE RETURNED TO THE CONSTRUCTION SITE BY THE END OF EACH WORKDAY AND DISPOSED IN THE MANNER DESCRIBED IN THIS PLAN. IN NO CASE SHALL THE SEDIMENT BE WASHED, SHOVELED, OR SWEPT INTO ANY ROADSIDE DITCH, STORM SEWER, OR SURFACE WATER.
- 18) ALL SEDIMENT REMOVED FROM BMPS SHALL BE DISPOSED OF IN THE MANNER DESCRIBED ON THE PLAN DRAWINGS AND NOTES.

- 19) AREAS WHICH ARE TO RECEIVE TOPSOIL SHALL BE SCARIFIED TO A MINIMUM DEPTH OF THREE (3) TO FIVE (5) INCHES (6 TO 12 INCHES ON COMPACTED SOILS) PRIOR TO PLACEMENT OF TOPSOIL. AREAS TO BE VEGETATED SHALL HAVE A MINIMUM 4 INCHES OF TOPSOIL IN PLACE PRIOR TO SEEDING AND MULCHING. FILL OUTSLOPES SHALL HAVE A MINIMUM OF TWO (2) INCHES OF TOPSOIL.
- 20) ALL FILLS SHALL BE COMPACTED AS REQUIRED TO REDUCE EROSION, SLIPPAGE, SETTLEMENT, SUBSIDENCE OR OTHER RELATED PROBLEMS. FILL INTENDED TO SUPPORT BUILDINGS, STRUCTURES AND CONDUITS, ETC. SHALL BE COMPACTED IN ACCORDANCE WITH LOCAL REQUIREMENTS OR CODES.
- 21) ALL EARTHEN FILLS SHALL BE PLACED IN COMPACTED LAYERS NOT TO EXCEED NINE (9) INCHES IN THICKNESS.
- 22) FILL MATERIALS SHALL BE FREE OF FROZEN PARTICLES, BRUSH, ROOTS, SOD, OR OTHER FOREIGN OR OBJECTIONABLE MATERIALS THAT WOULD INTERFERE WITH OR PREVENT CONSTRUCTION OF SATISFACTORY FILLS.
- 23) FROZEN MATERIALS OR SOFT, MUCKY, OR HIGHLY COMPRESSIBLE MATERIALS SHALL NOT BE INCORPORATED INTO FILLS.
- 24) FILL SHALL NOT BE PLACED ON SATURATED OR FROZEN SURFACES.
- 25) SEEPS OR SPRINGS ENCOUNTERED DURING CONSTRUCTION SHALL BE HANDLED IN ACCORDANCE WITH THE STANDARD AND SPECIFICATION FOR SUBSURFACE DRAIN OR OTHER APPROVED METHOD.
- 26) ALL GRADED AREAS SHALL BE PERMANENTLY STABILIZED IMMEDIATELY UPON REACHING FINISHED GRADE. CUT SLOPES IN COMPETENT BEDROCK AND ROCK FILLS NEED NOT BE VEGETATED. SEEDED AREAS WITHIN 50 FEET OF A SURFACE WATER, OR AS OTHERWISE SHOWN ON THE PLAN DRAWINGS, SHALL BE BLANKETED ACCORDING TO THE STANDARDS OF THIS PLAN.
- 27) IMMEDIATELY AFTER EARTH DISTURBANCE ACTIVITIES CEASE IN ANY AREA OR SUBAREA OF THE PROJECT, THE OPERATOR SHALL STABILIZE ALL DISTURBED AREAS. DURING NON-GERMINATING MONTHS, MULCH OR PROTECTIVE BLANKETING SHALL BE APPLIED AS DESCRIBED IN THE PLAN. AREAS NOT AT FINISHED GRADE, WHICH WILL BE REACTIVATED WITHIN ONE (1) YEAR, MAY BE STABILIZED IN ACCORDANCE WITH THE TEMPORARY STABILIZATION SPECIFICATIONS. THOSE AREAS WHICH WILL NOT BE REACTIVATED WITHIN ONE (1) YEAR SHALL BE STABILIZED IN ACCORDANCE WITH THE PERMANENT STABILIZATION SPECIFICATIONS.
- 28) PERMANENT STABILIZATION IS DEFINED AS A MINIMUM UNIFORM, PERENNIAL 70% VEGETATIVE COVER OR OTHER PERMANENT NON-VEGETATIVE COVER WITH A DENSITY SUFFICIENT TO RESIST ACCELERATED EROSION. CUT AND FILL SLOPES SHALL BE CAPABLE OF RESISTING FAILURE DUE TO SLUMPING, SLIDING, OR OTHER MOVEMENTS.
- 29) E&S BMPS SHALL REMAIN FUNCTIONAL AS SUCH UNTIL ALL AREAS TRIBUTARY TO THEM ARE PERMANENTLY STABILIZED OR UNTIL THEY ARE REPLACED BY ANOTHER BMP APPROVED BY THE LOCAL CONSERVATION DISTRICT OR THE DEPARTMENT.
- 30) UPON COMPLETION OF ALL EARTH DISTURBANCE ACTIVITIES AND PERMANENT STABILIZATION OF ALL DISTURBED AREAS, THE OWNER AND / OR OPERATOR SHALL CONTACT THE LOCAL CONSERVATION DISTRICT FOR AN INSPECTION PRIOR TO REMOVAL / CONVERSION OF THE E&S BMPS.
- 31) AFTER FINAL SITE STABILIZATION HAS BEEN ACHIEVED, TEMPORARY EROSION AND SEDIMENT BMPS MUST BE REMOVED OR CONVERTED TO PERMANENT POST CONSTRUCTION STORMWATER MANAGEMENT BMPS. AREAS DISTURBED DURING REMOVAL OR CONVERSION OF THE BMPS SHALL BE STABILIZED IMMEDIATELY. IN ORDER TO ENSURE RAPID REVEGETATION OF DISTURBED AREAS, SUCH REMOVAL / CONVERSIONS ARE TO BE DONE ONLY DURING THE GERMINATING SEASON.
- 32) FAILURE TO CORRECTLY INSTALL E&S BMPS, FAILURE TO PREVENT SEDIMENT-LADEN RUNOFF FROM LEAVING THE CONSTRUCTION SITE, OR FAILURE TO TAKE IMMEDIATE CORRECTIVE ACTION TO RESOLVE FAILURE OF E&S BMPS MAY RESULT IN ADMINISTRATIVE, CIVIL, AND / OR CRIMINAL PENALTIES BEING INSTITUTED BY THE DEPARTMENT AS DEFINED IN SECTION 602 OF THE PENNSYLVANIA CLEAN STREAMS LAW. THE CLEAN STREAMS LAW PROVIDES FOR UP TO \$10,000 PER DAY IN CIVIL PENALTIES, UP TO \$10,000 IN SUMMARY CRIMINAL PENALTIES, AND UP TO \$25,000 IN MISDEMEANOR CRIMINAL PENALTIES FOR EACH VIOLATION.

SEQUENCE OF BMP INSTALLATION

- 1. PRIOR TO EARTH DISTURBANCE AND CONSTRUCTION, THE LIMITS OF EARTH DISTURBANCE SHALL BE CLEARLY STAKED-OUT IN ORDER TO DELINEATE THE NPDES PERMIT AREA.
- 2. INSTALL CATCH BASIN INLET PROTECTION IN EXISTING SITE CATCH BASINS / DROP INLETS WHEREEVER THERE IS THE POSSIBILITY FOR SEDIMENT-LADEN RUNOFF RESULTING FROM CONSTRUCTION ACTIVITIES TO ENTER THE CATCH BASIN.
- 3. ONCE FINAL GRADES HAVE BEEN ACHIEVED, DISTURBED AREAS THAT ARE NOT TO BE COVERED WITH CONCRETE OR ASPHALT WILL BE TOPSOILED, FERTILIZED, SEEDED AND MULCHED ACCORDING TO THE SEEDING AND MULCHING SPECIFICATIONS SHOWN ON THE E&S NOTES. TOPSOIL APPLICATION LAYER SHALL BE A MINIMUM OF TWO (2) INCHES THICK.
- 4. COINCIDENT WITH CONSTRUCTION AND PRIOR TO THE FIRST DELIVERY OF CONCRETE TO THE SITE, THE MANUFACTURED VINYL CONCRETE WASHOUT WILL BE INSTALLED AT THE LOCATION SHOWN ON THE E&S PLAN DRAWINGS, OR AS DIRECTED BY THE CONSTRUCTION MANAGER.
- 5. IF RAINFALL EVENTS CAUSE EXCAVATION SITES TO BECOME FILLED WITH DIRTY / SEDIMENT-LADEN WATER, THE SEDIMENT LADEN WATER WILL BE PUMPED FROM THE EXCAVATION INTO A PUMPED WATER FILTER BAG.
- 6. INSTALL UNDERGROUND UTILITIES. THE LENGTH OF A TRENCH OPENING AT ANY GIVEN TIME SHALL BE HELD TO A MINIMUM. IN NO EVENT WILL THE LENGTH OF OPEN TRENCH EXCEED 100 FEET. TRENCH EXCAVATIONS SHALL ONLY BE MADE FOR THE AMOUNT OF PIPE THAT CAN BE INSTALLED DURING THAT DAY'S ACTIVITY AND SHALL IMMEDIATELY BE BACKFILLED, COMPACTED AND STABILIZED. SURFACE AREAS OF COMPLETED TRENCHES OUTSIDE OF PAVED AREAS WILL BE TOPSOILED, FERTILIZED, SEEDED AND

- MULCHED ACCORDING TO THE SEEDING AND MULCHING SPECIFICATIONS SHOWN ON THE E&S PLAN AND NARRATIVE. TOPSOIL APPLICATION LAYER SHALL BE A MINIMUM OF TWO (2) INCHES THICK.
- 7. ALL TEMPORARY EROSION CONTROL STRUCTURES (IDENTIFIED IN THIS CONSTRUCTION SEQUENCE) WILL BE REMOVED WITHIN TWENTY (20) DAYS AFTER THE CONSTRUCTION AREA HAS BEEN STABILIZED. THE STANDARD FOR VEGETATIVE STABILIZATION IS DEFINED AS A "MINIMUM UNIFORM 70 PERCENT PERENNIAL VEGETATIVE COVER, WITH A DENSITY CAPABLE OF RESISTING ACCELERATED EROSION AND SEDIMENTATION." THIS INCLUDES REMOVAL OF THE COMPOST FILTER SOCK. BIODEGRADABLE SOCK MAY BE CUT OPEN AND FILLER MATERIAL SPREAD ONSITE AS VEGETATIVE GROWTH MEDIUM. NON-BIODEGRADABLE FABRIC, AS WELL AS STAKES AND HARDWARE MUST BE REMOVED TO A PADEP OR COUNTY APPROVED WASTE SITE.
- 8. SEED AND MULCH ALL REMAINING DISTURBED AREAS PER PERMANENT SEEDING SPECIFICATIONS.
- 9. THE CONSTRUCTION AREA WILL BE PERIODICALLY INSPECTED TO ENSURE THAT VEGETATION HAS BECOME WELL ESTABLISHED. CONTRACTOR TO INCLUDE A TWO-YEAR GUARANTEE ON ALL VEGETATION INSTALLED WITHIN A BMP FOOTPRINT. IF RILLS OR GULLIES (OR OTHER INDICATIONS OF EROSION) OCCUR, THE PROBLEM WILL BE REPAIRED IMMEDIATELY.

WEST MILL
CREEK
PLAYGROUND
AREAS E & G

5100 Parrish St. Philadelphia, PA 19139

OLIN

LANDSCAPE ARCHITECTURE / URBAN DESIGN / PLANNING
ONE PENN CENTER
1617 JOHN F. KENNEDY BOULEVARD, SUITE 1900
PHILADELPHIA, PA 19103
TEL 215.440.0030 / FAX 215.440.0041
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Structural:
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190 Brodhead Road, Suite 120,
Bethlehem, PA 18017
(484) 895-3131

MEP: Mark Ulrick 30 N. 41ST SUITE 500 Philadelphia, PA 19104 (856) 320-8100

No. Date Description

 07/31/2024
 DESIGN DEVELOPMENT 100%

 10/25/2024
 DESIGN DEVELOPMENT 100%

 3/19/2025
 PWD COMMENTS

Erosion and Sediment Control Notes (2 of 2)

C-405

Scale: AS NOTED
Date: T.B.D.
Drawn: T.S.W
Checked: J.R.S.
Project No.: 2409

PWD TRACKING NUMBER: FY25-WEST-8011-01

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No. Date Description

07/31/2024 SCHEMATIC DESIGN 100%
 10/25/2024 DESIGN DEVELOPMENT 100%

3 05/09/2025 CONSTRUCTION DOCUMENTS 100%



SITE PLAN AREA E


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SITE PLAN AREA G

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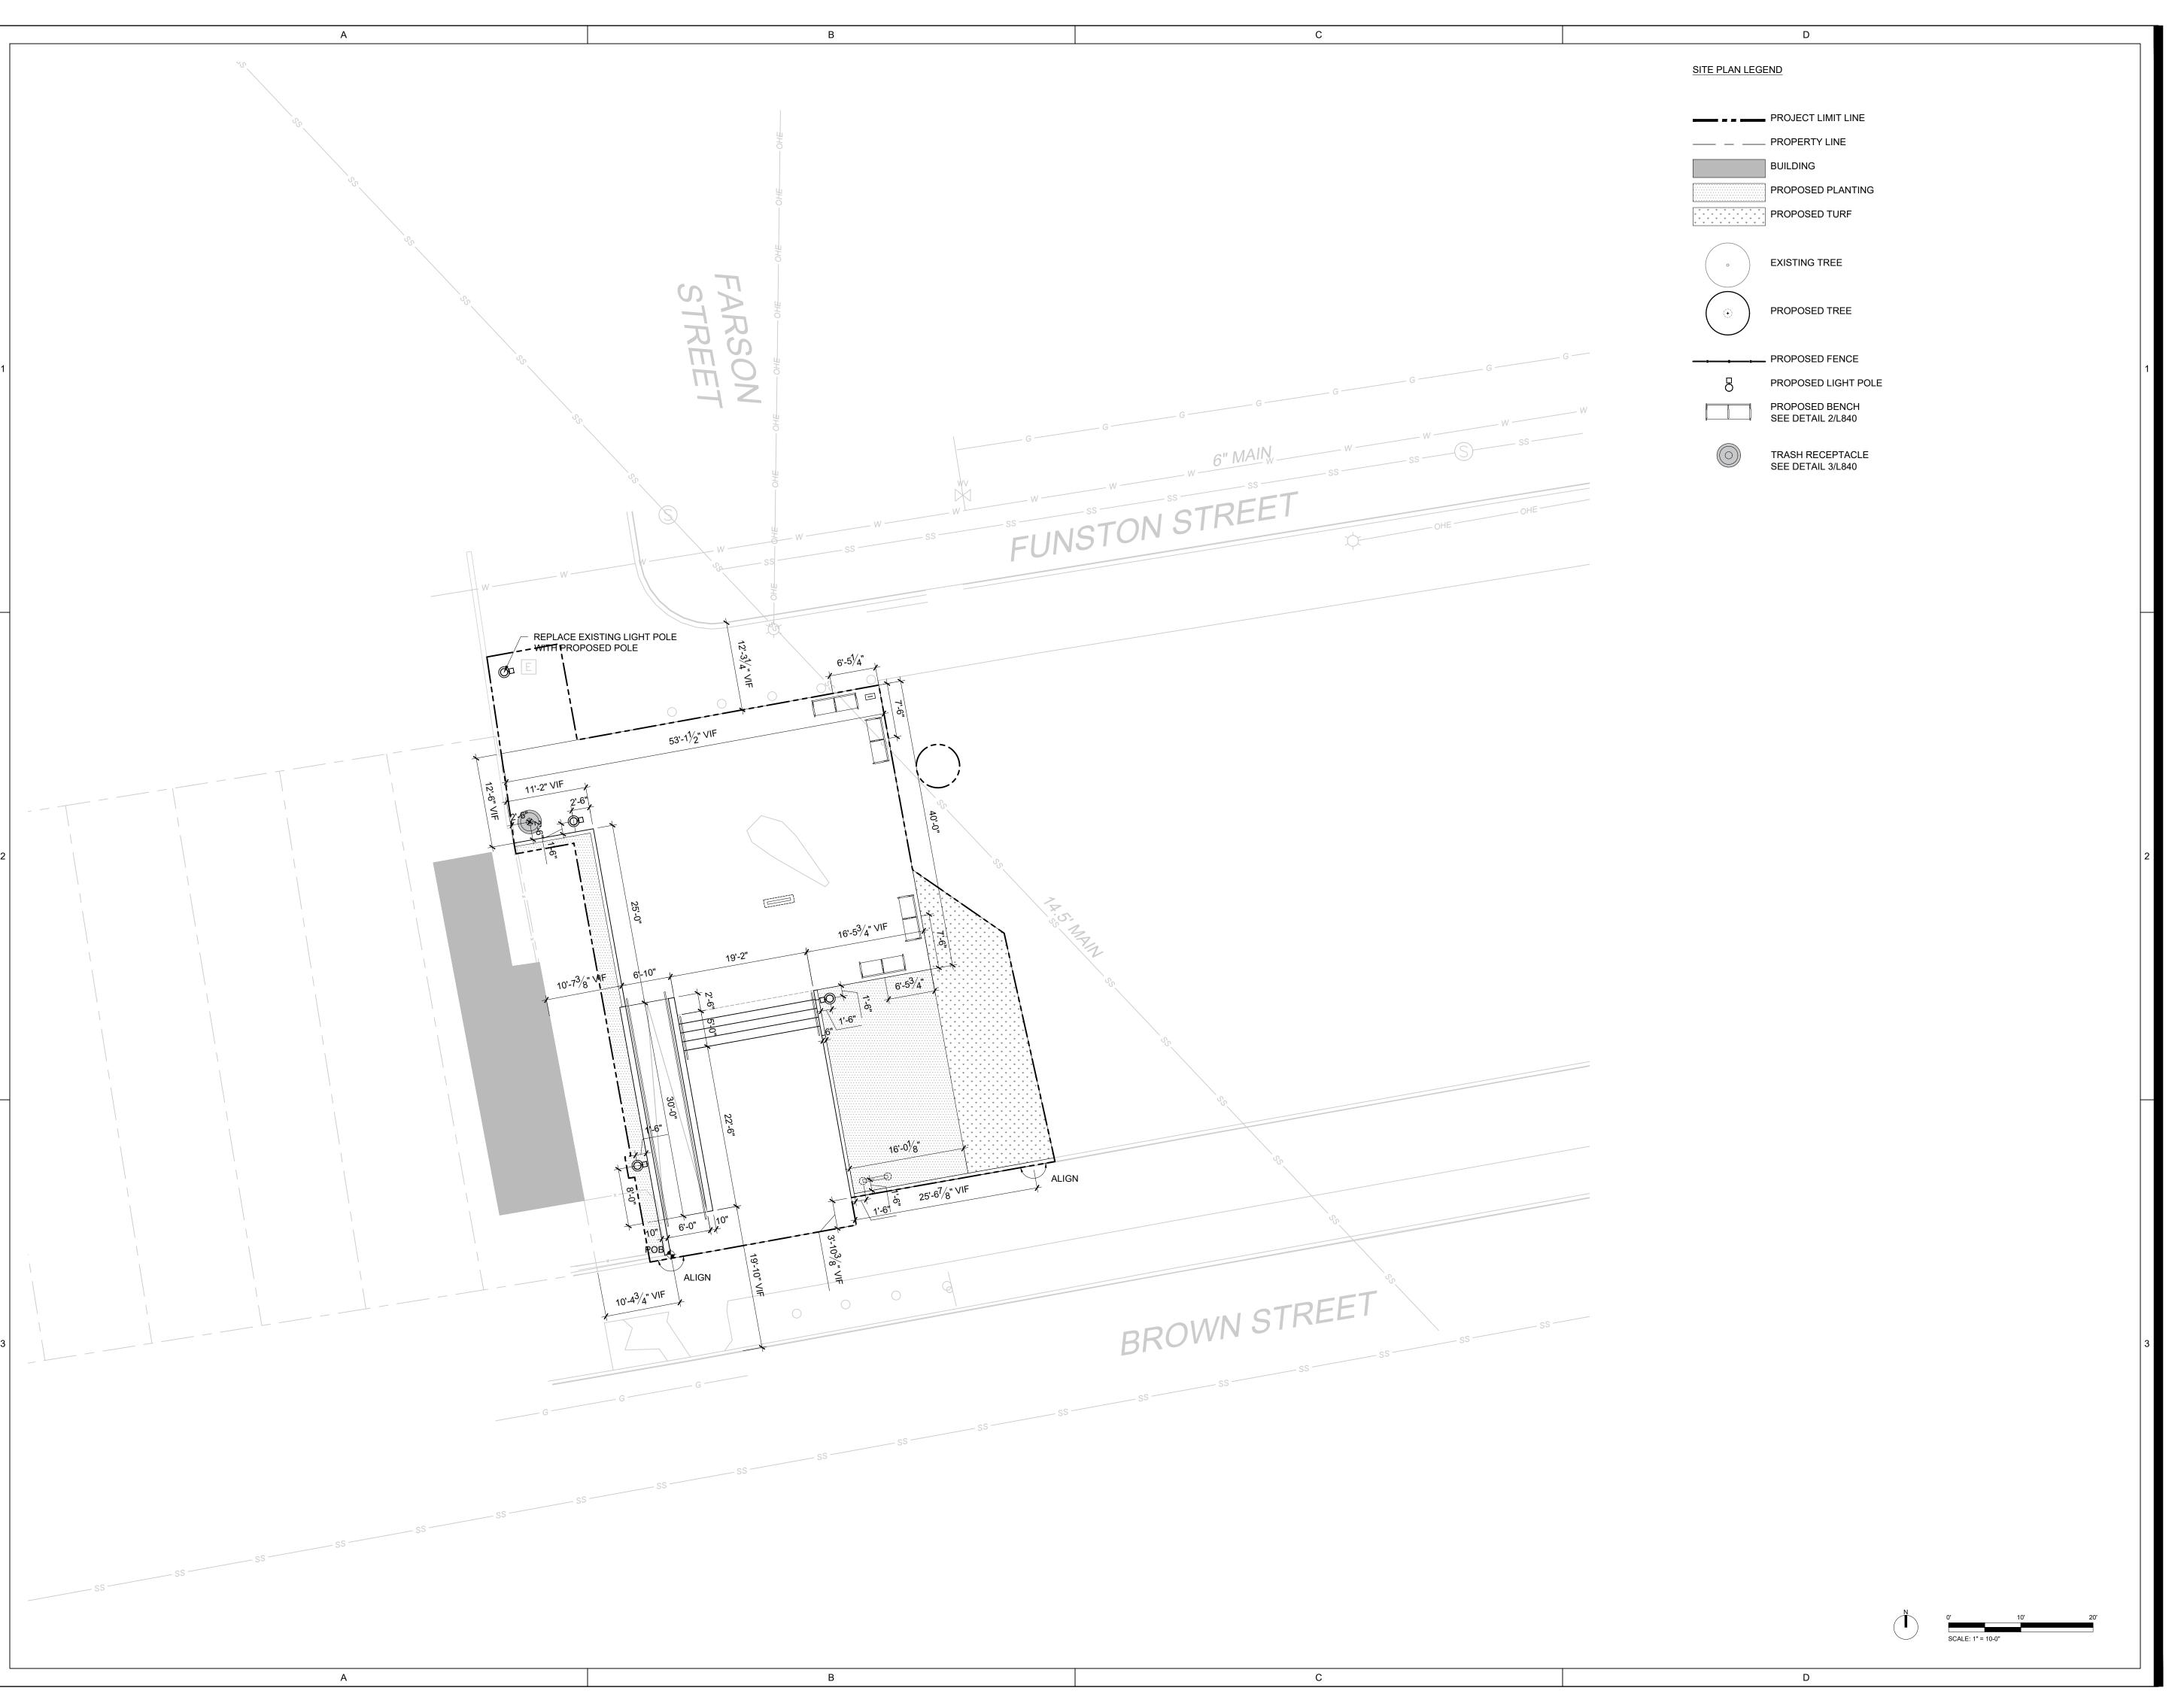
07/31/2024 SCHEMATIC DESIGN 100%
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05/09/2025 CONSTRUCTION DOCUMENTS 100%



LAYOUT PLAN AREA E

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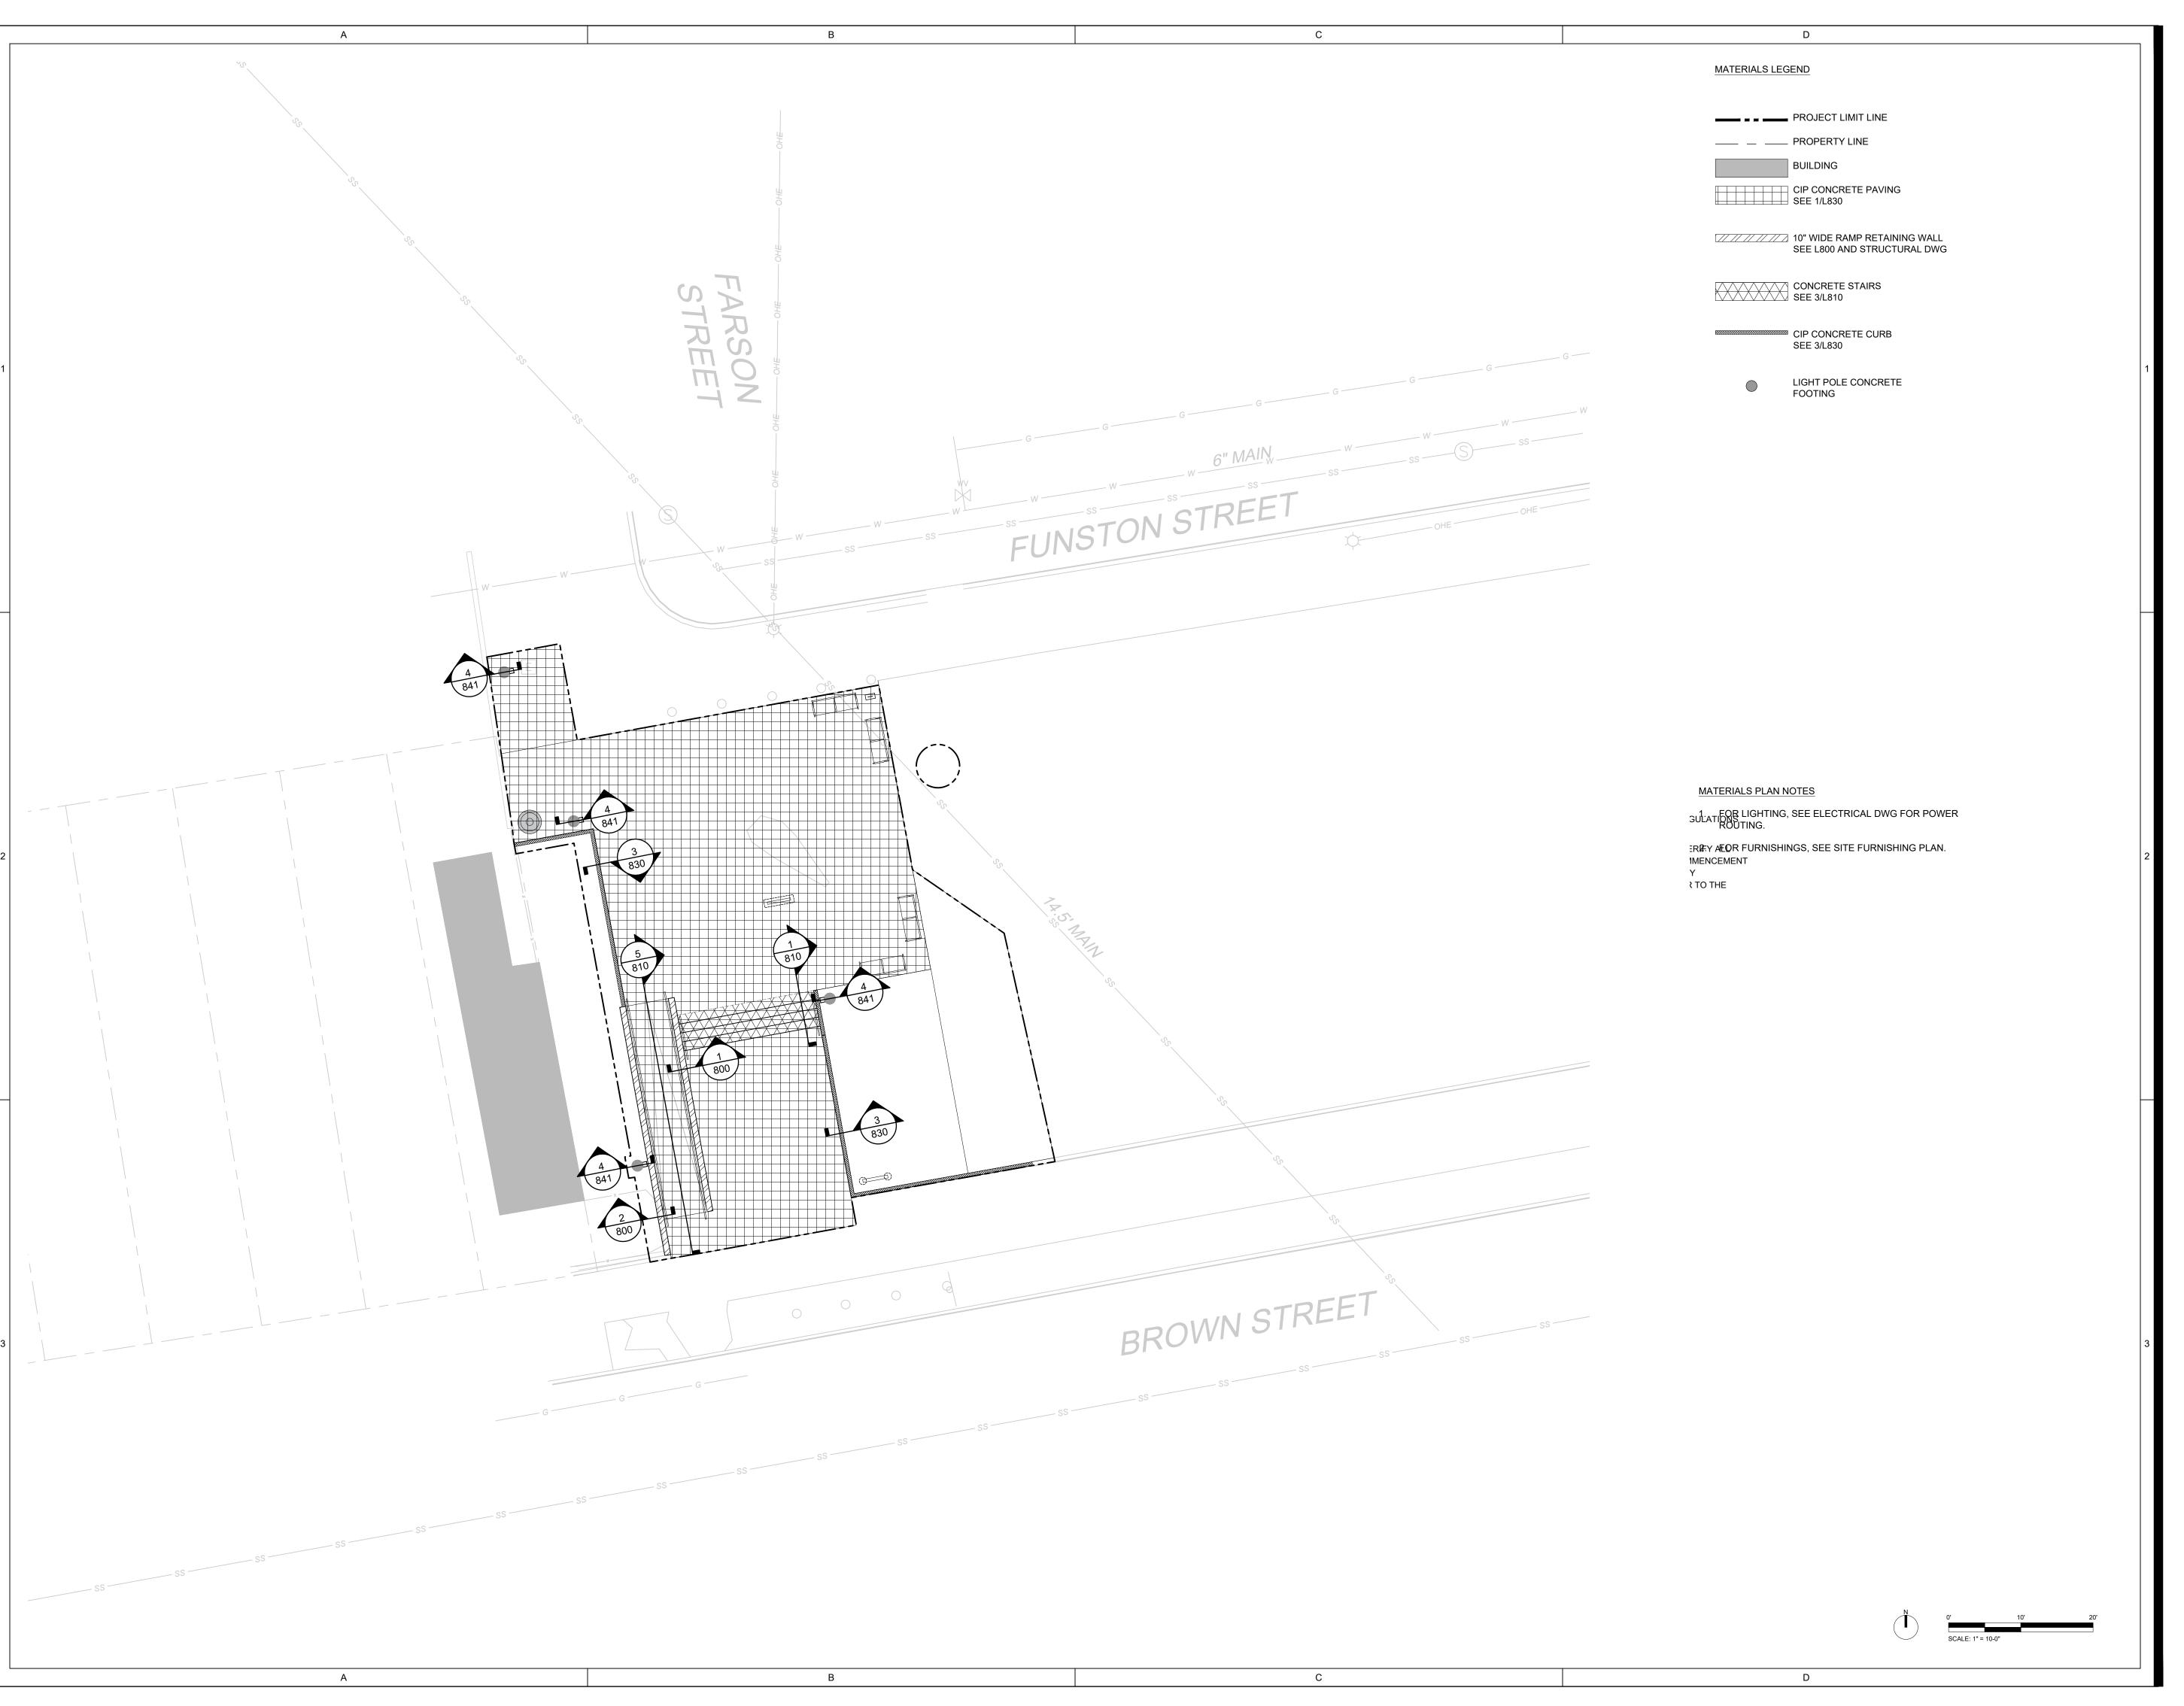
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 10/25/2024 DESIGN DEVELOPMENT 100%

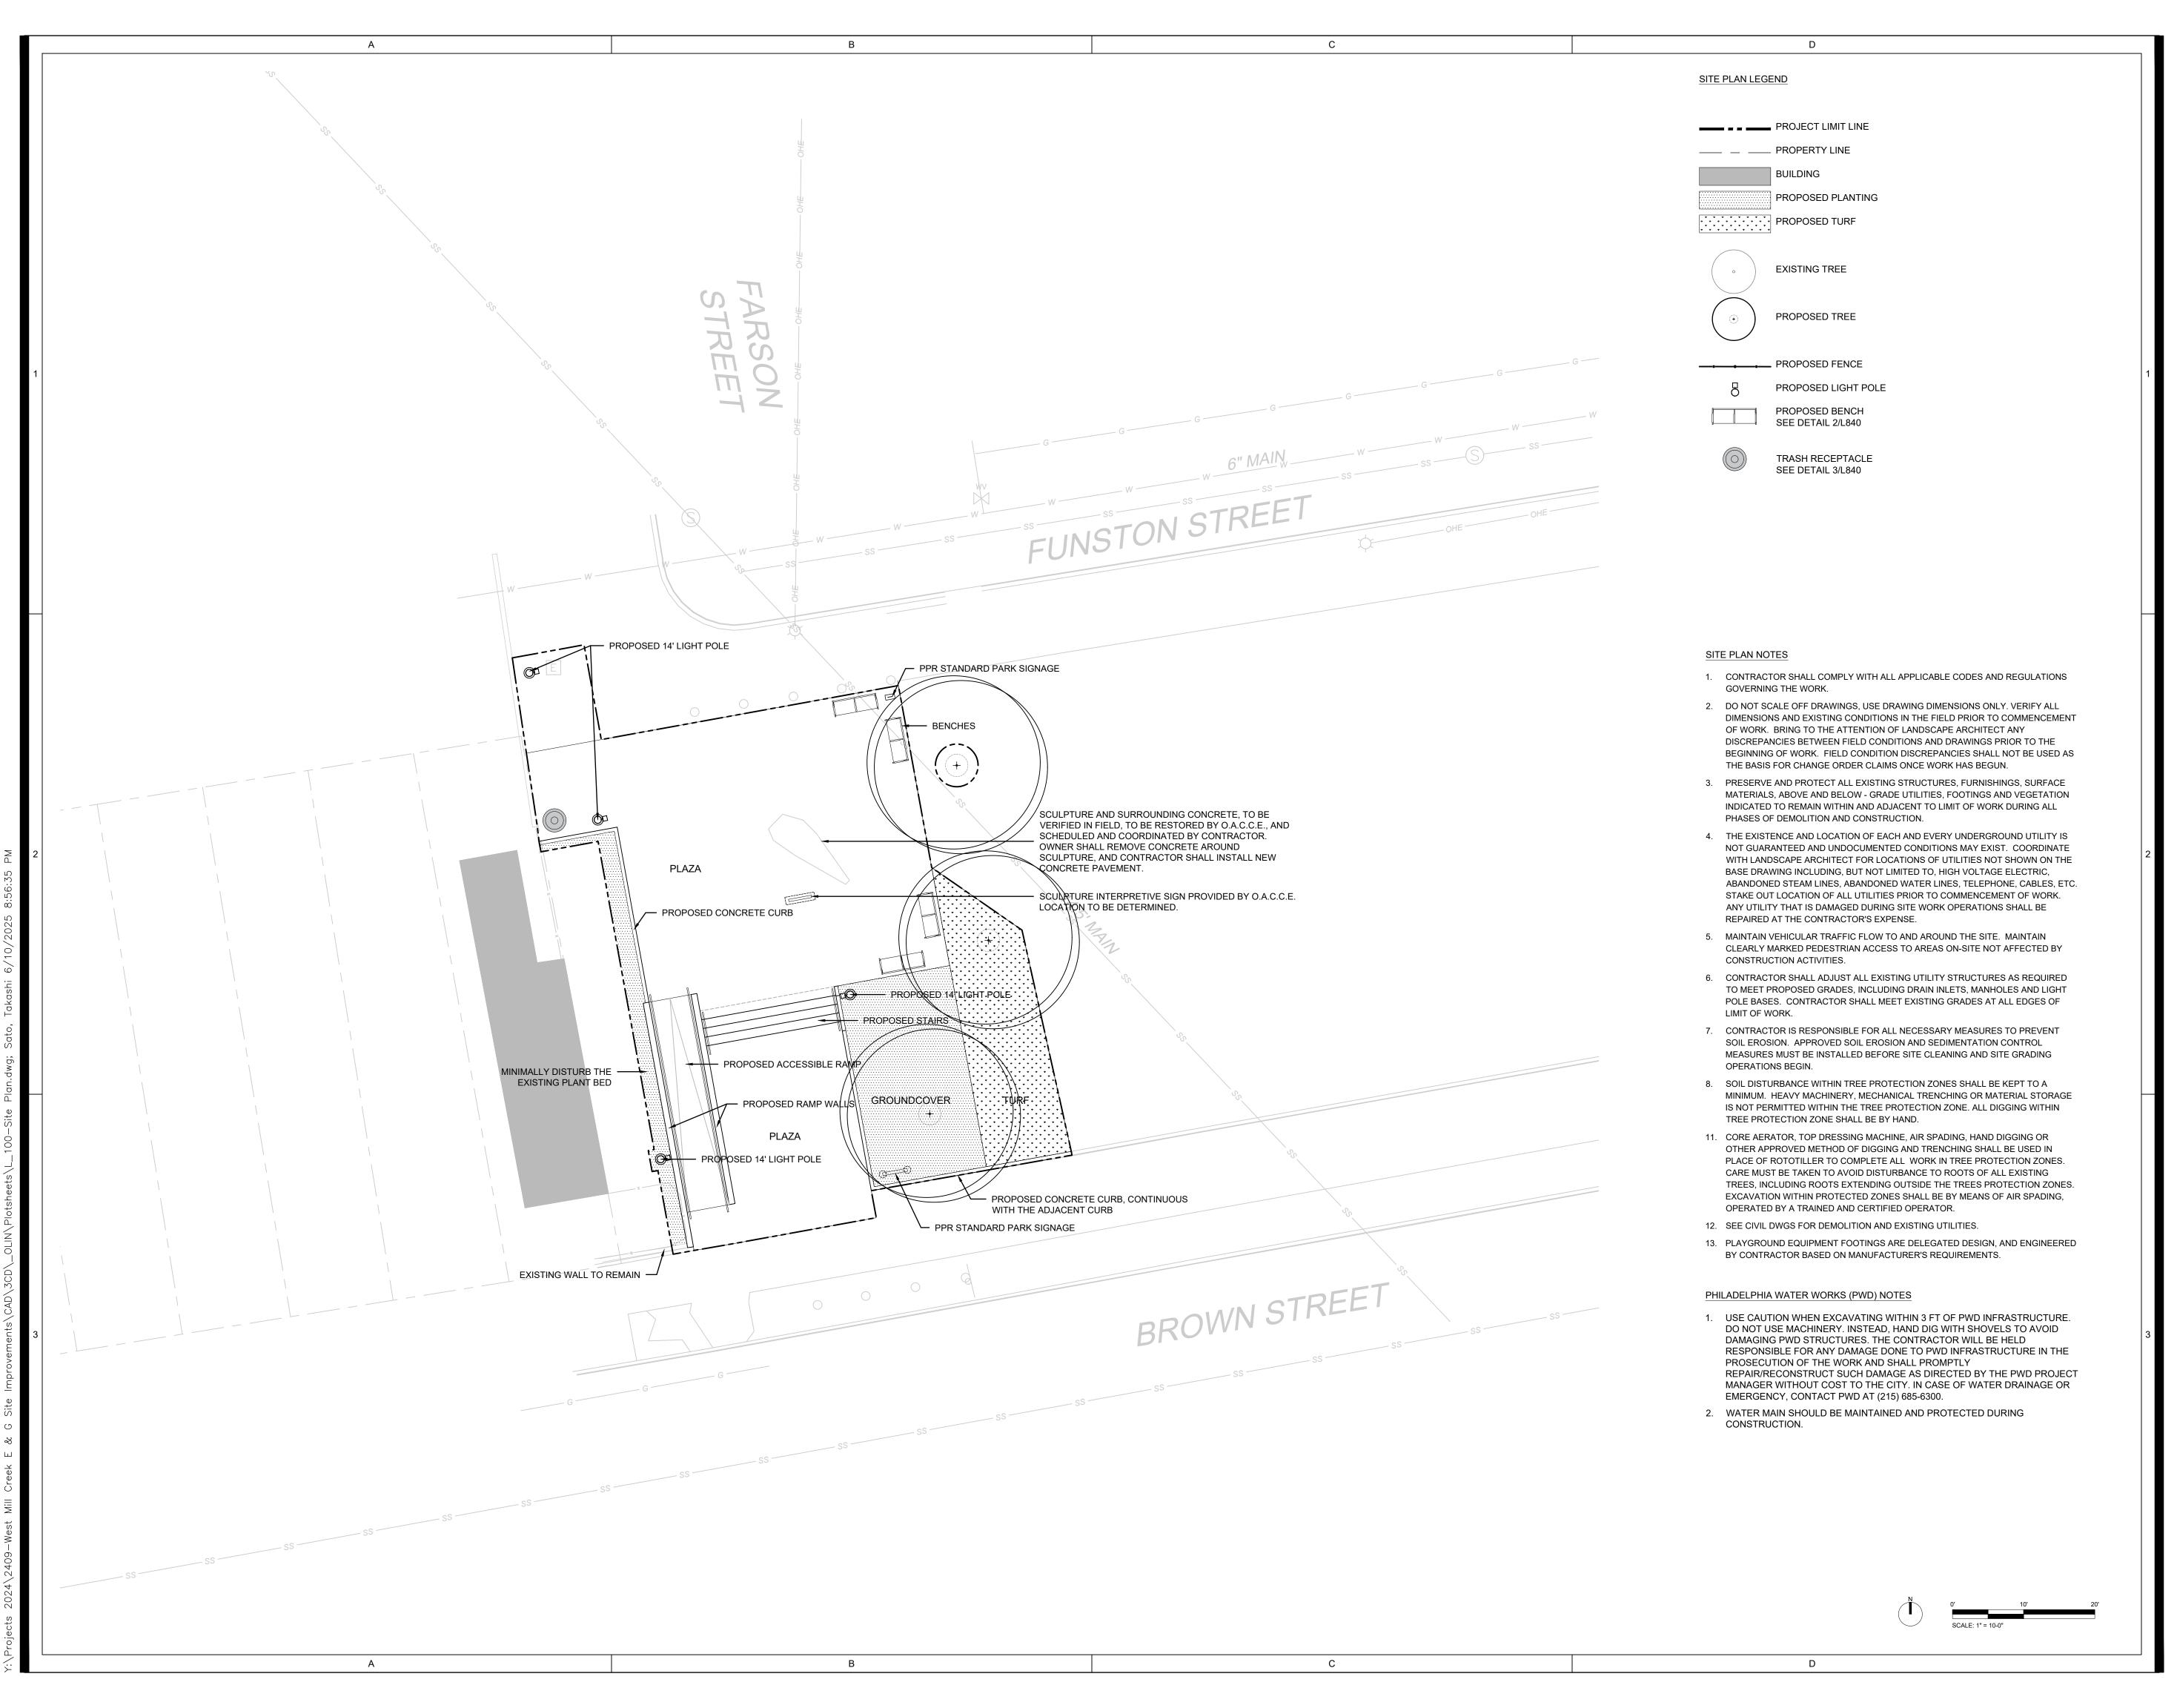05/09/2025 CONSTRUCTION DOCUMENTS 100%



MATERIALS PLAN AREA E

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MATERIALS PLAN AREA G

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PAVING LAYOUT PLAN AREA E


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 2409



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PAVING LAYOUT PLAN AREA G

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GRADING PLAN AREA E


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GRADING PLAN AREA G
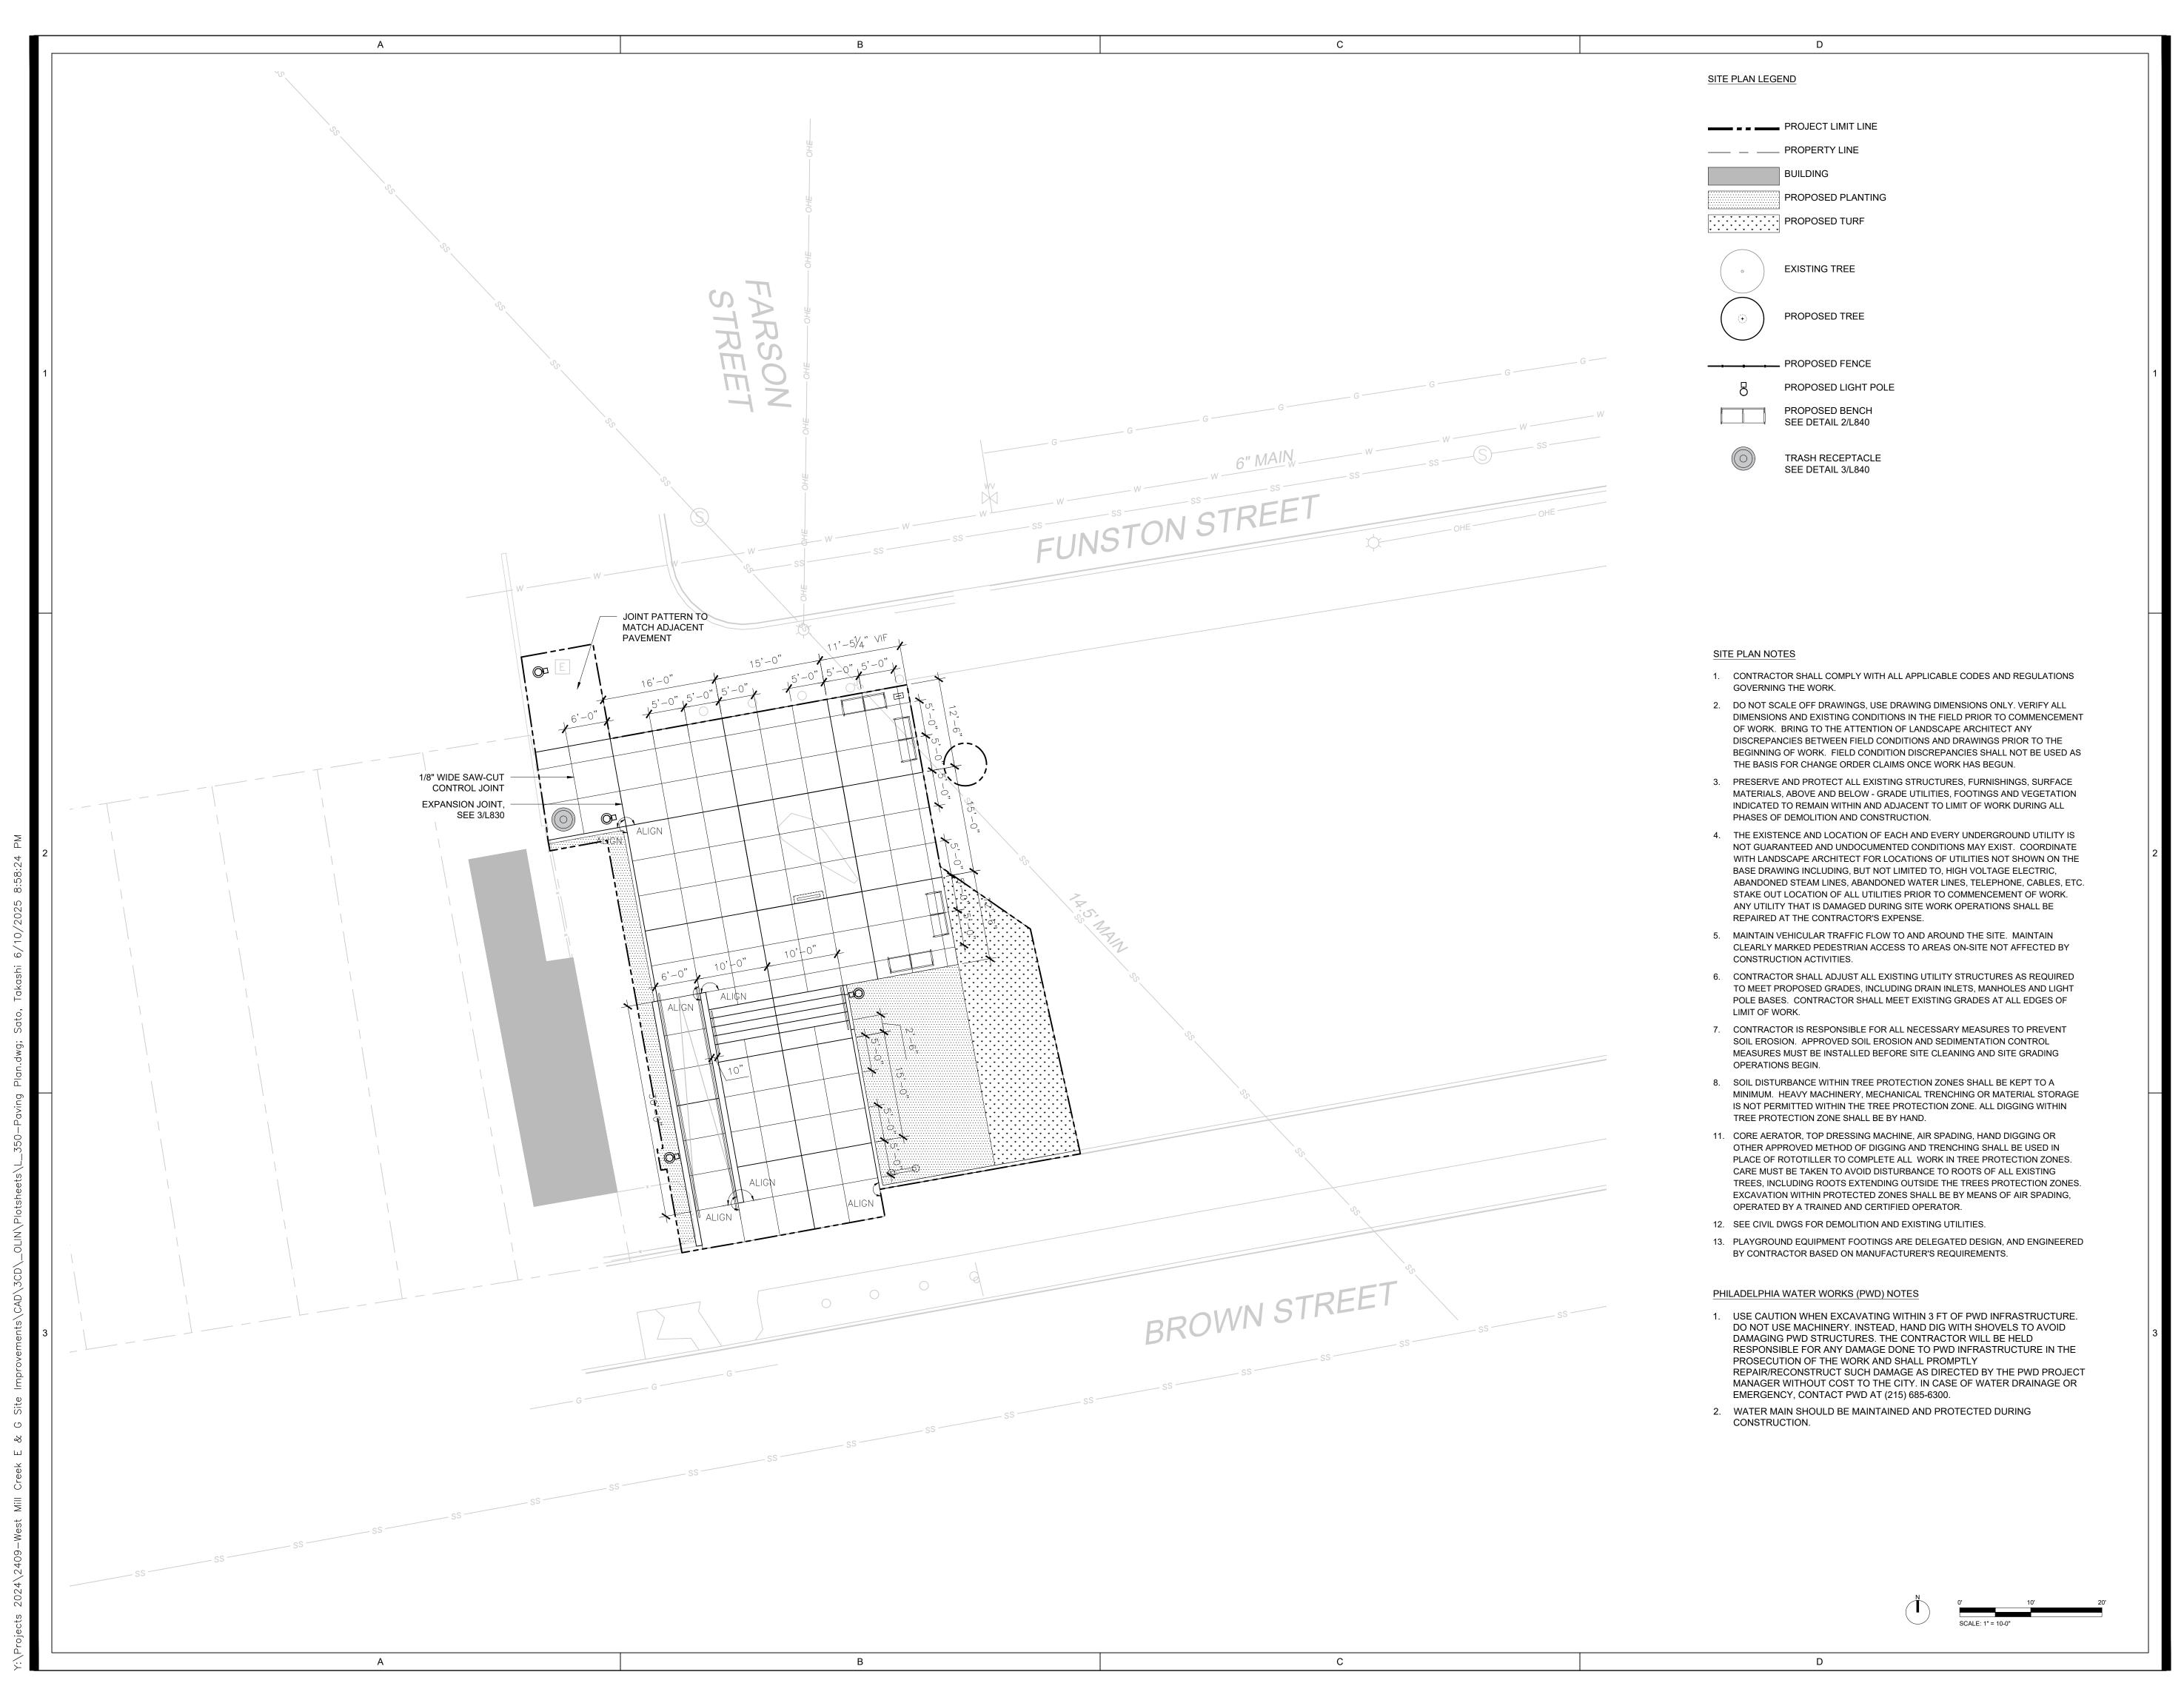
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 2409

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MEP: Mark Ulrick 30 N. 41ST SUITE 500 Philadelphia, PA 19104 (856) 320-8100

ate Description

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 10/25/2024 DESIGN DEVELOPMENT 100%

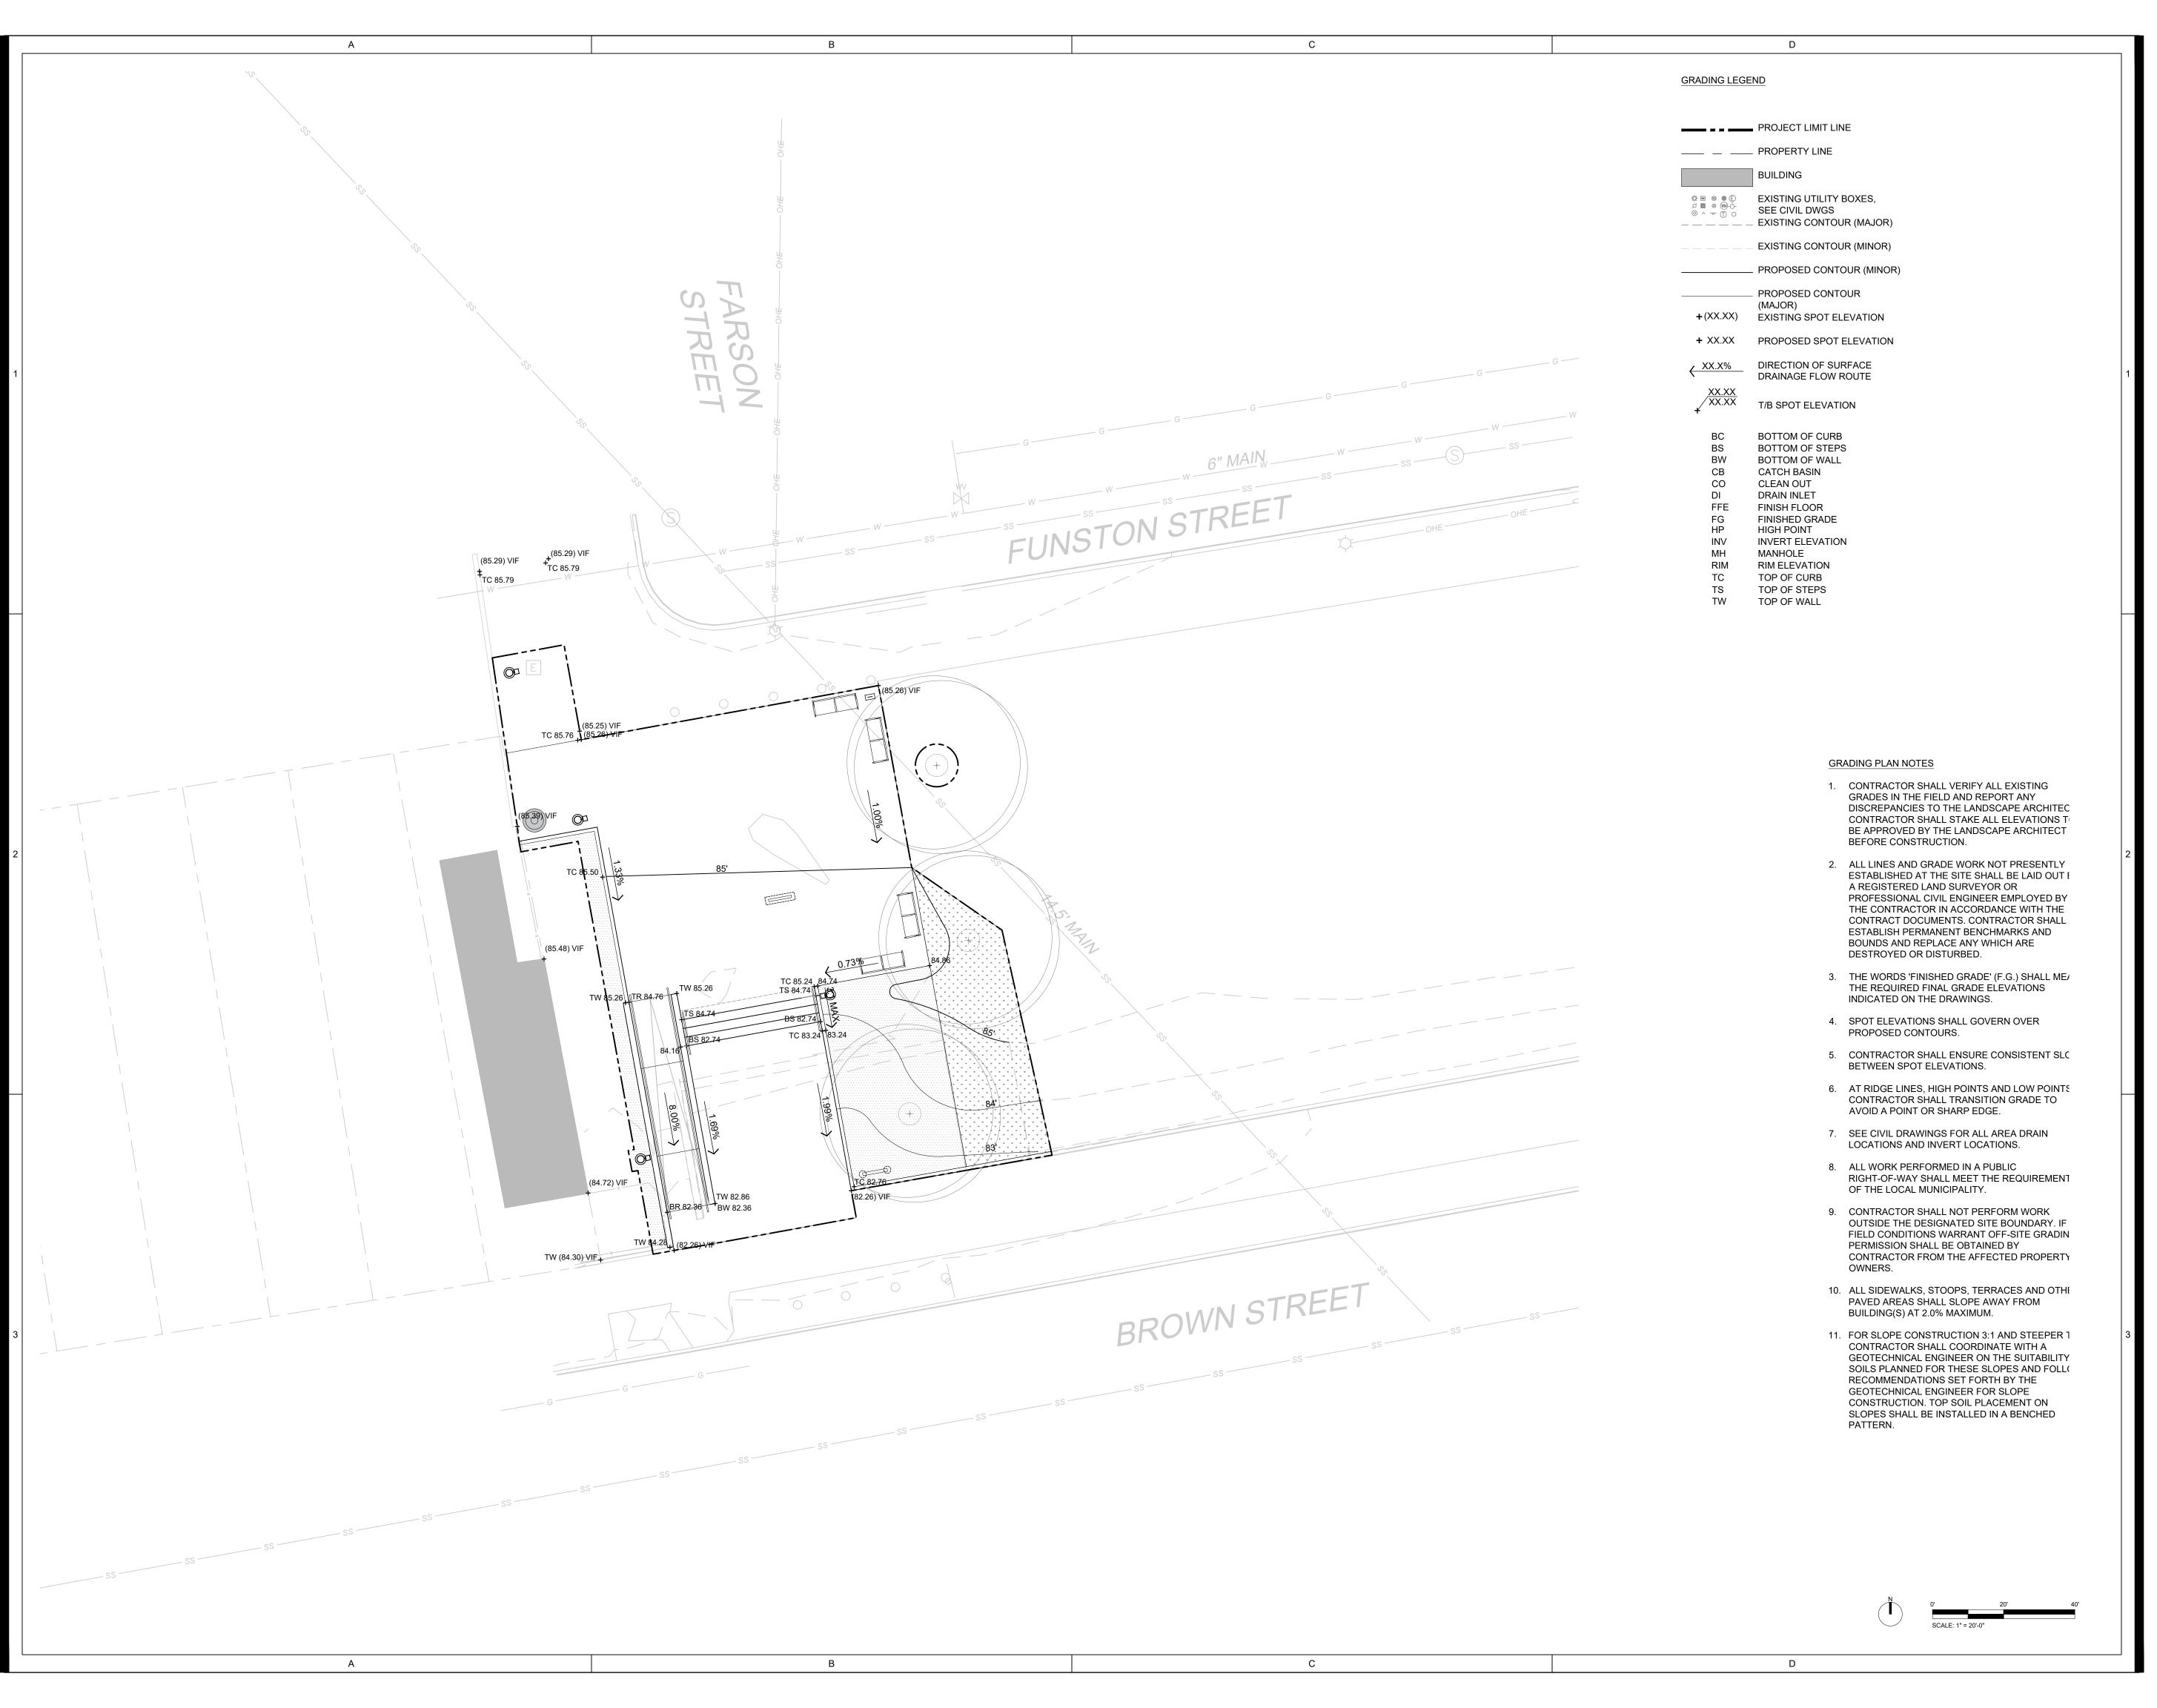3 05/09/2025 CONSTRUCTION DOCUMENTS 100%



SITE FURNISHINGS PLAN AREA E


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 Project No.:
 2409



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e Description

07/31/2024 SCHEMATIC DESIGN 100%
 10/25/2024 DESIGN DEVELOPMENT 100%


3 05/09/2025 CONSTRUCTION DOCUMENTS 100%

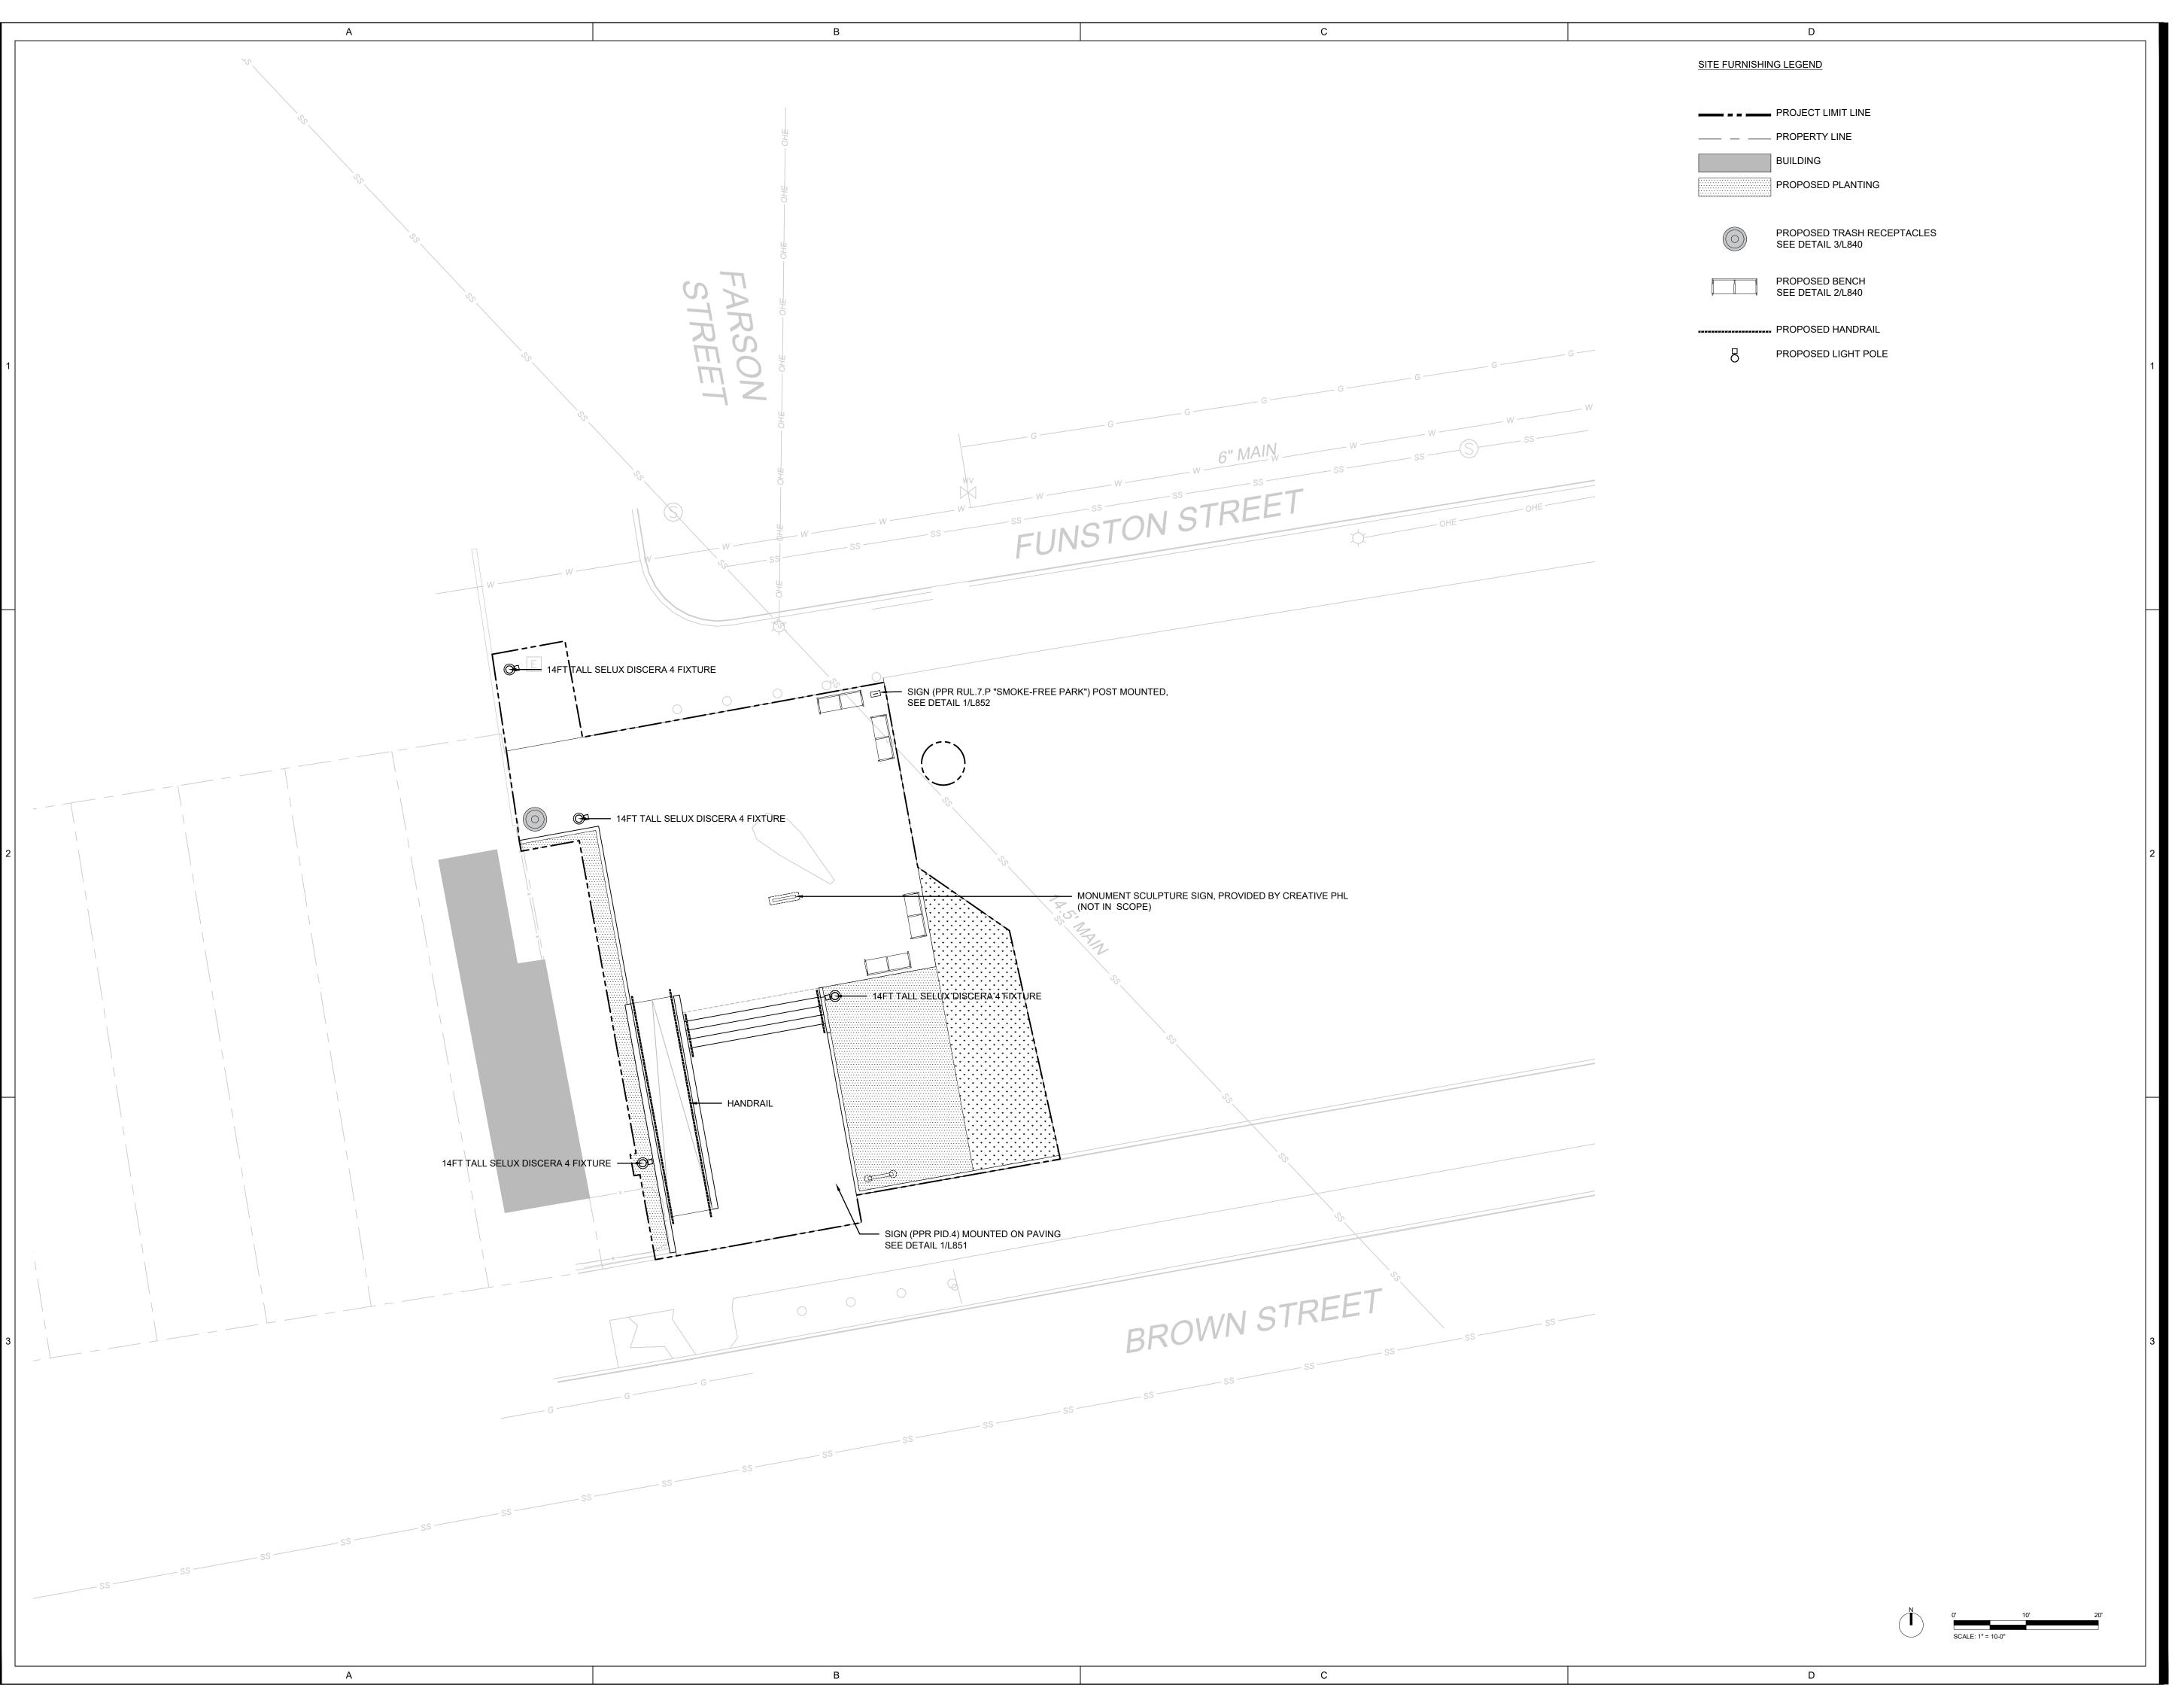

SITE FURNISHINGS PLAN AREA G

Scale: 1'
Date: 05/09/2
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(484) 895-3131

MEP: Mark Ulrick 30 N. 41ST SUITE 500 Philadelphia, PA 19104 (856) 320-8100

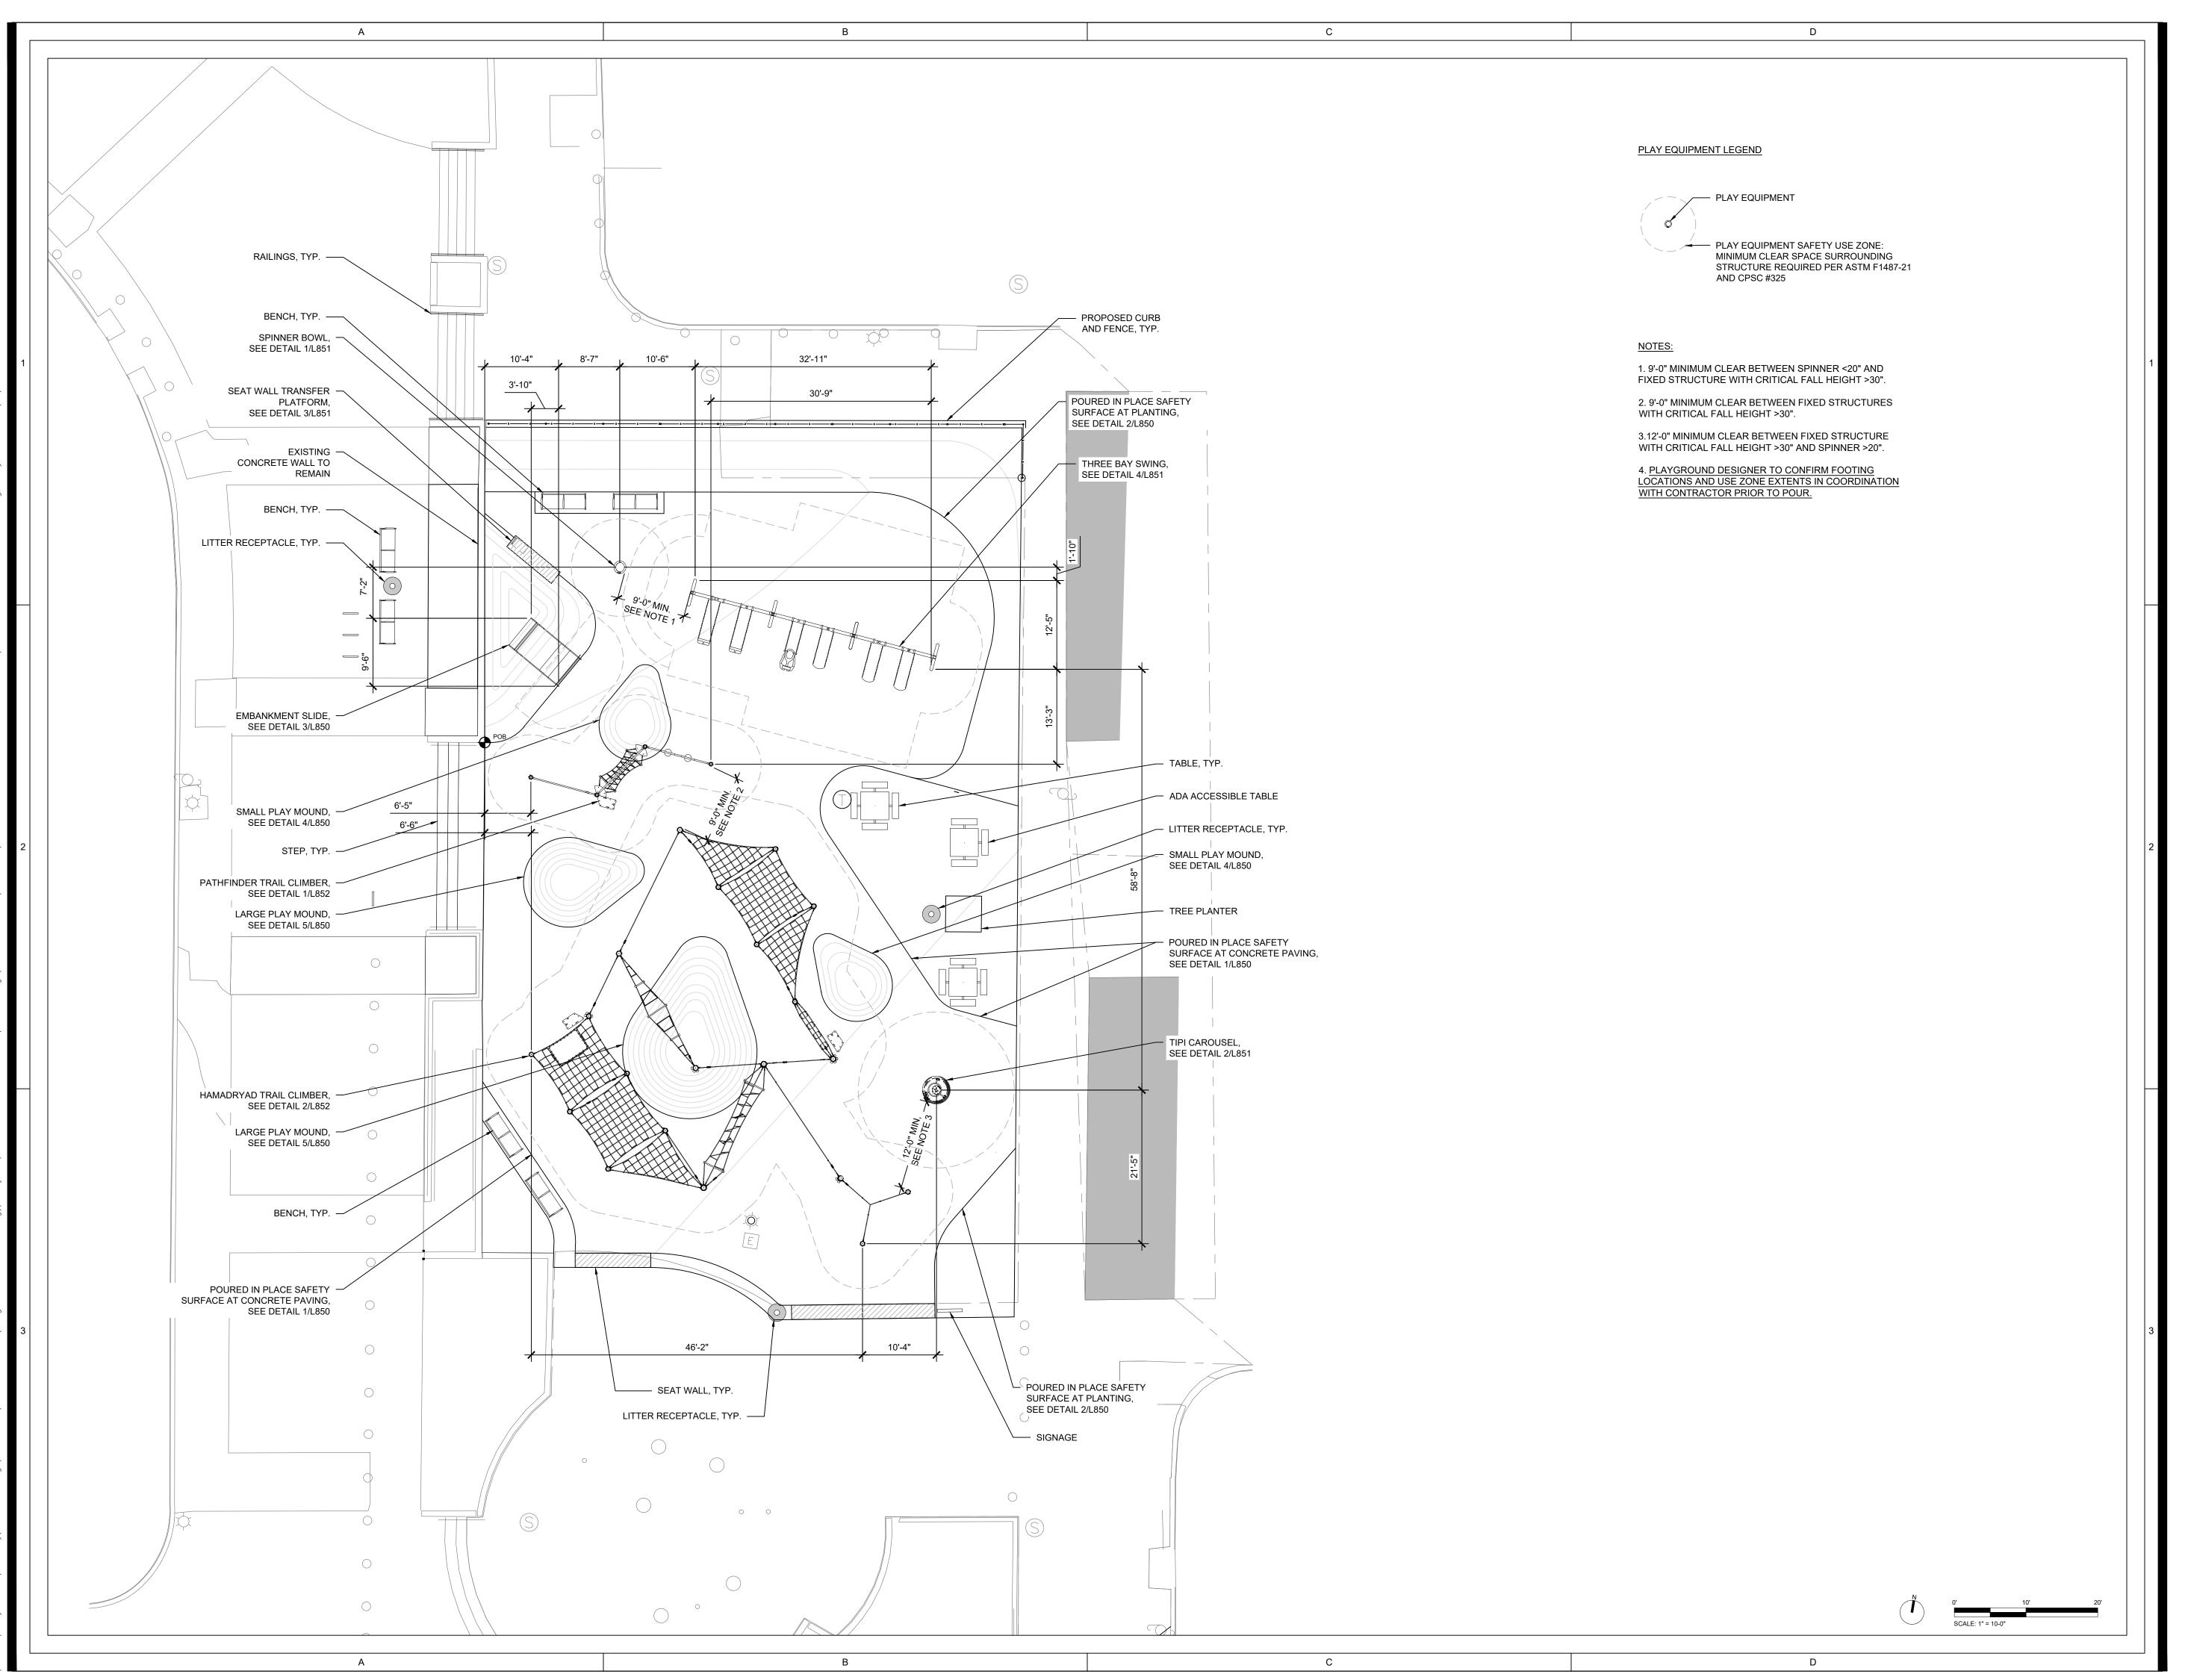No. Date Description

1 7/31/2024 100% Schematic Design 2 10/25/2024 100% Design Development

6/06/2025 100% Construction Documents



PLAY EQUIPMENT PLAN


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Date: 6/06/2025

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Project No.: 2409



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No. Date Description

1 7/31/2024 100% Schematic Design 2 10/25/2024 100% Design Development

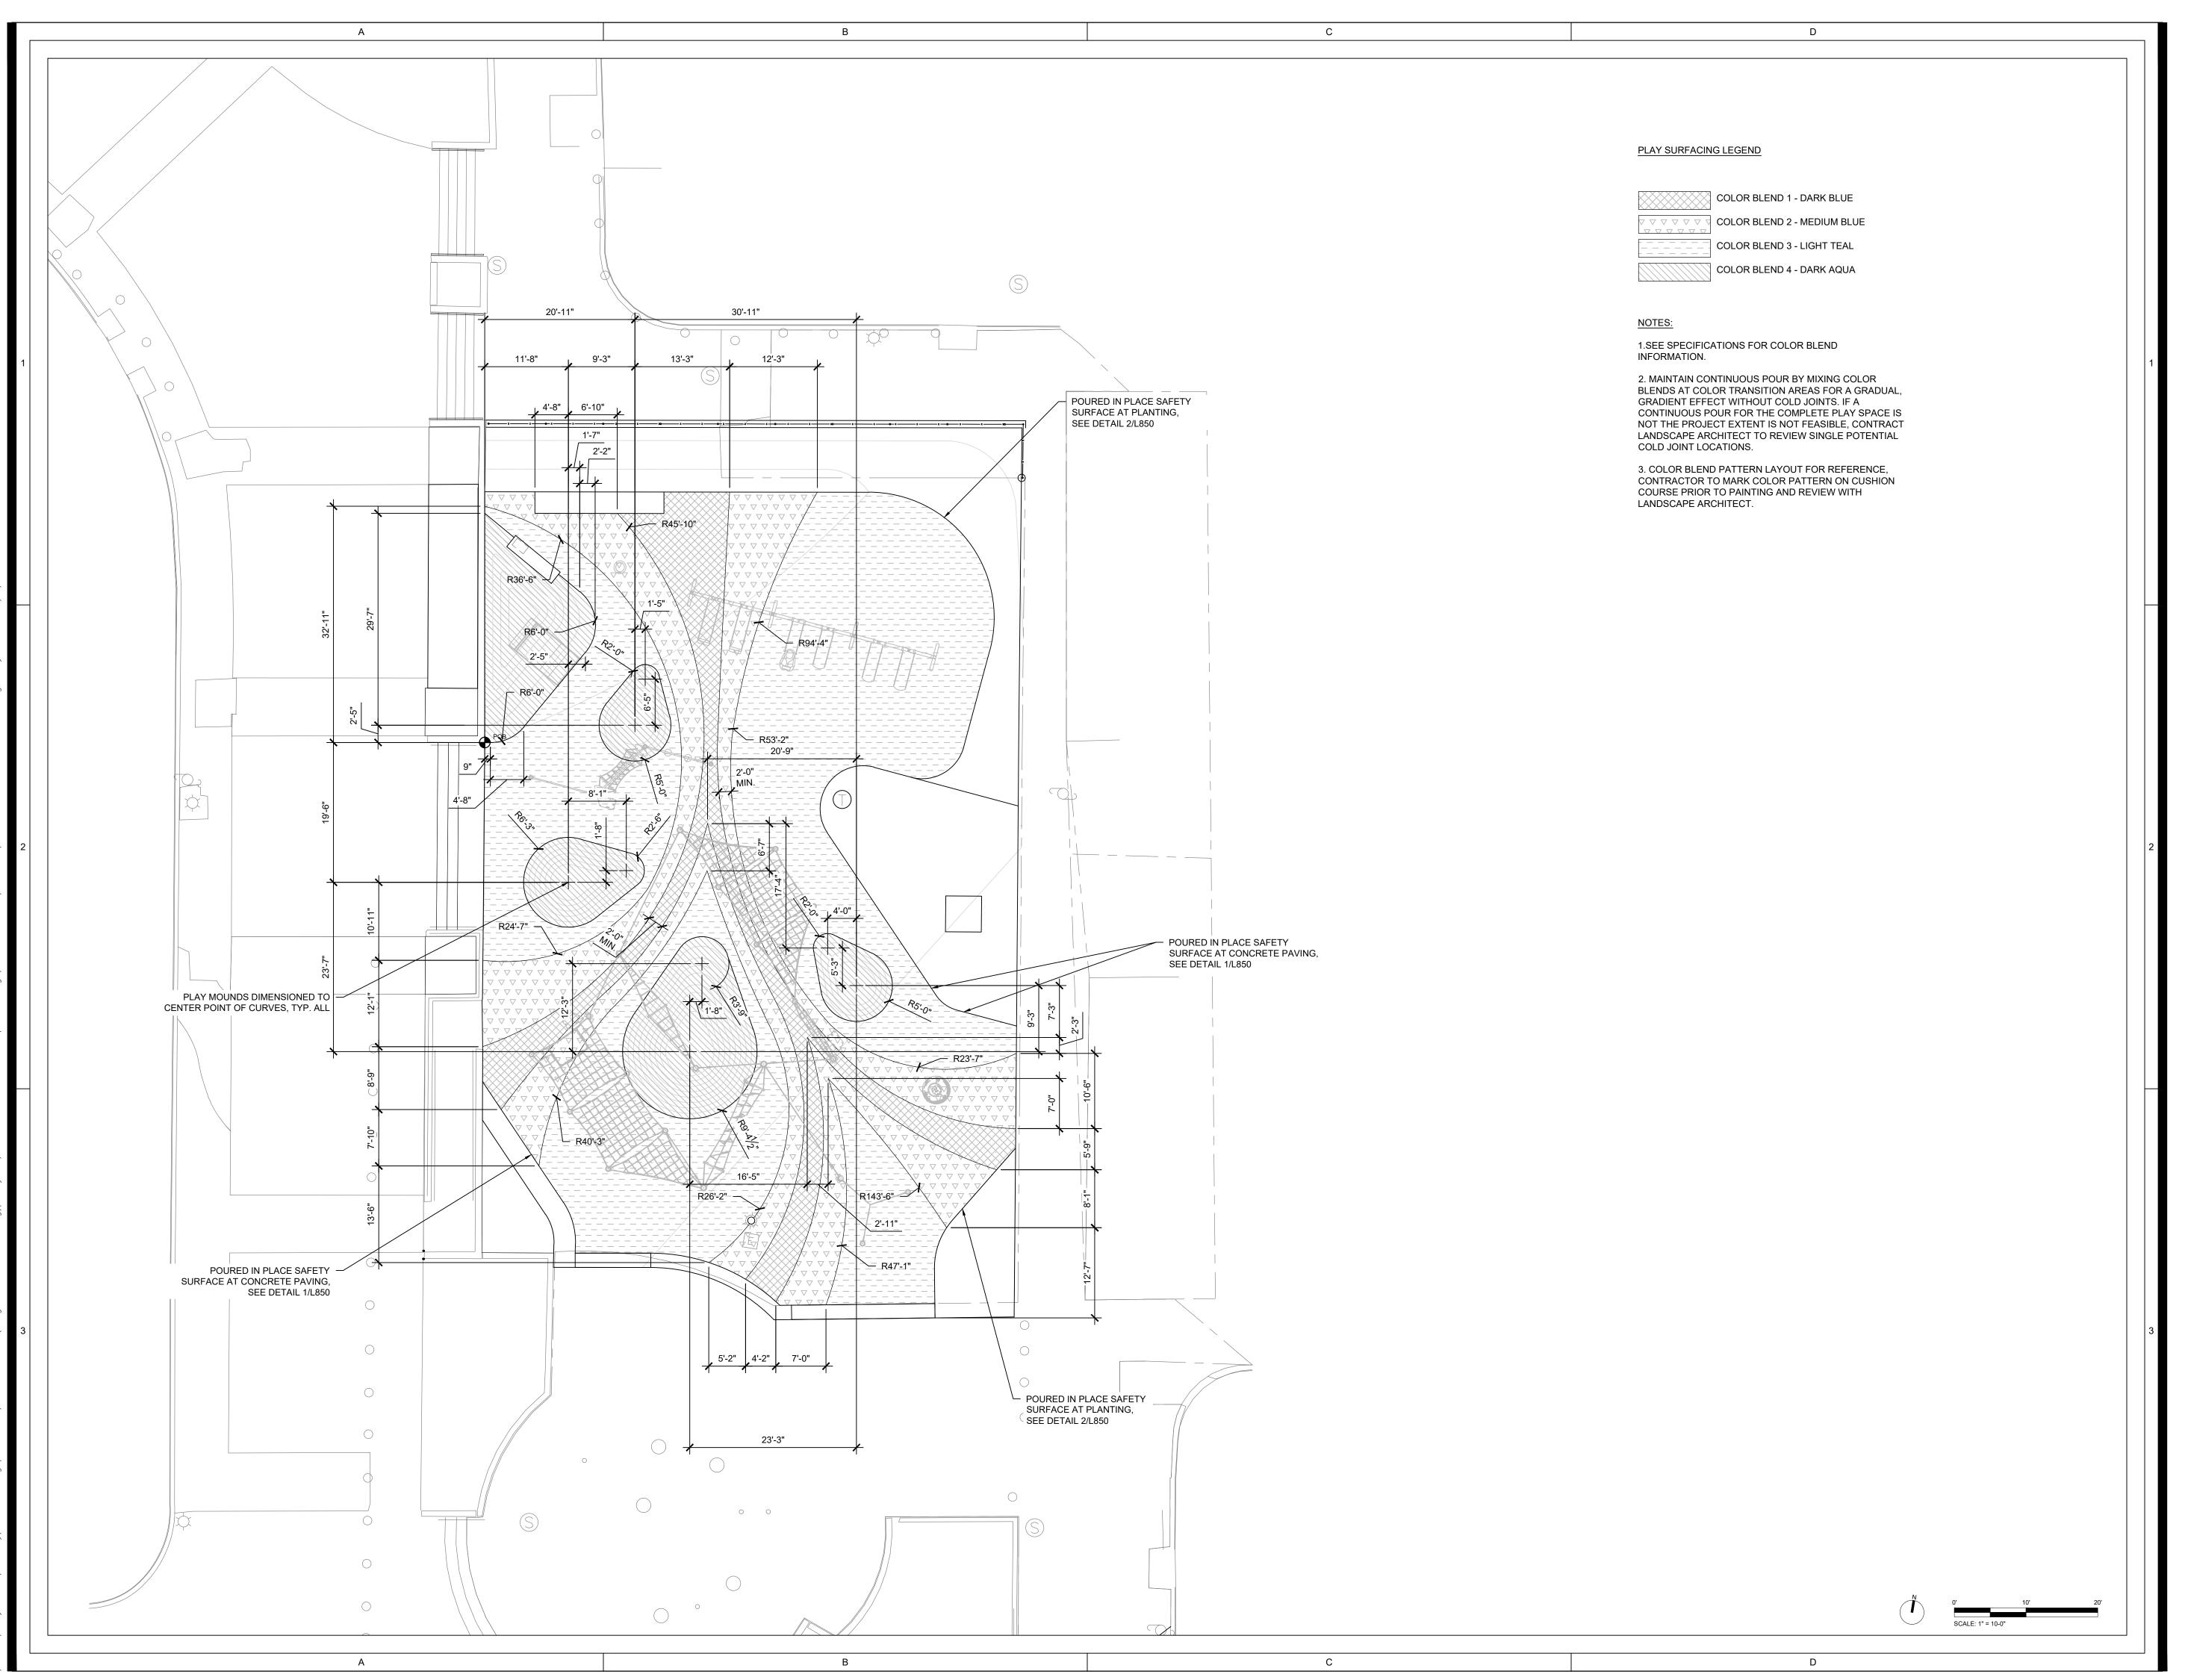3 5/09/2025 100% Construction Documents



PLAY EQUIPMENT SURFACING

Scale: 1" = 10'-0"

Date: 2-21-2025

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nto Description

7/31/2024 100% Schematic Design 10/25/2024 100% Design Development

5/09/2025 100% Construction Documents



PLAY EQUIPMENT FOOTING PLAN

Scale: 1" =
Date: 2-21
Drawn:
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Date Description

7/31/2024 100% Schematic Design
2 10/25/2024 100% Design Development
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SITE SECTION

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Date: 2-21-2025
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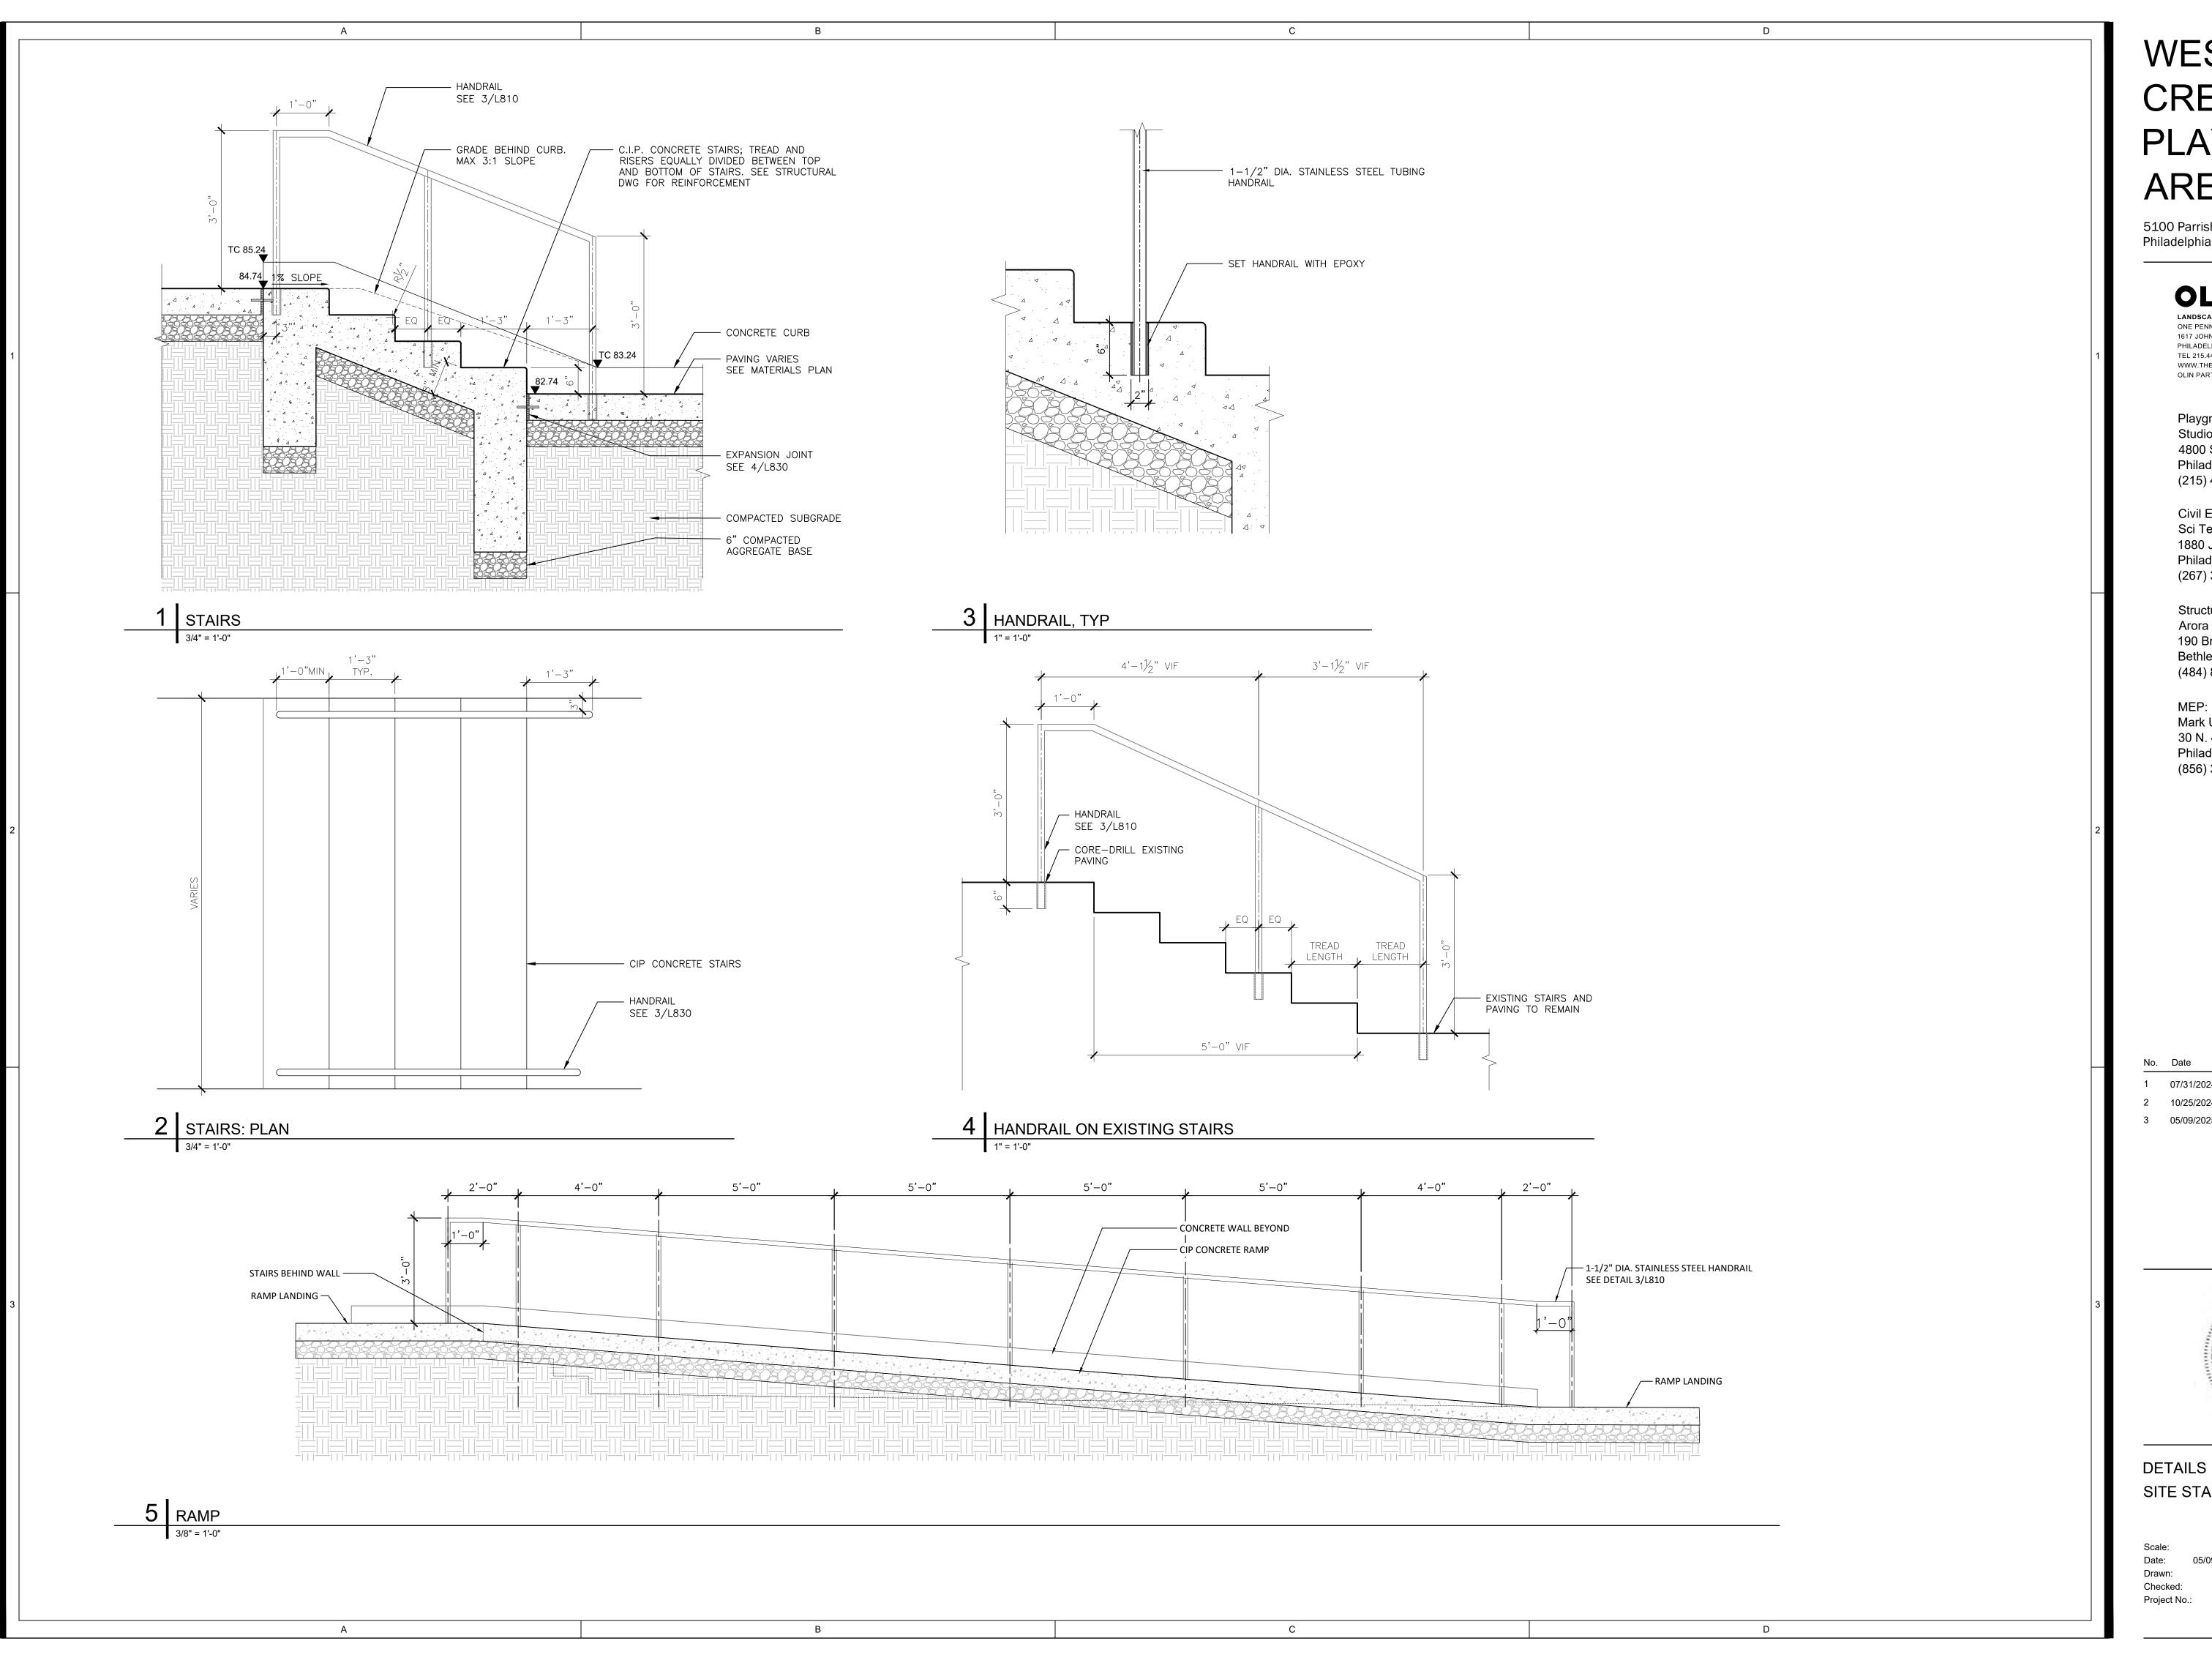
07/31/2024 SCHEMATIC DESIGN 100%
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3 05/09/2025 CONSTRUCTION DOCUMENTS 100%



DETAILS SITE WALLS

Scale: 1"=
Date: 05/09/20
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Description

- 1 07/31/2024 SCHEMATIC DESIGN 100% 2 10/25/2024 DESIGN DEVELOPMENT 100%
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SITE STAIRS RAMP AND HANDRAILS

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DETAILS FENCES

Scale: NA
Date: 05/09/2025
Drawn: TS
Checked: TS
Project No.: 2409

— PAVING MATERIAL VARIES, SEE MATERIALS PLAN 1/8" RADIUS TOOLED EDGE, SILICONE SEALANT TO SIT BELOW FINISHED GRADE. PLANT BED/SOILS,SEE PLANTING &SOILS PLANS - 6" CAST-IN-PLACE CONCRETE PAVEMENT WITH BROOM FINISH - BACKER ROD, SET BELOW FINISHED GRADE 1/8" SAWCUT CONTROL JOINT, 25% OF DEPTH — #4 REBARS EACH WAY, 2" CLEAR C.I.P. CONCRETECURB W/ 1/4"EXPANSION JOINT COVER, 12" O.C. TYP. - COMPRESSIVE FILLER 6" AGGREGATE BASE -(2) #4 REBARS (CONTINUOUS), 9" (3" CLEAT BOTTOM COMPACTED SUBGRADE — 6" MIN COMPACTED AGGREGATE BASE — COMPACTED SUBGRADE 3 RAISED CONCRETE CURB 4 EXPANSION JOINT 1 C.I.P. CONCRETE PAVING

С

WEST MILL CREEK PLAYGROUND AREAS E & G

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WWW.THEOLINSTUDIO.COM
OLIN PARTNERSHIP, LTD.

Playground Design: Studio Ludo 4800 Springfield Ave Philadelphia, PA 19143 (215) 454-6780

Civil Engineering: Sci Tek 1880 John F Kennedy Blvd #600, Philadelphia, PA 19103 (267) 314-5385

Structural: Arora and Associates, P.C. 190 Brodhead Road, Suite 120, Bethlehem, PA 18017 (484) 895-3131

MEP: Mark Ulrick 30 N. 41ST SUITE 500 Philadelphia, PA 19104 (856) 320-8100

Date Description


07/31/2024 SCHEMATIC DESIGN 100%
 10/25/2024 DESIGN DEVELOPMENT 100%

3 05/09/2025 CONSTRUCTION DOCUMENTS 100%



DETAILS PAVING

Scale: 1"=
Date: 05/09/20
Drawn:
Checked:

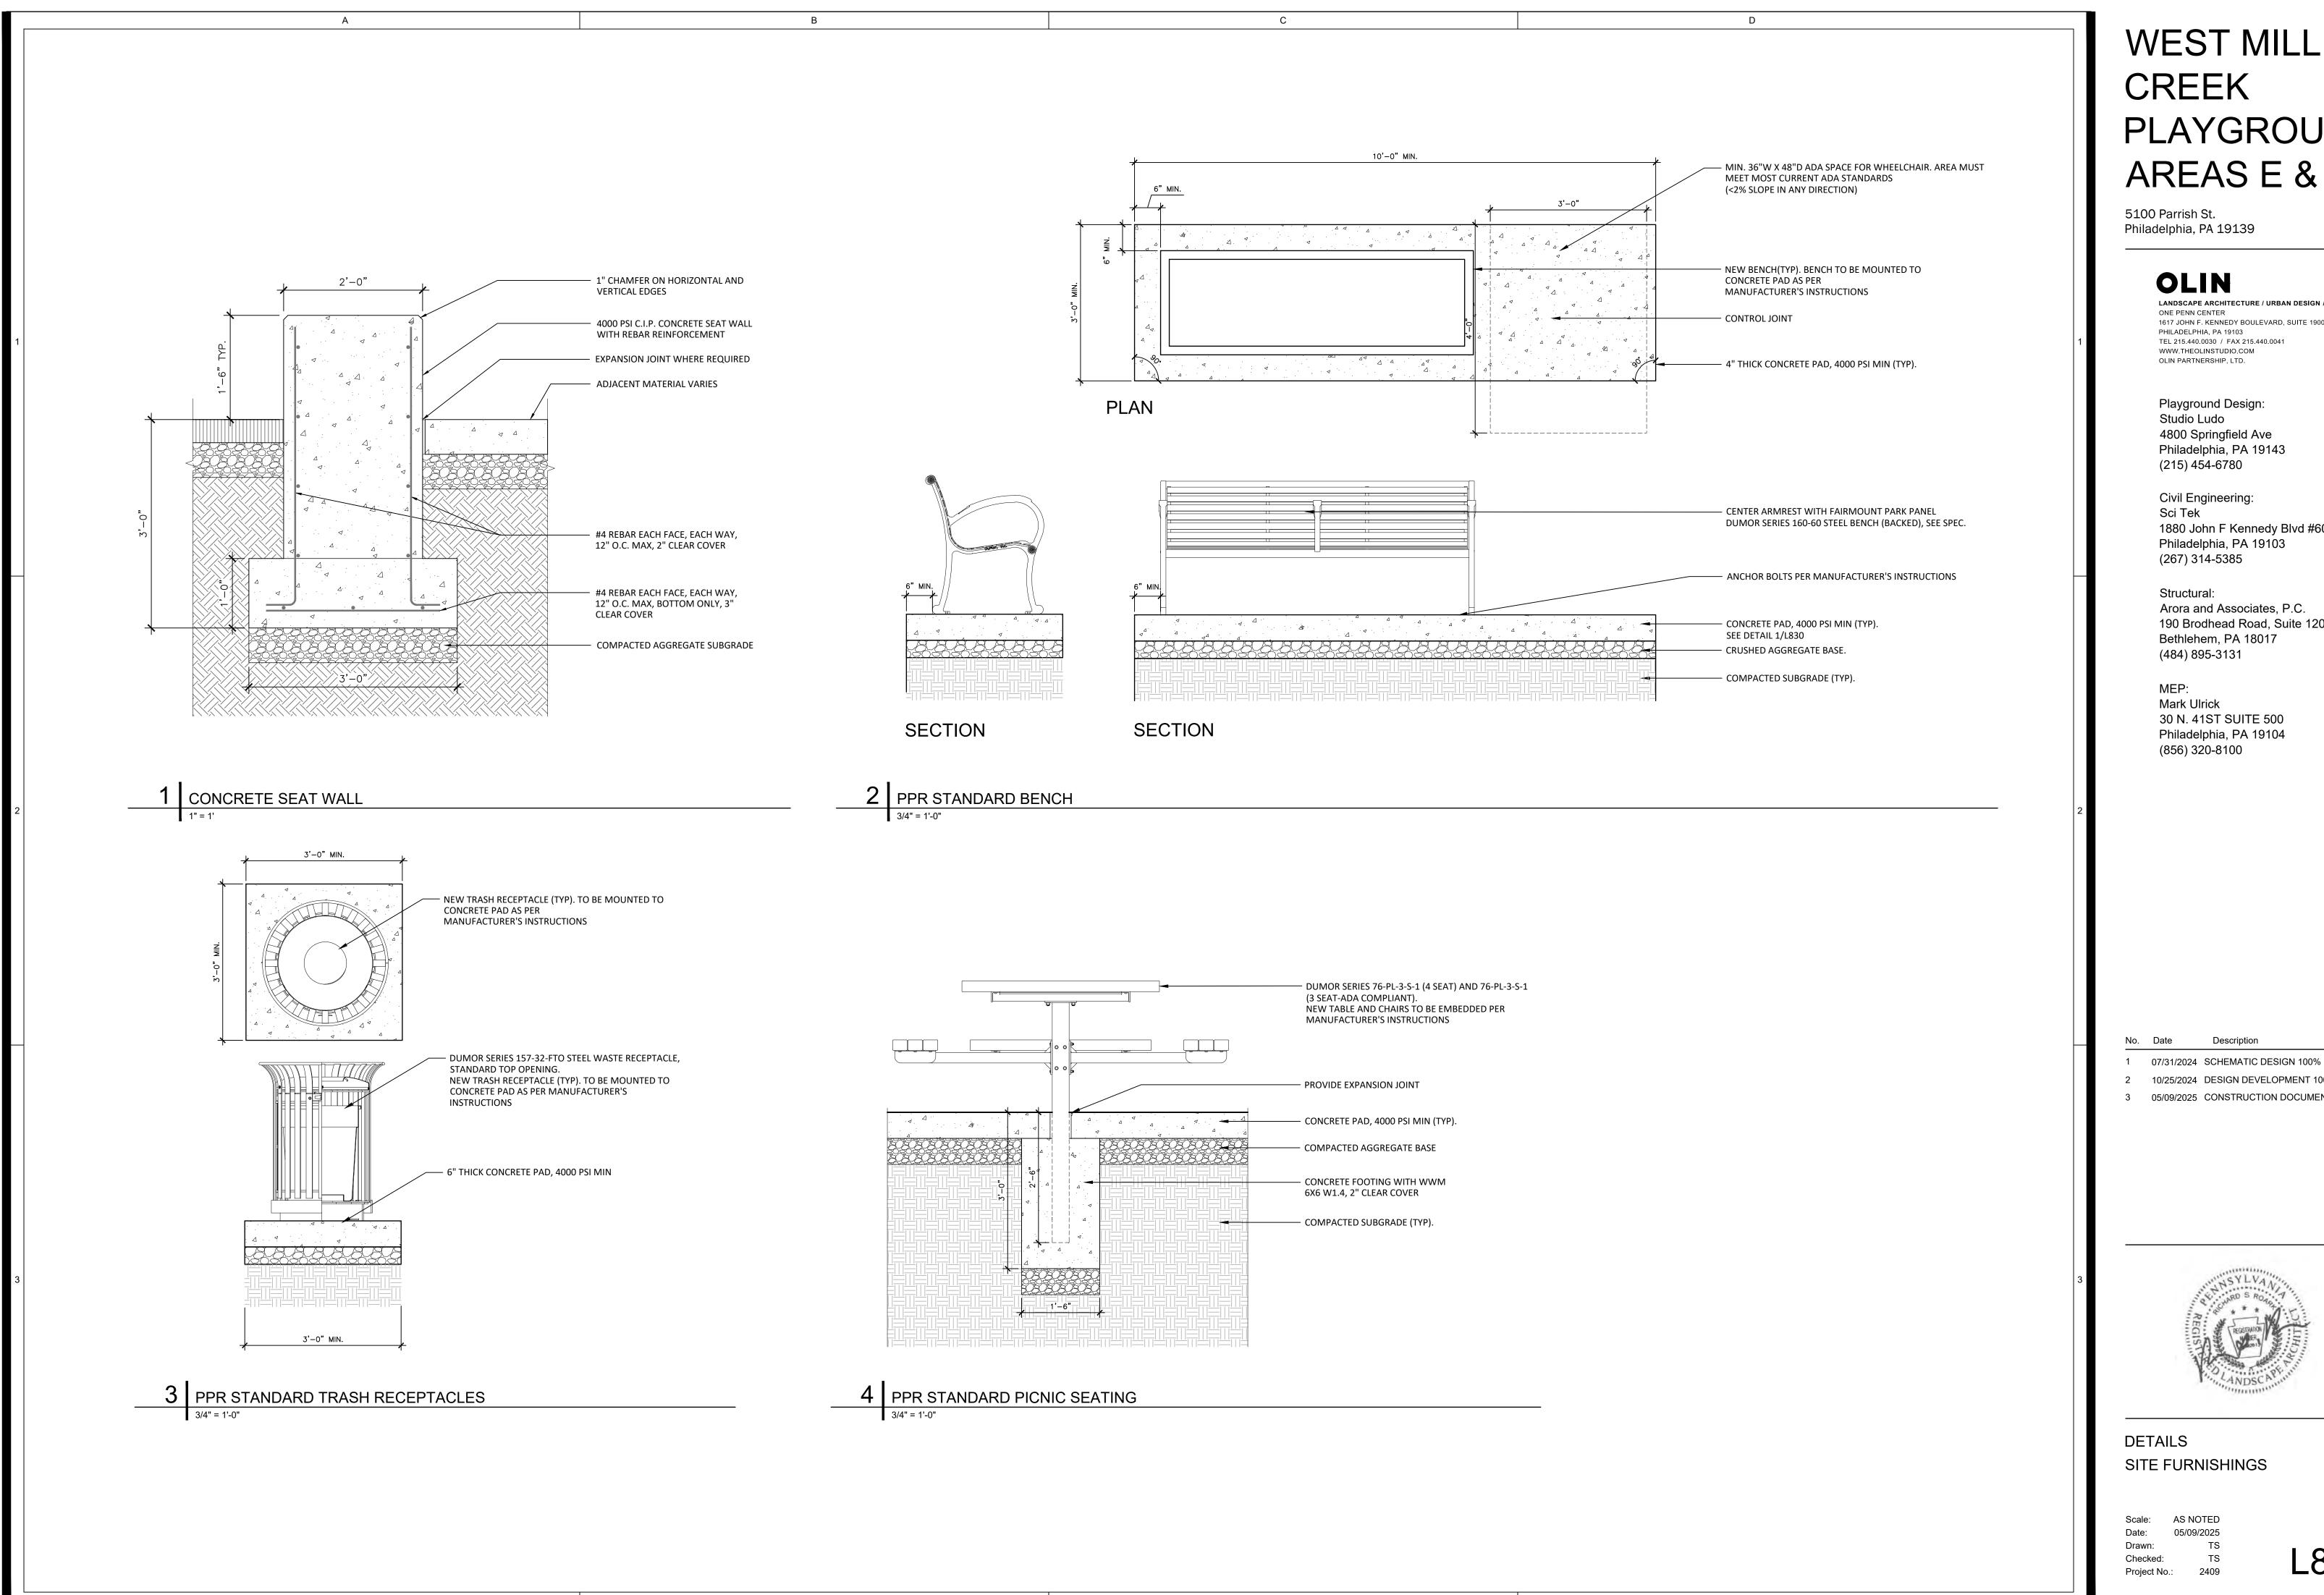

5100 Parrish St. Philadelphia, PA 19139

LANDSCAPE ARCHITECTURE / URBAN DESIGN / PLANNING ONE PENN CENTER 1617 JOHN F. KENNEDY BOULEVARD, SUITE 1900 PHILADELPHIA, PA 19103 TEL 215.440.0030 / FAX 215.440.0041 WWW.THEOLINSTUDIO.COM OLIN PARTNERSHIP, LTD.

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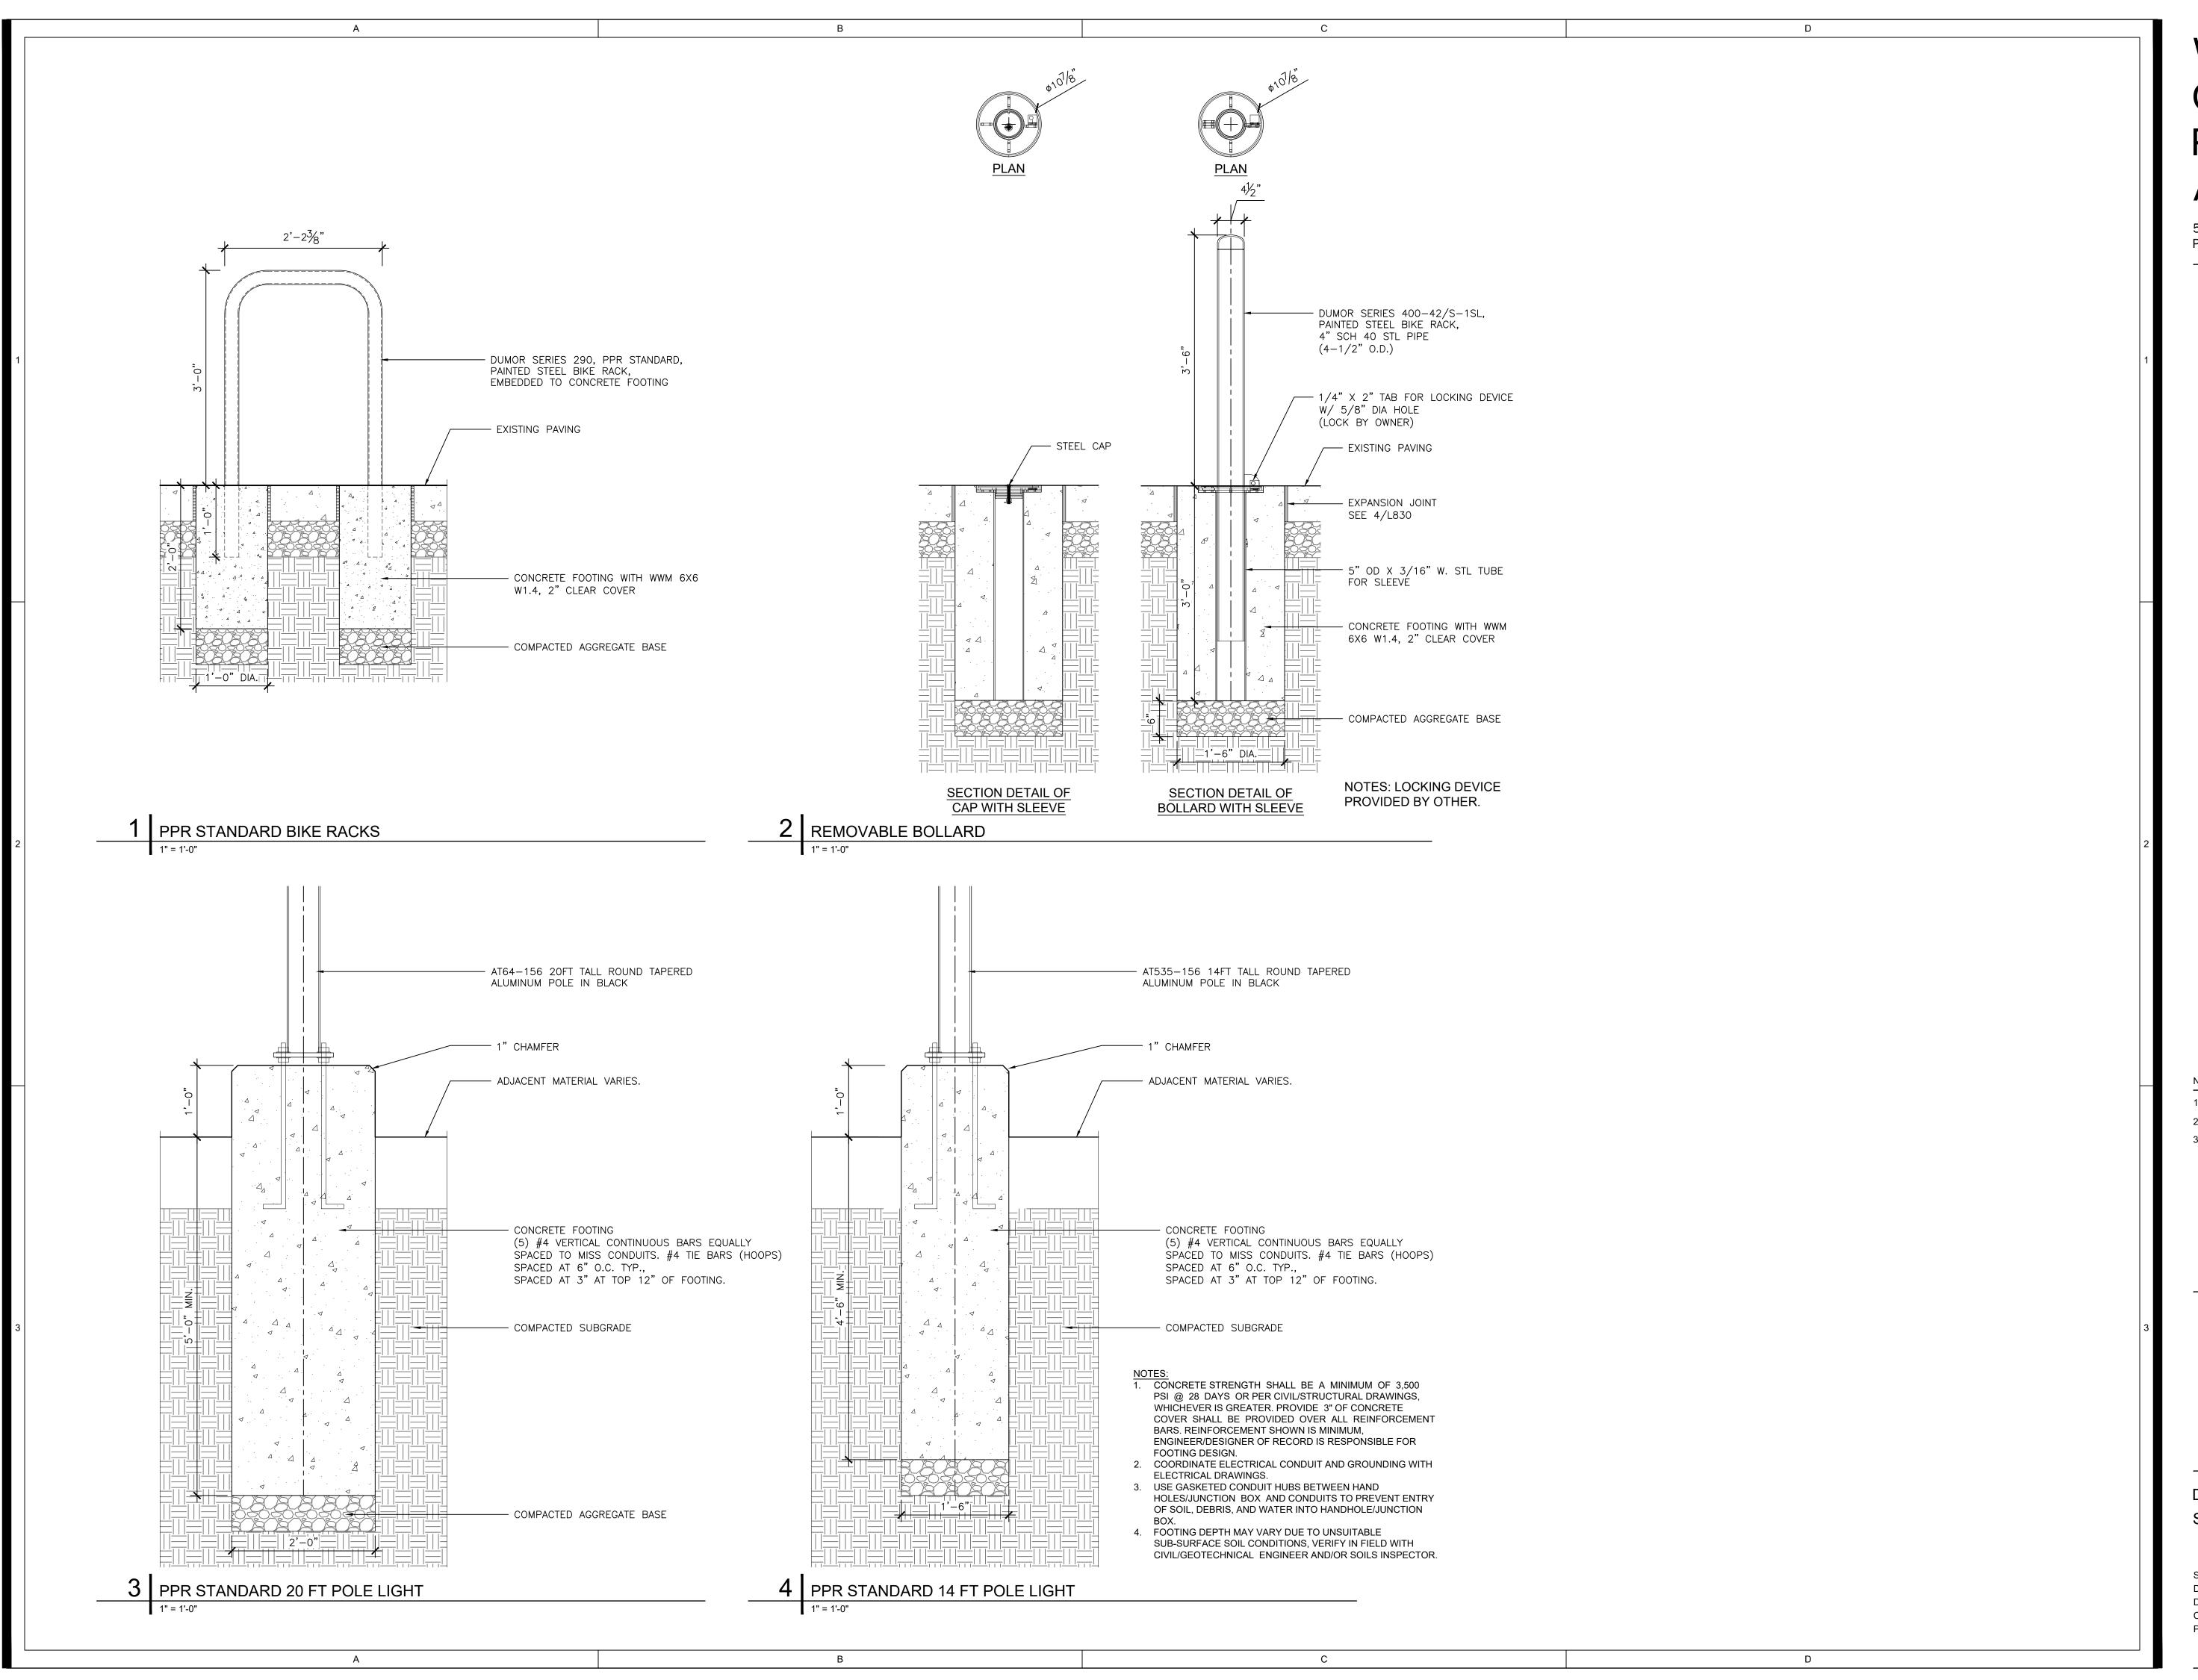
2 10/25/2024 DESIGN DEVELOPMENT 100%

3 05/09/2025 CONSTRUCTION DOCUMENTS 100%



DETAILS SITE FURNISHINGS

AS NOTED 05/09/2025 Drawn: Checked: TS



5100 Parrish St. Philadelphia, PA 19139

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No. Date Description

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 10/25/2024 DESIGN DEVELOPMENT 100%

3 05/09/2025 CONSTRUCTION DOCUMENTS 100%



DETAILS SITE FURNISHINGS

Scale: AS NOTED
Date: 05/09/2025
Drawn: TS
Checked: TS
Project No.: 2409

Α С D GENERAL NOTE: SIGNAGE TYPES ARE FOR REFERENCE ONLY. SIGNAGE CONTENT WILL BE CONFIRMMED BY OWNER IN SHOP DRAWING REVIEW PROCESS. PID.4 Sign Type Description This sign type is a pedestrian-scale park identification sign. This sign type can be used at all property types to identify a field complex or Sign Panels
Sizes vary. ½" thk custom high pressure laminate panels (CHPL). Printed messages and panel colors. Match colors as noted. Ref Sec 2C Aluminum Channel 4" x 1½" x .125 web 6063-T52 architectural (non-tapered) aluminum channel. Lengths vary. Finished and coated to match Scale: ¾"=1'-0" C Logo Panels 3 3/8" x 1" thk black locust lumber. PID.4.w PID.4.f Wall Mounted Fence Mounted Ref Sec 2C Ref Sec 2C #1 grade, eased edges. Lengths vary. Laser etch and fill logo graphic. UV ½" thk panel ½" thk panel clear coated. Recess fasteners, first and second surfaces. See Detail 3 for fastener connections and sizes. Support Tube 2 x 4 aluminum tube welded to Tacony Creek Aluminum Channels. Park Footer Attachment
3 3/8" x 1" thk aluminum welded to — A (M1) (D1) (D2) ¼" thk aluminum plate. Drill and tap E. Cayuga St. & I St. Hours: 7am – 10pm as required. Painted to match color as noted. Attach plate to concrete C M2 F2 footer. Secure sign (channels) to — A M1 D2 footer attachments. Footer plate should be below grade and covered - CURRENT SIDE PANEL REQUIREMENT IS ALLIMINUM IN LIEU OF as specified in Detail 3. Panel Options Graphic Panel Double-Sided A M1 D1 D3 D4 __ E P3 Ref Sec 2C B F1 F2 **Construction Details** Front Elevation Side View **Rear Elevation** Refer to Section 2C + 2D for Scale: 3/4"=1'-0" Scale: ¾"=1'-0" Scale: 3/4"=1'-0" construction drawings and mounting details and Section 2E for placement guidelines. PPR SIGN: PID.4 SCALE: 3/4" = 1' PLY.1 Sign Type Description This sign type is used to identify a playground within a Philadelphia Parks & Recreation site. This sign type is also used to post the playground rules and regulations. Sign Panels
Sizes vary. ½" thk custom high pressure laminate panels (CHPL). Printed messages and panel colors. Match colors as noted. Aluminum Channel 4" x 1½" x .125 web 6063-T52 architectural (non-tapered) aluminum channel. Lengths vary. Finished and coated to match Top View Scale: ¾"=1'-0" as noted. C Logo Panels 3 3/8" x 1" thk black locust lumber. Ref Sec 2C Ref Sec 2C #1 grade, eased edges. Lengths vary. PLY.1.w Laser etch and fill logo graphic. UV clear coated. Recess fasteners, first Wall Mounted ½" thk panel and second surfaces. See Detail 3 for fastener connections and sizes. Support Tube 2 x 4 aluminum tube welded to Aluminum Channels. Footer Attachment
3 3/8" x 1" thk aluminum welded to ¼" thk aluminum plate. Drill and tap as required. Painted to match color — A M1 D2 — A M1 D1 D3 D4 as noted. Attach plate to concrete footer. Secure sign (channels) to footer attachments. Footer plate Panel Options should be below grade and covered • Graphic Panel as specified in Detail 3. Double-Sided - CURRENT SIDE PLY.1.f REQUIREMENT IS ALUMINUM IN LIEU OF WOOD Fence Mounted ½" thk panel 1'-9" B (F1) (F2) Ref Sec 2C **Construction Details** Front Elevation Side View **Rear Elevation** Refer to Section 2C + 2D for Scale: 3/4"=1'-0" Scale: ¾"=1'-0" Scale: ¾"=1'-0" construction drawings and mounting details and Section 2E for placement guidelines. Date: PPR SIGN: PLY.1 SCALE: VARIES Project No.: С

WEST MILL CREEK PLAYGROUND AREAS E & G

5100 Parrish St. Philadelphia, PA 19139

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No. Date Description

1 07/31/2024 SCHEMATIC DESIGN 100% 2 10/25/2024 DESIGN DEVELOPMENT 100%

3 05/09/2025 CONSTRUCTION DOCUMENTS 100%



DETAILS - SITE SIGNAGE

05/09/2025 TS Drawn: Checked: TS

С RUL.7 Sign Type Description This sign type is used to post a singular regulatory message throughout a Philadelphia Parks & Recreation site/facility. Sign Panel ½" thk custom high pressure laminate panels (CHPL). Printed messages and panel colors. Match colors as noted. Aluminum Tube
1½" x 1½" aluminum tube (1/8" wall). Cap top end. Finished and coated to match as noted. Mounting Panel

¼" thk aluminum plate. Drill holes as required. Finished and coated to match as noted. Fasteners Grainger #10-32 (½"L) Tamper Resistant Screw with Flat Head Type, Plain Finish, 18-8 Stainless Leash and clean up after your pet Rear Elevation/Assembly Scale: NTS — A M1 D1 D2 B F1 F2 **Construction Details** Front Elevation Side View Refer to Section 2C + 2D for Scale: 1:2 Scale: 1:2 construction drawings and mounting details and Section 2E for placement guidelines. PPR SIGN: RUL.7 SCALE: 1:2 INH.2 Sign Type Description This sign type is used to interpret a property element or history of the site or structure. This sign type accommodates one 150-word A Sign Panel
Sizes vary. ¾" thk custom high pressure laminate panels (CHPL). Printed messages and panel colors. Match colors as noted. Aluminum Channel 4" x 1½" x .125 web 6063-T52 architectural (non-tapered) aluminum channel. Lengths vary. Finished and coated to match as noted. C Logo Panels 3 3/8" x 1" thk black locust lumber. #1 grade, eased edges. Lengths vary. Laser etch and fill logo graphic. UV INH.2.w Wall Mounted clear coated. Recess fasteners, first ½" thk panel and second surfaces. See Detail 3 for fastener connections and sizes. **Top View** Footer Attachment
3 3/8" x 1" thk aluminum welded to Scale: ¾"=1'-0" ¼" thk aluminum plate. Drill and tap as required. Painted to match color as noted. Attach plate to concrete 3'-3" footer. Secure sign (channels) to footer attachments. Footer plate 3'-0" should be below grade and covered - CURRENT SIDE PANEL REQUIREMENT IS as specified in Detail 3. ALUMINUM IN LIEU OF WOOD — A M1 D1 D3 D4 — A M1 D2 C M2 F2 B F1 F2 Ref Sec 2C **Construction Details** Front Elevation Side View Rear Elevation Refer to Section 2C + 2D for Scale: ¾"=1'-0" Scale: ¾"=1'-0" Scale: 3/4"=1'-0" construction drawings and mounting details and Section 2E for placement guidelines. Date: PPR SIGN: INH.2 SCALE: VARIES Project No.: С

WEST MILL CREEK PLAYGROUND AREAS E & G

5100 Parrish St. Philadelphia, PA 19139

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No. Date Description

1 07/31/2024 SCHEMATIC DESIGN 100% 2 10/25/2024 DESIGN DEVELOPMENT 100%

05/09/2025 CONSTRUCTION DOCUMENTS 100%



DETAILS - SITE SIGNAGE

05/09/2025 TS Drawn: TS Checked:

Design Wind load 300 PSF 120 MPH, 3 Sec Gust Wind, Exp C **Exploded View Assembled View** Remove all galvanizing runs H.S. Bolt with hex head, or beads in washer area. hex nut and washers Galv. steel 20 GA with each bolt ---Section View: J-Bolt Mounting Section View: Breakaway Mounting Scale: NTS Scale: NTS

A Aluminum Channel 4" x 1½" x .125 web 6063-T52 architectural (non-tapered) aluminum channel. Lengths vary.

Aluminum Plate 1/4" thk aluminum plate. Drill and tap as required. Attach plate to concrete footer. Secure sign (channels) to footer attachments.

J-Bolts
1" diameter steel J-Bolts.

as required.

Concrete Footer
Poured in place concrete footer 5,400 psi at 28 Days. Provide weather seal sand and gravel at footing. Compacted crushed stone

Finished Concrete
Minimum 2" thick concrete: poured, formed, brush finished, flush at grade.

> NOTE: When locating a footer within a single pavement block (max. 5'-0" x 5'-0"), adjacent to at least 2 expansion joints, the entire block of pavement shall be removed and replaced with the same materials and finish of


adjacent sidewalk areas.

PPR SIGN: CONCRETE FOOTING DETAIL SCALE: NTS

PPR SIGN: WALL MOUNT DETAILS

2D

CONSTRUCTION DETAILS | fence mount details

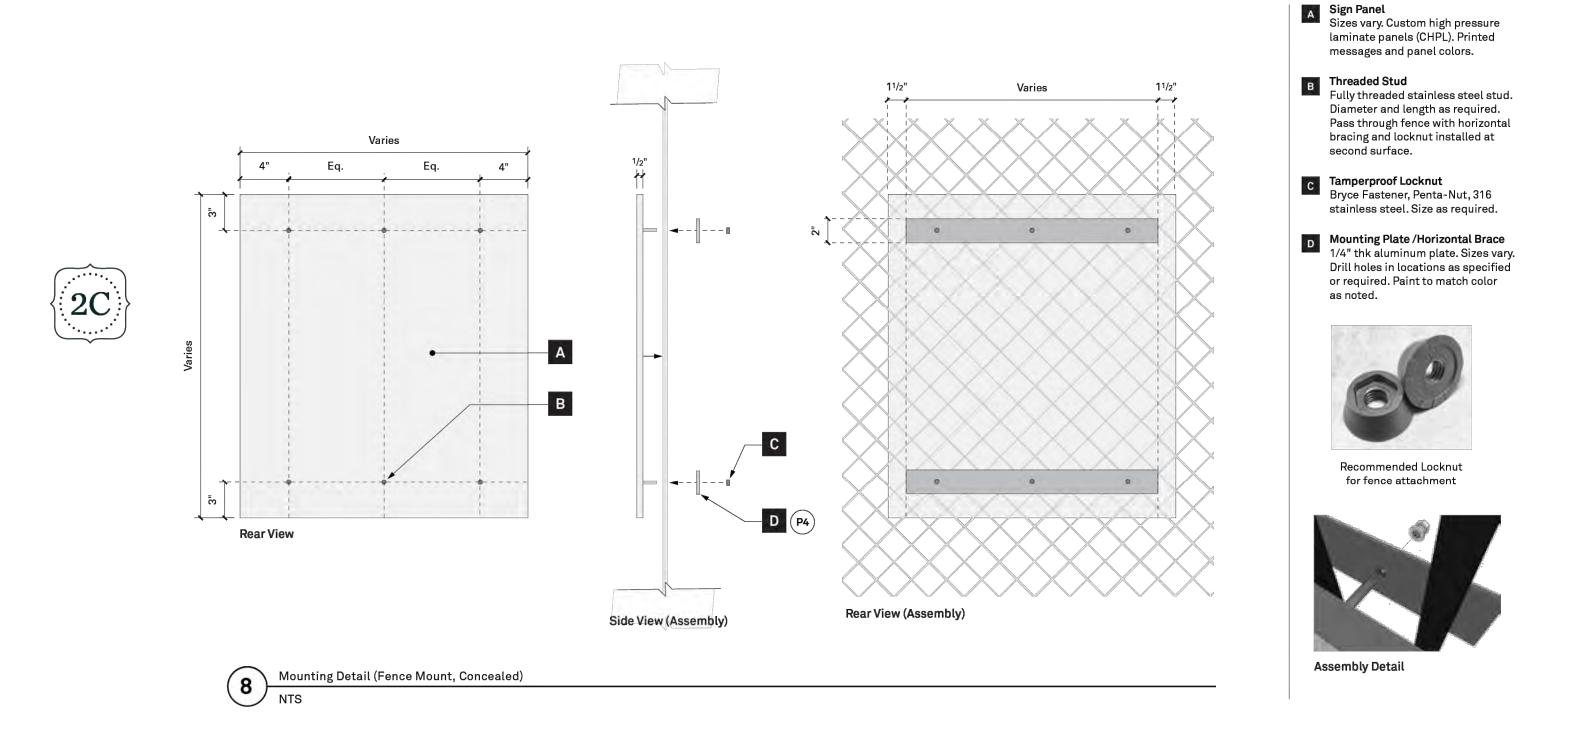

- 1. ASSUME PPR STANDARD PID.4.F PARK IDENTIFICATION SIGNAGE.
 DESIGN SHALL BE PROVIDED BY PPR. CONTRACTOR IS RESPONSIBLE FOR PROCUREMENT AND INSTALLATION.
- 2. SIGNAGE SHALL BE 1/2" THICK CUSTOM HIGH PRESSURE LAMINATE (CHPL) PANEL, MOUNTED ON EXISTING CHAINLINK FENCE. ATTACHMENT SHALL NOT BE VISIBLE FROM FACE OF SIGN.
- 3. ASSUME W2'-0" X H4'-7 1/8" SIGNAGE FOR PRICING 4. SEE SIGNAGE SPEC FOR DETAILS.
- 5. FIELD VERIFY SIGNAGE MOUNT LOCATION WITH LANDSCAPE ARCHITECT.

WALL MOUNT SIGN PLACEMENT

SCALE: 3/4" = 1'

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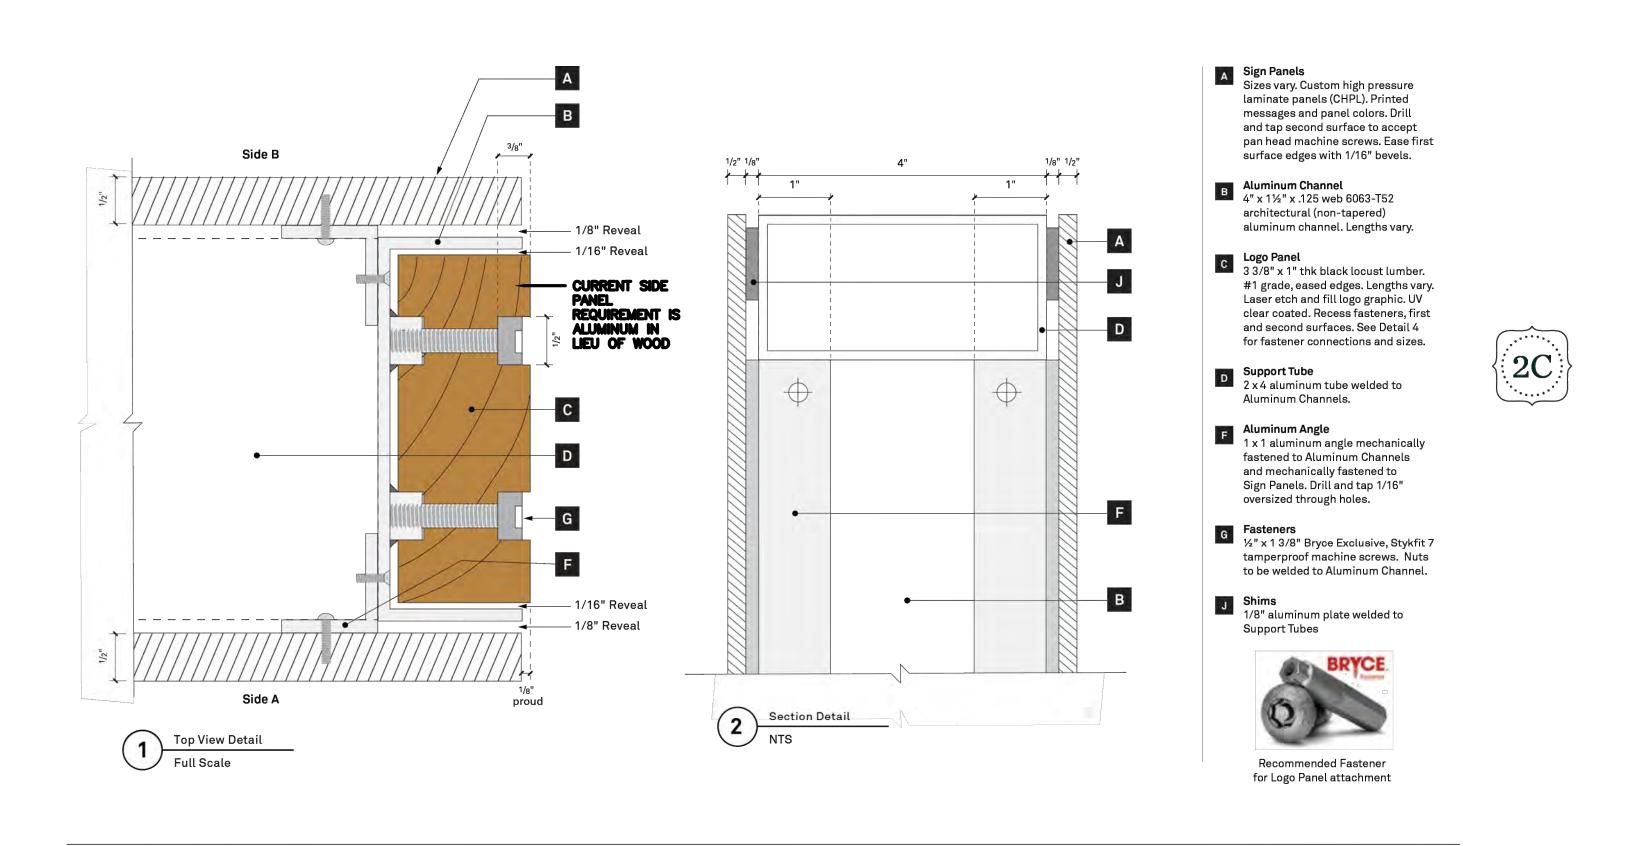
- 1 07/31/2024 SCHEMATIC DESIGN 100% 2 10/25/2024 DESIGN DEVELOPMENT 100%
- 05/09/2025 CONSTRUCTION DOCUMENTS 100%



DETAILS - SITE SIGNAGE

05/09/2025 Checked:

CONSTRUCTION DETAILS | post mount details



1 PPR SIGN: POST MOUNT DETAILS

SCALE: NTS

CONSTRUCTION DETAILS | post mount details



PPR SIGN: POST MOUNT DETAILS

SCALE: NTS

WEST MILL
CREEK
PLAYGROUND
AREAS E & G

5100 Parrish St. Philadelphia, PA 19139

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No. Date Description

2 10/25/2024 DESIGN DEVELOPMENT 100%

1 07/31/2024 SCHEMATIC DESIGN 100%


3 05/09/2025 CONSTRUCTION DOCUMENTS 100%



DETAILS - SITE SIGNAGE

Scale: NA
Date: 05/09/2025
Drawn: TS
Checked: TS
Project No: 2409


INSTALLATION DETAILS | post mount / footing details

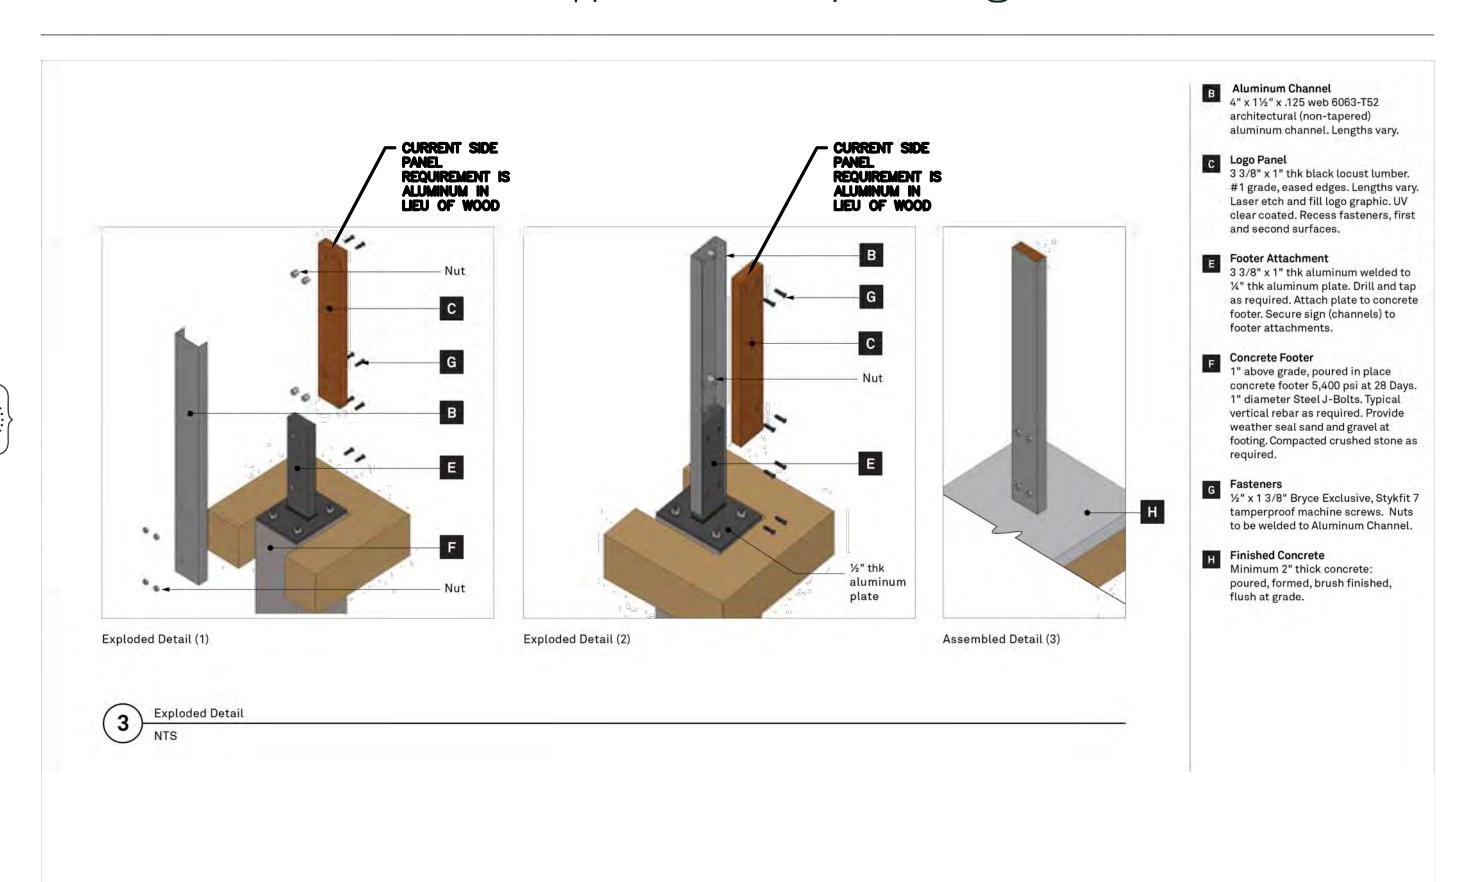

1 PPR SIGN: POST MOUNT DETAILS

SCALE: NTS

INSTALLATION DETAILS | post mount / footing details

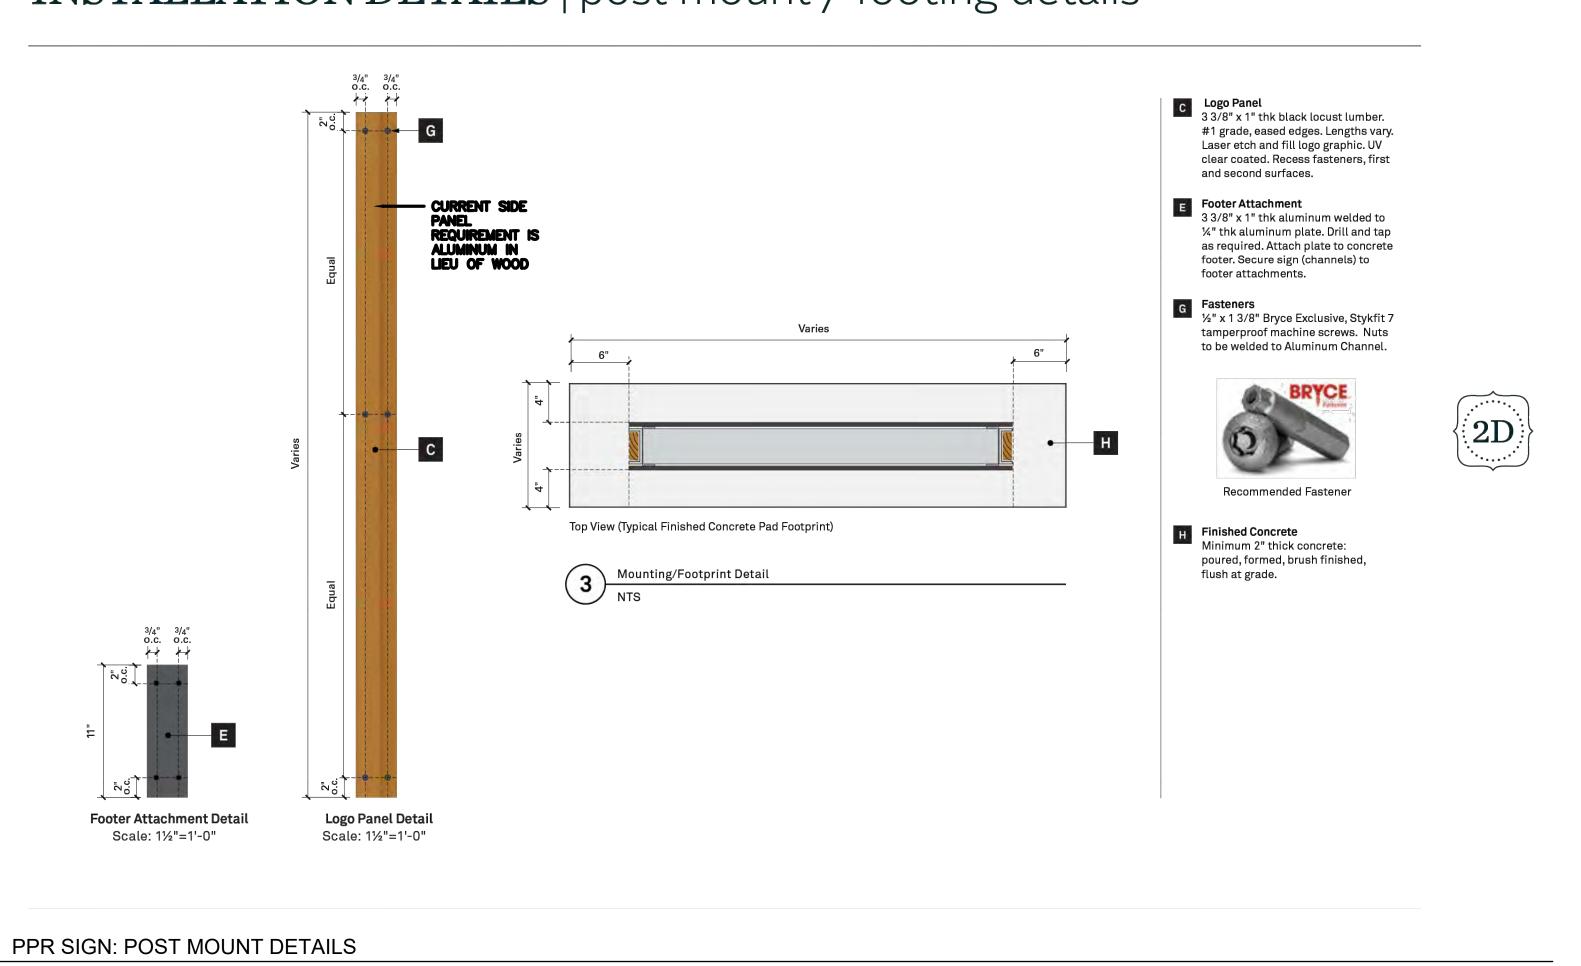

WEST MILL

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AREAS E & G

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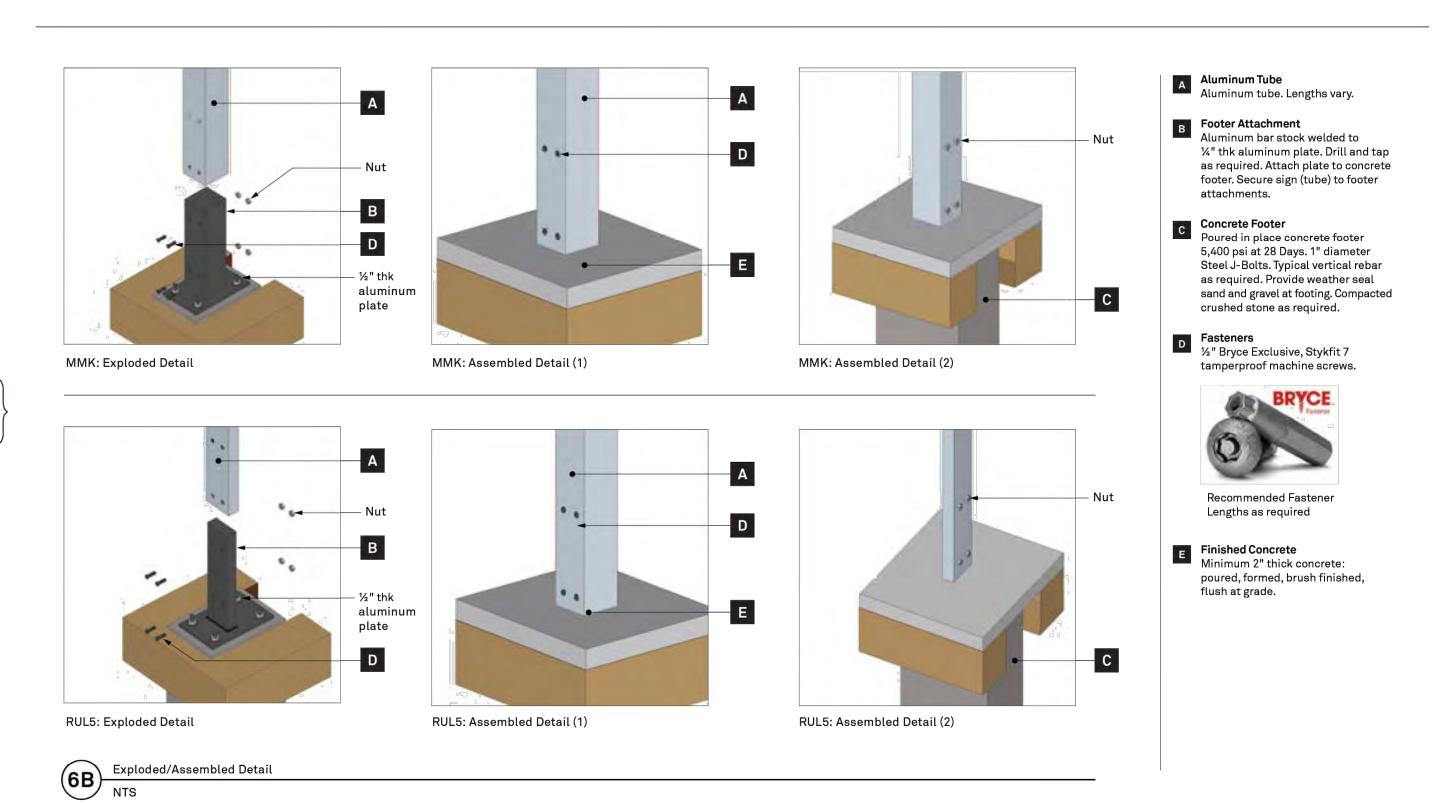
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DETAILS - SITE SIGNAGE


Scale: NA
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Drawn: TS
Checked: TS
Project No.: 2409



PPR SIGN: POST MOUNT DETAILS

SCALE: NTS

INSTALLATION DETAILS | post mount / footing

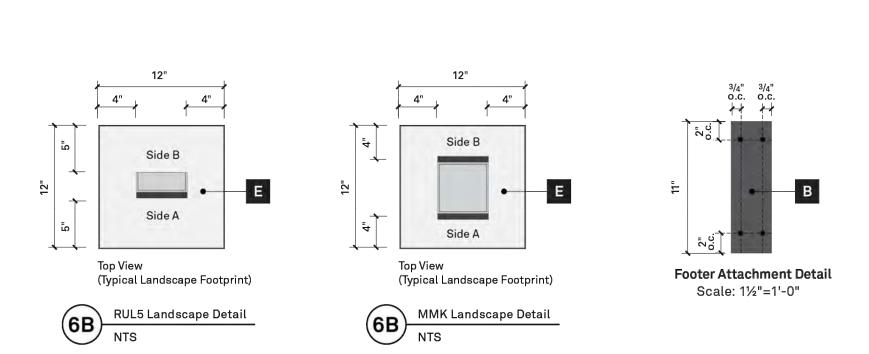

Footer Attachment
Aluminum bar stock welded to

Finished Concrete
Minimum 2" thick concrete:

poured, formed, brush finished, flush at grade.

attachments.

¼" thk aluminum plate. Drill and tap as required. Attach plate to concrete footer. Secure sign (tube) to footer

PPR SIGN: POST MOUNT DETAILS

WEST MILL CREEK PLAYGROUND AREAS E & G

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1 07/31/2024 SCHEMATIC DESIGN 100%

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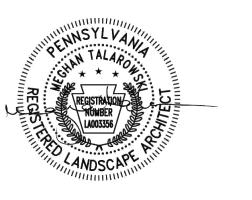
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No. Date Description

1 7/31/2024 100% Schematic Design

2 10/25/2024 100% Design Development

3 5/09/2025 100% Construction Documents



PLAY EQUIPMENT DETAILS

Scale: VARIES
Date: 2-21-2025
Drawn: TD
Checked: MT

Project No.:

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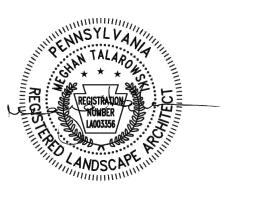
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No. Date Description

1 7/31/2024 100% Schematic Design

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3 5/09/2025 100% Construction Documents



PLAY EQUIPMENT DETAILS

Scale: 1/2" = 1'-0"

Date: 2-21-2025

Drawn: TD

Checked: MT

Project No.: 2409

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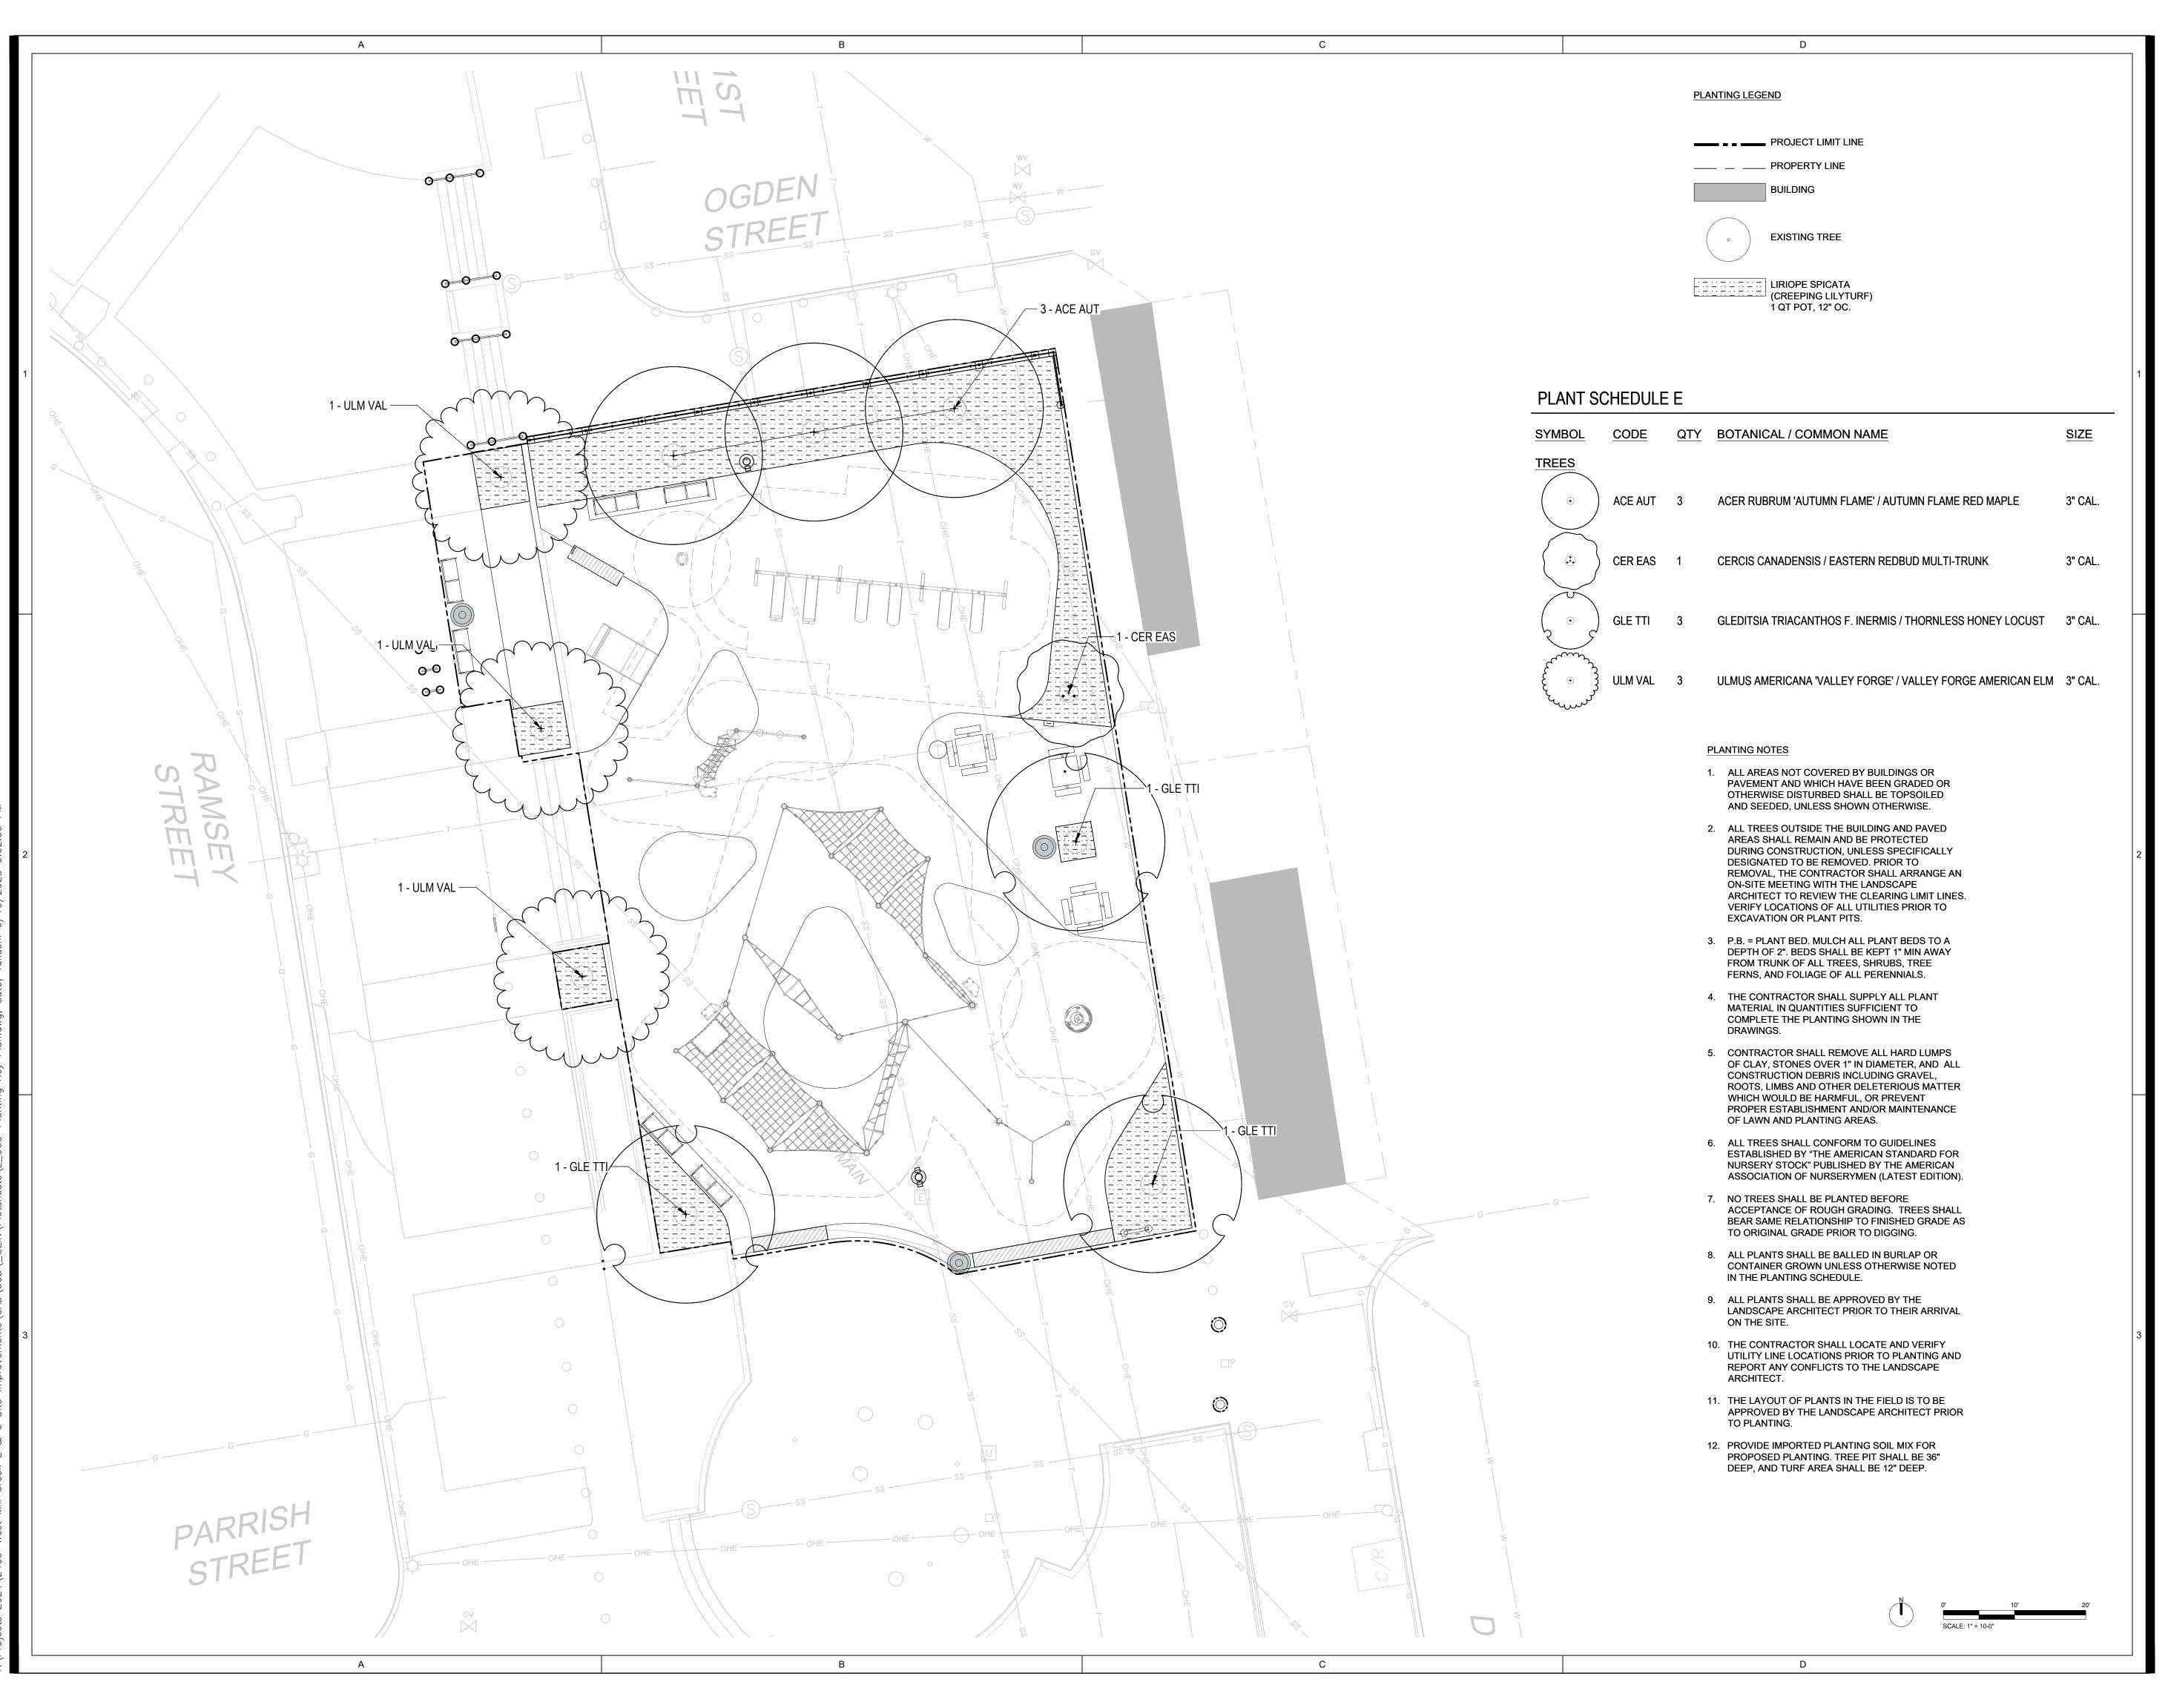
7/31/2024 100% Schematic Design 2 10/25/2024 100% Design Development





PLAY EQUIPMENT DETAILS

1/2" = 1'-0" 2-21-2025 Drawn: Checked:



WEST MILL CREEK PLAYGROUND AREAS E & G

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PLANTING PLAN AREA E


 Scale:
 1"=10'

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PLANTING PLAN AREA G


 Scale:
 1"=10'

 Date:
 05/09/2025

 Drawn:
 TS

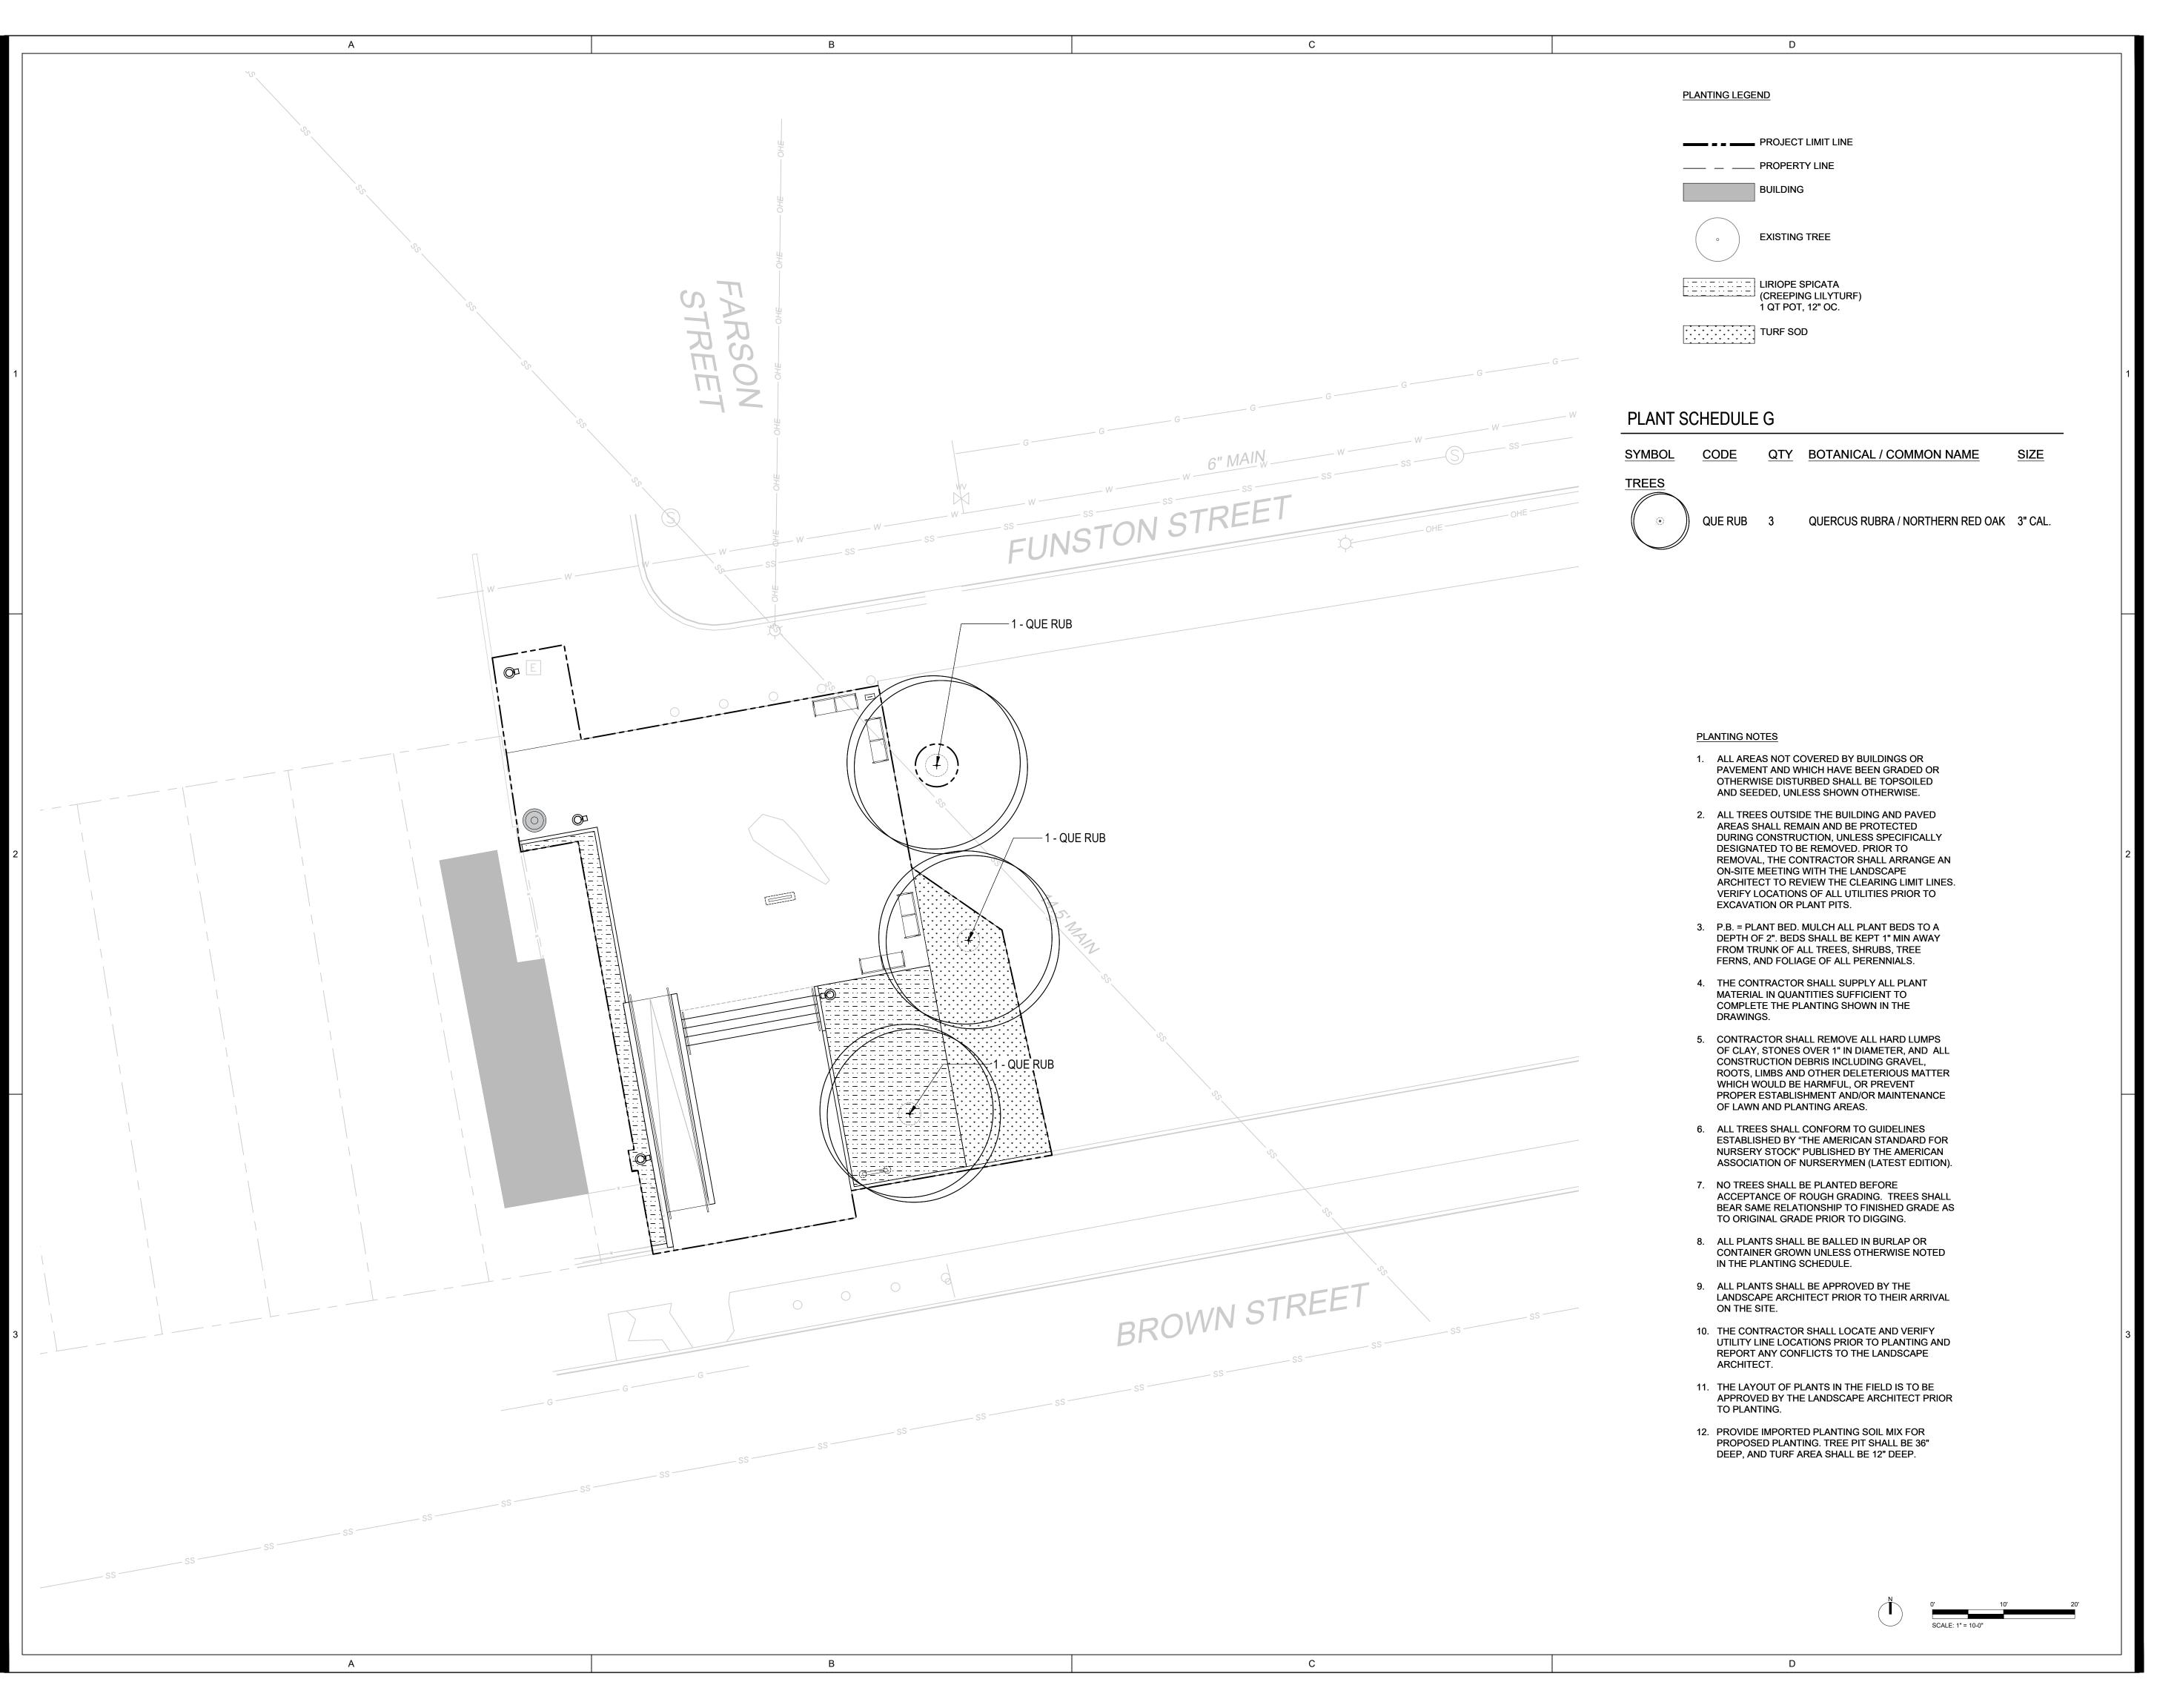 Checked:
 TS

 Project No.:
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Civil Engineering: Sci Tek 1880 John F Kennedy Blvd #600, Philadelphia, PA 19103 (267) 314-5385

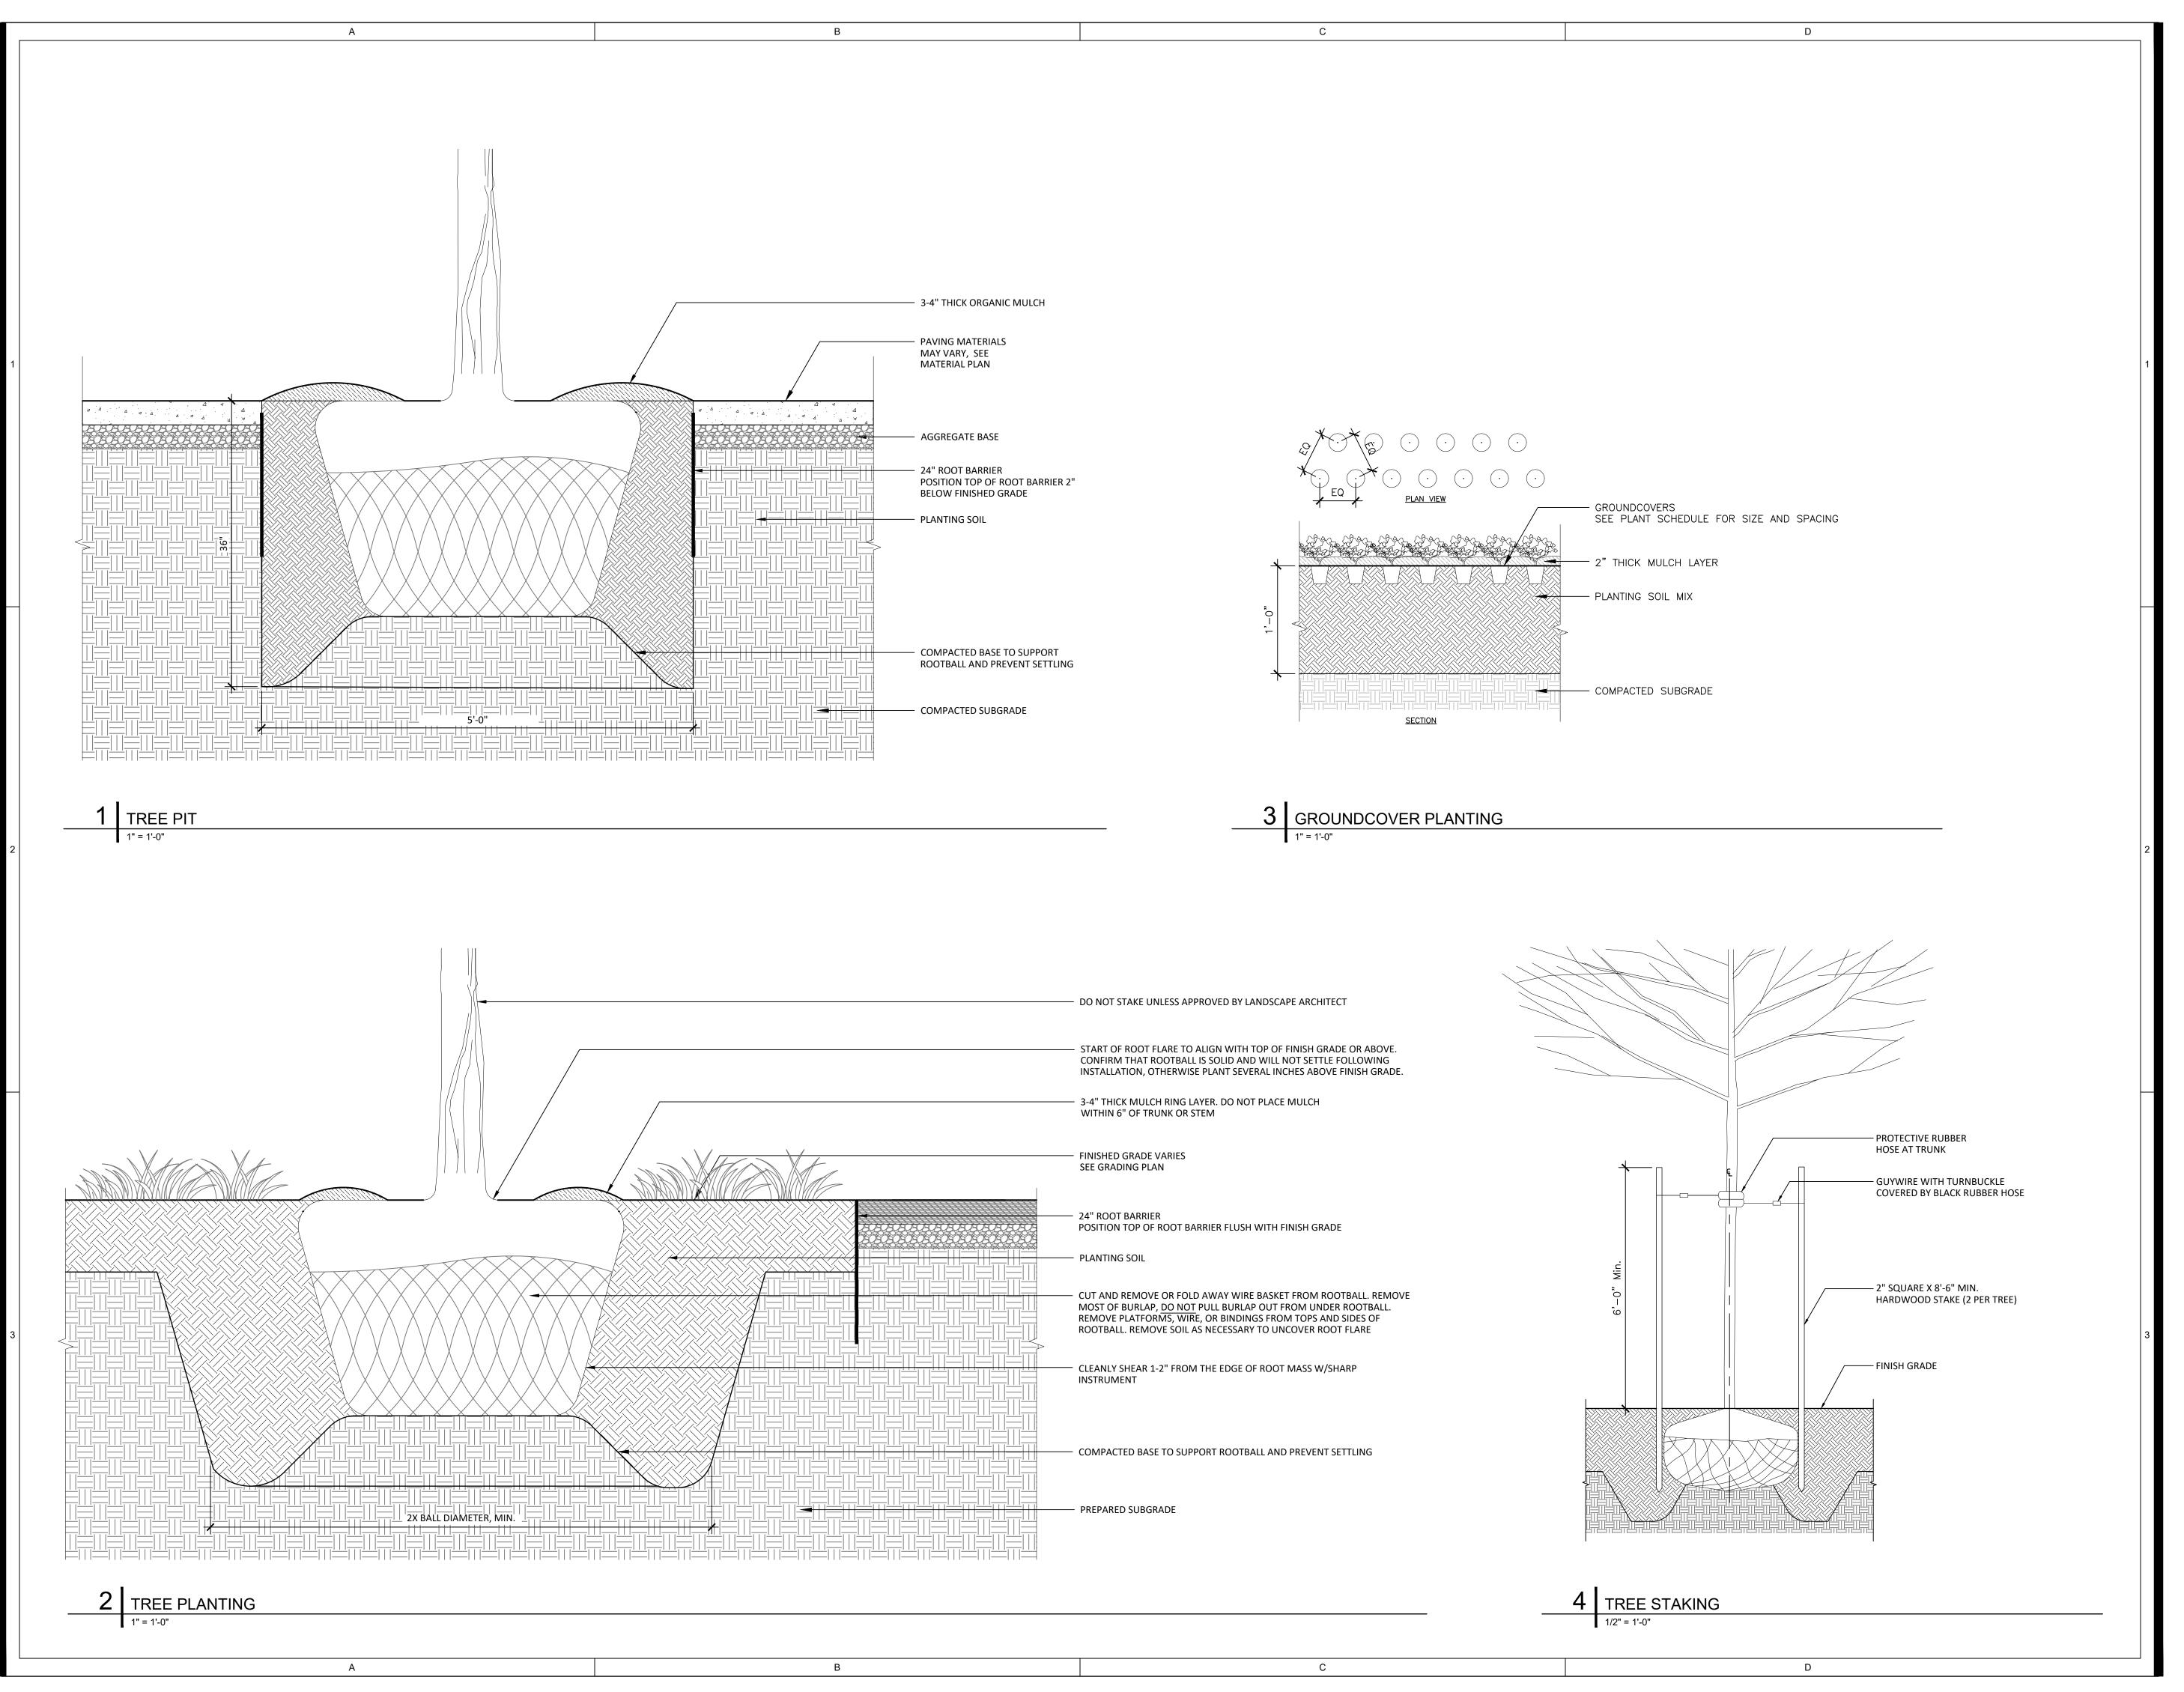Structural:
Arora and Associates, P.C.
190 Brodhead Road, Suite 120,
Bethlehem, PA 18017
(484) 895-3131

MEP: Mark Ulrick 30 N. 41ST SUITE 500 Philadelphia, PA 19104 (856) 320-8100

No. Date Description


07/31/2024 SCHEMATIC DESIGN 100%
 10/25/2024 DESIGN DEVELOPMENT 100%

3 05/09/2025 CONSTRUCTION DOCUMENTS 100%



DETAILS PLANTING

Scale: NA
Date: 05/09/2025
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Project No.: 2409

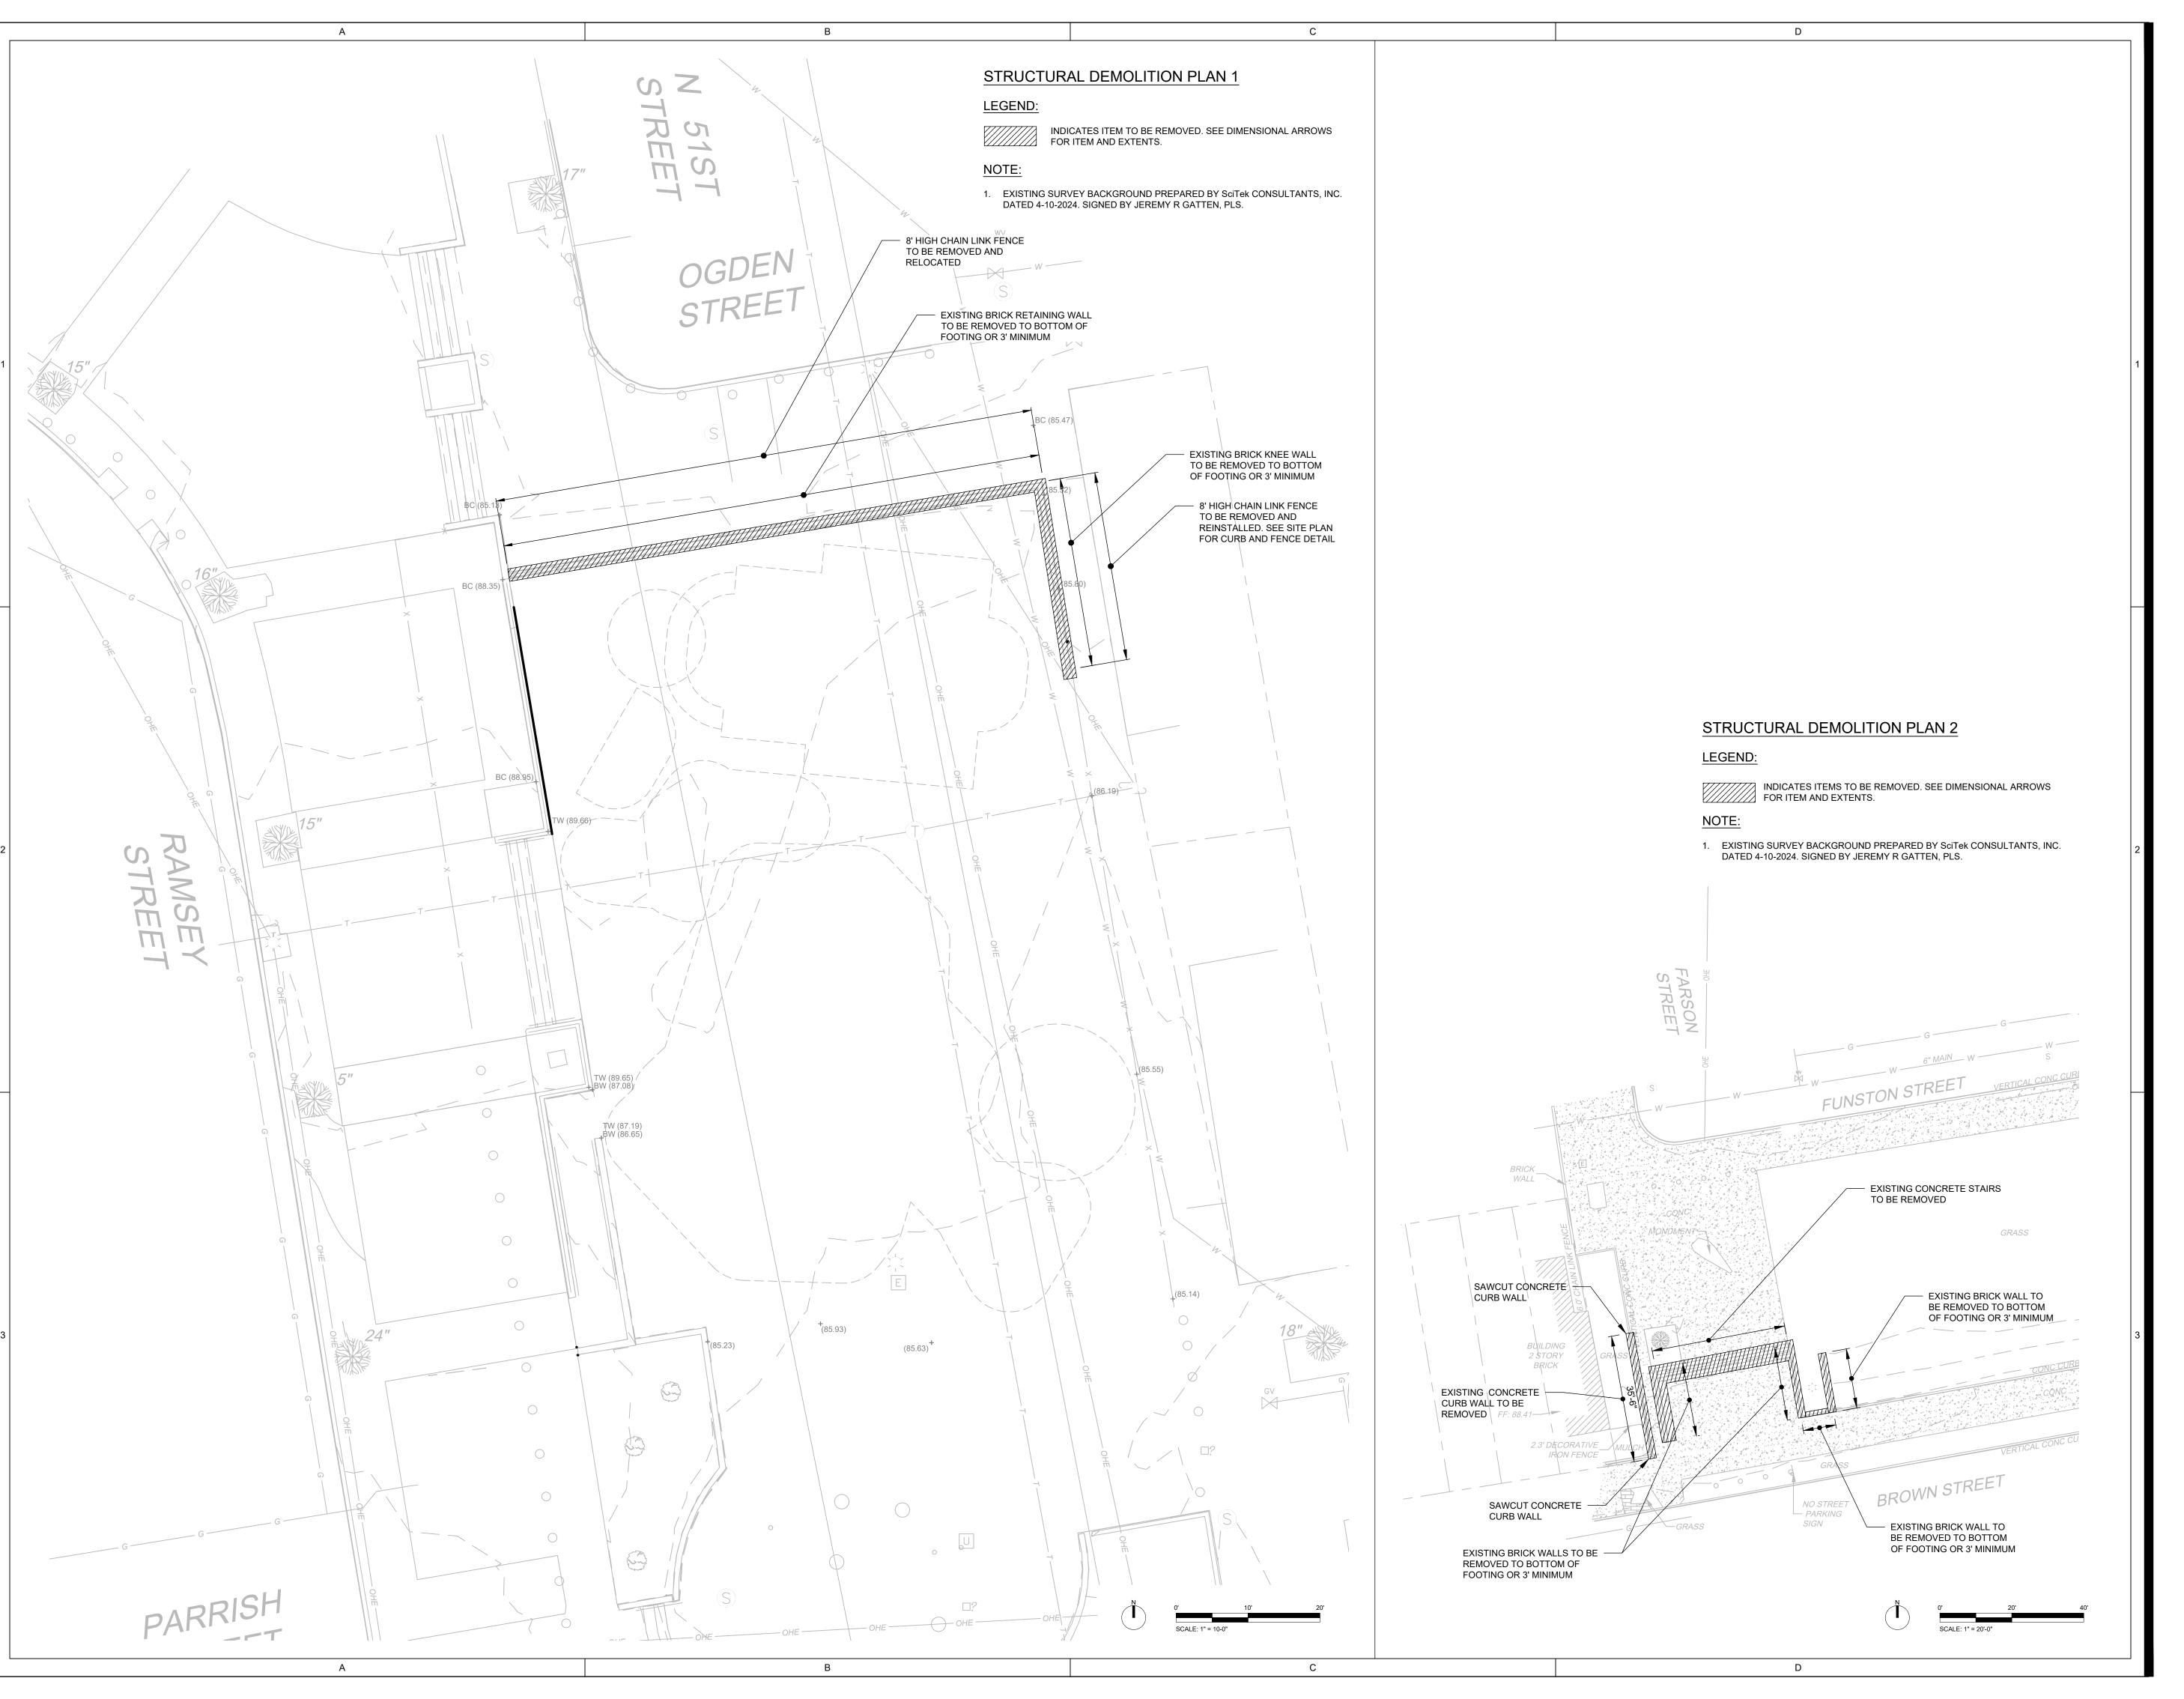

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07/31/2024 SCHEMATIC DESIGN 100% 11/14/2024 DESIGN DEVELOPMENT 100%

05/09/2025 CONSTRUCTION DOCUMENTS 100%

STRUCTURAL DEMOLITION PLAN AREAS E & G

Scale: AS NOTED
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GENERAL NOTES


FOUNDATIONS


- 1. PERFORM ALL SITE PREPARATION AND EXCAVATION WORK IN STRICT ACCORDANCE WITH THE
- A. SOILS REPORT PREPARED BY (N1, DATED NA2)
- 2. BOTTOM OF ALL FOOTINGS MUST BEAR ON SOIL CAPABLE OF SAFELY SUPPORTING 3000 PSF.
- 3. BOTTOM OF ALL FOOTINGS MUST BE INSPECTED AND APPROVED BY A LICENSE PROFESSIONAL ENGINEER BEFORE PLACING ANY CONCRETE. APPROVAL IN WRITING MUST INDICATE THAT THE SOILS ARE ADEQUATE TO SAFELY SUSTAIN THE SPECIFIED SOIL BEARING PRESSURE.
- 4. BOTTOM OF ALL EXTERIOR FOOTINGS SHALL BE A MINIMUM OF THREE FEET BELOW FINISH GRADE.
- RETAINING WALLS.


SHALL AVE CONTRACTION JOINTS AT 30 FEET MAXIMUM ON CENTERS UNLESS NOTED OTHERWISE. WALLS WITH INTEGRAL COLUMN PIERS OR PILASTERS SHALL HAVE A FORMED CONTRACTION JOINT ON ONE SIDE OF EACH PIER ON THE EXPOSED FACE OF THE WALL. JOINTS SHALL BE FILLED WITH AN APPROVED SEALANT.

CONCRETE

- 6. ALL CONCRETE SHALL BE READY-MIX, AS FOLLOWS:
- 6.1. HAVE A MINIMUM COMPRESSIVE STRENGTH OF 4500 PSI AT 28 DAYS,
- 6.2. SLUMP (AT POINT OF CONCRETE PLACEMENT) SHALL BE 3 INCH MINIMUM AND 6 INCH MAXIMUM, 6.3. CONCRETE EXPOSED TO WEATHER SHALL HAVE 5 ½ PERCENT AIR ENTRAINMENT.
- 6.3. CONCRETE EXPOSED TO WEATHER6.4. SUBMIT MIX DESIGNS FOR REVIEW.
- ALL CONCRETE WORK SHALL COMPLY WITH THE REQUIREMENTS OF THE LATEST EDITION OF THE ACI BUILDING CODE (ACI 318), THE ACI DETAILING MANUAL (ACI 315), AND THE SPECIFICATIONS FOR STRUCTURAL CONCRETE FOR BUILDING (ACI 301).
- 8. ALL REINFORCING STEEL SHALL BE MANUFACTURED FROM HIGH STRENGTH BILLET STEEL CONFORMING TO ASTM DESIGNATION A615 GRADE 60. WWF SHAL COMPLY WITH ASTM A185.
- 9. LAP ALL BARS MINIMUM 48 BAR DIAMETERS. LAP ALL WWF A MINIMUM OF 12 INCHES.

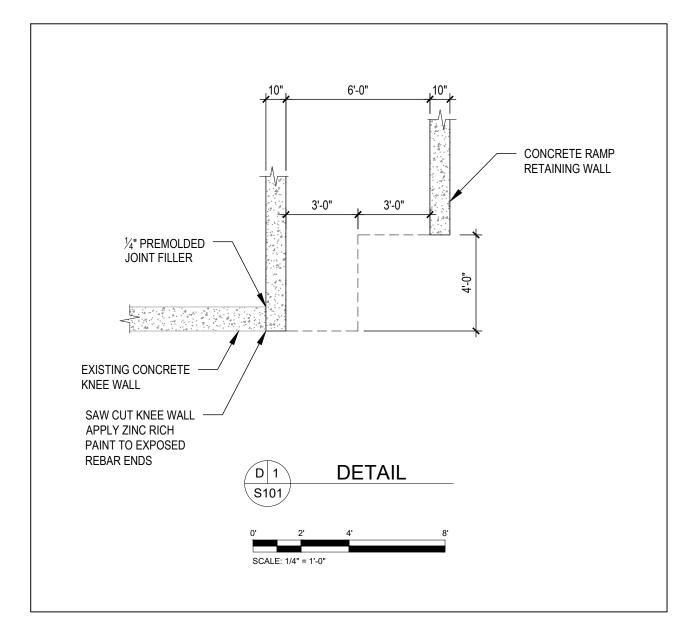

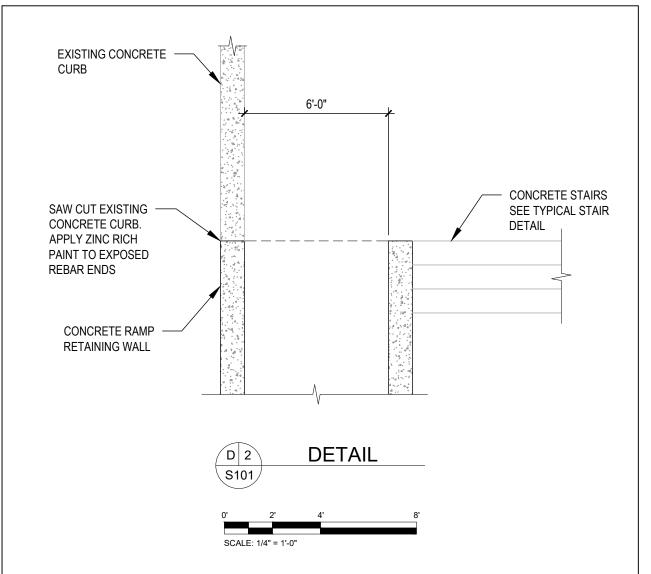

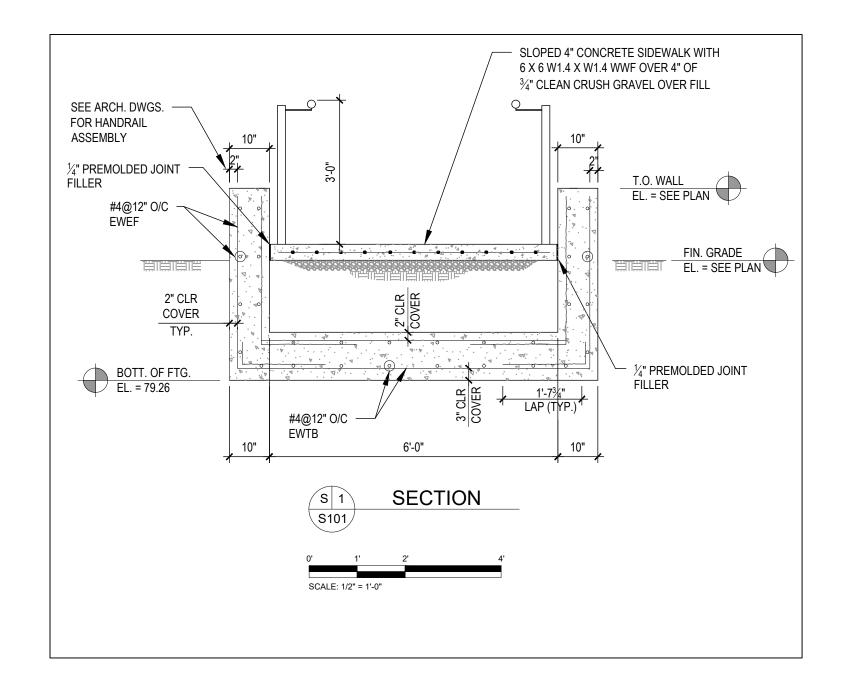

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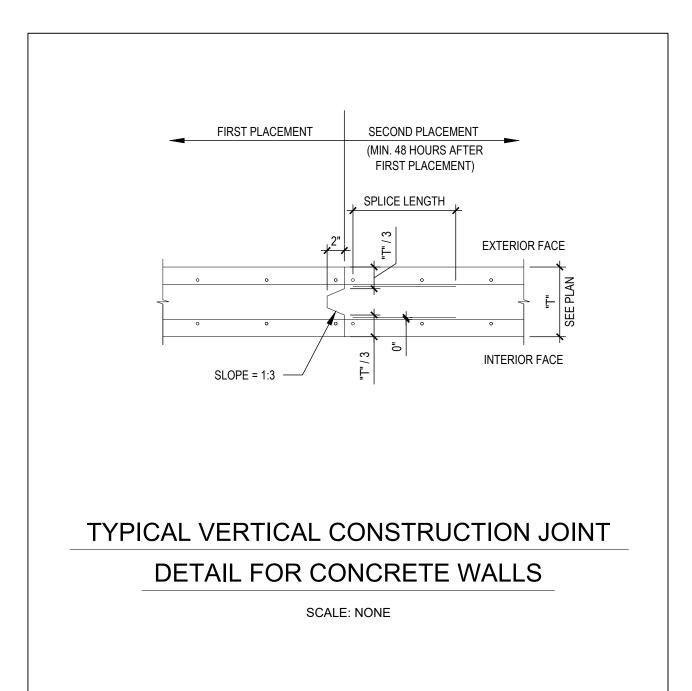
#3 BAR @ EACH NOSING


MIN. 4" CRUSH STONE

#4 @ 12" E.W.


TYPICAL STAIR SECTION

1 6 0 1 2 2 2 2 1 - 0"



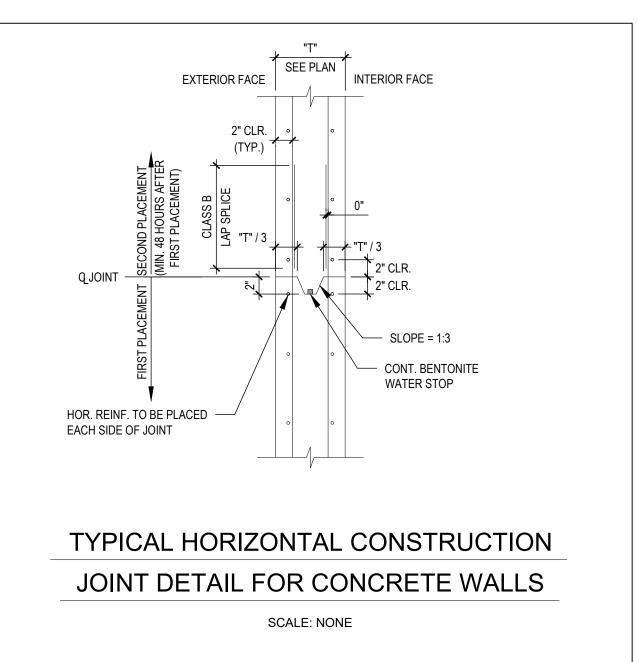

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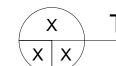


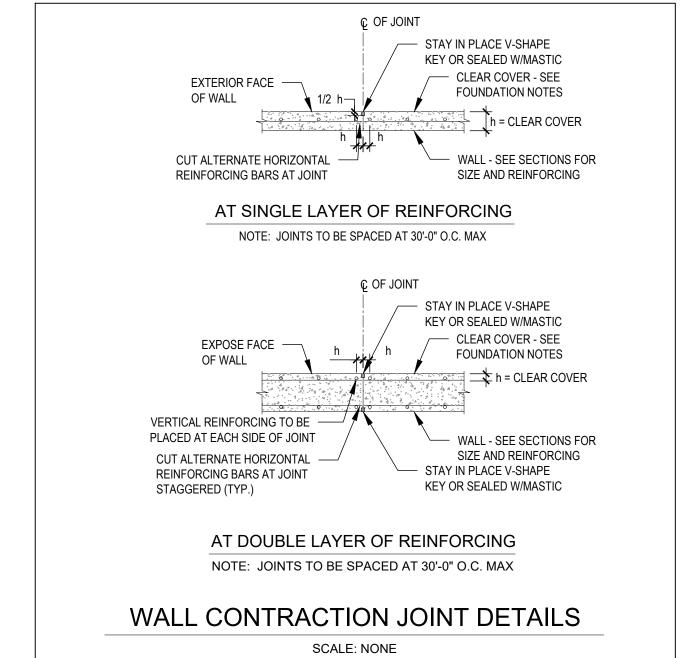REINFORCING BARS
OR MESH
(TYP.)

3/4" MIN, 3" MAX.

NOTES:


- TYPE 1 REPAIR IS ONLY APPLICABLE TO CONCRETE SPALLS THAT DO NOT REVEAL STEEL REINFORCING OR WIRE MESH AFTER DETERIORATED CONCRETE HAS BEEN REMOVED.
- 2. REMOVE ALL UNSOUND AND DETERIORATED CONCRETE.
- 3. APPLY EPOXY PATCH MATERIAL AS PER MANUFACTURER'S SPECIFICATIONS AND FINISH TO MATCH EXISTING CONCRETE SURFACES.
- 4. APPROVED EPOXY PATCH MATERIALS FOR VERTICAL AND OVERHEAD REPAIRS:
 - "VERTICOAT" BY THE EUCLID CHEMICAL COMPANY. - "SIKATOP 123 PLUS" BY SIKA CORPORATION.
- 5. APPROVED EPOXY PATCH MATERIALS FOR HORIZONTAL REPAIRS:
 - "EUCO THIN COAT, CONCRETE COAT" BY EUCLID CHEMICAL COMPANY.
 "SIKATOP 121 PLUS" OR "SIKATOP 122 PLUS" BY SIKA CORPORATION.
 "DURATOP" BY L&M CHEMICALS, INC.
- 6. PRODUCT SUBSTITUTIONS ARE PERMITTED SUBJECT TO APPROVAL BY ENGINEER.



TYPE 1 TYPICAL CONCRETE REPAIR

SCALE: NONE

(CONCRETE SPALL WITHOUT EXPOSED REINFORCING)

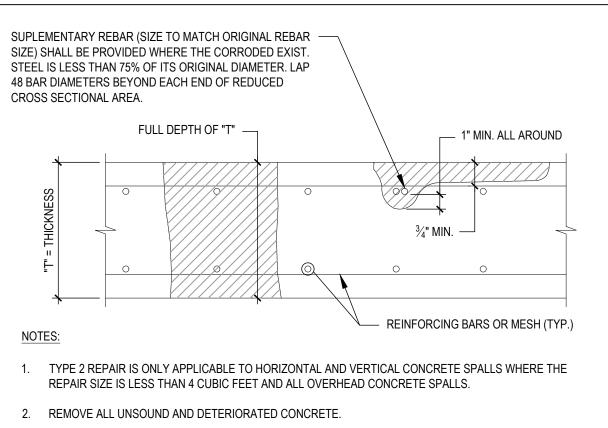


- 3. CLEAN TO BRIGHT METAL ALL EXPOSED REINFORCING STEEL INCLUDING WELDED WIRE FABRIC.
- WHEREVER MORE THAN 25% OF THE DIAMETER OF THE STEEL IS EXPOSED.
 OF CONCRETE REMOVAL AROUND THE BAR IS REQUIRED.
- 5. APPLY EPOXY PATCH MATERIAL AS PER MANUFACTURER'S SPECIFICATIONS AND FINISH TO MATCH EXISTING CONCRETE SURFACES.
- 6. APPROVED EPOXY PATCH MATERIALS FOR VERTICAL AND OVERHEAD REPAIRS:
 "VERTICOAT" BY THE EUCLID CHEMICAL COMPANY.
- VERTICOAT BY THE EUCLID CHEMICAL COMPANY.
 "SIKATOP 123 PLUS" BY SIKA CORPORATION.
- 7. APPROVED EPOXY PATCH MATERIALS FOR HORIZONTAL REPAIRS:

 "EUCO THIN COAT, CONCRETE COAT" BY EUCLID CHEMICAL COMPANY.

 "SIKATOP 121 PLUS" OR "SIKATOP 122 PLUS" BY SIKA CORPORATION.


 "DURATOP" BY L&M CHEMICALS, INC.
- 8. PRODUCT SUBSTITUTIONS ARE PERMITTED SUBJECT TO APPROVAL OF ENGINEER.

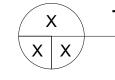

TYPE 2 TYPICAL CONCRETE REPAIR

(OVERHEAD CONCRETE SPALLS AND SMALL HORIZONTAL & VERTICAL CONCRETE SPALLS)

SCALE: NONE

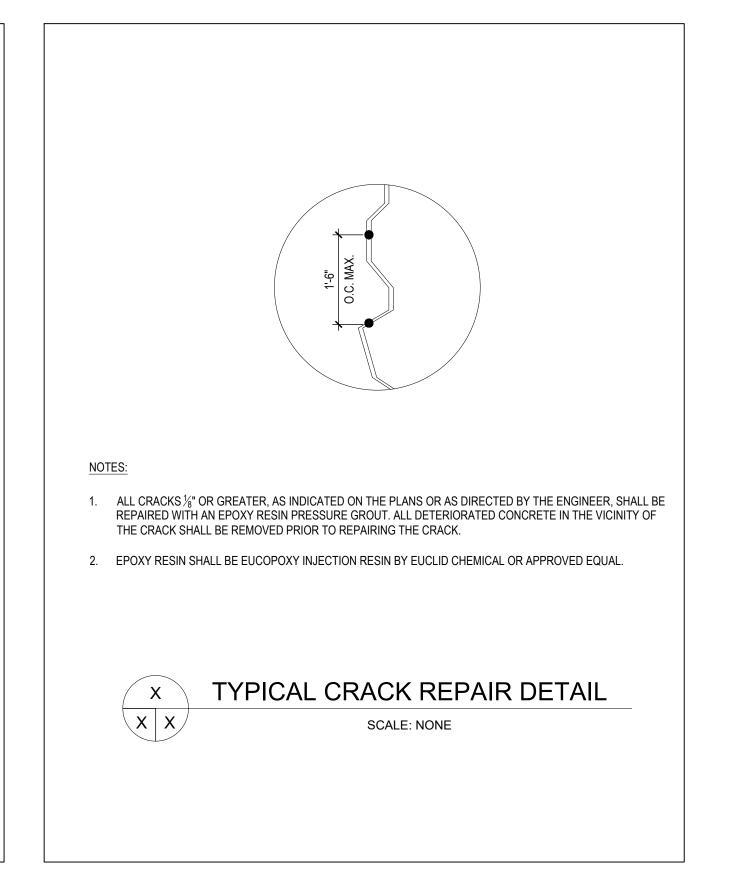

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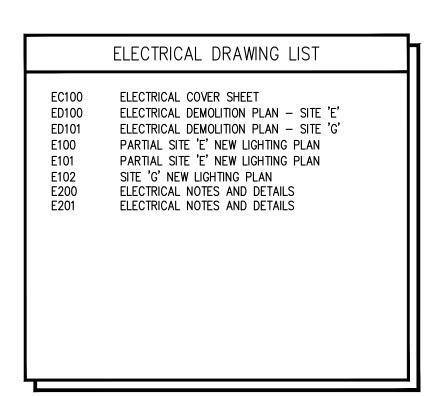
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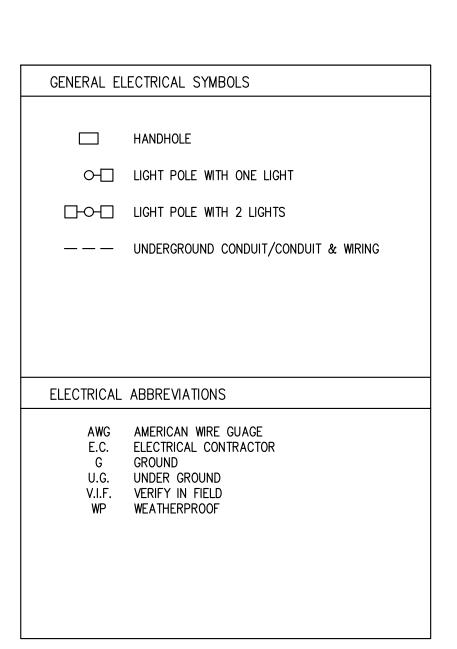
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 CONSTRUCTION DOCUMENTS 100%


STRUCTURAL DETAILS

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Project No.:





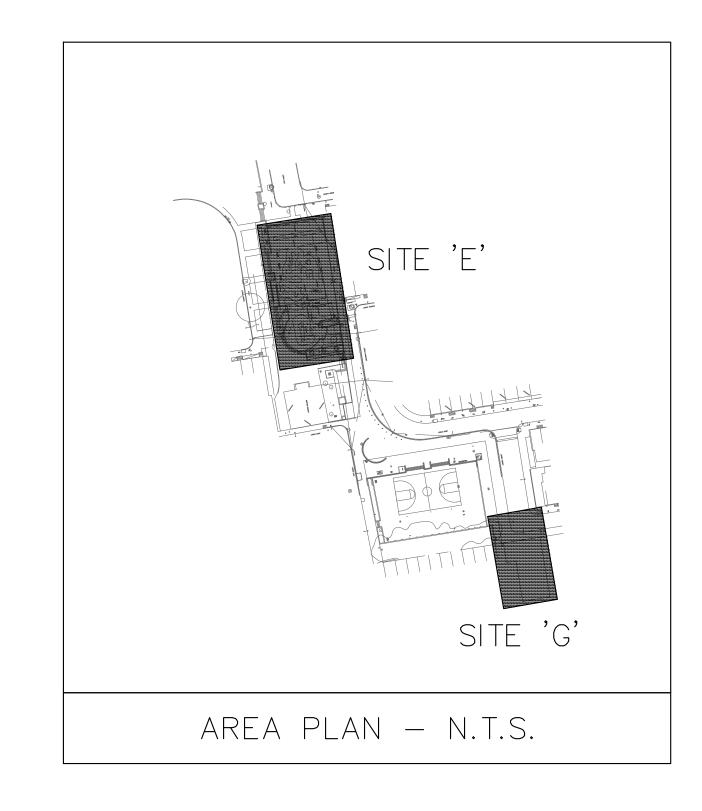

	LIGHTING FIXTURE SCHEDULE								
TYPE	DESCRIPTION	MOUNTING	QTY.	LAMPS LAMP DESIGNATION	MANUFACTURER'S CATALOG NUMBER		INPUT WATTS	VOLTS	REMARKS
A	NEW POLE MOUNTED SINGLE LIGHT FIXTURE ON 14' POLE	MOUNTING ARM	1	47W L.E.D.	SELUX #DSC4L-R2-S1-5G530-40-BK-UNV-TLRP WITH #AT535-156-14-BK-BC3 POLE	4854	47	UNV	POLE MOUNTED L.E.D. LIGHT FIXTURE WITH INTEGRAL PHOTOCELL CONTROL. VERIFY FINISH SELECTION WITH ARCHITECT. INSTALL POLE ON NEW POLE BASE. SEE TYPICAL POLE BASE DETAIL.
В	NEW POLE MOUNTED SINGLE LIGHT FIXTURE ON 20' POLE	MOUNTING ARM	1	62W L.E.D.	SELUX #DSC4L-R4-S1-5G700-40-BK-UNV-TLRP WITH #AT64-156-20-BK-BC9 POLE	6296	62	UNV	POLE MOUNTED L.E.D. LIGHT FIXTURE WITH INTEGRAL PHOTOCELL CONTROL. VERIFY FINISH SELECTION WITH ARCHITECT. INSTALL POLE ON NEW POLE BASE. SEE TYPICAL POLE BASE DETAIL.
С	NEW POLE MOUNTED DOUBLE LIGHT FIXTURE ON 20' POLE	MOUNTING ARM	2	62W L.E.D.	SELUX #DSC4L-R4-S2-5G700-40-BK-UNV-TLRP WITH #AT64-156-20-BK-BC9 POLE	2 @ 6296	124	UNV	POLE MOUNTED L.E.D. DOUBLE LIGHT FIXTURE WITH INTEGRAL PHOTOCELL CONTROL. VERIFY FINISH SELECTION WITH ARCHITECT. INSTALL POLE ON NEW POLE BASE. SEE TYPICAL POLE BASE DETAIL.

GENERAL NOTES FOR LIGHTING FIXTURE SCHEDULE:

- 1. ALL LIGHT FIXTURES SHALL BE AS SCHEDULED ABOVE AND SHALL BE PROVIDED, INSTALLED AND WRED BY ELECTRICAL CONTRACTOR.
- 2. VERIFY ALL FIXTURE WIRING REQUIREMENTS PRIOR TO INSTALLING FIXTURES AND WIRE.
- 3. VERIFY ALL LIGHT FIXTURE SELECTIONS AND FINISH COLORS WITH ARCHITECT.
- 4. PROVIDE WITH INTEGRAL PHOTOCELL CONTROL.
- 5. PROVIDE ALL FIXTURES COMPLETE WITH LAMPS.
- 6. PROVIDE ALL L.E.D. FIXTURE WITH COMPATIBLE DRIVERS. PROVIDE COMPATIBLE DIMMING DRIVER WHERE FIXTURES ARE CONTROLLED VIA DIMMING SWITCH.
- 7. REFER TO ARCHITECTURAL DRAWINGS FOR PRECISE LOCATIONS OF LIGHT FIXTURES.

GENERAL REQUIREMENTS FOR ELECTRICAL WORK

С

- 1. CONTRACTOR SHALL PROVIDE LABOR, MATERIAL, EQUIPMENT AND SERVICES FOR THE PROPER INSTALLATION AND OPERATION OF THE ELECTRICAL WORK AS INDICATED ON THE DRAWINGS AND AS SPECIFIED.
- 2. LABOR, MATERIAL, EQUIPMENT AND SERVICE OBVIOUSLY NECESSARY FOR THE PROPER INSTALLATION AND OPERATION OF ELECTRICAL SYSTEMS, ALTHOUGH NOT SPECIFICALLY MENTIONED OR SHOWN, SHALL BE
- 3. ELECTRICAL WORK SHALL CONFORM TO THE LATEST EDITIONS OF THE <u>NATIONAL ELECTRIC CODE</u> AND <u>APPLICABLE LAWS</u>, <u>CODES AND REGULATIONS OF MUNICIPAL</u>, <u>COUNTY</u>, <u>STATE</u>, <u>FEDERAL AUTHORITIES</u>, <u>UTILITY COMPANIES</u>, <u>INSURANCE AGENCIES</u> AND OTHER <u>AUTHORITIES HAVING JURISDICTION OVER THE WORK</u>.
- 4. CONTRACTOR AND ALL EMPLOYEES SHALL FAMILIARIZE THEMSELVES WITH OWNERS, STATE, LOCAL AND FEDERAL CONSTRUCTION SAFETY GUIDELINES PRIOR TO THE COMMENCEMENT OF WORK.
- 5. OBTAIN, PAY FOR AND DELIVER PERMITS AND CERTIFICATES OF INSPECTION AS REQUIRED BY THE AUTHORITIES HAVING JURISDICTION. DELIVER CERTIFICATES TO THE OWNER PRIOR TO FINAL ACCEPTANCE OF THE WORK. AN ELECTRICAL INSPECTION CERTIFICATE, FOR EACH CLASS OF WORK REQUIRING INSPECTION, MUST BE SUBMITTED PRIOR TO OR WITH THE FINAL PAYMENT INVOICE. CONTRACTOR MUST MAKE APPLICATION FOR THE INSPECTION, COORDINATE SAME, AND PAY THE REQUIRED INSPECTION FEE.
- 6. BEFORE SUBMITTING HIS BID, TRADE CONTRACTOR SHALL VERIFY EXISTING CONDITIONS IN THE FIELD. FAILURE TO DO SO SHALL NOT RELIEVE TRADE CONTRACTOR OF HIS OBLIGATION TO PAY FOR COSTS THAT MAY BE INCURRED DUE TO CONDITIONS THAT MAY AFFECT THE COST OF INSTALLING HIS WORK.
- 7. DRAWINGS ARE DIAGRAMMATIC, SMALL SCALE AND INDICATE THE GENERAL ARRANGEMENT OF SYSTEMS AND WORK INCLUDED. HOWEVER, CERTAIN RACEWAYS, BENDS, FITTINGS, BOXES, SYSTEM COMPONENTS, APPURTENANCES AND RELATED SPECIALTIES ARE NOT SHOWN, BUT SHALL BE PROVIDED TO INSURE A COMPLETE INSTALLATION.
- 8. CONSULT THE DRAWINGS FOR EXACT LOCATION OF FIXTURES AND EQUIPMENT. WHERE SAME ARE NOT DEFINITELY LOCATED, OBTAIN THIS INFORMATION FROM THE ARCHITECT/ENGINEER.
- 9. INCIDENTAL ACCESSORIES NECESSARY TO MAKE THE WORK COMPLETE AND READY FOR OPERATION, EVEN IF NOT PARTICULARLY SPECIFIED OR SHOWN, SHALL BE PROVIDED WITHOUT ADDITIONAL EXPENSE. MINOR DETAILS NOT USUALLY SHOWN OR SPECIFIED, BUT MANIFESTLY NECESSARY FOR THE PROPER INSTALLATION AND OPERATION OF THE VARIOUS SYSTEMS, SHALL BE INCLUDED IN THE WORK, THE SAME AS IF SPECIFIED OR SHOWN ON THE DRAWINGS. NO SUCH DEPARTURES SHALL BE MADE WITHOUT PRIOR WRITTEN REVIEW.
- 10. NO CONSIDERATION OR ALLOWANCE SHALL BE GRANTED FOR ALLEGED MISUNDERSTANDING OF MATERIALS AND EQUIPMENT TO BE FURNISHED FOR WORK TO BE ACCOMPLISHED.
- 11. WORK FURNISHED UNDER THE CONTRACT SHALL BE WARRANTED AGAINST DEFECTS IN WORKMANSHIP AND MATERIALS FOR A PERIOD OF NOT LESS THAN ONE (1) YEAR, OR AS OTHERWISE SPECIFIED, FROM THE DATE OF FINAL ACCEPTANCE.
- 12. MATERIAL AND EQUIPMENT IN THE WORK SHALL BE NEW, FIRST GRADE, FIRST CLASS, THE BEST OF THEIR RESPECTIVE KINDS, APPROPRIATE FOR THE APPLICATION AND ENVIRONMENT.
- 13. EQUIPMENT OR APPARATUS FOR ANY ONE SYSTEM SHALL BE THE PRODUCT OF ONE MANUFACTURER. THE TERM "MANUFACTURER" SHALL BE UNDERSTOOD AS APPLYING TO A COMPANY OF ESTABLISHED REPUTATION IN THE MANUFACTURE OF A PARTICULAR PIECE OF EQUIPMENT OR APPARATUS FROM PRODUCTS OF HIS OWN MAKE OR OTHERS, AND WHO ASSUMES FULL RESPONSIBILITY FOR PRODUCTS USED IN SUCH EQUIPMENT OR APPARATUS. THE MANUFACTURER MUST SUBMIT EVIDENCE OF FIVE (5) YEARS OR MORE MANUFACTURING EXPERIENCE IN THE PRODUCTION OF THESE PRODUCTS.
- 14. MATERIAL OR EQUIPMENT SPECIFIED BY MANUFACTURER, BRAND NAME, TYPE, OR CATALOG NUMBER ARE DESIGNED TO ESTABLISH STANDARDS OF DESIRED QUALITY, STYLE, PERFORMANCE, ELECTRICAL, MECHANICAL AND PHYSICAL CHARACTERISTICS, AND DIMENSIONS.
- 15. WHERE CABLE PASSES THROUGH FIRE RATED STRUCTURES PROVIDE FIREPROOF FITTINGS.
- 16. RACEWAYS SHALL BE CONCEALED IN THE CONSTRUCTION EXCEPT AS OTHERWISE SPECIFIED OR SHOWN.
- 17. WHERE CONDUIT TERMINATES IN A CABINET, BOX OR AUXILIARY GUTTER, THE CONDUCTORS SHALL BE PROTECTED BY AN INSULATING BUSHING. LOCKNUTS SHALL BE PROVIDED BOTH INSIDE AND OUTSIDE THE FNCI OSURE. WEATHERPROOF WHERE REQUIRED.
- 18. A PULL WIRE SHALL BE INSTALLED IN EMPTY RACEWAYS. PULL WIRE SHALL BE 200 POUND TEST NYLON. BOTH ENDS SHALL BE IDENTIFIED BY MEANS OF LABELS OR TAGS, READING "PULL WIRE" AND GIVING THE ORIGINATION AND TERMINATION POINTS.
- 19. GENERALLY, WIRING (OTHER THAN EMERGENCY) SHALL BE DONE WITH INSULATED COPPER CONDUCTORS IN CONTINUOUSLY GROUNDED METAL CONDUIT (EMT). CONDUCTORS AND RACEWAYS SHALL BE FIRST GRADE, INSTALLED CONCEALED IN THE CONSTRUCTION EXCEPT IN MECHANICAL OR ELECTRICAL SPACES, OPEN CONSTRUCTION AREAS OR WHERE SHOWN ON THE DRAWINGS.
- 20. LINE VOLTAGE AND LOW VOLTAGE WIRING SHALL BE RUN IN SEPARATE RACEWAYS.
- 21. EMERGENCY WIRING SHALL BE DONE WITH INSULATED COPPER CONDUCTORS IN CONTINUOUSLY GROUNDED METAL CONDUIT (EMT), SEPARATE FROM ALL OTHER WIRING AND RACEWAYS. CONDUCTORS AND RACEWAYS SHALL BE FIRST GRADE, INSTALLED CONCEALED IN THE CONSTRUCTION EXCEPT IN MECHANICAL OR ELECTRICAL SPACES, OPEN CONSTRUCTION AREAS OR WHERE SHOWN ON THE DRAWINGS.
- 22. RACEWAYS SHALL BE SUPPORTED TO COMPLY WITH NEC.

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- 23. NO "THROUGH—WALL" BOXES SHALL BE PERMITTED. WHERE DRAWINGS INDICATE BOXES BACK—TO—BACK, OR SIMILAR LOCATIONS, SUCH BOXES SHALL BE INSTALLED SEPARATELY, SPACED MINIMUM SIX INCHES APART
- 24. FOR CONDUITS OR CABLES THAT PENETRATE FIRE RATED WALLS, FLOORS, PARTITIONS, OR SLABS, FILL AND SEAL SPACES BETWEEN THE CONDUITS OR CABLES AND THE SLEEVE WITH 2-PART INTUMESCENT FOAM SEALANT CREATING A FIRE STOP EQUAL TO OR EXCEEDING FIRE RATING OF CONSTRUCTION MATERIAL BEING PENETRATED. FIRE SEALANT SHALL PREVENT SPREAD OF FLAME, SMOKE, AIR AND WATER THROUGH THE SLEEVE AND SHALL PASS 3 HOUR TEST PER ASTMA E814 AND UL 1479. FIRE SEALANT SHALL BE INSTALLED IN ACCORDANCE WITH MANUFACTURER'S WRITTEN INSTRUCTIONS.
- 25. ALL CONDUITS AND FLEXIBLE METAL CONDUIT SHALL CONTAIN A GROUNDING CONDUCTOR. CONDUITS ARE NOT TO BE USED AS A GROUNDING CONDUCTOR.
- 26. ALL BRANCH CIRCUIT WIRING SUPPLYING NEW RECEPTACLES AND LIGHTING BEING INSTALLED SHALL BE #12 COPPER CONDUCTORS MINIMUM.
- 27. CONTRACTOR SHALL SUPPLY AND INSTALL ADDITIONAL BRANCH CIRCUITS (BREAKERS, RACEWAYS, WIRING, ETC..)
 AS REQUIRED TO COMPLETE THE PROJECT.
- 28. JUNCTION BOX AND HANDHOLE LOCATIONS SHOWN ON PLANS ARE DIAGRAMMATIC ONLY. CONTRACTOR SHALL DETERMINE FINAL LOCATIONS OF ALL JUNCTION BOXES AND HANDHOLES. ALL JUNCTION BOXES SHALL BE INSTALLED IN AN ACCESSIBLE LOCATION AND LABELED WITH SOURCE AND SOURCE VOLTAGE. JUNCTION BOXES CONTAINING EMERGENCY WIRING SHALL HAVE RED COVERS AND LABELED AS ABOVE.
- 29. ALL ELECTRICAL EQUIPMENT SHALL BE LABELED TO COMPLY WITH OSHA AND ANSI/ASME A13.1-2007 STANDARDS FOR THE IDENTIFICATION OF SYSTEMS. THE MARKINGS MUST IDENTIFY THE EQUIPMENT, IT'S ORIGIN AND VOLTAGE OF THE CONTENTS. ALL EQUIPMENT SHALL BE IDENTIFIED USING PHENOLIC NAMEPLATES AND LABELED IN ACCORDANCE WITH THE NOMENCLATURE USED ON THE DRAWINGS AND MUST BE COMPATIBLE WITH THE MIMS SYSTEM.
- 30. CONTRACTOR SHALL PROVIDE TO OWNER A DETAILED AS—BUILT DRAWING OF THE WORK PERFORMED. THIS PLAN SHALL INDICATE THE BRANCH CIRCUITS SUPPLYING EACH LIGHT AND DEVICE ASSOCIATED WITH THE WORK PERFORMED ON THIS PROJECT.

ALSO SEE BOOK SPEC

D

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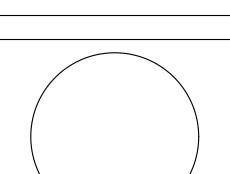
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BHG Consulting, Inc. 1812 South 22nd Street Philadelphia, PA 19145 Phone: 215.755.9318 Fax: 215.755.9319

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- 3 2/21/2025 CD COST ESTIMATE ISSUE
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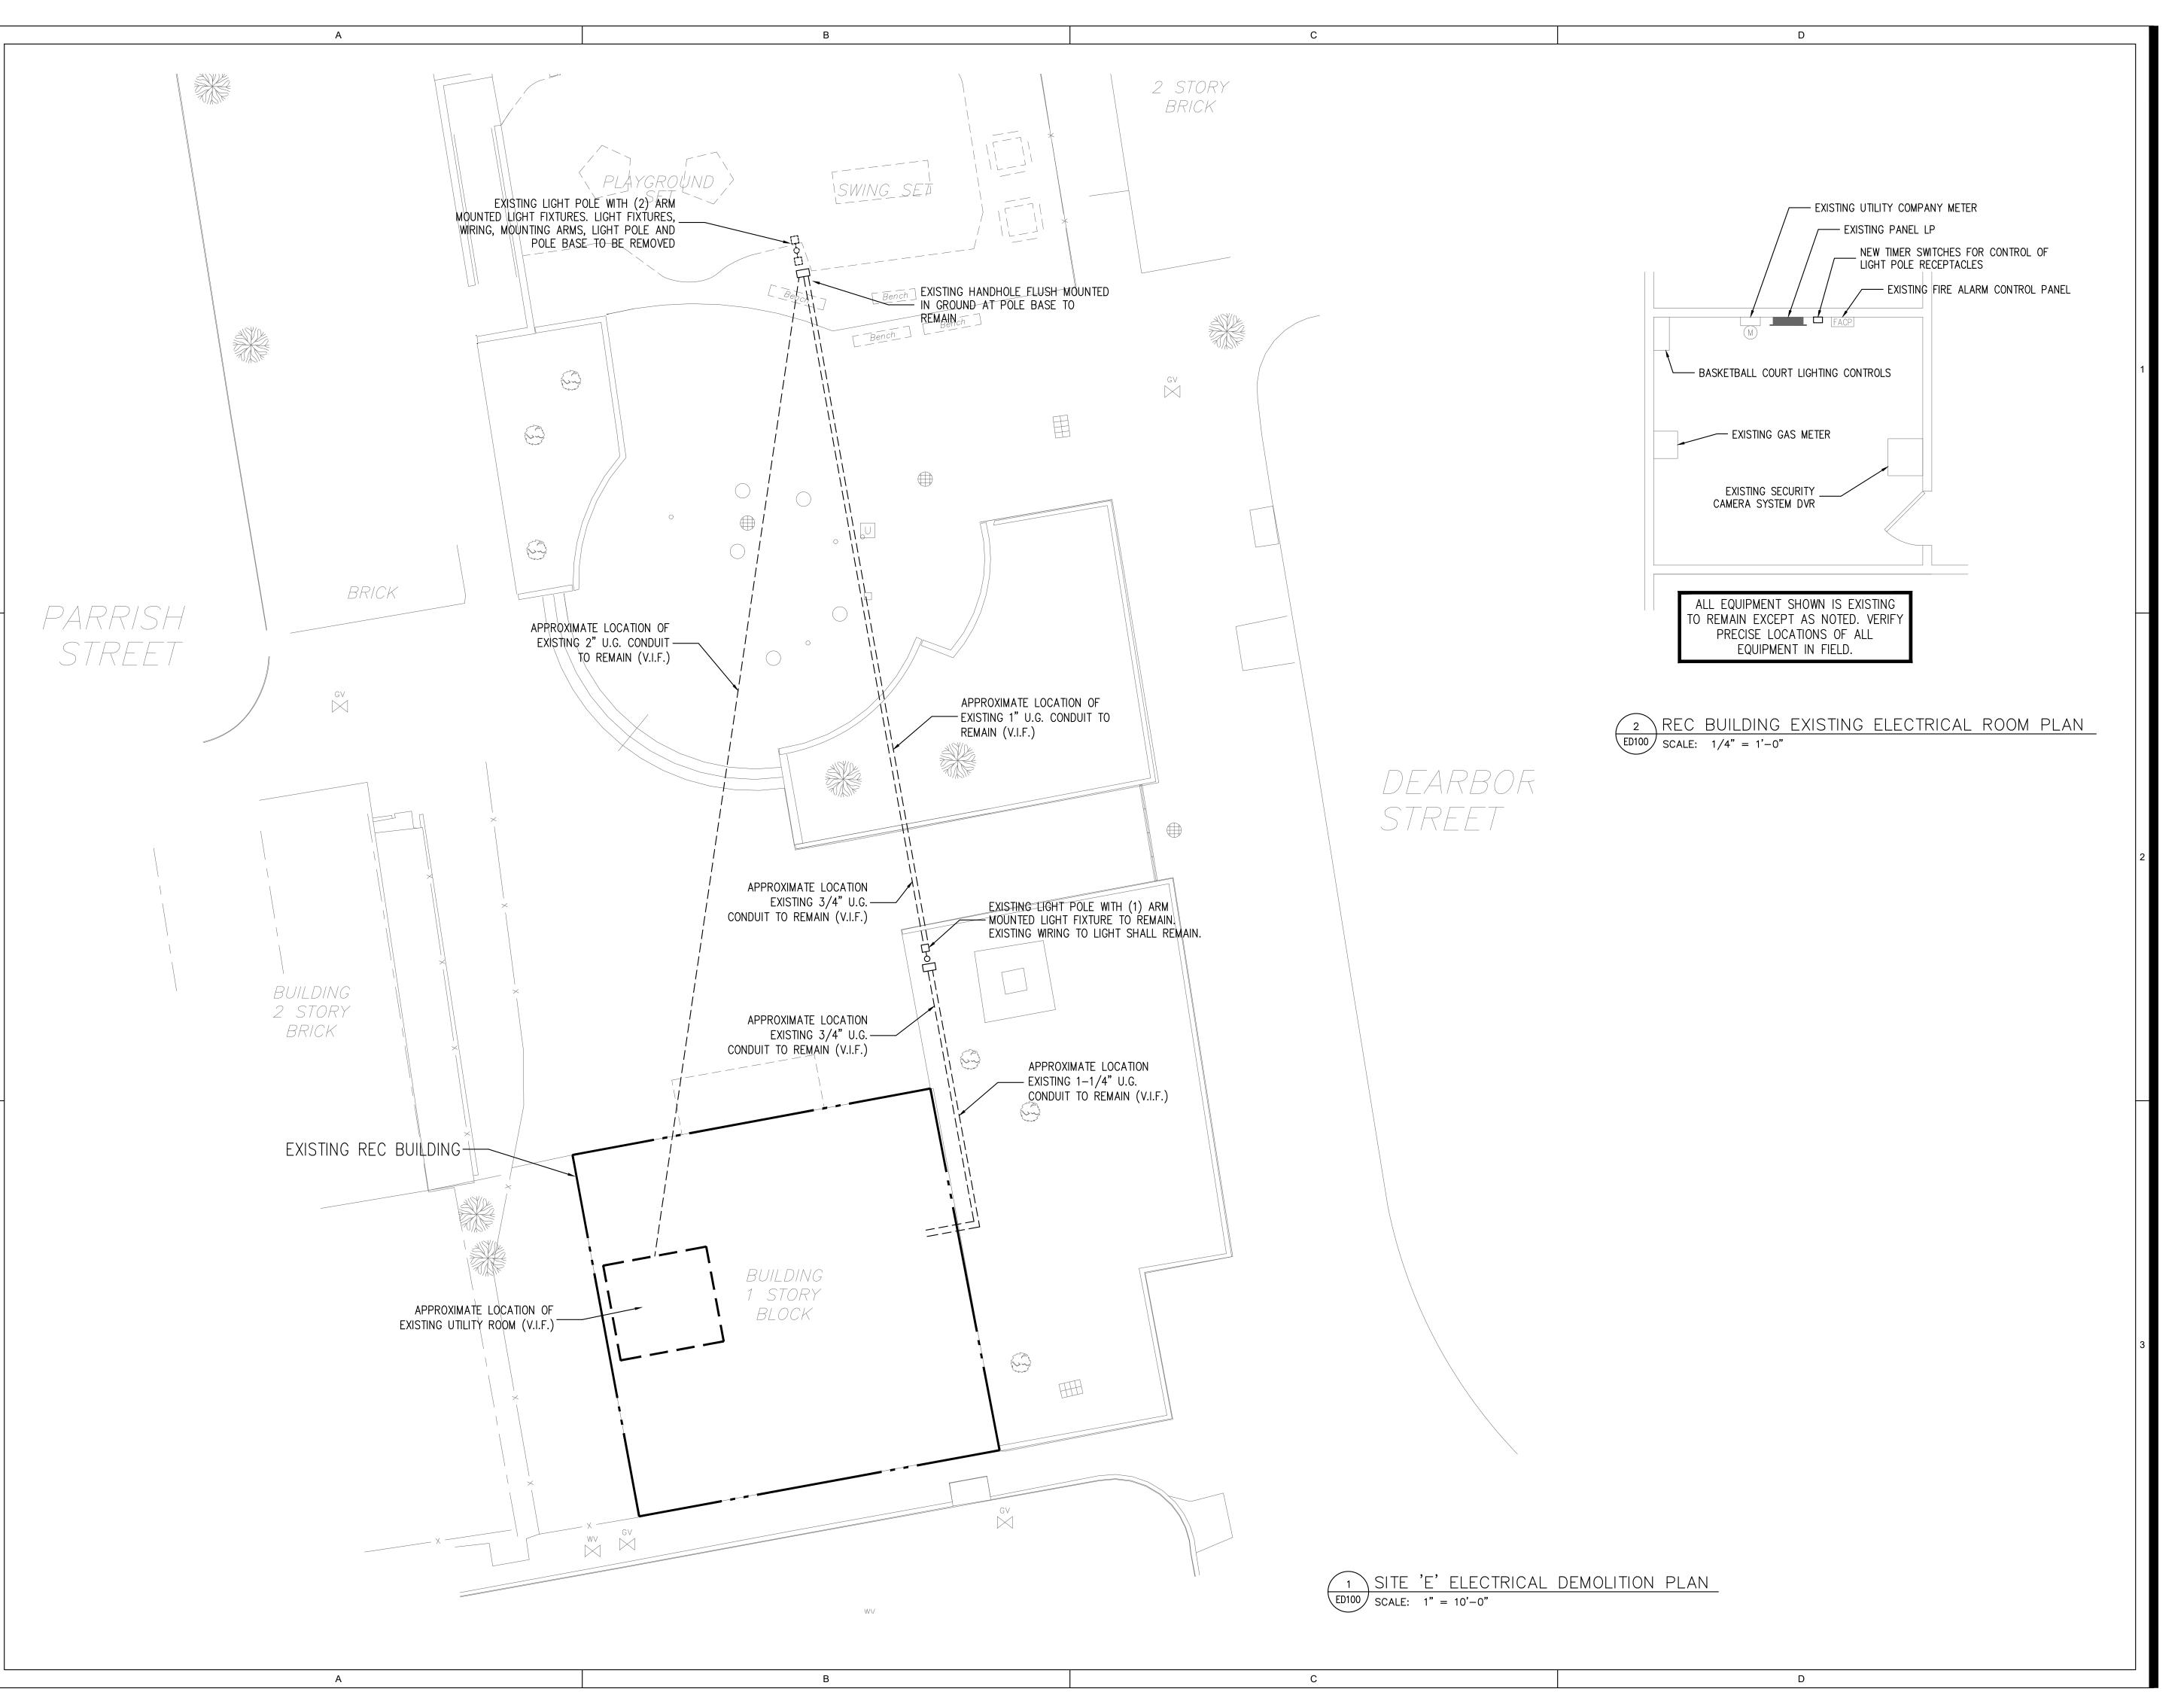
RONALD E. HEIGLER,JR. PE PA. LIC. PE-071002

ELECTRICAL COVER SHEET

Scale: AS N
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AS NOTED 5/9/2025 R.J.W. R.E.H. .: 2409

EC100



5100 Parrish St. Philadelphia, PA 19139

OLIN

LANDSCAPE ARCHITECTURE / URBAN DESIGN / PLANNING
ONE PENN CENTER

1617 JOHN F. KENNEDY BOULEVARD, SUITE 1900
PHILADELPHIA, PA 19103
TEL 215.440.0030 / FAX 215.440.0041
WWW.THEOLINSTUDIO.COM
OLIN PARTNERSHIP, LTD.

Playground Design: Studio Ludo 4800 Springfield Ave Philadelphia, PA 19143 (215) 454-6780

Civil Engineering: Sci Tek 1880 John F Kennedy Blvd #600, Philadelphia, PA 19103 (267) 314-5385

Structural: Arora and Associates, P.C. 190 Brodhead Road, Suite 120, Bethlehem, PA 18017 (484) 895-3131

MEP: Mark Ulrick 30 N. 41ST SUITE 500 Philadelphia, PA 19104 (856) 320-8100

BHG Consulting, Inc. 1812 South 22nd Street Philadelphia, PA 19145 Phone: 215.755.9318 Fax: 215.755.9319


No.	Date	Description

1 7/31/2024 SCHEMATIC DESIGN ISSUE

2 10/10/2024 DESIGN DEVELOPMENT ISSUE

3 2/21/2025 CD COST ESTIMATE ISSUE

3 05/09/2025 100% CD

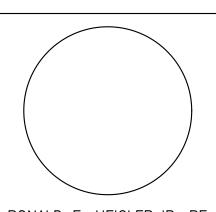

RONALD E. HEIGLER,JR. PE PA. LIC. PE-071002

ELECTRICAL DEMOLITION PLAN - SITE 'E'

Scale: AS NO
Date: 5/9
Drawn: F
Checked: F

AS NOTED


5/9/2025

R.J.W.

R.E.H.

2409

ED100

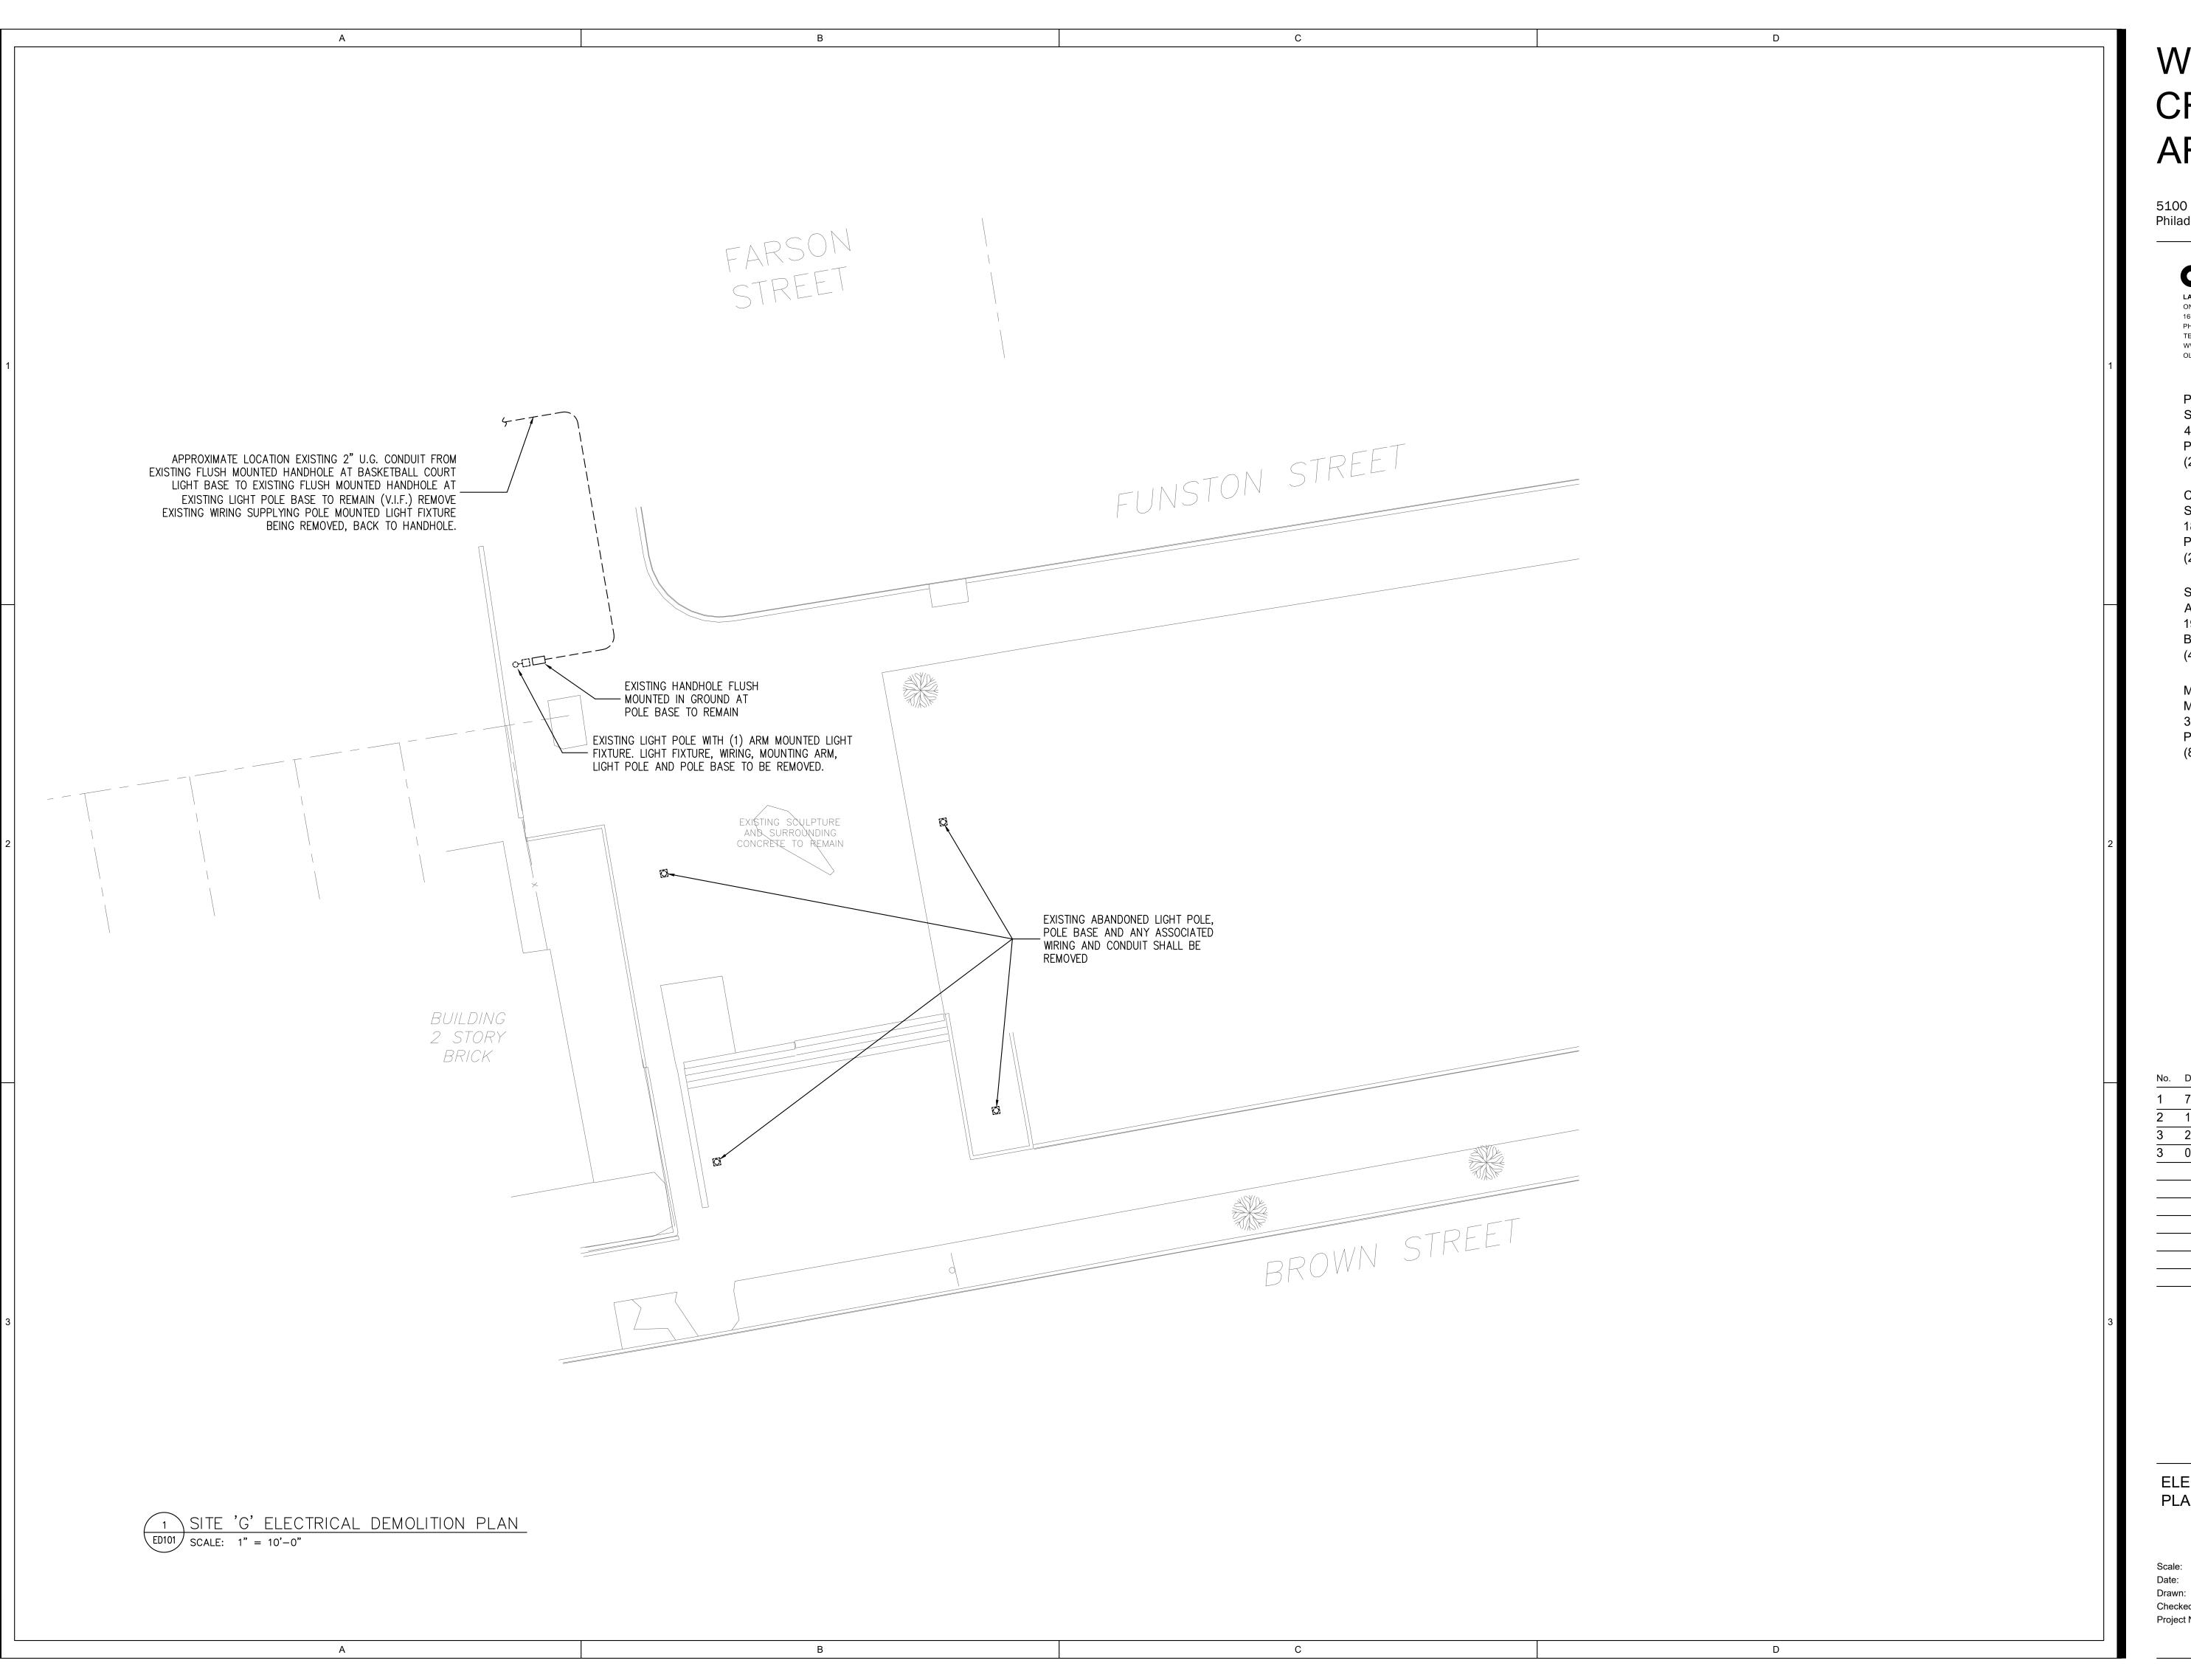

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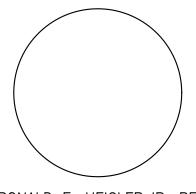
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Philadelphia, PA 19145
Phone: 215.755.9318
Fax: 215.755.9319

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1 7/31/2024 SCHEMATIC DESIGN ISSUE 2 10/10/2024 DESIGN DEVELOPMENT ISSUE

3 2/21/2025 CD COST ESTIMATE ISSUE

3 05/09/2025 100% CD



RONALD E. HEIGLER,JR. PE PA. LIC. PE-071002

ELECTRICAL DEMOLITION PLAN - SITE 'G'

Scale: AS NOTED
Date: 5/9/2025
Drawn: R.J.W.
Checked: R.E.H.
Project No.: 2409

ED101



5100 Parrish St. Philadelphia, PA 19139

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LANDSCAPE ARCHITECTURE / URBAN DESIGN / PLANNING

ONE PENN CENTER 1617 JOHN F. KENNEDY BOULEVARD, SUITE 1900 PHILADELPHIA, PA 19103 TEL 215.440.0030 / FAX 215.440.0041 WWW.THEOLINSTUDIO.COM OLIN PARTNERSHIP, LTD.

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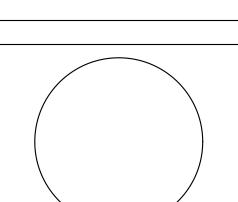
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Description No. Date

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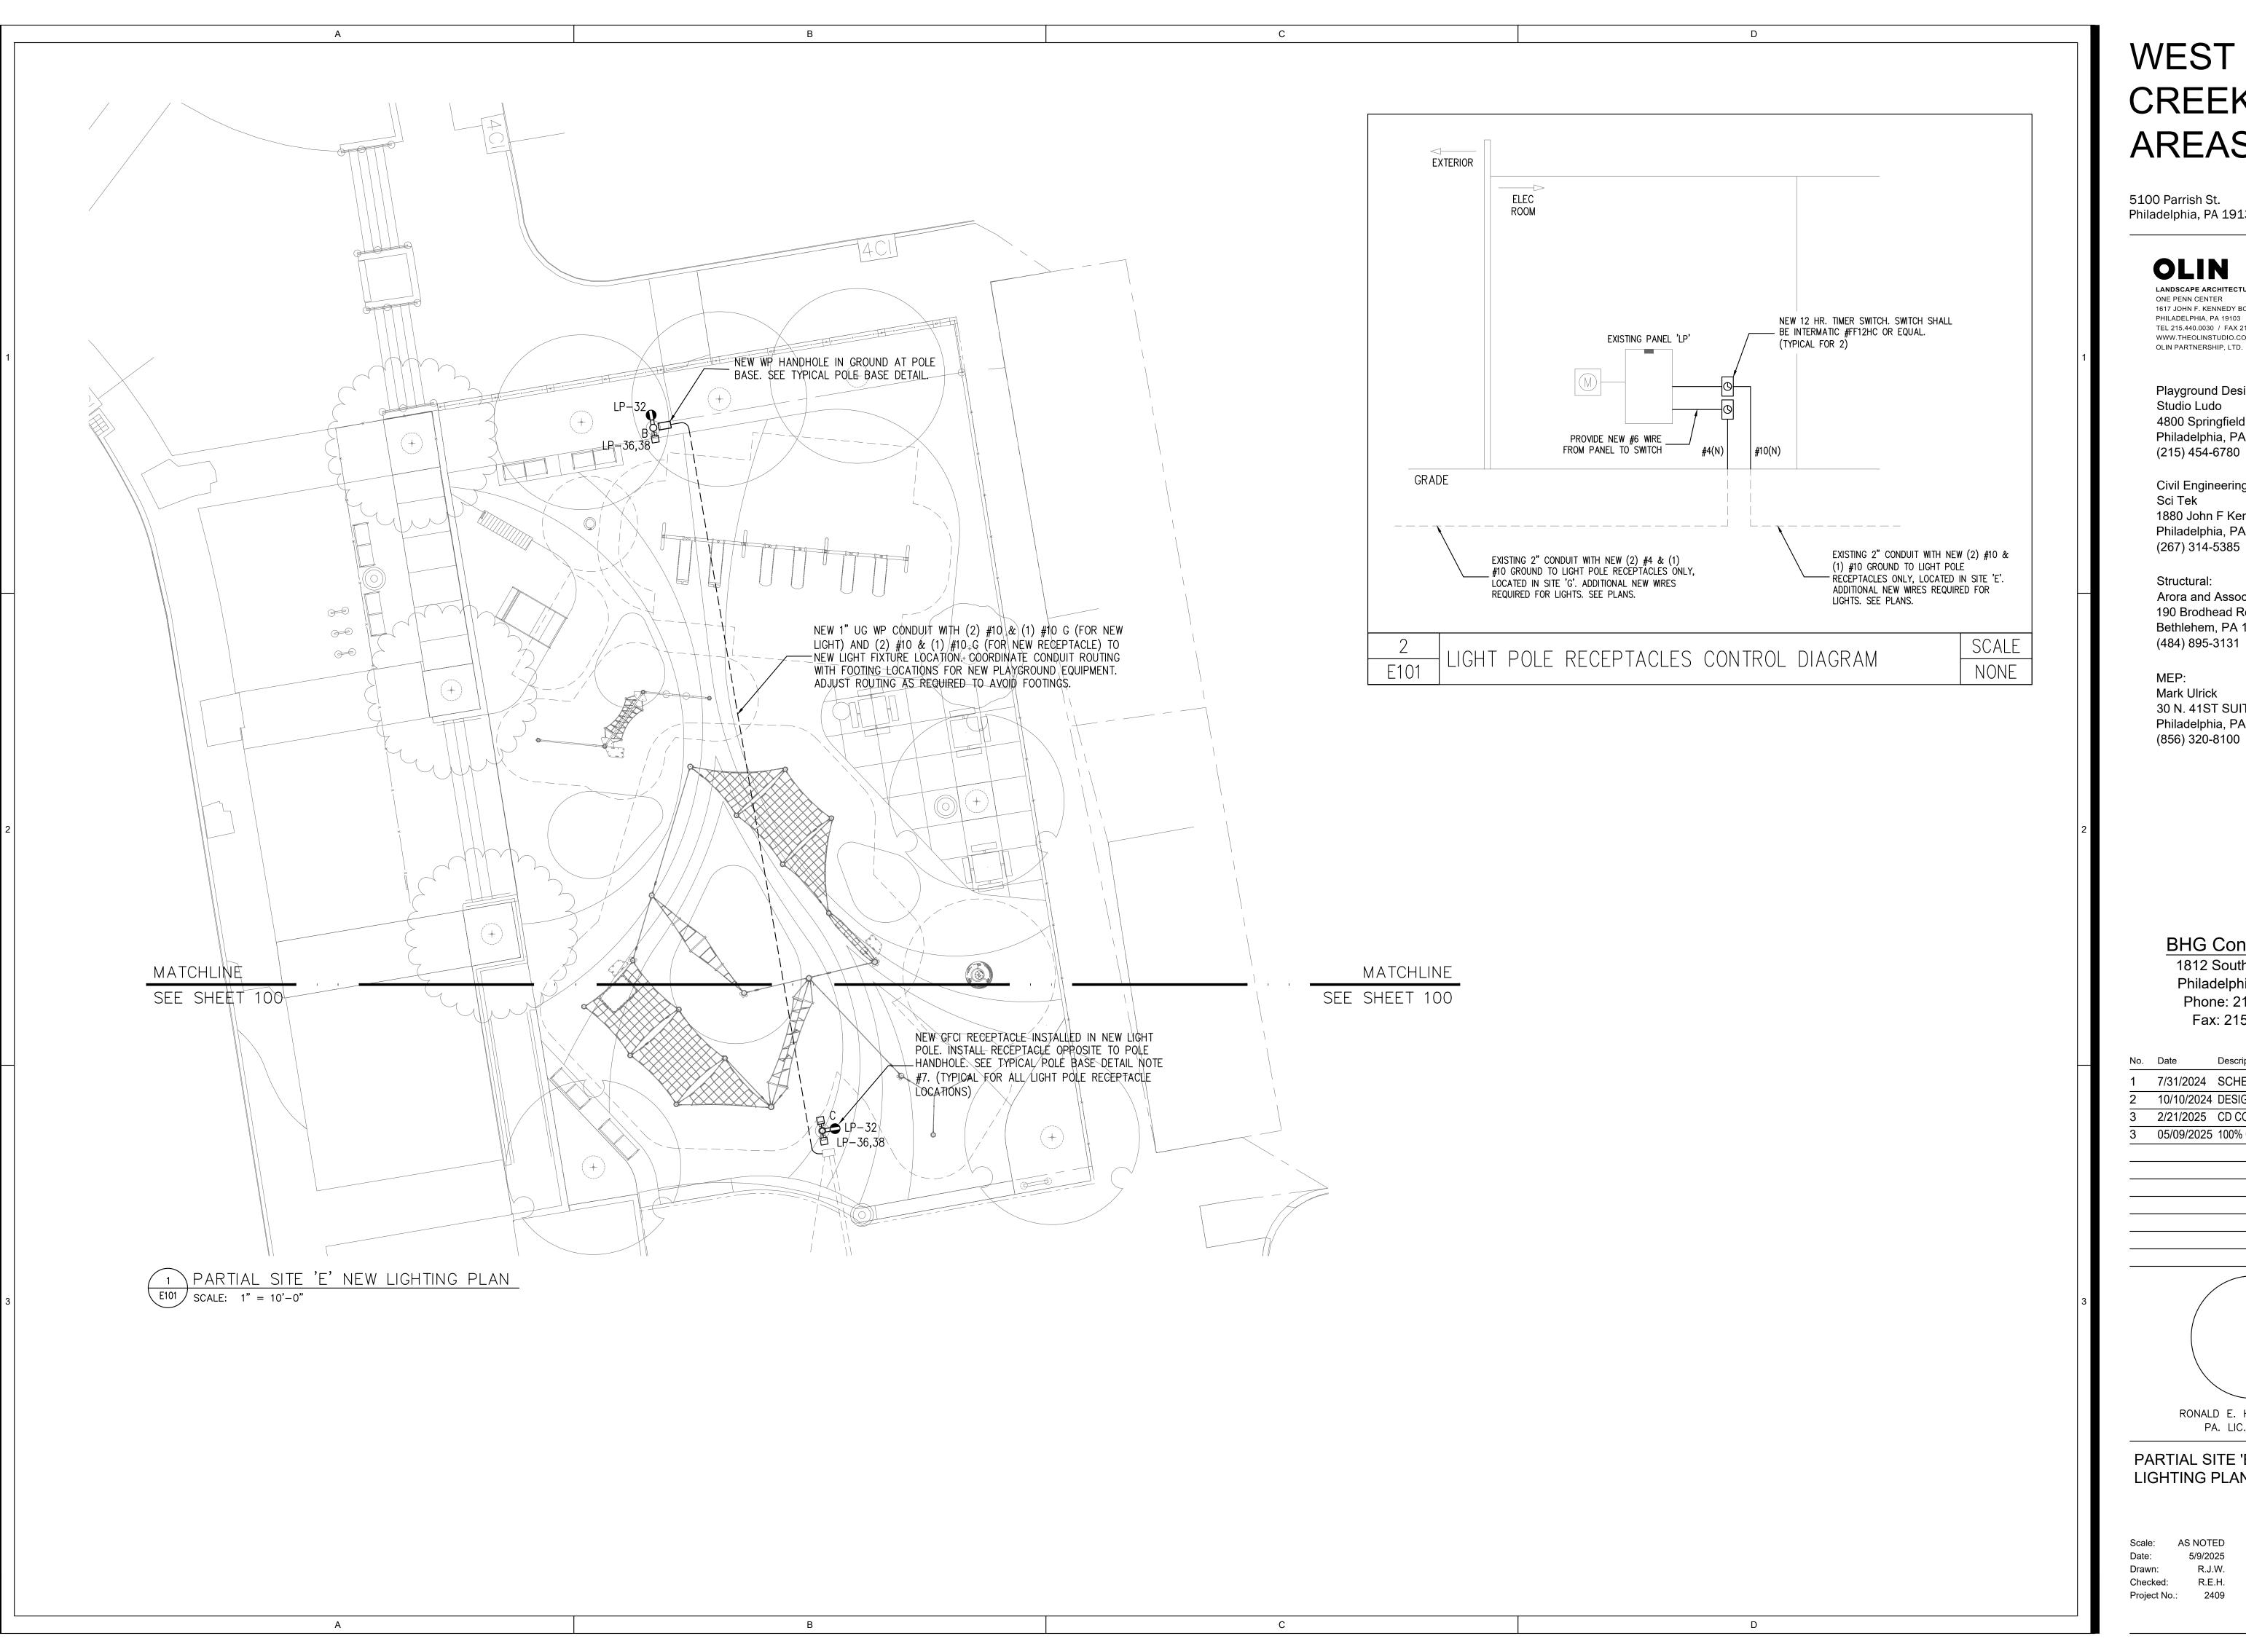
3 05/09/2025 100% CD



RONALD E. HEIGLER,JR. PE PA. LIC. PE-071002

PARTIAL SITE 'E' NEW LIGHTING PLAN

5/9/2025 R.E.H. 2409 Checked:



5100 Parrish St. Philadelphia, PA 19139

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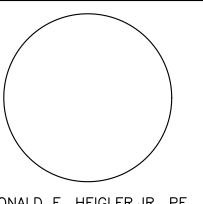
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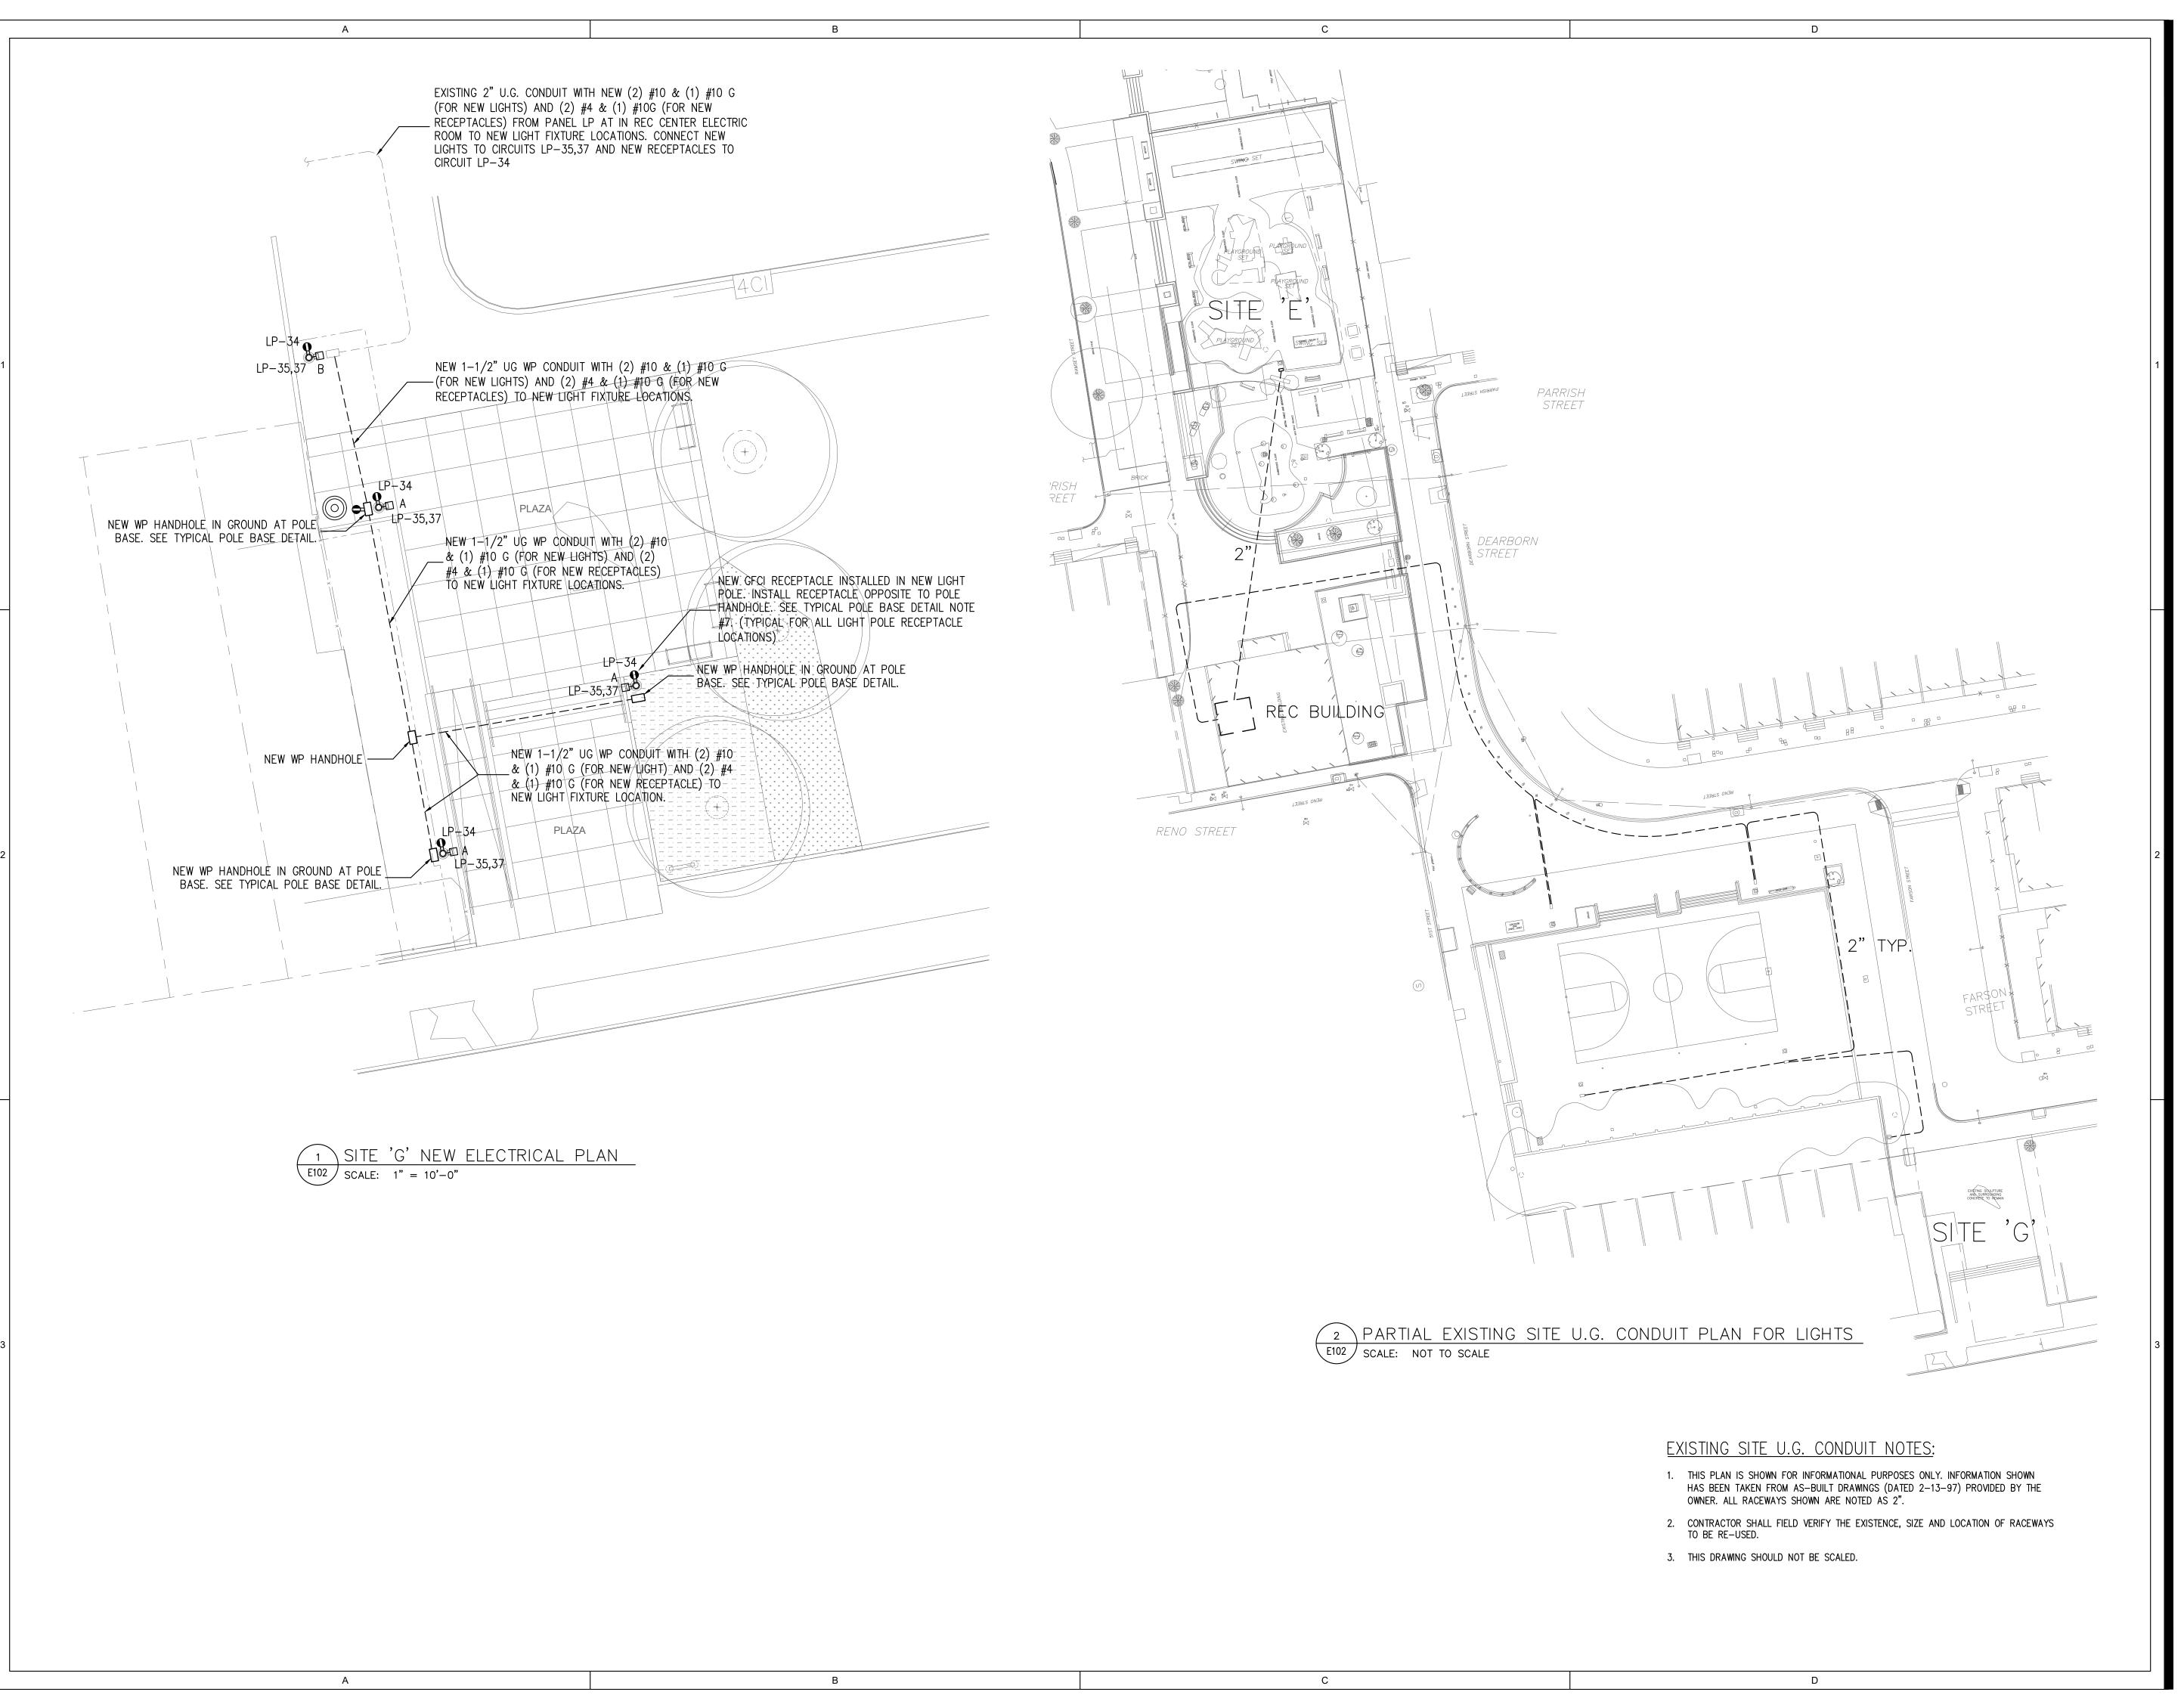
3 05/09/2025 100% CD



RONALD E. HEIGLER,JR. PE PA. LIC. PE-071002

PARTIAL SITE 'E' NEW LIGHTING PLAN

5/9/2025 Drawn: R.E.H. 2409 Checked:



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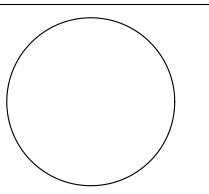
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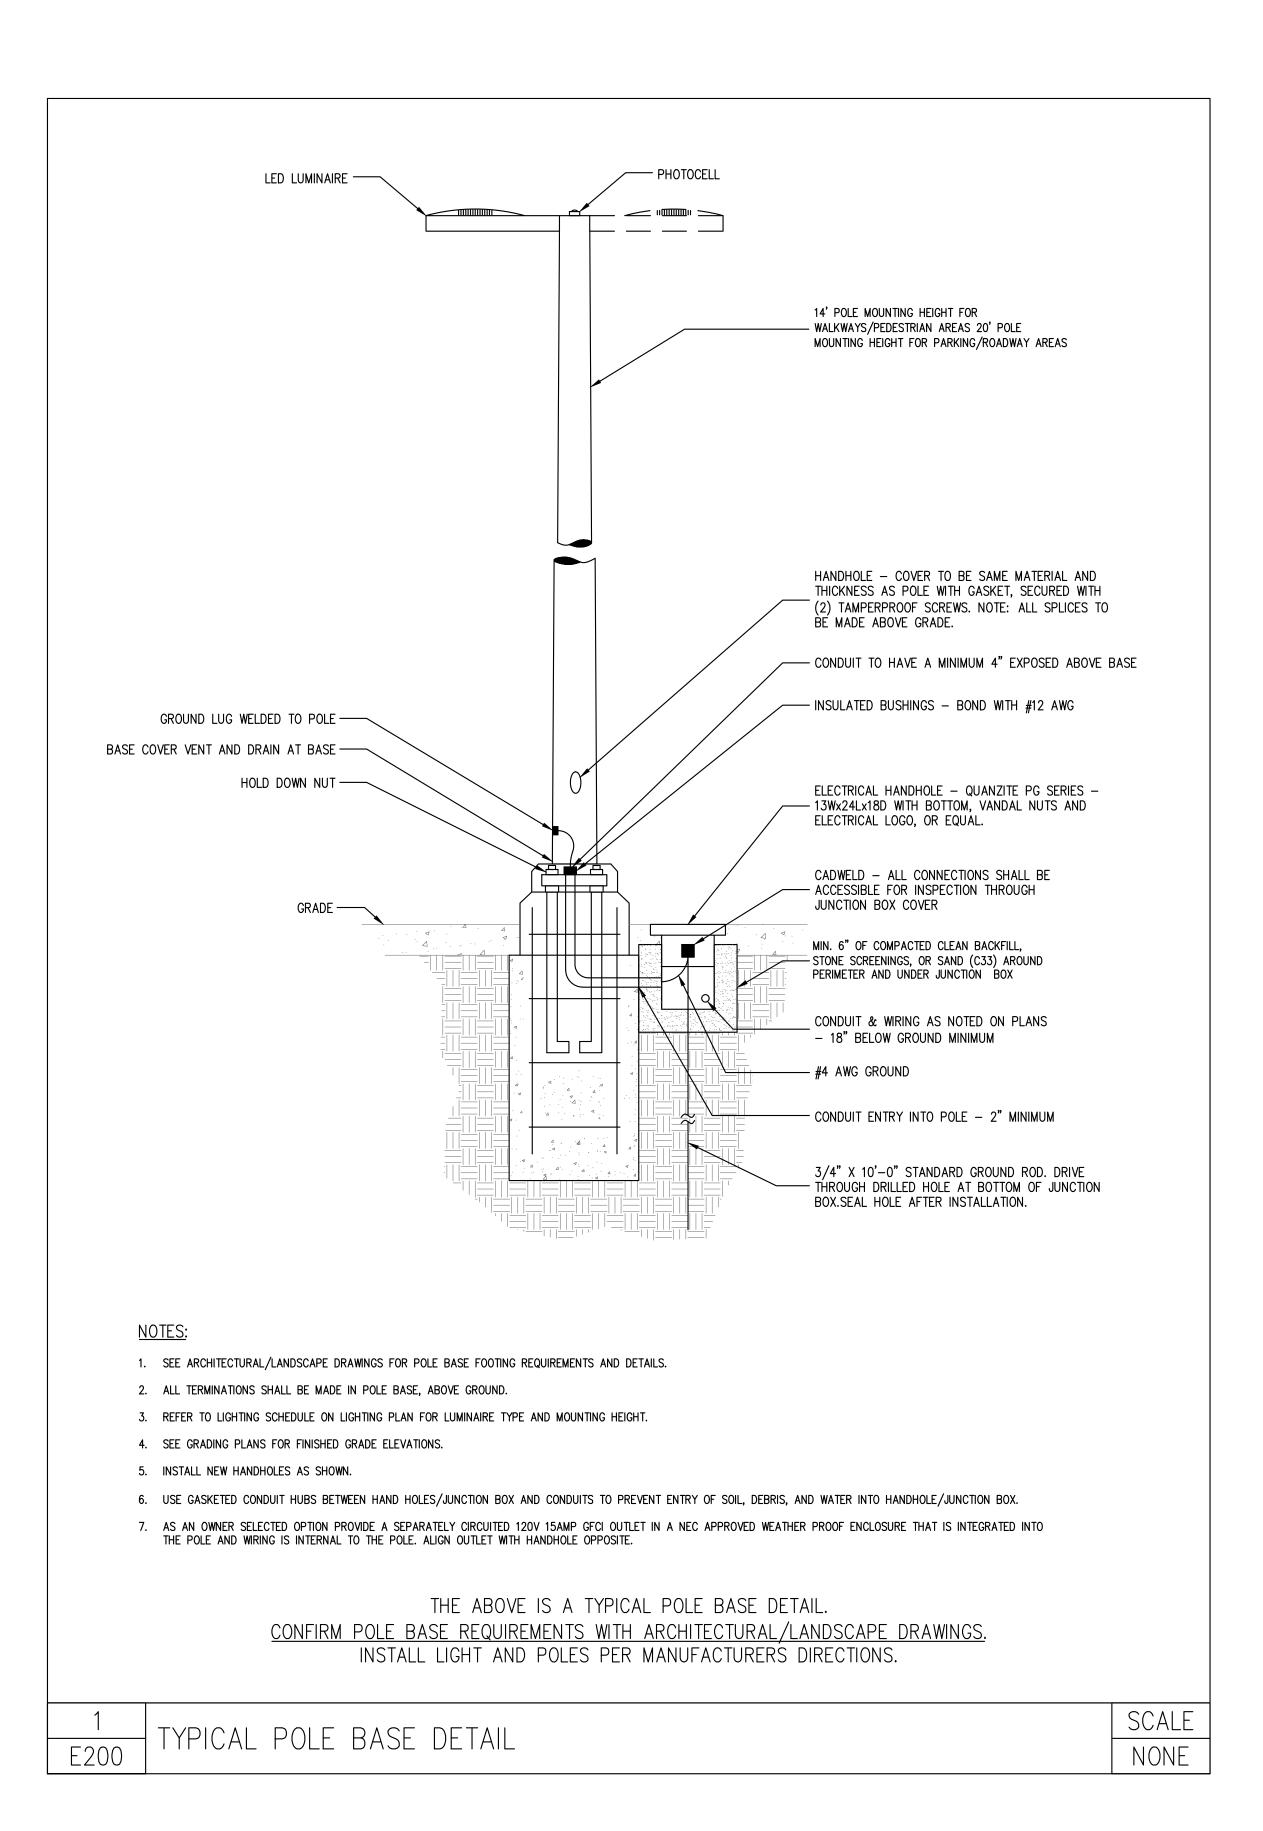


RONALD E. HEIGLER,JR. PE PA. LIC. PE-071002

SITE 'G' NEW LIGHTING PLAN

Scale: AS NOTED
Date: 5/9/2025
Drawn: R.J.W.
Checked: R.E.H.
Project No.: 2409

С



				OUND BUS: OUND BUS:		BAAIA	MAINS: I CIR. BKR.:		200A			
	ANEL LP (EXISTING ARRAI) STING PANEL BOARD	NGEIVIE	:N I)		MOUNTING:				I CIR. BRR.: IC RATING:		200A 3P M.C.B.	
IR.	OTHIO I AND DOARD	WIRE	BREAKER						BREAKER	WIRE		CIF
0.	DESCRIPTION	SIZE	AMPS	POLES	A (VA)	B (VA)	C (VA)	POLES	AMPS	SIZE	DESCRIPTION	NC
	BASKETBALL COURT LIGHTS	(E)	20	2	0			2 2	50	(E)	KILN	2
3	BACKETBALL COOKT LIGHTS	(=)	20			0	4 2	4	30	(=)	KIEN	4
5		(=)		_			0 •			 `		6
,	BASKETBALL COURT LIGHTS	(E)	20	2	0		•	2	30	(E)	AIR CONDITIONER	8
				_		0		1	20	(E)	HEATER	10
1	BASKETBALL COURT LIGHTS (E)		20	2			0	1	20	(E)	VANDAL LIGHTS	1:
3	BASKETBALL COURT LIGHTS (E)				0			1	20	(E)	MULTI PURPOSE ROOM COMPUTERS	1.
5			20	2		0	•	1	20	(E)	MULTI PURPOSE ROOM REFRIGERATOR	10
7			20				0	1	20	(E)	OFFICE & HANDICAP BATHROOM	18
19	BASKETBALL COURT LIGHTS	URT LIGHTS (E)		2	0		•	1	20	(E)	BATHROOM LIGHTS	20
21			20	1		0		1	20	(E)	KITCHENETTE	22
23	HALL & ARTS & CRAFTS LIGHTS	(E)	20	1			0	1	20	(E)	MULTI PRURPOSE RM LIGHTS & RECEPS	24
25	ARTS & CRAFTS RECEPTACLES	(E)	20	1	0			1	20	(E)	FIRE ALARM	26
27	UTILITY ROOM	(E)	20	1		0		1	20			28
29	WATER HEATER	(E)	20	1			0 4	1	20	(E)	VIDEO SYSTEM	30
31			20	1	0		•	1	20			32
33			20	1		0		1	20			34
35			20 (R)	1			0					36
37			20 (R)	1	0		U	2	20	(E)	PLAYGROUND POLE LIGHTS	38
39			20	1	0	0	4					40
11			20	1		U	0	2	30	(E)	ARTS & CRAFTS SUB PANEL	4:
	SUB TOTA	AL			0	0	0				SUB TOTAL	

PANELI	NO		JTRAL BUS: OUND BUS:			VOLTAGE: MAINS:			208Y/120V, 3PH, 4W & G 200A			
	NO. ANEL LP (NEW ARRANGEN					ΜΔΙΝ	I CIR. BKR.:					
	STING PANEL BOARD			ISO GROUND BUS: NO MOUNTING: SURFACE					IC RATING:		200A 01 W.O.B.	
CIR.			BREAKER				0.0(0)		BREAKER	WIRE	DECORIDATION	C
10.	DESCRIPTION	SIZE	AMPS	POLES	A (VA)	B (VA)	C (VA)	POLES	AMPS	SIZE	DESCRIPTION	N
3	BASKETBALL COURT LIGHTS	(E)	20	2	0	0	•	2	50	(E)	KILN	
5 7	BASKETBALL COURT LIGHTS	(E)	20	2	0		0	2	30	(E)	AIR CONDITIONER	
9	DANKETDALL OCUPT HOUTO	(=)				0		1	20	(E)	HEATER	•
11	BASKETBALL COURT LIGHTS	(E)	20	2			0	1	20	(E)	VANDAL LIGHTS	
13					0			1	20	(E)	MULTI PURPOSE ROOM COMPUTERS	
15	BASKETBALL COURT LIGHTS	(E)	20	2		0	l •	1	20	(E)	MULTI PURPOSE ROOM REFRIGERATOR	
17	DACKETDALL COLIDE LIQUITO (E)						0	1	20	(E)	OFFICE & HANDICAP BATHROOM	
19	BASKETBALL COURT LIGHTS	(E)	20	2	0			1	20	(E)	BATHROOM LIGHTS	
21			20	1		0		1	20	(E)	KITCHENETTE	
23	HALL & ARTS & CRAFTS LIGHTS	(E)	20	1			0	1	20	(E)	MULTI PRURPOSE RM LIGHTS & RECEPS	
25	ARTS & CRAFTS RECEPTACLES	(E)	20	1	0			1	20	(E)	FIRE ALARM	
27	UTILITY ROOM	(E)	20	1		0	•	1	20			
29	WATER HEATER	(E)	20	1			0 •	1	20	(E)	VIDEO SYSTEM	
31			20	1	0 360		•	1	20	#10 (N)	(N) AREA 'E' POLE RECEPTACLES	
33			20	1		0 720		1	20	#4 (N)	(N) AREA 'G' POLE RECEPTACLES	;
35	(N) AREA 'G' PLAZA LIGHTING	#10 (N)	20 (N)	2			203 186	2	20	#10 (N)	(N) PLAYGROUND POLE LIGHTS	
37	· , · · · · · · · · · · · · · · · · · ·	. (-7)	V7		0				-	1-7	, ,	
39			20	1		0		2	30	(E)	ARTS & CRAFTS SUB PANEL	L
41			20	1			0	_		(=)		
	SUB TOTA SEND: ** 6mA GROUND FAULT CIRCUIT				360 CTED LOAD	720 1.469	389	REMAR			SUB TOTAL	

NEW LIGHTING LOAD CALCULATION	NS
LOADS ARE SHOWN IN VA EXCEPT AS NOTED	
NEW LIGHTING LOAD BEING ADDED:	389
25% OF NEW LIGHTING LOAD:	97
NEW POLE RECEPTACLES:	1080
TOTAL NEW LOAD BEING ADDED:	1566
EXISTING LIGHTING LOAD BEING REMOVED:	750
TOTAL NEW LOAD BEING ADDED TO SERVICE:	816
TOTAL NEW LOAD BEING ADDED TO SERVICE (AMPS):	2.3

WEST MILL CREEK AREAS E & G

5100 Parrish St. Philadelphia, PA 19139

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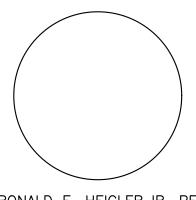
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ELECTRICAL NOTES AND **DETAILS**

AS NOTED 5/9/2025 R.J.W. Drawn: R.E.H. Checked: 2409 Project No.:

2.9 2.5 2.0 1.5 1.0 0.7 0.5 0.3 0.2 0.5 0.8 1.3 1.8 2.2 2.4 2.4 2.3 2.1 1.9 1.2 0.9 0.6 0.4 0.2 0.1 0.2 0.4 0.6 0.9 1.3 2.0 2.1 2.3 2.2 2.3 2.2 2.1 1.4 1.0 0.7 0.4 0.2 0.1 0.2 0.4 0.6 1.0 1.4 2.0 2.2 2.2 2.1 2.2 2.3 2.1 1.5 1.1 0.7 0.4 0.2 0.1 0.2 0.4 0.6 0.9 1.3 1.8 2.3 2.2 2.1 2.0 1.6 1.3 1.0 0.7 0.4 0.3 0.1 0.2 0.3 0.6 0.9 1.2 1.4 1.6 1.6 1.5 1.4 1.3 1.2 1.1 0.9 0.7 0.4 0.3 0. 0.2 0.3 0.5 0.7 1.0 1.1 1.1 1.0 1.0 0.9 0.9 0.8 0.7 0.6 0.4 0.3 0.2 0.1 0.2 0.4 0.6 0.7 0.8 0.8 0.7 0.7 0.7 0.6 0.6 0.6 0.5 0.5 0.3 0.2 0.2 0.1 0.2 0.3 0.4 0.6 0.6 0.5 0.5 0.5 0.5 0.5 0.4 0.4 0.4 0.3 0.3 0.2 0.2 0.1 01 0.2 0.3 0.3 0.4 0.4 0.4 0.4 0.4 0.4 0.3 0.3 0.3 0.3 0.3 0.3 0.3 0.2 0.2


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0.1 0.2 0.3 0.5 0.8 1.2 1.6 2.0 2.4 2.6 2.7 2.8 2.9 2.3 1.7 1.2 0.8 0.5 0.1 0.2 0.3 0.5 0.9 1.3 1.8 2.6 3.0 3.1 2.6 3.3 3.1 2.8 1.9 1.3 0.9 0.5 0.1 0.2 0.3 0.5 0.8 1.3 1.8 27 3.2 37 3.1 4.0 3.6 3.1 2.1 1.4 0.9 0.6 0.1 0.2 0.3 0.5 0.8 1.2 1.8 2.7 3.4 4.2 4.9 4.8 4.2 3.3 2.2 1.4 0.9 0.6 0.1 0.2 0.3 0.4 0.7 1.1 1.6 2.6 3.6 4.7 5.5 5.5 4.6 3.5 2.4 1.6 1.0 0.7 0.4 0.1 0.1 0.2 0.4 0.6 1.0 1.5 2.3 3.4 4.4 5.0 6.0 7.9 3.4 2.6 1.7 1.2 0.8 0.5 0.1 0.2 0.3 0.6 0.9 1.4 2.2 3.1 3.7 4.1 3.2 3.7 3.2 2.7 1.8 1.2 0.8 0.5


0.1 0.2 0.3 0.6 0.9 1.4 2.0 2.9 3.2 3.4 2.1 3.2 3.0 2.6 1.8 1.2 0.8 0.5 0.1 +0.2 +0.3 +0.5 +0.8 +1.2 +1.8 +2.5 +3.0 +2.9 +2.7 +2.7 +2.6 +2.0 +1.6 +1.2 +0.8 +0.5 0.1 0.2 0.3 0.5 0.7 1.1 1.5 1.8 2.1 2.1 2.0 1.8 1.7 1.5 1.3 1.0 0.7 0.5 D 0.1 0.1 0.2 0.4 0.6 0.9 1.2 1.4 1.4 1.4 1.3 1.2 1.1 1.0 0.9 0.8 0.6 0.4 0.3 0.1 0.1 0.2 0.3 0.5 0.7 0.9 1.0 1.0 0.9 0.9 0.8 0.7 0.7 0.6 0.6 0.5 0.3


0.1 +0.1 +0.1 +0.2 +0.4 +0.5 +0.7 +0.7 +0.6 +0.6 +0.5 +0.5 +0.5 +0.4 +0.4 +0.4 0.1 + 0.1 + 0.2 + 0.3 + 0.4 + 0.4 + 0.4 + 0.4 + 0.4 + 0.4 + 0.4 + 0.3 + 0.3 + 0.3 + 0.2 0.1 +0.2 +0.3 +0.3 +0.3 +0.3 +0.2 +0.2 +0.2 +0.2 +0.2 +0.2 0.1 +0.1 +0.1 +0.1 +0.1 +0.1 +0.1 +0.1 0.1 0.1 +0.1 +0.1 +0.1 +0.1 +0.1

1 SITE 'E' LIGHTING FOOT CANDLES PLAN E201 | SCALE: NOT TO SCALE

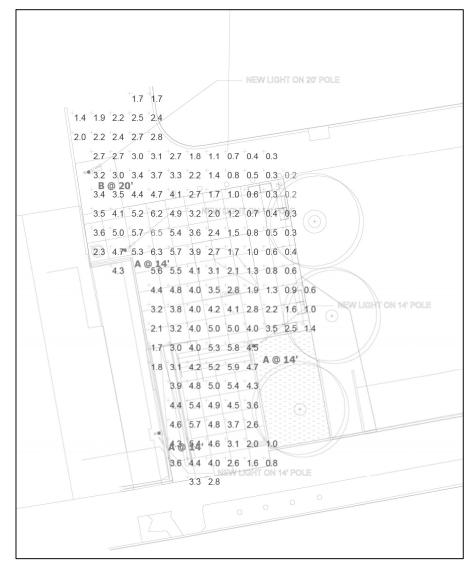

1 SITE 'G' LIGHTING FOOT CANDLES PLAN E201 SCALE: NOT TO SCALE

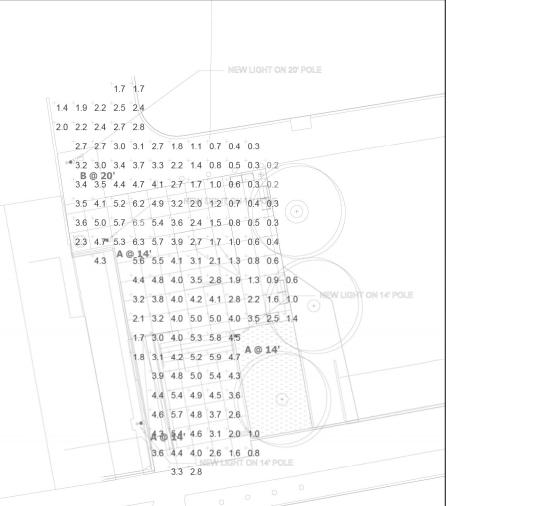

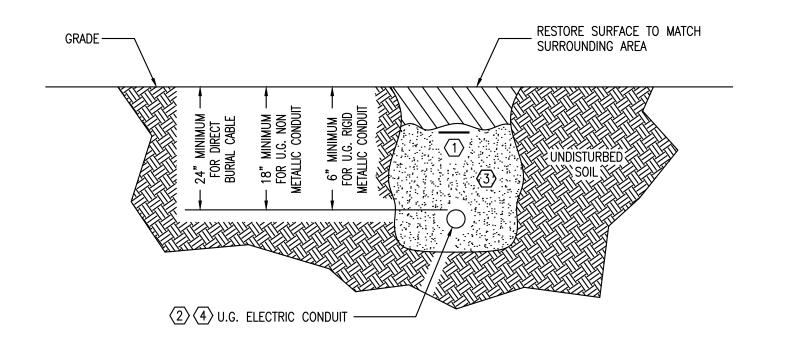

NOTE: CONDUIT DEPTHS SHALL MEET NEC TABLE 300.5 MINIMUM COVER REQUIREMENTS

DETAIL KEY NOTES:

Statistics

PARK

PLAZA

Description Symbol Avg

CALCULATIONS ARE ESTIMATES ONLY BASED ON INFORMATION PROVIDED

Min Max/Min Avg/Min

10.0:1

15.0:1

56.0:1

1.0 fc | 5.6 fc | 0.1 fc |

3.0 fc | 6.5 fc | 0.2 fc | 32.5:1

- DETECTABLE UNDERGROUND TAPE. BURY BELOW GRADE. USE SETON STYLE 85517 6" RED TAPE WITH BLACK LETTERS "CAUTION: BURIED ELECTRICAL LINE BELOW"
- (2) MAINTAIN 12" MINIMUM OUTSIDE TO OUTSIDE DIAMETER SEPARATION BETWEEN ELECTRICAL AND OTHER UTILITY CONDUIT. MAINTAIN AT LEAST 3" SEPARATION BETWEEN ELECTRICAL CONDUITS.
- (3) BACKFILL WITH 1-13 SELECT BACKFILL.
- 4 ALL UNDERGROUND CONDUIT SHALL BE **PVC SCHEDULE 80**. SEE PLAN FOR CONDUIT QUANTITY, SIZE AND FILL.

3	FIECTRICAL TRENCH DETAIL	SCALE
E201	ELECTRICAL TRENCH DETAIL	NONE

WEST MILL CREEK AREAS E & G

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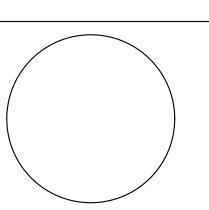
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ELECTRICAL NOTES AND DETAILS

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