



# FREE LIBRARY OF PHILADELPHIA RICHMOND BRANCH

2987 ALMOND STREET PHILADELPHIA, PA 19134

## ROOF SYSTEM REPLACEMENT

### DESIGN DEVELOPMENT SUBMISSION

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1515 Arch Street  
Mezzanine Level  
Philadelphia, PA 19107  
Phone: 215-686-0284  
Email: Cassie.OConnell@phila.gov  
Attn: Cassie O'Connell  
Rebuild Design & Construction Manager  
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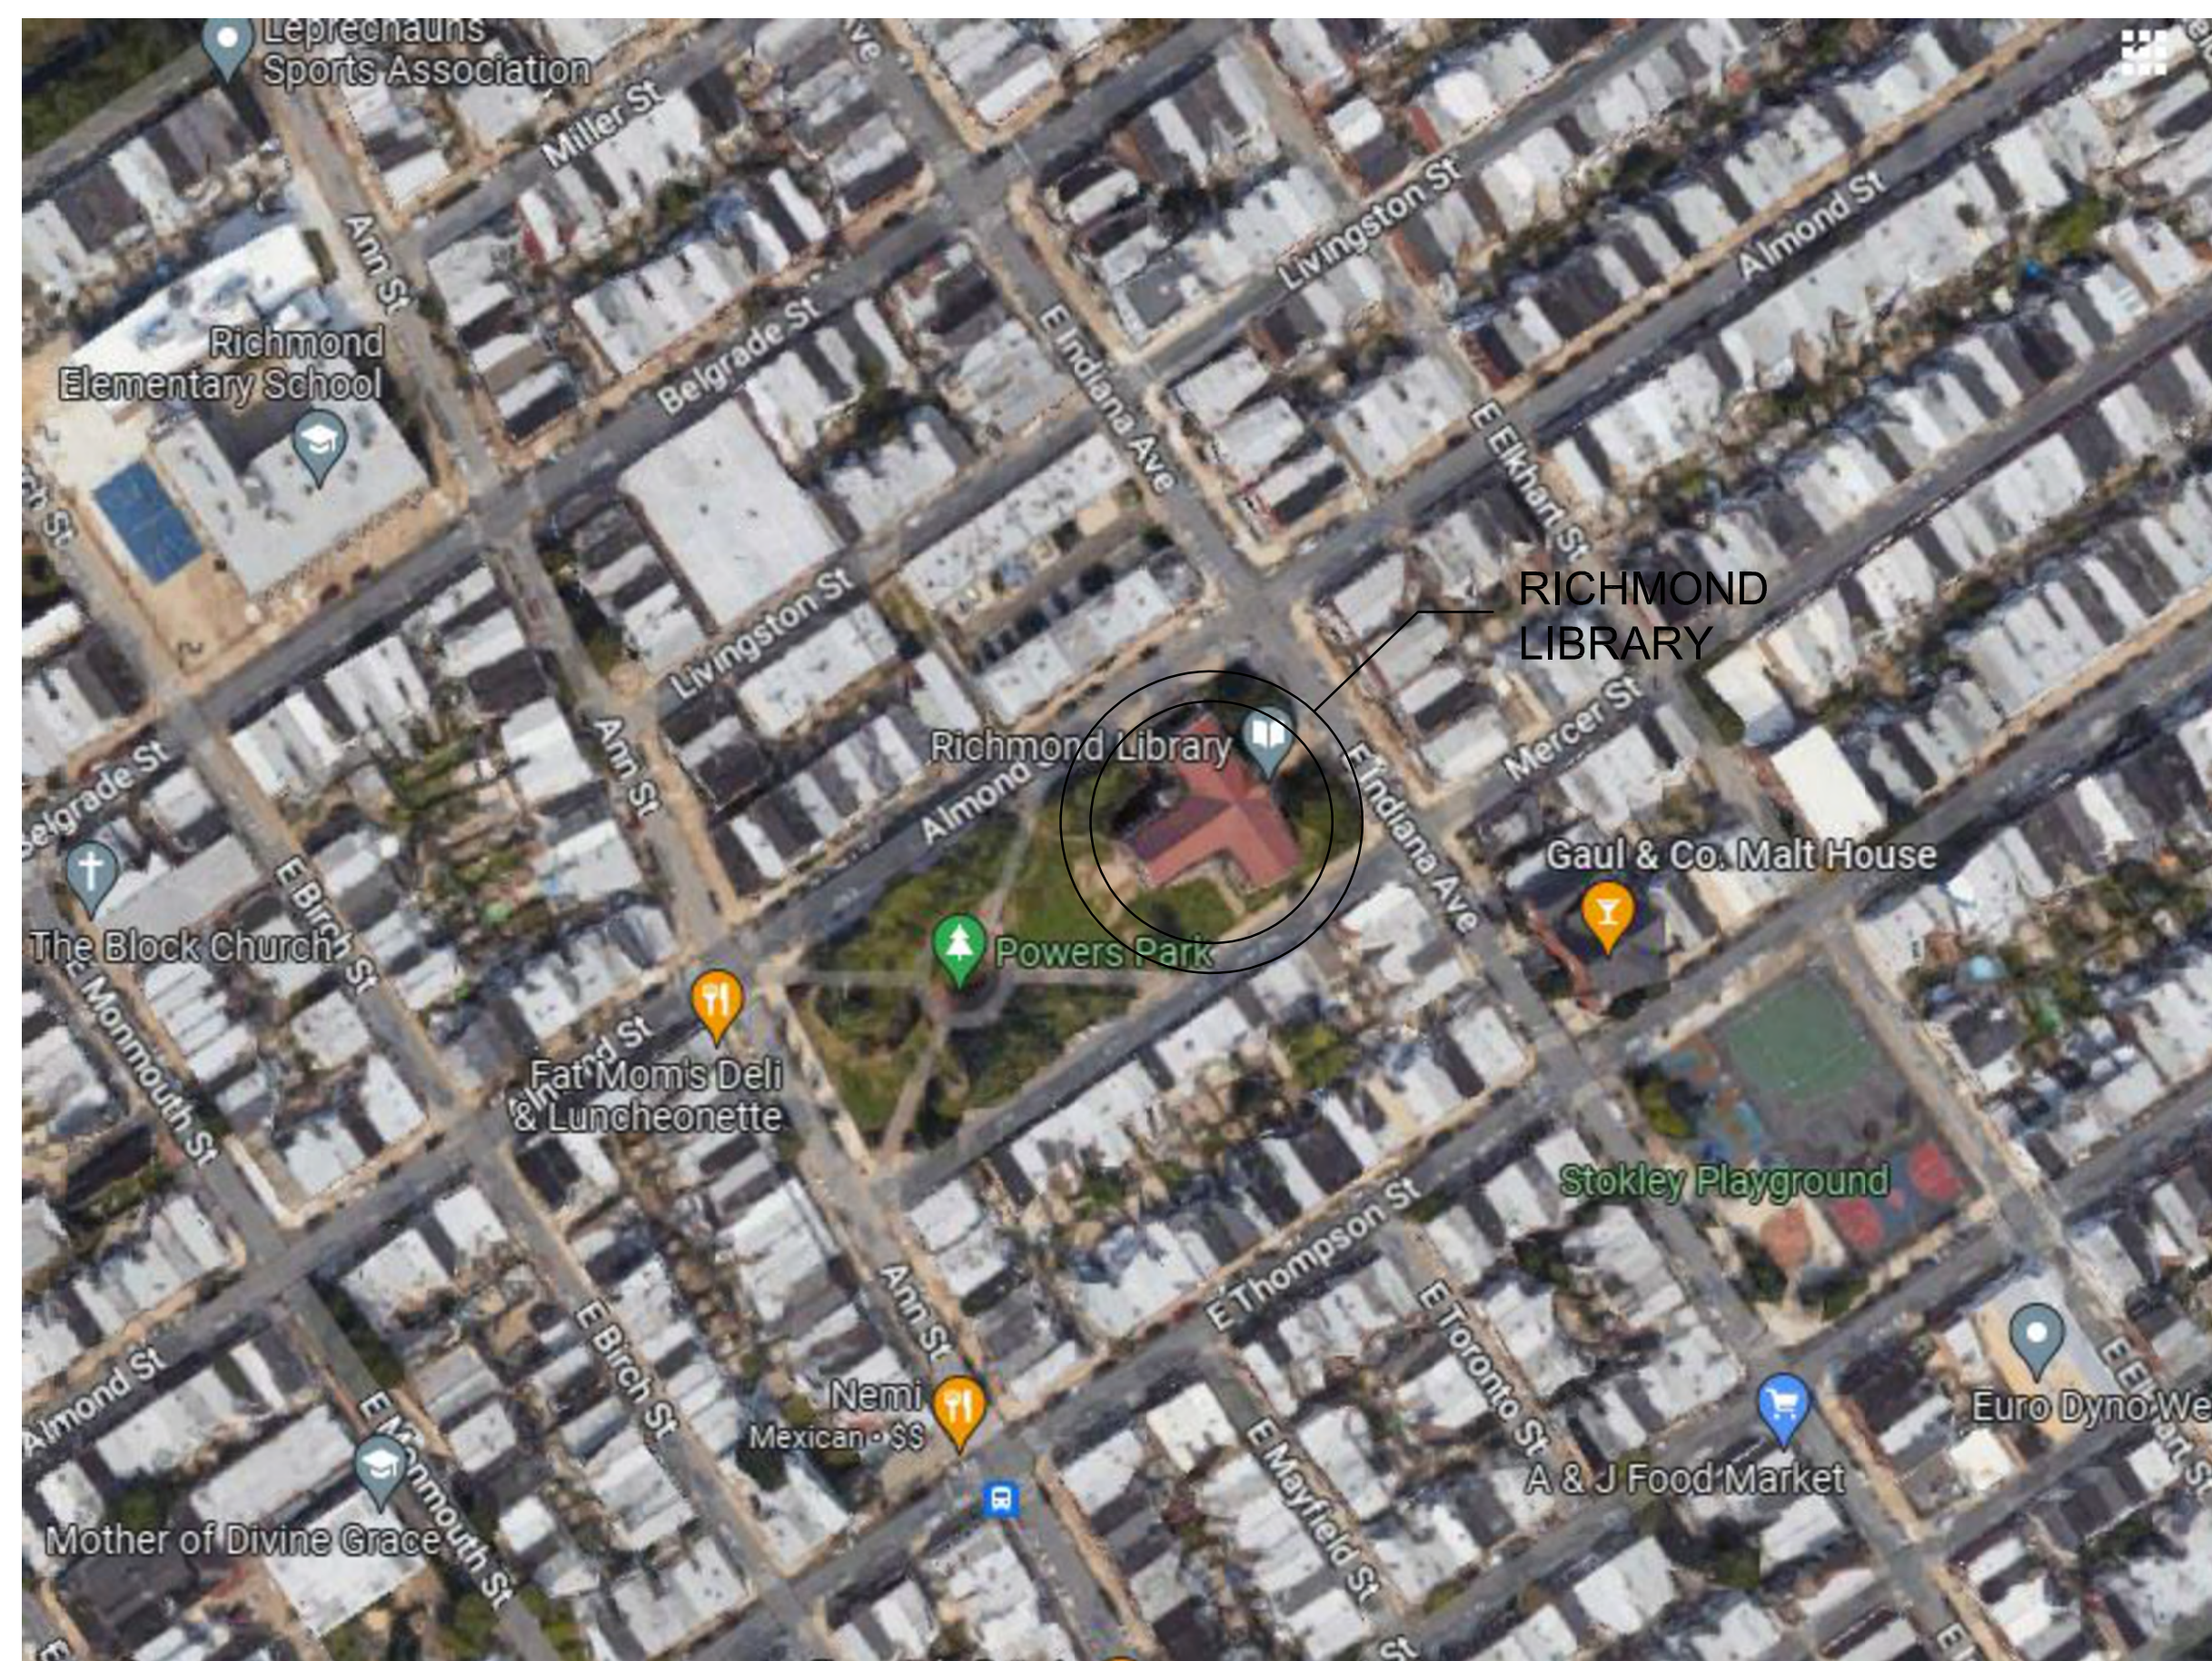
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Email: BenfordJ@freelibrary.org  
Attn: Joseph Benford  
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**CLIENT/ PROJECT USER**


GREATER PHILADELPHIA  
COMMUNITY ALLIANCE  
MAMIE NICHOLS CENTER  
1529 S. 22nd Street  
Philadelphia, PA 19146  
Phone: 215-239-4003  
Email: otisbullock@gpca-phila.org  
Attn: Otis L. Bullock, Jr.  
Executive Director  
www.gpca-phila.org

**LEAD ARCHITECT**

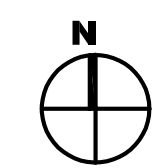
DIGROUPARCHITECTURE  
15 Bethany Street  
New Brunswick, NJ 08901  
Phone: (732) 249-6242  
Fax: (732) 247-1825  
Email: wharris@digrouparchitecture.com  
Attn: Wallace Harris




LOCATION MAP



NOT TO SCALE

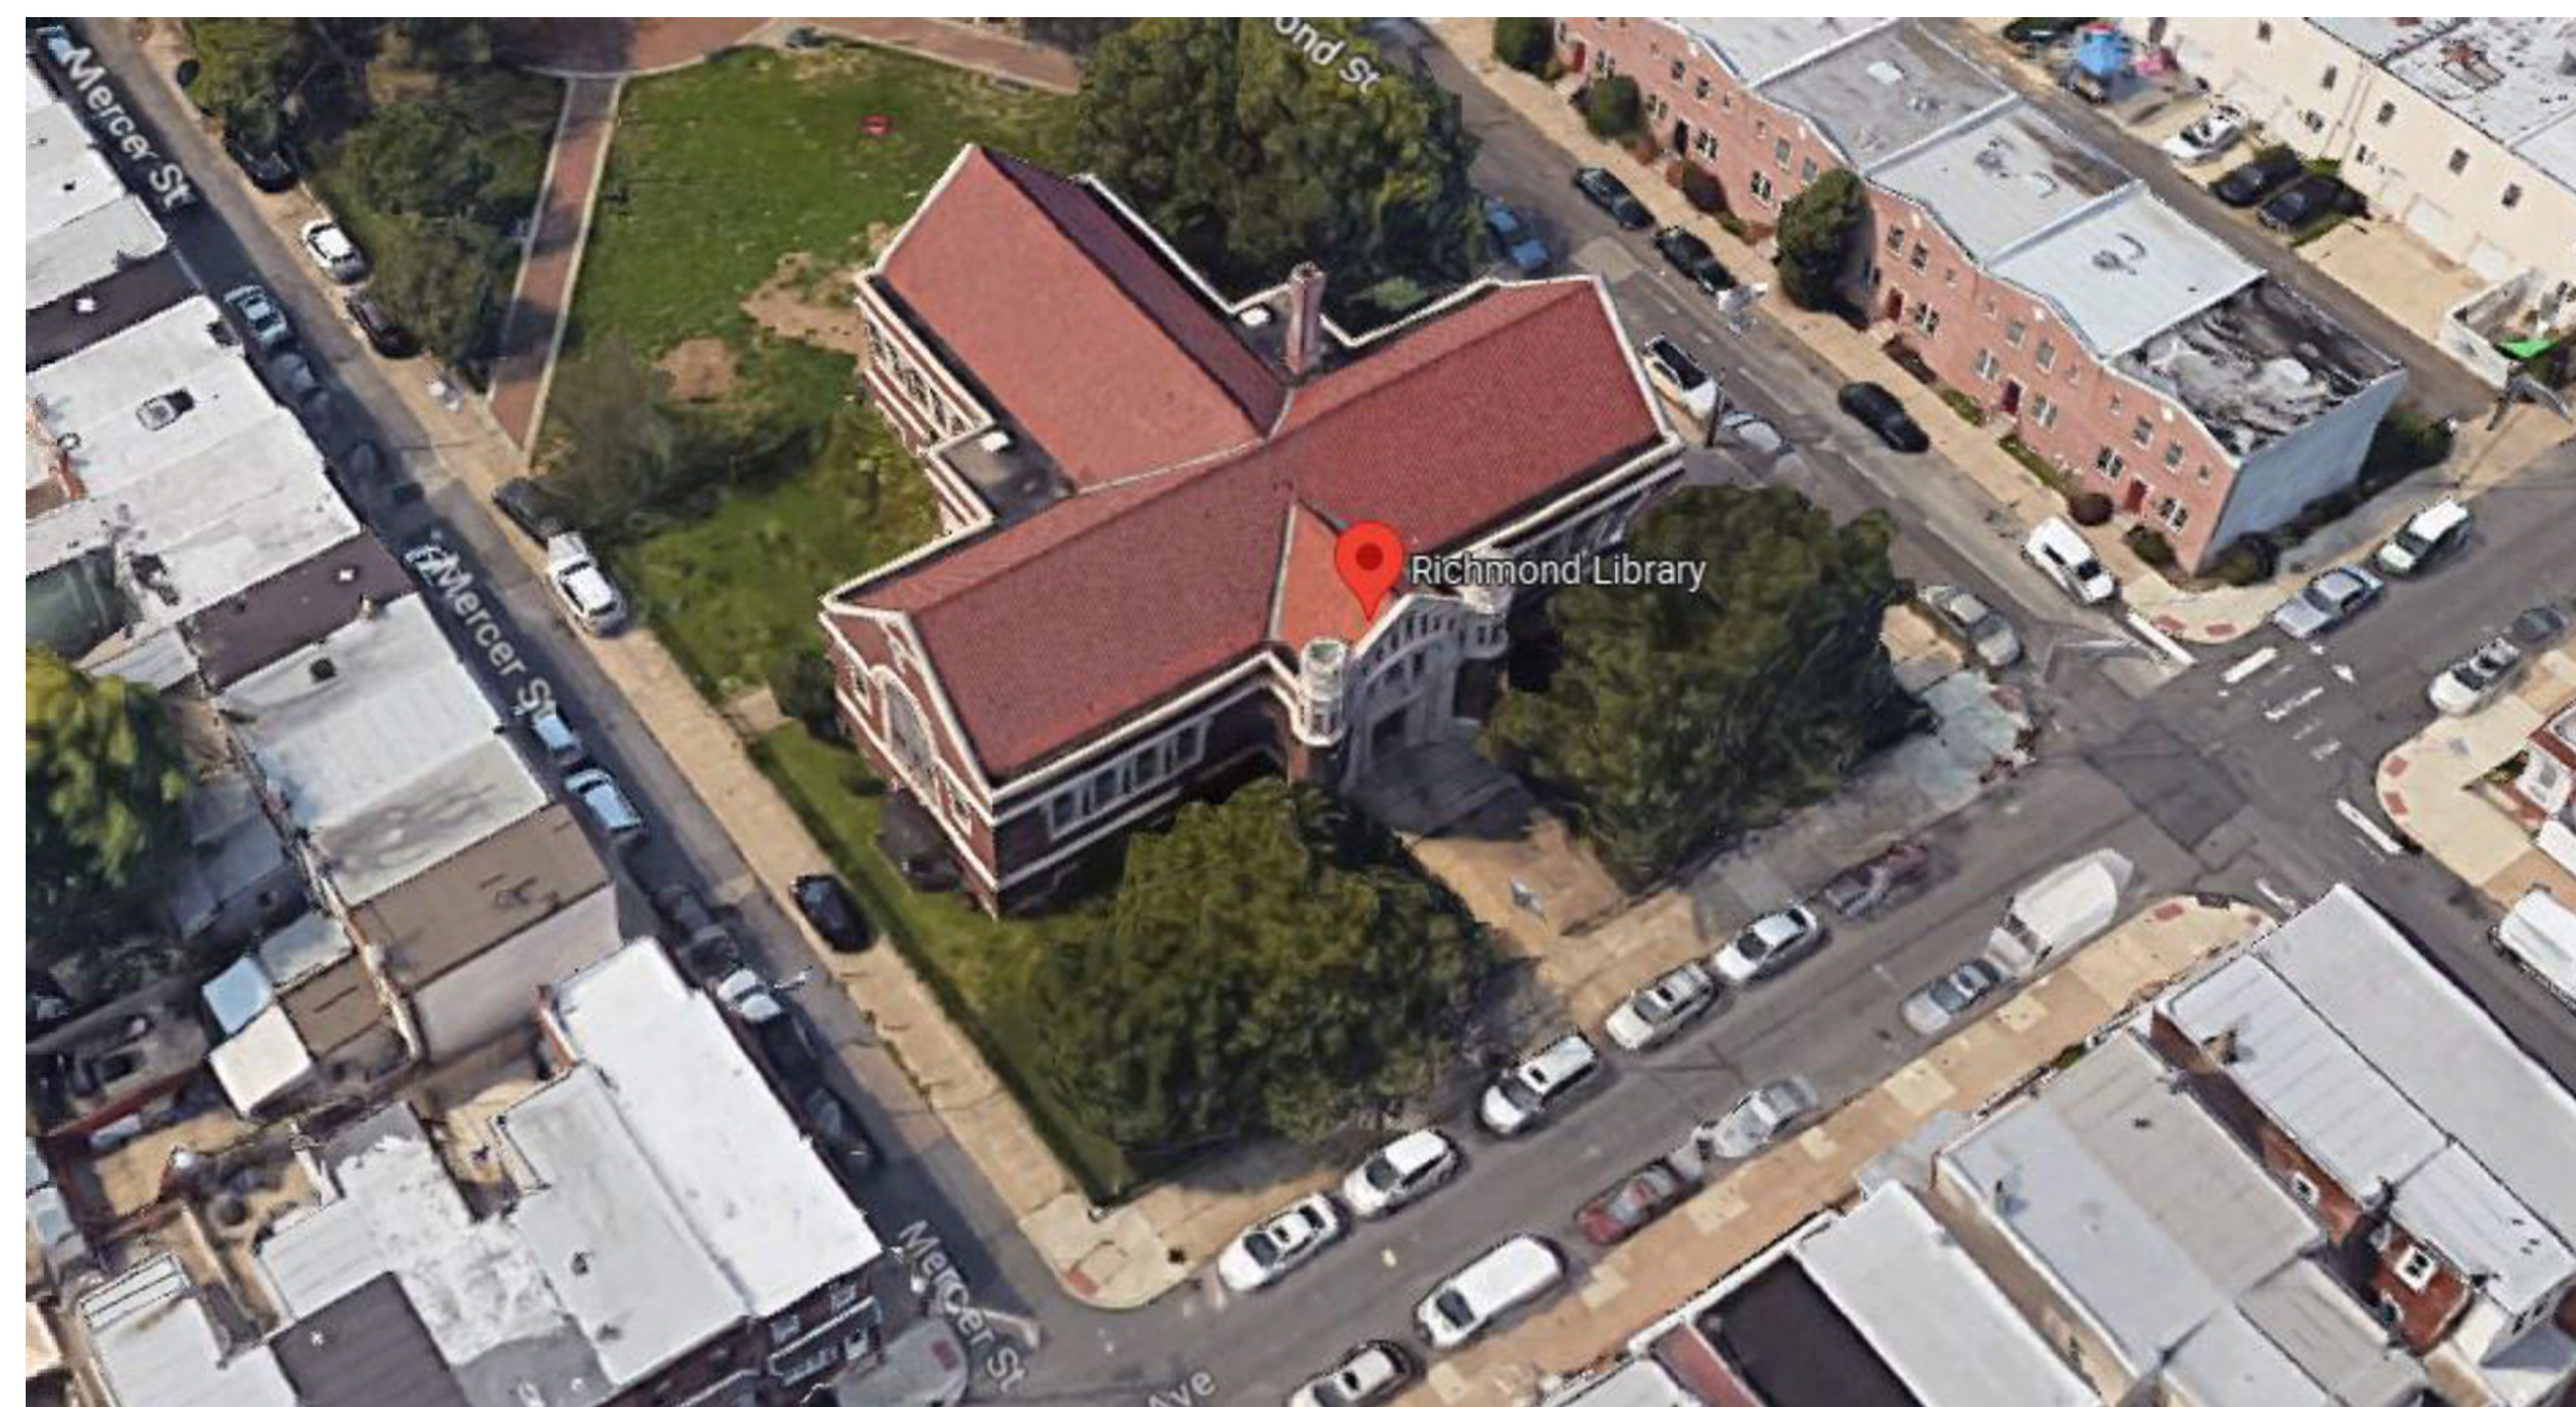

AERIAL VIEW

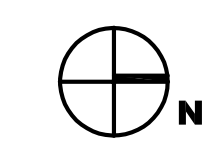

NOT TO SCALE

No.	Date	Description
6-30-2023	ISSUED FOR BID	
	Revisions / Issues	


**DIGroupArchitecture**  
ARCHITECTURE FOR CHANGE

15 Bethany Street • New Brunswick, NJ 08901 • T: 732.249.6242  
1417 N. 2nd St. Ste. 3M • Philadelphia, PA 19122 • T: 215.634.3400

Vincent A. Myers, AIA  
NJ RA AI 11415, NY RA 041541,  
PA RA 409369

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Clients:

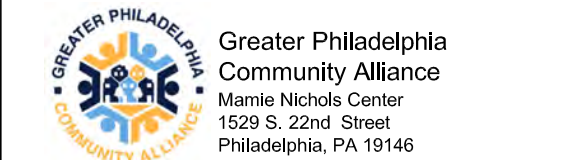

Project: **Free** Roof System Replacement at Free Library of Philadelphia Richmond Branch 2987 Almond Street Philadelphia, PA 19134

Drawing Information:  
Project No: 23-002  
Date: 06-30-2023  
Drawn By: WH  
Checked By: WH

Sheet Name:  
**COVER SHEET**

Sheet No:

**A-000**  
Sheet 1 of 6



### General Notes

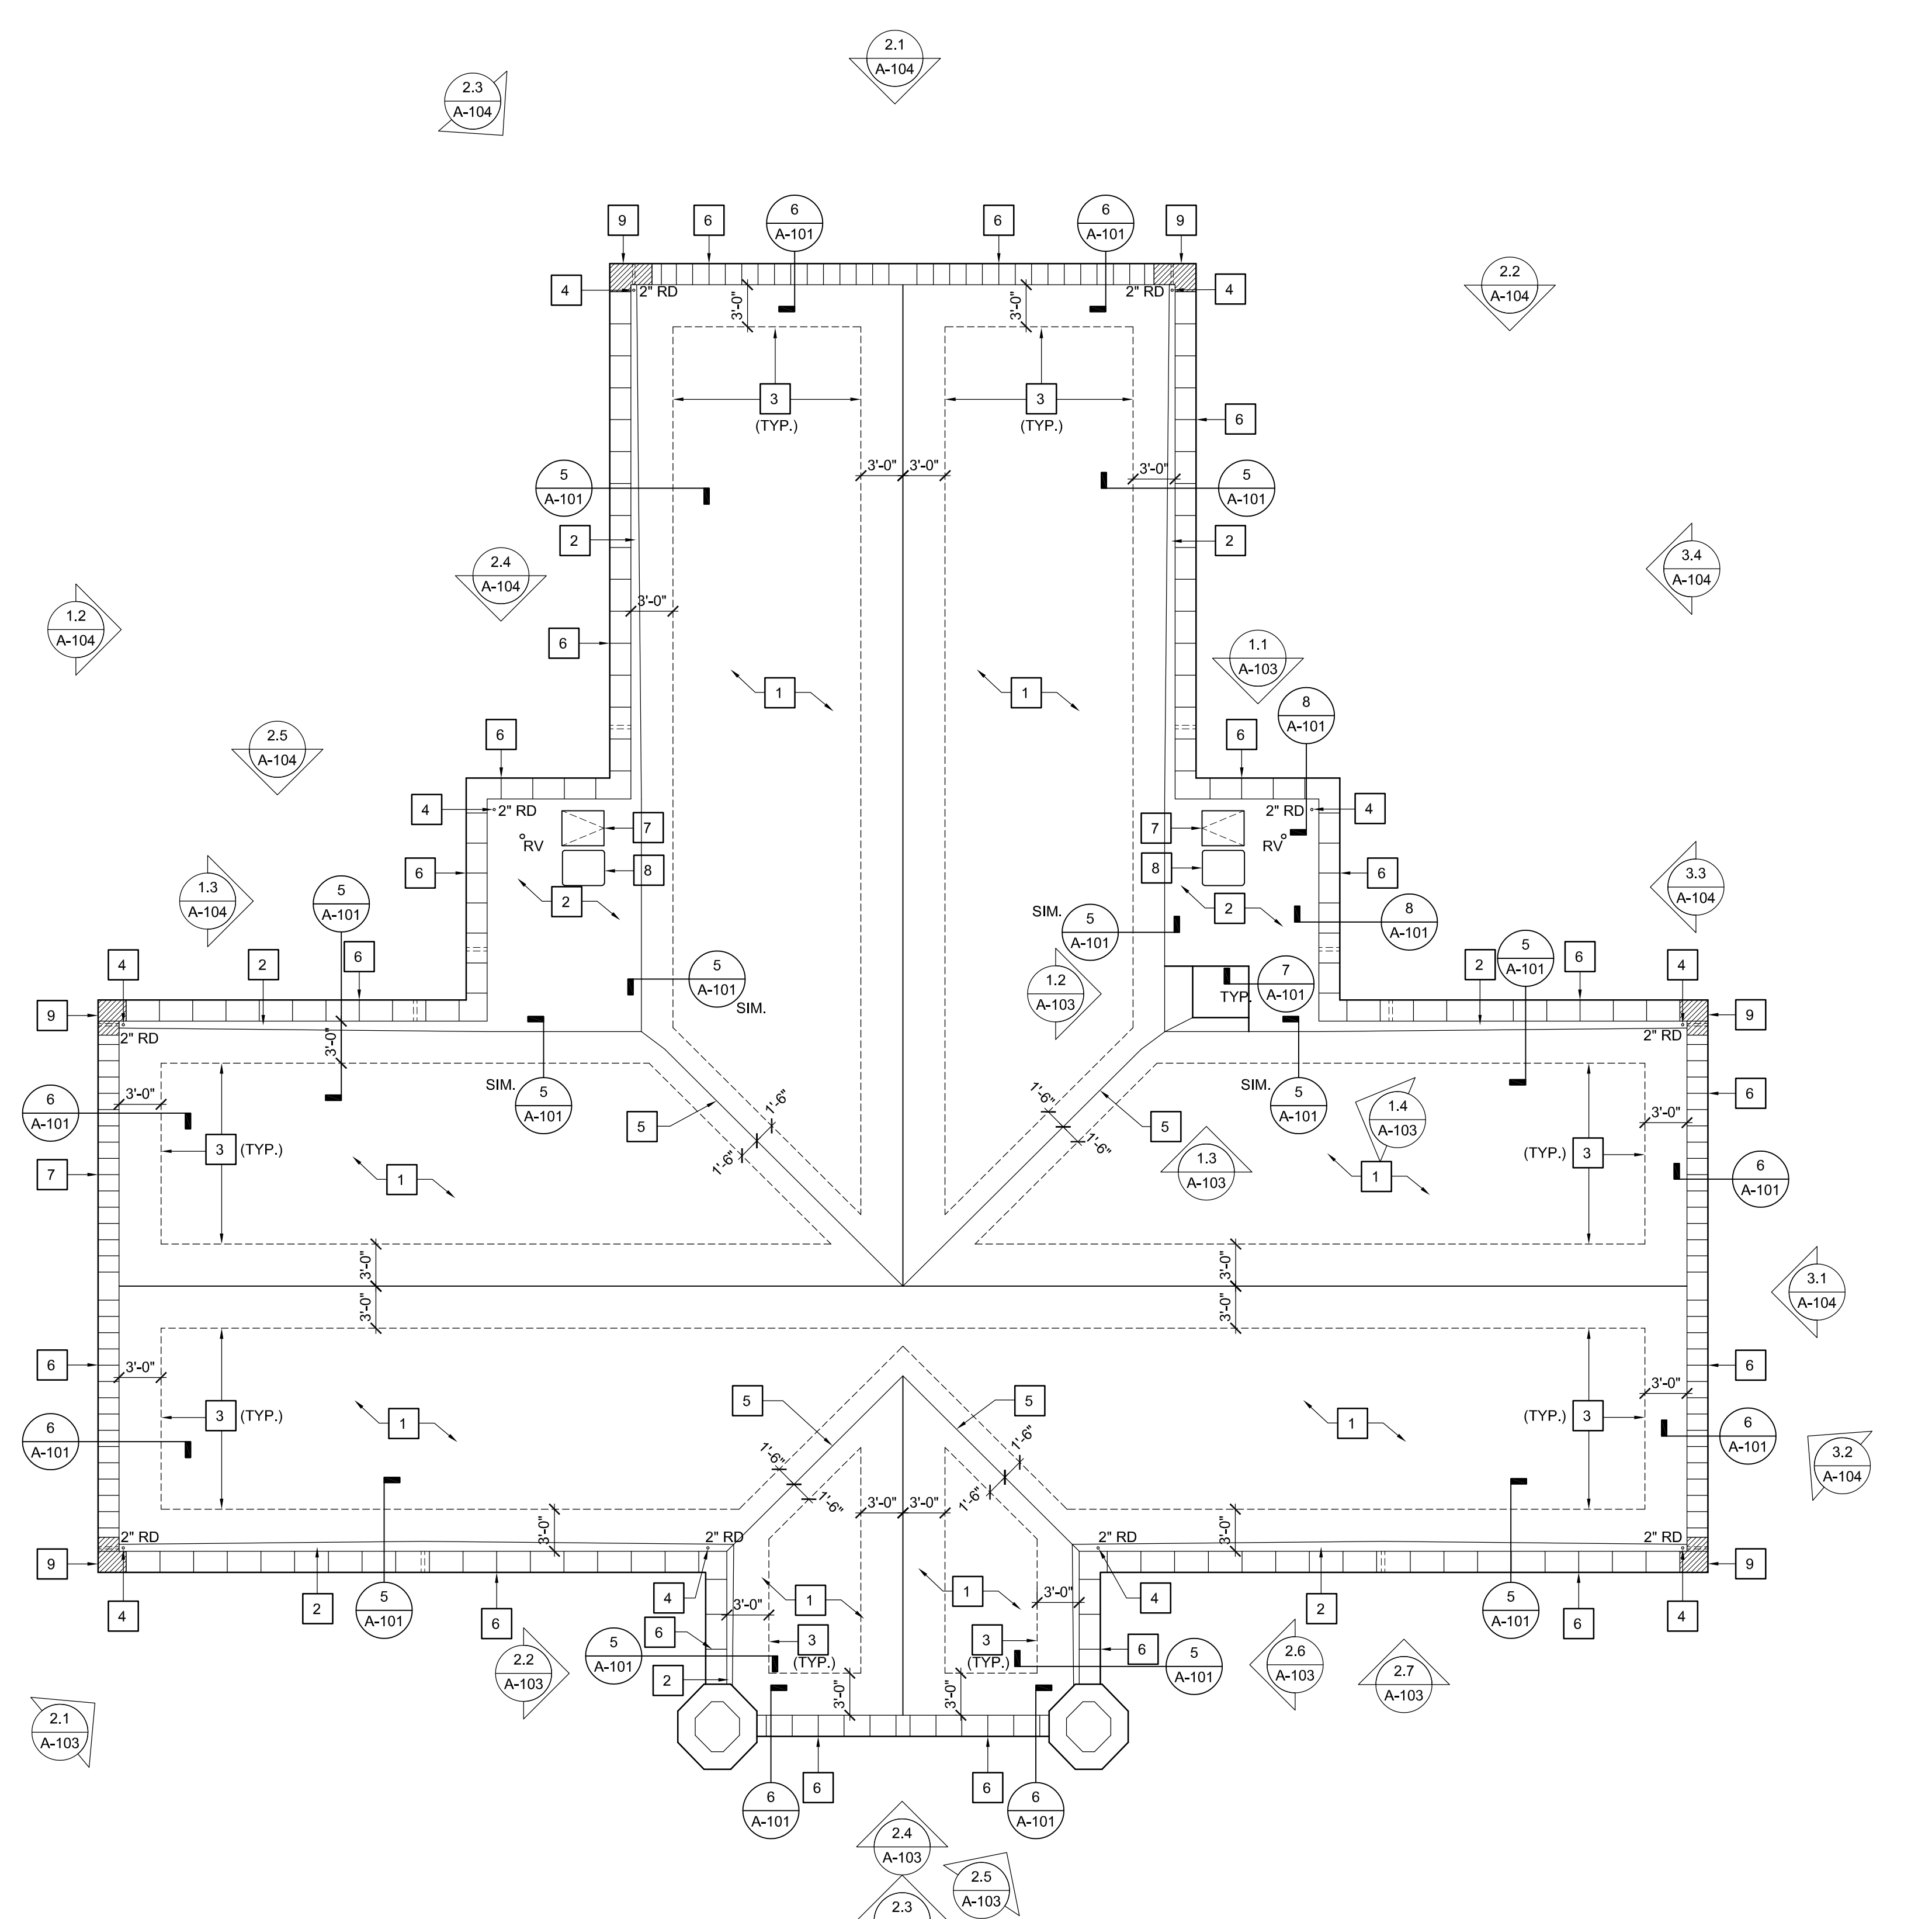
- A. PERMITTED HOURS OF WORK: 7:00 AM TO 4:30 PM MONDAY THROUGH FRIDAY IN ACCORDANCE WITH THE HAZARDOUS MATERIALS LAWS.
- B. IT IS ASSUMED THAT ALL MATERIAL IS ASBESTOS CONTAMINATED. DISPOSE OF ALL MATERIAL IN ACCORDANCE WITH THE HAZARDOUS MATERIALS LAWS.
- C. PRIOR TO SUBMITTING A BID, ALL CONTRACTORS SHALL FIELD VERIFY ALL EXISTING FIELD CONDITIONS & DIMENSIONS INDICATED ON THESE DRAWINGS AS THEY ARE APPROXIMATE AND ARE TO BE USED AS A GUIDE ONLY. THE CONTRACTOR SHALL ALSO BE RESPONSIBLE TO MAKE A QUANTITATIVE TAKE OFF, AND INCLUDE IN HIS BID, THE AMOUNT FOR ALL WORK REQUIRED AT ROOF TOP EQUIPMENT, ROOF DRAINS, WALL AND ROOF INTERSECTIONS AND ALL OTHER CONDITIONS DEEMED NECESSARY FOR THE COMPLETE INSTALLATION OF THE NEW ROOF SYSTEM INDICATED ON THESE DRAWINGS AND AS SPECIFIED.
- D. THE GENERAL CONTRACTOR SHALL OBTAIN AND ADHERE TO ANY / ALL WRITTEN GUIDELINES CONCERNING MATERIAL SEPARATION PROCEDURES FOR DUMP SITE DISPOSAL BY AGENCIES HAVING JURISDICTION.
- E. THE GENERAL CONTRACTOR, DURING THE PROCESS OF ANY AND ALL WORK RELATED TO THIS PROJECT SHALL PROTECT AND RETAIN ALL EXISTING TELEPHONE AND ELECTRIC UTILITY POLES AND ALL WIRING TO REMAIN AS INSTALLED ON THE SITE.
- F. CONTRACTOR IS TO PROVIDE AND MAINTAIN TWO (2) PORTABLE TOILETS AND SHALL LOCATE THEM AS DIRECTED BY THE OWNER. UNITS SHALL BE REMOVED BY THE DATE OF SUBSTANTIAL COMPLETION.
- G. ALL MATERIALS, EQUIPMENT AND FLUIDS WITHIN EQUIPMENT, IDENTIFIED TO BE REMOVED SHALL BE DISPOSED OF IN LEGAL DUMPSITES AND / OR UTILIZING LEGAL PROCEDURES APPROVED BY ALL AGENCIES HAVING JURISDICTION CONCERNING THE WORK AND LOCATION OF THIS CONTRACT. FLUIDS FOR DISPOSAL WITHIN EQUIPMENT SHALL BE CONTAINERIZED AND DISCARDED IN ACCORDANCE WITH THE GOVERNING AGENCIES GUIDELINES.
- H. ALL REMOVED MATERIAL AND EXCESS ROOF CONSTRUCTION MATERIAL SHALL BE LEGALLY DISPOSED OF OFFSITE BY THE CONTRACTOR.
- I. CONTRACTORS SHALL PROVIDE ALL PROTECTION AS REQUIRED TO PREVENT REMAINING EXISTING SURFACES AND ROOF TOP EQUIPMENT FROM BEING DAMAGED DURING THE COURSE OF PERFORMING THE ROOFING WORK. ALL DAMAGED AND / OR DISTURBED AREAS AND / OR EQUIPMENT CAUSED BY THE CONTRACTOR OR HIS SUBCONTRACTORS, DUE TO WATER PENETRATION, DURING THE COURSE OF ROOFING WORK SHALL BE RESTORED TO THEIR ORIGINAL CONDITION OR REPLACED BY THE ROOFING CONTRACTOR AT NO ADDITIONAL COST TO THE OWNER AND TO THE SATISFACTION OF THE OWNER AND ARCHITECT.
- J. OWNER'S DUMPSTERS ARE NOT TO BE USED FOR DISPOSAL OF ANY CONSTRUCTION DEBRIS AND ARE NOT TO BE USED BY CONTRACTORS FOR DISPOSAL OF ANY PERSONAL DEBRIS.
- K. THE CONTRACTOR AND/OR CONTRACTORS SHALL PROVIDE ALL LABOR, EQUIPMENT AND MATERIALS REQUIRED TO INSTALL AND COMPLETE ALL THE WORK DESCRIBED IN THE CONTRACT DOCUMENT DRAWINGS AND SPECIFICATIONS.
- L. ALL NEW MATERIALS AND ASSEMBLIES REQUIRED AND / OR DESCRIBED IN THE DRAWINGS, DRAWING NOTES AND SPECIFICATIONS TO "MATCH EXISTING" OR DESCRIBED AS "MATCHING" SHALL BE THE EXACT OR SAME MATERIAL AND ASSEMBLY, IN EVERY RESPECT.
- M. THE PLANS AND SPECIFICATIONS FOR THIS PROJECT MAY CONTAIN REQUIREMENTS FOR PERFORMANCE OF THE WORK THAT ARE HIGHER OR MORE STRINGENT THAN, OR OTHERWISE DEPART FROM, CUSTOMARY STANDARDS OF THE INDUSTRY OR THE MANUFACTURER'S RECOMMENDATIONS. THE BIDDER SHALL TAKE THOSE DIFFERING REQUIREMENTS INTO ACCOUNT WHEN PREPARING ITS BID. THE BIDDER ACKNOWLEDGES THAT IF IT FAILS TO ACCOUNT FOR THOSE DIFFERING REQUIREMENTS IN ITS BID, IT WILL NOT BE ENTITLED TO CHANGES OF THE CONTRACT SUM OR CONTRACT TIME.
- N. CONTRACTORS SHALL MAINTAIN A WATER TIGHT AND WEATHER TIGHT CONDITION AT ROOF AREAS AT ALL TIMES DURING THE ENTIRE CONSTRUCTION PERIOD.
- M. THE ROOFING CONTRACTOR SHALL REVIEW ALL FLASHING AND ROOFING DETAIL CONDITIONS INDICATED ON THE DRAWINGS WITH THE ROOF MANUFACTURER. THE CONTRACTOR SHALL RECEIVE THE WRITTEN APPROVAL OF ALL ROOF DETAILS FROM THE MANUFACTURER PRIOR TO STARTING WORK. ALL METAL FLASHING AND ROOF BASE FLASHING SHALL BE TIED INTO AND BE COMPATIBLE WITH THE EXISTING TYPE ROOFING SUBSTRATE MATERIAL AND THE EXISTING ROOF EDGE CONDITIONS.
- N. THE CONTRACTOR SHALL FIELD REVIEW ALL EXISTING ROOF CONDITIONS TO VERIFY ROOF ASSEMBLY CONDITIONS AND DISCUSS POTENTIAL DISCREPANCIES PRIOR TO START OF WORK.
- P. PRIOR TO THE COMMENCEMENT OF ANY ON-SITE CONSTRUCTION ACTIVITY, THE CONTRACTOR SHALL PHOTOGRAPH AND / OR VIDEO RECORD THE CONDITION OF THE EXISTING CURBING, SIDEWALKS, DRAINAGE INLETS, LAWN, LANDSCAPING AND PAVING ADJACENT TO THE BUILDING WINGS (PARKING LOT SIDE) WHICH ARE RECEIVING IMPROVEMENTS. THE PURPOSE OF THIS EXERCISE IS TO DOCUMENT ANY DAMAGED AREAS OF THE BUILDING AND SITE FOR FUTURE REFERENCE. ALL DOCUMENTATION IS TO BE SUBMITTED TO THE OWNER AND ARCHITECT PRIOR TO THE COMMENCEMENT OF CONSTRUCTION ACTIVITY.
- O. PRIOR TO CONSTRUCTION, THE CONTRACTOR SHALL PERFORM SCOPING AND CLEANING OF ALL EXISTING ROOF DRAINS. THE CONTRACTOR SHALL PROVIDE A DETAIL REPORT WITH WRITTEN DESCRIPTIONS OF EXISTING DRAIN LINES INCLUDING PHOTOS, KEY PLAN AND VIDEOS.

### Demolition Notes


- D1 REMOVE EXISTING TERRA COTTA TILE ROOF SYSTEMS DOWN TO EXISTING WOOD PLANKING SUBSTRATE. CARE MUST BE TAKEN TO NOT DAMAGE EXISTING WOOD PLANKING. (REPLACE DETERIORATED, ROTTEN AND UNSOUND WOOD PLANKING). REMOVALS ARE TO BE PERFORMED BY HAND WITH HAND TOOLS, IN ORDER TO MINIMIZE DAMAGE OF EXISTING ROOF DECK. HAMMERS AND CHOPPERS WILL NOT BE PERMITTED.
- D2 REMOVE AND DISCARD ALL EXISTING EPDM ROOF SYSTEM, INCLUDING MASTIC TO COMPLETELY EXPOSE EXISTING DECK SUBSTRATE. REMOVE AND DISCARD ALL PROJECTING FASTENING DEVICES AND ACCUMULATED ROOF ASPHALT AND / OR MASTIC TO PROVIDE A SMOOTH ROOF SURFACE FOR THE INSTALLATION OF NEW ROOF ASSEMBLY. SEE ALL ROOFING DETAILS FOR BLOCKING & CANTS TO BE REMOVED. REMOVALS ARE TO BE PERFORMED BY HAND WITH HAND TOOLS, IN ORDER TO MINIMIZE DAMAGE OF EXISTING ROOF DECK. HAMMERS AND CHOPPERS WILL NOT BE PERMITTED.
- D3 REMOVE EXISTING COPPER VALLEY SYSTEM, INCLUDING ALL MOUNTING HARDWARE.
- D4 CAREFULLY DISASSEMBLE & TEMPORARILY REMOVE EXISTING ROOF HATCH. REMOVE DISCARD BASE FLASHING. REMOVE ALL FASTENING DEVICES. REINSTALL ONCE ADDITIONAL BLOCKING HAS BEEN INSTALLED.
- D5 REMOVE EXISTING ROOF DRAIN DOMES AND FITTINGS. PREPARE FOR INSTALLATION OF NEW RETROFIT ROOF DRAIN UNITS WITH ALL REQUIRED FITTINGS, Sumps AND COLLARS, AS SPECIFIED.
- D6 EXISTING TRHU-WALL OVERFLOW SCUPPERS TO REMAIN PROTECTED. REMOVE ALL ASSOCIATED ROOF MEMBRANE FLASHING AND MASTICS.
- D7 EXISTING COPING STONE TO REMAIN AND PROTECTED.
- D8 REMOVE ALL CAULKING/SEALANT AND LOOSE MORTAR AND PREPARE JOINTS AT STONE COPINGS FOR RE-POINTING. (TYPICAL)

### New Work Notes

- SEE DEMOLITION NOTES AND GENERAL NOTES ON THIS DRAWING.
- SEE ALL TECHNICAL SPECIFICATIONS ALONG WITH DETAILS FOR THE DESCRIPTION AND BALANCE OF INFORMATION REGARDING THE NEW ROOF SYSTEM AND ASSEMBLY.
- G.C. MUST SCOPE ALL ROOF DRAINS AND ASSOCIATED DRAINAGE LEADERS PRIOR TO ANY WORK STARTING. G.C. TO PROVIDE DETAIL SCOPE REPORT WITH KEYED LOCATIONS.
- 1 PROVIDE AND INSTALL NEW SPANISH TILE ROOF SYSTEM. SEE SPECIFICATIONS FOR ADDITIONAL INFORMATION.
- 2 NEW 60 MIL EPDM ROOF SYSTEM OVER EXISTING ROOF DECK. SEE SPECIFICATIONS FOR ADDITIONAL INFORMATION.
- 3 PROVIDE SELF-ADHERING ICE AND WATER SHIELD OVER SUBSTRATE. 3'-0" FROM WARM SIDE OF EXTERIOR WALL AND CENTER LINE OF RIDGES AND 1'-6" FROM CENTER OF ALL VALLEYS.
- 4 NEW RETROFIT INSERT ROOF DRAIN. SEE DRAWING 2/A-102 FOR INFORMATION REGARDING REPLACEMENT OF EXISTING ROOF DRAINS.
- 5 INSTALL NEW COPPER VALLEY.
- 6 REPOINT ALL COPING STONE JOINTS
- 7 REINSTALL EXISTING ROOF HATCH SYSTEM. SEE DETAIL 3/A-102.
- 8 NEW WALKWAY PADS. SEE SPECIFICATIONS FOR ADDITIONAL INFORMATION.
- 9 CLEAN AND REPAIR EXISTING TERRA COTTA COPING STONE. SEE SPECIFICATIONS FOR ADDITIONAL INFORMATION.



**2 Roof Plan**  
SCALE: 1/8" = 1'-0"

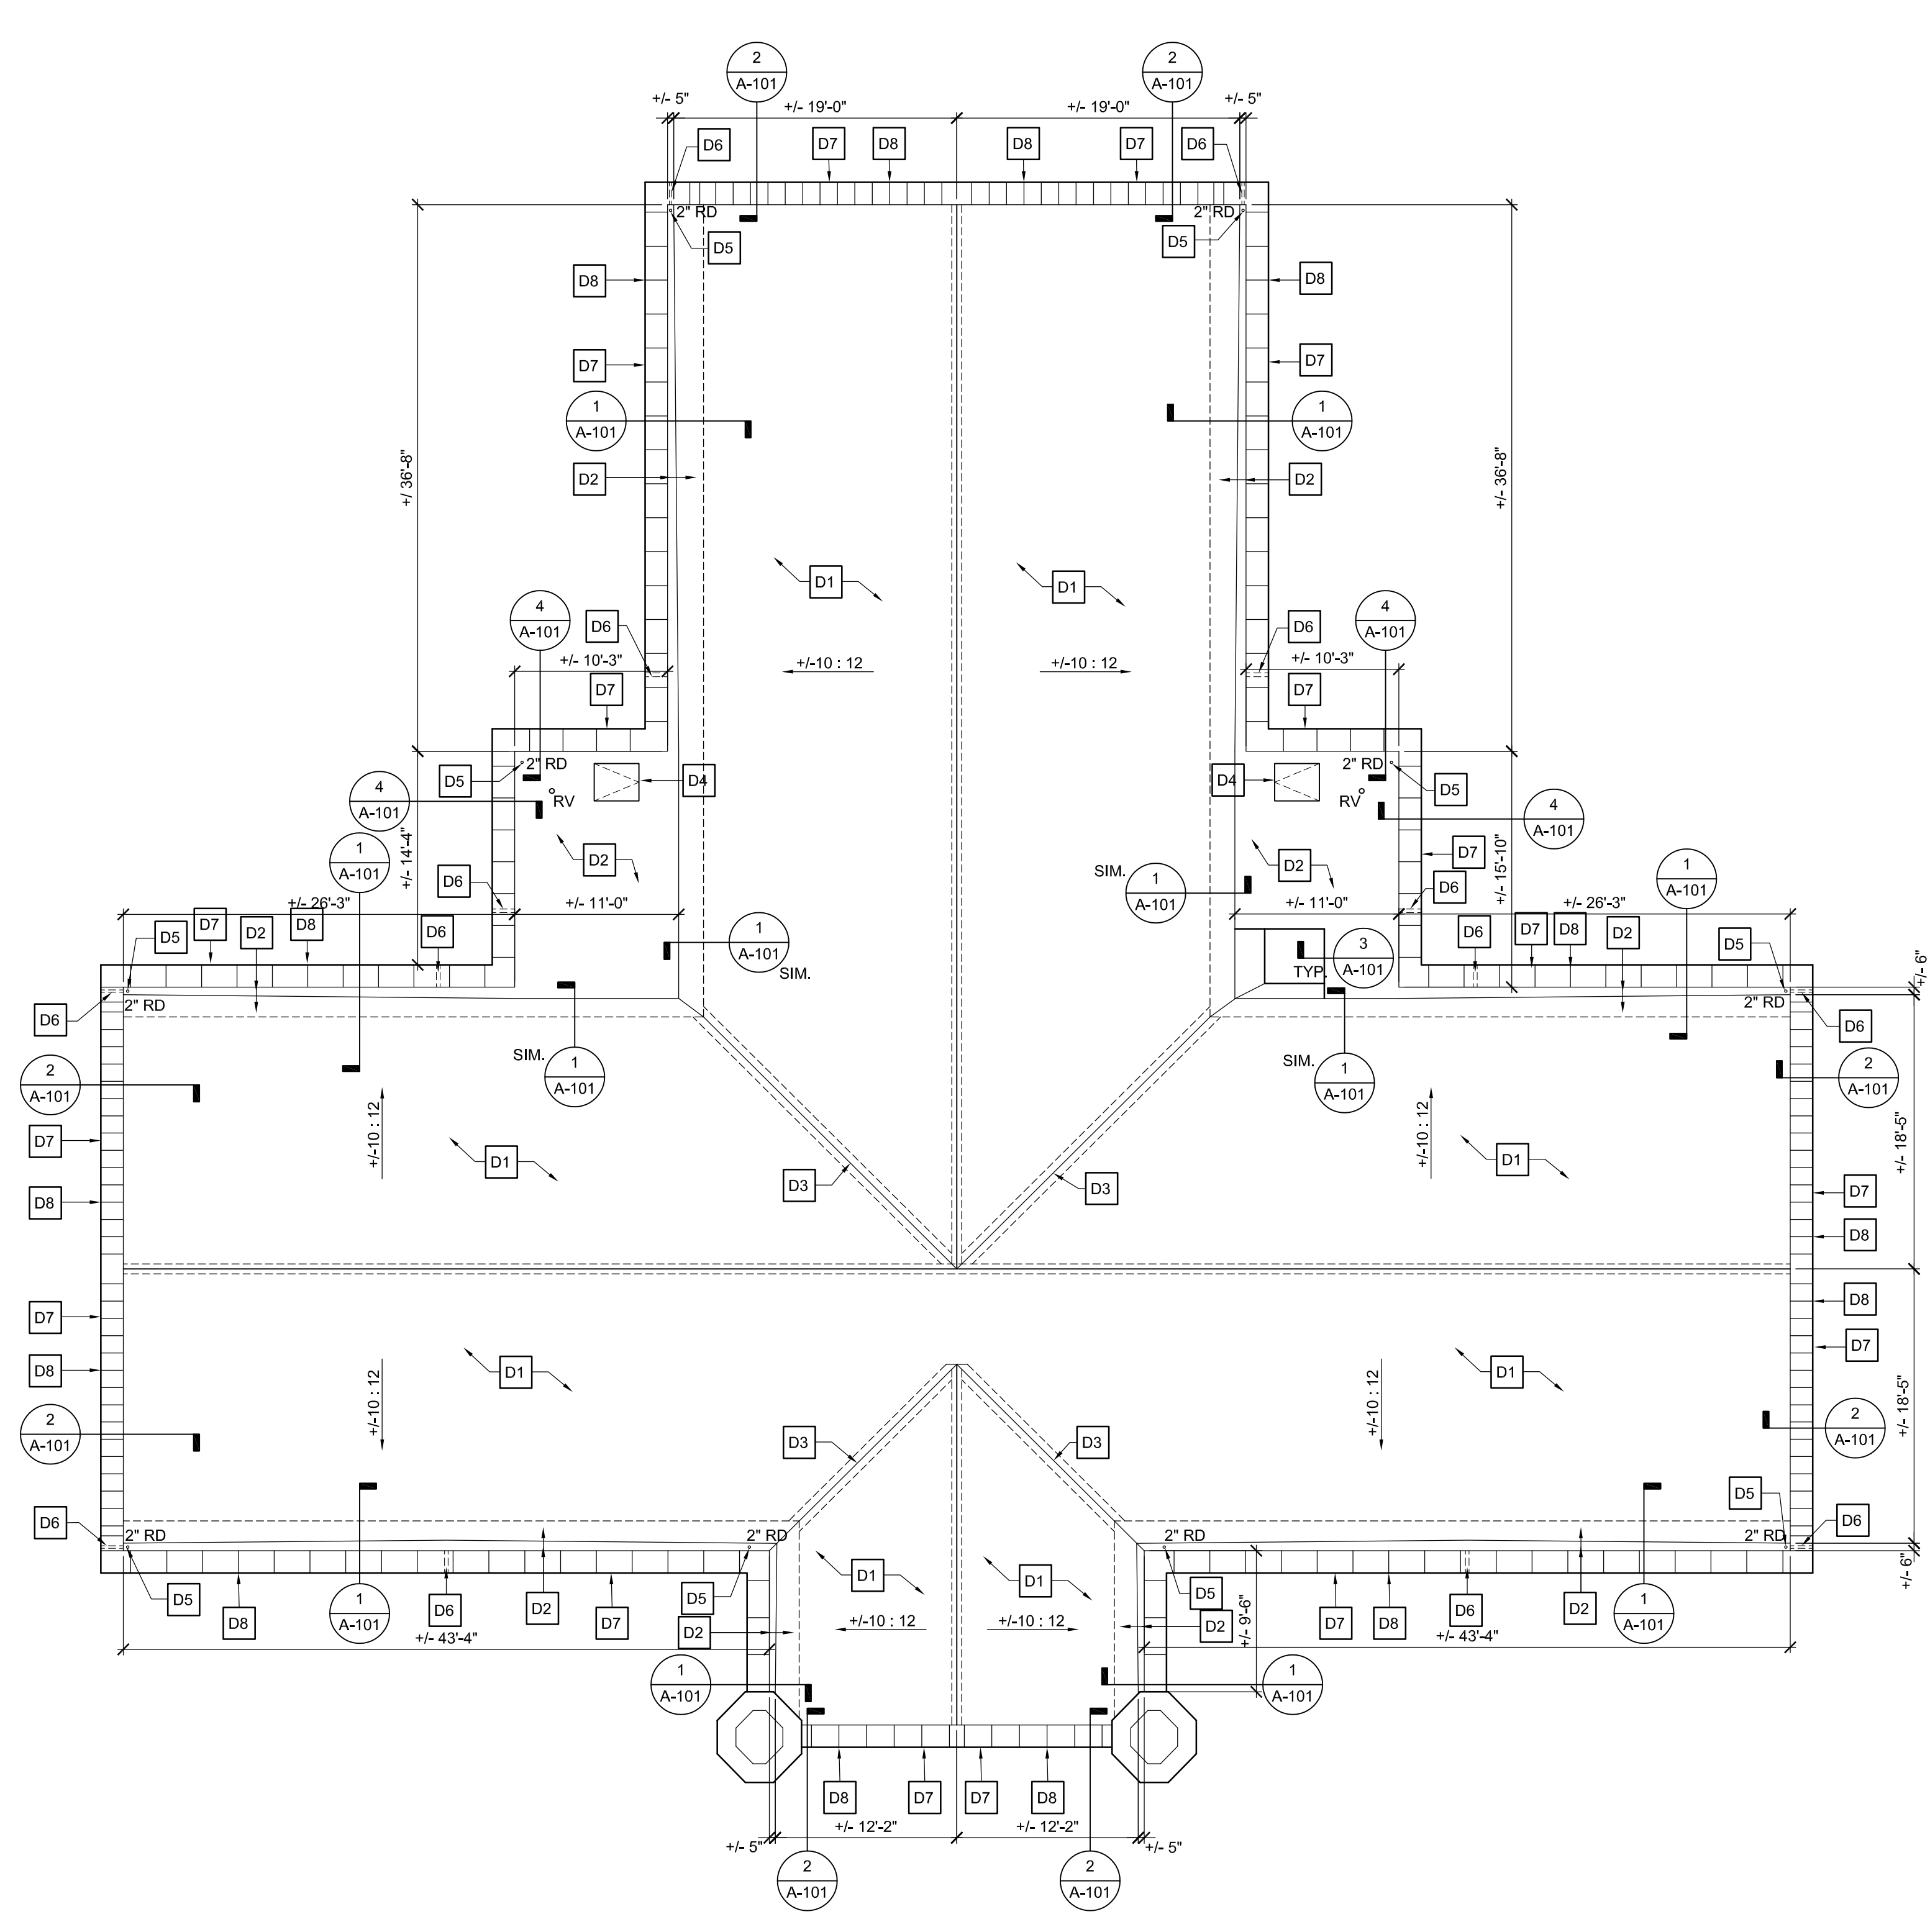

**1 Demolition Roof Plan**  
SCALE: 1/8" = 1'-0"

6-30-2023 ISSUED FOR BID  
No. Date Description  
Revisions / Issues

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PA RA 409369

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Minnie Nichols Center  
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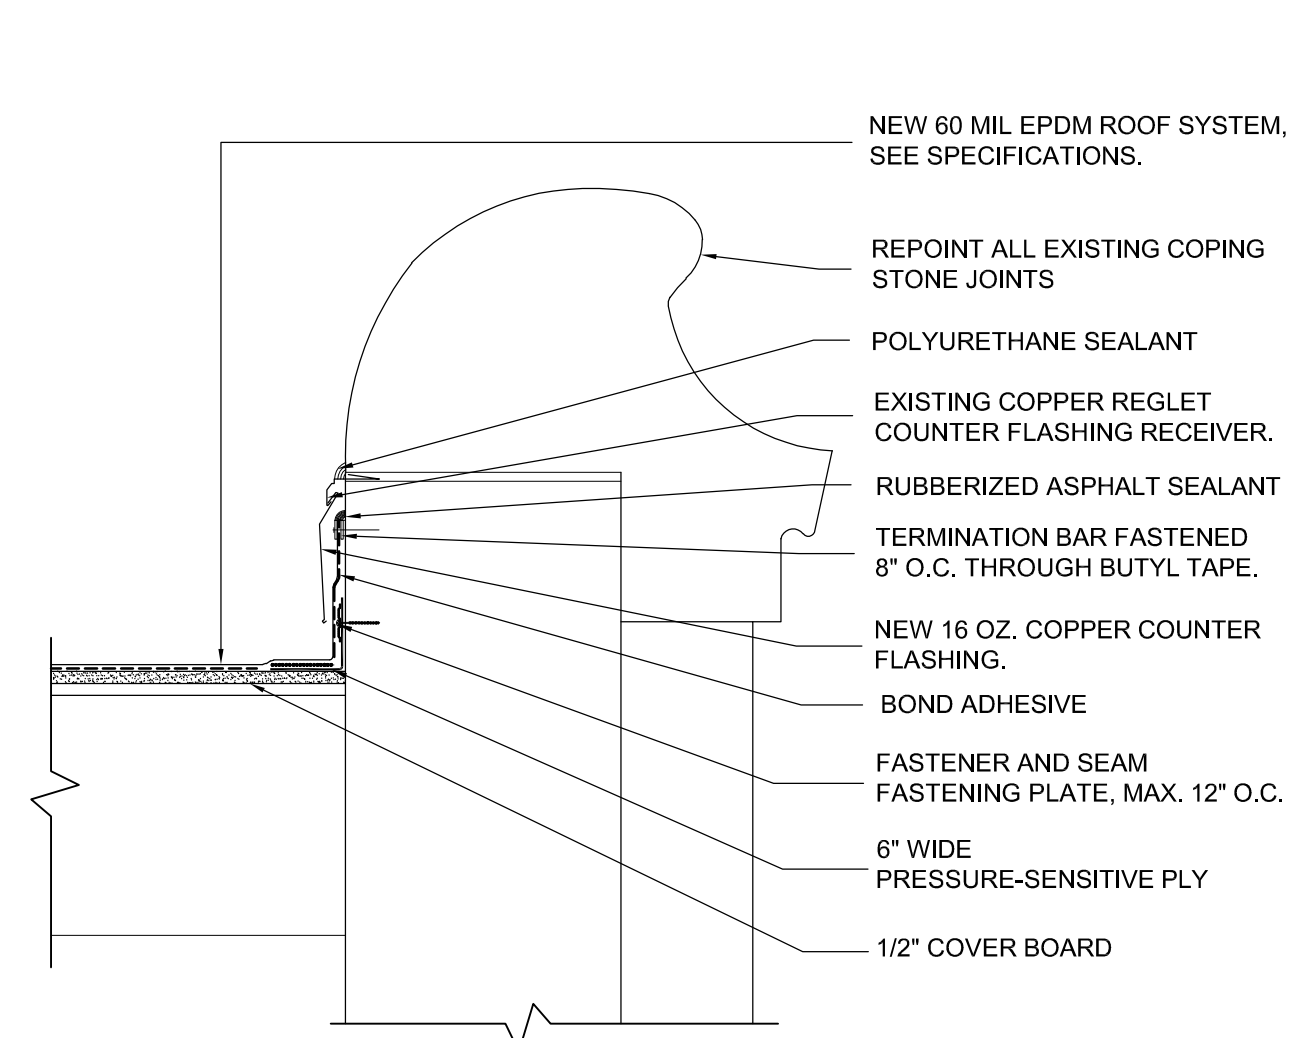
Project: **free** LIBRARY PHILADELPHIA  
Roof System Replacement at Free Library of Philadelphia Richmond Branch  
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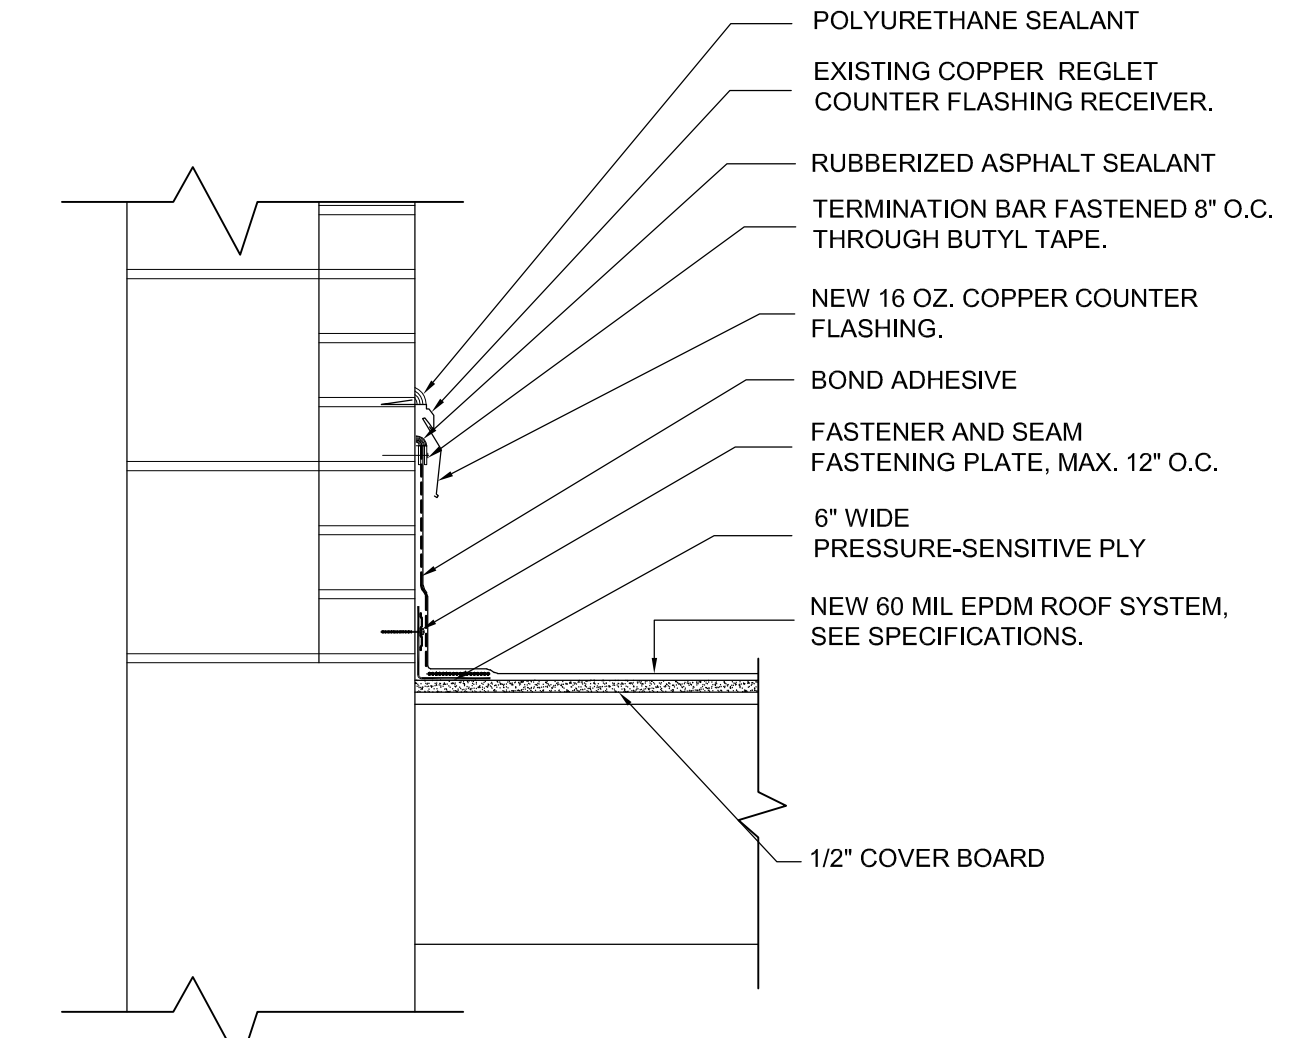
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Sheet No:  
**A-100**  
Sheet 2 of 6







**8 Roof Detail @ Parapet (New)**  
SCALE: 1 1/2" = 1'-0"



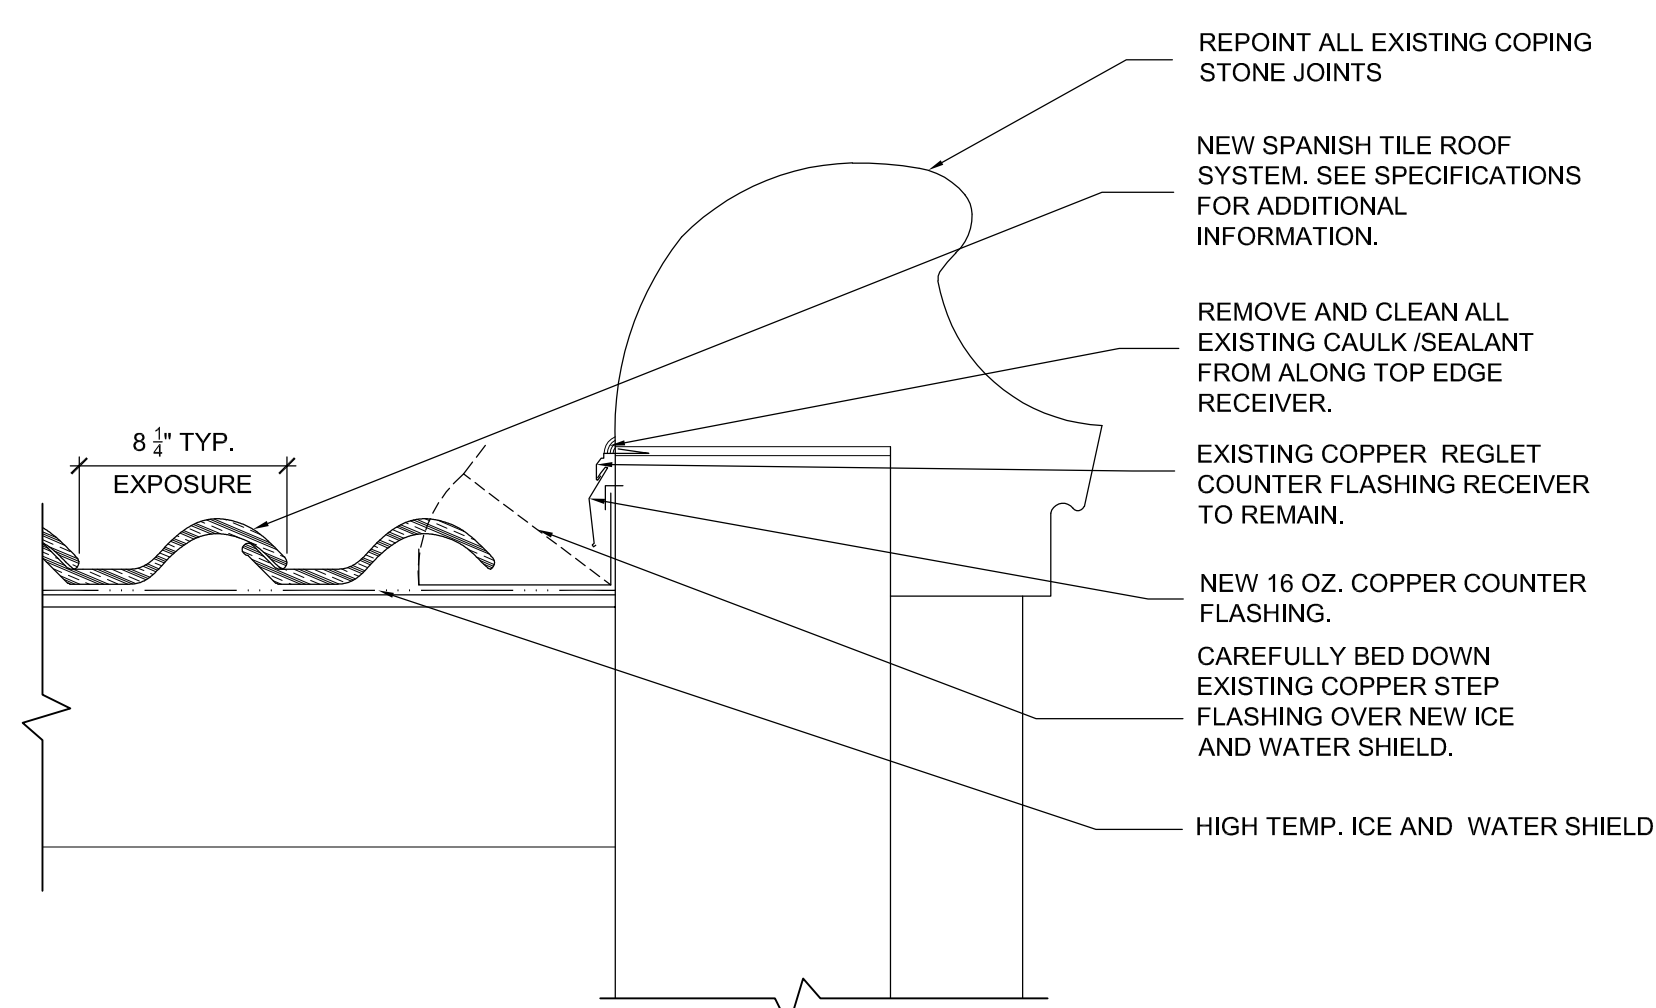
**7 Roof Detail @ Roof / Wall (New)**  
SCALE: 1 1/2" = 1'-0"



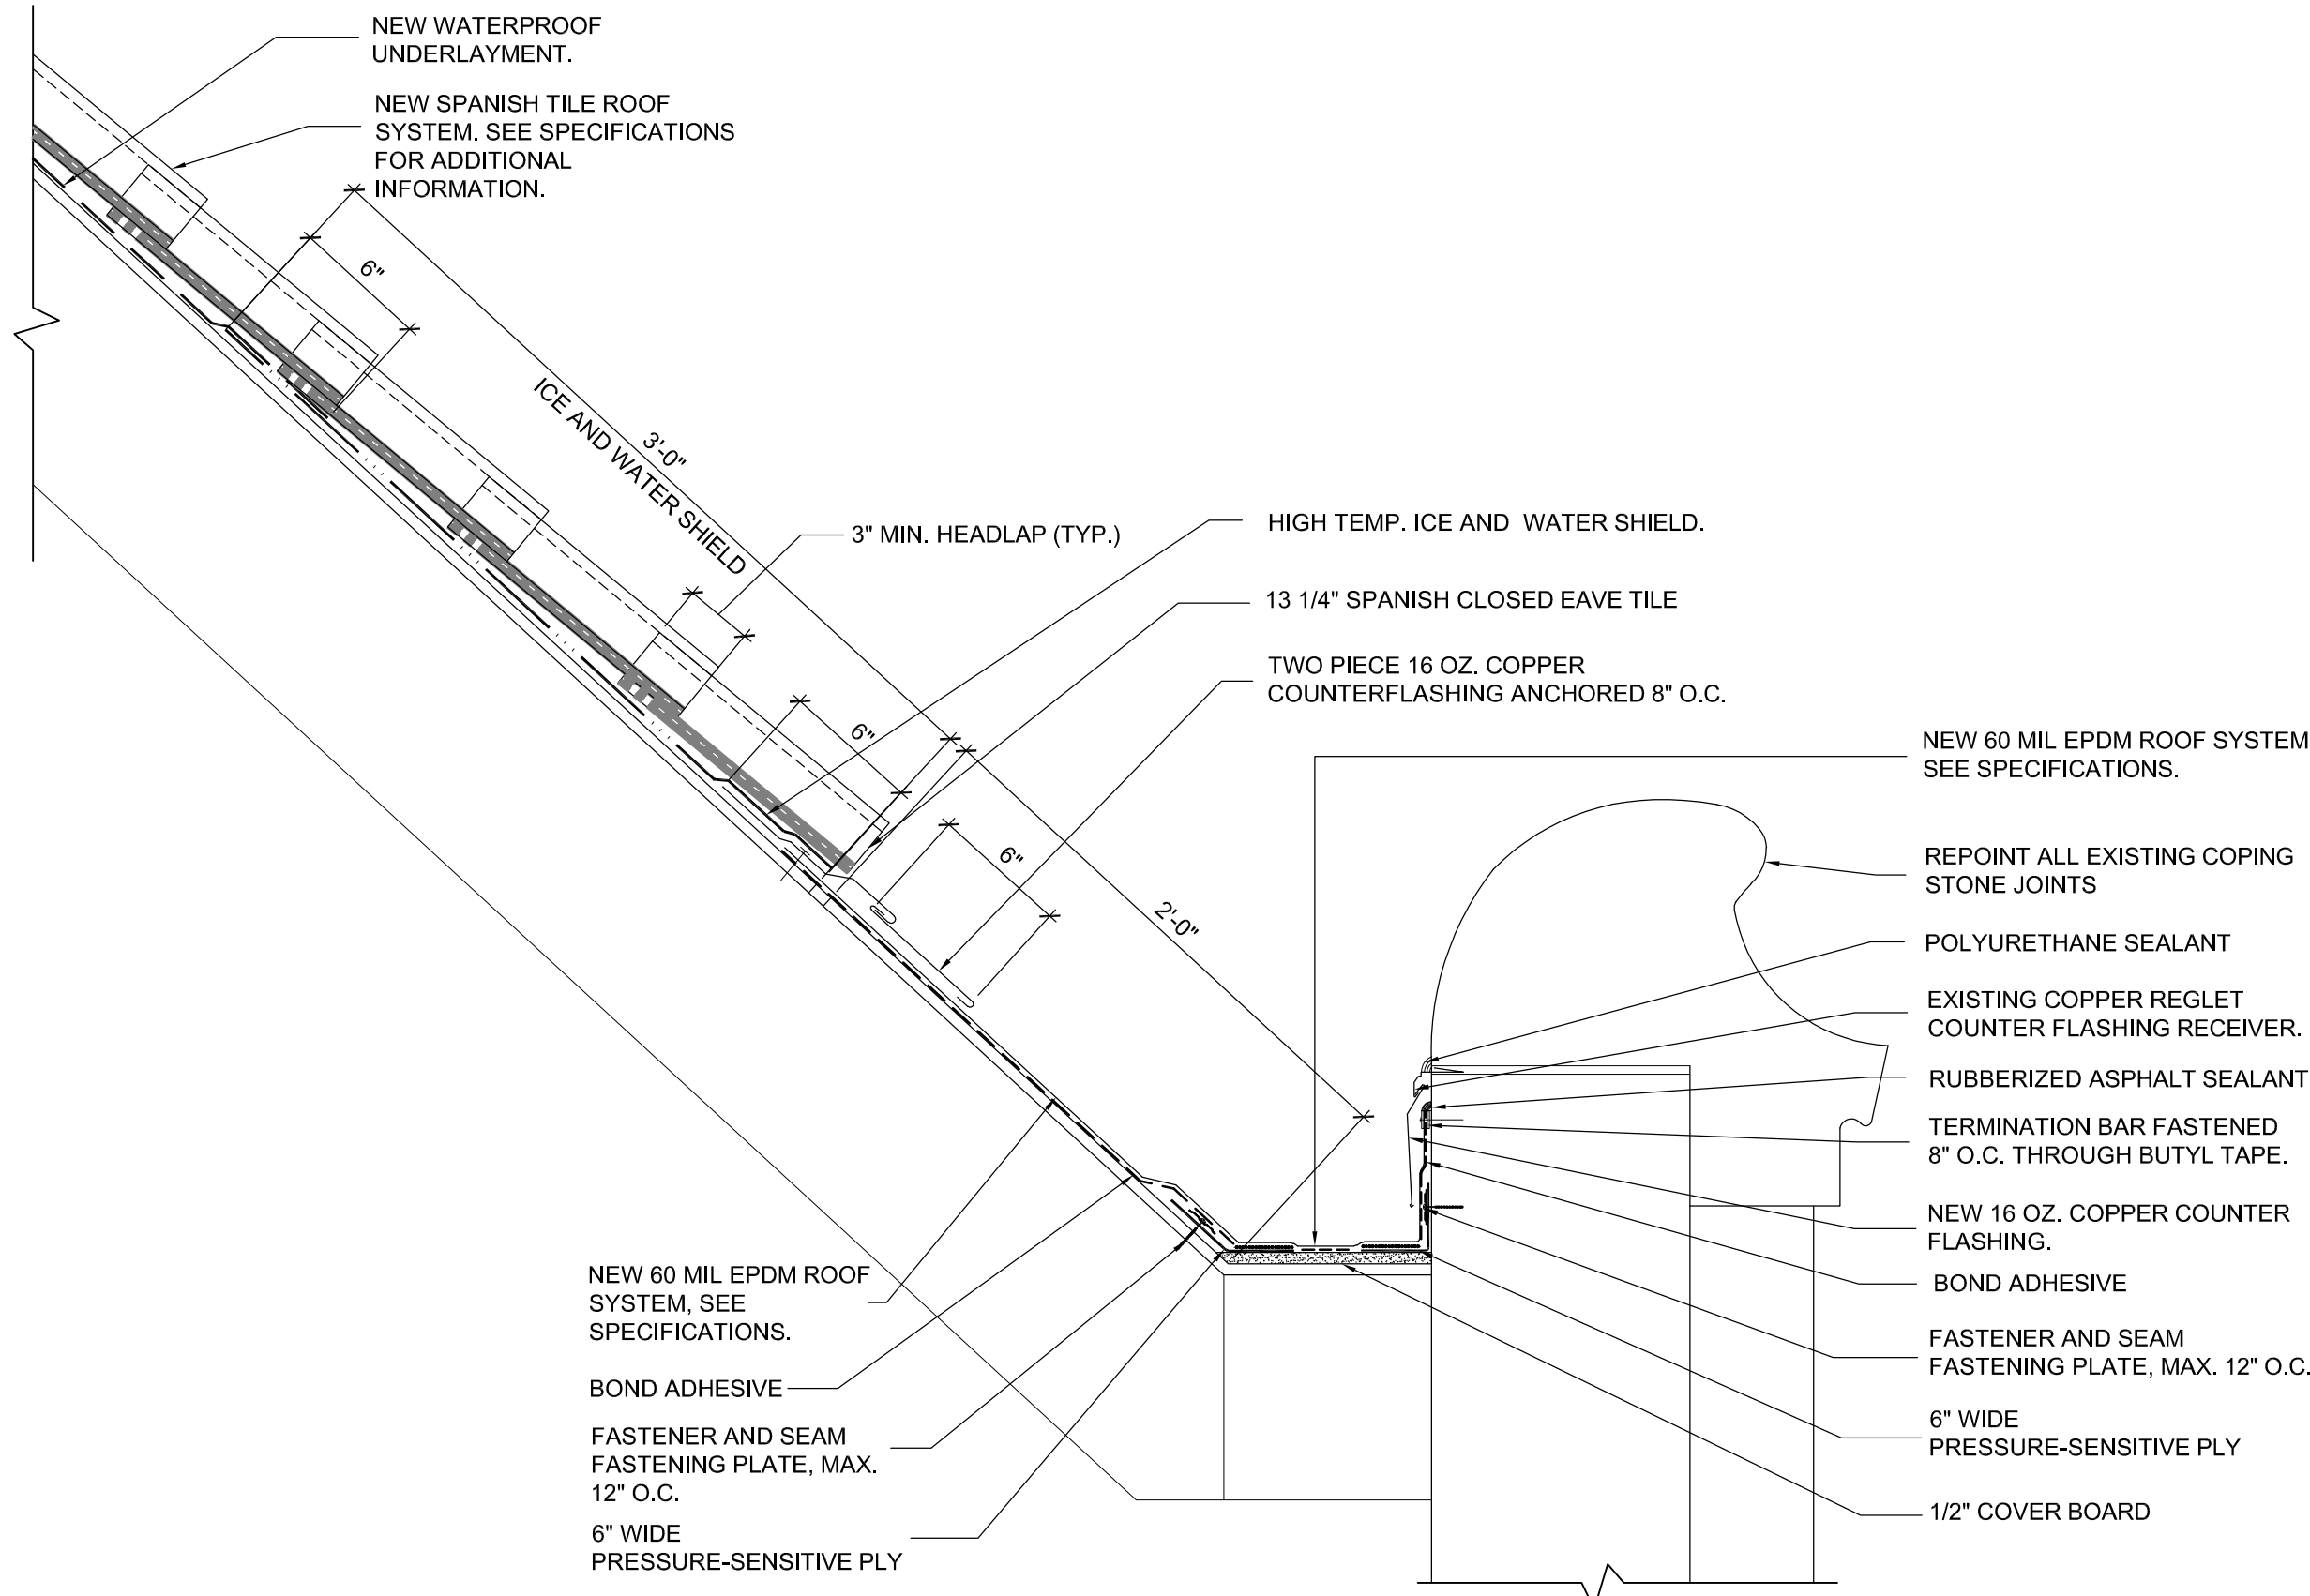
**6 Roof Detail @ Parapet (New)**  
SCALE: 1 1/2" = 1'-0"



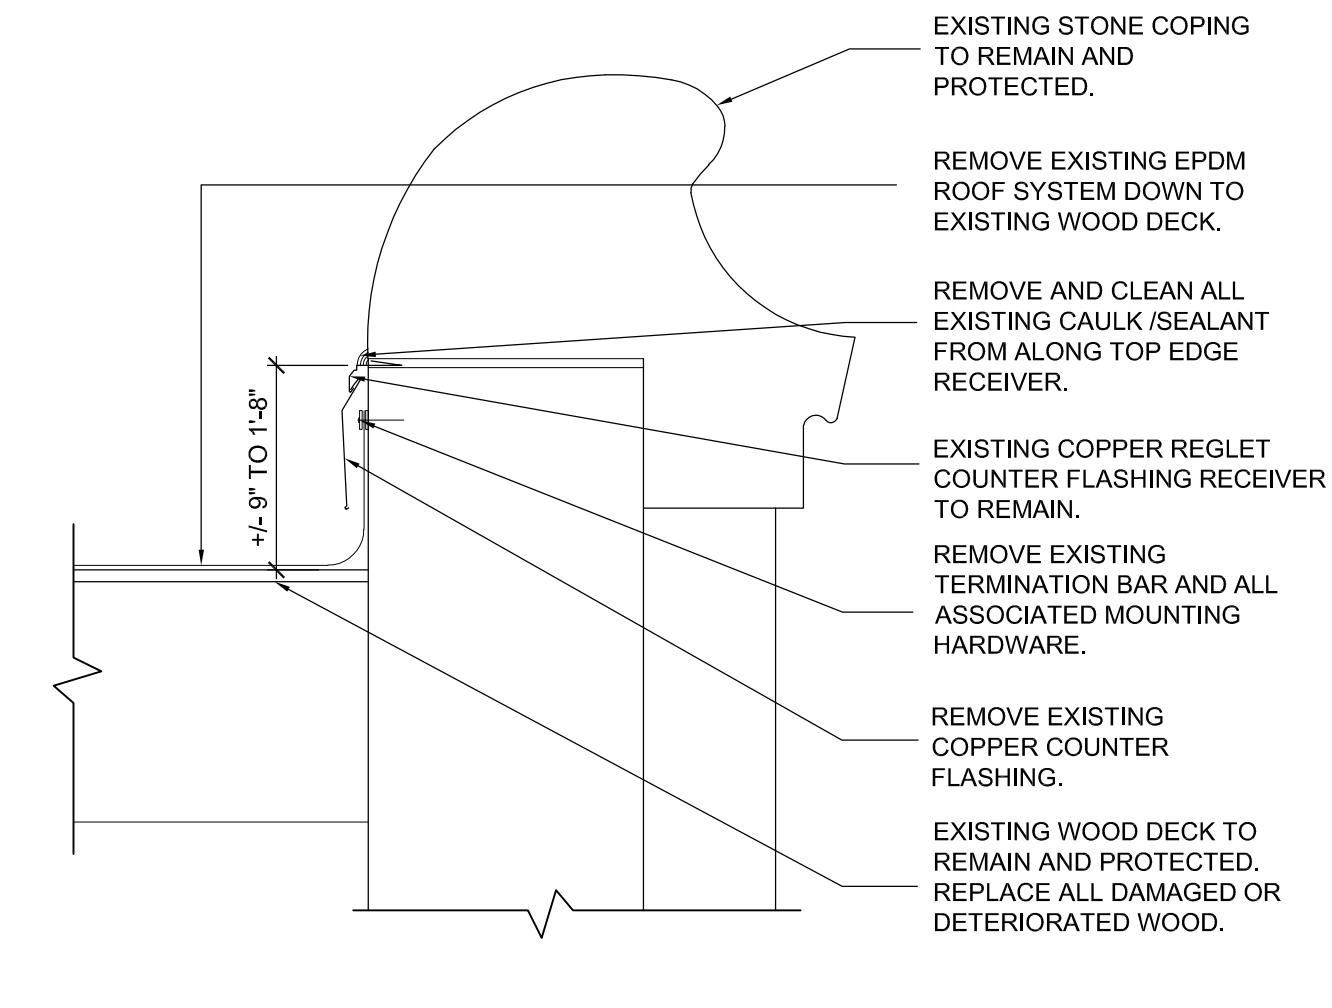
**5 Roof Detail @ Parapet (New)**  
SCALE: 1 1/2" = 1'-0"



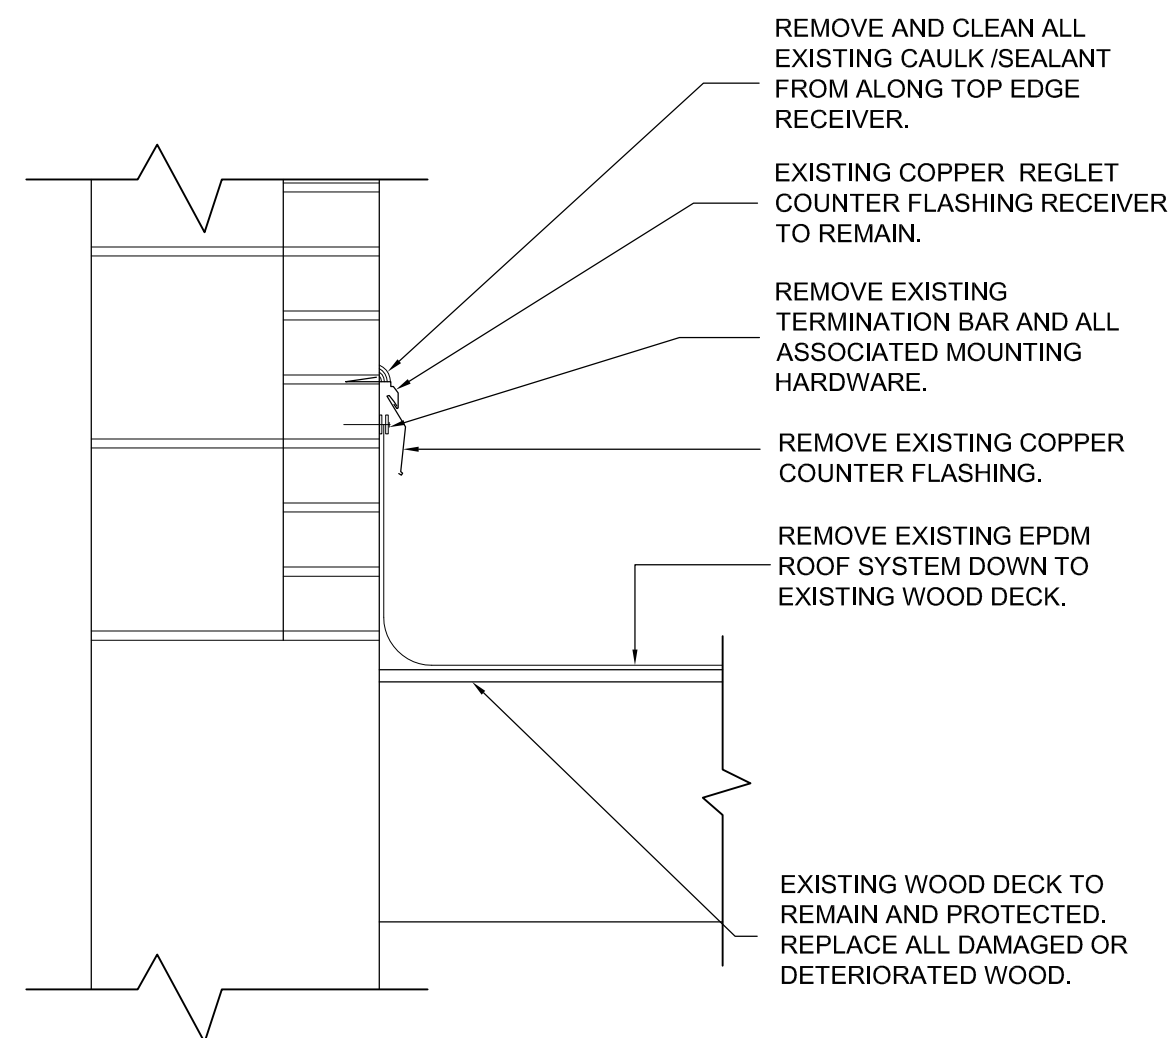
**4 Roof Detail @ Parapet (Existing)**  
SCALE: 1 1/2" = 1'-0"



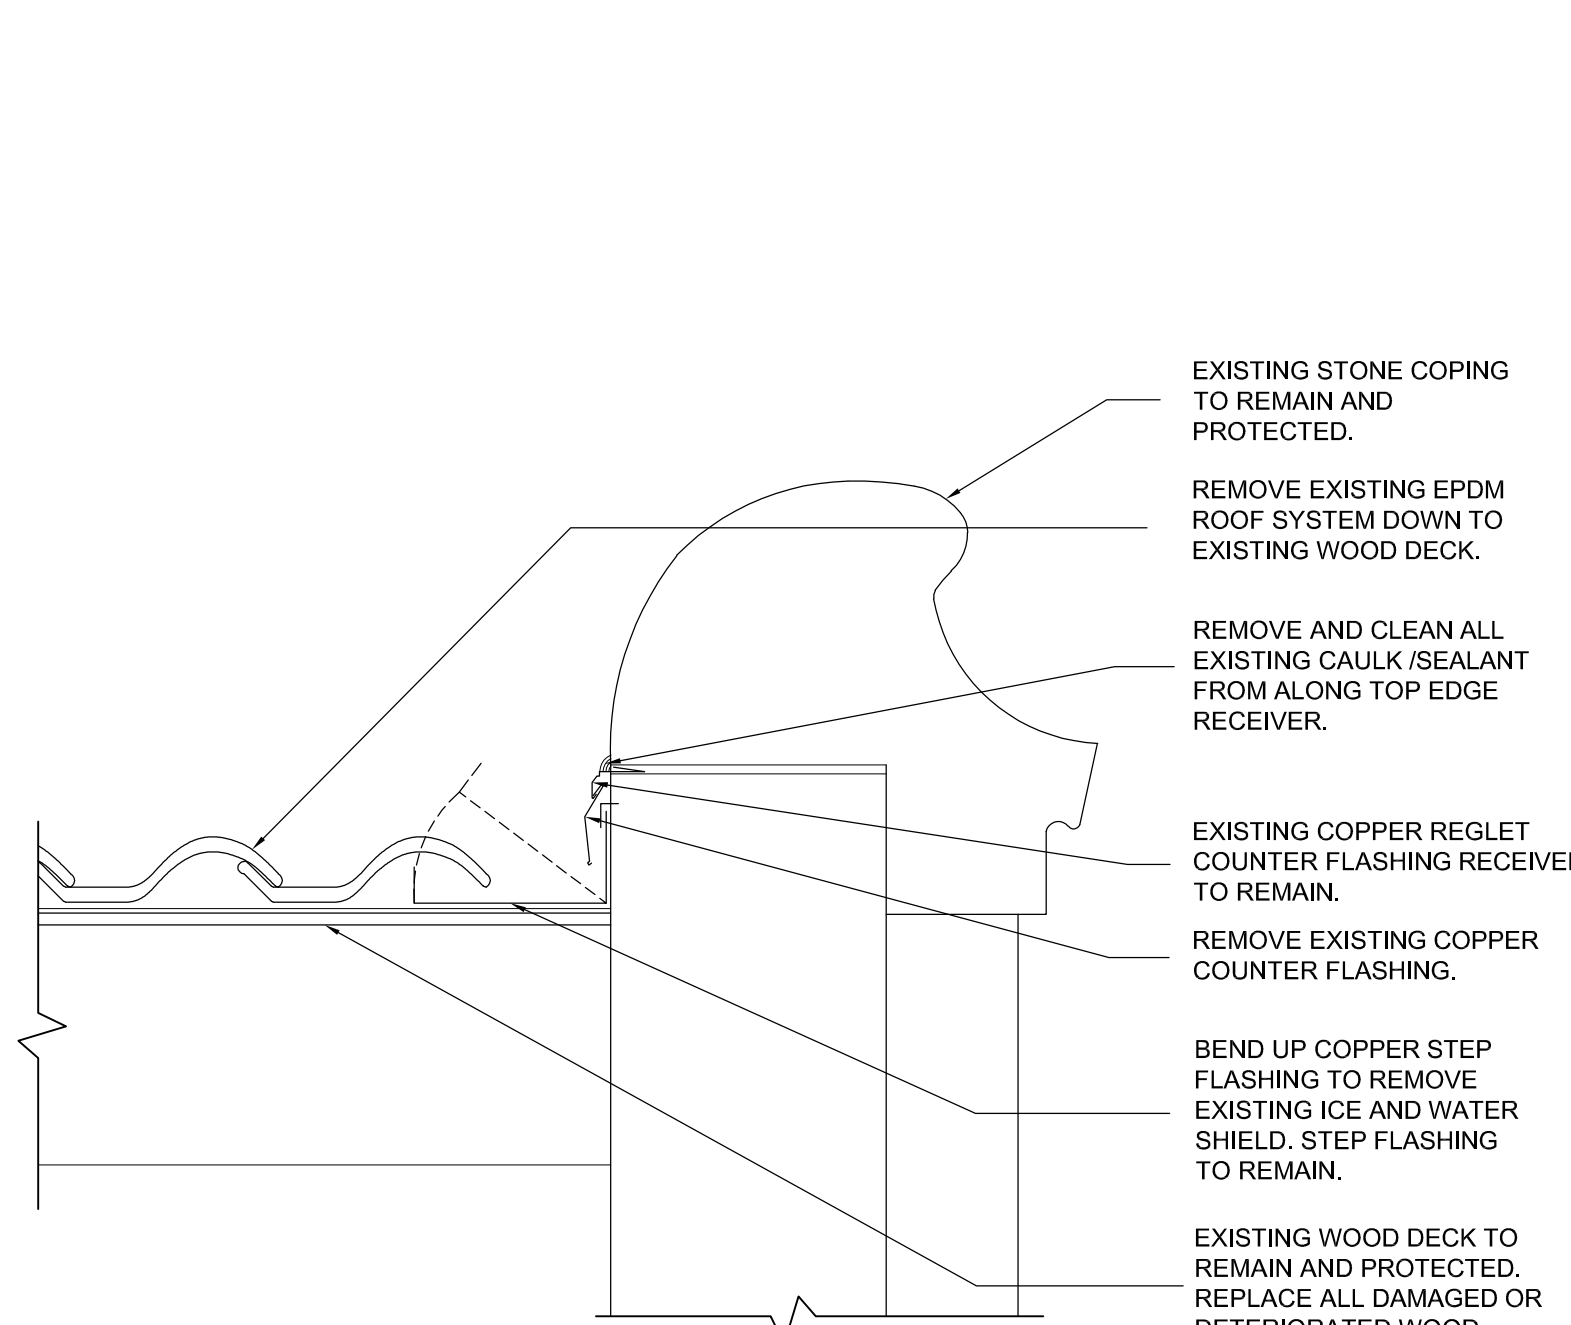**3 Roof Detail @ Roof / Wall (Existing)**  
SCALE: 1 1/2" = 1'-0"



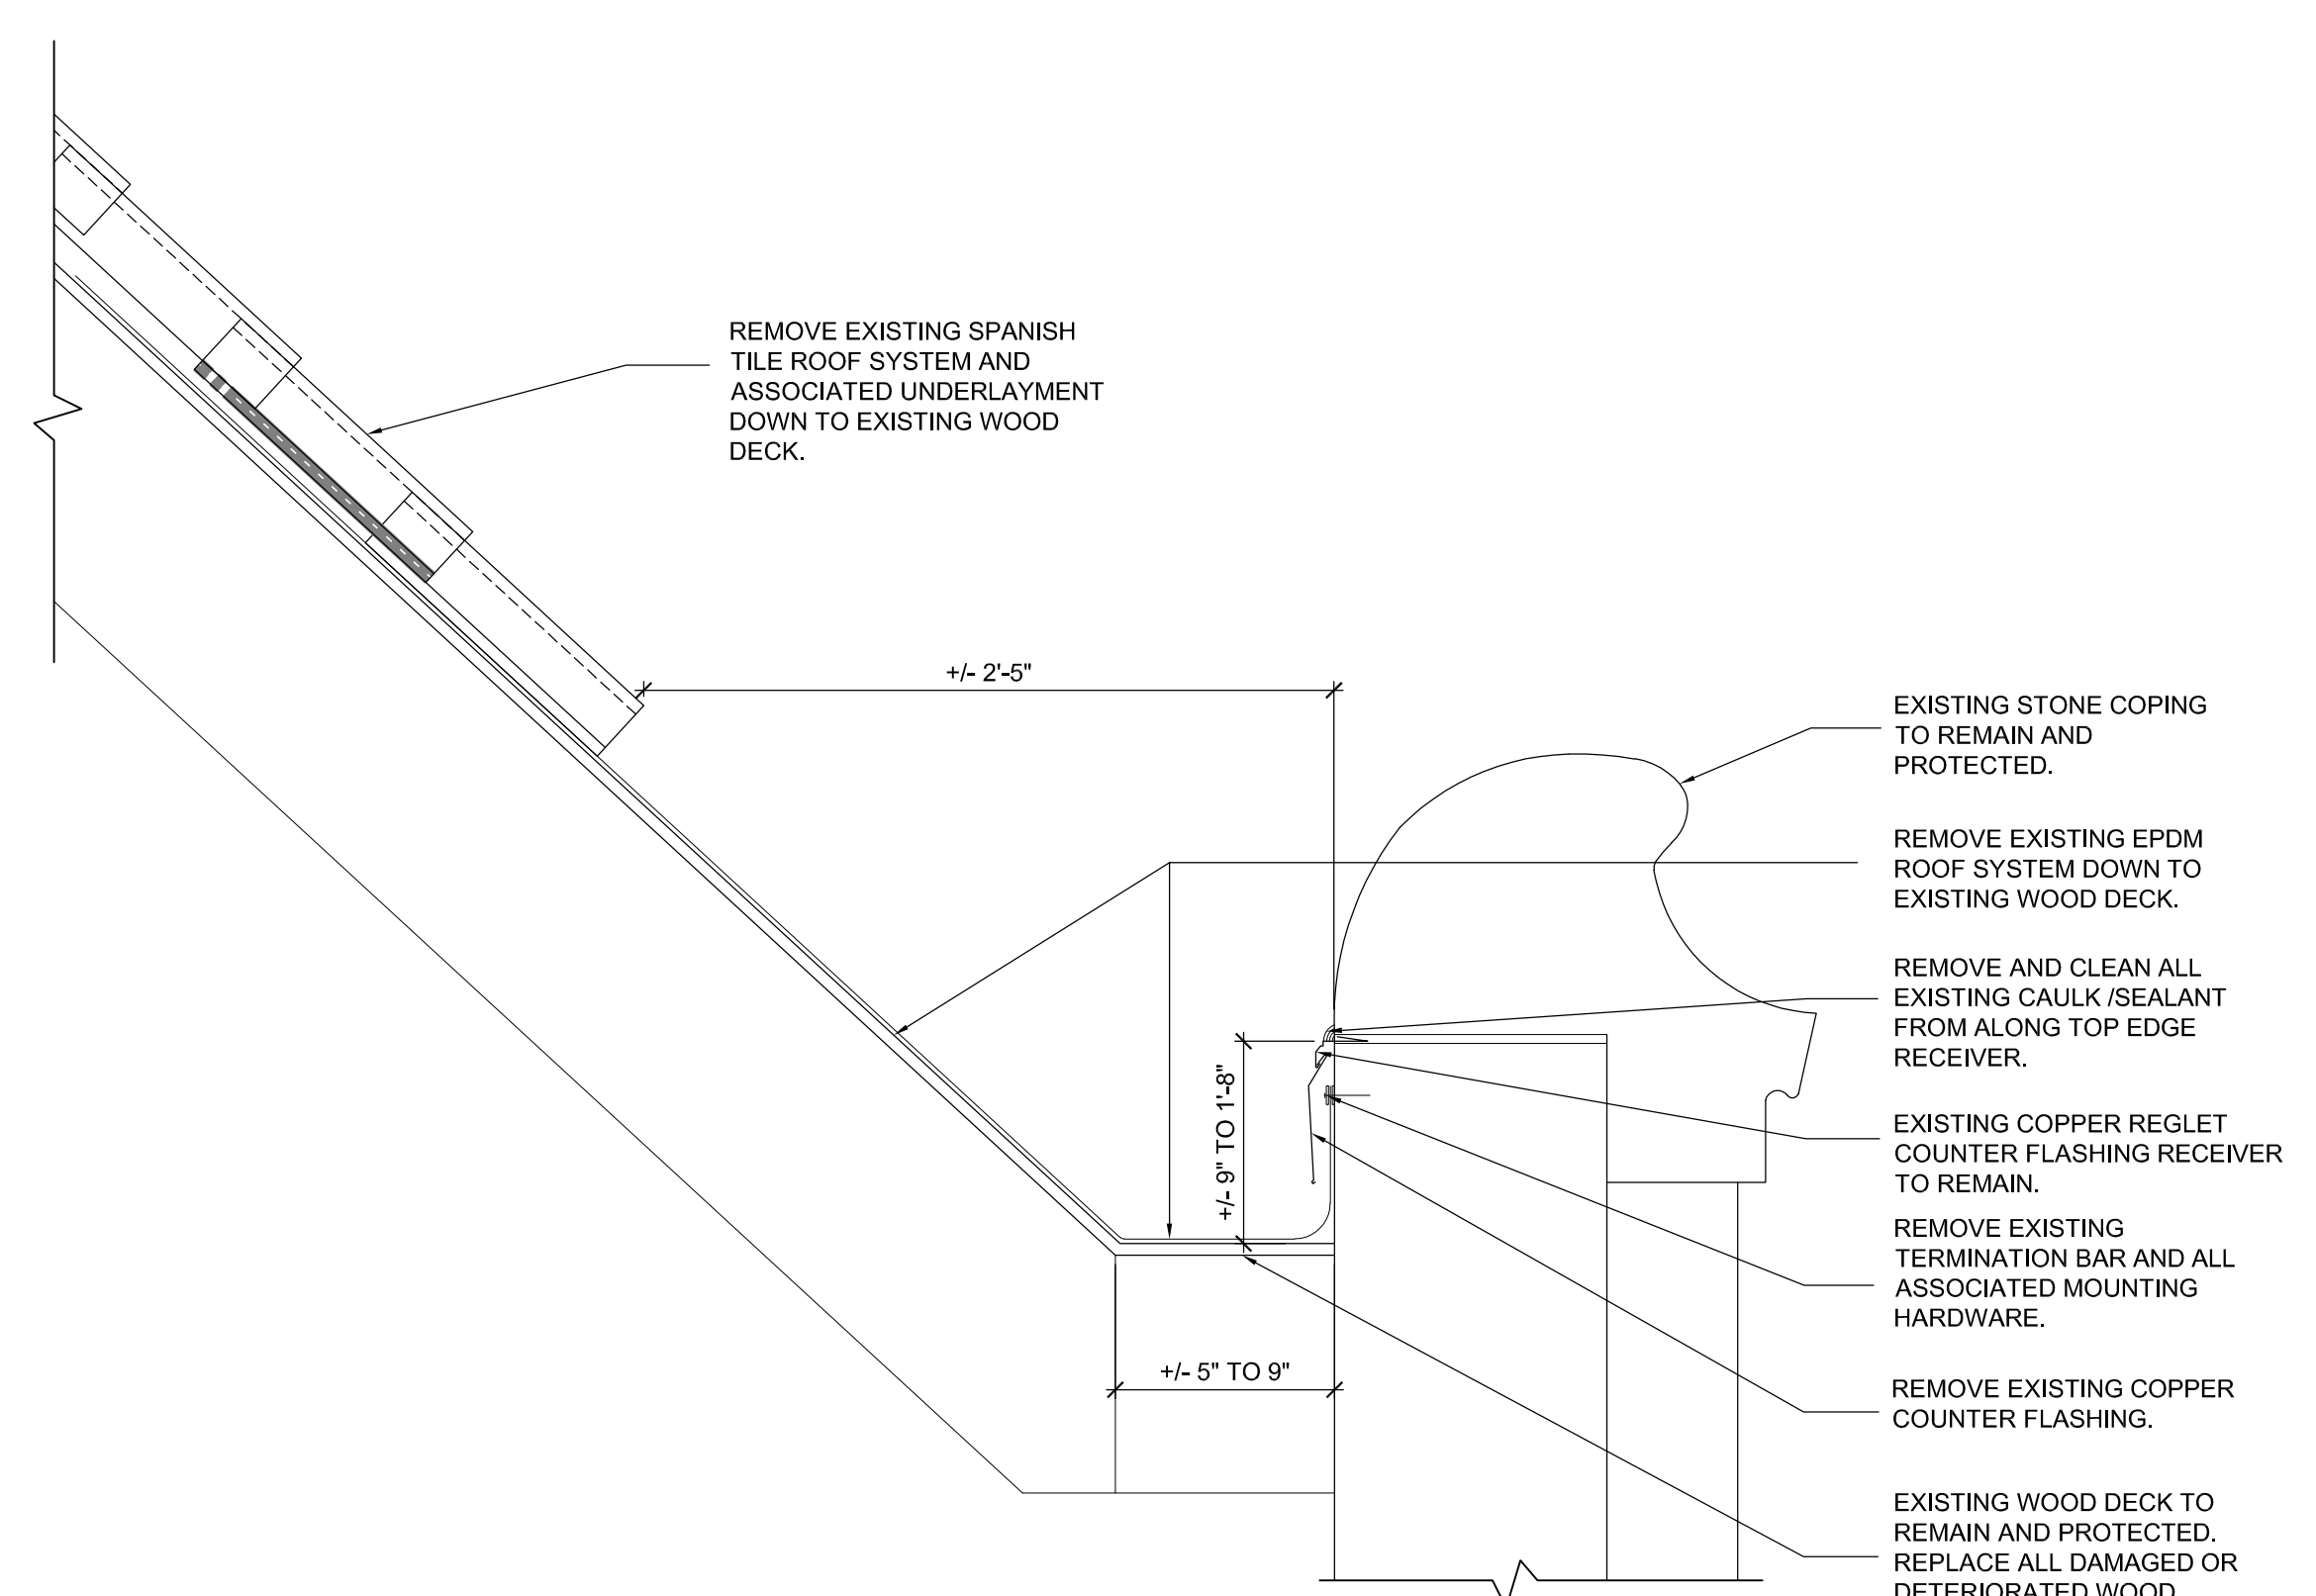**2 Roof Detail @ Parapet (Existing)**  
SCALE: 1 1/2" = 1'-0"



**1 Roof Detail @ Parapet (Existing)**  
SCALE: 1 1/2" = 1'-0"

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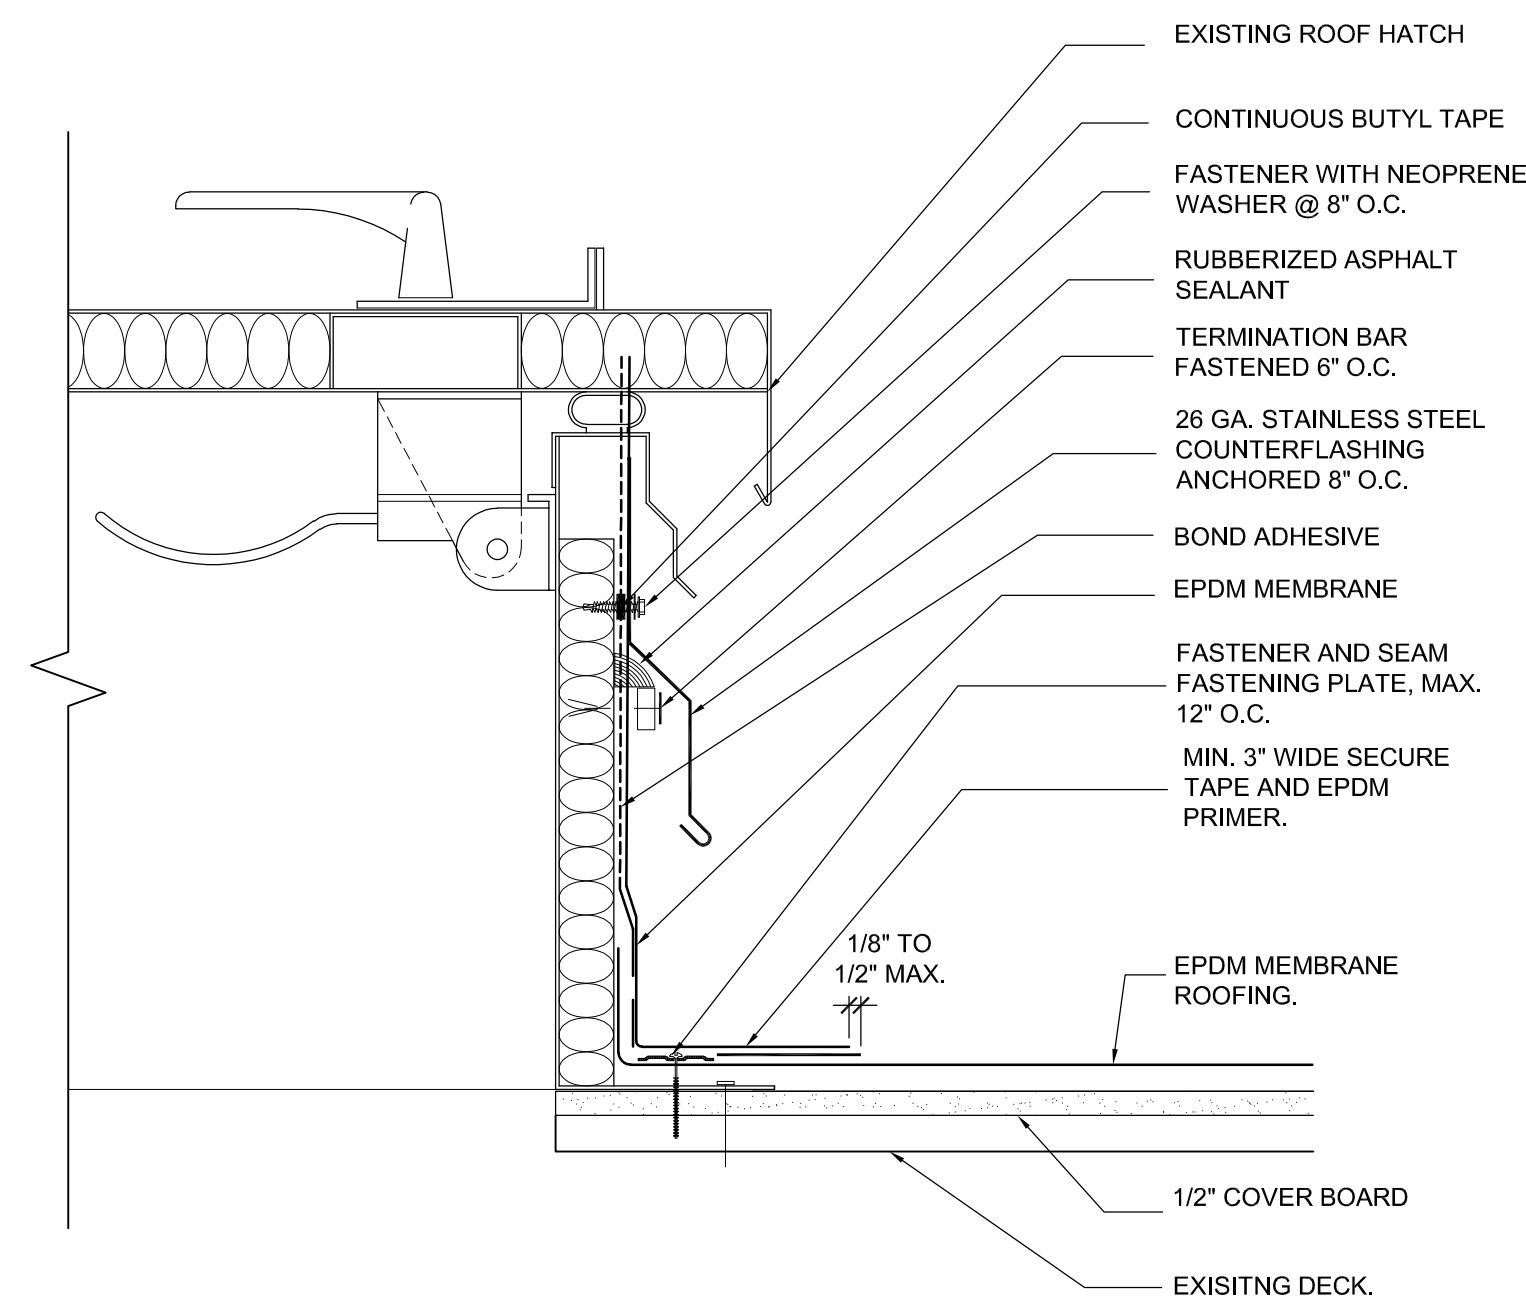
Project:  
**Free Library of Philadelphia**  
 Richmond Branch  
 2987 Almond Street  
 Philadelphia, PA 19134

Drawing Information:  
 Project No: 23-002  
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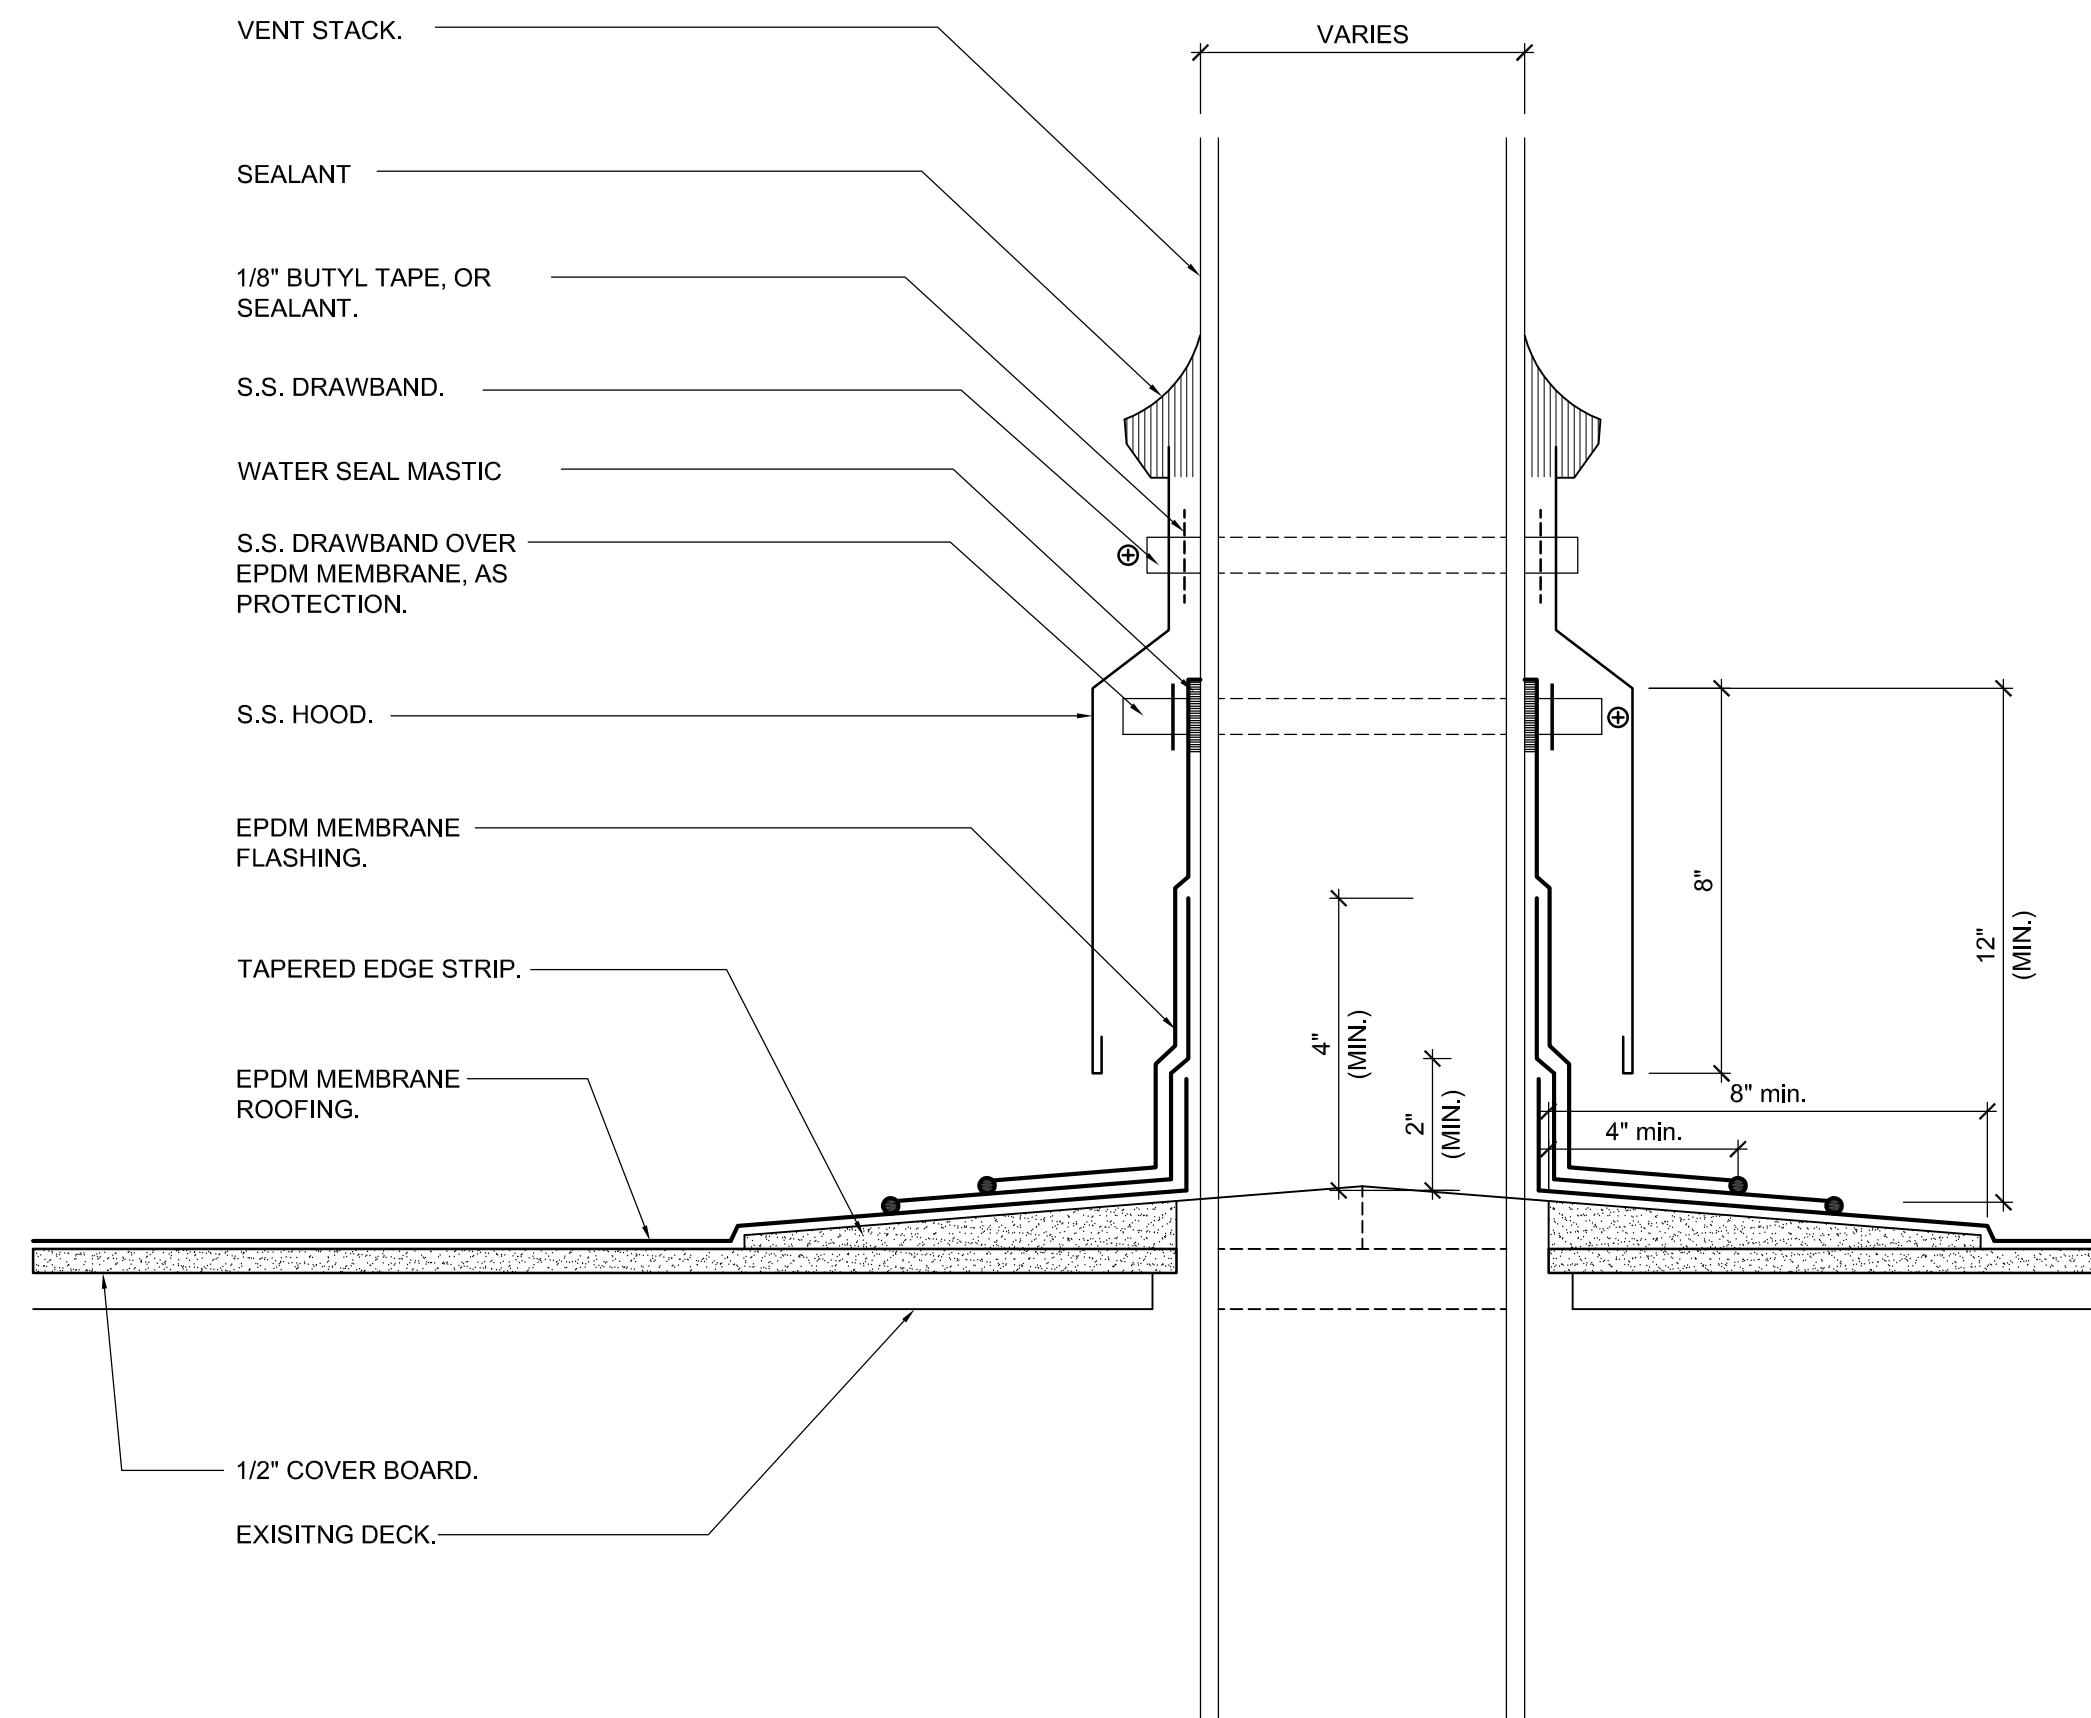
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**ROOF DETAILS**

Sheet No:  
**A-101**  
 Sheet 3 of 6

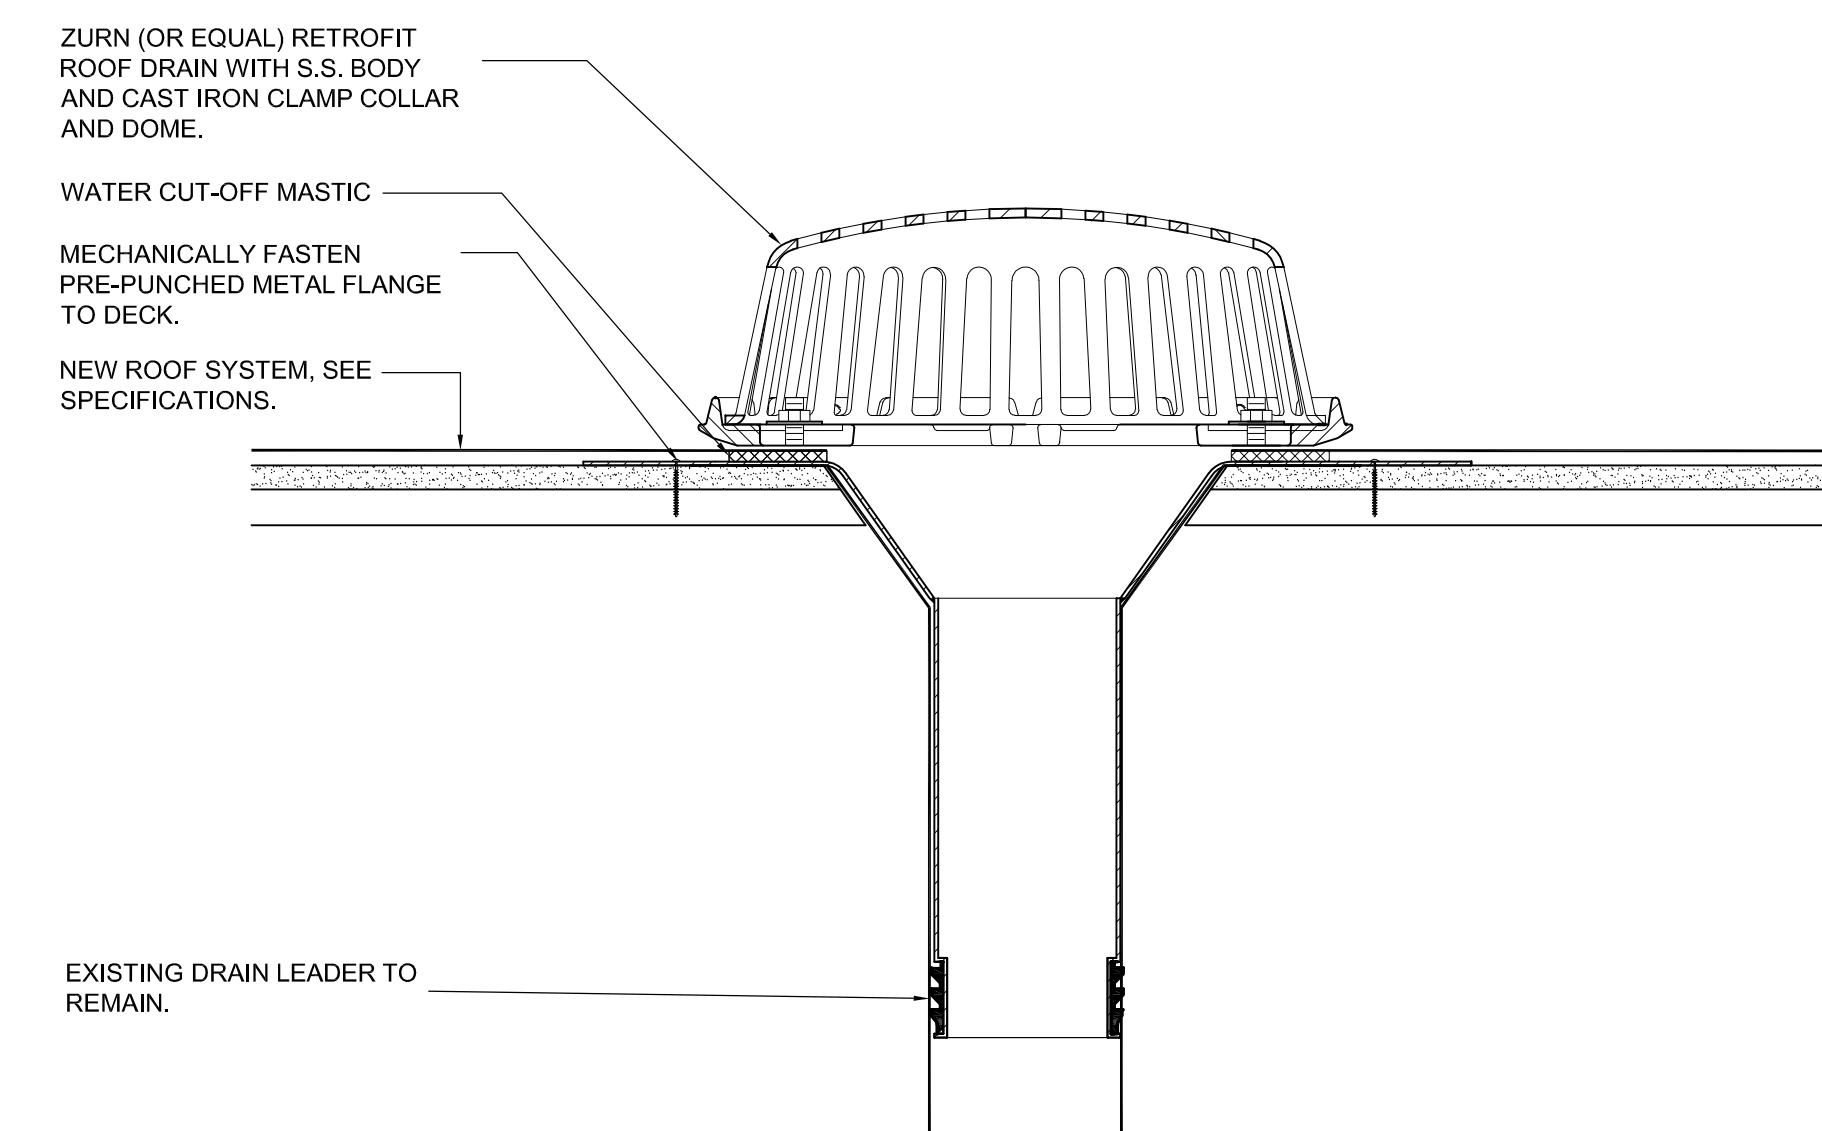




**3** Roof Detail @ Roof Hatch  
 SCALE: 3" = 1'-0"



**2** Roof Detail @ Vent Pipe  
 SCALE: 3" = 1'-0"



**1** Roof Detail @ Drain  
 SCALE: 3" = 1'-0"

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Clients:



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 Philadelphia, PA 19146

Project:

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 Richmond Branch  
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Drawing Information:  
 Project No: 23-002  
 Date: 06-30-2023  
 Drawn By: WH  
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Sheet Name:  
**TYPICAL ROOF DETAILS**

Sheet No:

**A-102**  
 Sheet 4 of 6



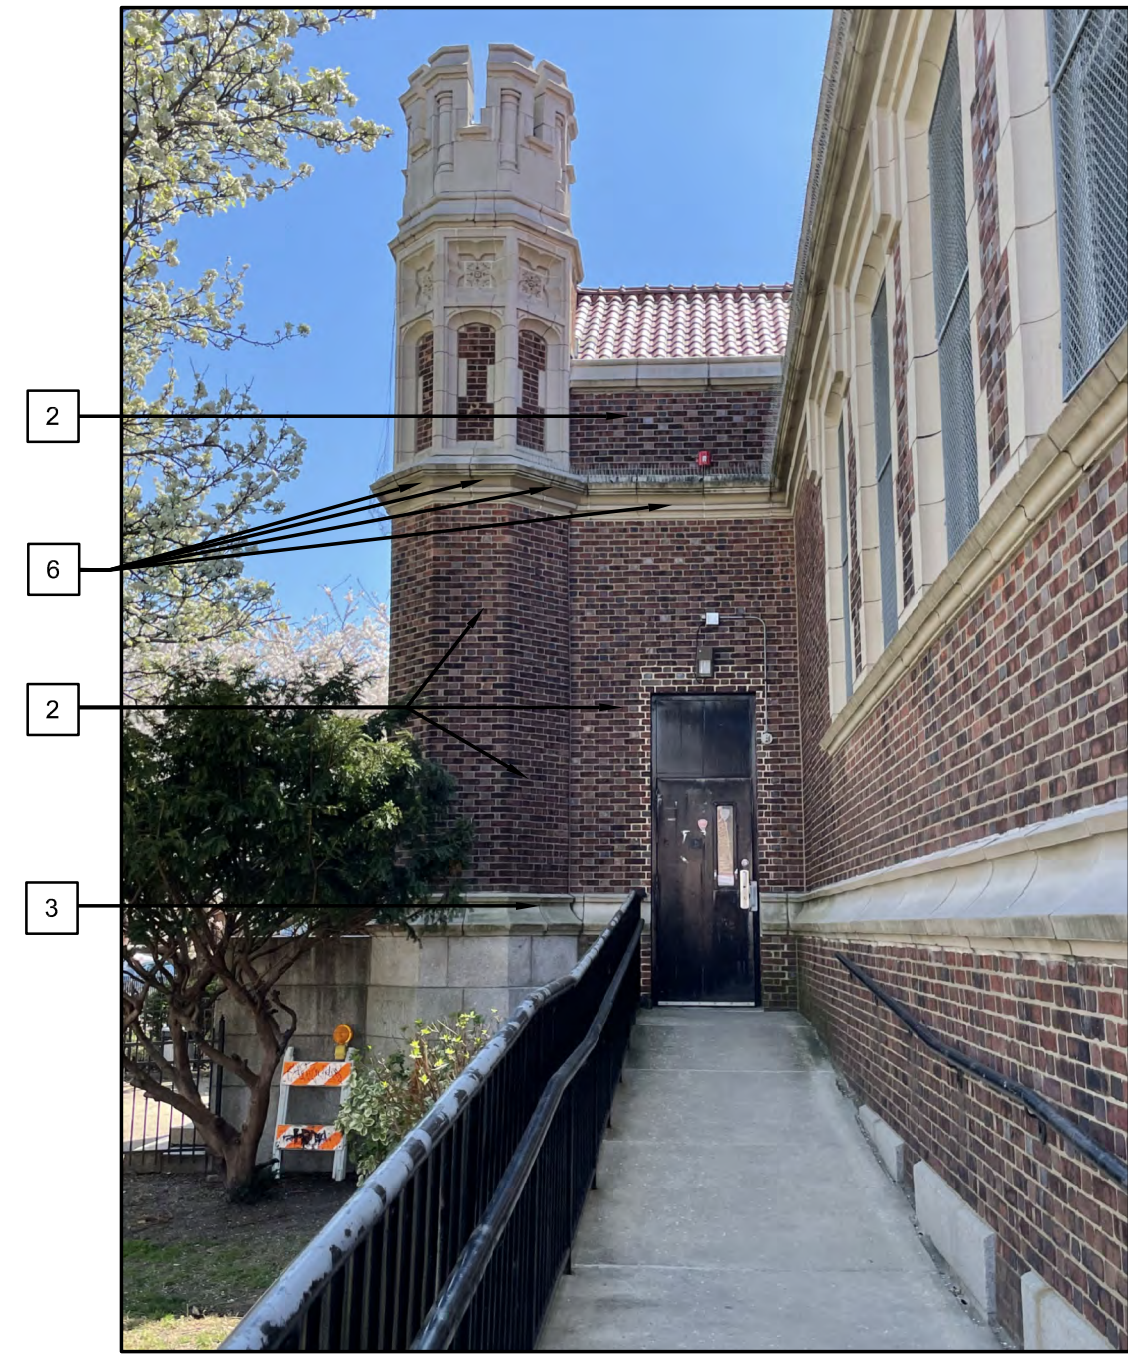


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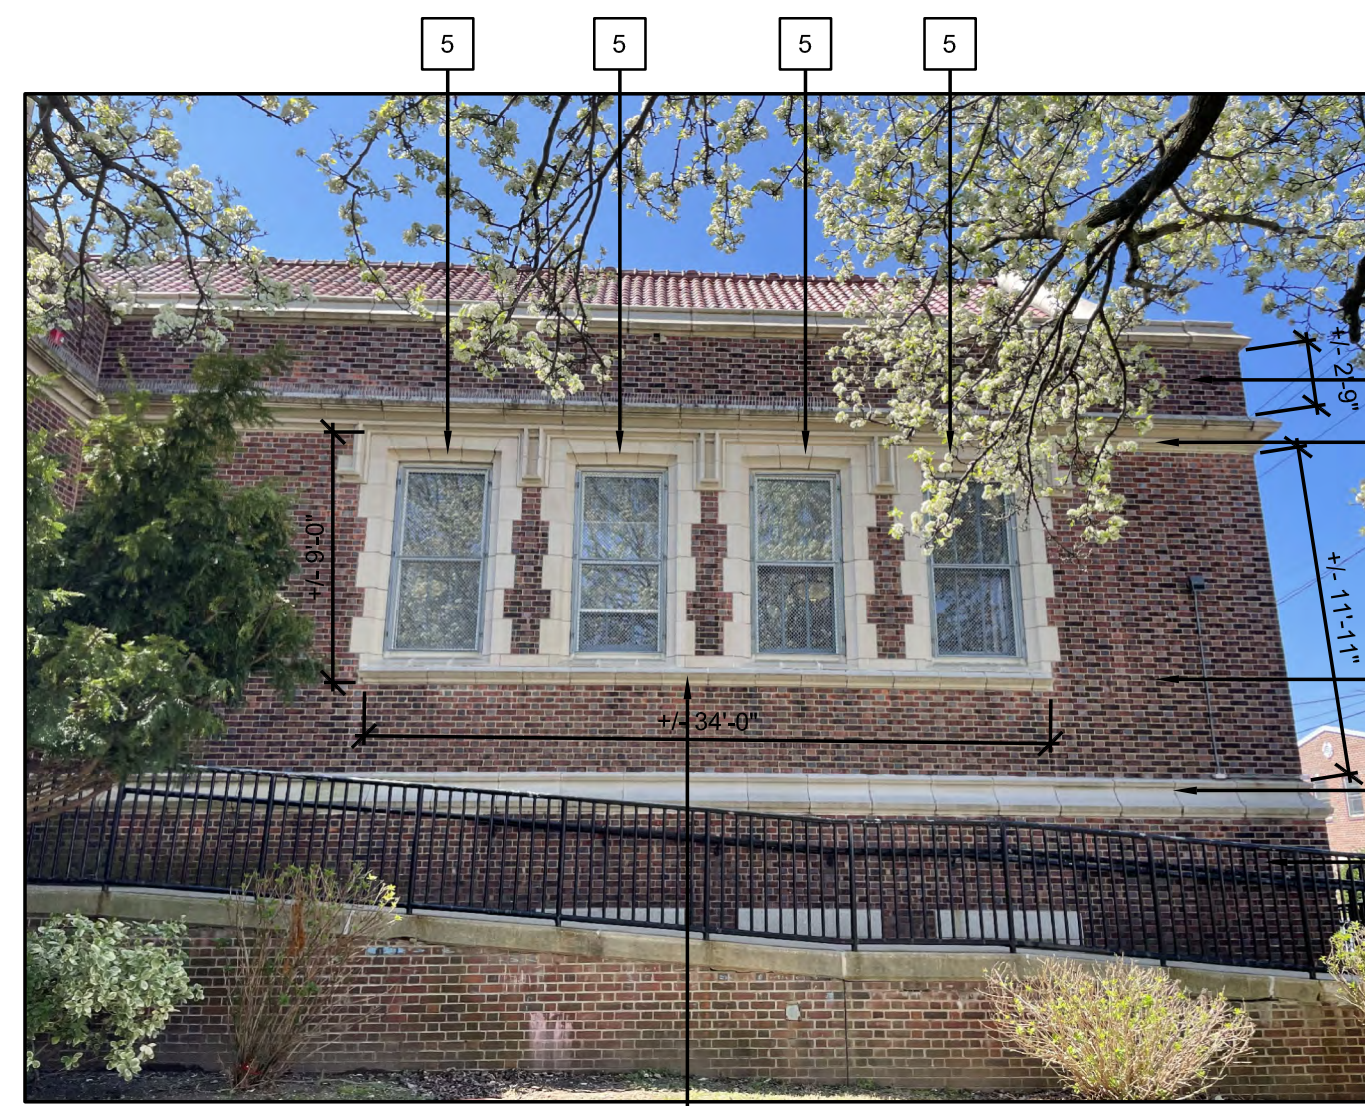
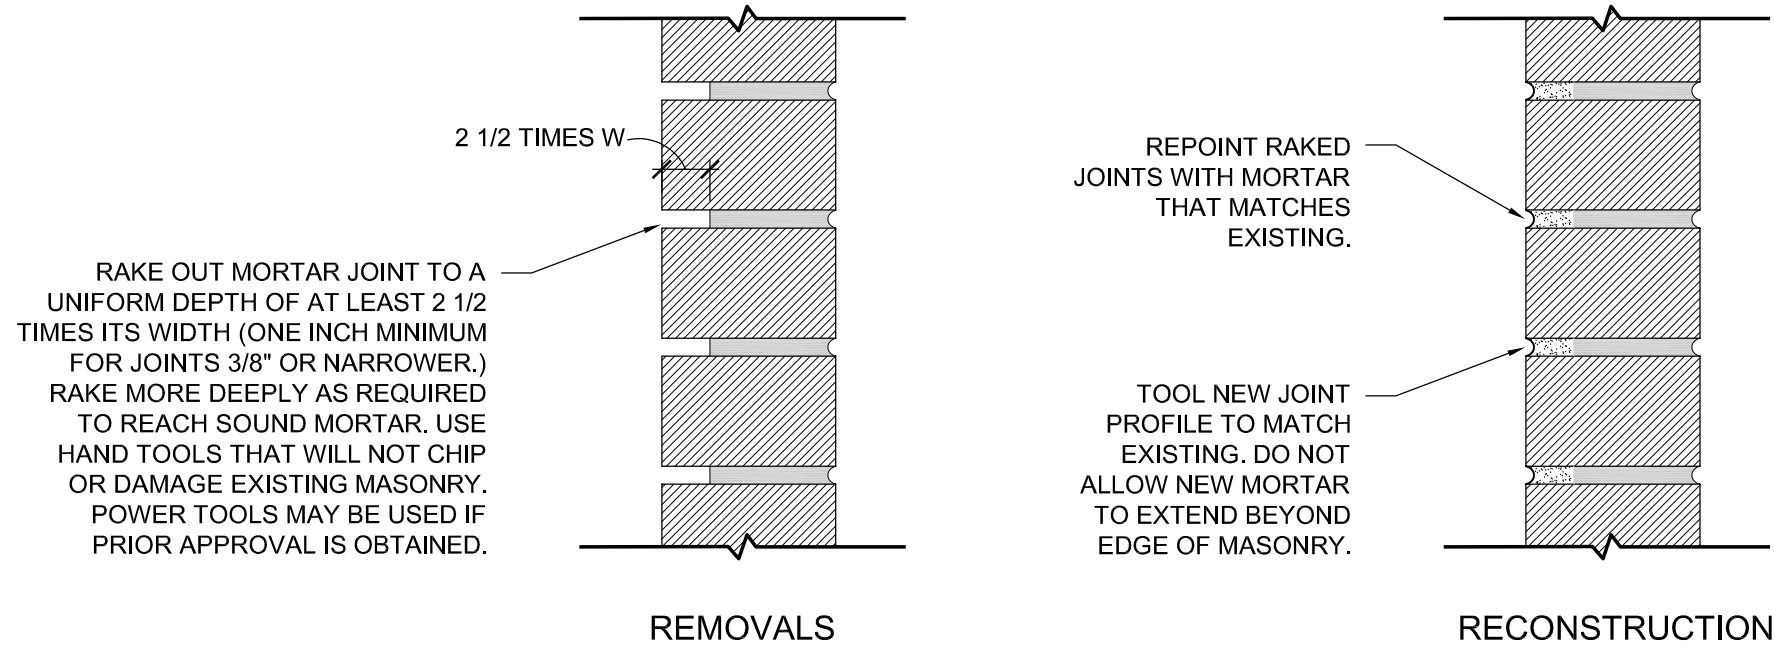



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### 4 MASONRY JOINT REPOINTING DETAIL

SCALE: 3" = 1'-0"

- #### New Work Notes
- 1 RAKE AND REPOINT BRICK MASONRY OF CHIMNEY IN ITS ENTIRETY. (ALL FOUR SIDES) SEE DETAILS 3/A-103 AND 4/A-103 FOR ADDITIONAL INFORMATION.
  - 2 RAKE AND REPOINT 100% BRICK MASONRY. SEE DETAILS 3/A-103 AND 4/A-103 FOR ADDITIONAL INFORMATION.
  - 3 RAKE AND REPOINT ALL TERRA COTTA BAND JOINTS INCLUDING CONTINUOUS TOP AND BOTTOM JOINTS. SEE DETAILS 3/A-103 AND 4/A-103 FOR ADDITIONAL INFORMATION.
  - 4 RAKE AND REPOINT ALL TERRA COTTA WINDOW WILL JOINTS INCLUDING CONTINUOUS TOP AND BOTTOM JOINTS. SEE DETAILS 3/A-103 AND 4/A-103 FOR ADDITIONAL INFORMATION.
  - 5 RAKE AND REPOINT ALL TERRA COTTA WINDOW SURROUNDS INCLUDING CONTINUOUS TOP AND BOTTOM JOINTS. SEE DETAILS 3/A-103 AND 4/A-103 FOR ADDITIONAL INFORMATION. CAREFULLY REMOVE AND STORE WINDOW SECURITY GRILLS AND REINSTALL FOLLOWING THE COMPLETION OF MASONRY WORK.
  - 6 RAKE AND REPOINT ALL TERRA COTTA COURSE INCLUDING CONTINUOUS TOP AND BOTTOM JOINTS. SEE DETAILS 3/A-103 AND 4/A-103 FOR ADDITIONAL INFORMATION.
  - 7 RAKE AND REPOINT ALL TERRA COTTA ENTRANCE SURROUNDS. SEE DETAILS 3/A-103 AND 4/A-103 FOR ADDITIONAL INFORMATION. REMOVE EXISTING BIRD NETTING. INSTALL NEW BIRD NETTING TO MATCH EXISTING ONCE MASONRY WORK HAS BEEN COMPLETED.
  - 8 RAKE AND REPOINT ALL TERRA COTTA AND LIME STONE ENTRANCE SURROUNDS. SEE DETAILS 3/A-103 AND 4/A-103 FOR ADDITIONAL INFORMATION.
  - 9 CLEAN SURFACE OF MASONRY CHIMNEY CAP. RAKE AND REPOINT MASONRY JOINTS OF CHIMNEY CAP AND ROUND FLUE. PROVIDE AND INSTALL NEW 1/4" 17"x21" (VERIFY AND COORDINATE SIZE OF CAP WITH EXISTING CHIMNEY FLUE) 304 STAINLESS STEEL TOP MOUNTED MESH FLUE CAP.



### 3 POINTING DETAIL AT EXISTING JOINT

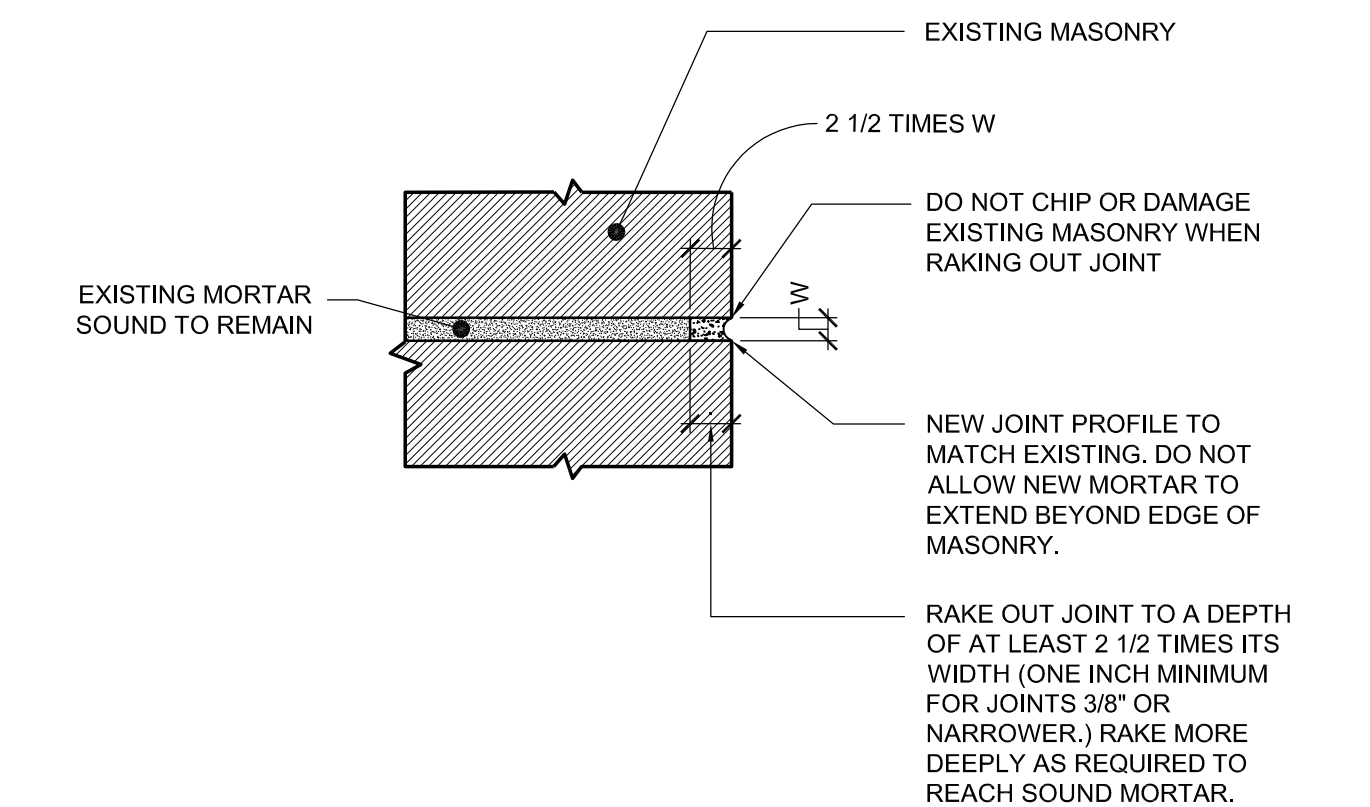SCALE: 3" = 1'-0"

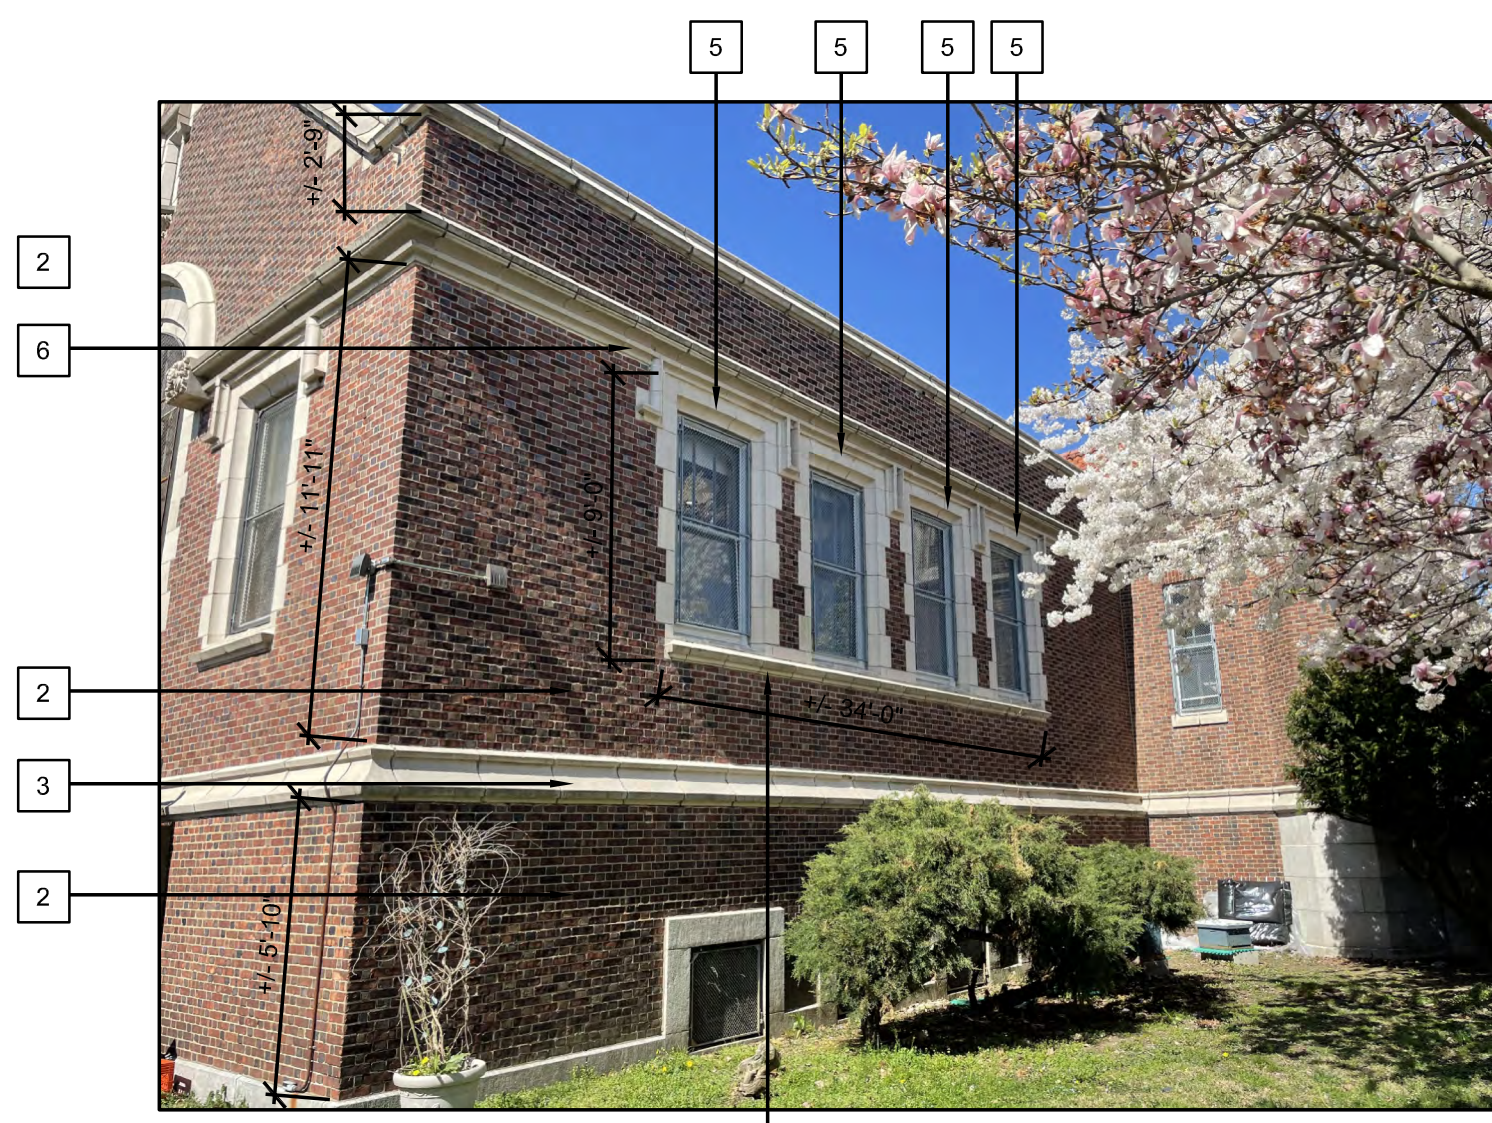


PHOTO No. 2.1



PHOTO No. 2.2



PHOTO No. 2.3



PHOTO No. 2.4



PHOTO No. 2.5

### 2 NORTH ELEVATION PHOTOS (ALTERNATE BID #1)

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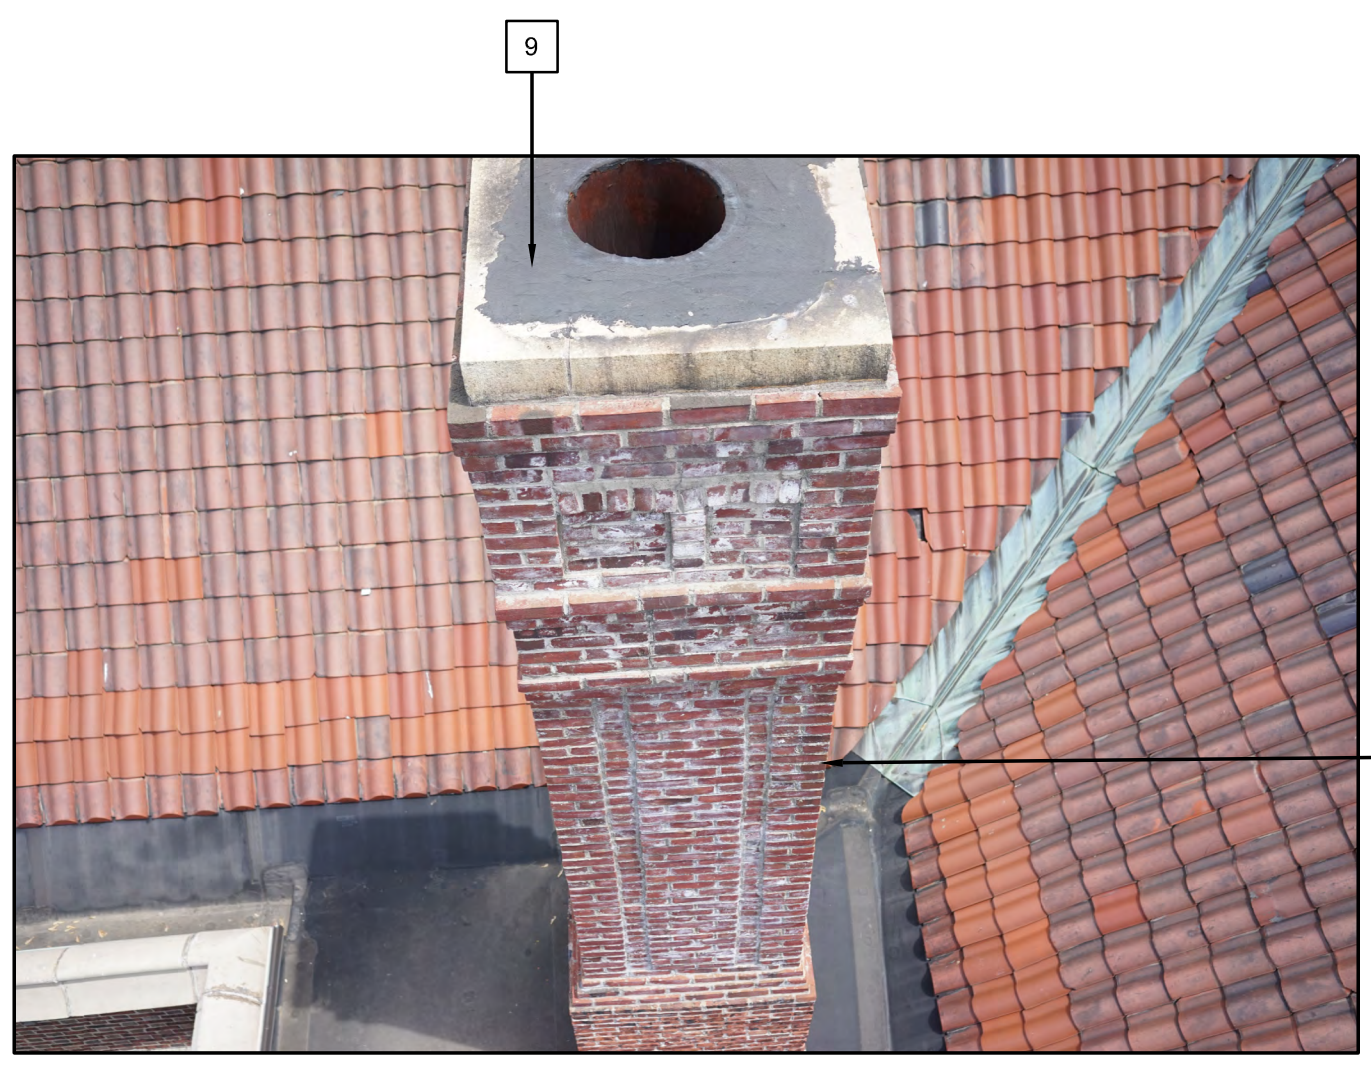


PHOTO No. 1.1



PHOTO No. 1.2



PHOTO No. 1.3



PHOTO No. 1.4

### 1 CHIMNEY ELEVATION PHOTOS (BASE BID)

SCALE: N.T.S.

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Sheet Name:  
**EXTERIOR PHOTOS, MASONRY DETAILS AND NOTES**

Sheet No:  
**A-103**  
Sheet 5 of 6





PHOTO No. 3.1



PHOTO No. 3.2

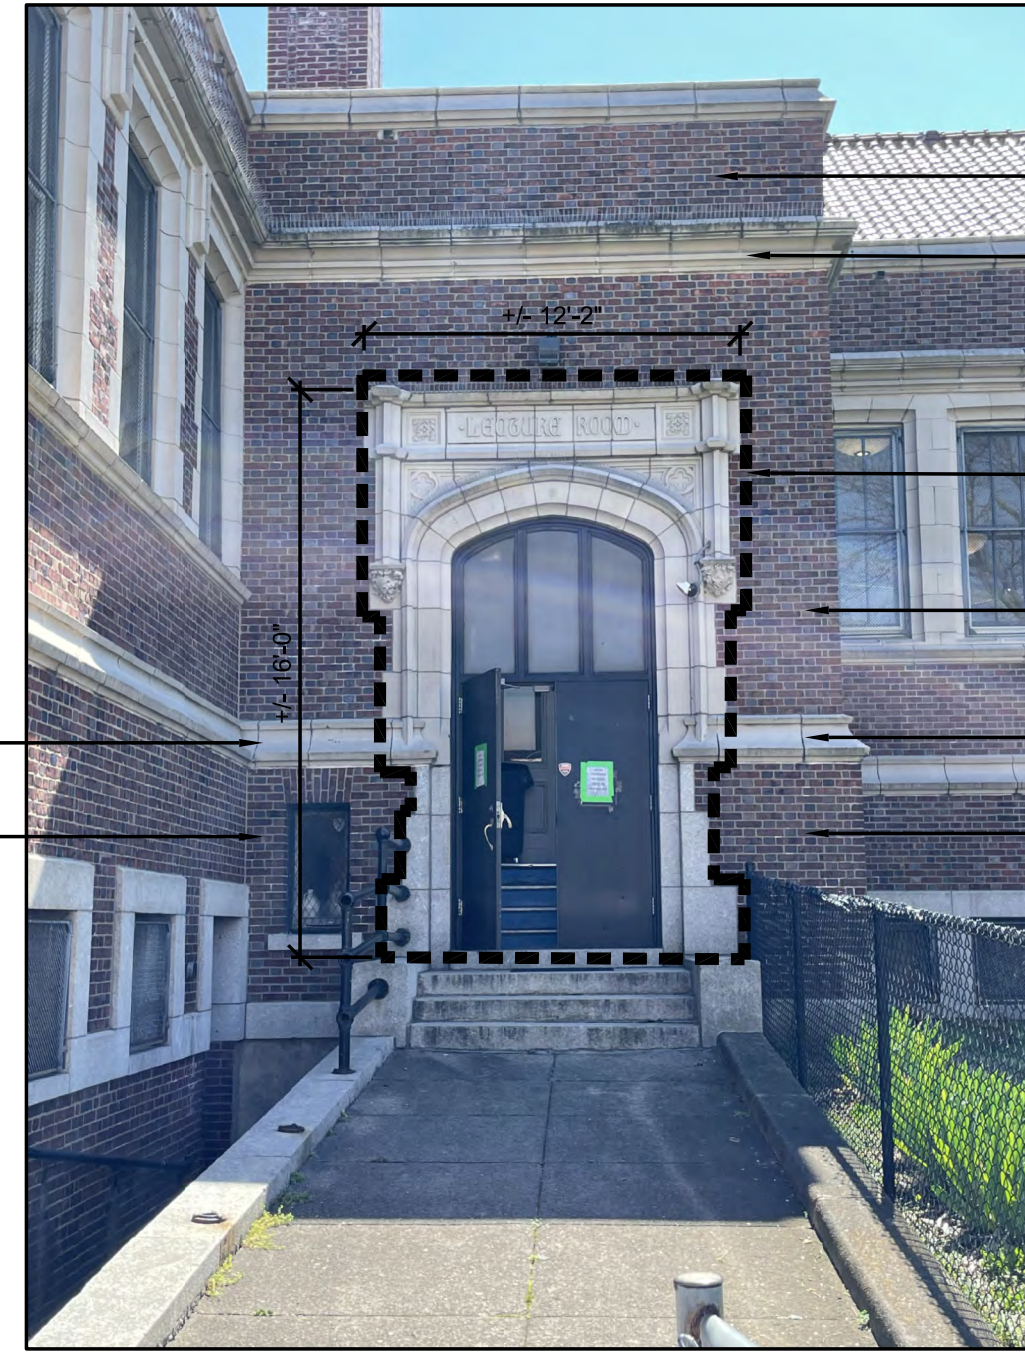


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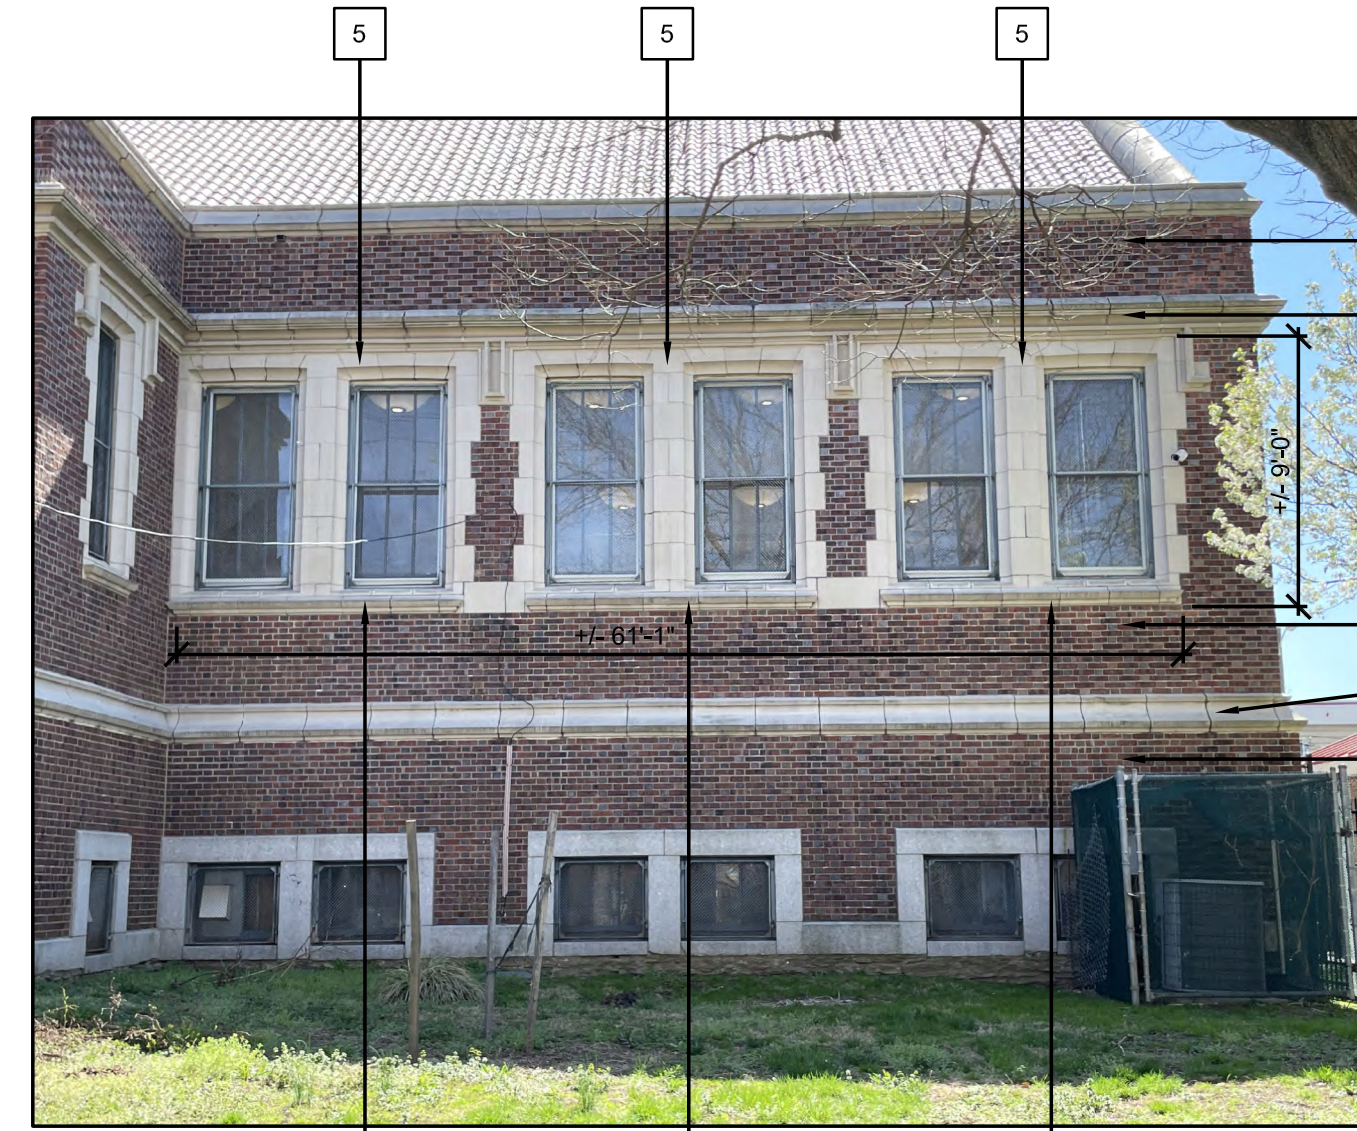


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**3 WEST ELEVATION PHOTOS (ALTERNATE BID #1)**  
SCALE: N.T.S.



PHOTO No. 2.1

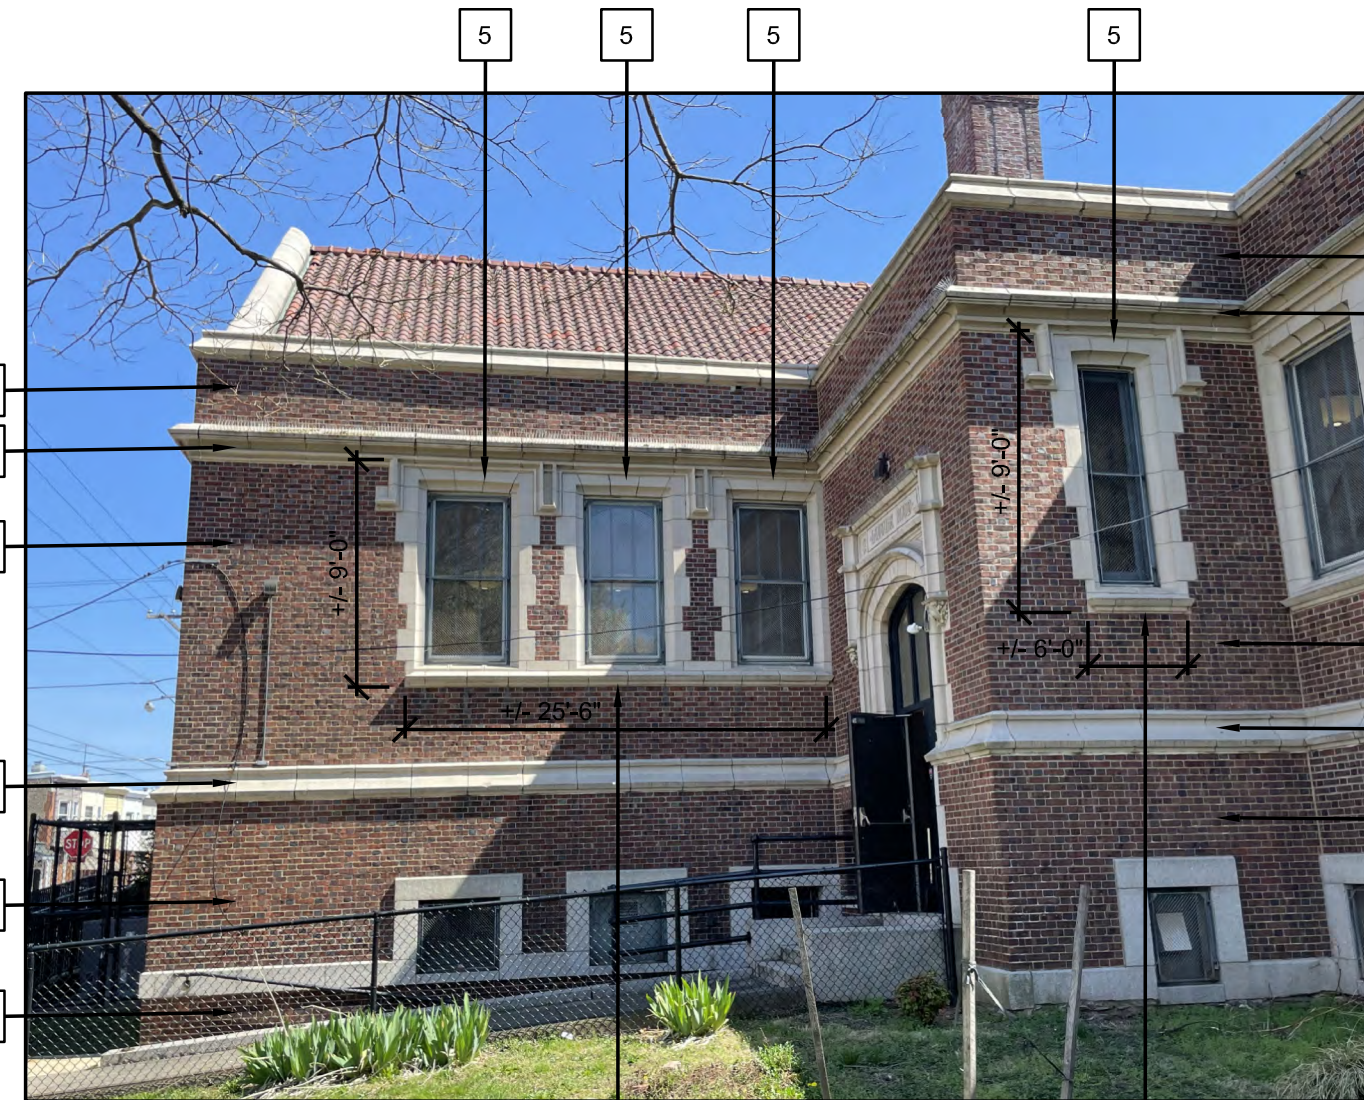


PHOTO No. 2.2



PHOTO No. 2.3



PHOTO No. 2.4



PHOTO No. 2.5

**2 SOUTH ELEVATION PHOTOS (ALTERNATE BID #1)**  
SCALE: N.T.S.



PHOTO No. 1.1



PHOTO No. 1.2



PHOTO No. 1.3

**1 EAST ELEVATION PHOTOS (ALTERNATE BID #1)**  
SCALE: N.T.S.

**New Work Notes**

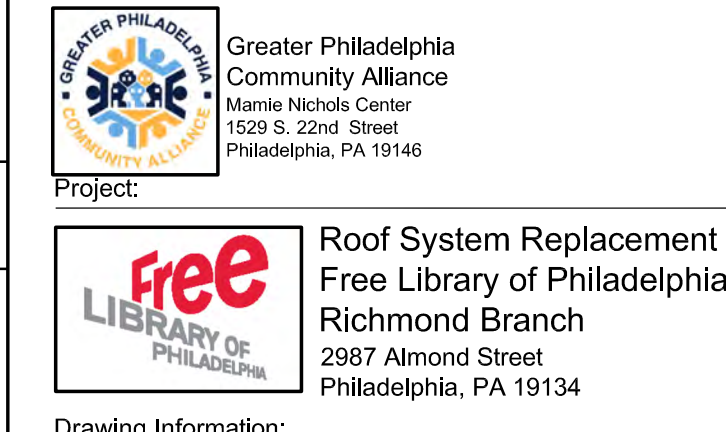
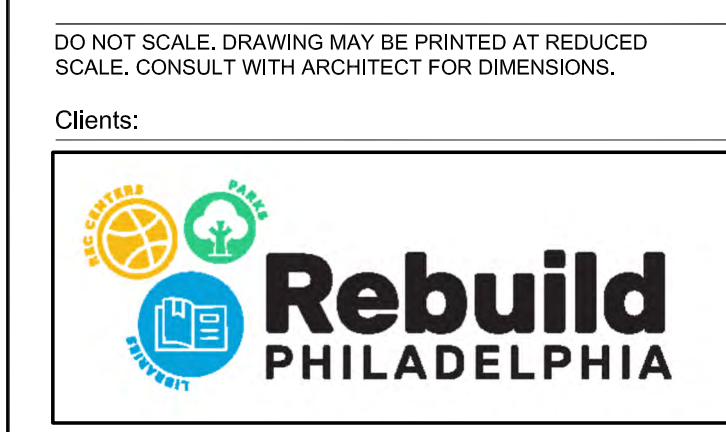
- RAKE AND REPOINT BRICK MASONRY OF CHIMNEY IN ITS ENTIRETY. (ALL FOUR SIDES) SEE DETAILS 3/A-103 AND 4/A-103 FOR ADDITIONAL INFORMATION.
- RAKE AND REPOINT 100% BRICK MASONRY. SEE DETAILS 3/A-103 AND 4/A-103 FOR ADDITIONAL INFORMATION.
- RAKE AND REPOINT ALL TERRA COTTA BAND JOINTS INCLUDING CONTINUOUS TOP AND BOTTOM JOINTS. SEE DETAILS 3/A-103 AND 4/A-103 FOR ADDITIONAL INFORMATION.
- RAKE AND REPOINT ALL TERRA COTTA WINDOW W/LL JOINTS INCLUDING CONTINUOUS TOP AND BOTTOM JOINTS. SEE DETAILS 3/A-103 AND 4/A-103 FOR ADDITIONAL INFORMATION.
- RAKE AND REPOINT ALL TERRA COTTA WINDOW SURROUNDS INCLUDING CONTINUOUS TOP AND BOTTOM JOINTS. SEE DETAILS 3/A-103 AND 4/A-103 FOR ADDITIONAL INFORMATION.
- RAKE AND REPOINT ALL TERRA COTTA COURNICHE INCLUDING CONTINUOUS TOP AND BOTTOM JOINTS. SEE DETAILS 3/A-103 AND 4/A-103 FOR ADDITIONAL INFORMATION.
- RAKE AND REPOINT ALL TERRA COTTA ENTRANCE SURROUNDS. SEE DETAILS 3/A-103 AND 4/A-103 FOR ADDITIONAL INFORMATION. REMOVE EXISTING BIRD NETTING. INSTALL NEW BIRD NETTING TO MATCH EXISTING ONCE MASONRY WORK HAS BEEN COMPLETED.
- RAKE AND REPOINT ALL TERRA COTTA AND LIME STONE ENTRANCE SURROUNDS. SEE DETAILS 3/A-103 AND 4/A-103 FOR ADDITIONAL INFORMATION.
- CLEAN SURFACE OF MASONRY CHIMNEY CAP. RAKE AND REPOINT MASONRY JOINTS OF CHIMNEY CAP AND ROUND FLUE. PROVIDE AND INSTALL NEW +/- 17"x21" (VERIFY AND COORDINATE SIZE OF CAP WITH EXISTING CHIMNEY FLUE) 304 STAINLESS STEEL TOP MOUNTED MESH FLUE CAP.

6-30-2023 ISSUED FOR BID  
 No. Date Description  
 Revisions / Issues

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 PA RA 409369



Drawing Information:  
 Project No: 23-002  
 Date: 06-30-2023  
 Drawn By: WH  
 Checked By: WH

Sheet Name:  
**EXTERIOR PHOTOS AND NOTES**

Sheet No:  
**A-104**  
 Sheet 6 of 6