

Sheet Index

PAGE	SHEET NUMBER	TITLE
	GENERAL	
1	G-000	COVER SHEET
	CIVIL	
2	C-001	GENERAL NOTES
3	C-010	EXISTING CONDITIONS PLAN
4	C-020	REMOVALS PLAN
5	C-100	GRADING PLAN
6	C-110	DETAILED GRADING PLAN
7	C-300	PCSM PLAN
8	C-310	PCSM DETAILS
9	C-400	E&SC PLAN
10	C-410	E&SC DETAILS
11	C-500	CONSTRUCTION DETAILS
12	C-501	CONSTRUCTION DETAILS
13	C-600	UTILITY PLAN
	LANDSCAPE	
14	L-001	GENERAL NOTES
15	L-010	KEY PLAN
16	L-100	LAYOUT PLAN - RHAWN ST. ENTRY
17	L-101	LAYOUT PLAN - PARKING AREA
18	L-102	LAYOUT PLAN - PLAYGROUND - NORTH
19	L-103	LAYOUT PLAN - PLAYGROUND - SOUTHEAST
20	L-104	LAYOUT PLAN - PLAYGROUND - SOUTHWEST
21	L-112	FOOTING LAYOUT PLAN - NORTH
22	L-113	FOOTING LAYOUT PLAN - SOUTHEAST
23	L-114	FOOTING LAYOUT PLAN - SOUTHWEST
24	L-120	PLAY EQUIPMENT SCHEDULE
25	L-200	PAVING PLAN - RHAWN ST. ENTRY
26	L-201	PAVING PLAN - PARKING AREA
27	L-202	PAVING PLAN - PLAYGROUND - NORTH
28	L-203	PAVING PLAN - PLAYGROUND - SOUTHEAST
29	L-204	PAVING PLAN - PLAYGROUND - SOUTHWEST
30	L-210	PAVING SCHEDULE
31	L-300	FURNISHING PLAN - RHAWN ST. ENTRY
32	L-301	FURNISHING PLAN - PARKING AREA
33	L-302	FURNISHING PLAN - PLAYGROUND - NORTH
34	L-303	FURNISHING PLAN - PLAYGROUND - SOUTHEAST
35	L-304	FURNISHING PLAN - PLAYGROUND - SOUTHWEST
36	L-310	FURNISHING SCHEDULE
37	L-400	SAFETY SURFACE COLOR PLAN
38	L-400	LIGHTING PLAN
39	L-500	PLANTING PLAN
40	L-700	SECTIONS - 1
41	L-701	SECTIONS - 2

42	L-702	SECTIONS - 3
43	L-900	TYPICAL DETAILS - 1
44	L-901	TYPICAL DETAILS - 2
45	L-902	TYPICAL DETAILS - 3
46	L-903	TYPICAL DETAILS - 4
47	L-904	TYPICAL DETAILS - 5
48	L-905	TYPICAL DETAILS - 6
49	L-906	TYPICAL DETAILS - 7
50	L-910	PLANTING DETAILS
51	L-920	SIGNAGE DETAILS - 1
52	L-921	SIGNAGE DETAILS - 2
53	L-922	SIGNAGE DETAILS - 3
	SITE ELECTRICAL	
54	SE-001	GENERAL NOTES
55	SE-200	SITE LIGHTING/SECURITY PLAN
	SITE PLUMBING	
56	SP-001	GENERAL NOTES
57	SP-100	SITE PLUMBING PLAN
58	SP-200	SITE PLUMBING DETAILS

CITY OF PHILADELPHIA DEPARTMENT OF PARKS AND RECREATION

MAYOR - JAMES F. KENNEY

MANAGING DIRECTOR - LAUREN MURPHY COMMISSIONER OF PARKS AND RECREATION - ORLANDO RENDON

PENNYPACK PARK UNIVERSAL PLAYGROUND **100% BID DOCUMENTS**

RHAWN ST. & HOLMEHURST AVE., PHILADELPHIA, PA 19136

Location Map



SCALE: N.T.S.

ISSUE			REVI		
		· · · · · · · · · · · · · · · · · · ·			
Ę					
	PHILADETP	HIN	MANET		
	D		MANEI	$\overline{\mathcal{A}}$	
		NIA ONE CALL 925 Irwin Run Roo	d	C.	
	w	lest Mifflin, Pennsylv 15122 - 1078	ania		
	PENNON		STEM. INC		
	STOP				
		YOU DIG ANY		76	
	PA LAW F NOTICE TO	S MUST BE CONT REQUIRES THREE WO UTILITIES BEFORE YO ILL, BLAST OR DEMO	RKING DAYS DU EXCAVATE.	TLY	
PA ONE-CALL NU	JMBER (FOR DESIG	SN ONLY):			
PPR PROJECT C	OORDINATOR:			MEGAN F	UNK
SEAL:		NSYLVA			
	In the second	S. RIVERA * * * *	A		
	REGI	REGISTRATION			
			HOH		
		LANDSCAP	ininini.		
SIGNATURE	M	A.R.	A		TE SIGNEI
4	por 1	//	- 0	, •	•
MARVEL 145 Hudsor	Street, Floo				
MARVEL	n Street, Floo NY 10013				
MARVEL 145 Hudsor New York, N SUB-CONSULTAN CIVIL/SURVEY: ENGINEERING & 219 Cuthbert Street	NY 10013 NY 10013 NTS: LAND PLANNING A et, 5th/ Floor	r 3			
MARVEL 145 Hudsor New York, N SUB-CONSULTAN CIVIL/SURVEY: ENGINEERING & 219 Cuthbert Stree Philadelphia, PA 1 MEP ENGINEER: SRW	NY 10013 NTS: LAND PLANNING A et, 5th/ Floor 19106	r 3			
MARVEL 145 Hudsor New York, N SUB-CONSULTAN CIVIL/SURVEY: ENGINEERING & 219 Cuthbert Stree Philadelphia, PA 1 MEP ENGINEER:	n Street, Floo NY 10013 NTS: LAND PLANNING A et, 5th/ Floor 19106 Suite 204	r 3			
MARVEL 145 Hudsor New York, N SUB-CONSULTAN CIVIL/SURVEY: ENGINEERING & 219 Cuthbert Stree Philadelphia, PA 1 MEP ENGINEER: SRW 417 N 8th Street, S Philadelphia, PA 1	NTS: LAND PLANNING A et, 5th/ Floor 9106 Suite 204 9123 NI: RACTICE tet, Suite 772	r 3			
MARVEL 145 Hudsor New York, N SUB-CONSULTAN CIVIL/SURVEY: ENGINEERING & 219 Cuthbert Stree Philadelphia, PA 1 MEP ENGINEER: SRW 417 N 8th Street, S Philadelphia, PA 1 267-585-2811 LIGHTING DESIG THE LIGHTING PE 600 Chestnut Stree Philadelphia, PA 1 COST ESTIMATO ELLANA CONSTR	NTS: LAND PLANNING A et, 5th/ Floor 9106 Suite 204 19123 NI: RACTICE et, Suite 772 19106 RI: RUCTION CONSULT	r 3			
MARVEL 145 Hudsor New York, N SUB-CONSULTAN CIVIL/SURVEY: ENGINEERING & 219 Cuthbert Stree Philadelphia, PA 1 MEP ENGINEER: SRW 417 N 8th Street, S Philadelphia, PA 1 267-585-2811 LIGHTING DESIG THE LIGHTING PH 600 Chestnut Stree Philadelphia, PA 1 COST ESTIMATO ELLANA CONSTR 32 Broadway, 8TH New York, NY 100 PLAYFUL LEARN	NTS: LAND PLANNING A et, 5th/ Floor 19106 Suite 204 19123 NI: RACTICE HEACT	r 3 .ssociates, inc			
MARVEL 145 Hudsor New York, N SUB-CONSULTAN CIVIL/SURVEY: ENGINEERING & 219 Cuthbert Stree Philadelphia, PA 1 MEP ENGINEER: SRW 417 N 8th Street, S Philadelphia, PA 1 267.585.2811 LIGHTING DESIG THE LIGHTING PE 600 Chestnut Stree Philadelphia, PA 1 COST ESTIMATO ELLANA CONSTF 32 Broadway, 8TH New York, NY 100 PLAYFUL LEARN Philadelphia, PA 267.468.8610	NTS: LAND PLANNING A et, 5th/ Floor 9106 Suite 204 19123 Suite 772 19106 Suite 772 1910 Suite 772 1	r 3 .ssociates, inc			
MARVEL 145 Hudsor New York, N SUB-CONSULTAN CIVIL/SURVEY: ENGINEERING & 219 Cuthbert Stree Philadelphia, PA 1 MEP ENGINEER: SRW 417 N 8th Street, S Philadelphia, PA 1 267.585.2811 LIGHTING DESIG THE LIGHTING PE 600 Chestnut Stree Philadelphia, PA 1 COST ESTIMATO ELLANA CONSTF 32 Broadway, 8TH New York, NY 100 PLAYFUL LEARN Philadelphia, PA 267.468.8610 ARBORIST: MORRIS ARBORE 100 East Northwes Philadelphia, PA	NTS: LAND PLANNING A et, 5th/ Floor 9106 Suite 204 9123 SN: RACTICE et, Suite 772 9106 RE: RUCTION CONSULT Floor 204 ING CONSULTANT: ING LANDSCAPES ETUM stern Avenue	r 3 .ssociates, inc			
MARVEL 145 Hudsor New York, N SUB-CONSULTAN CIVIL/SURVEY: ENGINEERING & 219 Cuthbert Stree Philadelphia, PA 1 MEP ENGINEER: SRW 417 N 8th Street, S Philadelphia, PA 1 267.585.2811 LIGHTING DESIG THE LIGHTING PESIG THE PESIG THE LIGHTING PESIG THE LIGHTING PESIG THE LIGHTING PESIG THE LIGHTING PESIG THE PESIG	NTS: LAND PLANNING A et, 5th/ Floor 19106 Suite 204 19123 N: RACTICE et, Suite 772 19106 R: RUCTION CONSULT AFLOOT 204 ING CONSULTANT: ETUM stern Avenue 19118 CONSULTANT:	r 3 .ssociates, inc			
MARVEL 145 Hudsor New York, N SUB-CONSULTAN CIVIL/SURVEY: ENGINEERING & 219 Cuthbert Stree Philadelphia, PA 1 MEP ENGINEER: SRW 417 N 8th Street, S Philadelphia, PA 1 267.585.2811 LIGHTING DESIG THE LIGHTING PH 600 Chestnut Stree Philadelphia, PA 1 COST ESTIMATO ELLANA CONSTR 32 Broadway, 8TH New York, NY 100 PLAYFUL LEARN Philadelphia, PA 267.468.8610 ARBORIST: MORRIS ARBORE 100 East Northwes Philadelphia, PA 1 215.247.5777 ACCESSIBILITY O	A Street, Floo NY 10013 NTS: LAND PLANNING A et, 5th/ Floor 9106 Suite 204 9106 Suite 204 9123 N: RACTICE et, Suite 772 9106 R: RUCTION CONSULT ING CONSULTANT: ING LANDSCAPES ETUM stern Avenue 9118 CONSULTANT: parks.nyc.gov	r 3 .ssociates, inc			
MARVEL 145 Hudsor New York, N SUB-CONSULTAN CIVIL/SURVEY: ENGINEERING & 219 Cuthbert Stree Philadelphia, PA 1 MEP ENGINEER: SRW 417 N 8th Street, S Philadelphia, PA 1 267-585-2811 LIGHTING DESIG THE LIGHTING PH 600 Chestnut Stree Philadelphia, PA 1 COST ESTIMATO ELLANA CONSTF 32 Broadway, 8TH New York, NY 100 PLAYFUL LEARN Philadelphia, PA 267-468.8610 ARBORIST: MORRIS ARBORE 100 East Northwes Philadelphia, PA 1 215-247-5777 ACCESSIBILITY O CHRIS NOEL christopher.noel@ 646.632.7344	A Street, Floo NY 10013 NTS: LAND PLANNING A et, 5th/ Floor 9106 Suite 204 9123 Suite 204 9123 Suite 204 9106 Suite 204 9123 Suite 204 9106 Suite 772 9106 Suite 772 9004 Suite 772 Suite 772 S	r 3 .ssociates, inc			
MARVEL 145 Hudsor New York, N SUB-CONSULTAN CIVIL/SURVEY: ENGINEERING & 219 Cuthbert Stree Philadelphia, PA 1 MEP ENGINEER: SRW 417 N 8th Street, S Philadelphia, PA 1 267.585.2811 LIGHTING DESIG THE LIGHTING DESIG THE LIGH	A Street, Floo NY 10013 NTS: LAND PLANNING A et, 5th/ Floor 9106 Suite 204 9123 Suite 204 9123 Suite 204 9106 Suite 204 9123 Suite 204 9106 Suite 772 9106 Suite 772 9004 Suite 772 Suite 772 S	r 3 .ssociates, inc			
MARVEL 145 Hudson New York, N SUB-CONSULTAN CIVIL/SURVEY: ENGINEERING & 219 Cuthbert Stree Philadelphia, PA 1 MEP ENGINEER: SRW 417 N 8th Street, S Philadelphia, PA 1 267.585.2811 LIGHTING DESIG THE LIGHTING DESIG THE LIGH	A Street, Floo NY 10013 NTS: LAND PLANNING A et, 5th/ Floor 19106 Suite 204 19123 Suite 204 19106 Suite 772 19106 Suite 772 Suite 772 Suit	r 3	DRK		2107
MARVEL 145 Hudson New York, N SUB-CONSULTAN CIVIL/SURVEY: ENGINEERING & 219 Cuthbert Stree Philadelphia, PA 1 MEP ENGINEER: SRW 417 N 8th Street, S Philadelphia, PA 1 267.585.2811 LIGHTING DESIG THE LIGHTING DESIG THE LIGHTING DESIG THE LIGHTING DESIG THE LIGHTING DESIG THE LIGHTING PI 600 Chestnut Stre Philadelphia, PA 1 COST ESTIMATO ELLANA CONSTF 32 Broadway, 8TH New York, NY 100 PLAYFUL LEARN Philadelphia, PA 1 267.468.8610 ARBORIST: MORRIS ARBORST 100 East Northwes Philadelphia, PA 1 215.247.5777 ACCESSIBILITY O CHRIS NOEL christopher.noel@ 646.632.7344 PLAY CONSULTA STUDIO LUDO 1313 S 33rd St, UF Philadelphia, PA 1	NTS: LAND PLANNING A et, 5th/ Floor 9106 Suite 204 9123 NE RACTICE ret, Suite 772 9106 NR: RUCTION CONSULT ING CONSULTANT: ING CONSULTANT: ING CONSULTANT: 2004 ETUM stern Avenue 19118 CONSULTANT: 2014 CONSULTANT: 2014 CONSULTANT: 2014 ROJECT NUMBER	r 3 SSOCIATES, INC ACTION NEXTWO PHIL			A
MARVEL 145 Hudson New York, N SUB-CONSULTAN CIVIL/SURVEY: ENGINEERING & 219 Cuthbert Stree Philadelphia, PA 1 MEP ENGINEER: SRW 417 N 8th Street, S Philadelphia, PA 1 267.585.2811 LIGHTING DESIG THE LIGHTING DESIG THE LIGHTING DESIG THE LIGHTING DESIG THE LIGHTING DESIG THE LIGHTING PI 600 Chestnut Stre Philadelphia, PA 1 COST ESTIMATO ELLANA CONSTF 32 Broadway, 8TH New York, NY 100 PLAYFUL LEARN Philadelphia, PA 1 267.468.8610 ARBORIST: MORRIS ARBORST 100 East Northwes Philadelphia, PA 1 215.247.5777 ACCESSIBILITY O CHRIS NOEL christopher.noel@ 646.632.7344 PLAY CONSULTA STUDIO LUDO 1313 S 33rd St, UF Philadelphia, PA 1	NTS: LAND PLANNING A et, 5th/ Floor 9106 Suite 204 9123 NE RACTICE ret, Suite 772 9106 NR: RUCTION CONSULT ING CONSULTANT: ING CONSULTANT: ING CONSULTANT: 2004 ING CONSULTANT: 2018 CONSULTANT:	r 3 SSOCIATES, INC ACTION NEXTWO PHILA PARKS A		ECREAT	A
MARVEL 145 Hudson New York, N SUB-CONSULTAN CIVIL/SURVEY: ENGINEERING & 219 Cuthbert Street Philadelphia, PA 1 MEP ENGINEER: SRW 417 N 8th Street, S Philadelphia, PA 1 267.585.2811 LIGHTING DESIG THE LIGHTING DESIG THE DIG LIGHTING DIG THE DIG LIGHTING DESIG THE DIG LIGHTING DESIG THE DIG LIGHT	NTS: LAND PLANNING A et, 5th/ Floor 9106 Suite 204 9123 NE RACTICE ret, Suite 772 9106 NR: RUCTION CONSULT ING CONSULTANT: ING CONSULTANT: ING CONSULTANT: 2004 ING CONSULTANT: 2018 CONSULTANT:	ARCH S		ECREAT	A FION
MARVEL 145 Hudson New York, N SUB-CONSULTAN CIVIL/SURVEY: ENGINEERING & 219 Cuthbert Street Philadelphia, PA 1 MEP ENGINEER: SRW 417 N 8th Street, S Philadelphia, PA 1 267.585.2811 LIGHTING DESIG THE LIGHTING DESIG THE DIG LIGHTING DIG THE DIG LIGHTING DESIG THE DIG LIGHTING DESIG THE DIG LIGHT	A Street, Floo NY 10013 NTS: LAND PLANNING A et, 5th/ Floor 19106 Suite 204 19123 NE: RACTICE HELTION CONSULT 19106 NR: RUCTION CONSULTANT: 19106 NG CONSULTANT: 19106 CONSULTANT: 2004 CONSULTANT: 2004 ROJECT NUMBER ROJECT NUMBER TY OF I ELPHIA F 1515 FLOOR, (UMBER	ANTS ACTION NEXTWO ACTION NEXTWO PHILA PARKS A ARCH S ONE PAF		ECREA 7 7 BUILDI 16-21-70	A FION NG
MARVEL 145 Hudsor New York, N SUB-CONSULTAN CIVIL/SURVEY: ENGINEERING & 219 Cuthbert Street Philadelphia, PA 1 MEP ENGINEER: SRW 417 N 8th Street, S Philadelphia, PA 1 267.585.2811 LIGHTING DESIG THE LIGHTING P 600 Chestnut Stre Philadelphia, PA 1 COST ESTIMATO ELLANA CONSTR 32 Broadway, 8TH New York, NY 100 PLAYFUL LEARN Philadelphia, PA 1 267.468.8610 ARBORIST: MORRIS ARBORE 100 East Northwes Philadelphia, PA 1 215.247.5777 ACCESSIBILITY O CHRIS NOEL CHRIS	A Street, Floo NY 10013 NTS: LAND PLANNING A et, 5th/ Floor 9106 Suite 204 9123 Suite 204 9123 Suite 204 9123 Suite 204 9123 Suite 204 9126 Suite 772 9106 NR: RUCTION CONSULT RUCTION CONSULT NING CONSULTANT: 1 Floor 904 ING CONSULTANT: 2004 CONSULTANT: 2004 CONSULTANT: 2004 CONSULTANT: 2004 ROJECT NUMBER CONSULTANT: 2004 ROJECT NUMBER CONSULTANT: 2004 SUITE 2005 SUITE SUITE SUITE SUITE SUITE S	ARCH SONE PAF		ECREAT 7 BUILDI 16-21-70	A FION NG
MARVEL 145 Hudsor New York, N SUB-CONSULTAN CIVIL/SURVEY: ENGINEERING & 219 Cuthbert Street Philadelphia, PA 1 MEP ENGINEER: SRW 417 N 8th Street, S Philadelphia, PA 1 267.585.2811 LIGHTING DESIG THE LIGHTING P 600 Chestnut Stre Philadelphia, PA 1 COST ESTIMATO ELLANA CONSTR 32 Broadway, 8TH New York, NY 100 PLAYFUL LEARN Philadelphia, PA 1 267.468.8610 ARBORIST: MORRIS ARBORE 100 East Northwes Philadelphia, PA 1 215.247.5777 ACCESSIBILITY O CHRIS NOEL CHRIS	A Street, Floo NY 10013 NTS: LAND PLANNING A et, 5th/ Floor 9106 Suite 204 9123 NE RACTICE ret, Suite 772 9106 NR: RUCTION CONSULT ING CONSULTANT: 1 Floor 104 ING CONSULTANT: 2014 CONSULTANT: 2014 CONSULTANT: 2014 CONSULTANT: 2014 CONSULTANT: 2014 CONSULTANT: 2014 CONSULTANT: 2014 CONSULTANT: 2014 CONSULTANT: 2015 CONSULTANT: 2	ANTS ACTION NEXTWO ACTION NEXTWO ARCH S ONE PAR ARCH S ONE PAR		ECREAT F F BUILDI 16-21-70 RK OUND AVE.	Δ ΓΙΟΝ NG
MARVEL 145 Hudsor New York, N SUB-CONSULTAN CIVIL/SURVEY: ENGINEERING & 219 Cuthbert Street Philadelphia, PA 1 MEP ENGINEER: SRW 417 N 8th Street, S Philadelphia, PA 1 267.585.2811 LIGHTING DESIG THE LIGHTING P 600 Chestnut Stre Philadelphia, PA 1 COST ESTIMATO ELLANA CONSTR 32 Broadway, 8TH New York, NY 100 PLAYFUL LEARN Philadelphia, PA 1 267.468.8610 ARBORIST: MORRIS ARBORE 100 East Northwes Philadelphia, PA 1 215.247.5777 ACCESSIBILITY O CHRIS NOEL CHRIS	A Street, Floo NY 10013 NTS: LAND PLANNING A et, 5th/ Floor 19106 Suite 204 19123 N: RACTICE set, Suite 772 19106 N: RUCTION CONSULT NING LANDSCAPES ETUM Stern Avenue 19118 CONSULTANT: ING LANDSCAPES ETUM Stern Avenue 19118 CONSULTANT: ING LANDSCAPES ETUM Stern Avenue 19118 CONSULTANT: ING LANDSCAPES ETUM Stern Avenue 19118 CONSULTANT: ING LANDSCAPES ETUM Stern Avenue 19118 CONSULTANT: ING LANDSCAPES ETUM Stern Avenue 1916 ROJECT NUMBER TO TO TO STERNA	ANTS		ECREAT F F BUILDI 16-21-70 RK OUND AVE.	A FION NG
MARVEL 145 Hudson New York, N SUB-CONSULTAN CIVIL/SURVEY: ENGINEERING & 219 Cuthbert Stree Philadelphia, PA 1 MEP ENGINEER: SRW 417 N 8th Street, S Philadelphia, PA 1 267.585.2811 LIGHTING DESIG THE LIGHTING DESIG THE LIGHTING DESIG THE LIGHTING PE 600 Chestnut Stre Philadelphia, PA 1 COST ESTIMATO ELLANA CONSTR 32 Broadway, 8TH New York, NY 100 PLAYFUL LEARN Philadelphia, PA 1 267.468.8610 ARBORIST: MORRIS ARBORE 100 East Northwes Philadelphia, PA 1 215.247.5777 ACCESSIBILITY O CHRIS NOEL christopher.noel@ 646.632.7344 PLAY CONSULTAN STUDIO LUDO 1313 S 33rd St, Ur Philadelphia, PA 1 CONSULTANT PF CONSULTANT PF ITHE CONSULTANT PF	A Street, Floo NY 10013 NTS: LAND PLANNING A et, 5th/ Floor 19106 Suite 204 19123 NE RACTICE set, Suite 772 19106 NE RUCTION CONSULT NE RUCTION CONSULT ING CONSULTANT: 1004 ING CONSULTANT: 2004 ING CONSULTANT: 2004 CONSULTANT: 2004 CONSULTANT: 2004 ROJECT NUMBER CONSULTANT: 2004 ROJECT NUMBER CONSULTANT: 2004 CONSULTANT: 2005 C	ANTS ACTION NEXTWO ACTION NEXTWO ARCH S ONE PAR ARCH S ONE PAR	DRK ADE ADE ADE AND RI TREET RKWAY CPAR AYGR EHURST PA 1913	ECREAT F F BUILDI 16-21-70 RK OUND AVE.	Δ ΓΙΟΝ NG
MARVEL 145 Hudson New York, N SUB-CONSULTAN CIVIL/SURVEY: ENGINEERING & 219 Cuthbert Stree Philadelphia, PA 1 MEP ENGINEER: SRW 417 N 8th Street, S Philadelphia, PA 1 267.585.2811 LIGHTING DESIG THE LIGHTING DESIG THE LIGHTING DESIG THE LIGHTING PE 600 Chestnut Stre Philadelphia, PA 1 COST ESTIMATO ELLANA CONSTR 32 Broadway, 8TH New York, NY 100 PLAYFUL LEARN Philadelphia, PA 1 267.468.8610 ARBORIST: MORRIS ARBORE 100 East Northwes Philadelphia, PA 1 215.247.5777 ACCESSIBILITY O CHRIS NOEL christopher.noel@ 646.632.7344 PLAY CONSULTAN STUDIO LUDO 1313 S 33rd St, Ur Philadelphia, PA 1 CONSULTANT PF CONSULTANT PF ITHE CONSULTANT PF	A Street, Floo NY 10013 NTS: LAND PLANNING A et, 5th/ Floor 9106 Suite 204 9123 NE RACTICE ret, Suite 772 9106 NE RUCTION CONSULT ING CONSULTANT: 1004 ING CONSULTANT: 2004 ING CONSULTANT: 2015 CONSULTANT: 2016 CONSULTANT: 2017	ANTS ACTION NEXTWO ACTION NEXTWO ACTION NEXTWO ARCH S ONE PAF AL PLA F. & HOLME DELPHIA, I VER SE	DRK ADE ADE ADE AND RI TREET RKWAY CPAR AYGR EHURST PA 1913	ECREAT 7 BUILDI 16-21-70 RK OUND AVE. 6	A FION NG
MARVEL 145 Hudsor New York, N SUB-CONSULTAN CIVIL/SURVEY: ENGINEERING & 219 Cuthbert Stree Philadelphia, PA 1 MEP ENGINEER: SRW 417 N 8th Street, S Philadelphia, PA 1 267.585.2811 LIGHTING DESIG THE LIGHTING DESIG THE LIGHTING DESIG THE LIGHTING PE 600 Chestnut Stre Philadelphia, PA 1 COST ESTIMATO ELLANA CONSTF 32 Broadway, 8TH New York, NY 100 PLAYFUL LEARN Philadelphia, PA 1 267.468.8610 ARBORIST: MORRIS ARBORE 100 East Northwes Philadelphia, PA 1 215.247.5777 ACCESSIBILITY O CHRIS NOEL christopher.noel@ 646.632.7344 PLAY CONSULTAN STUDIO LUDO 1313 S 33rd St, Ur Philadelphia, PA 1 CONSULTANT PF CONSULTANT PF ITHE CONSULTANT PF ITHE PROJECT NI PROJECT TITLE: U	A Street, Floo NY 10013 NTS: LAND PLANNING A et, 5th/ Floor 19106 Suite 204 19123 N: RACTICE set, Suite 772 19106 N: RUCTION CONSULT ING CONSULTANT: ING CONSULTANT: 1004 ING CONSULTANT: 1004 ING CONSULTANT: 1016 CONSULTANT: 1017 P118 CONSULTANT: 1016 PELPHIA F 1515 FLOOR, O UMBER PENN NIVERS RHAWN ST PHILA	ANTS ACTION NEXTWO ACTION NEXTWO ARCH S ONE PAF ARCH S ONE PAF IYPACK AL PLA T. & HOLME DELPHIA, I		ECREAT 7 BUILDI 16-21-70 RK OUND AVE. 6	A FION NG
MARVEL 145 Hudsor New York, N SUB-CONSULTAN CIVIL/SURVEY: ENGINEERING & 219 Cuthbert Street Philadelphia, PA 1 MEP ENGINEER: SRW 417 N 8th Street, SP Philadelphia, PA 1 267.585.2811 LIGHTING DESIG THE LIGHTING PI 600 Chestnut Stre Philadelphia, PA 1 COST ESTIMATO ELLANA CONSTF 32 Broadway, 8TP New York, NY 100 PLAYFUL LEARN Philadelphia, PA 1 COST ESTIMATO ELLANA CONSTF 32 Broadway, 8TP New York, NY 100 PLAYFUL LEARN Philadelphia, PA 1 215.247.5777 ACCESSIBILITY O CHRIS NOEL CHRIS TONEL CHRIS NOEL CHRIS TONEL CHRIS TONEL CHRIS TONEL CHRIS TONEL CHRIS TONEL CONSULTANT PF DATE:	A Street, Floo NY 10013 NTS: LAND PLANNING A et, 5th/ Floor 19106 Suite 204 19123 N: RACTICE et, Suite 772 19106 RUETION CONSULT RUETION CONSULT ING CONSULTANT: 1004 ING CONSULTANT: 1004 ING CONSULTANT: 10146 CONSULTANT: 10146 ROJECT NUMBER Y OF I ELPHIA F 1515 FLOOR, 0 UMBER PENN NIVERS RHAWN ST PHILA	ANTS ACTION NEXTWO ACTION NEXTWO PHILA PARKS A ARCH S ONE PAF IYPACH AL PLA T. & HOLME DELPHIA, I VER SH 1-7062-01	DRK ADE ADE AND RI TREET KWAY (PAR ADE ADE ADE ADE ADE ADE ADE ADE ADE ADE	ECREAT / BUILDI 16-21-70 RK OUND AVE. 6	A NG 62-01
MARVEL 145 Hudsor New York, N SUB-CONSULTAN CIVIL/SURVEY: ENGINEERING & 219 Cuthbert Street Philadelphia, PA 1 MEP ENGINEER: SRW 417 N 8th Street, S Philadelphia, PA 1 267.585.2811 LIGHTING DESIG THE LIGHTING P 600 Chestnut Stre Philadelphia, PA 1 COST ESTIMATO ELLANA CONSTF 32 Broadway, 8TH New York, NY 100 PLAYFUL LEARN Philadelphia, PA 1 267.468.8610 ARBORIST: MORRIS ARBORE 100 East Northwes Philadelphia, PA 1 215.247.5777 ACCESSIBILITY O CHRIS NOEL CHRIS	A Street, Floo NY 10013 NTS: LAND PLANNING A et, 5th/ Floor 19106 Suite 204 19123 N: RACTICE ret, Suite 772 19106 N: RUCTION CONSULT ING CONSULTANT: ING CONSULTANT: 19118 CONSULTANT: 19118 CONSULTANT: 19146 ROJECT NUMBER Y OF I ELPHIA F 1515 FLOOR, O UMBER PENN NIVERS RHAWN ST PHILA CONSULTANT: 1515 CONSULTANT: 1515 CONSULTANT: 1515 CONSULTANT: 1515 CONSULTANT: 1515 COC 0.: 1515 COC	ANTS ACTION NEXTWO ARCH S ONE PAF ARCH S ONE PAF ARCH S ONE PAF IYPACH AL PLA T. & HOLME DELPHIA, I VER SH DELPHIA, I 2107 2/15/2023 S NOTED	DRK ADE ADE AND RI TREET KWAY (PAR ADE ADE ADE ADE ADE ADE ADE ADE ADE ADE	ECREAT 7 BUILDI 16-21-70 RK OUND AVE. 6	A NG 62-01
MARVEL 145 Hudsor New York, N SUB-CONSULTAN CIVIL/SURVEY: ENGINEERING & 219 Cuthbert Stree Philadelphia, PA 1 MEP ENGINEER: SRW 417 N 8th Street, SP Philadelphia, PA 1 267.585.2811 LIGHTING DESIG THE LIGHTING PE 600 Chestnut Stre Philadelphia, PA 1 COST ESTIMATO ELANA CONSTF 32 Broadway, 8TH New York, NY 100 PLAYFUL LEARN Philadelphia, PA 1 COST ESTIMATO ELANA CONSTF 32 Broadway, 8TH New York, NY 100 PLAYFUL LEARN Philadelphia, PA 1 COST ESTIMATO ELANA CONSTF 32 Broadway, 8TH New York, NY 100 PLAYFUL LEARN Philadelphia, PA 1 CONSULTANT PA CONSULTANT PF CONSULTANT PF DATE: SCALE:	A Street, Floo NY 10013 NTS: LAND PLANNING A et, 5th/ Floor 19106 Suite 204 19123 N: RACTICE ret, Suite 772 19106 N: RUCTION CONSULT ING CONSULTANT: ING CONSULTANT: 19118 CONSULTANT: 19118 CONSULTANT: 19146 ROJECT NUMBER Y OF I ELPHIA F 1515 FLOOR, O UMBER PENN NIVERS RHAWN ST PHILA CONSULTANT: 1515 CONSULTANT: 1515 CONSULTANT: 1515 CONSULTANT: 1515 CONSULTANT: 1515 COC 0.: 1515 COC	ANTS ACTION NEXTWO PHILA PARKS A ARCH S ONE PAF ARCH S ONE PAF IYPACP AL PLA T. & HOLME DELPHIA, I VER SP I-7062-01 2107 2/15/2023	DRK ADE ADE AND RI TREET KWAY (PAR ADE ADE ADE ADE ADE ADE ADE ADE ADE ADE	ECREAT / BUILDI 16-21-70 RK OUND AVE. 6	A NG 62-01

REFERENCES:

1. A MAP ENTITLED "TOPOGRAPHIC & LOCATION SURVEY OF FAIRMOUNT PARK SYSTEM PENNYPACK PARK RHAWN STREET", PREPARED BY SAS GEOSPATIAL, LLC DATED 11/01/2021, OR LAST REVISED.

GENERAL NOTES:

OWNEF

- CITY OF PHILADELPHIA DEPARTMENT OF PUBLIC PROPERTY 702 CITY HALL, PHILADELPHIA, PA 19107
- 215-686-1776
- THESE PLANS ARE NOT TO BE USED AS SURVEYS. REFER TO REFERENCE SOURCES FOR BOUNDARY AND TOPOGRAPHIC INFORMATION (REFERENCES ABOVE)
- THE CONTRACTOR SHALL CONFINE ALL CONSTRUCTION ACTIVITIES TO WITHIN THE LIMIT OF WORK AND/OR THE RIGHT-OF-WAY. ALL DISTURBED AREAS ARE TO BE RESTORED TO EXISTING CONDITIONS OR AS INDICATED IN THE CONTRACT DOCUMENTS.
- 4. THE CONTRACTOR SHALL PROTECT ALL EXISTING STRUCTURES AND IMPROVEMENTS WITHIN THE PROJECT LIMITS AND RIGHT-OF-WAY. THESE FEATURES INCLUDE BUT ARE NOT LIMITED TO TREES, SHRUBS, LANDSCAPING, DRIVEWAYS, MAILBOXES, SIGNAGE, CURBING, SIDEWALKS, UTILITIES, JUNCTION BOXES, POLES, LIGHTING, HYDRANTS, VALVE BOXES, AND STRIPING.
- THE CONTRACTOR SHALL OBTAIN ALL CONSTRUCTION PERMITS REQUIRED BY LOCAL, COUNTY OR STATE JURISDICTIONS. THE CONTRACTOR SHALL BE RESPONSIBLE FOR APPLICATION, PAYMENT AND APPROVAL OF SAID PERMITS. NO ADDITIONAL PAYMENT SHALL BE MADE BY THE OWNER.
- 6. HOURS OF WORK SHALL BE BETWEEN 7:00AM AND 5:00PM EASTERN STANDARD TIME, UNLESS OTHERWISE PERMITTED BY THE CITY. 7. THE CONTRACTOR SHALL FIELD VERIFY EXISTING CONDITIONS BEFORE BEGINNING
- CONSTRUCTION. 8. THE CONTRACTOR IS RESPONSIBLE FOR PROTECTION OF THE PROJECT SITE,
- CONTRACTOR PROPERTY, EQUIPMENT, AND WORK. 9. THE CONTRACTOR IS RESPONSIBLE FOR CLEANING STREETS OF CONSTRUCTION DIRT AND DEBRIS AT CLOSE OF EACH WORK DAY.
- 10. THE CONDITION OF THE ADJACENT ROAD AND/OR RIGHT-OF-WAY, UPON COMPLETION OF THE JOB SHALL BE AS GOOD AS OR BETTER THAN PRIOR TO STARTING WORK.
- 11. PRIOR TO CONSTRUCTION, THE CONTRACTOR, ALONG WITH CONCURRENCE FROM OWNER. SHALL DETERMINE HIS/HER LAY-DOWN AND/OR STAGING AREA LOCATIONS. 16. THE CONTRACTOR SHALL NOTIFY ALL PROPERTY OWNERS A MINIMUM OF 24 HOURS
- PRIOR TO BLOCKING DRIVEWAYS OR ENTERING UTILITY EASEMENTS. 17. TRAFFIC INGRESS AND EGRESS FOR DRIVEWAYS AND PEDESTRIAN ACCESS FACILITIES SHALL BE MAINTAINED THROUGHOUT CONSTRUCTION.
- 18. ANY DAMAGE CAUSED BY THE CONTRACTOR SHALL BE REPLACED WITH LIKE-KIND OR BETTER AT THE CONTRACTOR'S EXPENSE. TREES, BUSHES, SHRUBBERY AND OTHER DAMAGED PLANTINGS TO REMAIN SHALL BE REPLACED WITHIN 72 HOURS OF REMOVAL AND ARE TO BE THOROUGHLY WATERED-IN. THE CONTRACTOR SHALL NOTIFY PPR OF DAMAGE IMMEDIATELY. PPR APPROVAL REQUIRED PRIOR TO PERFORMING ANY REPAIRS, REPLACEMENTS, OR RESTORATIONS.
- 19. PAVED SURFACES, PAVEMENT MARKERS AND MARKINGS SHALL BE PROTECTED FROM DAMAGE BY TRACKED EQUIPMENT. 20. PROPERTY MARKERS DISTURBED DURING CONSTRUCTION ARE TO BE REPLACED BY A
- REGISTERED PUBLIC LAND SURVEYOR FOR THE ORIGINAL PROPERTY OWNER AT NO SEPARATE PAY. 21. CONSTRUCTION STAKING WILL BE PROVIDED BY THE CONTRACTOR. TWO COPIES OF
- STAKING NOTES TO BE PROVIDED TO THE ENGINEER PRIOR TO CONSTRUCTION. 22. THE CONTRACTOR SHALL MAINTAIN UPDATED RED-LINED RECORD DRAWINGS ON SITE
- FOR INSPECTION BY THE ENGINEER. 23. MAINTENANCE AND CLEAN-UP OF THE PROJECT IS REQUIRED FOR THE PROJECT LIMITS AND DURATION, REGARDLESS OF THE CONTRACTOR'S SCOPE OF ACTIVITIES WITHIN
- THE PROJECT LIMITS. 24. THE REMOVAL OF ANY ABANDONED UTILITIES REQUIRED TO COMPLETE THE WORK SHALL BE INCIDENTAL AND NO SEPARATE PAYMENT SHALL BE MADE.
- IT IS THE CONTRACTOR'S RESPONSIBILITY TO STOCKPILE NECESSARY MATERIAL ON-SITE OR AT A SECURED OFF-SITE LOCATION AT NO ADDITIONAL EXPENSE TO THE OWNER
- 26. THESE DRAWINGS DO NOT INCLUDE THE NECESSARY COMPONENTS FOR CONSTRUCTION SAFETY. THE CONTRACTOR SHALL BE RESPONSIBLE TO INSURE "ON THE JOB" SAFETY FOR HIS EMPLOYEES, EMPLOYEES OF THE OWNER AND ALL OTHER PERSONS HAVING AUTHORIZED OR UNAUTHORIZED ACCESS TO THE WORK AND THE PUBLIC. CONTRACTOR SHALL PERFORM HIS WORK IN A SAFE MANNER AND IN COMPLIANCE WITH ALL APPLICABLE LOCAL. STATE AND FEDERAL REGULATIONS.
- 27. THE LOCATION, TYPE, SIZE, DEPTH, ETC. OF ALL EXISTING UTILITIES WITHIN PROJECT SITE AND ADJACENT RIGHT-OF-WAY ARE APPROXIMATE AND MUST BE VERIFIED IN THE FIELD BY THE CONTRACTOR AND AT HIS OWN EXPENSE PRIOR TO THE START OF CONSTRUCTION. THE CONTRACTOR SHALL NOTIFY ALL UTILITY COMPANIES OPERATING WITHIN THE CONSTRUCTION SITE 3 DAYS PRIOR TO COMMENCEMENT OF ANY EXCAVATION FOR ACCURATE FIELD LOCATIONS. FOR RIGHT-OF-WAY UTILITY MARKOUT, CALL 1-800-242-1776. THE CONTRACTOR SHALL IMMEDIATELY NOTIFY THE DESIGN ENGINEER OF ALL DEVIATIONS OF SITE CONDITIONS AND/OR IF DEPARTURES
- FROM THE APPROVED DESIGN BECOME NECESSARY DUE TO SUCH DEVIATIONS. 28. THE CONTRACTOR SHALL BE RESPONSIBLE FOR ALL LINES, ELEVATIONS, AND MEASUREMENTS, EXERCISING PRECAUTION TO VERIFY ALL DIMENSIONS SHOWN ON
- DRAWING. 29. THE CONTRACTOR SHALL IMMEDIATELY NOTIFY THE DESIGN ENGINEER SHOULD DEPARTURES FROM THE APPROVED DESIGN BECOME NECESSARY DUE TO CIRCUMSTANCES WHICH ARISE DURING CONSTRUCTION.
- 30. ITEMS NOT SPECIFIED BUT NECESSARY FOR PROPER CONSTRUCTION SHALL BE FURNISHED AND INSTALLED BY THE CONTRACTOR THE SAME AS IF SPECIFIED.
- 31. THE CONTRACTOR SHALL BE RESPONSIBLE FOR SCHEDULING ALL NECESSARY INSPECTIONS WITH L&I, INCLUDING FINAL INSPECTION AND PERMIT CLOSEOUT.

DEMOLITION NOTES:

- 1. CONTRACTOR IS RESPONSIBLE FOR THE COORDINATION AND SEQUENCING OF DEMOLITION AS DESCRIBED BY THESE DOCUMENTS AND SPECIFICATIONS. CONTRACTOR IS TO OBTAIN ALL PERMITS.
- 2. CONTRACTOR IS RESPONSIBLE FOR COORDINATION OF DEMOLITION OR RELOCATION WITH APPLICABLE UTILITY COMPANIES, IE, GAS, CABLE, POWER, TELEPHONE, WATER, SEWER, ELECTRIC, LIGHTING, ETC.
- 3. CONTRACTOR SHALL BE RESPONSIBLE TO IMMEDIATELY NOTIFY PPR AND FIX ANY ACTIVE UTILITIES DAMAGED DURING CONSTRUCTION AT THE CONTRACTOR'S EXPENSE. 4. ALL MATERIAL GENERATED BY THE DEMOLITION WILL BE HAULED FROM THE SITE AND
- DISPOSED OF PER LOCAL ORDINANCES. 5. INSTALL PROTECTION FENCE AS NOTED ON PLAN DURING DEMOLITION AND CONSTRUCTION.
- EXISTING UTILITY POLES, LIGHT POLES, HYDRANTS, ETC. THAT ARE NOT MARKED TO 6. BE REMOVED SHALL BE PROTECTED IN PLACE.
- SAW-CUT CONCRETE AND ASPHALT PAVEMENT, SIDEWALK OR CURB BEFORE 7. EXCAVATION WHERE CONSTRUCTION PLANS SHOW TIE-INS. REPAIR OR REPLACE ANY ADJACENT RETAINING WALLS CONCRETE CURBING AND/OR 8.
- SIDEWALK DAMAGED AS PART OF DEMOLITION PROCESS. ROOT ZONE OF TREES TO REMAIN SHALL BE PROTECTED AGAINST COMPACTION AND EXCAVATION. REPLACE ANY TREES OR SHRUBS MARKED TO REMAIN IF DAMAGED AS
- PART OF DEMOLITION OR CONSTRUCTION PROCESS. 10. THIS DEMOLITION PLAN COVERS SURFACE LEVEL EXISTING CONDITIONS, UTILITIES, AND OTHER SITE ELEMENTS. SEE ARCHITECTURAL DEMO PLAN FOR EXTENTS OF
- DEMOLITION OF EXISTING STRUCTURES. 11. PRIOR TO REMOVAL OF SITE FURNISHINGS, CONTRACTOR SHALL WALK THROUGH THE SITE WITH THE CLIENT AND IDENTIFY WHICH EXISTING SITE ELEMENTS ARE TO BE
- SALVAGED FOR RE-USE. 12. ALL EXISTING MONUMENTS AND HISTORIC SCULPTURES SHALL REMAIN AND BE PROTECTED IN PLACE.
- 13. TREE REMOVAL PER DEMOLITION PLAN SHALL INCLUDE STUMPS. 14. ALL TRASH RECEPTACLES TO BE SALVAGED AND RELOCATED ON SITE PER OWNER'S DIRECTION.
- 15. EXISTING PICNIC TABLES TO BE SALVAGED AND RELOCATED IF IN GOOD CONDITION. CONFIRM AND COORDINATE WITH PPR PROJECT MANAGER AT THE TIME OF DEMOLITION.

SITE/CIVIL NOTES:

- GOVERNING THE WORK.
- DO NOT SCALE OFF DRAWINGS, USE DRAWING DIMENSIONS VERIFY ALL DIMENSIONS AND EXISTING CONDITIONS IN THE FIELD PRIOR TO COMMENCEMENT OF WORK. BRING TO THE ATTENTION OF ENGINEER ANY DISCREPANCIES BETWEEN FIELD CONDITIONS AND DRAWINGS PRIOR TO THE BEGINNING OF WORK. FIELD CONDITION DISCREPANCIES SHALL NOT BE USED AS THE BASIS FOR CHANGE ORDER CLAIMS ONCE WORK HAS BEGUN.
- PRESERVE AND PROTECT ALL EXISTING STRUCTURES, FURNISHINGS, SURFACE MATERIALS, ABOVE AND BELOW GRADE UTILITIES, FOOTINGS AND VEGETATION INDICATED TO REMAIN WITHIN AND ADJACENT TO LIMIT OF WORK DURING ALL PHASES OF DEMOLITION AND CONSTRUCTION.
- THE EXISTENCE AND LOCATION OF EACH UNDERGROUND UTILITY IS NOT GUARANTEED AND UNDOCUMENTED CONDITIONS MAY COORDINATE WITH ENGINEER FOR LOCATIONS OF UTILITIES NOT SHOWN ON THE BASE DRAWING INCLUDING, BUT NOT LIMITED TO, HIGH VOLTAGE ELECTRIC, ABANDONED STEAM LINES, ABANDONED WATER LINES, TELEPHONE. CABLES. ETC. STAKE OUT LOCATION OF ALL UTILITIES PRIOR TO COMMENCEMENT OF ANY UTILITY THAT IS DAMAGED DURING SITE WORK OPERATIONS SHALL BE REPAIRED AT THE CONTRACTOR'S EXPENSE. MAINTAIN VEHICULAR TRAFFIC FLOW TO AND AROUND THE SITE. MAINTAIN CLEARLY MARKED PEDESTRIAN ACCESS TO AREAS ON-SITE NOT AFFECTED BY CONSTRUCTION
- ACTIVITIES. CONTRACTOR SHALL ADJUST ALL EXISTING UTILITY STRUCTURES AS REQUIRED TO MEET PROPOSED GRADES, INCLUDING DRAIN INLETS, MANHOLES AND LIGHT POLE. CONTRACTOR SHALL MEET EXISTING GRADES AT ALL EDGES OF LIMIT OF WORK.
- CONTRACTOR IS RESPONSIBLE FOR ALL NECESSARY MEASURES TO PREVENT SOIL EROSION. APPROVED SOIL EROSION AND SEDIMENTATION CONTROL MEASURES MUST BE INSTALLED BEFORE SITE CLEARING AND SITE GRADING OPERATIONS BEGIN. 8. SOIL DISTURBANCE WITHIN TREE PROTECTION ZONES SHALL BE KEPT TO A MINIMUM.
- PERMITTED WITHIN THE TREE PROTECTION ZONE. ALL DIGGING WITHIN TREE PROTECTION ZONE SHALL BE BY HAND. 9. CORE AERATOR, TOP DRESSING MACHINE, AIR SPADING, HAND DIGGING OR OTHER APPROVED METHOD OF DIGGING AND TRENCHING SHALL BE USED IN PLACE OF ROTOTILLER TO COMPLETE ALL WORK IN TREE PROTECTION ZONES. CARE MUST BE TAKEN TO AVOID DISTURBANCE TO ROOTS OF ALL EXISTING TREES, INCLUDING ROOTS EXTENDING OUTSIDE THE TREES PROTECTION ZONES. EXCAVATION WITHIN PROTECTED ZONES SHALL BE BY MEANS OF AIR SPADING, OPERATED BY A TRAINED AND CERTIFIED OPERATOR. THE CONTRACTOR IS RESPONSIBLE FOR ENSURING
- PROPER DRAINAGE OF THE PROJECT SITE AND ALL UPGRADIENT AREAS TO THE SITE. 10. MILLINGS, STONE, SOIL, CONSTRUCTION DEBRIS, AND ALL OTHER RELATED MATERIALS SHALL BECOME THE PROPERTY OF THE CONTRACTOR FOR OFF-SITE DISPOSAL. 11. CONTRACTOR IS RESPONSIBLE FOR COORDINATING WITH PROPER UTILITY COMPANY
- OR AGENCY FOR DISCONNECTING SERVICES, RELOCATING SERVICES, AND PROVIDING NEW SERVICES WITHIN THE PROJECT AREA. 12. WHERE CONSTRUCTION, INCLUDING UTILITY LINES, CROSSES OR IS ADJACENT TO EXISTING UTILITY LINES (FUEL, WATER, SEWER, TELECOMMUNICATION, GAS OR ELECTRIC), CONTRACTOR SHALL DIG TEST PITS AND CAREFULLY HAND EXCAVATE SO AS TO LOCATE, MARK, AND PROTECT THE UTILITY LINES AGAINST DISTURBANCE OR DAMAGE.
- GAS AND ELECTRIC LINES.
- PLACE. 15. WHERE MANUFACTURER'S NAMES AND PRODUCT NUMBERS ARE INDICATED ON DRAWINGS, IT SHALL BE CONSTRUED TO MEAN THE ESTABLISHMENT OF QUALITY AND PERFORMANCE STANDARDS OF SUCH ITEMS. ALL OTHER PRODUCTS MUST BE SUBMITTED TO THE ENGINEER FOR APPROVAL BEFORE THEY SHALL BE DEEMED EQUAL
- 16. EXISTING ASPHALT OR CONCRETE PAVEMENT IN THE AREAS OF NEW PAVEMENT SHALL BE ENTIRELY REMOVED AND DISPOSED OF BY THE CONTRACTOR IN CONFORMANCE WITH PADEP AND PHILADELPHIA CODE. THE SUBGRADE SHALL BE PREPARED AND BROUGHT TO THE REQUIRED ELEVATION PRIOR TO CONSTRUCTING BASE AND TOP
- COURSE 17. WHERE EXISTING CONCRETE PAVEMENT OR ASPHALT CONCRETE PAVEMENT ARE REMOVED, THE CONTRACTOR SHALL SAWCUT AND NEATLY TRIM EDGE OF REMAINING PAVEMENT BEFORE INSTALLING NEW CONSTRUCTION.

GRADING NOTES:

- 1. CONTRACTOR SHALL VERIFY ALL EXISTING GRADES IN THE FIELD AND REPORT ANY DISCREPANCIES TO THE ENGINEER. CONTRACTOR SHALL STAKE ALL ELEVATIONS TO BE APPROVED BY THE ENGINEER BEFORE CONSTRUCTION.
- 2. ALL LINES AND GRADE WORK NOT PRESENTLY ESTABLISHED AT THE SITE SHALL BE LAID OUT BY A REGISTERED LAND SURVEYOR OR PROFESSIONAL CIVIL ENGINEER EMPLOYED BY THE CONTRACTOR IN ACCORDANCE WITH THE CONTRACT DOCUMENTS. CONTRACTOR SHALL ESTABLISH PERMANENT BENCHMARKS AND BOUNDS AND REPLACE ANY WHICH ARE DESTROYED OR DISTURBED.
- THE WORDS 'FINISHED GRADE' (F.G.) SHALL MEAN THE REQUIRED FINAL GRADE ELEVATIONS INDICATED ON THE DRAWINGS.
- SPOT ELEVATIONS SHALL GOVERN OVER PROPOSED CONTOURS. CONTRACTOR SHALL ENSURE CONSISTENT SLOPE BETWEEN SPOT ELEVATIONS.
- AT RIDGE LINES, HIGH POINTS AND LOW POINTS, CONTRACTOR SHALL TRANSITION GRADE TO AVOID A POINT OR SHARP EDGE. ALL WORK PERFORMED IN A PUBLIC RIGHT-OF-WAY SHALL MEET THE REQUIREMENTS OF THE CITY OF PHILADELPHIA. CONTRACTOR SHALL NOT PERFORM WORK OUTSIDE THE DESIGNATED SITE BOUNDARY. IF FIELD CONDITIONS WARRANT OFF-SITE GRADING,
- PERMISSION SHALL BE OBTAINED BY CONTRACTOR FROM THE AFFECTED PROPERTY OWNERS. FOR SLOPE CONSTRUCTION 3:1 AND STEEPER THE CONTRACTOR SHALL COORDINATE
- WITH A GEOTECHNICAL ENGINEER ON THE SUITABILITY OF SOILS PLANNED FOR THESE SLOPES AND FOLLOW RECOMMENDATIONS SET FORTH BY THE GEOTECHNICAL ENGINEER FOR SLOPE CONSTRUCTION. TOP SOIL PLACEMENT ON SLOPES SHALL BE INSTALLED IN A BENCHED PATTERN.

HEAVY MACHINERY, MECHANICAL TRENCHING OR MATERIAL STORAGE IS NOT

- 13. THE CONTRACTOR SHALL EXERCISE CAUTION WHEN REGRADING OVER EXISTING/NEW UTILITIES INCLUDING, BUT NOT LIMITED TO STORM AND SANITARY SEWERS, WATER MAINS,
- 14. THE CONTRACTOR IS TO EXERCISE EXTREME CARE WHEN PERFORMING ANY WORK ACTIVITIES ADJACENT TO BUILDING OR EXTERIOR SITE WALLS THAT ARE TO REMAIN IN

TRAFFIC CONTROL:

- 1. THE CONTRACTOR SHALL PROVIDE AND INSTALL TRAFFIC CONTROL DEVICES IN CONFORMANCE WITH THE MOST RECENT EDITION OF THE MANUAL ON UNIFORM TRAFFIC CONTROL DEVICES (MUTCD).
- 2. THE CONTRACTOR SHALL MAINTAIN AT LEAST ONE LANE OF TRAFFIC IN EACH DIRECTION DURING WORKING HOURS EXCEPT DURING FLAGGING OPERATION OR PROVIDE DETOURS AROUND THE CONSTRUCTION SITE AND PROVIDE PUBLIC NOTIFICATION.
- DETOURS REQUIRE PRIOR APPROVAL OF THE TOWN ENGINEER. DETOUR PLANS, IF ALLOWED, MUST INCLUDE APPROPRIATE DETOUR SIGNAGE, PUBLIC NOTICE VIA SIGNAGE TWO WEEKS IN ADVANCE STATING THE DATES OF THE AGREED UPON DATE OF CLOSURE AND DATE THE ROAD WILL RE-OPEN TO TRAFFIC. CONTRACTOR TO USE CONSTRUCTION METHODS TO MINIMIZE THE DURATION OF THE DETOUR AND TO ENSURE THAT THE ROADWAY IS OPEN ON, OR PRIOR TO, THE AGREED UPON DATE.
- ONE DAY PRIOR TO THE IMPLEMENTATION OF A TRAFFIC CONTROL PLAN PHASE OR STEP, OR THE IMPLEMENTATION OF AN ADDITIONAL, REVISED, OR NEW TRAFFIC CONTROL ELEMENT, THE CONTRACTOR SHALL MEET WITH THE ENGINEER TO GIVE A DETAILED DESCRIPTION OF THE CONTRACTOR'S PLAN AND PREPARATIONS. THE CONTRACTOR SHALL OBTAIN WRITTEN APPROVAL FROM THE ENGINEER THAT ADEQUATE PROJECT PROGRESS HAS BEEN ACHIEVED AND THAT ADEQUATE PREPARATIONS ARE IN PLACE PRIOR TO SWITCHING TRAFFIC. IF, IN THE OPINION OF THE ENGINEER. REQUIRED PROGRESS AND ADEQUATE PREPARATIONS ARE NOT COMPLETE, THE CONTRACTOR SHALL NOT IMPLEMENT THE NEXT PHASE, STEP, OR ELEMENT OF TRAFFIC CONTROL UNTIL INCOMPLETE CONSTRUCTION ITEMS OR PREPARATIONS ARE COMPLETED. TIME EXTENSIONS WILL NOT BE GRANTED FOR DELAYS CAUSED BY THE INCOMPLETE CONSTRUCTION ITEMS OR INADEQUATE CONTRACTOR PREPARATIONS REQUIRED TO IMPLEMENT TRAFFIC CONTROL.
- TRAFFIC CONTROL PER THE CONTRACT IS REQUIRED FOR THE ENTIRE DURATION OF THE PROJECT, INCLUDING THE PUNCHLIST PERIOD.
- 6. THE CONTRACTOR SHALL SUBMIT A TRAFFIC CONTROL PLAN TO THE TOWN FOR REVIEW AND APPROVAL A MINIMUM OF 3 DAYS PRIOR TO THE START OF CONSTRUCTION

ISSUE			
	DATE	RE	VISIONS
Ĺ	PENNSYLVAN	IA ONE CALL SYSTEM	VETO VETO
	BEFORE PENNSYLVAN NON-MEMBERS PA LAW RE NOTICE TO U DRIL	225 Irwin Run Road st Mifflin, Pennsylvania 15122 – 1078	2-1776 Directly
PPR PROJECT CO			MEGAN FUNK
		ROFESSIONAL ROFESSIONAL RD D. CONFAIR J ENGINEER No. PE092932	R.
SIGNATURE			DATE SIGN
CA	MM	man	04/04/20
PRIMARY CONSU	ILTANT, LANDSCAPI	E ARCHITECT:	
219 Cuthbert Stree Philadelphia, PA 1 MEP ENGINEER: SRW 417 N 8th Street, S Philadelphia, PA 1 267.585.2811	9106 Suite 204 9123	SOCIATES, INC.	
LIGHTING DESIGI THE LIGHTING PF 600 Chestnut Stree Philadelphia, PA 19 COST ESTIMATO	RACTICE et, Suite 772 9106		
32 Broadway, 8TH New York, NY 100	04	NTS	
PLAYFUL LEARNI Philadelphia, PA 267.468.8610	NG CONSULTANT: NG LANDSCAPES A	CTION NEXTWORK	
ARBORIST:			
MORRIS ARBORE 100 East Northwes Philadelphia, PA 1 215.247.5777	tern Avenue		
MORRIS ARBORE 100 East Northwes Philadelphia, PA 12 215.247.5777 ACCESSIBILITY C CHRIS NOEL christopher.noel@	tern Avenue 9118 CONSULTANT:		
MORRIS ARBORE 100 East Northwes Philadelphia, PA 1: 215.247.5777 ACCESSIBILITY C CHRIS NOEL	tern Avenue 9118 CONSULTANT: parks.nyc.gov NT: it A		
MORRIS ARBORE 100 East Northwes Philadelphia, PA 1: 215.247.5777 ACCESSIBILITY O CHRIS NOEL christopher.noel@ 646.632.7344 PLAY CONSULTA STUDIO LUDO 1313 S 33rd St, Ur	tern Avenue 9118 CONSULTANT: parks.nyc.gov NT: it A 9146		2107
MORRIS ARBORE 100 East Northwes Philadelphia, PA 12 215.247.5777 ACCESSIBILITY C CHRIS NOEL christopher.noel@ 646.632.7344 PLAY CONSULTA STUDIO LUDO 1313 S 33rd St, Ur Philadelphia, PA 12 CONSULTANT PR	tern Avenue 9118 CONSULTANT: parks.nyc.gov NT: iit A 9146 COJECT NUMBER		2107 ELPHIA RECREATION
MORRIS ARBORE 100 East Northwes Philadelphia, PA 1: 215.247.5777 ACCESSIBILITY C CHRIS NOEL christopher.noel@ 646.632.7344 PLAY CONSULTA STUDIO LUDO 1313 S 33rd St, Ur Philadelphia, PA 1: CONSULTANT PE CONSULTANT PE	tern Avenue 9118 CONSULTANT: parks.nyc.gov NT: iit A 9146 COJECT NUMBER Y OF F ELPHIA P. 1515 FLOOR, C	ARKS AND ARCH STRE	ELPHIA RECREATION
MORRIS ARBORE 100 East Northwes Philadelphia, PA 1: 215.247.5777 ACCESSIBILITY O CHRIS NOEL christopher.noel@ 646.632.7344 PLAY CONSULTA STUDIO LUDO 1313 S 33rd St, Ur Philadelphia, PA 1: CONSULTANT PR CONSULTANT PR	tern Avenue 2118 CONSULTANT: parks.nyc.gov NT: it A 20146 COJECT NUMBER Y OF F ELPHIA P. 1515 FLOOR, C	ARKS AND ARCH STRE	ELPHIA RECREATION EET /AY BUILDING 16-21-7062-07
MORRIS ARBORE 100 East Northwes Philadelphia, PA 1: 215.247.5777 ACCESSIBILITY C CHRIS NOEL christopher.noel@ 646.632.7344 PLAY CONSULTA STUDIO LUDO 1313 S 33rd St, Ur Philadelphia, PA 1: CONSULTANT PF CONSULTANT PF CONSULTANT PF DHILADI DHILADI PPR PROJECT NU PROJECT TITLE:	tern Avenue 9118 CONSULTANT: parks.nyc.gov NT: iit A 9146 COJECT NUMBER Y OF F ELPHIA PA 1515 FLOOR, C JMBER PENN NIVERSA RHAWN ST	ARKS AND ARCH STRE DNE PARKW	ELPHIA RECREATION EET /AY BUILDING 16-21-7062-07 ARK BROUND RST AVE.
MORRIS ARBORE 100 East Northwes Philadelphia, PA 1: 215.247.5777 ACCESSIBILITY C CHRIS NOEL christopher.noel@ 646.632.7344 PLAY CONSULTA STUDIO LUDO 1313 S 33rd St, Ur Philadelphia, PA 1: CONSULTANT PF CONSULTANT PF CONSULTANT PF PHILADI 11TH PPR PROJECT NU PROJECT TITLE:	tern Avenue 9118 CONSULTANT: barks.nyc.gov NT: iit A 9146 COJECT NUMBER Y OF F ELPHIA PA 1515 FLOOR, C JMBER PENN NIVERSA RHAWN ST PHILAE	ARKS AND ARCH STRE DNE PARKW YPACK PA AL PLAYC & HOLMEHUF	ELPHIA RECREATION EET /AY BUILDING 16-21-7062-07 ARK BROUND RST AVE. 9136
MORRIS ARBORE 100 East Northwes Philadelphia, PA 1: 215.247.5777 ACCESSIBILITY C CHRIS NOEL christopher.noel@ 646.632.7344 PLAY CONSULTA STUDIO LUDO 1313 S 33rd St, Ur Philadelphia, PA 1: CONSULTANT PF CONSULTANT PF CONSULTANT PF PHILADI 11TH PPR PROJECT NU PROJECT TITLE:	tern Avenue 2118 CONSULTANT: Darks.nyc.gov NT: iit A 20JECT NUMBER Y OF F ELPHIA PA 1515 FLOOR, C JMBER PENN NIVERSA RHAWN ST PHILAE GENE	ARKS AND ARCH STRE DNE PARKW YPACK PA AL PLAYO AL PLAYO AL PLAYO ERAL NOT	ELPHIA RECREATION EET /AY BUILDING 16-21-7062-07 ARK BROUND RST AVE. 9136
MORRIS ARBORE 100 East Northwes Philadelphia, PA 1: 215.247.5777 ACCESSIBILITY C CHRIS NOEL christopher.noel@ 646.632.7344 PLAY CONSULTA STUDIO LUDO 1313 S 33rd St, Ur Philadelphia, PA 1: CONSULTANT PF CONSULTANT PF CONSULTANT PF DHILADI 11TH PPR PROJECT NU PROJECT TITLE: U	tern Avenue 2118 CONSULTANT: Darks.nyc.gov NT: it A 20JECT NUMBER Y OF F ELPHIA PA 1515 FLOOR, C JMBER PENN NIVERSA RHAWN ST PHILAE GENE	ARKS AND ARCH STRE DNE PARKW YPACK PA AL PLAYO AL PLAYO ELPHIA, PA 19 ERAL NOT	ELPHIA RECREATION EET (AY BUILDING 16-21-7062-07 ARK BROUND RST AVE. 9136
MORRIS ARBORE 100 East Northwes Philadelphia, PA 12 215.247.5777 ACCESSIBILITY C CHRIS NOEL christopher.noel@ 646.632.7344 PLAY CONSULTA STUDIO LUDO 1313 S 33rd St, Ur Philadelphia, PA 12 CONSULTANT PE CITT PHILADI 11TTH PPR PROJECT NU PROJECT TITLE: U DRAWING TITLE: CONSULTANT PE	tern Avenue 2118 CONSULTANT: Darks.nyc.gov NT: itt A 20JECT NUMBER Y OF F ELPHIA PA 1515 FLOOR, C JMBER PENN NIVERSA RHAWN ST PHILAE CENE	ARKS AND ARCH STRE DNE PARKW YPACK PA AL PLAYG AL PLAYG AL PLAYG ERAL NOT ERAL NOT	ELPHIA RECREATION EET /AY BUILDING 16-21-7062-07 ARK BROUND RST AVE. 9136
MORRIS ARBORE 100 East Northwes Philadelphia, PA 12 215.247.5777 ACCESSIBILITY C CHRIS NOEL christopher.noel@ 646.632.7344 PLAY CONSULTA STUDIO LUDO 1313 S 33rd St, Ur Philadelphia, PA 12 CONSULTANT PF CONSULTANT PF PROJECT TITLE: U PROJECT TITLE: U PROJECT TITLE:	tern Avenue 2118 CONSULTANT: parks.nyc.gov NT: it A 20JECT NUMBER Y OF F ELPHIA P. 1515 FLOOR, C JMBER PENN NIVERSA RHAWN ST PHILAE C.: 16-21 C.: 12/	ARKS AND ARCH STRE DNE PARKW YPACK PA AL PLAYG AL PLAYG AL PLAYG ERAL NOT ERAL NOT	ELPHIA RECREATION EET (AY BUILDING 16-21-7062-07 ARK BROUND RST AVE. 9136

BRT/OPA: 871402520 PHILADELPHIA WATER TRACKING NO. FY22-PENN-6850-01

PENNSYLVANIA ONE CALL SYSTEM. INC SITE IDENTIFICATION NO 20220322281 925 Irwin Run Road





GENERAL NOTES:

- OWNE **CITY OF PHILADELPHIA** DEPARTMENT OF PUBLIC PROPERTY 702 CITY HALL, PHILADELPHIA, PA 19107 215-686-1776
- 2. SURVEYOR SAS GEOSPATIAL, LLC 1432 EASTON ROAD, SUITE 5F WARRINGTON, PA 18976 215-3435989
- 3. BOUNDARY AND TOPOGRAPHIC INFORMATION FROM A PLAN TITLED "TOPOGRAPHIC & LOCATION SURVEY PENNYPACK PARK" PREPARED BY SAS GEOSPATIAL, LLC DATED 11/10/23 OR LAST REVISED.
- 4. VERTICAL INFORMATION AS SHOWN HEREON IS BASED ON NORTH AMERICAN VERTICAL DATUM OF 1988 (NAVD88).
- 5. HORIZONTAL INFORMATION IS BASED ON THE PENNSYLVANIA STATE PLANE COORDINATE SYSTEM
- 6. THIS PLAN WAS PREPARED IN ACCORDANCE WITH INSTRUCTIONS FROM THE CLIENT.
- 7. THIS PLAN WAS PREPARED WITHOUT THE BENEFIT OF A TITLE REPORT.
- 8. EXCEPT AS SPECIFICALLY STATED OR SHOWN ON THIS PLAT, THIS SURVEY DOES NOT PURPORT TO REFLECT ANY OF THE FOLLOWING WHICH MAY BE APPLICABLE TO THE SUBJECT REAL ESTATE: EASEMENTS, OTHER THAN POSSIBLE EASEMENTS THAT WERE VISIBLE AT THE TIME OF MAKING OF THIS SURVEY; BUILDING SETBACK LINES; RESTRICTIVE COVENANTS; SUBDIVISION RESTRICTIONS; ZONING OR OTHER LAND USE REGULATIONS; AND ANY OTHER FACTS THAT AN ACCURATE TITLE SEARCH MAY DISCLOSE.
- 9. SURVEYOR HAS MADE NO INVESTIGATION OR INDEPENDENT SEARCH FOR EASEMENTS OR RECORD, ENCUMBRANCES, RESTRICTIVE COVENANTS, OWNERSHIP TITLE EVIDENCE, OR ANY OTHER FACTS THAT AN ACCURATE TITLE SEARCH MAY DISCLOSE.
- 10. THE WORD "CERTIFY" AS USED IN ITS VARIOUS FORMS HEREON, IS UNDERSTOOD TO BE AN EXPRESSION OF PROFESSIONAL OPINION BY THE SURVEYOR, WHICH IS BASED ON HIS BEST KNOWLEDGE, INFORMATION AND BELIEF. AS SUCH, IT CONSTITUTES NEITHER A GUARANTEE OR WARRANTY, EITHER EXPRESSED OR IMPLIED.
- 11. UNDERGROUND UTILITIES LOCATED ARE BASED ON VISIBLE INSPECTION OF PIPE AND CONDUITS DURING THE TIME OF SURVEY AND UTILITY MARK OUT BY SINGER UTILITY ENGINEERING, P.C..
- 12. MAP ENTITLED "UTILITY DESIGNATING PLAN, PENNYPACK PARK, PHILADELPHIA, PA" PREPARED BY SINGER UTILITY ENGINEERING, PC, JOB #21-063PA, SHEET 1 OF 1.
- 13. STREET STATUS CARD LC016658.
- 14. PER PHILADELPHIA WATER DEPARTMENT RECORD DRAWING 248922, THERE IS A 12" WATER MAIN ALONG RHAWN STREET. THERE ARE NO STORMSEWER LINES IN RHAWN STREET.
- 15. TREE LOCATIONS, SPECIES, AND CALIPER TAKEN A FROM A REPORT TITLEED "PENNYPACK PARK PLAYGROUND TREE MANAGEMENT PLAN" PREPARED BY MORRIS ARBORETUM OF THE UNIVERSITY OF PENNSYLVANIA – URBAN FORESTRY CONSULTANTS, DATED 6/13/2022

FLOOD ZONE INFORMATION:


1. BY GRAPHIC PLOTTING ONLY, SUBJECT PARCEL AREA IS LOCATED IN ZONE X OF THE FLOOD INSURANCE RATE MAP, PANEL NO. 116 OF 230, COMMUNITY MAP NO. 4207570116GWHICH BEARS AN EFFECTIVE DATE OF JANUARY 17, 2007. NO FIELD SURVEYING WAS PERFORMED TO DETERMINE THIS ZONE AND AN ELEVATION CERTIFICATE MAY BE NEEDED TO VERIFY THIS DETERMINATION OR APPLY FOR A VARIANCE FROM THE FEDERAL EMERGENCY MANAGEMENT AGENCY.

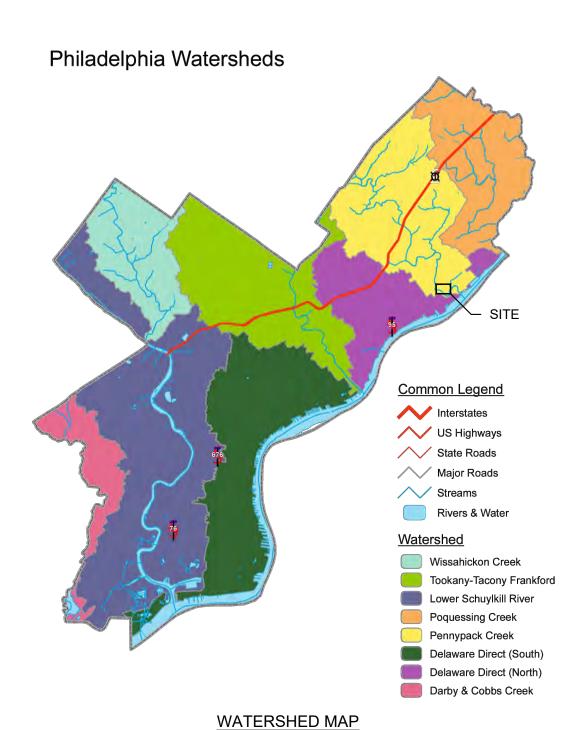

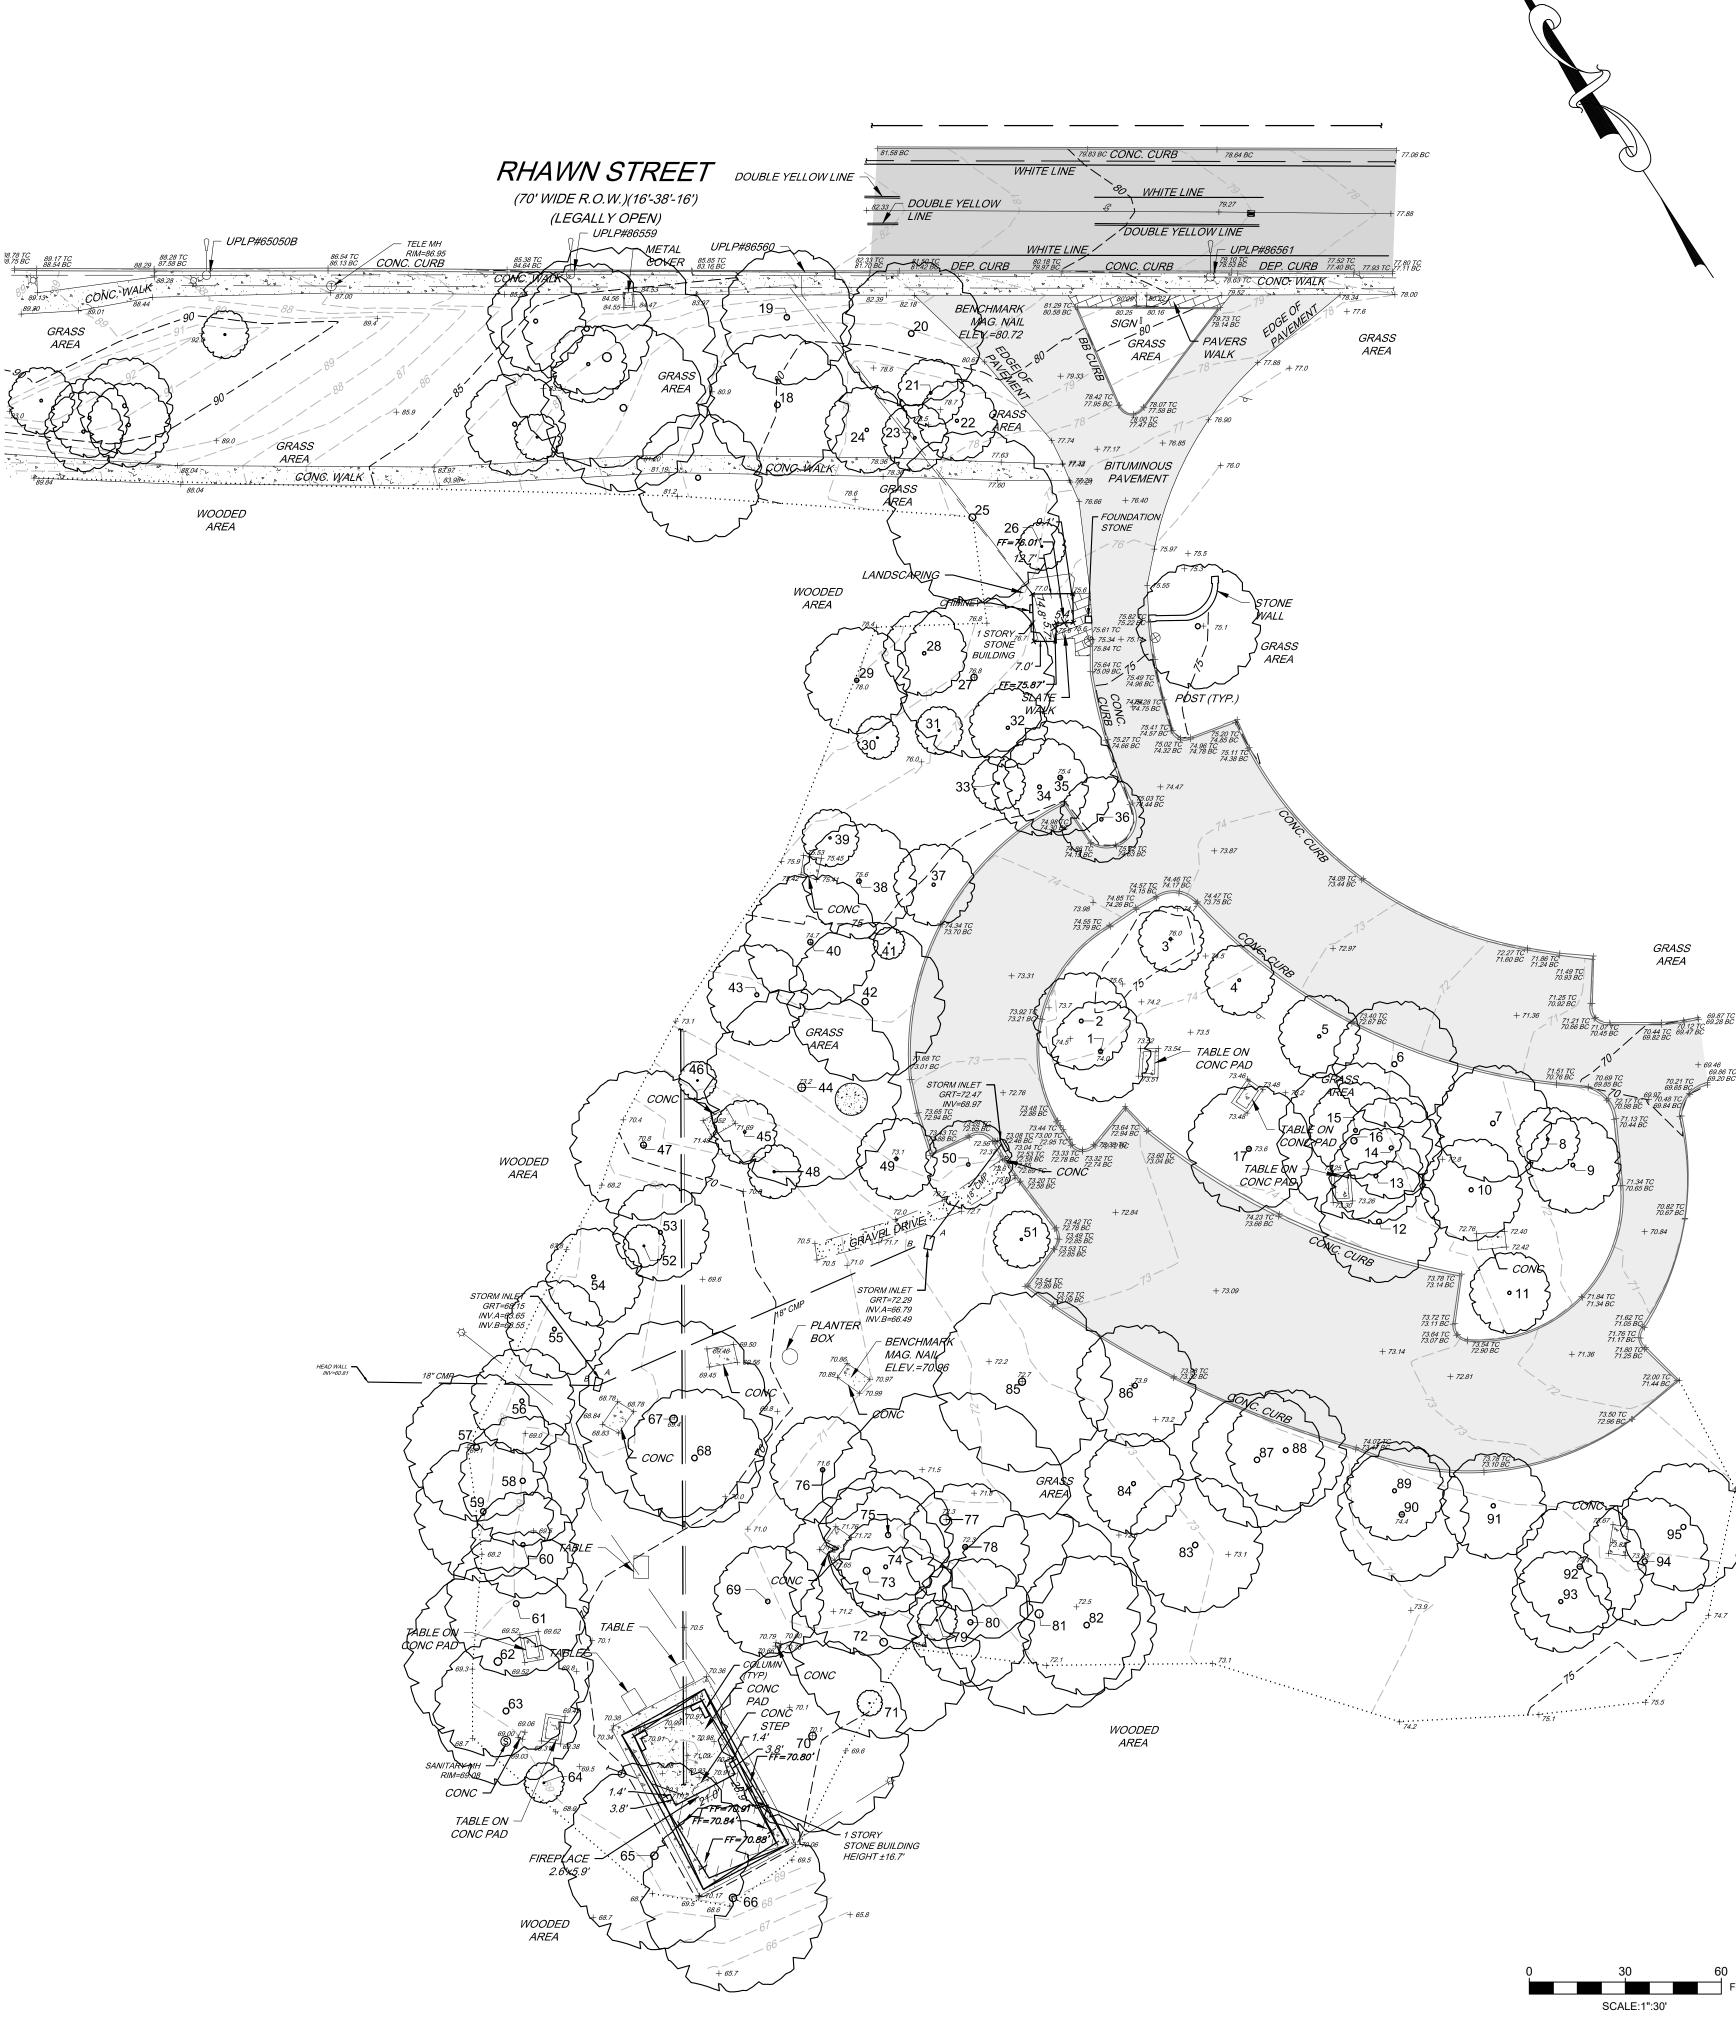



LEGEND

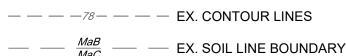


 EX. PAVEMENT
 EX. CURB
EX. BUILDING
EX. CONCRETE
EX. SLATE
EX. ASPHALT

 $\overline{\bigcirc}$	-
\triangleright	
Þ	
~~~Q	

_	EX. CURB
$\setminus$	EX. BUILDING
	EX. CONCRETE
	EX. SLATE
	EX. ASPHALT
_	EX. UTILITY LINES
	EX. TREE
	EX. BENCHMARK
	EX. HYDRANT

EX. LIGHT UTILITY POLE

EXISTING TREES							
TREE NUMBER	CALIPER	TREE NUMBER	CALIPER	TREE NUMBER	CALIPER		
1	27.5	33	8.6	65	6.7		
2	6.7	34	10.5	66	33.1		
3	6.7	35	10.2	67	22.3		
4	8.9	36	9.9	68	23.2		
5	6.7	37	7.0	69	23.6		
6	5.7	38	5.7	70	24.8		
7	24.1	39	3.8	71	2.5		
8	6.4	40	31.8	72	2.5		
9	16.6	41	2.9	73	18.8		
10	35.0	42	23.9	74	18.5		
11	7.0	43	2.9	75	19.4		
12	32.9	44	36.6	76	19.7		
13	18.8	45	4.8	77	21.0		
14	21.0	46	2.2	78	20.1		
15	19.1	47	33.7	79	2.5		
16	28.3	48	1.9	80	24.5		
17	16.2	49	5.7	81	20.4		
18	33.1	50	5.7	82	23.6		
19	22.0	51	7.6	83	10.8		
20	32.1	52	2.9	84	12.7		
21	9.5	53	3.2	85	13.1		
22	13.1	54	3.8	86	29.1		
23	10.2	55	2.9	87	26.5		
24	14.0	56	3.8	88	17.8		
25	18.8	57	5.4	89	27.2		
26	4.1	58	4.1	90	20.4		
27	28.0	59	3.8	91	24.8		
28	5.7	60	3.2	92	19.4		
29	4.1	61	1.9	93	2.2		
30	4.1	62	29.0	94	22.3		
31	4.1	63	3.5	95	22.0		
32	6.7	64	2.9				

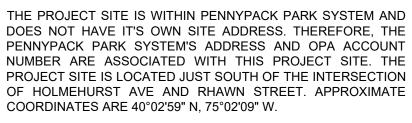



ADDRESS: 8300 FRANKFORD AVE PHILADELPHIA, PA 19136 <u>BRT/OPA:</u> 871402520


PHILADELPHIA WATER TRACKING NO .: FY22-PENN-6850-01

PENNSYLVANIA ONE CALL SYSTEM, INC. SITE IDENTIFICATION NO .: 20220322281 925 Irwin Run Road

West Mifflin, Pennsylvania 15122 - 1078

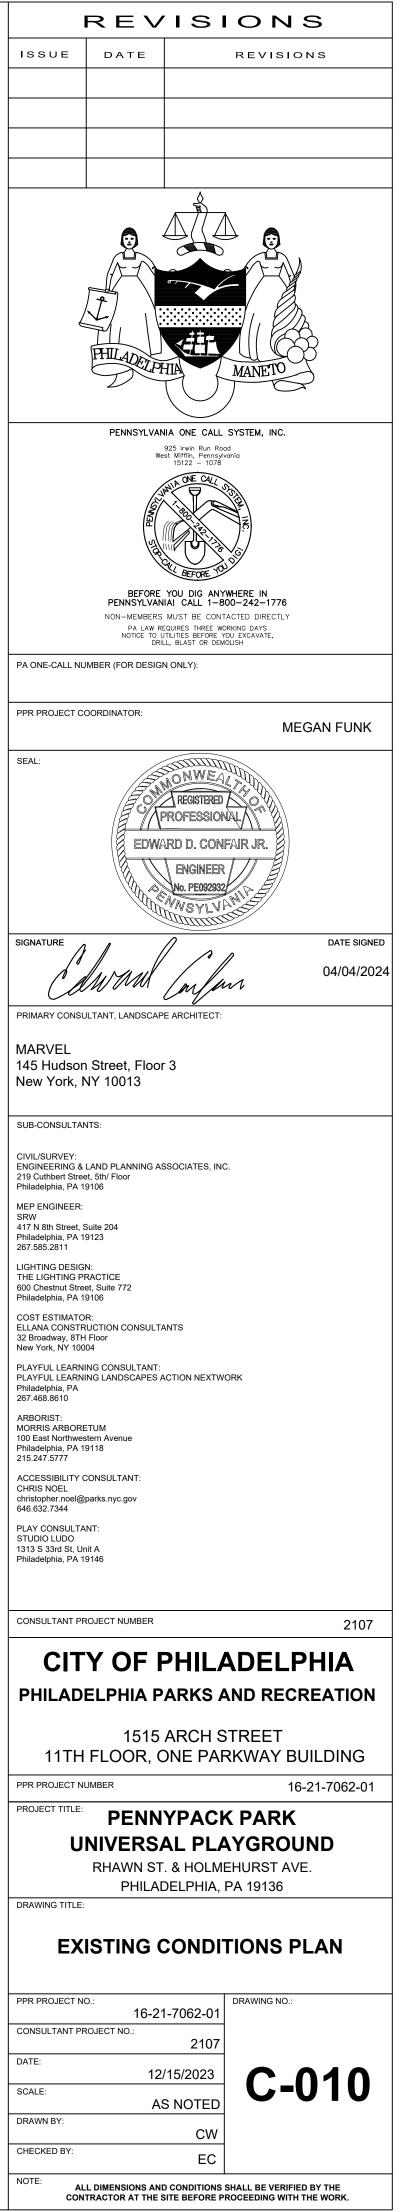


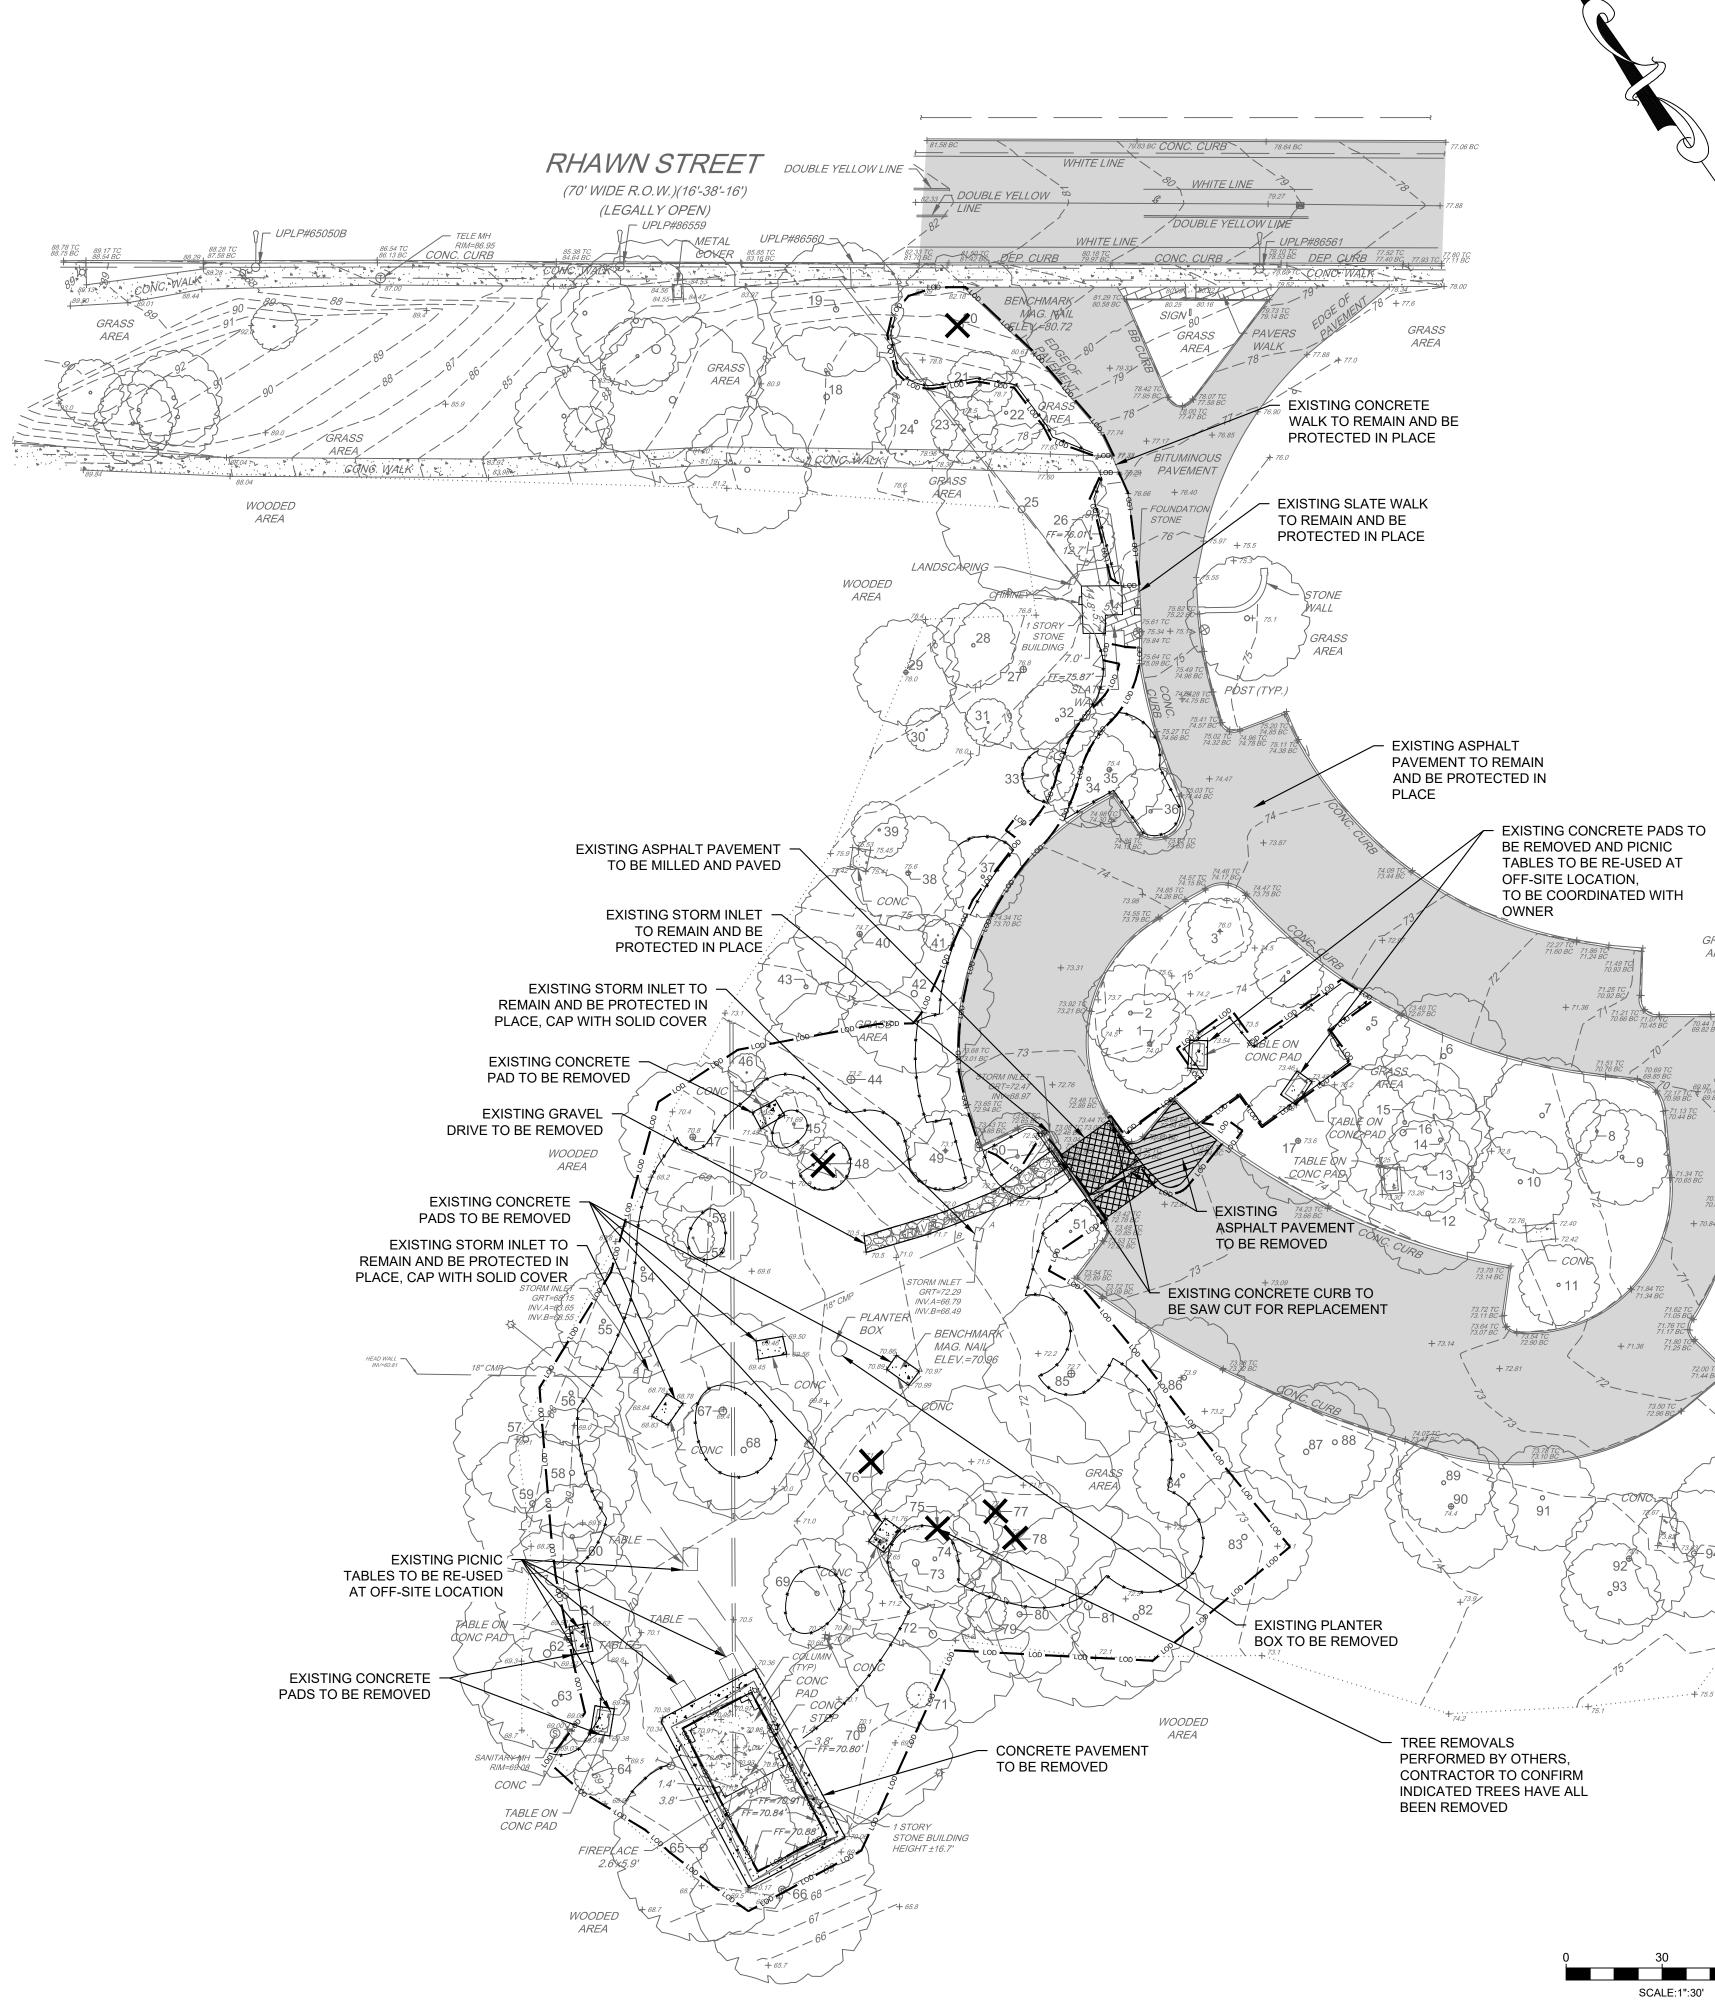

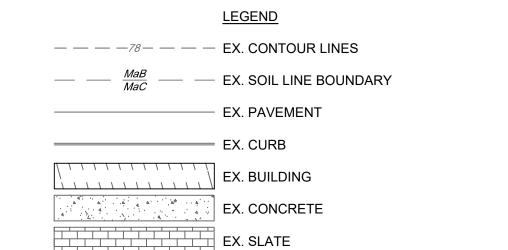

EX. ASPHALT

- EX. FULL DEPTH ASPHALT REMOVAL
- EX. UTILITY LINES
  - EX. TREE
  - EX. BENCHMARK EX. HYDRANT
  - EX. LIGHT UTILITY POLE
  - TREE TO BE REMOVED

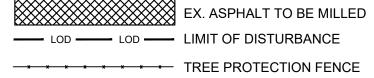

GRASS

AREA

+ 70.84

**٤**•

Þ

 $\sim \lambda$ 

X

EXISTING TREES						
TREE NUMBER	CALIPER	TREE NUMBER	CALIPER	TREE NUMBER	CALIPER	
1	27.5	33	8.6	65	6.7	
2	6.7	34	10.5	66	33.1	
3	6.7	35	10.2	67	22.3	
4	8.9	36	9.9	68	23.2	
5	6.7	37	7.0	69	23.6	
6	5.7	38	5.7	70	24.8	
7	24.1	39	3.8	71	2.5	
8	6.4	40	31.8	72	2.5	
9	16.6	41	2.9	73	18.8	
10	35.0	42	23.9	74	18.5	
11	7.0	43	2.9	75	19.4	
12	32.9	44	36.6	76	19.7	
13	18.8	45	4.8	77	21.0	
14	21.0	46	2.2	78	20.1	
15	19.1	47	33.7	79	2.5	
16	28.3	48	1.9	80	24.5	
17	16.2	49	5.7	81	20.4	
18	33.1	50	5.7	82	23.6	
19	22.0	51	7.6	83	10.8	
20	32.1	52	2.9	84	12.7	
21	9.5	53	3.2	85	13.1	
22	13.1	54	3.8	86	29.1	
23	10.2	55	2.9	87	26.5	
24	14.0	56	3.8	88	17.8	
25	18.8	57	5.4	89	27.2	
26	4.1	58	4.1	90	20.4	
27	28.0	59	3.8	91	24.8	
28	5.7	60	3.2	92	19.4	
29	4.1	61	1.9	93	2.2	
30	4.1	62	29.0	94	22.3	
31	4.1	63	3.5	95	22.0	
32	6.7	64	2.9			


THE PROJECT SITE IS WITHIN PENNYPACK PARK SYSTEM AND DOES NOT HAVE IT'S OWN SITE ADDRESS. THEREFORE, THE PENNYPACK PARK SYSTEM'S ADDRESS AND OPA ACCOUNT NUMBER ARE ASSOCIATED WITH THIS PROJECT SITE. THE PROJECT SITE IS LOCATED JUST SOUTH OF THE INTERSECTION OF HOLMEHURST AVE AND RHAWN STREET. APPROXIMATE COORDINATES ARE 40°02'59" N, 75°02'09" W.

ADDRESS: 8300 FRANKFORD AVE PHILADELPHIA, PA 19136 <u>BRT/OPA:</u> 871402520

PHILADELPHIA WATER TRACKING NO .: FY22-PENN-6850-01


PENNSYLVANIA ONE CALL SYSTEM, INC. SITE IDENTIFICATION NO .: 20220322281 925 Irwin Run Road West Mifflin, Pennsylvania 15122 - 1078



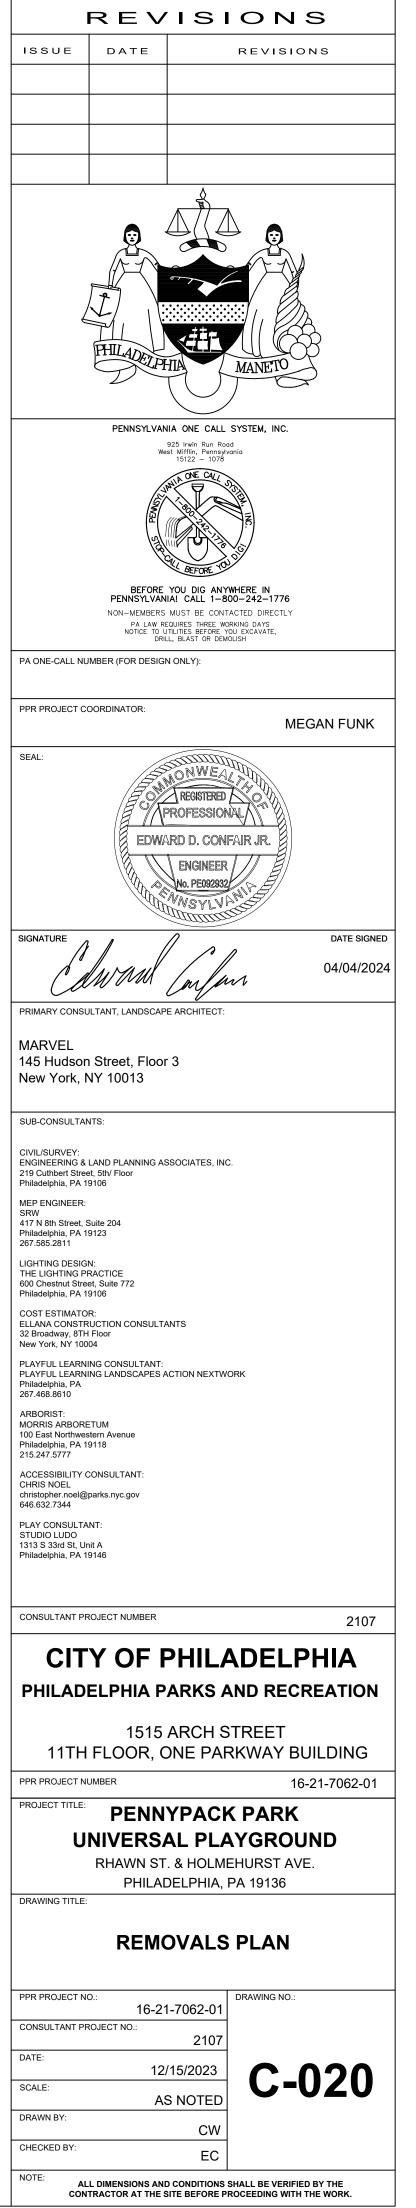


GRADING NOTES:

1. LESS THAN 2% CROSS SLOPE TO BE MAINTAINED AT ALL PROPOSED WALKWAYS.

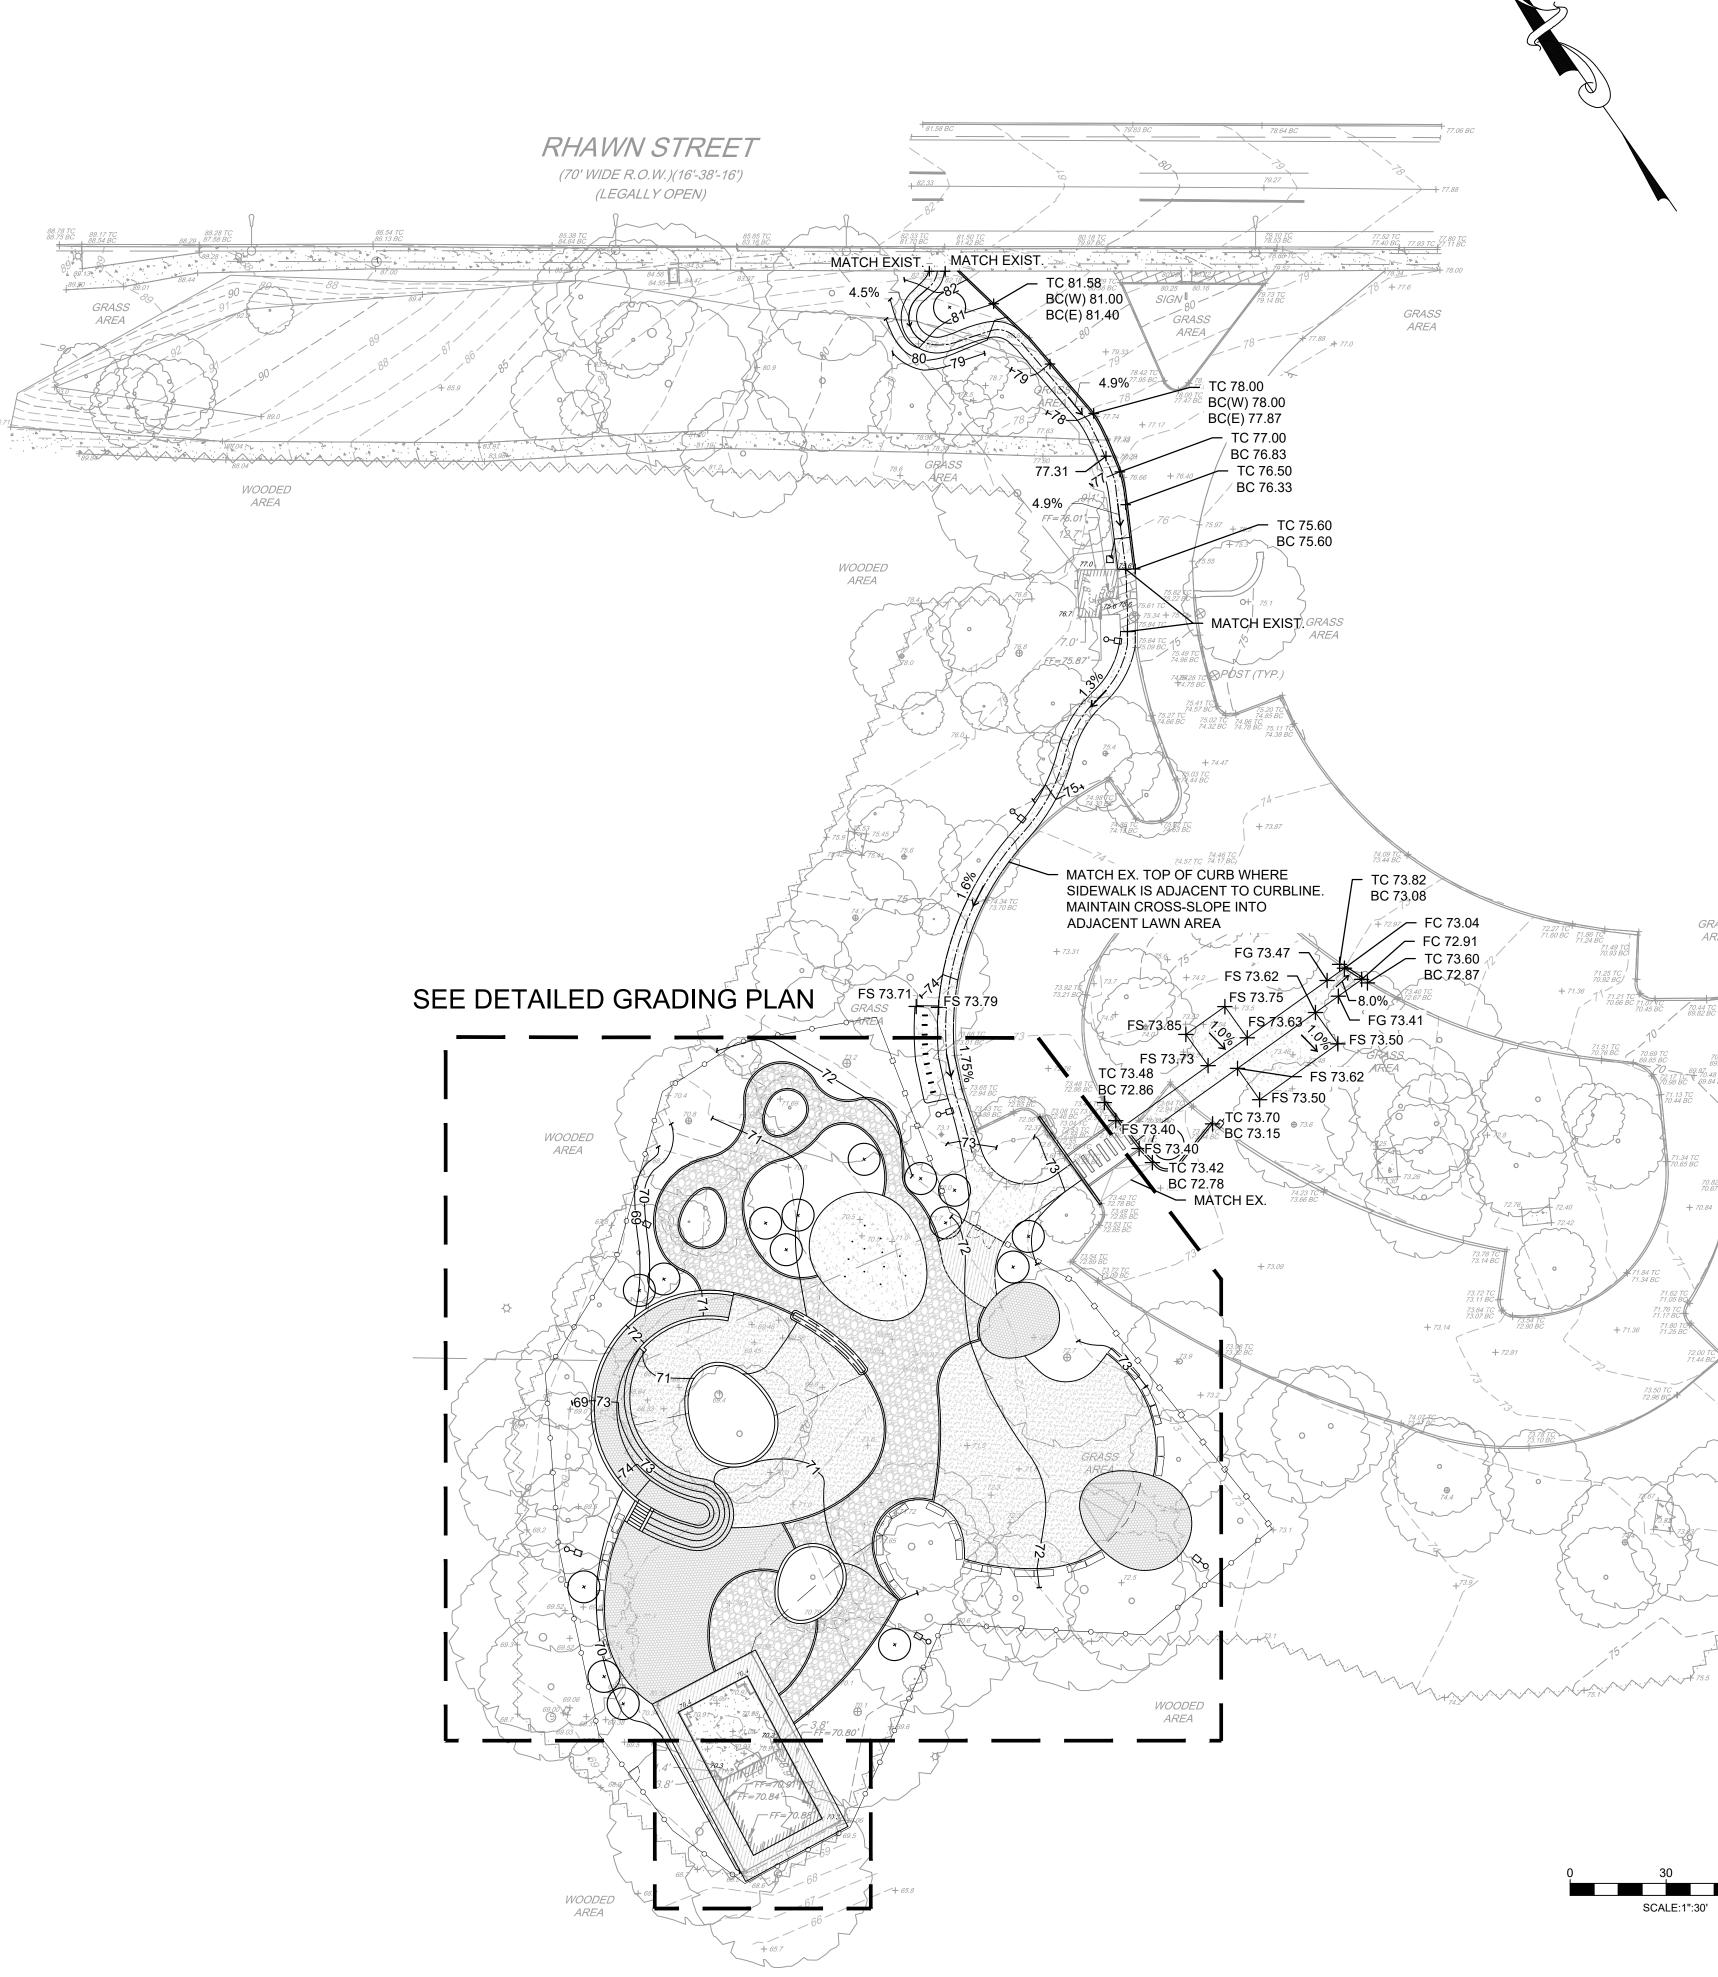



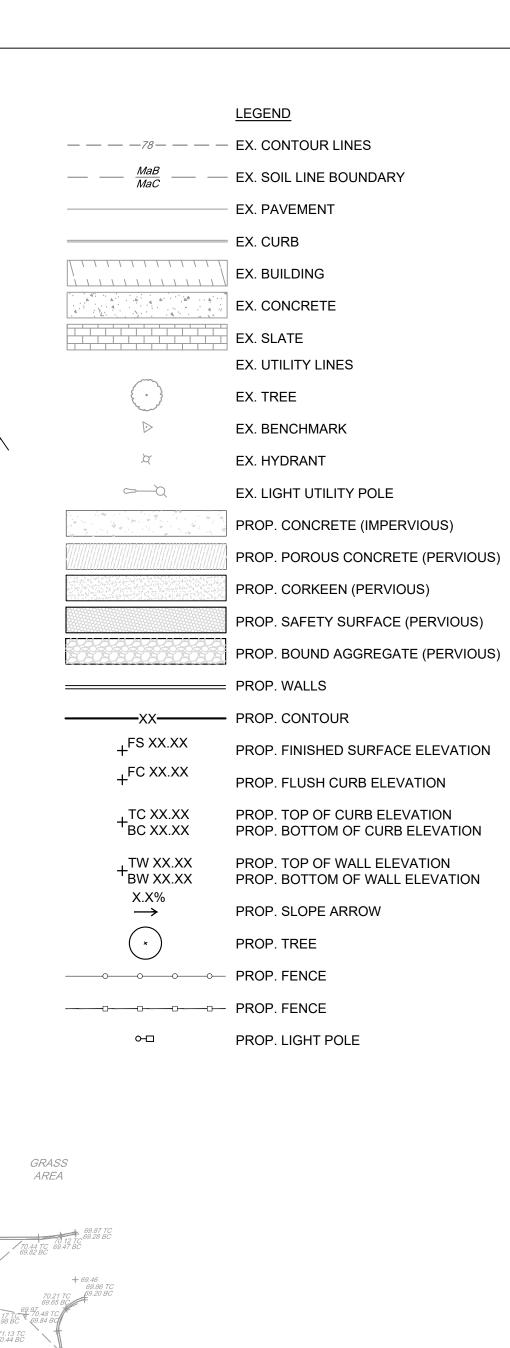

THE PROJECT SITE IS WITHIN PENNYPACK PARK SYSTEM AND DOES NOT HAVE IT'S OWN SITE ADDRESS. THEREFORE, THE PENNYPACK PARK SYSTEM'S ADDRESS AND OPA ACCOUNT NUMBER ARE ASSOCIATED WITH THIS PROJECT SITE. THE PROJECT SITE IS LOCATED JUST SOUTH OF THE INTERSECTION OF HOLMEHURST AVE AND RHAWN STREET. APPROXIMATE COORDINATES ARE 40°02'59" N, 75°02'09" W.

+ 70.8

Feet

SCALE:1":30'


+ 71.36 71.80 7 71.25 B

ADDRESS: 8300 FRANKFORD AVE PHILADELPHIA, PA 19136 <u>BRT/OPA:</u> 871402520 PHILADELPHIA WATER TRACKING NO .: FY22-PENN-6850-01

> PENNSYLVANIA ONE CALL SYSTEM, INC. SITE IDENTIFICATION NO .: 20220322281





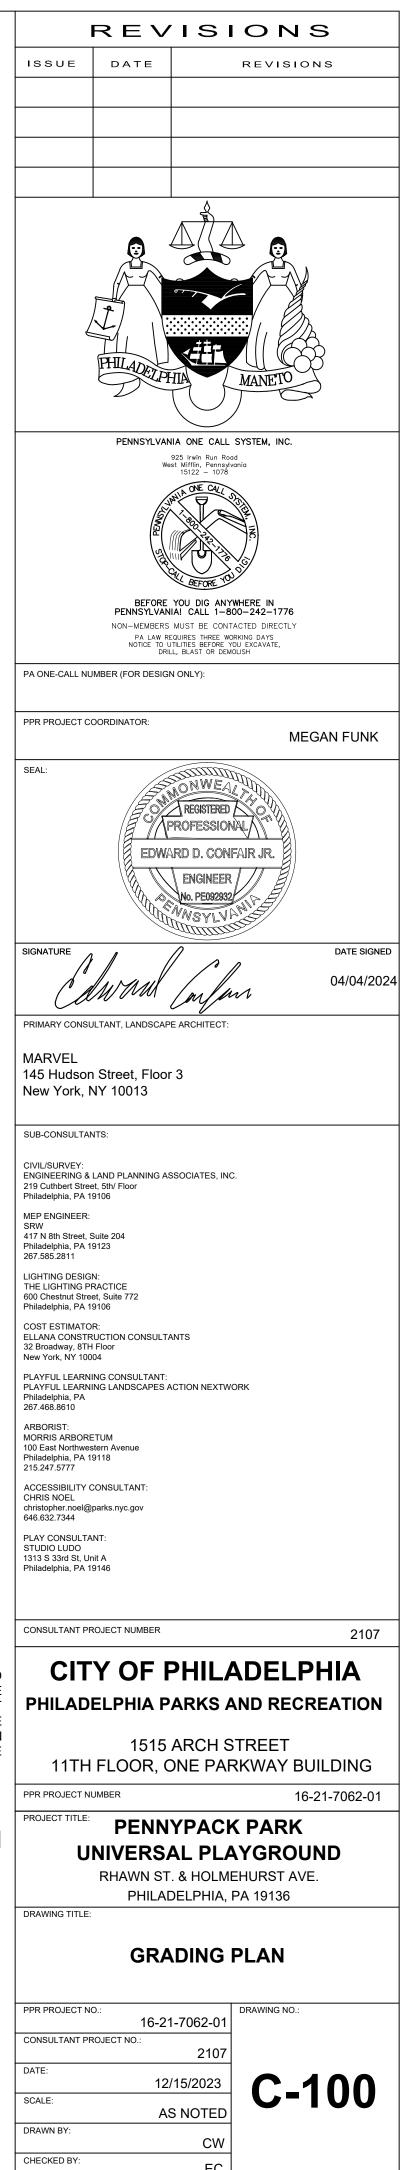



SCALE:1":10'

### DETAILED GRADING PLAN

MEGAN FUNK

DATE SIGNED

04/04/2024


2107

16-21-7062-01

PPR PROJECT NO.:	16-21-7062-01	DRAWING NO.:
CONSULTANT PROJECT NO.:	2107	
DATE:	12/15/2023	C 110
SCALE:	AS NOTED	C-110
DRAWN BY:	CW	
CHECKED BY:	EC	
NOTE:		

ALL DIMENSIONS AND CONDITIONS SHALL BE VERIFIED BY THE CONTRACTOR AT THE SITE BEFORE PROCEEDING WITH THE WORK.

#### Philadelphia Watersheds

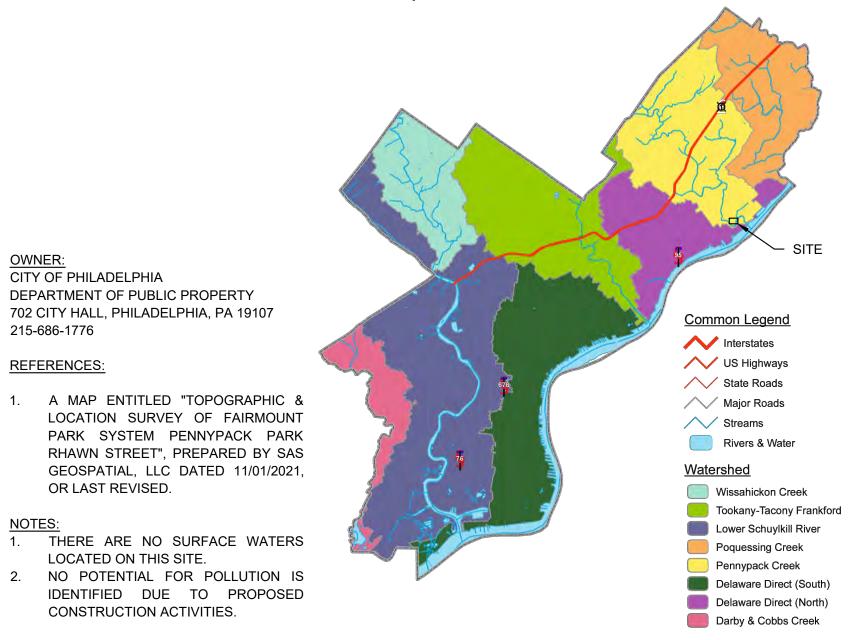

PCSM NOTES:

OWNER:

215-686-1776

REFERENCES:

CITY OF PHILADELPHIA

DEPARTMENT OF PUBLIC PROPERTY 702 CITY HALL, PHILADELPHIA, PA 19107

OR LAST REVISED.

LOCATED ON THIS SITE.


CONSTRUCTION ACTIVITIES.

- 1. THE LOCATION, TYPE, LINE, SIZE, DEPTH, ETC. OF ALL EXISTING UTILITIES, ARE APPROXIMATE. LOCATION OF SERVICE LATERALS MUST BE VERIFIED IN THE FIELD BY THE CONTRACTOR AND AT HIS OWN EXPENSE PRIOR TO THE START OF CONSTRUCTION AND IN ACCORDANCE WITH PA ACT 287 OF 1974 AS AMENDED BY PA ACT 181 OF 2008, 73 P.S. 176 ET, SEQ.
- 2. ALL AREAS ON SITE LOCATED OUTSIDE OF THE SHOWN LIMIT OF DISTURBANCE ARE TO BE PRESERVED AND PROTECTED. PRIOR TO CONSTRUCTION THE CONTRACTOR IS TO CLEARLY MARKOUT THE PROPOSED LIMITS OF DISTURBANCE AND CONFINE ALL CONSTRUCTION ACTIVITY TO THAT AREA.
- 3. THIS PCSM PLAN, INSPECTION REPORTS, AND MONITORING RECORDS SHALL BE AVAILABLE FOR REVIEW AND INSPECTION BY THE DEPARTMENT.
- 4. PROPOSED TREES ARE 2"-4" CALIPER FLOWERING DOGWOOD (CORNUS FLORIDA 'WHITE')

COVER CALCULATIONS				WATER QUALITY CALCULATIONS					
						AREA [SF]	AREA [AC.]		IMPERVIOUS COVER
	EXIS	TING	PROPOSED				,		PAVEMENT DISCONNE
	AREA [SF]	AREA [AC.]	AREA (SF)	AREA [AC.]	TOTAL PROP. IMPERVIOUS	22,858	0.525	╞	
					TOTAL PROP. DIC	22,858	0.525		EXISTING TREE CRE
IMPERVIOUS	2,464	0.057	22,858	0.525	TOTAL FROF. DIC	22,000	0.525		POROUS PAVEME
PERVIOUS	40,133	0.921	19,739	0.453	DCIA TO BE MANAGED	0	0	┝┝	
TOTAL	42,597	0.978	42,597	0.978					NEW TREE CRED
	,		,						TOTAL DIC



TREE CREDIT KEY PLAN

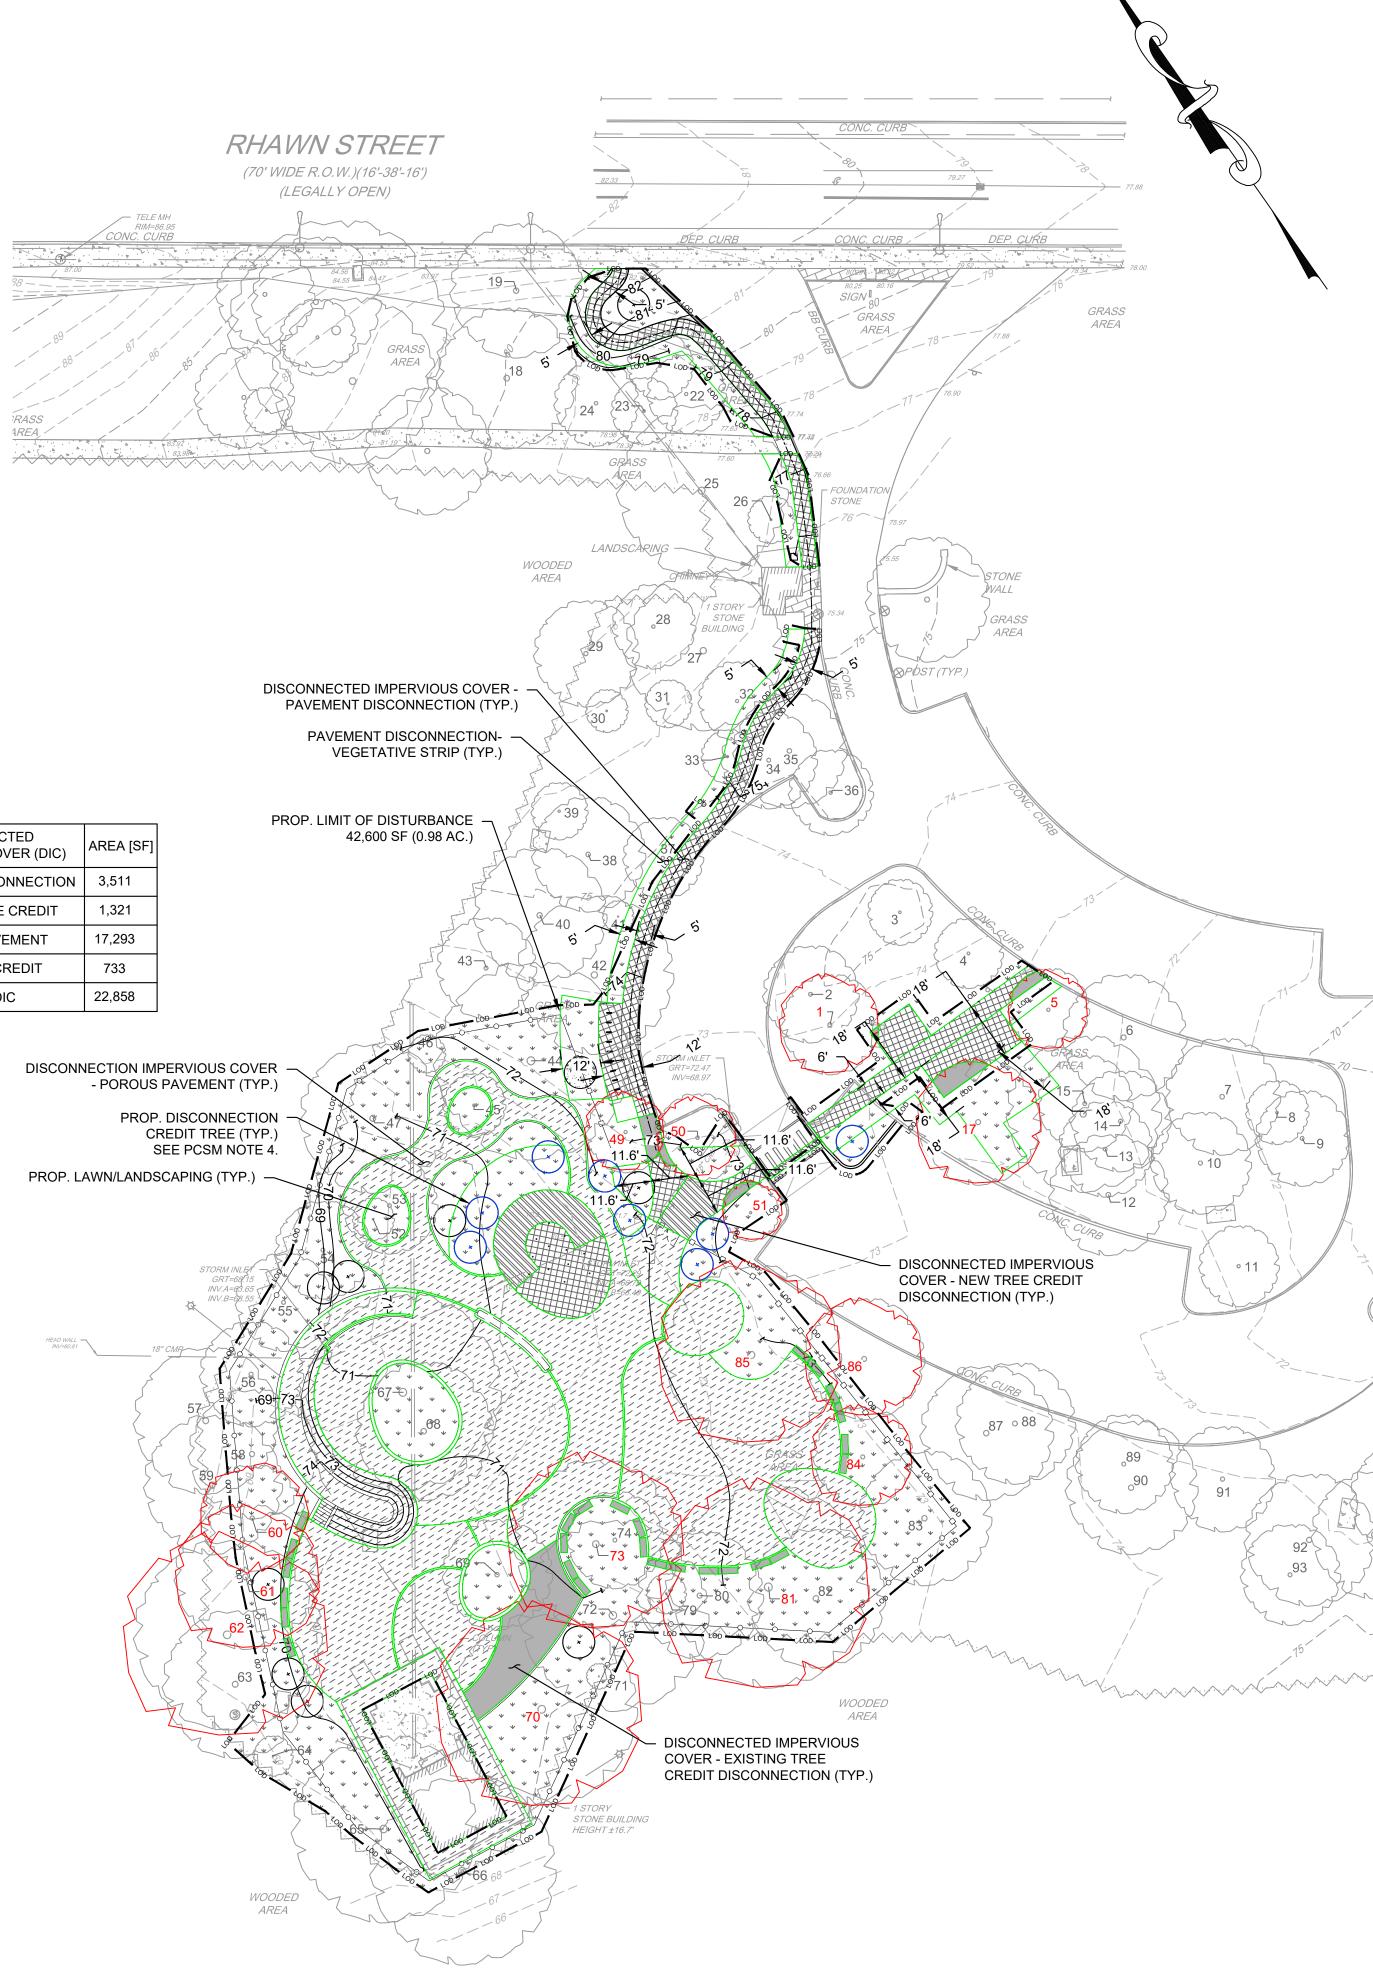

SCALE:1":30'

° 11

— — — —78— — — —	EX. CONTOUR LINES	ISSUE
<u>MaB</u> MaC	EX. SOIL LINE BOUNDARY	
	EX. PAVEMENT	
	EX. CURB	
	EX. BUILDING	
	EX. CONCRETE	
	EX. SLATE	
	EX. UTILITY LINES	
$\odot$	EX. TREE	/
$\triangleright$	EX. BENCHMARK	6
X	EX. HYDRANT	
	EX. LIGHT UTILITY POLE	
×	PROP. TREE	
	DISCONNECTED IMPERVIOUS COVER - PAVEMENT DISCONNECTION	
	DISCONNECTED IMPERVIOUS COVER - EXISTING TREE CREDIT DISCONNECTION	
	DISCONNECTION IMPERVIOUS COVER - POROUS PAVEMENT	
	DISCONNECTED IMPERVIOUS COVER - NEW TREE CREDIT DISCONNECTION	
$\begin{array}{cccccccccccccccccccccccccccccccccccc$	PAVEMENT DISCONNECTION- VEGETATIVE STRIP	PA ONE-CALL NU
* * * * * * * * * * * * * * *	PROP. LAWN/LANDSCAPING	PPR PROJECT CO

NUMBER CALIPER CLAIMED

6.7

16.2

5.7

5.7

7.6

3.2

1.9

20.4

12.7

13.1

62 29.0

70 24.8

73 18.8

86 29.1

1 27.5

TREE

5

17

49

50

51

60

61

81

84

85

GRASS

AREA

EX. TREE CREDIT

PROP. TREE CREDIT

EXISTING TREE CREDITS

SPECIES

Fraxinus spp.

Acer saccharum

Prunus serotina

Acer saccharum

Quercus phellos

Quercus bicolor

Acer rubrum

Acer rubrum

Liriodendron tulipifera

Liriodendron tulipifera

Liriodendron tulipifera

Liriodendron tulipifera

Liriodendron tulipifera

Quercus rubra

Acer rubrum

TREE CREDIT

Х

Х

<u>LEGEND</u>

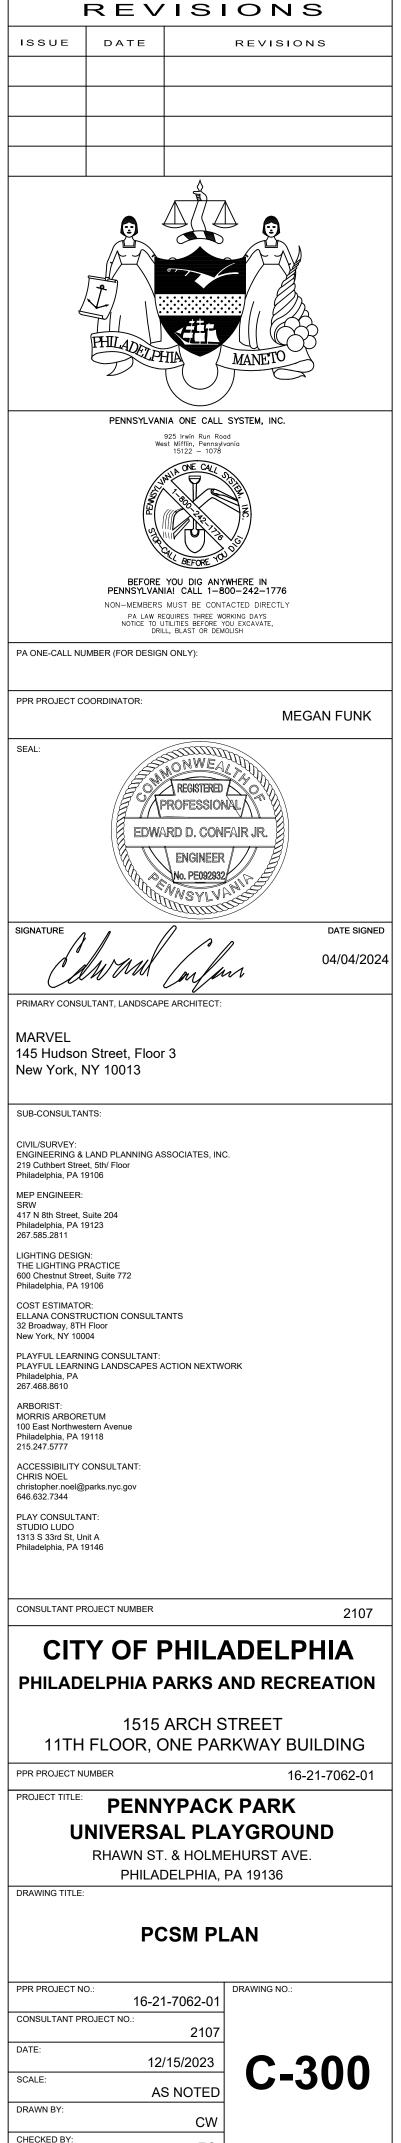


ALL DIMENSIONS AND CONDITIONS SHALL BE VERIFIED BY THE CONTRACTOR AT THE SITE BEFORE PROCEEDING WITH THE WORK

THÈ PROJECT SITE IS WITHIN PENNYPACK PARK SYSTEM AND DOES NOT HAVE IT'S OWN SITE ADDRESS. THEREFORE, THE PENNYPACK PARK SYSTEM'S ADDRESS AND OPA ACCOUNT  $^{\prime\prime}$ NUMBER ARE ASSOCIATED WITH THIS PROJECT SITE. THE PROJECT SITE IS LOCATED JUST SOUTH OF THE INTERSECTION OF HOLMEHURST AVE AND RHAWN STREET. APPROXIMATE COORDINATES ARE 40°02'59" N, 75°02'09" W. ADDRESS: 8300 FRANKFORD AVE PHILADELPHIA, PA 19136 BRT/OPA: 871402520

PHILADELPHIA WATER TRACKING NO .: FY22-PENN-6850-01 PENNSYLVANIA ONE CALL SYSTEM, INC. SITE IDENTIFICATION NO .:

20220322281

925 Irwin Run Road West Mifflin, Pennsylvania 15122 - 1078

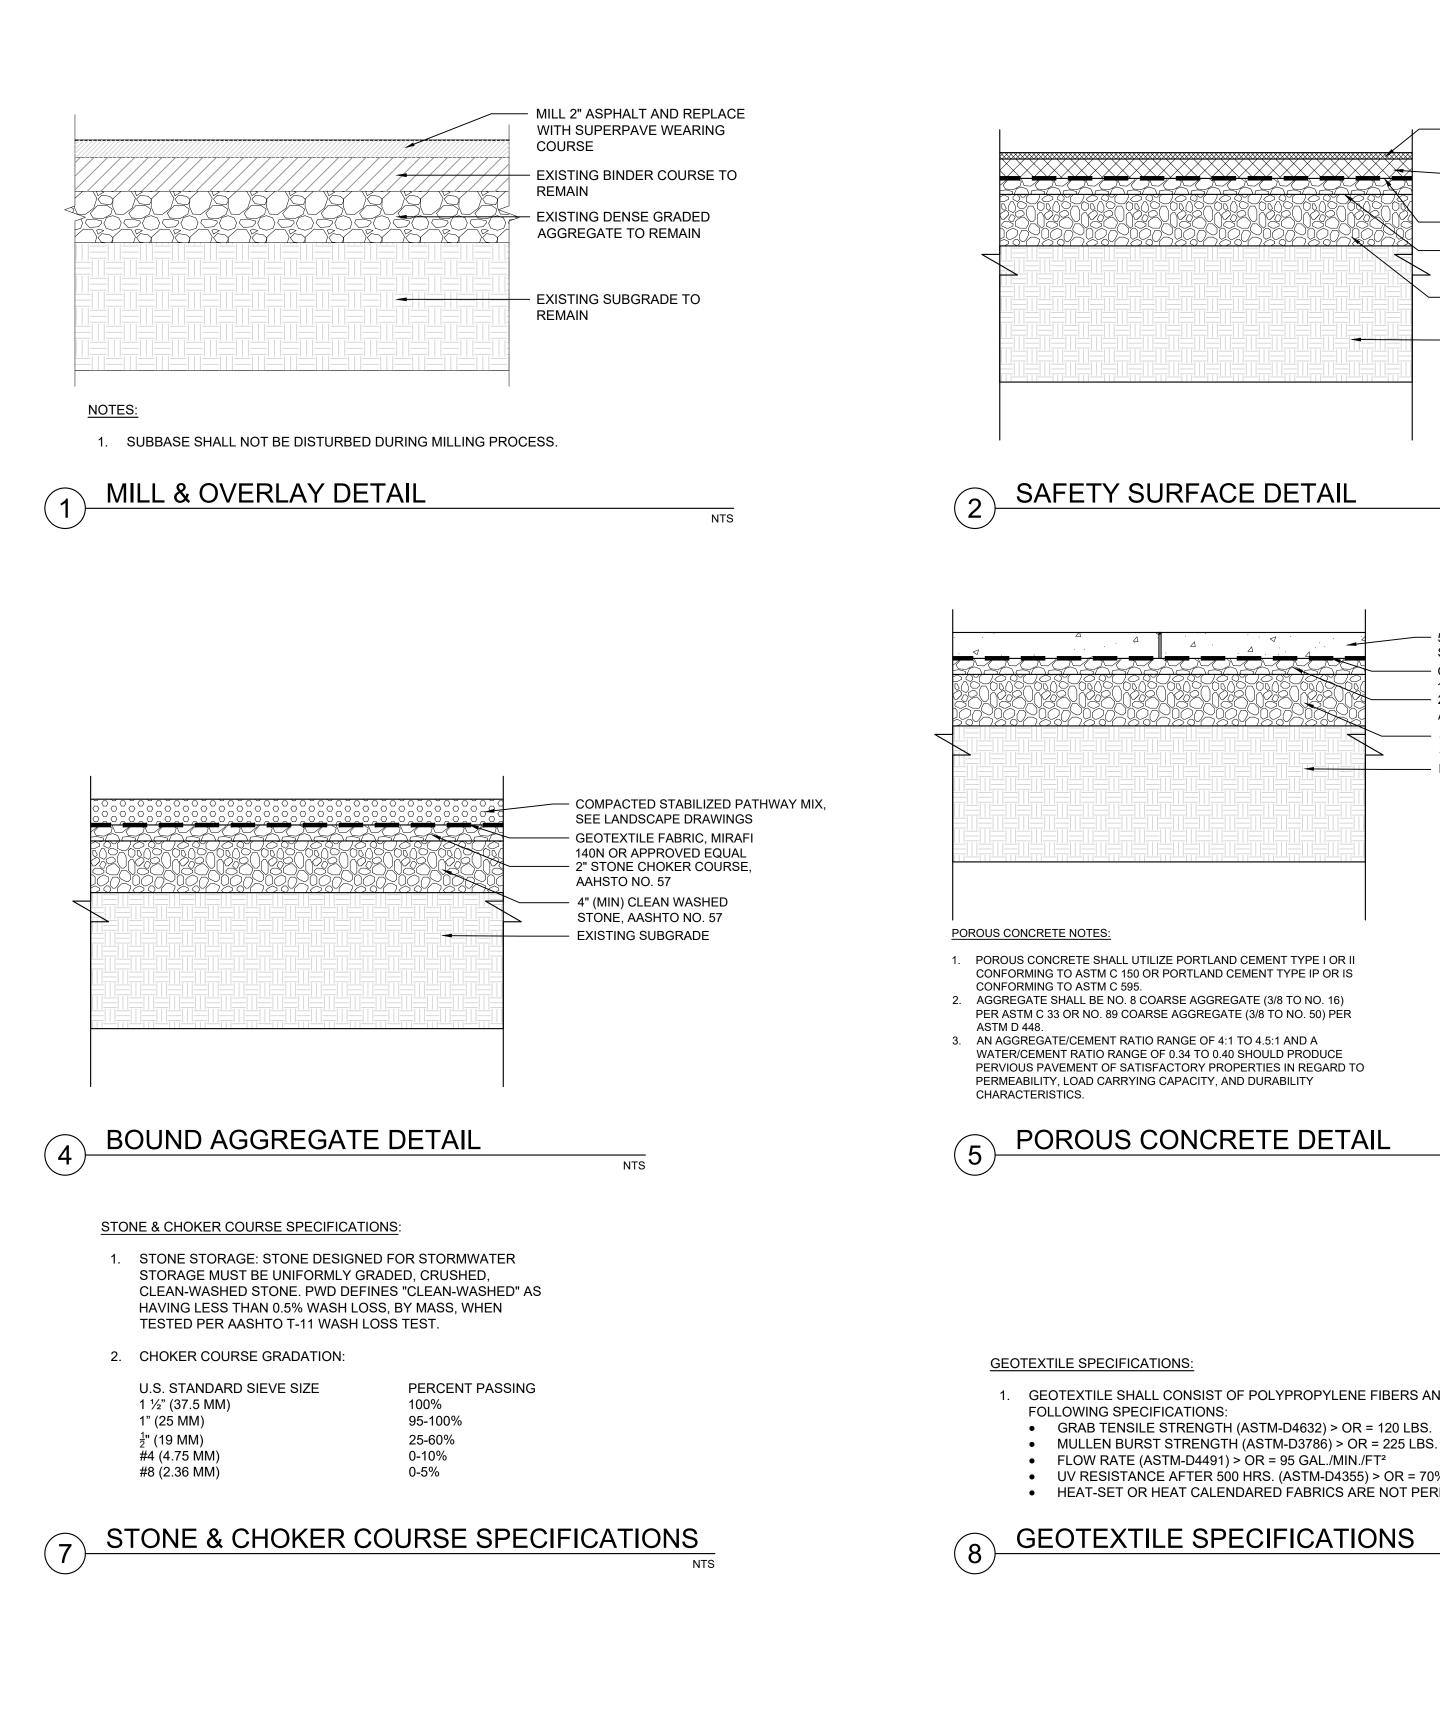

×
Ž
×
1

——— SAFETY SURFACE WEAR COURSE (THICKNESS VARIES), SEE LANDSCAPE DRAWINGS ------ SAFETY SURFACE BASE COURSE (THICKNESS VARIES), SEE LANDSCAPE DRAWINGS —— GEOTEXTILE FABRIC, MIRAFI 140N OR APPROVED EQUAL — 2" STONE CHOKER COURSE, AAHSTO NO. 57

—— 4" (MIN) CLEAN WASHED STONE, AASHTO NO. 57 — EXISTING SUBGRADE

NTS

SEE LANDSCAPE DRAWINGS

- GEOTEXTILE FABRIC, MIRAFI

140N OR APPROVED EQUAL

4" (MIN) CLEAN WASHED

STONE, AASHTO NO. 57 — EXISTING SUBGRADE

AAHSTO NO. 57

2" STONE CHOKER COURSE,

5" POROUS CONCRETE SLAB, 15-25% VOIDS,


NTS


1. GEOTEXTILE SHALL CONSIST OF POLYPROPYLENE FIBERS AND MEET THE

GRAB TENSILE STRENGTH (ASTM-D4632) > OR = 120 LBS.


 UV RESISTANCE AFTER 500 HRS. (ASTM-D4355) > OR = 70% HEAT-SET OR HEAT CALENDARED FABRICS ARE NOT PERMITTED


NTS

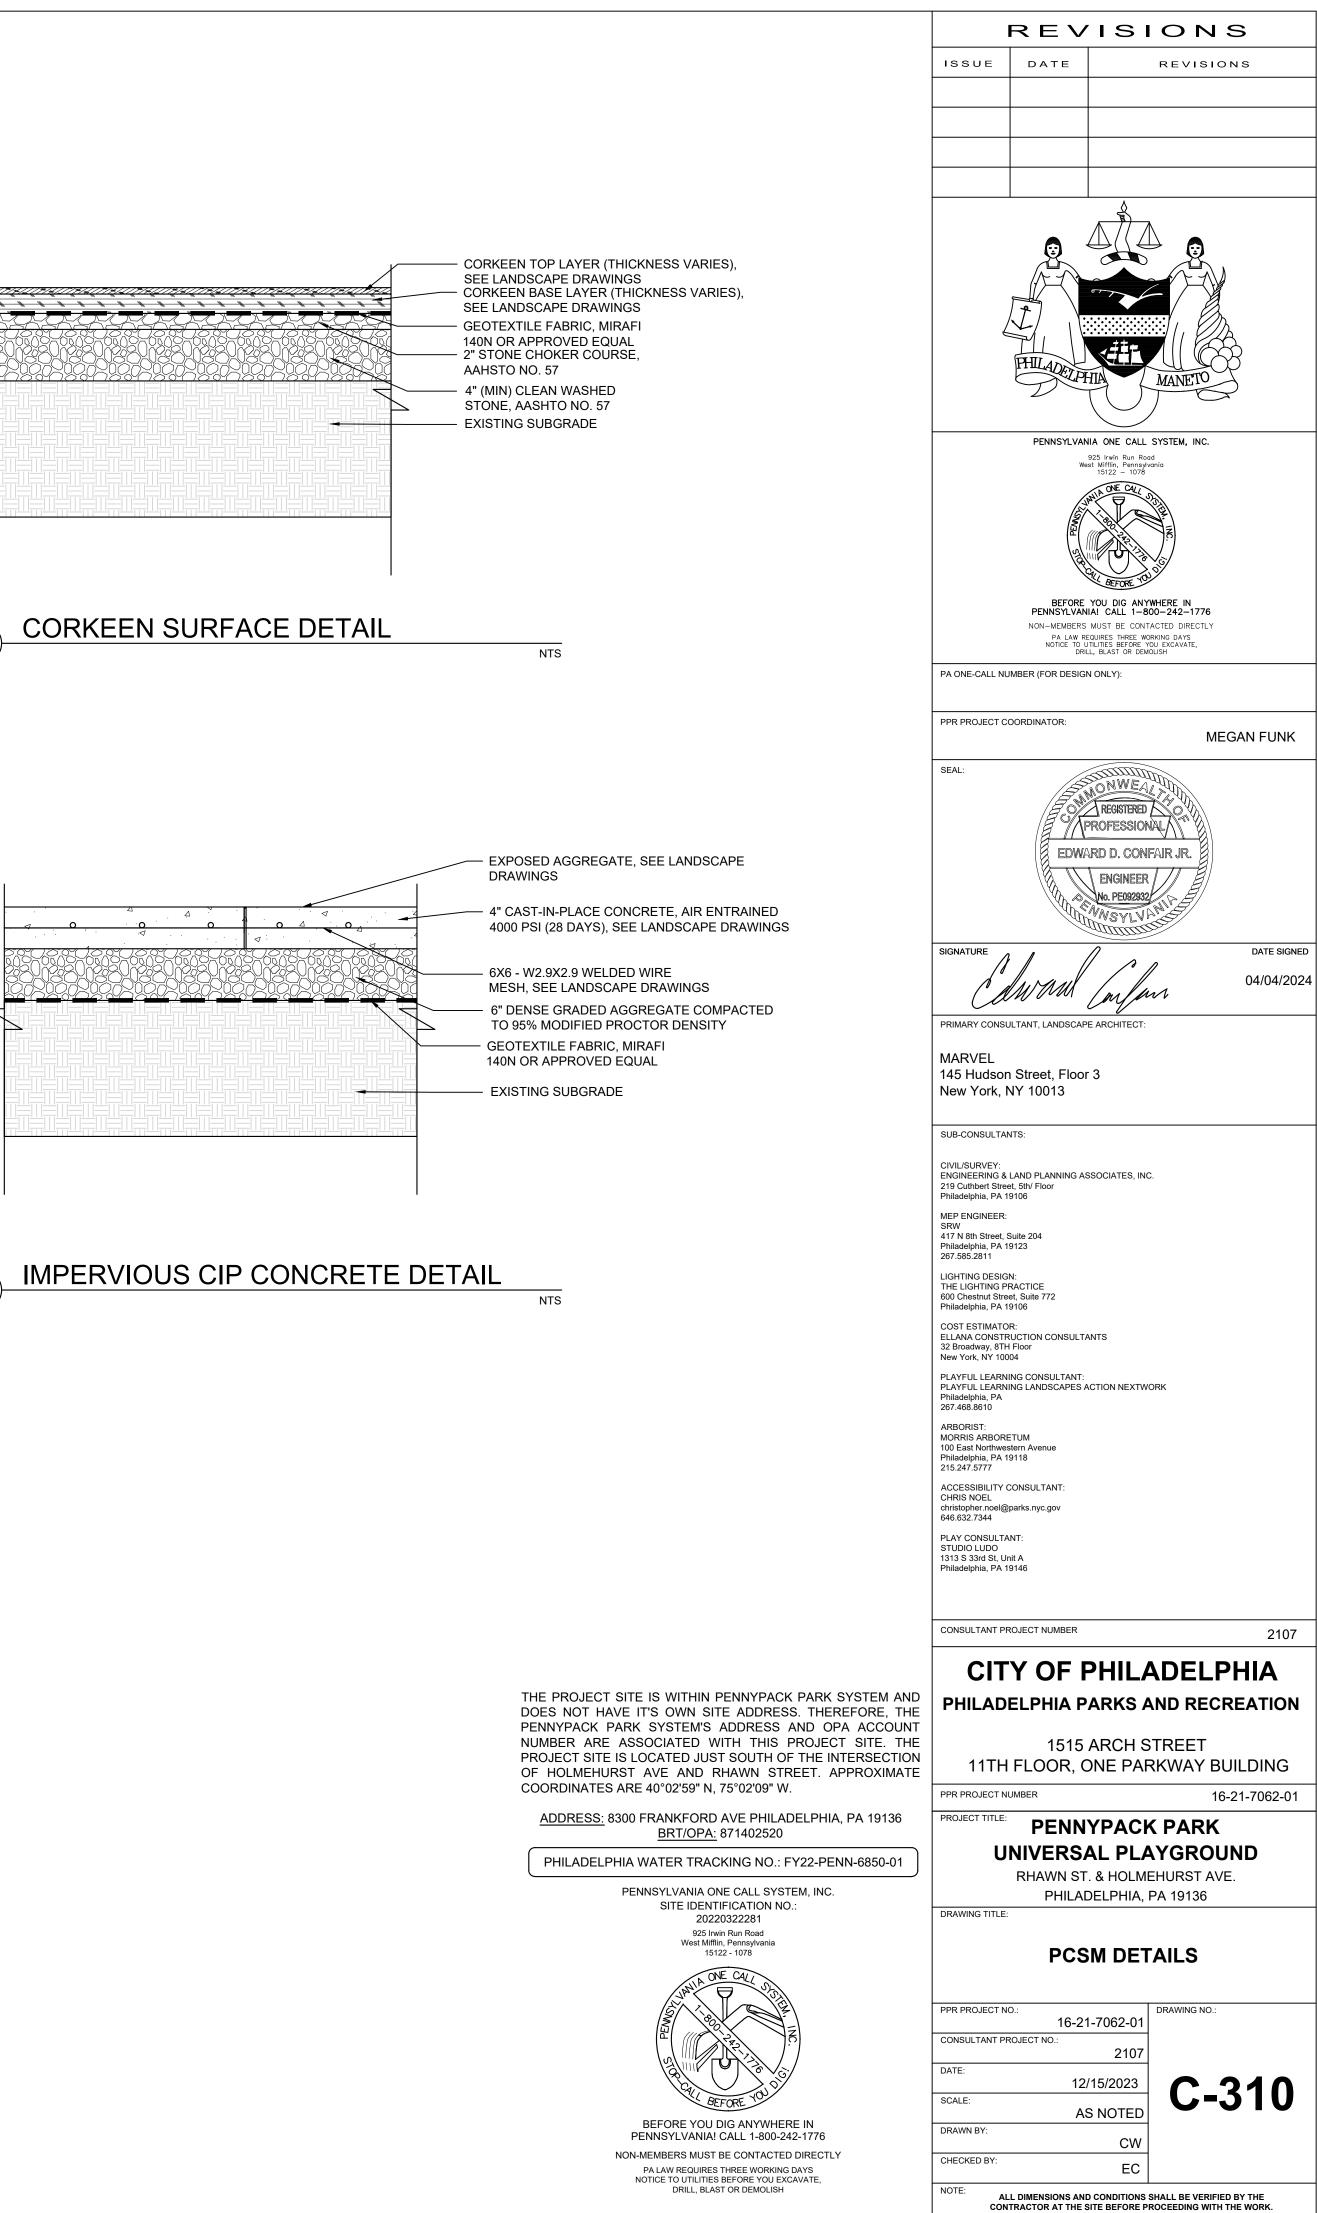

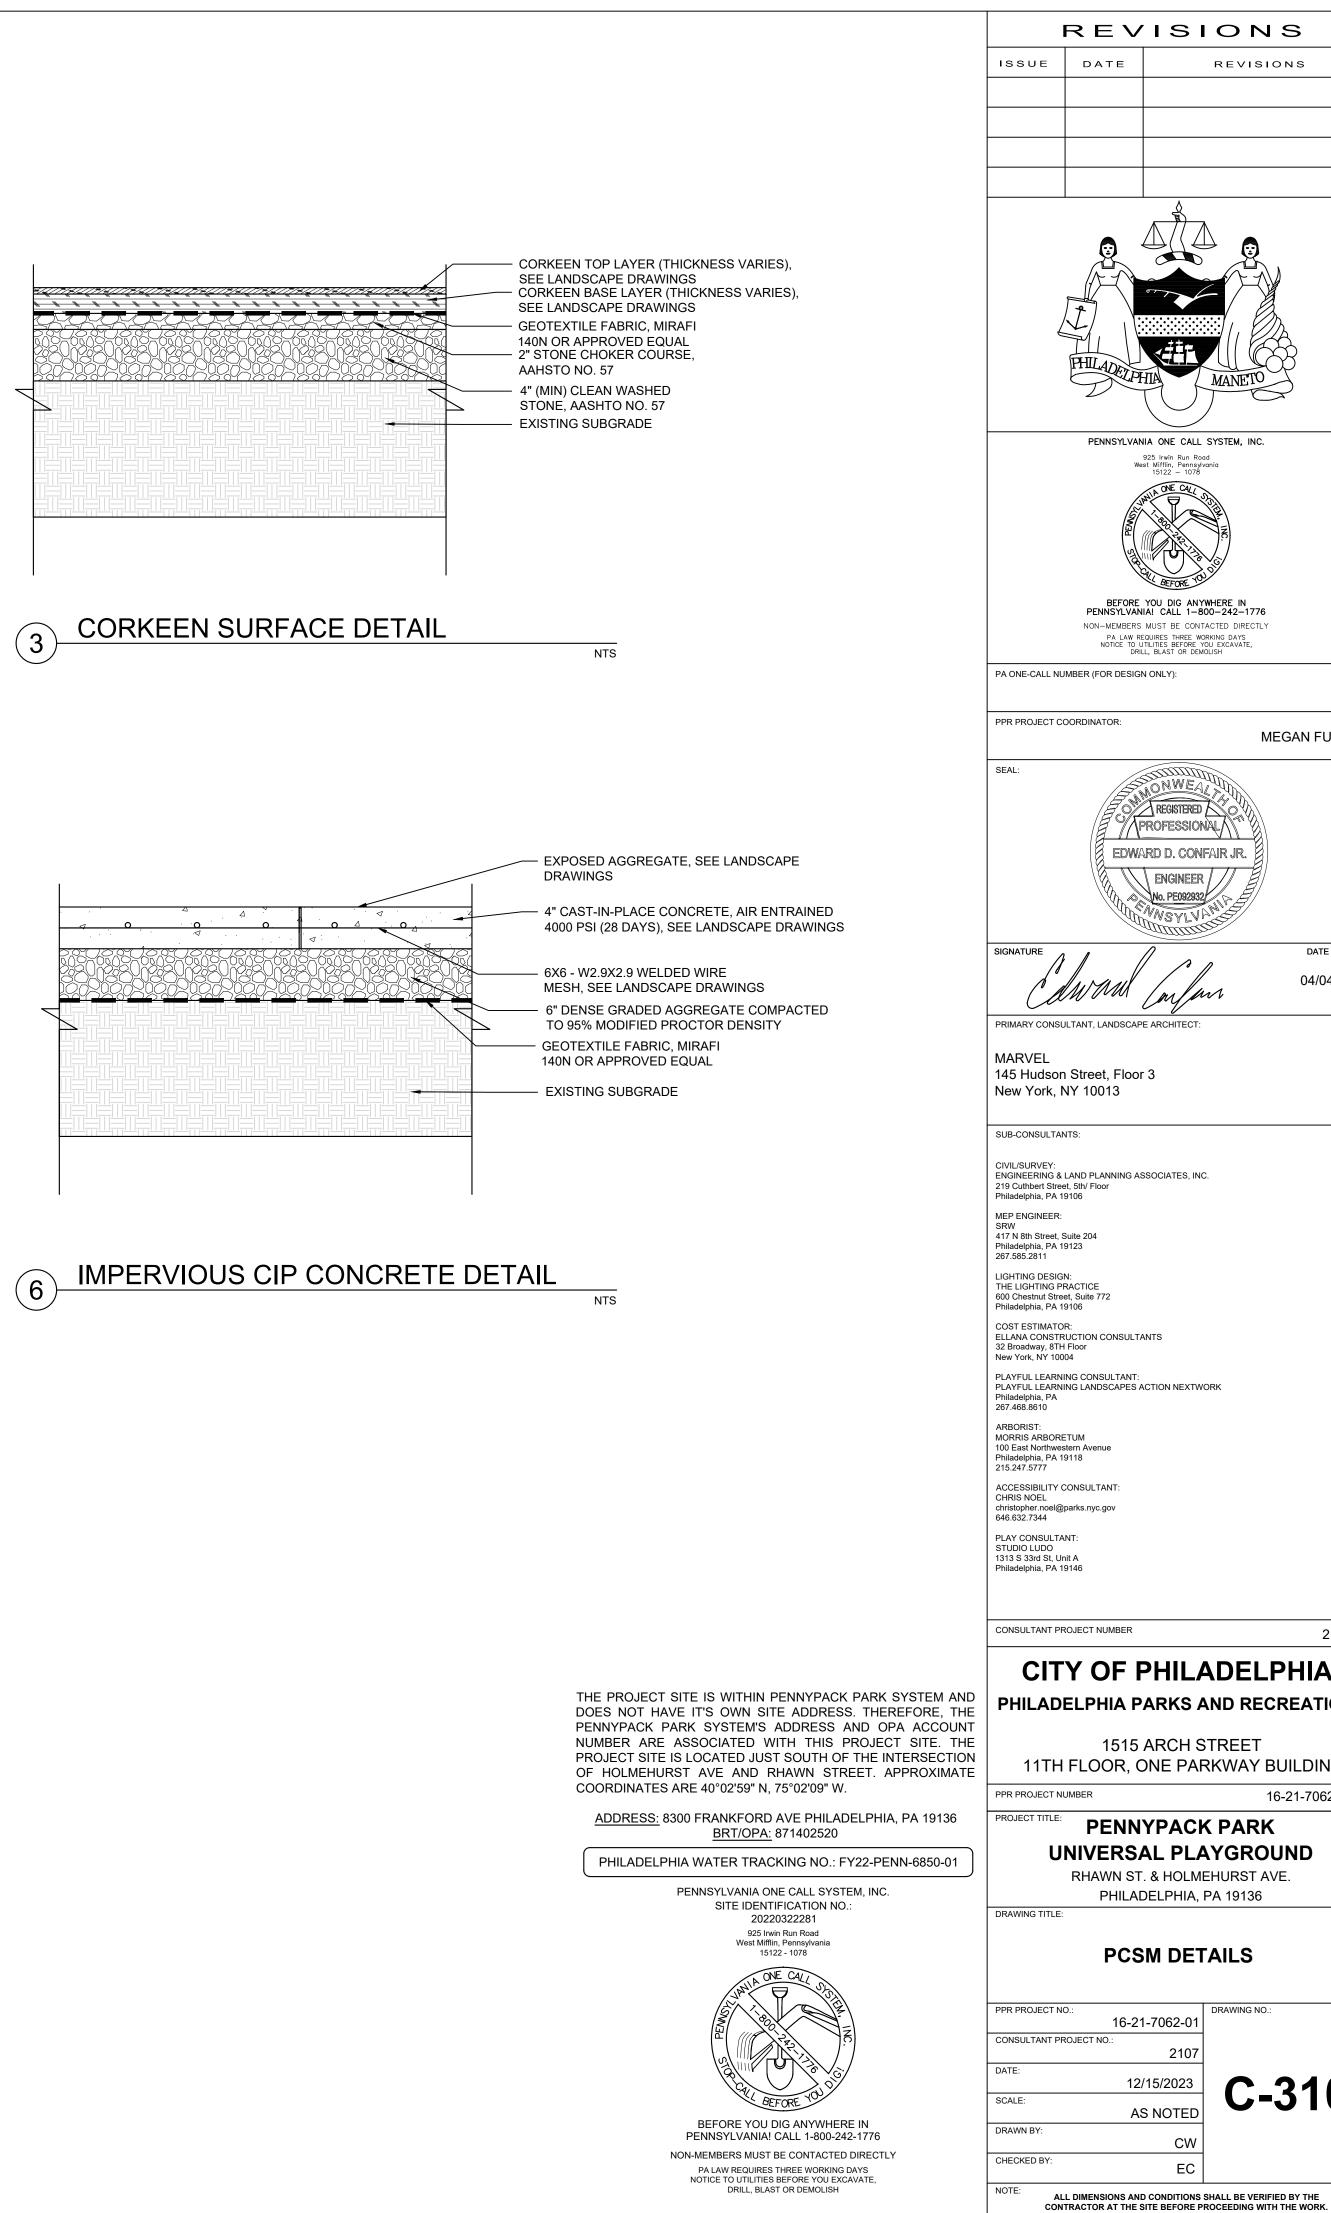

#### Philadelphia Watersheds

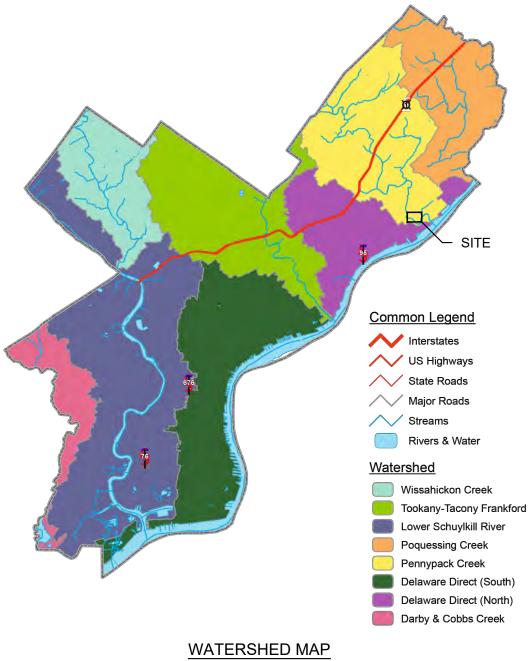

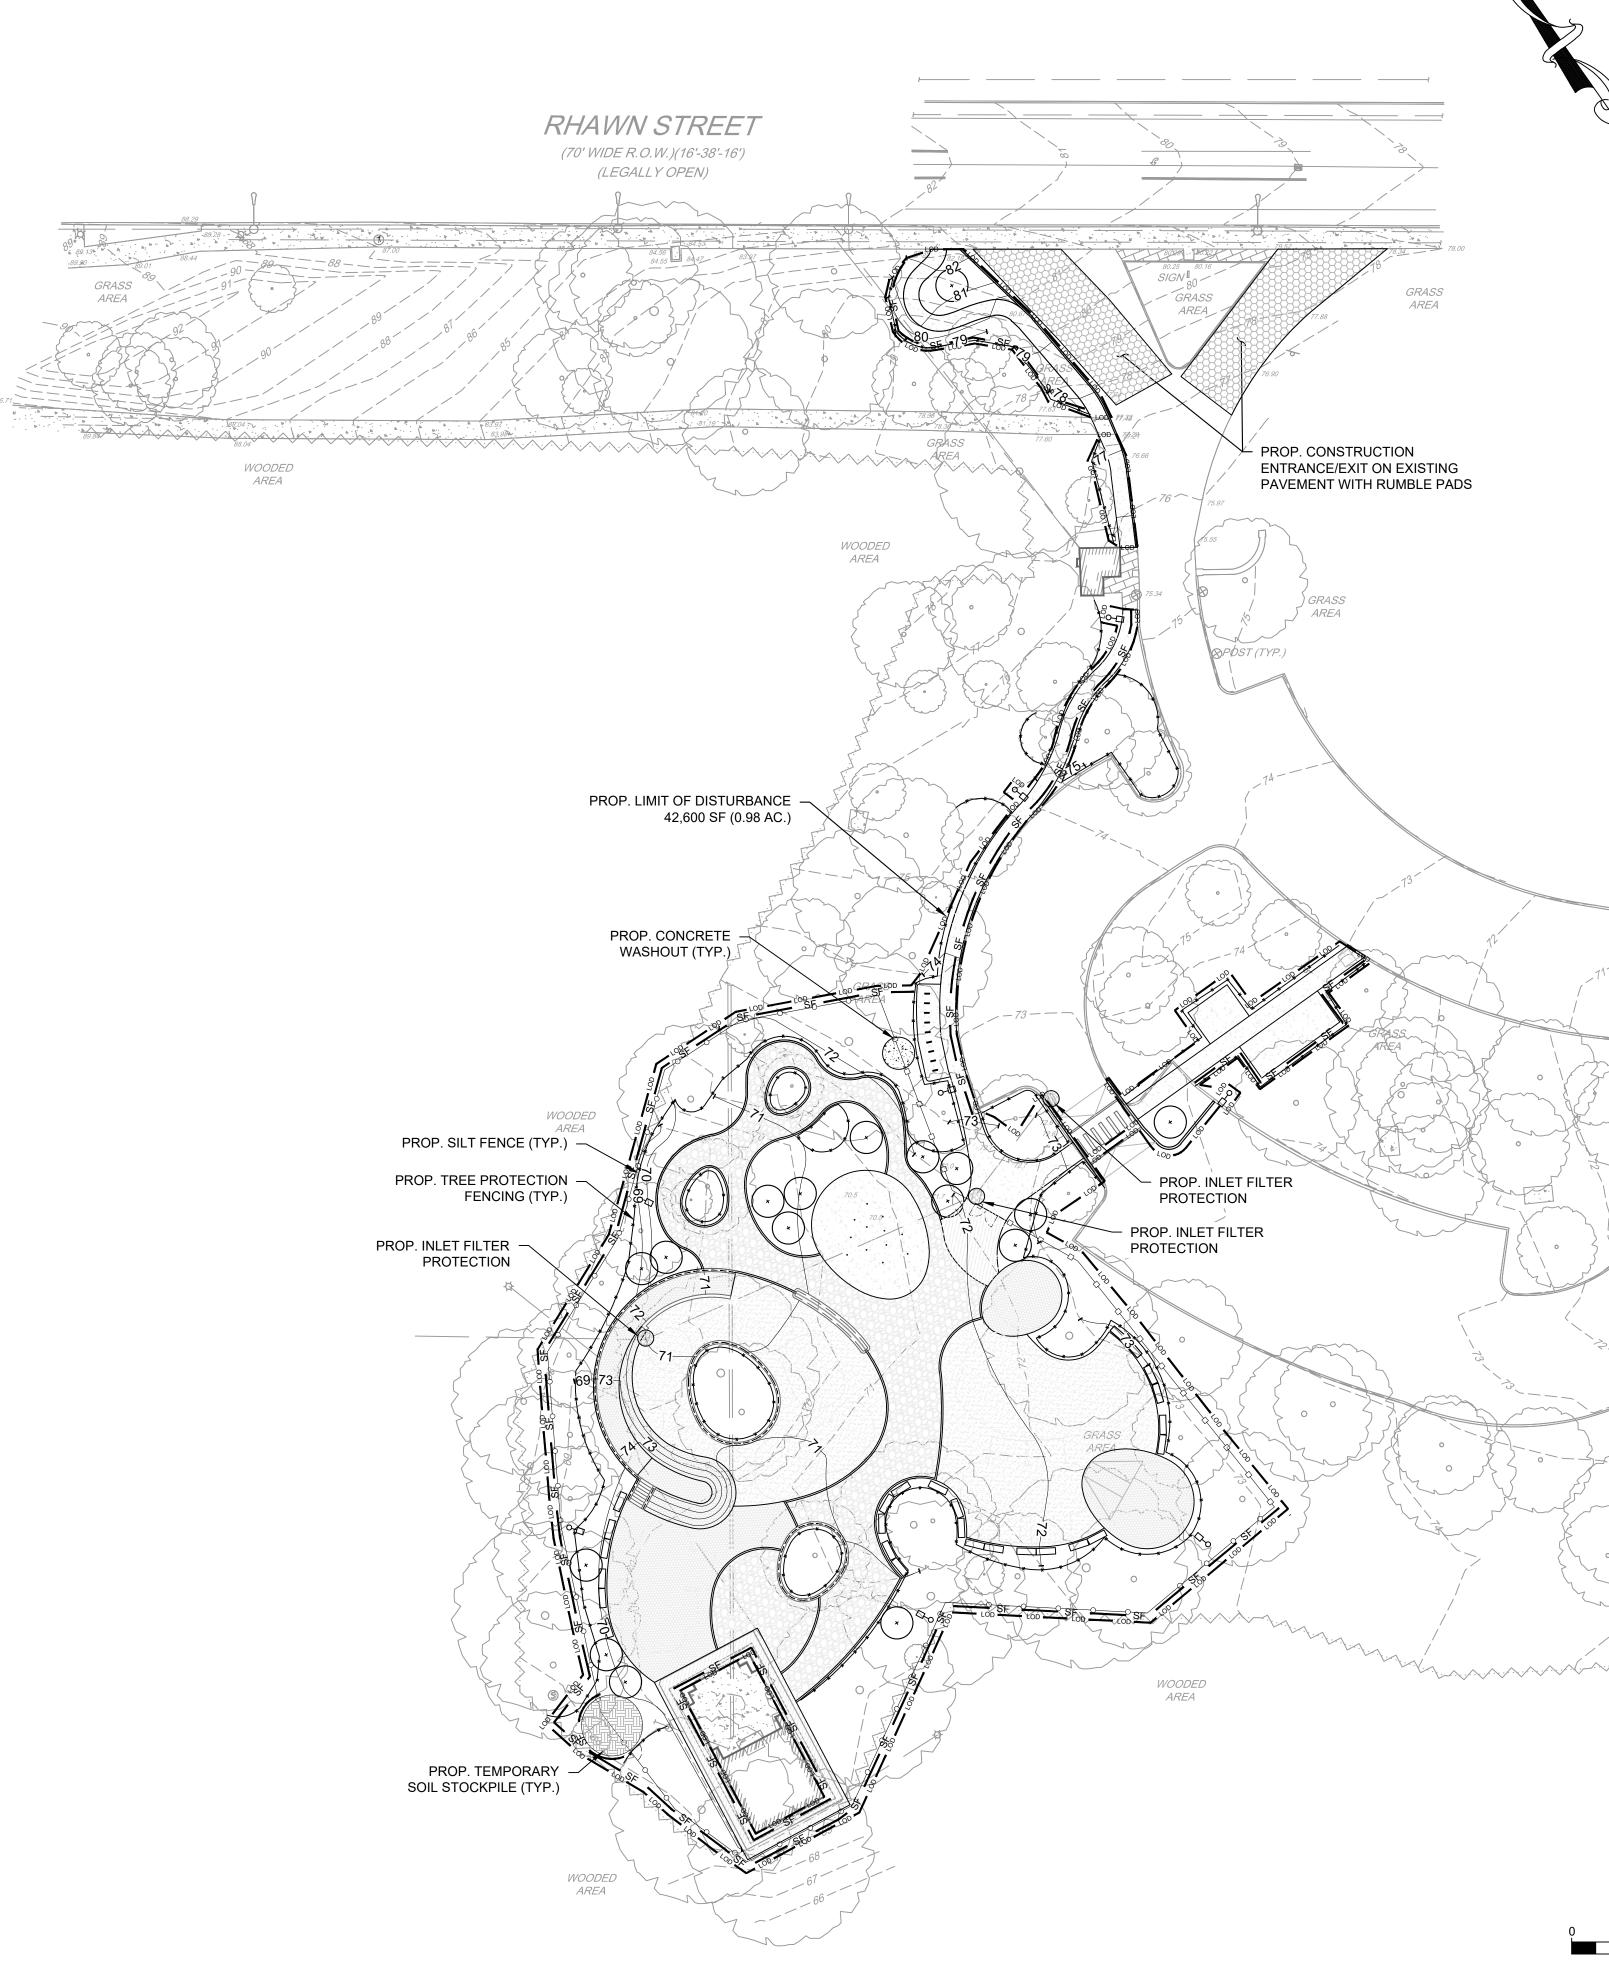

#### NOTES:

- 1. ROCK CONSTRUCTION ENTRANCE IS REQUIRED IF SEDIMENT IS TRACKED OFFSITE DURING CONSTRUCTION.
- DUST CONTROL REQUIREMENTS (AIR MANAGEMENT REGULATION (AMR) II. SECTION IX.)1.NOTIFY OCCUPANTS OF NEARBY PROPERTIES, IN WRITING, TEN (10) DAYS BEFORE<br/>ENGAGING IN EARTHWORKS (EXCAVATION, LAND CLEARING, OR OTHER ACTIVITY<br/>THAT WILL DISTURB MORE THAN 5,000 SQ FT LAND AREA), CONSTRUCTION, AND<br/>DEMOLITION ACTIVITIES. (AMR II. § IX.A.)
  - A. FOR EARTHWORKS, OR CONSTRUCTION / DEMOLITION INVOLVING STRUCTURE
     > 2 STORIES IN HEIGHT WRITTEN NOTIFICATION TO MUST BE DISTRIBUTED TO THE OCCUPANTS OF THE THREE (3) NEAREST PROPERTIES ON EITHER SIDE OF THE WORKSITE, THE SEVEN (7) NEAREST PROPERTIES ACROSS THE STREET FROM THE WORKSITE, AND THE SEVEN (7) NEAREST PROPERTIES TO THE REAR OF THE WORKSITE.

2. CONSTRUCTION AND DEMOLITION WORK PRACTICES TO REDUCE / MINIMIZE DUST (AMR II. § IX.C.)

- A. FUGITIVE DUST FORM CONSTRUCTION, DEMOLITION, AND EARTHWORKS ACTIVITIES MAY NOT BE VISIBLE AT THE POINT IT PASSES THE WORKSITE PROPERTY LINE.
- B. USE OF VACUUM OR SIMILAR SUCTION SYSTEMS TO CAPTURE DUST KICKED UP BY POWER TOOLS WHEN GRINDING / CUTTING.
- C. APPLICATION OF WATER OR APPROVED DUST SUPPRESSANT TO A WORKSITE WITH ONGOING EXCAVATION, LAND CLEARING, DEMOLITION, OR OTHER EARTH DISTURBANCE RELATED ACTIVITIES TO SUPPRESS DUST FORMATION.
- D. GENERAL PROHIBITION AGAINST DRY ABRASIVE BLASTING OF EXTERIOR SURFACES OPEN TO THE OUTSIDE AIR WHEN TEMPERATURE IS ABOVE FREEZING.
- E. COVERING AND WETTING OF STOCKPILED EARTH, SAND, GRAVEL, AND OTHER SIMILAR CONSTRUCTION MATERIALS.
- F. USE OF A MATERIAL CHUTE WHEN DROPPING MATERIAL OR DEBRIS MORE THAN 20 FT OUTSIDE OF THE EXTERIOR WALLS OF A BUILDING OR STRUCTURE. MATERIALS MUST BE WETTED WHEN DROPPED, AND / OR EXIT OF CHUTE MUST BE SEALED AGAINST THE TOP OF THE RECEIVING CONTAINER / DUMPSTER.
- G. ALL TEMPORARY PERIMETER FENCING AROUND MUST HAVE DUST CONTROL FABRIC; MUST MEASURE A MINIMUM OF 5 FT IN HEIGHT FROM THE BOTTOM OF THE FENCING.
- H. A 10 MILES PER HOUR SPEED LIMIT FOR ALL EQUIPMENT AND TRUCKS TRAVELING WITHIN THE WORKSITE.
- I. WETTING AND SWEEPING OF ROADWAYS / ACCESS ROADS IN A WORKSITE TO PREVENT DUST FORMATION.
- J. VEHICLE ACCESS POINTS MUST BE EQUIPPED WITH DUST SUPPRESSION MEASURES (I.E. WHEEL WASH SYSTEMS, RUMBLE GRATES, AND/OR GRAVEL PADS)

			REVISIC	
		LEGEND	ISSUE DATE RE	VISIONS
		EX. CONTOUR LINES		
	<u>MaB</u> MaC	- EX. SOIL LINE BOUNDARY		
		EX. PAVEMENT EX. CURB		
		EX. BUILDING		•
$\mathcal{D}$		EX. SLATE		
		EX. UTILITY LINES		, Øz
	$\bigcirc$	EX. TREE	HILAD HIL	
		EX. BENCHMARK	HILADELPHIA MAN	VETO T
$\setminus$	Þ	EX. HYDRANT		
	~~~~Q	EX. LIGHT UTILITY POLE	PENNSYLVANIA ONE CALL SYSTEM 925 Irwin Run Road West Mifflin, Pennsylvania	и, INC.
		PROP. CONCRETE (IMPERVIOUS)	15122 - 1076	
		PROP. POROUS CONCRETE (PERVIOUS)		
		PROP. CORKEEN (PERVIOUS)		
		PROP. SAFETY SURFACE (PERVIOUS)	BEFORE YOU DIG ANYWHERE	IN
		PROP. BOUND AGGREGATE (PERVIOUS)	BEFORE YOU DIG ANYWHERE PENNSYLVANIA! CALL 1-800-242 NON-MEMBERS MUST BE CONTACTED D	2–1776 DIRECTLY
		PROP. WALLS	PA LAW REQUIRES THREE WORKING DA NOTICE TO UTILITIES BEFORE YOU EXCAN DRILL, BLAST OR DEMOLISH	V-S VATE,
	×	PROP. TREE	PA ONE-CALL NUMBER (FOR DESIGN ONLY):	
		PROP. LIMIT OF DISTURBANCE	PPR PROJECT COORDINATOR:	
		PROP. SILT FENCE	SEAL	MEGAN FUNK
		PROP. TEMPORARY SOIL STOCKPILE	SEAL:	D
		PROP. CONCRETE WASHOUT	PROFESSIONAL	
			EDWARD D. CONFAIR J	R.
		PROP. CONSTRUCTION ENTRANCE	ENGINEER No. PE092932	
	*********	* PROP. TREE PROTECTION	ALL CANSYLVAND	
			SIGNATURE	DATE SIGNE
			ANTAN MAN	04/04/202
			PRIMARY CONSULTANT, LANDSCAPE ARCHITECT:	
			MARVEL	
GRASS			145 Hudson Street, Floor 3	
AREA			New York, NY 10013	
			SUB-CONSULTANTS:	
	-		CIVIL/SURVEY: ENGINEERING & LAND PLANNING ASSOCIATES, INC. 219 Cuthbert Street, 5th/ Floor	
			Philadelphia, PA 19106 MEP ENGINEER:	
70			SRW 417 N 8th Street, Suite 204 Philadelphia, PA 19123 267.585.2811	
			LIGHTING DESIGN: THE LIGHTING PRACTICE	
			600 Chestnut Street, Suite 772 Philadelphia, PA 19106	
			COST ESTIMATOR: ELLANA CONSTRUCTION CONSULTANTS 32 Broadway, 8TH Floor	
			New York, NY 10004 PLAYFUL LEARNING CONSULTANT: PLAYFUL LEARNING LANDSCAPES ACTION NEXTWORK	
			Philadelphia, PA 267.468.8610	
			ARBORIST: MORRIS ARBORETUM 100 East Northwestern Avenue	
			Philadelphia, PA 19118 215.247.5777	
			ACCESSIBILITY CONSULTANT: CHRIS NOEL christopher.noel@parks.nyc.gov 646 632 7344	
2			646.632.7344 PLAY CONSULTANT: STUDIO LUDO	
			1313 S 33rd St, Unit A Philadelphia, PA 19146	
	Line I and the second s			
mit	N. A.		CONSULTANT PROJECT NUMBER	2107
		SITE IS WITHIN PENNYPACK PARK SYSTEM AND	CITY OF PHILAD	ELPHIA
	DOES NOT HA	VE IT'S OWN SITE ADDRESS. THEREFORE, THE PARK SYSTEM'S ADDRESS AND OPA ACCOUNT	PHILADELPHIA PARKS AND	
	NUMBER ARE PROJECT SITE	ASSOCIATED WITH THIS PROJECT SITE. THE IS LOCATED JUST SOUTH OF THE INTERSECTION		=FT
ngth F) OF HOLMEHU	RST AVE AND RHAWN STREET. APPROXIMATE ARE 40°02'59" N, 75°02'09" W.		
	ADDRESS: 8	300 FRANKFORD AVE PHILADELPHIA, PA 19136	PPR PROJECT NUMBER	16-21-7062-01
15°		BRT/OPA: 871402520 HIA WATER TRACKING NO.: FY22-PENN-6850-01	PROJECT TITLE: PENNYPACK PA	
)		
		PENNSYLVANIA ONE CALL SYSTEM, INC. SITE IDENTIFICATION NO.: 20220322281	RHAWN ST. & HOLMEHUF PHILADELPHIA, PA 19	
		925 Irwin Run Road West Mifflin, Pennsylvania	DRAWING TITLE:	
		West Mittlin, Pennsylvania 15122 - 1078	E&SC PLAN	
		MAN A SEE		
			16-21-7062-01	VING NO.:
			CONSULTANT PROJECT NO.: 2107 DATE:	
		BEFORE YOU		C-400
30	60 ──│ Feet	BEFORE YOU DIG ANYWHERE IN	SCALE: AS NOTED	
SCALE:1":30'		PENNSYLVANIA! CALL 1-800-242-1776 ON-MEMBERS MUST BE CONTACTED DIRECTLY	CHECKED BY:	
		PA LAW REQUIRES THREE WORKING DAYS NOTICE TO UTILITIES BEFORE YOU EXCAVATE, DRILL, BLAST OR DEMOLISH	EC	
			ALL DIMENSIONS AND CONDITIONS SHALL E CONTRACTOR AT THE SITE BEFORE PROCEED	

STANDARD PHILADELPHIA WATER DEPARTMENT E&S PLAN NOTES:

- AN INDUSTRIAL WASTE PERMIT WILL BE REQUIRED SHOULD 25. FILL SHALL NOT BE PLACED ON SATURATED OR FROZEN PUMPING TO CITY-OWNED INFRASTRUCTURE BECOME WATER FROM ANY WORK AREA SHALL BE DONE ACCORDING TO THE PROCEDURE DESCRIBED IN THIS PLAN, OVER UNDISTURBED VEGETATED AREAS.
- OWNED BY PWD THAT ARE LOCATED WITHIN ONE BLOCK OF THE PROJECT SITE.
- 3. PWD IS NOT RESPONSIBLE FOR ANY CLEANING OR REPAIRS NEEDED ON CITY-OWNED INFRASTRUCTURE DUE TO FAILURE OF ANY EROSION AND SEDIMENT CONTROL PRACTICES. THE OWNER SHALL BE RESPONSIBLE FOR THESE MEASURES:
 - CITY OF PHILADELPHIA DEPARTMENT OF PUBLIC PROPERTY

702 CITY HALL, PHILADELPHIA, PA 19107 215-686-1776

- INSPECTION AND MAINTENANCE OF ALL EROSION AND SEDIMENT CONTROL BEST MANAGEMENT PRACTICES SHALL OCCUR ON A WEEKLY BASIS, BEFORE ANY ANTICIPATED PRECIPITATION EVENTS, AND AFTER ALL PRECIPITATION EVENTS.
- THE MAXIMUM HEIGHT FOR STOCKPILES AREAS SHALL BE 20 5. FEET. THE MAXIMUM SIDE SLOPE FOR STOCKPILE AREAS SHALL NOT EXCEED 2:1
- THE ROCK CONSTRUCTION ENTRANCE THICKNESS SHALL BE MAINTAINED ON-SITE FOR THIS PURPOSE. AT THE END OF EACH CONSTRUCTION DAY, ALL SEDIMENT DEPOSITED ON PAVED ROADWAYS SHALL BE REMOVED AND RETURNED TO THE CONSTRUCTION SITE. IN NO CASE SHALL THE SEDIMENT BE WASHED, SHOVELED, OR SWEPT INTO ANY ROADSIDE DITCH, STORM SEWER, OR SURFACE WATER.
- FILTER FABRIC FENCE SHOULD BE INSTALLED AT LEVEL GRADE. BOTH ENDS OF EACH FENCE SECTION SHOULD BE EXTENDED AT LEAST 8 FEET UPSLOPE AT 45 DEGREES TO THE MAIN BARRIER ALIGNMENT. SUPPORT STAKES SHALL BE SPACED AT A MAXIMUM OF 8 FEET. SEDIMENT MUST BE REMOVED WHEN ACCUMULATIONS REACH 1/2 THE ABOVE 31. GROUND HEIGHT OF THE FILTER FENCE.
- ANY FENCE SECTION WHICH HAS BEEN UNDERMINED OR TOPPED MUST BE IMMEDIATELY REPLACED WITH A ROCK FILTER OUTLET. SEDIMENT MUST BE REMOVED WHEN ACCUMULATIONS REACH 1/3 THE HEIGHT OF THE OUTLET.
- EROSION CONTROL BLANKETING SHALL BE INSTALLED ON ALL SLOPES 3H:1V OR STEEPER WITHIN 50 FEET OF A SURFACE WATER AND ON ALL OTHER DISTURBED AREAS SPECIFIED ON THE PLAN MAPS AND/OR DETAIL SHEETS.
- 10. IMMEDIATELY UPON DISCOVERING UNFORESEEN CIRCUMSTANCES POSING THE POTENTIAL FOR ACCELERATED EROSION AND/OR SEDIMENT POLLUTION, THE OPERATOR SHALL IMPLEMENT APPROPRIATE BEST MANAGEMENT PRACTICES TO MINIMIZE THE POTENTIAL FOR EROSION AND 33. DURING CONSTRUCTION, THE SELECTED CONTRACTOR IS SEDIMENT POLLUTION AND NOTIFY PWD AND PA DEP.
- 11. UNTIL THE SITE IS STABILIZED, ALL E&S BMPS SHALL BE MAINTAINED PROPERLY. MAINTENANCE SHALL INCLUDE INSPECTIONS OF ALL E&S BMPS PRIOR TO ANY ANTICIPATED 34. STORM EVENT, AFTER EACH RUNOFF EVENT AND ON A WEEKLY BASIS. ALL PREVENTATIVE AND REMEDIAL MAINTENANCE WORK, INCLUDING CLEAN OUT, REPAIR REPLACEMENT, REGRADING, RESEEDING, REMULCHING, AND RENETTING, MUST BE PERFORMED IMMEDIATELY. IF THE E&S BMPS FAIL TO PERFORM AS EXPECTED, REPLACEMENT BMPS, OR MODIFICATIONS OF THOSE INSTALLED, WILL BE REQUIRED.
- ALL EARTH DISTURBANCES, INCLUDING CLEARING AND GRUBBING, AS WELL AS CUTS AND FILLS, SHALL BE DONE IN ACCORDANCE WITH THE APPROVED E&S PLAN. A COPY OF THE APPROVED DRAWINGS MUST BE AVAILABLE AT THE 36. PROJECT SITE AT ALL TIMES. PWD SHALL BE NOTIFIED OF ANY CHANGES TO THE APPROVED PLAN PRIOR TO IMPLEMENTATION OF THOSE CHANGES. PWD MAY REQUIRE A WRITTEN SUBMITTAL OF THOSE CHANGES FOR REVIEW AND APPROVAL AT ITS DISCRETION.
- 13. AT LEAST THREE (3) DAYS PRIOR TO STARTING ANY EARTH DISTURBANCE ACTIVITIES, OR EXPANDING INTO AN AREA 37. PREVIOUSLY UNMARKED, THE PENNSYLVANIA ONE CALL SYSTEM INC. SHALL BE NOTIFIED AT 1-800-242-1776 FOR THE LOCATION OF EXISTING UNDERGROUND UTILITIES.
- 14. ALL EARTH DISTURBANCE ACTIVITIES SHALL PROCEED IN ACCORDANCE WITH THE SEQUENCE PROVIDED ON THE PLAN DRAWINGS. DEVIATION FROM THAT SEQUENCE MUST BE APPROVED IN WRITING BY PWD AND THE PA DEP PRIOR TO IMPLEMENTATION.
- 15. AREAS TO BE FILLED ARE TO BE CLEARED, GRUBBED, AND STRIPPED OF TOPSOIL TO REMOVE TREES, VEGETATION, ROOTS, AND OTHER OBJECTIONABLE MATERIAL
- 16. CLEARING, GRUBBING, AND TOPSOIL STRIPPING SHALL BE LIMITED TO THOSE AREAS DESCRIBED IN EACH STAGE OF THE CONSTRUCTION SEQUENCE. GENERAL SITE CLEARING, GRUBBING, AND TOPSOIL STRIPPING MAY NOT COMMENCE IN ANY STAGE OF THE PROJECT UNTIL THE E&S BMPS SPECIFIED BY THE BMP SEQUENCE FOR THAT STAGE HAVE BEEN INSTALLED AND ARE FUNCTIONING AS DESCRIBED IN THIS E&S
- 17. AT NO TIME SHALL CONSTRUCTION VEHICLES BE ALLOWED 2. TO ENTER AREAS OUTSIDE THE LIMIT OF DISTURBANCE 3. BOUNDARIES SHOWN ON THE PLAN MAPS. THESE AREAS MUST BE CLEARLY MARKED AND FENCED OFF BEFORE CLEARING AND GRUBBING OPERATIONS BEGIN
- 18. A LOG SHOWING DATES THAT E&S BMPS WERE INSPECTED AS WELL AS ANY DEFICIENCIES FOUND AND THE DATE THEY WERE CORRECTED SHALL BE MAINTAINED ON THE SITE AND BE MADE AVAILABLE TO PWD AT THE TIME OF INSPECTION.
- 19. ALL SEDIMENT REMOVED FROM BMPS SHALL BE DISPOSED OF IN THE FOLLOWING MANNER: AT AN APPROVED OFF-SITE DISPOSAL FACILITY
- 20. AREAS WHICH ARE TO BE TOPSOILED SHALL BE SCARIFIED TO A MINIMUM DEPTH OF THREE TO FIVE INCHES — SIX TO 12 5. INCHES ON COMPACTED SOILS — PRIOR TO PLACEMENT OF TOPSOIL. AREAS TO BE VEGETATED SHALL HAVE A MINIMUM FOUR INCHES OF TOPSOIL IN PLACE PRIOR TO SEEDING AND MULCHING. FILL OUTSLOPES SHALL HAVE A MINIMUM OF TWO INCHES OF TOPSOIL
- 21. ALL FILLS SHALL BE COMPACTED AS REQUIRED TO REDUCE EROSION, SLIPPAGE, SETTLEMENT, SUBSIDENCE, OR OTHER RELATED PROBLEMS. FILL INTENDED TO SUPPORT BUILDINGS, STRUCTURES, AND CONDUITS, ETC. SHALL BE COMPACTED IN ACCORDANCE WITH LOCAL REQUIREMENTS OR CODES.
- 22. ALL EARTHEN FILLS SHALL BE PLACED IN COMPACTED LAYERS NOT TO EXCEED NINE INCHES IN THICKNESS.
- 23. FILL MATERIALS SHALL BE FREE OF FROZEN PARTICLES, BRUSH, ROOTS, SOD, OR OTHER FOREIGN OR OBJECTIONABLE MATERIALS THAT WOULD INTERFERE WITH 5.2. OR PREVENT CONSTRUCTION OF SATISFACTORY FILLS.
- 24. FROZEN MATERIALS OR SOFT, MUCKY, OR HIGHLY

COMPRESSIBLE MATERIALS SHALL NOT BE INCORPORATED INTO FILLS.

- SURFACES NECESSARY DURING CONSTRUCTION. ALL PUMPING OF 26. SEEPS OR SPRINGS ENCOUNTERED DURING CONSTRUCTION SHALL BE HANDLED IN ACCORDANCE WITH THE STANDARD AND SPECIFICATION FOR SUBSURFACE DRAIN OR OTHER APPROVED METHOD.
- INLET PROTECTION SHOULD BE PROVIDED FOR ALL INLETS 27. ALL GRADED AREAS SHALL BE PERMANENTLY STABILIZED IMMEDIATELY UPON REACHING FINISHED GRADE. CUT SLOPES IN COMPETENT BEDROCK AND ROCK FILLS NEED NOT BE VEGETATED. SEEDED AREAS WITHIN 50 FEET OF A SURFACE WATER, OR AS OTHERWISE SHOWN ON THE PLAN DRAWINGS, SHALL BE BLANKETED ACCORDING TO THE 5.3. STANDARDS OF THIS PLAN.
 - 28. IMMEDIATELY AFTER EARTH DISTURBANCE ACTIVITIES CEASE IN ANY AREA OR SUBAREA OF THE PROJECT, THE OPERATOR SHALL STABILIZE ALL DISTURBED AREAS. DURING 5.4 NON-GERMINATING MONTHS, MULCH OR PROTECTIVE BLANKETING SHALL BE APPLIED AS DESCRIBED IN THE PLAN. AREAS NOT AT FINISHED GRADE, WHICH WILL BE REACTIVATED WITHIN ONE YEAR, MAY BE STABILIZED IN ACCORDANCE WITH THE TEMPORARY STABILIZATION SPECIFICATIONS. THOSE AREAS WHICH WILL NOT BE REACTIVATED WITHIN ONE YEAR SHALL BE STABILIZED IN ACCORDANCE WITH THE PERMANENT STABILIZATION SPECIFICATIONS
- CONSTANTLY MAINTAINED ON-SITE. A STOCKPILE SHALL BE 29. PERMANENT STABILIZATION IS DEFINED AS A MINIMUM UNIFORM, PERENNIAL 70% VEGETATIVE COVER OR OTHER PERMANENT NON-VEGETATIVE COVER WITH A DENSITY SUFFICIENT TO RESIST ACCELERATED EROSION. CUT AND FILL SLOPES SHALL BE CAPABLE OF RESISTING FAILURE DUE TO SLUMPING, SLIDING, OR OTHER MOVEMENTS.
 - 30. E&S BMPS SHALL REMAIN FUNCTIONAL AS SUCH UNTIL ALL AREAS TRIBUTARY TO THEM ARE PERMANENTLY STABILIZED OR UNTIL THEY ARE REPLACED BY ANOTHER BMP APPROVED BY PWD AND PA DEP.
 - AFTER FINAL SITE STABILIZATION HAS BEEN ACHIEVED, TEMPORARY E&S BMPS MUST BE REMOVED OR CONVERTED TO PERMANENT POST-CONSTRUCTION STORMWATER MANAGEMENT PRACTICES. AREAS DISTURBED DURING REMOVAL OR CONVERSION OF THE E&S BMPS SHALL BE STABILIZED IMMEDIATELY. IN ORDER TO ENSURE RAPID REVEGETATION OF DISTURBED AREAS, SUCH REMOVAL/CONVERSIONS ARE TO BE DONE ONLY DURING THE GERMINATING SEASON.
 - 32. SEDIMENT BASINS AND/OR TRAPS SHALL BE KEPT FREE OF ALL CONSTRUCTION WASTE, WASH WATER, AND OTHER DEBRIS HAVING POTENTIAL TO CLOG THE BASIN/TRAP OUTLET STRUCTURES AND/OR POLLUTE THE SURFACE WATERS.(WHEN APPLICABLE)
 - EXPECTED TO FOLLOW THE PCSMP APPROVED BY PWD. NO CHANGE OR DEVIATION FROM THE APPROVED PCSMP IS 2. PERMITTED WITHOUT PRIOR APPROVAL FROM PWD.
 - ALL WORK ASSOCIATED WITH PWD WATER CONVEYANCE AND SEWER INFRASTRUCTURE SHALL BE DONE IN ACCORDANCE WITH THE CITY OF PHILADELPHIA WATER DEPARTMENT "WATER MAIN STANDARD DETAILS AND CORROSION CONTROL SPECIFICATIONS", 1985 EDITION, AND "STANDARD DETAILS AND STANDARD SPECIFICATIONS FOR SEWERS", 1985 EDITION 35. CONTACT PWD WATER TRANSPORT RECORDS (1101 MARKET
 - STREET, 2ND FLOOR, PHONE: 215-685-6271) FOR ADDITIONAL APPROVALS AND PERMITS REQUIRED FOR ALL WATER SERVICES, METERS, AND CONNECTIONS TO THE EXISTING AND/OR PROPOSED PWD FACILITIES
 - ALL BUILDING MATERIALS AND WASTES SHALL BE REMOVED FROM THE SITE AND RECYCLED OR DISPOSED OF IN ACCORDANCE WITH THE PADEP'S SOLID WASTE MANAGEMENT REGULATIONS AT 25 PA CODE 260.1 ET SEQ. 271.1, AND 287.1 ET SEQ. NO BUILDING MATERIALS OR WASTES OR UNUSED BUILDING MATERIALS SHALL BE BURNED, BURIED, DUMPED, OR DISCHARGED AT THE SITE.
 - ALL EXCESS SOIL SHALL BE DISPOSED OF IN ACCORDANCE WITH LOCAL, STATE, AND FEDERAL REGULATIONS. CONTAMINATED SOIL SHALL BE DISPOSED OF AT EITHER A) AN APPROVED DISPOSAL FACILITY WITH AN APPROVED AND CURRENT PADEP SOIL WASTE MANAGEMENT PERMIT, OR B) AN APPROVED LANDFILL (TYPICALLY DISPOSAL AT A LANDFILL DOES NOT REQUIRE A WASTE PERMIT), AND (2) "WASTE MATERIALS, SCRAP OR EXCESS CONSTRUCTION MATERIALS SHALL BE COLLECTED, STORED AND DISPOSED OF IN ACCORDANCE WITH THE SOLID WASTE MANAGEMENT ACT (35 P. S. § § 6018.101-THE MUNICIPAL WASTE PLANNING RECYCLING AND WASTE REDUCTION ACT (53 P. S. § § 4000.101-4000.1904), THE CLEAN STREAMS LAW (35 P. S. § § 691.1-691.1001) AND RELATED RULES AND REGULATIONS.

PROJECT SEQUENCE OF CONSTRUCTION NOTES:

- AREAS FOR POROUS PAVEMENT SYSTEMS MUST BE CLEARLY MARKED BEFORE ANY SITE WORK BEGINS TO AVOID SOIL DISTURBANCE AND COMPACTION DURING CONSTRUCTION. COMPLETE SITE CLEARING AND DEMOLITION.
- INSTALL UTILITY SERVICES AND STORM CONVEYANCE SYSTEMS AND TEMPORARY INLET FILTERS. STRUCTURES SUCH AS INLET BOXES, REINFORCED CONCRETE BOXES INLET CONTROLS, AND OUTLET CONTROLS MUST BE CONSTRUCTED ACCORDING TO MANUFACTURER'S GUIDELINES OR DESIGN PROFESSIONAL'S GUIDANCE. A REGISTERED PROFESSIONAL MUST DOCUMENT THE RELEVANT ELEVATIONS AND MEASUREMENTS AS REQUIRED BY THE SMP CONSTRUCTION CERTIFICATION FORMS CONTAINED WITHIN THE CCP.
- COMPLETE SITE ELEVATION GRADING AND STABILIZE ALL DISTURBED SOIL
- POROUS PAVEMENT INSTALLATION EXCAVATE POROUS PAVEMENT SUBSURFACE AREA TO 5.1. PROPOSED DEPTH. EXCAVATION SHOULD TAKE PLACE AFTER CONTRIBUTING UPSTREAM DISTURBED AREAS HAVE BEEN PERMANENTLY STABILIZED. IF THIS IS IMPRACTICAL, INSTALL PWD-APPROVED EROSION AND SEDIMENTATION CONTROL BEST MANAGEMENT PRACTICES (BMPS) TO PREVENT RUNOFF AND SEDIMENT FROM ENTERING THE EXCAVATED BED. WHERE EROSION OF SUBGRADE HAS CAUSED ACCUMULATION OF FINE MATERIALS AND/OR SURFACE PONDING, THIS MATERIAL MUST BE REMOVED WITH LIGHT EQUIPMENT AND THE UNDERLYING SOILS SCARIFIED TO A MINIMUM DEPTH OF SIX INCHES WITH A YORK RAKE OR EQUIVALENT AND LIGHT TRACTOR.
- EXISTING SUBGRADE MUST NOT BE COMPACTED AND CONSTRUCTION EQUIPMENT TRAFFIC MUST BE MINIMIZED (3PRIOR TO PLACEMENT OF THE GEOTEXTILE AND STONE

MUST BE AT A LEVEL GRADE.

5.5.

GRADES INDICATED ON THE DRAWINGS. 5.7. INSTALL POROUS PAVEMENT SURFACE COURSE COMPLETE FINAL GRADING OF REMAINING SITE AREA AND CONSTRUCT SITE IMPROVEMENTS. RESTORE ALL AREAS AS

APPROPRIATE. INSTALL TOPSOIL, PLANTS, SEEDING, AND MULCH. ONCE THE SITE IS PERMANENTLY STABILIZED WITH VEGETATION, REMOVE TEMPORARY EROSION AND SEDIMENT CONTROL MEASURES.

STANDARD PWD SEQUENCE OF CONSTRUCTION NOTES:


PRECONSTRUCTION MEETING. **INSPECTION (FOR EACH SMP)**


BMPS AS SOON AS SLOPES, CHANNELS, DITCHES, AND OTHER DISTURBED AREAS REACH FINAL GRADE, THEY MUST BE STABILIZED. CESSATION OF ACTIVITY FOR FOUR (4) DAYS OR LONGER REQUIRES TEMPORARY STABILIZATION. 6. THE NPDES NOTICE OF TERMINATION (N.O.T.) MUST BE SUBMITTED TO PA DEP UPON COMPLETION OF CONSTRUCTION (WHEN APPLICABLE). WATER PUMPED FROM WORK AREAS SHOULD BE TREATED FOR SEDIMENT REMOVAL PRIOR TO DISCHARGING TO A "SURFACE WATER" (WHEN APPLICABLE).

► R-3 ROCK

OUTLET CROSS-SECTION

WOOD POSTS

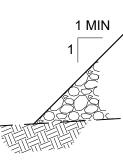

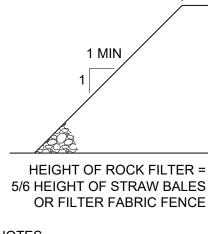

OUTLET.

BED. THE USE OF MACHINERY TO LOAD STONE FROM OUTSIDE OF THE BASIN FOOTPRINT IS RECOMMENDED. IF IT IS ESSENTIAL THAT EQUIPMENT BE USED IN THE EXCAVATED AREA, ALL EQUIPMENT MUST BE APPROVED BY THE ENGINEER. EQUIPMENT WITH NARROW TRACKS OR TIRES, RUBBER TIRES WITH LARGE LUGS, OR HIGH PRESSURE TIRES WILL CAUSE EXCESSIVE COMPACTION AND MUST NOT BE USED. SHOULD THE SUBGRADE BE COMPACTED DURING CONSTRUCTION, TESTING OF SOIL INFILTRATION RATES AND SYSTEM REDESIGN MAY BE REQUIRED AT NO ADDITIONAL COST TO OWNER. ROCK CONSTRUCTION ENTRANCES MUST NOT BE LOCATED ON TOP OF AREAS PROPOSED FOR INFILTRATION PRACTICES BRING SUBGRADE OF STONE BED TO LINE, GRADE, AND ELEVATIONS INDICATED IN THE DRAWINGS, WHILE AVOIDING COMPACTION. THE BOTTOM OF THE STONE BED

PLACE GEOTEXTILE AND RECHARGE BED AGGREGATE IMMEDIATELY AFTER APPROVAL OF SUBGRADE PREPARATION TO PREVENT ACCUMULATION OF DEBRIS OR SEDIMENT. AGGREGATE INSTALLATION SHOULD TAKE PLACE AFTER CONTRIBUTING UPSTREAM DISTURBED AREAS HAVE BEEN PERMANENTLY STABILIZED. INSTALL PWD-APPROVED EROSION AND SEDIMENTATION CONTROL BMPS TO PREVENT RUNOFF AND SEDIMENT FROM ENTERING THE STORAGE BED DURING THE PLACEMENT OF THE GEOTEXTILE AND AGGREGATE BED. PLACE GEOTEXTILE IN ACCORDANCE WITH MANUFACTURER'S STANDARDS AND RECOMMENDATIONS ADJACENT STRIPS OF FILTER FABRIC MUST OVERLAP A MINIMUM OF 16 INCHES. FABRIC MUST BE SECURED AT LEAST FOUR FEET OUTSIDE OF BED. THIS EDGE STRIP SHOULD REMAIN IN PLACE UNTIL ALL BARE SOILS CONTIGUOUS TO BEDS ARE STABILIZED AND VEGETATED. AS THE SITE IS FULLY STABILIZED, EXCESS GEOTEXTILE CAN BE CUT BACK TO THE EDGE OF THE BED.


INSTALL AGGREGATE COURSE IN LIFTS OF SIX TO EIGHT INCHES. COMPACT EACH LAYER WITH EQUIPMENT KEEPING EQUIPMENT MOVEMENT OVER STORAGE BED SUBGRADES TO A MINIMUM. INSTALL AGGREGATE TO

AT LEAST SEVEN (7) DAYS PRIOR TO ANY EARTH DISTURBANCE, THE INSPECTIONS COORDINATOR OF PWD (OFFICE: 215-685-6387) MUST BE CALLED TO SCHEDULE A

AT LEAST THREE (3) DAYS PRIOR TO POROUS PAVEMENT INSTALLATION, THE INSPECTIONS COORDINATOR OF PWD (OFFICE: 215-685-6387) MUST BE CALLED TO SCHEDULE AN

ALL STONE THAT MAKES UP THE POROUS PAVEMENT BASE MUST REMAIN FREE OF SEDIMENT. IF SEDIMENT ENTERS THE STONE, THE CONTRACTOR MAY BE REQUIRED TO REMOVE THE SEDIMENT AND REPLACE IT WITH CLEAN-WASHED STONE. UPON COMPLETION OF ALL EARTH DISTURBANCE ACTIVITIES

AND PERMANENT STABILIZATION OF ALL DISTURBED AREAS, THE OWNER AND/OR OPERATOR SHALL CONTACT INSPECTIONS COORDINATOR OF PWD (OFFICE: 215-685-6387) FOR A FINAL INSPECTION PRIOR TO REMOVAL/CONVERSION OF THE E&S

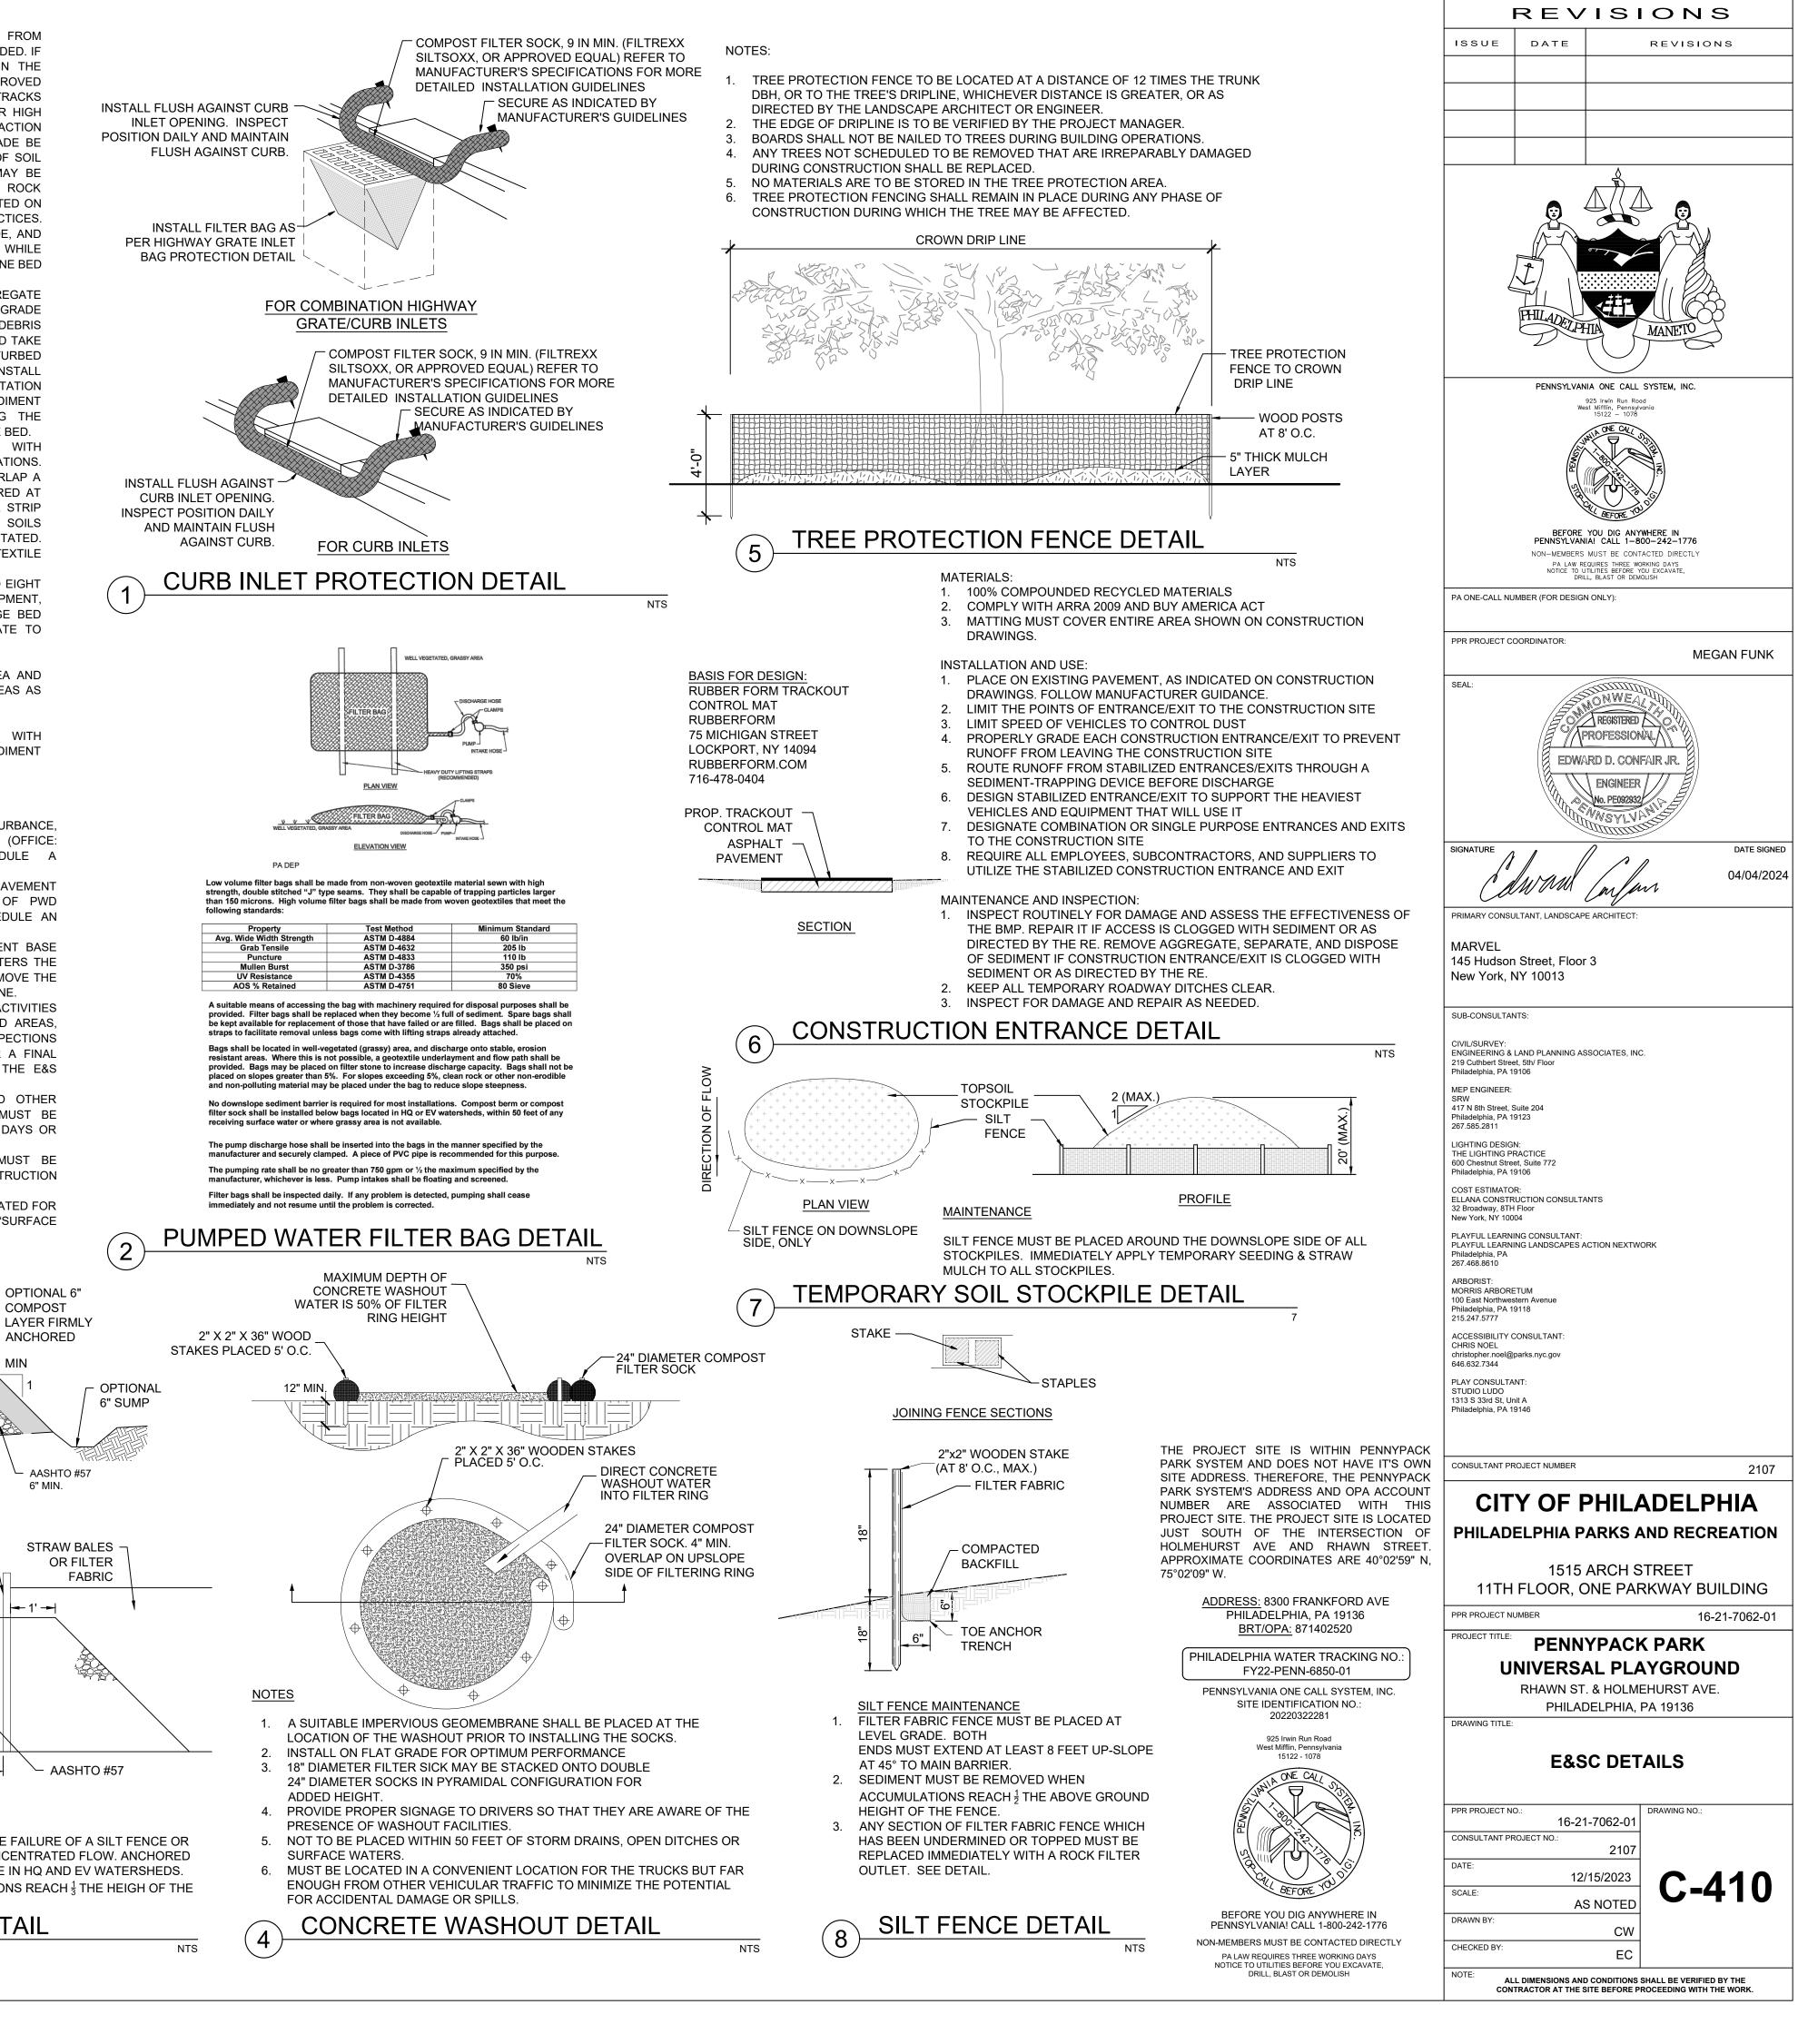

A ROCK FILTER OUTLET SHALL BE INSTALLED WHERE FAILURE OF A SILT FENCE OR STRAW BALE BARRIER HAS OCCURRED DUE TO CONCENTRATED FLOW. ANCHORED COMPOST LAYER SHALL BE USED ON UPSLOPE FACE IN HQ AND EV WATERSHEDS. SEDIMENT SHALL BE REMOVED WHEN ACCUMULATIONS REACH $\frac{1}{3}$ THE HEIGH OF THE

COMPOST

6" MIN.


|→ 1' →

1 MIN

ROCK FILTER OUTLET DETAIL

– 3' MIN

UP-SLOPE FACE

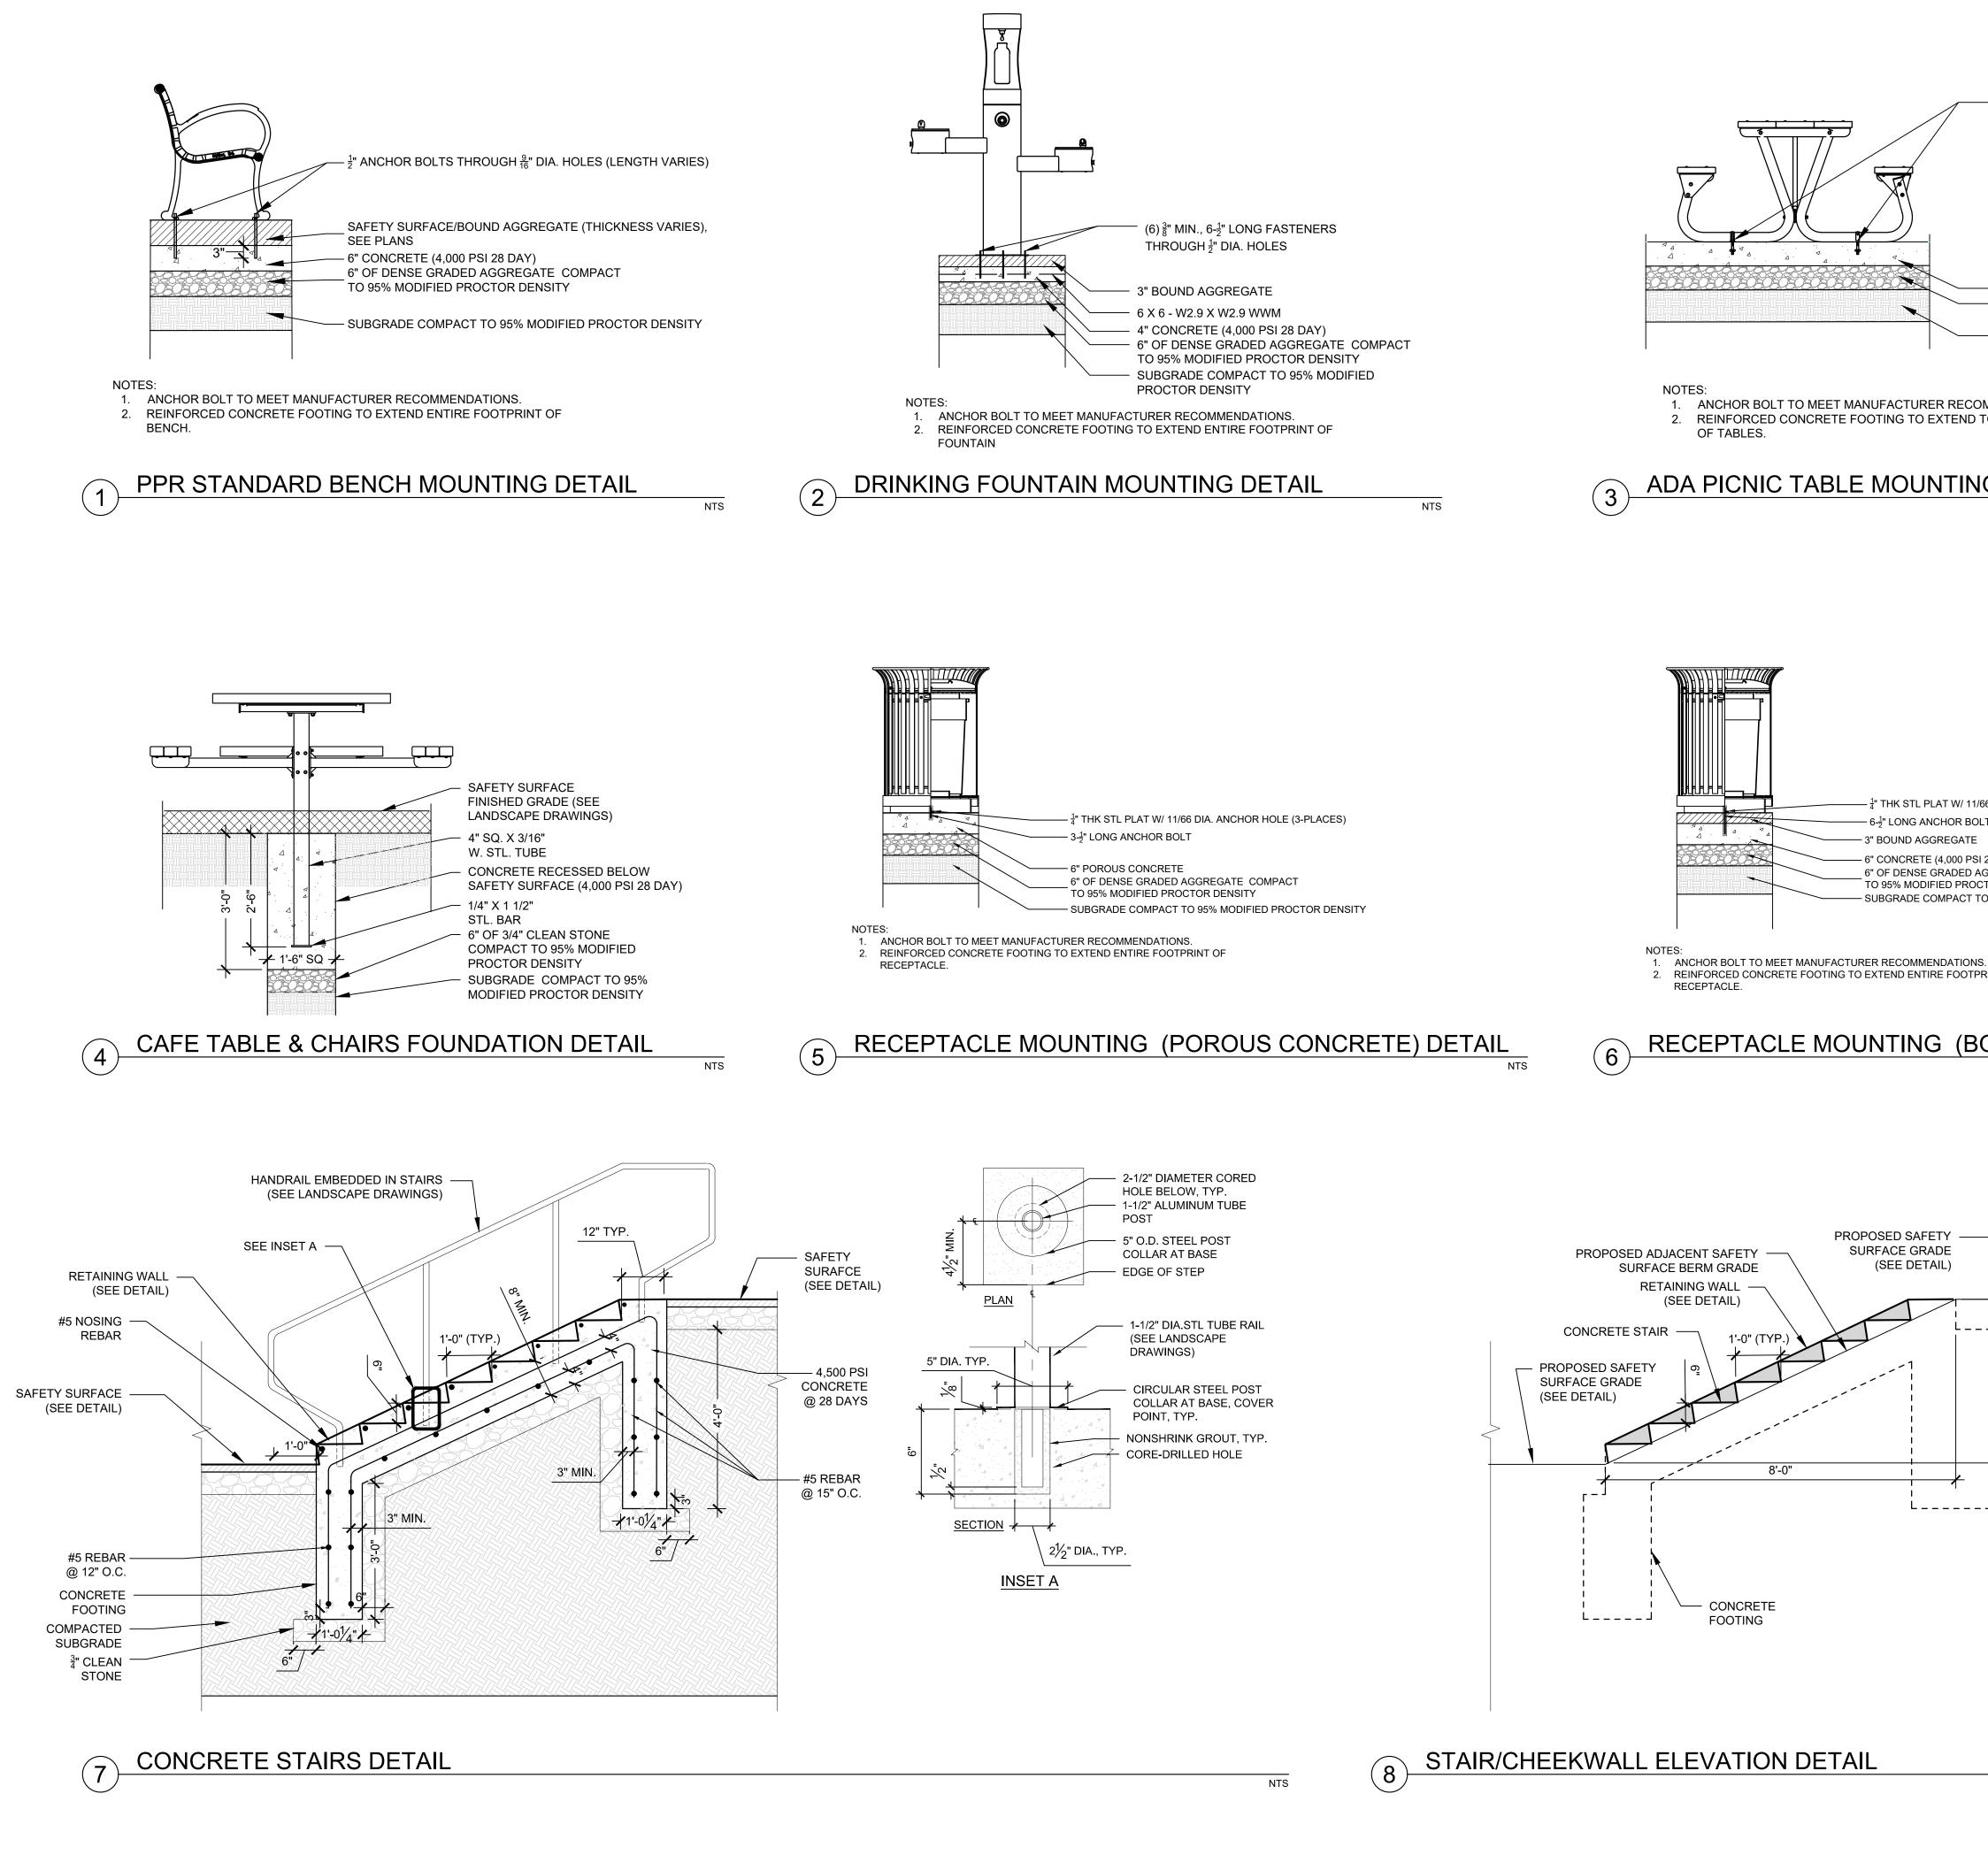


		REV	'ISIC	DNS
	ISSUE	DATE	RI	EVISIONS
$\frac{1}{2}$ " X 3- $\frac{3}{4}$ " EXPANSION ANCHORS				
THROUGH 2" PIPE CLAMPS				
 — 6" CONCRETE (4,000 PSI 28 DAY) — 6" OF DENSE GRADED AGGREGATE COMPACT TO 95% MODIFIED PROCTOR DENSITY — SUBGRADE COMPACT TO 95% MODIFIED PROCTOR DENSITY 		HILADELP.	HIA MA	NETO
PROCTOR DENSITY		PENNSYLVA	NIA ONE CALL SYST	EM, INC.
OMMENDATIONS. TO ENTIRE FOOTPRINT		Wind and a second se	925 Irwin Run Road est Mifflin, Pennsylvonia 15122 – 1078)
IG DETAIL		PENNSYLVAN NON-MEMBERS	YOU DIG ANYWHERI VIA! CALL 1-800-24 S MUST BE CONTACTED REQUIRES THREE WORKING UTILITES BEFORE YOU EXC UTILITES BEFORE YOU EXC	42–1776 DIRECTLY
		UMBER (FOR DESIG		
	SEAL:		SUSSEED ON WEAL	MEGAN FUNK
			REGISTERED PROFESSIONAL ARD D. CONFAIR ENGINEER No. PE092932	
66 DIA. ANCHOR HOLE (3-PLACES) LT	SIGNATURE	a lurant		DATE SIGNI 04/04/202
I 28 DAY) AGGREGATE COMPACT CTOR DENSITY	PRIMARY CONS	SULTANT, LANDSCAF	PE ARCHITECT:	
O 95% MODIFIED PROCTOR DENSITY	MARVEL 145 Hudson New York,	n Street, Floo NY 10013	r 3	
S. PRINT OF				
	SUB-CONSULTA CIVIL/SURVEY: ENGINEERING 8 219 Cuthbert Stre	& LAND PLANNING A	SSOCIATES, INC.	
OUND AGGREGATE) DETAIL	Philadelphia, PA MEP ENGINEER SRW 417 N 8th Street,	19106 :: Suite 204		
	Philadelphia, PA 267.585.2811 LIGHTING DESIC THE LIGHTING F 600 Chestnut Stre	19123 GN: PRACTICE		
	Philadelphia, PA COST ESTIMATO ELLANA CONST	19106 DR: RUCTION CONSULT	ANTS	
	PLAYFUL LEARN Philadelphia, PA	004 NING CONSULTANT: NING LANDSCAPES /	ACTION NEXTWORK	
	267.468.8610 ARBORIST: MORRIS ARBOR 100 East Northwe Philadelphia, PA	estern Avenue		
	215.247.5777 ACCESSIBILITY CHRIS NOEL christopher.noel@			
	646.632.7344 PLAY CONSULT, STUDIO LUDO			
	1313 S 33rd St, U Philadelphia, PA			
	CONSULTANT P	ROJECT NUMBER		2107
THE PROJECT SITE IS WITHIN PENNYPACK PARK SYSTEM AND DOES NOT HAVE IT'S OWN SITE ADDRESS. THEREFORE, THE PENNYPACK PARK SYSTEM'S ADDRESS AND OPA ACCOUNT NUMBER ARE ASSOCIATED WITH THIS PROJECT SITE. THE				ELPHIA
PROJECT SITE IS LOCATED JUST SOUTH OF THE INTERSECTION OF HOLMEHURST AVE AND RHAWN STREET. APPROXIMATE COORDINATES ARE 40°02'59" N, 75°02'09" W.		f Floor, (ARCH STR ONE PARKV	EET VAY BUILDING 16-21-7062-01
ADDRESS: 8300 FRANKFORD AVE PHILADELPHIA, PA 19136 BRT/OPA: 871402520 PHILADELPHIA WATER TRACKING NO.: FY22-PENN-6850-01 PENNSYLVANIA ONE CALL SYSTEM, INC. SITE IDENTIFICATION NO.:	PROJECT TITLE	PENN	YPACK P AL PLAY(7. & HOLMEHU DELPHIA, PA 1	ARK GROUND RST AVE.
925 Irwin Run Road West Mifflin, Pennsylvania 15122 - 1078		E:	UCTION E	
NTS NTS	PPR PROJECT N	16-2	1-7062-01	WING NO.:
ALL BEFORE YOU DI	DATE: SCALE:		2107 2/15/2023	C-500
BEFORE YOU DIG ANYWHERE IN PENNSYLVANIA! CALL 1-800-242-1776 NON-MEMBERS MUST BE CONTACTED DIRECTLY PA LAW REQUIRES THREE WORKING DAYS	DRAWN BY: CHECKED BY:	A	S NOTED CW EC	~
PA LAW REQUIRES THREE WORKING DAYS NOTICE TO UTILITIES BEFORE YOU EXCAVATE, DRILL, BLAST OR DEMOLISH	NOTE:			


DATE SIGNED

04/04/2024

ALL DIMENSIONS AND CONDITIONS SHALL BE VERIFIED BY THE CONTRACTOR AT THE SITE BEFORE PROCEEDING WITH THE WORK.

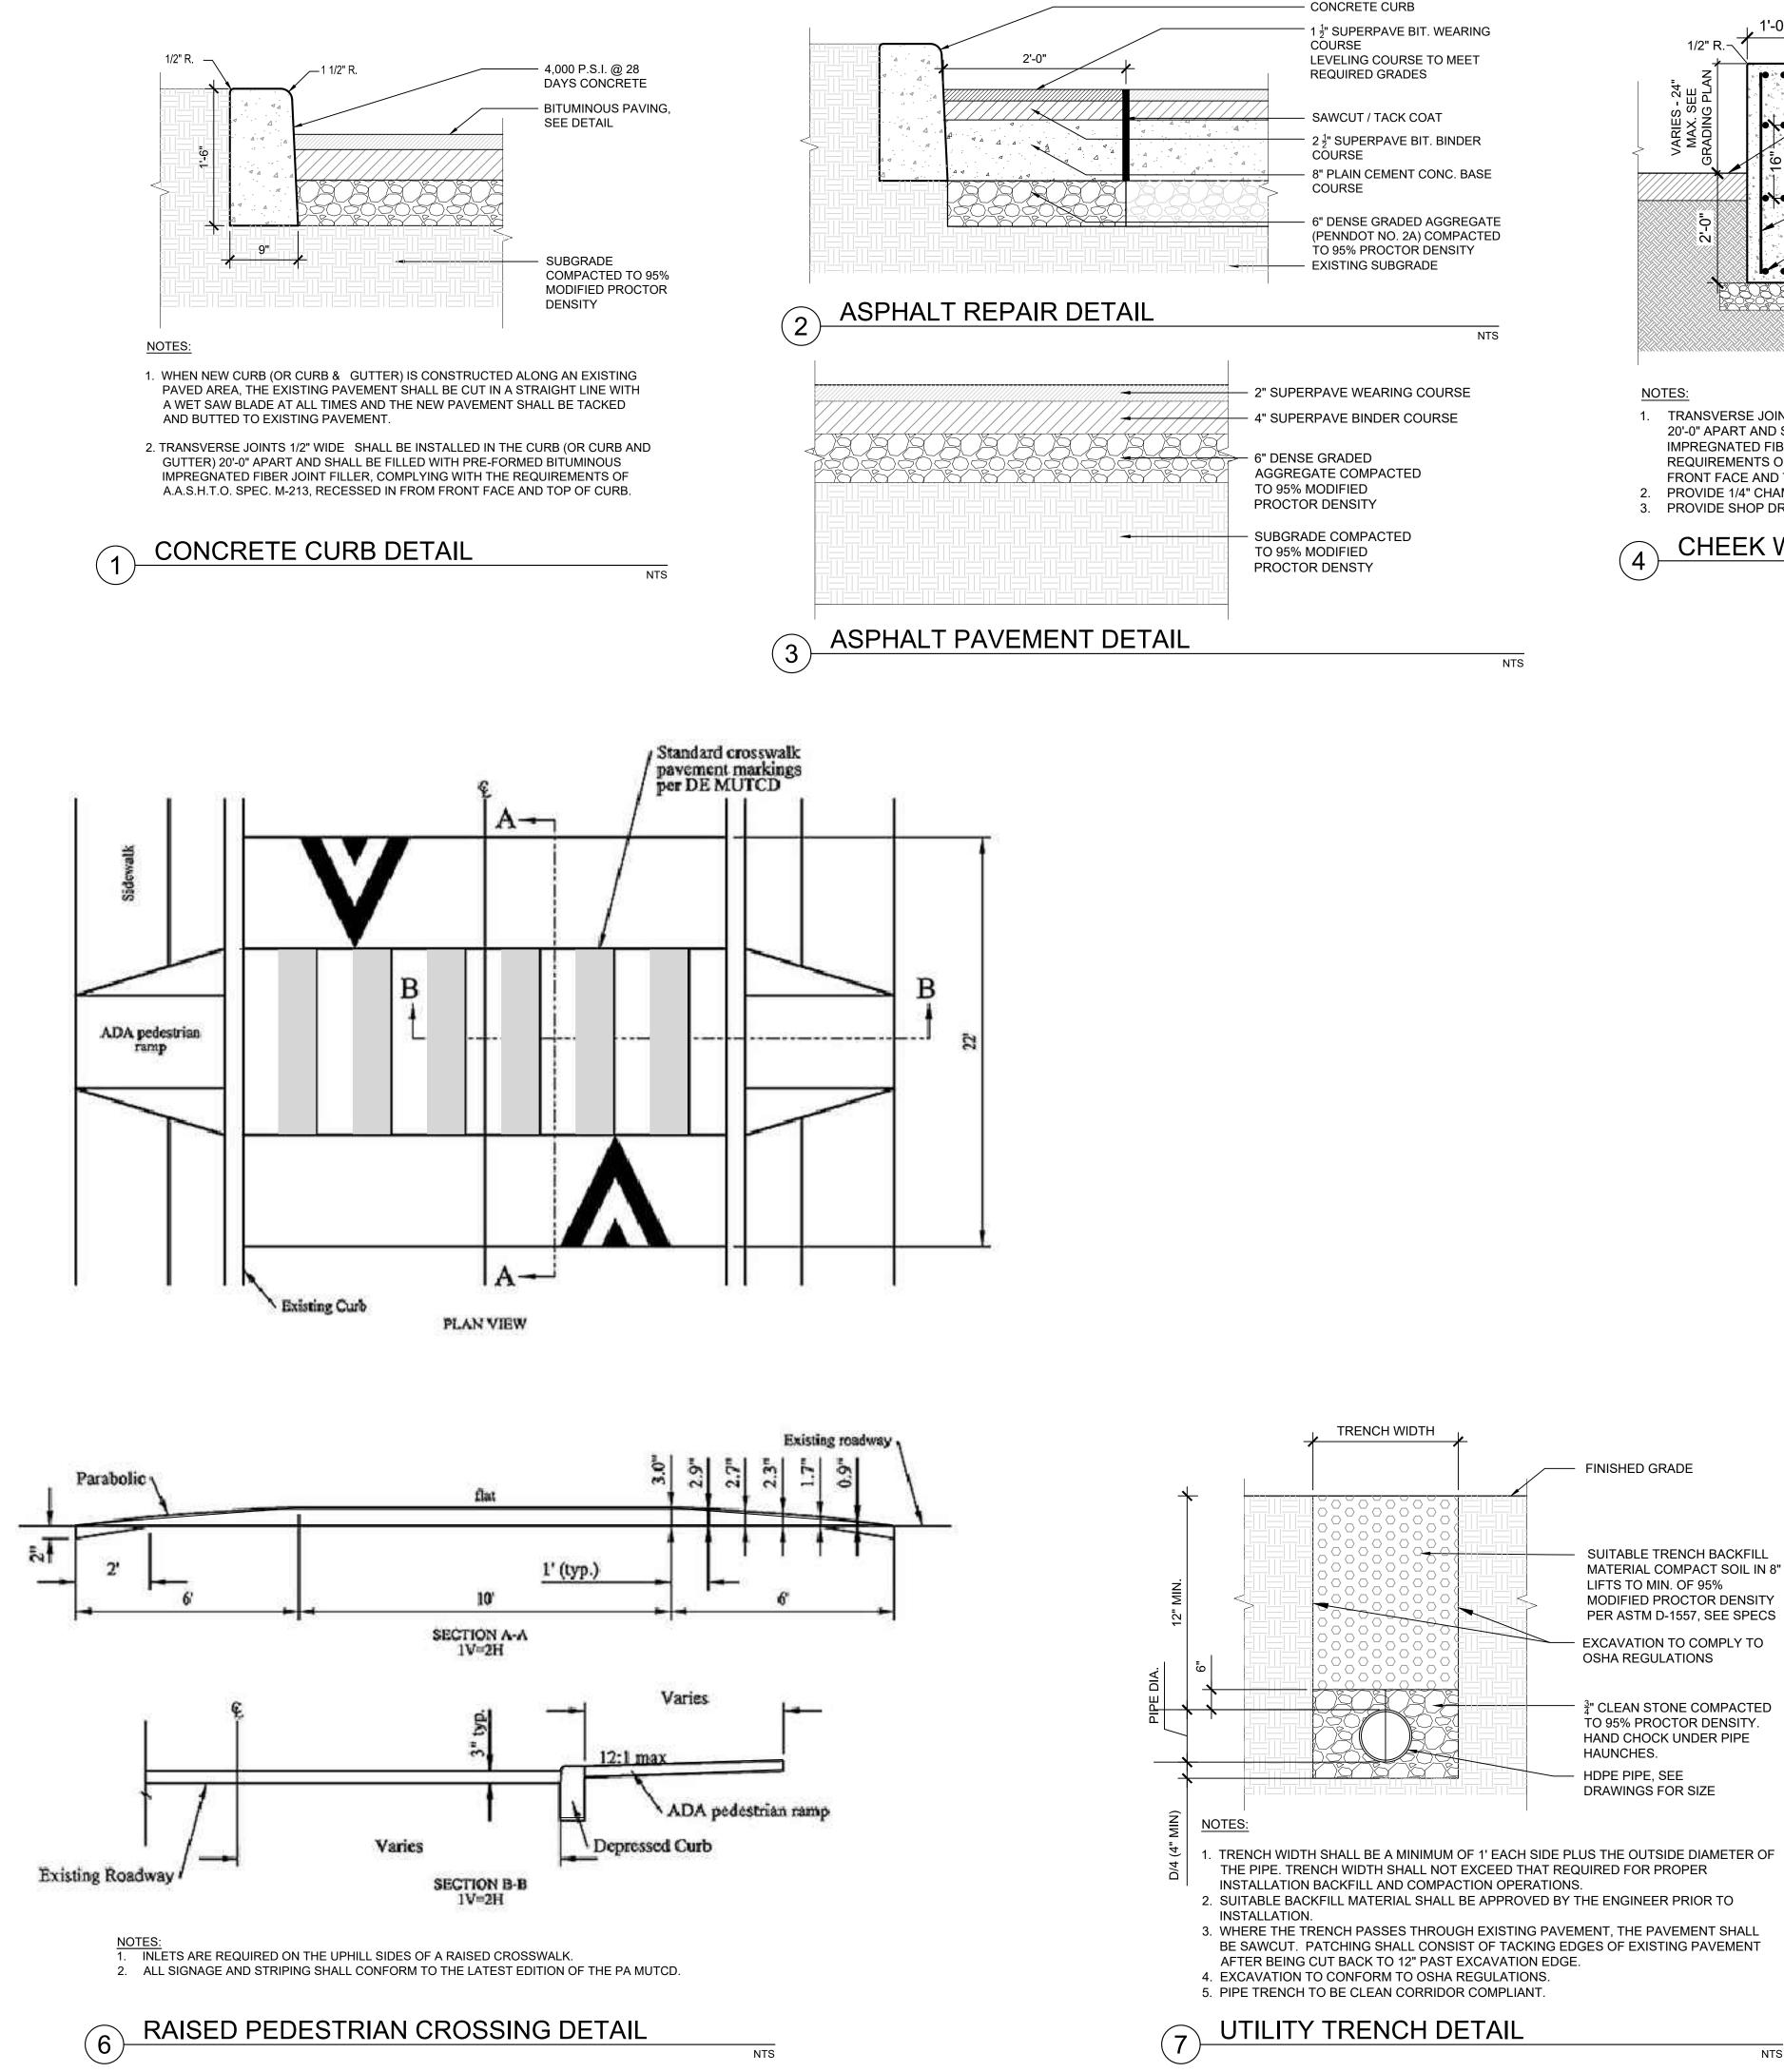

- CONCRETE CURB

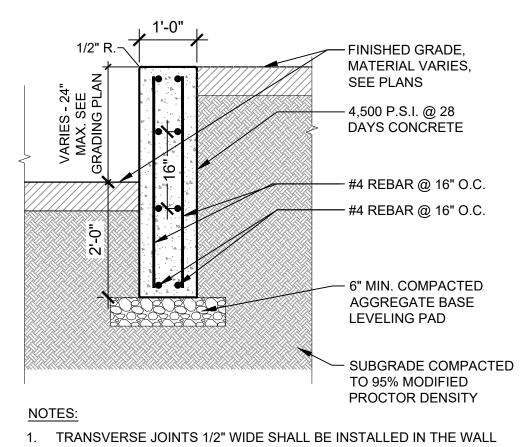


20'-0" APART AND SHALL BE FILLED WITH PRE-FORMED BITUMINOUS IMPREGNATED FIBER JOINT FILLER, COMPLYING WITH THE REQUIREMENTS OF A.A.S.H.O. SPEC. M-213, RECESSED IN FROM FRONT FACE AND TOP OF WALL. 2. PROVIDE 1/4" CHAMFER ON VERTICAL EDGES.

NTS

3. PROVIDE SHOP DRAWINGS FOR REVIEW.

CHEEK WALL DETAIL

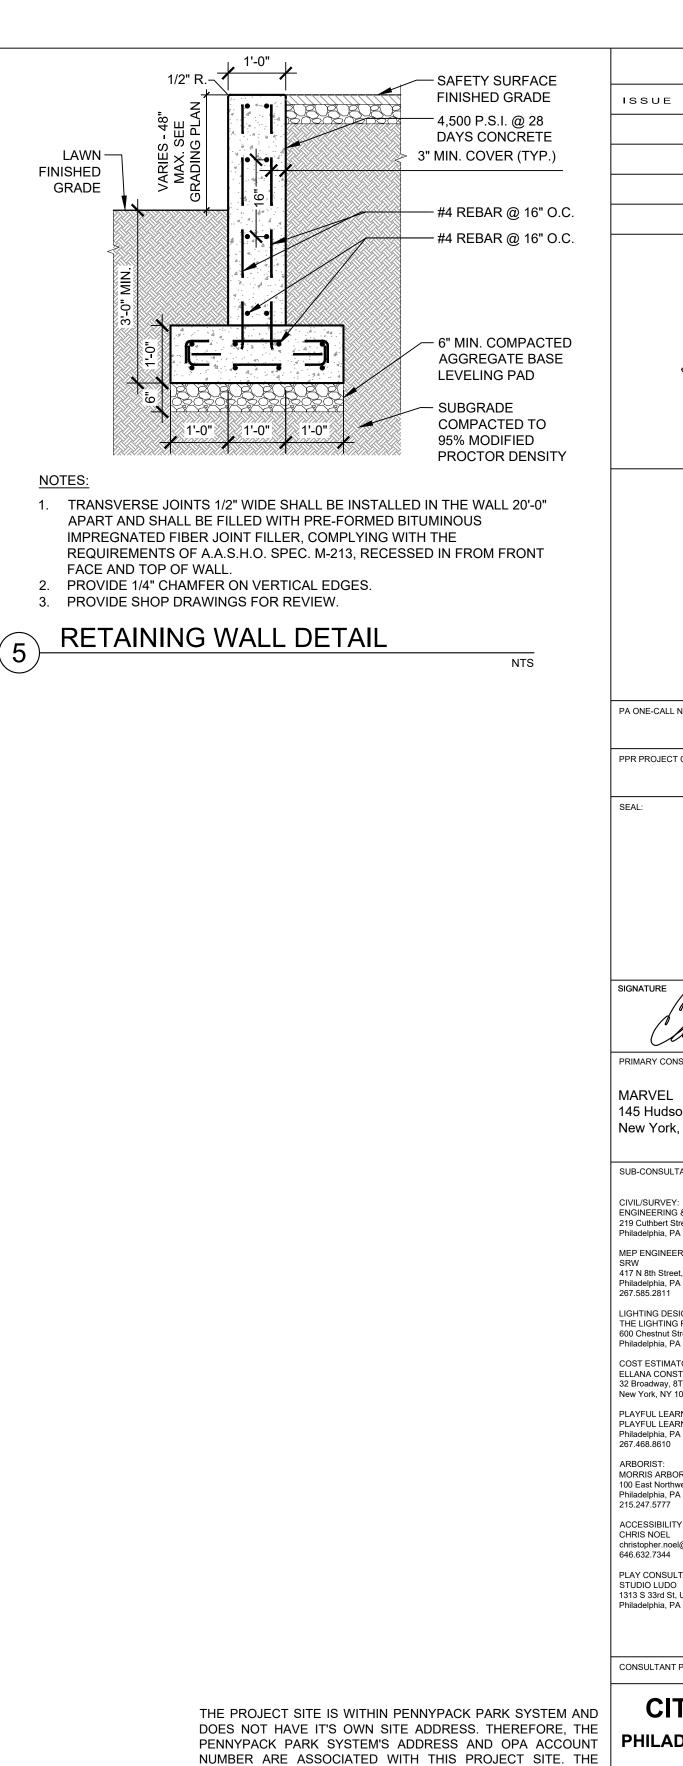

DAYS CONCRETE	
SNIC CONCILETE 3" MIN. COVER (TYP.)	
#4 REBAR @ 16" O.C. #4 REBAR @ 16" O.C.	
6" MIN. COMPACTED	
AGGREGATE BASE LEVELING PAD	
	HILADELPHIA MANETO
1'-0" 1'-0" 95% MODIFIED PROCTOR DENSITY	
NTS 1/2" WIDE SHALL BE INSTALLED IN THE WALL 20'-0"	PENNSYLVANIA ONE CALL SYSTEM, INC. 925 Irwin Run Road West Wifflin, Pennsylvania
BE FILLED WITH PRE-FORMED BITUMINOUS ER JOINT FILLER, COMPLYING WITH THE	15122 - 1076
F A.A.S.H.O. SPEC. M-213, RECESSED IN FROM FRONT WALL.	
MFER ON VERTICAL EDGES. RAWINGS FOR REVIEW.	
G WALL DETAIL	BEFORE YOU DIG ANYWHERE IN PENNSYLVANIA! CALL 1-800-242-1776
NTS	NON-MEMBERS MUST BE CONTACTED DIRECTLY PA LAW REQUIRES THREE WORKING DAYS NOTICE TO UTILITIES BEFORE YOU EXCAVATE, DRILL, BLAST OR DEMOLISH
	PA ONE-CALL NUMBER (FOR DESIGN ONLY):
	PPR PROJECT COORDINATOR:
	MEGAN FUNK
	SEAL:
	PROFESSIONAL
	EDWARD D. CONFAIR JR.
	ENGINEER No. PE092932
	SIGNATURE DATE SIGNED 04/04/2024
	Carlina Configuration Configuration
	PRIMARY CONSULTANT, LANDSCAPE ARCHITECT:
	145 Hudson Street, Floor 3 New York, NY 10013
	SUB-CONSULTANTS:
	CIVIL/SURVEY:
	ENGINEERING & LAND PLANNING ASSOCIATES, INC. 219 Cuthbert Street, 5th/ Floor Philadelphia, PA 19106
	MEP ENGINEER: SRW 417 N 8th Street, Suite 204
	Philadelphia, PA 19123 267.585.2811 LIGHTING DESIGN:
	THE LIGHTING PRACTICE 600 Chestnut Street, Suite 772 Philadelphia, PA 19106
	COST ESTIMATOR: ELLANA CONSTRUCTION CONSULTANTS 32 Broadway, 8TH Floor
	New York, NY 10004 PLAYFUL LEARNING CONSULTANT: PLAYFUL LEARNING LANDSCAPES ACTION NEXTWORK
	Philadelphia, PA 267.468.8610 ARBORIST:
	MORRIS ARBORETUM 100 East Northwestern Avenue Philadelphia, PA 19118
	215.247.5777 ACCESSIBILITY CONSULTANT: CHRIS NOEL
	christopher.noel@parks.nyc.gov 646.632.7344 PLAY CONSULTANT:
	STUDIO LUDO 1313 S 33rd St, Unit A Philadelphia, PA 19146
	CONSULTANT PROJECT NUMBER 2107
THE PROJECT SITE IS WITHIN PENNYPACK PARK SYSTEM AND DOES NOT HAVE IT'S OWN SITE ADDRESS. THEREFORE, THE	CITY OF PHILADELPHIA
PENNYPACK PARK SYSTEM'S ADDRESS AND OPA ACCOUNT NUMBER ARE ASSOCIATED WITH THIS PROJECT SITE. THE	PHILADELPHIA PARKS AND RECREATION
PROJECT SITE IS LOCATED JUST SOUTH OF THE INTERSECTION OF HOLMEHURST AVE AND RHAWN STREET. APPROXIMATE	1515 ARCH STREET 11TH FLOOR, ONE PARKWAY BUILDING
COORDINATES ARE 40°02'59" N, 75°02'09" W. ADDRESS: 8300 FRANKFORD AVE PHILADELPHIA, PA 19136	PPR PROJECT NUMBER 16-21-7062-01
BRT/OPA: 871402520 PHILADELPHIA WATER TRACKING NO.: FY22-PENN-6850-01	PROJECT TITLE: PENNYPACK PARK
PENNSYLVANIA ONE CALL SYSTEM, INC.	UNIVERSAL PLAYGROUND RHAWN ST. & HOLMEHURST AVE.
SITE IDENTIFICATION NO.: 20220322281	PHILADELPHIA, PA 19136
925 Irwin Run Road West Mifflin, Pennsylvania 15122 - 1078	CONSTRUCTION DETAILS
JANIA ONE CALL ST	CONSTRUCTION DETAILS
	PPR PROJECT NO.: DRAWING NO.: 16-21-7062-01
	CONSULTANT PROJECT NO.: 2107
Received a contraction of the co	DATE: 12/15/2023 C-501
BEFORE YOU DIG ANYWHERE IN PENNSYLVANIA! CALL 1-800-242-1776	AS NOTED DRAWN BY:
NON-MEMBERS MUST BE CONTACTED DIRECTLY PA LAW REQUIRES THREE WORKING DAYS	CHECKED BY: EC
NOTICE TO UTILITIES BEFORE YOU EXCAVATE, DRILL, BLAST OR DEMOLISH	NOTE: ALL DIMENSIONS AND CONDITIONS SHALL BE VERIFIED BY THE CONTRACTOR AT THE SITE BEFORE PROCEEDING WITH THE WORK.

REVISIONS

REVISIONS

DATE

NOTES:

- ENGINEER'S NAME: EDWARD CONFAIR, P.E., P.L.A. ENGINEERING & LAND PLANNING ASSOCIATES 140 W. MAIN ST. HIGH BRIDGE NEW JERSEY, 08829
- OWNER'S NAME: CITY OF PHILADELPHIA DEPARTMENT OF PUBLIC PROPERTY 702 CITY HALL, PHILADELPHIA, PA 19107 215-686-1776
- DEVELOPER'S NAME PHILADELPHIA PARKS AND RECREATION CITY OF PHILADELPHIA OFFICE OF SPECIAL EVENTS 1515 ARCH ST. #10, PHILADELPHIA, PA 19102 215683-3600
- 4. NO BUILDINGS ARE PROPOSED.

5. NO SEWER OR WATER INFRASTRUCTURE WILL BE DECOMMISSIONED.

- 6. NO PROPERTY LINES WILL BE ALTERED AS PART OF THE PROPOSED PROJECT. 7. NO RIGHT-OF-WAY LINES WILL BE ALTERED AS PART OF THE PROPOSED
- PROJECT. 8. NO RIGHT-OF-WAY ENCROACHMENTS ARE PROPOSED.
- 9. NO INFRASTRUCTURE WILL BE PROPOSED BY PWD.
- 10. NO EASEMENTS ARE PROPOSED.
- 11. NO WATER METER IS PROPOSED. 12. NO DOMESTIC OR FIRE SERVICE IS PROPOSED.
- 13. NO WATER SERVICE OF BACKFLOW PROTECTION IS PROPOSED.
- 14. NO CRANE WILL BE USED FOR CONSTRUCTION. 15. DEVELOPER/OWNER WILL COMPLY WITH ALL PHILADELPHIA REGULATIONS PERTAINING TO PROPER ABANDONMENT AND/OR REUSE OF WATER SERVICE LINES AND SEWER LATERALS. PROOF OF ABANDONMENT AND/OR WATER DISCONTINUANCE MUST BE PROVIDED UPON REQUEST.

REFERENCES:

1. A MAP ENTITLED "TOPOGRAPHIC & LOCATION SURVEY OF PENNYPACK PARK", PREPARED BY:SAS GEOSPATIAL. DATED: 11/10/2023 OR LAST REVISED

PROJECT DESCRIPTION:

THIS PROJECT CONSISTS OF THE DEMOLITION OF EXISTING CONCRETE PADS, CONCRETE PAVEMENT AROUND THE STRUCTURE AT THE SOUTH END OF THE SITE, SELECT CURBS SELECT TREES, AREA INLET, AND GRAVEL PATH..

THE PROJECT PROPOSES THE CONSTRUCTION OF BENCHES, LIGHT POLES, PLAY STRUCTURES, CONCRETE PATH, BOUND AGGREGATE PATH, PLAY SURFACING, CONCRETE STAIRS, RETAINING WALL, CHEEK WALL, RAISED PEDESTRIAN CROSSING AND ELECTRIC LINES.


NO CONNECTIONS TO WATER OR SANITARY UTILITIES ARE PROPOSED.


PROJECT DESCRIPTION: INSTITUTIONAL PUBLIC PARK ENHANCEMENTS SITE GOVERNANCE: PHILADELPHIA PARKS AND RECREATION


SITE DATA:


SITE SQUARE FOOTAGE: 42,600 SF (THE PROJECT SITE IS WITHIN PENNYPACK PARK SYSTEM AND THEREFORE DOES NOT HAVE A TAX LOT WITH A DEFINED AREA

- ASSOCIATED WITH IT.)
- EARTH DISTURBANCE: 42.600 SF
- PWD STORMWATER TRACKING #: FY22-PENN-6850-01 PWD UPR TRACKING #: UPR-FY24-PENN-6606

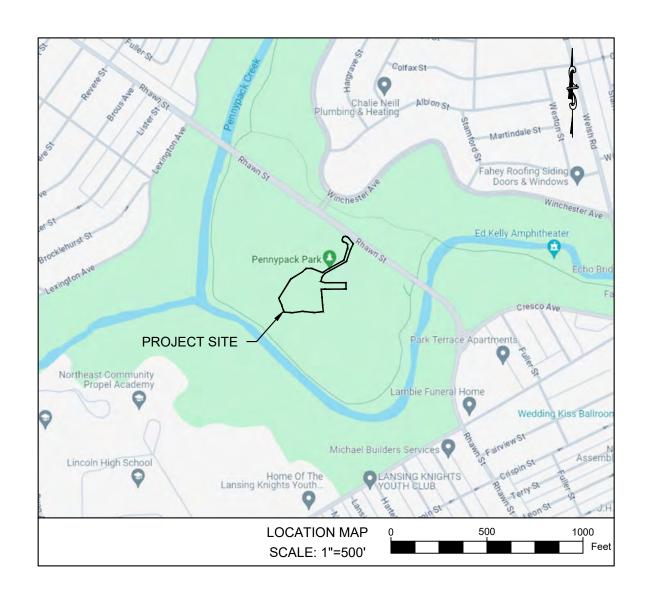

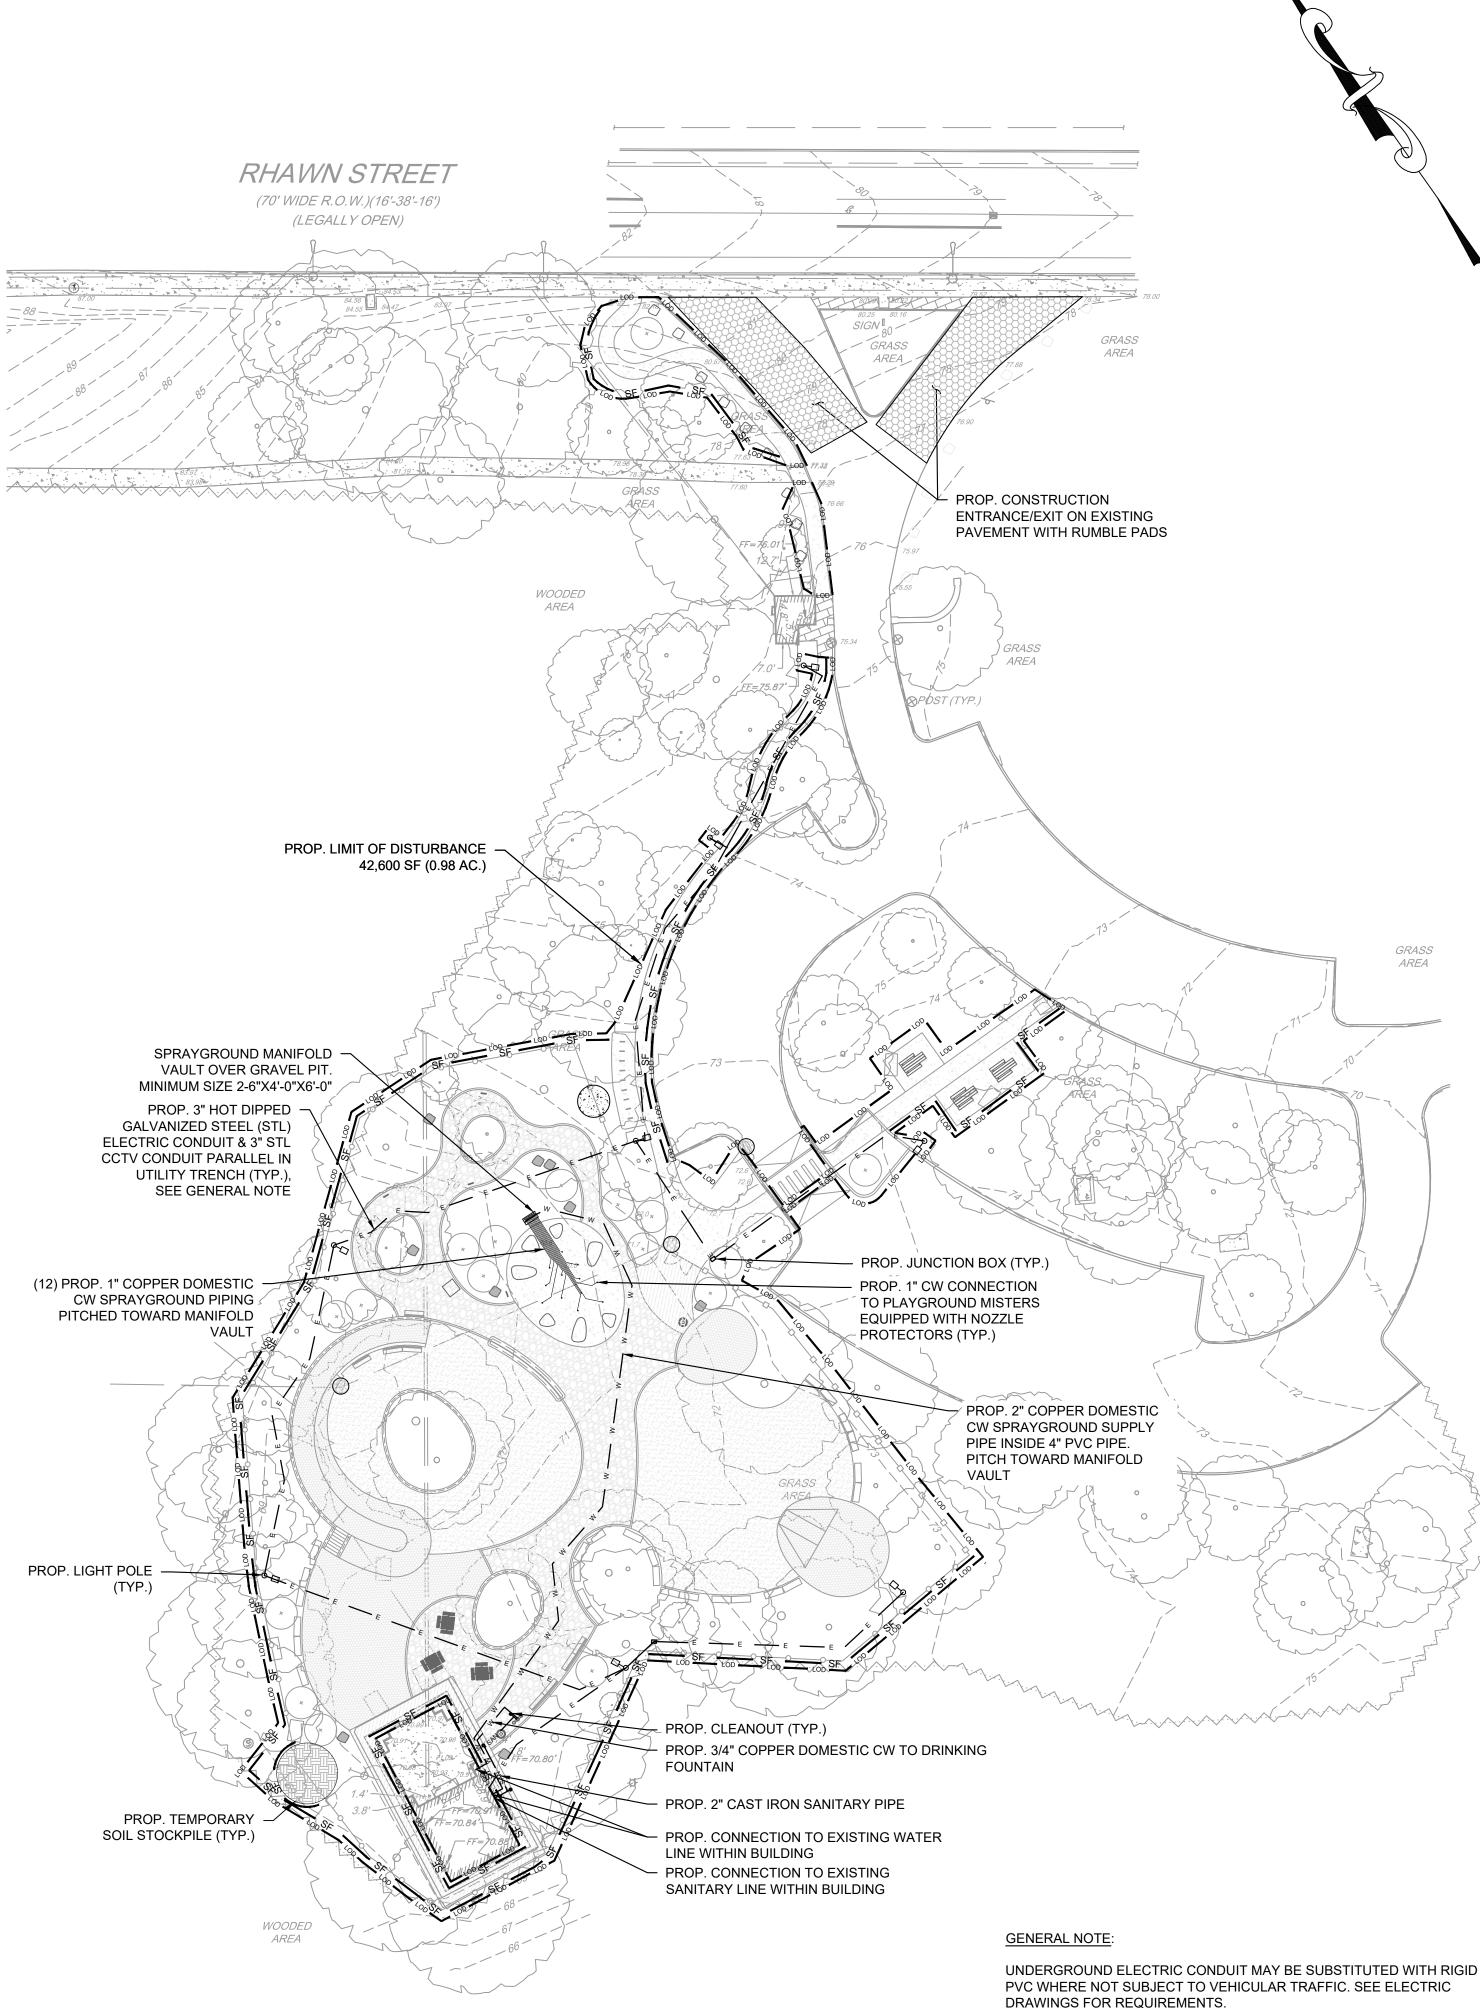

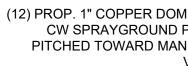

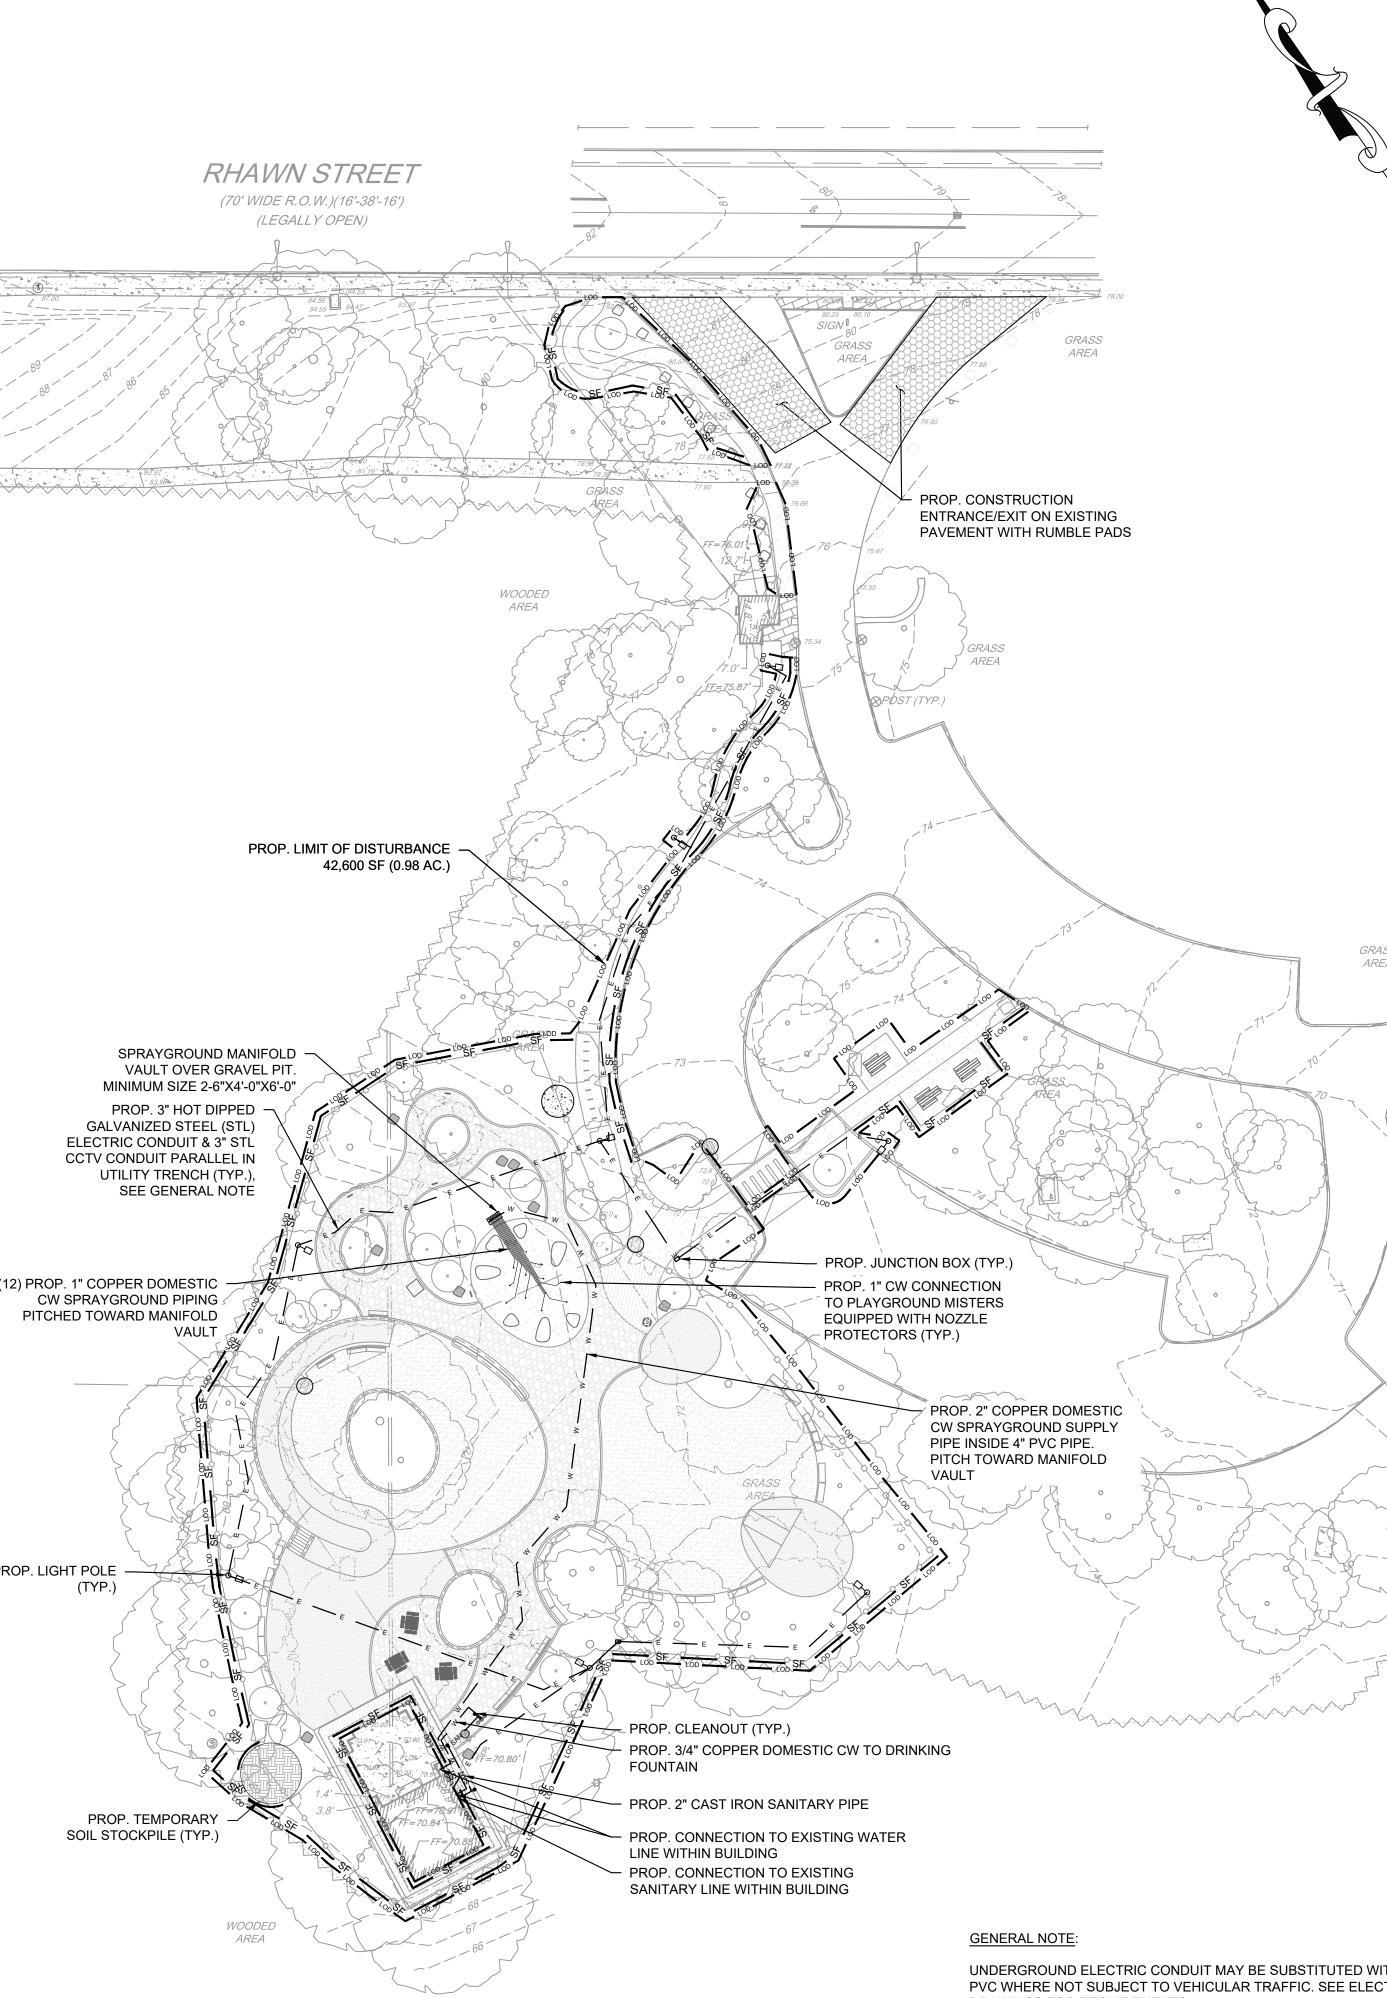


		REVISIONS			NS
	LEGEND	ISSUE	DATE 01.18.24		SUBMISSION
- — — — 78 — — — —	EX. CONTOUR LINES				
<u>MaB</u> MaC	EX. SOIL LINE BOUNDARY				
	EX. PAVEMENT				
	EX. CURB				
	EX. BUILDING				3
	EX. CONCRETE				
	EX. SLATE				
	EX. UTILITY LINES			·······················///////////////	
\bigcirc	EX. TREE		HILADEIPH		
\square	EX. BENCHMARK		DelPH	IA MANI	TO
ğ	EX. HYDRANT				
	EX. LIGHT UTILITY POLE		Q,	A ONE CALL SYSTEM, 25 Irwin Run Road	INC.
			West	Mifflin, Pennsylvania 15122 – 1078	
	PROP. CONCRETE (IMPERVIOUS)		AN A		
	PROP. POROUS CONCRETE (PERVIOUS)			A A A A A A A A A A A A A A A A A A A	
	PROP. CORKEEN (PERVIOUS)		100-12	BEFORE 10	
03030303030303030303	PROP. SAFETY SURFACE (PERVIOUS)		BEFORE) PENNSYLVANIA	OU DIG ANYWHERE IN V CALL 1-800-242-	l 1776
08	PROP. BOUND AGGREGATE (PERVIOUS)		NON-MEMBERS M	IUST BE CONTACTED DIF UIRES THREE WORKING DAYS LITIES BEFORE YOU EXCAVA , BLAST OR DEMOLISH	ECTLY
	PROP. WALLS	PA ONE-CALL N	UMBER (FOR DESIGN		
×	PROP. TREE			- ,	
	- PROP. FENCE	PPR PROJECT	COORDINATOR:		MEGAN FUNK
	- PROP. FENCE	SEAL:			
LOD LOD LOD	PROP. LIMIT OF DISTURBANCE	SEAL.		ONWEALT	\mathbf{X}
SF SF	PROP. SILT FENCE			REGISTERED COR	
	PROP. TEMPORARY SOIL STOCKPILE		EDWAF	RD D. CONFAIR JR	
	PROP. CONSTRUCTION ENTRANCE			ENGINEER	
— E — E — E —	PROP. ELECTRIC LINE		All Sold States	No. PE092932	
www	PROP. WATER SERVICE LINE	SIGNATURE			DATE SIGNED
SAN SAN	PROP. SANITARY LINE		had		04/04/2024
Πø	PROP. LIGHT FIXTURE	Ce	MM TAM	affan	
_		PRIMARY CONS	SULTANT, LANDSCAPE	ARCHITECT:	
		MARVEL	n Street, Floor	3	
		New York,		0	
		SUB-CONSULT/	ANTS:		
		CIVIL/SURVEY:			
			& LAND PLANNING ASS eet, 5th/ Floor	SOCIATES, INC.	
		MEP ENGINEEF			
		417 N 8th Street Philadelphia, PA 267.585.2811			
		LIGHTING DESI			
		600 Chestnut Str Philadelphia, PA	reet, Suite 772 19106		
		COST ESTIMAT ELLANA CONST 32 Broadway, 8T New York, NY 10	RUCTION CONSULTAN H Floor	ITS	
			NING CONSULTANT: NING LANDSCAPES AC	TION NEXTWORK	
		ARBORIST: MORRIS ARBOR 100 East Northwa	estern Avenue		
		Philadelphia, PA	19118		
		Philadelphia, PA 215.247.5777 ACCESSIBILITY CHRIS NOEL christopher.noel(646.632.7344	CONSULTANT:		

THE PROJECT SITE IS WITHIN PENNYPACK PARK SYSTEM AND DOES NOT HAVE IT'S OWN SITE ADDRESS. THEREFORE, THE PENNYPACK PARK SYSTEM'S ADDRESS AND OPA ACCOUNT NUMBER ARE ASSOCIATED WITH THIS PROJECT SITE. THE PROJECT SITE IS LOCATED JUST SOUTH OF THE INTERSECTION OF HOLMEHURST AVE AND RHAWN STREET. APPROXIMATE COORDINATES ARE 40°02'59" N, 75°02'09" W.

ADDRESS: 8300 FRANKFORD AVE PHILADELPHIA, PA 19136 BRT/OPA: 871402520


PHILADELPHIA WATER TRACKING NO .: FY22-PENN-6850-01

PENNSYLVANIA ONE CALL SYSTEM, INC. SITE IDENTIFICATION NO .: 20220322281

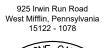



BEFORE YOU DIG ANYWHERE IN PENNSYLVANIA! CALL 1-800-242-1776 NON-MEMBERS MUST BE CONTACTED DIRECTLY PA LAW REQUIRES THREE WORKING DAYS NOTICE TO UTILITIES BEFORE YOU EXCAVATE, DRILL, BLAST OR DEMOLISH

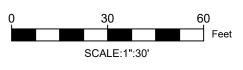

DRAWN BY

CHECKED BY

STUDIO LUDO 1313 S 33rd St, Unit A Philadelphia, PA 19146 CONSULTANT PROJECT NUMBER 2107 **CITY OF PHILADELPHIA** PHILADELPHIA PARKS AND RECREATION 1515 ARCH STREET 11TH FLOOR, ONE PARKWAY BUILDING PPR PROJECT NUMBER 16-21-7062-01 PROJECT TITLE: PENNYPACK PARK UNIVERSAL PLAYGROUND RHAWN ST. & HOLMEHURST AVE. PHILADELPHIA, PA 19136 DRAWING TITLE: UTILITY PLAN PPR PROJECT NO .: DRAWING NO 16-21-7062-01 CONSULTANT PROJECT NO .: 2107 DATE 12/15/2023 **C-600** SCALE: AS NOTED

> ALL DIMENSIONS AND CONDITIONS SHALL BE VERIFIED BY THE CONTRACTOR AT THE SITE BEFORE PROCEEDING WITH THE WORK

GENERAL

- DO NOT SCALE DRAWINGS. CONSULT THE LANDSCAPE ARCHITECT FOR ANSWERS TO ALL QUESTIONS REGARDING DIMENSIONS. THE CONTRACTOR IS ADVISED THAT THIS INFORMATION IS DIAGRAMMATIC AND NOT NECESSARILY COMPLETE.
- 2. THE CONTRACTOR IS ADVISED THAT ALL UTILITY INFORMATION INDICATED HEREIN AND/OR AVAILABLE FROM AGENCIES, PRIVATE UTILITIES AND/OR THE OWNER MAY NOT BE COMPLETE.
- ALL EXISTING CONDITIONS INFORMATION SHOWN IS FOR REFERENCE ONLY. THE CONTRACTOR IS RESPONSIBLE FOR VERIFYING ALL EXISTING CONDITIONS. THE LANDSCAPE ARCHITECT ASSUMES NO RESPONSIBILITY FOR THE SURVEY INFORMATION SHOWN.
- PRIOR TO COMMENCEMENT OF THE WORK, THE CONTRACTOR SHALL VERIFY STATUS OF EXISTING UTILITIES WITHIN THE PROJECT AREA AS REQUIRED BY LOCAL LAW, ALL COMMUNICATIONS AND COORDINATION MEETINGS RELATIVE TO THE PROJECT BETWEEN THE CONTRACTOR AND ANY AGENCY. UTILITY COMPANY OR ORGANIZATION WILL BE CONDUCTED AND/OR APPROVED BY THE CLIENT. THE LANDSCAPE ARCHITECT SHALL RECEIVE NOTIFICATION OF ANY MEETINGS AND COPIES OF ANY AND ALL MINUTES OR COMMUNICATIONS AS A RESULT OF THOSE COMMUNICATIONS OR COORDINATION MEETINGS.
- THE CONTRACTOR SHALL MAKE TEST PITS AS REQUIRED TO VERIFY LOCATIONS AND ELEVATIONS OF UTILITIES AND OTHER SUBSURFACE ELEMENTS AS THE WORK PROGRESSES. SUCH WORK SHALL BE DEEMED TO BE INCLUDED IN THE LUMP SUM BUD FOR THE PROJECT. ALL WORK SHALL COMPLY WITH APPLICABLE BUILDING CODE AND LOCAL LAWS.
- 6. THE CONTRACTOR SHALL COORDINATE ALL WORK WITH THE CLIENT, PRIVATE UTILITY COMPANIES, AND THE CITY AGENCIES AS REQUIRED FOR THE EXPEDITIOUS **EXECUTION OF WORK.**
- IT IS THE CONTRACTOR'S RESPONSIBILITY TO FAMILIARIZE THEMSELVES WITH ALL THE EXISTING FIELD CONDITIONS ADJACENT TO THE SITE INCLUDING BUT NOT LIMITED TO ALL STRUCTURES, UTILITIES, FENCES, PAVEMENTS, SHRUBS, TREES, LIGHT POSTS, ETC, THROUGHOUT THE DURATION OF THE WORK, IT SHALL BE THE CONTRACTOR'S RESPONSIBILITY TO PROTECT AND MAINTAIN ALL EXISTING CONDITIONS ADJACENT TO THE SITE, OR AS INDICATED ON CONTRACT DRAWINGS. IN THE EVENT THE CONTRACTOR'S OPERATIONS RESULT IN DAMAGE TO EXISTING CONDITIONS ADJACENT TO THE SITE, OR CONDITIONS INDICATED TO REMAIN ON CONTRACT DRAWINGS, THE CONTRACTOR SHALL REPAIR AND CORRECT ALL DAMAGES TO THE SATISFACTION OF THE CLIENT AT NO EXTRA COST.
- CHANGES IN THE WORK; ALL REQUESTS FOR CHANGES AND/OR SUBSTITUTIONS IN THE WORK SHALL BE MADE IN WRITING TO THE PHILADELPHIA PARKS AND RECREATION DEPARTMENT (PPR) AND THE LANDSCAPE ARCHITECT.
- 9. THE CONTRACTOR SHALL STUDY THE INTERRELATIONSHIP OF ALL THE VARIOUS ELEMENTS OF CONSTRUCTION SHOWN ON THE CONTRACT DRAWINGS AND DESCRIBED IN THE PROJECT SPECIFICATIONS AND BULLETINS, AND SHALL COORDINATE THEIR CONSTRUCTION OPERATIONS ACCORDINGLY. ANY CONFLICTS WHICH MAY BECOME APPARENT FROM THE COORDINATION STUDY SHALL BE IMMEDIATELY BROUGHT TO THE ATTENTION OF THE LANDSCAPE ARCHITECT.
- ALL NEW AND EXISTING INLETS, BASINS, AND CONNECTIONS WITHIN THE LIMITS OF THIS CONTRACT ARE TO BE CLEANED, FLUSHED, AND OTHERWISE MADE OPERABLE TO THE SATISFACTION OF THE CLIENT AND ARE TO BE INCLUDED IN THE LUMP SUM BID.
- 11. PRIOR TO COMMENCEMENT OF WORK, THE CONTRACTOR SHALL BRING CONDITIONS WHICH CONFLICT WITH PROPOSED GRADING AND SITE CONSTRUCTION TO THE ATTENTION OF THE LANDSCAPE ARCHITECT AND THE CLIENT.
- 12. ANY COST CAUSED BY DEFECTIVE OR ILL-TIMED WORK, IMPROPER SCHEDULING OR DELINQUENT ORDERING SHALL BE BORNE BY THE CONTRACTOR.
- 13. ANY REQUIRED APPROVALS FROM ALL CITY AGENCIES HAVING JURISDICTION, AS WELL AS FROM PRIVATE UTILITY COMPANIES, MUST BE OBTAINED PRIOR TO ACCEPTANCE OF THE PROJECT BY THE CLIENT.
- ALL MECHANICAL EQUIPMENT, CONCEALED WATER AND GAS VALVES, ETC. TO REMAIN UNLESS OTHERWISE SPECIFICALLY NOTED.
- MINOR DETAILS NOT USUALLY SHOWN OR SPECIFIED, BUT NECESSARY FOR 15. PROPER CONSTRUCTION OF ANY PART OF THE WORK SHALL BE INCLUDED AS IF THEY WERE INDICATED ON THE DRAWINGS.
- 16. AT ALL TIMES, THE SITE SHALL BE KEPT NEAT, AND KEPT FREE OF DEBRIS LEFT FROM ALL CONSTRUCTION OPERATIONS. IT SHALL BE THE CONTRACTOR'S RESPONSIBILITY TO PRESERVE AND PROTECT ALL WORK FINISHED OR IN PROGRESS, AND TO PROTECT THE PUBLIC FROM ANY INJURY THAT MAY OCCUR AS A RESULT OF THE SITE BEING ACCESSIBLE DURING PROJECT CONSTRUCTION.
- 17. UNLESS OTHERWISE NOTED. DETAILED DRAWINGS AND PART PLANS SHALL HAVE PRECEDENCE OVER LAYOUT DRAWINGS (I.E. SITE PLAN) FOR ACCURACY OF INFORMATION.
- 18. SEE PROJECT SPECIFICATIONS FOR REQUIRED SUBMITTALS.
- 19. THE SHOP DRAWINGS SUBMITTED BY THE CONTRACTOR SHALL SHOW ALL FASTENING DEVICES AND LOCATIONS COMPLETE WITH FASTENINGS TO ALL FOUNDATION WALLS AND PAVEMENTS. THE SHOP DRAWINGS SHALL PROVIDE SUFFICIENT DETAIL TO ALLOW THE LANDSCAPE ARCHITECT TO REVIEW AND APPROVE THE SYSTEM AND PIECES.
- 20. IT SHALL BE THE CONTRACTOR'S RESPONSIBILITY TO GUARANTEE ANY AND ALL ANCHORING SYSTEMS FOR ALL WORK.
- 21. THE CONTRACTOR SHALL INSTALL GALVANIZED STEEL PIPE SLEEVES AS REQUIRED TO INSTALL UTILITY WORK THROUGH CONCRETE AND MASONRY FOOTINGS AND FOUNDATIONS. ALL PIPE SLEEVES SHALL BE SCHEDULE 40 PIPE AND BE TWICE THE DIAMETER OF THE UTILITY PIPE UNLESS OTHERWISE NOTED.
- 22. CONCRETE FOR CURBS, FOOTINGS, AND WALLS COMPLY WITH STRUCTURAL AND ARCHITECTURAL SPECIFICATIONS FOR CAST-IN-PLACE CONCRETE WORK.
- 23. THE CONTRACTOR SHALL PROVIDE AND MAINTAIN SAFE ACCESS TO ALL BUILDING ENTRANCES AT ALL TIMES DURING THE CONSTRUCTION PERIOD.
- 24. PAVER SYSTEMS SHALL MEET (ADJACENT) ALTERNATE MATERIAL PAVEMENTS FLUSH. THE CONTRACTOR SHALL VERIFY THE INTERIOR GRADES AND THEIR RELATIONSHIP WITH THE PROPOSED GRADES. THE CLIENT SHALL BE NOTIFIED IF THERE ARE ANY DISCREPANCIES IN THE ELEVATIONS. ADJUSTMENTS SHALL BE MADE AS NECESSARY AND SHALL BE APPROVED BY THE OWNER PRIOR TO CONSTRUCTION.
- EXISTING DRAINS/VALVE COVERS, ETC. SHALL BE ADJUSTED AS NECESSARY IN AREAS WHERE PROPOSED WORK IS TO BE INSTALLED.
- 26. CONCRETE CURBS/FOOTINGS FOR ALL FENCING AND WALLS SHALL BRIDGE OVER ANY EXISTING DRAIN INLETS AND UTILITIES AND SHALL BE BROUGHT TO THE ATTENTION OF THE CLIENT AND THE LANDSCAPE ARCHITECT.
- 27. CONTRACTOR SHALL SUPPLY THE CLIENT WITH MANUFACTURER'S SHOP DRAWINGS AND INSTALLATION DRAWINGS PRIOR TO THE INSTALLATION OF ANY SPECIFIED ITEM.
- 28. CONTRACTOR IS REQUIRED TO OBTAIN ALL PERMITS FOR WORK UNDER THIS CONTRACT.
- 29. CONTRACTOR IS RESPONSIBLE FOR SCHEDULING ALL NECESSARY INSPECTIONS WITH DEPARTMENT OF LICENSURE AND INSPECTIONS (L&I), INCLUDING FINAL INSPECTION AND PERMIT CLOSEOUT.

DEMOLITION AND REMOVALS

1. THE CONTRACTOR IS RESPONSIBLE FOR COORDINATION BETWEEN THE EXISTING

CONDITIONS AND THE LANDSCAPE PLAN IN PREPARING BIDS AND EXECUTING WORK.

- 2. IT IS THE CONTRACTOR'S RESPONSIBILITY TO PRESERVE AND PROTECT ALL EXISTING FACILITIES NOT SPECIFICALLY STATED FOR REMOVAL WITHIN THE WORK ARFA
- 3. IT IS THE CONTRACTOR'S RESPONSIBILITY TO LOCATE AND VERIFY ELEVATIONS OF ALL UTILITY/MECHANICAL STRUCTURES, AND UTILITY LINES. IT IS THE CONTRACTOR'S RESPONSIBILITY TO PROTECT THE UTILITY/MECHANICAL LINES AND CONDUITS/PIPES DURING REMOVALS AND CONSTRUCTION. DAMAGE TO UTILITIES SHALL BE REPAIRED AT THE CONTRACTOR'S EXPENSE SUBJECT TO LANDSCAPE ARCHITECT AND THE CLIENT'S APPROVAL.
- 4. THE CONTRACTOR SHALL, AS PART OF THEIR CONTRACTUAL OBLIGATIONS, REMOVE AS DIRECTED, ALL BALLAST AGGREGATE AND OTHER ENCROACHMENTS THAT INTERFERE WITH LANDSCAPE WORK.
- 5. ALL REMOVED MATERIAL NOT STATED FOR REUSE SHALL BE REMOVED FROM THE SITE AND SHALL NOT BE MIXED WITH NEW FILL OR GRAVEL TO BE BROUGHT ON SITE.
- 6. REMOVE ALL EXISTING RUBBLE, DEBRIS, AND ENCROACHMENT FROM THE SITE AND DISPOSE OF LEGALLY. EVIDENCE OF LEGAL DISPOSAL SHALL BE GIVEN BY THE CONTRACTOR TO THE LANDSCAPE ARCHITECT AND THE CLIENT.
- 7. IT SHALL BE THE CONTRACTOR'S RESPONSIBILITY AS PART OF THIS CONTRACT TO DETERMINE THE MOST APPROPRIATE METHOD OF REMOVALS OF EXCAVATED AND/OR DEMOLITION MATERIALS FROM THE SITE WITHIN THE CONTRACT LIMIT REMOVALS WHETHER BY MACHINE OR BY HAND SHALL BE INCLUDED IN THE CONTRACTOR'S PROPOSAL. STRIP EXISTING BALLAST AGGREGATE IN AREAS OF CONSTRUCTION AND STOCKPILE FOR FUTURE RE-USE, IF APPROVED, AS MAY BE REQUIRED.

WATER SUPPLY / MAINTENANCE WORK

- 1. THE CONTRACTOR SHALL LOCATE ALL EXISTING VALVE BOXES WITHIN THE CONTRACT LIMIT LINES AND SHALL INDICATED THEM IN THE FIELD TO THE SATISFACTION OF THE LANDSCAPE ARCHITECT. FURTHERMORE, THE CONTRACTOR'S ATTENTION IS DIRECTED TO THE FACT THAT THEY WILL BE **RESPONSIBLE FOR THE REPLACEMENT AND RESETTING OF ALL VALVE BOXES NOT** STATED FOR REMOVAL WHICH, ARE DAMAGED OR DISTURBED AS A RESULT OF THEIR OPERATIONS, SUBJECT TO APPROVAL OF THE LANDSCAPE ARCHITECT.
- ALL EXISTING DRAIN AND WATER SUPPLY CONNECTIONS SHOULD BE CONTINUOUSLY MAINTAINED DURING CONSTRUCTION OF ANY WATER LINES. IF ANY HOUSE CONNECTION MUST BE DISCONNECTED FOR CONSTRUCTION PURPOSES, FLOW MUST BE MAINTAINED BY PLUMBING OR OTHER SUITABLE MEANS AS DIRECTED BY THE LANDSCAPE ARCHITECT, AND IN SUCH A MANNER THAT NO BACK-UPS OCCUR. ANY AND ALL EXISTING HOUSE CONNECTIONS OR OTHER SEWER APPURTENANCES WHICH ARE TO REMAIN AND WHICH MUST BE DISTURBED FOR CONSTRUCTION PURPOSES SHALL BE RESTORED TO THEIR PRESENT CONNECTIONS AFTER COMPLETION OF THE WORK SUBJECT TO APPROVAL OF LANDSCAPE ARCHITECT AND THE CLIENT. ANY DAMAGE DONE AS A RESULT OF THE WORK SHALL BE REPAIRED AT NO COST TO THE CLIENT.

DRAINAGE WORK

- 1. ALL PROPOSED DRAINAGE WORK SHALL BE DONE IN CONFORMANCE WITH THE LATEST STANDARDS ANY OTHER APPLICABLE CODES.
- ALL AREA DRAINS WITHIN THE CONTRACT LIMITS SHALL BE ADJUSTED AS NECESSARY, SO THAT THEY WILL BE OPERATIONAL, ACCESSIBLE, AND CONCEALED FROM PROJECTS OCCUPANTS AFTER THE COMPLETION OF THE WORK.
- ANY DAMAGE TO EXISTING AREA DRAINS, AND CONNECTIONS CAUSED BY THE CONTRACTOR'S WORK SHALL BE REPAIRED OR REPLACED BY THE CONTRACTOR, AT NO COST TO THE CLIENT, SUBJECT TO THE APPROVAL OF THE LANDSCAPE ARCHITECT AND THE CLIENT.
- 4. ALL EXISTING AREA DRAINS AND CONNECTIONS WITHIN THE LIMITS OF THIS CONTRACT AND CONTIGUOUS ARE TO BE CLEANED OUT, REPAIRED, AND OTHERWISE MADE OPERABLE TO THE SATISFACTION OF THE LANDSCAPE ARCHITECT

LAYOUT PLANS, L-100 SERIES

- 1. CONTRACTOR SHALL LAYOUT AND STAKE IN THE FIELD THE ALIGNMENT AND GRADE OF ALL CURBS, PAVEMENTS AND ALL OTHER SITE ELEMENTS FOR REVIEW AND APPROVAL BY THE LANDSCAPE ARCHITECT PRIOR TO THE INSTALLATION.
- 2. THE CONTRACTOR SHALL VERIFY ALL EXISTING SITE CONDITIONS, BOTH ABOVE AND BELOW THE SURFACE. ANY DISCREPANCIES BETWEEN INFORMATION SHOWN ON THE DRAWINGS AND ACTUAL FIELD CONDITIONS SHALL BE BROUGHT TO THE ATTENTION OF THE LANDSCAPE ARCHITECT IN WRITING, PRIOR TO COMMENCEMENT OF WORK.
- NO CHANGES SHALL BE MADE TO THE DESIGN OR LAYOUT WITHOUT THE WRITTEN APPROVAL OF THE LANDSCAPE ARCHITECT. THE CONTRACTOR SHALL LAYOUT THE WORK AS DIMENSIONED ON THE PLANS. WRITTEN DIMENSIONS SHALL GOVERN. DO NOT SCALE DISTANCES.

PAVING PLANS, L-200 SERIES

- 1. THE CONTRACTOR SHALL USE CARE DURING CONSTRUCTION TO AVOID DISTURBING OR DAMAGING ADJACENT STRUCTURES, EITHER SUB-GRADE OR ABOVE-GRADE. THE CONTRACTOR SHALL NOTIFY THE CLIENT OF DAMAGE IMMEDIATELY. CLIENT APPROVAL IS REQUIRED PRIOR TO PERFORMING ANY REPAIRS, REPLACEMENTS, OR RESTORATIONS. ANY DAMAGE TO EXISTING STRUCTURES RESULTING FROM CONSTRUCTION SHALL BE THE CONTRACTOR'S **RESPONSIBILITY AND SHALL BE RESTORED AT THE CONTRACTOR'S EXPENSE TO** THE SATISFACTION OF THE OWNER.
- THE CONTRACTOR SHALL BE RESPONSIBLE FOR COORDINATING WORK WITH THE WORK OF OTHER CONTRACTORS AND SUBCONTRACTORS ON SITE, SUCH AS IRRIGATION, ELECTRICIAN, CARPENTERS, PLUMBERS, AND SPECIALTY TRADES. COMPLY WITH REQUIREMENTS AND SCHEDULE OF GENERAL CONTRACTOR.
- WORK SHALL INCLUDE, BUT NOT BE LIMITED TO CONSTRUCTION OF PAVEMENTS, 3. CURBS, WALKS, STEPS, WALLS, RAILINGS, FENCING, STRUCTURES, LIGHTING, MANUFACTURED SOILS AND OTHER ELEMENTS, DAILY CLEAN-UP, MAINTENANCE AND GUARANTEE.
- 4. VERIFY ALL DIMENSIONS AND GRADES IN THE FIELD AND NOTIFY LANDSCAPE ARCHITECT OF ANY DISCREPANCIES IMMEDIATELY.
- 5. SECURE ALL REQUIRED PERMITS AND APPROVALS FROM LOCAL OR SUPERVISORY AUTHORITIES. POST ON THE SITE OR HAVE AVAILABLE FOR REVIEW BY INSPECTORS.
- 6. KEEP THE SITE CLEAN AND NEAT; REGULARLY WATER DOWN WORK ROADS AND AREAS ADJACENT TO THE SITE TO KEEP THEM FREE OF DUST AND AIR-BORNE POLLUTANTS.
- 7. DECISIONS REGARDING ALL QUESTIONS WHICH MAY ARISE AS TO THE QUALITY OF ACCEPTABILITY OF MATERIALS FURNISHED, WORK PERFORMED, PROGRESS OF THE WORK, INTERPRETATION OF DRAWINGS AND SPECIFICATIONS, AND ALL QUESTIONS AS TO ACCEPTABLE FULFILLMENT OF THE CONTRACT BY THE CONTRACTOR SHALL BE MADE BY THE LANDSCAPE ARCHITECT.
- ALL WORK AND MATERIALS REJECTED BY THE LANDSCAPE ARCHITECT AS FAILING TO COMPLY WITH THE CONTRACT DOCUMENTS SHALL BE PROMPTLY REMOVED, REPLACED, AND/OR RE-EXECUTED BY THE CONTRACTOR TO BRING IT INTO COMPLIANCE WITH THE REQUIREMENTS. THIS SHALL BE DONE AT THE EXPENSE OF THE CONTRACTOR WITHOUT COST TO THE OWNER AND SHALL INCLUDE MAKING

GOOD ALL WORK OF THE CONTRACTOR AND OTHER CONTRACTORS DESTROYED.

PLANTING PLAN, L-600

1. SEE L-910 FOR PLANTING DETAILS.

- 2. PLANT GROUPINGS AND LOCATIONS ARE DIAGRAMMATIC THE LOCATION OF PLANTS SHALL BE APPROVED IN THE FIELD BY THE LANDSCAPE ARCHITECT.
- 3. ALL PLANTS SHALL BE PLANTED AT THE TIME OF DELIVERY DUE TO LIMITED STORAGE ON SITE. PLANTS IN THE SAME PLANTING BED SHALL BE PLANTED AT THE SAME TIME. ANY PLANTS REMAINING UNPLANTED ON THE SITE FOR MORE THAN 24 HOURS SHALL BE PROTECTED AND MAINTAINED INCLUDING BUT NOT LIMITED TO WATER AND SHADE. ANY DAMAGED PLANTS SHALL BE REPLACED AS DIRECTED, AT THE CONTRACTOR'S EXPENSE.
- THERE WILL BE NO SUBSTITUTIONS OF PLANT MATERIAL WITHOUT PRIOR WRITTEN APPROVAL BY THE LANDSCAPE ARCHITECT.
- CONTRACTOR SHALL IMPLEMENT THE PLANTING PLAN AS SHOWN. PLANTS SHALL BE LOCATED AS CLOSE AS POSSIBLE TO LAYOUT PROVIDED OR AS DIRECTED IN THE FIELD BY THE LANDSCAPE ARCHITECT.
- 6. PLANTING BEDS SHALL RECEIVE A MIN. 2" THICK LAYER OF SHREDDED HARDWOOD MULCH, AS INDICATED ON THE PLANTING DETAILS AND SPECS.
- PRIOR TO COMMENCING PLANTING, THE CONTRACTOR SHALL STAKE OUT THE EXACT LOCATION OF THE ALL TREES FOR THE LANDSCAPE ARCHITECT'S APPROVAL. ALL PLANTING OPERATIONS AND LAYOUT SHALL PROCEED UNDER CLOSE COORDINATION WITH THE LANDSCAPE ARCHITECT. TREE LOCATIONS MAY VARY AS DIRECTED BY THE LANDSCAPE ARCHITECT IN THE FIELD. THE ACTUAL LOCATION OF PLANT MATERIALS MAY VARY DUE TO FIELD CONDITIONS. FINAL PLACEMENT OF PLANT MATERIAL SHALL BE APPROVED BEFORE PITS ARE DUG. IF INITIAL PLACEMENT IS NOT SATISFACTORY, PLANTS SHALL BE RELOCATED IN THE FIELD AT THE DIRECTION OF THE LANDSCAPE ARCHITECT, AT NO ADDITIONAL COST TO THE OWNER.
- MATERIAL WILL BE INSPECTED AND APPROVED AT PLACE OF GROWTH BY THE LANDSCAPE ARCHITECT. HOWEVER, PLANT MATERIAL WHICH HAS BECOME DAMAGED OR DISEASED OR WHICH IS UNACCEPTABLE TO THE LANDSCAPE ARCHITECT MAY BE REJECTED UPON DELIVERY TO THE SITE.
- 9. SHOULD THERE BE ANY DISCREPANCIES BETWEEN THE QUANTITIES CALLED FOR ON THE PLANT LIST AND THOSE INDICATED ON THE PLAN, THE GREATER QUANTITY SHALL GOVERN.
- 10. AT ALL TIMES, THE SITE SHALL BE KEPT NEAT AND FREE OF DEBRIS LEFT FROM THE PLANTING OPERATION.
- 11. ALL PLANT MATERIAL TO BE VIGOROUS, AND FREE OF INJURY OR DEFECTS. ALL PLANT MATERIAL TO BE TRUE REPRESENTATIVES OF THEIR SPECIES.
- 12. ALL PLANT TAGS MUST REMAIN ON THE PLANT MATERIAL UNTIL THE LANDSCAPE ARCHITECT REVIEWS THE LAYOUT AND APPROVES QUANTITIES.
- 13. ALL TREES TO INCLUDE A 1 YEAR FULL REPLACEMENT WARRANTY.

LIGHTING NOTES:

- ALL LIGHTING FIXTURES, LAMPS AND RELATED DEVICES FURNISHED UNDER THIS CONTRACT SHALL CARRY THE APPROVAL LABEL OF UL OR ETL FOR THE SPECIFIC APPLICATION IN WHICH THEY ARE USED.
- 2. THE STATEMENT "FINISH TO BE SELECTED BY DESIGN PROFESSIONAL" SHALL BE INTERPRETED TO MEAN THAT THE FINISH OF THE LUMINAIRE SHALL MATCH THE APPEARANCE OF A PAINT CHIP, COLOR NUMBER, OR METAL SWATCH FURNISHED BY THE DESIGN PROFESSIONAL DURING THE SUBMITTAL REVIEW PROCESS.
- CONTRACTOR SHALL CONFIRM FIXTURE VOLTAGES AND MOUNTING HARDWARE ARE 3 COMPATIBLE WITH THEIR APPLICATION AS DETERMINED BY THE DESIGN PROFESSIONAL PRIOR TO ORDERING FIXTURES.
- CONTRACTOR SHALL PROVIDE ALL MOUNTING HARDWARE AS REQUIRED FOR FIXTURE INSTALLATION.
- DIMMING RANGES IDENTIFIED IN THE LIGHTING FIXTURES INDICATE THE REQUIRED LOW END DIMMING. ALL LIGHTING EQUIPMENT IDENTIFIED AS DIMMABLE SHALL PROVIDE SMOOTH, CONTINUOUS DIMMING FROM 100% POWER OUTPUT TO THE LOW-END PERCENTAGE OF POWER OUTPUT IDENTIFIED IN THE FIXTURE SCHEDULE.
- 6. LED CHROMATICITY AND COLOR RENDERING INDEX (CRI): WHITE LEDS SHALL MEET, AT A MINIMUM, CHROMATICITY STANDARDS SET BY ANSI/NEMA/ANSLG C78.377-2015.

UNLESS OTHERWISE NOTED, THE COLOR RENDERING INDEX (CRI) FOR LED EQUIPMENT SHALL MEET THE FOLLOWING MINIMUM REQUIREMENTS: EXTERIOR LUMINAIRES >/ 70 CRI

INTERIOR LUMINAIRES >/ 80 CRI LED LUMEN MAINTENANCE (L70): LED LUMEN MAINTENANCE SHALL BE MEASURED IN ACCORDANCE WITH IESNA LM-80 STANDARDS. PHOTOMETRIC TESTING FOR SOLID STATE LUMINAIRES SHALL BE IN ACCORDANCE WITH IESNA LM-79 STANDARDS.

UNLESS OTHERWISE NOTED, THE LUMEN MAINTENANCE (L70) RATED LIFETIME FOR LED EQUIPMENT SHALL MEET THE FOLLOWING MINIMUM REQUIREMENTS:

INTEGRATED LED CHIP-BASED LUMINAIRES >/ 50,000 HOURS LINEAR FLUORESCENT LED TUBES >/_ 35,000 HOURS SCREW-BASE, GU10 BASE & PIN BASE LED LAMPS >/ 25,000 HOURS WEDGE-BASE LED LAMPS >/_ 8,000 HOURS

- 8. LED WARRANTY: UNLESS OTHERWISE INDICATED, ALL LIGHTING EQUIPMENT WITH INTEGRATED LED LIGHT ENGINES SHALL PROVIDE A MINIMUM 5-YEAR MANUFACTURER WARRANTY ON THE LED LIGHT ENGINE AND ASSOCIATED DRIVER(S). ALL SELF-CONTAINED LED LAMPS (SCREW-BASE, PIN-BASE) SHALL PROVIDE A MINIMUM 3-YEAR WARRANTY ON THE LAMP MODULE.
- 9. CONTRACTOR SHALL SELECT, FURNISH AND INSTALL THE CORRECT SIZE OF SECONDARY WIRING FROM REMOTE TRANSFORMERS AND/OR REMOTE BALLASTS AS REQUIRED TO KEEP VOLTAGE DROP IN THE SECONDARY WIRING BELOW 3% OF RATED VOLTAGE.
- 10. CONTRACTOR SHALL PROVIDE LABOR AND EQUIPMENT FOR FOCUSING OF ADJUSTABLE FIXTURES AND PRESETTING OF LIGHTING CONTROL SYSTEMS. FOCUSING AND PRESETTING SHALL BE DONE IN THE PRESENCE OF THE DESIGN PROFESSIONAL. CONTRACTOR SHALL FOCUS LIGHTING AFTER DARK IF DIRECTED BY THE OWNER'S REPRESENTATIVE. UNLESS OTHERWISE NOTED, CONTRACTOR SHALL PROVIDE AT LEAST ONE DAY OF A FACTORY-TRAINED AND CERTIFIED TECHNICIAN TO PROVIDE WARRANTY START UP AND PROGRAMMING FOR ALL LIGHTING CONTROL SYSTEMS AND PROGRAMMABLE LIGHTING FIXTURES.
- 11. CONTRACTOR SHALL PROVIDE THE FOLLOWING WITH THEIR BID: 11.a. THE UNIT PRICE, WITHOUT LAMP, FOR EACH LIGHTING FIXTURE TYPE LISTED WITHIN THE LIGHTING FIXTURE SCHEDULE. THE UNIT PRICE SHALL BE FOR ONE OF THE LISTED MANUFACTURER'S FOR THAT PARTICULAR FIXTURE. THE MANUFACTURER SHALL BE IDENTIFIED. SUBSTITUTIONS FOR FIXTURES PROVIDED BY MANUFACTURERS NOT LISTED IN THE SCHEDULE ARE NOT ACCEPTABLE. SEE BELOW FOR REQUIREMENTS ASSOCIATED WITH SUBMITTING LIGHTING FIXTURE SUBSTITUTIONS. 11.b. THE TOTAL QUANTITY OF EACH FIXTURE TYPE WITH THE EXTENDED COST FOR THAT QUANTITY
- 11.c. THE UNIT PRICE, TYPE, AND QUANTITY OF LAMPS.
- 12. WITHIN 21 DAYS OF CONTRACT AWARD, THE CONTRACTOR SHALL FURNISH SUBMITTALS FOR ALL SPECIFIED LIGHTING FIXTURES FOR REVIEW BY THE DESIGN PROFESSIONAL. THE SUBMITTALS SHALL INCLUDE LUMINAIRE CATALOG CUTS, SUBMITTAL SHEETS, OR MANUFACTURERS SHOP DRAWINGS INDICATING THE FOLLOWING: 12.a. MANUFACTURER'S NAME AND COMPLETE CATALOG NUMBER
- 12.b. FIXTURE TYPE, DIMENSIONS AND FINISHES
- 12.c. FIXTURE PHOTOMETRIC TEST DATA FROM AN INDEPENDENT TEST LABORATORY

12.d. FIXTURE ACCESSORIES, COMPONENTS, AND HARDWARE WHEN SPECIFIED LAMP TYPE, QUANTITY, WATTAGE, LUMEN OUTPUT, RATED LIFE, COLOR 12.e. TEMPERATURE, COLOR RENDERING INDEX AND BEAM SPREAD AS APPLICABLE

- BALLAST TYPE AND FIXTURE VOLTAGE 12.f.
- 13. LIGHTING FIXTURE SUBSTITUTION REQUESTS MUST BE SENT TO AND RECEIVED BY THE LIGHTING DESIGNER FOR REVIEW 14 DAYS PRIOR TO BID DATE. FAILURE TO SUBMIT WITHIN THIS DEADLINE SHALL CONSTITUTE A GUARANTEE THAT THE SPECIFIED FIXTURES
- WILL BE SUPPLIED. THE SUBMITTAL SHALL INCLUDE THE FOLLOWING: 13.a. SIX HARD COPIES OF THE SUBMITTALS REQUIRED ABOVE FOR BOTH THE SPECIFIED
- FIXTURE AND THE PROPOSED SUBSTITUTION.
- 13.b. ONE NON-RETURNABLE WORKING SAMPLE OF THE PROPOSED SUBSTITUTE FIXTURE WITH CORD & PLUG CONNECTION FOR 120 VOLT OPERATION, AND SPECIFIED LAMP(S) 13.c. CONTRACTOR'S STATEMENT INDICATING THE EFFECT OF THE SUBSTITUTION ON THE CONSTRUCTION SCHEDULE COMPARED TO THE SCHEDULE WITHOUT THE APPROVAL
- OF THE PROPOSED SUBSTITUTION. 13.d. CONTRACTOR'S CERTIFICATION STATING THAT THE PROPOSED SUBSTITUTION CONFORMS TO THE REQUIREMENTS OF THE CONTRACT DOCUMENTS IN EVERY RESPECT AND IS APPROPRIATE FOR THE APPLICATIONS INDICATED IN THE
- DOCUMENTS 13.e. CONTRACTOR'S CERTIFICATION STATING THAT ANY MODIFICATIONS TO ANY BUILDING SYSTEM OR EQUIPMENT THAT MAY RESULT FROM THE PROPOSED LIGHTING FIXTURE SUBSTITUTION WILL BE DESIGNED AND CONSTRUCTED AT THE CONTRACTOR'S
- EXPENSE 13.f. CONTRACTOR'S WAIVER OF RIGHTS TO ADDITIONAL PAYMENT OR TIME THAT MAY BECOME NECESSARY SHOULD THE PROPOSED SUBSTITUTION FAIL TO PERFORM IN A
- MANNER THAT MATCHES THE SPECIFIED FIXTURE. 13.g. CONTRACTOR-NET UNIT PRICE FOR THE SPECIFIED FIXTURE AND FOR THE PROPOSED SUBSTITUTE FIXTURE.

THE LIGHTING DESIGNER SHALL BE REIMBURSED BY THE CONTRACTOR FOR ALL OF THE DESIGNER'S TIME ASSOCIATED WITH THE REVIEW OF THE PROPOSED FIXTURE SUBSTITUTION(S). PAYMENT SHALL BE MADE IN ADVANCE OF THE REVIEW. BASED ON THE DESIGNER'S ESTIMATE OF THE REQUIRED TIME. THE PAYMENT SHALL BE BASED ON THE DESIGNER'S STANDARD HOURLY RATES FOR THE PERSONNEL INVOLVED IN THE REVIEW.

LIGHTING DEFINITIONS:


- CORRELATED COLOR TEMPERATURE (CCT): THE ABSOLUTE TEMPERATURE, MEASURED IN DEGREES KELVIN, OF A BLACKBODY RADIATOR HAVING CHROMATICITY RESEMBLING THAT OF AN ELECTRIC LIGHT SOURCE. FOR LED SOURCES CCT SHALL NOT DEVIATE FROM THE REFERENCE COLOR TEMPERATURE BY NO MORE THAN THREE MACADAM ELLIPSES, AS DEFINED BY NEMA/ANSI/ANSLG C78.377-2015.
- COLOR RENDERING INDEX (CRI): MEASURE OF COLOR SHIFT OBJECTS UNDERGO WHEN ILLUMINATED BY AN ELECTRIC LIGHT SOURCE AS COMPARED WITH THE COLOR OF THE SAME OBJECTS ILLUMINATED BY A REFERENCE SOURCE AT THE SAME COLOR TEMPERATURE. CRI VALUES FOR ELECTRIC LIGHT SOURCES RANGE FROM APPROXIMATELY 20 (LOW PRESSURE SODIUM) TO 99 (HALOGEN). CRI VALUES FOR LED SOURCES SHALL BE MEASURED AFTER 6000 HOURS AND SHALL NOT DEVIATE MORE THAN **3 POINTS FROM THE RATED VALUE.**
- LED LIGHT ENGINE: THE COMBINED LED LIGHT SOURCE AND ITS ASSOCIATED ELECTRONIC DRIVER. THE LED LIGHT ENGINE MAY HAVE AN INTEGRAL DRIVER OR THE DRIVER MAY BE HOUSED IN A SEPARATE ENCLOSURE.
- LED DRIVER: CONTROL DEVICE THAT MAINTAINS CONSTANT AMOUNT OF CURRENT TO THE LED LIGHT SOURCE. LED DRIVERS GENERALLY OPERATE AT 12VDC OR 24VDC. SOME DRIVERS ARE DESIGNED TO ACCEPT BRANCH CIRCUIT VOLTAGE RANGING FROM 120VAC THROUGH 277VAC OR MAY REQUIRE A SEPARATE TRANSFORMER.
- 5. TRANSFORMER: ELECTROMAGNETIC OR ELECTRONIC DEVICE THAT STEPS DOWN PRIMARY VOLTAGE TO A LOWER SECONDARY VOLTAGE. GENERALLY SECONDARY VOLTAGE WILL BE 12V OR 24V.
- 6. DIMMING: THE REDUCTION OF LIGHT INTENSITY OF A LIGHT SOURCE. ALL SOURCES SHALL HAVE A SMOOTH, FLICKER-FREE AND CONTINUOUS DIMMING CURVE. LED SOURCES MAY BE DIMMED BY EITHER CONSTANT CURRENT REDUCTION (CCR) OR BY PULSE WIDTH MODULATION (PWM) DIMMING FOR CONSTANT CURRENT DRIVERS.
- RATED LUMEN MAINTENANCE LIFE: THE ELAPSED OPERATING TIME OVER WHICH AN LED LIGHT SOURCE WILL MAINTAIN THE PERCENTAGE OF ITS INITIAL LUMEN OUTPUT. L70: TIME. IN HOURS. TO 70% LUMEN MAINTENANCI L50: TIME, IN HOURS, TO 50% LUMEN MAINTENANCE


REVISIONS ISSUE DATE REVISIONS PENNSYLVANIA ONE CALL SYSTEM, INC. BEFORE YOU DIG ANYWHERE IN PENNSYLVANIA! CALL 1-800-242-1776 NON-MEMBERS MUST BE CONTACTED DIRECTLY PA LAW REQUIRES THREE WORKING DAYS NOTICE TO UTILITIES BEFORE YOU EXCAVATE, DRILL, BLAST OR DEMOLISH PA ONE-CALL NUMBER (FOR DESIGN ONLY) PPR PROJECT COORDINATOR MEGAN FUNK SEAL RIMARY CONSULTANT, LANDSCAPE ARCHITECT: MARVEL 145 Hudson Street, Floor 3 New York, NY 10013 SUB-CONSULTANTS CIVIL/SURVEY ENGINEERING & LAND PLANNING ASSOCIATES, INC. 219 Cuthbert Street, 5th/ Floor Philadelphia, PA 19106 MEP ENGINEER: 417 N 8th Street, Suite 204 hiladelphia, PA 19123 267.585.2811 LIGHTING DESIGN: THE LIGHTING PRACTICE 600 Chestnut Street, Suite 772 Philadelphia, PA 19106 COST ESTIMATOR: ELLANA CONSTRUCTION CONSULTANTS 32 Broadway, 8TH Floo New York, NY 10004 PLAYFUL LEARNING CONSULTANT: PLAYFUL LEARNING LANDSCAPES ACTION NEXTWORK Philadelphia, PA 267.468.8610 MORRIS ARBORETUM 100 East Northwestern Avenue Philadelphia, PA 19118 215.247.5777 ACCESSIBILITY CONSULTANT CHRIS NOEL christopher.noel@parks.nyc.gov 646.632.7344 PLAY CONSULTANT: STUDIO LUDO 1313 S 33rd St, Unit A Philadelphia, PA 19146 CONSULTANT PROJECT NUMBER 2107 **CITY OF PHILADELPHIA** PHILADELPHIA PARKS AND RECREATION 1515 ARCH STREET 11TH FLOOR, ONE PARKWAY BUILDING PPR PROJECT NUMBER 16-21-7062-01 PROJECT TITLE: PENNYPACK PARK UNIVERSAL PLAYGROUND RHAWN ST. & HOLMEHURST AVE. PHILADELPHIA, PA 19136 DRAWING TITLE GENERAL NOTES PPR PROJECT NO DRAWING NO 16-21-7062-01 CONSULTANT PROJECT NC 2107 12/15/2023 SCALE: AS NOTED DRAWN BY SS, TW CHECKED BY ALL DIMENSIONS AND CONDITIONS SHALL BE VERIFIED BY THE CONTRACTOR AT THE SITE BEFORE PROCEEDING WITH THE WORK



LEGEND	
TREE CANOPY	
C.I.P. CONCRETE CURB	
BENCH	
GRANITE BLOCK SEATING	
SITE BOULDER	
LITTER RECEPTACLE	0
DRINKING FOUNTAIN	0-2-0
CAFE TABLE	
PICNIC TABLE	
STREET LIGHT POLE	\widetilde{Q}
ENTRY FENCE	0-
SECURITY FENCE AND GATE	0-
RAIL	
WOODLAND EDGE	
BIKE RACK	-
PROPOSED TREE	+
MULCH	

EXISTING BUILDING

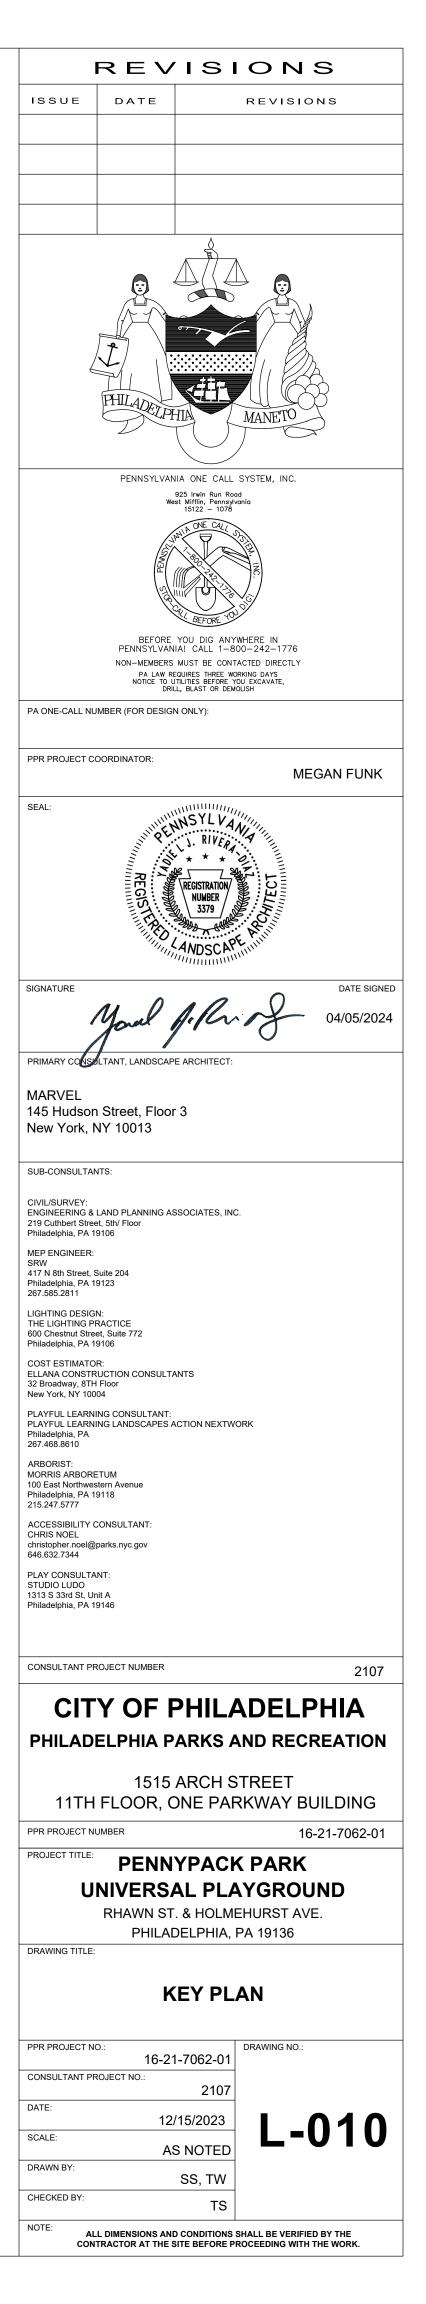

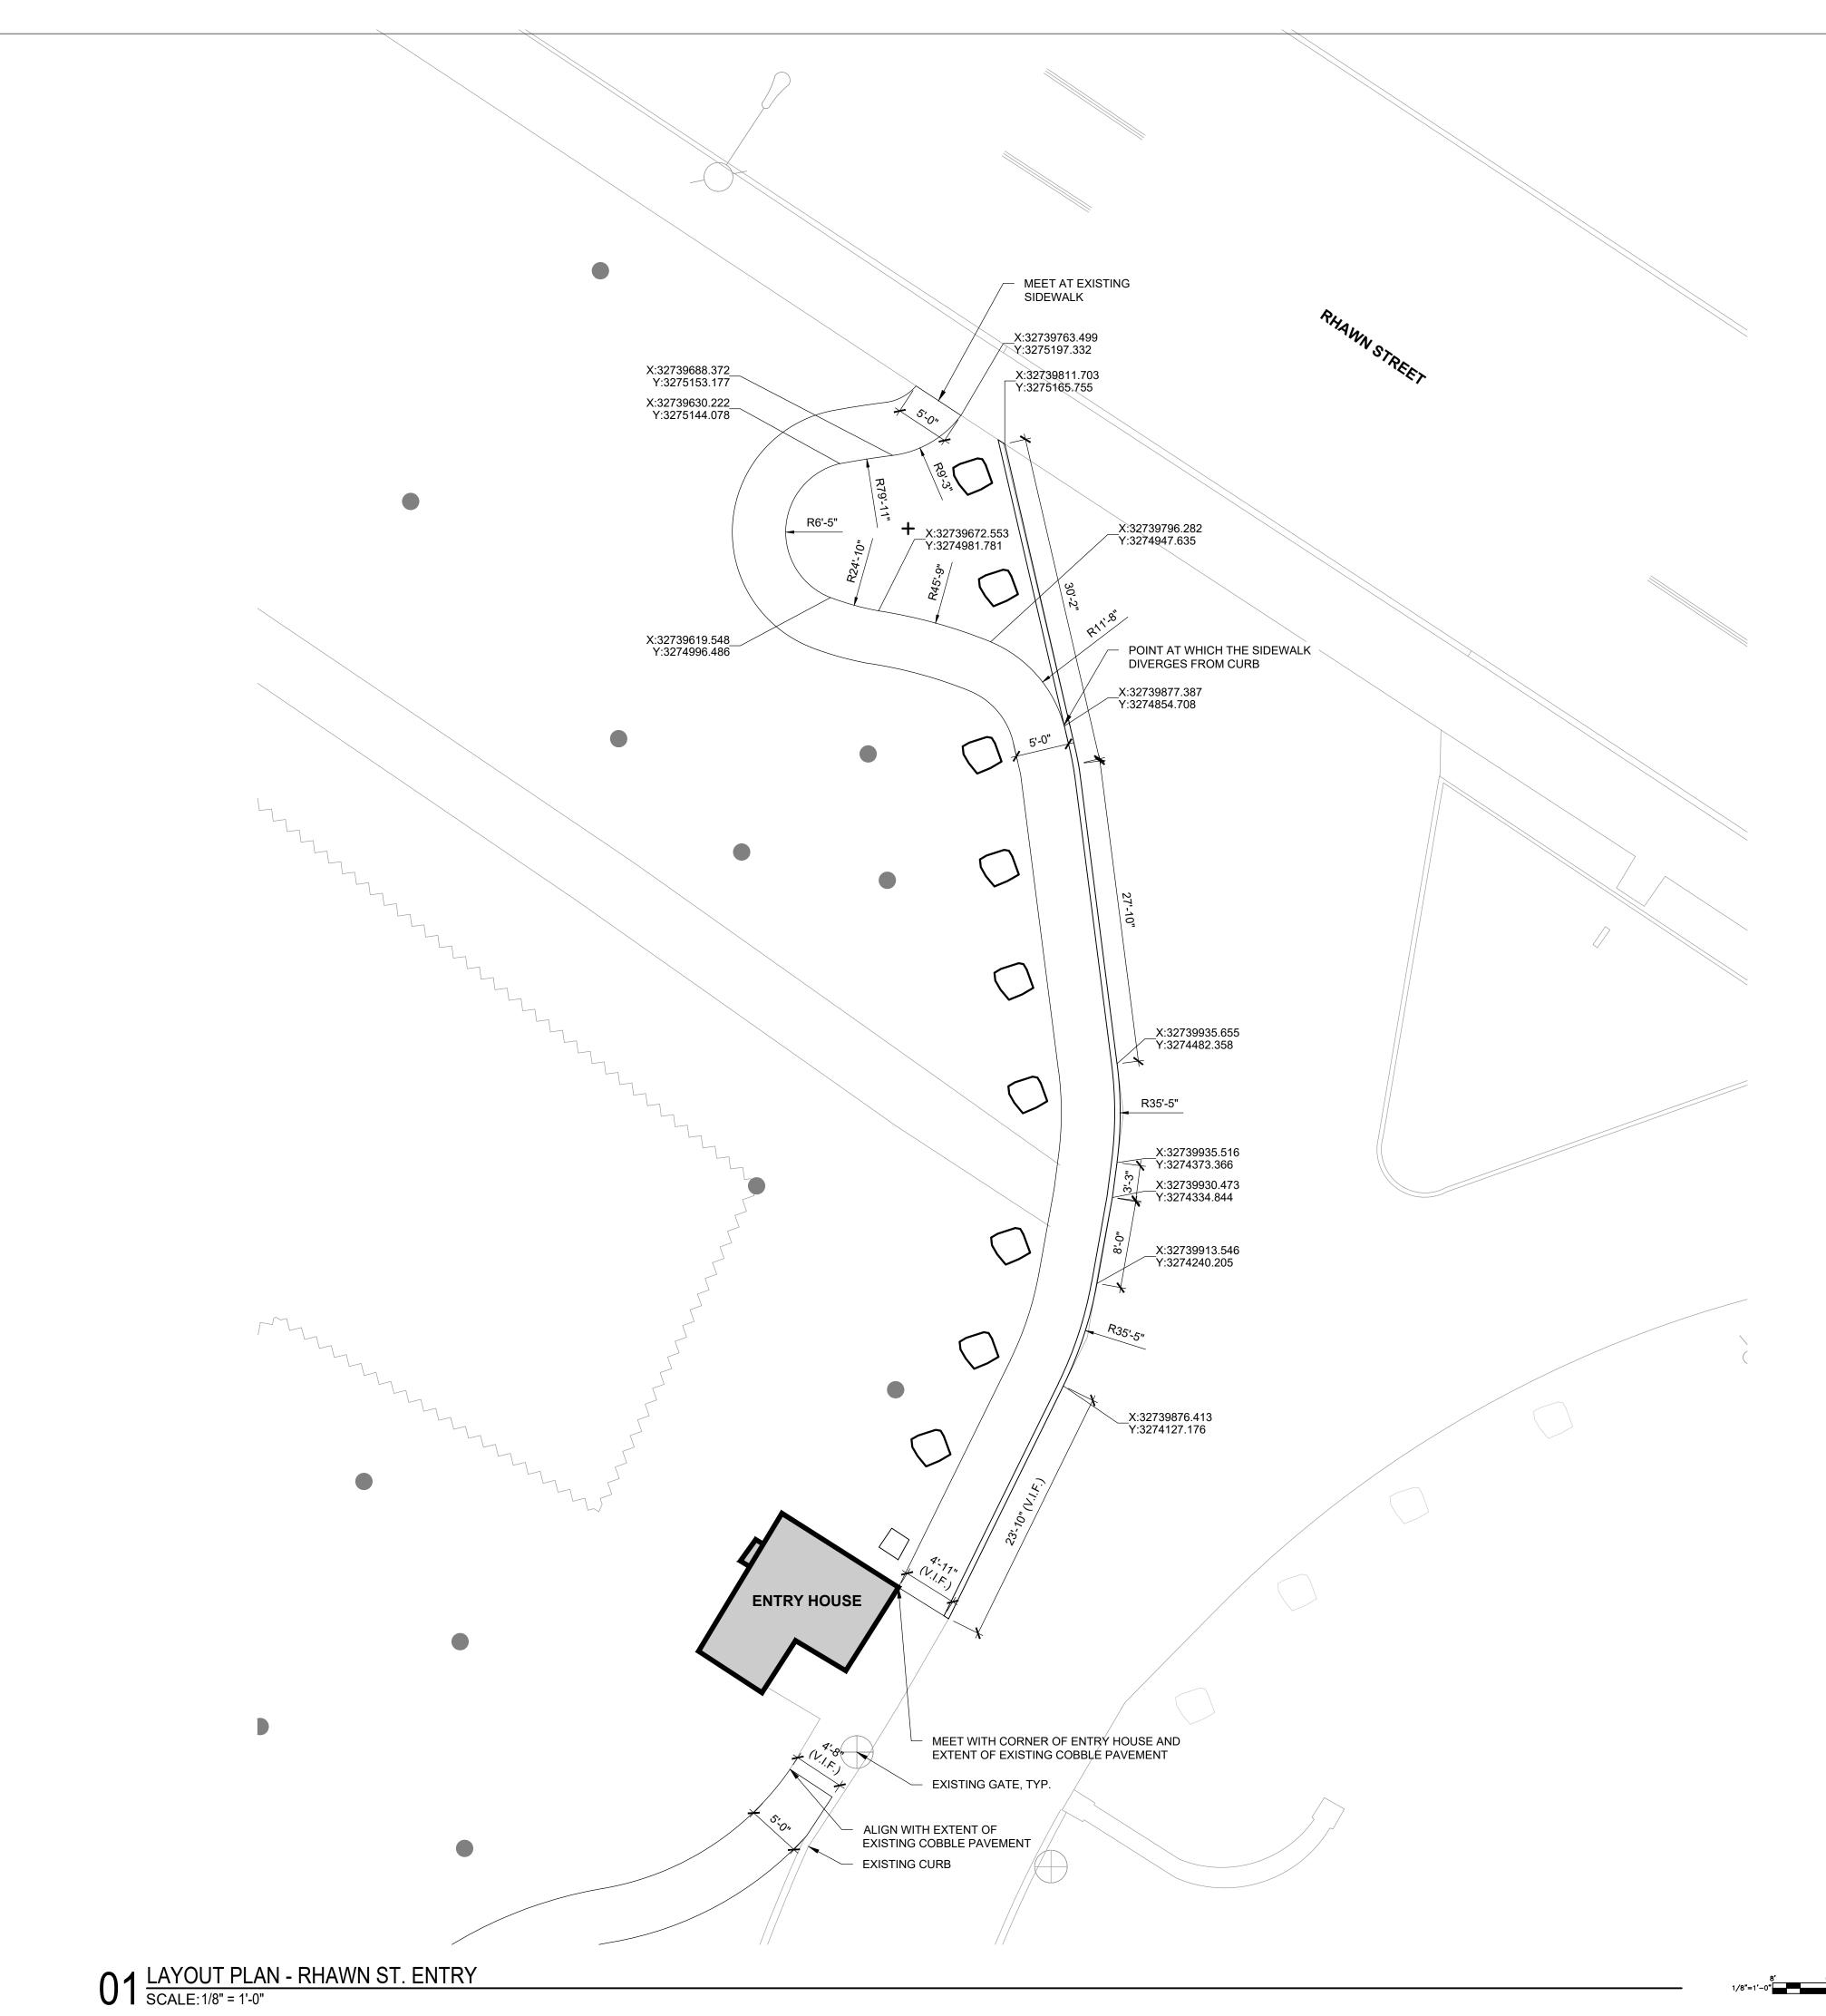

<u>LEGEND</u>

TREE TRUNK

C.I.P. CONCRETE CURB

STREET LIGHT POLE

WOODLAND EDGE

EXISTING BOULDER

PROPOSED TREE

EXISTING BUILDING

NOTE:


SEE L-001 FOR LAYOUT NOTES.

REVISIONS ISSUE DATE REVISIONS PENNSYLVANIA ONE CALL SYSTEM, INC. 925 Irwin Run Road West Mifflin, Pennsylvania 15122 — 1078 BEFORE YOU DIG ANYWHERE IN PENNSYLVANIA! CALL 1-800-242-1776 NON-MEMBERS MUST BE CONTACTED DIRECTLY PA LAW REQUIRES THREE WORKING DAYS NOTICE TO UTILITIES BEFORE YOU EXCAVATE, DRILL, BLAST OR DEMOLISH PA ONE-CALL NUMBER (FOR DESIGN ONLY): PPR PROJECT COORDINATOR: MEGAN FUNK SEAL: DATE SIGNED SIGNATURE al A. R. A. 04/05/2024 PRIMARY CONSULTANT, LANDSCAPE ARCHITECT: MARVEL 145 Hudson Street, Floor 3 New York, NY 10013 SUB-CONSULTANTS: CIVIL/SURVEY: ENGINEERING & LAND PLANNING ASSOCIATES, INC. 219 Cuthbert Street, 5th/ Floor Philadelphia, PA 19106 MEP ENGINEER: SRW 417 N 8th Street, Suite 204 Philadelphia, PA 19123 267.585.2811 LIGHTING DESIGN: THE LIGHTING PRACTICE 600 Chestnut Street, Suite 772 Philadelphia, PA 19106 COST ESTIMATOR: ELLANA CONSTRUCTION CONSULTANTS 32 Broadway, 8TH Floor New York, NY 10004 PLAYFUL LEARNING CONSULTANT: PLAYFUL LEARNING LANDSCAPES ACTION NEXTWORK Philadelphia, PA 267.468.8610 ARBORIST: MORRIS ARBORETUM 100 East Northwestern Avenue Philadelphia, PA 19118 215.247.5777 ACCESSIBILITY CONSULTANT: CHRIS NOEL christopher.noel@parks.nyc.gov 646.632.7344 PLAY CONSULTANT: STUDIO LUDO 1313 S 33rd St, Unit A Philadelphia, PA 19146 CONSULTANT PROJECT NUMBER 2107 **CITY OF PHILADELPHIA** PHILADELPHIA PARKS AND RECREATION 1515 ARCH STREET 11TH FLOOR, ONE PARKWAY BUILDING PPR PROJECT NUMBER 16-21-7062-01 PROJECT TITLE: PENNYPACK PARK UNIVERSAL PLAYGROUND RHAWN ST. & HOLMEHURST AVE. PHILADELPHIA, PA 19136 DRAWING TITLE: LAYOUT PLAN -**RHAWN ST.ENTRY** PPR PROJECT NO .: DRAWING NO .: 16-21-7062-01 CONSULTANT PROJECT NO .: 2107 DATE: 12/15/2023 L-100 SCALE: AS NOTED DRAWN BY: SS, TW CHECKED BY:

> ALL DIMENSIONS AND CONDITIONS SHALL BE VERIFIED BY THE CONTRACTOR AT THE SITE BEFORE PROCEEDING WITH THE WORK.

NOTE:

TS

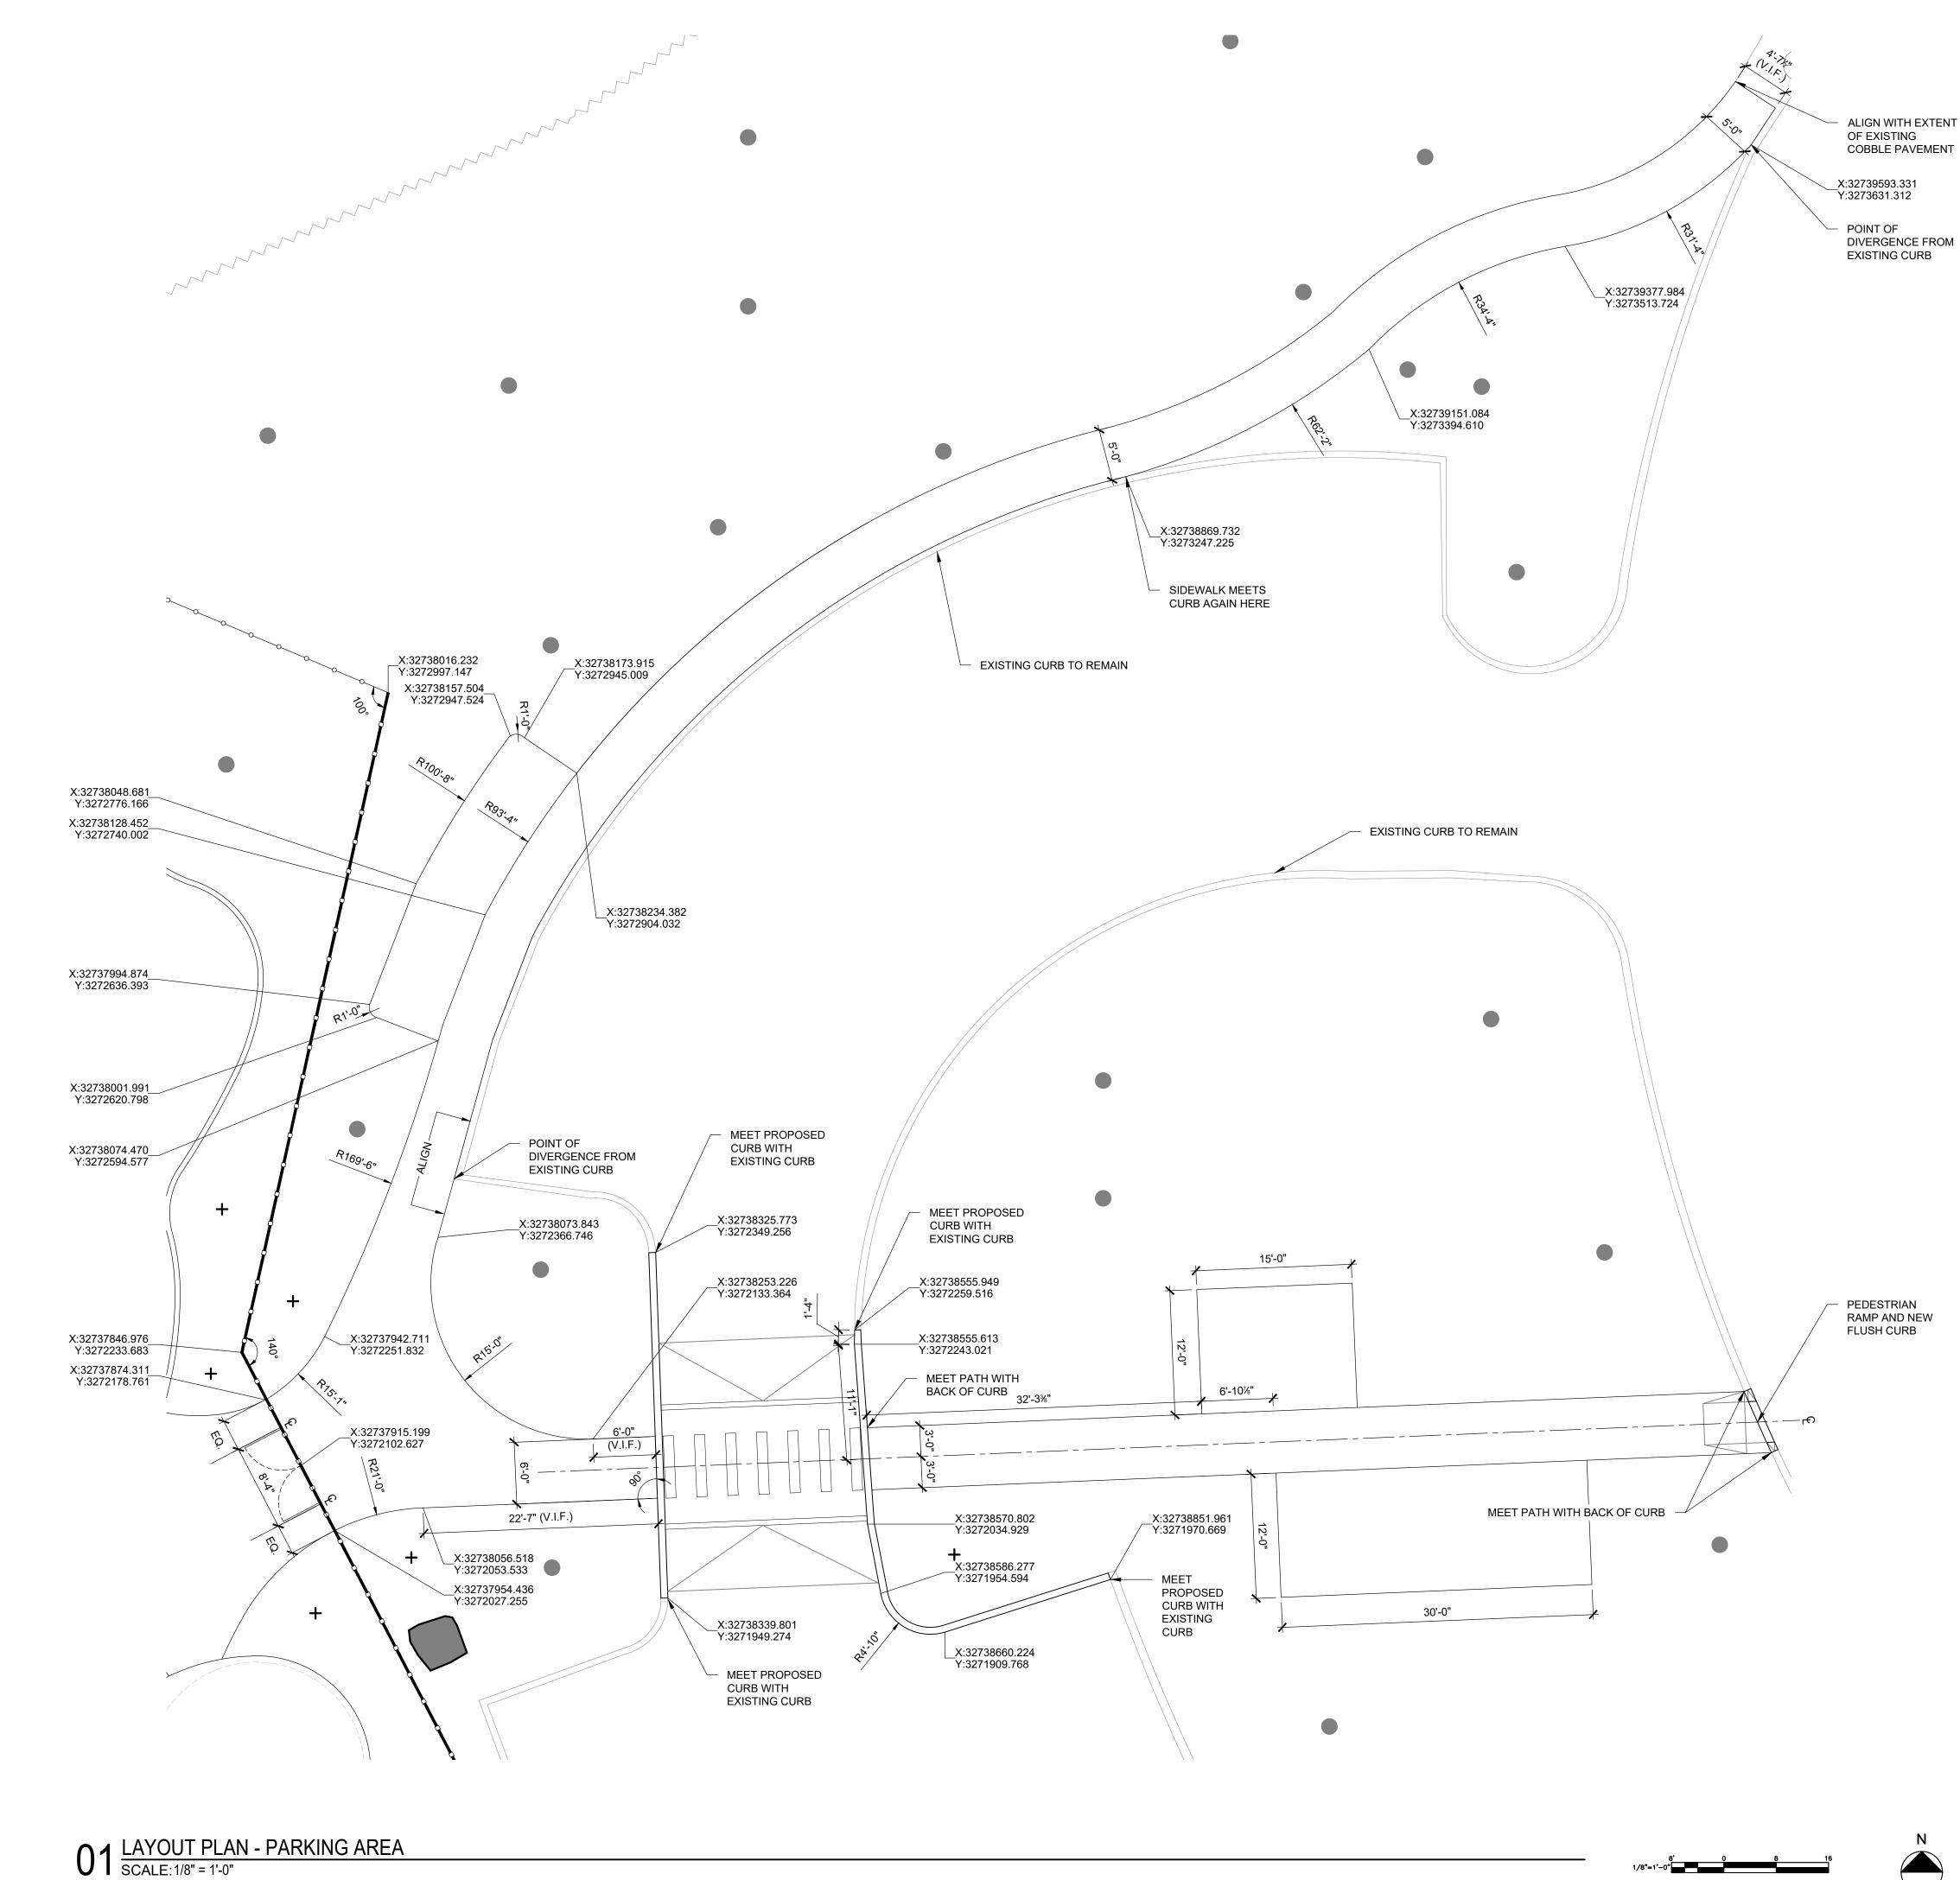



<u>LEGEND</u>

TREE TRUNK

01 L-903

ENTRY FENCE

C.I.P. CONCRETE CURB

03 L-903

SECURITY FENCE AND GATE

WOODLAND EDGE

PROPOSED TREE

08 L-901

SITE BOULDER

NOTE: SEE L-001 FOR LAYOUT NOTES.

SIGNATURE l Aller od/05/2024 PRIMARY CONSULTANT, LANDSCAPE ARCHITECT:

PA ONE-CALL NUMBER (FOR DESIGN ONLY):

PPR PROJECT COORDINATOR:

SEAL:

REVISIONS

PENNSYLVANIA ONE CALL SYSTEM, INC. 925 Irwin Run Road West Mifflin, Pennsylvani 15122 — 1078

BEFORE YOU DIG ANYWHERE IN PENNSYLVANIA! CALL 1-800-242-1776 NON-MEMBERS MUST BE CONTACTED DIRECTLY

PA LAW REQUIRES THREE WORKING DAYS NOTICE TO UTILITIES BEFORE YOU EXCAVATE, DRILL, BLAST OR DEMOLISH

MEGAN FUNK

DATE SIGNED

REVISIONS

ISSUE DATE

MARVEL 145 Hudson Street, Floor 3 New York, NY 10013

SUB-CONSULTANTS:

CIVIL/SURVEY: ENGINEERING & LAND PLANNING ASSOCIATES, INC. 219 Cuthbert Street, 5th/ Floor Philadelphia, PA 19106

MEP ENGINEER: SRW 417 N 8th Street, Suite 204 Philadelphia, PA 19123 267.585.2811

LIGHTING DESIGN: THE LIGHTING PRACTICE 600 Chestnut Street, Suite 772 Philadelphia, PA 19106

COST ESTIMATOR: ELLANA CONSTRUCTION CONSULTANTS 32 Broadway, 8TH Floor New York, NY 10004

PLAYFUL LEARNING CONSULTANT: PLAYFUL LEARNING LANDSCAPES ACTION NEXTWORK Philadelphia, PA 267.468.8610

ARBORIST: MORRIS ARBORETUM 100 East Northwestern Avenue Philadelphia, PA 19118 215.247.5777

ACCESSIBILITY CONSULTANT: CHRIS NOEL christopher.noel@parks.nyc.gov 646.632.7344

CONSULTANT PROJECT NUMBER

PLAY CONSULTANT: STUDIO LUDO 1313 S 33rd St, Unit A Philadelphia, PA 19146

2107

CITY OF PHILADELPHIA

PHILADELPHIA PARKS AND RECREATION

1515 ARCH STREET 11TH FLOOR, ONE PARKWAY BUILDING PPR PROJECT NUMBER 16-21-7062-01 PROJECT TITLE:

PENNYPACK PARK UNIVERSAL PLAYGROUND RHAWN ST. & HOLMEHURST AVE.


PHILADELPHIA, PA 19136 DRAWING TITLE:

NOTE:

LAYOUT PLAN -PARKING AREA

PPR PROJECT NO .: DRAWING NO .: 16-21-7062-01 CONSULTANT PROJECT NO .: 2107 DATE: 12/15/2023 L-101 SCALE: AS NOTED DRAWN BY: SS, TW CHECKED BY: TS

> ALL DIMENSIONS AND CONDITIONS SHALL BE VERIFIED BY THE CONTRACTOR AT THE SITE BEFORE PROCEEDING WITH THE WORK.

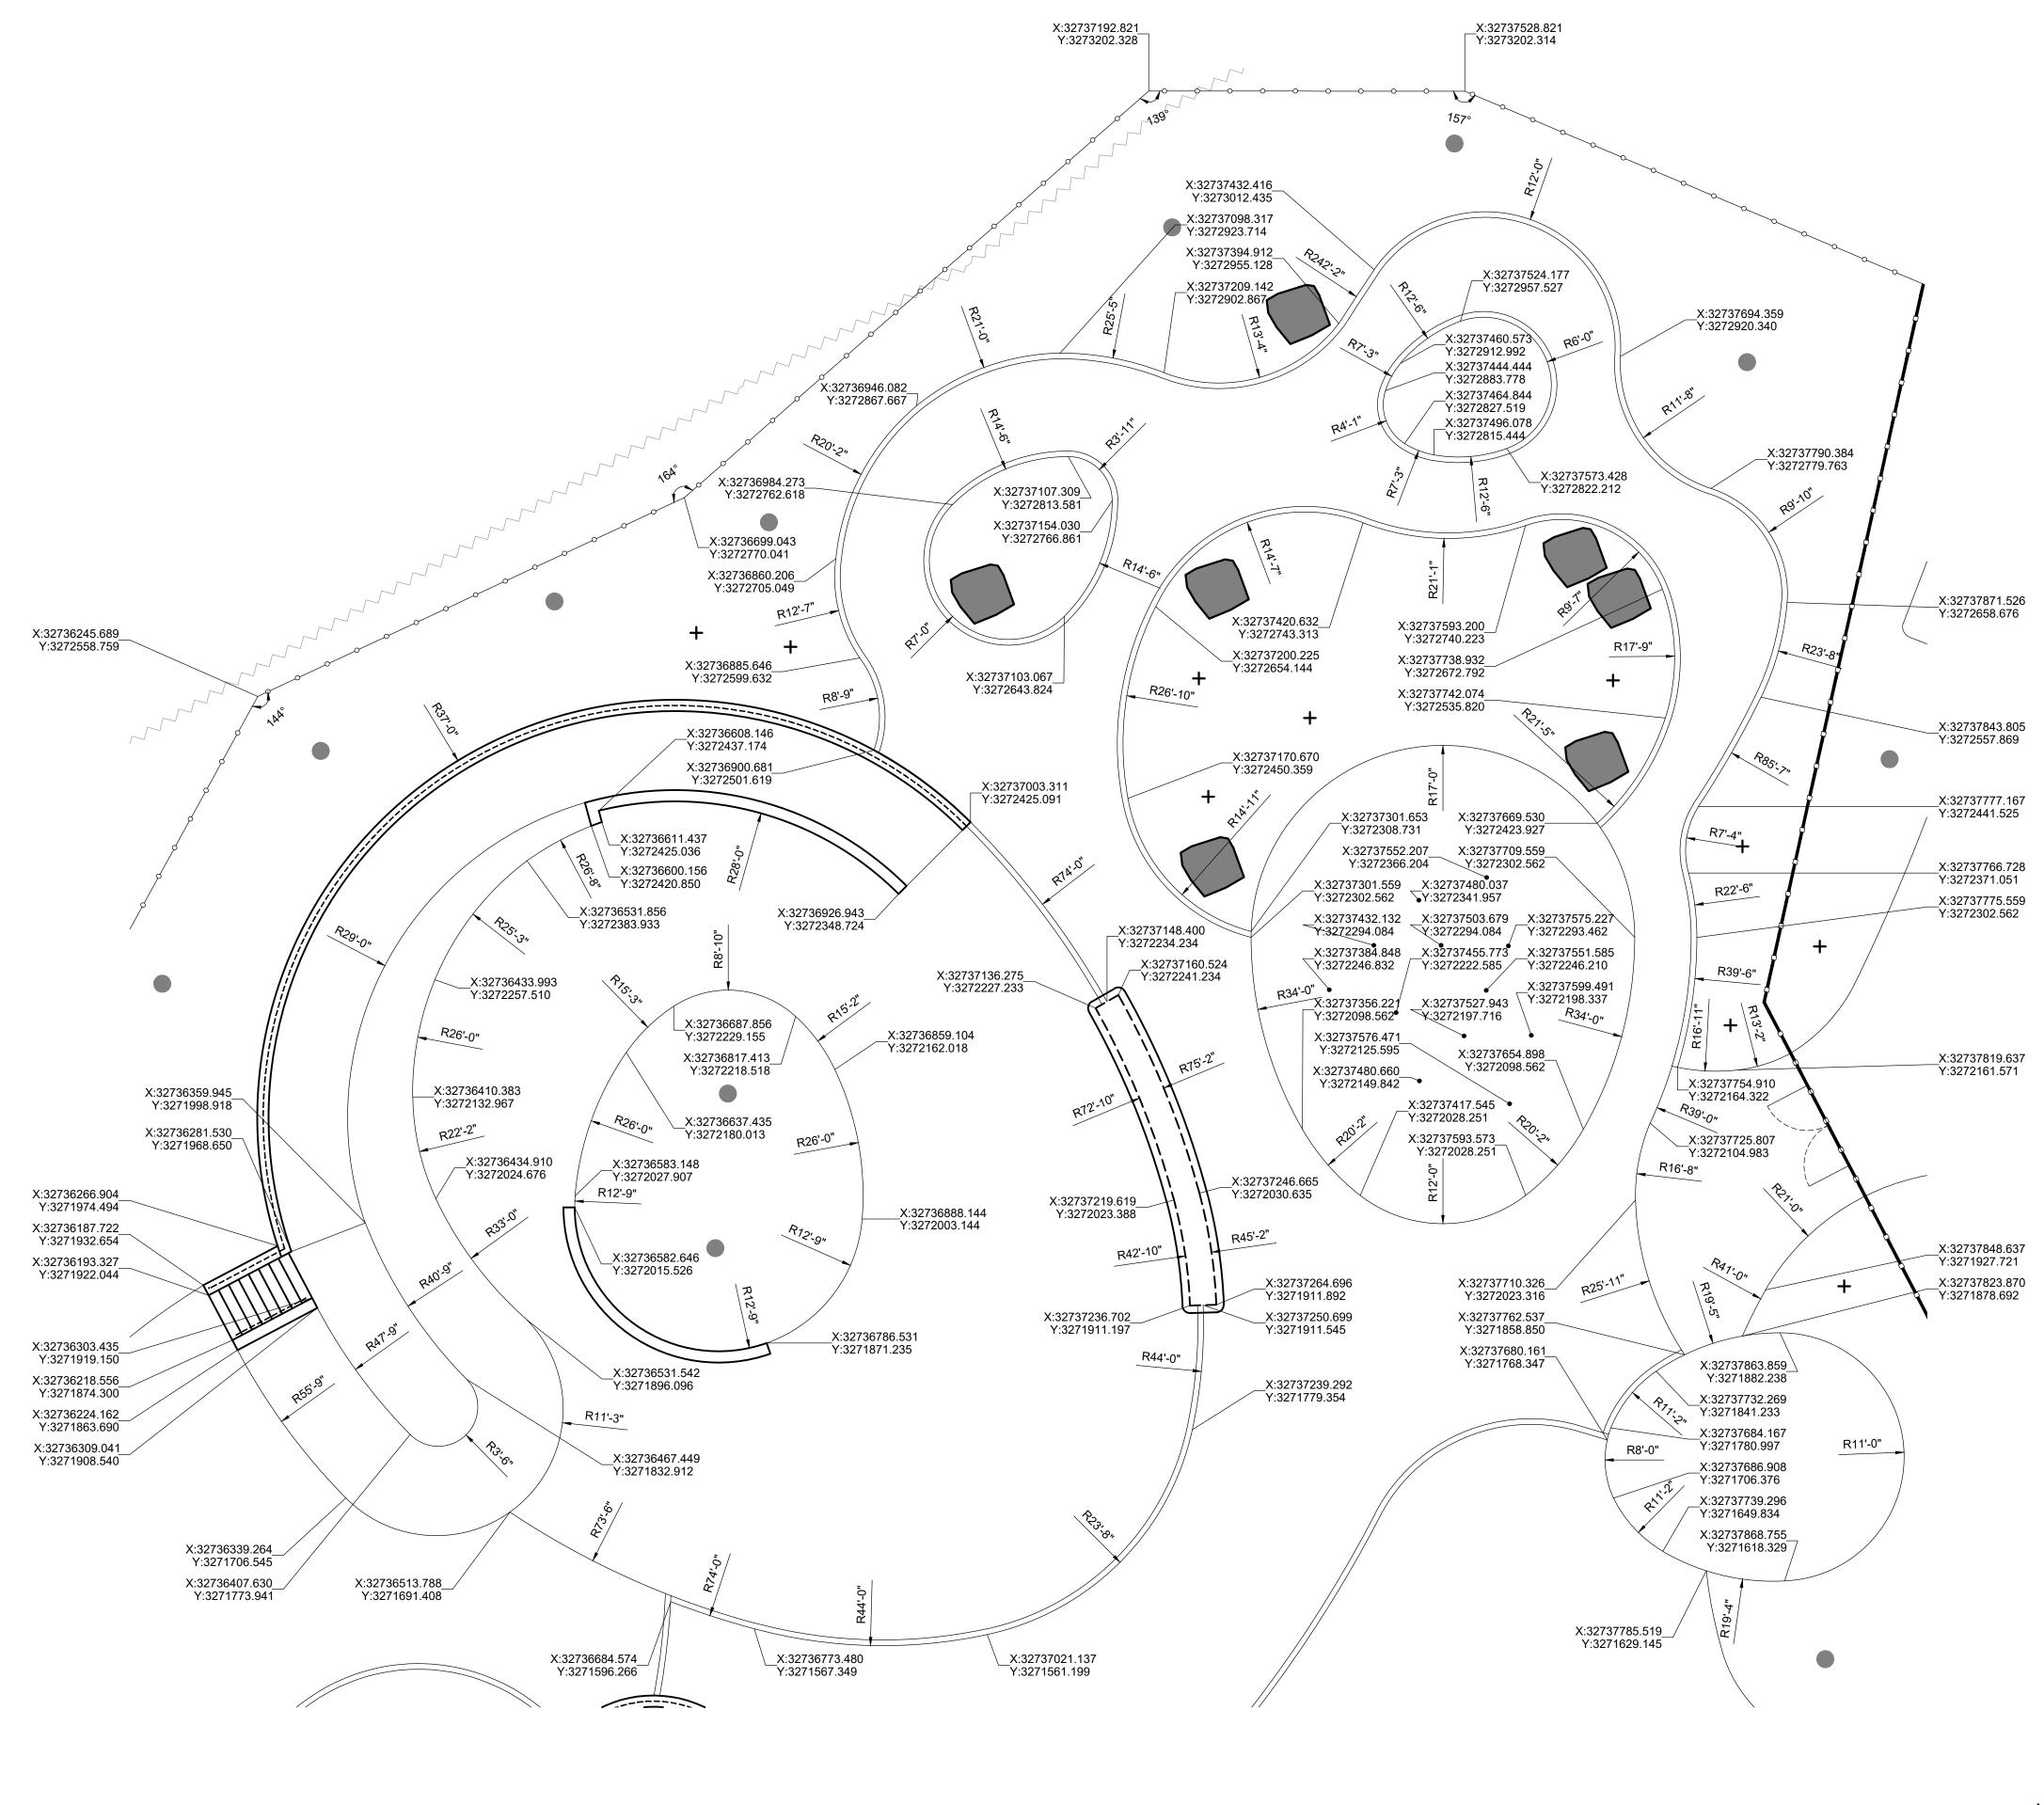

01 <u>LAYOUT PLAN - PLAYGROUND - NORTH</u> SCALE: 1/8" = 1'-0"



REVISIONS <u>LEGEND</u> ISSUE DATE REVISIONS TREE TRUNK C.I.P. CONCRETE CURB 01 L-903 ENTRY FENCE PENNSYLVANIA ONE CALL SYSTEM, INC. 925 Irwin Run Road West Mifflin, Pennsylvo 15122 - 1078 03 L-903 SECURITY FENCE AND GATE ____<u>O___O___O__</u>O___O_ BEFORE YOU DIG ANYWHERE IN PENNSYLVANIA! CALL 1-800-242-1776 NON-MEMBERS MUST BE CONTACTED DIRECTLY PA LAW REQUIRES THREE WORKING DAYS NOTICE TO UTILITIES BEFORE YOU EXCAVATE, DRILL, BLAST OR DEMOLISH RAIL _____ PA ONE-CALL NUMBER (FOR DESIGN ONLY): PPR PROJECT COORDINATOR: MEGAN FUNK SEAL: WOODLAND EDGE PROPOSED TREE DATE SIGNED SIGNATUR - 04/05/2024 08 L-901 SITE BOULDER PRIMARY CONSULTANT, LANDSCAPE ARCHITECT: MARVEL 145 Hudson Street, Floor 3 New York, NY 10013 NOTE: SUB-CONSULTANTS: SEE L-001 FOR LAYOUT NOTES. CIVIL/SURVEY ENGINEERING & LAND PLANNING ASSOCIATES, INC. 219 Cuthbert Street, 5th/ Floor Philadelphia, PA 19106 MEP ENGINEER: 417 N 8th Street, Suite 204 Philadelphia, PA 19123 267.585.2811 LIGHTING DESIGN: THE LIGHTING PRACTICE 600 Chestnut Street, Suite 772 Philadelphia, PA 19106 COST ESTIMATOR: ELLANA CONSTRUCTION CONSULTANTS 32 Broadway, 8TH Floor New York, NY 10004 PLAYFUL LEARNING CONSULTANT: PLAYFUL LEARNING LANDSCAPES ACTION NEXTWORK Philadelphia, PA 267.468.8610 ARBORIST: MORRIS ARBORETUM 100 East Northwestern Avenue Philadelphia, PA 19118 215.247.5777 ACCESSIBILITY CONSULTANT: CHRIS NOEL christopher.noel@parks.nyc.gov 646.632.7344 PLAY CONSULTANT: STUDIO LUDO 1313 S 33rd St, Unit A Philadelphia, PA 19146 CONSULTANT PROJECT NUMBER 2107 **CITY OF PHILADELPHIA** PHILADELPHIA PARKS AND RECREATION 1515 ARCH STREET 11TH FLOOR, ONE PARKWAY BUILDING PPR PROJECT NUMBER 16-21-7062-01 PROJECT TITLE: PENNYPACK PARK UNIVERSAL PLAYGROUND RHAWN ST. & HOLMEHURST AVE.


PHILADELPHIA, PA 19136 LAYOUT PLAN -PLAYGROUND -NORTH

DRAWING TITLE:

DATE:

PPR PROJECT NO .: DRAWING NO 16-21-7062-01 CONSULTANT PROJECT NO .: 2107 L-102 12/15/2023 SCALE: AS NOTED DRAWN BY: SS, TW CHECKED BY: TS


NOTE ALL DIMENSIONS AND CONDITIONS SHALL BE VERIFIED BY THE CONTRACTOR AT THE SITE BEFORE PROCEEDING WITH THE WORK.

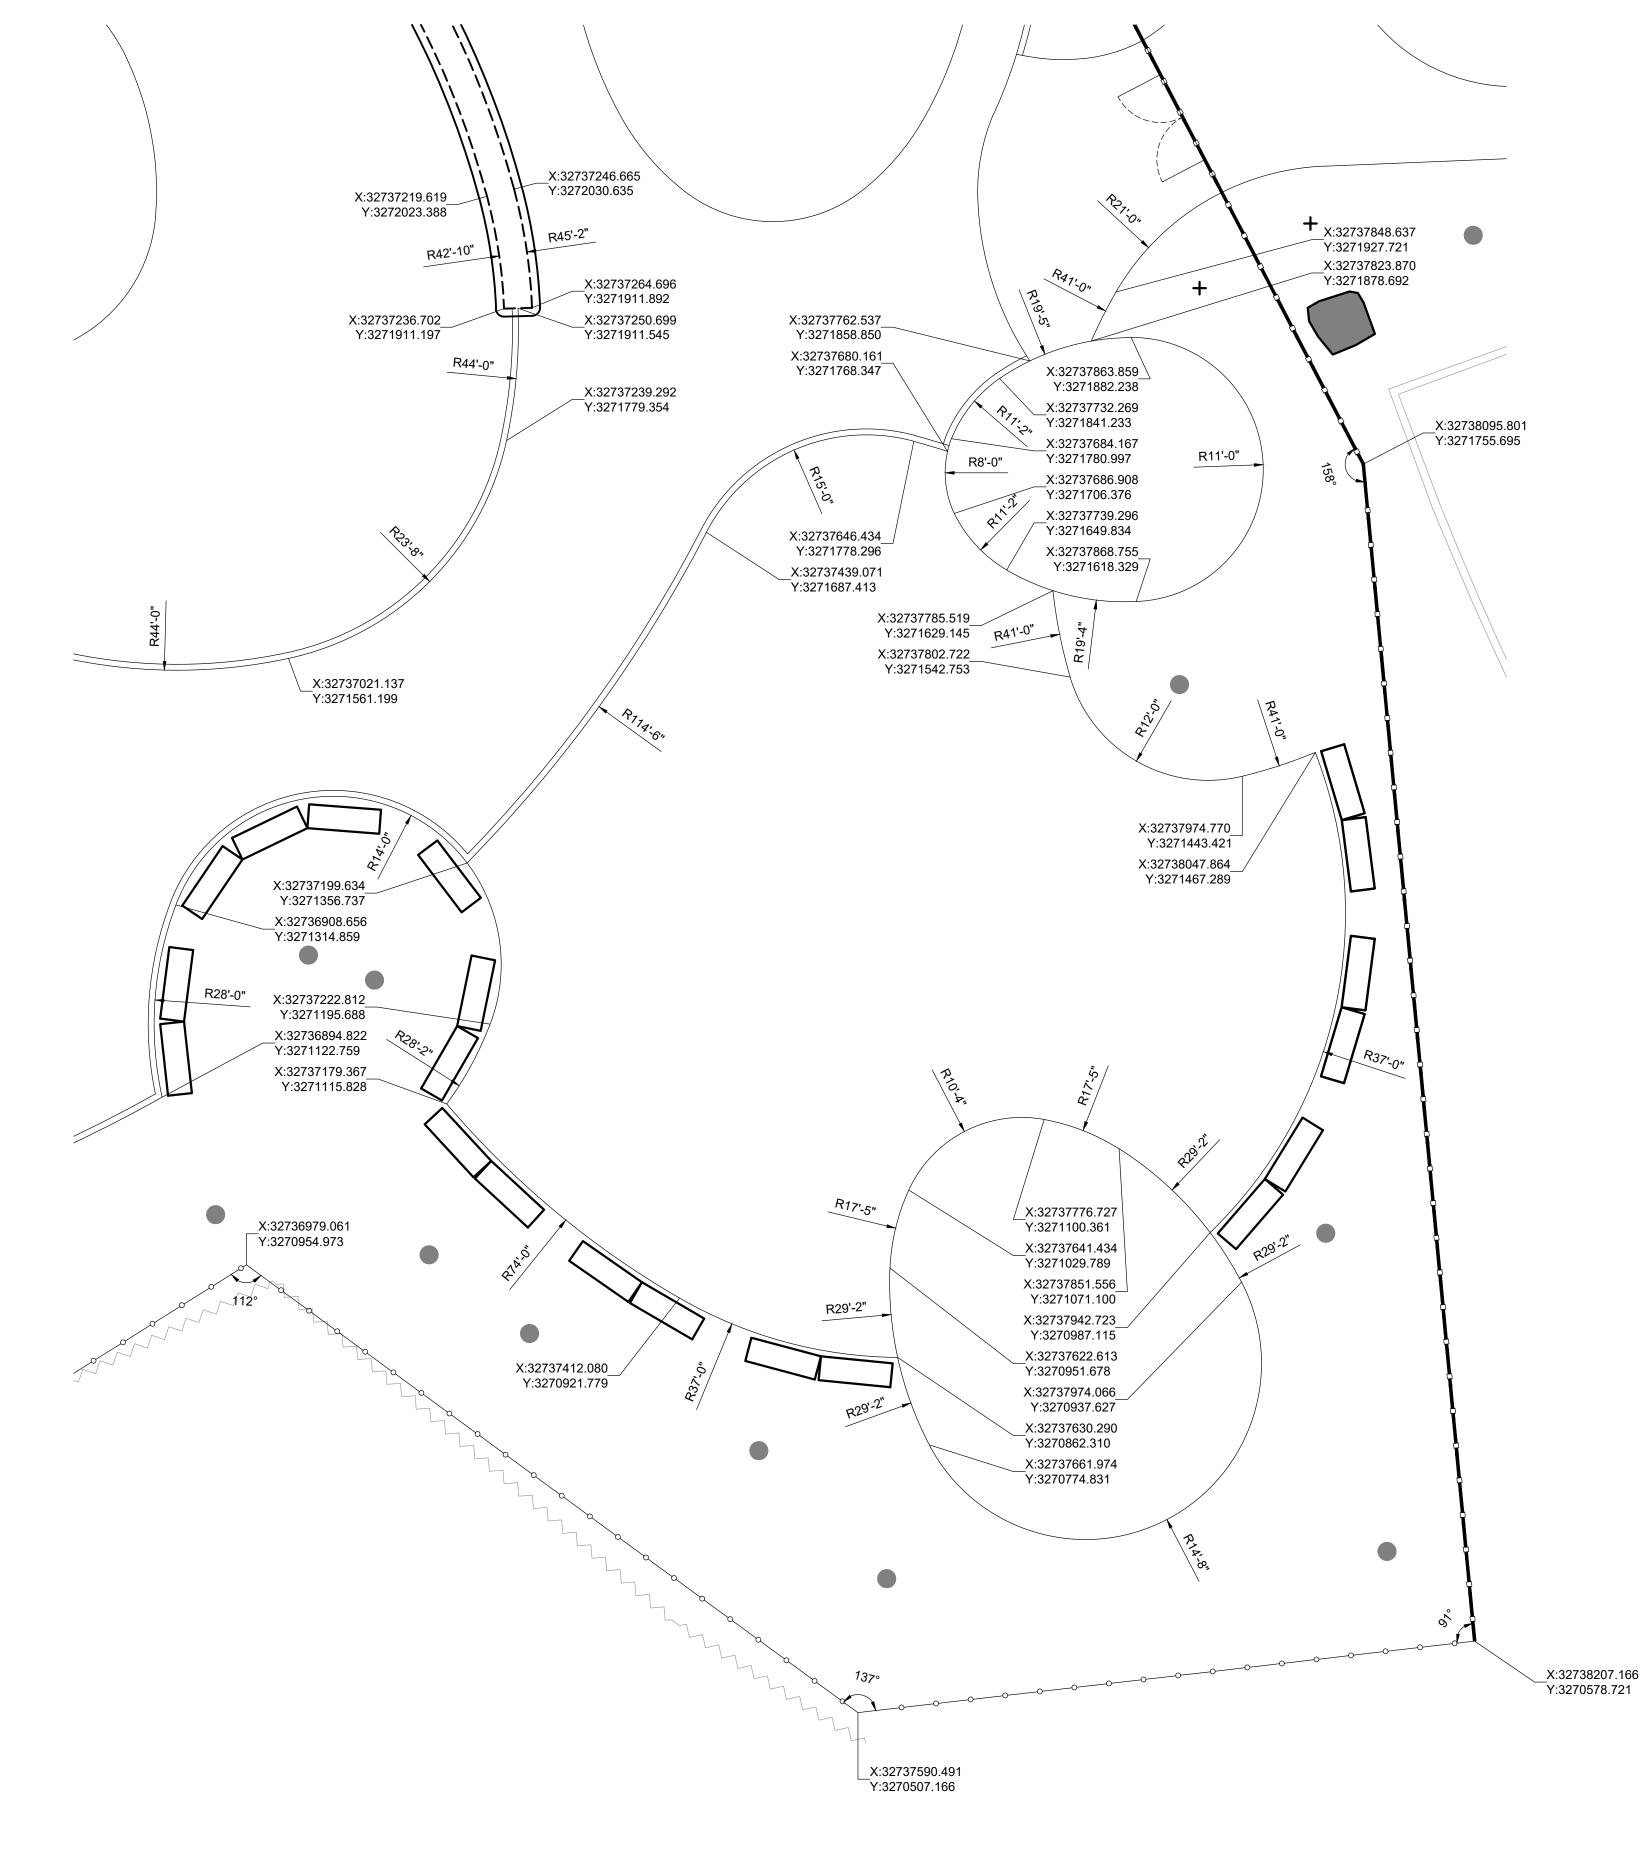



8' 0 8 1/8"=1'-0"

REVISIONS <u>LEGEND</u> ISSUE DATE REVISIONS TREE TRUNK C.I.P. CONCRETE CURB 01 L-903 ENTRY FENCE PENNSYLVANIA ONE CALL SYSTEM, INC. 925 Irwin Run Road West Mifflin, Pennsylvani 15122 — 1078 03 L-903 SECURITY FENCE AND GATE ____O___O___O___O__ BEFORE YOU DIG ANYWHERE IN PENNSYLVANIA! CALL 1-800-242-1776 NON-MEMBERS MUST BE CONTACTED DIRECTLY PA LAW REQUIRES THREE WORKING DAYS NOTICE TO UTILITIES BEFORE YOU EXCAVATE, DRILL, BLAST OR DEMOLISH RAIL _____ PA ONE-CALL NUMBER (FOR DESIGN ONLY): PPR PROJECT COORDINATOR: MEGAN FUNK WOODLAND EDGE SEAL: PROPOSED TREE + DATE SIGNED SIGNATURE al following 04/05/2024 08 L-901 SITE BOULDER PRIMARY CONSULTANT, LANDSCAPE ARCHITECT: MARVEL 145 Hudson Street, Floor 3 New York, NY 10013 (06, 07) L-901 SUB-CONSULTANTS: GRANITE BLOCK SEATING CIVIL/SURVEY: ENGINEERING & LAND PLANNING ASSOCIATES, INC. 219 Cuthbert Street, 5th/ Floor Philadelphia, PA 19106 MEP ENGINEER: SRW 417 N 8th Street, Suite 204 NOTE: Philadelphia, PA 19123 267.585.2811 SEE L-001 FOR LAYOUT NOTES. LIGHTING DESIGN: THE LIGHTING PRACTICE 600 Chestnut Street, Suite 772 Philadelphia, PA 19106 COST ESTIMATOR: ELLANA CONSTRUCTION CONSULTANTS 32 Broadway, 8TH Floor New York, NY 10004 PLAYFUL LEARNING CONSULTANT: PLAYFUL LEARNING LANDSCAPES ACTION NEXTWORK Philadelphia, PA 267.468.8610 ARBORIST: MORRIS ARBORETUM 100 East Northwestern Avenue Philadelphia, PA 19118 215.247.5777 ACCESSIBILITY CONSULTANT: CHRIS NOEL christopher.noel@parks.nyc.gov 646.632.7344 PLAY CONSULTANT: STUDIO LUDO 1313 S 33rd St, Unit A Philadelphia, PA 19146 CONSULTANT PROJECT NUMBER 2107 CITY OF PHILADELPHIA PHILADELPHIA PARKS AND RECREATION 1515 ARCH STREET 11TH FLOOR, ONE PARKWAY BUILDING PPR PROJECT NUMBER 16-21-7062-01 PROJECT TITLE: PENNYPACK PARK UNIVERSAL PLAYGROUND RHAWN ST. & HOLMEHURST AVE. PHILADELPHIA, PA 19136 DRAWING TITLE: LAYOUT PLAN -PLAYGROUND -SOUTHEAST PPR PROJECT NO .: DRAWING NO 16-21-7062-01 CONSULTANT PROJECT NO .: 2107 DATE: 12/15/2023 L-103 SCALE: AS NOTED DRAWN BY: SS, TW CHECKED BY: TS NOTE: ALL DIMENSIONS AND CONDITIONS SHALL BE VERIFIED BY THE CONTRACTOR AT THE SITE BEFORE PROCEEDING WITH THE WORK.

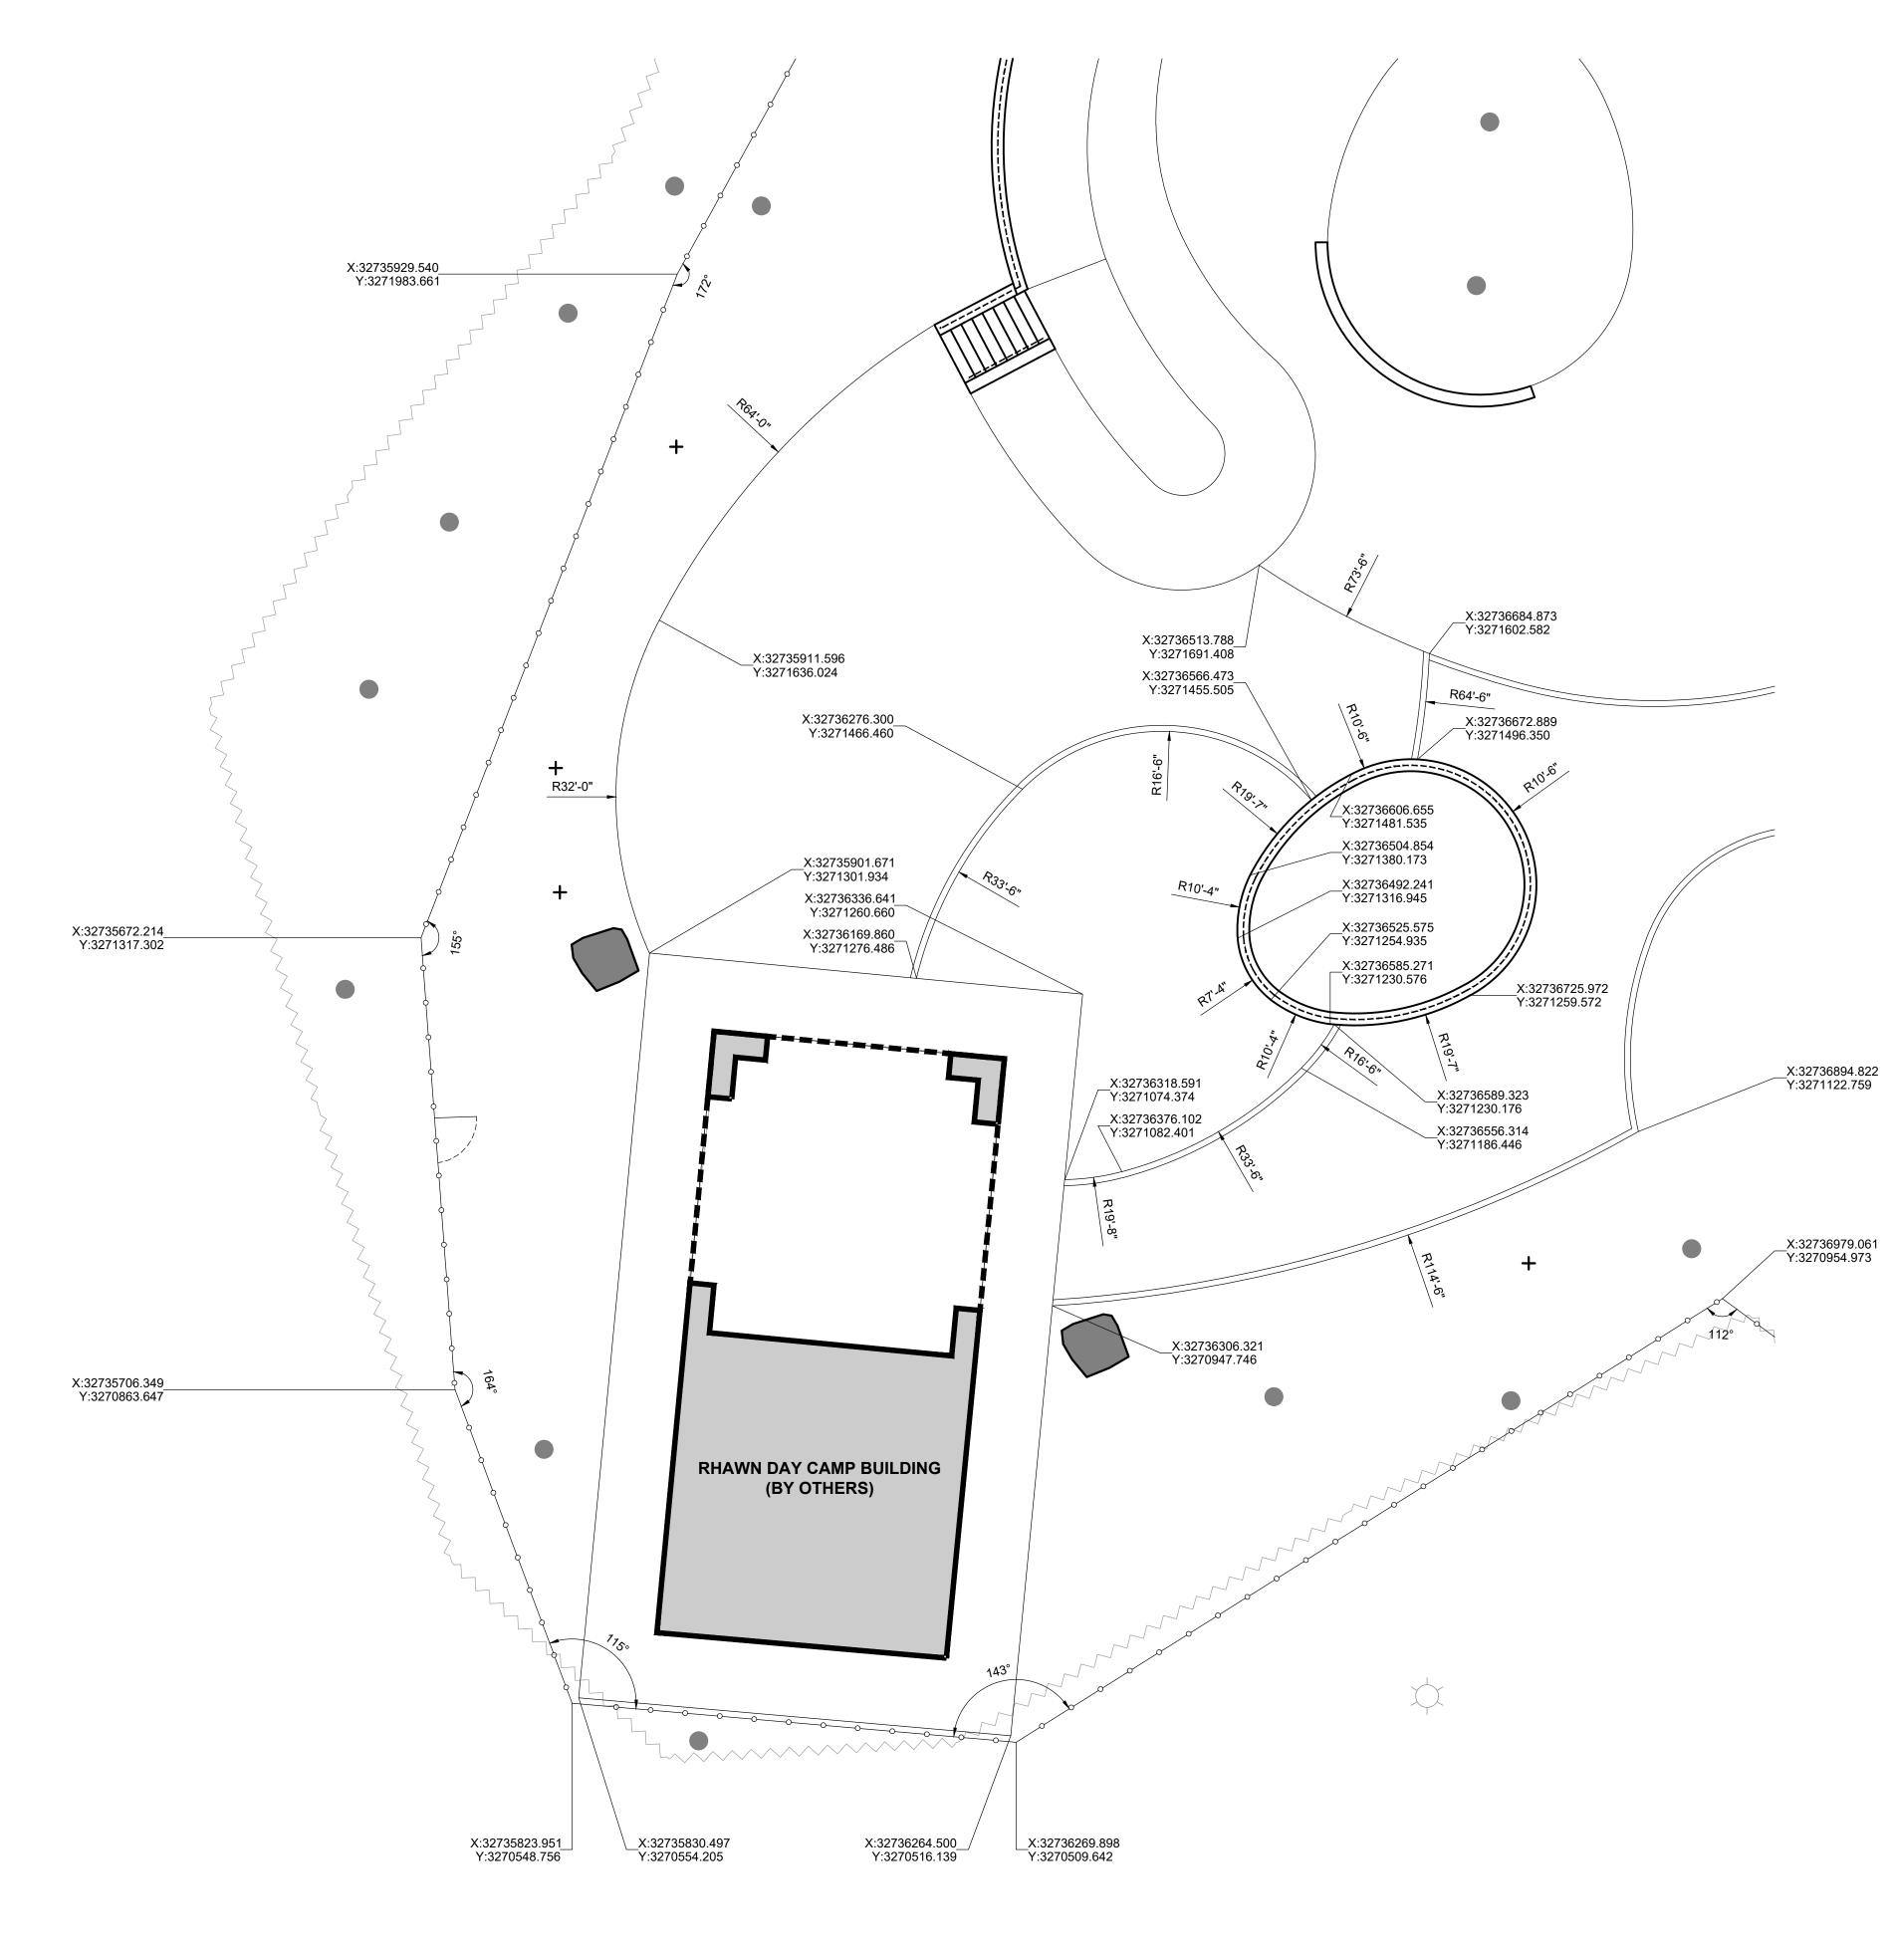


01 <u>LAYOUT PLAN - PLAYGROUND - SOUTHWEST</u> SCALE: 1/8" = 1'-0"

8' 0 8 16 1/8"=1'-0"

REVISIONS <u>LEGEND</u> ISSUE DATE REVISIONS TREE TRUNK C.I.P. CONCRETE CURB 01 L-903 ENTRY FENCE PENNSYLVANIA ONE CALL SYSTEM, INC. 925 Irwin Run Road West Mifflin, Pennsylvania 15122 — 1078 03 L-903 SECURITY FENCE AND GATE ____O___O___O___O__ BEFORE YOU DIG ANYWHERE IN PENNSYLVANIA! CALL 1-800-242-1776 NON-MEMBERS MUST BE CONTACTED DIRECTLY PA LAW REQUIRES THREE WORKING DAYS NOTICE TO UTILITIES BEFORE YOU EXCAVATE, DRILL, BLAST OR DEMOLISH RAIL _____ PA ONE-CALL NUMBER (FOR DESIGN ONLY): PPR PROJECT COORDINATOR: MEGAN FUNK WOODLAND EDGE SEAL: PROPOSED TREE + DATE SIGNED SIGNATURE al A. M. A. 04/05/2024 06, 07 L-901 GRANITE BLOCK SEATING PRIMARY CONSULTANT, LANDSCAPE ARCHITECT: MARVEL 145 Hudson Street, Floor 3 New York, NY 10013 $\begin{pmatrix} 08 \\ L-901 \end{pmatrix}$ SUB-CONSULTANTS: SITE BOULDER CIVIL/SURVEY: ENGINEERING & LAND PLANNING ASSOCIATES, INC. 219 Cuthbert Street, 5th/ Floor Philadelphia, PA 19106 MEP ENGINEER: SRW 417 N 8th Street, Suite 204 Philadelphia, PA 19123 267.585.2811 EXISTING BUILDING LIGHTING DESIGN: THE LIGHTING PRACTICE 600 Chestnut Street, Suite 772 Philadelphia, PA 19106 COST ESTIMATOR: ELLANA CONSTRUCTION CONSULTANTS 32 Broadway, 8TH Floor New York, NY 10004 NOTE: PLAYFUL LEARNING CONSULTANT: PLAYFUL LEARNING LANDSCAPES ACTION NEXTWORK SEE L-001 FOR LAYOUT NOTES. Philadelphia, PA 267.468.8610 ARBORIST: MORRIS ARBORETUM 100 East Northwestern Avenue Philadelphia, PA 19118 215.247.5777 ACCESSIBILITY CONSULTANT: CHRIS NOEL christopher.noel@parks.nyc.gov 646.632.7344 PLAY CONSULTANT: STUDIO LUDO 1313 S 33rd St, Unit A Philadelphia, PA 19146 CONSULTANT PROJECT NUMBER 2107 CITY OF PHILADELPHIA PHILADELPHIA PARKS AND RECREATION 1515 ARCH STREET 11TH FLOOR, ONE PARKWAY BUILDING PPR PROJECT NUMBER 16-21-7062-01 PROJECT TITLE: PENNYPACK PARK UNIVERSAL PLAYGROUND RHAWN ST. & HOLMEHURST AVE. PHILADELPHIA, PA 19136 DRAWING TITLE: LAYOUT PLAN -PLAYGROUND -SOUTHWEST PPR PROJECT NO .: DRAWING NO. 16-21-7062-01 CONSULTANT PROJECT NO .: 2107 DATE: 12/15/2023 L-104 SCALE: AS NOTED DRAWN BY: SS, TW CHECKED BY: TS NOTE: ALL DIMENSIONS AND CONDITIONS SHALL BE VERIFIED BY THE

CONTRACTOR AT THE SITE BEFORE PROCEEDING WITH THE WORK.

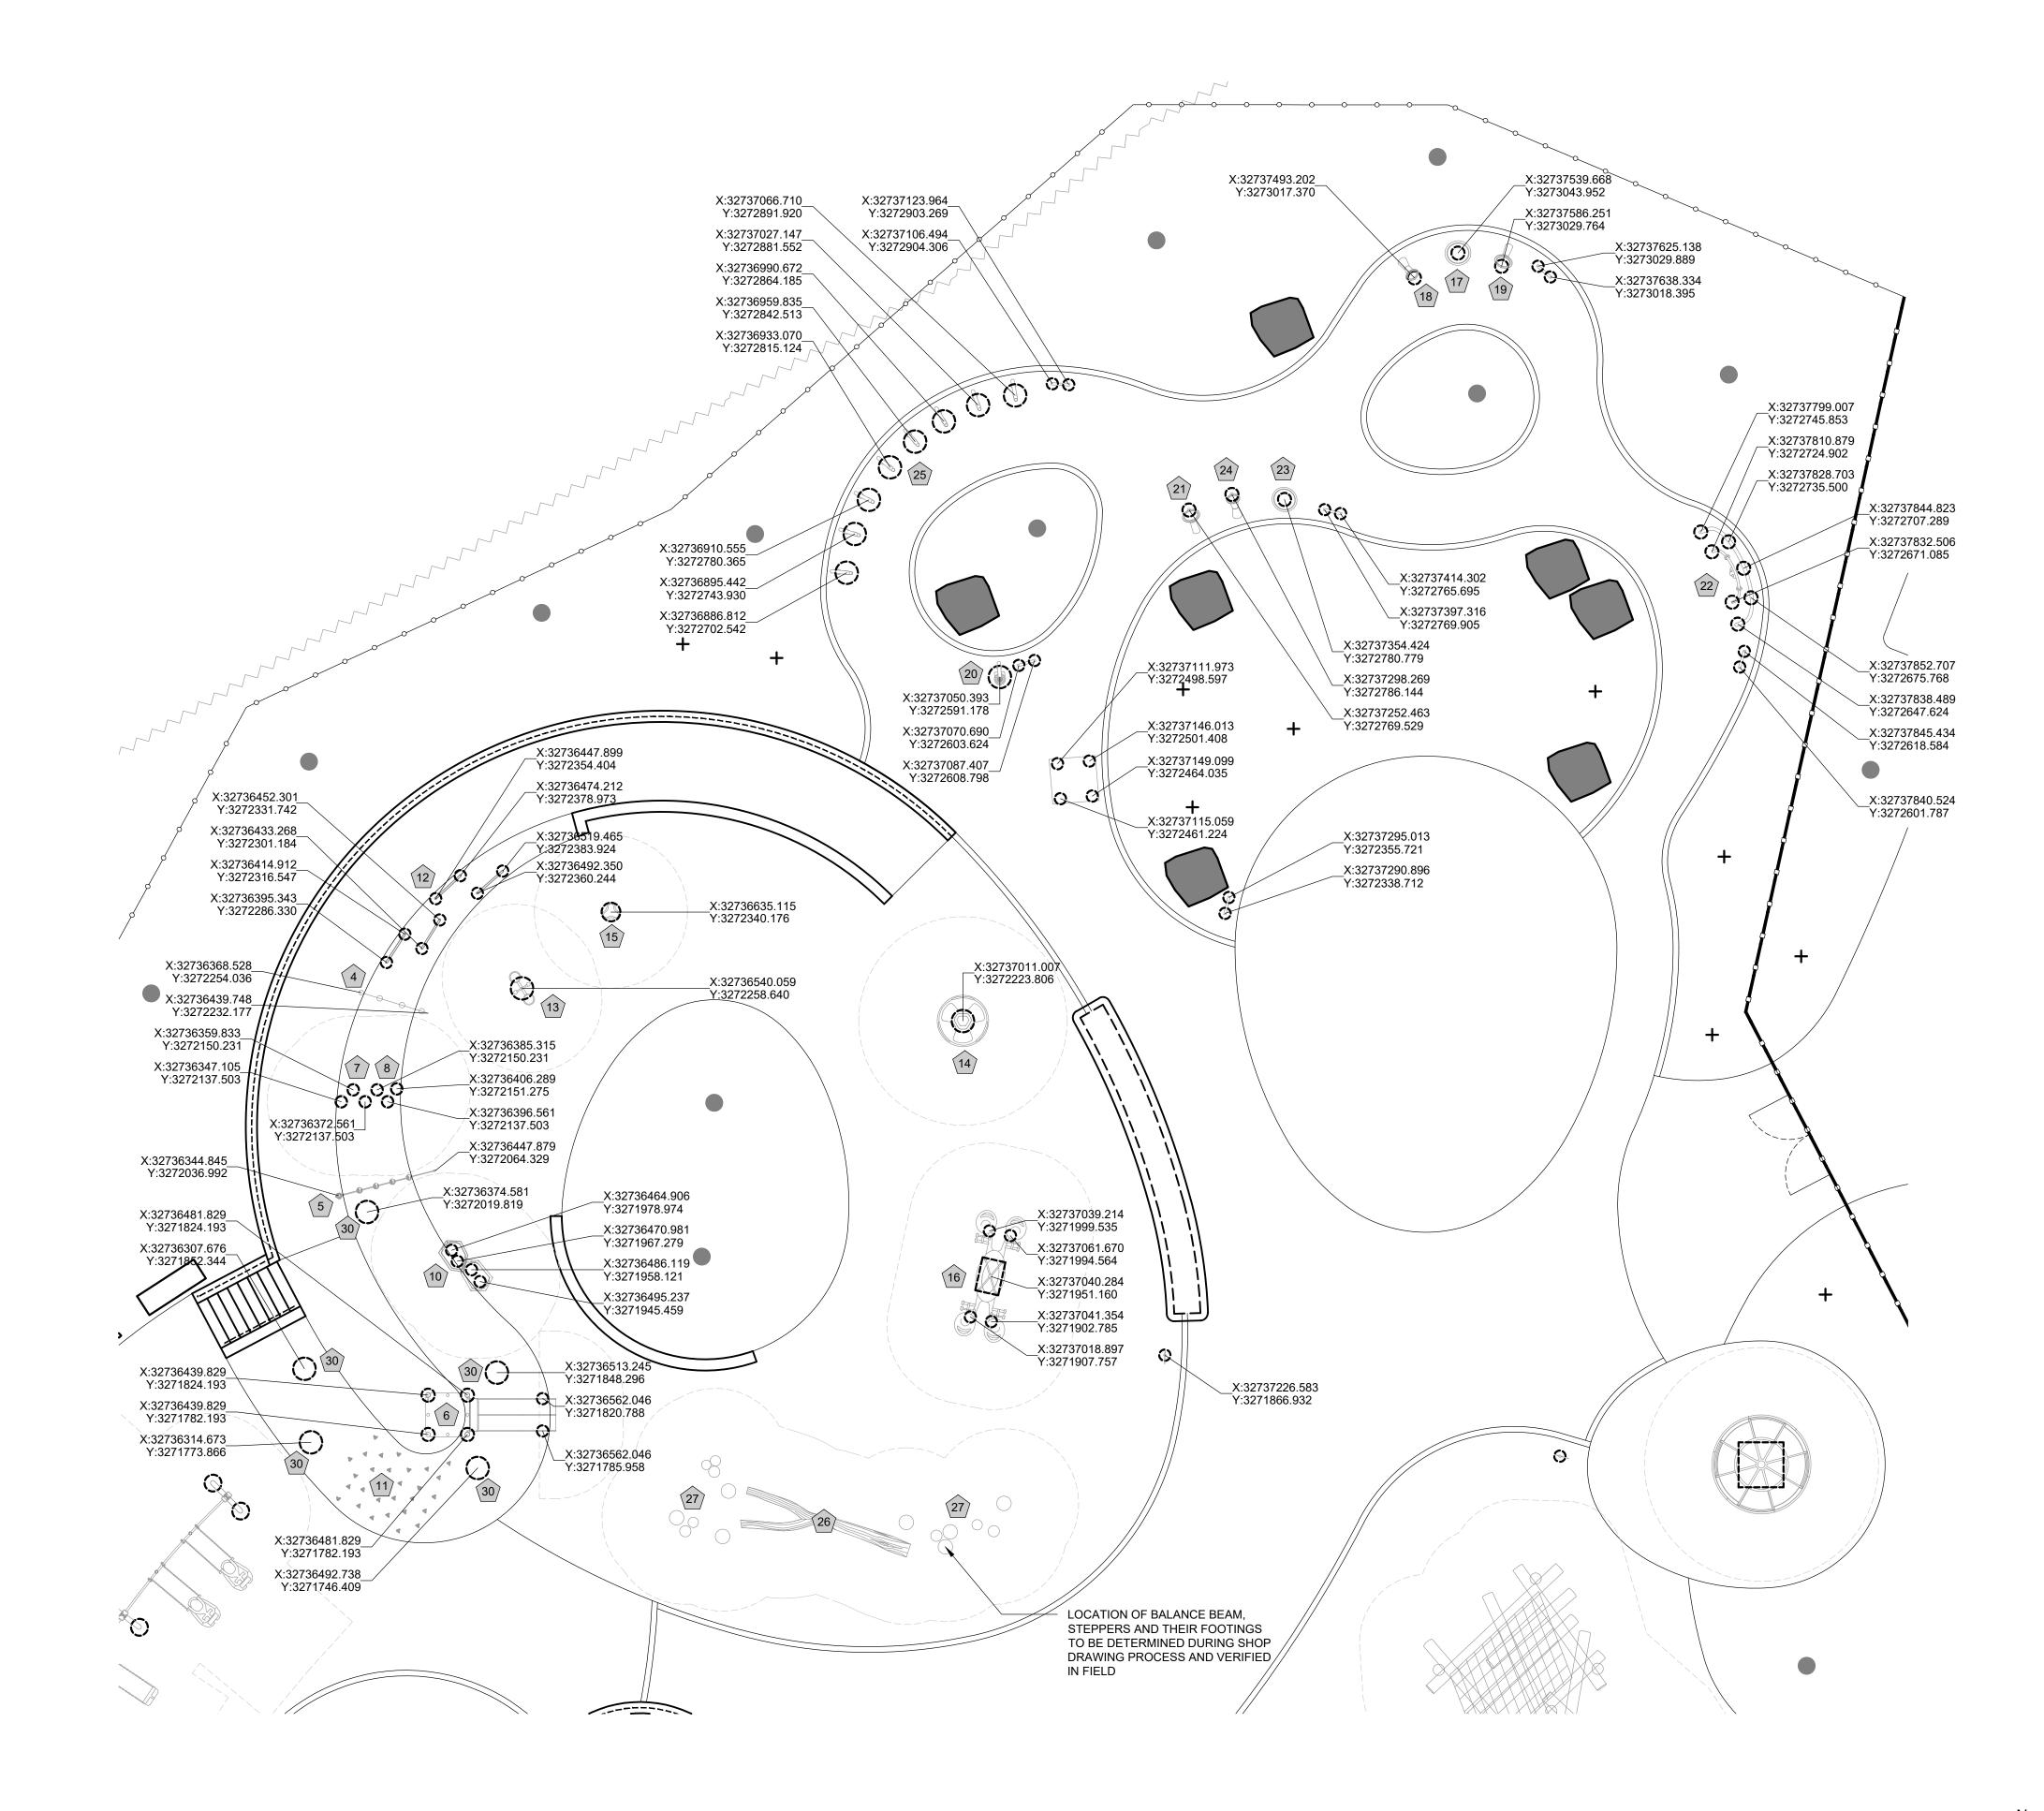

01 FOOTING LAYOUT PLAN - NORTH SCALE: 1/8" = 1'-0"




REVISIONS <u>LEGEND</u> ISSUE DATE REVISIONS TREE TRUNK C.I.P. CONCRETE CURB 01 L-903 ENTRY FENCE PENNSYLVANIA ONE CALL SYSTEM, INC. 925 Irwin Run Road West Mifflin, Pennsylvo 15122 - 1078 03 L-903 SECURITY FENCE AND GATE ____O___O___O___O___O__ BEFORE YOU DIG ANYWHERE IN PENNSYLVANIA! CALL 1-800-242-1776 NON-MEMBERS MUST BE CONTACTED DIRECTLY PA LAW REQUIRES THREE WORKING DAYS NOTICE TO UTILITIES BEFORE YOU EXCAVATE, DRILL, BLAST OR DEMOLISH RAIL _____ PA ONE-CALL NUMBER (FOR DESIGN ONLY): PPR PROJECT COORDINATOR: MEGAN FUNK SEAL: WOODLAND EDGE PROPOSED TREE + DATE SIGNED SIGNATUR A. R. 9 04/05/2024 08 L-901 SITE BOULDER PRIMARY CONSULTANT, LANDSCAPE ARCHITECT: MARVEL 145 Hudson Street, Floor 3 New York, NY 10013 FOOTING SUB-CONSULTANTS: CIVIL/SURVEY ENGINEERING & LAND PLANNING ASSOCIATES, INC. 219 Cuthbert Street, 5th/ Floor Philadelphia, PA 19106 MEP ENGINEER: 417 N 8th Street, Suite 204 Philadelphia, PA 19123 267.585.2811 FALL ZONE LIGHTING DESIGN: THE LIGHTING PRACTICE 600 Chestnut Street, Suite 772 Philadelphia, PA 19106 COST ESTIMATOR: ELLANA CONSTRUCTION CONSULTANTS 32 Broadway, 8TH Floor New York, NY 10004 PLAYFUL LEARNING CONSULTANT: PLAYFUL LEARNING LANDSCAPES ACTION NEXTWORK NOTES: Philadelphia, PA 267.468.8610 1. SEE L-001 FOR LAYOUT NOTES. ARBORIST: MORRIS ARBORETUM 100 East Northwestern Avenue Philadelphia, PA 19118 215.247.5777 2. COORDINATES SHOWN ARE LOCATING CENTER POINTS OF EACH FOOTING. REFER TO MANUFACTURER INSTALLATION SPECIFICATIONS FOR FOOTING DIMENSIONS. ACCESSIBILITY CONSULTANT: CHRIS NOEL christopher.noel@parks.nyc.gov 3. SEE L-120 FOR PLAY EQUIPMENT SCHEDULE. 646.632.7344 PLAY CONSULTANT: STUDIO LUDO 1313 S 33rd St, Unit A Philadelphia, PA 19146 CONSULTANT PROJECT NUMBER 2107 **CITY OF PHILADELPHIA** PHILADELPHIA PARKS AND RECREATION 1515 ARCH STREET 11TH FLOOR, ONE PARKWAY BUILDING PPR PROJECT NUMBER 16-21-7062-01 PROJECT TITLE: PENNYPACK PARK UNIVERSAL PLAYGROUND RHAWN ST. & HOLMEHURST AVE. PHILADELPHIA, PA 19136 DRAWING TITLE: FOOTING LAYOUT PLAN - NORTH PPR PROJECT NO .: DRAWING NO 16-21-7062-01 CONSULTANT PROJECT NO .: 2107 DATE: 12/15/2023 L-112 SCALE: AS NOTED DRAWN BY: SS, TW CHECKED BY

ALL DIMENSIONS AND CONDITIONS SHALL BE VERIFIED BY THE CONTRACTOR AT THE SITE BEFORE PROCEEDING WITH THE WORK.


NOTE

TS

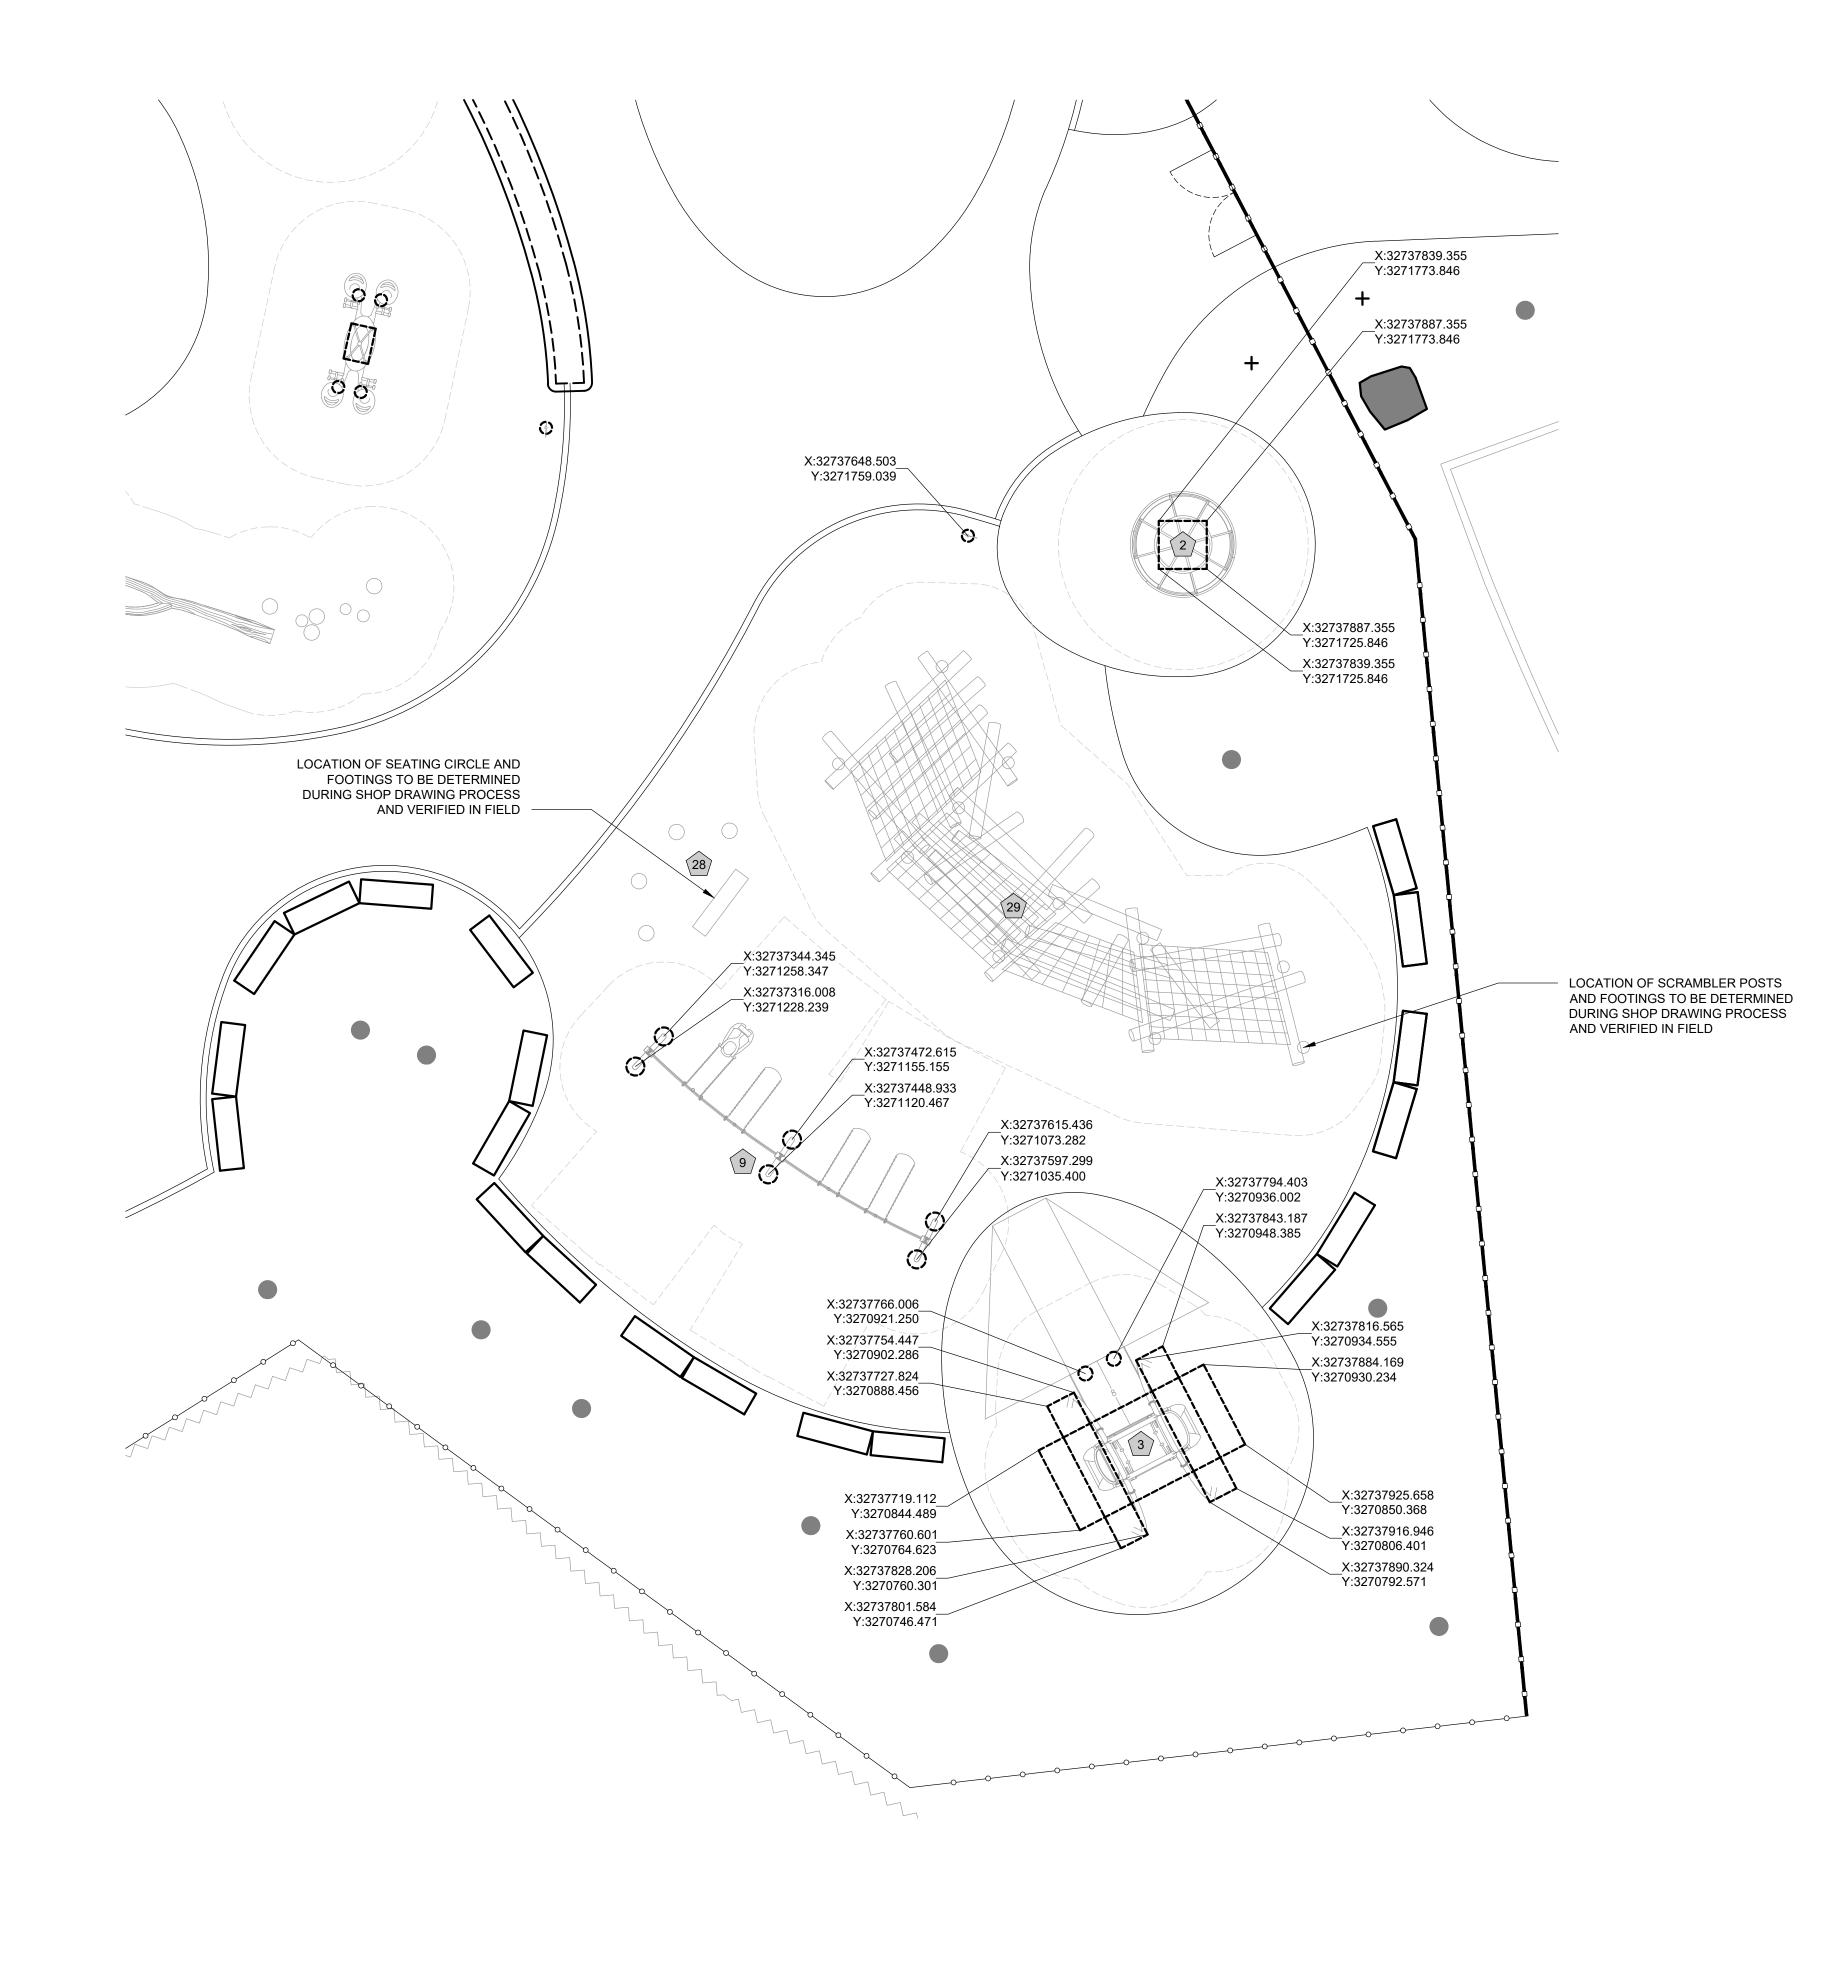



			REV	'ISIONS
	LEGEND		ISSUE DATE	REVISIONS
	TREE TRUNK			
	C.I.P. CONCRETE CURB			
01 L-903	ENTRY FENCE			NIA ONE CALL SYSTEM, INC. 925 Irwin Run Rood est Mifflin, Pennsylvonia 15122 – 1078
03 L-903	SECURITY FENCE AND GATE	ooo	BEFORE PENNSYLVAN	YOU DIG ANYWHERE IN NIA! CALL 1-800-242-1776
	RAIL			S MUST BE CONTACTED DIRECTLY REQUIRES THREE WORKING DAYS UTUTIESE BEFORE YOU EXCAVATE, ILL, BLAST OR DEMOLISH SN ONLY):
	WOODLAND EDGE		PPR PROJECT COORDINATOR:	MEGAN FUNK
	PROPOSED TREE	+	REGISTER	REGISTRATION 3379
06, 07 L-901	GRANITE BLOCK SEATING		SIGNATURE PRIMARY CONSULTANT, LANDSCAF MARVEL 145 Hudson Street, Floo	
	FOOTING		New York, NY 10013 SUB-CONSULTANTS: CIVIL/SURVEY:	
	FALL ZONE		ENGINEERING & LAND PLANNING A 219 Cuthbert Street, 5th/ Floor Philadelphia, PA 19106 MEP ENGINEER: SRW 417 N 8th Street, Suite 204 Philadelphia, PA 19123 267.585.2811 LIGHTING DESIGN: THE LIGHTING PRACTICE 600 Chestnut Street, Suite 772 Philadelphia, PA 19106	SSOCIATES, INC.
	 NOTES: SEE L-001 FOR LAYOUT NOTES. COORDINATES SHOWN ARE LOCAT EACH FOOTING. REFER TO MANUFA SPECIFICATIONS FOR FOOTING DIM SEE L-120 FOR PLAY EQUIPMENT SO 	CTURER INSTALLATION ENSIONS.	COST ESTIMATOR: ELLANA CONSTRUCTION CONSULT 32 Broadway, 8TH Floor New York, NY 10004 PLAYFUL LEARNING CONSULTANT: PLAYFUL LEARNING LANDSCAPES. Philadelphia, PA 267.468.8610 ARBORIST: MORRIS ARBORETUM 100 East Northwestern Avenue Philadelphia, PA 19118 215.247.5777 ACCESSIBILITY CONSULTANT: CHRIS NOEL christopher.noel@parks.nyc.gov 646.632.7344 PLAY CONSULTANT: STUDIO LUDO 1313 S 33rd St, Unit A Philadelphia, PA 19146	
			CONSULTANT PROJECT NUMBER	2107 PHILADELPHIA PARKS AND RECREATION
			1515	ARCH STREET ONE PARKWAY BUILDING
			UNIVERS RHAWN ST	16-21-7062-01 IYPACK PARK AL PLAYGROUND T. & HOLMEHURST AVE. DELPHIA, PA 19136
			DRAWING TITLE:	TING LAYOUT - SOUTHEAST
			CONSULTANT PROJECT NO.: DATE:	DRAWING NO.: 2107 2/15/2023 C NOTED
			A DRAWN BY: CHECKED BY: NOTE: ALL DIMENSIONS AN	S NOTED SS, TW TS D CONDITIONS SHALL BE VERIFIED BY THE SITE BEFORE PROCEEDING WITH THE WORK.

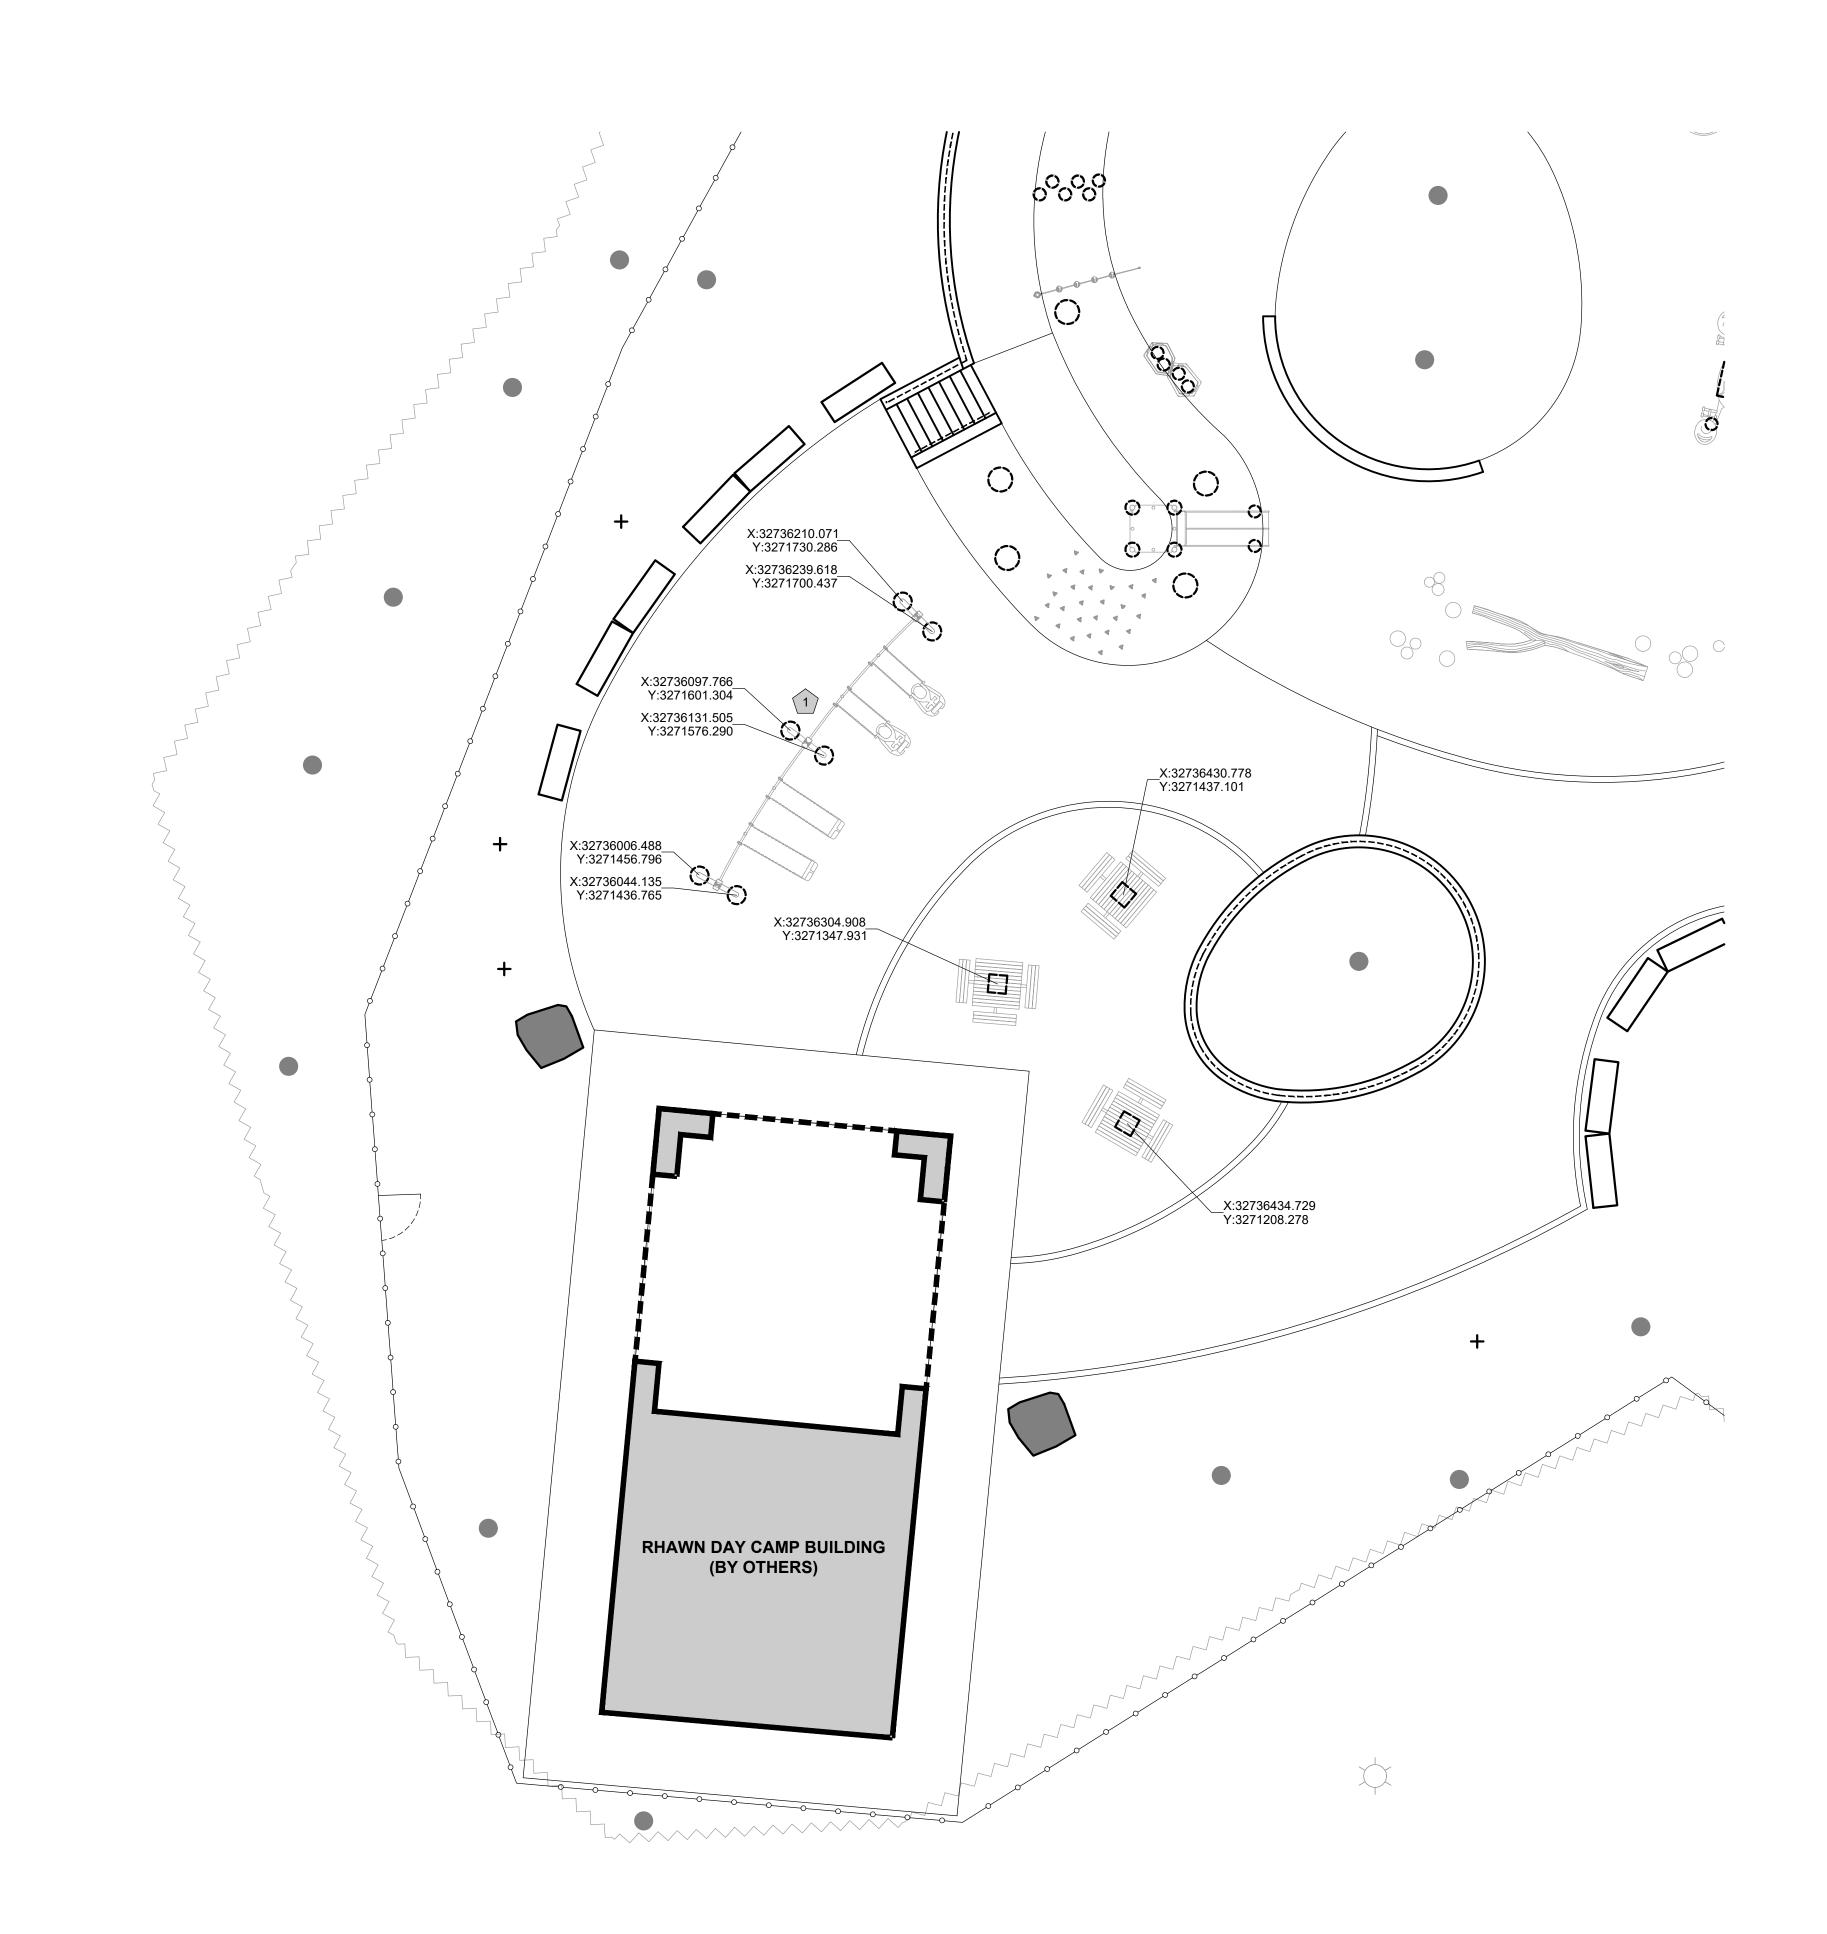



N 1/8"=1'-0"

		REVISIONS
	LEGEND	ISSUE DATE REVISIONS
	TREE TRUNK	
	C.I.P. CONCRETE CURB	THILADETPHIA MANETO
01	ENTRY FENCE	PENNSYLVANIA ONE CALL SYSTEM, INC. 925 Irwin Run Road
03	SECURITY FENCE AND GATE	West Mifflin, Pennsylvania 15122 - 1078
	RAIL	BEFORE YOU DIG ANYWHERE IN PENNSYLVANIA! CALL 1-800-242-1776 NON-MEMBERS MUST BE CONTACTED DIRECTLY PA LAW REQUIRES THREE WORKING DAYS NOTICE TO UTILITES BEFORE YOU EXCAVATE, DRILL, BLAST OR DEMOLISH PA ONE-CALL NUMBER (FOR DESIGN ONLY):
	WOODLAND EDGE	PPR PROJECT COORDINATOR: MEGAN FUNK SEAL: SEAL:
	PROPOSED TREE	REGISTRATION NUMBER 3379
	EXISTING BUILDING	SIGNATURE DATE SIGNED MARVEL 145 Hudson Street, Floor 3
96, 07 901	GRANITE BLOCK SEATING	SUB-CONSULTANTS: CIVIL/SURVEY: ENGINEERING & LAND PLANNING ASSOCIATES, INC. 219 Cuthbert Street, 5th/ Floor Philadelphia, PA 19106
08	SITE BOULDER	MEP ENGINEER: SRW 417 N 8th Street, Suite 204 Philadelphia, PA 19123 267.585.2811 LIGHTING DESIGN: THE LIGHTING PRACTICE 600 Chestnut Street, Suite 772 Philadelphia, PA 19106 COST ESTIMATOR:
	FOOTING	ELLANA CONSTRUCTION CONSULTANTS 32 Broadway, 8TH Floor New York, NY 10004 PLAYFUL LEARNING CONSULTANT: PLAYFUL LEARNING LANDSCAPES ACTION NEXTWORK Philadelphia, PA 267.468.8610 ARBORIST: MORRIS ARBORETUM 100 East Northwestern Avenue
	FALL ZONE	Philadelphia, PA 19118 215.247.5777 ACCESSIBILITY CONSULTANT: CHRIS NOEL christopher.noel@parks.nyc.gov 646.632.7344 PLAY CONSULTANT: STUDIO LUDO 1313 S 33rd St, Unit A Philadelphia, PA 19146
	NOTES:	CONSULTANT PROJECT NUMBER 2107
	 SEE L-001 FOR LAYOUT NOTES. COORDINATES SHOWN ARE LOCATING CENTER POINTS OF EACH FOOTING. REFER TO MANUFACTURER INSTALLATION SPECIFICATIONS FOR FOOTING DIMENSIONS. 	CITY OF PHILADELPHIA PHILADELPHIA PARKS AND RECREATION
	3. SEE L-120 FOR PLAY EQUIPMENT SCHEDULE.	1515 ARCH STREET 11TH FLOOR, ONE PARKWAY BUILDING
		PPR PROJECT NUMBER 16-21-7062-01
		PROJECT TITLE: PENNYPACK PARK UNIVERSAL PLAYGROUND RHAWN ST. & HOLMEHURST AVE. PHILADELPHIA, PA 19136
		DRAWING TITLE: FOOTING LAYOUT PLAN - SOUTHWEST
		PPR PROJECT NO.: DRAWING NO.: 16-21-7062-01 DRAWING NO.: CONSULTANT PROJECT NO.: 2107 DATE: 10/15/2000
		12/15/2023 SCALE: AS NOTED DRAWN BY: SS, TW CHECKED BY:

ALL DIMENSIONS AND CONDITIONS SHALL BE VERIFIED BY THE CONTRACTOR AT THE SITE BEFORE PROCEEDING WITH THE WORK.

	PLAY EQUIPMENT SCHEDULE					
TAG #	ITEM	QTY MODEL #	PRODUCT DESCRIPTION	FOOTING TYPE	MANUFACTURER	INSTALLATION
1	Curved Swingset System - 2-5 Age Group	1 CP033846 (2-5)	2 Bay (2) 2-5 AG. ADA Seats, (2) Full Bucket Seats. Antiwrap Swing Hangers.	Direct Bury	Landscape Structures Inc.	Per Manufactures Instructions
2	Wheelchair Accessible Spinner	1 248819A	We-Go-Round w/Perf Panels - 2 seats	Direct Bury	Landscape Structures Inc.	Per Manufactures Instructions
3	Wheelchair Accessible Swing	1 277778A	We-Go-Swing w/1 Accessible Bay	Direct Bury	Landscape Structures Inc.	Per Manufactures Instructions
4	Hillside Rope Climber	1 CP033511	Rope Pull Climber for 24" Elevation	Direct Bury	Landscape Structures Inc.	Per Manufactures Instructions
5	Hillside Rope Climber	1 CP034448	Rope Pull Climber for 48" Elevation	Direct Bury	Landscape Structures Inc.	Per Manufactures Instructions
6	Hillside Stainless Steel Slide	1 190857B	S/S Double Slide w/SteelX Hood, Posts, Grab Bar & Deck	Direct Bury	Landscape Structures Inc.	Per Manufactures Instructions
7	Hillside Pod Climber	2 158997A	Pod Climber 10" Height	Direct Bury	Landscape Structures Inc.	Per Manufactures Instructions
8	Hillside Pod Climber	4 120711A	Pod Climber 16" Height	Direct Bury	Landscape Structures Inc.	Per Manufactures Instructions
9	Curved Swingset System -5-12 Age Group	1 CP033846 (5-12)	2 Bay (1) 5-12 AG. ADA Seats, (3) Belt Seats. Antiwrap Swing Hangers.	Direct Bury	Landscape Structures Inc.	Per Manufactures Instructions
10	Hillside Transfer Station	1 CP029500	Angular GripX Transfer Station & Pods	Direct Bury	Landscape Structures Inc.	Per Manufactures Instructions
11	Hillside Climbing Grips	1 CP033040	Tri-Handhold Handgrips - Set of 30	Surface Mount	Landscape Structures Inc.	Per Manufactures Instructions
12	Hillside Climbing Loop	4 CP001153	Single Hill Loop 36" OC	Direct Bury	Landscape Structures Inc.	Per Manufactures Instructions
13	Independent Spring Rider	1 164075B	Double Bobble Rider	Direct Bury	Landscape Structures Inc.	Per Manufactures Instructions
14	Independent Bouncer	1 295696A	ReviRock Bouncer	Direct Bury	Landscape Structures Inc.	Per Manufactures Instructions
15	Independent Spinner	1 152179A	Saddle Spinner DB 12"Height	Direct Bury	Landscape Structures Inc.	Per Manufactures Instructions
16	Accessible See-Saw	1 186490A	We-saw	Direct Bury	Landscape Structures Inc.	Per Manufactures Instructions
17	Musical Equipment - 2-5 Age Group	1 228217A	Rhapsody Kettle Drum Junior	Direct Bury	Landscape Structures Inc.	Per Manufactures Instructions
18	Musical Equipment - 2-5 Age Group	1 228218A	Rhapsody Kundu Drum Junior	Direct Bury	Landscape Structures Inc.	Per Manufactures Instructions
19	Musical Equipment - 2-5 Age Group	1 228215A	Rhapsody Goblet Drum Junior	Direct Bury	Landscape Structures Inc.	Per Manufactures Instructions
20	Musical Equipment - 5-12 Age Group	1 250340A	Rhapsody Cascata Bells	Direct Bury	Landscape Structures Inc.	Per Manufactures Instructions
21	Musical Equipment - 5-12 Age Group	1 214443A	Rhapsody Goblet Drum	Direct Bury	Landscape Structures Inc.	Per Manufactures Instructions
22	Musical Equipment - 5-12 Age Group	1 214442A	Rhapsody Grandioso Chimes	Direct Bury	Landscape Structures Inc.	Per Manufactures Instructions
23	Musical Equipment - 5-12 Age Group	1 214445A	Rhapsody Kettle Drum	Direct Bury	Landscape Structures Inc.	Per Manufactures Instructions
24	Musical Equipment - 5-12 Age Group	1 214444A	Rhapsody Kundu Drum	Direct Bury	Landscape Structures Inc.	Per Manufactures Instructions
25	Musical Equipment - 5-12 Age Group	1 251573A	Rhapsody Vibra Chimes - Full Set	Direct Bury	Landscape Structures Inc.	Per Manufactures Instructions
26	Log Balance Beam	1 Custom	Whole tree with branches laid horizontally	Surface Mount	Whole Trees	Per Manufactures Instructions
27	Log Steppers	8 Custom	Stumps at varrying heights	Direct Bury	Whole Trees	Per Manufactures Instructions
28	Seating Circle	1 Custom	Split log bench (1) w/ Stump Benches (4)	Direct Bury, Pinning	Whole Trees	Per Manufactures Instructions
29	Scrambler	1 Custom	Large lumber climber on posts (11) w/ Netting	Direct Bury	Whole Trees	Per Manufactures Instructions
30	Grove Sculpture	5 Custom	Large (25' ht.) whole trees with branching	Direct Bury	Whole Trees	Per Manufactures Instructions

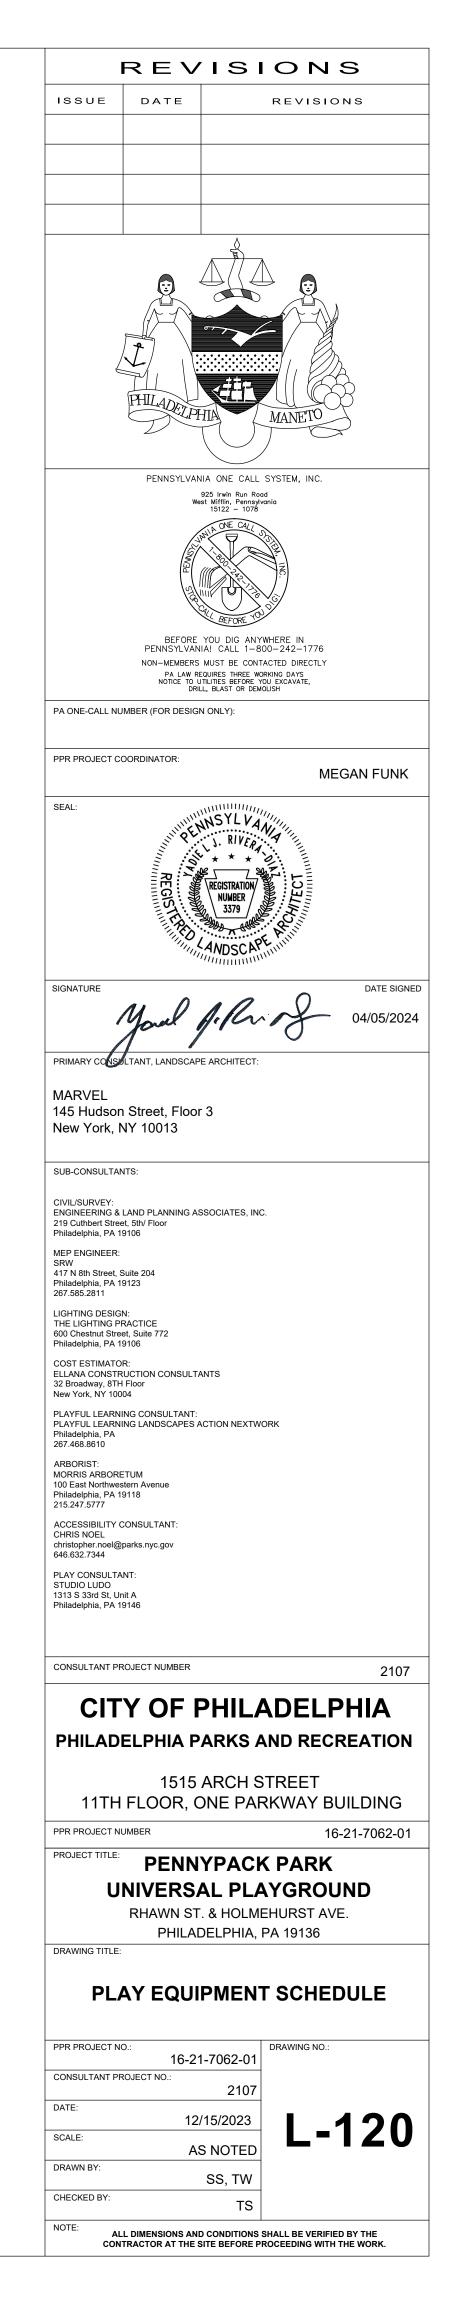

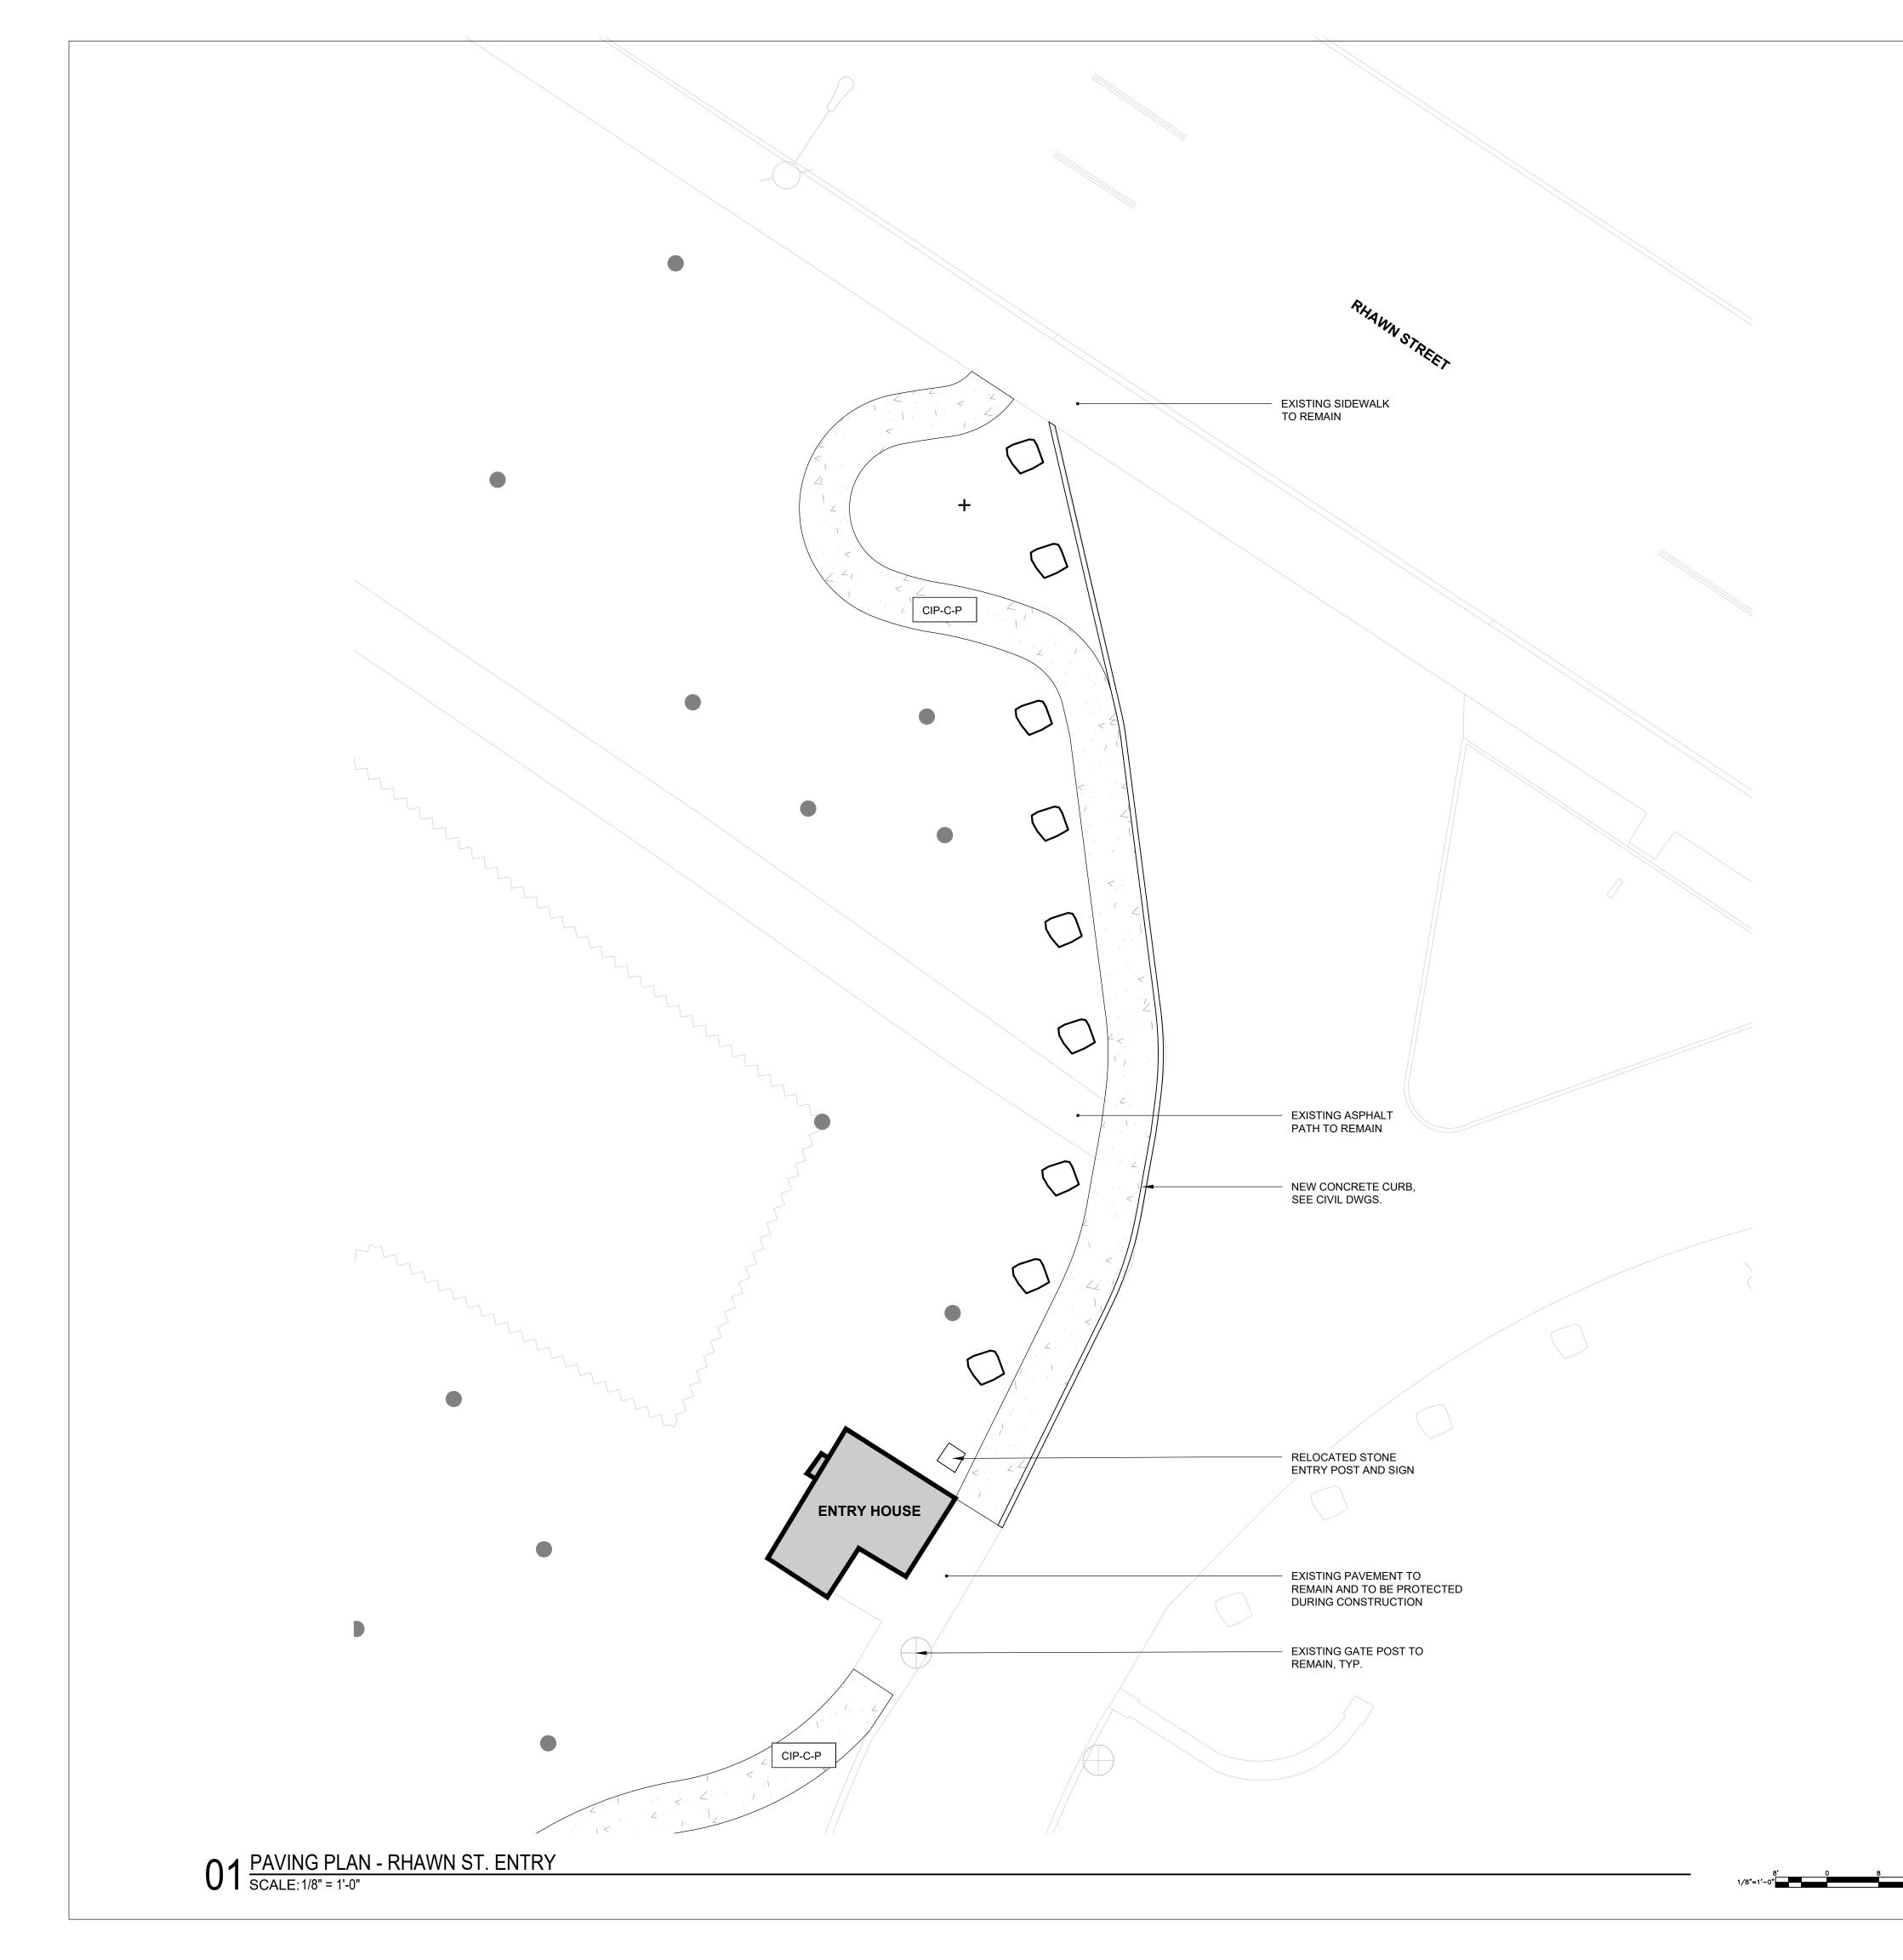


N

REVISIONS <u>LEGEND</u> ISSUE DATE REVISIONS TREE TRUNK C.I.P. CONCRETE CURB STREET LIGHT POLE PENNSYLVANIA ONE CALL SYSTEM, INC. 925 Irwin Run Road West Mifflin, Pennsylvania 15122 — 1078 WOODLAND EDGE BEFORE YOU DIG ANYWHERE IN PENNSYLVANIA! CALL 1-800-242-1776 NON-MEMBERS MUST BE CONTACTED DIRECTLY PA LAW REQUIRES THREE WORKING DAYS NOTICE TO UTILITIES BEFORE YOU EXCAVATE, DRILL, BLAST OR DEMOLISH EXISTING BUILDING PA ONE-CALL NUMBER (FOR DESIGN ONLY): PPR PROJECT COORDINATOR: MEGAN FUNK SEAL: PROPOSED TREE 01 L-900 C.I.P. CONCRETE PAVING - AT CIP-C-P PATHWAYS Jare SIGNED Marel J. R. J. 04/05/2024 SIGNATURE PRIMARY CONSULTANT, LANDSCAPE ARCHITECT: EXISTING BOULDER MARVEL 145 Hudson Street, Floor 3 New York, NY 10013 NOTE: SUB-CONSULTANTS: FOR PAVING NOTES, SEE L-001. CIVIL/SURVEY: ENGINEERING & LAND PLANNING ASSOCIATES, INC. 219 Cuthbert Street, 5th/ Floor Philadelphia, PA 19106 MEP ENGINEER: SRW 417 N 8th Street, Suite 204 Philadelphia, PA 19123 267.585.2811 LIGHTING DESIGN: THE LIGHTING PRACTICE 600 Chestnut Street, Suite 772 Philadelphia, PA 19106 COST ESTIMATOR: ELLANA CONSTRUCTION CONSULTANTS 32 Broadway, 8TH Floor New York, NY 10004 PLAYFUL LEARNING CONSULTANT: PLAYFUL LEARNING LANDSCAPES ACTION NEXTWORK Philadelphia, PA 267.468.8610 ARBORIST: MORRIS ARBORETUM 100 East Northwestern Avenue Philadelphia, PA 19118 215.247.5777 ACCESSIBILITY CONSULTANT: CHRIS NOEL christopher.noel@parks.nyc.gov 646.632.7344 PLAY CONSULTANT: STUDIO LUDO 1313 S 33rd St, Unit A Philadelphia, PA 19146 CONSULTANT PROJECT NUMBER 2107 **CITY OF PHILADELPHIA** PHILADELPHIA PARKS AND RECREATION 1515 ARCH STREET 11TH FLOOR, ONE PARKWAY BUILDING PPR PROJECT NUMBER 16-21-7062-01 PROJECT TITLE: PENNYPACK PARK UNIVERSAL PLAYGROUND RHAWN ST. & HOLMEHURST AVE. PHILADELPHIA, PA 19136 DRAWING TITLE: PAVING PLAN - RHAWN ST. ENTRY PPR PROJECT NO .: DRAWING NO .: 16-21-7062-01 CONSULTANT PROJECT NO .: 2107 DATE: 12/15/2023 L-200 SCALE: AS NOTED DRAWN BY: SS, TW CHECKED BY: TS NOTE: ALL DIMENSIONS AND CONDITIONS SHALL BE VERIFIED BY THE CONTRACTOR AT THE SITE BEFORE PROCEEDING WITH THE WORK.



REVISIONS <u>LEGEND</u> ISSUE DATE REVISIONS TREE TRUNK C.I.P. CONCRETE CURB 01 L-903 ENTRY FENCE PENNSYLVANIA ONE CALL SYSTEM, INC. 925 Irwin Run Road West Mifflin, Pennsylvania 15122 — 1078 03 L-903 SECURITY FENCE AND GATE ____<u>O</u>___O___O___O__ BEFORE YOU DIG ANYWHERE IN PENNSYLVANIA! CALL 1-800-242-1776 NON-MEMBERS MUST BE CONTACTED DIRECTLY PA LAW REQUIRES THREE WORKING DAYS NOTICE TO UTILITIES BEFORE YOU EXCAVATE, DRILL, BLAST OR DEMOLISH WOODLAND EDGE PA ONE-CALL NUMBER (FOR DESIGN ONLY): PPR PROJECT COORDINATOR: MEGAN FUNK SEAL: PROPOSED TREE 08 L-901 SITE BOULDER DATE SIGNED SIGNATURE I Arland 04/05/2024 01 L-900 C.I.P. CONCRETE PAVING - AT PATHWAYS CIP-C-P PRIMARY CONSULTANT, LANDSCAPE ARCHITECT: MARVEL 145 Hudson Street, Floor 3 New York, NY 10013 (03) L-900 POROUS CONCRETE PC SUB-CONSULTANTS: PAVING CIVIL/SURVEY: ENGINEERING & LAND PLANNING ASSOCIATES, INC. 219 Cuthbert Street, 5th/ Floor Philadelphia, PA 19106 MEP ENGINEER: SRW 417 N 8th Street, Suite 204 Philadelphia, PA 19123 267.585.2811 NOTE: LIGHTING DESIGN: THE LIGHTING PRACTICE 600 Chestnut Street, Suite 772 Philadelphia, PA 19106 FOR PAVING NOTES, SEE L-001. COST ESTIMATOR: ELLANA CONSTRUCTION CONSULTANTS 32 Broadway, 8TH Floor New York, NY 10004 PLAYFUL LEARNING CONSULTANT: PLAYFUL LEARNING LANDSCAPES ACTION NEXTWORK Philadelphia, PA 267.468.8610 ARBORIST: MORRIS ARBORETUM 100 East Northwestern Avenue Philadelphia, PA 19118 215.247.5777 ACCESSIBILITY CONSULTANT: CHRIS NOEL christopher.noel@parks.nyc.gov 646.632.7344 PLAY CONSULTANT: STUDIO LUDO 1313 S 33rd St, Unit A Philadelphia, PA 19146 CONSULTANT PROJECT NUMBER 2107 **CITY OF PHILADELPHIA** PHILADELPHIA PARKS AND RECREATION 1515 ARCH STREET 11TH FLOOR, ONE PARKWAY BUILDING PPR PROJECT NUMBER 16-21-7062-01 PROJECT TITLE: PENNYPACK PARK UNIVERSAL PLAYGROUND RHAWN ST. & HOLMEHURST AVE. PHILADELPHIA, PA 19136 DRAWING TITLE: **PAVING PLAN - PARKING** AREA PPR PROJECT NO .: DRAWING NO .: 16-21-7062-01 CONSULTANT PROJECT NO .: 2107 DATE: 12/15/2023 L-201 SCALE: AS NOTED DRAWN BY: SS, TW CHECKED BY: TS NOTE: ALL DIMENSIONS AND CONDITIONS SHALL BE VERIFIED BY THE CONTRACTOR AT THE SITE BEFORE PROCEEDING WITH THE WORK.

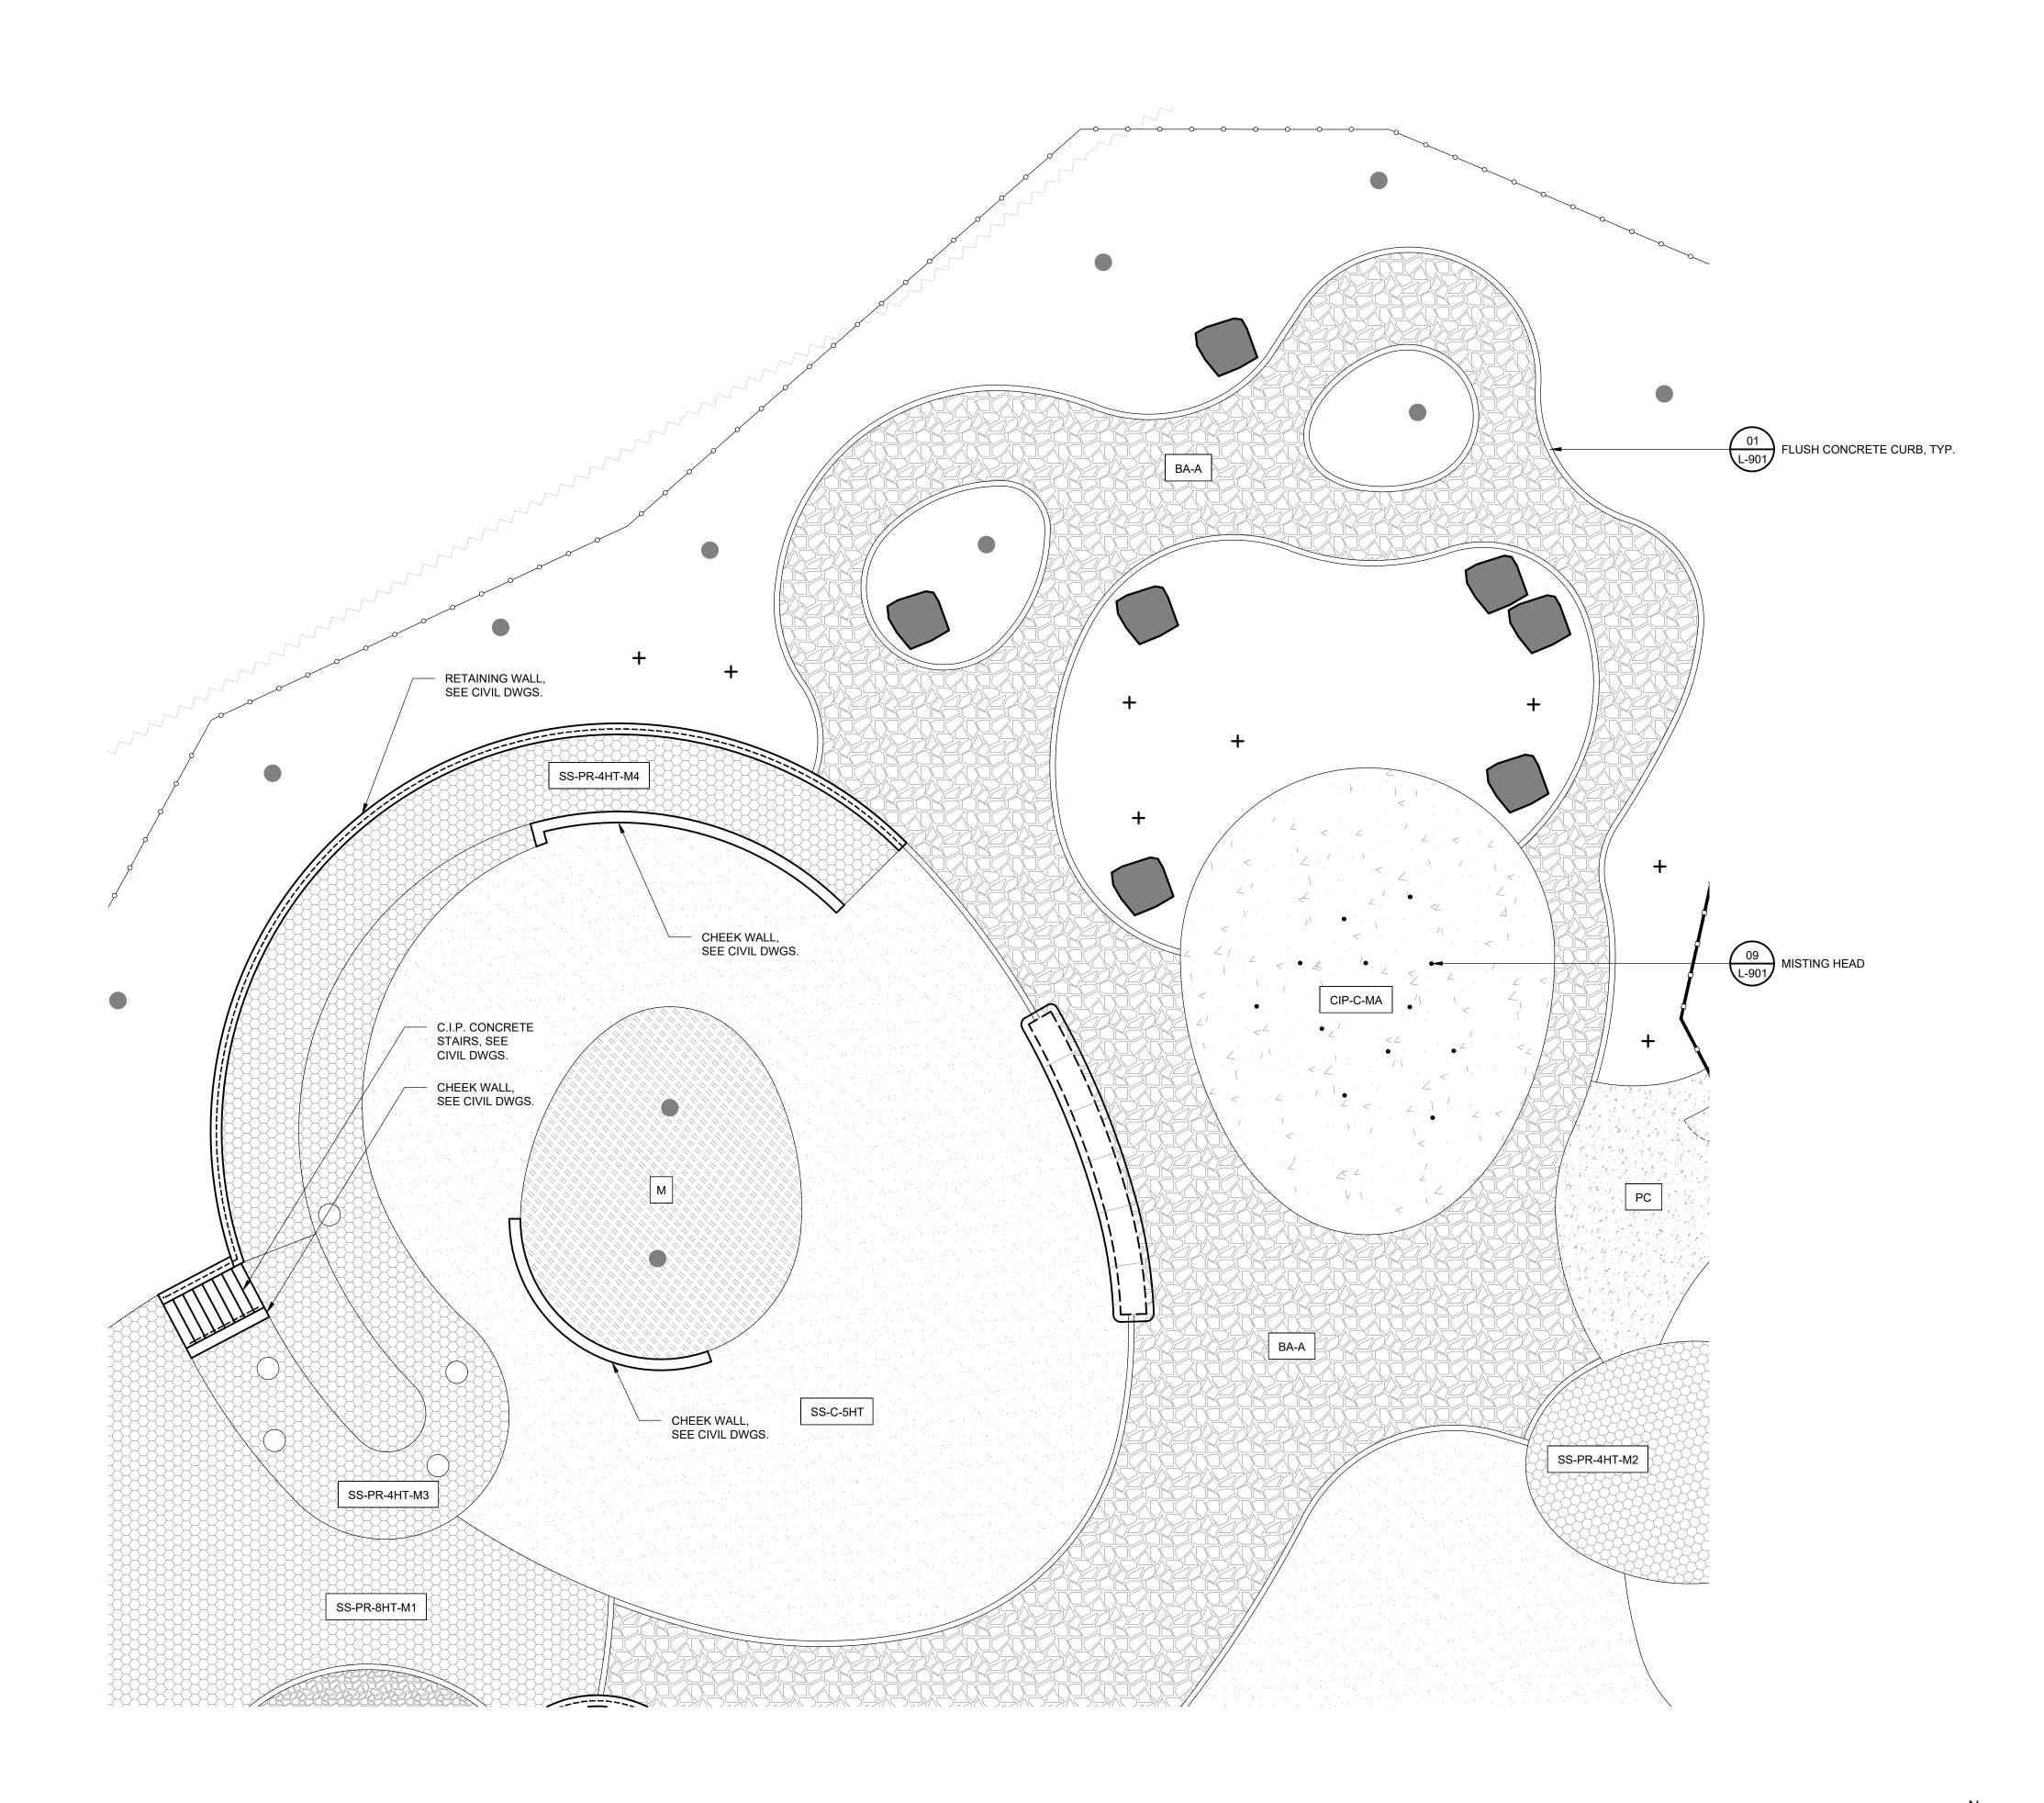

01 PAVING PLAN - PLAYGROUND - NORTH SCALE: 1/8" = 1'-0"

				REV	ISIONS
	LEGEND		ISSUE	DATE	REVISIONS
	TREE TRUNK				
	C.I.P. CONCRETE CURB		Ę		
01 L-903	ENTRY FENCE			9	A ONE CALL SYSTEM, INC. 25 Irwin Run Road Wifflin, Pennsyvania
03 L-903	SECURITY FENCE AND GATE	ooo		BEFORE	15122 - 1078 A OVE CALL BEFORE TO COU DIG ANYWHERE IN AL CALL 1-800-242-1776
	RAIL		PA ONE-CALL NU	NON-MEMBERS	MUST BE CONTACTED DIRECTLY DURES THREE WORKING DAYS ILITIES BEFORE YOU EXCAVATE, , BLAST OR DEMOLISH
			PPR PROJECT C	OORDINATOR:	MEGAN FUNK
	WOODLAND EDGE	~~~~~~	SEAL:		NSYL V AN 1999 S. RIVER
	PROPOSED TREE	+		REGISTER	REGISTRATION NUMBER 3379
			SIGNATURE	AL D	
08	SITE BOULDER			Your J	v
L-901	SITE BOULDER		MARVEL		
			145 Hudsor New York, I	n Street, Floor NY 10013	3
02 L-900	C.I.P. CONCRETE PAVING - AT MISTING AREA		SUB-CONSULTA	NTS:	
			CIVIL/SURVEY: ENGINEERING & 219 Cuthbert Stre Philadelphia, PA 1		SOCIATES, INC.
03			MEP ENGINEER: SRW 417 N 8th Street, 3 Philadelphia, PA 1	Suite 204	
L-900	POROUS CONCRETE PAVING		267.585.2811 LIGHTING DESIG THE LIGHTING P	RACTICE	
			600 Chestnut Stre Philadelphia, PA 1 COST ESTIMATC	9106	271
08	SAFETY SURFACE - CORKEEN,	SS-C-5HT	32 Broadway, 8TH New York, NY 100	l Floor	NIS
L-900	5' FALL HT.		PLAYFUL LEARN Philadelphia, PA 267.468.8610	ING LANDSCAPES AC	CTION NEXTWORK
			ARBORIST: MORRIS ARBORI 100 East Northwe Philadelphia, PA 1 215.247.5777	stern Avenue	
05 L-900	SAFETY SURFACE - POURED RUBBER, 4' FALL HT., MIX 2	SS-PR-4HT-M2	ACCESSIBILITY (CHRIS NOEL christopher.noel@		
			646.632.7344 PLAY CONSULTA STUDIO LUDO	NT:	
			1313 S 33rd St, U Philadelphia, PA 1		
05 L-900	SAFETY SURFACE - POURED RUBBER, 4' FALL HT., MIX 3	SS-PR-4HT-M3	CONSULTANT PF	ROJECT NUMBER	2107
			CIT	Y OF F	HILADELPHIA
05		<u> </u>	PHILAD	ELPHIA P/	ARKS AND RECREATION
L-900	SAFETY SURFACE - POURED RUBBER, 4' FALL HT., MIX 4	SS-PR-4HT-M4	11TH		ARCH STREET NE PARKWAY BUILDING
			PPR PROJECT N	UMBER	16-21-7062-01
06 L-900	SAFETY SURFACE - POURED RUBBER, 8' FALL HT., MIX 1	SS-PR-8HT-M1		PENN NIVERSA RHAWN ST.	PACK PARK L PLAYGROUND & HOLMEHURST AVE. ELPHIA, PA 19136
			DRAWING TITLE:	:	ING PLAN -
04 L-900	BOUND AGGREGATE PAVING - TYPE A	BA-A	PPR PROJECT N	PLA ` o.:	YGROUND - NORTH DRAWING NO.:
			CONSULTANT PP	16-21	2107
	MULCH		DATE: SCALE:	12/	L-202
	NOTE:		DRAWN BY:		NOTED SS, TW
	 FOR PAVING NOTES, SEE L-001. FOR PAVING SCHEDULE, SEE L-210. 		CHECKED BY:		

ALL DIMENSIONS AND CONDITIONS SHALL BE VERIFIED BY THE CONTRACTOR AT THE SITE BEFORE PROCEEDING WITH THE WORK.

- FOR PAVING NOTES, SEE L-001.
 FOR PAVING SCHEDULE, SEE L-210.





REVISIONS <u>LEGEND</u> ISSUE DATE REVISIONS TREE TRUNK C.I.P. CONCRETE CURB 01 L-903 ENTRY FENCE PENNSYLVANIA ONE CALL SYSTEM, INC. 925 Irwin Run Road West Mifflin, Pennsylvania 15122 — 1078 03 L-903 SECURITY FENCE AND GATE ____O___O___O___O__ BEFORE YOU DIG ANYWHERE IN PENNSYLVANIA! CALL 1-800-242-1776 NON-MEMBERS MUST BE CONTACTED DIRECTLY PA LAW REQUIRES THREE WORKING DAYS NOTICE TO UTILITIES BEFORE YOU EXCAVATE, DRILL, BLAST OR DEMOLISH RAIL _____ PA ONE-CALL NUMBER (FOR DESIGN ONLY): PPR PROJECT COORDINATOR: MEGAN FUNK SEAL: WOODLAND EDGE PROPOSED TREE + e DATE SIGNED Marel Arland 04/05/2024 SIGNATURE 08 L-901 SITE BOULDER PRIMARY CONSULTANT, LANDSCAPE ARCHITECT: MARVEL 145 Hudson Street, Floor 3 New York, NY 10013 SUB-CONSULTANTS: 06, 07 L-901 GRANITE BLOCK SEATING CIVIL/SURVEY: ENGINEERING & LAND PLANNING ASSOCIATES, INC. 219 Cuthbert Street, 5th/ Floor Philadelphia, PA 19106 MEP ENGINEER: SRW 417 N 8th Street, Suite 204 Philadelphia, PA 19123 267.585.2811 01 L-900 C.I.P. CONCRETE PAVING - AT PATHWAYS CIP-C-P LIGHTING DESIGN: THE LIGHTING PRACTICE 600 Chestnut Street, Suite 772 Philadelphia, PA 19106 COST ESTIMATOR: ELLANA CONSTRUCTION CONSULTANTS 32 Broadway, 8TH Floor New York, NY 10004 PLAYFUL LEARNING CONSULTANT: PLAYFUL LEARNING LANDSCAPES ACTION NEXTWORK Philadelphia, PA 267.468.8610 03 L-900 POROUS CONCRETE PAVING ARBORIST: MORRIS ARBORETUM 100 East Northwestern Avenue Philadelphia, PA 19118 215.247.5777 ACCESSIBILITY CONSULTANT: 08 L-900 CHRIS NOEL christopher.noel@parks.nyc.gov 646.632.7344 SAFETY SURFACE - CORKEEN, 5' FALL HT. SS-C-5HT PLAY CONSULTANT: STUDIO LUDO 1313 S 33rd St, Unit A Philadelphia, PA 19146 SAFETY SURFACE - CORKEEN, SS-C-8HT 09 L-900 8' FALL HT. CONSULTANT PROJECT NUMBER 2107 **CITY OF PHILADELPHIA** PHILADELPHIA PARKS AND RECREATION 04, 05 L-900 1515 ARCH STREET SAFETY SURFACE - POURED SS-PR-4HT-M2 RUBBER, 4' FALL HT., MIX 2 11TH FLOOR, ONE PARKWAY BUILDING PPR PROJECT NUMBER 16-21-7062-01 PROJECT TITLE: PENNYPACK PARK UNIVERSAL PLAYGROUND 03 L-900 BOUND AGGREGATE PAVING -BA-A RHAWN ST. & HOLMEHURST AVE. TYPE A PHILADELPHIA, PA 19136 DRAWING TITLE: **PAVING PLAN -**PLAYGROUND -NOTE: SOUTHEAST FOR PAVING NOTES, SEE L-001. PPR PROJECT NO .: DRAWING NO. 16-21-7062-01 CONSULTANT PROJECT NO .: 2107 DATE: 12/15/2023 L-203 SCALE:

TS


AS NOTED

SS, TW

DRAWN BY:

CHECKED BY:

NOTE:

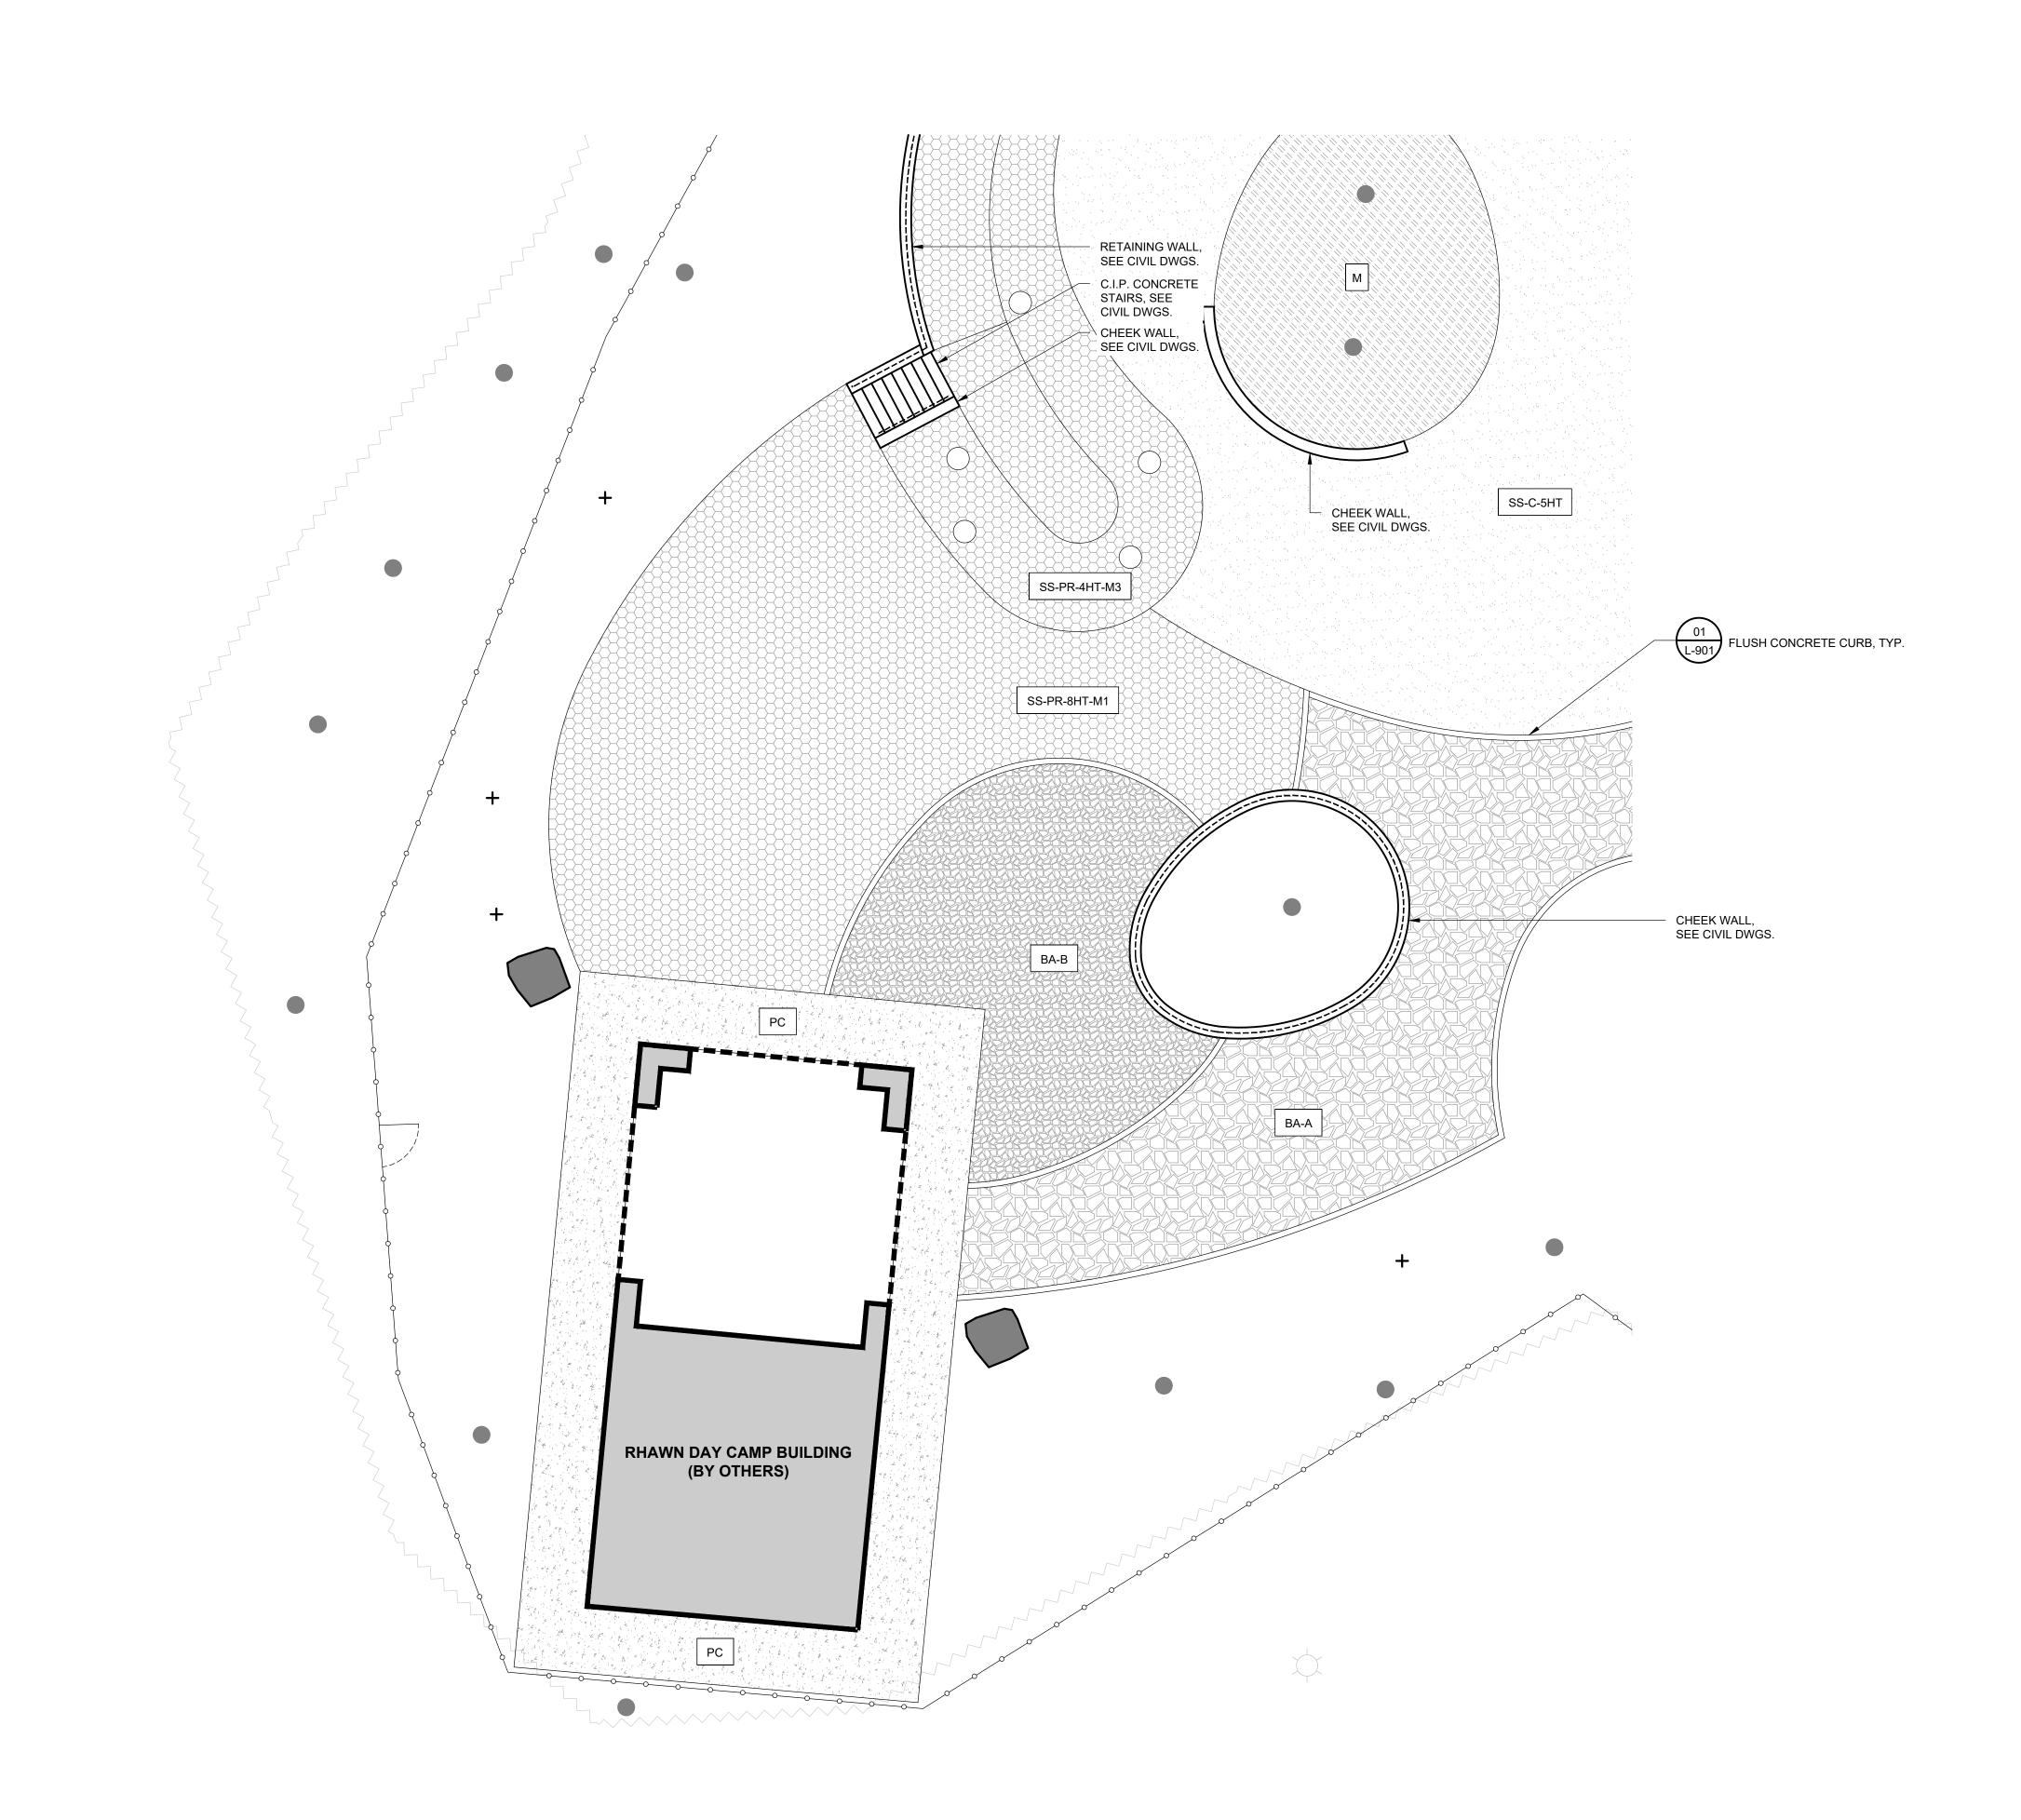



REVISIONS <u>LEGEND</u> ISSUE DATE REVISIONS TREE TRUNK C.I.P. CONCRETE CURB 01 L-903 ENTRY FENCE PENNSYLVANIA ONE CALL SYSTEM, INC. 03 L-903 925 Irwin Run Road West Mifflin, Pennsylvania 15122 — 1078 SECURITY FENCE AND GATE RAIL _____ BEFORE YOU DIG ANYWHERE IN PENNSYLVANIA! CALL 1-800-242-1776 NON-MEMBERS MUST BE CONTACTED DIRECTLY PA LAW REQUIRES THREE WORKING DAYS NOTICE TO UTILITIES BEFORE YOU EXCAVATE, DRILL, BLAST OR DEMOLISH PA ONE-CALL NUMBER (FOR DESIGN ONLY): WOODLAND EDGE PPR PROJECT COORDINATOR: MEGAN FUNK SEAL: PROPOSED TREE + 08 L-901 SITE BOULDER DATE SIGNED al film o4/05/2024 SIGNATURE (06, 07 L-901 GRANITE BLOCK SEATING PRIMARY CONSULTANT, LANDSCAPE ARCHITECT: MARVEL 145 Hudson Street, Floor 3 03 L-900 POROUS CONCRETE New York, NY 10013 PAVING SUB-CONSULTANTS: CIVIL/SURVEY: ENGINEERING & LAND PLANNING ASSOCIATES, INC. 219 Cuthbert Street, 5th/ Floor Philadelphia, PA 19106 08 L-900 SAFETY SURFACE - CORKEEN, SS-C-5HT MEP ENGINEER: 5' FALL HT. SRW 417 N 8th Street, Suite 204 Philadelphia, PA 19123 267.585.2811 LIGHTING DESIGN: THE LIGHTING PRACTICE 600 Chestnut Street, Suite 772 Philadelphia, PA 19106 05 L-900 SAFETY SURFACE - POURED COST ESTIMATOR: ELLANA CONSTRUCTION CONSULTANTS 32 Broadway, 8TH Floor New York, NY 10004 SS-PR-4HT-M3 RUBBER, 4' FALL HT., MIX 3 PLAYFUL LEARNING CONSULTANT: PLAYFUL LEARNING LANDSCAPES ACTION NEXTWORK Philadelphia, PA 267.468.8610 ARBORIST: MORRIS ARBORETUM \prec \rightarrow \rightarrow \rightarrow \rightarrow \rightarrow \rightarrow \rightarrow \rightarrow 06 L-900 SAFETY SURFACE - POURED SS-PR-8HT-M1 100 East Northwestern Avenue Philadelphia, PA 19118 215.247.5777 RUBBER, 8' FALL HT., MIX 1 ACCESSIBILITY CONSULTANT: CHRIS NOEL christopher.noel@parks.nyc.gov 646.632.7344 PLAY CONSULTANT: STUDIO LUDO 1313 S 33rd St, Unit A Philadelphia, PA 19146 04 L-900 BOUND AGGREGATE PAVING -BA-A TYPE A CONSULTANT PROJECT NUMBER 2107 CITY OF PHILADELPHIA 04 L-900 BOUND AGGREGATE PAVING -BA-B TYPE B PHILADELPHIA PARKS AND RECREATION 1515 ARCH STREET 11TH FLOOR, ONE PARKWAY BUILDING PPR PROJECT NUMBER 16-21-7062-01 M MULCH PROJECT TITLE: PENNYPACK PARK UNIVERSAL PLAYGROUND RHAWN ST. & HOLMEHURST AVE. PHILADELPHIA, PA 19136 DRAWING TITLE: EXISTING BUILDING **PAVING PLAN -**PLAYGROUND -SOUTHWEST PPR PROJECT NO .: DRAWING NO .: 16-21-7062-01 NOTE: CONSULTANT PROJECT NO .: 2107 FOR PAVING NOTES, SEE L-001. DATE: 12/15/2023 L-204 SCALE: AS NOTED

DRAWN BY:

NOTE:


CHECKED BY:


SS, TW


TS

ALL DIMENSIONS AND CONDITIONS SHALL BE VERIFIED BY THE CONTRACTOR AT THE SITE BEFORE PROCEEDING WITH THE WORK.

PAVING SCHEDULE						
SYM.	NAME	DETAIL NO.	SHEET NO.	FINISH/COLOR	QTY. (SF)	
✓ △ CIP-C-P	C.I.P. CONCRETE PAVING - AT PATHWAYS	01	L-900	BROOM FINISH	3,133	
 ✓ △ CIP-C-MA 	C.I.P. CONCRETE PAVING - AT MISTING AREA	02	L-900	BROOM FINISH, PAINTED WITH SPORT COURT PAINT WITH GRIT	1,127	
	POROUS CONCRETE PAVING	03	L-900	BROOM FINISH	1,383	
BA-A	BOUND AGGREGATE PAVING - TYPE A	04	L-900	LIGHT GREY	4,777	
ВА-В	BOUND AGGREGATE PAVING - TYPE B	04	L-900	TAN	741	
SS-PR-4HT-M2	SAFETY SURFACE · POURED RUBBER, 4' FALL HT.	05	L-900	MIX 2: 33% RED, 33% ORANGE, 33% PRIMARY RED	1,295	
SS-PR-4HT-M3	SAFETY SURFACE · POURED RUBBER, 4' FALL HT.	05	L-900	MIX 3: 33% BRIGHT YELLOW, 33% EGGSHELL, 33% CREAM	757	
SS-PR-4HT-M4	SAFETY SURFACE · POURED RUBBER, 4' FALL HT.	05	L-900	MIX 4: 33% BEIGE, 33% EARTH YELLOW, 33% ORANGE	578	
SS-PR-8HT-M1	SAFETY SURFACE · POURED RUBBER, 8' FALL HT.	06	L-900	MIX 1: 50% RED, 50% BROWN	1,809	
SS-C-5HT	SAFETY SURFACE · CORKEEN, 5' FALL HT.	08	L-900	N/A	3,285	
SS-C-8HT	SAFETY SURFACE · CORKEEN, 8' FALL HT.	09	L-900	N/A	3,440	
M	MULCH			SEE PPR STANDARD SPECS	638	

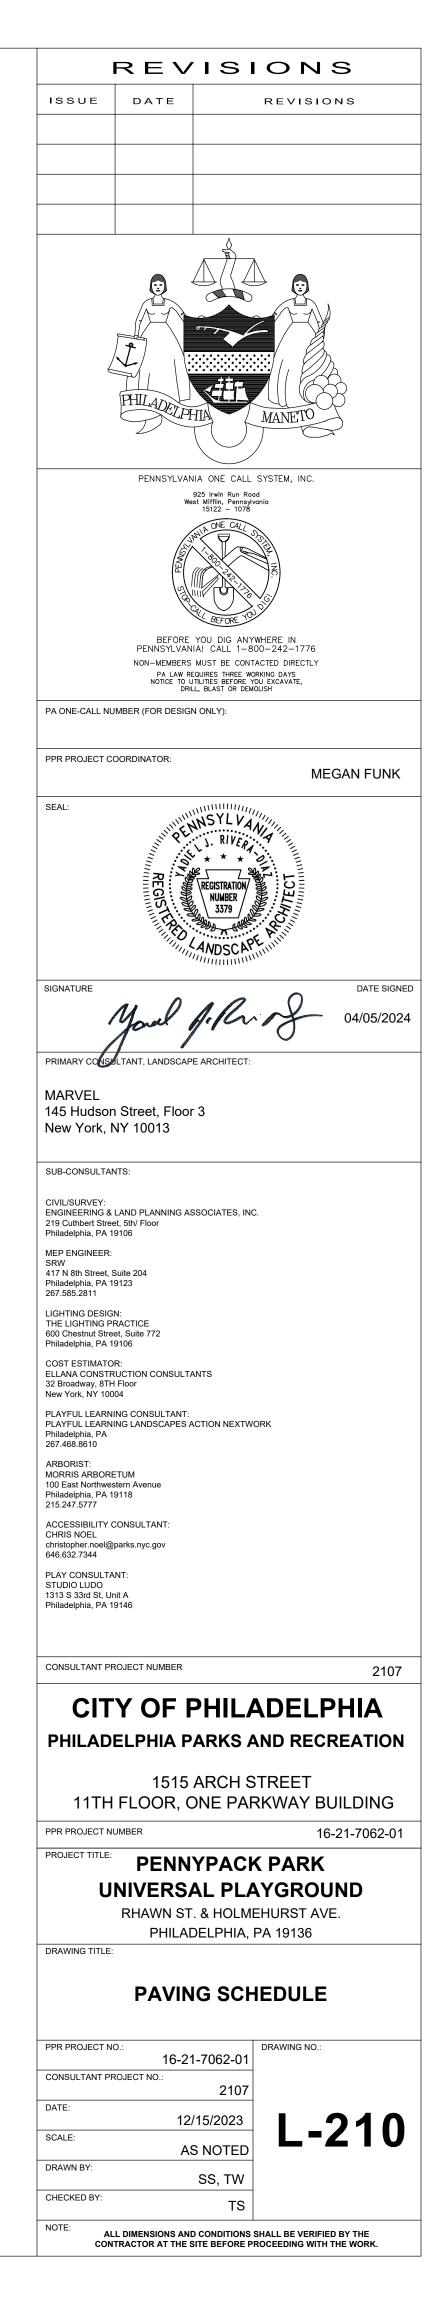

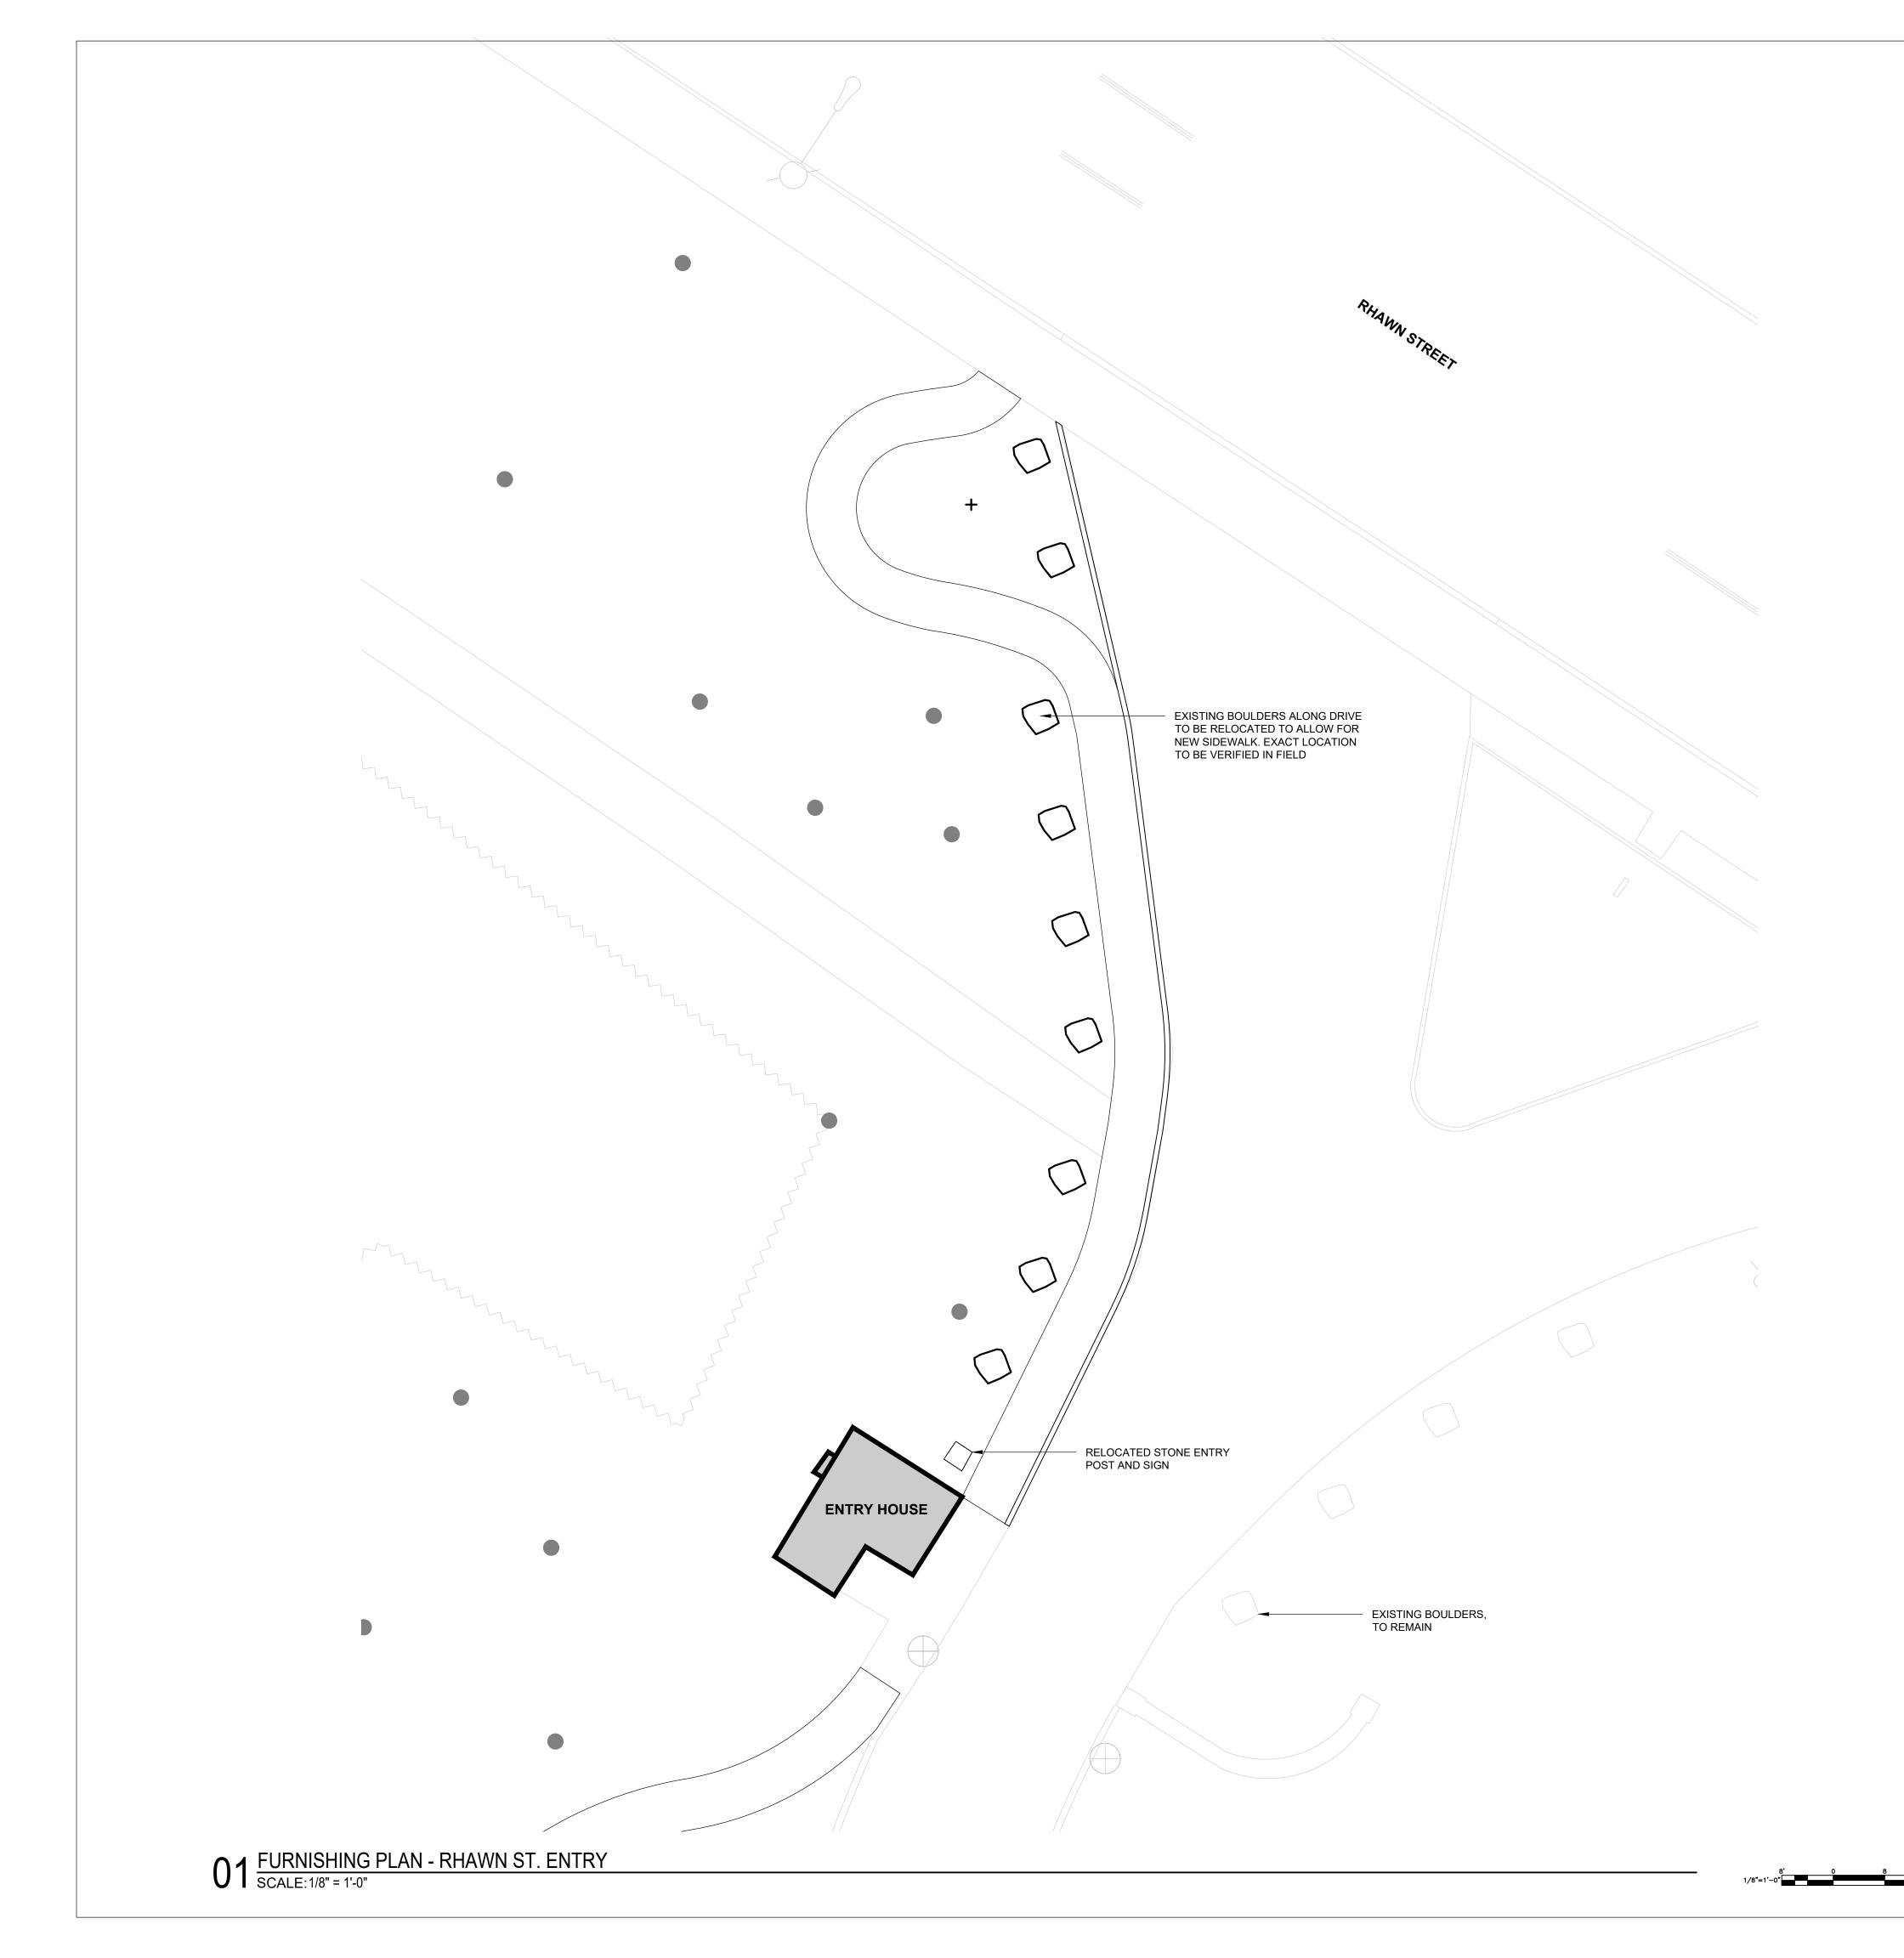

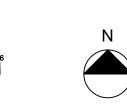

<u>LEGEND</u>

TREE TRUNK


C.I.P. CONCRETE CURB

STREET LIGHT POLE

WOODLAND EDGE

EXISTING BOULDER


PROPOSED TREE

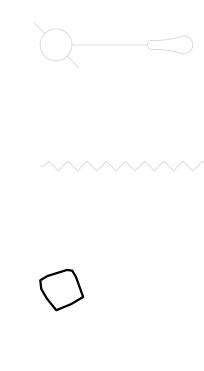

EXISTING BUILDING

NOTE:

1. BOULDER LOCATIONS TO BE V.I.F.

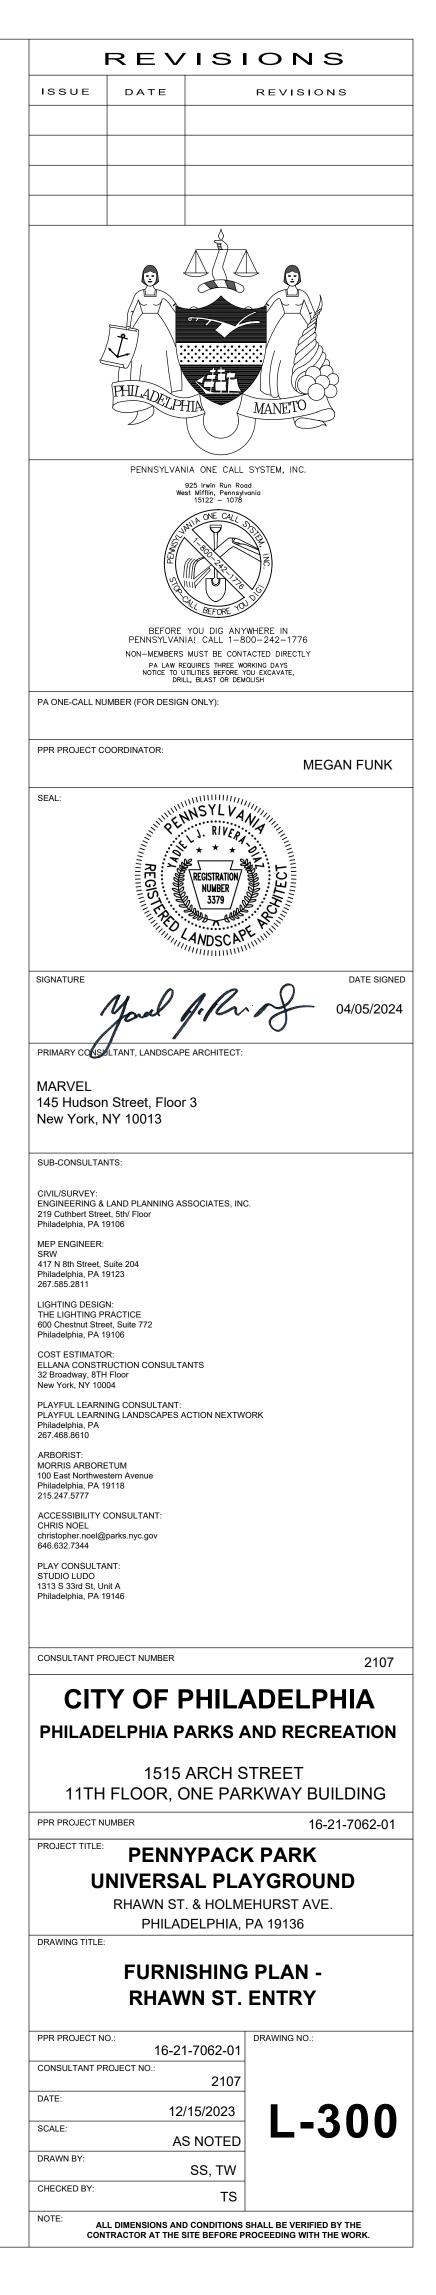



01 FURNISHING PLAN - PARKING AREA SCALE: 1/8" = 1'-0"



8' 0 8 16 1/8"=1'-0"

REVISIONS <u>LEGEND</u> ISSUE DATE REVISIONS TREE TRUNK C.I.P. CONCRETE CURB 08 L-901 SITE BOULDER PENNSYLVANIA ONE CALL SYSTEM, INC. 925 Irwin Run Road West Mifflin, Pennsylvania 15122 — 1078 \bigcirc LITTER RECEPTACLE BEFORE YOU DIG ANYWHERE IN PENNSYLVANIA! CALL 1-800-242-1776 NON-MEMBERS MUST BE CONTACTED DIRECTLY PA LAW REQUIRES THREE WORKING DAYS NOTICE TO UTILITIES BEFORE YOU EXCAVATE, DRILL, BLAST OR DEMOLISH PICNIC TABLE PA ONE-CALL NUMBER (FOR DESIGN ONLY): PPR PROJECT COORDINATOR: MEGAN FUNK 01 L-903 SEAL: ENTRY FENCE 03 L-903 SECURITY FENCE AND GATE ____O___O___O___O___O_ DATE SIGNED 04/05/2024 SIGNATURE WOODLAND EDGE PRIMARY CONSULTANT, LANDSCAPE ARCHITECT: MARVEL 145 Hudson Street, Floor 3 New York, NY 10013 **BIKE RACK** SUB-CONSULTANTS: CIVIL/SURVEY: ENGINEERING & LAND PLANNING ASSOCIATES, INC. 219 Cuthbert Street, 5th/ Floor Philadelphia, PA 19106 MEP ENGINEER: SRW 417 N 8th Street, Suite 204 Philadelphia, PA 19123 267.585.2811 PROPOSED TREE + LIGHTING DESIGN: THE LIGHTING PRACTICE 600 Chestnut Street, Suite 772 Philadelphia, PA 19106 COST ESTIMATOR: ELLANA CONSTRUCTION CONSULTANTS 32 Broadway, 8TH Floor New York, NY 10004 NOTES: PLAYFUL LEARNING CONSULTANT: PLAYFUL LEARNING LANDSCAPES ACTION NEXTWORK Philadelphia, PA 267.468.8610 1. BOULDER LOCATIONS TO BE V.I.F. 2. FOR FURNISHING QUANTITY AND PRODUCT DETAILS, SEE FURNISHING SCHEDULE, L-310 ARBORIST: MORRIS ARBORETUM 100 East Northwestern Avenue Philadelphia, PA 19118 215.247.5777 ACCESSIBILITY CONSULTANT: CHRIS NOEL christopher.noel@parks.nyc.gov 646.632.7344 PLAY CONSULTANT: STUDIO LUDO 1313 S 33rd St, Unit A Philadelphia, PA 19146 CONSULTANT PROJECT NUMBER 2107 **CITY OF PHILADELPHIA** PHILADELPHIA PARKS AND RECREATION

1515 ARCH STREET 11TH FLOOR, ONE PARKWAY BUILDING PPR PROJECT NUMBER 16-21-7062-01 PROJECT TITLE: DEDINIVED A CIC DA DIC


TITLE: PENNYPACK PARK UNIVERSAL PLAYGROUND RHAWN ST. & HOLMEHURST AVE.

PHILADELPHIA, PA 19136 DRAWING TITLE:

FURNISHING PLAN -PARKING AREA

PPR PROJECT NO.: 16-21-7062-01 CONSULTANT PROJECT NO.: 2107 DATE: 12/15/2023 SCALE: AS NOTED DRAWN BY: SS, TW CHECKED BY: TS

ALL DIMENSIONS AND CONDITIONS SHALL BE VERIFIED BY THE CONTRACTOR AT THE SITE BEFORE PROCEEDING WITH THE WORK.

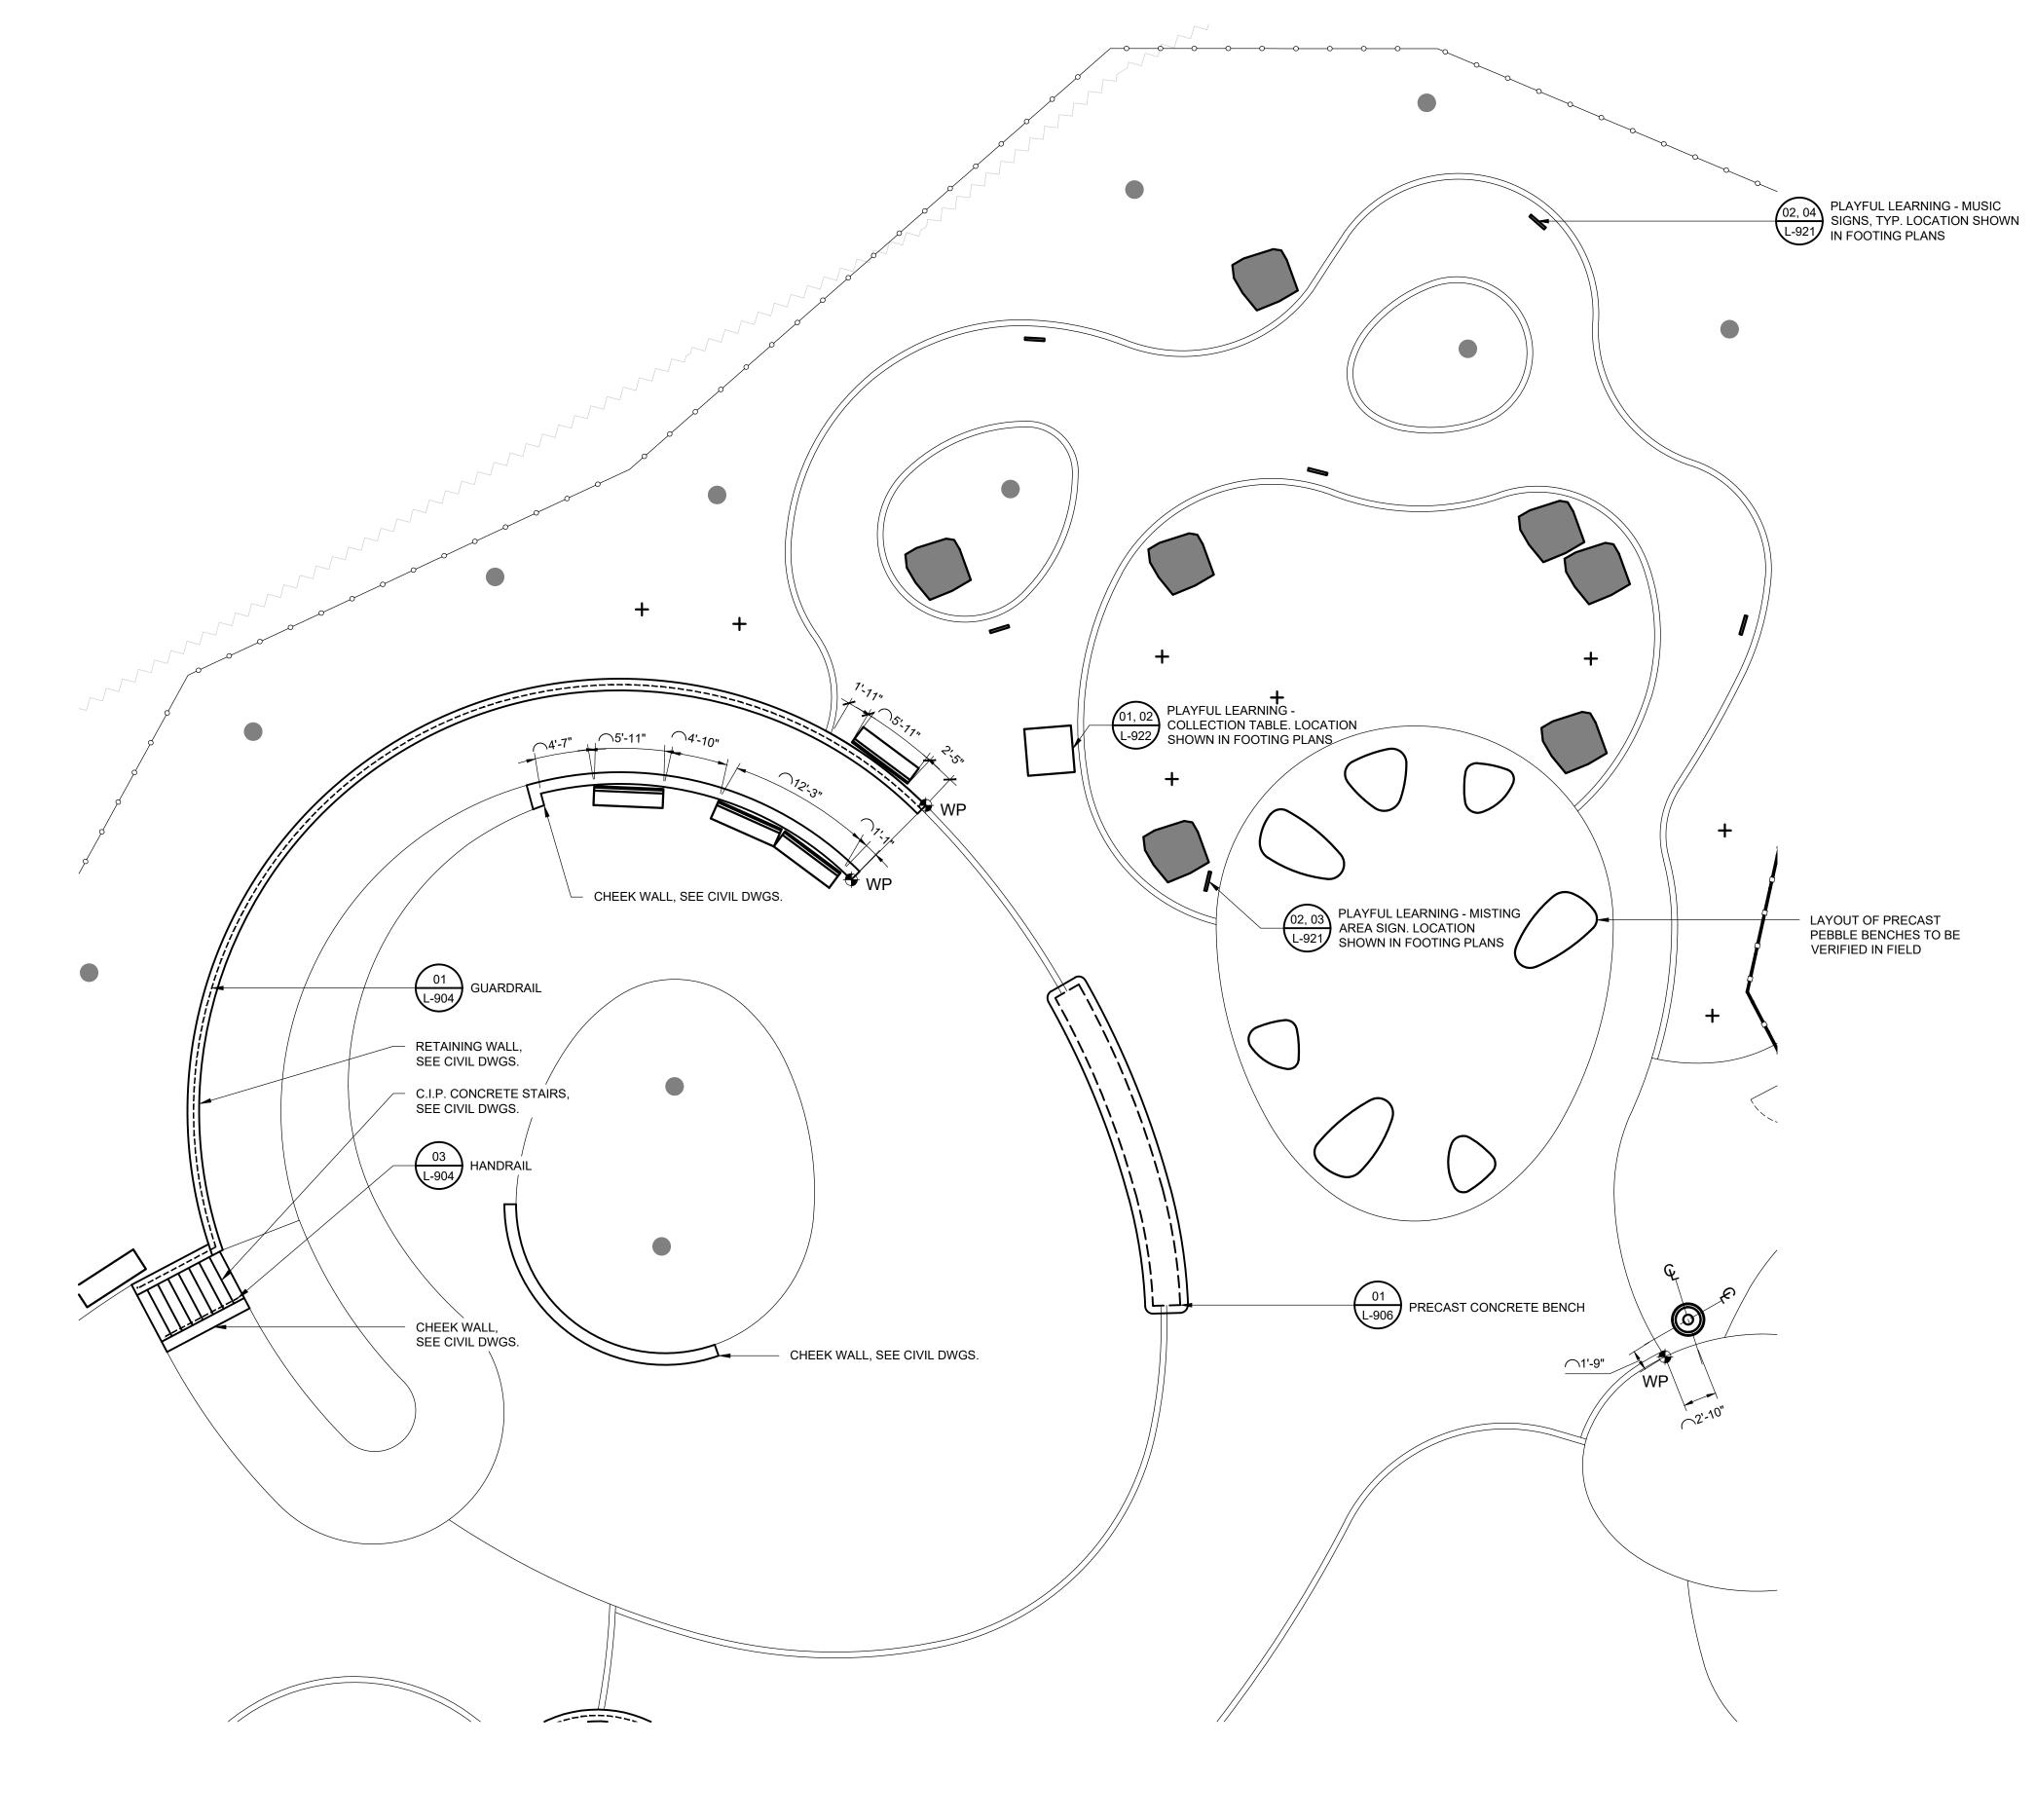

01 FURNISHING PLAN - PLAYGROUND - NORTH SCALE: 1/8" = 1'-0"


N


8' 0 8 1/8"=1'-0"

REVISIONS <u>LEGEND</u> ISSUE DATE REVISIONS TREE TRUNK C.I.P. CONCRETE CURB BENCH PENNSYLVANIA ONE CALL SYSTEM, INC. 925 Irwin Run Road West Mifflin, Pennsylvania 15122 — 1078 08 L-901 SITE BOULDER BEFORE YOU DIG ANYWHERE IN PENNSYLVANIA! CALL 1-800-242-1776 NON-MEMBERS MUST BE CONTACTED DIRECTLY PA LAW REQUIRES THREE WORKING DAYS NOTICE TO UTLITIES BEFORE YOU EXCAVATE, DRILL, BLAST OR DEMOLISH \bigcirc LITTER RECEPTACLE PA ONE-CALL NUMBER (FOR DESIGN ONLY): PPR PROJECT COORDINATOR: MEGAN FUNK 01 L-903 ENTRY FENCE SEAL: 03 L-903 SECURITY FENCE AND GATE ____O___O___O__ DATE SIGNED SIGNATURE Are signed 04/05/2024 RAIL _____ PRIMARY CONSULTANT, LANDSCAPE ARCHITECT: MARVEL 145 Hudson Street, Floor 3 New York, NY 10013 WOODLAND EDGE SUB-CONSULTANTS: CIVIL/SURVEY: ENGINEERING & LAND PLANNING ASSOCIATES, INC. 219 Cuthbert Street, 5th/ Floor Philadelphia, PA 19106 MEP ENGINEER: SRW 417 N 8th Street, Suite 204 Philadelphia, PA 19123 267.585.2811 PROPOSED TREE + LIGHTING DESIGN: THE LIGHTING PRACTICE 600 Chestnut Street, Suite 772 Philadelphia, PA 19106 COST ESTIMATOR: ELLANA CONSTRUCTION CONSULTANTS 32 Broadway, 8TH Floor New York, NY 10004 NOTES: PLAYFUL LEARNING CONSULTANT: PLAYFUL LEARNING LANDSCAPES ACTION NEXTWORK Philadelphia, PA 267.468.8610 1. BOULDER LOCATIONS TO BE V.I.F. 2. FOR FOOTING LOCATIONS, SEE FOOTING PLAN, L-112. ARBORIST: MORRIS ARBORETUM 100 East Northwestern Avenue Philadelphia, PA 19118 215.247.5777 3. FOR FURNISHING QUANTITY AND PRODUCT DETAILS, SEE FURNISHING SCHEDULE, L-310 ACCESSIBILITY CONSULTANT: CHRIS NOEL christopher.noel@parks.nyc.gov 646.632.7344 PLAY CONSULTANT: STUDIO LUDO 1313 S 33rd St, Unit A Philadelphia, PA 19146 CONSULTANT PROJECT NUMBER 2107 CITY OF PHILADELPHIA PHILADELPHIA PARKS AND RECREATION 1515 ARCH STREET 11TH FLOOR, ONE PARKWAY BUILDING PPR PROJECT NUMBER 16-21-7062-01 PROJECT TITLE: PENNYPACK PARK UNIVERSAL PLAYGROUND RHAWN ST. & HOLMEHURST AVE. PHILADELPHIA, PA 19136 DRAWING TITLE: FURNISHING PLAN -

PLAYGROUND -NORTH

PPR PROJECT NO.:	16-21-7062-01	DRAWING NO.:
CONSULTANT PROJECT N	^{0.:} 2107	
DATE:	12/15/2023	L-302
SCALE:	AS NOTED	L-302
DRAWN BY:	SS, TW	
CHECKED BY:	TS	
		SHALL BE VERIFIED BY THE ROCEEDING WITH THE WORK.

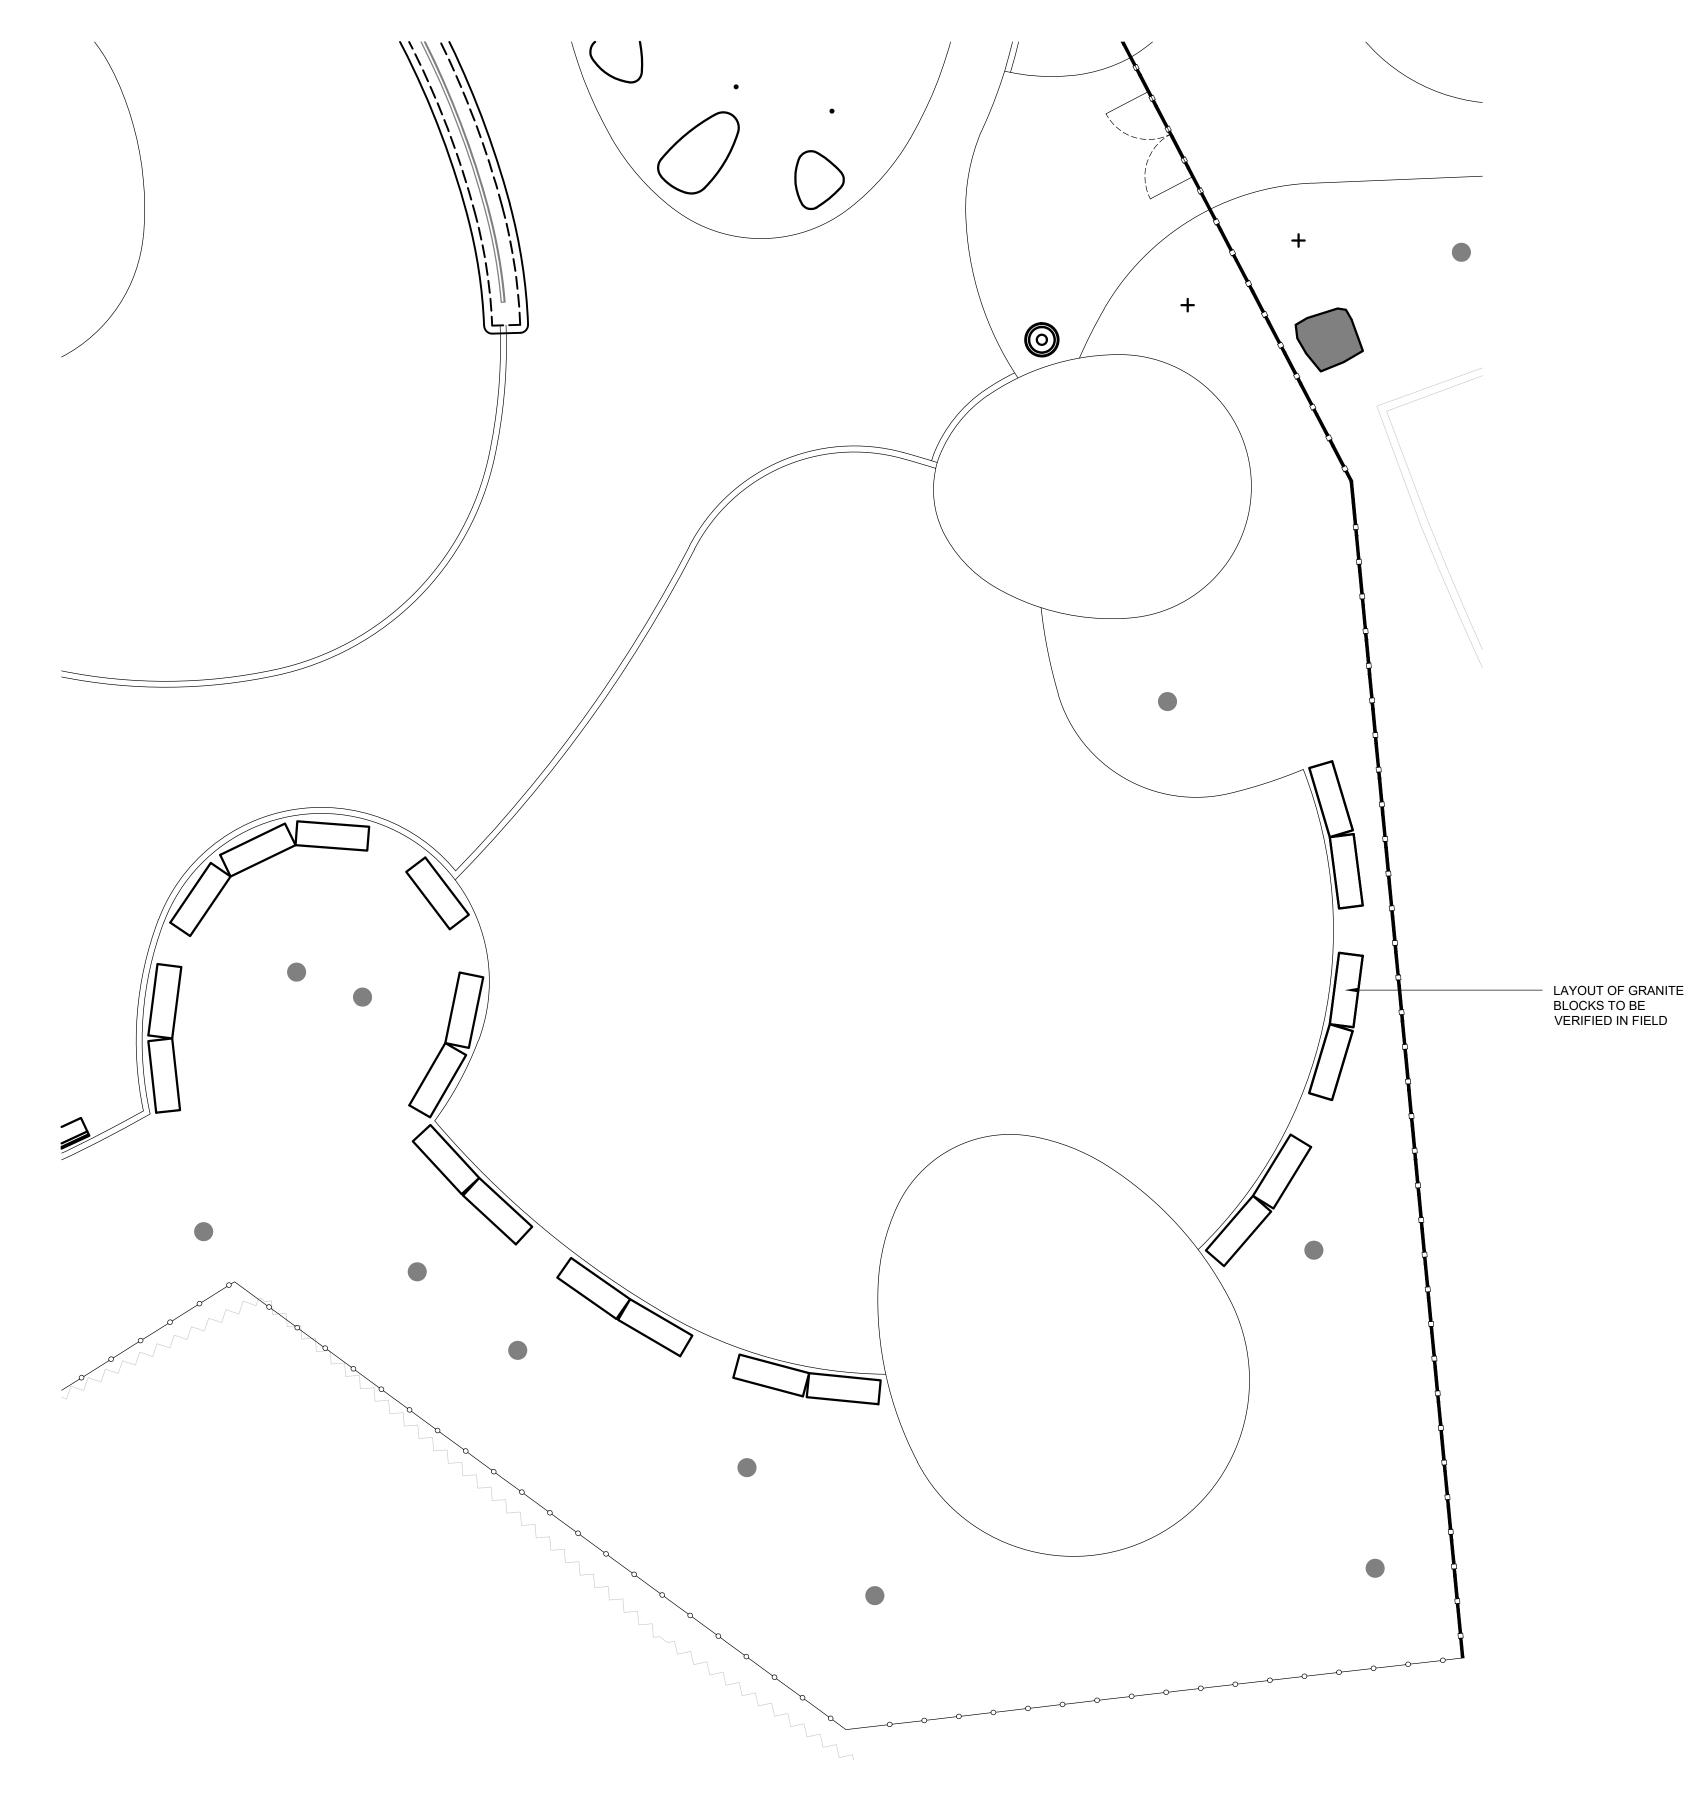

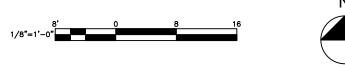

REVISIONS <u>LEGEND</u> ISSUE DATE REVISIONS TREE TRUNK C.I.P. CONCRETE CURB BENCH PENNSYLVANIA ONE CALL SYSTEM, INC. 925 Irwin Run Road West Mifflin, Pennsylvania 15122 — 1078 06, 07 L-901 GRANITE BLOCK SEATING BEFORE YOU DIG ANYWHERE IN PENNSYLVANIA! CALL 1-800-242-1776 NON-MEMBERS MUST BE CONTACTED DIRECTLY PA LAW REQUIRES THREE WORKING DAYS NOTICE TO UTILITIES BEFORE YOU EXCAVATE, DRILL, BLAST OR DEMOLISH 08 L-901 SITE BOULDER PA ONE-CALL NUMBER (FOR DESIGN ONLY): PPR PROJECT COORDINATOR: MEGAN FUNK \bigcirc LITTER RECEPTACLE SEAL: 01 L-903 ENTRY FENCE DATE SIGNED al film of 04/05/2024 SIGNATURE 03 L-903 SECURITY FENCE AND GATE ____O___O___O___O__ PRIMARY CONSIDITANT, LANDSCAPE ARCHITECT: MARVEL 145 Hudson Street, Floor 3 New York, NY 10013 RAIL ------SUB-CONSULTANTS: CIVIL/SURVEY: ENGINEERING & LAND PLANNING ASSOCIATES, INC. 219 Cuthbert Street, 5th/ Floor Philadelphia, PA 19106 MEP ENGINEER: SRW 417 N 8th Street, Suite 204 Philadelphia, PA 19123 267.585.2811 WOODLAND EDGE LIGHTING DESIGN: THE LIGHTING PRACTICE 600 Chestnut Street, Suite 772 Philadelphia, PA 19106 COST ESTIMATOR: ELLANA CONSTRUCTION CONSULTANTS 32 Broadway, 8TH Floor New York, NY 10004 PLAYFUL LEARNING CONSULTANT: PLAYFUL LEARNING LANDSCAPES ACTION NEXTWORK Philadelphia, PA 267.468.8610 PROPOSED TREE + ARBORIST: MORRIS ARBORETUM 100 East Northwestern Avenue Philadelphia, PA 19118 215.247.5777 NOTES: ACCESSIBILITY CONSULTANT: CHRIS NOEL christopher.noel@parks.nyc.gov 646.632.7344

PLAY CONSULTANT: STUDIO LUDO 1313 S 33rd St, Unit A Philadelphia, PA 19146

PPR PROJECT NUMBER

PROJECT TITLE:

DRAWING TITLE:

PPR PROJECT NO .:

DATE:

SCALE:

DRAWN BY:

NOTE:

CHECKED BY:

CONSULTANT PROJECT NO .:

CONSULTANT PROJECT NUMBER

CITY OF PHILADELPHIA

PHILADELPHIA PARKS AND RECREATION

1515 ARCH STREET 11TH FLOOR, ONE PARKWAY BUILDING

PENNYPACK PARK

UNIVERSAL PLAYGROUND RHAWN ST. & HOLMEHURST AVE. PHILADELPHIA, PA 19136

> FURNISHING PLAN -PLAYGROUND -

> > SOUTHEAST

2107

16-21-7062-01

12/15/2023

AS NOTED

SS, TW

TS

ALL DIMENSIONS AND CONDITIONS SHALL BE VERIFIED BY THE CONTRACTOR AT THE SITE BEFORE PROCEEDING WITH THE WORK.


DRAWING NO.

2107

16-21-7062-01

L-303

- 1. BOULDER LOCATIONS TO BE V.I.F.
- 2. FOR FOOTING LOCATIONS, SEE FOOTING PLAN, L-112
- 3. FOR FURNISHING QUANTITY AND PRODUCT DETAILS, SEE FURNISHING SCHEDULE, L-310

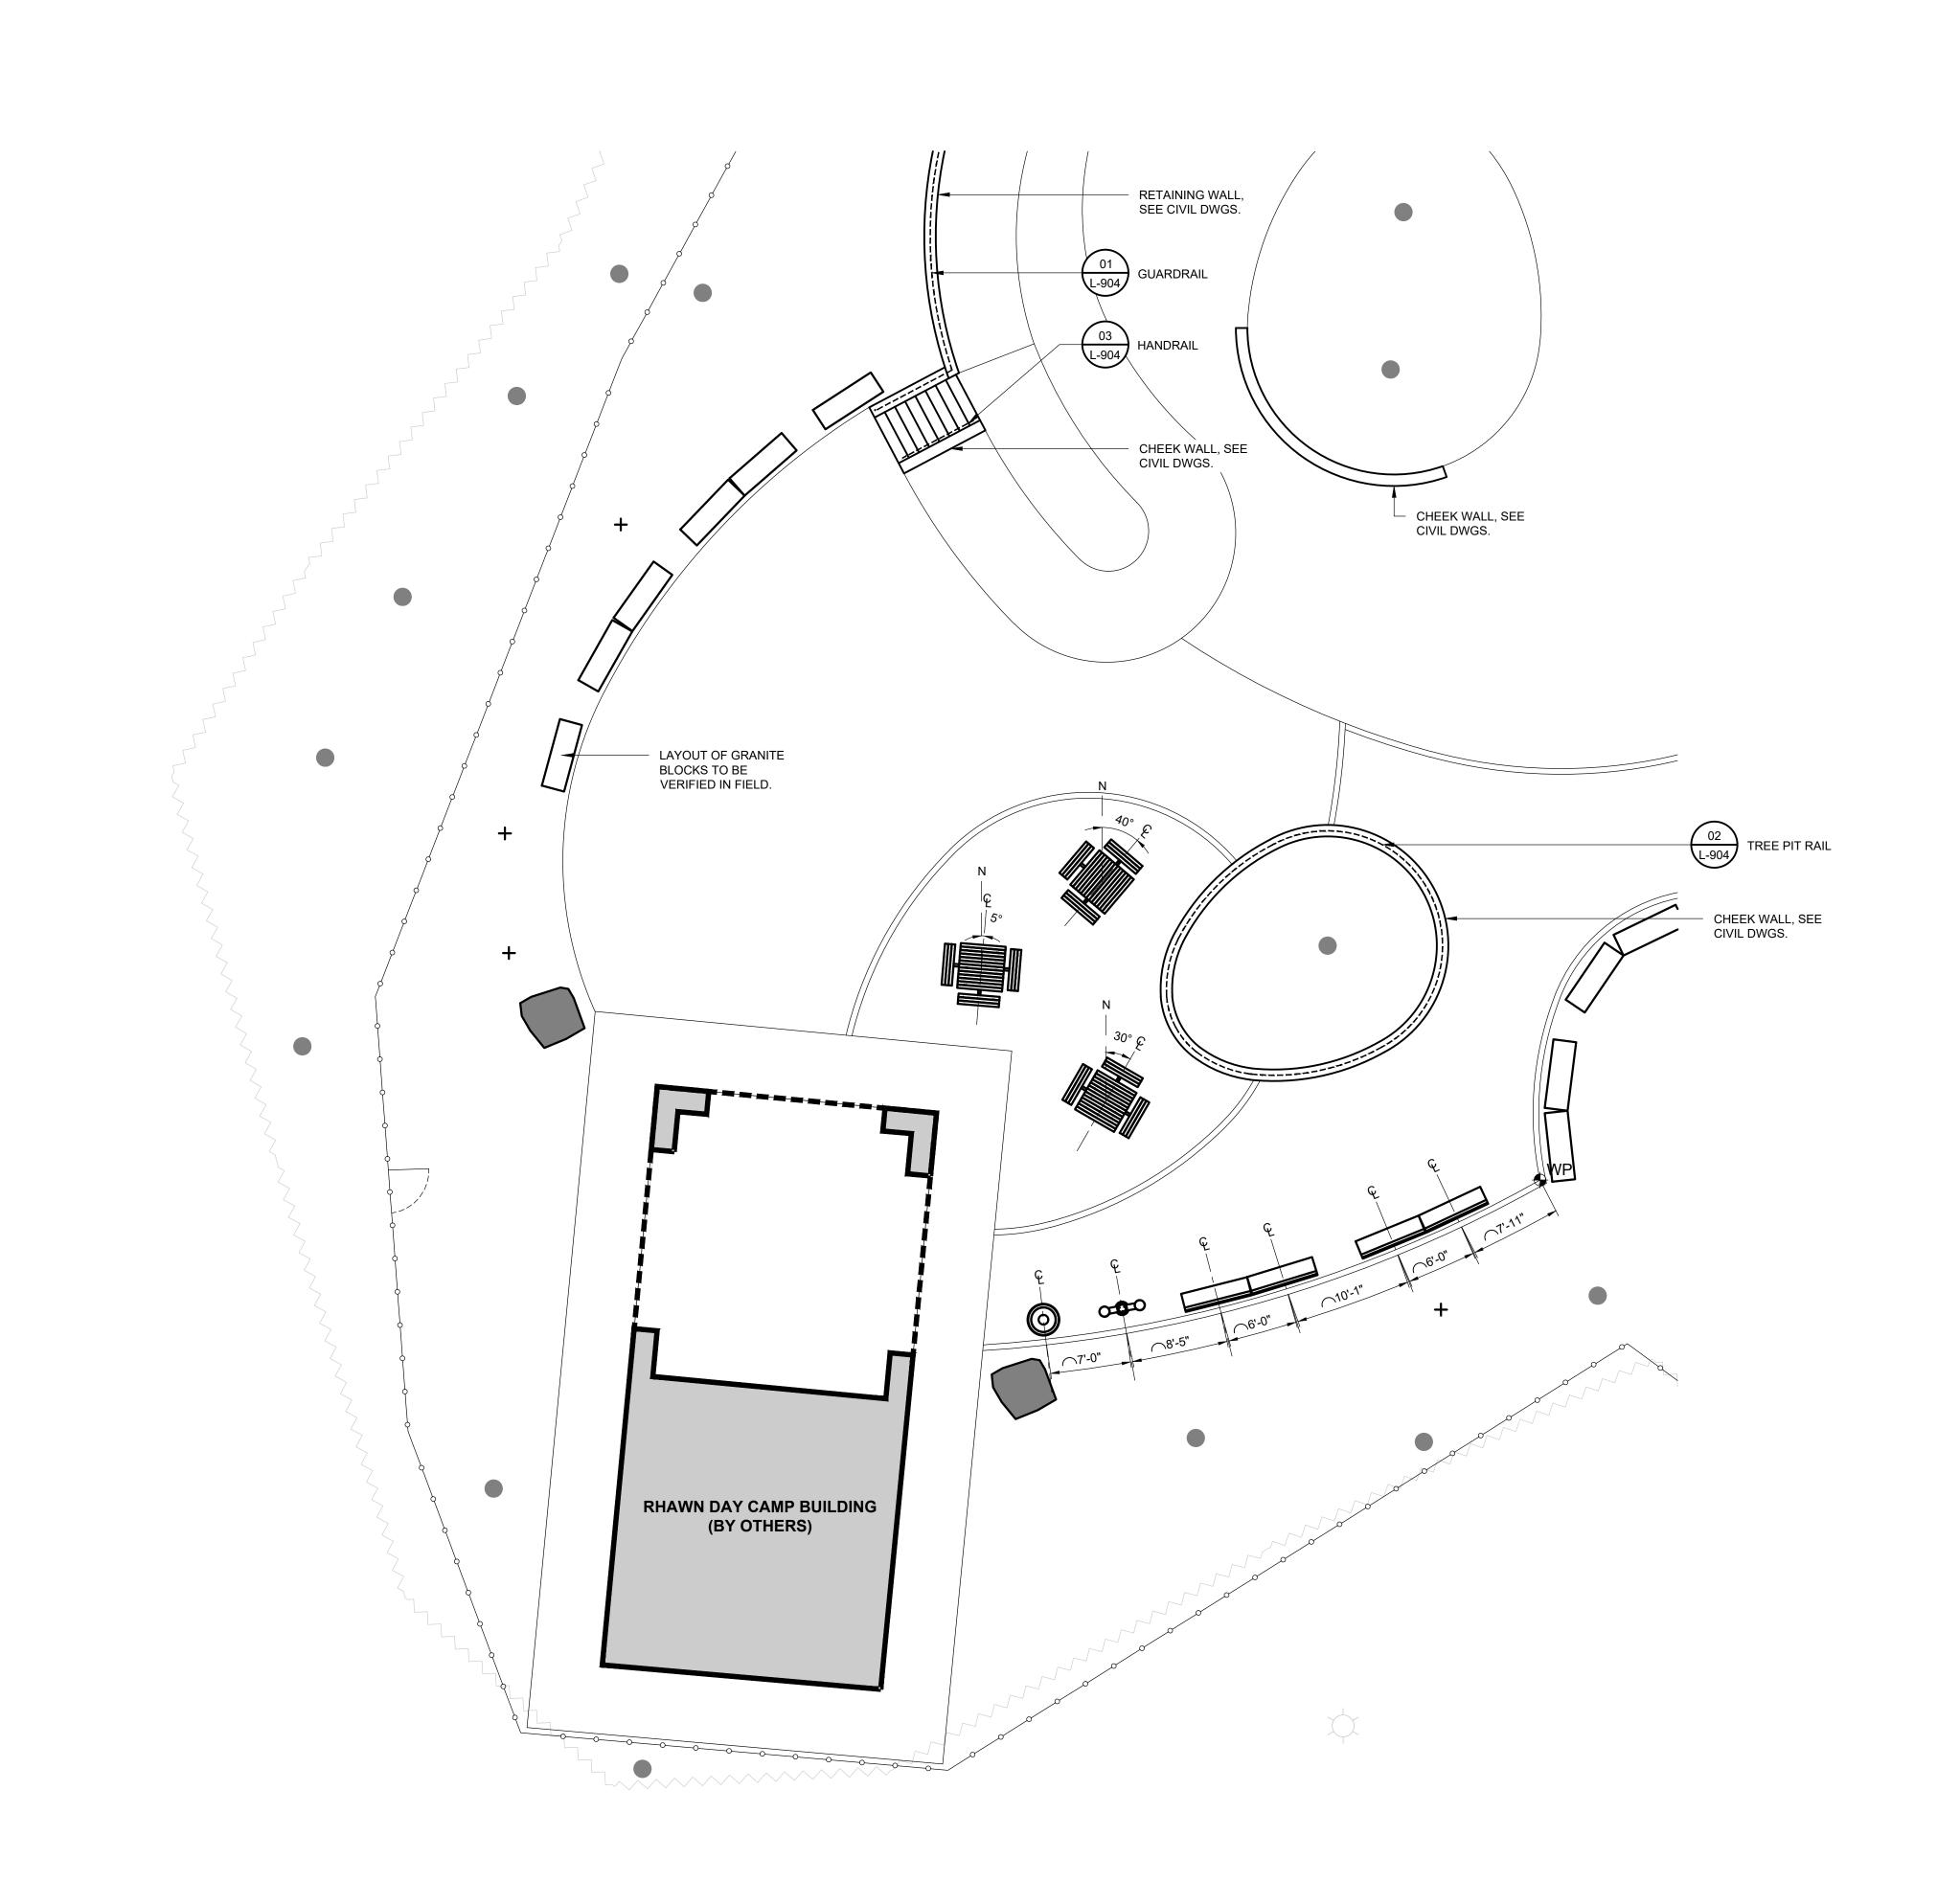



REVISIONS <u>LEGEND</u> ISSUE DATE REVISIONS TREE TRUNK C.I.P. CONCRETE CURB BENCH PENNSYLVANIA ONE CALL SYSTEM, INC. 925 Irwin Run Road West Mifflin, Pennsylvania 15122 — 1078 06, 07 L-901 GRANITE BLOCK SEATING BEFORE YOU DIG ANYWHERE IN PENNSYLVANIA! CALL 1-800-242-1776 NON-MEMBERS MUST BE CONTACTED DIRECTLY PA LAW REQUIRES THREE WORKING DAYS NOTICE TO UTILITIES BEFORE YOU EXCAVATE, DRILL, BLAST OR DEMOLISH 08 L-901 SITE BOULDER PA ONE-CALL NUMBER (FOR DESIGN ONLY): PPR PROJECT COORDINATOR: MEGAN FUNK \bigcirc SEAL: LITTER RECEPTACLE 01 L-903 ENTRY FENCE DATE SIGNED SIGNATURE al film o4/05/2024 03 L-903 SECURITY FENCE AND GATE ____O___O___O___O__ PRIMARY CONSULTANT, LANDSCAPE ARCHITECT: MARVEL 145 Hudson Street, Floor 3 New York, NY 10013 RAIL ______ SUB-CONSULTANTS: CIVIL/SURVEY: ENGINEERING & LAND PLANNING ASSOCIATES, INC. 219 Cuthbert Street, 5th/ Floor Philadelphia, PA 19106 MEP ENGINEER: SRW 417 N 8th Street, Suite 204 Philadelphia, PA 19123 267.585.2811 WOODLAND EDGE LIGHTING DESIGN: THE LIGHTING PRACTICE 600 Chestnut Street, Suite 772 Philadelphia, PA 19106 COST ESTIMATOR: ELLANA CONSTRUCTION CONSULTANTS 32 Broadway, 8TH Floor New York, NY 10004 PROPOSED TREE PLAYFUL LEARNING CONSULTANT: PLAYFUL LEARNING LANDSCAPES ACTION NEXTWORK Philadelphia, PA 267.468.8610 + ARBORIST: MORRIS ARBORETUM 100 East Northwestern Avenue Philadelphia, PA 19118 215.247.5777 NOTES: ACCESSIBILITY CONSULTANT: CHRIS NOEL christopher.noel@parks.nyc.gov 646.632.7344 1. BOULDER LOCATIONS TO BE V.I.F.

PLAY CONSULTANT: STUDIO LUDO 1313 S 33rd St, Unit A Philadelphia, PA 19146

CONSULTANT PROJECT NUMBER

PPR PROJECT NUMBER

PROJECT TITLE:

DRAWING TITLE:

PPR PROJECT NO .:

DATE:

SCALE:

DRAWN BY:

CHECKED BY:

NOTE:

CONSULTANT PROJECT NO .:

CITY OF PHILADELPHIA

PHILADELPHIA PARKS AND RECREATION

1515 ARCH STREET 11TH FLOOR, ONE PARKWAY BUILDING

PENNYPACK PARK

UNIVERSAL PLAYGROUND

RHAWN ST. & HOLMEHURST AVE. PHILADELPHIA, PA 19136

FURNISHING PLAN -PLAYGROUND -SOUTHWEST

2107

16-21-7062-01

12/15/2023

AS NOTED

SS, TW

TS

ALL DIMENSIONS AND CONDITIONS SHALL BE VERIFIED BY THE CONTRACTOR AT THE SITE BEFORE PROCEEDING WITH THE WORK.

DRAWING NO.

2107

16-21-7062-01

L-304


- 2. FOR FOOTING LOCATIONS, SEE FOOTING PLAN, L-112
- 3. FOR FURNISHING QUANTITY AND PRODUCT DETAILS, SEE FURNISHING SCHEDULE, L-310

	FURNISHING SCHEDULE						
SYM.	NAME	MANUFACTURER	PRODUCT	FINISH/COLOR	QUANTITY		
	CAFE TABLE	DUMOR	76-33D, 4' SQ. TABLE, 3 SEATS, 3 X 4 DOUGLAS FIR	COLOR: BLACK, FINISH: POWDERCOAT, TOPPER: DOUGLAS FIR	3		
	BENCH	DUMOR	69 871 6D 3ART 6' CAST BENCH, 3 ARMS, TAMPER PROOF	COLOR: BLACK, FINISH: POWDERCOAT, STL SLATS	8		
	PICNIC TABLE	DUMOR	FRAMES: 71-20, TABLES: 71-68-1D	COLOR: BLACK, FINISH: POWDERCOAT, TOPPER: DOUGLAS FIR	3		
O	LITTER RECEPTACLE	DUMOR	57 32 32 GAL STL RECEPT	BLACK	2		
_	BIKE RACK	DUMOR	83·00/S·1	COLOR: BLACK, FINISH: POWDERCOAT	9		
	DRINKING FOUNTAIN	ELKAY	OUTDOOR EZH2O UPPER BOTTLE FILLING STATION TRI-LEVEL PEDESTAL, NON-FILTERED NON-REFRIGERATED, MODEL LK4430BF1U	BLACK	1		
\square	PRECAST CONCRETE PEBBLE BENCH 1	WAUSAU TILE	GALET I BENCH	COLOR: FOG, FINISH: ACID WASH	3		
	PRECAST CONCRETE PEBBLE BENCH 2	WAUSAU TILE	GALET II BENCH	COLOR: BUFF, FINISH: ACID WASH	1		
	PRECAST CONCRETE PEBBLE BENCH 3	WAUSAU TILE	GALET III BENCH	COLOR: CHARCOAL, FINISH: ACID WASH	3		
	BOULDER	WISSAHICKON STONE QUARRY	QUARRIED WISSAHICKON SCHIST, 6'x6' OR SIM.	N/A	10		
	STONE BLOCK SEATING	STONE FARM	RECLAIMED STONE BLOCKS (TYPE TBD, DEPENDS ON STOCK)	N/A	26		
	GUARDRAIL	N/A	CUSTOM, SEE DETAIL 01/L-904	POWDERCOATED STEEL, COLOR TO BE SELECTED BY LANDSCAPE ARCHITECT	108 LF		
	TREE PIT RAIL	N/A	CUSTOM, SEE DETAIL 02/L-904	POWDERCOATED STEEL, COLOR TO BE SELECTED BY LANDSCAPE ARCHITECT	71 LF		

PPR STANDARD SIGNAGE SCHEDULE						
SIGN TYPE	SIGN NAME	MOUNTING TYPE	LOCATION	QUANTITY		
VID.1	VEHICULAR PARK ID	POST MOUNT	RHAWN STREET ENTRANCE	1		
PID.2	LARGE PARK ID (WITH MAP)	POST MOUNT	NEAR GUARD HOUSE	1		
PID.4	PARK ID	POST MOUNT	OUTSIDE PLAYGROUND GATES AT ENTRANCE	1		
VID. 1	PLAYGROUND ID/RULES + REGS	POST MOUNT OR FENCE MOUNT	INSIDE PLAYGROUND	2		
PLY.1	PET WASTE STATION	POST MOUNT	PARKING LOT ISLAND/PICNIC AREA	1		
SID.3	VEHICLE PARKING ID: RULES	POST MOUNT	NEAR PARKING ENTRANCE, PAST GUARD HOUSE/LOT GATE	1		
RUL.6	SMOKE-FREE PARK	FENCE MOUNT	PLAYGROUND ENTRANCE	1		
RUL.6	NO LITTERING	FENCE MOUNT	PLAYGROUND ENTRANCE	1		
RUL.6	NO ANIMALS	FENCE MOUNT	PLAYGROUND ENTRANCE	1		
RUL.7	NO DUMPING	POST MOUNT	PARKING LOT ISLAND/PICNIC AREA	1		
RUL.7	NO FEEDING WILDLIFE	POST MOUNT	PARKING LOT ISLAND/PICNIC AREA	1		

ADDITIONAL SIGNAGE SCHEDULE						
SIGN NAME	MOUNTING TYPE	LOCATION	QUANTITY			
PEDESTRIAN CROSSING	POST MOUNT	RAISED CROSSWALK	1			
DCNR GRANT SIGN	FENCE MOUNT	PLAYGROUND ENTRANCE	1			

- NOTE: 1. EXACT PPR STANDARD SIGN LOCATION TO BE CONFIRMED BY LANDSCAPE ARCHITECT. 1. EXACT PPR STANDARD DEDESTRIAN CROSSING SIGN REQUIRED AT RAISED (2. ADDITIONAL NON-PPR STANDARD PEDESTRIAN CROSSING SIGN REQUIRED AT RAISED CROSSWALK.
- 3. DCNR SIGN (DETAIL 01/L-921) LOCATION TO BE CONFIRMED BY LANDSCAPE ARCHITECT.

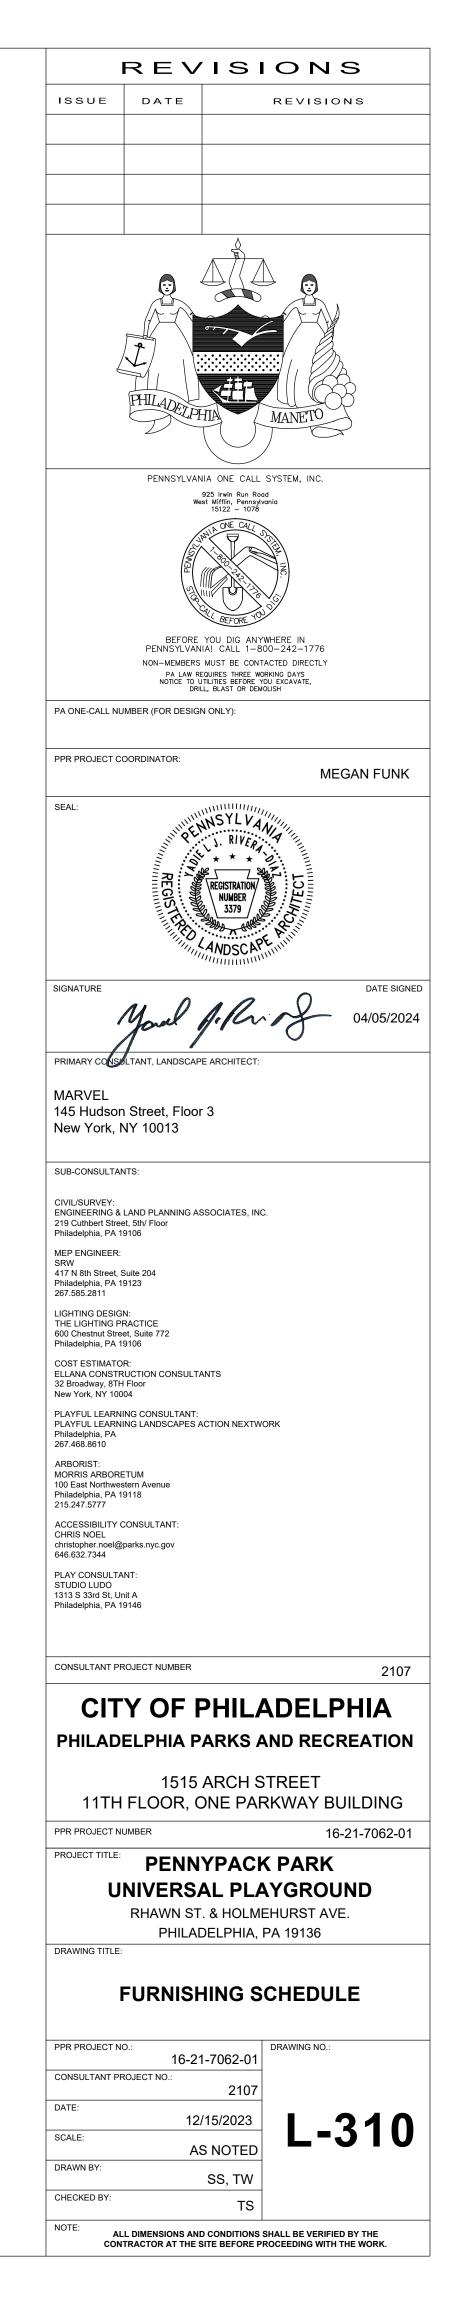



LEGEND

TREE TRUNK
C.I.P. CONCRETE CURB
ENTRY FENCE



01 L-903

RAIL

WOODLAND EDGE

BIKE RACK

PROPOSED TREE

MULCH

NOTE: 1. SEE L-210 PAVING SCHEDULE FOR SAFETY SURFACE COLOR MIXES AND QUANTITIES.


0

+



SS-PR-8HT-M1

SS-PR-4HT-M2

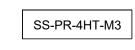


SS-PR-4HT-M4

SS-C-5HT SS-C-8HT

ISSUE DATE	ISIONS REVISIONS
THILADER P	
BEFORE PENNSYLVAN NON-MEMBERS PA LAW R NOTE TO L	IIA ONE CALL SYSTEM, INC. 925 Irwin Run Road 15122 - 1078 WINTHIN, Pennsyvania 15122 - 1078 WINTHIN, Pennsyvania 15122 - 1078 WINTHING STATES 15122 - 1078 WINTHING STATES 15122 - 1078 WINTHIGHT STATES 15122 - 1078 15122 - 1
PPR PROJECT COORDINATOR:	MEGAN FUNK
SIGNATURE SIGNATURE MARVEL 145 HUGSON Street, Floor New York, NY 10013 SUB-CONSULTANTS: CIVIL/SURVEY: ENGINEERING & LAND PLANNING AS 219 Cuthbert Street, 5th/ Floor Philadelphia, PA 19106 MEP ENGINEER: SRW 417 N 8th Street, Sth/ Floor Philadelphia, PA 19103 MEP ENGINEER: SRW 417 N 8th Street, Suite 204 Philadelphia, PA 19123 267-585-2811 LIGHTING DESIGN: THE LIGHTING PRACTICE 600 Chestnul Street, Suite 772 Philadelphia, PA 19106 COST ESTIMATOR: ELLANA CONSTRUCTION CONSULT/ 32 Broadway, 8TH Floor New York, NY 10004 PLAYFUL LEARNING CONSULTANT: Philadelphia, PA 19106 COST ESTIMATOR: ELLANA CONSTRUCTION CONSULT/ 32 Broadway, 8TH Floor New York, NY 10004 PLAYFUL LEARNING CONSULTANT: PLAYFUL LEARNING CONSULTANT: COST ESTIMATOR: ELLANA CONSTRUCTION CONSULT/ 32 Broadway, 8TH Floor New York, NY 10004 PLAYFUL LEARNING CONSULTANT: PLAYFUL LEARNING CONSULTANT: COST ESTIMATOR: ELLANA CONSTRUCTION CONSULT/ 32 Broadway, 8TH Floor New York, NY 10004 PLAYFUL LEARNING CONSULTANT: COST ESTIMATOR: ELLANA CONSTRUCTION CONSULTANT: COST ESTIMATOR: ELLANA CONSTRUCTION CONSULT/ 32 Broadway, 8TH Floor New York, NY 10004 PLAYFUL LEARNING CONSULTANT: CHRIS NOEL COST ESTIMATOR: PLAY CONSULTANT: CHRIS NOEL CONSULTANT: STUDIO LUDO 1313 S 33rd St, Unit A Philadelphia, PA 19146	SSOCIATES, INC.
PHILADELPHIA P 1515 11TH FLOOR, C PPR PROJECT NUMBER	2107 PHILADELPHIA ARKS AND RECREATION ARCH STREET DNE PARKWAY BUILDING 16-21-7062-01
PENN UNIVERS RHAWN ST PHILAI DRAWING TITLE:	YPACK PARK AL PLAYGROUND . & HOLMEHURST AVE. DELPHIA, PA 19136 TY SURFACE
	LOR PLAN
CONSULTANT PROJECT NO.: DATE: SCALE:	DRAWING NO.: 2107 /15/2023 S NOTED
DRAWN BY: CHECKED BY:	SS, TW TS
	D CONDITIONS SHALL BE VERIFIED BY THE SITE BEFORE PROCEEDING WITH THE WORK.

LIC	GHTING FIXTURE SCHEE	DULE	
	TYPE	MTG.	DESCRIPTION
	P1	POLE	LIGHT POLE ASSEMBLY CONSISTING OF ARM-MOUNTED LUMINAIRE ATTACHED TO 25 FOOT TALL POLE. HEAD: LED FULL CUTOFF POST-TOP LUMINAIRE, NOMINAL 15-3/4 INCH DIAMETER X 4 INCH TALL ALUMINUM HOUSING, PROVIDE WITH NOMI AND POLE-TOP SLIP-FITTER FOR USE WITH 3-1/2 INCH OUTSIDE DIAMETER POLE TOP OR TENON, CLEAR TEMPERED GLASS LENS, S FINISH TO BE BLACK. U.L. WET LOCATION LISTED. LUMINAIRE EFFECTIVE PROJECTED AREA NOT TO EXCEED 0.47 SQUARE FEET. PROVIDE IP66 OUTDOOR RATED PHOTOCELL DEVICE POLE: STRAIGHT ROUND ALUMINUM POLE, NOMINAL 25 FOOT TALL X 6 INCH DIAMETER WITH MINIMUM 0.156 INCH WALL THICKNESS. PROV DIAMETER POLE-TOP TENON FOR LUMINAIRE MOUNTING, OVERALL POLE FINISH TO MATCH LUMINAIRE HEADS, ANCHOR BOLT DETA STRUCTURAL ENGINEER. POLE SHALL BE RATED TO SUPPORT MINIMUM 2.7 EPA AT 100 MPH WIND WITH A 1.3 GUST FACTOR.
	P2	POLE	LIGHTING POLE ASSEMBLY CONSISTING OF MODULAR FLOOD LIGHT ATTACHED TO 25 FOOT TALL POLE. LUMINAIRE: NOMINAL 13 INCH LONG X 5 INCH TALL X 6 INCH DEEP DIE-CAST ALUMINUM HOUSING. PROVIDE TILT MOUNTING BRACKET AND POLE 2-3/8 INCH OUTSIDE DIAMETER POLE TOP OR TENON, POLYCARBONATE LENS, OVERALL PAINT FINISH TO BE BLACK, INTEGRAL DIMI LISTED, LUMINAIRE EFFECTIVE PROJECTED AREA NOT TO EXCEED 0.50 SQUARE FEET, PROVIDE IP66 OUTDOOR RATED PHOTOCELI POLE: STRAIGHT ROUND ALUMINUM POLE, NOMINAL 25 FOOT TALL X 6 INCH DIAMETER WITH MINIMUM 0.156 INCH WALL THICKNESS. PROV DIAMETER POLE-TOP TENON FOR LUMINAIRE MOUNTING, FULL BASE COVER, HAND HOLE AT BASE, OVERALL POLE FINISH TO MATCO DETAIL TO BE COORDINATED WITH STRUCTURAL ENGINEER. POLE SHALL BE RATED TO SUPPORT MINIMUM 2.7 EPA AT 100 MPH WIND WITH A 1.3 GUST FACTOR.

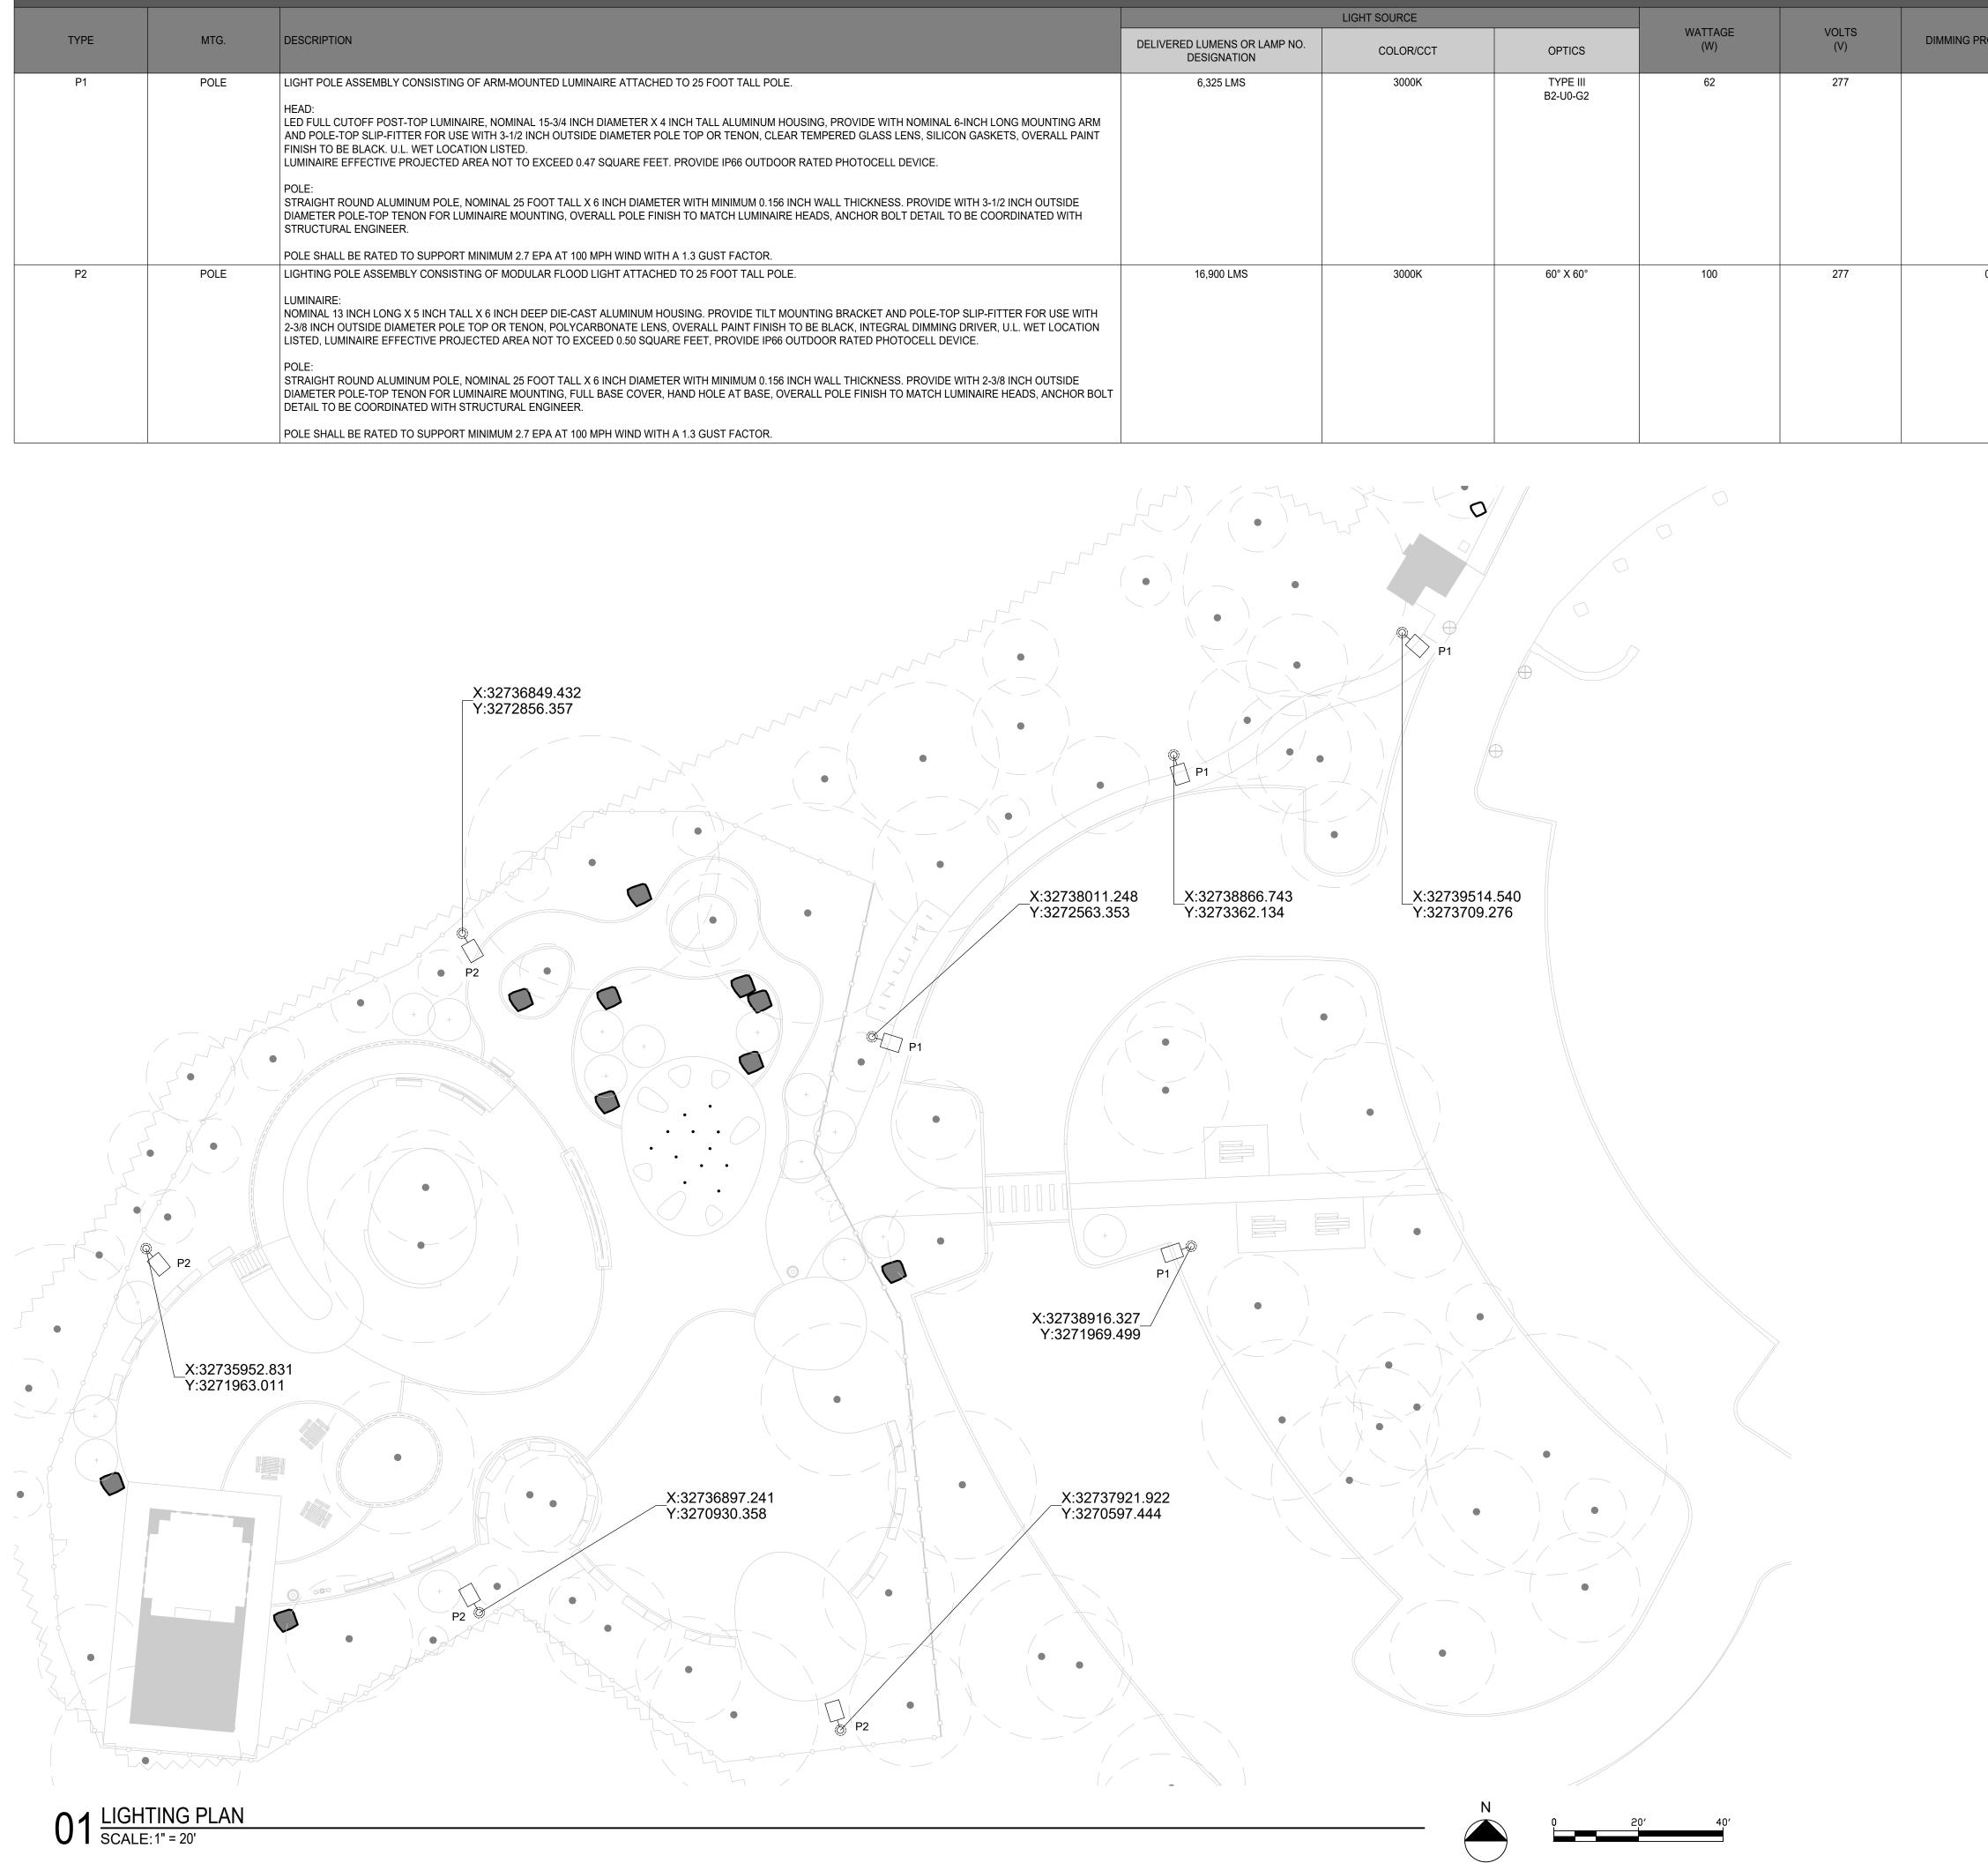


PROTOCOL/RANGE ⁶	MANUFACTURER	CATALOG NUMBER
-	SELUX VALMONT	HEAD: DSC4L-R3W-S1-5G700-30-25-BLACK-U NV-TLRP POLE: R-+250060605S4-P3-DBL
0-10V	SPECGRADE	HEAD: MFL-100-3000K-60-V01-[FINISH]-TL-VD IM-80CRI-GS POLE: R-+250060605S4-P2-DBL


<u>LEGEND</u>

TREE CANOPY	
TREE TRUNK	
C.I.P. CONCRETE CURB	
BENCH	
GRANITE BLOCK SEATING	
SITE BOULDER	
LITTER RECEPTACLE	\odot
DRINKING FOUNTAIN	0-2-0
CAFE TABLE	
PICNIC TABLE	
ENTRY FENCE	C
SECURITY FENCE AND GATE	0
RAIL	
WOODLAND EDGE	-~~~~-
BIKE RACK	_
PROPOSED TREE	+
EXISTING BUILDING	

NOTE:


1. SEE L-001 FOR LIGHTING NOTES.

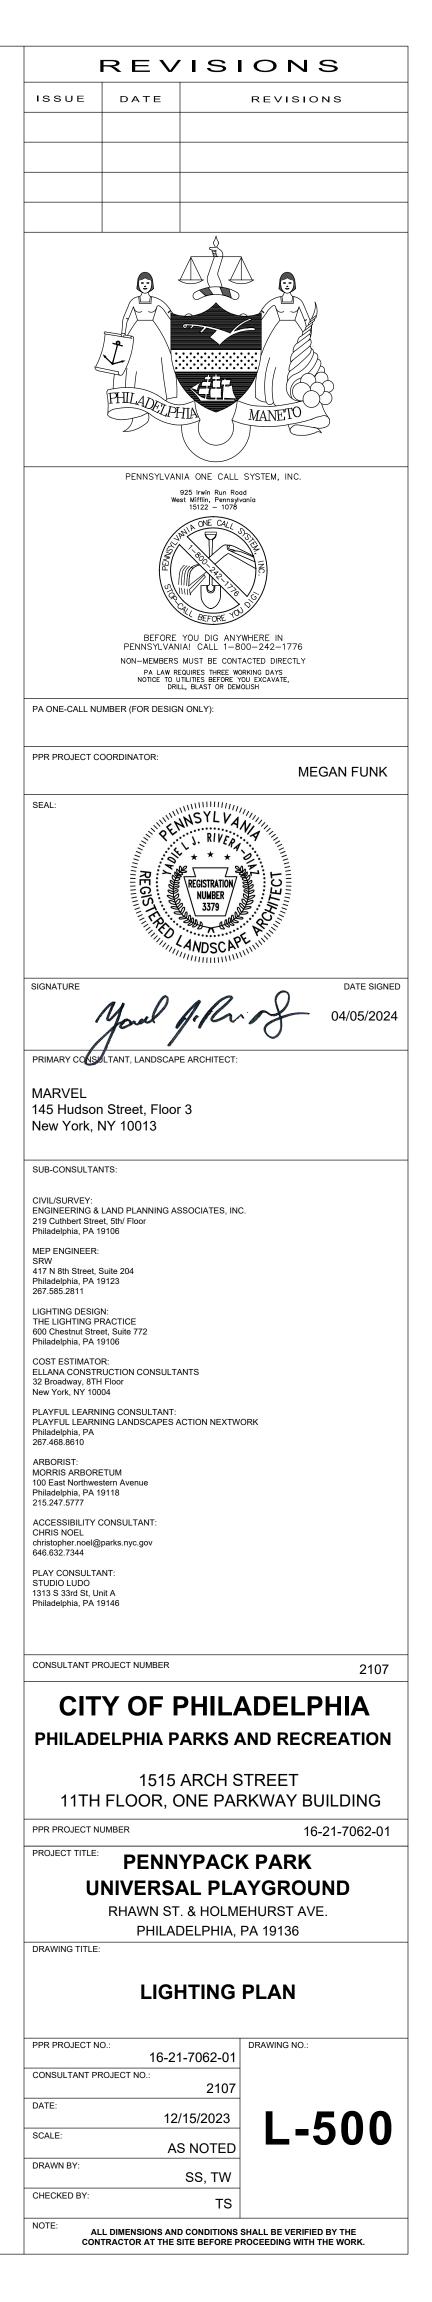

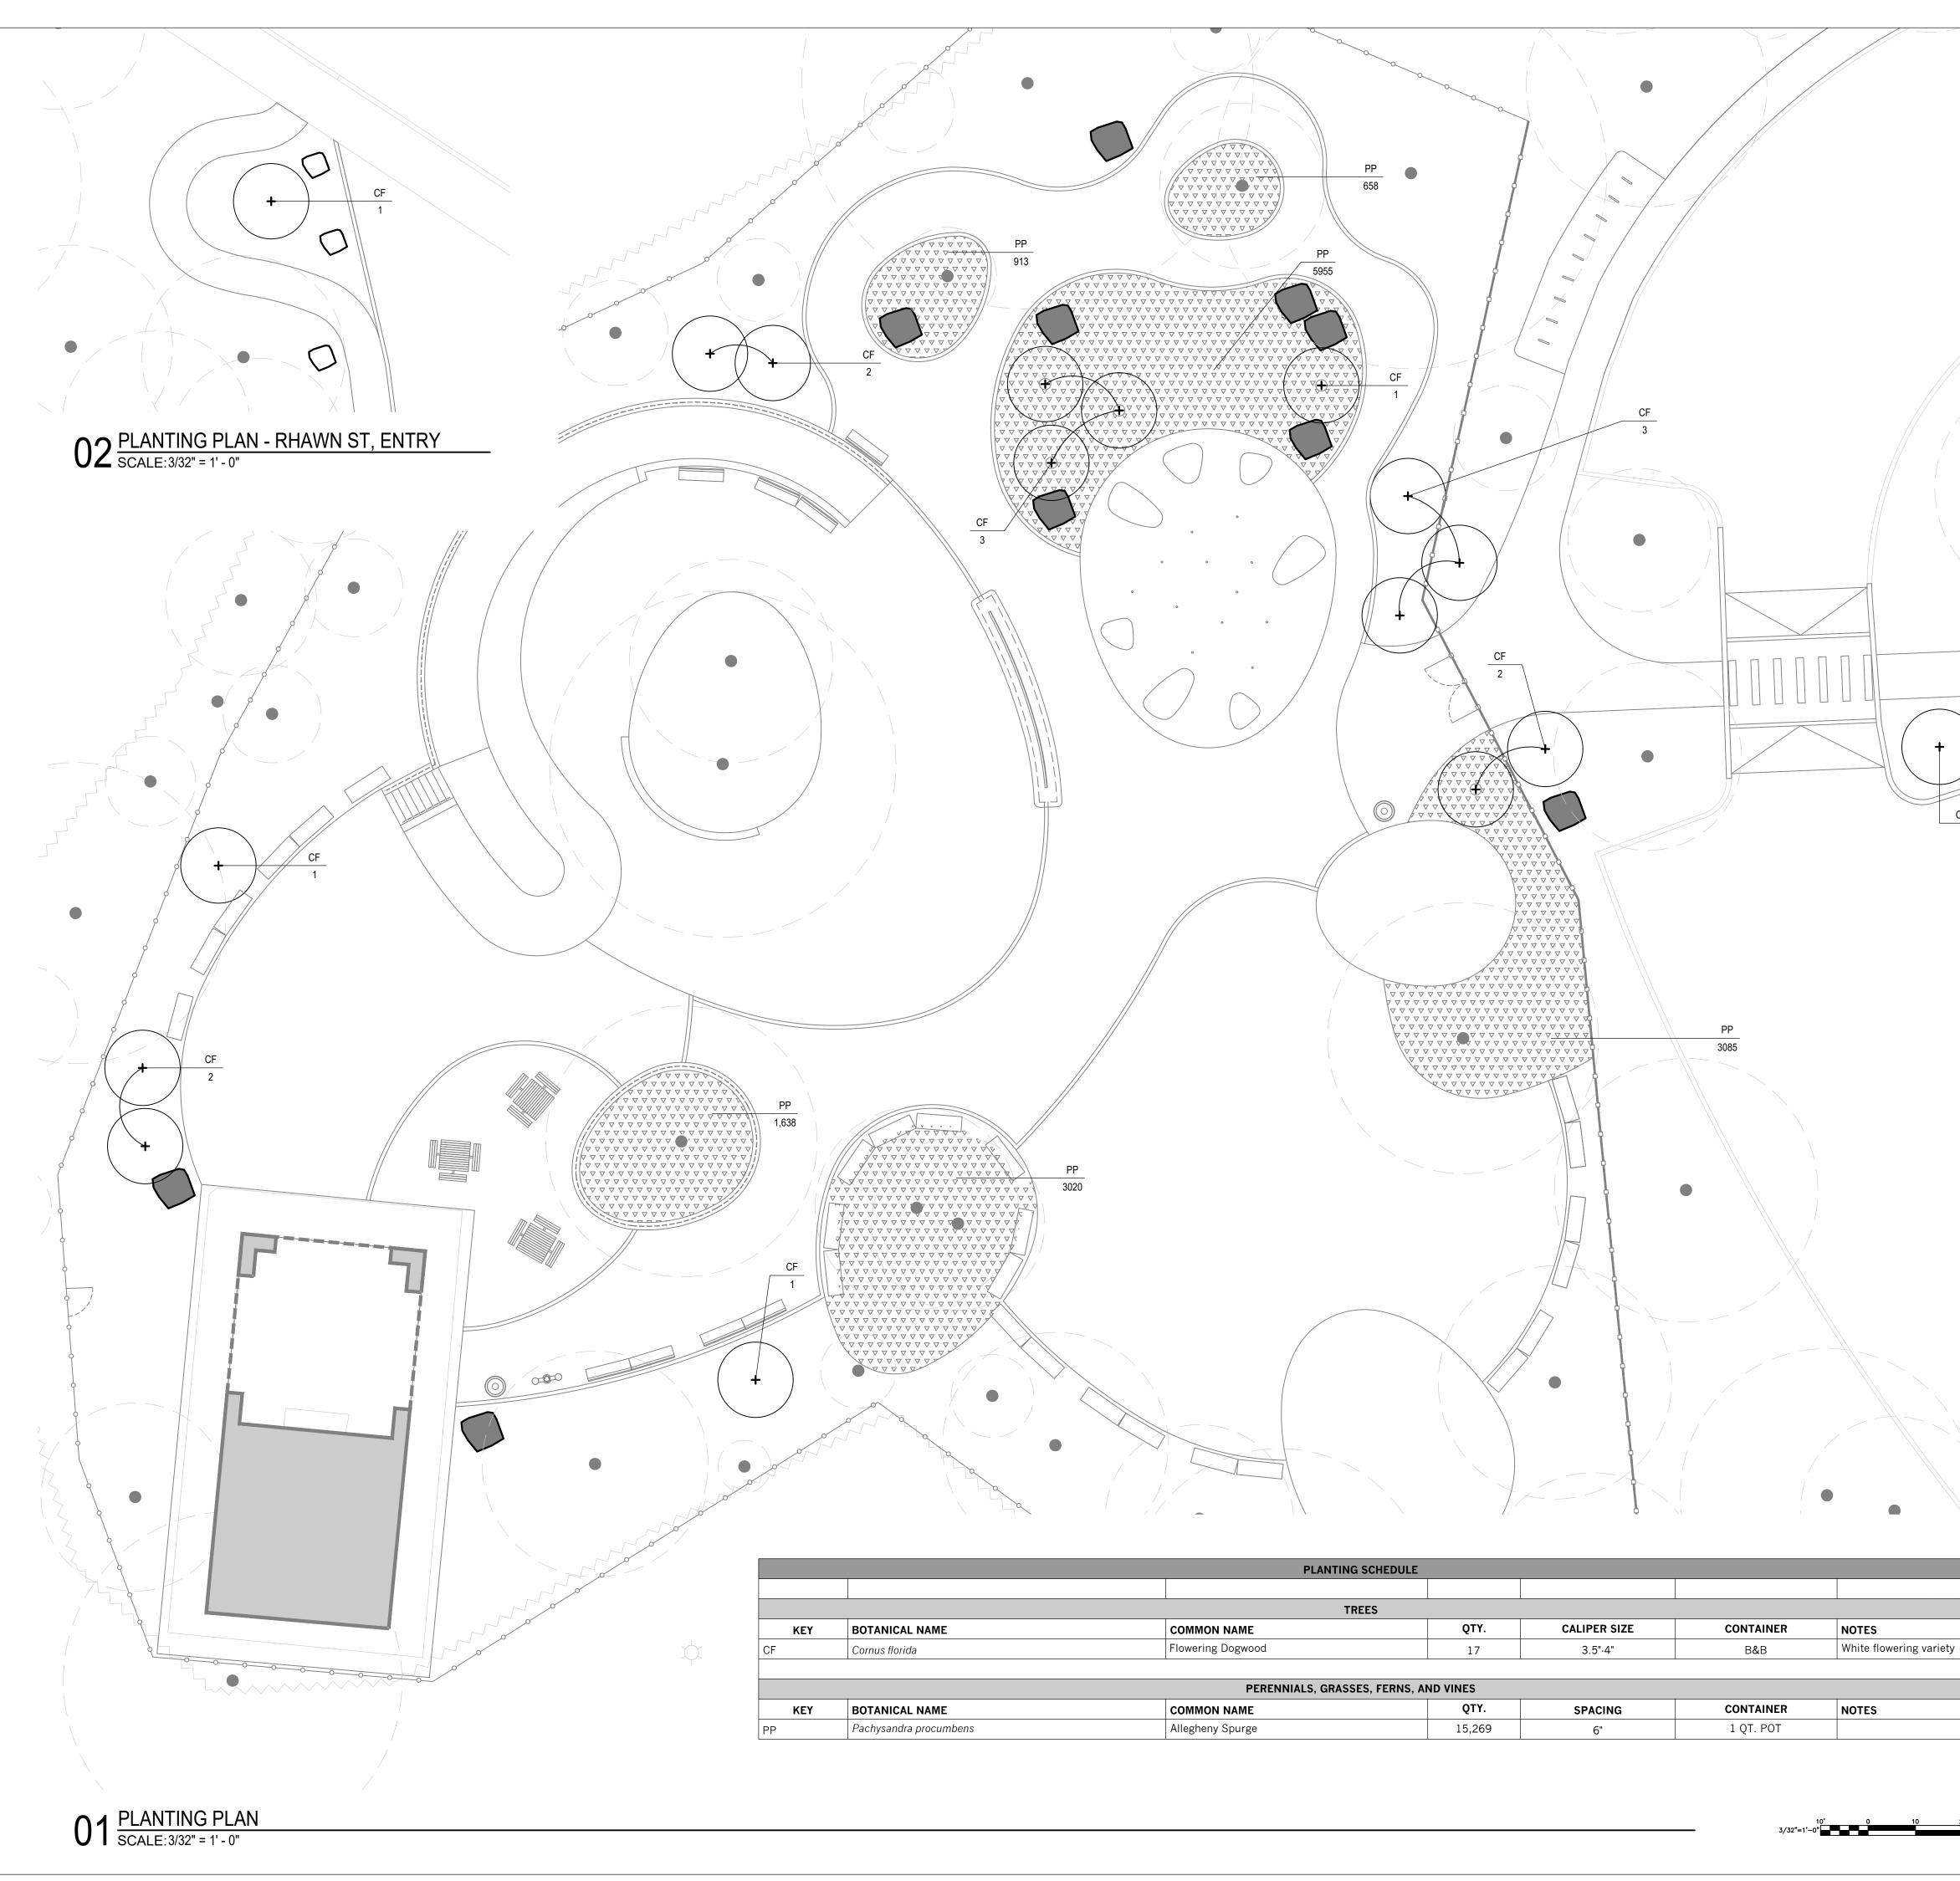

	PLANTING	SCHEDULE			
	TRI	EES			
DTANICAL NAME	COMMON NAME	QTY.	CALIPER SIZE	CONTAINER	NOTES
rnus florida	Flowering Dogwood	17	3.5"-4"	B&B	White flo
		· ·			
	PERENNIALS, GRASSE	S, FERNS, AND VINES			
DTANICAL NAME	COMMON NAME	QTY.	SPACING	CONTAINER	NOTES
chysandra procumbens	Allegheny Spurge	15,269	6"	1 QT. POT	
	l.				

LEGEND

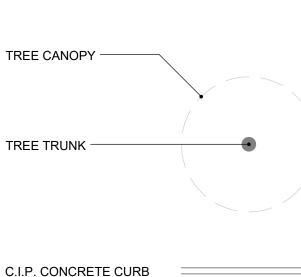

C.I.P. CONCRETE CURB



SITE BOULDER

ENTRY FENCE

SECURITY FENCE AND



_____O____O____O____

+

 $\bigtriangledown \lor \lor \lor \lor \lor \lor \lor \lor \lor \lor$

~ ~ ~ ~ ~ ~ ~ ~ ~ ~ ~ ~ ~ ~ $\begin{array}{c} & & & \\ & & & \\ & & & \\ & & & \\ & & & \\ & & & \\ & & & \\ & & & \\ & & & \\ & & & \\ & & & \\ & & & \\ & & & \\ & & & \\ & & & \\ & & & \\ & & \\ & & & \\ &$

RAIL

GATE

WOODLAND EDGE

BIKE RACK

PROPOSED TREE

EXISTING BUILDING

PROPOSED PERENNIALS

NOTES:

1. SEE L-001 FOR PLANTING NOTES. 2. SEE L-910 FOR PLANTING DETAILS.

PENNSYLVANIA ONE CALL SYSTEM, INC. 925 Irwin Run Road West Mifflin, Pennsylvani 15122 — 1078 BEFORE YOU DIG ANYWHERE IN PENNSYLVANIA! CALL 1-800-242-1776 NON-MEMBERS MUST BE CONTACTED DIRECTLY PA LAW REQUIRES THREE WORKING DAYS NOTICE TO UTILITIES BEFORE YOU EXCAVATE, DRILL, BLAST OR DEMOLISH PA ONE-CALL NUMBER (FOR DESIGN ONLY): PPR PROJECT COORDINATOR: MEGAN FUNK SEAL: SIGNATURE al film o4/05/2024 PRIMARY CONSULTANT, LANDSCAPE ARCHITECT: MARVEL

REVISIONS

REVISIONS

ISSUE DATE

145 Hudson Street, Floor 3 New York, NY 10013

SUB-CONSULTANTS:

CIVIL/SURVEY: ENGINEERING & LAND PLANNING ASSOCIATES, INC. 219 Cuthbert Street, 5th/ Floor Philadelphia, PA 19106

417 N 8th Street, Suite 204 Philadelphia, PA 19123 267.585.2811

MEP ENGINEER:

LIGHTING DESIGN: THE LIGHTING PRACTICE 600 Chestnut Street, Suite 772 Philadelphia, PA 19106

COST ESTIMATOR: ELLANA CONSTRUCTION CONSULTANTS 32 Broadway, 8TH Floor New York, NY 10004

PLAYFUL LEARNING CONSULTANT: PLAYFUL LEARNING LANDSCAPES ACTION NEXTWORK Philadelphia. PA 267.468.8610

ARBORIST: MORRIS ARBORETUM 100 East Northwestern Avenue Philadelphia, PA 19118 215.247.5777

ACCESSIBILITY CONSULTANT: CHRIS NOEL christopher.noel@parks.nyc.gov 646.632.7344

PLAY CONSULTANT: STUDIO LUDO 1313 S 33rd St, Unit A Philadelphia, PA 19146

CONSULTANT PROJECT NUMBER

2107

DATE SIGNED

CITY OF PHILADELPHIA

PHILADELPHIA PARKS AND RECREATION

1515 ARCH STREET 11TH FLOOR, ONE PARKWAY BUILDING PPR PROJECT NUMBER 16-21-7062-01

PROJECT TITLE: PENNYPACK PARK UNIVERSAL PLAYGROUND RHAWN ST. & HOLMEHURST AVE.

PLANTING PLAN

PHILADELPHIA, PA 19136

DRAWING TITLE:

PPR PROJECT NO .: DRAWING NO .: 16-21-7062-01 CONSULTANT PROJECT NO .: 2107 DATE: 12/15/2023 L-600 SCALE: AS NOTED DRAWN BY: SS, TW CHECKED BY: TS NOTE: ALL DIMENSIONS AND CONDITIONS SHALL BE VERIFIED BY THE

CONTRACTOR AT THE SITE BEFORE PROCEEDING WITH THE WORK.







































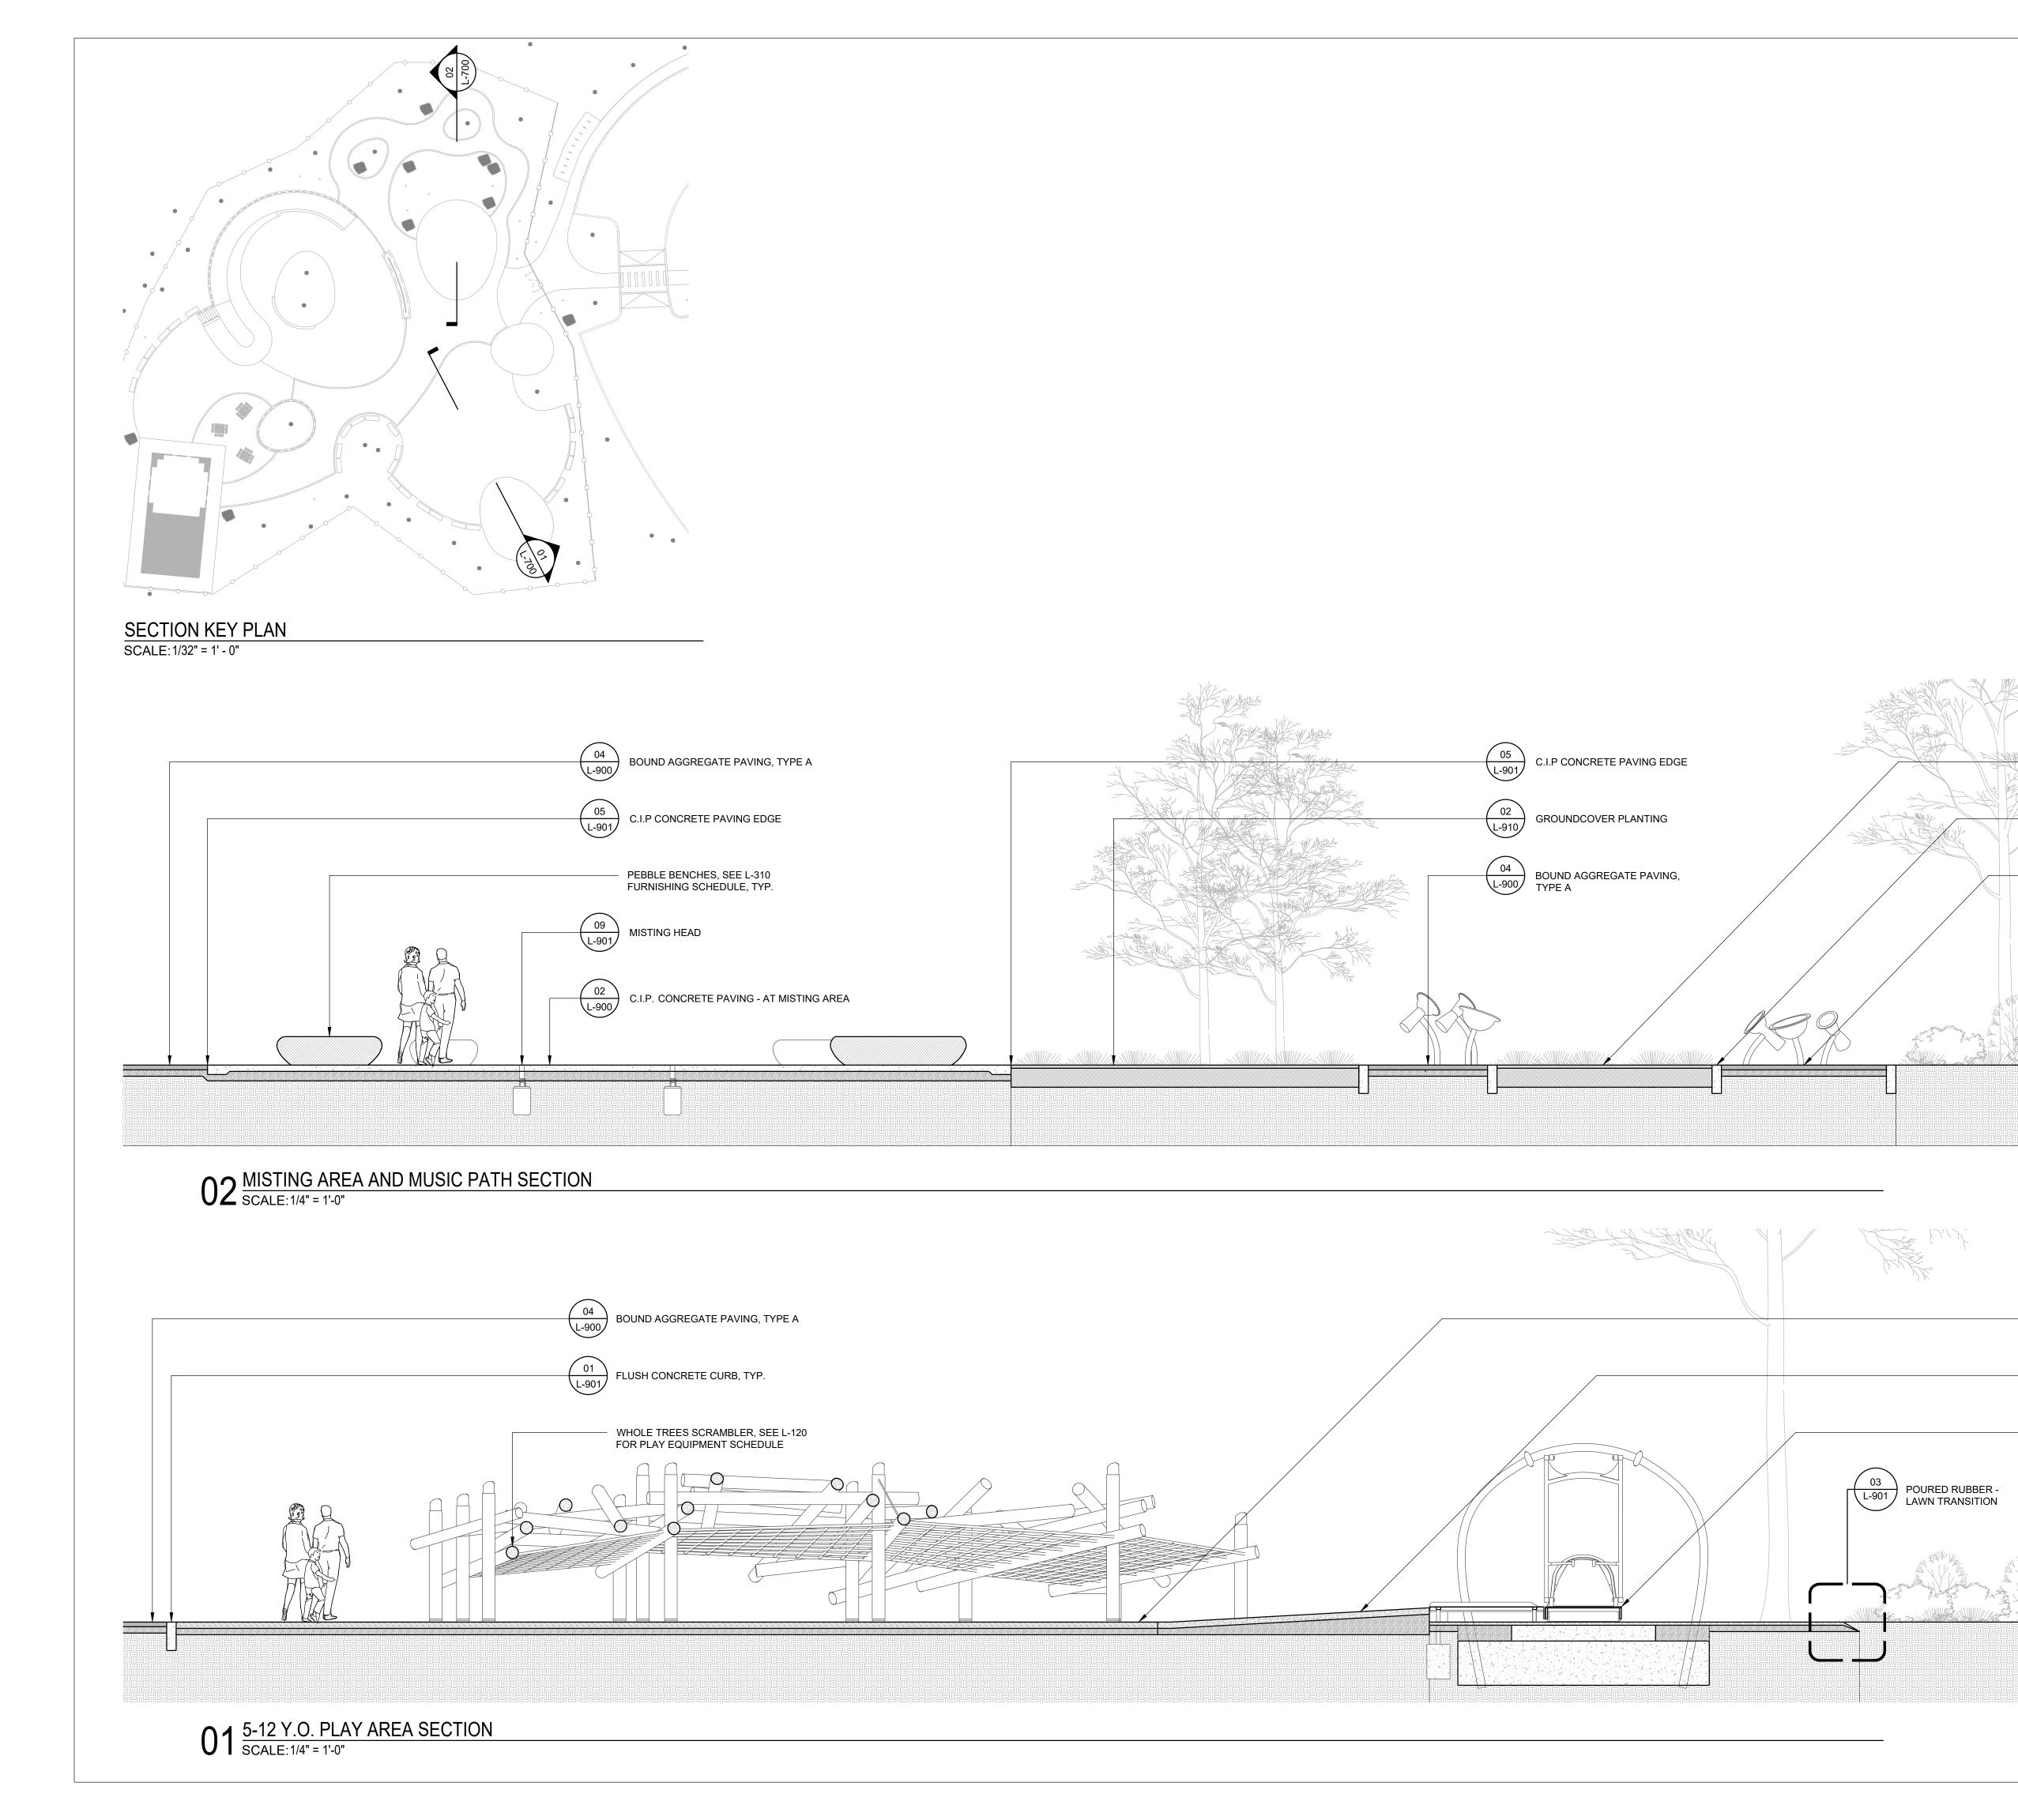


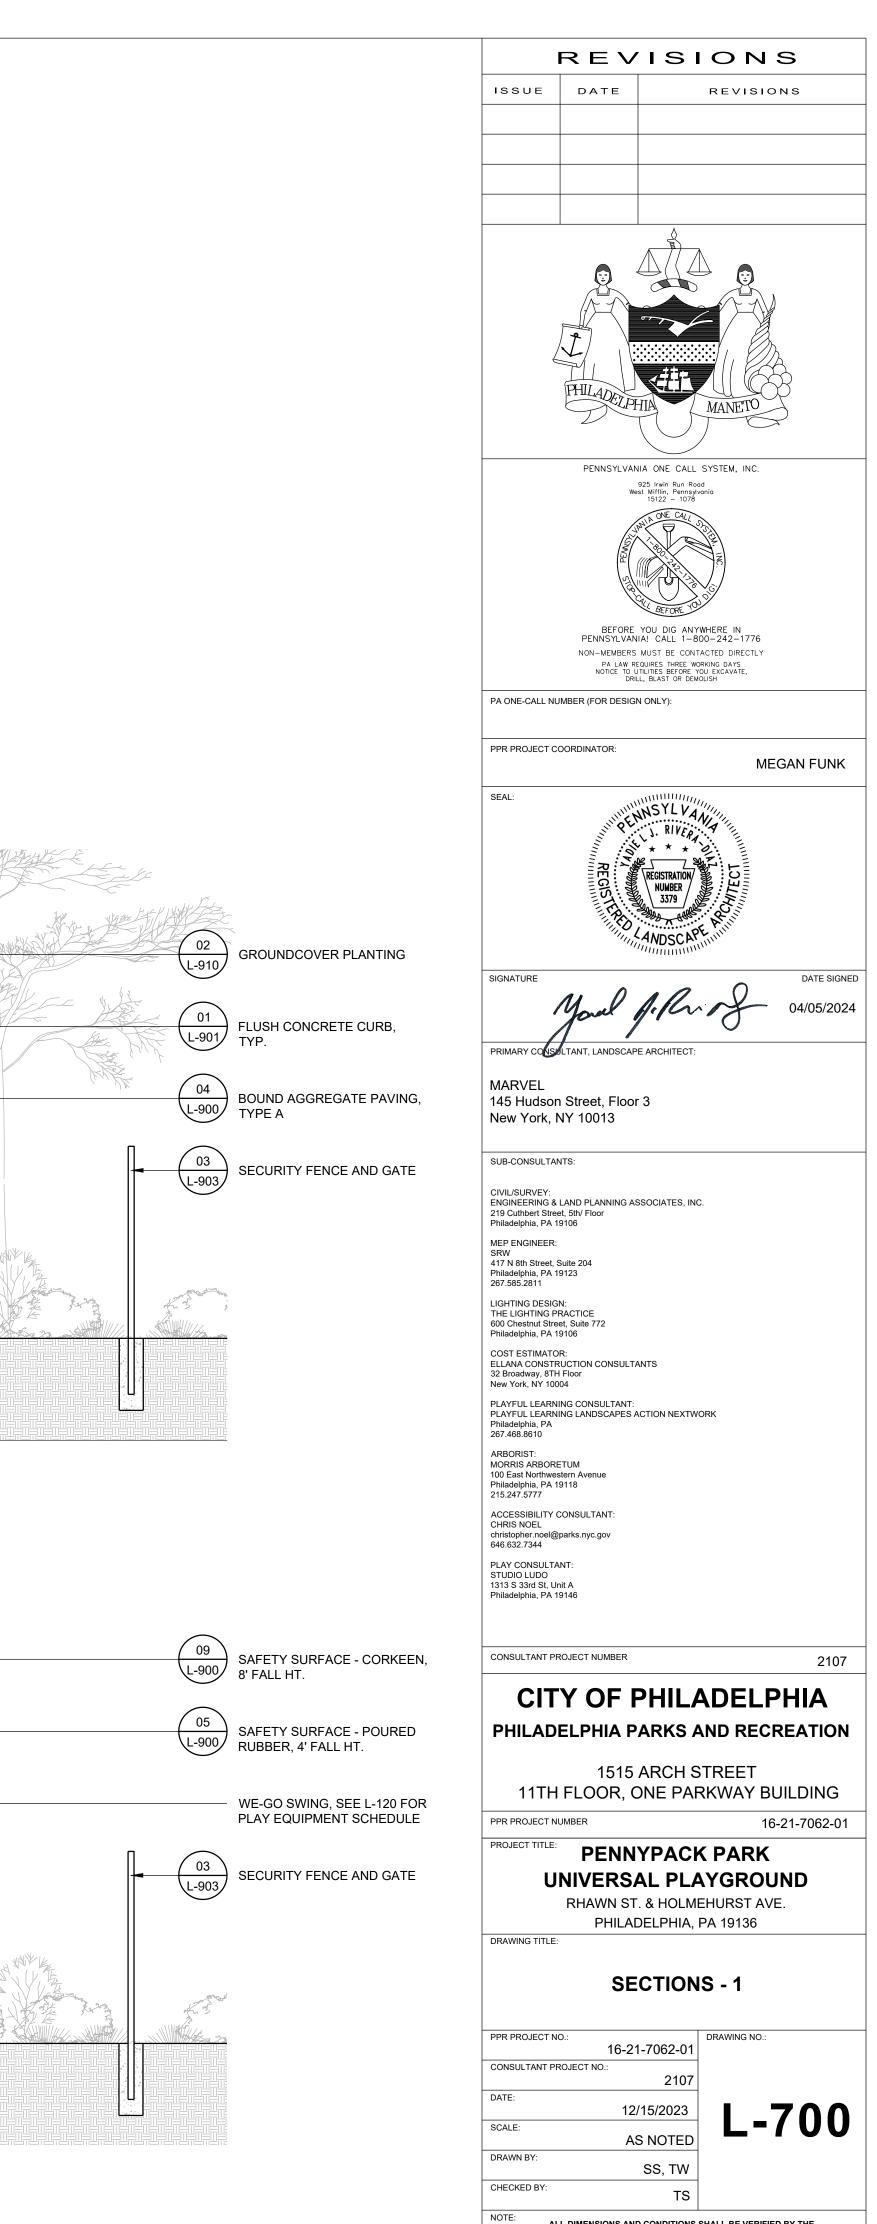


ALL DIMENSIONS AND CONDITIONS SHALL BE VERIFIED BY THE CONTRACTOR AT THE SITE BEFORE PROCEEDING WITH THE WORK.

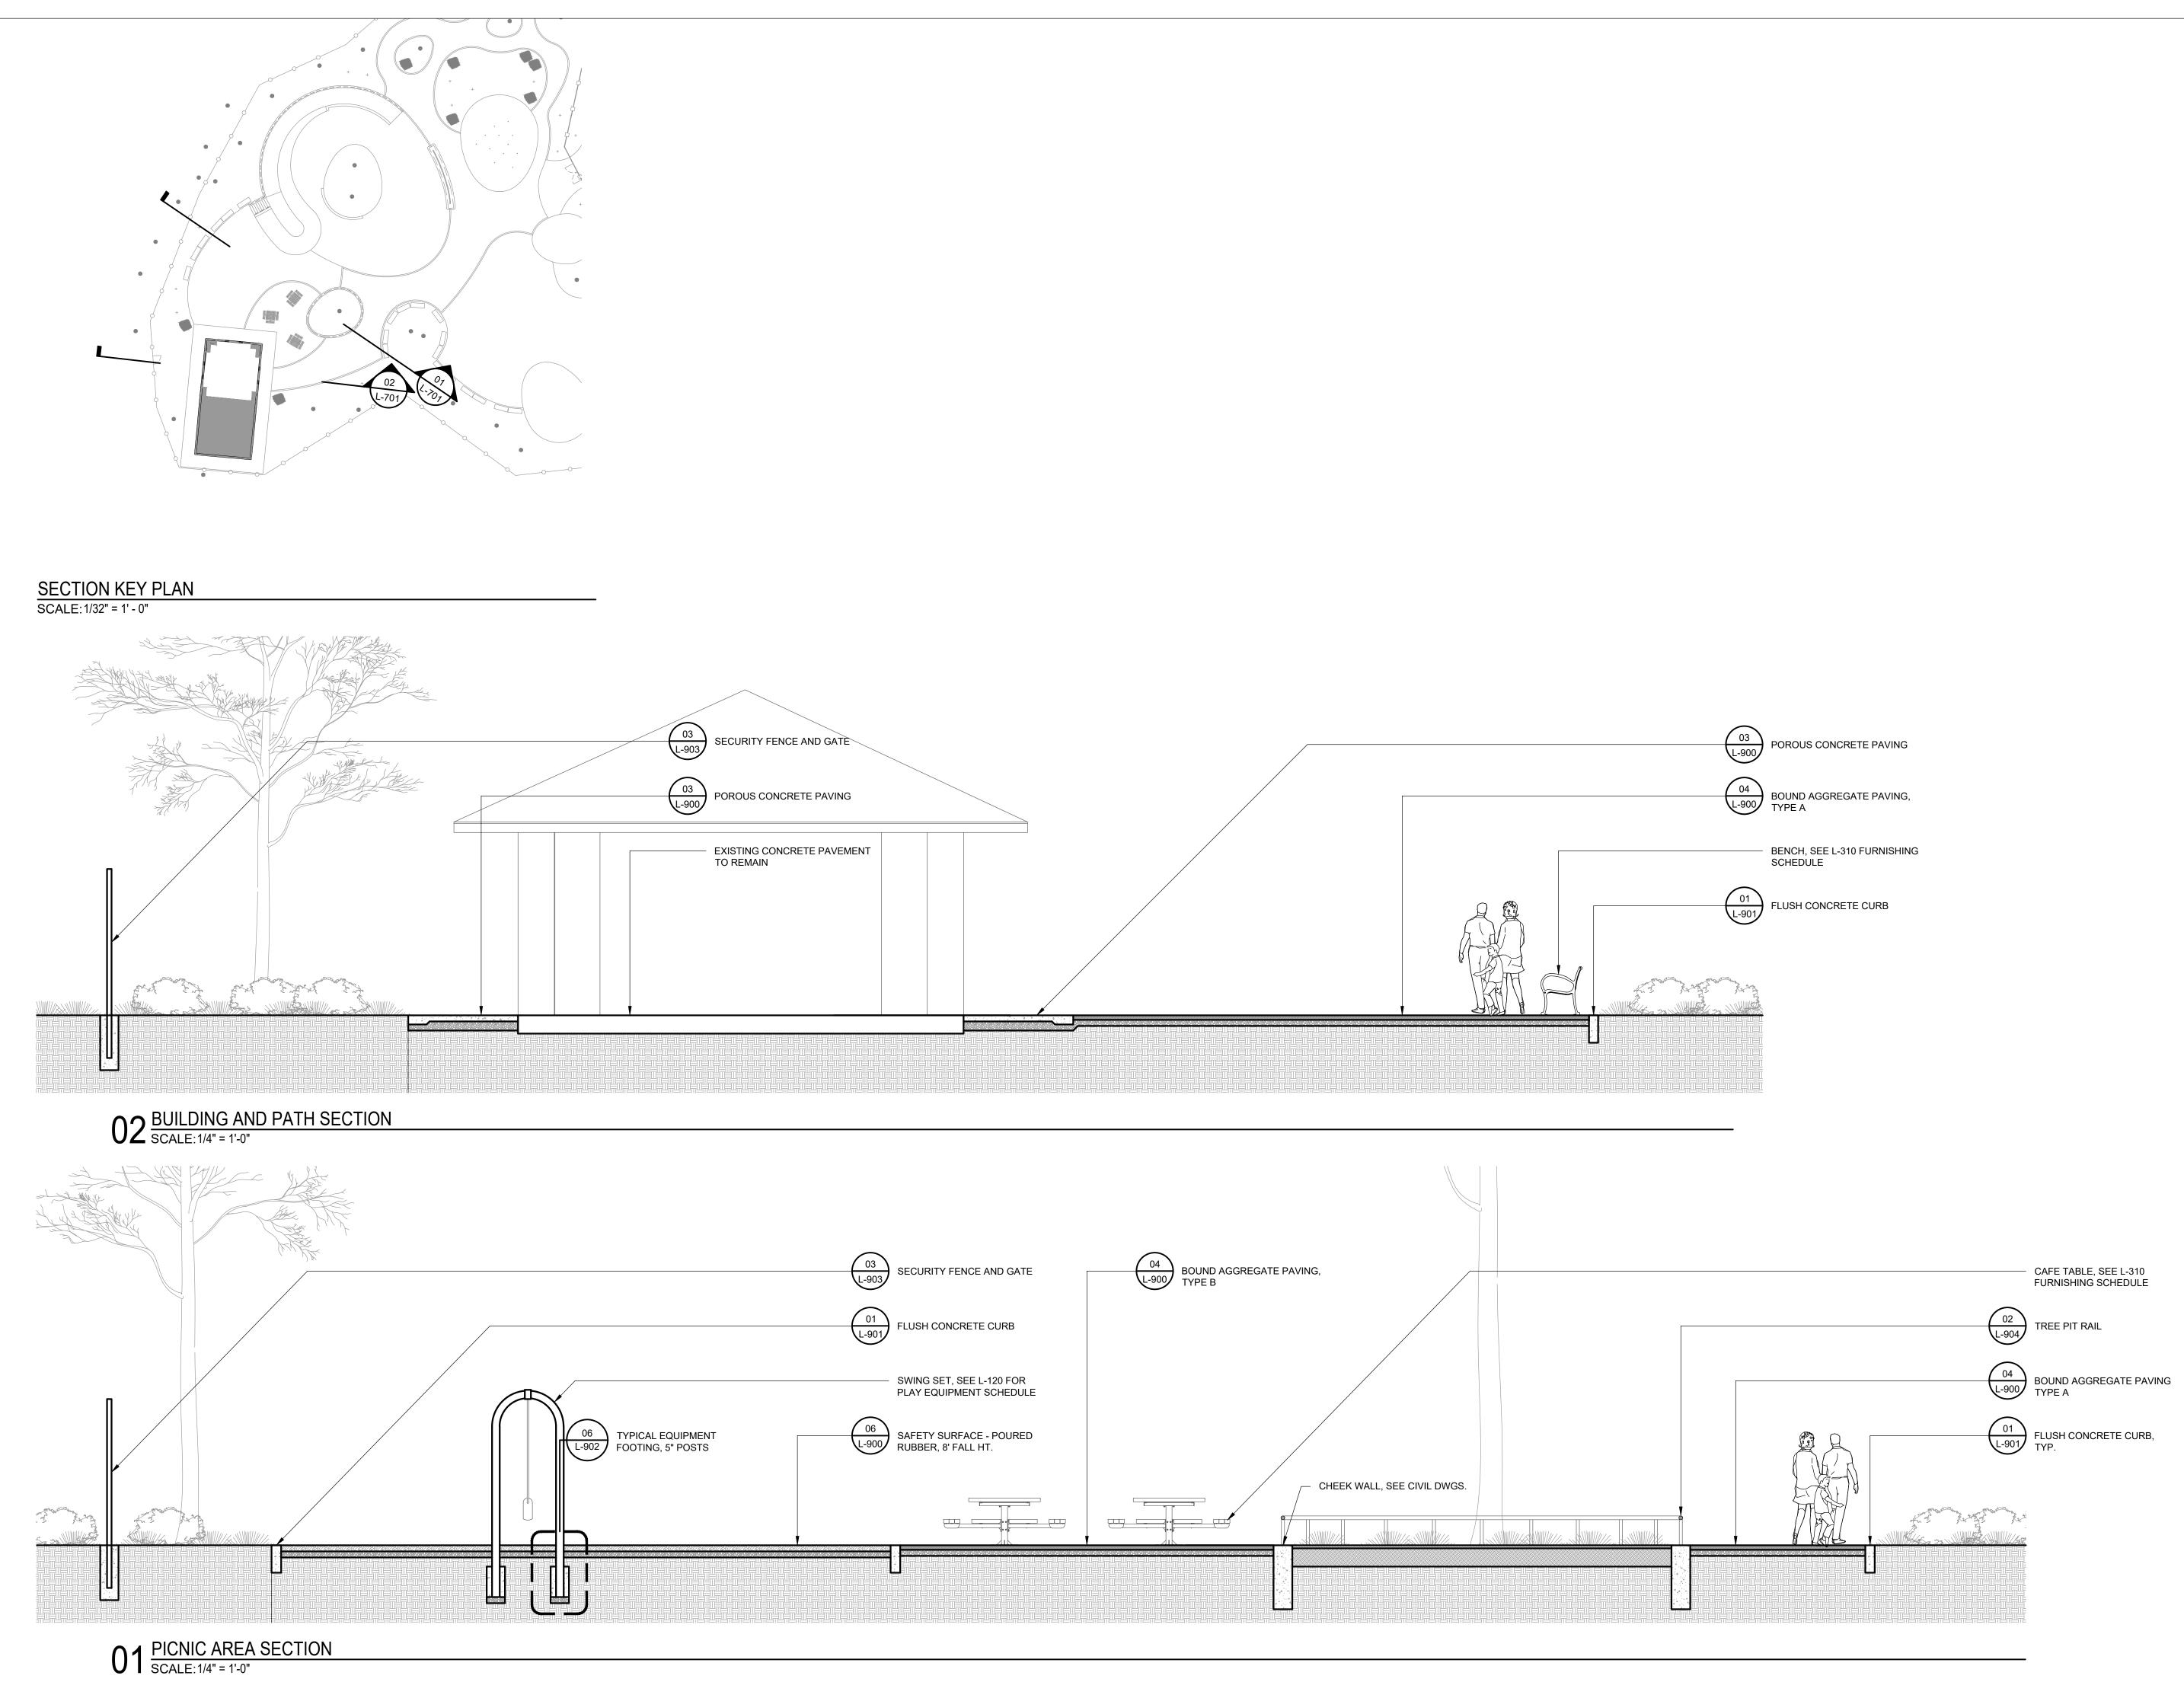


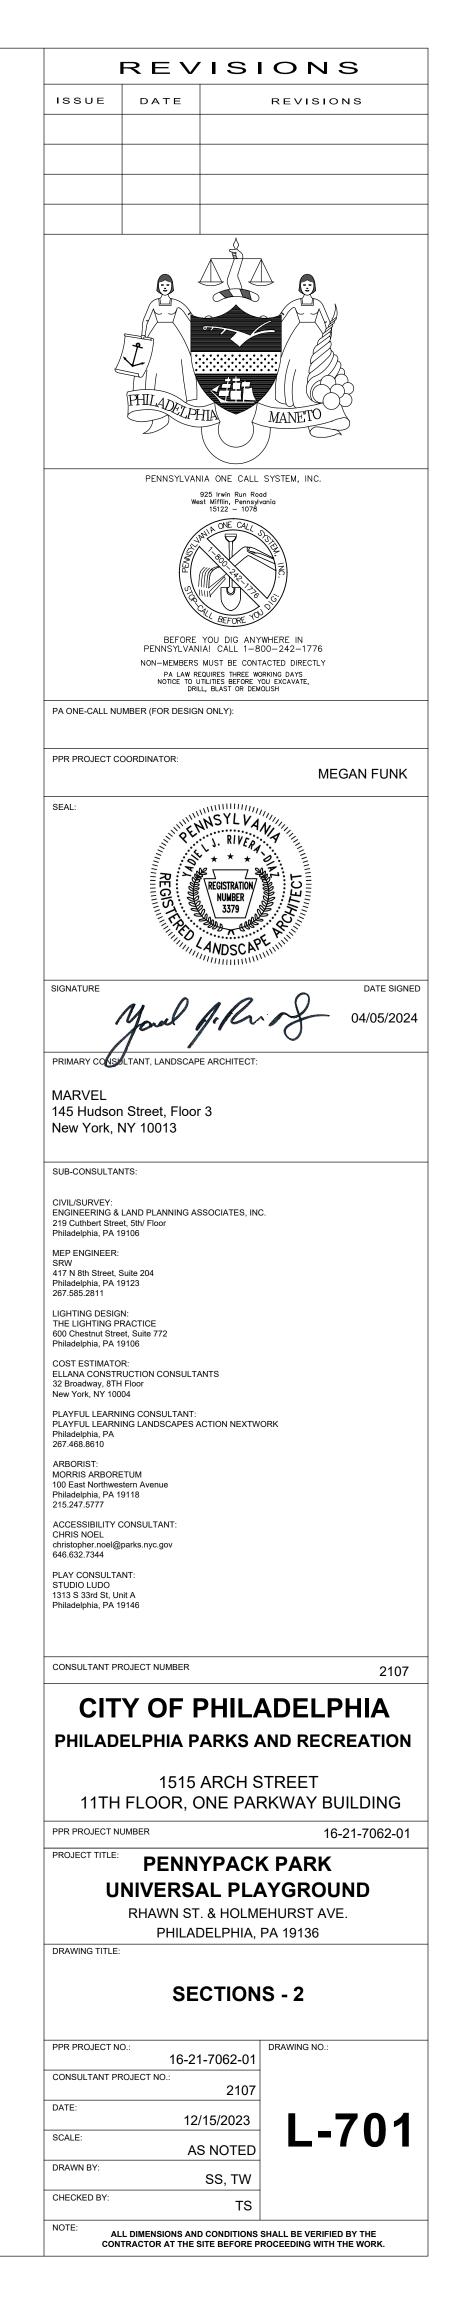


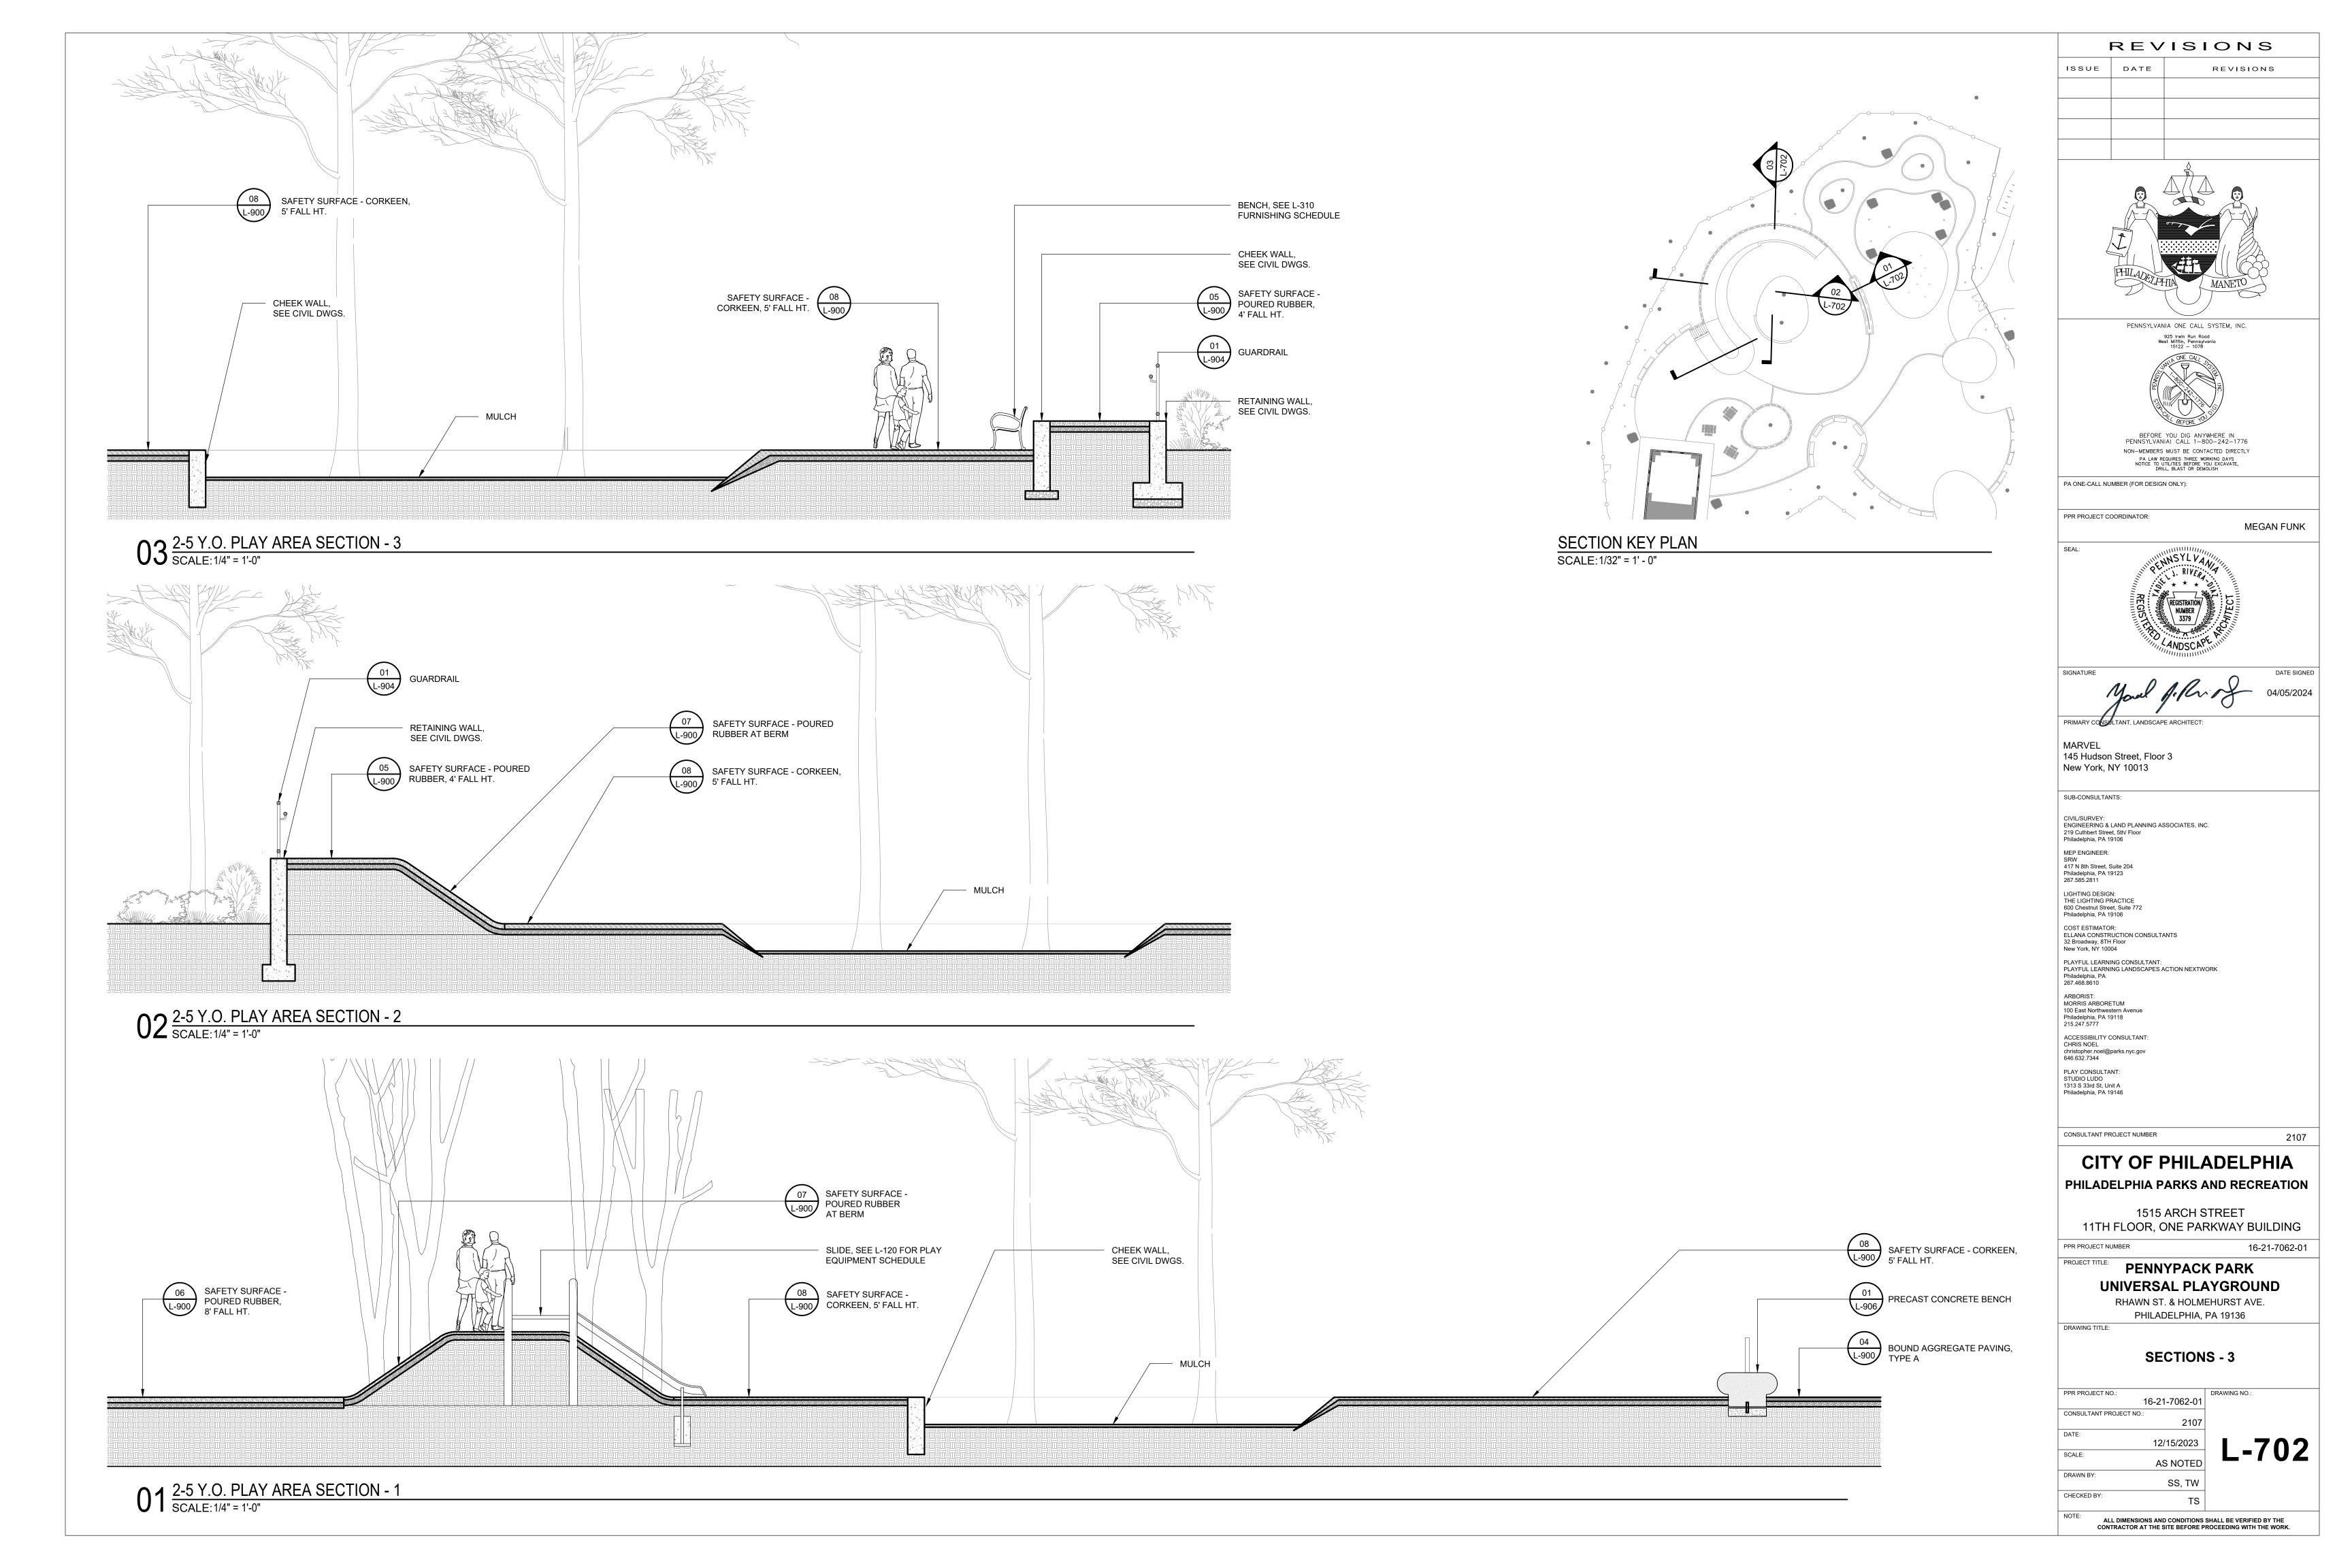

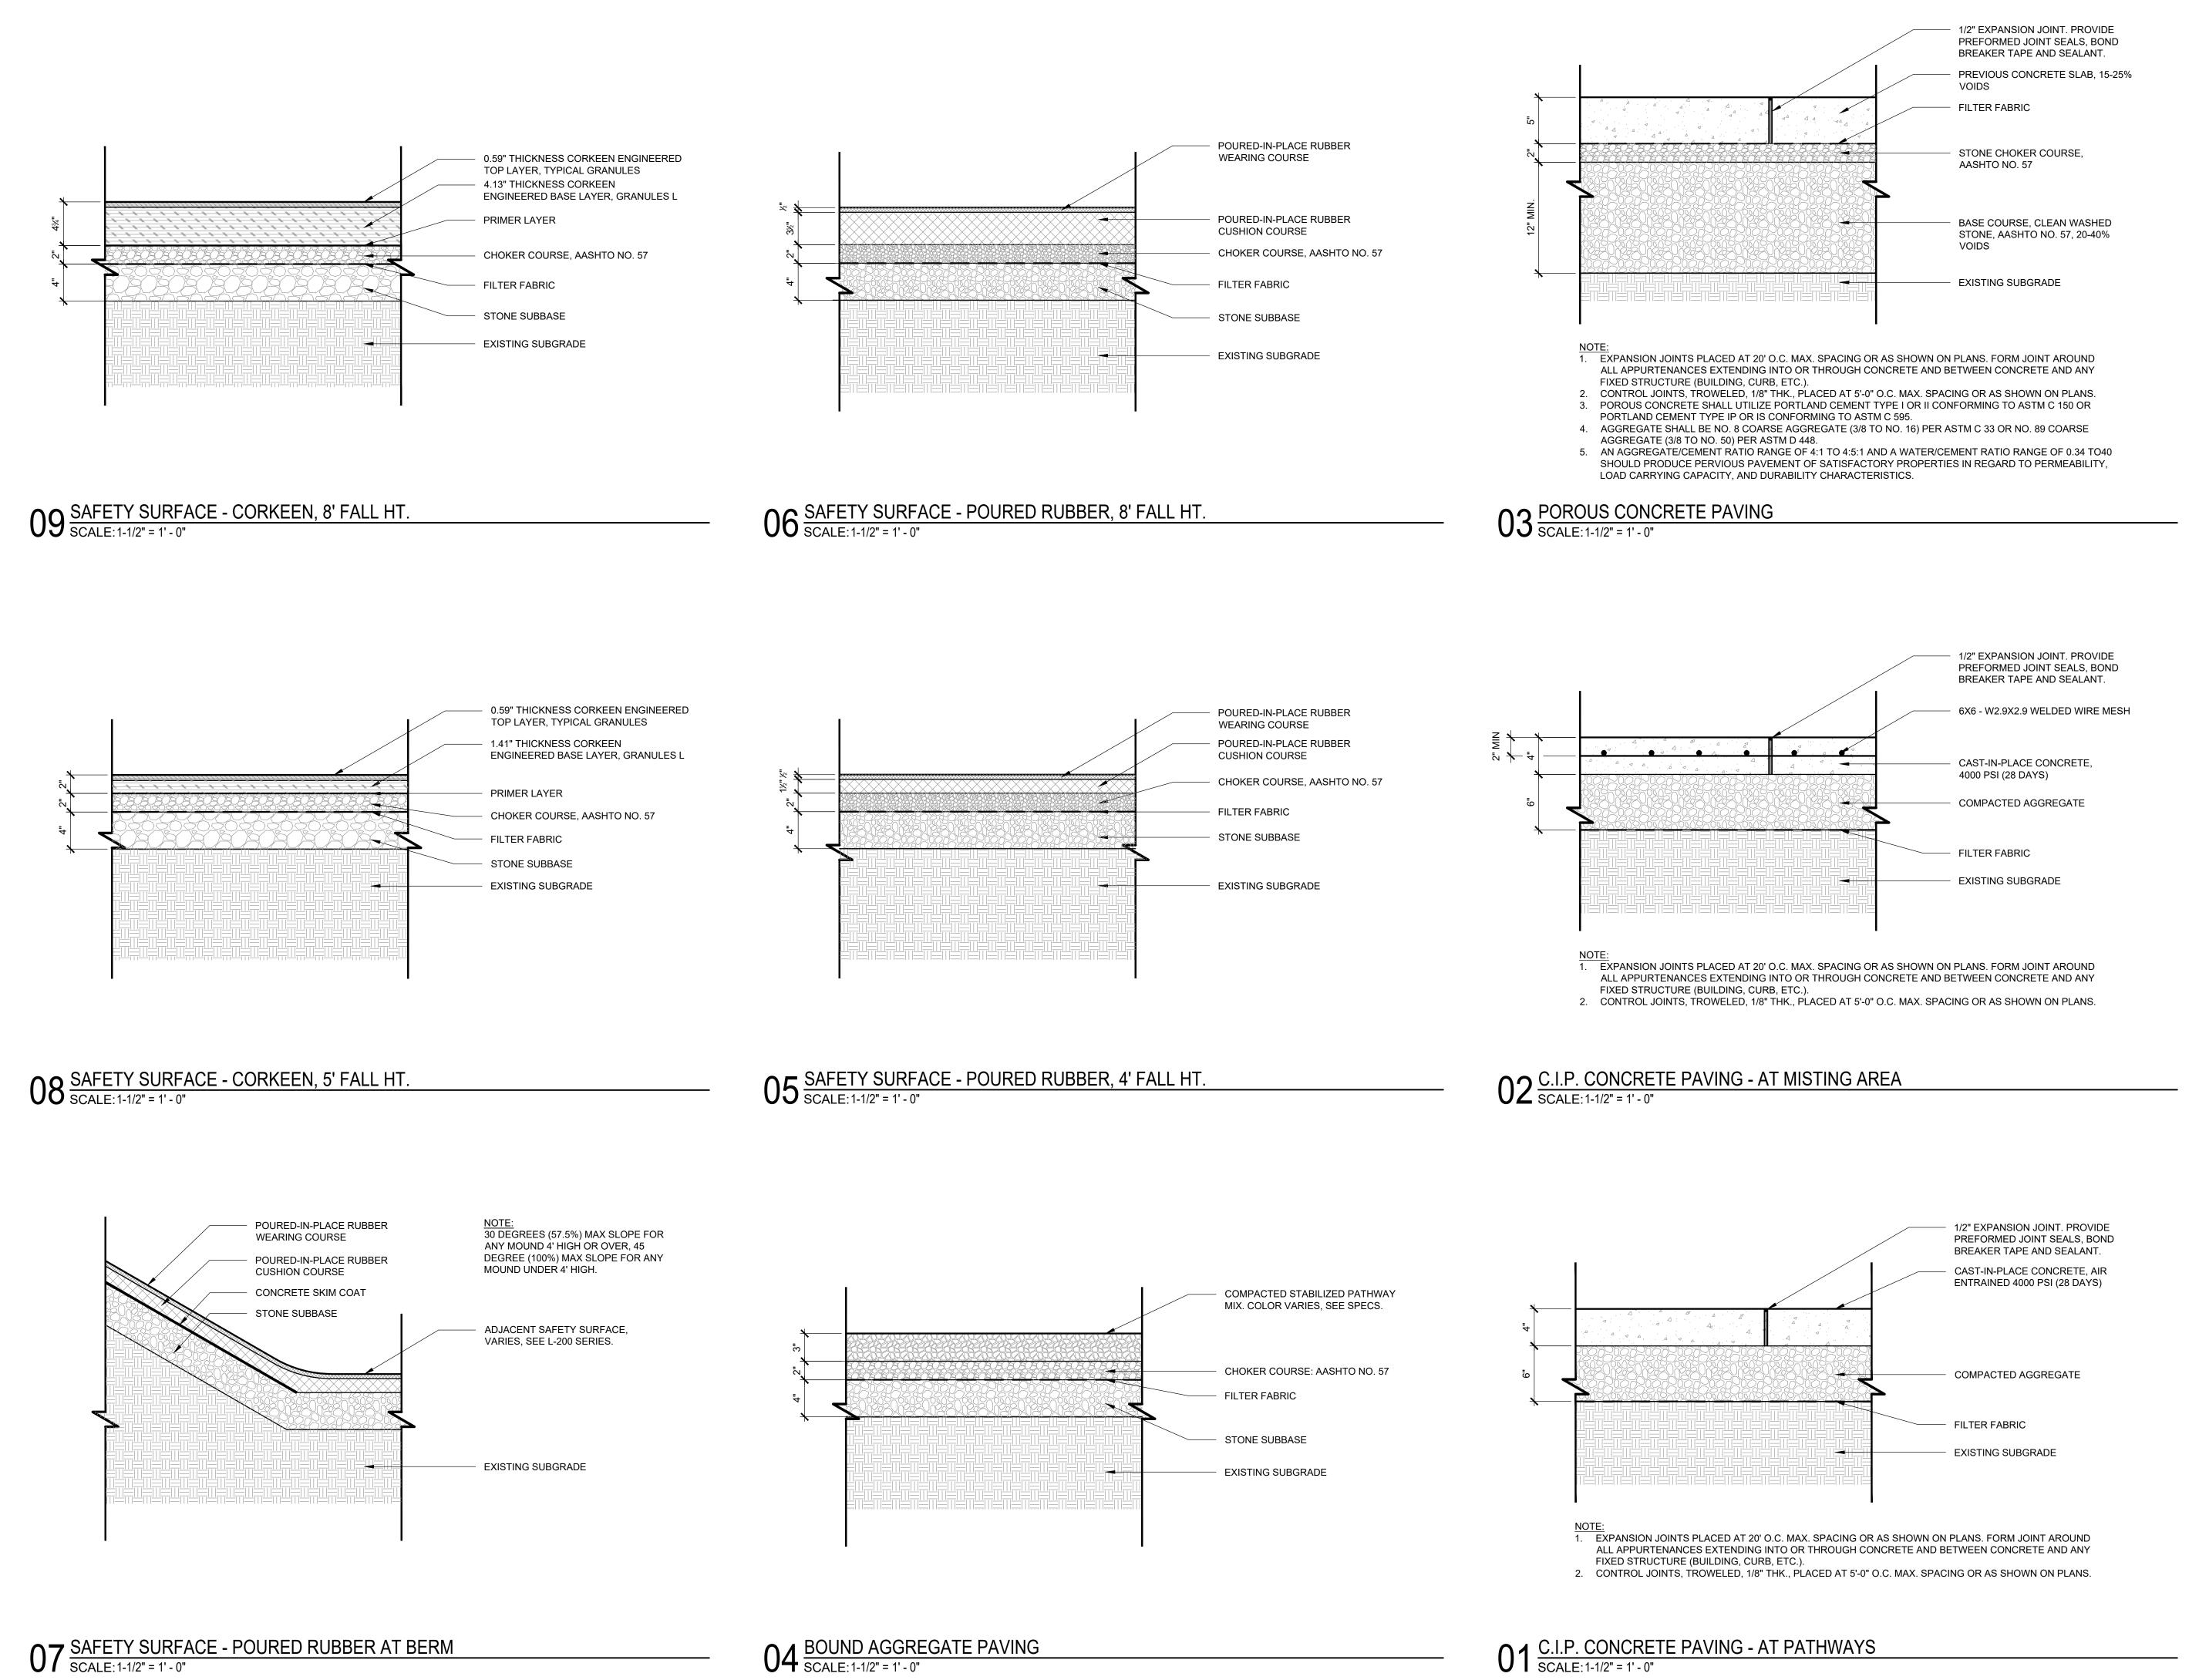


	REVISIONS
ISSUE	DATE REVISIONS
	PHILADELPHIA MANETO
	PENNSYLVANIA ONE CALL SYSTEM, INC. 925 Irwin Run Road West Wifflin, Pennsylvania 15122 - 1078 Weight ONE CALL OF DEFORE YOU DIG ANYWHERE IN PENNSYLVANIAL CALL 1-800-242-1776
	NON-MEMBERS MUST BE CONTACTED DIRECTLY PA LAW REQUIRES THREE WORKING DAYS NOTICE TO UTILITIES BEFORE YOU EXCAVATE,
PA ONE-CALL	NOTICE TO UTILITIES BEFORE YOU EXCAVATE, DRILL, BLAST OR DEMOLISH NUMBER (FOR DESIGN ONLY):
	· · · · · · · · · · · · · · · · · · ·
PPR PROJECT	
SEAL:	
	NINE WASYL VAN
	REGISTRATION NUMBER 3379
	LANDOC NPE WITH
SIGNATURE	
	Moral feller of 04/05/2024
	on Street, Floor 3
145 Huds	, NY 10013
145 Huds New York SUB-CONSULT	;, NY 10013 Tants:
145 Huds New York SUB-CONSULT	TANTS:
145 Huds New York SUB-CONSUL CIVIL/SURVEY ENGINEERING 219 Cuthbert S	TANTS:
145 Huds New York SUB-CONSUL CIVIL/SURVEY ENGINEERING 219 Cuthbert S Philadelphia, P/ MEP ENGINEE SRW 417 N 8th Stree Philadelphia, P/ 267.585.2811	TANTS:
145 Huds New York SUB-CONSUL ⁻ CIVIL/SURVEY ENGINEERING 219 Cuthbert S Philadelphia, P/ MEP ENGINEE SRW 417 N 8th Street Philadelphia, P/ 267.585.2811 LIGHTING DES THE LIGHTING 600 Chestnut S	TANTS:
145 Huds New York SUB-CONSUL CIVIL/SURVEY ENGINEERING 219 Cuthbert S Philadelphia, P, MEP ENGINEE SRW 417 N 8th Stree Philadelphia, P, 267.585.2811 LIGHTING DES THE LIGHTING 600 Chestnut S Philadelphia, P, COST ESTIMA	TANTS:
145 Huds New York SUB-CONSUL CIVIL/SURVEY ENGINEERING 219 Cuthbert S Philadelphia, P, MEP ENGINEE SRW 417 N 8th Stree Philadelphia, P, 267.585.2811 LIGHTING DES THE LIGHTING 600 Chestnut S Philadelphia, P, COST ESTIMA	TANTS: TANTS: S & LAND PLANNING ASSOCIATES, INC. treet, 5th/ Floor A 19106 SR: et, Suite 204 A 19123 SIGN: 5 PRACTICE Street, Suite 772 A 19106 TOR: STRUCTION CONSULTANTS STH Floor
145 Huds New York SUB-CONSUL CIVIL/SURVEY ENGINEERING 219 Cuthbert S Philadelphia, P, MEP ENGINEE SRW 417 N 8th Stree Philadelphia, P, 267.585.2811 LIGHTING DES THE LIGHTING 600 Chestnut S Philadelphia, P, COST ESTIMA ELLANA CONS 32 Broadway, 8 New York, NY	TANTS: TANTS: S & LAND PLANNING ASSOCIATES, INC. treet, 5th/ Floor A 19106 SR: et, Suite 204 A 19123 SIGN: B PRACTICE Street, Suite 772 A 19106 TOR: STRUCTION CONSULTANTS STH Floor 10004 RNING CONSULTANT: RNING CONSULTANT: RNING CONSULTANT: RNING LANDSCAPES ACTION NEXTWORK
145 Huds New York SUB-CONSULT CIVIL/SURVEY ENGINEERING 219 Cuthbert S Philadelphia, P. 267.585.2811 LIGHTING DES THE LIGHTING 600 Chestnut S Philadelphia, P. 267.585.2811 LIGHTING DES THE LIGHTING 600 Chestnut S Philadelphia, P. COST ESTIMA ELLANA CONS 32 Broadway, 8 New York, NY	TANTS: TANTS: S & LAND PLANNING ASSOCIATES, INC. treet, 5th/ Floor A 19106 SR: et, Suite 204 A 19123 SIGN: B PRACTICE Street, Suite 772 A 19106 TOR: STRUCTION CONSULTANTS STRUCTION CONSULTANTS
145 Huds New York SUB-CONSUL CIVIL/SURVEY ENGINEERING 219 Cuthbert S Philadelphia, P, MEP ENGINEE SRW 417 N 8th Stree Philadelphia, P, 267.585.2811 LIGHTING DES THE LIGHTING 600 Chestnut S Philadelphia, P, COST ESTIMA ELLANA CONS 32 Broadway, 8 New York, NY PLAYFUL LEAI Philadelphia, P, 267.468.8610 ARBORIST: MORRIS ARBO	TANTS: TANTS: S & LAND PLANNING ASSOCIATES, INC. treet, 5th/ Floor A 19106 SR: et, Suite 204 A 19123 SIGN: S PRACTICE Street, Suite 772 A 19106 TOR: STRUCTION CONSULTANTS STRUCTION CONSULANT
145 Huds New York	TANTS: TANTS: S & LAND PLANNING ASSOCIATES, INC. treet, 5th/ Floor A 19106 SR: at, Suite 204 A 19123 SIGN: B PRACTICE Street, Suite 772 A 19106 TOR: STRUCTION CONSULTANTS STH Floor 10004 RNING CONSULTANT: RNING LANDSCAPES ACTION NEXTWORK A DRETUM western Avenue A 19118 Y CONSULTANT:
145 Huds New York	TANTS: S & LAND PLANNING ASSOCIATES, INC. treet, 5th/ Floor A 19106 SR: et, Suite 204 A 19123 SIGN: S PRACTICE STRUCTION CONSULTANTS STRUCTION CONSULT
145 Huds New York	A, NY 10013 TANTS:
145 Huds New York	A, NY 10013 TANTS:
145 Huds New York	A, NY 10013 TANTS:
145 Huds New York	r, NY 10013 TANTS:
145 Huds New York SUB-CONSULT CIVIL/SURVEY ENGINEERING 219 Cuthbert S Philadelphia, P. MEP ENGINEE SRW 417 N 8th Stree Philadelphia, P. 267.585.2811 LIGHTING DES THE LIGHTING 600 Chestnut S Philadelphia, P. 267.585.2811 LIGHTING DES THE LIGHTING 200 Chestnut S Philadelphia, P. 267.468.8610 ARBORIST: MORRIS ARBOC 100 East North Philadelphia, P. 267.468.8610 ARBORIST: MORRIS ARBOC 100 East North Philadelphia, P. 215.247.5777 ACCESSIBILIT CHRIS NOEL christopher.noe 646.632.7344 PLAY CONSUL STUDIO LUDO 1313 S 33rd St, Philadelphia, P. CONSULTANT	r, NY 10013 TANTS:
145 Huds New York SUB-CONSULT CIVIL/SURVEY ENGINEERING 219 Cuthbert S Philadelphia, P. MEP ENGINEE SRW 417 N 8th Stree Philadelphia, P. 267.585.2811 LIGHTING DES THE LIGHTING 600 Chestnut S Philadelphia, P. 267.585.2811 LIGHTING DES THE LIGHTING 200 Chestnut S Philadelphia, P. 267.468.8610 ARBORIST: MORRIS ARBOC 100 East North Philadelphia, P. 267.468.8610 ARBORIST: MORRIS ARBOC 100 East North Philadelphia, P. 215.247.5777 ACCESSIBILIT CHRIS NOEL christopher.noe 646.632.7344 PLAY CONSUL STUDIO LUDO 1313 S 33rd St, Philadelphia, P. CONSULTANT	r, NY 10013 TANTS: TANTS: TANTS: TRUELION CONSULTATES, INC. Treet, Stif Floor A 19103 SIGN: SPRACTICE STRUCTION CONSULTANTS STH Floor STRUCTION CONSULTANTS STRUCTION STRUCTION NEXTWORK A STRUCTION STRUCTION STRUCTION STRUCTUON STRUCTION STRUCTION STRUCTION STRUCTUON STRUCTION STRUCTION STRUCTION STRUCTUON STRUCTION STRUCTION STRUCTUON STRUCTUON STRUCTION STRUCTION STRUCTUON STRUCTUON STRUCTION STRUCTION STRUCTUON STRUCTUON STRUCTION STRUCTION STRUCTUON STRUCTION STRUCTUON STRUCTION STRUCTION STRUCTUON STRUCTU
145 Huds New York SUB-CONSULT CIVIL/SURVEY ENGINEERING 219 Cuthbert S Philadelphia, P, MEP ENGINEE SRW 417 N 8th Stree Philadelphia, P, 267.585.2811 LIGHTING DES THE LIGHTING 600 Chestnut S Philadelphia, P, COST ESTIMA ELLANA CONS 32 Broadway, 8 New York, NY PLAYFUL LEAI Philadelphia, P, 267.468.8610 ARBORIST: MORRIS ARBC 100 East North Philadelphia, P, 215.247.5777 ACCESSIBILIT CHRIS NOEL christopher.noe 646.632.7344 PLAY CONSUL STUDIO LUDO 1313 S 33rd St, Philadelphia, P, CONSULTANT	r, NY 10013 TANTS: S LAND PLANNING ASSOCIATES, INC. treet, 5th/ Floor A 19106 SR: B PRACTICE STRUE, Suite 204 A 19123 SIGN: B PRACTICE STRUCTION CONSULTANTS STRUCTION CONSULTANTS STRUCTION CONSULTANTS STRUCTION CONSULTANTS STRUCTION CONSULTANTS STRUCTION CONSULTANTS TRINING CANSULTANT: RNING CONSULTANT: PROJECT NUMBER PRO
145 Huds New York SUB-CONSULT CIVIL/SURVEY ENGINEERING 219 Cuthert S Philadelphia, P, MEP ENGINEE SRW 417 N 8th Stree Philadelphia, P, 267.585.2811 LIGHTING DES THE LIGHTING 600 Chestnut S Philadelphia, P, COST ESTIMA ELLANA CONS 32 Broadway, 8 New York, NY PLAYFUL LEAI Philadelphia, P, 267.468.8610 ARBORIST: MORRIS ARBC 100 East North Philadelphia, P, 267.468.8610 ARBORIST: MORRIS ARBC 100 East North Philadelphia, P, 215.247.5777 ACCESSIBILIT CHRIS NOEL christopher.noe 646.632.7344 PLAY CONSUL STUDIO LUDO 1313 S 33rd St, Philadelphia, P, CONSULTANT CONSULTANT CONSULTANT	s, NY 10013 TANTS: TANTS: Staland PLANNING ASSOCIATES, INC. Treet, Stil/Floor A 19108 SR: SR: SIGN: SPRACTICE SPRACTICE STRUCTION CONSULTANTS TOR: STRUCTION CONSULTANTS TOR: STRUCTION CONSULTANTS STRUCTION CONSULTANTS STRUCTION CONSULTANTS TOR: STRUCTION CONSULTANT: STRUCTION CONSULTANTS TOR: STRUCTION CONSULTANTS STRUCTION CONSULTANTS STRUCTION CONSULTANTS STRUCTION CONSULTANT: STRUCTION CONSULTANTS STRUCTION CONSULTANTS STRUCTION CONSULTANT: STRUCTION CONSULTANT: STRUCTION CONSULTANTS STRUCTION CONSULTANTS STRUCTION CONSULTANT: STRUCTION CONSULTANT: STRUCTION CONSULTANT: STRUCTION CONSULTANTS STRUCTION ST
145 Huds New York SUB-CONSULT CIVIL/SURVEY ENGINEERING 219 Cuthbert S Philadelphia, P, MEP ENGINEE SRW 417 N 8th Stree Philadelphia, P, 267.585.2811 LIGHTING DES THE LIGHTING 600 CheStINA ELLANA CONS 32 Broadway, 8 New York, NY PLAYFUL LEAI Philadelphia, P, 267.468.8610 ARBORIST: MORRIS ARBC 100 East Northu Philadelphia, P, 267.468.8610 ARBORIST: MORRIS ARBC 100 East Northu Philadelphia, P, 267.468.8610 ARBORIST: MORRIS ARBC 100 East Northu Philadelphia, P, 267.468.8610 CONSULTANT CONSULTANT CONSULTANT CONSULTANT CONSULTANT CONSULTANT PLAY CONSUL STUDIO LUDO 1313 S 33rd St, Philadelphia, P, CONSULTANT	s, NY 10013 TANTS: TANTS: Staland PLANNING ASSOCIATES, INC. treet, Sth/ Floor A 19106 Str a 19106 Str a 19108 Str b PRACTICE Street, Suile 204 A 19123 Str FYRUCTION CONSULTANTS STR H FLOO STRUCTION CONSULTANTS STR H FLOO STRUCTION CONSULTANTS TOR: UNING CONSULTANT: RNING LANDSCAPES ACTION NEXTWORK A STR H FLOO STRUCTION CONSULTANTS TOR: UNING LANDSCAPES ACTION NEXTWORK A STR
145 Huds New York SUB-CONSULT CIVIL/SURVEY ENGINEERING 219 Cuthbert S Philadelphia, P, MEP ENGINEE SRW 417 N 8th Stree Philadelphia, P, 267.585.2811 LIGHTING DES THE LIGHTING 600 CheStINA ELLANA CONS 32 Broadway, 8 New York, NY PLAYFUL LEAI Philadelphia, P, 267.468.8610 ARBORIST: MORRIS ARBC 100 East Northu Philadelphia, P, 267.468.8610 ARBORIST: MORRIS ARBC 100 East Northu Philadelphia, P, 267.468.8610 ARBORIST: MORRIS ARBC 100 East Northu Philadelphia, P, 267.468.8610 CONSULTANT CONSULTANT CONSULTANT CONSULTANT CONSULTANT CONSULTANT PLAY CONSUL STUDIO LUDO 1313 S 33rd St, Philadelphia, P, CONSULTANT	r, NY 10013 TANTS: TANTS: TANTS: TAINTS: TS & LAND PLANNING ASSOCIATES, INC. Treet, Stil/ Floor A 19106 TRI: TS & LAND PLANNING ASSOCIATES, INC. Treet, Stil/ Floor A 19108 TRI: TS & LAND PLANNING ASSOCIATES, INC. Treet, Stil/ Floor A 19108 TOR: TOR: TOR: TOR: TOR: TOR: TOR: TOR:
145 Huds New York SUB-CONSULT CIVIL/SURVEY ENGINEERING 219 Cuthbert S Philadelphia, P, MEP ENGINEE SRW 417 N 8th Stree Philadelphia, P, 267.585.2811 LIGHTING DES THE LIGHTING 600 CheSTESTIMA ELLANA CONS 32 Broadway, 8 New York, NY PLAYFUL LEAI Philadelphia, P, 267.468.8610 ARBORIST: MORRIS ARBORIST: MORRIS ARBORIST: MORRIS ARBORIST: MORRIS ARBORIST: MORRIS ARBORIST: MORRIS ANOTH Philadelphia, P, 215.247.5777 ACCESSIBILIT CHRIS NOEL christopher.noe 646.632.7344 PLAY CONSUL STUDIO LUDO 1313 S 33rd St, Philadelphia, P, 215.247.5777 ACCESSIBILIT CHRIS NOEL christopher.noe 646.632.7344 PLAY CONSUL STUDIO LUDO 1313 S 33rd St, Philadelphia, P, CONSULTANT CONSULTANT CONSULTANT PLAY CONSUL STUDIO LUDO 1313 C ST PHILADI	A, NY 10013 TANTS: TANT
145 Huds New York SUB-CONSULT CIVIL/SURVEY ENGINEERING 219 Cuthbert S Philadelphia, P, MEP ENGINEE SRW 417 N 8th Stree Philadelphia, P, 267.585.2811 LIGHTING DES THE LIGHTING 600 CheStINA ELLANA CONS 32 Broadway, 8 New York, NY PLAYFUL LEAI Philadelphia, P, 267.468.8610 ARBORIST: MORRIS ARBC 100 East Northu Philadelphia, P, 267.468.8610 ARBORIST: MORRIS ARBC 100 East Northu Philadelphia, P, 267.468.8610 ARBORIST: MORRIS ARBC 100 East Northu Philadelphia, P, 267.468.8610 CONSULTANT CONSULTANT CONSULTANT CONSULTANT CONSULTANT CONSULTANT PLAY CONSUL STUDIO LUDO 1313 S 33rd St, Philadelphia, P, CONSULTANT	r, NY 10013 TANTS: Set LAND PLANNING ASSOCIATES, INC. treet, SH/ Floor A 19106 SET SET SUBJE 772 A 19106 SET STRUCTION CONSULTANTS STRUCTION CONSULTANTS STRUCTION CONSULTANTS STRUCTION CONSULTANTS STRUCTION CONSULTANTS STRUCTION CONSULTANTS TH Floor STRUCTION CONSULTANTS TH Floor STRUCTION CONSULTANTS TH Floor STRUCTION CONSULTANTS STRUCTION STRUCTION CONSULTANTS STRUCTION STRUCTION STRUCTION CONSULTANTS STRUCTION STRUCTION CONSULTANTS STRUCTION STRUCTION CONSULTANTS STRUCTION STRUCT
145 Huds New York SUB-CONSULT CIVIL/SURVEY ENGINEERING 219 Cuthbert S Philadelphia, P, MEP ENGINEE SRW 417 N 8th Stree Philadelphia, P, 267.585.2811 LIGHTING DES THE LIGHTING 600 CheSTESTIMA ELLANA CONS 32 Broadway, 8 New York, NY PLAYFUL LEAI Philadelphia, P, 267.468.8610 ARBORIST: MORRIS ARBORIST: MORRIS ARBORIST: MORRIS ARBORIST: MORRIS ARBORIST: MORRIS ARBORIST: MORRIS ANOTH Philadelphia, P, 215.247.5777 ACCESSIBILIT CHRIS NOEL christopher.noe 646.632.7344 PLAY CONSUL STUDIO LUDO 1313 S 33rd St, Philadelphia, P, 215.247.5777 ACCESSIBILIT CHRIS NOEL christopher.noe 646.632.7344 PLAY CONSUL STUDIO LUDO 1313 S 33rd St, Philadelphia, P, CONSULTANT CONSULTANT CONSULTANT PLAY CONSUL STUDIO LUDO 1313 C ST PHILADI	A, NY 10013 TANTS: TANT
145 Huds New York SUB-CONSUL CIVIL/SURVEY ENGINEERING 219 Cuthbert S Philadelphia, P, 207.585.2811 LIGHTING DES THE LIGHTING 600 CheSTESTIMA ELLANA CONS 32 Broadway, 8 New York, NY PLAYFUL LEAI Philadelphia, P, 267.468.8610 ARBORIST: MORRIS ARBORIST: MORRIS ARBORIST: MORRIS ARBORIST: MORRIS ARBORIST: MORRIS ARBORIST: MORRIS ARBORIST: MORRIS ASCIONA 215.247.5777 ACCESSIBILIT CHRIS NOEL christopher.noe 646.632.7344 PLAY CONSULTANT CONSULTANT CONSULTANT CONSULTANT PHILADIO LUDO 313 S 33rd St, Philadelphia, P, 215.247.5777 ACCESSIBILIT CHRIS NOEL christopher.noe 646.632.7344 PLAY CONSUL STUDIO LUDO 1313 S 33rd St, Philadelphia, P, CONSULTANT CONSULTANT CONSULTANT CONSULTANT	s, NY 10013 TANTS: ** LAND PLANNING ASSOCIATES, INC. treet, Shir Floor A 19108 ** ** A Suite 204 A 19123 ** ** PRACTICE *** ** TOP *** ** CONSULTANT: *** *** *** *** *** *** *** *
145 Huds New York SUB-CONSULT CIVIL/SURVEY ENGINEERING 219 Cuthert S Philadelphia, P, MEP ENGINEE SRW 417 N 8th Stree Philadelphia, P, 267.585.2811 LIGHTING DES THE LIGHTING OOC TESTIMA ELLANA CONS 32 Broadway, 8 New York, NY PLAYFUL LEAI Philadelphia, P, 267.468.8610 ARBORIST: MORRIS ARBC 100 East North Philadelphia, P, 267.468.8610 ARBORIST: MORRIS ARBC 100 East North Philadelphia, P, 215.247.5777 ACCESSIBILIT CHRIS NOEL christopher.noe 646.632.7344 PLAY CONSULTANT CONSULTANT CONSULTANT CONSULTANT PROJECT TITL PPR PROJECT PROJECT TITL PROJECT TITL	TANTS: TANTS: TANTS: TANTS: TANTS: TANTS: TRUE LAND PLANNING ASSOCIATES, INC. Tree, Status 772 A 19106 SR: at Suite 204 A 19123 SRING 204 SRING 204 SRING 204 SRING 204 STRUCTOR CONSULTANTS: STRUCTOR STRUCTOR STRUCTOR STRUCTOR STRUCTOR STRUCTOR STRUCTOR STRUC
145 Huds New York SUB-CONSULT CIVIL/SURVEY ENGINEERING 219 Cuthert S Philadelphia, P, MEP ENGINEE SRW 417 N 8th Stree Philadelphia, P, 267.585.2811 LIGHTING DES THE LIGHTING OOC TESTIMA ELLANA CONS 32 Broadway, 8 New York, NY PLAYFUL LEAI Philadelphia, P, 267.468.8610 ARBORIST: MORRIS ARBC 100 East North Philadelphia, P, 267.468.8610 ARBORIST: MORRIS ARBC 100 East North Philadelphia, P, 215.247.5777 ACCESSIBILIT CHRIS NOEL christopher.noe 646.632.7344 PLAY CONSULTANT CONSULTANT CONSULTANT CONSULTANT PROJECT TITL PPR PROJECT PROJECT TITL PROJECT TITL	A 1910 TANTS: (* A LAND PLANNING ASSOCIATES, INC. tract, Still Floor A 19106 SR. It Suite 204 A 19102 SIGN: SPRACTICE SPRA
145 Huds New York SUB-CONSULT CIVIL/SURVEY ENGINEERING 219 Cuthbert S Philadelphia, P, MEP ENGINEE SRW 417 N 8th Stree Philadelphia, P, 267.585.2811 LIGHTING DES THE LIGHTING 600 CheSTINA ELLANA CONS 32 Broadway, 8 New York, NY PLAYFUL LEAI Philadelphia, P, 267.468.8610 ARBORIST: MORRIS ARBC 100 East Northy Philadelphia, P, CONSULTANT CONSULTANT PROJECT TITL PPR PROJECT PROJECT TITL PROJECT TITL PROJECT TITL	A NY 10013 TANTS: TANTS: TANTS: TRUCTION CONSULTANTS TRUCTION TRUMER TOT TANT: UNIT A TISTIC TRUCTION TRU
145 Huds New York SUB-CONSULT CIVIL/SURVEY ENGINEERING 219 Cuthbert S Philadelphia, P, MEP ENGINEE SRW 417 N 8th Stree Philadelphia, P, 267.585.2811 LIGHTING DES THE LIGHTING DES TOD EAST NOTH Philadelphia, P, 267.468.8610 ARBORIST: MORRIS ARBC 100 East North Philadelphia, P, 27.468.8610 ARBORIST: MORRIS ARBC 100 East North Philadelphia, P, 27.468.8610 ARBORIST: MORRIS ARBC 100 East North Philadelphia, P, 27.468.8610 ARBORIST: MORRIS ARBC 100 East North Philadelphia, P, 27.468.8610 ARBORIST: MORRIS ARBC 100 East North Philadelphia, P, 27.47.47.47.47.47.47.47.47.47.47.47.47.47	A NY 10013 TANTS: TANTS: TANTS: TANTS: TRUE CAUSE CANNON CASSOCIATES, INC. Treet, SMF FLOR A 19108 TOR: TRUE CAUSE CANNON CASSOCIATES, INC. TRUE CAUSE CASSOCIATES, INC. TRUE CASSOCIA
145 Huds New York SUB-CONSUL CIVIL/SURVEY ENGINEERING 219 Cuthbert S Philadelphia, P, MEP ENGINEE SRW 417 N 8th Stree Philadelphia, P, 267.585.2811 LIGHTING DES THE LIGHTING 600 Chestnut S Philadelphia, P, COST ESTIMA ELLANA CONS 32 Broadway, 8 New York, NY PLAYFUL LEAI Philadelphia, P, 267.468.8610 ARBORIST: MORRIS ARBOR 100 East North Philadelphia, P, 267.468.8610 ARBORIST: MORRIS ARBOR 100 East North Philadelphia, P, 267.468.8610 ARBORIST: MORRIS ARBOR 100 East North Philadelphia, P, 215.247.5777 ACCESSIBILIT CONSULTANT CONSULTANT CONSULTANT PPR PROJECT PROJECT TITL PPR PROJECT IT PROJECT TITL DATE: SCALE:	A NY 10013 TANTS: TANTS: State of the second

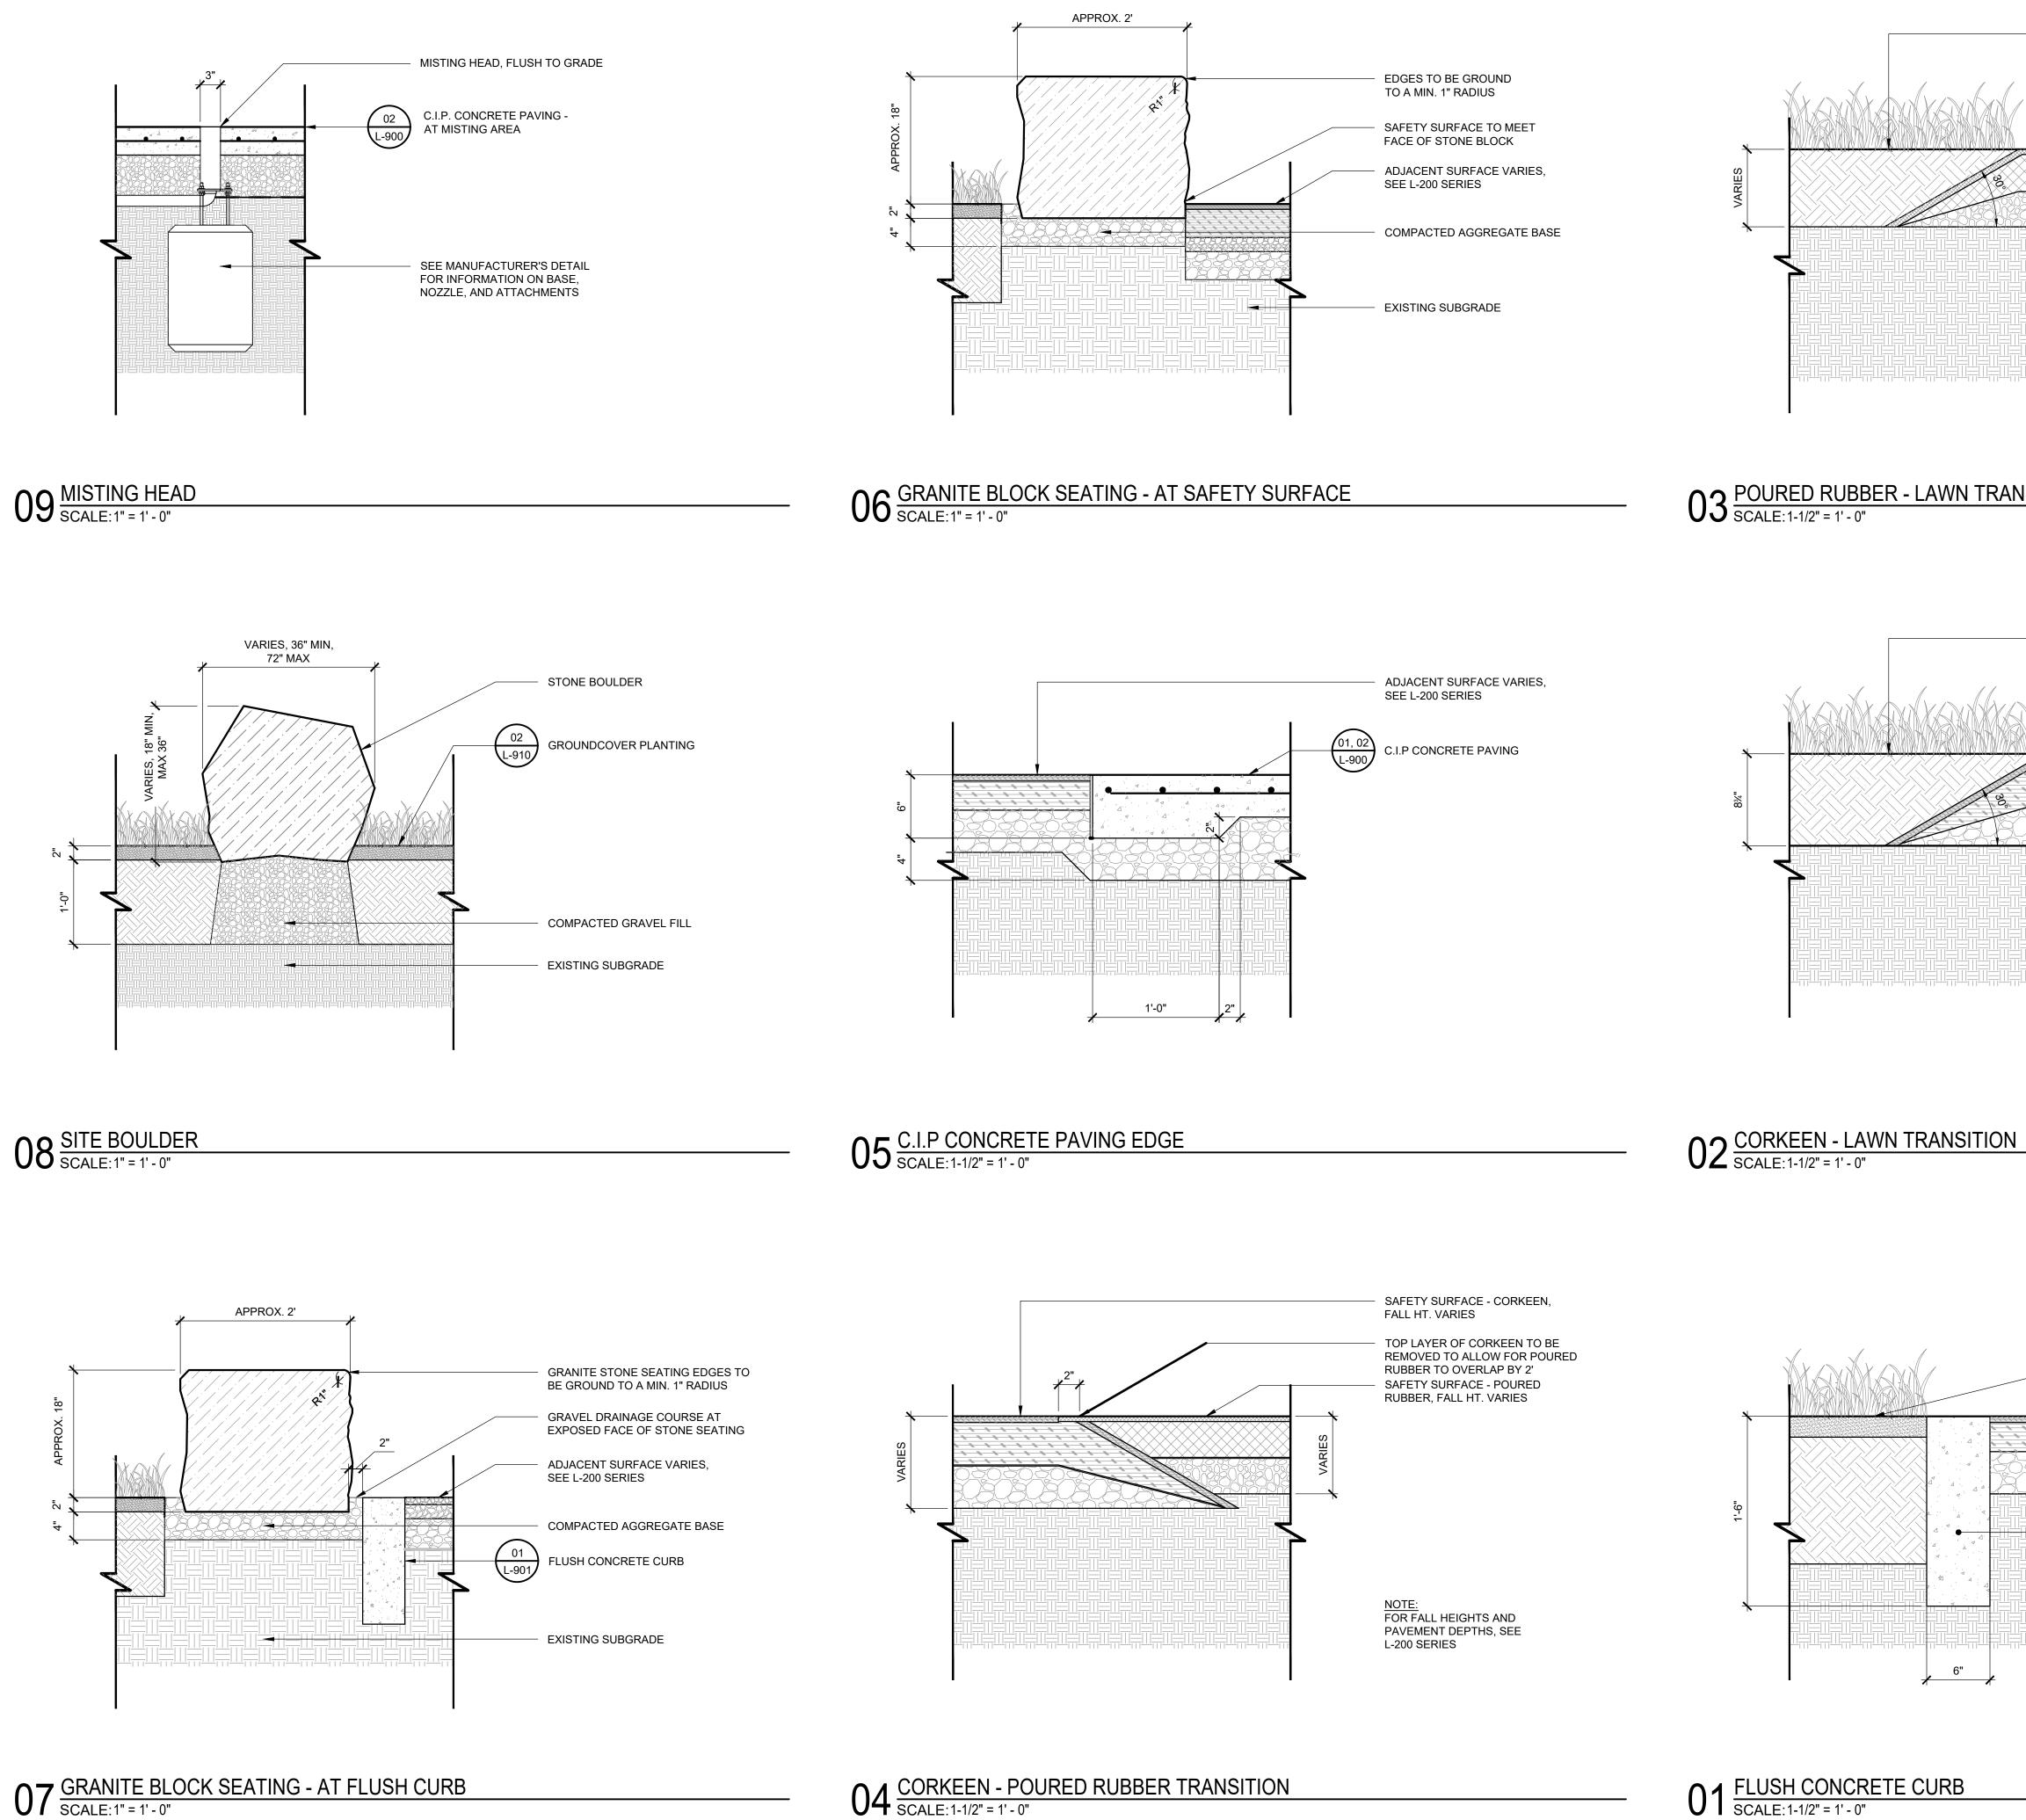

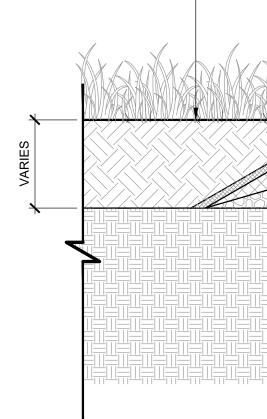

03 POURED RUBBER - LAWN TRANSITION SCALE: 1-1/2" = 1' - 0"

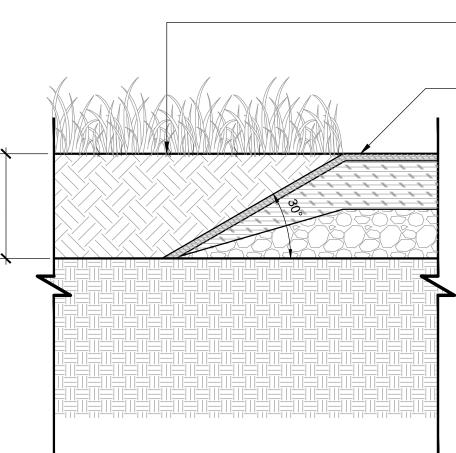

 $04 \frac{\text{CORKEEN - POURED RUBBER TRANSITION}}{\text{SCALE: 1-1/2"} = 1' - 0"}$

01 FLUSH CONCRETE CURB SCALE: 1-1/2" = 1' - 0"

EXISTING LAWN

EXISTING LAWN


SAFETY SURFACE - POURED

RUBBER, FALL HT. VARIES

NOTE: FOR FALL HEIGHTS AND PAVEMENT DEPTHS, SEE


L-200 SERIES


SAFETY SURFACE - CORKEEN, 8' FALL HT. L-900

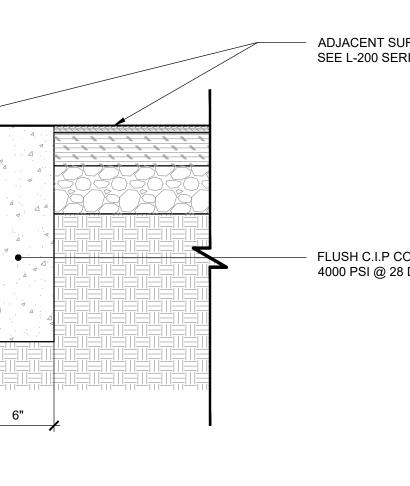


ADJACENT SURFACE VARIES, SEE L-200 SERIES


FLUSH C.I.P CONCRETE CURB, 4000 PSI @ 28 DAYS

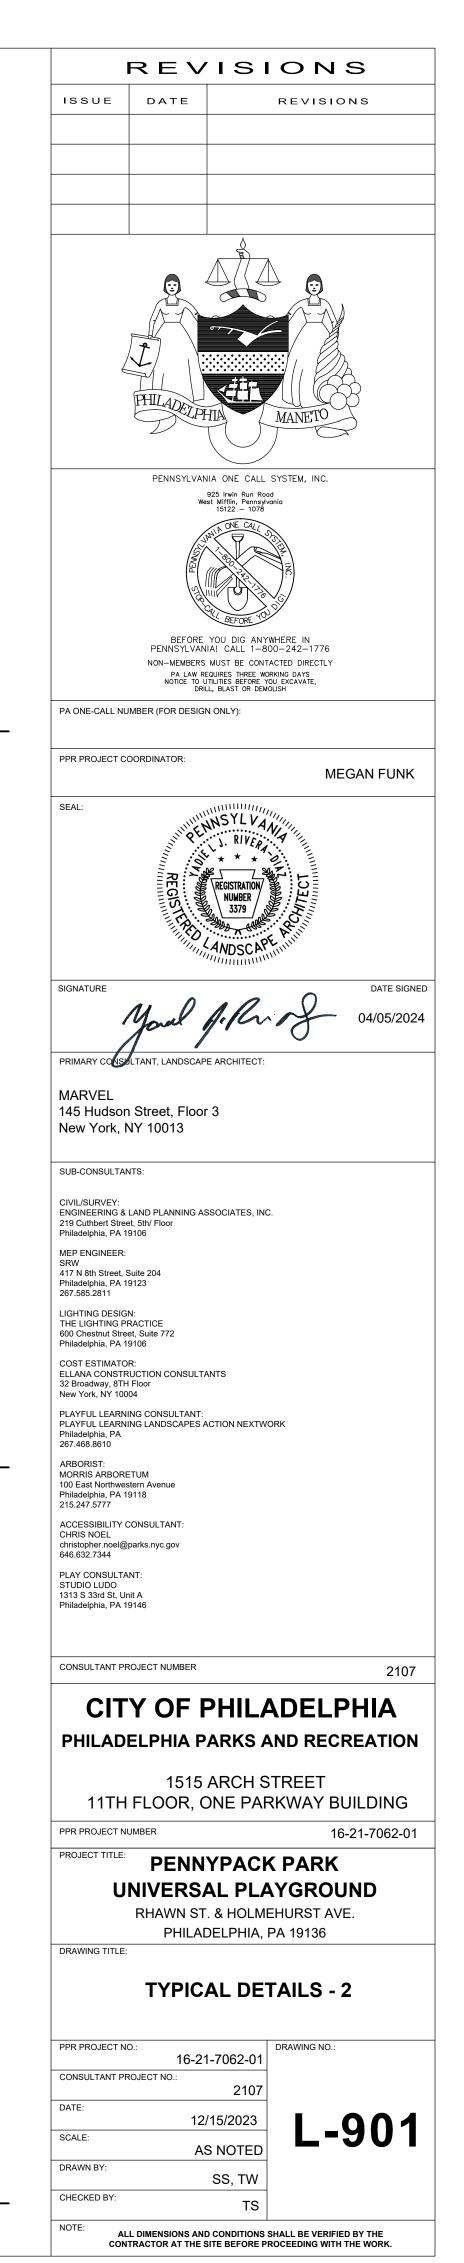


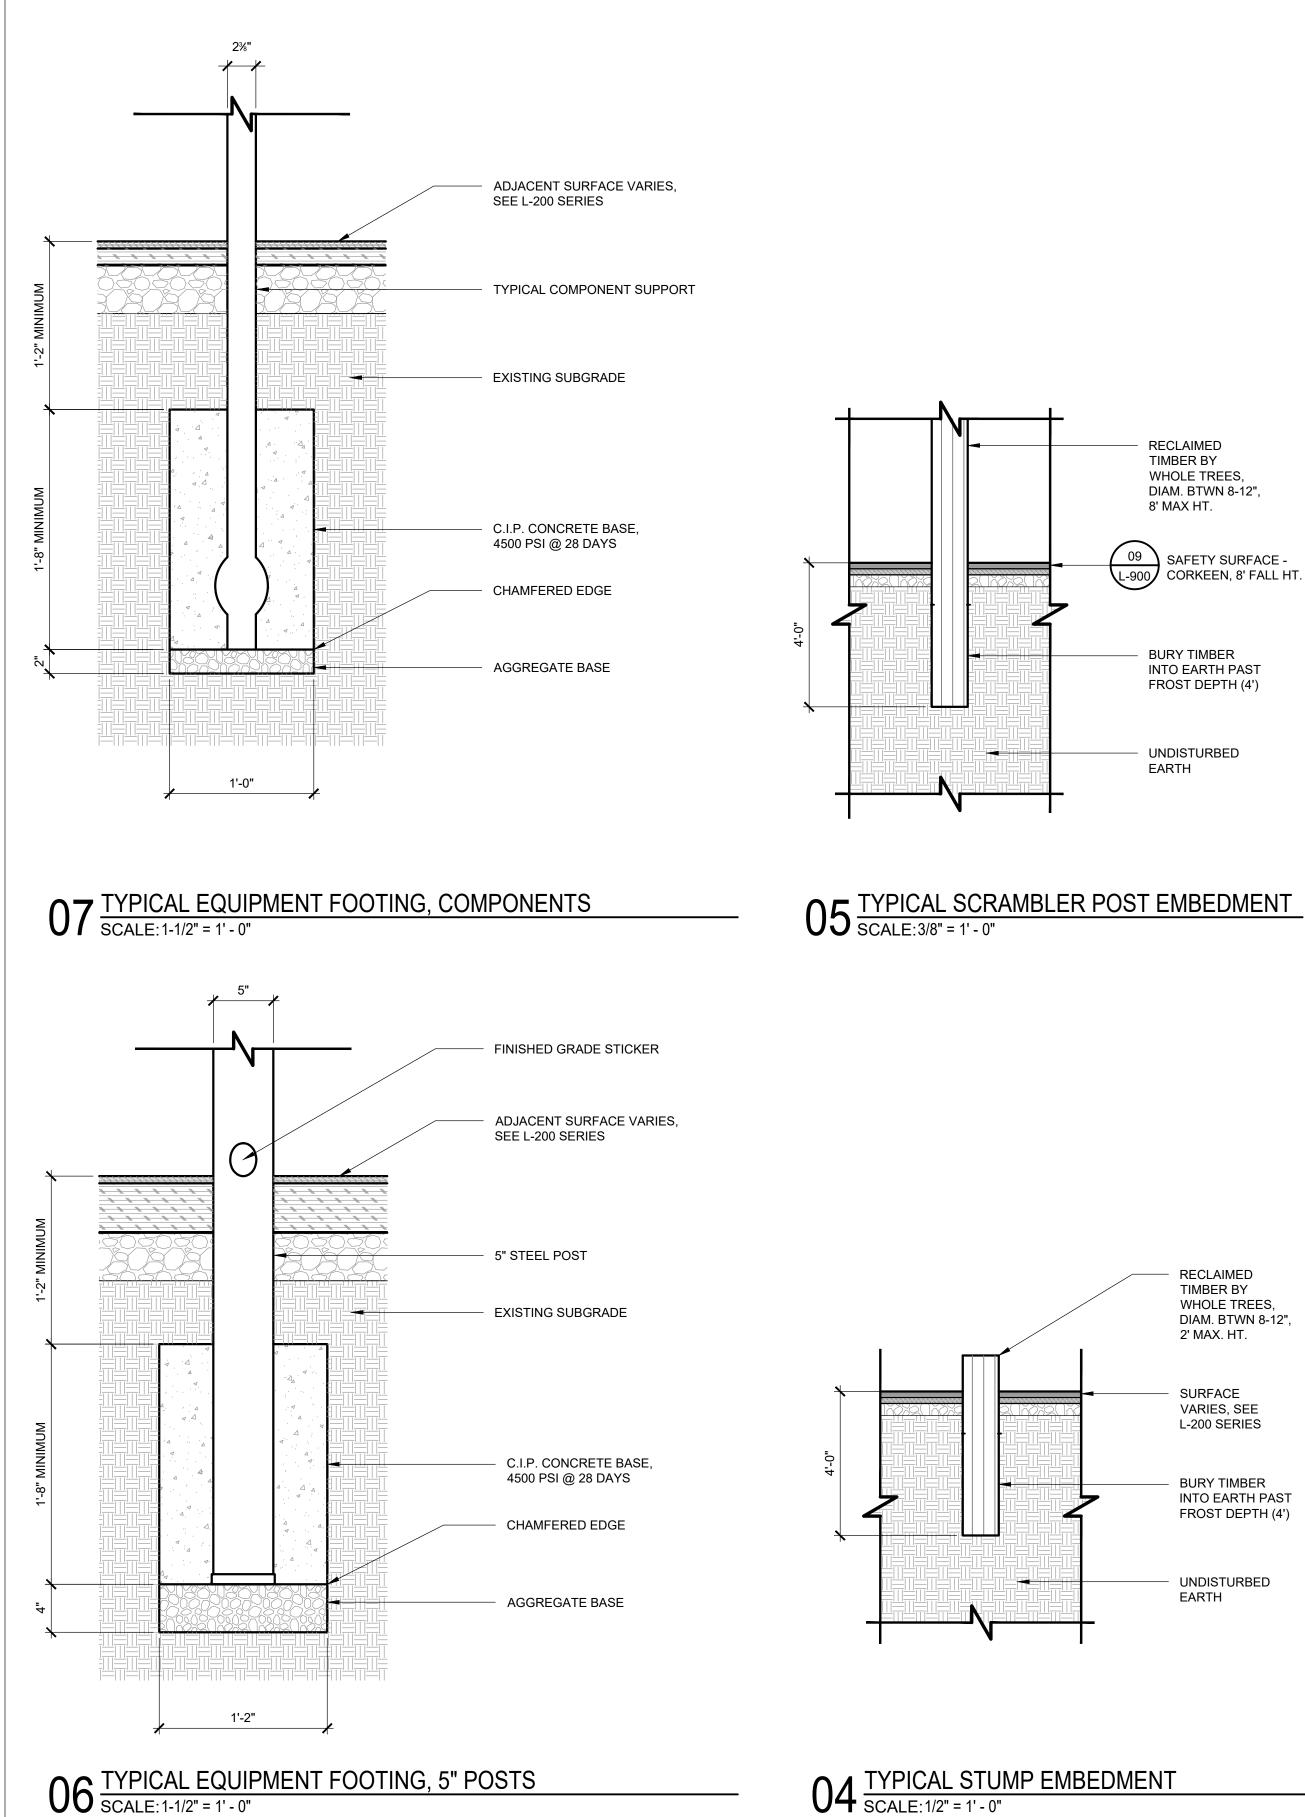


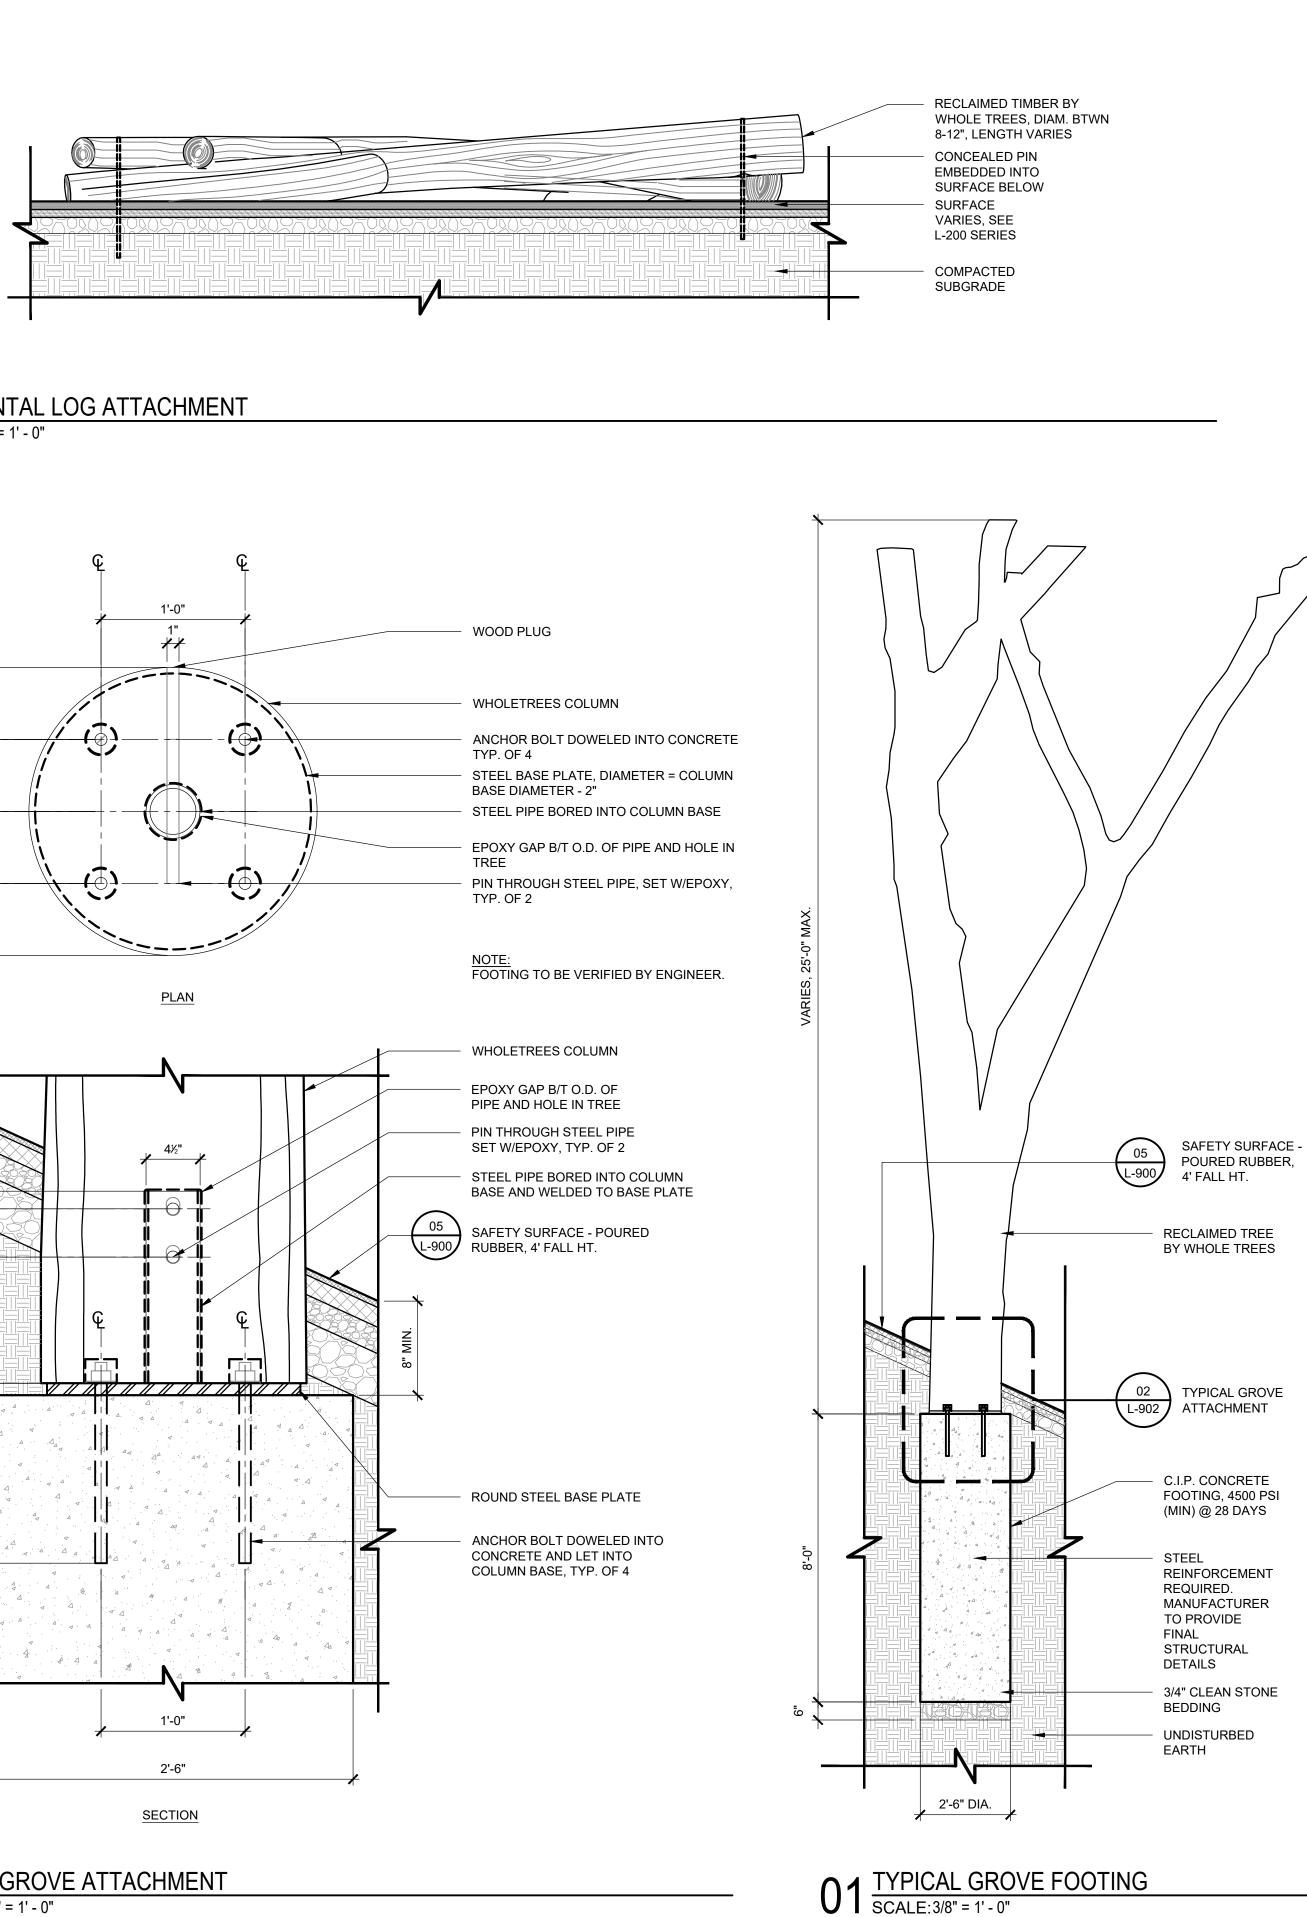


03 HORIZONTAL LOG ATTACHMENT SCALE: 1/2" = 1' - 0"

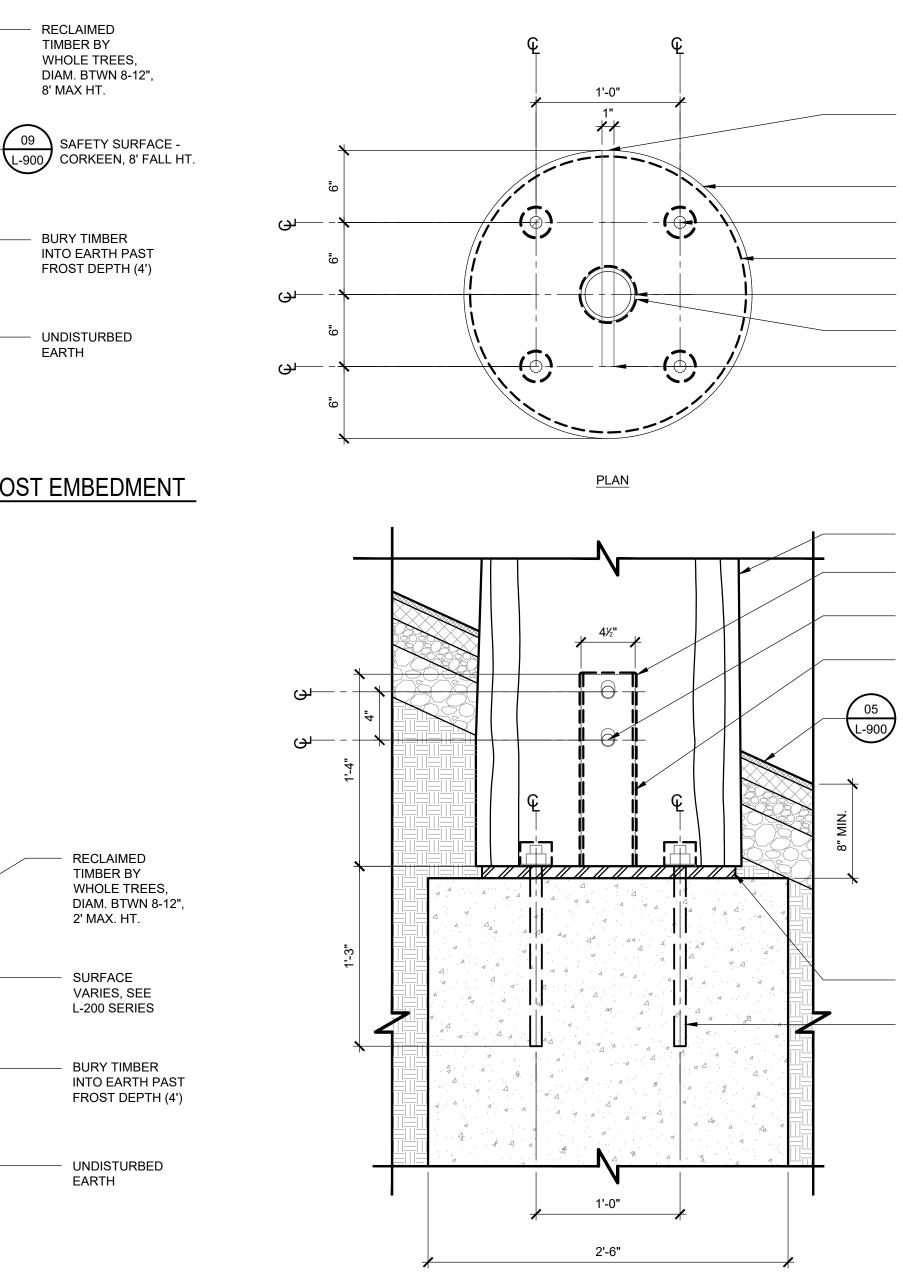


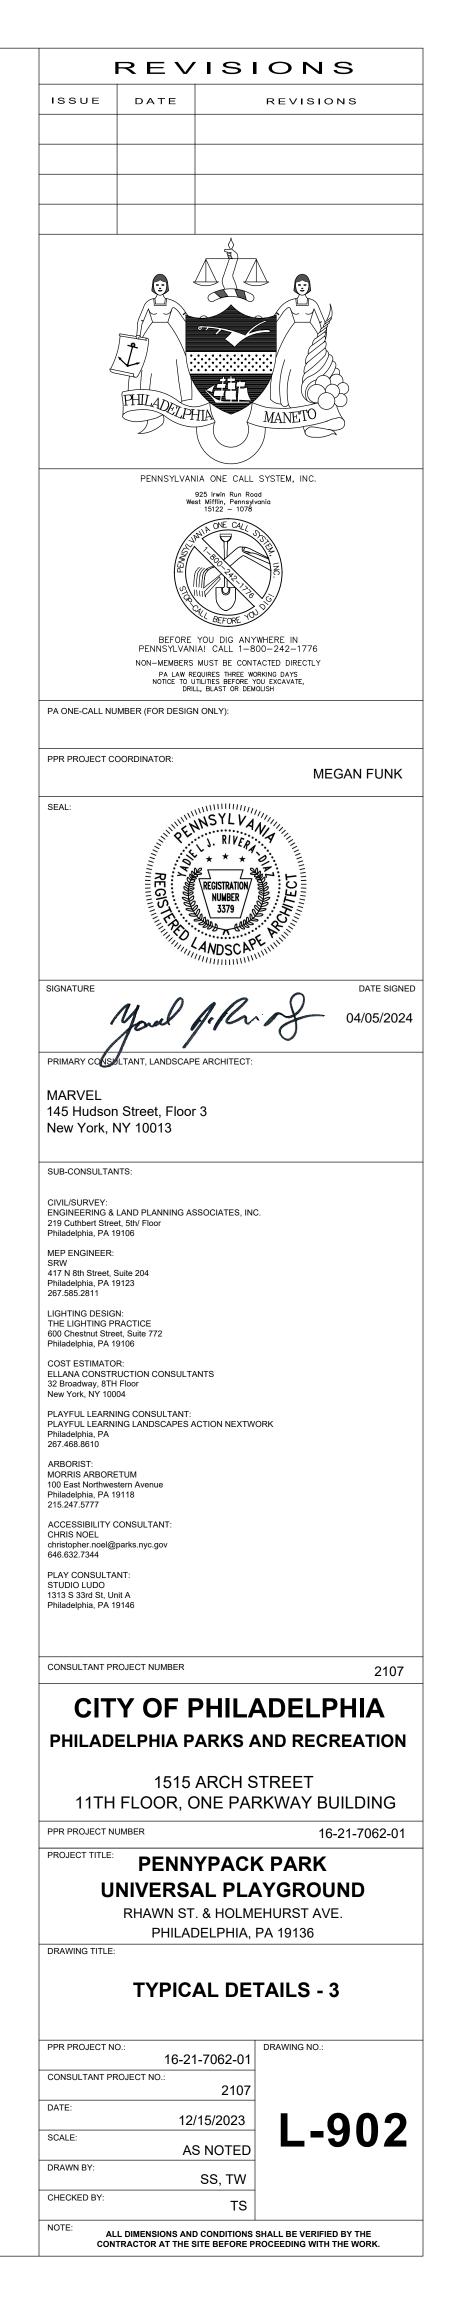


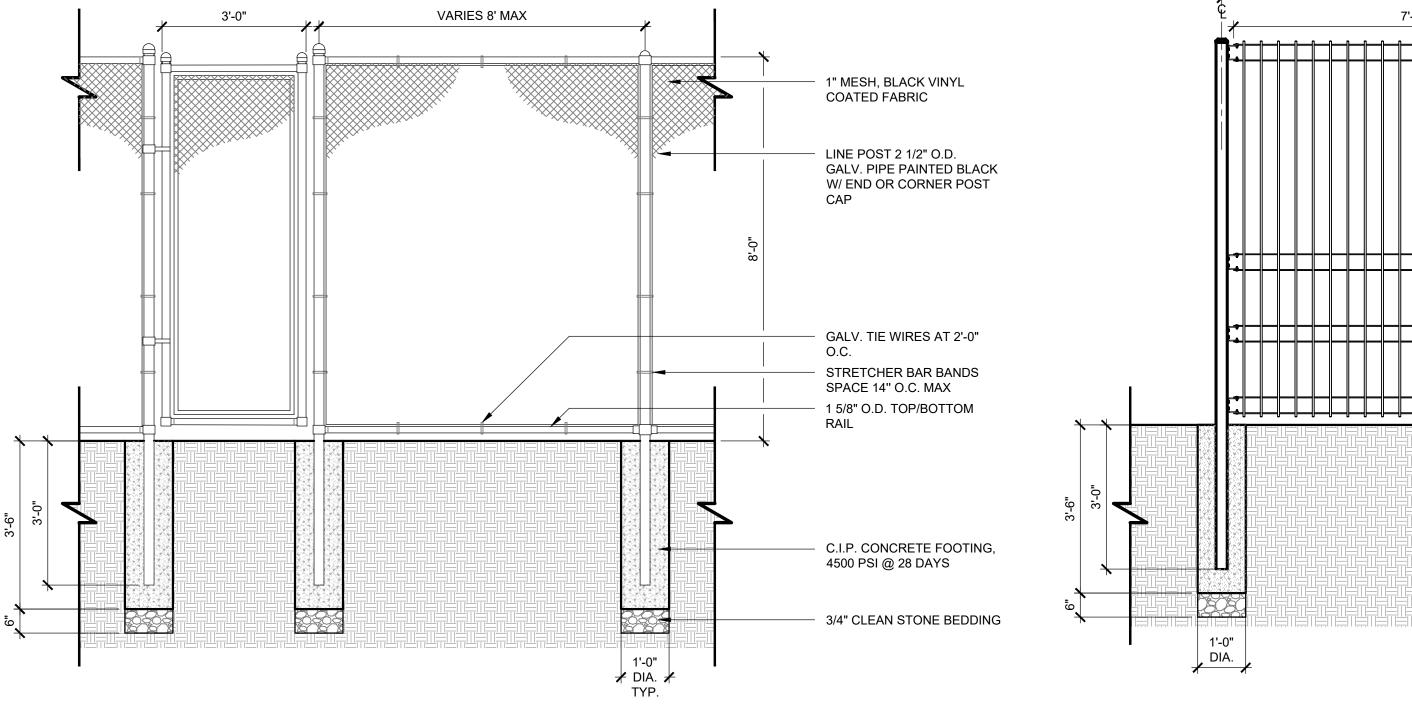





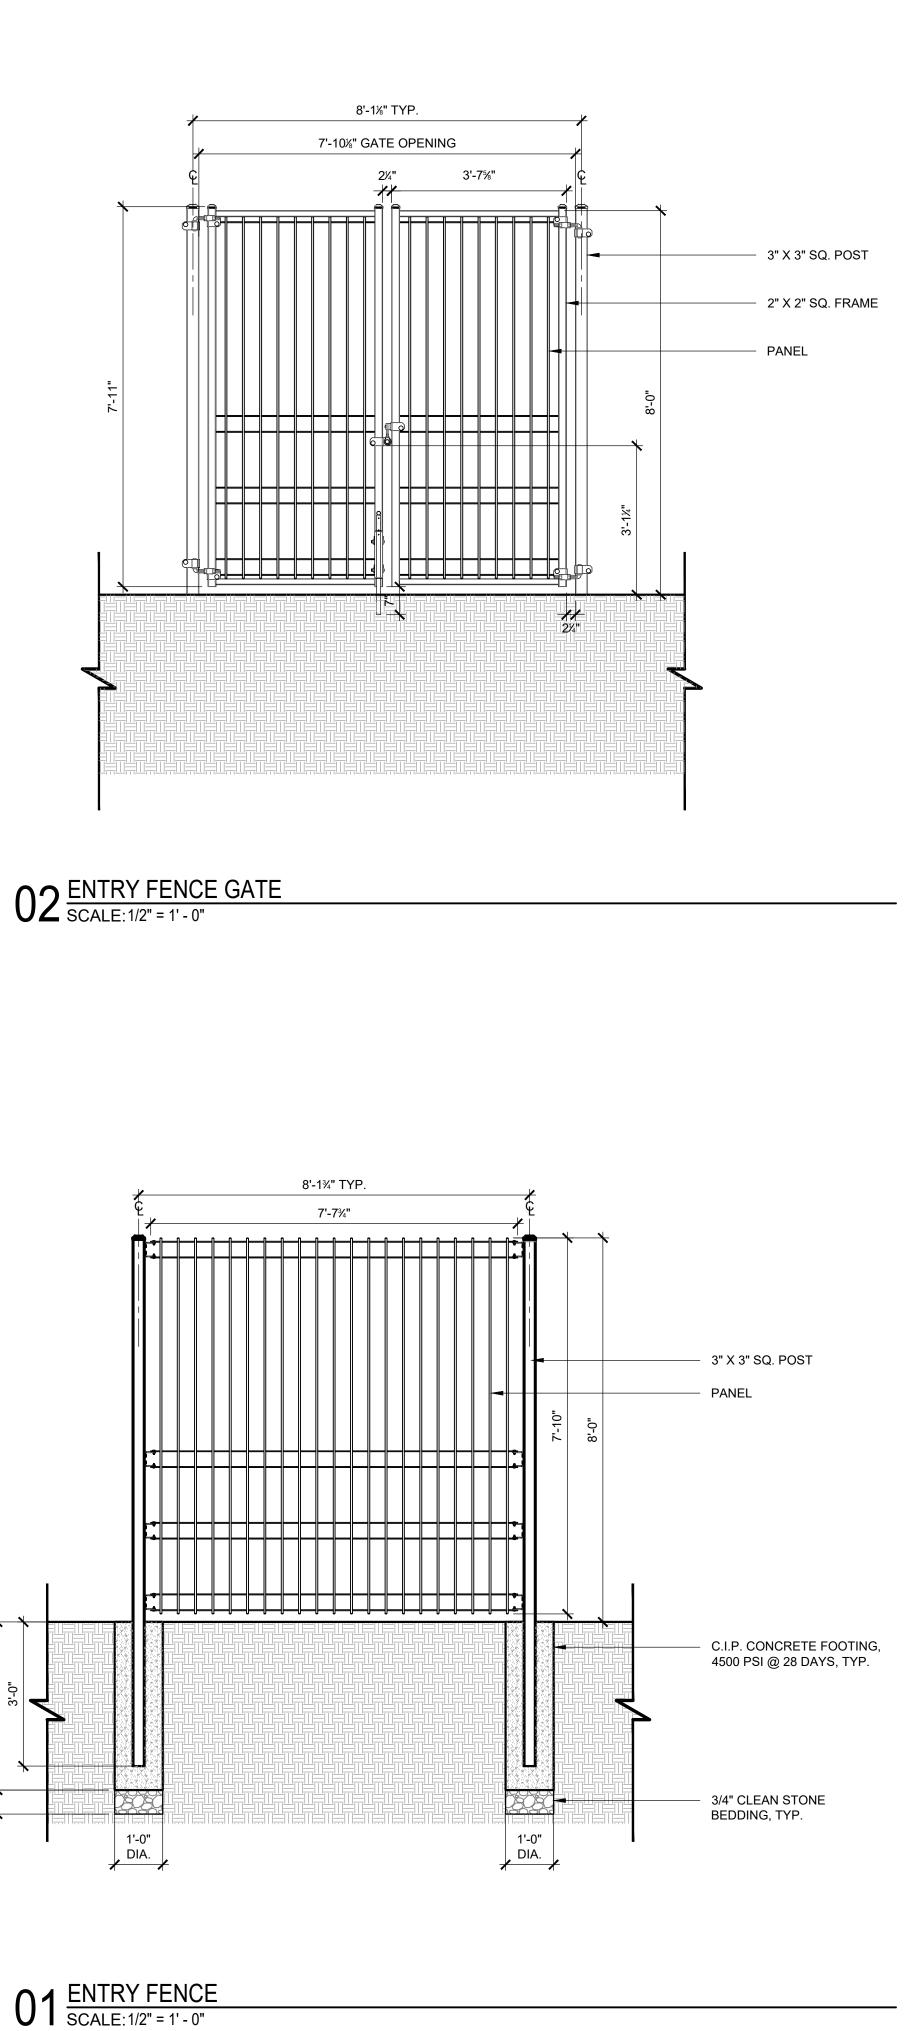

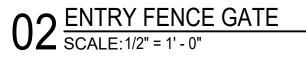


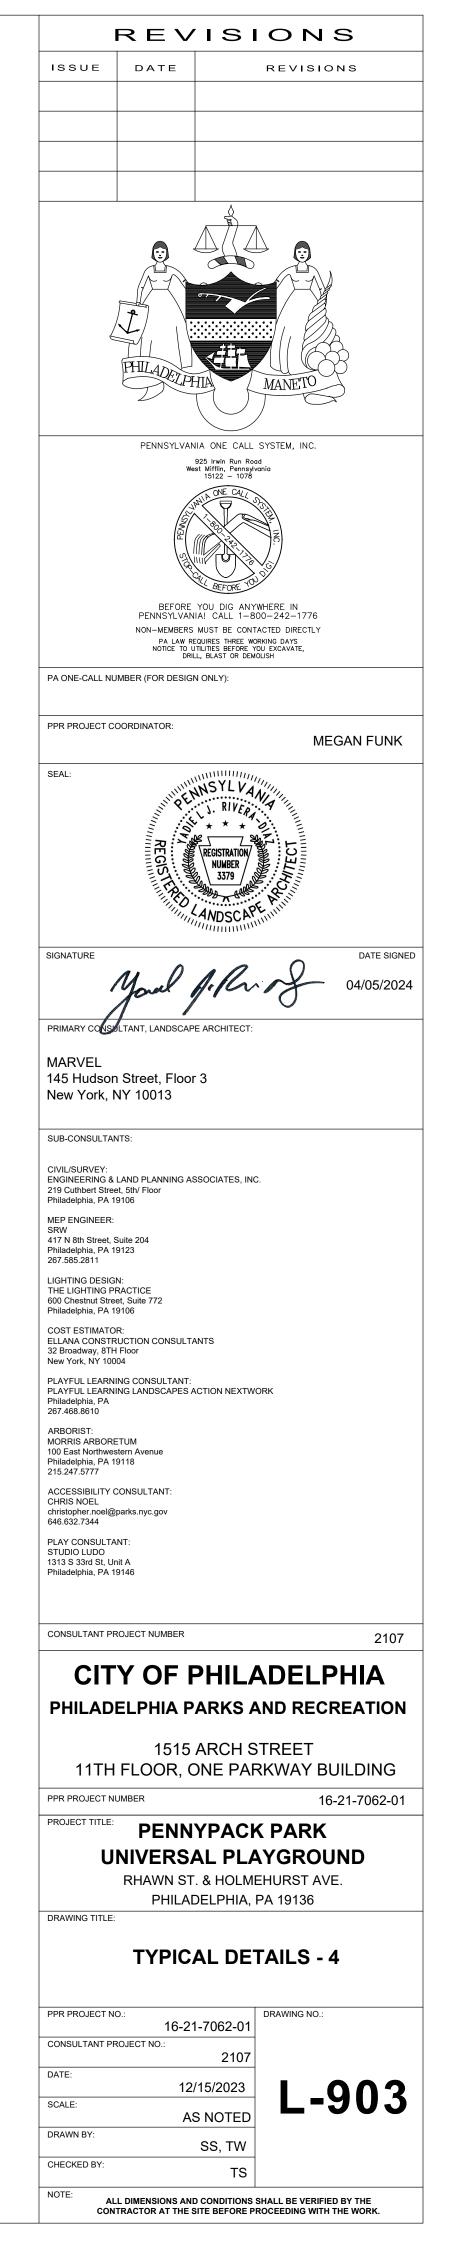


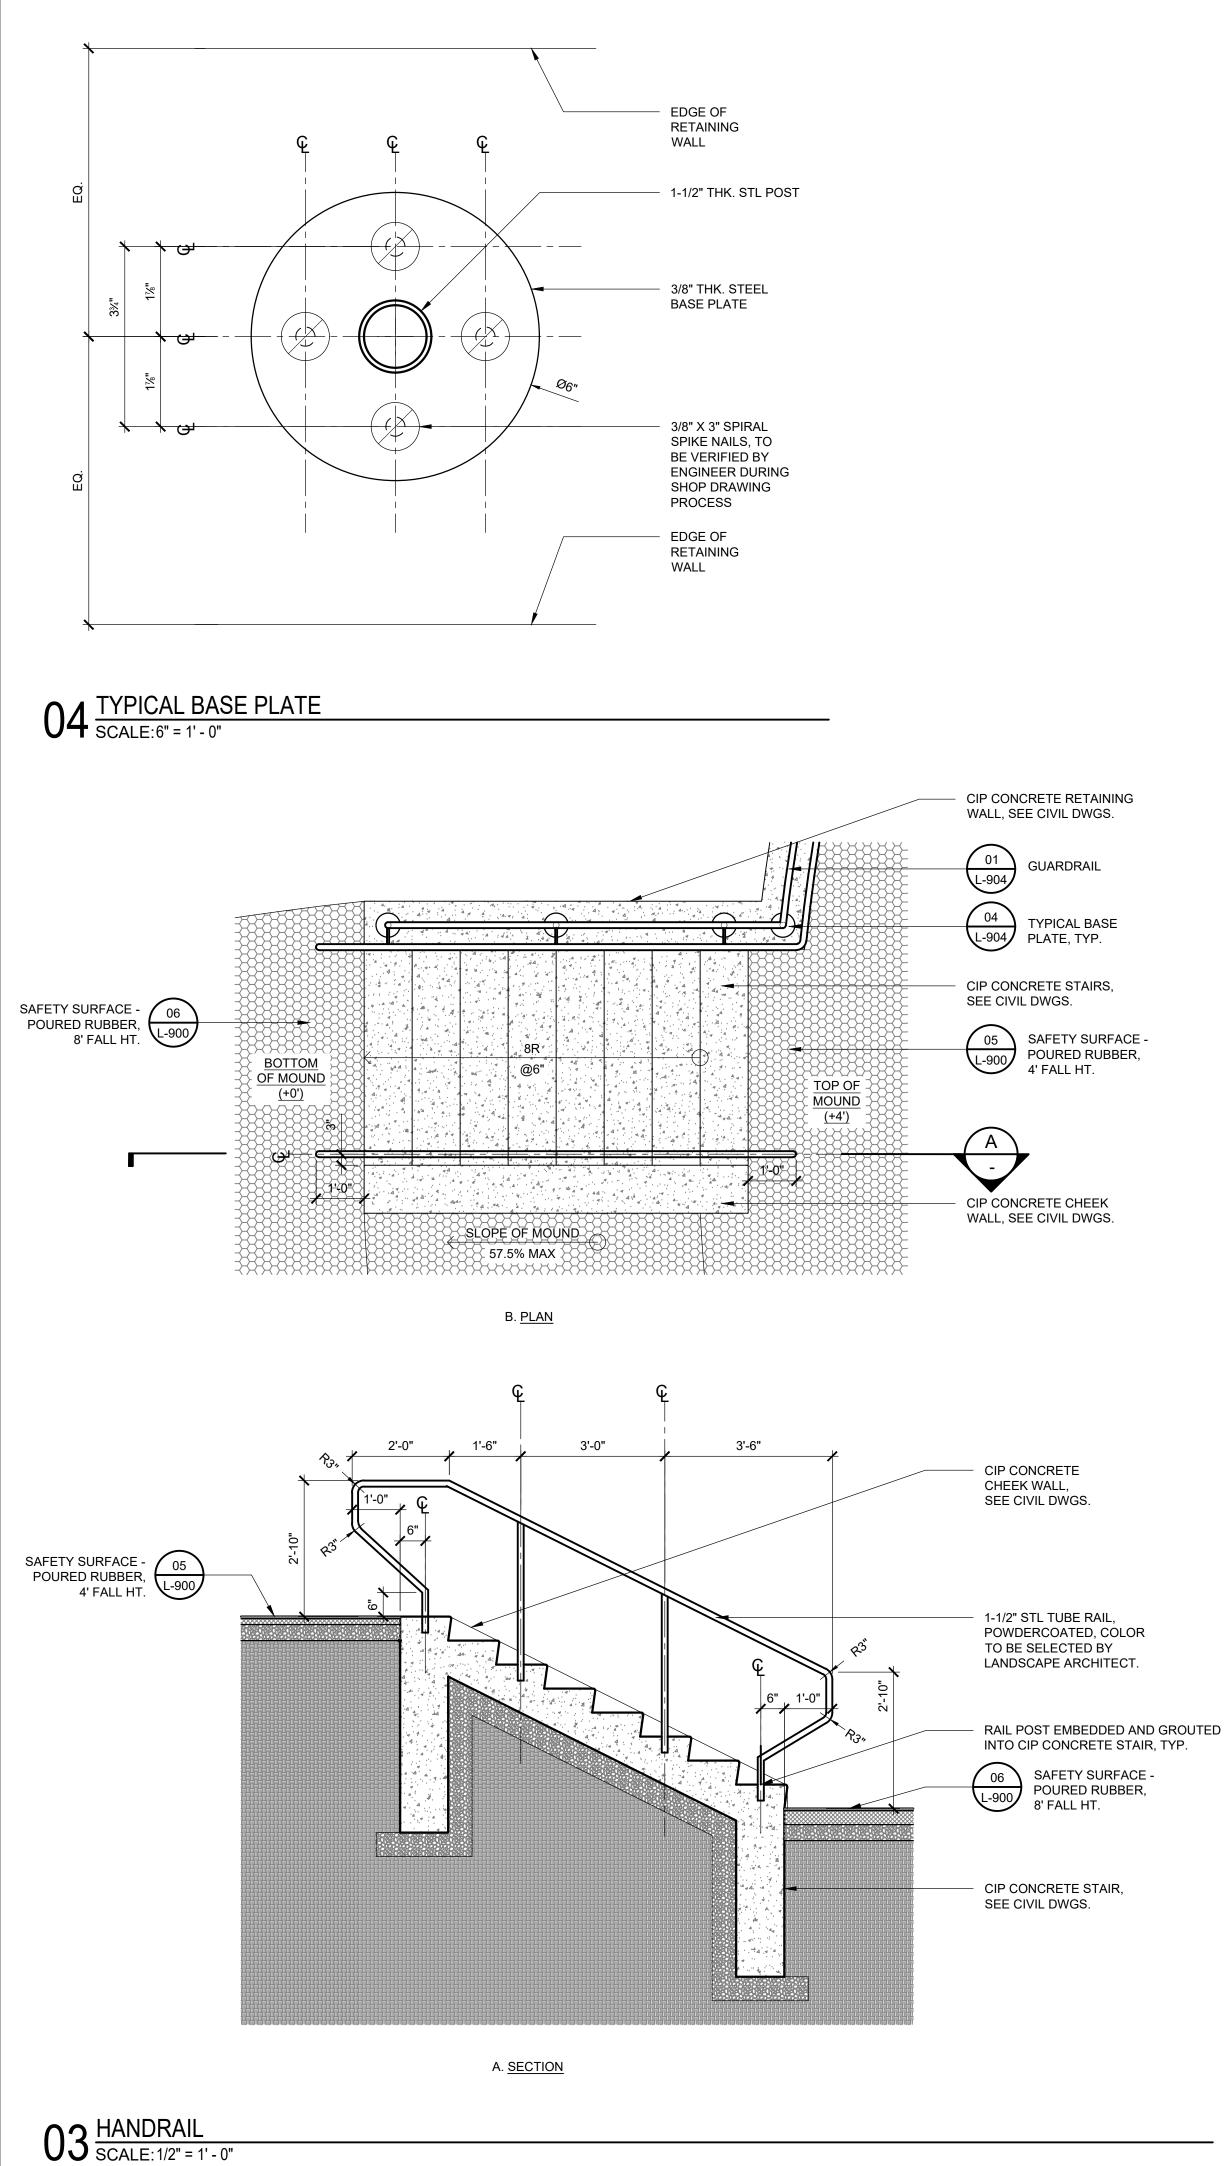


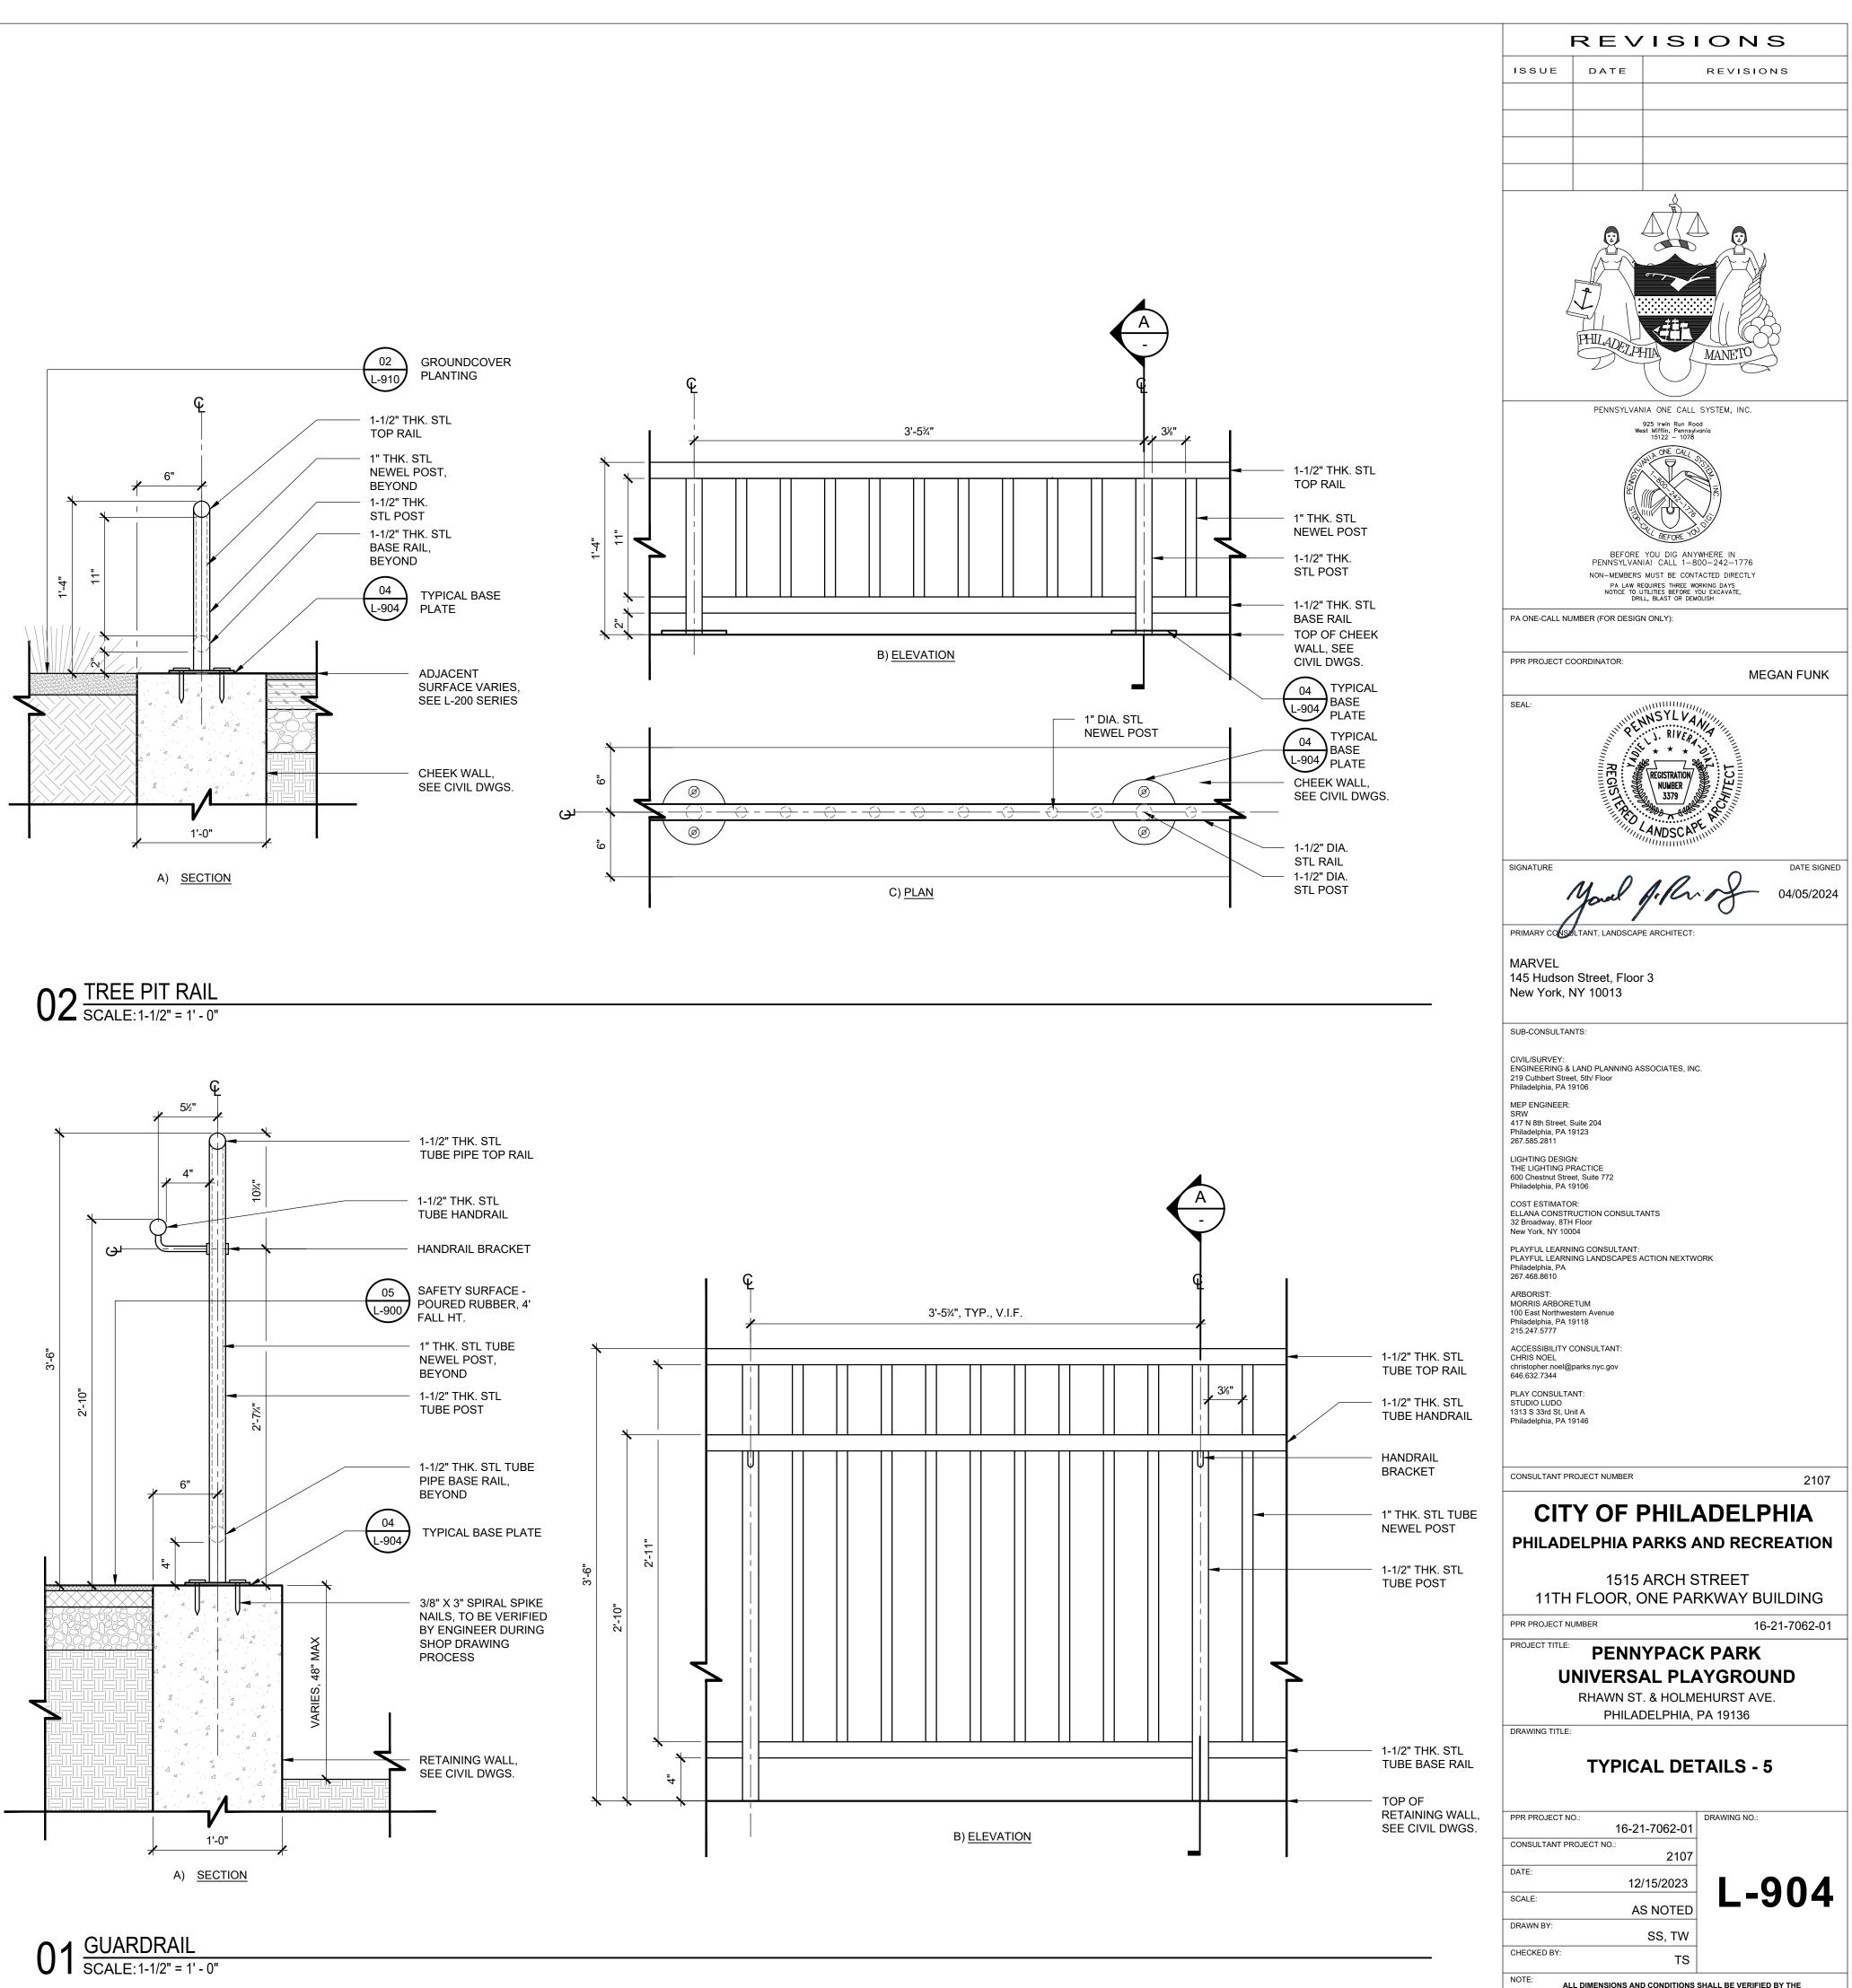


CONTRACTOR AT THE SITE BEFORE PROCEEDING WITH THE WORK.

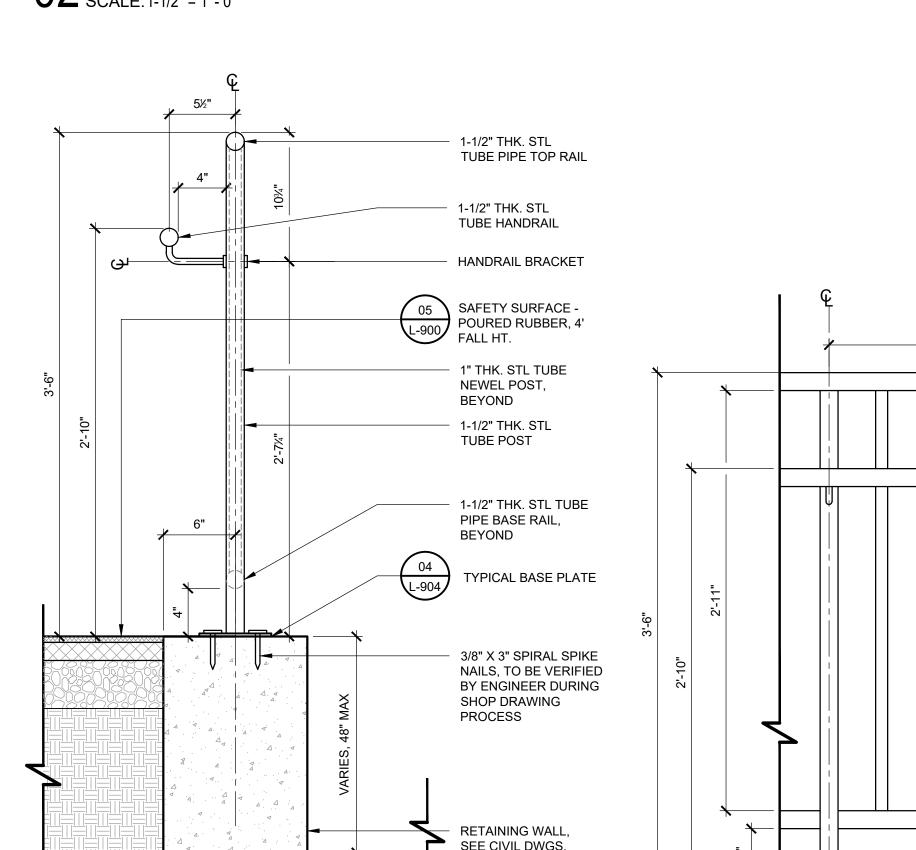

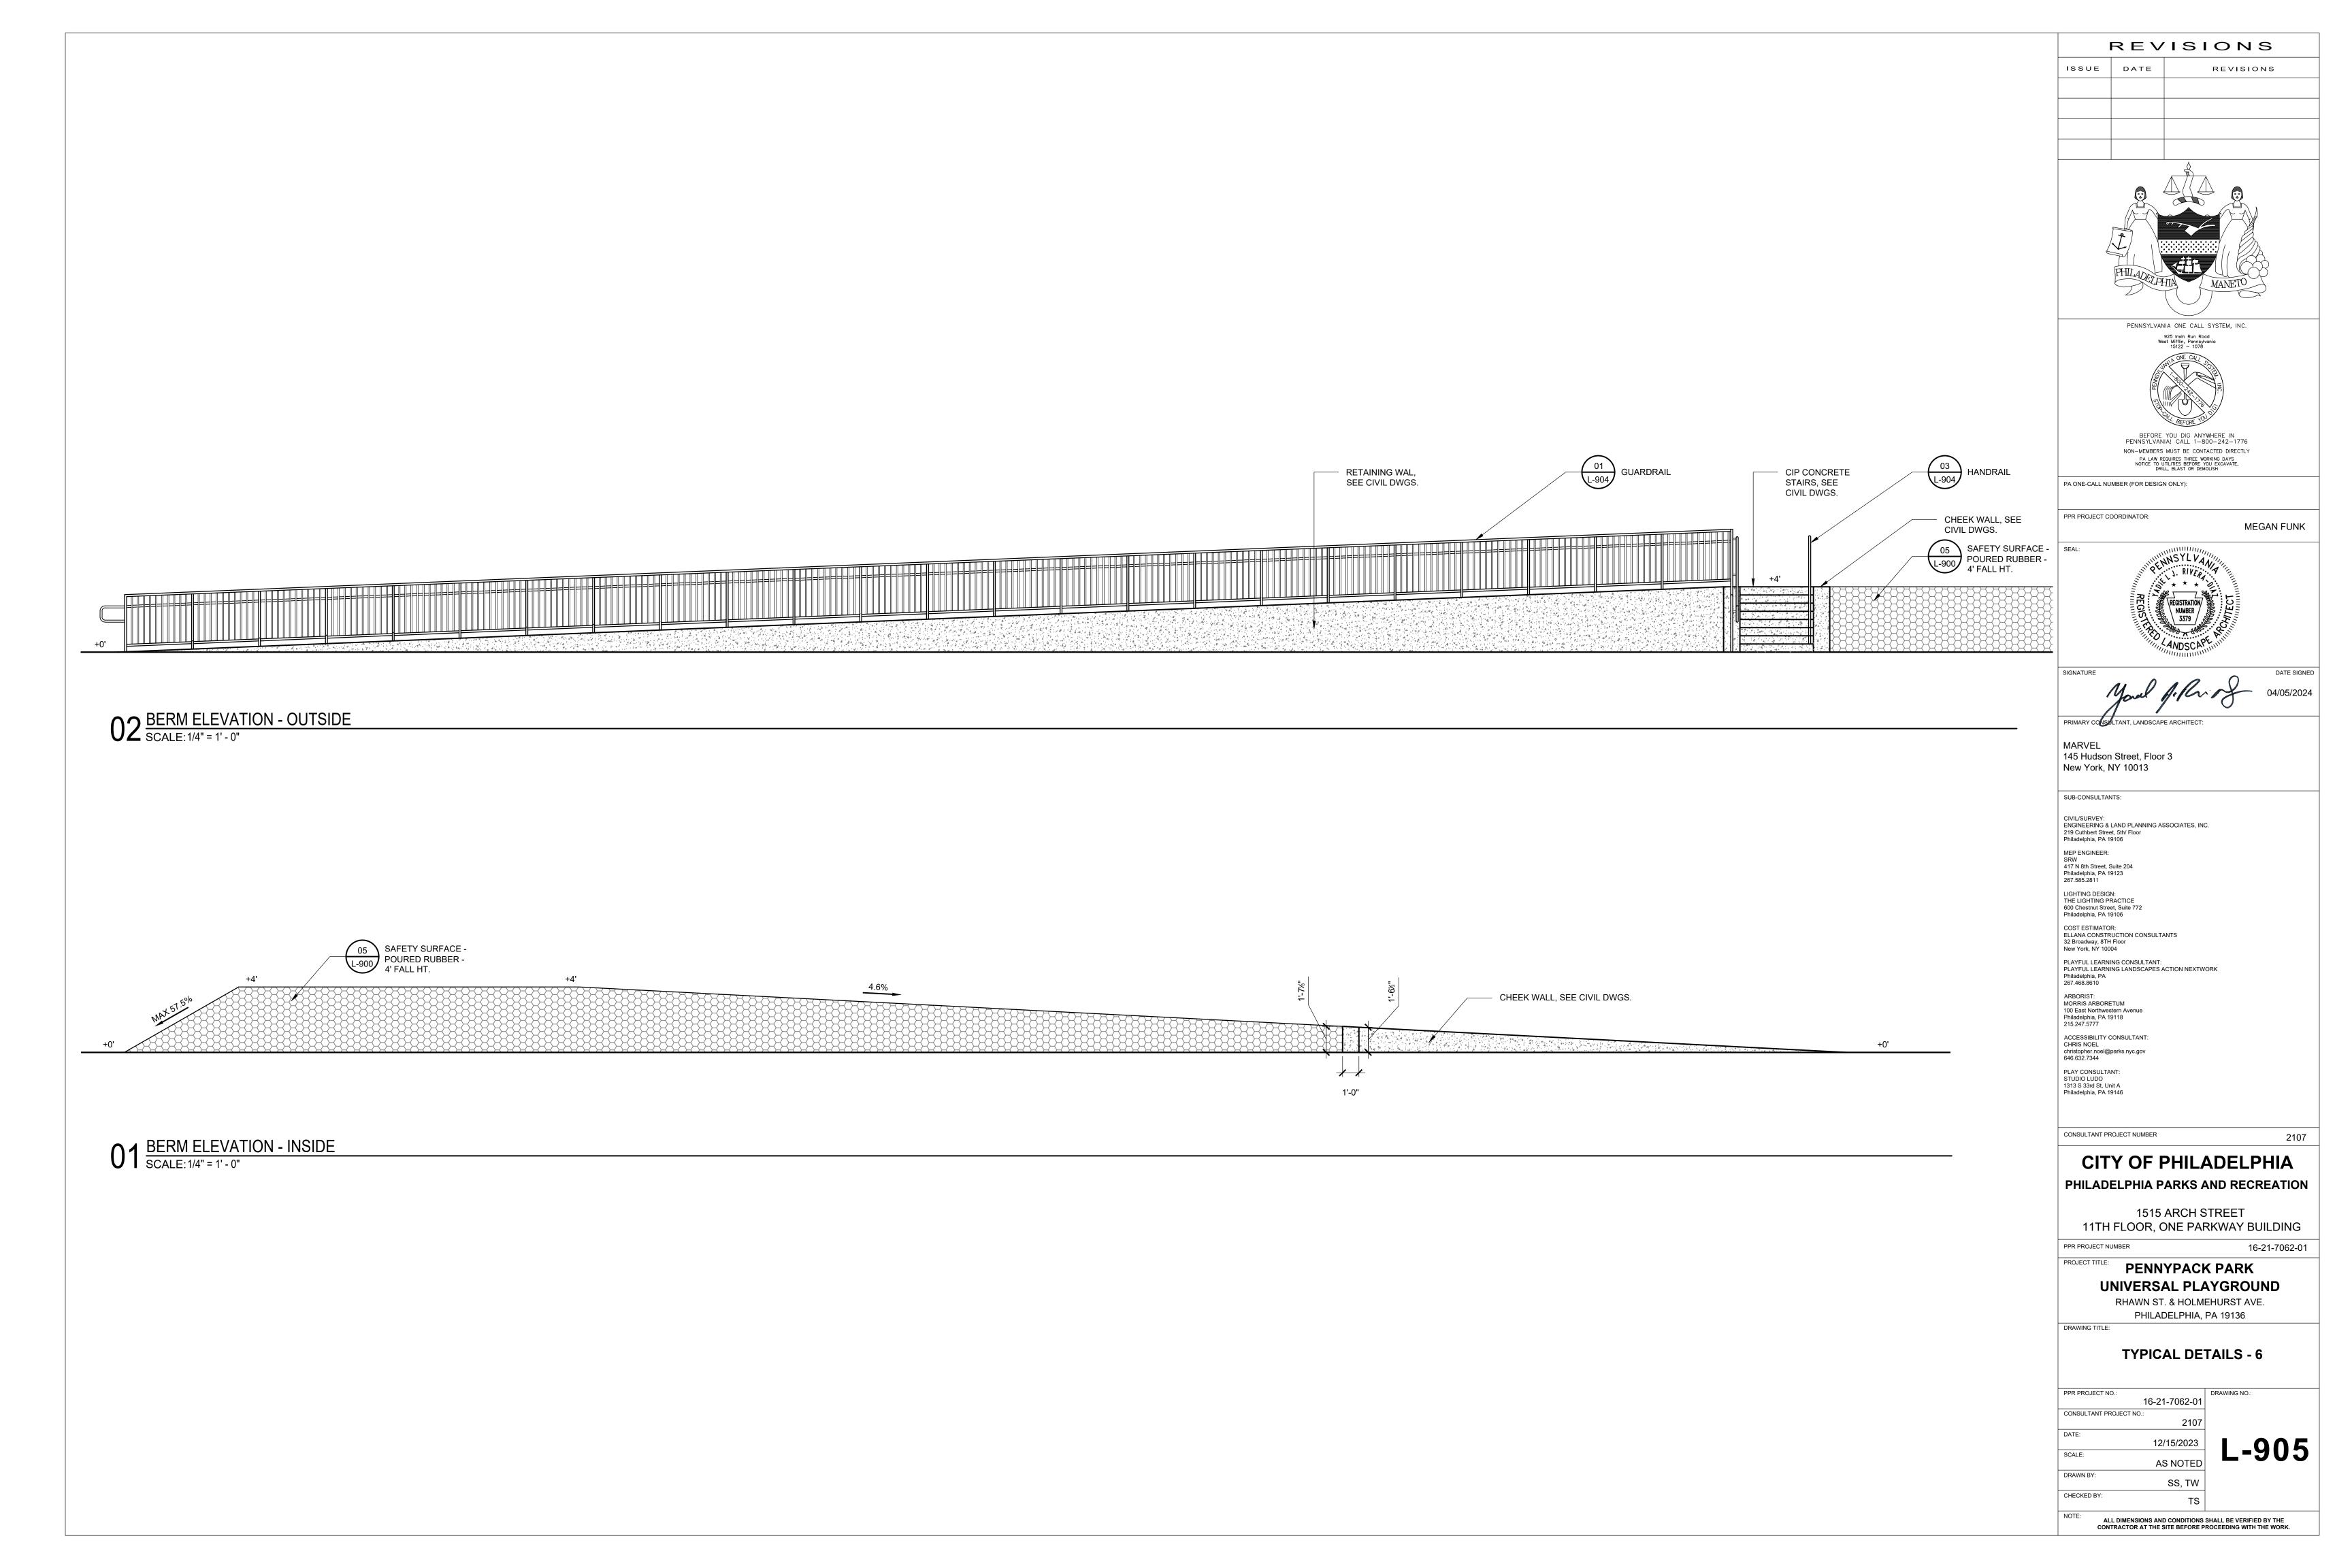


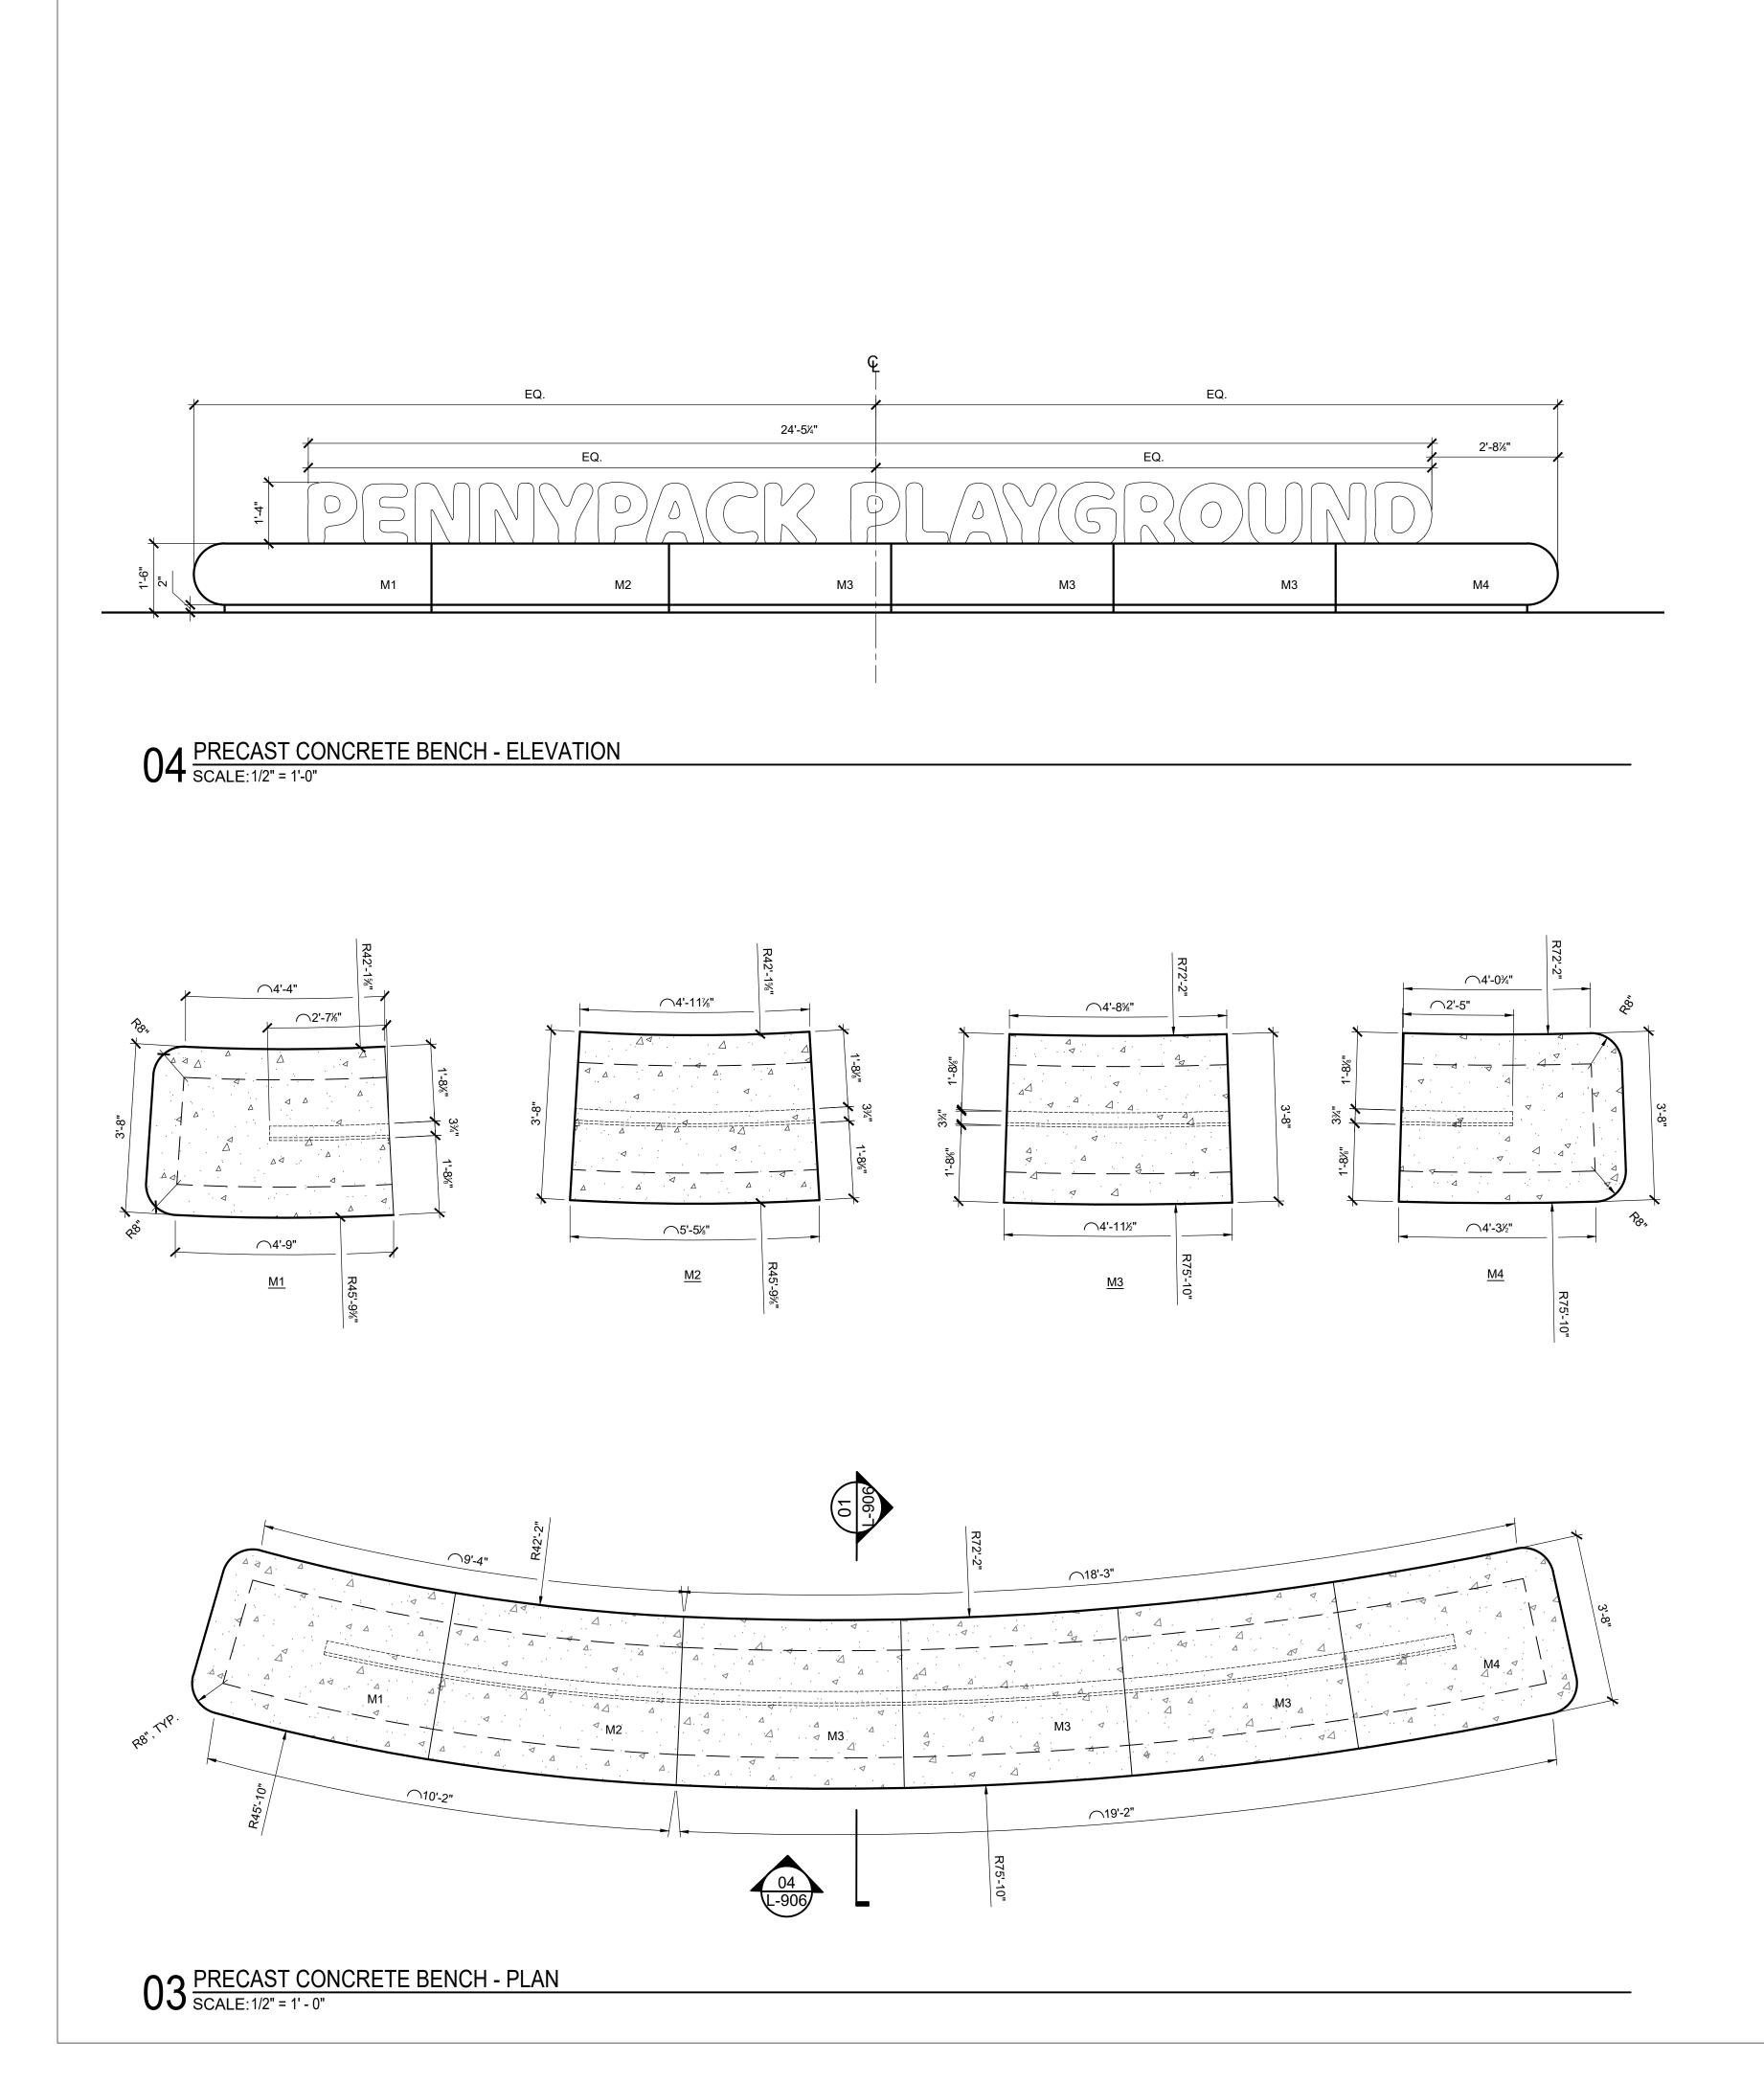




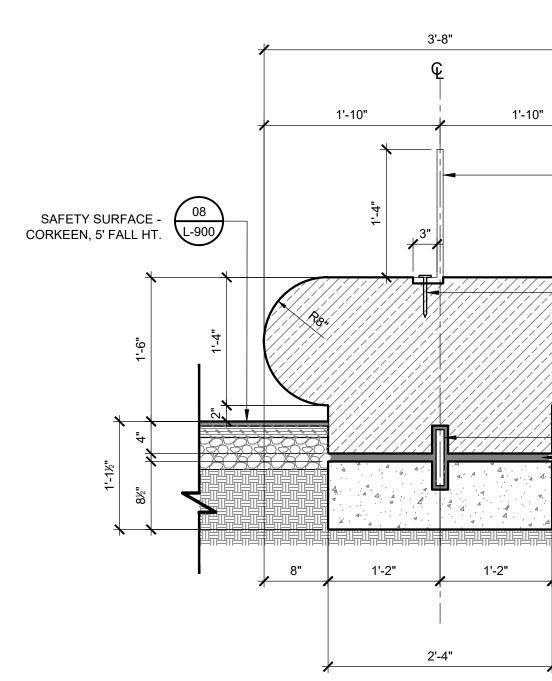



01 PRECAST CONCRETE BENCH - SECTION SCALE: 1" = 1' - 0"

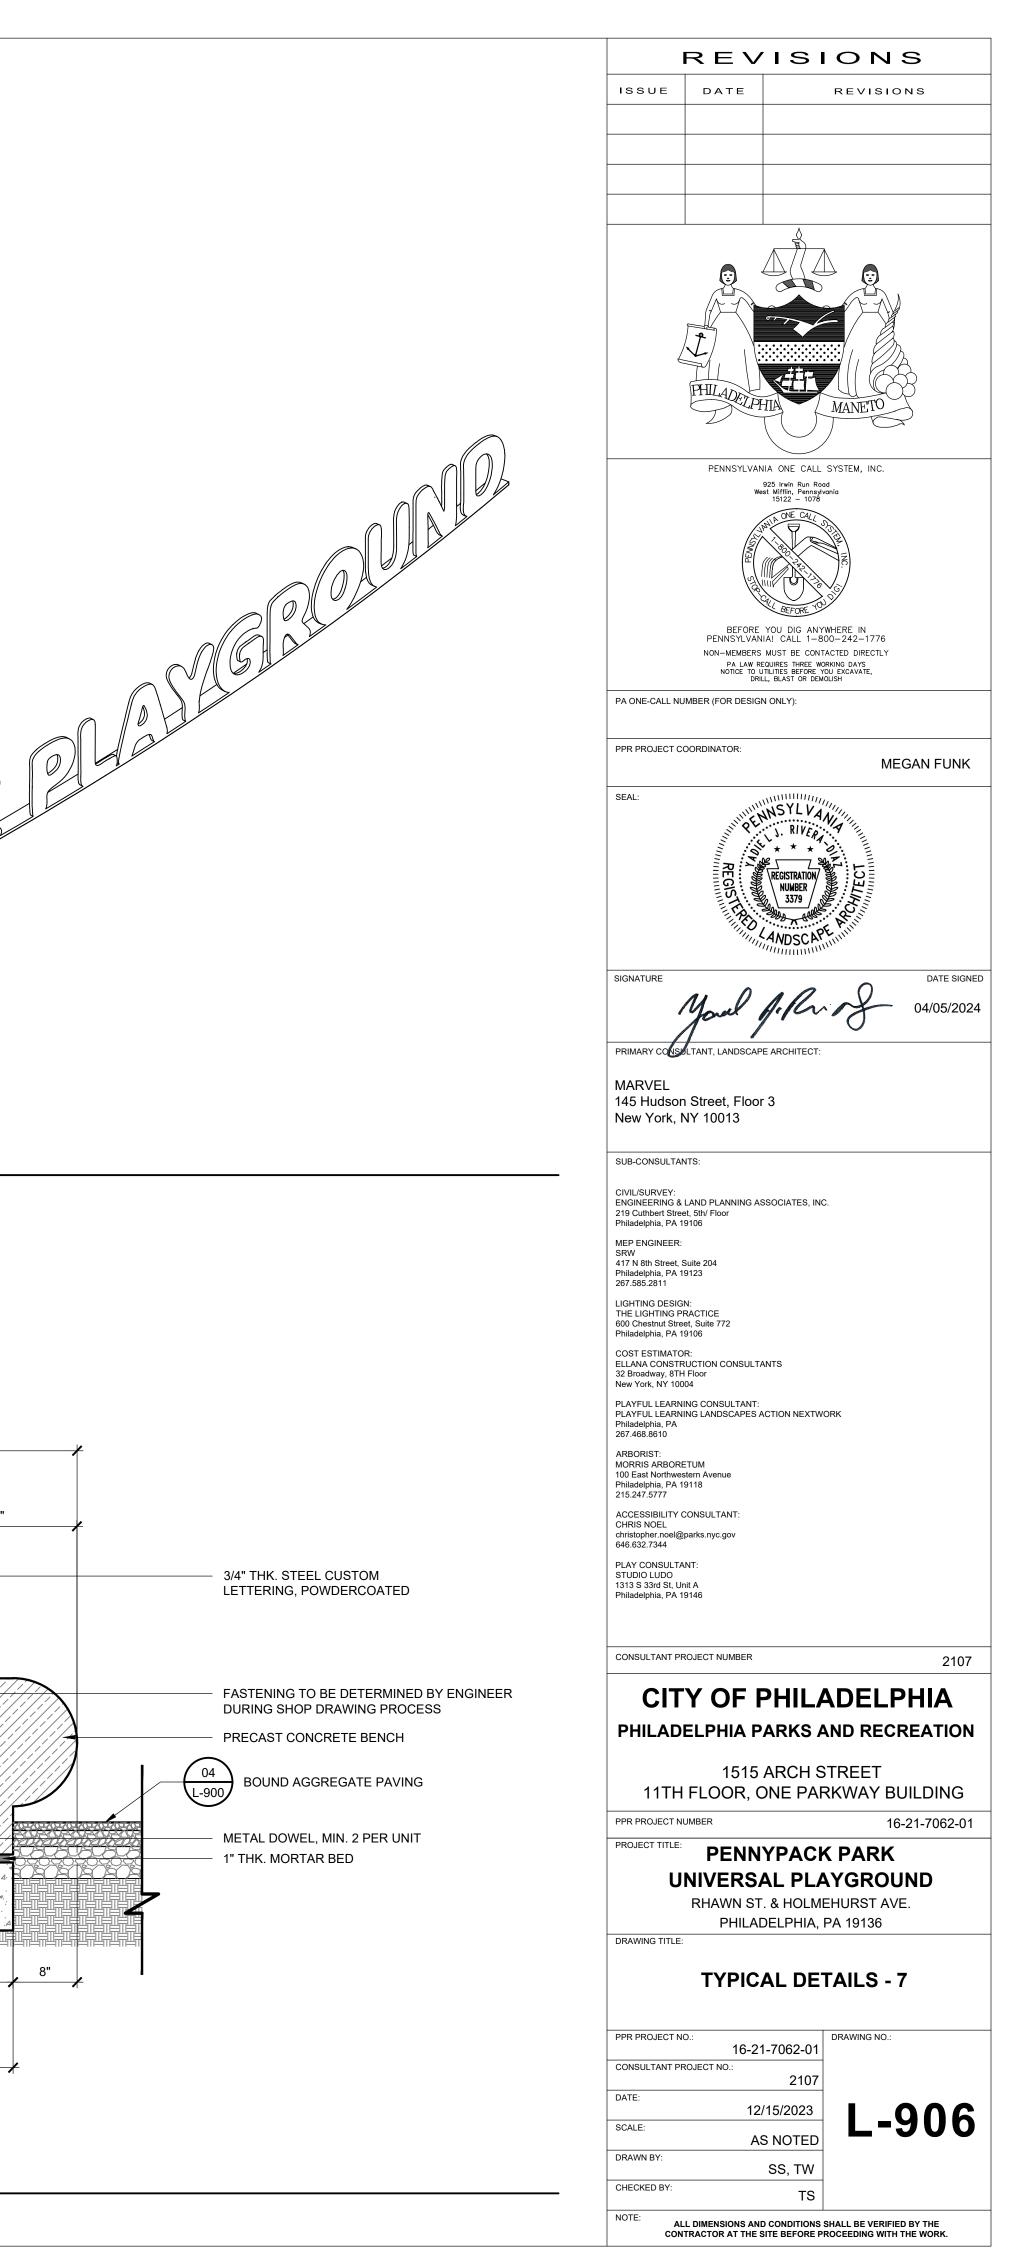

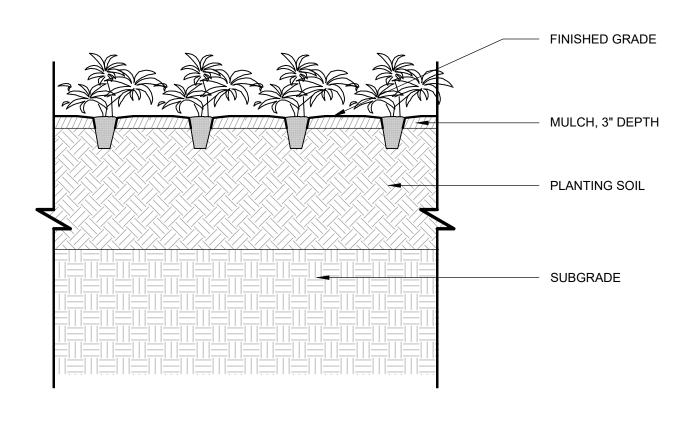




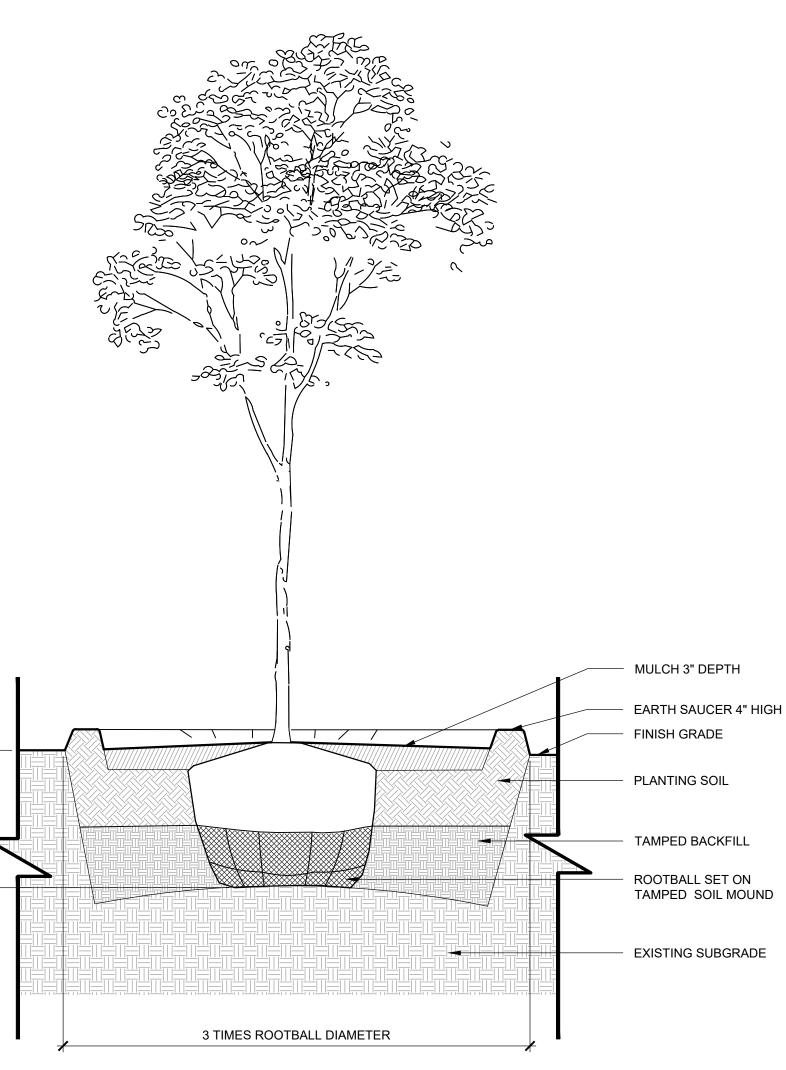

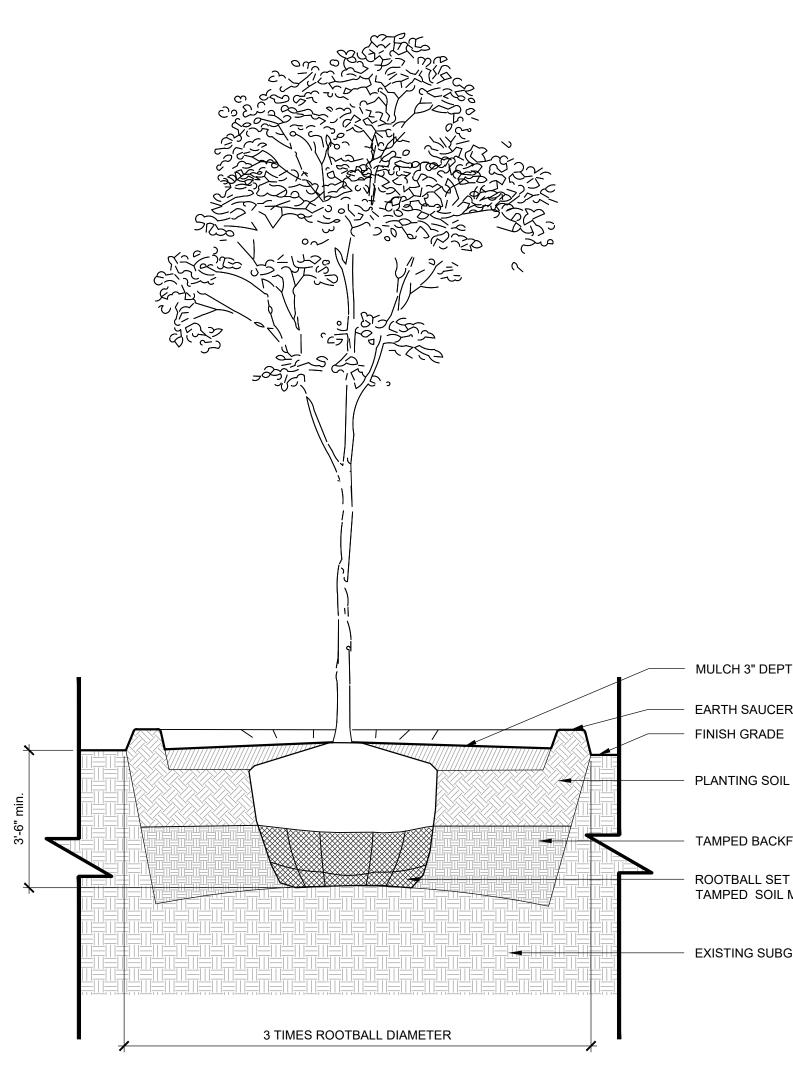




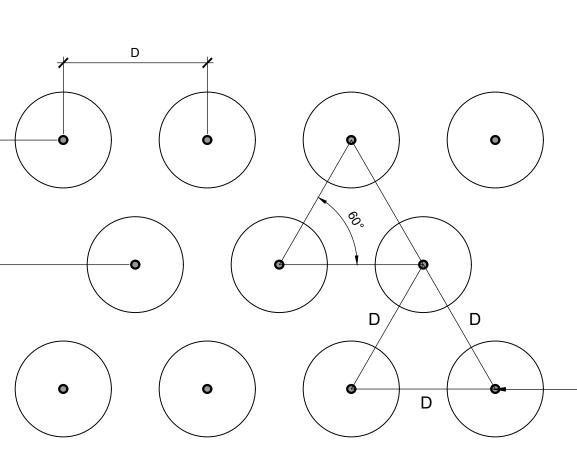



NOTE: 1. REMOVE ALL WIRE AND PLASTIC TAGS OR SYNTHETIC MATERIAL FROM PLANTS PRIOR TO PLANTING
D = TYPICAL ON CENTER (O.C) SPACING AS INDICATED IN THE PLANT LIST


- PLANT CENTER TYP.

03 PLANT SPACING SCALE: 1" = 1' - 0"

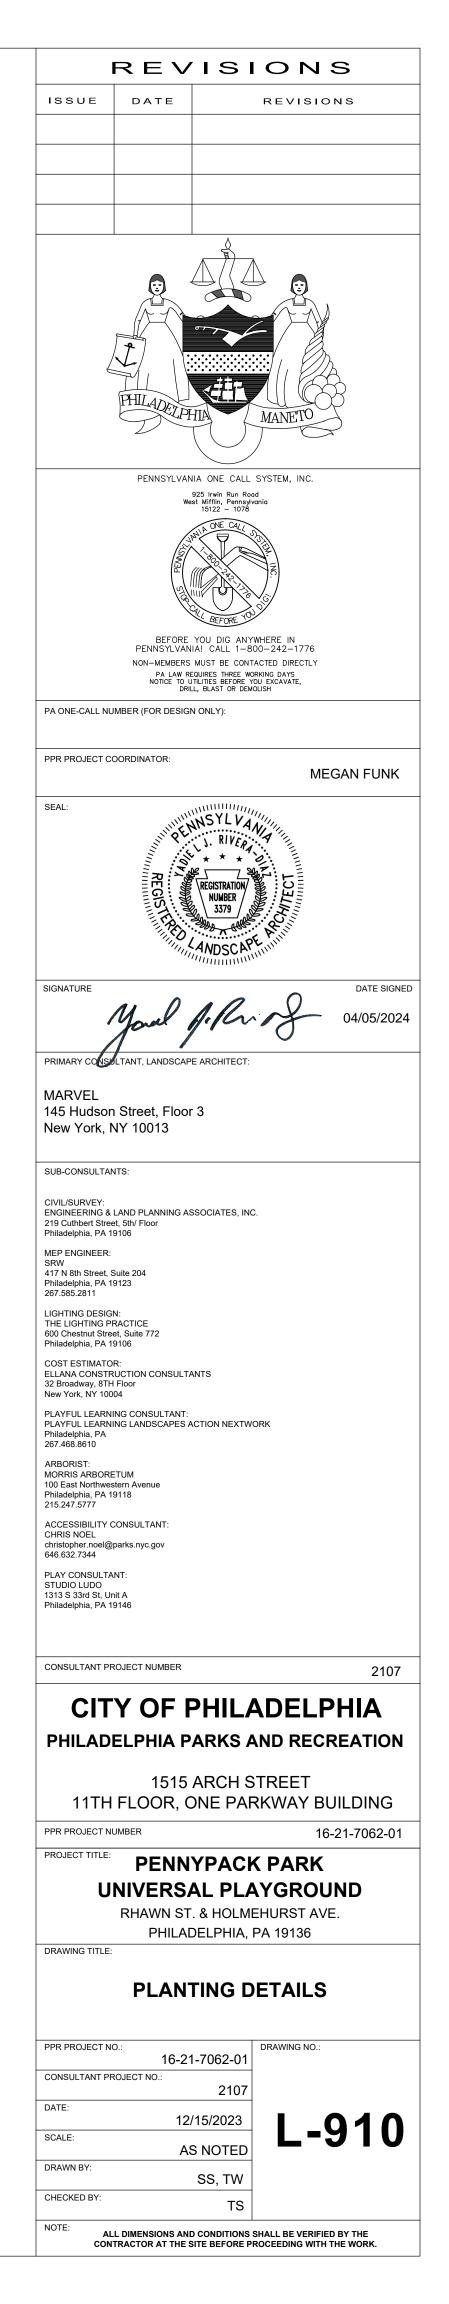


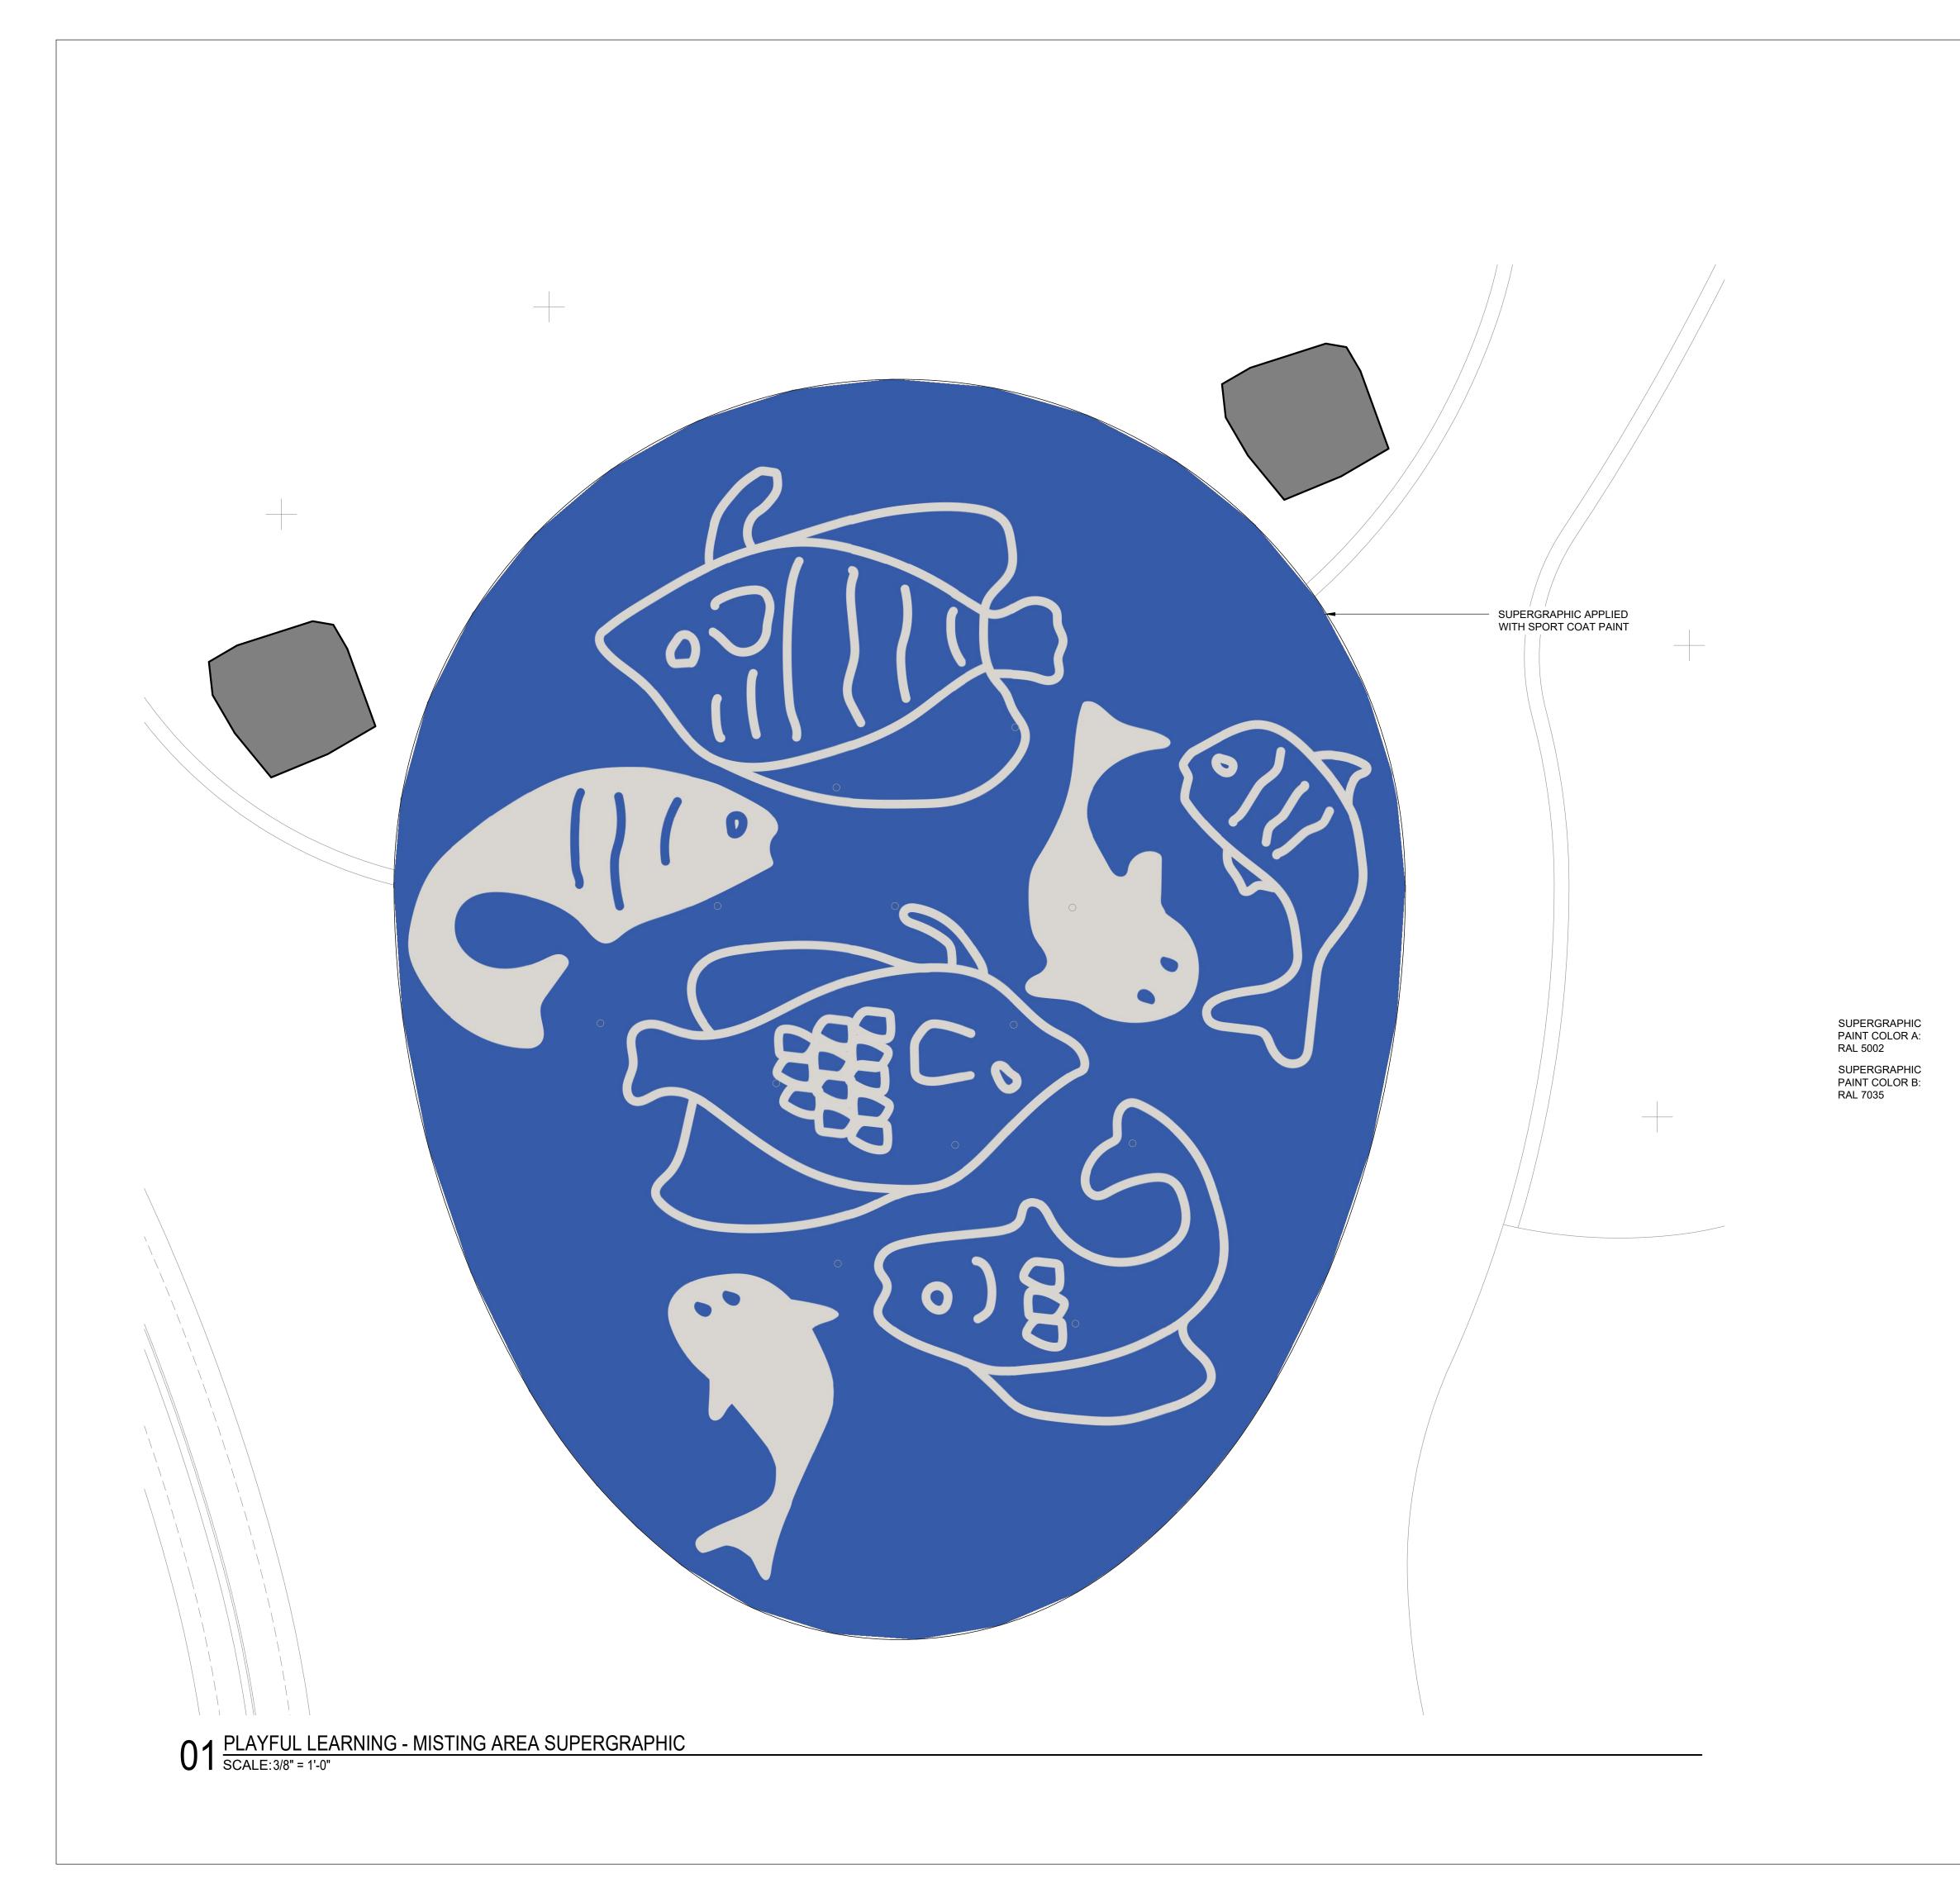


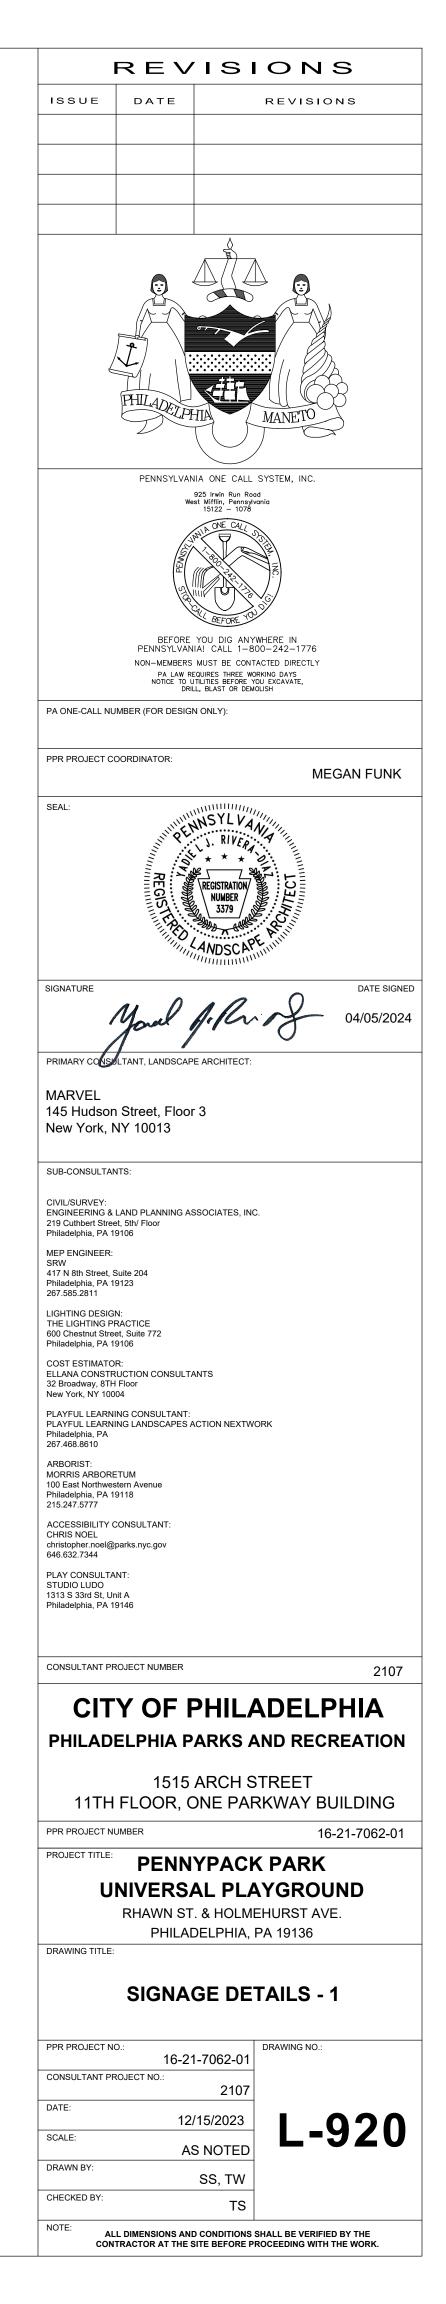

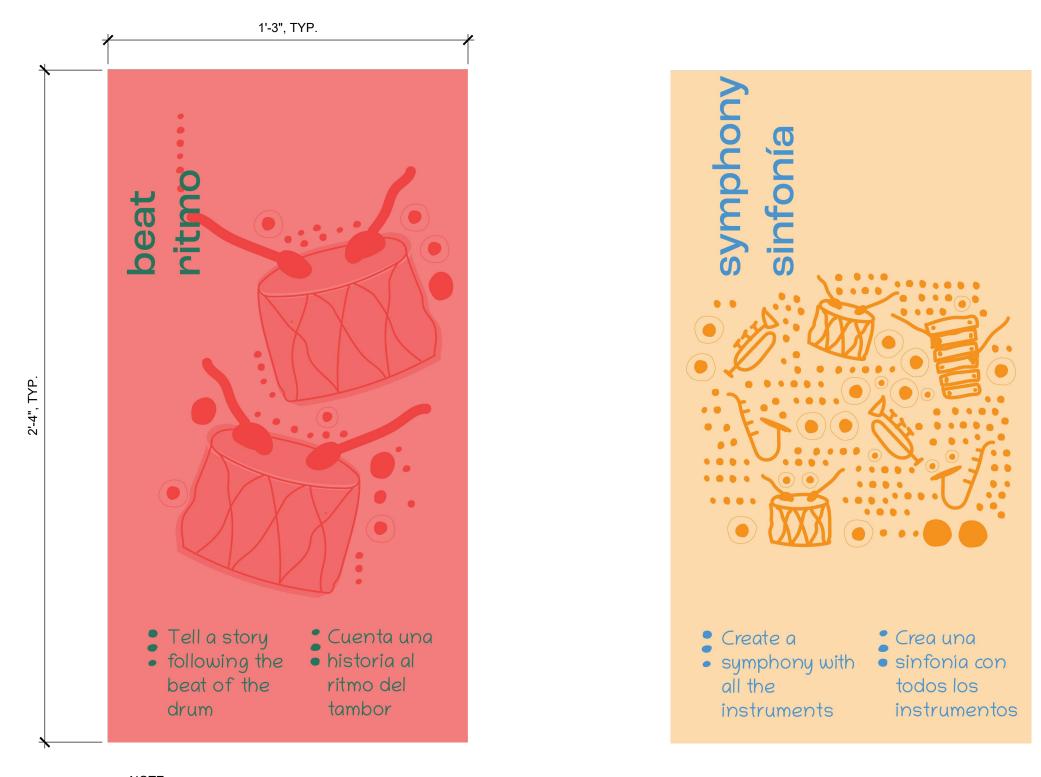


<u>NOTE:</u> THE BEAT / RITMO GRAPHIC WILL BE USED TWICE, ONE AT EACH DRUM SETS

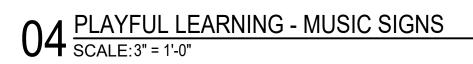


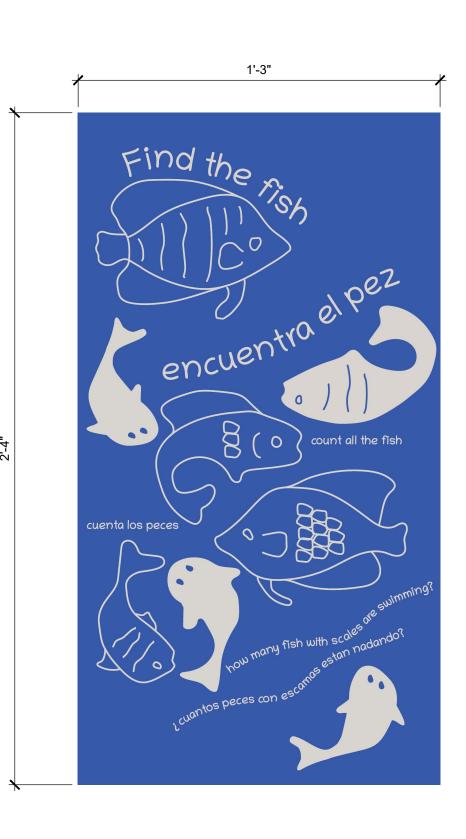






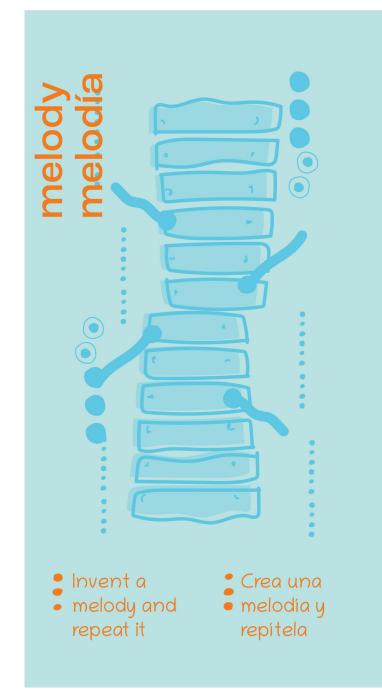

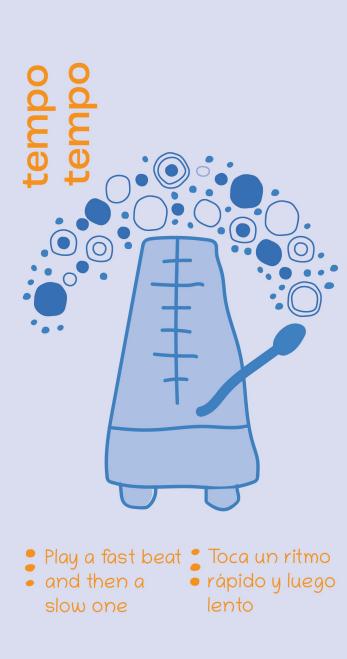

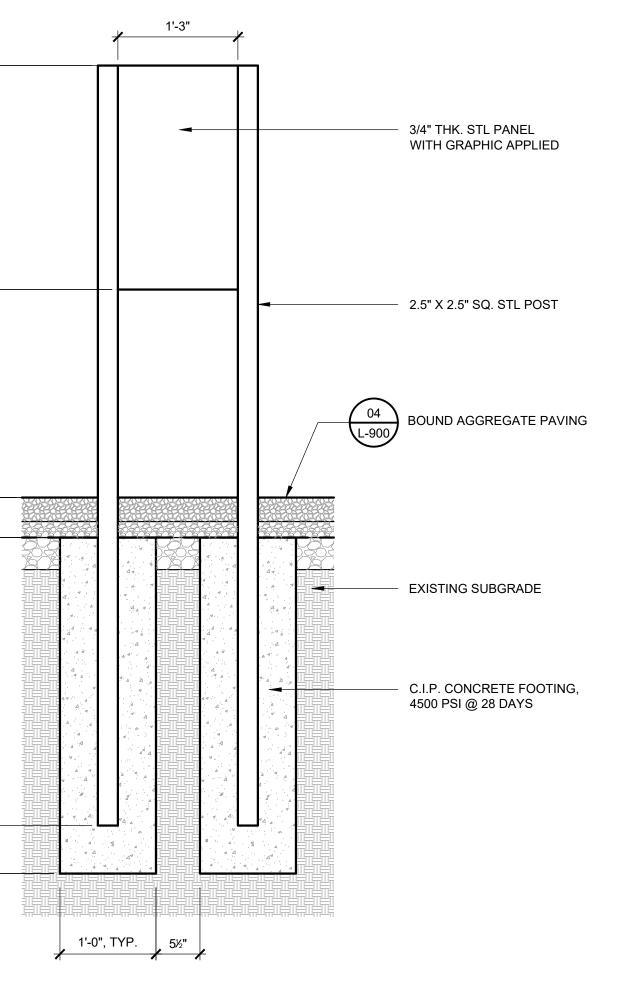

02 PLAYFUL LEARNING - TYPICAL SIGN SCALE: 1" = 1'-0"


OURTOWN PARK BOROUGH OF OURTOWN


Funding assistance has been provided by the Department of Conservation and Natural Resources Bureau of Recreation and Conservation Keystone Recreation, Park and Conservation Fund





NOTE 1. OVERALL SIZE: 18"x24" 2. BASE MATERIAL: ALUMINUM 3. THICKNESS: 0.080 4. OVERLAY: EG VINYL

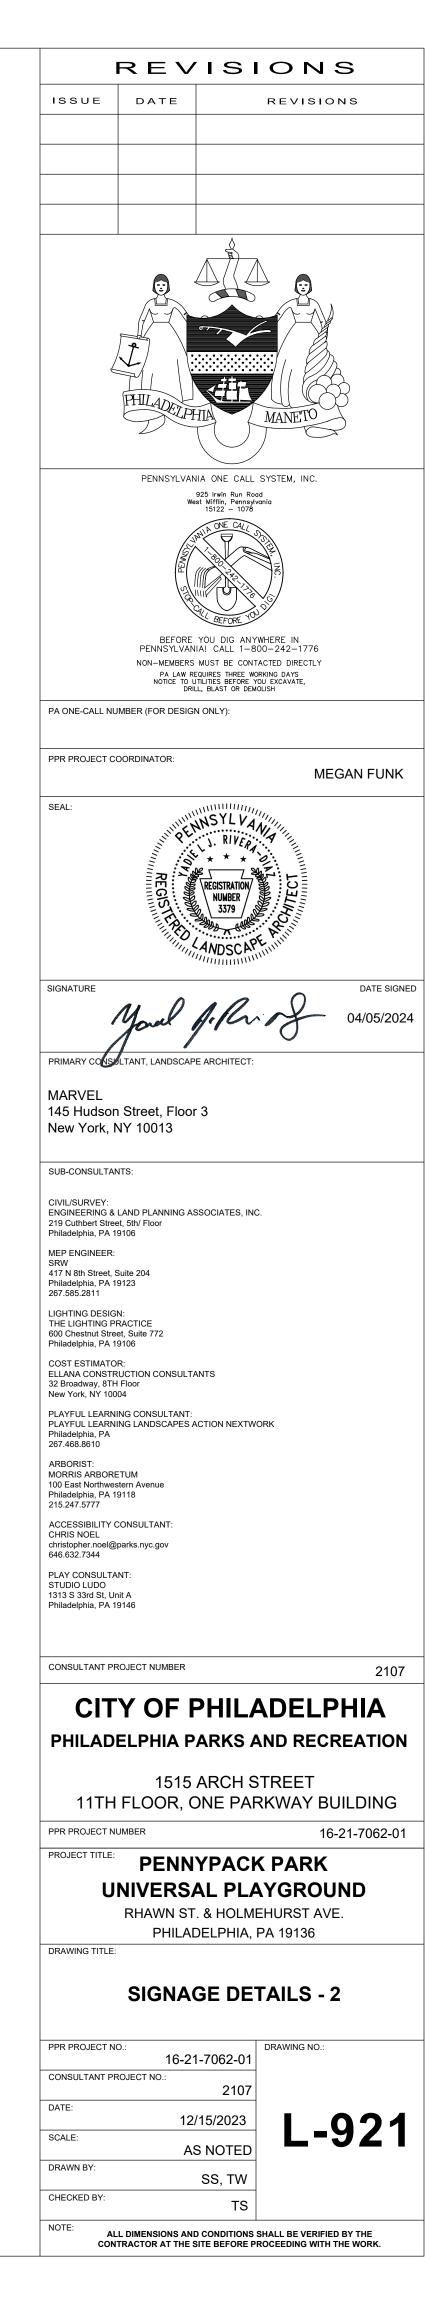

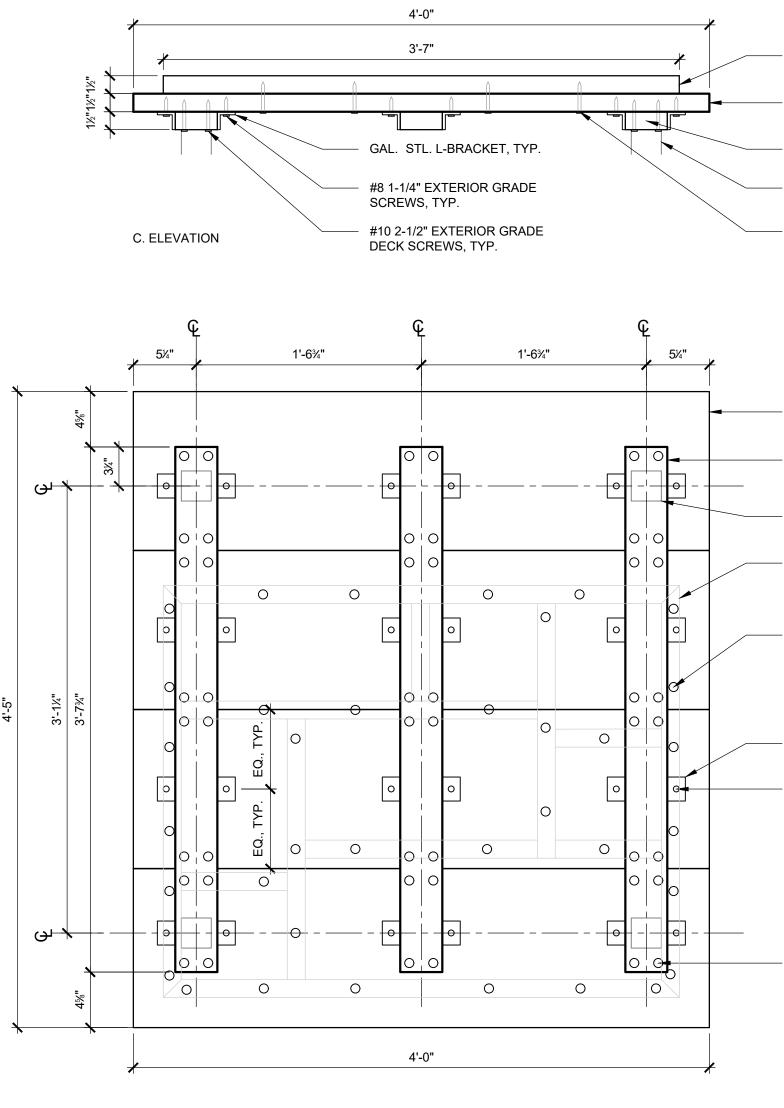

B. BACK





02 PLAYFUL LEARNING - COLLECTION TABLE - TABLE TOP SCALE: 3" = 1'-0"

LASER ETCHED LETTERING - 2x14 NOM. LUMBER 2x2 NOM. LUMBER FRAMING 8%" 8%" 2%"

#10 2-1/2" EXTERIOR GRADE DECK SCREWS IN BRACING, TYP.

#8 1-1/4" EXTERIOR GRADE SCREWS IN BRACKETS, TYP.

GAL. STL. L-BRACKET, TYP.

GRADE DECK SCREWS THROUGH BACKBOARD INTO FRAMING, TYP.

TYP. #10 2-1/2" EXTERIOR

POSTS, TYP. 2x2 NOM. LUMBER FRAMING, BEYOND,


CROSS BRACING 3x3 NOM. LUMBER

2x14 NOM. LUMBER BASEBOARDS 2x4 NOM. LUMBER


2x4 NOM. LUMBER CROSS BRACING , TYP. 3x3 NOM. LUMBER POST, TYP. #10 2-1/2" EXTERIOR GRADE DECK SCREWS, TYP.

2x14 NOM. LUMBER BASEBOARDS

2x2 NOM. LUMBER FRAMING

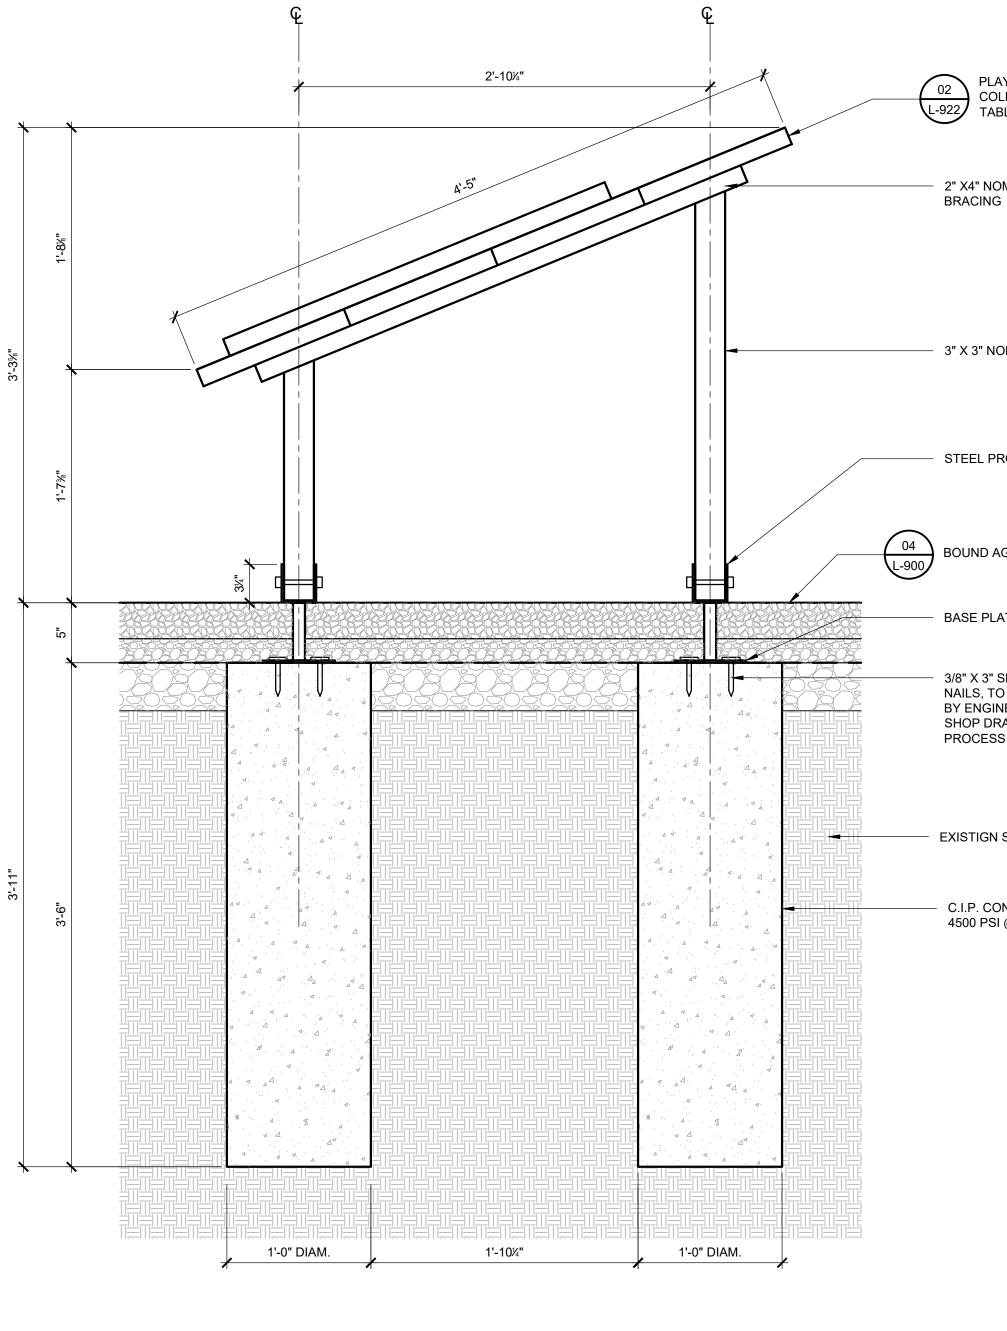

01 PLAYFUL LEARNING - COLLECTION TABLE - SECTION SCALE: 1-1/2" = 1'-0"

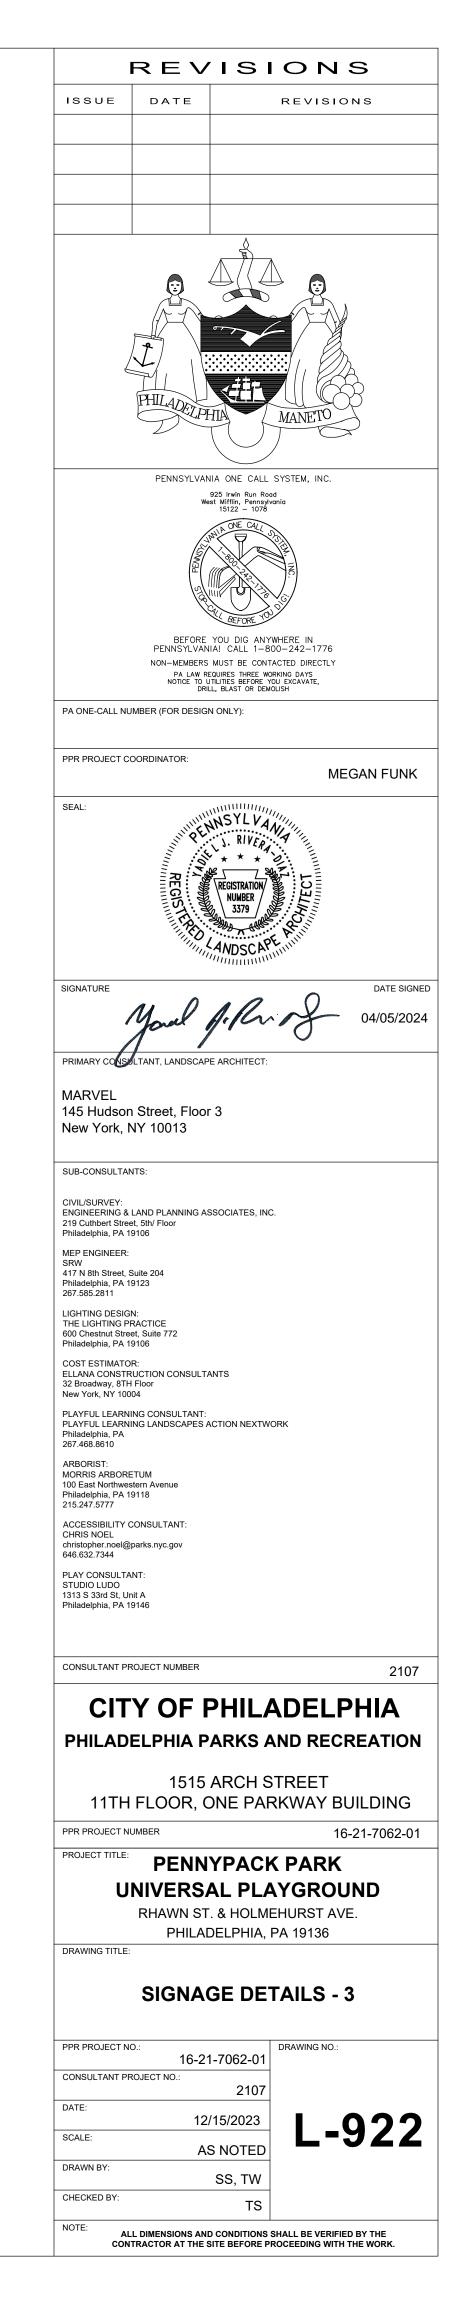

02 L-922 PLAYFUL LEARNING -COLLECTION TABLE -TABLE TOP

2" X4" NOM. LUMBER CROSS

- 3" X 3" NOM. LUMBER POST

- STEEL PROTECTION SHOES

BOUND AGGREGATE PAVING

BASE PLATE

3/8" X 3" SPIRAL SPIKE NAILS, TO BE VERIFIED BY ENGINEER DURING SHOP DRAWING PROCESS

EXISTIGN SUBGRADE

C.I.P. CONCRETE FOOTING, 4500 PSI @ 28 DAYS

GENERAL ELECTRICAL NOTES

- 1. ALL WORK SHALL CONFORM TO THE LATEST REQUIREMENTS OF THE NATIONAL ELECTRICAL CODE, PENNSYLVANIA CODES, NFPA, UL, THE LATEST ENERGY CONSERVATION CONSTRUCTION CODE, AND ALL OTHER GOVERNING AGENCIES HAVING JURISDICTION. ALL WORK SHALL BE PERFORMED BY A LICENSED ELECTRICAL CONTRACTOR AND FILED WILL ALL AUTHORITIES HAVING JURISDICTION.
- 2. THE ELECTRICAL CONTRACTOR SHALL VISIT AND CAREFULLY EXAMINE THE AREAS AFFECTED BY THIS WORK TO BECOME FAMILIAR WITH EXISTING CONDITIONS AND WITH DIFFICULTIES THAT WILL AFFECT THE EXECUTION OF THE WORK. CONTRACTOR SHALL PERFORM THIS PRIOR TO SUBMITTING HIS PROPOSAL. SUBMISSION OF A PROPOSAL WILL BE CONSTRUED AS EVIDENCE THAT SUCH AN EXAMINATION HAS BEEN MADE AND LATER CLAIMS WILL NOT BE RECOGNIZED FOR EXTRA LABOR, EQUIPMENT OR MATERIALS REQUIRED BECAUSE OF DIFFICULTIES ENCOUNTERED WHICH COULD HAVE BEEN FORESEEN HAD SUCH AN EXAMINATION BEEN MADE.
- 3. SUBSEQUENT TO AWARD OF THE CONTRACT, THE ELECTRICAL CONTRACTOR SHALL SUBMIT A PROPOSED SCHEDULE OF WORK TO THE ARCHITECT. THE SCHEDULE SHALL BE MODIFIED AS NECESSARY AND RE-ISSUED WHEN ANY CHANGES THERETO ARE REQUIRED.
- 4. THE DRAWINGS INDICATE SIZE AND GENERAL LOCATION OF WORK. SCALED 33. DIMENSIONS SHALL NOT BE USED. THE EXACT LOCATIONS AND ELEVATIONS OF ALL LIGHTING FIXTURES, ETC., SHALL BE DETERMINED BY THE ARCHITECT AND OWNER.
- 5. CIRCUIT NUMBERS INDICATED ON PLANS ARE FOR GROUPING PURPOSES ONLY. WHERE DRAWINGS CALL FOR SEPARATE NEUTRAL WIRES OR DEDICATED CIRCUITS, THE ELECTRICAL CONTRACTOR SHALL PROVIDE CIRCUITS WITH PROPER PHASE SEQUENCING FOR EVERY SHARED NEUTRAL WIRE.
- 6. BRANCH CIRCUITS SHALL BE ARRANGED TO BALANCE LOADS TO THE EXTENT POSSIBLE. LOADS IMBALANCES BETWEEN PHASES SHALL NOT EXCEED 10%.
- 7. ALL PANELS SHALL HAVE COMPLETE DIRECTORIES INDICATING LOADS SERVED AS WELL AS SPARES AND SPACES.
- 8. ELECTRIC PANEL COVERS SHALL NOT BE LEFT OFF AT ANY TIME UNLESS CONTRACTOR'S PERSONNEL ARE WORKING ON SAME. COVERS SHALL BE REPLACED AT THE END OF THE WORK DAY.
- 9. PROVIDE GROUND WIRE IN ALL FEEDERS TO MOTORIZED EQUIPMENT.
- 10. PROVIDE ARC FAULT CIRCUIT BREAKERS OR RECEPTACLES WHERE INDICATED OR WHERE REQUIRED BY CODE.
- 11. PROVIDE GROUND FAULT CIRCUIT BREAKERS OR RECEPTACLES WHERE INDICATED OR WHERE REQUIRED BY CODE.
- 12. ANY ELECTRICAL EQUIPMENT INDICATED OUTDOORS SHALL BE WEATHERPROOF IN NEMA 3R ENCLOSURES.
- 13. ALL DEVICE COLORS AND FINISHES, AND MOUNTING HEIGHTS OF ELECTRICAL DEVICES SHALL BE IN ACCORDANCE TO ARCHITECTURAL DRAWINGS.
- 14. 1/2" CONDUIT SHALL BE THE MINIMUM SIZE CONDUIT INSTALLED.
- 15. ARMOR CLAD (AC) OR METAL-CLAD CABLE (MC) MAY BE USED AS PERMITTED BY CODE. ELECTRICAL METALLIC TUBING (EMT) MAY BE USED WITH SET SCREW TYPE FITTINGS.
- 16. FLEXIBLE METALLIC CONDUIT (FMC) (GREENFIELD) SHALL BE USED FOR FINAL CONNECTION TO MOTORS AND TO RECESSED MOUNTED LIGHTING FIXTURES. LENGTH SHALL NOT EXCEED 6 FEET.
- 17. ALL MATERIALS SHALL BE NEW AND SHALL CONFORM WITH THE STANDARDS OF THE UNDERWRITERS LABORATORIES, INC. (UL) WHERE SUCH A STANDARD HAS BEEN ESTABLISHED FOR THE PARTICULAR TYPE OF MATERIAL IN QUESTION, UNLESS OTHERWISE NOTED.
- 18. THE CONTRACTOR SHALL SUBMIT CATALOG CUTS AND SHOP DRAWINGS OF ALL DEVICES, EQUIPMENT AND MATERIAL PROPOSED TO BE USED TO THE ARCHITECT AND ENGINEER FOR REVIEW AND APPROVAL, A SHOP DRAWING LOG SHALL BE MAINTAINED BY THE CONTRACTOR AND STATUS OF SUBMISSIONS SHALL BE UPDATED AT LEAST BI-WEEKLY.
- 19. THE ELECTRICAL CONTRACTOR SHALL COORDINATE HIS WORK WITH OTHER TRADES AND CONTRACTORS WHOSE WORK MIGHT AFFECT THIS INSTALLATION.
- 20. BEFORE INSTALLING ANY WORK, THE CONTRACTOR, SHALL CONFIRM THAT IT DOES NOT INTERFERE WITH CLEARANCES REQUIRED FOR EQUIPMENT. FINISHES AND OTHER ITEMS, AS SHOWN ON THE ARCHITECTURAL DRAWINGS AND DETAILS. IF ANY WORK IS SO INSTALLED AND IT LATER DEVELOPS THAT SUCH DETAILS OR DESIGN CANNOT BE FOLLOWED, THIS CONTRACTOR AT HIS OWN EXPENSE SHALL MAKE SUCH CHANGES IN THE WORK AS NECESSARY AND AS DIRECTED BY THE ARCHITECT, TO PERMIT THE INSTALLATION OF THE ARCHITECTURAL WORK AS SHOWN ON THE PLANS AND DETAILS.
- 21. DURING THE PROJECT DURATION, THE ARCHITECT AND ENGINEER WILL INSPECT THE WORK PROGRESS. ANY WORK WHICH IS JUDGED UNSATISFACTORY FOR ANY REASON OR NOT IN COMPLIANCE WITH THE CONTRACT, CODE, OR STANDARDS SHALL BE REMOVED AND REPLACED AS DIRECTED AND AT THE EXPENSE OF THE CONTRACTOR.
- 22. CHOPPING OR CHASING OF MASONRY MUST BE COORDINATED WITH THE ENGINEER AND ARCHITECT PRIOR TO COMMENCING WORK.
- 23. UPON COMPLETION OF THE WORK, A SET OF "AS-BUILT" DRAWINGS SHALL BE SUBMITTED TO THE ENGINEER FOR REVIEW AND ACCEPTANCE. FINAL AS-BUILTS SHALL BE SUBMITTED TO THE OWNER PRIOR TO PROJECT CLOSEOUT.
- 24. THE ENERGIZATION OF THE ELECTRICAL INSTALLATION DOES NOT CONSTITUTE AN ACCEPTANCE OF THE WORK BY THE OWNER. FINAL ACCEPTANCE IS TO BE MADE AFTER THE CONTRACTOR HAS DEMONSTRATED THAT THE WORK FULFILLS THE REQUIREMENTS OF THE PLANS AND SPECIFICATIONS AND HAS FURNISHED ALL REQUIRED CERTIFICATES OF APPROVAL FROM THE STATE AUTHORITIES, MUNICIPAL AUTHORITIES AND UNDERWRITERS.
- 25. ELECTRICAL CONTRACTOR SHALL FILE FOR NECESSARY INSPECTIONS AND SHALL PROVIDE AN ELECTRICAL INSPECTION APPROVAL CERTIFICATE TO THE ARCHITECT UPON COMPLETION OF THE WORK.
- 26. ALL ELECTRICAL WORK TO CONFORM TO NEC AND LOCAL ELECTRICAL CODES.
- 27. THE ELECTRICAL SYSTEM SHALL BE GROUNDED IN ACCORDANCE WITH NEC REQUIREMENTS. ALL NON-CURRENT METAL PARTS SHALL BE

CONNECTED TO THE GROUNDING SYSTEM. PROVIDE GROUND ROD IN FIRST BOX & BOND TO CONDUIT.


- 28 ALL UNDERGROUND CONDUIT SHALL BE HOT DIPPED GALVANIZED STEEL WITH WARNING TAPE ABOVE IT. RIGID PVC CONDUIT IS ACCEPTABLE TO USE FOR ALL UNDERGROUND RACEWAYS IN AREAS NOT REGULARLY SUBJECT TO VEHICULAR TRAFFIC. PROVIDE CODE-SIZED GROUND WIRE IN EACH PVC CONDUIT AS PER NEC 250.
- 29. FOR EXACT LAYOUT & EQUIPMENT LOCATIONS SEE LANDSCAPE PLAN
- 30. COORDINATE CONDUIT ROUTING/LAYOUT TO AVOID ANY EQUIPMENT FOOTINGS & TREE ROOTS.
- 31. EXCAVATION AROUND TREES SHALL BE PERFORMED BY HAND TO NOT DISTURB EXISTING ROOT SYSTEM.
- 32. MINIMUM SIZE WIRING SHALL BE #12. ELECTRICAL CONTRACTOR SHALL INCREASE WIRE SIZE AND CONDUIT AS NECESSARY TO MEET ALL VOLTAGE DROP LIMITATIONS
- CONTRACTOR SHALL INSTALL PULL BOXES AS REQUIRED BY CODE AND TO FACILITATE CABLE INSTALLATION. COORDINATE LOCATIONS OF PULL BOXES WITH LANDSCAPE ARCHITECT PRIOR TO INSTALLATION.

TRENCHING NOTES

- 1. CONTRACTOR SHALL LOCATE ALL EXISTING UNDERGROUND UTILITIES PRIOR TO DIGGING.
- 2. ALL EXCAVATION IN THE AREA OF THE EXISTING UNDERGROUND EQUIPMENT, PIPES AND CONDUITS SHALL BE PERFORMED BY HAND.
- 3. ANY AREA PLANTS OR LANDSCAPING OR PAVEMENT DISTURBED DURING THE EXCAVATION SHALL BE RESTORED OR REPLACED TO MATCH EXISTING CONDITIONS BY THE CONTRACTOR AT NO COST TO THE OWNER.
- 4. ANY EXISTING BURIED CONDUITS, DRAINAGE, SPRINKLER PIPING, ETC. THAT IS DISTURBED AND/OR DAMAGED DURING CONSTRUCTION SHALL BE REPAIRED BY THE CONTRACTOR AT NO COST TO THE OWNER.
- 5. CONTRACTOR SHALL VERIFY AND COORDINATE FOR EXISTING UNDERGROUND UTILITIES AND UTILITIES OF ALL OTHER TRADES TO BE INSTALLED AS PART OF THIS CONTRACT TO LOCATE FEEDERS SHOWN ON THESE DRAWINGS. THE CONTRACTOR IS WARNED THAT THE EXACT OR EVEN APPROXIMATE LOCATION OF SUCH UTILITY PIPELINES, SUBSURFACE STRUCTURES AND/OR UTILITIES IN THE AREA MAY OR MAY NOT BE SHOWN OR EXACTLY DEPICTED ON THE PLANS. IT IS RESPONSIBILITY OF THIS CONTRACTOR TO PROCEED WITH GREAT CARE IN EXECUTING ANY WORK.

А	AMPERES	EM	EMERGENCY
ACT	ABOVE COUNTER TOP		
AFF	ABOVE FINISH FLOOR	EQUIP	
AWG	AMERICAN WIRE GAUGE	FACP	FIRE ALARM CONTR
BLDG	BUILDING	FBO	FURNISH OTHER DI WORK
С	CONDUIT	FIXT	FIXTURE
CAT	CATALOG	FL	FLOOR
CAM	CAMERA	FLEX	FLEXIBLE
СВ	CIRCUIT BREAKER	FT	FEET OR FOOT
СКТ	CIRCUIT	GA	GAUGE
CLG	CEILING	G,GRD,GND,	GROUND
DGP	DATA GATHERING PANEL	GC	GENERAL CONTRAC
DISC	DISCONNECT	GFI	GROUND FAULT INT
DN	DOWN	HD	HAND DRYER
DR	DOOR RELEASE	HP	HORSEPOWER
DWG	DRAWING	HVAC	HEATING, VENTILAT
ELEC	ELECTRICAL		CONDITIONING

			LI	GHT SOURCE						
TYPE	MTG.	DESCRIPTION	DELIVERED LUMENS OR LAMP NO. DESIGNATION	COLOR/CCT	OPTICS	WATTAGE (W)	VOLTS (V)	DIMMING PROTOCOL/RANGE ⁶	MANUFACTURER	CATALOG NUMBER
P1	POLE	LIGHT POLE ASSEMBLY CONSISTING OF ARM-MOUNTED LUMINAIRE ATTACHED TO 25 FOOT TALL POLE.	6,325 LMS	3000K	TYPE III B2-U0-G2	62	277	-	SELUX VALMONT	HEAD: DSC4L-R3W-S1-5G700-30-25-BLACK-UNV-TLR POLE: R-+250060605S4-P3-DBL
P2	POLE	LIGHT POLE ASSEMBLY CONSISTING OF MODULAR FLOOD LIGHT ATTACHED TO 25 FOOT TALL POLE.	16,900 LMS	3000K	60° X 60°	100	277	0-10V	SPECGRADE	HEAD: MFL-100-3000K-60-V01-[FINISH]-TL-VDIM-80CRI-GS
									VALMONT	POLE: R-+250060605S4-P2-DBL

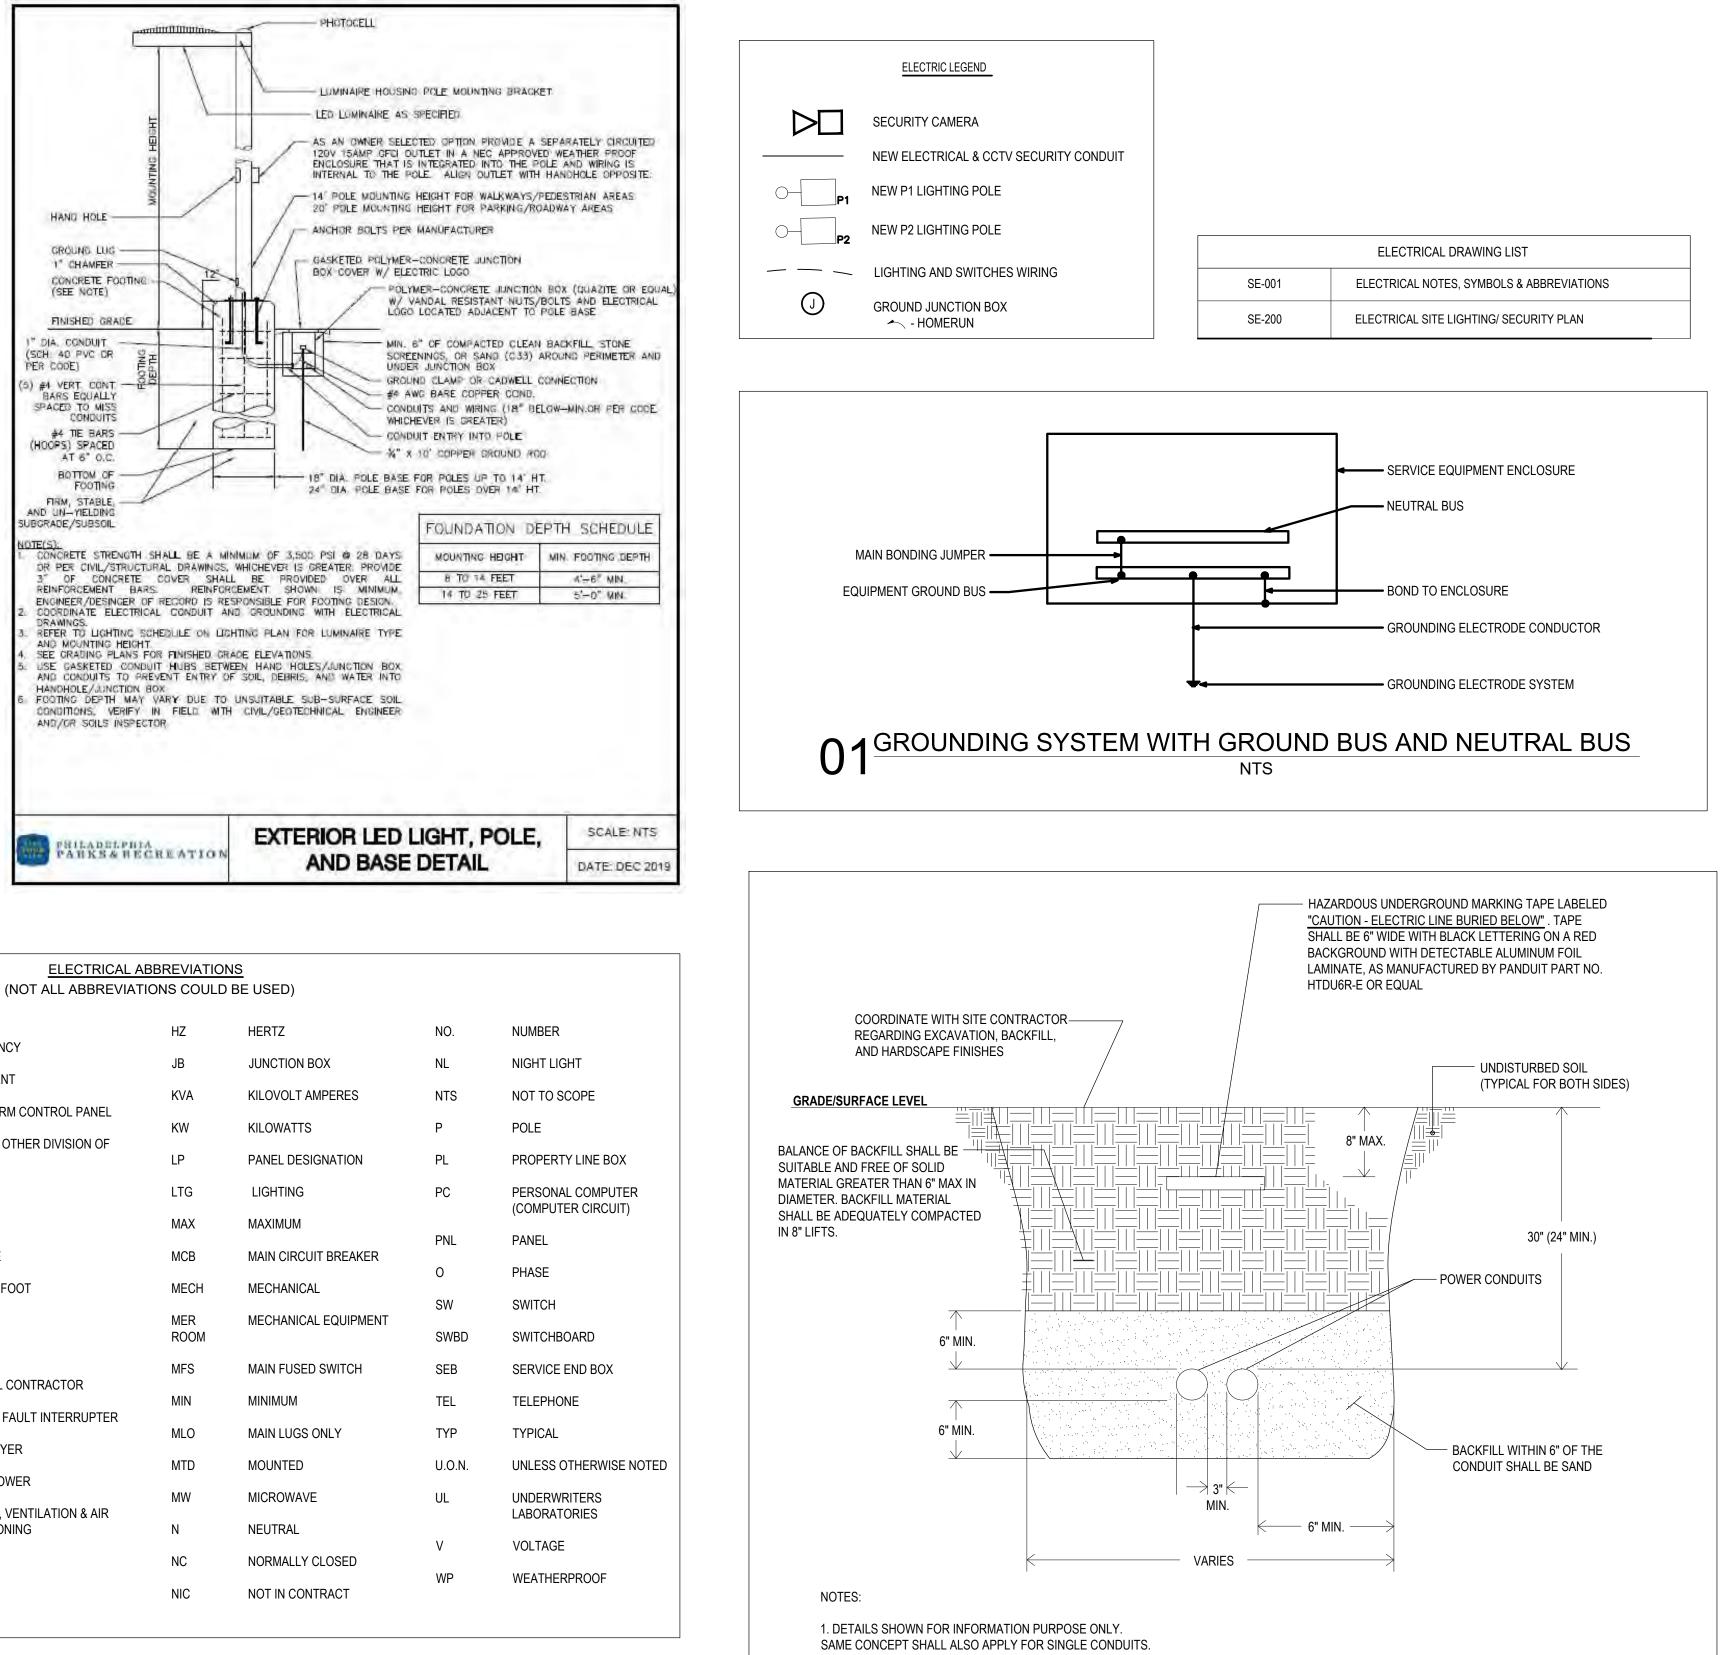

02 ^{TRENCHING D}	ETA
02	Ν

AIL FOR CONDUITS NTS

ISSUE		
1	DATE	REVISIONS
		Δ
	¢	
I	HILADELPHIA	MANETO
	925 Irwin	CALL SYSTEM, INC.
	West Mifflin, 15122	Pennsylvania - 1078 CALL DE
	BEFORE YOU DI PENNSYLVANIA! CAL	G ANYWHERE IN L 1-800-242-1776
	NON-MEMBERS MUST B PA LAW REQUIRES T NOTICE TO UTILITIES B	E CONTACTED DIRECTLY HREE WORKING DAYS HEFORE YOU EXCAVATE,
PA ONE-CALL NUME	DRILL, BLAST	OR DEMOLISH
PPR PROJECT COO	RDINATOR	
		MEGAN FUNK
SEAL:	ULLON	WEALS
	NO PROFE	SIONAL
	CAPPY	ASABI
	- OF	E071694
SIGNATURE	- NS	DATE SIGN
		04/05/20
	ANT, LANDSCAPE ARCH	ITECT:
MARVEL	,	
145 Hudson S		
New York, NY	10013	
SUB-CONSULTANTS	3: 	
CIVIL/SURVEY: ENGINEERING & LAI 219 Cuthbert Street, 5 Philadelphia, PA 1910		TES, INC.
MEP ENGINEER: SRW		
417 N 8th Street, Suit Philadelphia, PA 1912 267.585.2811		
LIGHTING DESIGN: THE LIGHTING PRAC 600 Chestnut Street, 5 Philadelphia, PA 1910	Suite 772	
COST ESTIMATOR:		
	TION CONSULTANTS	
ELLANA CONSTRUC 32 Broadway, 8TH Flo New York, NY 10004 PLAYFUL LEARNING	oor	
32 Broadway, 8TH Flo New York, NY 10004 PLAYFUL LEARNING	oor	NEXTWORK
32 Broadway, 8TH Fit New York, NY 10004 PLAYFUL LEARNING Philadelphia, PA 267.468.8610 ARBORIST: MORRIS ARBORETL 100 East Northwester	oor G CONSULTANT: G LANDSCAPES ACTION M JM n Avenue	NEXTWORK
32 Broadway, 8TH Fic New York, NY 10004 PLAYFUL LEARNING Philadelphia, PA 267.468.8610 ARBORIST: MORRIS ARBORETL 100 East Northwester Philadelphia, PA 1911 215.247.5777	oor G CONSULTANT: G LANDSCAPES ACTION M JM n Avenue 18	NEXTWORK
32 Broadway, 8TH Fit New York, NY 10004 PLAYFUL LEARNING Philadelphia, PA 267.468.8610 ARBORIST: MORRIS ARBORETL 100 East Northwester Philadelphia, PA 1911 215.247.5777 ACCESSIBILITY CON CHRIS NOEL christopher.noel@par	oor G CONSULTANT: G LANDSCAPES ACTION N M n Avenue 18 NSULTANT:	NEXTWORK
32 Broadway, 8TH Fik New York, NY 10004 PLAYFUL LEARNING Philadelphia, PA 267.468.8610 ARBORIST: MORRIS ARBORETL 100 East Northwester Philadelphia, PA 1911 215.247.5777 ACCESSIBILITY CON CHRIS NOEL christopher.noel@par 646.632.7344 PLAY CONSULTANT STUDIO LUDO	oor G CONSULTANT: G LANDSCAPES ACTION M M n Avenue 18 NSULTANT: rks.nyc.gov	NEXTWORK
32 Broadway, 8TH Fik New York, NY 10004 PLAYFUL LEARNING PLAYFUL LEARNING Philadelphia, PA 267.468.8610 ARBORIST: MORRIS ARBORETL 100 East Northwester Philadelphia, PA 1911 215.247.5777 ACCESSIBILITY CON CHRIS NOEL christopher.noel@par 646.632.7344 PLAY CONSULTANT STUDIO LUDO 1313 S 33rd St, Unit A	oor G CONSULTANT: G LANDSCAPES ACTION N n Avenue 18 NSULTANT: ks.nyc.gov	NEXTWORK
32 Broadway, 8TH Fik New York, NY 10004 PLAYFUL LEARNING Philadelphia, PA 267.468.8610 ARBORIST: MORRIS ARBORETL 100 East Northwester Philadelphia, PA 1911 215.247.5777 ACCESSIBILITY CON CHRIS NOEL christopher.noel@par 646.632.7344 PLAY CONSULTANT STUDIO LUDO 1313 S 33rd St, Unit <i>A</i> Philadelphia, PA 1914	oor G CONSULTANT: G LANDSCAPES ACTION N n Avenue 18 NSULTANT: ks.nyc.gov : A 46	
32 Broadway, 8TH Fik New York, NY 10004 PLAYFUL LEARNING PLAYFUL LEARNING Philadelphia, PA 267.468.8610 ARBORIST: MORRIS ARBORETL 100 East Northwester Philadelphia, PA 1911 215.247.5777 ACCESSIBILITY CON CHRIS NOEL christopher.noel@par 646.632.7344 PLAY CONSULTANT STUDIO LUDO 1313 S 33rd St, Unit <i>A</i> Philadelphia, PA 1914 CONSULTANT PROJ	oor G CONSULTANT: G LANDSCAPES ACTION N n Avenue 18 NSULTANT: ks.nyc.gov : A 46 JECT NUMBER	2107
32 Broadway, 8TH Fik New York, NY 10004 PLAYFUL LEARNING Philadelphia, PA 267.468.8610 ARBORIST: MORRIS ARBORETL 100 East Northwester Philadelphia, PA 1911 215.247.5777 ACCESSIBILITY CON CHRIS NOEL christopher.noel@par 646.632.7344 PLAY CONSULTANT STUDIO LUDO 1313 S 33rd St, Unit A Philadelphia, PA 1914	OOF CONSULTANT: LANDSCAPES ACTION N Avenue NSULTANT: ks.nyc.gov LAN A A COF PH	2107 ILADELPHIA
32 Broadway, 8TH Fik New York, NY 10004 PLAYFUL LEARNING Philadelphia, PA 267.468.8610 ARBORIST: MORRIS ARBORETL 100 East Northwester Philadelphia, PA 1911 215.247.5777 ACCESSIBILITY CON CHRIS NOEL christopher.noel@par 646.632.7344 PLAY CONSULTANT STUDIO LUDO 1313 S 33rd St, Unit A Philadelphia, PA 1914	oor CONSULTANT: LANDSCAPES ACTION N Avenue NSULTANT: ks.nyc.gov LECT NUMBER COF PHI LPHIA PARK	2107 ILADELPHIA (S AND RECREATION
32 Broadway, 8TH Fik New York, NY 10004 PLAYFUL LEARNING PLAYFUL LEARNING Philadelphia, PA 267.468.8610 ARBORIST: MORRIS ARBORETL 100 East Northwester Philadelphia, PA 1911 215.247.5777 ACCESSIBILITY CON CHRIS NOEL christopher.noel@par 646.632.7344 PLAY CONSULTANT STUDIO LUDO 1313 S 33rd St, Unit <i>A</i> Philadelphia, PA 1914 CONSULTANT PROJ	DOOT S CONSULTANT: S LANDSCAPES ACTION I IN IN NSULTANT: IN INSULTANT: IN IN IN IN IN IN IN IN IN IN	2107 ILADELPHIA
32 Broadway, 8TH Fik New York, NY 10004 PLAYFUL LEARNING PLAYFUL LEARNING Philadelphia, PA 267.468.8610 ARBORIST: MORRIS ARBORETL 100 East Northwester Philadelphia, PA 1911 215.247.5777 ACCESSIBILITY CON CHRIS NOEL christopher.noel@par 646.632.7344 PLAY CONSULTANT STUDIO LUDO 1313 S 33rd St, Unit <i>A</i> Philadelphia, PA 1914 CONSULTANT PROJ CONSULTANT PROJ PHILADEI 11TH F PPR PROJECT NUM	CONSULTANT: CANDSCAPES ACTION M Avenue B NSULTANT: ks.nyc.gov C A A A A COF PHI LPHIA PARK 1515 ARC COR, ONE	2107 ILADELPHIA (S AND RECREATION CH STREET
32 Broadway, 8TH Fik New York, NY 10004 PLAYFUL LEARNING PLAYFUL LEARNING Philadelphia, PA 267.468.8610 ARBORIST: MORRIS ARBORETL 100 East Northwester Philadelphia, PA 1911 215.247.5777 ACCESSIBILITY CON CHRIS NOEL christopher.noel@par 646.632.7344 PLAY CONSULTANT STUDIO LUDO 1313 S 33rd St, Unit <i>A</i> Philadelphia, PA 1914 CONSULTANT PROJ CONSULTANT PROJ CONSULTANT PROJ PHILADEI 11TH F PPR PROJECT NUM PROJECT TITLE:	OOT CONSULTANT: CANDSCAPES ACTION N Avenue B NSULTANT: ks.nyc.gov CA A A A COF PHI LPHIA PARK 1515 ARC LOOR, ONE BER PENNYPA	2107 ILADELPHIA KS AND RECREATION CH STREET PARKWAY BUILDING 16-21-7062-07 ACK PARK
32 Broadway, 8TH Fik New York, NY 10004 PLAYFUL LEARNING PLAYFUL LEARNING Philadelphia, PA 267.468.8610 ARBORIST: MORRIS ARBORETL 100 East Northwester Philadelphia, PA 1911 215.247.5777 ACCESSIBILITY CON CHRIS NOEL christopher.noel@par 646.632.7344 PLAY CONSULTANT STUDIO LUDO 1313 S 33rd St, Unit <i>A</i> Philadelphia, PA 1914 CONSULTANT PROJ CONSULTANT PROJ CONSULTANT PROJ PHILADEI PHILADEI PPR PROJECT NUM PROJECT TITLE: UN	oor CONSULTANT: LANDSCAPES ACTION N Avenue NSULTANT: ks.nyc.gov COF PHI LPHIA PARK 1515 ARC LOOR, ONE BER PENNYPA IVERSAL I RHAWN ST. & HO	2107 ILADELPHIA KS AND RECREATION CH STREET PARKWAY BUILDING 16-21-7062-07 ACK PARK PLAYGROUND OLMEHURST AVE.
32 Broadway, 8TH Fik New York, NY 10004 PLAYFUL LEARNING PLAYFUL LEARNING Philadelphia, PA 267.468.8610 ARBORIST: MORRIS ARBORETL 100 East Northwester Philadelphia, PA 1911 215.247.5777 ACCESSIBILITY CON CHRIS NOEL christopher.noel@par 646.632.7344 PLAY CONSULTANT STUDIO LUDO 1313 S 33rd St, Unit <i>A</i> Philadelphia, PA 1914 CONSULTANT PROJ CONSULTANT PROJ CONSULTANT PROJ PHILADEI PHILADEI PPR PROJECT NUM PROJECT TITLE: UN	oor CONSULTANT: LANDSCAPES ACTION N Avenue NSULTANT: ks.nyc.gov COF PHI LPHIA PARK 1515 ARC LOOR, ONE BER PENNYPA IVERSAL I RHAWN ST. & HO	2107 ILADELPHIA (S AND RECREATION CH STREET PARKWAY BUILDING 16-21-7062-07 ACK PARK PLAYGROUND
32 Broadway, 8TH Fik New York, NY 10004 PLAYFUL LEARNING PLAYFUL LEARNING Philadelphia, PA 267.468.8610 ARBORIST: MORRIS ARBORETL 100 East Northwester Philadelphia, PA 1911 215.247.5777 ACCESSIBILITY COL CHRIS NOEL christopher.noel@par 646.632.7344 PLAY CONSULTANT STUDIO LUDO 1313 S 33rd St, Unit A Philadelphia, PA 1914 CONSULTANT PROJ CONSULTANT PROJ CONSULTANT PROJ PHILADEI 11TH F PPR PROJECT NUM PROJECT TITLE: UN	oor S CONSULTANT: S LANDSCAPES ACTION P M n Avenue 18 NSULTANT: ks.nyc.gov : A 46 JECT NUMBER OF PHI LPHIA PARK 1515 ARC LOOR, ONE BER PENNYPA IVERSAL I RHAWN ST. & HO PHILADELP SITE EL	2107 ILADELPHIA S AND RECREATION CH STREET PARKWAY BUILDING 16-21-7062-07 ACK PARK PLAYGROUND OLMEHURST AVE. HIA, PA 19136 .ECTRICAL
32 Broadway, 8TH Fik New York, NY 10004 PLAYFUL LEARNING PLAYFUL LEARNING Philadelphia, PA 267.468.8610 ARBORIST: MORRIS ARBORETL 100 East Northwester Philadelphia, PA 1911 215.247.5777 ACCESSIBILITY COL CHRIS NOEL christopher.noel@par 646.632.7344 PLAY CONSULTANT STUDIO LUDO 1313 S 33rd St, Unit A Philadelphia, PA 1914 CONSULTANT PROJ CONSULTANT PROJ CONSULTANT PROJ PHILADEI 11TH F PPR PROJECT NUM PROJECT TITLE: UN	oor S CONSULTANT: S LANDSCAPES ACTION P M n Avenue 18 NSULTANT: ks.nyc.gov : A 46 JECT NUMBER OF PHI LPHIA PARK 1515 ARC LOOR, ONE BER PENNYPA IVERSAL I RHAWN ST. & HO PHILADELP SITE EL	2107 ILADELPHIA S AND RECREATION CH STREET PARKWAY BUILDING 16-21-7062-07 ACK PARK PLAYGROUND OLMEHURST AVE. HIA, PA 19136
32 Broadway, 8TH Flo New York, NY 10004 PLAYFUL LEARNING PLAYFUL LEARNING PHILAGEINA RBORIST: MORRIS ARBORETL 100 East Northwester Philadelphia, PA 1911 215.247.5777 ACCESSIBILITY COL CHRIS NOEL christopher.noel@par 646.632.7344 PLAY CONSULTANT STUDIO LUDO 1313 S 33rd St, Unit <i>A</i> Philadelphia, PA 1914 CONSULTANT PROJ CONSULTANT PROJ CONSULTANT PROJ PHILADEI 11TH F PPR PROJECT NUM PROJECT TITLE: UN F	oor S CONSULTANT: S LANDSCAPES ACTION P M n Avenue 18 NSULTANT: ks.nyc.gov : A 46 JECT NUMBER OF PHI LPHIA PARK 1515 ARC LOOR, ONE BER PENNYPA IVERSAL I RHAWN ST. & HO PHILADELP SITE EL	2107 ILADELPHIA S AND RECREATION CH STREET PARKWAY BUILDING 16-21-7062-07 ACK PARK PLAYGROUND OLMEHURST AVE. HIA, PA 19136 ECTRICAL AL NOTES
32 Broadway, 8TH FIR New York, NY 10004 PLAYFUL LEARNING PLAYFUL LEARNING Philadelphia, PA 267.468.8610 ARBORIST: MORRIS ARBORETL 100 East Northwester Philadelphia, PA 1911 215.247.5777 ACCESSIBILITY CON CHRIS NOEL christopher.noel@par 646.632.7344 PLAY CONSULTANT STUDIO LUDO 1313 S 33rd St, Unit <i>A</i> Philadelphia, PA 1914 CONSULTANT PROJ CONSULTANT PROJ CONSULTANT PROJ PHILADEI PHILADEI PR PROJECT NUM PROJECT TITLE: UN F DRAWING TITLE:	DOD S CONSULTANT: S LANDSCAPES ACTION I M n Avenue 18 NSULTANT: ks.nyc.gov : A A IECT NUMBER IECT NUMBER ISTIS ARCO LOOR, ONE BER PENNYPA ISTIS ARCO LOOR, ONE BER PENNYPA ISTIS ARCO LOOR, ONE BER PENNYPA ISTIS ARCO LOOR, ONE BER PENNYPA ISTIS ARCO LOOR, ONE BER PENNYPA ISTIS ARCO SITE EL GENER 16-21-7062 JECT NO.:	2107 ILADELPHIA S AND RECREATION CH STREET PARKWAY BUILDING 16-21-7062-07 ACK PARK PLAYGROUND OLMEHURST AVE. HIA, PA 19136 ECTRICAL AL NOTES
32 Broadway, 8TH FIR New York, NY 10004 PLAYFUL LEARNING PLAYFUL LEARNING Philadelphia, PA 267.468.8610 ARBORIST: MORRIS ARBORETL 100 East Northwester Philadelphia, PA 1911 215.247.5777 ACCESSIBILITY CON CHRIS NOEL christopher.noel@par 646.632.7344 PLAY CONSULTANT STUDIO LUDO 1313 S 33rd St, Unit <i>A</i> Philadelphia, PA 1914 CONSULTANT PROJ CONSULTANT PROJ PHILADEI PHILADEI DRAWING TITLE: UN F PPR PROJECT NO.: CONSULTANT PROJ DATE:	DOD S CONSULTANT: S LANDSCAPES ACTION I M n Avenue 18 NSULTANT: ks.nyc.gov : A A IECT NUMBER IECT NUMBER ISTIS ARCO LOOR, ONE BER PENNYPA ISTIS ARCO LOOR, ONE BER PENNYPA ISTIS ARCO LOOR, ONE BER PENNYPA ISTIS ARCO LOOR, ONE BER PENNYPA ISTIS ARCO LOOR, ONE BER PENNYPA ISTIS ARCO SITE EL GENER 16-21-7062 JECT NO.:	2107 ILADELPHIA S AND RECREATION CH STREET PARKWAY BUILDING 16-21-7062-07 ACK PARK PLAYGROUND OLMEHURST AVE. HIA, PA 19136 ECTRICAL AL NOTES
32 Broadway, 8TH Fik New York, NY 10004 PLAYFUL LEARNING PLAYFUL LEARNING Philadelphia, PA 267.468.8610 ARBORIST: MORRIS ARBORETL 100 East Northwester Philadelphia, PA 1911 215.247.5777 ACCESSIBILITY CON CHRIS NOEL christopher.noel@par 646.632.7344 PLAY CONSULTANT STUDIO LUDO CONSULTANT PROJ CONSULTANT PROJ CONSULTANT PROJ PHILADEI PPR PROJECT NUM PROJECT TITLE: UN F DRAWING TITLE: PPR PROJECT NO.: CONSULTANT PROJ DATE: SCALE:	DOT S CONSULTANT: S LANDSCAPES ACTION I M n Avenue 18 NSULTANT: ks.nyc.gov : A 16 IECT NUMBER OF PHI LPHIA PARK 1515 ARC LOOR, ONE BER PENNYPA ISTE EL GENER IVERSAL I RHAWN ST. & HO PHILADELPI SITE EL GENER 16-21-7062 IECT NO.: 2	2107 ILADELPHIA S AND RECREATION CH STREET PARKWAY BUILDING 16-21-7062-07 ACK PARK PLAYGROUND 0LMEHURST AVE. HIA, PA 19136 ECTRICAL AL NOTES ECTRICAL AL NOTES I DRAWING NO.: 2-01 DRAWING NO.: 2-01 SE-00
32 Broadway, 8TH Fik New York, NY 10004 PLAYFUL LEARNING PLAYFUL LEARNING Philadelphia, PA 267.468.8610 ARBORIST: MORRIS ARBORETL 100 East Northwester Philadelphia, PA 1911 215.247.5777 ACCESSIBILITY COL CHRIS NOEL christopher.noel@par 646.632.7344 PLAY CONSULTANT STUDIO LUDO 1313 S 33rd St, Unit A Philadelphia, PA 1914 CONSULTANT PROJ CONSULTANT PROJ CONSULTANT PROJ PHILADEI 11TH F PPR PROJECT NUM PROJECT TITLE: UN	DOD S CONSULTANT: S LANDSCAPES ACTION I M n Avenue 18 NSULTANT: ks.nyc.gov C OF PHI LPHIA PARK 1515 ARC LOOR, ONE BER PENNYPA ISTE EL GENER IVERSAL I RHAWN ST. & HO PHILADELPI SITE EL GENER 16-21-7062 JECT NO.: 2 12/15/20	2107 ILADELPHIA (S AND RECREATION CH STREET PARKWAY BUILDING 16-21-7062-07 ACK PARK PLAYGROUND OLMEHURST AVE. HIA, PA 19136 ECTRICAL AL NOTES 2-01 DRAWING NO.: 2-01 DRAWING NO.:

LIGHTING / SECURITY CAMERA NOTES

1. REFER TO E-001 FOR NOTES

- 2. CONTRACTOR TO TEST AND VERIFY THAT ALL LIGHTING CONTROLS ARE FUNCTIONAL
- 3. CONTRACTOR TO INCLUDE AN ALLOWANCE TO PROVIDE NEW CIRCUITING TO ALL LIGHT POLES
- 4. CONTRACTOR SHALL INCLUDE AN ALLOWANCE FOR ALL LIGHTING CONTROLS AS ONE TO ONE REPLACEMENTS, AS PER PPR LIGHTING CONTROL DESIGN STANDARDS
- 5. SECURITY CAMERA SHALL BE MOUNTED ON LIGHT POLES AS INDICATED ON THE DRAWINGS.
- 6. ALL SECURITY EQUIPMENT AND CAMERAS SHALL BE INSTALLED BY A CERTIFIED INSTALLER.
- 7. CERTIFIED INSTALLER SHALL AIM CAMERAS AND DEMONSTRATE TO THE OWNER COVERAGE, OPERABILITY AND TRAIN OWNER'S STAFF.
- 8. REFER TO SPECIFICATIONS SECTION 28 23 00 FOR CAMERA AND CABLING SPECIFICATIONS.
- 9. VIDEO SURVEILLANCE SYSTEM SHALL BE GENETEC STANDARD OMNICAST PACKAGE WITH SECURITY CENTER BASE PACKAGE, OR APPROVED EQUAL BY OTHERS. REFER TO SPEC SECTION FOR BASIS OF DESIGN.


PRODUCT CODES ARE AS FOLLOWS: BASE PACKAGE: GSC-BASE-5.10

- a. CLIENT & WEB CONNECTION: GSC-1STU
- b. MOBILE CONNECTION: GSC-1MOBILESTU
- c. FAILOVER DIRECTORY: GSC-1FOD
- d. CAMERA INTEGRITY MONITOR: GSC-OM-1CIM-5K (ONE PER CAMERA NEEDED)
- e. OMNICAST STANDARD BASE PACKAGE: GSC-OM-S
- f. CAMERA CONNECTION: GSC-OM-S-1C
- g. DEMO LICENSE: GSC-DEMO-ACCESSVIDEO
- h. SERVER: SEE SPECS ATTACHED
- WORKSTATION SEE SPECS ATTACHED


I. WORKSTATION. SEE SPECS ATTACHED						
SECURITY CAMERA SCHEDULE						
CODE	MANUFACTURER/ CATALOG NO.		NOTES			
	AXIS P3267-LVE DOME - P	OLE MOUNTED	REFER TO SPECIFICATION SECTION 28 23 00			
		A BY OTHERS				
		& CCTV SECURITY CONDUIT				
	0-	NEW LIGHTING PC	DLE			
		LIGHTING AND SW	/ITCHES WIRING			

SPRAYGROUND GROUNDING NOTES:

- 1. THE CONTRACTOR SHALL FURNISH AND INSTALL ALL GROUNDING AS REQUIRED TO MAKE A COMPLETE GROUNDING SYSTEM FOR SPRAY GROUND AS REQUIRED BY THE LATEST NATIONAL ELECTRICAL CODE (NFPA 70).
- 2. ALL PRODUCTS ASSOCIATED WITH THE GROUNDING SYSTEM SHALL BE UL-LISTED AND LABELED.
- 3. CONTRACTOR SHALL COORDINATE HIS WORK WITH THE PLUMBING AND GENERAL CONTRACTOR TO ENSURE THAT ALL PLUMBING WORK ARE COMPLETE PRIOR TO BEGINNING THE INSTALLATION OF GROUNDING PROTECTION COMPONENTS.

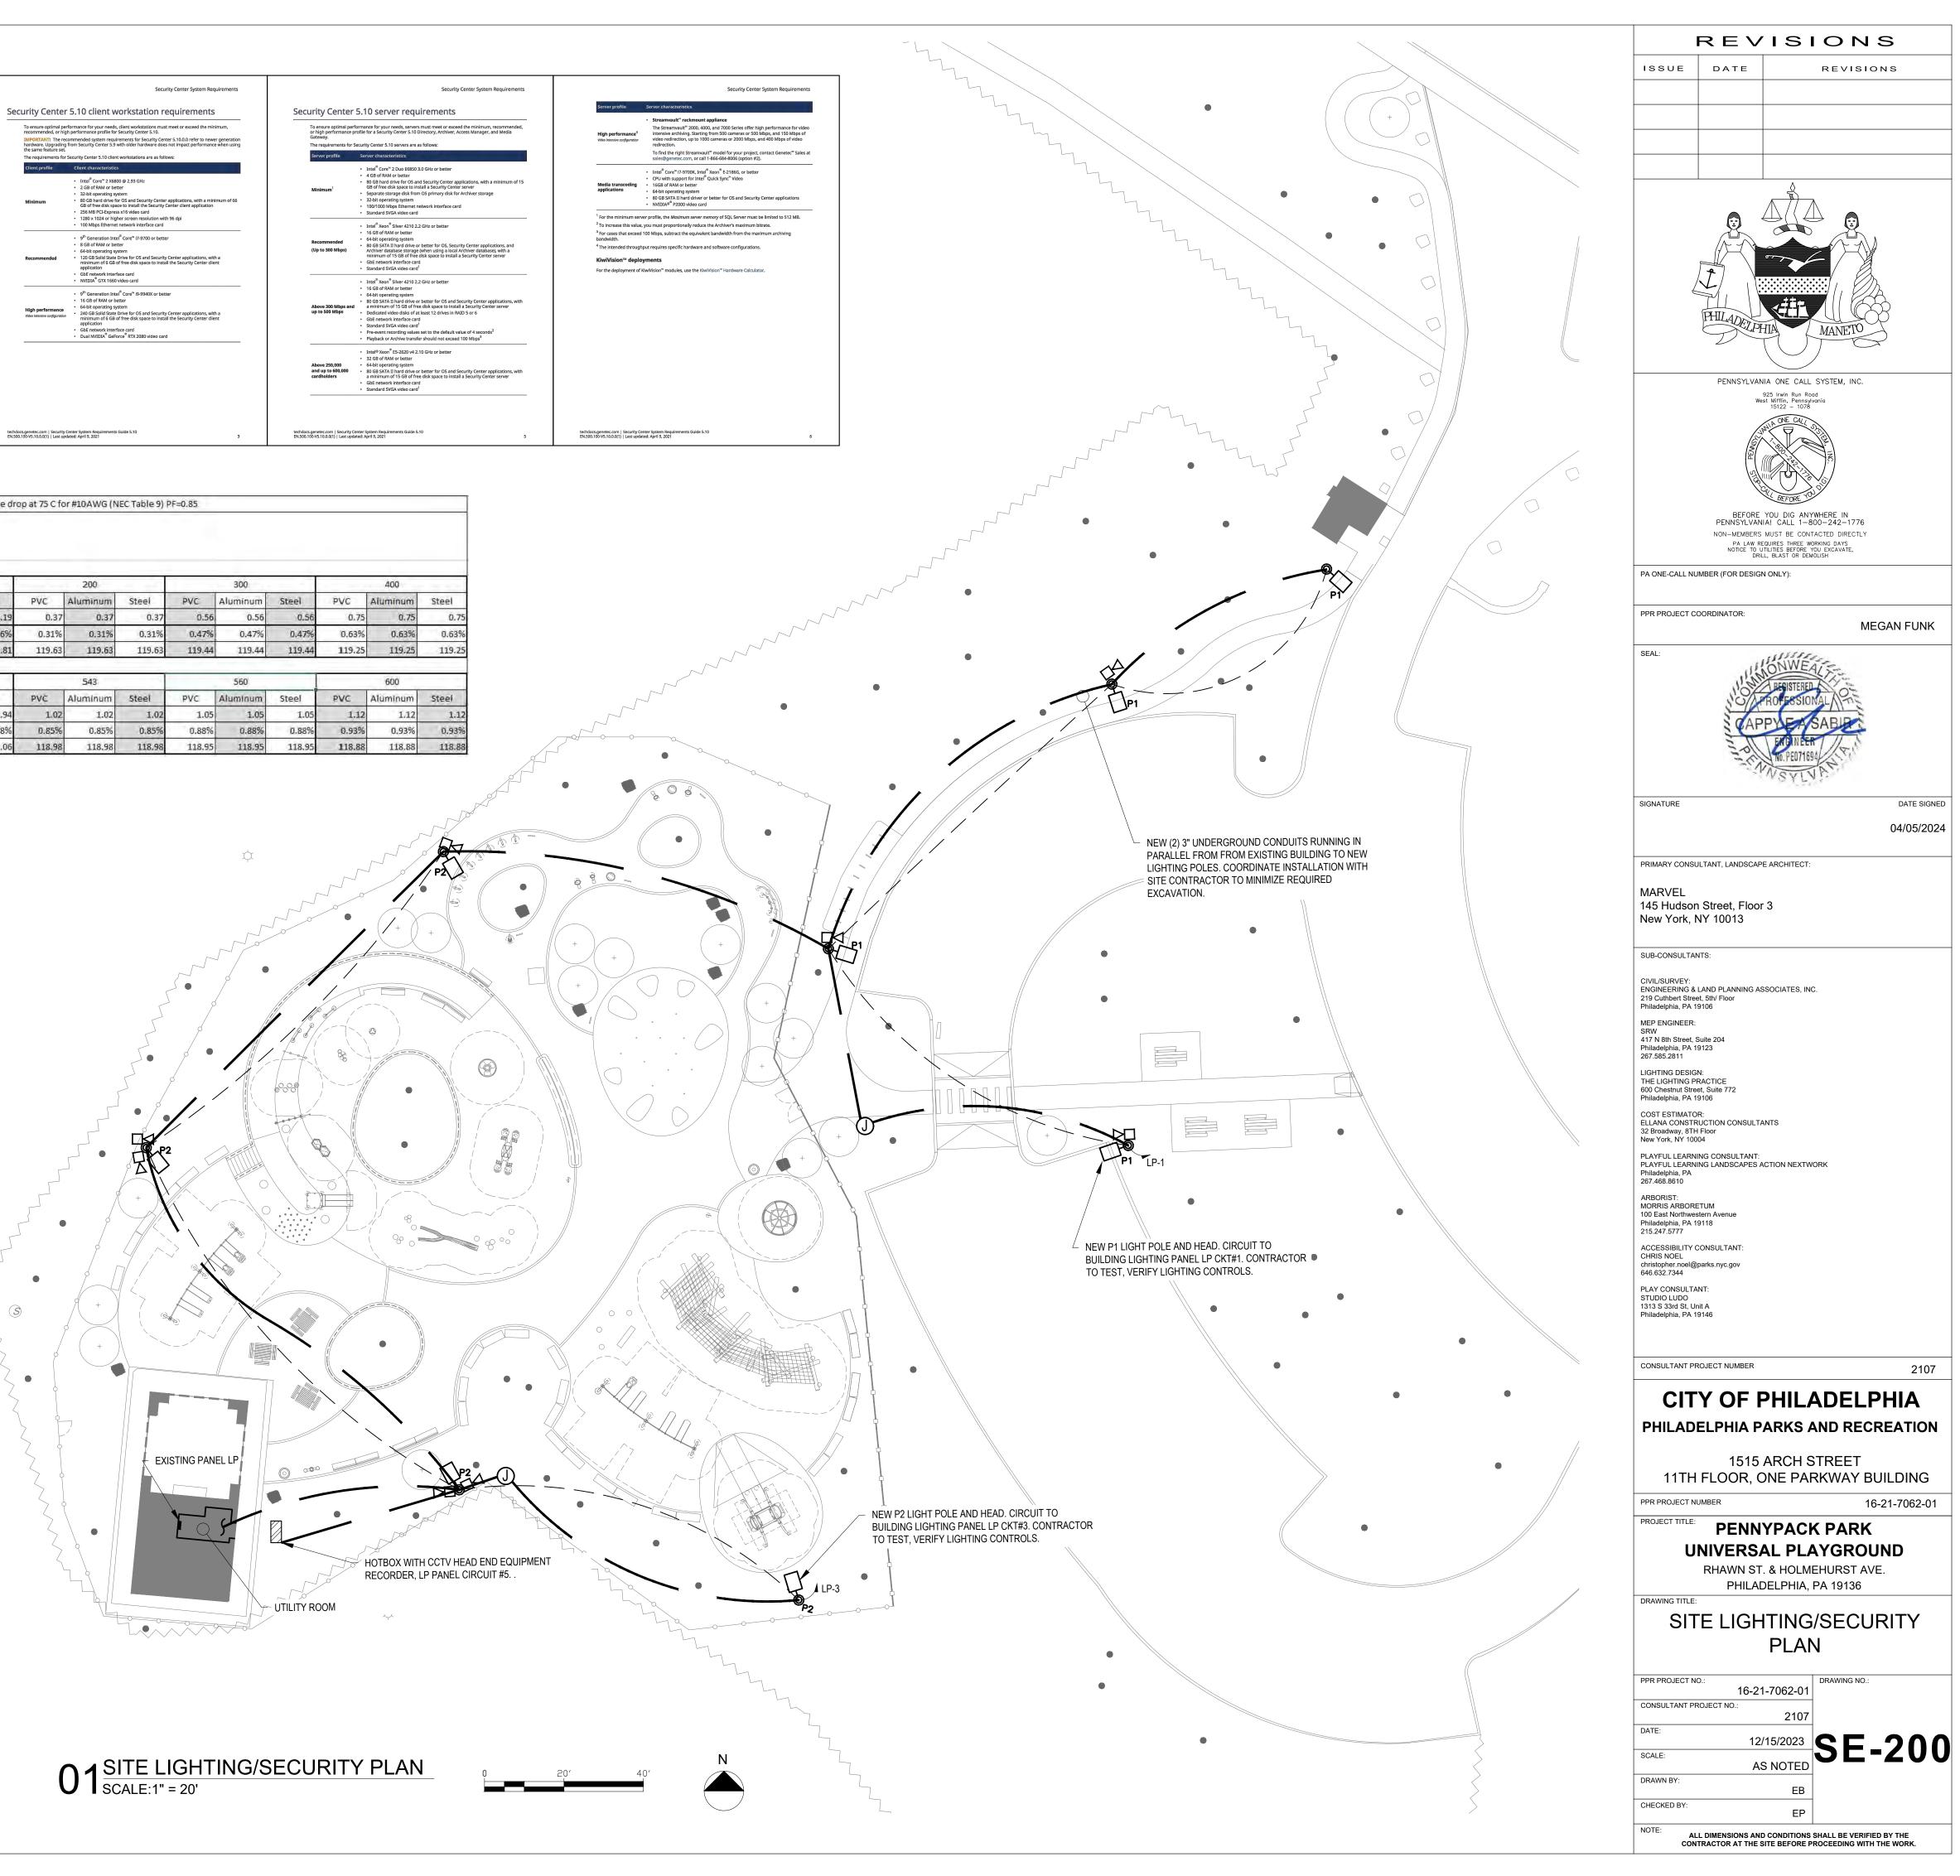

				Voltage dro	p at 75 C fo	or #10AWG (N	E
Voltage	120						
Phase	1						
Current draw (A)	0.85						
Parallel sets	1			- 1/2			
Run Length (ft)			100			200	
Conduit Material		PVC	Aluminum	Steel	PVC	Aluminum	
Voltage drop (V)		0.19	0.19	0,19	0.37	0.37	
Percentage drop		0.16%	0.16%	0.16%	0.31%	0.31%	1
End Voltage (V)		119.81	119.81	119.81	119.63	119.63	
Run Length (ft)		1	500	1		543	
Conduit Material		PVC	Aluminum	Steel	PVC	Aluminum	
Voltage drop (V)		0.94	0.94	0.94	1.02	1.02	
Percentage drop		0.78%	0.78%	0.78%	0.85%	0.85%	
End Voltage (V)		119.06	119.06	119.06	118.98	118.98	

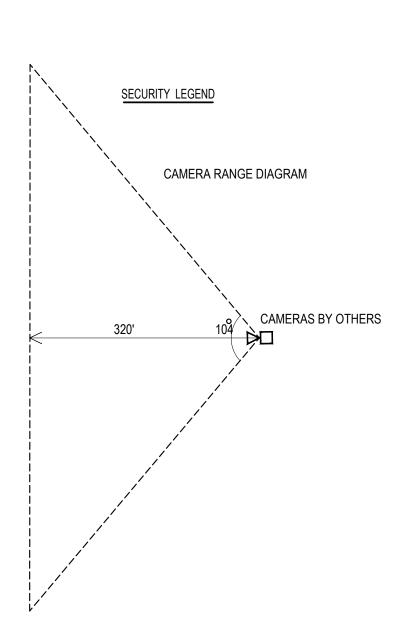

PLUMBING GENERAL NOTES - "A"

- 1. THE WORK INDICATED ON THESE DRAWINGS ARE DRAWN DIAGRAMMATIC AND ARE INTENDED TO INDICATE GENERAL ARRANGEMENT OF EQUIPMENT AND PIPING. THE CONTRACTOR MAY MAKE CHANGES WHEN APPROVED IN WRITING BY THE ARCHITECT/ENGINEER WITH NO ADDITIONAL COST.
- 2. THE CONTRACTOR SHALL PROVIDE NEW PLUMBING FIXTURES, PIPING, INSULATION, VALVES AN APPURTENANCES AS SHOWN ON THE DRAWINGS AND AS REQUIRED FOR A COMPLETE SYSTEM.
- 3. DURING CONSTRUCTION ALL OPEN ENDS OF PIPING SHALL BE PLUGGED AND CAPPED WITH
- PLASTIC OR METAL CAPS TO KEEP DIRT OUT OF THE SYSTEM.
- 4. NO DEAD ENDS SHALL BE LEFT ON ANY DRAINAGE PIPING UPON COMPLETION OF WORK.
- 5. UPON COMPLETION OF WORK THE ENTIRE SYSTEM SHALL BE LEFT IN PERFECT WORKING ORDER. 6. SUBMIT SHOP DRAWINGS SUFFICIENTLY IN ADVANCE OF THE WORK TO ALLOW PROPER TIME FO REVIEW. MATERIALS SHALL NOT BE FABRICATED OR DELIVERED TO THE SITE BEFORE THE SHOP DRAWINGS
- HAVE BEEN APPROVED. 7. NEW SHUT-OFF VALVES SHALL BE PROVIDED AS REQUIRED TO ISOLATE DIFFERENT AREAS OF THE PLUMBING SYSTEM.
- 8. VENT PIPE SHALL BE GRADED TO DRAIN OUT ALL MOISTURE AND PREVENT SCALE ACCUMULATION.
- 9. ALL VALVES AND SPECIALTIES SHALL BE SO PLACED AS TO PERMIT EASY OPERATION AND ACCESS.
- 10. PROVIDE CAULKING BETWEEN WATER CLOSETS AND FINISHED FLOOR AS REQUIRED.
- 11. FINAL INSPECTION AND TEST OF COMPLETED SYSTEM SHALL BE MADE IN THE PRESENCE OF THE OWNER'S REPRESENTATIVE. 12. THE CONTRACTOR SHALL INSULATE ALL HOT AND COLD DOMESTIC WATER PIPING LOCATED ABOVE
- CEILINGS AND IN WALLS AFTER TESTING THE SYSTEM. 13. BEFORE BEING PLACED IN SERVICE ALL POTABLE WATER PIPING SHALL BE CLEANED, FLUSHED AND
- DISINFECTED. 14. UPON COMPLETION OF WORK ALL EXCESS MATERIAL, DEBRIS, ETC, SHALL BE REMOVED AND WORK AREA LEFT CLEAN TO THE OWNER'S SATISFACTORY.
- 15. INSTALL ARROWS ON PIPING IN ACCESSIBLE AREAS TO INDICATE DIRECTION OF FLOW.
- 16. ALL CONSTRUCTION MATERIALS DISTURBED BY THIS CONTRACTOR SHALL BE REPLACED WITH NEW MATERIAL TO MATCH EXISTING.
- 17. WHEN THE NEW EQUIPMENT IS INSTALLED BY OTHERS, THE PLUMBING CONTRACTOR SHALL BE RESPONSIBLE FOR FURNISHING ALL NEW APPROPRIATE ROUGHING AND MAKING FINAL CONNECTIONS SUCH AS COLD AND HOT WATER, VENTS, GAS, ETC.
- 18. TESTING OF COMPLETE SYSTEM SHALL BE MADE IN THE PRESENCE OF OWNER'S REPRESENTATIVE AND THE AUTHORITIES HAVING JURISDICTION, AS REQUIRED BY LOCAL CODE.
- 19. IF INSPECTION OR TEST SHOW DEFECTS, SUCH DEFECTIVE WORK OR MATERIAL SHALL BE REPLACED AND INSPECTION AND TEST SHALL BE REPORTED. REPAIR TO PIPING SHALL BE MADE WITH NEW MATERIAL.
- 20. STANDARD FOR EQUIPMENT MANUFACTURER, MODEL AND CAPACITY OF EQUIPMENT OR FIXTURES ARE LISTED ON THE DRAWINGS OR IN SPECIFICATION. ANY OTHER MANUFACTURER OR MODELS ARE CONSIDERED TO BE SUBSTITUTIONS.
- 21. SUBSTITUTIONS ARE SUBJECT TO THE APPROVAL OF THE ENGINEER. IF A SUBSTITUTION IS SUBMITTED, IT IS THE CONTRACTOR'S RESPONSIBILITY TO EVALUATE IT AND CERTIFY THAT THE SUBSTITUTION IS EQUIVALENT IN ALL RESPECTS TO THE BASE SPECIFICATIONS.
- 22. IF SUBSTITUTION ARE APPROVED, NOTIFY ALL OTHER CONTRACTORS OR TRADES AFFECTED BY THE SUBSTITUTION AND FULLY COORDINATE. ANY COST RESULTING FROM SUBSTITUTION AND WHETHER BY CONTRACTOR OR OTHERS, SHALL BE THE RESPONSIBILITY OF AND PAID FOR BY SUBSTITUTION CONTRACTORS.
- 23. FIRE STOP ALL PENETRATIONS OF FIRE RATED CONSTRUCTION IN A CODE APPROVED MANNER IN ORDER TO MAINTAIN FIRE RATING. PROVIDE UL LISTED FIRE STOPPING.
- 24. FULLY WARRANTY ALL MATERIALS, EQUIPMENT AND WORKMANSHIP FOR ONE YEAR FROM DATE OF ACCEPTANCE.
- 25. REPAIR OR REPLACE WITHOUT CHARGE TO THE OWNER ALL ITEMS FOUND DEFECTIVE DURING THE WARRANTY PERIOD.
- 26. PIPING INSTALLED UNDER SLAB SHALL BE CAREFULLY LAID OR PLACED ON WELL PREPARED, TAMPED SOIL BED OF FINE CRUSHED STONE OR SAND TO FIT THE PIPE CONTOUR, WITH ALL VOID UNDER PIPE FILLED AND THOROUGHLY TAMPED PROVIDING FULL BARREL LENGTH SUPPORT.
- 27. INSTALL PIPE TO UNIFORM PITCHES BETWEEN POINTS FOR WHICH ELEVATIONS ARE ESTABLISHED OR SHALL BE VERIFIED BY USE OF LEVEL OR OTHER APPROVED METHOD. PIPE INVERT SHALL BE ADJUSTED BY THE ADDITION OR SUBTRACTION OF FULL BEDDING AND NOT BY WEDGING OR BLOCKING.
- 28. ACCESS DOORS SHALL BE PROVIDED, AS MINIMUM FOR: 1. CONCEALED VALVES.
- 2. CONCEALED SHOCK ABSORBERS.
- 3. CONCEALED AIR-POP CONNECTIONS. 4. CONCEALED TRAP PRIMER UNITS.
- 29. ACCESS DOOR SHALL BE FURNISHED BY THIS CONTRACTOR AND INSTALLED BY GENERAL CONTRACTOR. 30. CONTRACTOR SHALL SIZE ACCESS DOOR TO PERMIT REMOVAL AND SERVICING OF ALL EQUIPMENT, BUT IN ANY CASE, SHALL NOT BE LESS THAN 12"X16".
- 31. NOTES ON ANY DRAWING SHALL ALSO APPLY TO ALL OTHER CONTRACT DRAWINGS UNLESS OTHERWISE SPECIFIED.
- 32. ALL BRACKETS, PLATES, CHANNELS, ETC, SHALL BE GALVANIZED UNLESS OTHERWISE SPECIFIED.
- 33. ALL SURFACES DAMAGED IN THE COURSE OF THE WORK SHALL BE RESTORED TO THEIR ORIGINAL
- CONDITION AND IN A FULLY OPERABLE MANNER.
- 34. COORDINATE AND SCHEDULE ALL WORK TO MEET THE OVERALL DESIGN OBJECTIVE. 35. FOR ALL PIPES AND CONDUITS PASSING THROUGH WALL OR FLOORS, PROVIDE PIPE SLEEVES.
- 36. PROVIDE DRAIN VALVES AT ALL LOW POINTS.
- 37. CHANGES IN DIRECTION IN DRAINAGE PIPING SHALL BE MADE WITH APPROPRIATE USE OF 45 DEGREE WYES, LONG SWEEPS, QUARTER, SIXTH, EIGHTH, OR SIXTEENTH BENDS.
- 38. PROVIDE CLEANOUTS ON DRAIN LINES AS SHOWN ON DRAWINGS AND AS REQUIRED BY CODE.
- 39. CORE DRILLING FOR PENETRATION THROUGH FOUNDATION WALLS SHALL BE DONE BY PLUMBING CONTRACTOR.
- 40. CONTRACTOR SHALL NOT FASTEN ANY EQUIPMENT AND MATERIAL FROM ROOF DECKING. CONTRACTOR SHALL SUPPORT EQUIPMENT AND MATERIAL FROM BEAMS/JOISTS, IF NEED TO CONTRACTOR SHALL PROVIDE ADDITIONAL SUPPORT STEEL ON METAL TO ATTACH TO BEAMS.
- 41. ALL PLUMBING EQUIPMENT SHALL BE INSTALLED AND ADJUSTED IN ACCORDANCE WITH THE MANUFACTURER'S RECOMMENDATION UNLESS OTHERWISE SHOWN.

EXCEPTION: PROVIDE 1/2" INSULATION FOR ALL COLD WATER PIPES

42. ALL GALVANIZED PARTS SHALL BE PAINTED PER SPECIFICATIONS BY THE PLUMBING CONTRACTOR. 43. ALL PIPES 1.5" IN DIAMETER AND SMALLER SHALL HAVE A MINIMUM OF 1" INSULATION. PIPES LARGER THAN 1.5" IN DIAMETER SHALL HAVE A MINIMUM OF 1.5" OF INSULATION.

PHILADELPHIA DEPARTMENT OF

THE PLUMBING SYSTEMS (SANITARY GAS) AND ALL ASSOCIATED EQUIPME MAINTAINED IN ACCORDANCE WITH BUILDING CODE OF THE CITY OF PHIL THE IBC FUEL GAS CODE AND APPLIC

- 1. MATERIALS, INSTALLATIONS, SU COMPLIANCE WITH SECTIOR-30
- 2. THE TESTING AND INSPECTION OF PIPING AND INSTALLATIONS WILL BE IN FULLACCORDANCE WITH CHAPTER 15
- 3. THE INSTALLATION OF FIXTURES WILL BE IN FULL ACCORDANCE OF ALL APPLICABLE SECTIONS OF CHAPTER 7 OF THE PLUMBING CODE.
- 4. THE INSTALLATION OF WATER HEATERS WILL BE IN FULL ACCORDANCE OF ALLAPPLICABLE SECTIONS OF CHAPTER 8 OF THE PLUMBING CODE.
- 5. THE WATER SUPPLY SYSTEMS OF THE SUBJECT BUILDING SHALL BE INSTALLED ANDMAINTAINED IN FULL COMPLIANCE WITH ALL APPLICABLE SECTIONS OFTHE PLUMBING CODE.
- 6. THE SANITARY DRAINAGE SYSTEM WILL BE SIZED AND INSTALLED IN FULCOMPLIANCE WITH ALL APPLICABLE SECTIONS OF CHAPTER 9 OF THE PLUMBINGCODE.
- 7.
- SECTIONS OF CHAPTER 11 OF THE PLUMBING CODE.
- 9.
- OF THELUMBING CODE.
- AS PER SECTIONP-718.

PLUMBING GENERAL NOTES - "B"

1. ALL EXPOSED PIPES SHALL BE ARRANGED TO PERMIT ACCESS FOR MAINTENANCE.

- 2. ALL DRAIN AND VENT PIPES SHALL HAVE A MINIMUM SLOPE OF 1/8" PER FOOT.
- CONTRACTOR FOR POWER SUPPLY.
- 5. COORDINATE SLOPING OF FLOORS TO FLOOR DRAINS.
- WITH INSTALLATION.
- 7. THE CONTRACTOR SHALL REPAIR AT OWN OF THE DEFECTED EQUIPMENT OR MATERIAL.
- PIPING.
- ADDITIONAL COST TO THE OWNER.

	PIPE MA	ATERIA	L SCH	EDULE	-	
SERVICE	MAXIMUM	PIPE	MATERIA		COUPLING	JOINTS
SLIVICL	PRESSURE	CI	COP	STL	(4 BANDS)	3011113
DOMESTIC WATER	125 PSI		х			BRAZED
SANITARY WASTE	10" W.C.	Х			Х	NO HUB
SANITARY VENT		Х			Х	NO HUB

PIPING	INSULATION SCHEDULE	
PIPING SYSTEM	PIPE SIZE	INSULATION MINIMUM THICKNESS, INCHES
DOMESTIC COLD AND GREY WATER	UP TO 6 INCHES	1.0
	8 INCHES AND LARGER	1.0
FLOOR DRAIN RECEIVING CONDENSATE/ WASTE FROM HVAC COOLING EQUIPMENT, PLUS 15 FEET OF ASSOCIATED DOWNSTREAM DRAIN PIPING.	ALL	1.0
LAVATORY WASTE PIPING, EXPOSED UNDER FIXTURES FOR THE DISABLED	ALL	0.5

	F	PLUMBING DRAWING LIST
F LICENSE & INSPECTION	SP-001	SITE PLUMBING GENERAL NOTES
RY, VENT, WATER DISTRIBUTION AND MENT WILL BE INSTALLED AND I THE FULL REQUIREMENTS OF THE	SP-100	SITE PLUMBING PLAN
HILADELPHIA, THE PHILADELPHIA PLUMBING CODE, LICABLE LOCAL LAWS.	SP-200	SITE PLUMBING DETAILS
SUPPORT, ETC WILL BE FULL		
301 TO 305		

	EVIATIONS & S	
SYMBOL	ABBREVIATIO SAN/W/S	
	V	SANITARY/WASTE/SOIL PIPING VENT PIPING
	CW	COLD WATER PIPING
	HW	HOT WATER PIPING
	HWR	HOT WATER RETURN PIPING
		EXISTING PIPING
	0000	
©	CODP	
 &	CV	
<u> </u>		CHECK VALVE
—— I	C0DP	CLEANOUT DECK PLATE
\bullet		NEW PIPING CONNECT TO EXISTING
	H&CW	HOT & COLD WATER
	EX or EXIST	EXISTING
a X		SOLENOID VALVE WITH TIMER
T		TIMER
		PIPE REDUCER
	SS	SERVICE SINK
	DF	DRINKING FOUNTAIN
	HB	HOSE BIBB
	BFP	BACKFLOW PREVENTER
	RPV	PRESSURE REDUCING VALVE
	WH	WATER HEATER
	FD	FLOOR DRAIN
	CI	CAST IRON
	COP	COPPER
	STL	STEEL

		PL	UMBING FIXTURE SCH	EDUL	Ε				
FIXTURE		DESCRIPTIO	N		SERVIC	E CONNEC	TION		REMARKS
TYPE	FIXTURE	MANUFACTURER	MODEL & NUMBER	S	W	V	CW	HW	
DF	DRINKING FOUNTAIN	ELKAY	LK4430BF1U	-	2"	1 1/2"	1⁄2"	-	OUTDOOR INSTALLATION

					PUMPS SCHE	EDU	ILE				
TAG	DESIGNATION	No. REQUIRED	GPM	TDH , FEET	MODEL NO. (BASED ON)	H.P.	R.P.M.	VOLTS	PHASE	CYCLE	EFFICIENCY
SGP	SPRAY GROUND BOOSTER PUMP	1	81	104	TACO 1900 SERIES, MODEL 1915	3	3500	115	1	60	54

2. COORDINATE ALL POWER REQUIREMENTS, CONTROLS & CONTROL WIRING OF AQUASTAT WITH THE ELECTRICAL CONTRACTOR. 3. PROVIDE BALL VALVE ISOLATION FLANGES AS MANUFACTURED BY BELL AND GOSSETT.

ENERGY CODE NOTES

1. ALL PIPING IN CIRCULATING SYSTEM IS INSULATED. 1.5" FOR

- PIPES <= 1.5" AND 2" FOR PIPES > 1.5".
- 2. OPERATION AND MAINTENANCE MANUAL SHALL BE PROVIDED TO BUILDING OWNER 3. AUTOMATIC CONTROLS FOR FREEZE PROTECTION SYSTEMS SHALL BE PRESENT.
- 4. AUTOMATIC TIME SWITCHES SHALL BE INSTALLED TO AUTOMATICALLY SWITCH
- OFF THE RECIRCULATING HOT-WATER SYSTEM. 5. PIPING FLUIDS ABOVE 105 DEGREES AND BELOW 55 DEGREES
- SHALL HAVE A MINIMUM OF R-3 INSULATION
- 6. DOMESTIC WATER HEATER MEETS MINIMUM 95% EFFICIENCY REQUIREMENTS: 7. ALL PIPING IN DOMESTIC HOT AND COLD WATER SYSTEM IS INSULATED. 1.5" FOR PIPES <= 1.5" AND 2" FOR PIPES > 1.5".

THIS PLAN IS APPROVED FOR WORK INDICATED ON THE APPLICATION SPECIFICATION SHEET. ALL OTHER MATTERS SHOWN ARE NOT TO BE RELIED UPON TO BE CONSIDERED AS EITHER BEING APPROVED OR IN

THIS PLAN IS APPROVED FOR WORK INDICATED ON THE APPLICATION SPECIFICATION SHEET. ALL OTHER MATTERS SHOWN ARE NOT TO BE RELIED UPON TO BE CONSIDERED AS EITHER BEING APPROVED OR IN ACCORDANCE WITH APPLICABLE CODES.

ANY INDIRECT/SPECIAL WASTES WILL BE SIZED AND INSTALLED IN FULL COMPLIANCEALL APPLICABLE SECTIONS OF CHAPTER 12 OF THE PLUMBING CODE.

THE VENT PIPING FOR THE SANITARY DRAINAGE SYSTEM OF THE SUBJECT BUILDINGWILL BE INSTALLED IN FULL COMPLIANCE WITH ALL APPLICABLE

TRAPS/INTERCEPTOR INSTALLED WITHIN THE SANITARY DRAINAGE SYSTEM OF THE SUBJECT BUILDING WILL BE INSTALLED IN FULL COMPLIANCE WITH ALL APPLICABLE SECTIONS OF CHAPTERS 9 & 11 OF THE PLUMBING CODE. 10. THE STORM DRAINAGE SYSTEM OF THE SUBJECT BUILDING WILL BE INSTALLED IN FULL COMPLIANCE WITH ALL APPLICABLE SECTIONS OF CHAPTER 10

11. TEMPORARY TOILET FACILITIES SHALL BE PROVIDED FOR WORKMAN

3. ALL COLD WATER PIPES OUTSIDE THE HEATED STRUCTURES LESS THAN 4'-6" BELOW GRADE OR

SUBJECT TO FREEZING SHALL BE INSULATED AND HEAT TRACED. COORDINATE WITH ELECTRICAL

4. COORDINATE WORK SHOWN ON THESE DRAWINGS WITH OTHER DRAWINGS.

6. THE CONTRACTOR SHALL FOLLOW DRAWINGS IN LAYING OUT WORK AND CHECK THE DRAWINGS OF THE OTHER TRADES TO VERIFY WHICH WORK WILL BE INSTALLED FIRST BEFORE PROCEEDING


EXPENSE ANY PIECE OF EQUIPMENT AND /OR MATERIAL WHICH IS FOUND TO BE DEFECTIVE. THE REPLACEMENT OR REPAIR SHALL BE DONE AS SOON AS NOTIFIED. THE CONTRACTOR SHALL ALSO REPAIR ALL DAMAGES TO SURROUNDING WORK CAUSED BY FAILURE OF REPAIR OR REPLACEMENT

8. MINIMUM PITCH FOR SANITARY WASTE AND STORM DRAINAGE LINES SHALL BE 1/8 INCH PER FOOT.


9. RECORD DRAWINGS SHALL BE PREPARED BY CONTRACTOR AND SHALL INDICATE THE ACTUAL INSTALLED LOCATION OF ALL PIPING AND VALVES INCLUDING INVERT ELEVATION FOR UNDERSLAB

10. THE CONTRACTOR SHALL GIVE ALL NECESSARY NOTICES, OBTAIN ALL PERMITS AND PAY ALL


GOVERNMENT SALES TAXES, FEES AND OTHER COST INCLUDING UTILITY CONNECTIONS COST. 11. IT IS NOT POSSIBLE TO INDICATE ALL OFFSETS, FITTINGS AND ACCESSORIES THAT MAY BE REQUIRED. CONTRACTOR SHALL MAKE ALL NECESSARY OFFSETS, FITTINGS AND ACCESSORIES AS REQUIRED WITH NO

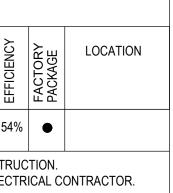

ISSUE	DATE	Р	
		KI	EVISIONS
	PHILADELPHIA	\bigcup	NETO NETO
PA ONE-CALL NU	925 West MI 15 West MI 15 West MI BEFORE YOU PENNSYLVANIA! NON-MEMBERS MUS PA LAW REQUIR NOTCE TO UTILIT	Irwin Run Road Ifflin, Pennsylvania 122 - 1078 ONE CAL DIG ANYWHER CALL 1-800-2: ST BE CONTACTED ESTHREE WORKING ES BEFORE YOU EXCLANT	E IN 42-1776 DIRECTLY DAYS
PPR PROJECT CC	DORDINATOR:		MEGAN FUNK
SEAL:	CAPP'	NWEALS HERISTERED HERI	A CHARTER AND A
SIGNATURE			DATE SIGNE 04/05/202
PRIMARY CONSU	LTANT, LANDSCAPE AF	RCHITECT:	
219 Cuthbert Stree Philadelphia, PA 19 MEP ENGINEER:	ITS: LAND PLANNING ASSO t, 5th/ Floor	CIATES, INC.	
SRW			
417 N 8th Street, S Philadelphia, PA 19 267.585.2811 LIGHTING DESIGN THE LIGHTING PF 600 Chestnut Stree Philadelphia, PA 19	RACTICE et, Suite 772		
417 N 8th Street, S Philadelphia, PA 15 267.585.2811 LIGHTING DESIGN THE LIGHTING PF 600 Chestnut Street Philadelphia, PA 15 COST ESTIMATOF ELLANA CONSTR 32 Broadway, 8TH	RACTICE at, Suite 772 9106 R: UCTION CONSULTANTS Floor	5	
417 N 8th Street, S Philadelphia, PA 15 267.585.2811 LIGHTING DESIGN THE LIGHTING PF 600 Chestnut Stree Philadelphia, PA 19 COST ESTIMATOF ELLANA CONSTR 32 Broadway, 8TH New York, NY 1000 PLAYFUL LEARNII Philadelphia, PA 267.468.8610	RACTICE at, Suite 772 9106 R: UCTION CONSULTANTS Floor		
417 N 8th Street, S Philadelphia, PA 15 267.585.2811 LIGHTING DESIGN THE LIGHTING PE 600 Chestnut Stree Philadelphia, PA 15 COST ESTIMATOF ELLANA CONSTRI 32 Broadway, 8TH New York, NY 1000 PLAYFUL LEARNII Philadelphia, PA 267.468.8610 ARBORIST: MORRIS ARBORE 100 East Northwes Philadelphia, PA 15 215.247.5777	RACTICE et, Suite 772 9106 R: UCTION CONSULTANTS Floor D4 NG CONSULTANT: NG LANDSCAPES ACTI- STUM tern Avenue 9118		
417 N 8th Street, S Philadelphia, PA 15 267.585.2811 LIGHTING DESIGN THE LIGHTING PF 600 Chestnut Street Philadelphia, PA 15 COST ESTIMATOF ELLANA CONSTR 32 Broadway, 8TH New York, NY 1000 PLAYFUL LEARNII Philadelphia, PA 267.468.8610 ARBORIST: MORRIS ARBORE 100 East Northwes Philadelphia, PA 15	RACTICE et, Suite 772 9106 R: UCTION CONSULTANTS Floor 04 NG CONSULTANT: NG LANDSCAPES ACTION TUM tern Avenue 9118 CONSULTANT:		
417 N 8th Street, S Philadelphia, PA 15 267.585.2811 LIGHTING DESIGN THE LIGHTING PF 600 Chestnut Street Philadelphia, PA 15 COST ESTIMATOF ELLANA CONSTRI 32 Broadway, 8TH New York, NY 1000 PLAYFUL LEARNII PLAYFUL LEARNII Philadelphia, PA 267.468.8610 ARBORIST: MORRIS ARBORE 100 East Northwes Philadelphia, PA 15 215.247.5777 ACCESSIBILITY C CHRIS NOEL christopher.noel@g	RACTICE et, Suite 772 9106 R: UCTION CONSULTANTS Floor 04 NG CONSULTANT: NG LANDSCAPES ACTI- STUM tern Avenue 9118 CONSULTANT: parks.nyc.gov NT: it A		
417 N 8th Street, S Philadelphia, PA 15 267.585.2811 LIGHTING DESIGN THE LIGHTING PE 600 Chestnut Stree Philadelphia, PA 19 COST ESTIMATOF ELLANA CONSTR 32 Broadway, 8TH New York, NY 1000 PLAYFUL LEARNII Philadelphia, PA 19 267.468.8610 ARBORIST: MORRIS ARBORE 100 East Northwes Philadelphia, PA 15 215.247.5777 ACCESSIBILITY C CHRIS NOEL christopher.noel@p 646.632.7344	RACTICE et, Suite 772 9106 R: UCTION CONSULTANTS Floor 04 NG CONSULTANT: NG LANDSCAPES ACTI STUM tern Avenue 9118 CONSULTANT: parks.nyc.gov NT: it A 9146		2107
417 N 8th Street, S Philadelphia, PA 15 267.585.2811 LIGHTING DESIGN THE LIGHTING PF 600 Chestnut Street Philadelphia, PA 15 COST ESTIMATOF ELLANA CONSTR 32 Broadway, 8TH New York, NY 1000 PLAYFUL LEARNII PLAYFUL LEARNII PLAYFUL LEARNII PLAYFUL LEARNII PLAYFUL LEARNII Philadelphia, PA 267.468.8610 ARBORIST: MORRIS ARBORE 100 East Northwes Philadelphia, PA 255.247.5777 ACCESSIBILITY C CHRIS NOEL christopher.noel@p 646.632.7344 PLAY CONSULTAI STUDIO LUDO 1313 S 33rd St, Un Philadelphia, PA 15 CONSULTANT PR	RACTICE et, Suite 772 9106 R: UCTION CONSULTANTS Floor 04 NG CONSULTANT: NG LANDSCAPES ACTI STUM tern Avenue 9118 CONSULTANT: Darks.nyc.gov NT: it A 9146 COJECT NUMBER	ON NEXTWORK	ELPHIA
417 N 8th Street, S Philadelphia, PA 15 267.585.2811 LIGHTING DESIGN THE LIGHTING PF 600 Chestnut Stree Philadelphia, PA 19 COST ESTIMATOF ELLANA CONSTR 32 Broadway, 8TH New York, NY 1000 PLAYFUL LEARNII Philadelphia, PA 19 267.468.8610 ARBORIST: MORRIS ARBORE 100 East Northwes Philadelphia, PA 19 215.247.5777 ACCESSIBILITY C CHRIS NOEL christopher.noel@p 646.632.7344 PLAY CONSULTAI STUDIO LUDO 1313 S 33rd St, UN Philadelphia, PA 19 CONSULTANT PR CONSULTANT PR	RACTICE et, Suite 772 P106 R: UCTION CONSULTANTS Floor D4 NG CONSULTANT: NG LANDSCAPES ACTION STUM tern Avenue P118 CONSULTANT: Darks.nyc.gov NT: iit A P146 COJECT NUMBER Y OF PI ELPHIA PAI STI5 AF FLOOR, ON	ON NEXTWORK	ELPHIA
417 N 8th Street, S Philadelphia, PA 15 267.585.2811 LIGHTING DESIGN THE LIGHTING PE 600 Chestnut Stree Philadelphia, PA 13 COST ESTIMATOF ELLANA CONSTR 32 Broadway, 8TH New York, NY 1000 PLAYFUL LEARNII Philadelphia, PA 13 267.468.8610 ARBORIST: MORRIS ARBORE 100 East Northwes Philadelphia, PA 15 215.247.5777 ACCESSIBILITY C CHRIS NOEL christopher.noel@p 646.632.7344 PLAY CONSULTAI STUDIO LUDO 1313 S 33rd St, Un Philadelphia, PA 15 CONSULTANT PR CONSULTANT PR CONSULTANT PR CONSULTANT PR PHILADI DI DI TITH	RACTICE et, Suite 772 P106 R: UCTION CONSULTANTS Floor D4 NG CONSULTANT: NG LANDSCAPES ACTION SCONSULTANT: D3146 CONSULTANT: CONSULTANT: D3146 CONSULTANT: C	ON NEXTWORK	DELPHIA DRECREATION EET VAY BUILDING 16-21-7062-01 PARK GROUND IRST AVE.
417 N 8th Street, S Philadelphia, PA 15 267.585.2811 LIGHTING DESIGN THE LIGHTING PF 600 Chestnul Stree Philadelphia, PA 19 COST ESTIMATOF ELLANA CONSTR 32 Broadway, 8TH New York, NY 1000 PLAYFUL LEARNII PLAYFUL LEARNII Philadelphia, PA 26 7.468.8610 ARBORIST: MORRIS ARBORE 100 East Northwes Philadelphia, PA 19 215.247.5777 ACCESSIBILITY C CHRIS NOEL christopher.noel@p 646.632.7344 PLAY CONSULTAI STUDIO LUDO 1313 S 337 dSt, UN Philadelphia, PA 19 CONSULTANT PR CONSULTANT PR CONSULTANT PR PHILADIE PHILADIE UI PROJECT TITLE: UI	RACTICE at, Suite 772 P106 R: UCTION CONSULTANTS Floor D4 NG CONSULTANT: NG LANDSCAPES ACTIV TUM tern Avenue P118 CONSULTANT: Darks.nyc.gov NT: it A P146 COJECT NUMBER Y OF PI ELPHIA PAI 1515 AF FLOOR, ON JMBER PENNYI NIVERSAL RHAWN ST. & PHILADEI SITE PLUN	ON NEXTWORK	DELPHIA DRECREATION EET VAY BUILDING 16-21-7062-01 PARK GROUND IRST AVE. 19136
417 N 8th Street, S Philadelphia, PA 15 267.585.2811 LIGHTING DESIGN THE LIGHTING PF 600 Chestnul Stree Philadelphia, PA 19 COST ESTIMATOF ELLANA CONSTR 32 Broadway, 8TH New York, NY 1000 PLAYFUL LEARNII PLAYFUL LEARNII Philadelphia, PA 26 7.468.8610 ARBORIST: MORRIS ARBORE 100 East Northwes Philadelphia, PA 19 215.247.5777 ACCESSIBILITY C CHRIS NOEL christopher.noel@p 646.632.7344 PLAY CONSULTAI STUDIO LUDO 1313 S 337 dSt, UN Philadelphia, PA 19 CONSULTANT PR CONSULTANT PR CONSULTANT PR PHILADIE PHILADIE PROJECT TITLE: UI DRAWING TITLE:	RACTICE et, Suite 772 9106 R: UCTION CONSULTANTS Floor 04 NG CONSULTANT: NG LANDSCAPES ACTI- TUM tern Avenue 9118 CONSULTANT: Darks.nyc.gov NT: it A 9146 COJECT NUMBER Y OF PI ELPHIA PAI T515 AF FLOOR, ON JMBER PENNYI NIVERSAL RHAWN ST. & PHILADEI SITE PLUN NIVERSAL	ON NEXTWORK	DELPHIA DRECREATION EET VAY BUILDING 16-21-7062-01 PARK GROUND IRST AVE. 19136
417 N 8th Street, S Philadelphia, PA 15 267.585.2811 LIGHTING DESIGN THE LIGHTING PF 600 Chestnut Stree Philadelphia, PA 13 COST ESTIMATOF ELLANA CONSTRI 32 Broadway, 8TH New York, NY 1000 PLAYFUL LEARNII Philadelphia, PA 13 267.468.8610 ARBORIST: MORRIS ARBORE 100 East Northwes Philadelphia, PA 15 215.247.5777 ACCESSIBILITY C CHRIS NOEL christopher.noel@p 646.632.7344 PLAY CONSULTAI STUDIO LUDO 1313 S 33rd St, Un Philadelphia, PA 15 CONSULTANT PR CONSULTANT PR CONSULTANT PR I 11TH PPR PROJECT NU PROJECT TITLE: UI DRAWING TITLE:	RACTICE et, Suite 772 9106 R: UCTION CONSULTANTS Floor D4 NG CONSULTANT: NG LANDSCAPES ACTI- TUM tern Avenue 9118 CONSULTANT: Darks.nyc.gov NT: it A 9146 COJECT NUMBER Y OF PI ELPHIA PAI 1515 AF FLOOR, ON JMBER PENNYI NIVERSAL RHAWN ST. & PHILADEI SITE PLUN N C: 16-21-7	ON NEXTWORK	DELPHIA DECREATION EET VAY BUILDING 16-21-7062-01 PARK GROUND RST AVE. 19136 DENERAL
417 N 8th Street, S Philadelphia, PA 15 267.585.2811 LIGHTING DESIGN THE LIGHTING PF 600 Chestnut Street Philadelphia, PA 13 COST ESTIMATOF ELLANA CONSTRI 32 Broadway, 8TH New York, NY 1000 PLAYFUL LEARNII Philadelphia, PA 13 267.468.8610 ARBORIST: MORRIS ARBORET 100 East Northwes Philadelphia, PA 15 215.247.5777 ACCESSIBILITY C CHRIS NOEL christopher.noel@r 646.632.7344 PLAY CONSULTANT PR CONSULTANT PR CONSULTANT PR DEATON UDO 1313 S 33rd St, Un Philadelphia, PA 15 CONSULTANT PR DEATON UDO 1313 S 33rd St, Un Philadelphia, PA 15 CONSULTANT PR CONSULTANT PR DRAWING TITLE: S PPR PROJECT NC CONSULTANT PR	RACTICE et, Suite 772 P106 R: UCTION CONSULTANTS Floor D4 NG CONSULTANT: NG LANDSCAPES ACTION TUM tern Avenue P118 CONSULTANT: Darks.nyc.gov NT: it A P146 COJECT NUMBER Y OF PI ELPHIA PAI 1515 AF FLOOR, ON JMBER PENNYI NIVERSAL RHAWN ST. & PHILADEI SITE PLUN N D:: 16-21-7 COJECT NO.: 12/15	ON NEXTWORK	DELPHIA RECREATION EET VAY BUILDING 16-21-7062-01 PARK GROUND IRST AVE. 19136

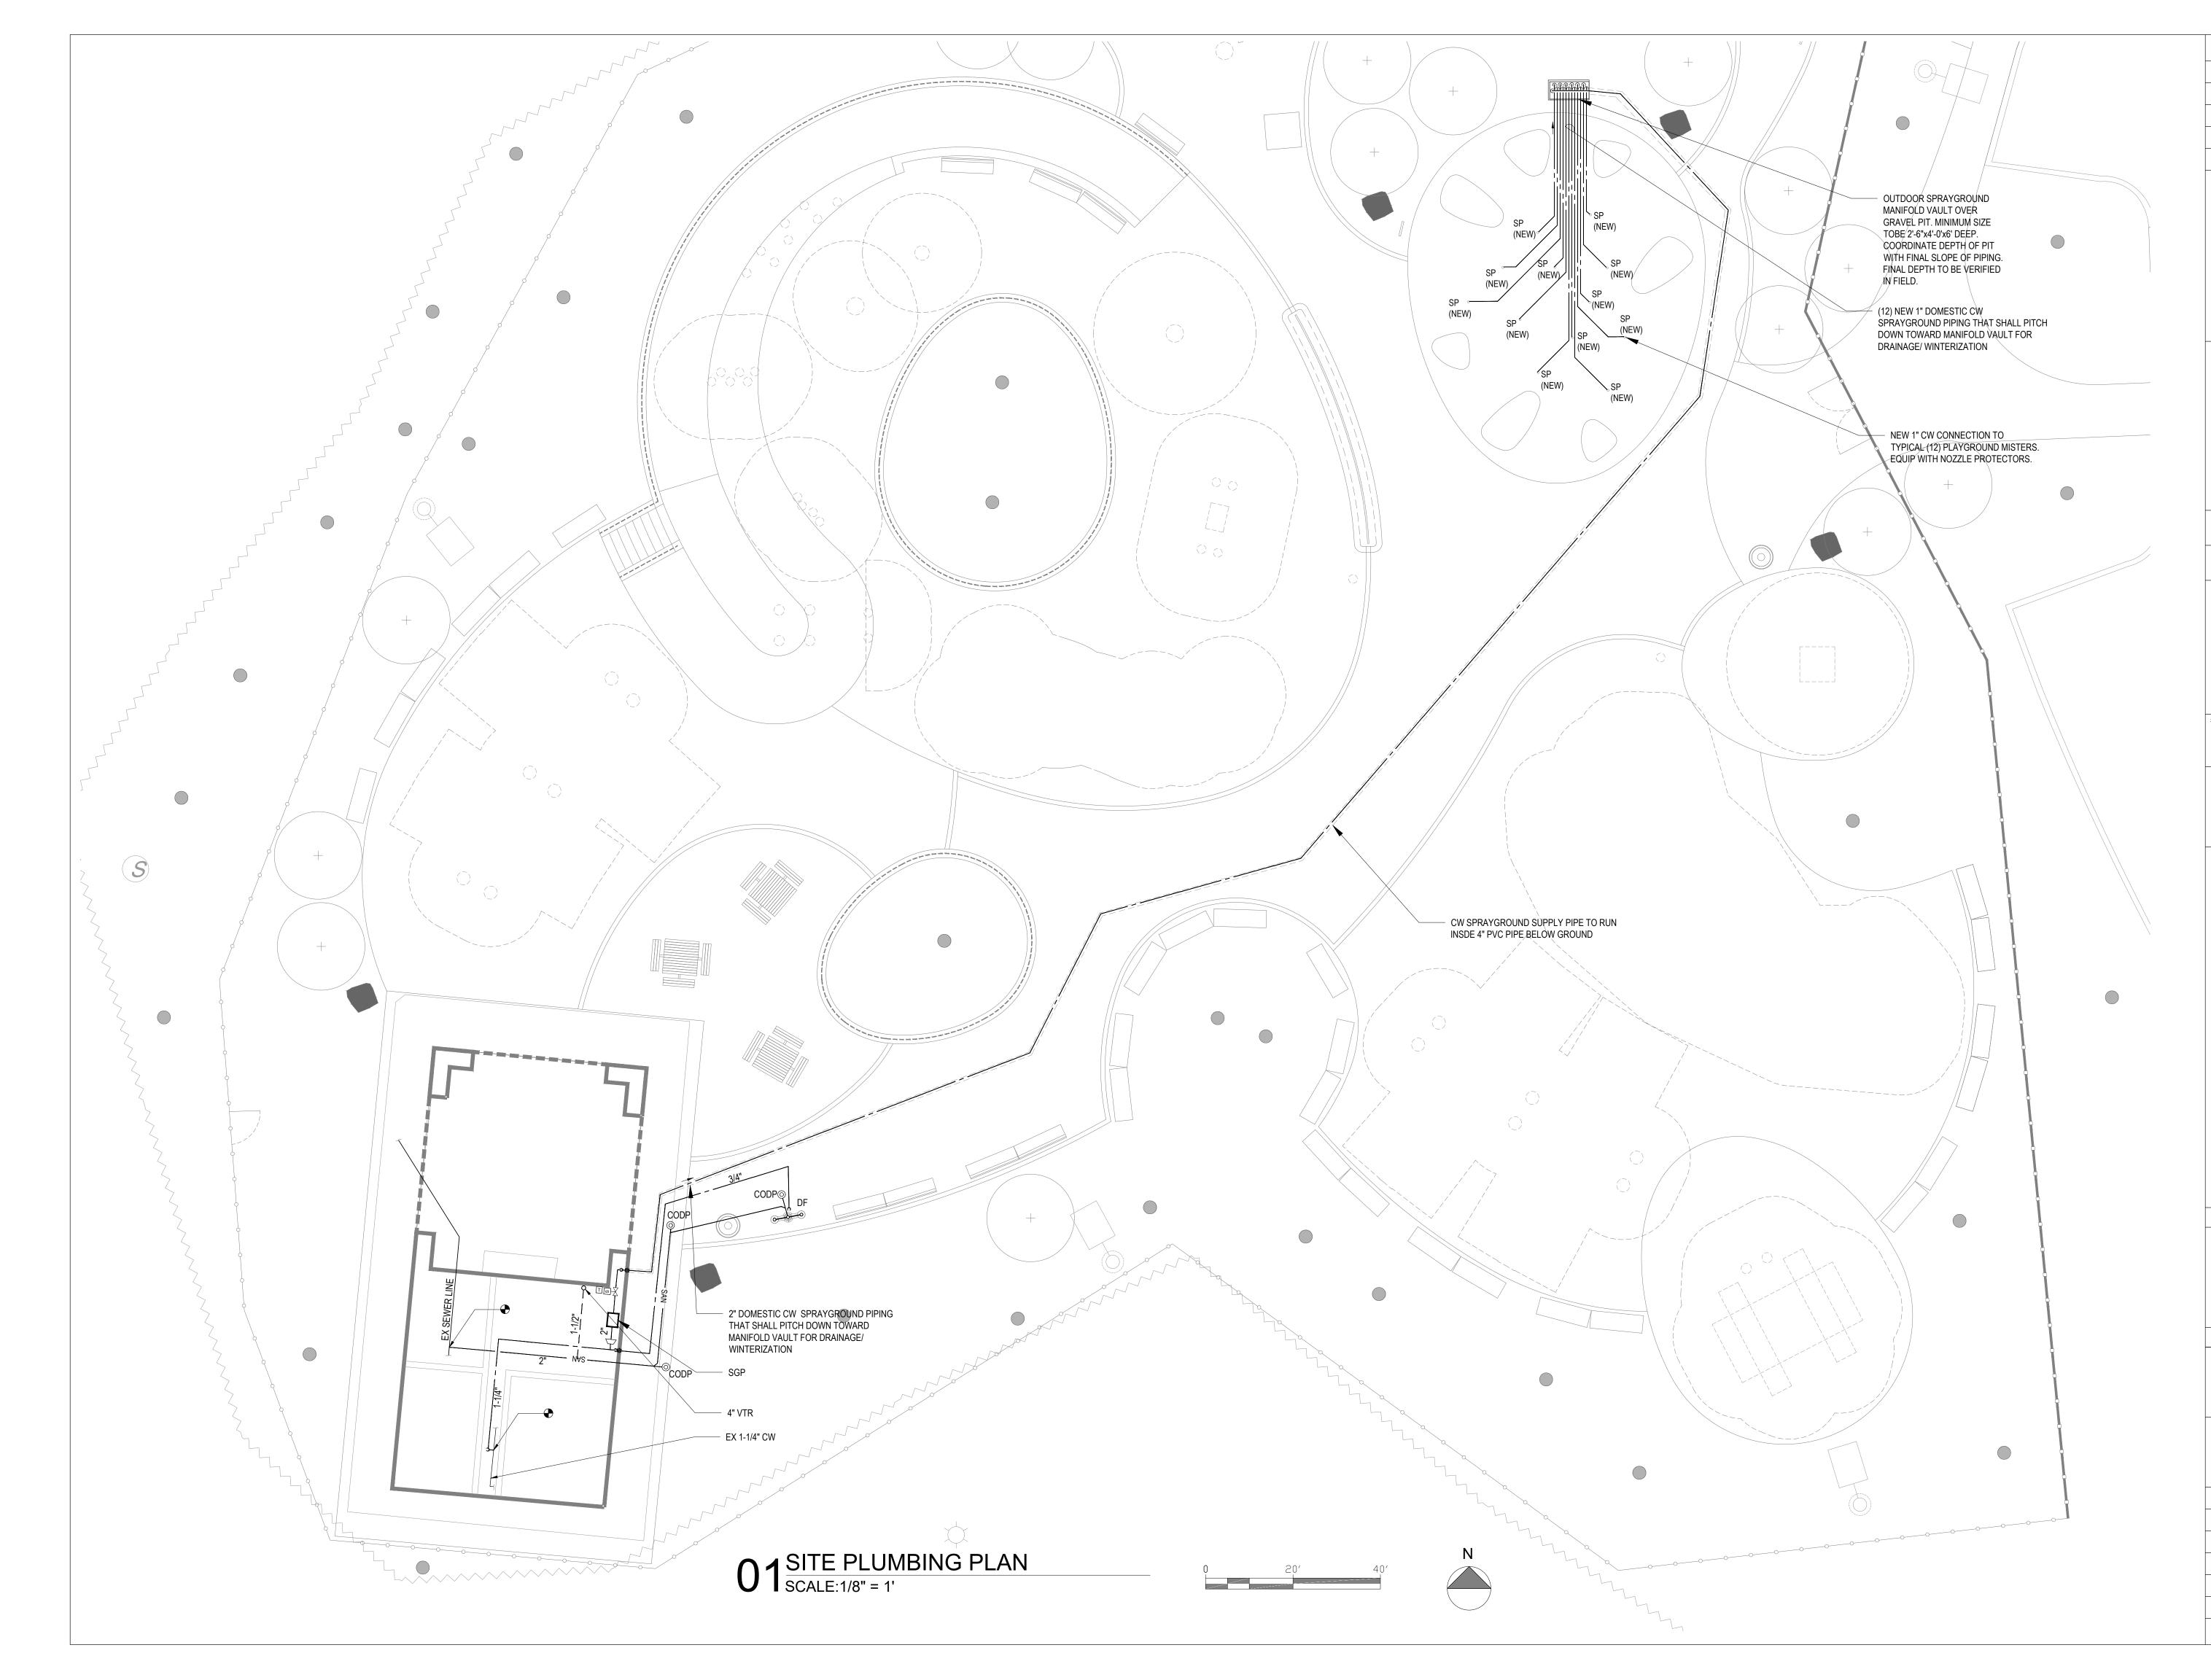





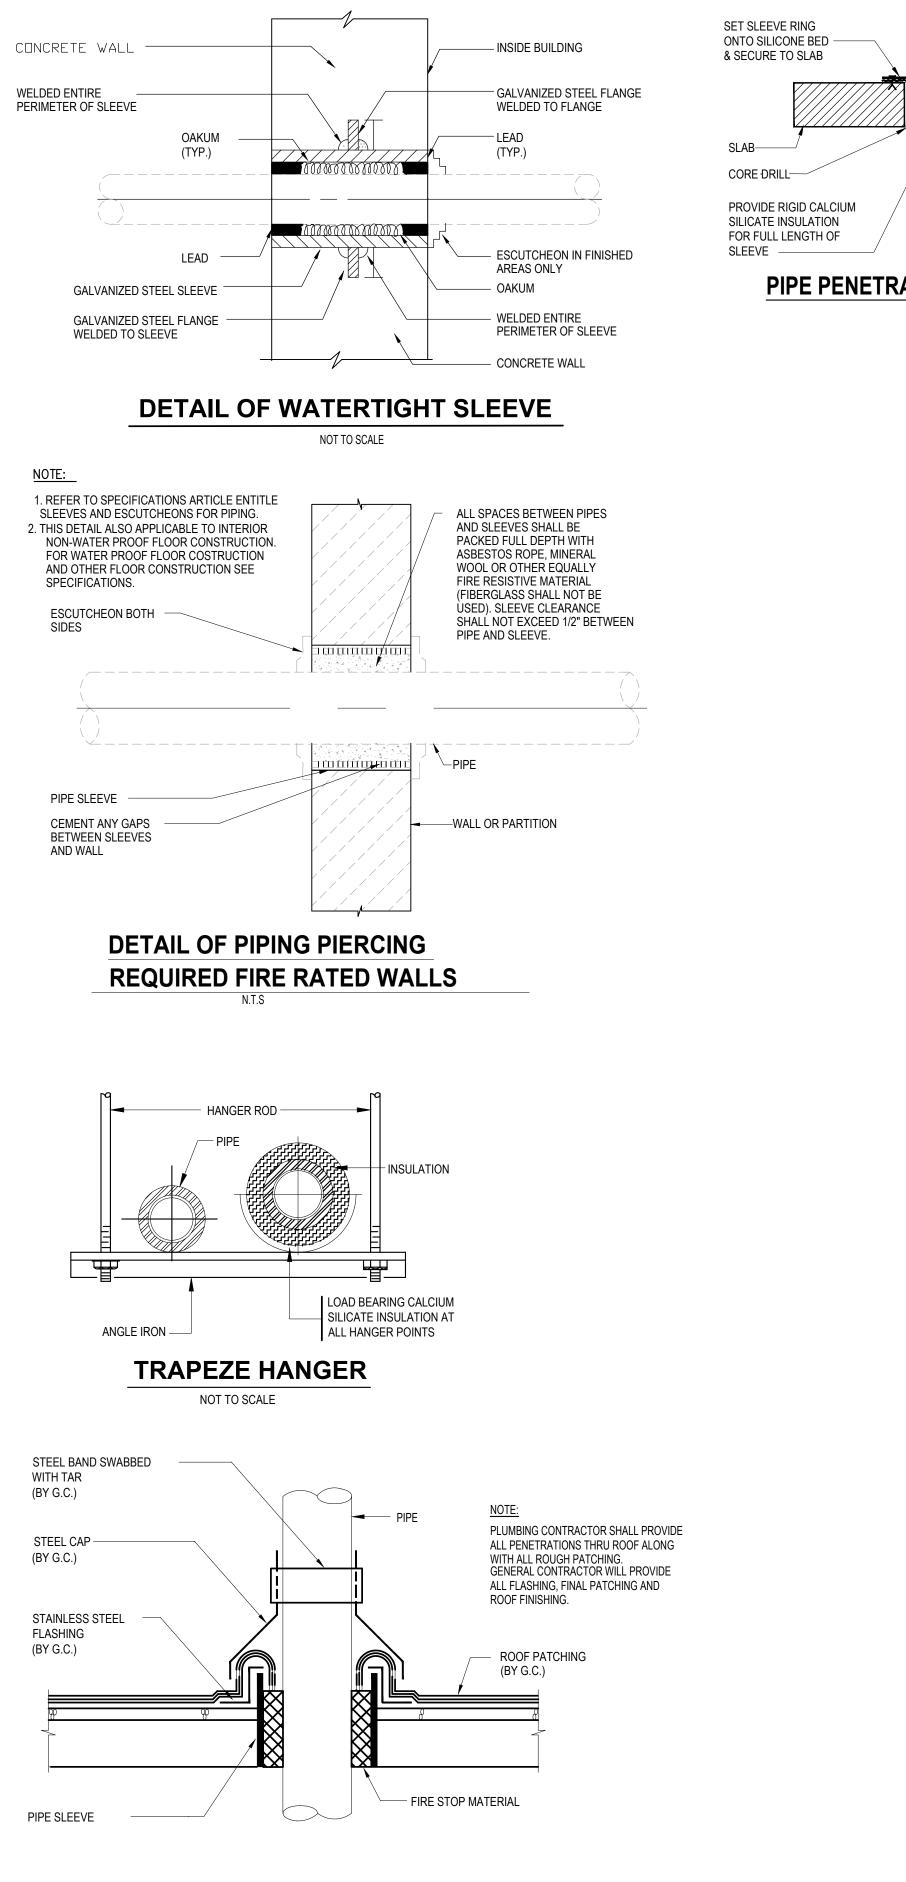

PIPE PENETRATION THRU ROOF DETAIL

NOT TO SCALE

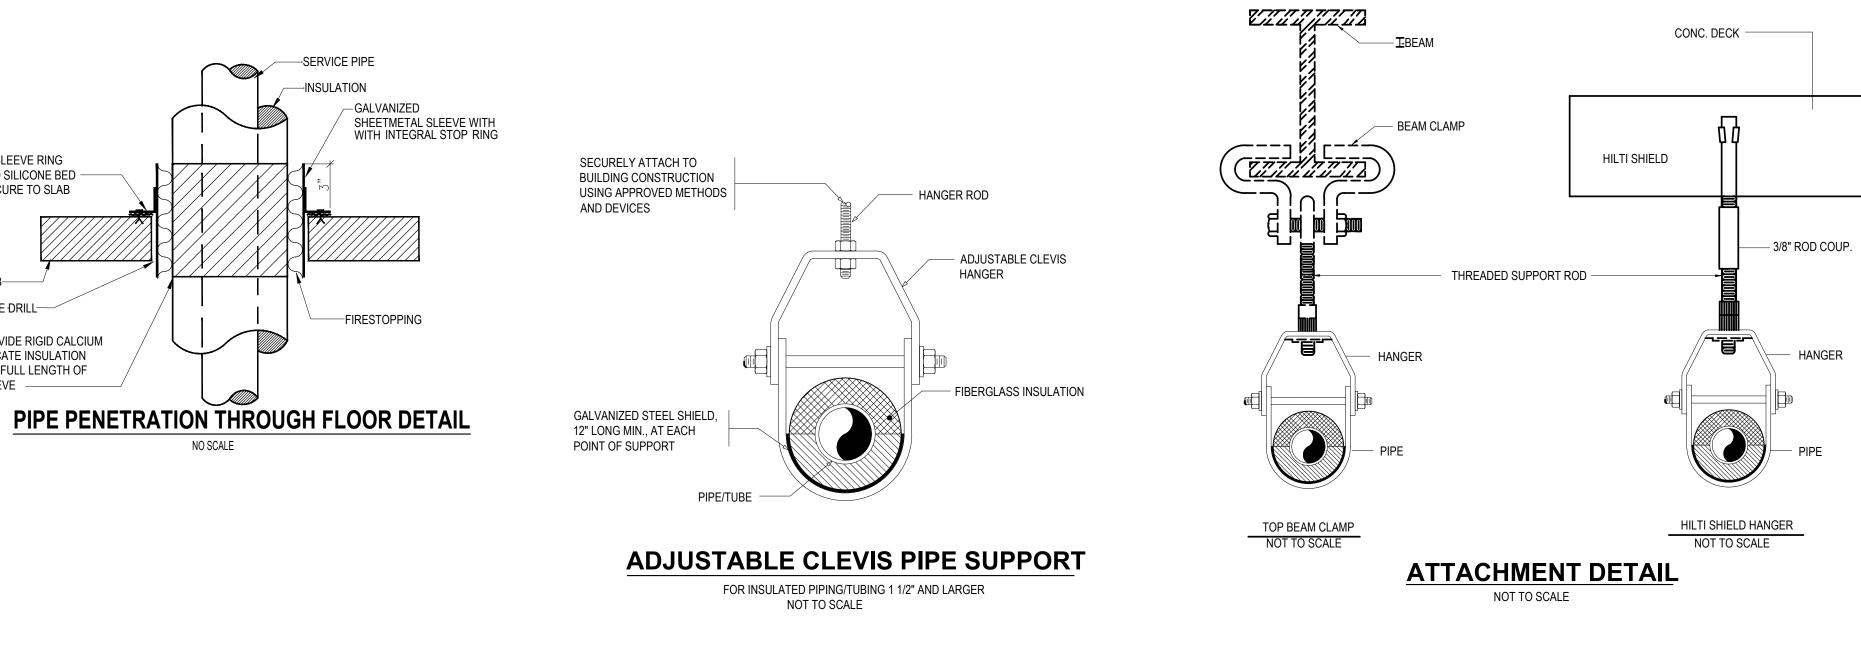

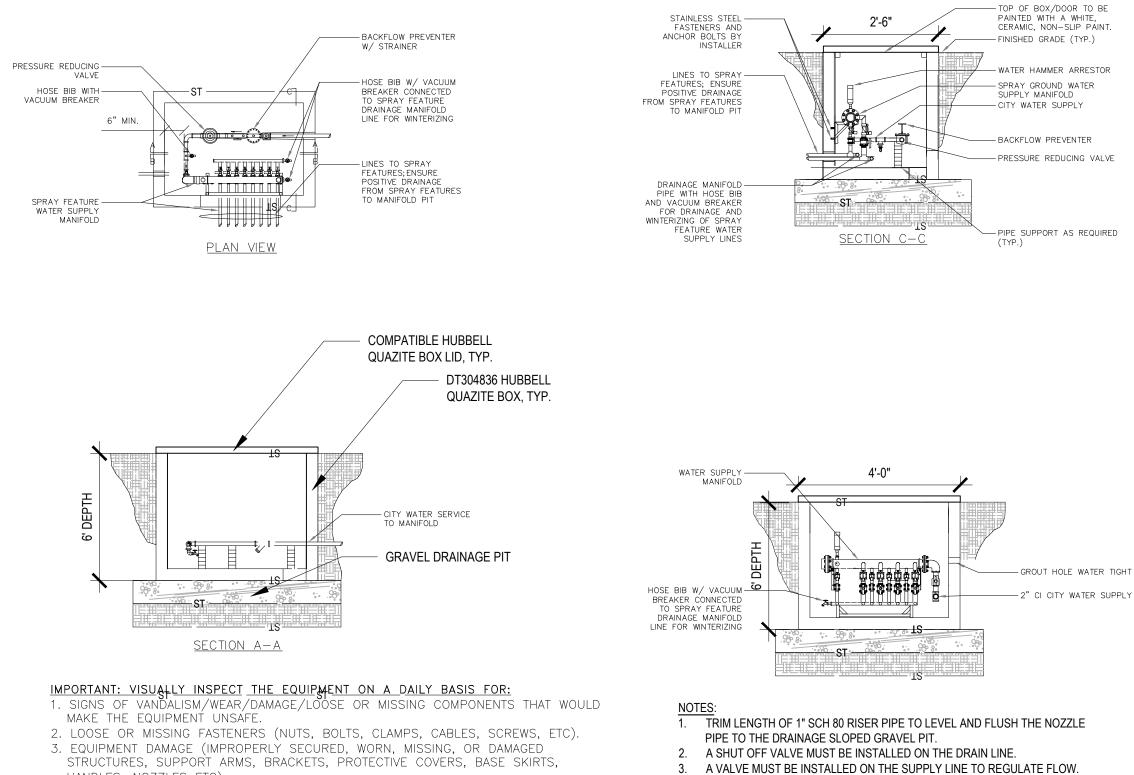

- HANDLES, NOZZLES ETC). 4. EQUIPMENT MALFUNCTION (LOOSE, MISSING, WORN, DAMAGED EQUIPMENT
- COMPONENTS).
- 5. IF COMPONENT REPLACEMENT IS REQUIRED, REPLACE WITH NEW COMPONENT OF
- SAME TYPE/DESIGN. <u>DO NOT_{ST}REUSE COMPONENT.</u> 6. IT IS NOT RECOMMENDED TO RE-USE FLANGE MOUNTING GASKETS. 7. PROPERLY BALANCED AND SANITIZED WATER SUPPLY.

SPRAYGROUND OUTDOOR MANIFOLD DETAIL

4. WINTERIZATION TO BE PERFORMED BY A TRAINED TECHNICIAN FAMILIAR

5. USE STACKABLE ASSEMBLY AS NEEDED TO REACH REQUIRED DEPTH.

WITH PROPER WINTERIZATION PROCEDURES.

NOT TO SCALE

REVISIONS ISSUE DATE REVISIONS PENNSYLVANIA ONE CALL SYSTEM, INC. 925 Irwin Run Road West Mifflin, Pennsylv 15122 - 1078 BEFORE YOU DIG ANYWHERE IN PENNSYLVANIA! CALL 1-800-242-1776 NON-MEMBERS MUST BE CONTACTED DIRECTLY PA LAW REQUIRES THREE WORKING DAYS NOTICE TO UTILITIES BEFORE YOU EXCAVATE, DRILL, BLAST OR DEMOLISH PA ONE-CALL NUMBER (FOR DESIGN ONLY): PPR PROJECT COORDINATOR: MEGAN FUNK SEAL: SIGNATURE DATE SIGNED 04/05/2024 PRIMARY CONSULTANT, LANDSCAPE ARCHITECT: MARVEL 145 Hudson Street, Floor 3 New York, NY 10013 SUB-CONSULTANTS: CIVIL/SURVEY ENGINEERING & LAND PLANNING ASSOCIATES, INC. 219 Cuthbert Street, 5th/ Floor Philadelphia, PA 19106 MEP ENGINEER: 417 N 8th Street, Suite 204 Philadelphia, PA 19123 267.585.2811 LIGHTING DESIGN: THE LIGHTING PRACTICE 600 Chestnut Street, Suite 772 Philadelphia, PA 19106 COST ESTIMATOR: ELLANA CONSTRUCTION CONSULTANTS 32 Broadway, 8TH Floor New York, NY 10004 PLAYFUL LEARNING CONSULTANT: PLAYFUL LEARNING LANDSCAPES ACTION NEXTWORK Philadelphia, PA 267.468.8610 ARBORIST: MORRIS ARBORETUM 100 East Northwestern Avenue Philadelphia, PA 19118 215.247.5777 ACCESSIBILITY CONSULTANT: CHRIS NOEL christopher.noel@parks.nyc.gov 646.632.7344 PLAY CONSULTANT: STUDIO LUDO 1313 S 33rd St, Unit A Philadelphia, PA 19146 CONSULTANT PROJECT NUMBER 2107 **CITY OF PHILADELPHIA** PHILADELPHIA PARKS AND RECREATION 1515 ARCH STREET 11TH FLOOR, ONE PARKWAY BUILDING PPR PROJECT NUMBER 16-21-7062-01 PROJECT TITLE: PENNYPACK PARK UNIVERSAL PLAYGROUND RHAWN ST. & HOLMEHURST AVE. PHILADELPHIA, PA 19136 DRAWING TITLE: SITE PLUMBING DETAILS PPR PROJECT NO .: DRAWING NO. 16-21-7062-01 CONSULTANT PROJECT NO. 2107 DATE: 12/15/2023 SP-200 SCALE:

DRAWN BY: CHECKED BY:

NOTE

ALL DIMENSIONS AND CONDITIONS SHALL BE VERIFIED BY THE CONTRACTOR AT THE SITE BEFORE PROCEEDING WITH THE WORK

CW

CS

AS NOTED