## ADDENDUM COVER SHEET Addendum No. 1

Pennypack Park Universal Playground Philadelphia Redevelopment Authority

Issue Date: May 20, 2024

ITEMS:
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- Questions & Answers (attached)
- Project Drawings (Updated & Attached)
- ➤ Chain-Link Fencing & Gate Specifications (Updated & Attached)
- ➤ Low Voltage Electrical Power Conductors & Cables Specifications (Attached)

➤ Bidders must acknowledge receipt of Addendum No. 1. The signed acknowledgement must be included in your bid proposal. Please sign below:

Acknowledgement of Addendum No. 1

### Pennypack Park Universal Playground Questions/RFIs:

- 1. Drawing SP-100: Spray Ground Booster Pump is not shown on Electrical Drawings.
  - a) Does pump require power feed? From where?

SRW Response: Yes, power feed coming from new panel LP.

b) Does pump require a starter or disconnect?

SRW Response: Pump is hard wired and circuited to breaker.

c) Does pump require any controls?

SRW Response: Pump and sprayground output is controlled by timer and timed solenoid valve. See SP-100 and plumbing specifications for more information.

### 2. Drawing SE-200

- a) Can you provide a panel schedule for existing Panel LP? SRW Response: A schedule for a new panel is shown on the building portion drawings E-100.
- b) Do we need to install new circuit breakers or are they existing? Can you tell us a make, manu., voltage and amperage of panel?

SRW Response: A schedule for a new panel is shown on the building portion drawings E-100.

c) Light fixtures are specified at 277V. Power for CCTV is 120V. How do we do this from the same panel, do we include costs for transformer?

L SRW Response: Lighting catalog number is specified for UNV 120-277 option selected. 120V will be used to power the poles.

### 3. Drawing SE-200

a) Can you provide a specification for the "hot box"?

SRW Response: CCTV equipment will be housed inside the existing building.

b) Does hot box require a concrete pad?

SRW Response: Hot box no longer in scope.

c) Can you provide dimensions and ventilation requirements? SRW Response: Hot box no longer in scope.

4. Can you give us a scope of the work for CCTV?

a) Do we bid 3" PVC conduit, junction boxes at each pole receiving cameras, 1" PVC conduit from junction box to pole base and pull strings in each conduit?

SRW Response: This is correct.

b) Do we supply and install the "hot box" and concrete pad? If we are supplying, can you provide a specification for the "hot box"? It will require heat, air conditioning and ventilation for the electronic equipment. Where do we get the electric power? A hotbox spec will be provided, power will be coming from Panel.


SRW Response: Hot box no longer in scope.

5. Is it necessary to encase the 2" domestic copper in 4" pvc? This detail is not a code requirement and would require a lot of time and extra cost.

SRW Response: It is necessary to encase the 2" domestic water copper piping in 4" PVC. The PVC piping will prevent the copper pipe from breaking if the earth shifts.

6. Are we to include wiring for the cameras?

PPR Response: Please only include conduit in this scope. Plan to lay conduit with fishing wire so that [others] can install cameras and fish required security wiring through for each light pole.

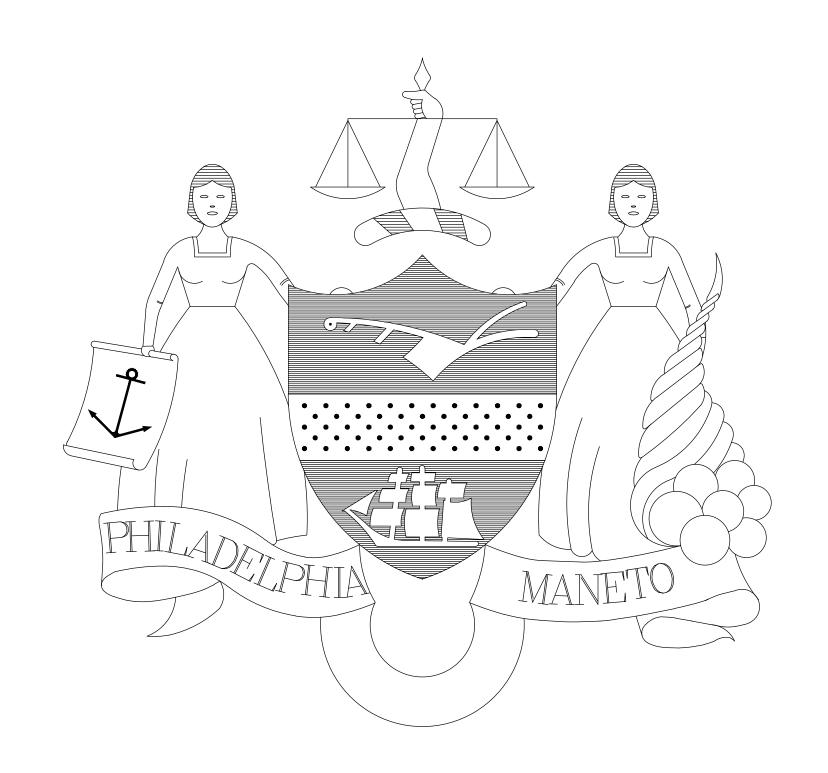

# CITY OF PHILADELPHIA

# DEPARTMENT OF PARKS AND RECREATION

MAYOR - JAMES F. KENNEY

MANAGING DIRECTOR - LAUREN MURPHY

COMMISSIONER OF PARKS AND RECREATION - ORLANDO RENDON

# PENNYPACK PARK UNIVERSAL PLAYGROUND 100% BID DOCUMENTS

RHAWN ST. & HOLMEHURST AVE., PHILADELPHIA, PA 19136

**Location Map** 

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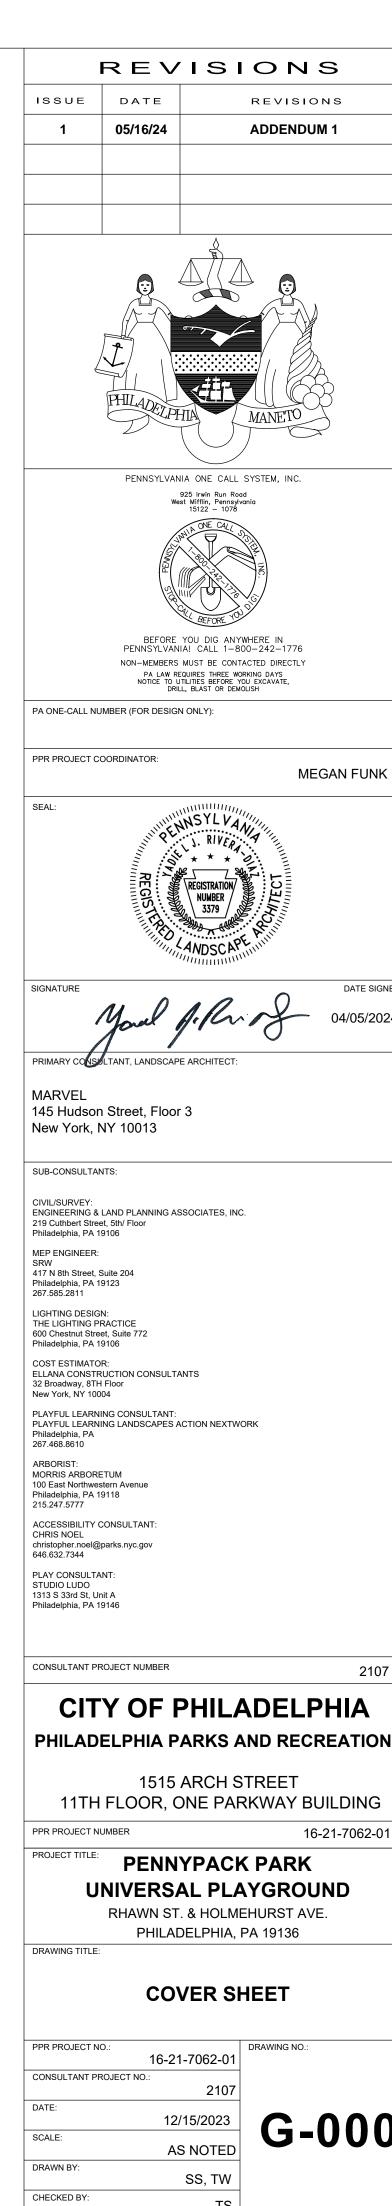
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### REFERENCES:

1. A MAP ENTITLED "TOPOGRAPHIC & LOCATION SURVEY OF FAIRMOUNT PARK SYSTEM PENNYPACK PARK RHAWN STREET", PREPARED BY SAS GEOSPATIAL, LLC DATED 11/01/2021, OR LAST REVISED.

### **GENERAL NOTES:**

- . OWNER:
  CITY OF PHILADELPHIA
  DEPARTMENT OF PUBLIC PROPERTY
  702 CITY HALL, PHILADELPHIA, PA 19107
  215-686-1776
- 2. THESE PLANS ARE NOT TO BE USED AS SURVEYS. REFER TO REFERENCE SOURCES FOR BOUNDARY AND TOPOGRAPHIC INFORMATION (REFERENCES ABOVE).
- THE CONTRACTOR SHALL CONFINE ALL CONSTRUCTION ACTIVITIES TO WITHIN THE LIMIT OF WORK AND/OR THE RIGHT-OF-WAY. ALL DISTURBED AREAS ARE TO BE RESTORED TO EXISTING CONDITIONS OR AS INDICATED IN THE CONTRACT DOCUMENTS.
- 4. THE CONTRACTOR SHALL PROTECT ALL EXISTING STRUCTURES AND IMPROVEMENTS WITHIN THE PROJECT LIMITS AND RIGHT-OF-WAY. THESE FEATURES INCLUDE BUT ARE NOT LIMITED TO TREES, SHRUBS, LANDSCAPING, DRIVEWAYS, MAILBOXES, SIGNAGE, CURBING, SIDEWALKS, UTILITIES, JUNCTION BOXES, POLES, LIGHTING, HYDRANTS, VALVE BOXES, AND STRIPING.
- THE CONTRACTOR SHALL OBTAIN ALL CONSTRUCTION PERMITS REQUIRED BY LOCAL, COUNTY OR STATE JURISDICTIONS. THE CONTRACTOR SHALL BE RESPONSIBLE FOR APPLICATION, PAYMENT AND APPROVAL OF SAID PERMITS. NO ADDITIONAL PAYMENT SHALL BE MADE BY THE OWNER.
- 6. HOURS OF WORK SHALL BE BETWEEN 7:00AM AND 5:00PM EASTERN STANDARD TIME, UNLESS OTHERWISE PERMITTED BY THE CITY.
- 7. THE CONTRACTOR SHALL FIELD VERIFY EXISTING CONDITIONS BEFORE BEGINNING CONSTRUCTION.
- 8. THE CONTRACTOR IS RESPONSIBLE FOR PROTECTION OF THE PROJECT SITE,
   CONTRACTOR PROPERTY, EQUIPMENT, AND WORK.
   9. THE CONTRACTOR IS RESPONSIBLE FOR CLEANING STREETS OF CONSTRUCTION DIRT
- 9. THE CONTRACTOR IS RESPONSIBLE FOR CLEANING STREETS OF CONSTRUCTION DIRT AND DEBRIS AT CLOSE OF EACH WORK DAY.
- THE CONDITION OF THE ADJACENT ROAD AND/OR RIGHT-OF-WAY, UPON COMPLETION OF THE JOB SHALL BE AS GOOD AS OR BETTER THAN PRIOR TO STARTING WORK.
   PRIOR TO CONSTRUCTION, THE CONTRACTOR, ALONG WITH CONCURRENCE FROM
- OWNER, SHALL DETERMINE HIS/HER LAY-DOWN AND/OR STAGING AREA LOCATIONS.

  16. THE CONTRACTOR SHALL NOTIFY ALL PROPERTY OWNERS A MINIMUM OF 24 HOURS
- PRIOR TO BLOCKING DRIVEWAYS OR ENTERING UTILITY EASEMENTS.

  17. TRAFFIC INGRESS AND EGRESS FOR DRIVEWAYS AND PEDESTRIAN ACCESS FACILITIES

SHALL BE MAINTAINED THROUGHOUT CONSTRUCTION.

- 18. ANY DAMAGE CAUSED BY THE CONTRACTOR SHALL BE REPLACED WITH LIKE-KIND OR BETTER AT THE CONTRACTOR'S EXPENSE. TREES, BUSHES, SHRUBBERY AND OTHER DAMAGED PLANTINGS TO REMAIN SHALL BE REPLACED WITHIN 72 HOURS OF REMOVAL AND ARE TO BE THOROUGHLY WATERED-IN. THE CONTRACTOR SHALL NOTIFY PPR OF DAMAGE IMMEDIATELY. PPR APPROVAL REQUIRED PRIOR TO PERFORMING ANY REPAIRS, REPLACEMENTS, OR RESTORATIONS.
- 19. PAVED SURFACES, PAVEMENT MARKERS AND MARKINGS SHALL BE PROTECTED FROM DAMAGE BY TRACKED EQUIPMENT.
- 20. PROPERTY MARKERS DISTURBED DURING CONSTRUCTION ARE TO BE REPLACED BY A REGISTERED PUBLIC LAND SURVEYOR FOR THE ORIGINAL PROPERTY OWNER AT NO SEPARATE DAY
- SEPARATE PAY.

  21. CONSTRUCTION STAKING WILL BE PROVIDED BY THE CONTRACTOR. TWO COPIES OF STAKING NOTES TO BE PROVIDED TO THE ENGINEER PRIOR TO CONSTRUCTION.
- 22. THE CONTRACTOR SHALL MAINTAIN UPDATED RED-LINED RECORD DRAWINGS ON SITE FOR INSPECTION BY THE ENGINEER.
- 23. MAINTENANCE AND CLEAN-UP OF THE PROJECT IS REQUIRED FOR THE PROJECT LIMITS AND DURATION, REGARDLESS OF THE CONTRACTOR'S SCOPE OF ACTIVITIES WITHIN THE PROJECT LIMITS.
- 24. THE REMOVAL OF ANY ABANDONED UTILITIES REQUIRED TO COMPLETE THE WORK SHALL BE INCIDENTAL AND NO SEPARATE PAYMENT SHALL BE MADE.
- 25. IT IS THE CONTRACTOR'S RESPONSIBILITY TO STOCKPILE NECESSARY MATERIAL ON-SITE OR AT A SECURED OFF-SITE LOCATION AT NO ADDITIONAL EXPENSE TO THE
- 26. THESE DRAWINGS DO NOT INCLUDE THE NECESSARY COMPONENTS FOR CONSTRUCTION SAFETY. THE CONTRACTOR SHALL BE RESPONSIBLE TO INSURE "ON THE JOB" SAFETY FOR HIS EMPLOYEES, EMPLOYEES OF THE OWNER AND ALL OTHER PERSONS HAVING AUTHORIZED OR UNAUTHORIZED ACCESS TO THE WORK AND THE PUBLIC. CONTRACTOR SHALL PERFORM HIS WORK IN A SAFE MANNER AND IN COMPLIANCE WITH ALL APPLICABLE LOCAL, STATE AND FEDERAL REGULATIONS.
- 27. THE LOCATION, TYPE, SIZE, DEPTH, ETC. OF ALL EXISTING UTILITIES WITHIN PROJECT SITE AND ADJACENT RIGHT-OF-WAY ARE APPROXIMATE AND MUST BE VERIFIED IN THE FIELD BY THE CONTRACTOR AND AT HIS OWN EXPENSE PRIOR TO THE START OF CONSTRUCTION. THE CONTRACTOR SHALL NOTIFY ALL UTILITY COMPANIES OPERATING WITHIN THE CONSTRUCTION SITE 3 DAYS PRIOR TO COMMENCEMENT OF ANY EXCAVATION FOR ACCURATE FIELD LOCATIONS. FOR RIGHT-OF-WAY UTILITY MARKOUT, CALL 1-800-242-1776. THE CONTRACTOR SHALL IMMEDIATELY NOTIFY THE DESIGN ENGINEER OF ALL DEVIATIONS OF SITE CONDITIONS AND/OR IF DEPARTURES
- FROM THE APPROVED DESIGN BECOME NECESSARY DUE TO SUCH DEVIATIONS.

  28. THE CONTRACTOR SHALL BE RESPONSIBLE FOR ALL LINES, ELEVATIONS, AND MEASUREMENTS, EXERCISING PRECAUTION TO VERIFY ALL DIMENSIONS SHOWN ON DRAWING.
- 29. THE CONTRACTOR SHALL IMMEDIATELY NOTIFY THE DESIGN ENGINEER SHOULD DEPARTURES FROM THE APPROVED DESIGN BECOME NECESSARY DUE TO CIRCUMSTANCES WHICH ARISE DURING CONSTRUCTION.
- 30. ITEMS NOT SPECIFIED BUT NECESSARY FOR PROPER CONSTRUCTION SHALL BE FURNISHED AND INSTALLED BY THE CONTRACTOR THE SAME AS IF SPECIFIED.
- 31. THE CONTRACTOR SHALL BE RESPONSIBLE FOR SCHEDULING ALL NECESSARY INSPECTIONS WITH L&I, INCLUDING FINAL INSPECTION AND PERMIT CLOSEOUT.

### DEMOLITION NOTES:

- CONTRACTOR IS RESPONSIBLE FOR THE COORDINATION AND SEQUENCING OF DEMOLITION AS DESCRIBED BY THESE DOCUMENTS AND SPECIFICATIONS. CONTRACTOR IS TO OBTAIN ALL PERMITS.
- 2. CONTRACTOR IS RESPONSIBLE FOR COORDINATION OF DEMOLITION OR RELOCATION WITH APPLICABLE UTILITY COMPANIES, IE, GAS, CABLE, POWER, TELEPHONE, WATER, SEWER, ELECTRIC, LIGHTING, ETC.
- 3. CONTRACTOR SHALL BE RESPONSIBLE TO IMMEDIATELY NOTIFY PPR AND FIX ANY ACTIVE UTILITIES DAMAGED DURING CONSTRUCTION AT THE CONTRACTOR'S EXPENSE.
- 4. ALL MATERIAL GENERATED BY THE DEMOLITION WILL BE HAULED FROM THE SITE AND DISPOSED OF PER LOCAL ORDINANCES.
- CONSTRUCTION.
  6. EXISTING UTILITY POLES, LIGHT POLES, HYDRANTS, ETC. THAT ARE NOT MARKED TO
- BE REMOVED SHALL BE PROTECTED IN PLACE.

  7. SAW-CUT CONCRETE AND ASPHALT PAVEMENT, SIDEWALK OR CURB BEFORE

INSTALL PROTECTION FENCE AS NOTED ON PLAN DURING DEMOLITION AND

- EXCAVATION WHERE CONSTRUCTION PLANS SHOW TIE-INS.

  8. REPAIR OR REPLACE ANY ADJACENT RETAINING WALLS CONCRETE CURBING AND/OR
- SIDEWALK DAMAGED AS PART OF DEMOLITION PROCESS.

  9. ROOT ZONE OF TREES TO REMAIN SHALL BE PROTECTED AGAINST COMPACTION AND EXCAVATION. REPLACE ANY TREES OR SHRUBS MARKED TO REMAIN IF DAMAGED AS
- PART OF DEMOLITION OR CONSTRUCTION PROCESS.

  10. THIS DEMOLITION PLAN COVERS SURFACE LEVEL EXISTING CONDITIONS, UTILITIES, AND OTHER SITE ELEMENTS. SEE ARCHITECTURAL DEMO PLAN FOR EXTENTS OF
- DEMOLITION OF EXISTING STRUCTURES.

  11. PRIOR TO REMOVAL OF SITE FURNISHINGS, CONTRACTOR SHALL WALK THROUGH THE SITE WITH THE CLIENT AND IDENTIFY WHICH EXISTING SITE ELEMENTS ARE TO BE
- SITE WITH THE CLIENT AND IDENTIFY WHICH EXISTING SITE ELEMENTS ARE TO BE SALVAGED FOR RE-USE.

  12. ALL EXISTING MONUMENTS AND HISTORIC SCULPTURES SHALL REMAIN AND BE
- PROTECTED IN PLACE.

  13. TREE REMOVAL PER DEMOLITION PLAN SHALL INCLUDE STUMPS.
- 13. TREE REMOVAL PER DEMOLITION PLAN SHALL INCLUDE STUMPS.

  14. ALL TRASH RECEPTACLES TO BE SALVAGED AND RELOCATED ON SITE PER OWNER'S
- 15. EXISTING PICNIC TABLES TO BE SALVAGED AND RELOCATED IF IN GOOD CONDITION. CONFIRM AND COORDINATE WITH PPR PROJECT MANAGER AT THE TIME OF DEMOLITION.

### SITE/CIVIL NOTES:

- 1. CONTRACTOR SHALL COMPLY WITH ALL APPLICABLE CODES AND REGULATIONS
- GOVERNING THE WORK.

  2. DO NOT SCALE OFF DRAWINGS, USE DRAWING DIMENSIONS VERIFY ALL DIMENSIONS AND EXISTING CONDITIONS IN THE FIELD PRIOR TO COMMENCEMENT OF WORK. BRING TO THE ATTENTION OF ENGINEER ANY DISCREPANCIES BETWEEN FIELD CONDITIONS AND DRAWINGS PRIOR TO THE BEGINNING OF WORK. FIELD CONDITION DISCREPANCIES SHALL NOT BE USED AS THE BASIS FOR CHANGE ORDER CLAIMS ONCE WORK HAS BEGUN.
- 3. PRESERVE AND PROTECT ALL EXISTING STRUCTURES, FURNISHINGS, SURFACE MATERIALS, ABOVE AND BELOW GRADE UTILITIES, FOOTINGS AND VEGETATION INDICATED TO REMAIN WITHIN AND ADJACENT TO LIMIT OF WORK DURING ALL PHASES OF DEMOLITION AND CONSTRUCTION.
- 4. THE EXISTENCE AND LOCATION OF EACH UNDERGROUND UTILITY IS NOT GUARANTEED AND UNDOCUMENTED CONDITIONS MAY COORDINATE WITH ENGINEER FOR LOCATIONS OF UTILITIES NOT SHOWN ON THE BASE DRAWING INCLUDING, BUT NOT LIMITED TO, HIGH VOLTAGE ELECTRIC, ABANDONED STEAM LINES, ABANDONED WATER LINES, TELEPHONE, CABLES, ETC. STAKE OUT LOCATION OF ALL UTILITIES PRIOR TO COMMENCEMENT OF ANY UTILITY THAT IS DAMAGED DURING SITE WORK OPERATIONS SHALL BE REPAIRED AT THE CONTRACTOR'S EXPENSE.
- 5. MAINTAIN VEHICULAR TRAFFIC FLOW TO AND AROUND THE SITE. MAINTAIN CLEARLY MARKED PEDESTRIAN ACCESS TO AREAS ON-SITE NOT AFFECTED BY CONSTRUCTION ACTIVITIES.
- CONTRACTOR SHALL ADJUST ALL EXISTING UTILITY STRUCTURES AS REQUIRED TO MEET PROPOSED GRADES, INCLUDING DRAIN INLETS, MANHOLES AND LIGHT POLE. CONTRACTOR SHALL MEET EXISTING GRADES AT ALL EDGES OF LIMIT OF WORK.
   CONTRACTOR IS RESPONSIBLE FOR ALL NECESSARY MEASURES TO PREVENT SOIL
- EROSION. APPROVED SOIL EROSION AND SEDIMENTATION CONTROL MEASURES MUST BE INSTALLED BEFORE SITE CLEARING AND SITE GRADING OPERATIONS BEGIN.

  8. SOIL DISTURBANCE WITHIN TREE PROTECTION ZONES SHALL BE KEPT TO A MINIMUM.
- HEAVY MACHINERY, MECHANICAL TRENCHING OR MATERIAL STORAGE IS NOT PERMITTED WITHIN THE TREE PROTECTION ZONE. ALL DIGGING WITHIN TREE PROTECTION ZONE SHALL BE BY HAND.

  9. CORE AERATOR, TOP DRESSING MACHINE, AIR SPADING, HAND DIGGING OR OTHER
- APPROVED METHOD OF DIGGING AND TRENCHING SHALL BE USED IN PLACE OF ROTOTILLER TO COMPLETE ALL WORK IN TREE PROTECTION ZONES. CARE MUST BE TAKEN TO AVOID DISTURBANCE TO ROOTS OF ALL EXISTING TREES, INCLUDING ROOTS EXTENDING OUTSIDE THE TREES PROTECTION ZONES. EXCAVATION WITHIN PROTECTED ZONES SHALL BE BY MEANS OF AIR SPADING, OPERATED BY A TRAINED AND CERTIFIED OPERATOR. THE CONTRACTOR IS RESPONSIBLE FOR ENSURING PROPER DRAINAGE OF THE PROJECT SITE AND ALL UPGRADIENT AREAS TO THE SITE.
- MILLINGS, STONE, SOIL, CONSTRUCTION DEBRIS, AND ALL OTHER RELATED MATERIALS SHALL BECOME THE PROPERTY OF THE CONTRACTOR FOR OFF-SITE DISPOSAL.
   CONTRACTOR IS RESPONSIBLE FOR COORDINATING WITH PROPER UTILITY COMPANY
- 11. CONTRACTOR IS RESPONSIBLE FOR COORDINATING WITH PROPER UTILITY COMPANY OR AGENCY FOR DISCONNECTING SERVICES, RELOCATING SERVICES, AND PROVIDING NEW SERVICES WITHIN THE PROJECT AREA.
- 12. WHERE CONSTRUCTION, INCLUDING UTILITY LINES, CROSSES OR IS ADJACENT TO EXISTING UTILITY LINES (FUEL, WATER, SEWER, TELECOMMUNICATION, GAS OR ELECTRIC), CONTRACTOR SHALL DIG TEST PITS AND CAREFULLY HAND EXCAVATE SO AS TO LOCATE, MARK, AND PROTECT THE UTILITY LINES AGAINST DISTURBANCE OR DAMAGE.
- 13. THE CONTRACTOR SHALL EXERCISE CAUTION WHEN REGRADING OVER EXISTING/NEW UTILITIES INCLUDING, BUT NOT LIMITED TO STORM AND SANITARY SEWERS, WATER MAINS, GAS AND ELECTRIC LINES.
- 14. THE CONTRACTOR IS TO EXERCISE EXTREME CARE WHEN PERFORMING ANY WORK ACTIVITIES ADJACENT TO BUILDING OR EXTERIOR SITE WALLS THAT ARE TO REMAIN IN PLACE
- 15. WHERE MANUFACTURER'S NAMES AND PRODUCT NUMBERS ARE INDICATED ON DRAWINGS, IT SHALL BE CONSTRUED TO MEAN THE ESTABLISHMENT OF QUALITY AND PERFORMANCE STANDARDS OF SUCH ITEMS. ALL OTHER PRODUCTS MUST BE SUBMITTED TO THE ENGINEER FOR APPROVAL BEFORE THEY SHALL BE DEEMED
- 16. EXISTING ASPHALT OR CONCRETE PAVEMENT IN THE AREAS OF NEW PAVEMENT SHALL BE ENTIRELY REMOVED AND DISPOSED OF BY THE CONTRACTOR IN CONFORMANCE WITH PADEP AND PHILADELPHIA CODE. THE SUBGRADE SHALL BE PREPARED AND BROUGHT TO THE REQUIRED ELEVATION PRIOR TO CONSTRUCTING BASE AND TOP
- 17. WHERE EXISTING CONCRETE PAVEMENT OR ASPHALT CONCRETE PAVEMENT ARE REMOVED, THE CONTRACTOR SHALL SAWCUT AND NEATLY TRIM EDGE OF REMAINING PAVEMENT BEFORE INSTALLING NEW CONSTRUCTION.

### GRADING NOTES:

- CONTRACTOR SHALL VERIFY ALL EXISTING GRADES IN THE FIELD AND REPORT ANY DISCREPANCIES TO THE ENGINEER. CONTRACTOR SHALL STAKE ALL ELEVATIONS TO BE APPROVED BY THE ENGINEER BEFORE CONSTRUCTION.
- 2. ALL LINES AND GRADE WORK NOT PRESENTLY ESTABLISHED AT THE SITE SHALL BE LAID OUT BY A REGISTERED LAND SURVEYOR OR PROFESSIONAL CIVIL ENGINEER EMPLOYED BY THE CONTRACTOR IN ACCORDANCE WITH THE CONTRACT DOCUMENTS. CONTRACTOR SHALL ESTABLISH PERMANENT BENCHMARKS AND BOUNDS AND REPLACE ANY WHICH ARE DESTROYED OR DISTURBED.
- THE WORDS 'FINISHED GRADE' (F.G.) SHALL MEAN THE REQUIRED FINAL GRADE ELEVATIONS INDICATED ON THE DRAWINGS.
- ELEVATIONS INDICATED ON THE DRAWINGS.

  4. SPOT ELEVATIONS SHALL GOVERN OVER PROPOSED CONTOURS.
- 5. CONTRACTOR SHALL ENSURE CONSISTENT SLOPE BETWEEN SPOT ELEVATIONS.
- AT RIDGE LINES, HIGH POINTS AND LOW POINTS, CONTRACTOR SHALL TRANSITION GRADE TO AVOID A POINT OR SHARP EDGE.
   ALL WORK PERFORMED IN A PUBLIC RIGHT-OF-WAY SHALL MEET THE REQUIREMENTS
- 7. ALL WORK PERFORMED IN A PUBLIC RIGHT-OF-WAY SHALL MEET THE REQUIREMENTS OF THE CITY OF PHILADELPHIA. CONTRACTOR SHALL NOT PERFORM WORK OUTSIDE THE DESIGNATED SITE BOUNDARY. IF FIELD CONDITIONS WARRANT OFF-SITE GRADING, PERMISSION SHALL BE OBTAINED BY CONTRACTOR FROM THE AFFECTED PROPERTY OWNERS.
- 8. FOR SLOPE CONSTRUCTION 3:1 AND STEEPER THE CONTRACTOR SHALL COORDINATE WITH A GEOTECHNICAL ENGINEER ON THE SUITABILITY OF SOILS PLANNED FOR THESE SLOPES AND FOLLOW RECOMMENDATIONS SET FORTH BY THE GEOTECHNICAL ENGINEER FOR SLOPE CONSTRUCTION. TOP SOIL PLACEMENT ON SLOPES SHALL BE INSTALLED IN A BENCHED PATTERN.


### TRAFFIC CONTROL:

- THE CONTRACTOR SHALL PROVIDE AND INSTALL TRAFFIC CONTROL DEVICES IN CONFORMANCE WITH THE MOST RECENT EDITION OF THE MANUAL ON UNIFORM TRAFFIC CONTROL DEVICES (MUTCD).
- THE CONTRACTOR SHALL MAINTAIN AT LEAST ONE LANE OF TRAFFIC IN EACH DIRECTION DURING WORKING HOURS EXCEPT DURING FLAGGING OPERATION OR PROVIDE DETOURS AROUND THE CONSTRUCTION SITE AND PROVIDE PUBLIC NOTIFICATION.
- DETOURS REQUIRE PRIOR APPROVAL OF THE TOWN ENGINEER. DETOUR PLANS, IF ALLOWED, MUST INCLUDE APPROPRIATE DETOUR SIGNAGE, PUBLIC NOTICE VIA SIGNAGE TWO WEEKS IN ADVANCE STATING THE DATES OF THE AGREED UPON DATE OF CLOSURE AND DATE THE ROAD WILL RE-OPEN TO TRAFFIC. CONTRACTOR TO USE CONSTRUCTION METHODS TO MINIMIZE THE DURATION OF THE DETOUR AND TO ENSURE THAT THE ROADWAY IS OPEN ON, OR PRIOR TO, THE AGREED UPON DATE.
- ONE DAY PRIOR TO THE IMPLEMENTATION OF A TRAFFIC CONTROL PLAN PHASE OR STEP, OR THE IMPLEMENTATION OF AN ADDITIONAL, REVISED, OR NEW TRAFFIC CONTROL ELEMENT, THE CONTRACTOR SHALL MEET WITH THE ENGINEER TO GIVE A DETAILED DESCRIPTION OF THE CONTRACTOR'S PLAN AND PREPARATIONS. THE CONTRACTOR SHALL OBTAIN WRITTEN APPROVAL FROM THE ENGINEER THAT ADEQUATE PROJECT PROGRESS HAS BEEN ACHIEVED AND THAT ADEQUATE PREPARATIONS ARE IN PLACE PRIOR TO SWITCHING TRAFFIC. IF, IN THE OPINION OF THE ENGINEER, REQUIRED PROGRESS AND ADEQUATE PREPARATIONS ARE NOT COMPLETE, THE CONTRACTOR SHALL NOT IMPLEMENT THE NEXT PHASE, STEP, OR ELEMENT OF TRAFFIC CONTROL UNTIL INCOMPLETE CONSTRUCTION ITEMS OR PREPARATIONS ARE COMPLETED. TIME EXTENSIONS WILL NOT BE GRANTED FOR DELAYS CAUSED BY THE INCOMPLETE CONSTRUCTION ITEMS OR INADEQUATE CONTRACTOR PREPARATIONS REQUIRED TO IMPLEMENT TRAFFIC CONTROL.
- 5. TRAFFIC CONTROL PER THE CONTRACT IS REQUIRED FOR THE ENTIRE DURATION OF THE PROJECT, INCLUDING THE PUNCHLIST PERIOD.
- 6. THE CONTRACTOR SHALL SUBMIT A TRAFFIC CONTROL PLAN TO THE TOWN FOR REVIEW AND APPROVAL A MINIMUM OF 3 DAYS PRIOR TO THE START OF CONSTRUCTION.

REVISIONS

ISSUE DATE REVISIONS

1 05/16/24 ADDENDUM 1

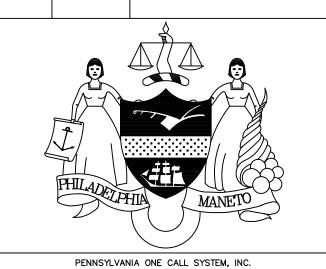


BEFORE YOU DIG ANYWHERE IN PENNSYLVANIA! CALL 1-800-242-1776

NON-MEMBERS MUST BE CONTACTED DIRECTLY

PA ONE-CALL NUMBER (FOR DESIGN ONLY):

PPR PROJECT COORDINATOR:

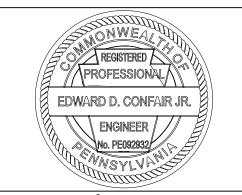

MEGAN FUNK

04/04/2024

PRIMARY CONSULTANT, LANDSCAPE ARCHITECT:

MARVEL 145 Hudson Street, Floor 3 New York, NY 10013

SUB-CONSULTANTS:

CIVIL/SURVEY: ENGINEERING & LAND PLANNING ASSOCIATES, INC. 219 Cuthbert Street, 5th/ Floor Philadelphia, PA 19106

MEP ENGINEER: SRW 417 N 8th Street, Suite 204 Philadelphia, PA 19123 267.585.2811

LIGHTING DESIGN:

600 Chestnut Street, Suite 772
Philadelphia, PA 19106

COST ESTIMATOR:
ELLANA CONSTRUCTION CONSULTANTS

32 Broadway, 8TH Floor
New York, NY 10004

PLAYFUL LEARNING CONSULTANT:
PLAYFUL LEARNING LANDSCAPES ACTION NEXTWORK

ARBORIST:
MORRIS ARBORETUM
100 East Northwestern Avenue
Philadelphia, PA 19118

215.247.5777

ACCESSIBILITY CONSULTANT:
CHRIS NOEL
christopher.noel@parks.nyc.gov
646.632.7344

PLAY CONSULTANT: STUDIO LUDO 1313 S 33rd St, Unit A Philadelphia, PA 19146

CONSULTANT PROJECT NUMBER

CITY OF PHILADELPHIA
PHILADELPHIA PARKS AND RECREATION

1515 ARCH STREET

UNIVERSAL PLAYGROUND

11TH FLOOR, ONE PARKWAY BUILDING

PROJECT NUMBER 16-21-7062-01

PROJECT TITLE: PENNYPACK PARK

RHAWN ST. & HOLMEHURST AVE.
PHILADELPHIA, PA 19136

DRAWING TITLE:

GENERAL NOTES

16-21-7062-01

CONSULTANT PROJECT NO.:

DATE:

12/1

SCALE:

DATE:

12/15/2023

SCALE:

AS NOTED

DRAWN BY:

CW

CHECKED BY:

EC

PPR PROJECT NO.:

ALL DIMENSIONS AND CONDITIONS SHALL BE VERIFIED BY THE

BRT/OPA: 871402520

PHILADELPHIA WATER TRACKING NO.:

PENNSYLVANIA ONE CALL SYSTEM, INC.
SITE IDENTIFICATION NO.:
20220322281

FY22-PENN-6850-01

925 Irwin Run Road
West Mifflin, Pennsylvania
15122 - 1078

DRILL, BLAST OR DEMOLISH

BEFORE YOU DIG ANYWHERE IN PENNSYLVANIA! CALL 1-800-242-1776


NON-MEMBERS MUST BE CONTACTED DIRECTLY PA LAW REQUIRES THREE WORKING DAYS NOTICE TO UTILITIES BEFORE YOU EXCAVATE.


### **GENERAL NOTES:**

- CITY OF PHILADELPHIA DEPARTMENT OF PUBLIC PROPERTY 702 CITY HALL, PHILADELPHIA, PA 19107 215-686-1776
- SAS GEOSPATIAL, LLC 1432 EASTON ROAD, SUITE 5F WARRINGTON, PA 18976 215-3435989
- 3. BOUNDARY AND TOPOGRAPHIC INFORMATION FROM A PLAN TITLED "TOPOGRAPHIC & LOCATION SURVEY PENNYPACK PARK" PREPARED BY SAS GEOSPATIAL, LLC DATED 11/10/23 OR LAST REVISED.
- 4. VERTICAL INFORMATION AS SHOWN HEREON IS BASED ON NORTH AMERICAN VERTICAL DATUM OF 1988 (NAVD88).
- 5. HORIZONTAL INFORMATION IS BASED ON THE PENNSYLVANIA STATE PLANE COORDINATE SYSTEM
- 6. THIS PLAN WAS PREPARED IN ACCORDANCE WITH INSTRUCTIONS FROM THE CLIENT.
- 7. THIS PLAN WAS PREPARED WITHOUT THE BENEFIT OF A TITLE REPORT.
- 8. EXCEPT AS SPECIFICALLY STATED OR SHOWN ON THIS PLAT, THIS SURVEY DOES NOT PURPORT TO REFLECT ANY OF THE FOLLOWING WHICH MAY BE APPLICABLE TO THE SUBJECT REAL ESTATE: EASEMENTS, OTHER THAN POSSIBLE EASEMENTS THAT WERE VISIBLE AT THE TIME OF MAKING OF THIS SURVEY; BUILDING SETBACK LINES; RESTRICTIVE COVENANTS; SUBDIVISION RESTRICTIONS; ZONING OR OTHER LAND USE REGULATIONS; AND ANY OTHER FACTS THAT AN ACCURATE TITLE SEARCH MAY DISCLOSE.
- 9. SURVEYOR HAS MADE NO INVESTIGATION OR INDEPENDENT SEARCH FOR EASEMENTS OR RECORD, ENCUMBRANCES, RESTRICTIVE COVENANTS, OWNERSHIP TITLE EVIDENCE, OR ANY OTHER FACTS THAT AN ACCURATE TITLE SEARCH MAY DISCLOSE.
- 10. THE WORD "CERTIFY" AS USED IN ITS VARIOUS FORMS HEREON, IS UNDERSTOOD TO BE AN EXPRESSION OF PROFESSIONAL OPINION BY THE SURVEYOR, WHICH IS BASED ON HIS BEST KNOWLEDGE, INFORMATION AND BELIEF. AS SUCH, IT CONSTITUTES NEITHER A GUARANTEE OR WARRANTY, EITHER EXPRESSED OR IMPLIED.
- 11. UNDERGROUND UTILITIES LOCATED ARE BASED ON VISIBLE INSPECTION OF PIPE AND CONDUITS DURING THE TIME OF SURVEY AND UTILITY MARK OUT BY SINGER UTILITY ENGINEERING, P.C..
- 12. MAP ENTITLED "UTILITY DESIGNATING PLAN, PENNYPACK PARK, PHILADELPHIA, PA" PREPARED BY SINGER UTILITY ENGINEERING, PC, JOB #21-063PA, SHEET 1 OF 1.
- 13. STREET STATUS CARD LC016658.
- 14. PER PHILADELPHIA WATER DEPARTMENT RECORD DRAWING 248922, THERE IS A 12" WATER MAIN ALONG RHAWN STREET. THERE ARE NO STORMSEWER LINES IN RHAWN STREET.
- 15. TREE LOCATIONS, SPECIES, AND CALIPER TAKEN A FROM A REPORT TITLEED "PENNYPACK PARK PLAYGROUND TREE MANAGEMENT PLAN" PREPARED BY MORRIS ARBORETUM OF THE UNIVERSITY OF PENNSYLVANIA – URBAN FORESTRY CONSULTANTS, DATED 6/13/2022

### FLOOD ZONE INFORMATION:

1. BY GRAPHIC PLOTTING ONLY, SUBJECT PARCEL AREA IS LOCATED IN ZONE X OF THE FLOOD INSURANCE RATE MAP, PANEL NO. 116 OF 230, COMMUNITY MAP NO. 4207570116GWHICH BEARS AN EFFECTIVE DATE OF JANUARY 17, 2007. NO FIELD SURVEYING WAS PERFORMED TO DETERMINE THIS ZONE AND AN ELEVATION CERTIFICATE MAY BE NEEDED TO VERIFY THIS DETERMINATION OR APPLY FOR A VARIANCE FROM THE FEDERAL EMERGENCY MANAGEMENT AGENCY.

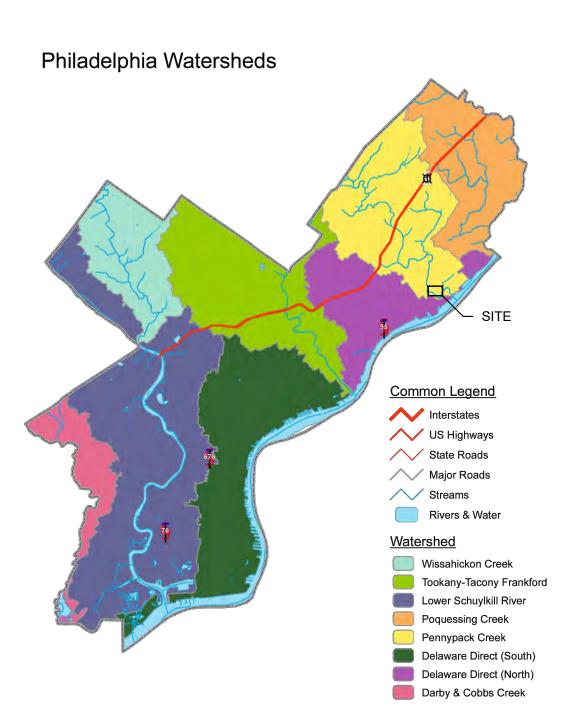

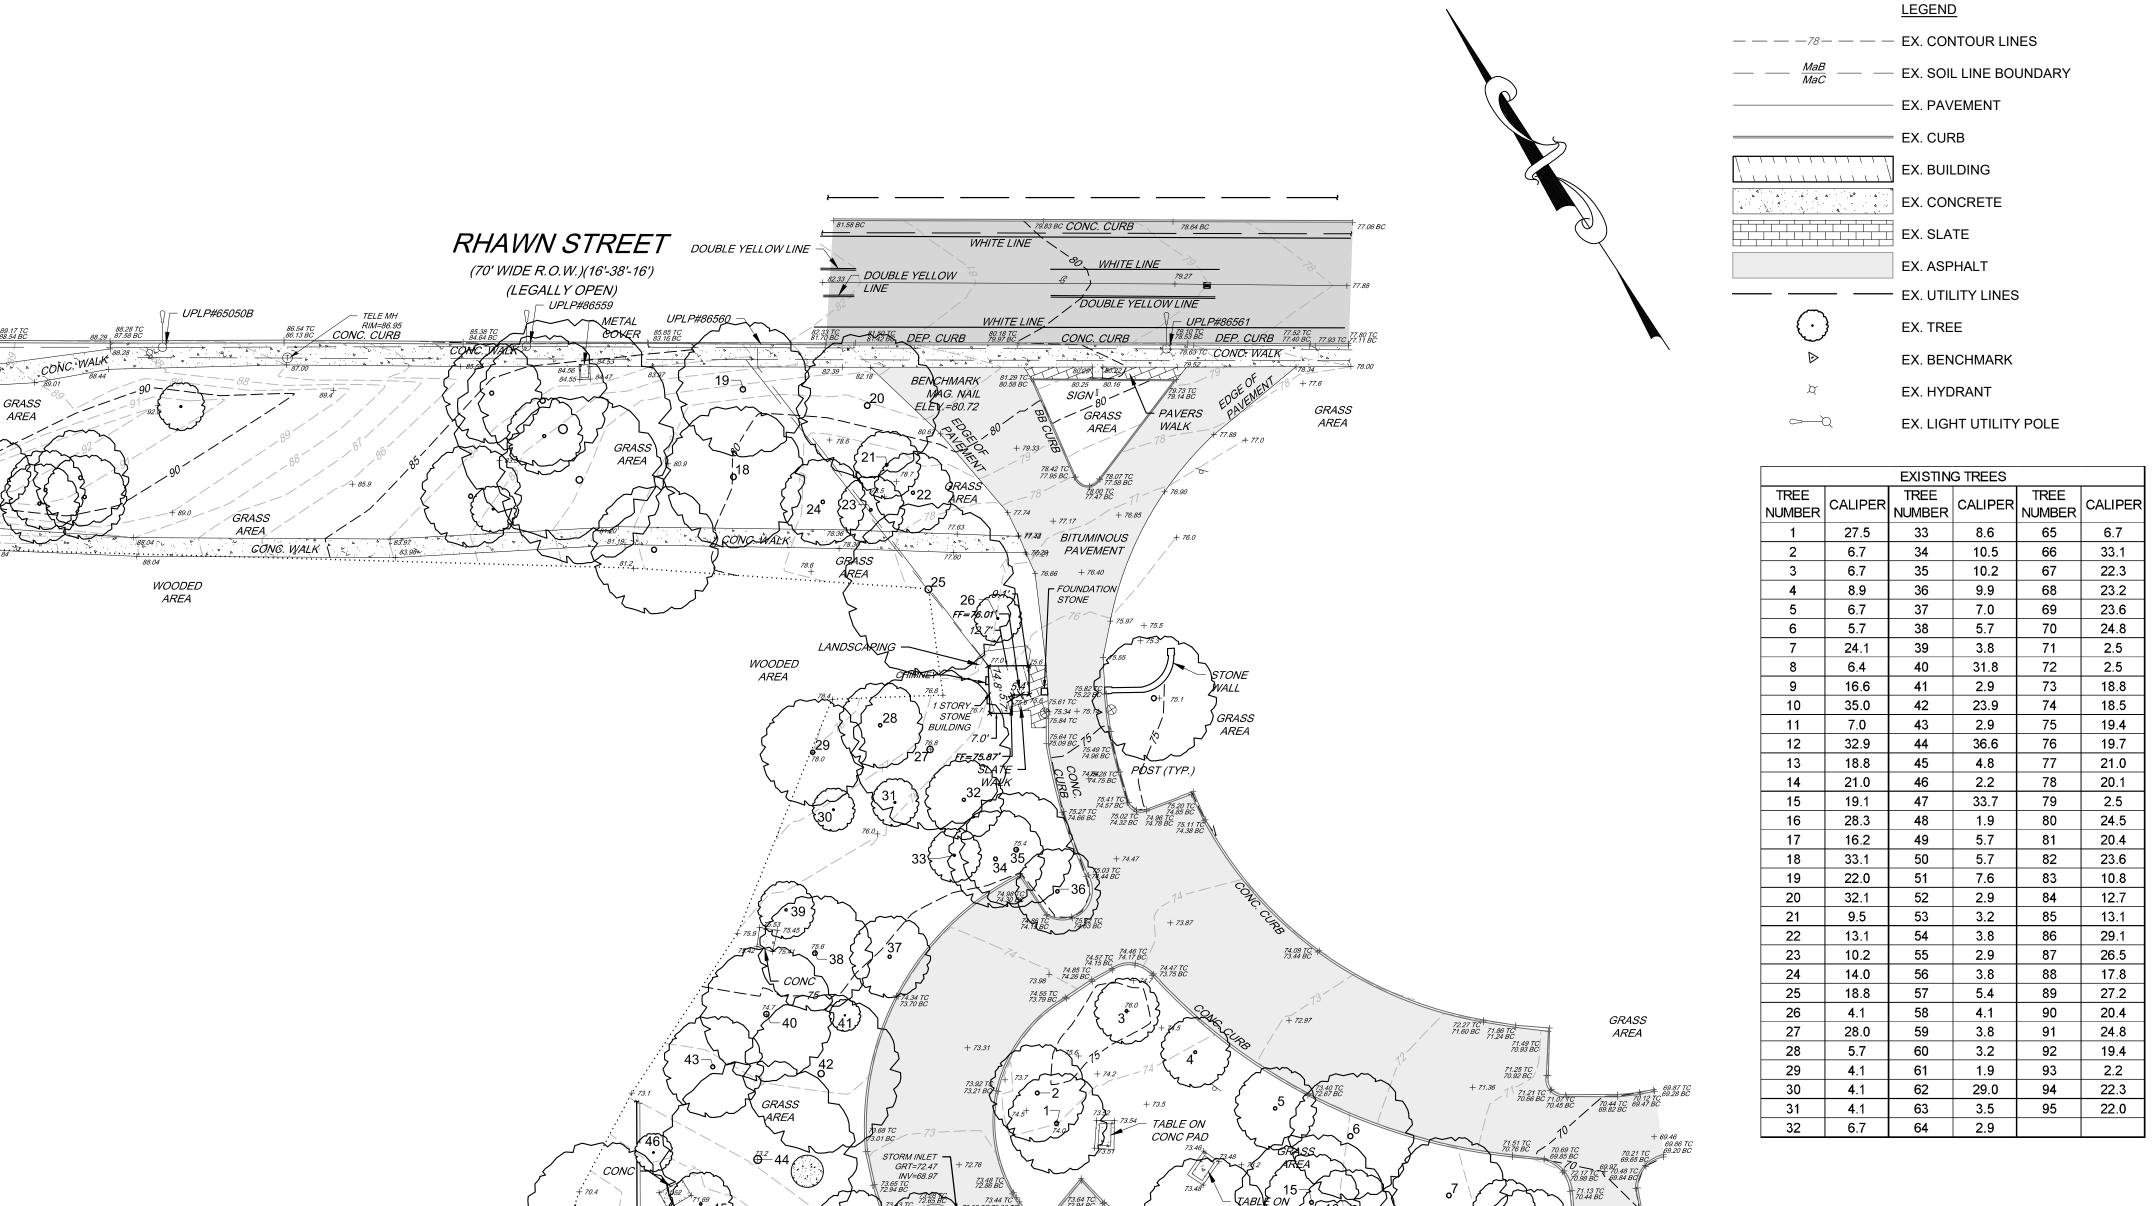

WOODED

AREA

STORM INLET -

GRT=72.29 INV.A=66.79

STONE BUILDING

– BENCHMARK

MAG. NAIL

ELEV.=70.96

- PLANTER INV.B=66.49

BOX


WOODED

TABLE ON -

FIREPLACE

WOODED

CONC PAD

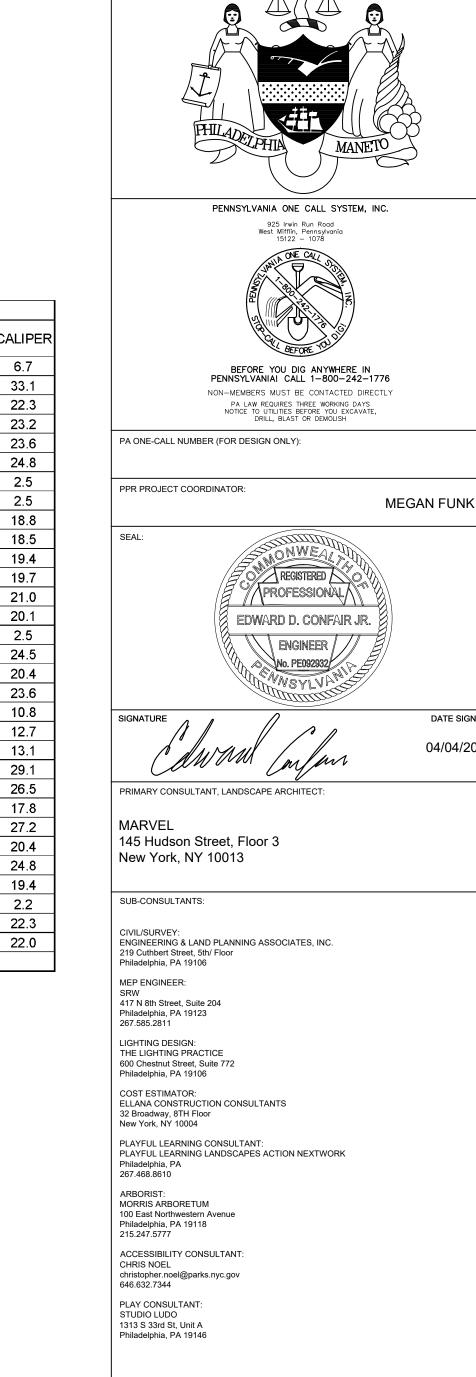

REVISIONS

REVISIONS

**ADDENDUM 1** 

04/04/2024

ISSUE

DATE

05/16/24

THE PROJECT SITE IS WITHIN PENNYPACK PARK SYSTEM AND DOES NOT HAVE IT'S OWN SITE ADDRESS. THEREFORE, THE PENNYPACK PARK SYSTEM'S ADDRESS AND OPA ACCOUNT NUMBER ARE ASSOCIATED WITH THIS PROJECT SITE. THE PROJECT SITE IS LOCATED JUST SOUTH OF THE INTERSECTION OF HOLMEHURST AVE AND RHAWN STREET. APPROXIMATE COORDINATES ARE 40°02'59" N, 75°02'09" W.

71.62 TC 71.05 BCy 71.76 TC ( 71.17 BC (

SCALE:1":30'

+ 71.36 71.80 TC

ADDRESS: 8300 FRANKFORD AVE PHILADELPHIA, PA 19136 BRT/OPA: 871402520

PHILADELPHIA WATER TRACKING NO.: FY22-PENN-6850-01

PENNSYLVANIA ONE CALL SYSTEM, INC. SITE IDENTIFICATION NO.:

20220322281

925 Irwin Run Road

BEFORE YOU DIG ANYWHERE IN PENNSYLVANIA! CALL 1-800-242-1776 NON-MEMBERS MUST BE CONTACTED DIRECTLY PA LAW REQUIRES THREE WORKING DAYS NOTICE TO UTILITIES BEFORE YOU EXCAVATE, DRILL, BLAST OR DEMOLISH



1515 ARCH STREET

11TH FLOOR, ONE PARKWAY BUILDING PPR PROJECT NUMBER

CONSULTANT PROJECT NUMBER

16-21-7062-01

### PENNYPACK PARK UNIVERSAL PLAYGROUND

RHAWN ST. & HOLMEHURST AVE.

PHILADELPHIA, PA 19136 DRAWING TITLE:


### **EXISTING CONDITIONS PLAN**


PPR PROJECT NO.: 16-21-7062-01 CONSULTANT PROJECT NO 12/15/2023 SCALE: AS NOTED DRAWN BY


CHECKED BY:


ALL DIMENSIONS AND CONDITIONS SHALL BE VERIFIED BY THE CONTRACTOR AT THE SITE BEFORE PROCEEDING WITH THE WORK.


WATERSHED MAP

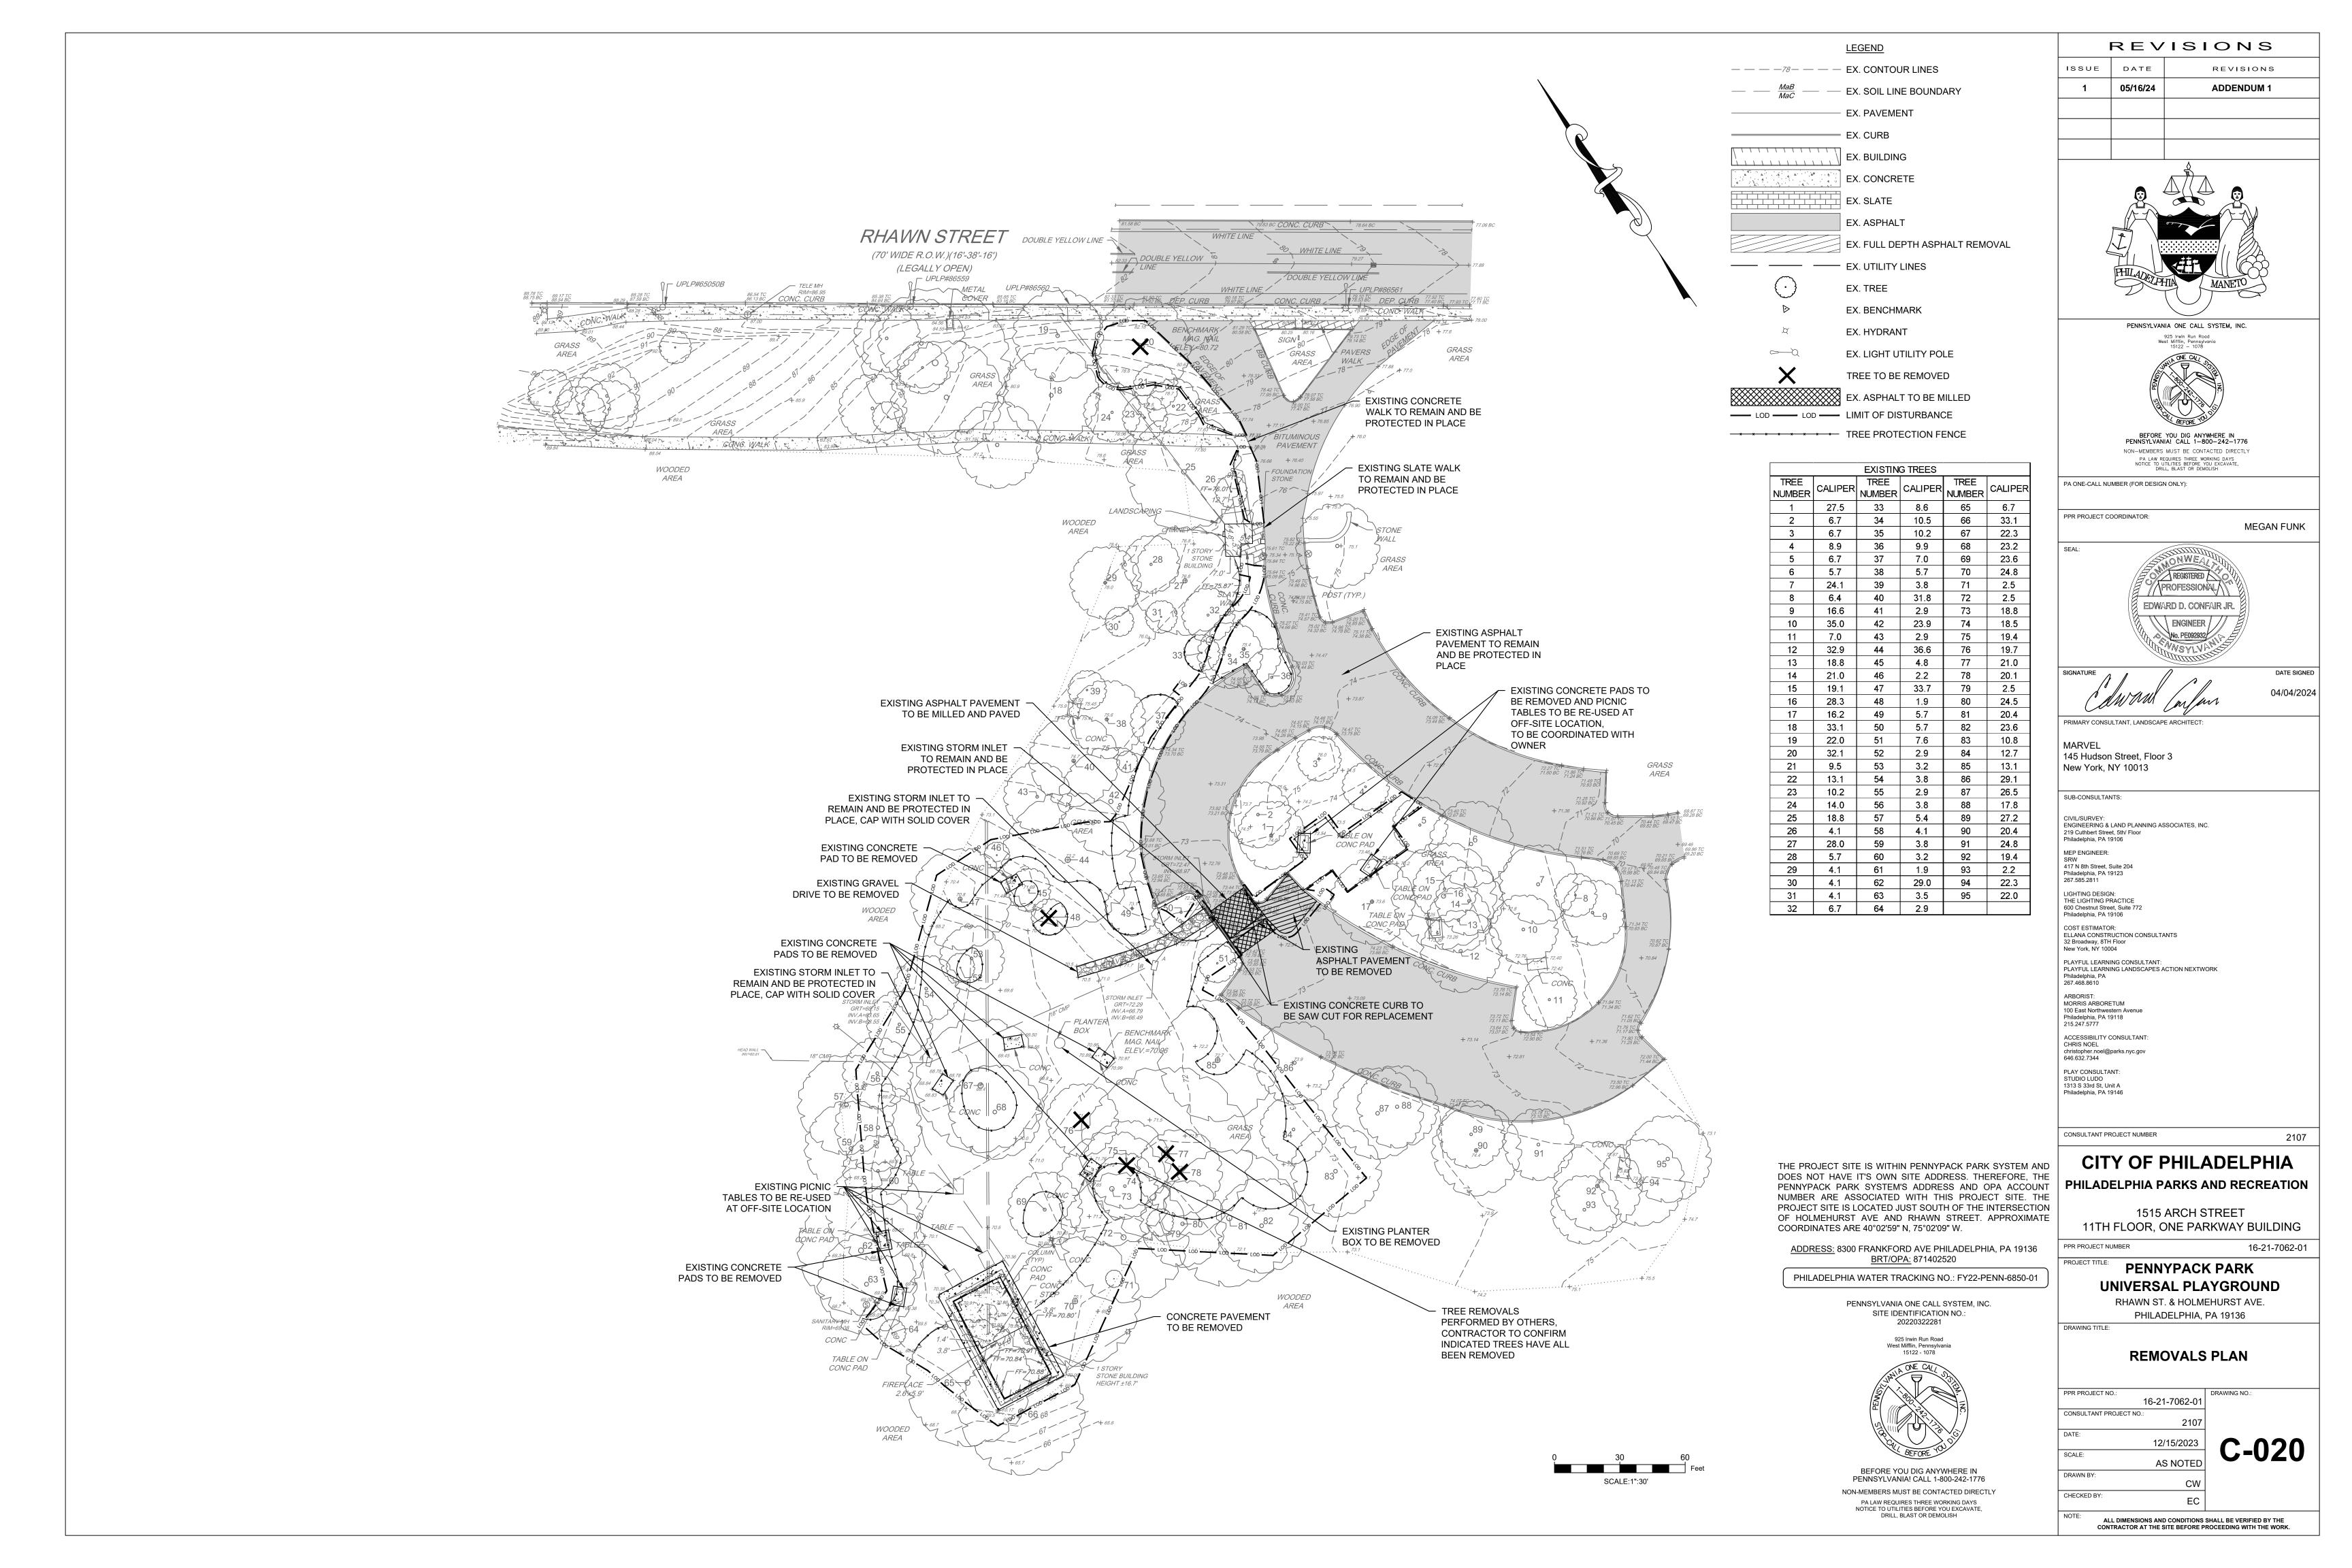

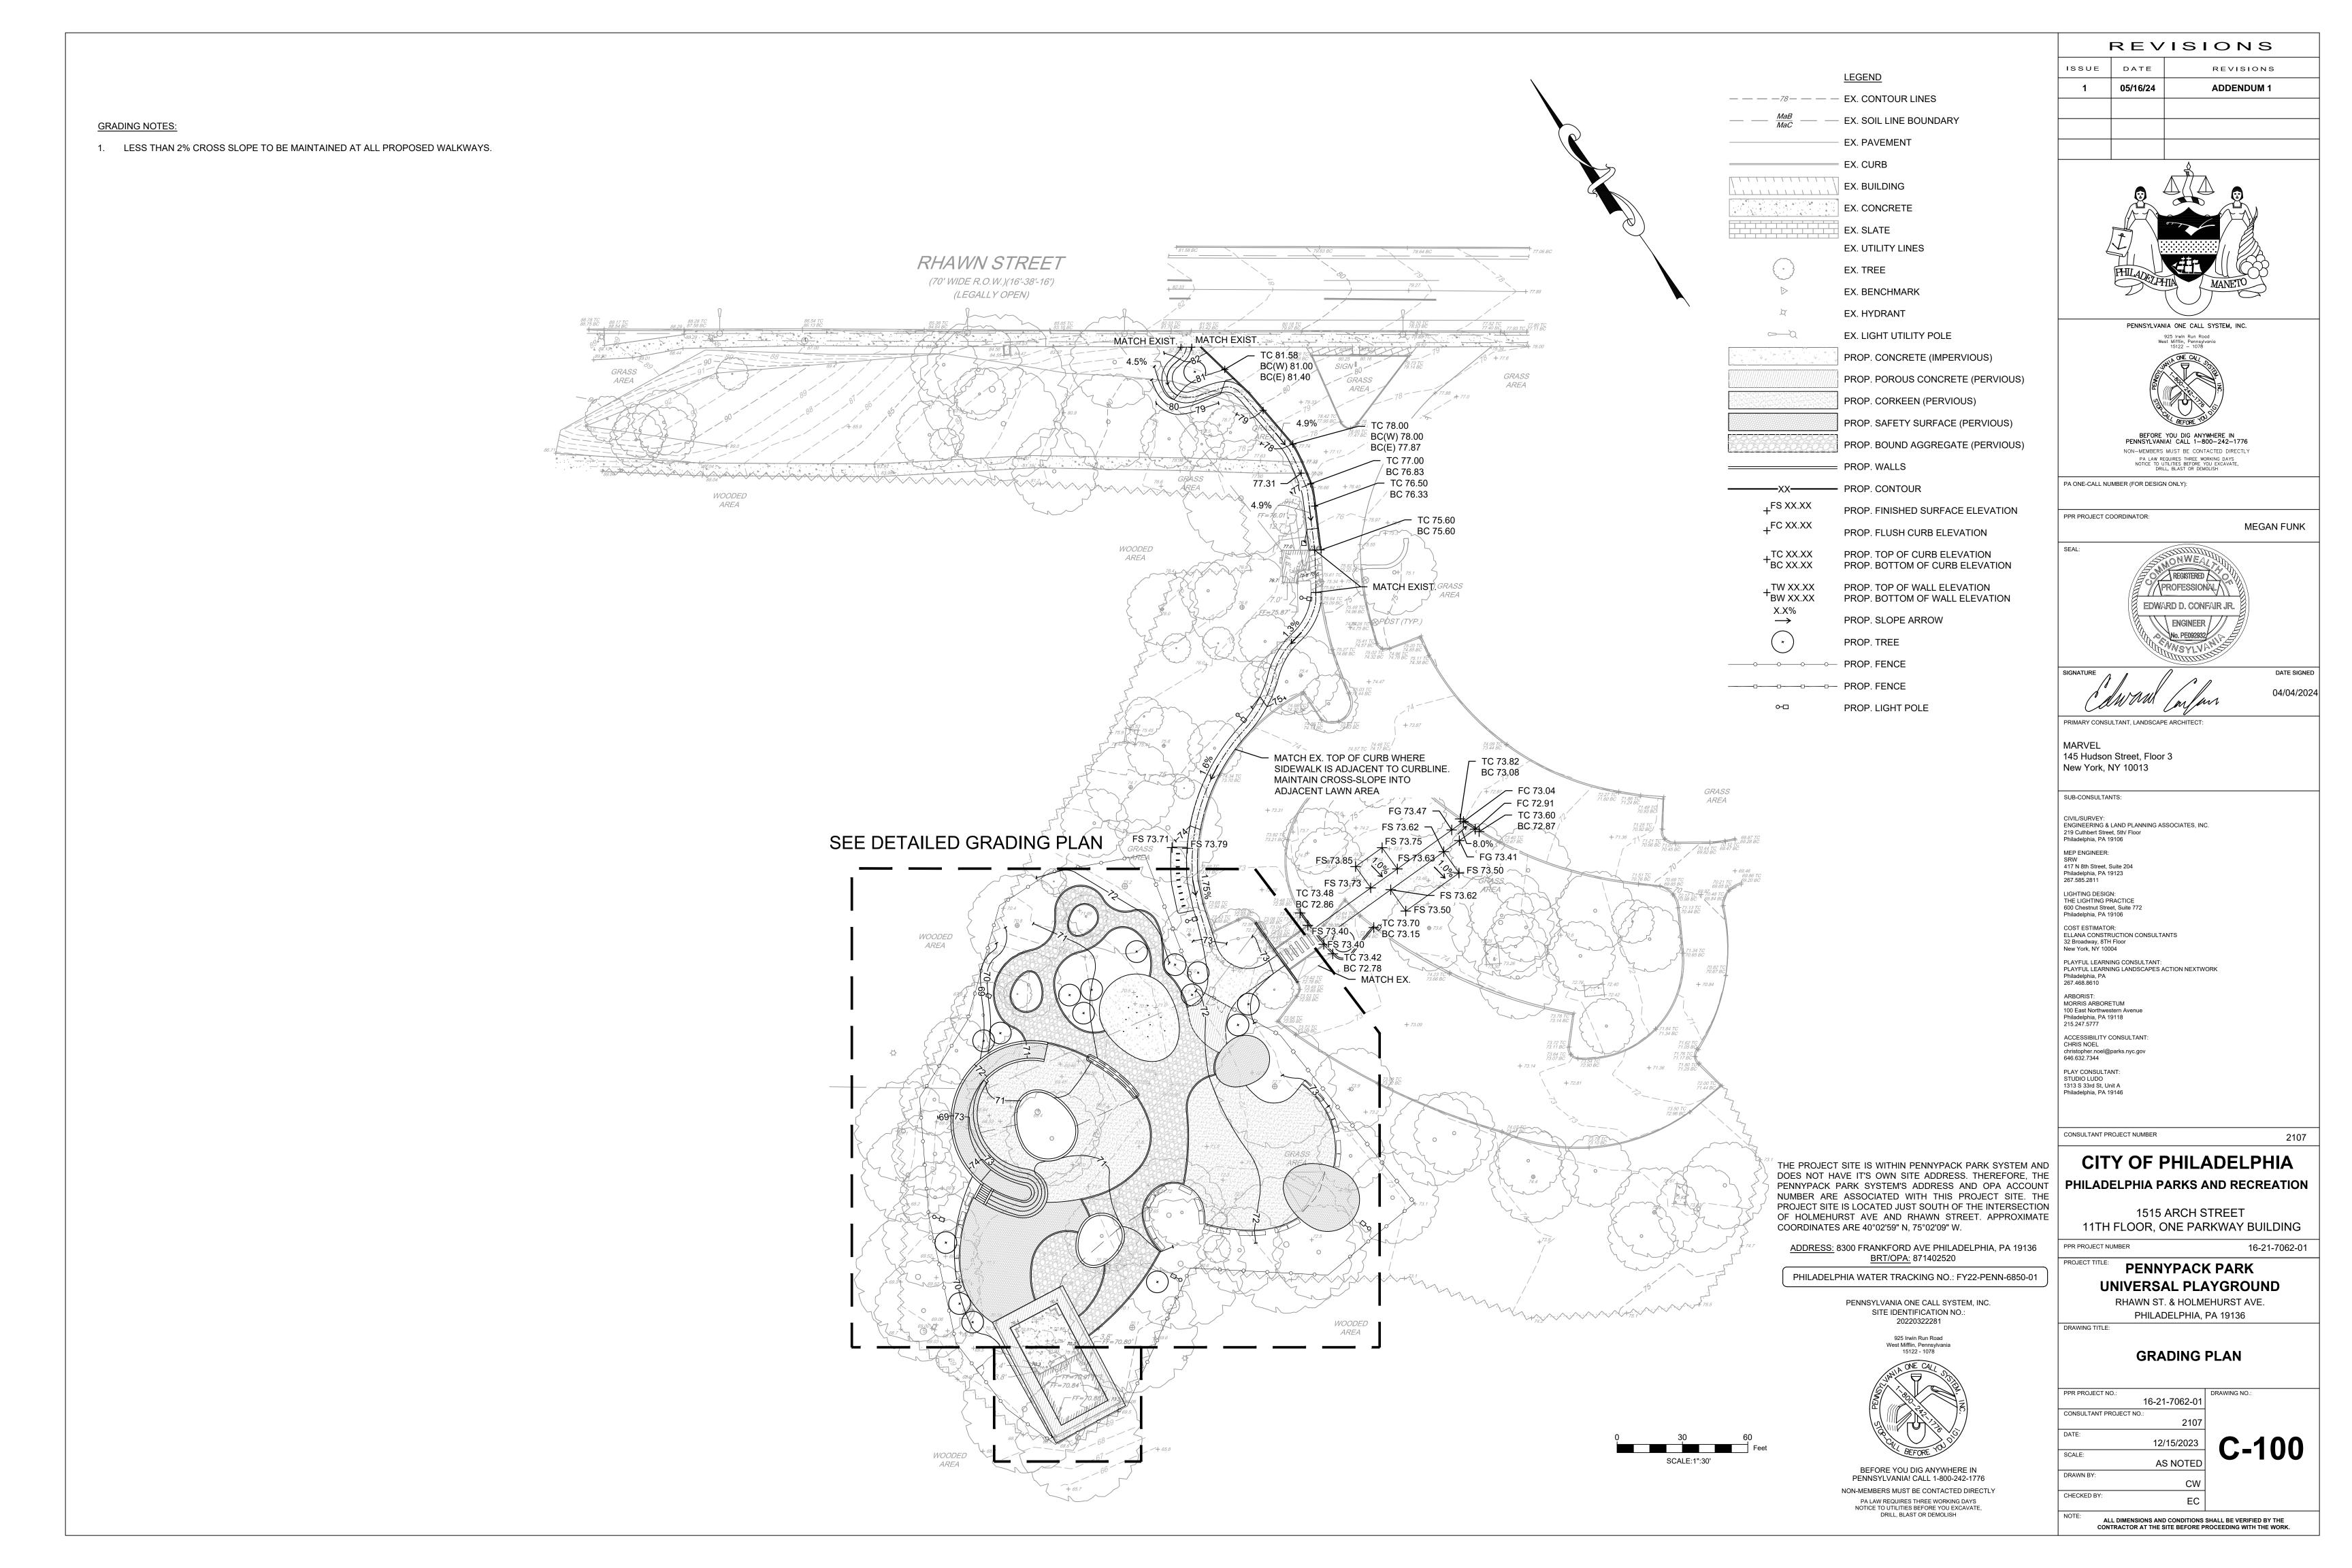

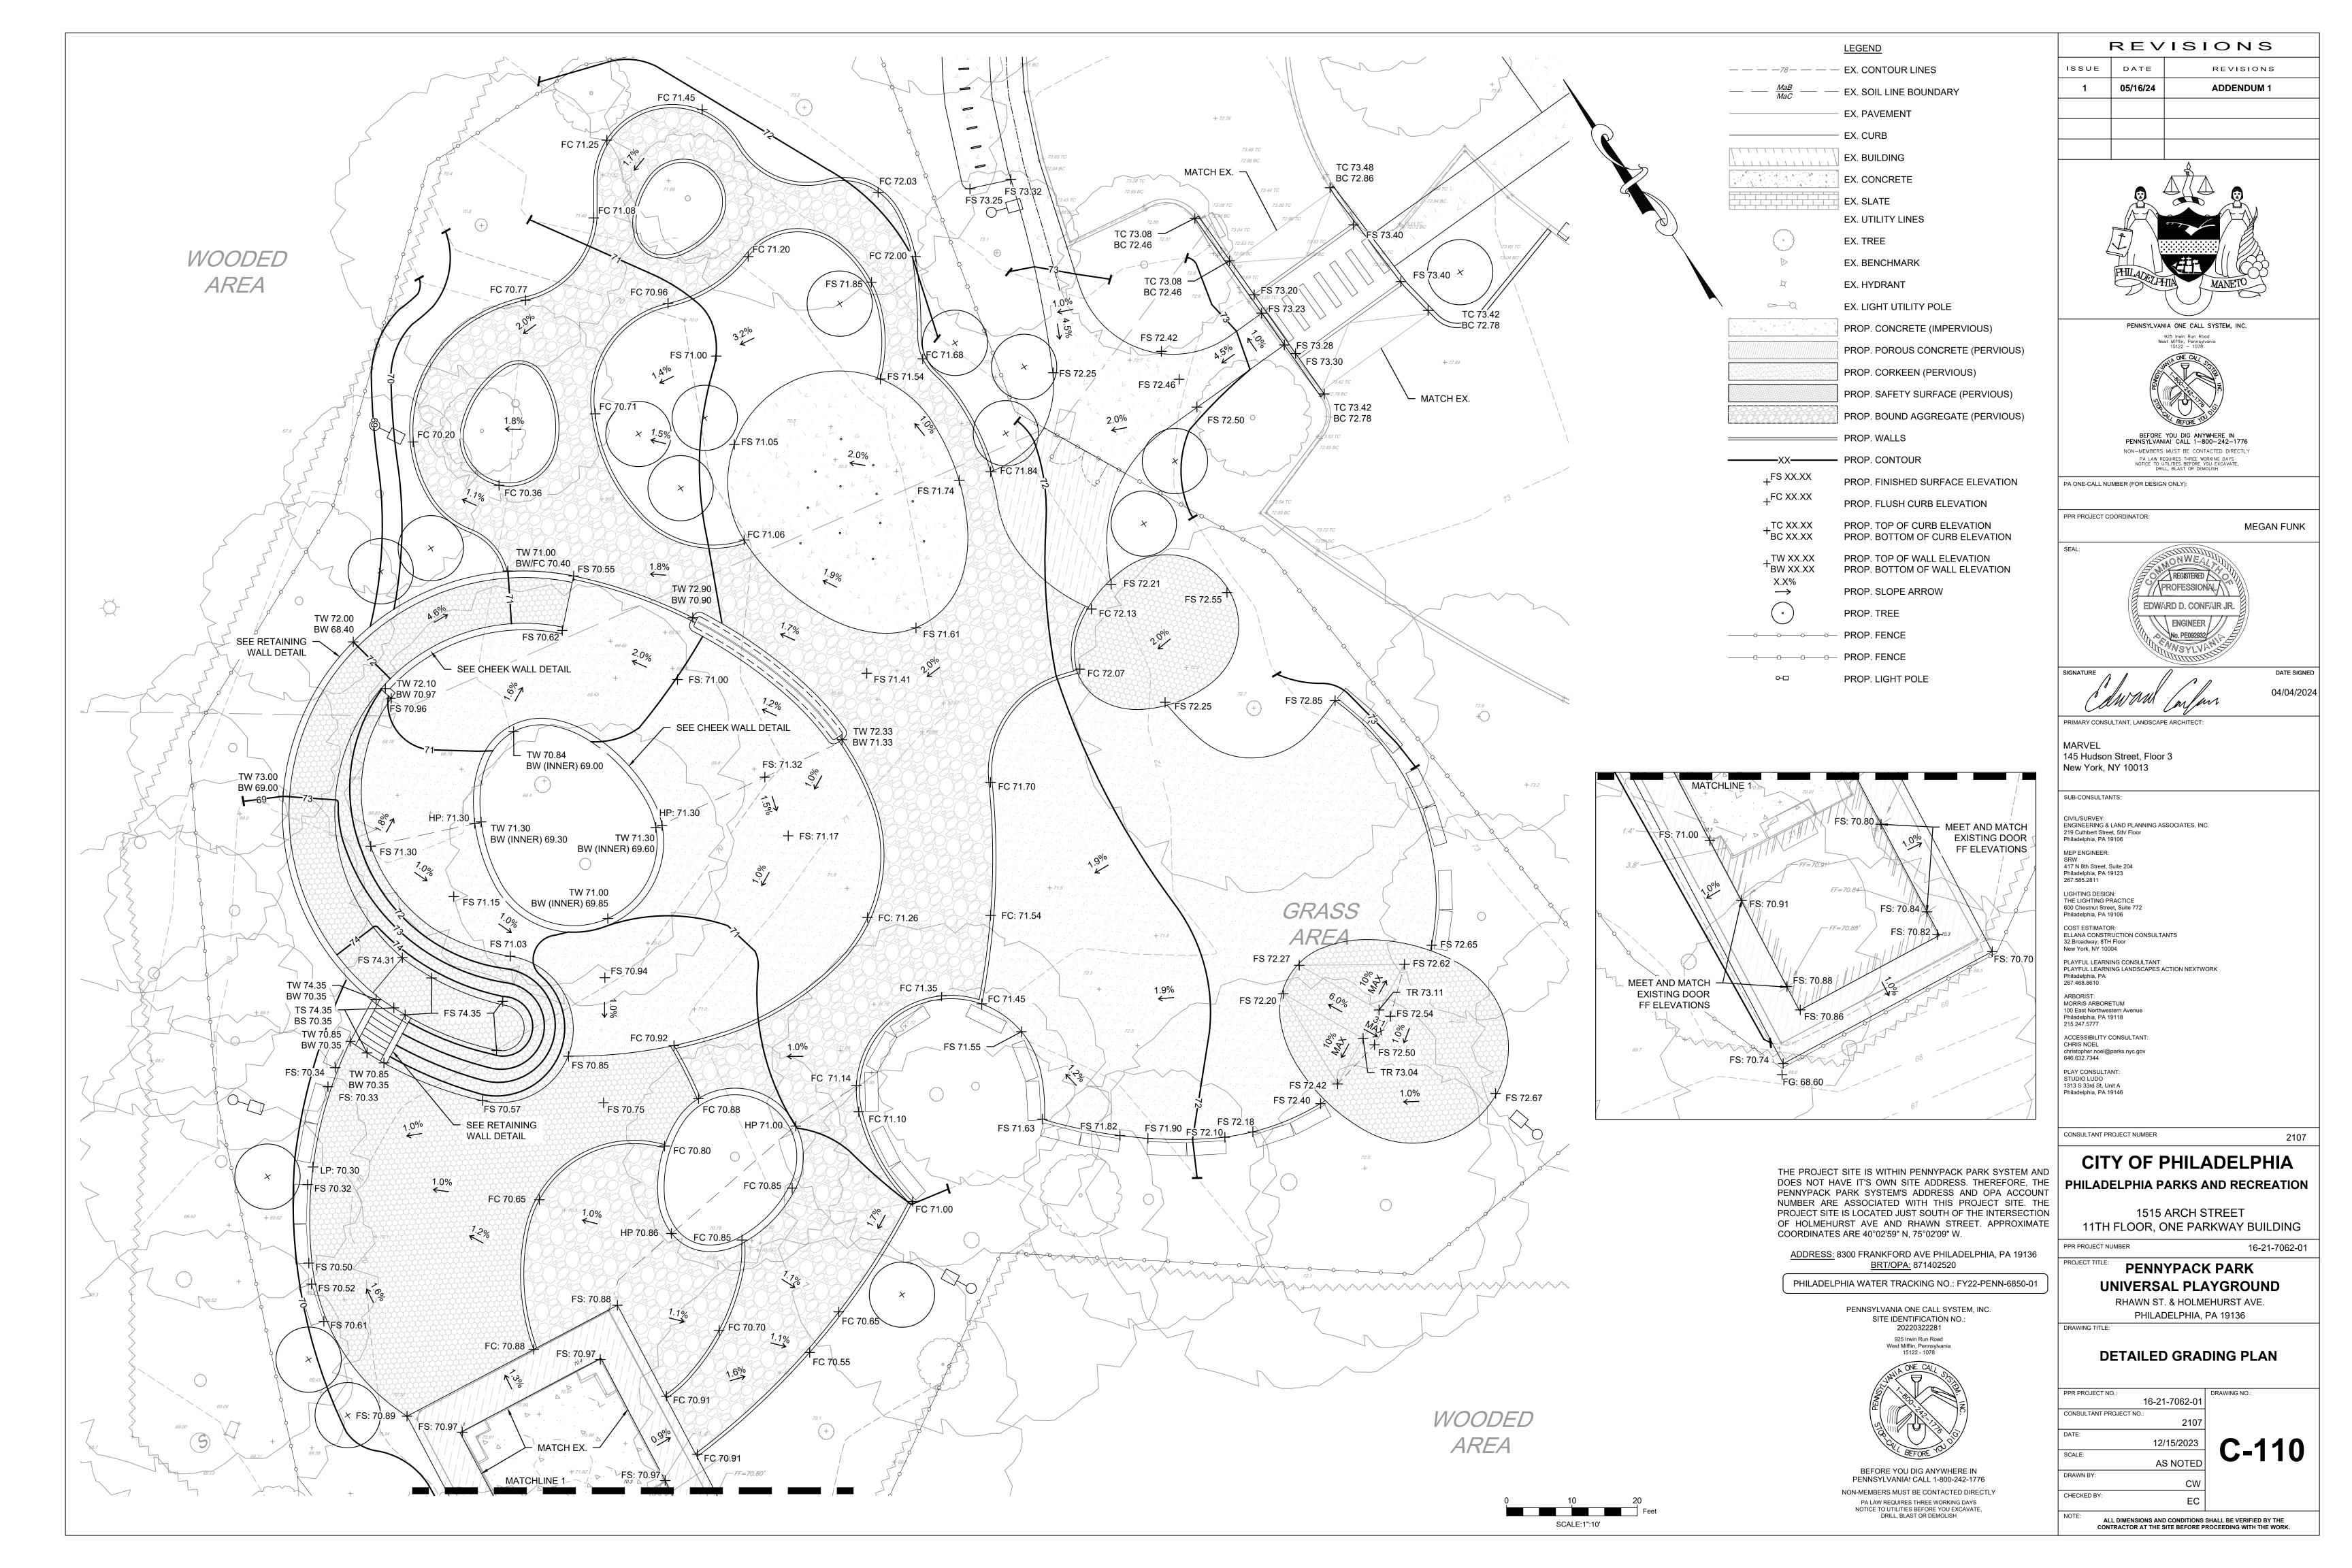


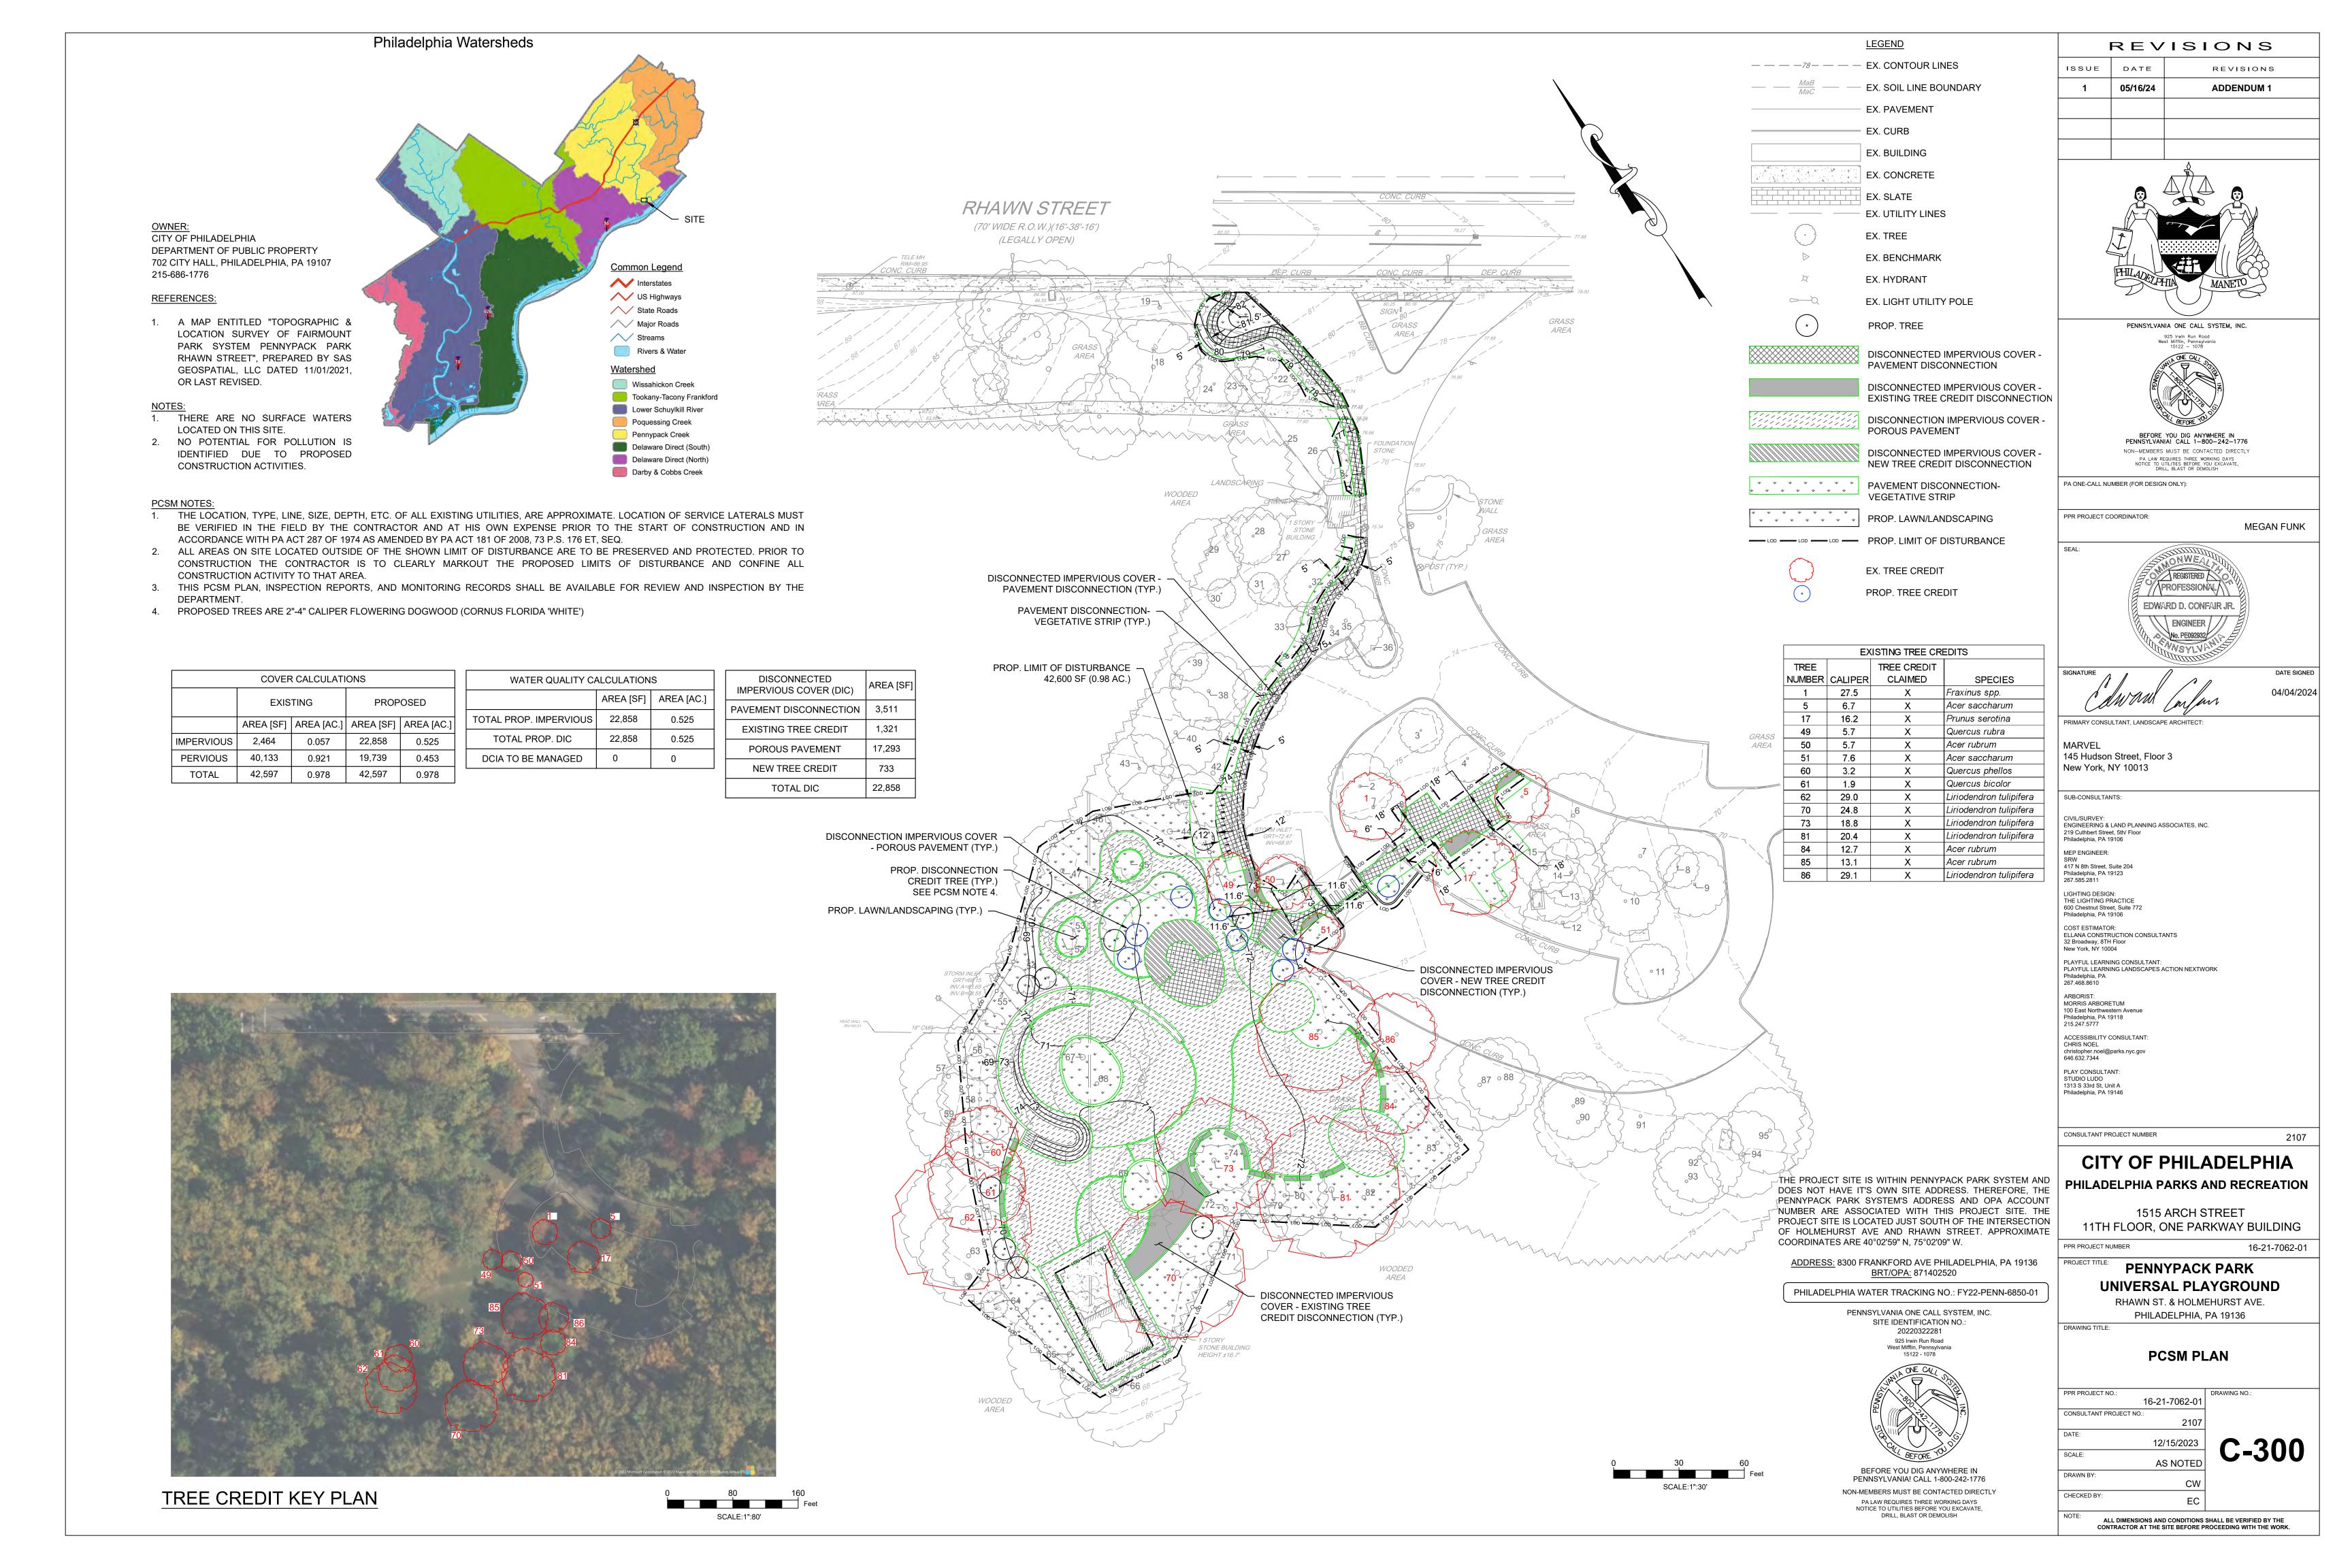

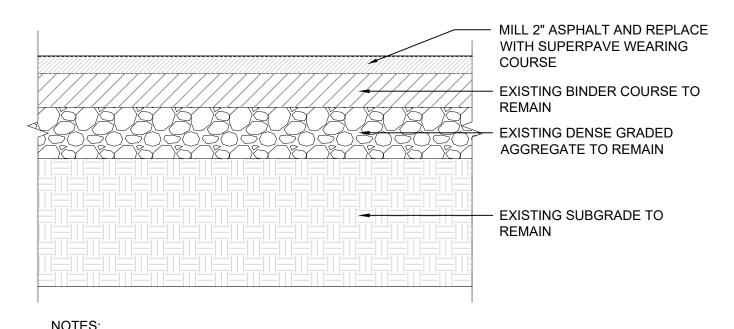

1. SUBBASE SHALL NOT BE DISTURBED DURING MILLING PROCESS.

MILL & OVERLAY DETAIL

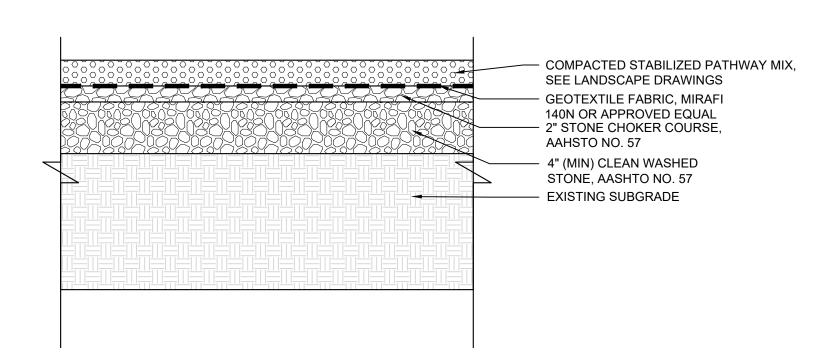

NTS

**BOUND AGGREGATE DETAIL** 


### STONE & CHOKER COURSE SPECIFICATIONS:

1. STONE STORAGE: STONE DESIGNED FOR STORMWATER STORAGE MUST BE UNIFORMLY GRADED, CRUSHED, CLEAN-WASHED STONE. PWD DEFINES "CLEAN-WASHED" AS HAVING LESS THAN 0.5% WASH LOSS, BY MASS, WHEN TESTED PER AASHTO T-11 WASH LOSS TEST.


CHOKER COURSE GRADATION:

U.S. STANDARD SIEVE SIZE PERCENT PASSING 1 ½" (37.5 MM) 100% 1" (25 MM) 95-100% ½" (19 MM) 25-60% #4 (4.75 MM) 0-10% 0-5% #8 (2.36 MM)

STONE & CHOKER COURSE SPECIFICATIONS

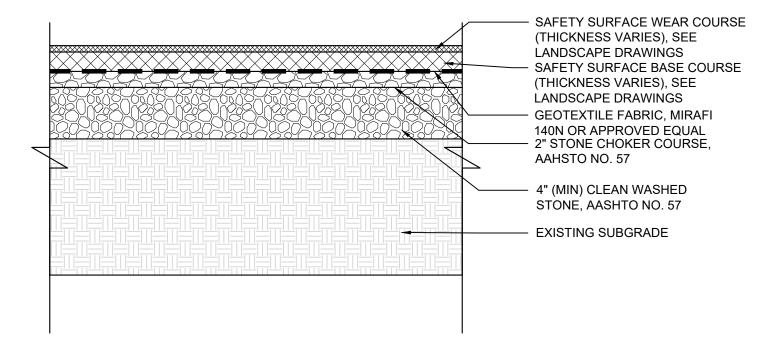

SAFETY SURFACE DETAIL

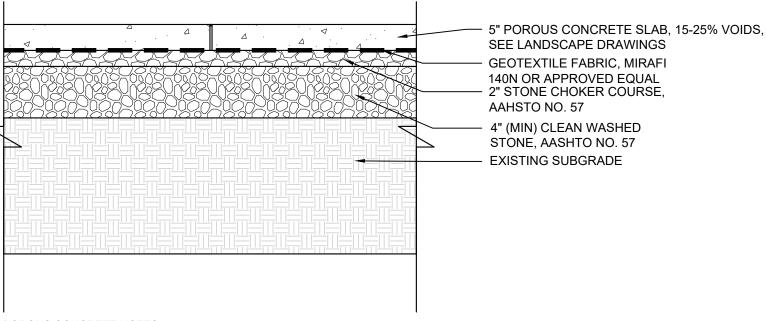

### POROUS CONCRETE NOTES:

- 1. POROUS CONCRETE SHALL UTILIZE PORTLAND CEMENT TYPE I OR II CONFORMING TO ASTM C 150 OR PORTLAND CEMENT TYPE IP OR IS CONFORMING TO ASTM C 595.
- 2. AGGREGATE SHALL BE NO. 8 COARSE AGGREGATE (3/8 TO NO. 16) PER ASTM C 33 OR NO. 89 COARSE AGGREGATE (3/8 TO NO. 50) PER
- 3. AN AGGREGATE/CEMENT RATIO RANGE OF 4:1 TO 4.5:1 AND A WATER/CEMENT RATIO RANGE OF 0.34 TO 0.40 SHOULD PRODUCE PERVIOUS PAVEMENT OF SATISFACTORY PROPERTIES IN REGARD TO PERMEABILITY, LOAD CARRYING CAPACITY, AND DURABILITY CHARACTERISTICS.

POROUS CONCRETE DETAIL


**GEOTEXTILE SPECIFICATIONS:** 

- 1. GEOTEXTILE SHALL CONSIST OF POLYPROPYLENE FIBERS AND MEET THE
- FOLLOWING SPECIFICATIONS: GRAB TENSILE STRENGTH (ASTM-D4632) > OR = 120 LBS.
- MULLEN BURST STRENGTH (ASTM-D3786) > OR = 225 LBS.
- FLOW RATE (ASTM-D4491) > OR = 95 GAL./MIN./FT<sup>2</sup> UV RESISTANCE AFTER 500 HRS. (ASTM-D4355) > OR = 70%
- HEAT-SET OR HEAT CALENDARED FABRICS ARE NOT PERMITTED


GEOTEXTILE SPECIFICATIONS

NTS

NTS

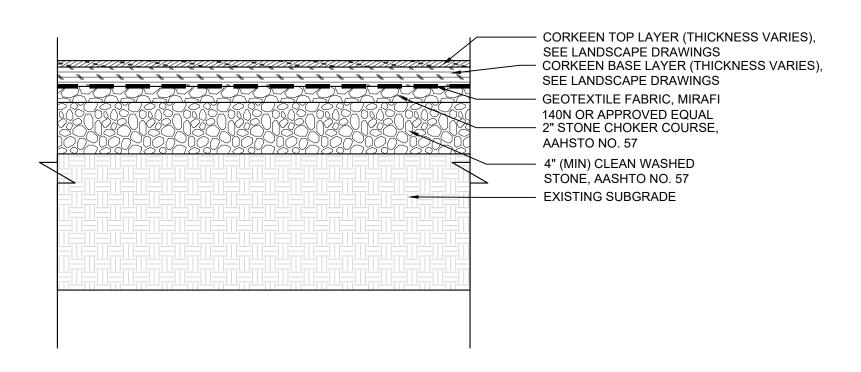

CORKEEN SURFACE DETAIL

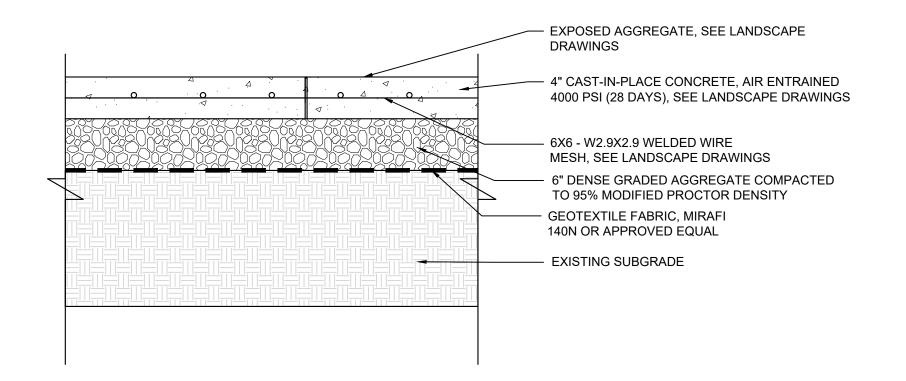

NTS

NTS

(6) IMPERVIOUS CIP CONCRETE DETAIL

THE PROJECT SITE IS WITHIN PENNYPACK PARK SYSTEM AND DOES NOT HAVE IT'S OWN SITE ADDRESS. THEREFORE, THE PENNYPACK PARK SYSTEM'S ADDRESS AND OPA ACCOUNT NUMBER ARE ASSOCIATED WITH THIS PROJECT SITE. THE PROJECT SITE IS LOCATED JUST SOUTH OF THE INTERSECTION OF HOLMEHURST AVE AND RHAWN STREET. APPROXIMATE COORDINATES ARE 40°02'59" N, 75°02'09" W.

ADDRESS: 8300 FRANKFORD AVE PHILADELPHIA, PA 19136 BRT/OPA: 871402520

PHILADELPHIA WATER TRACKING NO.: FY22-PENN-6850-01

PENNSYLVANIA ONE CALL SYSTEM, INC. SITE IDENTIFICATION NO.: 20220322281 925 Irwin Run Road



BEFORE YOU DIG ANYWHERE IN PENNSYLVANIA! CALL 1-800-242-1776 NON-MEMBERS MUST BE CONTACTED DIRECTLY PA LAW REQUIRES THREE WORKING DAYS NOTICE TO UTILITIES BEFORE YOU EXCAVATE, DRILL, BLAST OR DEMOLISH

CITY OF PHILADELPHIA PHILADELPHIA PARKS AND RECREATION 1515 ARCH STREET 11TH FLOOR, ONE PARKWAY BUILDING

CHECKED BY

PPR PROJECT NUMBER

PENNYPACK PARK UNIVERSAL PLAYGROUND

REVISIONS

PENNSYLVANIA ONE CALL SYSTEM, INC.

BEFORE YOU DIG ANYWHERE IN PENNSYLVANIA! CALL 1-800-242-1776

NON-MEMBERS MUST BE CONTACTED DIRECTLY PA LAW REQUIRES THREE WORKING DAYS NOTICE TO UTILITIES BEFORE YOU EXCAVATE, DRILL, BLAST OR DEMOLISH

 $\Lambda$ PROFESSIONAL/

EDWARD D. CONFAIR JR.

MEGAN FUNK

04/04/2024

2107

16-21-7062-01

PA ONE-CALL NUMBER (FOR DESIGN ONLY):

PRIMARY CONSULTANT, LANDSCAPE ARCHITECT:

ENGINEERING & LAND PLANNING ASSOCIATES, INC.

145 Hudson Street, Floor 3 New York, NY 10013

MARVEL

SUB-CONSULTANTS:

219 Cuthbert Street, 5th/ Floor Philadelphia, PA 19106

417 N 8th Street, Suite 204 Philadelphia, PA 19123 267.585.2811

LIGHTING DESIGN: THE LIGHTING PRACTICE
600 Chestnut Street, Suite 772

Philadelphia, PA 19106 COST ESTIMATOR:

New York, NY 10004

MORRIS ARBORETUM

100 East Northwestern Avenue Philadelphia, PA 19118 215.247.5777

ACCESSIBILITY CONSULTANT:

christopher.noel@parks.nyc.gov

CONSULTANT PROJECT NUMBER

Philadelphia, PA

CHRIS NOEL

646.632.7344

PLAY CONSULTANT:

1313 S 33rd St, Unit A

Philadelphia, PA 19146

ELLANA CONSTRUCTION CONSULTANTS

PLAYFUL LEARNING LANDSCAPES ACTION NEXTWORK

PLAYFUL LEARNING CONSULTANT:

CIVIL/SURVEY

MEP ENGINEER:

PPR PROJECT COORDINATOR:

REVISIONS

**ADDENDUM 1** 

ISSUE

DATE


05/16/24

RHAWN ST. & HOLMEHURST AVE. PHILADELPHIA, PA 19136 DRAWING TITLE:

**PCSM DETAILS** 

PPR PROJECT NO.: 16-21-7062-01 CONSULTANT PROJECT NO .: 12/15/2023 SCALE: AS NOTED DRAWN BY:

ALL DIMENSIONS AND CONDITIONS SHALL BE VERIFIED BY THE CONTRACTOR AT THE SITE BEFORE PROCEEDING WITH THE WORK.

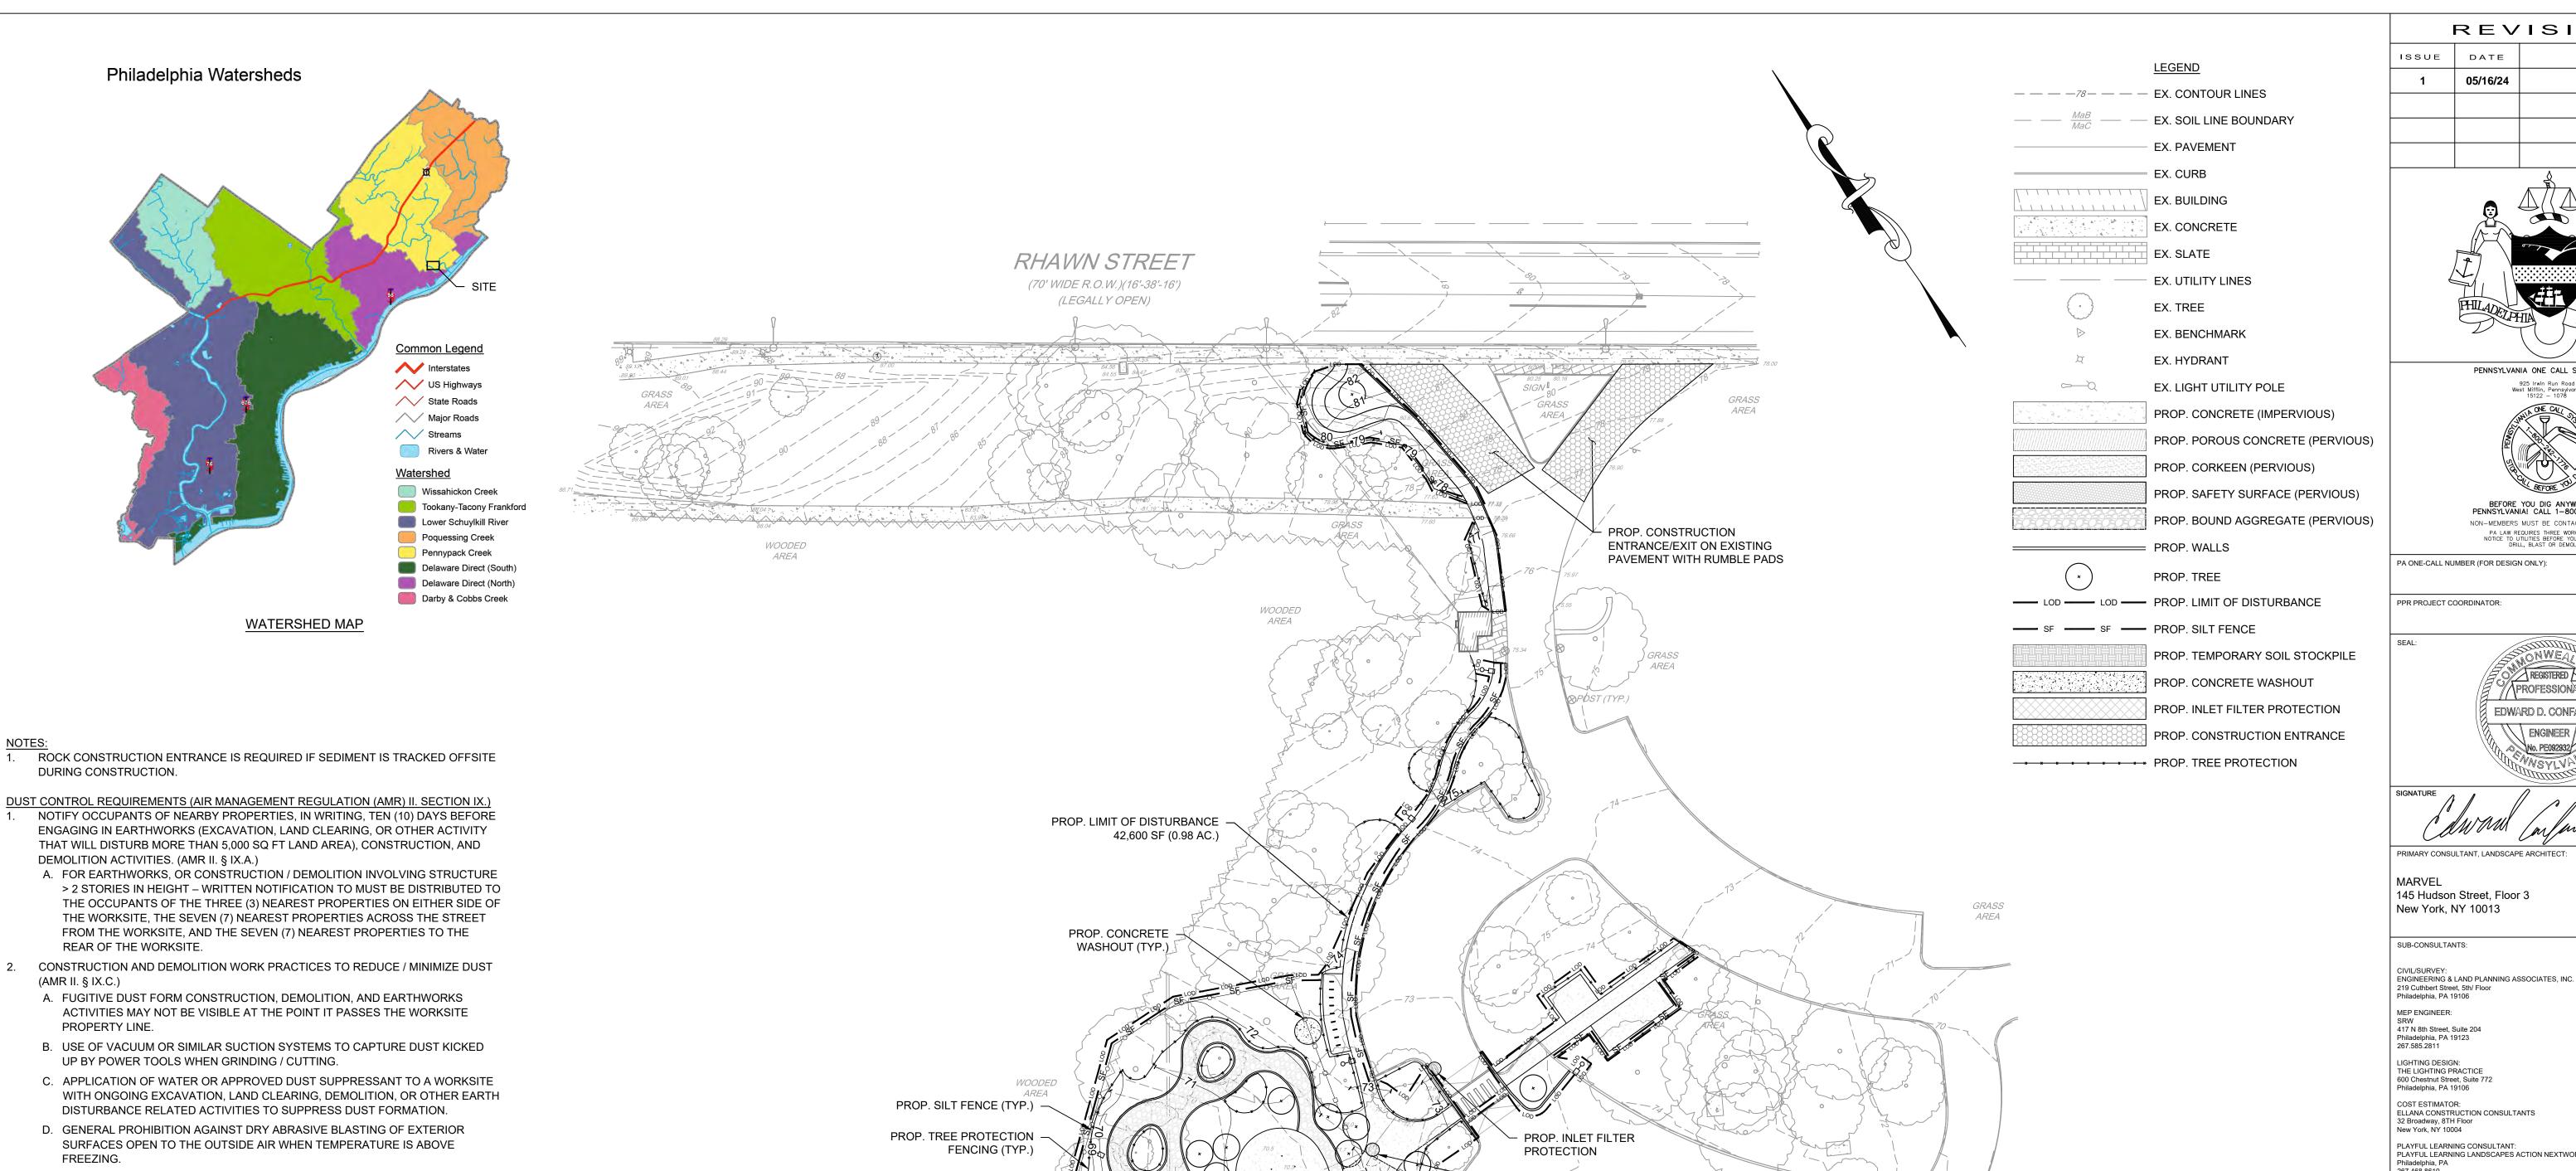

COST ESTIMATOR: ELLANA CONSTRUCTION CONSULTANTS New York, NY 10004 PLAYFUL LEARNING CONSULTANT: PLAYFUL LEARNING LANDSCAPES ACTION NEXTWORK

Philadelphia, PA ARBORIST: MORRIS ARBORETUM

100 East Northwestern Avenue Philadelphia, PA 19118 215.247.5777 ACCESSIBILITY CONSULTANT: CHRIS NOEL christopher.noel@parks.nyc.gov

646.632.7344 PLAY CONSULTANT: 1313 S 33rd St, Unit A Philadelphia, PA 19146

CONSULTANT PROJECT NUMBER

### CITY OF PHILADELPHIA PHILADELPHIA PARKS AND RECREATION

REVISIONS

PENNSYLVANIA ONE CALL SYSTEM, INC.

NON-MEMBERS MUST BE CONTACTED DIRECTLY

/\PROFESSIONAL/

EDWARD D. CONFAIR JR. \engineer /

MEGAN FUNK

04/04/2024

05/16/24

REVISIONS

**ADDENDUM 1** 

1515 ARCH STREET

11TH FLOOR, ONE PARKWAY BUILDING

PPR PROJECT NUMBER 16-21-7062-01

### PENNYPACK PARK UNIVERSAL PLAYGROUND

RHAWN ST. & HOLMEHURST AVE.

PHILADELPHIA, PA 19136

**E&SC PLAN** 

PPR PROJECT NO.: 16-21-7062-01 CONSULTANT PROJECT NO .: 12/15/2023 SCALE: AS NOTED DRAWN BY:

CHECKED BY

ALL DIMENSIONS AND CONDITIONS SHALL BE VERIFIED BY THE

PROP. INLET FILTER

PROTECTION

AREA

I. WETTING AND SWEEPING OF ROADWAYS / ACCESS ROADS IN A WORKSITE TO J. VEHICLE ACCESS POINTS MUST BE EQUIPPED WITH DUST SUPPRESSION MEASURES (I.E. WHEEL WASH SYSTEMS, RUMBLE GRATES, AND/OR GRAVEL

E. COVERING AND WETTING OF STOCKPILED EARTH, SAND, GRAVEL, AND OTHER

THAN 20 FT OUTSIDE OF THE EXTERIOR WALLS OF A BUILDING OR STRUCTURE.

MATERIALS MUST BE WETTED WHEN DROPPED, AND / OR EXIT OF CHUTE MUST

FABRIC; MUST MEASURE A MINIMUM OF 5 FT IN HEIGHT FROM THE BOTTOM OF

BE SEALED AGAINST THE TOP OF THE RECEIVING CONTAINER / DUMPSTER.

G. ALL TEMPORARY PERIMETER FENCING AROUND MUST HAVE DUST CONTROL

H. A 10 MILES PER HOUR SPEED LIMIT FOR ALL EQUIPMENT AND TRUCKS

F. USE OF A MATERIAL CHUTE WHEN DROPPING MATERIAL OR DEBRIS MORE

SIMILAR CONSTRUCTION MATERIALS.

TRAVELING WITHIN THE WORKSITE.

PREVENT DUST FORMATION.

THE FENCING.

PADS)

PROP. INLET FILTER

PROTECTION

WOODED AREA

PROP. TEMPORARY SOIL STOCKPILE (TYP.)

WOODED

SCALE:1":30'

BEFORE YOU DIG ANYWHERE IN PENNSYLVANIA! CALL 1-800-242-1776 NON-MEMBERS MUST BE CONTACTED DIRECTLY PA LAW REQUIRES THREE WORKING DAYS NOTICE TO UTILITIES BEFORE YOU EXCAVATE, DRILL, BLAST OR DEMOLISH

THE PROJECT SITE IS WITHIN PENNYPACK PARK SYSTEM AND

DOES NOT HAVE IT'S OWN SITE ADDRESS. THEREFORE, THE

PENNYPACK PARK SYSTEM'S ADDRESS AND OPA ACCOUNT

NUMBER ARE ASSOCIATED WITH THIS PROJECT SITE. THE PROJECT SITE IS LOCATED JUST SOUTH OF THE INTERSECTION

OF HOLMEHURST AVE AND RHAWN STREET. APPROXIMATE

ADDRESS: 8300 FRANKFORD AVE PHILADELPHIA, PA 19136 BRT/OPA: 871402520

PHILADELPHIA WATER TRACKING NO.: FY22-PENN-6850-01

PENNSYLVANIA ONE CALL SYSTEM, INC.

925 Irwin Run Road West Mifflin, Pennsylvania

SITE IDENTIFICATION NO.:

20220322281

COORDINATES ARE 40°02'59" N, 75°02'09" W.

- AN INDUSTRIAL WASTE PERMIT WILL BE REQUIRED SHOULD 25. FILL SHALL NOT BE PLACED ON SATURATED OR FROZEN PUMPING TO CITY-OWNED INFRASTRUCTURE BECOME WATER FROM ANY WORK AREA SHALL BE DONE ACCORDING TO THE PROCEDURE DESCRIBED IN THIS PLAN, OVER UNDISTURBED VEGETATED AREAS.
- OWNED BY PWD THAT ARE LOCATED WITHIN ONE BLOCK OF THE PROJECT SITE.
- 3. PWD IS NOT RESPONSIBLE FOR ANY CLEANING OR REPAIRS NEEDED ON CITY-OWNED INFRASTRUCTURE DUE TO FAILURE OF ANY EROSION AND SEDIMENT CONTROL PRACTICES. THE OWNER SHALL BE RESPONSIBLE FOR THESE MEASURES: CITY OF PHILADELPHIA

### DEPARTMENT OF PUBLIC PROPERTY 702 CITY HALL, PHILADELPHIA, PA 19107

EVENTS.

- 215-686-1776 INSPECTION AND MAINTENANCE OF ALL EROSION AND SEDIMENT CONTROL BEST MANAGEMENT PRACTICES SHALL OCCUR ON A WEEKLY BASIS, BEFORE ANY ANTICIPATED PRECIPITATION EVENTS, AND AFTER ALL PRECIPITATION
- THE MAXIMUM HEIGHT FOR STOCKPILES AREAS SHALL BE 20 FEET. THE MAXIMUM SIDE SLOPE FOR STOCKPILE AREAS
- THE ROCK CONSTRUCTION ENTRANCE THICKNESS SHALL BE MAINTAINED ON-SITE FOR THIS PURPOSE. AT THE END OF EACH CONSTRUCTION DAY, ALL SEDIMENT DEPOSITED ON PAVED ROADWAYS SHALL BE REMOVED AND RETURNED TO THE CONSTRUCTION SITE. IN NO CASE SHALL THE SEDIMENT BE WASHED. SHOVELED. OR SWEPT INTO ANY ROADSIDE DITCH, STORM SEWER, OR SURFACE WATER.
- FILTER FABRIC FENCE SHOULD BE INSTALLED AT LEVEL GRADE. BOTH ENDS OF EACH FENCE SECTION SHOULD BE EXTENDED AT LEAST 8 FEET UPSLOPE AT 45 DEGREES TO THE MAIN BARRIER ALIGNMENT. SUPPORT STAKES SHALL BE SPACED AT A MAXIMUM OF 8 FEET. SEDIMENT MUST BE REMOVED WHEN ACCUMULATIONS REACH 1/2 THE ABOVE 31. GROUND HEIGHT OF THE FILTER FENCE.
- ANY FENCE SECTION WHICH HAS BEEN UNDERMINED OR TOPPED MUST BE IMMEDIATELY REPLACED WITH A ROCK FILTER OUTLET. SEDIMENT MUST BE REMOVED WHEN ACCUMULATIONS REACH 1/3 THE HEIGHT OF THE OUTLET.
- EROSION CONTROL BLANKETING SHALL BE INSTALLED ON ALL SLOPES 3H:1V OR STEEPER WITHIN 50 FEET OF A SURFACE WATER AND ON ALL OTHER DISTURBED AREAS SPECIFIED ON THE PLAN MAPS AND/OR DETAIL SHEETS.
- 10. IMMEDIATELY UPON DISCOVERING UNFORESEEN CIRCUMSTANCES POSING THE POTENTIAL FOR ACCELERATED EROSION AND/OR SEDIMENT POLLUTION, THE OPERATOR SHALL IMPLEMENT APPROPRIATE BEST MANAGEMENT SEDIMENT POLLUTION AND NOTIFY PWD AND PA DEP.
- 11. UNTIL THE SITE IS STABILIZED, ALL E&S BMPS SHALL BE MAINTAINED PROPERLY. MAINTENANCE SHALL INCLUDE INSPECTIONS OF ALL E&S BMPS PRIOR TO ANY ANTICIPATED 34. STORM EVENT, AFTER EACH RUNOFF EVENT AND ON A WEEKLY BASIS. ALL PREVENTATIVE AND REMEDIAL MAINTENANCE WORK, INCLUDING CLEAN OUT, REPAIR REPLACEMENT, REGRADING, RESEEDING, REMULCHING, AND RENETTING, MUST BE PERFORMED IMMEDIATELY. IF THE E&S BMPS FAIL TO PERFORM AS EXPECTED, REPLACEMENT BMPS, OR MODIFICATIONS OF THOSE INSTALLED, WILL BE REQUIRED. ALL EARTH DISTURBANCES, INCLUDING CLEARING AND
- GRUBBING, AS WELL AS CUTS AND FILLS, SHALL BE DONE IN ACCORDANCE WITH THE APPROVED E&S PLAN. A COPY OF THE APPROVED DRAWINGS MUST BE AVAILABLE AT THE 36. PROJECT SITE AT ALL TIMES. PWD SHALL BE NOTIFIED OF ANY CHANGES TO THE APPROVED PLAN PRIOR TO IMPLEMENTATION OF THOSE CHANGES. PWD MAY REQUIRE A WRITTEN SUBMITTAL OF THOSE CHANGES FOR REVIEW AND APPROVAL AT ITS DISCRETION.
- 13. AT LEAST THREE (3) DAYS PRIOR TO STARTING ANY EARTH DISTURBANCE ACTIVITIES, OR EXPANDING INTO AN AREA 37. PREVIOUSLY UNMARKED, THE PENNSYLVANIA ONE CALL SYSTEM INC. SHALL BE NOTIFIED AT 1-800-242-1776 FOR THE LOCATION OF EXISTING UNDERGROUND UTILITIES.
- 14. ALL EARTH DISTURBANCE ACTIVITIES SHALL PROCEED IN ACCORDANCE WITH THE SEQUENCE PROVIDED ON THE PLAN DRAWINGS. DEVIATION FROM THAT SEQUENCE MUST BE APPROVED IN WRITING BY PWD AND THE PA DEP PRIOR TO IMPLEMENTATION.
- 15. AREAS TO BE FILLED ARE TO BE CLEARED, GRUBBED, AND STRIPPED OF TOPSOIL TO REMOVE TREES, VEGETATION, ROOTS, AND OTHER OBJECTIONABLE MATERIAL
- CLEARING, GRUBBING, AND TOPSOIL STRIPPING SHALL BE LIMITED TO THOSE AREAS DESCRIBED IN EACH STAGE OF THE CONSTRUCTION SEQUENCE. GENERAL SITE CLEARING, GRUBBING, AND TOPSOIL STRIPPING MAY NOT COMMENCE IN ANY STAGE OF THE PROJECT UNTIL THE E&S BMPS SPECIFIED BY THE BMP SEQUENCE FOR THAT STAGE HAVE BEEN INSTALLED AND ARE FUNCTIONING AS DESCRIBED IN THIS E&S
- 17. AT NO TIME SHALL CONSTRUCTION VEHICLES BE ALLOWED 2. TO ENTER AREAS OUTSIDE THE LIMIT OF DISTURBANCE 3. BOUNDARIES SHOWN ON THE PLAN MAPS. THESE AREAS MUST BE CLEARLY MARKED AND FENCED OFF BEFORE CLEARING AND GRUBBING OPERATIONS BEGIN
- 18. A LOG SHOWING DATES THAT E&S BMPS WERE INSPECTED AS WELL AS ANY DEFICIENCIES FOUND AND THE DATE THEY WERE CORRECTED SHALL BE MAINTAINED ON THE SITE AND BE MADE AVAILABLE TO PWD AT THE TIME OF INSPECTION.
- 19. ALL SEDIMENT REMOVED FROM BMPS SHALL BE DISPOSED OF IN THE FOLLOWING MANNER: AT AN APPROVED OFF-SITE DISPOSAL FACILITY.
- 20. AREAS WHICH ARE TO BE TOPSOILED SHALL BE SCARIFIED TO A MINIMUM DEPTH OF THREE TO FIVE INCHES — SIX TO 12 5. INCHES ON COMPACTED SOILS — PRIOR TO PLACEMENT OF TOPSOIL. AREAS TO BE VEGETATED SHALL HAVE A MINIMUM FOUR INCHES OF TOPSOIL IN PLACE PRIOR TO SEEDING AND MULCHING. FILL OUTSLOPES SHALL HAVE A MINIMUM OF TWO
- INCHES OF TOPSOIL 21. ALL FILLS SHALL BE COMPACTED AS REQUIRED TO REDUCE EROSION, SLIPPAGE, SETTLEMENT, SUBSIDENCE, OR OTHER RELATED PROBLEMS. FILL INTENDED TO SUPPORT BUILDINGS, STRUCTURES, AND CONDUITS, ETC. SHALL BE COMPACTED IN ACCORDANCE WITH LOCAL REQUIREMENTS OR CODES.
- 22. ALL EARTHEN FILLS SHALL BE PLACED IN COMPACTED LAYERS NOT TO EXCEED NINE INCHES IN THICKNESS.
- 23. FILL MATERIALS SHALL BE FREE OF FROZEN PARTICLES, BRUSH, ROOTS, SOD, OR OTHER FOREIGN OR OBJECTIONABLE MATERIALS THAT WOULD INTERFERE WITH 5.2.
- OR PREVENT CONSTRUCTION OF SATISFACTORY FILLS. 24. FROZEN MATERIALS OR SOFT, MUCKY, OR HIGHLY

- COMPRESSIBLE MATERIALS SHALL NOT BE INCORPORATED
- SURFACES NECESSARY DURING CONSTRUCTION. ALL PUMPING OF 26. SEEPS OR SPRINGS ENCOUNTERED DURING CONSTRUCTION SHALL BE HANDLED IN ACCORDANCE WITH THE STANDARD AND SPECIFICATION FOR SUBSURFACE DRAIN OR OTHER
- APPROVED METHOD. INLET PROTECTION SHOULD BE PROVIDED FOR ALL INLETS 27. ALL GRADED AREAS SHALL BE PERMANENTLY STABILIZED IMMEDIATELY UPON REACHING FINISHED GRADE. CUT SLOPES IN COMPETENT BEDROCK AND ROCK FILLS NEED NOT BE VEGETATED. SEEDED AREAS WITHIN 50 FEET OF A SURFACE WATER, OR AS OTHERWISE SHOWN ON THE PLAN DRAWINGS, SHALL BE BLANKETED ACCORDING TO THE 5.3. STANDARDS OF THIS PLAN.
  - 28. IMMEDIATELY AFTER EARTH DISTURBANCE ACTIVITIES CEASE IN ANY AREA OR SUBAREA OF THE PROJECT, THE OPERATOR SHALL STABILIZE ALL DISTURBED AREAS. DURING NON-GERMINATING MONTHS, MULCH OR PROTECTIVE BLANKETING SHALL BE APPLIED AS DESCRIBED IN THE PLAN. AREAS NOT AT FINISHED GRADE, WHICH WILL BE REACTIVATED WITHIN ONE YEAR, MAY BE STABILIZED IN ACCORDANCE WITH THE TEMPORARY STABILIZATION SPECIFICATIONS. THOSE AREAS WHICH WILL NOT BE REACTIVATED WITHIN ONE YEAR SHALL BE STABILIZED IN ACCORDANCE WITH THE PERMANENT STABILIZATION
- CONSTANTLY MAINTAINED ON-SITE. A STOCKPILE SHALL BE 29. PERMANENT STABILIZATION IS DEFINED AS A MINIMUM UNIFORM, PERENNIAL 70% VEGETATIVE COVER OR OTHER PERMANENT NON-VEGETATIVE COVER WITH A DENSITY SUFFICIENT TO RESIST ACCELERATED EROSION. CUT AND FILL SLOPES SHALL BE CAPABLE OF RESISTING FAILURE DUE TO SLUMPING, SLIDING, OR OTHER MOVEMENTS.
  - E&S BMPS SHALL REMAIN FUNCTIONAL AS SUCH UNTIL ALL AREAS TRIBUTARY TO THEM ARE PERMANENTLY STABILIZED OR UNTIL THEY ARE REPLACED BY ANOTHER BMP APPROVED BY PWD AND PA DEP.
  - AFTER FINAL SITE STABILIZATION HAS BEEN ACHIEVED, TEMPORARY E&S BMPS MUST BE REMOVED OR CONVERTED TO PERMANENT POST-CONSTRUCTION STORMWATER MANAGEMENT PRACTICES. AREAS DISTURBED DURING REMOVAL OR CONVERSION OF THE E&S BMPS SHALL BE STABILIZED IMMEDIATELY. IN ORDER TO ENSURE RAPID REVEGETATION OF DISTURBED AREAS, SUCH REMOVAL/CONVERSIONS ARE TO BE DONE ONLY DURING THE GERMINATING SEASON.
  - 32. SEDIMENT BASINS AND/OR TRAPS SHALL BE KEPT FREE OF ALL CONSTRUCTION WASTE, WASH WATER, AND OTHER DEBRIS HAVING POTENTIAL TO CLOG THE BASIN/TRAP OUTLET STRUCTURES AND/OR POLLUTE THE SURFACE WATERS.(WHEN APPLICABLE)
- PRACTICES TO MINIMIZE THE POTENTIAL FOR EROSION AND 33. DURING CONSTRUCTION, THE SELECTED CONTRACTOR IS EXPECTED TO FOLLOW THE PCSMP APPROVED BY PWD. NO CHANGE OR DEVIATION FROM THE APPROVED PCSMP IS 2. PERMITTED WITHOUT PRIOR APPROVAL FROM PWD.
  - ALL WORK ASSOCIATED WITH PWD WATER CONVEYANCE AND SEWER INFRASTRUCTURE SHALL BE DONE IN ACCORDANCE WITH THE CITY OF PHILADELPHIA WATER DEPARTMENT "WATER MAIN STANDARD DETAILS AND CORROSION CONTROL SPECIFICATIONS", 1985 EDITION, AND "STANDARD DETAILS AND STANDARD SPECIFICATIONS FOR SEWERS". 1985 EDITION
  - 35. CONTACT PWD WATER TRANSPORT RECORDS (1101 MARKET STREET, 2ND FLOOR, PHONE: 215-685-6271) FOR ADDITIONAL APPROVALS AND PERMITS REQUIRED FOR ALL WATER SERVICES, METERS, AND CONNECTIONS TO THE EXISTING AND/OR PROPOSED PWD FACILITIES
  - ALL BUILDING MATERIALS AND WASTES SHALL BE REMOVED FROM THE SITE AND RECYCLED OR DISPOSED OF IN ACCORDANCE WITH THE PADEP'S SOLID WASTE MANAGEMENT REGULATIONS AT 25 PA CODE 260.1 ET SEQ. 271.1, AND 287.1 ET SEQ. NO BUILDING MATERIALS OR WASTES OR UNUSED BUILDING MATERIALS SHALL BE BURNED, BURIED, DUMPED, OR DISCHARGED AT THE SITE.
  - ALL EXCESS SOIL SHALL BE DISPOSED OF IN ACCORDANCE WITH LOCAL, STATE, AND FEDERAL REGULATIONS. CONTAMINATED SOIL SHALL BE DISPOSED OF AT EITHER A) AN APPROVED DISPOSAL FACILITY WITH AN APPROVED AND CURRENT PADEP SOIL WASTE MANAGEMENT PERMIT, OR B) AN APPROVED LANDFILL (TYPICALLY DISPOSAL AT A LANDFILL DOES NOT REQUIRE A WASTE PERMIT), AND (2) "WASTE MATERIALS, SCRAP OR EXCESS CONSTRUCTION MATERIALS SHALL BE COLLECTED, STORED AND DISPOSED OF IN ACCORDANCE WITH THE SOLID WASTE MANAGEMENT ACT (35 P. S. § § 6018.101—THE MUNICIPAL WASTE PLANNING RECYCLING AND WASTE REDUCTION ACT (53 P. S. § § 4000.101-4000.1904), THE CLEAN STREAMS LAW (35 P. S. § § 691.1—691.1001) AND RELATED RULES AND REGULATIONS.

### PROJECT SEQUENCE OF CONSTRUCTION NOTES:

- AREAS FOR POROUS PAVEMENT SYSTEMS MUST BE CLEARLY MARKED BEFORE ANY SITE WORK BEGINS TO AVOID SOIL DISTURBANCE AND COMPACTION DURING CONSTRUCTION. COMPLETE SITE CLEARING AND DEMOLITION.
- INSTALL UTILITY SERVICES AND STORM CONVEYANCE SYSTEMS AND TEMPORARY INLET FILTERS. STRUCTURES SUCH AS INLET BOXES, REINFORCED CONCRETE BOXES INLET CONTROLS, AND OUTLET CONTROLS MUST BE CONSTRUCTED ACCORDING TO MANUFACTURER'S GUIDELINES OR DESIGN PROFESSIONAL'S GUIDANCE. A REGISTERED PROFESSIONAL MUST DOCUMENT THE RELEVANT ELEVATIONS AND MEASUREMENTS AS REQUIRED BY THE SMP CONSTRUCTION CERTIFICATION FORMS CONTAINED WITHIN THE CCP.
- COMPLETE SITE ELEVATION GRADING AND STABILIZE ALL DISTURBED SOIL
- POROUS PAVEMENT INSTALLATION
- EXCAVATE POROUS PAVEMENT SUBSURFACE AREA TO PROPOSED DEPTH. EXCAVATION SHOULD TAKE PLACE AFTER CONTRIBUTING UPSTREAM DISTURBED AREAS HAVE BEEN PERMANENTLY STABILIZED. IF THIS IS IMPRACTICAL, INSTALL PWD-APPROVED EROSION AND SEDIMENTATION CONTROL BEST MANAGEMENT PRACTICES (BMPS) TO PREVENT RUNOFF AND SEDIMENT FROM ENTERING THE EXCAVATED BED. WHERE EROSION OF SUBGRADE HAS CAUSED ACCUMULATION OF FINE MATERIALS AND/OR SURFACE PONDING, THIS MATERIAL MUST BE REMOVED WITH LIGHT EQUIPMENT AND THE UNDERLYING SOILS SCARIFIED TO A MINIMUM DEPTH OF SIX INCHES WITH A YORK RAKE OR EQUIVALENT AND
- LIGHT TRACTOR. EXISTING SUBGRADE MUST NOT BE COMPACTED AND CONSTRUCTION EQUIPMENT TRAFFIC MUST BE MINIMIZED (3 PRIOR TO PLACEMENT OF THE GEOTEXTILE AND STONE

- BED. THE USE OF MACHINERY TO LOAD STONE FROM OUTSIDE OF THE BASIN FOOTPRINT IS RECOMMENDED. IF IT IS ESSENTIAL THAT EQUIPMENT BE USED IN THE EXCAVATED AREA, ALL EQUIPMENT MUST BE APPROVED BY THE ENGINEER. EQUIPMENT WITH NARROW TRACKS OR TIRES, RUBBER TIRES WITH LARGE LUGS, OR HIGH PRESSURE TIRES WILL CAUSE EXCESSIVE COMPACTION AND MUST NOT BE USED. SHOULD THE SUBGRADE BE COMPACTED DURING CONSTRUCTION, TESTING OF SOIL INFILTRATION RATES AND SYSTEM REDESIGN MAY BE REQUIRED AT NO ADDITIONAL COST TO OWNER. ROCK CONSTRUCTION ENTRANCES MUST NOT BE LOCATED ON TOP OF AREAS PROPOSED FOR INFILTRATION PRACTICES BRING SUBGRADE OF STONE BED TO LINE, GRADE, AND ELEVATIONS INDICATED IN THE DRAWINGS, WHILE AVOIDING COMPACTION. THE BOTTOM OF THE STONE BED
- MUST BE AT A LEVEL GRADE. PLACE GEOTEXTILE AND RECHARGE BED AGGREGATE IMMEDIATELY AFTER APPROVAL OF SUBGRADE PREPARATION TO PREVENT ACCUMULATION OF DEBRIS OR SEDIMENT. AGGREGATE INSTALLATION SHOULD TAKE PLACE AFTER CONTRIBUTING UPSTREAM DISTURBED AREAS HAVE BEEN PERMANENTLY STABILIZED. INSTALL PWD-APPROVED EROSION AND SEDIMENTATION CONTROL BMPS TO PREVENT RUNOFF AND SEDIMENT FROM ENTERING THE STORAGE BED DURING THE PLACEMENT OF THE GEOTEXTILE AND AGGREGATE BED.
- PLACE GEOTEXTILE IN ACCORDANCE WITH MANUFACTURER'S STANDARDS AND RECOMMENDATIONS ADJACENT STRIPS OF FILTER FABRIC MUST OVERLAP A MINIMUM OF 16 INCHES. FABRIC MUST BE SECURED AT LEAST FOUR FEET OUTSIDE OF BED. THIS EDGE STRIP SHOULD REMAIN IN PLACE UNTIL ALL BARE SOILS CONTIGUOUS TO BEDS ARE STABILIZED AND VEGETATED. AS THE SITE IS FULLY STABILIZED, EXCESS GEOTEXTILE CAN BE CUT BACK TO THE EDGE OF THE BED.
- INSTALL AGGREGATE COURSE IN LIFTS OF SIX TO EIGHT INCHES. COMPACT EACH LAYER WITH EQUIPMENT KEEPING EQUIPMENT MOVEMENT OVER STORAGE BED SUBGRADES TO A MINIMUM. INSTALL AGGREGATE TO GRADES INDICATED ON THE DRAWINGS. INSTALL POROUS PAVEMENT SURFACE COURSE
- COMPLETE FINAL GRADING OF REMAINING SITE AREA AND CONSTRUCT SITE IMPROVEMENTS. RESTORE ALL AREAS AS APPROPRIATE.
- INSTALL TOPSOIL, PLANTS, SEEDING, AND MULCH. ONCE THE SITE IS PERMANENTLY STABILIZED WITH VEGETATION, REMOVE TEMPORARY EROSION AND SEDIMENT

### STANDARD PWD SEQUENCE OF CONSTRUCTION NOTES:

CONTROL MEASURES.

- AT LEAST SEVEN (7) DAYS PRIOR TO ANY EARTH DISTURBANCE, THE INSPECTIONS COORDINATOR OF PWD (OFFICE: 215-685-6387) MUST BE CALLED TO SCHEDULE A PRECONSTRUCTION MEETING.
- AT LEAST THREE (3) DAYS PRIOR TO POROUS PAVEMENT INSTALLATION, THE INSPECTIONS COORDINATOR OF PWD (OFFICE: 215-685-6387) MUST BE CALLED TO SCHEDULE AN INSPECTION (FOR EACH SMP)
- ALL STONE THAT MAKES UP THE POROUS PAVEMENT BASE MUST REMAIN FREE OF SEDIMENT. IF SEDIMENT ENTERS THE STONE, THE CONTRACTOR MAY BE REQUIRED TO REMOVE THE SEDIMENT AND REPLACE IT WITH CLEAN-WASHED STONE.
- UPON COMPLETION OF ALL EARTH DISTURBANCE ACTIVITIES AND PERMANENT STABILIZATION OF ALL DISTURBED AREAS, THE OWNER AND/OR OPERATOR SHALL CONTACT INSPECTIONS COORDINATOR OF PWD (OFFICE: 215-685-6387) FOR A FINAL INSPECTION PRIOR TO REMOVAL/CONVERSION OF THE E&S
- AS SOON AS SLOPES, CHANNELS, DITCHES, AND OTHER DISTURBED AREAS REACH FINAL GRADE, THEY MUST BE STABILIZED. CESSATION OF ACTIVITY FOR FOUR (4) DAYS OR LONGER REQUIRES TEMPORARY STABILIZATION.
- 6. THE NPDES NOTICE OF TERMINATION (N.O.T.) MUST BE SUBMITTED TO PA DEP UPON COMPLETION OF CONSTRUCTION (WHEN APPLICABLE).
- WATER PUMPED FROM WORK AREAS SHOULD BE TREATED FOR SEDIMENT REMOVAL PRIOR TO DISCHARGING TO A "SURFACE WATER" (WHEN APPLICABLE).

HEIGHT OF ROCK FILTER =

OR FILTER FABRIC FENCE

**UP-SLOPE FACE** 

A ROCK FILTER OUTLET SHALL BE INSTALLED WHERE FAILURE OF A SILT FENCE OR

STRAW BALE BARRIER HAS OCCURRED DUE TO CONCENTRATED FLOW. ANCHORED

SEDIMENT SHALL BE REMOVED WHEN ACCUMULATIONS REACH 1/3 THE HEIGH OF THE

COMPOST LAYER SHALL BE USED ON UPSLOPE FACE IN HQ AND EV WATERSHEDS.

**ROCK FILTER OUTLET DETAIL** 

5/6 HEIGHT OF STRAW BALES

### COMPOST FILTER SOCK, 9 IN MIN. (FILTREXX SILTSOXX, OR APPROVED EQUAL) REFER TO MANUFACTURER'S SPECIFICATIONS FOR MORE DETAILED INSTALLATION GUIDELINES SECURE AS INDICATED BY INSTALL FLUSH AGAINST CURB MANUFACTURER'S GUIDELINES INLET OPENING. INSPECT POSITION DAILY AND MAINTAIN FLUSH AGAINST CURB. INSTALL FILTER BAG AS PER HIGHWAY GRATE INLET **BAG PROTECTION DETAIL** FOR COMBINATION HIGHWAY GRATE/CURB INLETS COMPOST FILTER SOCK, 9 IN MIN. (FILTREXX SILTSOXX, OR APPROVED EQUAL) REFER TO MANUFACTURER'S SPECIFICATIONS FOR MORE DETAILED INSTALLATION GUIDELINES – SECURE AS INDICATED BY MANUFACTURER'S GUIDELINES **INSTALL FLUSH AGAINST** CURB INLET OPENING **INSPECT POSITION DAILY** AND MAINTAIN FLUSH

FOR CURB INLETS

**CURB INLET PROTECTION DETAIL** 

WELL VEGETATED, GRASSY AREA ELEVATION VIEW Low volume filter bags shall be made from non-woven geotextile material sewn with high strength, double stitched "J" type seams. They shall be capable of trapping particles larger than 150 microns. High volume filter bags shall be made from woven geotextiles that meet the Avg. Wide Width Strength ASTM D-4884

AGAINST CURB.

ASTM D-4632 Grab Tensile ASTM D-4833 Mullen Burst ASTM D-3786 provided. Filter bags shall be replaced when they become \( \frac{1}{2} \) full of sediment. Spare bags shall straps to facilitate removal unless bags come with lifting straps already attached.


provided. Bags may be placed on filter stone to increase discharge capacity. Bags shall not be placed on slopes greater than 5%. For slopes exceeding 5%, clean rock or other non-erodible and non-polluting material may be placed under the bag to reduce slope steepness o downslope sediment barrier is required for most installations. Compost berm or composi filter sock shall be installed below bags located in HQ or EV watersheds, within 50 feet of an

esistant areas. Where this is not possible, a geotextile underlayment and flow path shall be

receiving surface water or where grassy area is not available. The pump discharge hose shall be inserted into the bags in the manner specified by the anufacturer and securely clamped. A piece of PVC pipe is recommended for this purpose

The pumping rate shall be no greater than 750 gpm or ½ the maximum specified by the anufacturer, whichever is less. Pump intakes shall be floating and screened. Filter bags shall be inspected daily. If any problem is detected, pumping shall cease

# PUMPED WATER FILTER BAG DETAIL

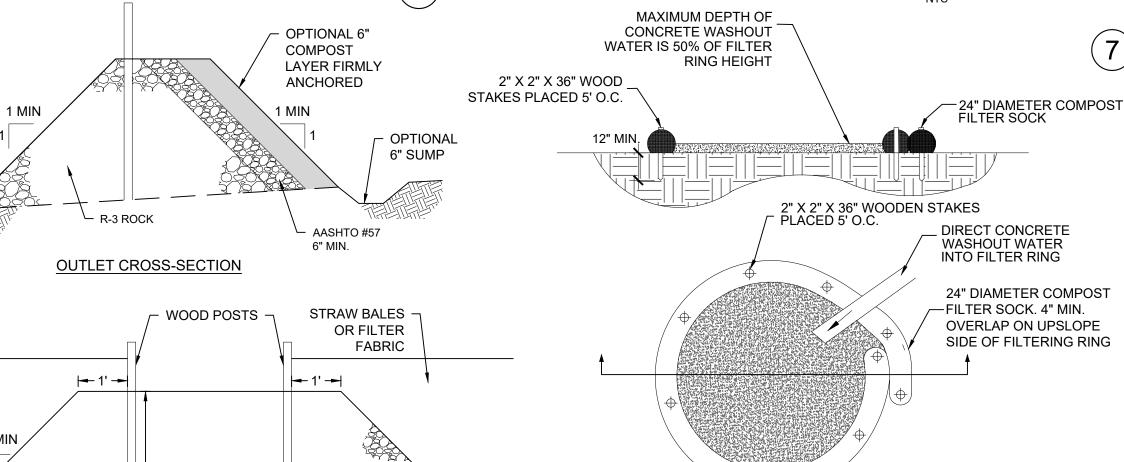

NTS

NOTES 1. A SUITABLE IMPERVIOUS GEOMEMBRANE SHALL BE PLACED AT THE LOCATION OF THE WASHOUT PRIOR TO INSTALLING THE SOCKS. INSTALL ON FLAT GRADE FOR OPTIMUM PERFORMANCE 18" DIAMETER FILTER SICK MAY BE STACKED ONTO DOUBLE AASHTO #57 24" DIAMETER SOCKS IN PYRAMIDAL CONFIGURATION FOR

ADDED HEIGHT 4. PROVIDE PROPER SIGNAGE TO DRIVERS SO THAT THEY ARE AWARE OF THE PRESENCE OF WASHOUT FACILITIES

5. NOT TO BE PLACED WITHIN 50 FEET OF STORM DRAINS, OPEN DITCHES OR SURFACE WATERS 6. MUST BE LOCATED IN A CONVENIENT LOCATION FOR THE TRUCKS BUT FAR

ENOUGH FROM OTHER VEHICULAR TRAFFIC TO MINIMIZE THE POTENTIAL

FOR ACCIDENTAL DAMAGE OR SPILLS. **CONCRETE WASHOUT DETAIL** 

RUBBER FORM TRACKOUT DRAWINGS. FOLLOW MANUFACTURER GUIDANCE. CONTROL MAT 2. LIMIT THE POINTS OF ENTRANCE/EXIT TO THE CONSTRUCTION SITE RUBBERFORM LIMIT SPEED OF VEHICLES TO CONTROL DUST 75 MICHIGAN STREET 4. PROPERLY GRADE EACH CONSTRUCTION ENTRANCE/EXIT TO PREVENT LOCKPORT, NY 14094 RUNOFF FROM LEAVING THE CONSTRUCTION SITE RUBBERFORM.COM 5. ROUTE RUNOFF FROM STABILIZED ENTRANCES/EXITS THROUGH A 716-478-0404 SEDIMENT-TRAPPING DEVICE BEFORE DISCHARGE DESIGN STABILIZED ENTRANCE/EXIT TO SUPPORT THE HEAVIEST PROP. TRACKOUT VEHICLES AND EQUIPMENT THAT WILL USE IT **CONTROL MAT** 7. DESIGNATE COMBINATION OR SINGLE PURPOSE ENTRANCES AND EXITS TO THE CONSTRUCTION SITE

BASIS FOR DESIGN:

ASPHALT

PAVEMENT

NTS

8. REQUIRE ALL EMPLOYEES, SUBCONTRACTORS, AND SUPPLIERS TO UTILIZE THE STABILIZED CONSTRUCTION ENTRANCE AND EXIT MAINTENANCE AND INSPECTION: 1. INSPECT ROUTINELY FOR DAMAGE AND ASSESS THE EFFECTIVENESS OF SECTION THE BMP. REPAIR IT IF ACCESS IS CLOGGED WITH SEDIMENT OR AS DIRECTED BY THE RE. REMOVE AGGREGATE. SEPARATE. AND DISPOSE

100% COMPOUNDED RECYCLED MATERIALS

COMPLY WITH ARRA 2009 AND BUY AMERICA ACT

3. MATTING MUST COVER ENTIRE AREA SHOWN ON CONSTRUCTION

1. PLACE ON EXISTING PAVEMENT, AS INDICATED ON CONSTRUCTION

TREE PROTECTION FENCE TO BE LOCATED AT A DISTANCE OF 12 TIMES THE TRUNK

DBH, OR TO THE TREE'S DRIPLINE, WHICHEVER DISTANCE IS GREATER, OR AS

ANY TREES NOT SCHEDULED TO BE REMOVED THAT ARE IRREPARABLY DAMAGED

THE EDGE OF DRIPLINE IS TO BE VERIFIED BY THE PROJECT MANAGER.

NO MATERIALS ARE TO BE STORED IN THE TREE PROTECTION AREA.

CONSTRUCTION DURING WHICH THE TREE MAY BE AFFECTED.

BOARDS SHALL NOT BE NAILED TO TREES DURING BUILDING OPERATIONS.

TREE PROTECTION FENCING SHALL REMAIN IN PLACE DURING ANY PHASE OF

TREE PROTECTION FENCE DETAIL

DRAWINGS.

INSTALLATION AND USE:

**CROWN DRIP LINE** 

DIRECTED BY THE LANDSCAPE ARCHITECT OR ENGINEER.

DURING CONSTRUCTION SHALL BE REPLACED

OF SEDIMENT IF CONSTRUCTION ENTRANCE/EXIT IS CLOGGED WITH SEDIMENT OR AS DIRECTED BY THE RE. 2. KEEP ALL TEMPORARY ROADWAY DITCHES CLEAR

STOCKPILES. IMMEDIATELY APPLY TEMPORARY SEEDING & STRAW

3. INSPECT FOR DAMAGE AND REPAIR AS NEEDED. CONSTRUCTION ENTRANCE DETAIL NTS STOCKPILE - SILT FENCE <u>PLAN VIEW</u> **MAINTENANCE**  SILT FENCE ON DOWNSLOPE SILT FENCE MUST BE PLACED AROUND THE DOWNSLOPE SIDE OF ALL SIDE, ONLY

MULCH TO ALL STOCKPILES. TEMPORARY SOIL STOCKPILE DETAIL

> JOINING FENCE SECTIONS 2"x2" WOODEN STAKE (AT 8' O.C., MAX.) FILTER FABRIC - COMPACTED BACKFILL TOE ANCHOR

SILT FENCE MAINTENANCE 1. FILTER FABRIC FENCE MUST BE PLACED AT LEVEL GRADE. BOTH

TRENCH

ENDS MUST EXTEND AT LEAST 8 FEET UP-SLOPE AT 45° TO MAIN BARRIER 2. SEDIMENT MUST BE REMOVED WHEN ACCUMULATIONS REACH 2 THE ABOVE GROUND HEIGHT OF THE FENCE.

3. ANY SECTION OF FILTER FABRIC FENCE WHICH HAS BEEN UNDERMINED OR TOPPED MUST BE REPLACED IMMEDIATELY WITH A ROCK FILTER OUTLET. SEE DETAIL

THE PROJECT SITE IS WITHIN PENNYPACK PARK SYSTEM AND DOES NOT HAVE IT'S OWN SITE ADDRESS. THEREFORE, THE PENNYPACK PARK SYSTEM'S ADDRESS AND OPA ACCOUNT NUMBER ARE ASSOCIATED WITH THIS PROJECT SITE. THE PROJECT SITE IS LOCATED JUST SOUTH OF THE INTERSECTION OF HOLMEHURST AVE AND RHAWN STREET. APPROXIMATE COORDINATES ARE 40°02'59" N, 75°02'09" W.

TREE PROTECTION

FENCE TO CROWN

AT 8' O.C.

5" THICK MULCH

- WOOD POSTS

DRIP LINE

LAYER

ADDRESS: 8300 FRANKFORD AVE PHILADELPHIA, PA 19136 BRT/OPA: 871402520

PHILADELPHIA WATER TRACKING NO.: FY22-PENN-6850-01 PENNSYLVANIA ONE CALL SYSTEM, INC. SITE IDENTIFICATION NO. 20220322281

925 Irwin Run Road West Mifflin, Pennsylvania 15122 - 1078



BEFORE YOU DIG ANYWHERE IN PENNSYLVANIA! CALL 1-800-242-1776 NON-MEMBERS MUST BE CONTACTED DIRECTL' PA LAW REQUIRES THREE WORKING DAYS NOTICE TO UTILITIES BEFORE YOU EXCAVATE, DRILL, BLAST OR DEMOLISH

REVISIONS ISSUE REVISIONS 05/16/24 **ADDENDUM 1** PENNSYLVANIA ONE CALL SYSTEM, INC

BEFORE YOU DIG ANYWHERE IN PENNSYLVANIA! CALL 1-800-242-1776 NON-MEMBERS MUST BE CONTACTED DIRECTLY PA ONE-CALL NUMBER (FOR DESIGN ONLY)

PPR PROJECT COORDINATOR MEGAN FUNK ↑ REGISTERED / ∕\PROFESSIONAL*|* EDWARD D. CONFAIR JR. \ engineer /

04/04/2024

PRIMARY CONSULTANT, LANDSCAPE ARCHITECT

145 Hudson Street, Floor 3 New York, NY 10013

SUB-CONSULTANTS ENGINEERING & LAND PLANNING ASSOCIATES, INC. 219 Cuthbert Street, 5th/ Floor Philadelphia, PA 19106

MEP ENGINEER: 417 N 8th Street, Suite 204 Philadelphia, PA 19123 267.585.2811

IGHTING DESIGN: HE LIGHTING PRACTICE 600 Chestnut Street, Suite 772 COST ESTIMATOR: ELLANA CONSTRUCTION CONSULTANTS

New York, NY 10004 PLAYFUL LEARNING CONSULTANT

MORRIS ARBORETUM 00 East Northwestern Avenue hiladelphia, PA 19118 215.247.5777

ACCESSIBILITY CONSULTANT: christopher.noel@parks.nyc.gov 646.632.7344 PLAY CONSULTANT

1313 S 33rd St, Unit A Philadelphia, PA 19146

DRAWING TITLE

DRAWN BY

CHECKED BY

CONSULTANT PROJECT NUMBER

CITY OF PHILADELPHIA PHILADELPHIA PARKS AND RECREATION

> 1515 ARCH STREET 11TH FLOOR, ONE PARKWAY BUILDING

PPR PROJECT NUMBER 16-21-7062-01 PENNYPACK PARK


UNIVERSAL PLAYGROUND RHAWN ST. & HOLMEHURST AVE. PHILADELPHIA, PA 19136

E&SC DETAILS

PPR PROJECT NO. 16-21-7062-01 CONSULTANT PROJECT NO 12/15/2023 SCALE:

**AS NOTED** 


ALL DIMENSIONS AND CONDITIONS SHALL BE VERIFIED BY THE CONTRACTOR AT THE SITE BEFORE PROCEEDING WITH THE WORK

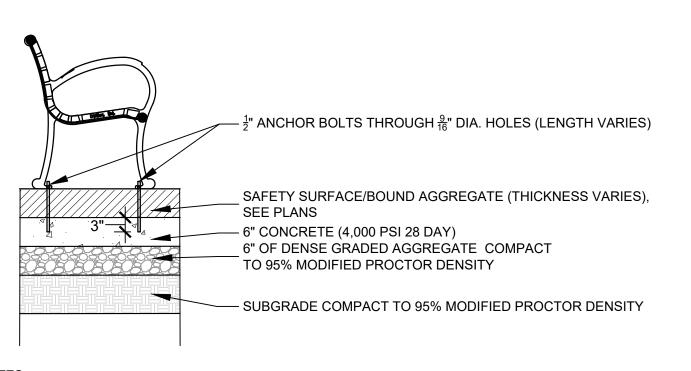


1. ANCHOR BOLT TO MEET MANUFACTURER RECOMMENDATIONS. 2. REINFORCED CONCRETE FOOTING TO EXTEND ENTIRE FOOTPRINT OF

BENCH.

PPR STANDARD BENCH MOUNTING DETAIL

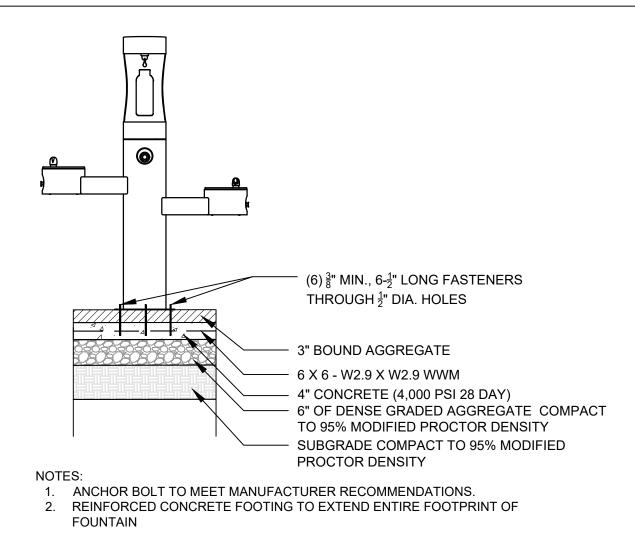

DRINKING FOUNTAIN MOUNTING DETAIL

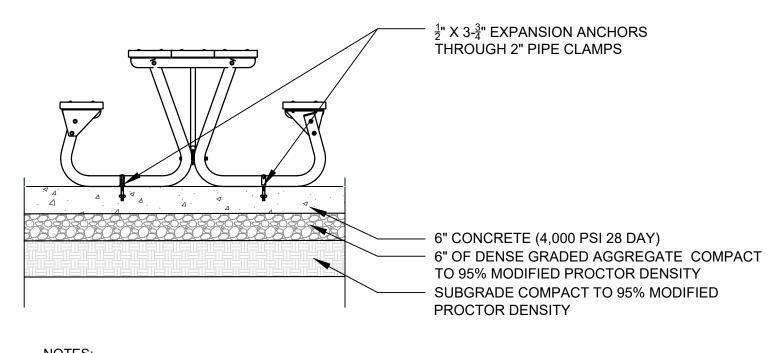


ANCHOR BOLT TO MEET MANUFACTURER RECOMMENDATIONS. 2. REINFORCED CONCRETE FOOTING TO EXTEND TO ENTIRE FOOTPRINT OF TABLES.

ADA PICNIC TABLE MOUNTING DETAIL

SAFETY SURFACE FINISHED GRADE (SEE LANDSCAPE DRAWINGS) 4" SQ. X 3/16" W. STL. TUBE CONCRETE RECESSED BELOW SAFETY SURFACE (4,000 PSI 28 DAY) - 1/4" X 1 1/2" STL. BAR 6" OF 3/4" CLEAN STONE COMPACT TO 95% MODIFIED 🖈 1'-6" SQ 🤿 PROCTOR DENSITY SUBGRADE COMPACT TO 95% MODIFIED PROCTOR DENSITY CAFE TABLE & CHAIRS FOUNDATION DETAIL


CONCRETE STAIRS DETAIL

1. ANCHOR BOLT TO MEET MANUFACTURER RECOMMENDATIONS. 2. REINFORCED CONCRETE FOOTING TO EXTEND ENTIRE FOOTPRINT OF RECEPTACLE.

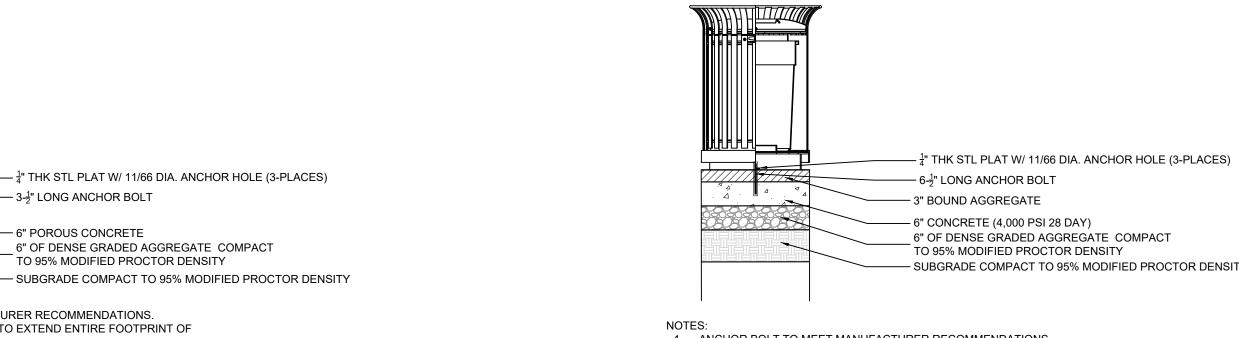


RECEPTACLE MOUNTING (POROUS CONCRETE) DETAIL

(6) RECEPTACLE MOUNTING (BOUND AGGREGATE) DETAIL

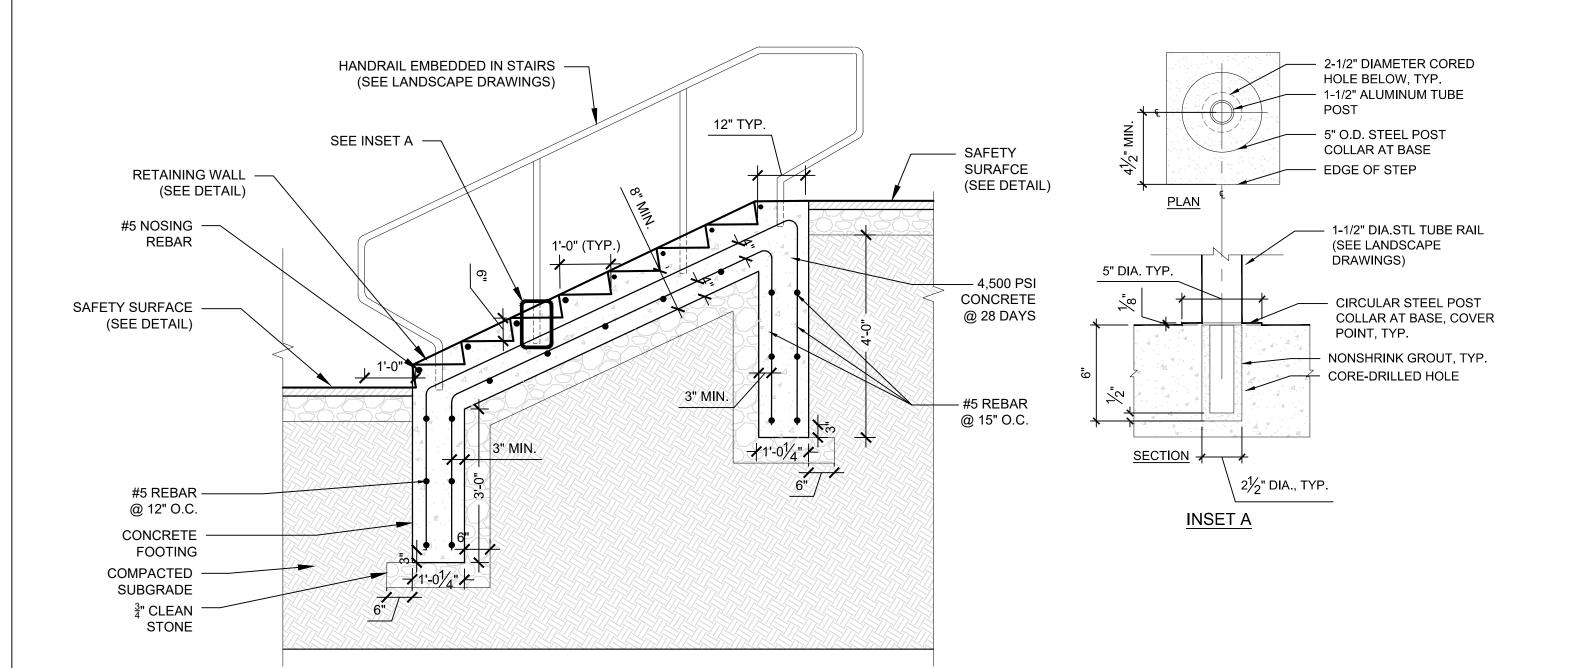

STAIR/CHEEKWALL ELEVATION DETAIL

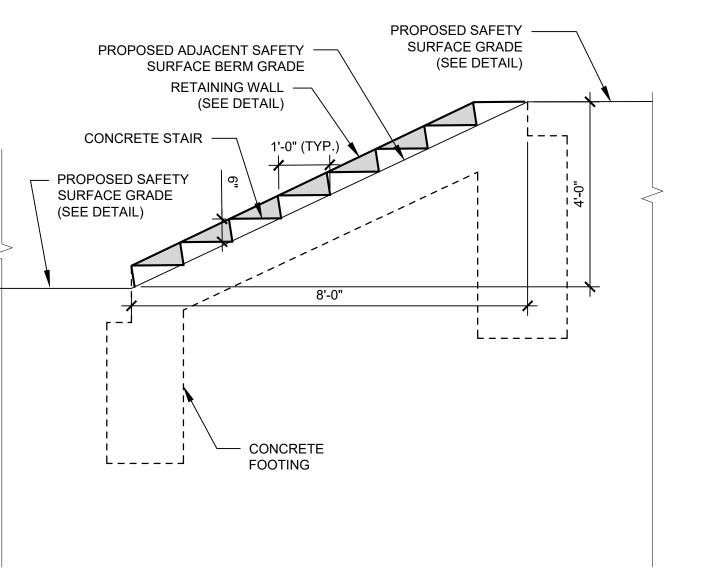

DOES NOT HAVE IT'S OWN SITE ADDRESS. THEREFORE, THE PENNYPACK PARK SYSTEM'S ADDRESS AND OPA ACCOUNT NUMBER ARE ASSOCIATED WITH THIS PROJECT SITE. THE PROJECT SITE IS LOCATED JUST SOUTH OF THE INTERSECTION


ADDRESS: 8300 FRANKFORD AVE PHILADELPHIA, PA 19136

BRT/OPA: 871402520 PHILADELPHIA WATER TRACKING NO.: FY22-PENN-6850-01

> PENNSYLVANIA ONE CALL SYSTEM, INC. SITE IDENTIFICATION NO.:

> > West Mifflin, Pennsylvania

20220322281

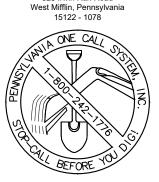


BEFORE YOU DIG ANYWHERE IN PA LAW REQUIRES THREE WORKING DAYS NOTICE TO UTILITIES BEFORE YOU EXCAVATE, DRILL, BLAST OR DEMOLISH

THE PROJECT SITE IS WITHIN PENNYPACK PARK SYSTEM AND OF HOLMEHURST AVE AND RHAWN STREET. APPROXIMATE COORDINATES ARE 40°02'59" N, 75°02'09" W.

PHILADELPHIA, PA 19136

DRAWING TITLE

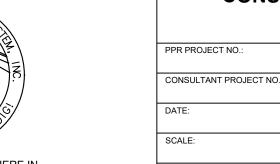

12/15/2023 C-500 AS NOTED DRAWN BY: CHECKED BY

ALL DIMENSIONS AND CONDITIONS SHALL BE VERIFIED BY THE CONTRACTOR AT THE SITE BEFORE PROCEEDING WITH THE WORK.

PENNSYLVANIA! CALL 1-800-242-1776 NON-MEMBERS MUST BE CONTACTED DIRECTLY

NTS

- SUBGRADE COMPACT TO 95% MODIFIED PROCTOR DENSITY 1. ANCHOR BOLT TO MEET MANUFACTURER RECOMMENDATIONS.

2. REINFORCED CONCRETE FOOTING TO EXTEND ENTIRE FOOTPRINT OF RECEPTACLE.

> CONSULTANT PROJECT NUMBER **CITY OF PHILADELPHIA** PHILADELPHIA PARKS AND RECREATION

> > 1515 ARCH STREET

11TH FLOOR, ONE PARKWAY BUILDING

PPR PROJECT NUMBER 16-21-7062-01

REVISIONS

PENNSYLVANIA ONE CALL SYSTEM, INC.

NON-MEMBERS MUST BE CONTACTED DIRECTLY PA LAW REQUIRES THREE WORKING DAYS NOTICE TO UTILITIES BEFORE YOU EXCAVATE, DRILL, BLAST OR DEMOLISH

> ^PROFESSIONAL*|* EDWARD D. CONFAIR JR.

MEGAN FUNK

04/04/2024

PA ONE-CALL NUMBER (FOR DESIGN ONLY):

PRIMARY CONSULTANT, LANDSCAPE ARCHITECT:

ENGINEERING & LAND PLANNING ASSOCIATES, INC.

145 Hudson Street, Floor 3

New York, NY 10013

219 Cuthbert Street, 5th/ Floor Philadelphia, PA 19106

ELLANA CONSTRUCTION CONSULTANTS

PLAYFUL LEARNING LANDSCAPES ACTION NEXTWORK

PLAYFUL LEARNING CONSULTANT:

SUB-CONSULTANTS:

CIVIL/SURVEY

MEP ENGINEER: 417 N 8th Street, Suite 204 Philadelphia, PA 19123 267.585.2811 LIGHTING DESIGN: THE LIGHTING PRACTICE 600 Chestnut Street, Suite 772 Philadelphia, PA 19106 COST ESTIMATOR:

New York, NY 10004

MORRIS ARBORETUM

Philadelphia, PA 19118 215.247.5777

100 East Northwestern Avenue

ACCESSIBILITY CONSULTANT:

christopher.noel@parks.nyc.gov

Philadelphia, PA

CHRIS NOEL

646.632.7344

STUDIO LUDO

PLAY CONSULTANT:

1313 S 33rd St, Unit A

Philadelphia, PA 19146

MARVEL

PPR PROJECT COORDINATOR:

REVISIONS

**ADDENDUM 1** 

ISSUE


05/16/24

PENNYPACK PARK

UNIVERSAL PLAYGROUND RHAWN ST. & HOLMEHURST AVE.


**CONSTRUCTION DETAILS** 


16-21-7062-01

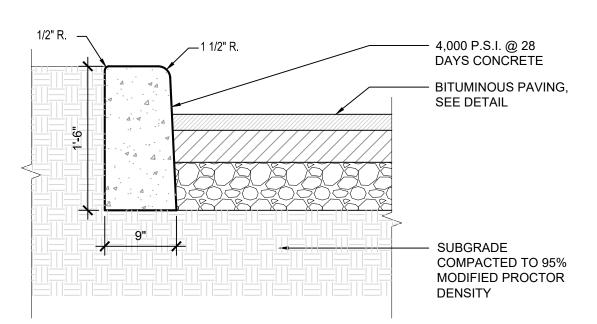


- 1. WHEN NEW CURB (OR CURB & GUTTER) IS CONSTRUCTED ALONG AN EXISTING PAVED AREA, THE EXISTING PAVEMENT SHALL BE CUT IN A STRAIGHT LINE WITH A WET SAW BLADE AT ALL TIMES AND THE NEW PAVEMENT SHALL BE TACKED AND BUTTED TO EXISTING PAVEMENT.
- 2. TRANSVERSE JOINTS 1/2" WIDE SHALL BE INSTALLED IN THE CURB (OR CURB AND GUTTER) 20'-0" APART AND SHALL BE FILLED WITH PRE-FORMED BITUMINOUS IMPREGNATED FIBER JOINT FILLER, COMPLYING WITH THE REQUIREMENTS OF A.A.S.H.T.O. SPEC. M-213, RECESSED IN FROM FRONT FACE AND TOP OF CURB.

### CONCRETE CURB DETAIL

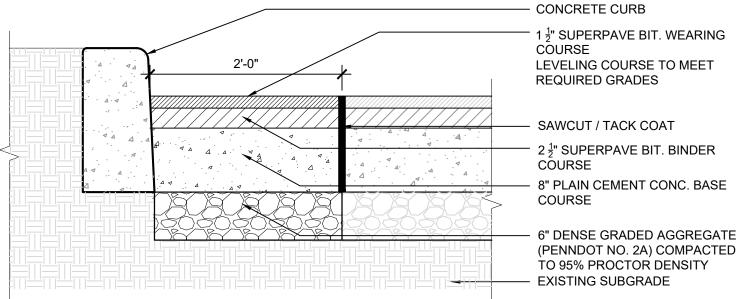

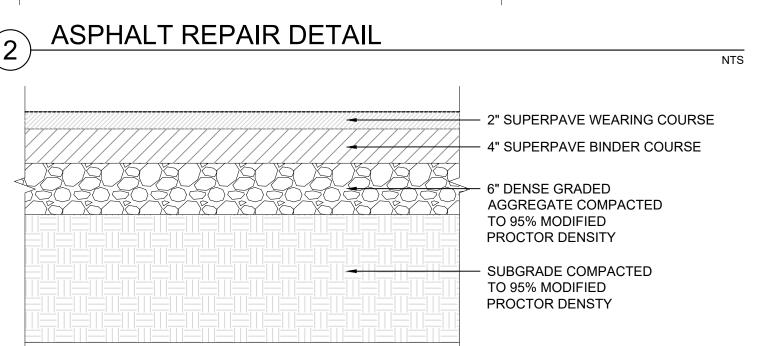


ASPHALT PAVEMENT DETAIL

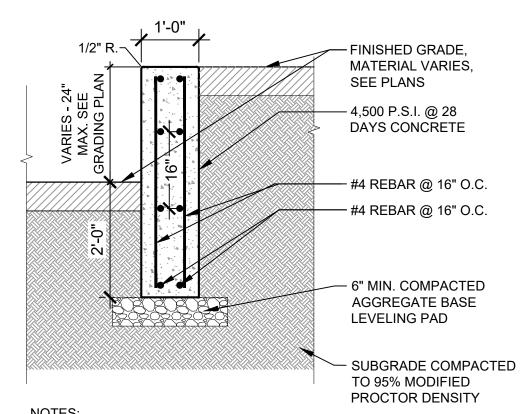

- TRANSVERSE JOINTS 1/2" WIDE SHALL BE INSTALLED IN THE WALL 20'-0" APART AND SHALL BE FILLED WITH PRE-FORMED BITUMINOUS IMPREGNATED FIBER JOINT FILLER, COMPLYING WITH THE REQUIREMENTS OF A.A.S.H.O. SPEC. M-213, RECESSED IN FROM FRONT FACE AND TOP OF WALL.
- 2. PROVIDE 1/4" CHAMFER ON VERTICAL EDGES. PROVIDE SHOP DRAWINGS FOR REVIEW.

CHEEK WALL DETAIL

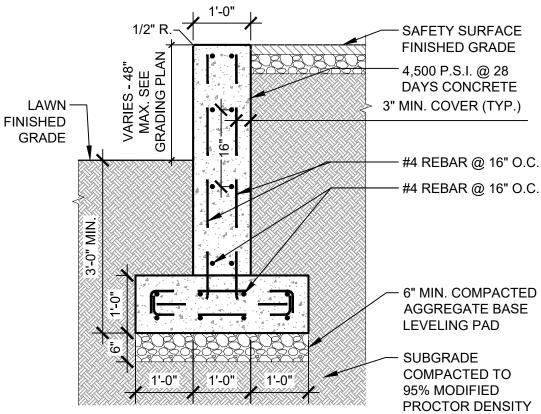

### NOTES:

NTS

- 1. TRANSVERSE JOINTS 1/2" WIDE SHALL BE INSTALLED IN THE WALL 20'-0" APART AND SHALL BE FILLED WITH PRE-FORMED BITUMINOUS IMPREGNATED FIBER JOINT FILLER, COMPLYING WITH THE REQUIREMENTS OF A.A.S.H.O. SPEC. M-213, RECESSED IN FROM FRONT FACE AND TOP OF WALL.
- 2. PROVIDE 1/4" CHAMFER ON VERTICAL EDGES. 3. PROVIDE SHOP DRAWINGS FOR REVIEW.
- RETAINING WALL DETAIL

NTS

THE PROJECT SITE IS WITHIN PENNYPACK PARK SYSTEM AND DOES NOT HAVE IT'S OWN SITE ADDRESS. THEREFORE, THE

PENNYPACK PARK SYSTEM'S ADDRESS AND OPA ACCOUNT

NUMBER ARE ASSOCIATED WITH THIS PROJECT SITE. THE PROJECT SITE IS LOCATED JUST SOUTH OF THE INTERSECTION

OF HOLMEHURST AVE AND RHAWN STREET. APPROXIMATE

ADDRESS: 8300 FRANKFORD AVE PHILADELPHIA, PA 19136

BRT/OPA: 871402520

PHILADELPHIA WATER TRACKING NO.: FY22-PENN-6850-01

PENNSYLVANIA ONE CALL SYSTEM, INC.

SITE IDENTIFICATION NO.:

20220322281

925 Irwin Run Road West Mifflin, Pennsylvania 15122 - 1078


BEFORE YOU DIG ANYWHERE IN

PENNSYLVANIA! CALL 1-800-242-1776

NON-MEMBERS MUST BE CONTACTED DIRECTLY

PA LAW REQUIRES THREE WORKING DAYS NOTICE TO UTILITIES BEFORE YOU EXCAVATE, DRILL, BLAST OR DEMOLISH

COORDINATES ARE 40°02'59" N, 75°02'09" W.

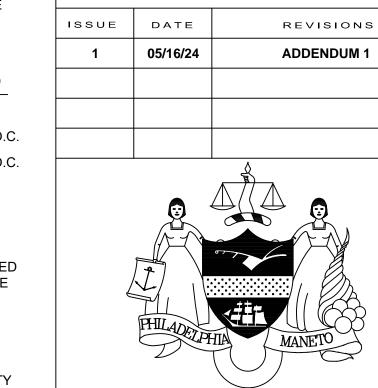



REVISIONS

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PA ONE-CALL NUMBER (FOR DESIGN ONLY):

PPR PROJECT COORDINATOR:

MEGAN FUNK /\PROFESSIONAL/ EDWARD D. CONFAIR JR. \engineer /

04/04/2024

PRIMARY CONSULTANT, LANDSCAPE ARCHITECT:

MARVEL 145 Hudson Street, Floor 3 New York, NY 10013

SUB-CONSULTANTS: CIVIL/SURVEY ENGINEERING & LAND PLANNING ASSOCIATES, INC. 219 Cuthbert Street, 5th/ Floor Philadelphia, PA 19106

417 N 8th Street, Suite 204 Philadelphia, PA 19123 267.585.2811 LIGHTING DESIGN: THE LIGHTING PRACTICE

600 Chestnut Street, Suite 772

MEP ENGINEER:

Philadelphia, PA 19106 COST ESTIMATOR: ELLANA CONSTRUCTION CONSULTANTS New York, NY 10004

PLAYEUL LEARNING CONSULTANT:

PLAYFUL LEARNING LANDSCAPES ACTION NEXTWORK Philadelphia, PA

MORRIS ARBORETUM 100 East Northwestern Avenue Philadelphia, PA 19118 215.247.5777

ACCESSIBILITY CONSULTANT: CHRIS NOEL christopher.noel@parks.nyc.gov

PLAY CONSULTANT: 1313 S 33rd St, Unit A Philadelphia, PA 19146

646.632.7344

CONSULTANT PROJECT NUMBER

**CITY OF PHILADELPHIA** PHILADELPHIA PARKS AND RECREATION

1515 ARCH STREET 11TH FLOOR, ONE PARKWAY BUILDING

PPR PROJECT NUMBER 16-21-7062-01

PENNYPACK PARK UNIVERSAL PLAYGROUND


RHAWN ST. & HOLMEHURST AVE. PHILADELPHIA, PA 19136 DRAWING TITLE:


**CONSTRUCTION DETAILS** 

PPR PROJECT NO.: 16-21-7062-01 CONSULTANT PROJECT NO. 12/15/2023 SCALE: AS NOTED DRAWN BY:

CHECKED BY

ALL DIMENSIONS AND CONDITIONS SHALL BE VERIFIED BY THE CONTRACTOR AT THE SITE BEFORE PROCEEDING WITH THE WORK.

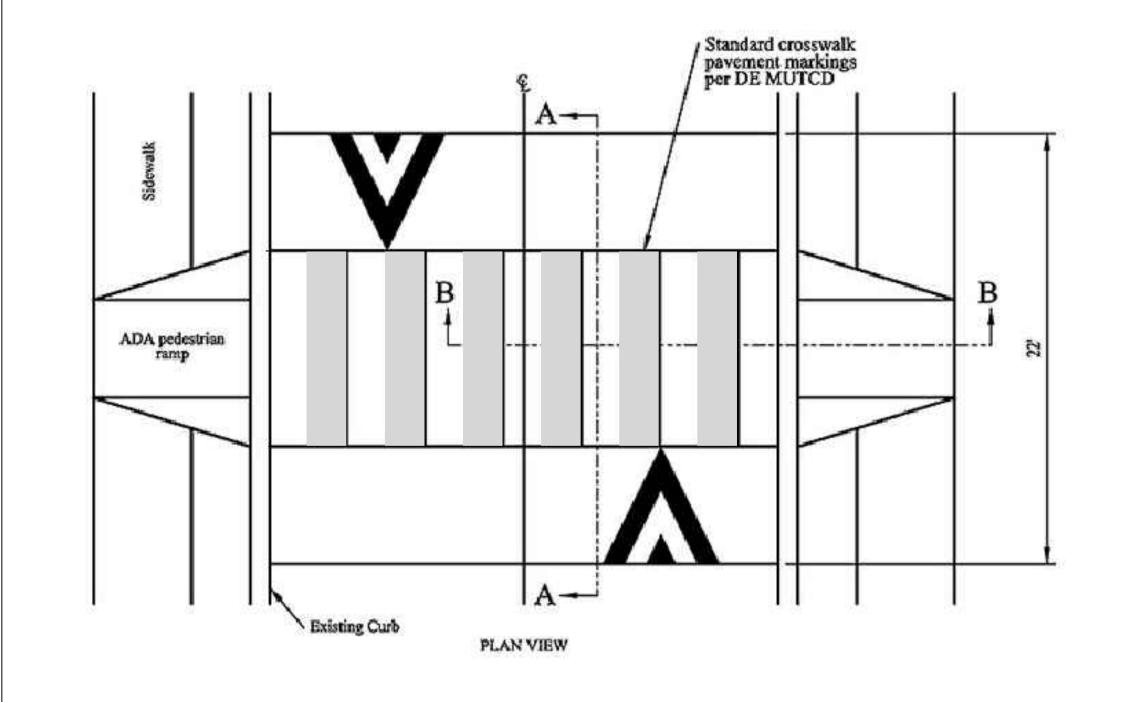


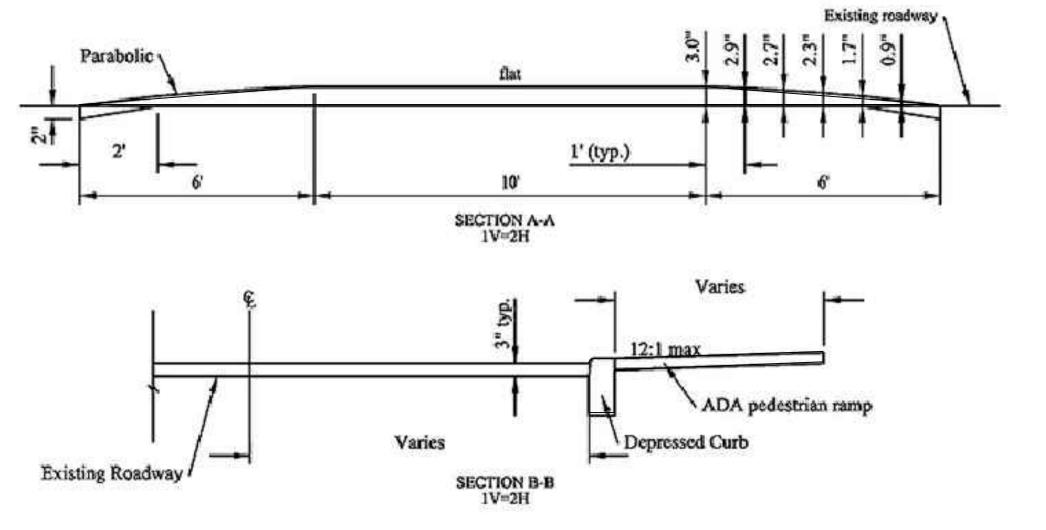

NTS

1. INLETS ARE REQUIRED ON THE UPHILL SIDES OF A RAISED CROSSWALK. 2. ALL SIGNAGE AND STRIPING SHALL CONFORM TO THE LATEST EDITION OF THE PA MUTCD.

RAISED PEDESTRIAN CROSSING DETAIL

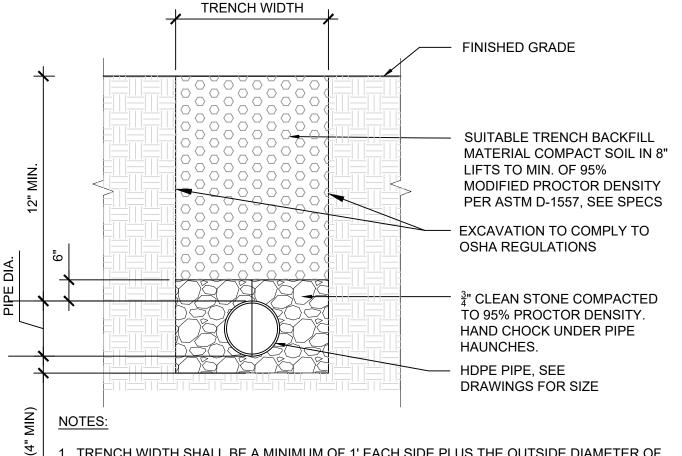

- . TRENCH WIDTH SHALL BE A MINIMUM OF 1' EACH SIDE PLUS THE OUTSIDE DIAMETER OF THE PIPE. TRENCH WIDTH SHALL NOT EXCEED THAT REQUIRED FOR PROPER INSTALLATION BACKFILL AND COMPACTION OPERATIONS.
- 2. SUITABLE BACKFILL MATERIAL SHALL BE APPROVED BY THE ENGINEER PRIOR TO INSTALLATION.
- 3. WHERE THE TRENCH PASSES THROUGH EXISTING PAVEMENT, THE PAVEMENT SHALL BE SAWCUT. PATCHING SHALL CONSIST OF TACKING EDGES OF EXISTING PAVEMENT AFTER BEING CUT BACK TO 12" PAST EXCAVATION EDGE.
- 5. PIPE TRENCH TO BE CLEAN CORRIDOR COMPLIANT

4. EXCAVATION TO CONFORM TO OSHA REGULATIONS.

UTILITY TRENCH DETAIL

NTS

ENGINEER'S NAME: EDWARD CONFAIR, P.E., P.L.A. ENGINEERING & LAND PLANNING ASSOCIATES 140 W. MAIN ST. HIGH BRIDGE NEW JERSEY, 08829

OWNER'S NAME: CITY OF PHILADELPHIA DEPARTMENT OF PUBLIC PROPERTY 702 CITY HALL, PHILADELPHIA, PA 19107 215-686-1776

DEVELOPER'S NAME PHILADELPHIA PARKS AND RECREATION CITY OF PHILADELPHIA OFFICE OF SPECIAL EVENTS 1515 ARCH ST. #10, PHILADELPHIA, PA 19102 215683-3600

4. NO BUILDINGS ARE PROPOSED.

NO SEWER OR WATER INFRASTRUCTURE WILL BE DECOMMISSIONED.

6. NO PROPERTY LINES WILL BE ALTERED AS PART OF THE PROPOSED PROJECT. 7. NO RIGHT-OF-WAY LINES WILL BE ALTERED AS PART OF THE PROPOSED

8. NO RIGHT-OF-WAY ENCROACHMENTS ARE PROPOSED.

9. NO INFRASTRUCTURE WILL BE PROPOSED BY PWD. 10. NO EASEMENTS ARE PROPOSED.

11. NO WATER METER IS PROPOSED.

PWD UPR TRACKING #: UPR-FY24-PENN-6606

12. NO DOMESTIC OR FIRE SERVICE IS PROPOSED. 13. NO WATER SERVICE OF BACKFLOW PROTECTION IS PROPOSED.

14. NO CRANE WILL BE USED FOR CONSTRUCTION.

15. DEVELOPER/OWNER WILL COMPLY WITH ALL PHILADELPHIA REGULATIONS PERTAINING TO PROPER ABANDONMENT AND/OR REUSE OF WATER SERVICE LINES AND SEWER LATERALS. PROOF OF ABANDONMENT AND/OR WATER DISCONTINUANCE MUST BE PROVIDED UPON REQUEST.

### REFERENCES:

1. A MAP ENTITLED "TOPOGRAPHIC & LOCATION SURVEY OF PENNYPACK PARK". PREPARED BY:SAS GEOSPATIAL. DATED: 11/10/2023 OR LAST REVISED

### PROJECT DESCRIPTION:

THIS PROJECT CONSISTS OF THE DEMOLITION OF EXISTING CONCRETE PADS, CONCRETE PAVEMENT AROUND THE STRUCTURE AT THE SOUTH END OF THE SITE, SELECT CURBS SELECT TREES, AREA INLET, AND GRAVEL PATH..


THE PROJECT PROPOSES THE CONSTRUCTION OF BENCHES, LIGHT POLES, PLAY STRUCTURES, CONCRETE PATH, BOUND AGGREGATE PATH, PLAY SURFACING, CONCRETE STAIRS, RETAINING WALL, CHEEK WALL, RAISED PEDESTRIAN CROSSING AND ELECTRIC LINES.


NO CONNECTIONS TO WATER OR SANITARY UTILITIES ARE PROPOSED.


PROJECT DESCRIPTION: INSTITUTIONAL PUBLIC PARK ENHANCEMENTS SITE GOVERNANCE: PHILADELPHIA PARKS AND RECREATION

### SITE DATA:

SITE SQUARE FOOTAGE: 42,600 SF (THE PROJECT SITE IS WITHIN PENNYPACK PARK SYSTEM AND THEREFORE DOES NOT HAVE A TAX LOT WITH A DEFINED AREA ASSOCIATED WITH IT.) EARTH DISTURBANCE: 42,600 SF PWD STORMWATER TRACKING #: FY22-PENN-6850-01

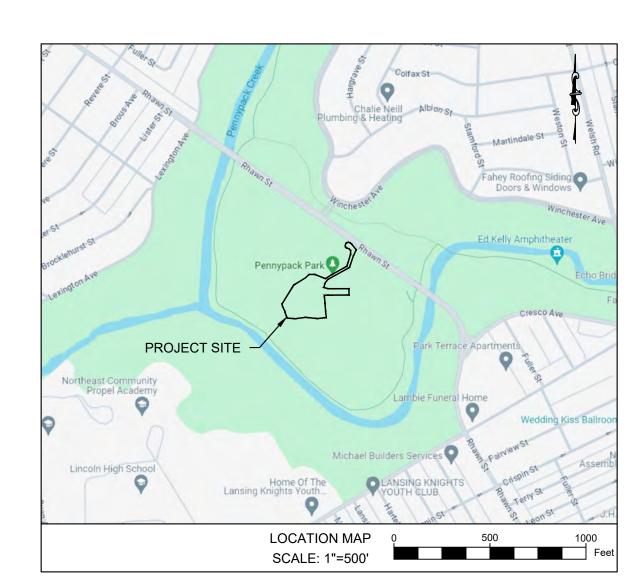

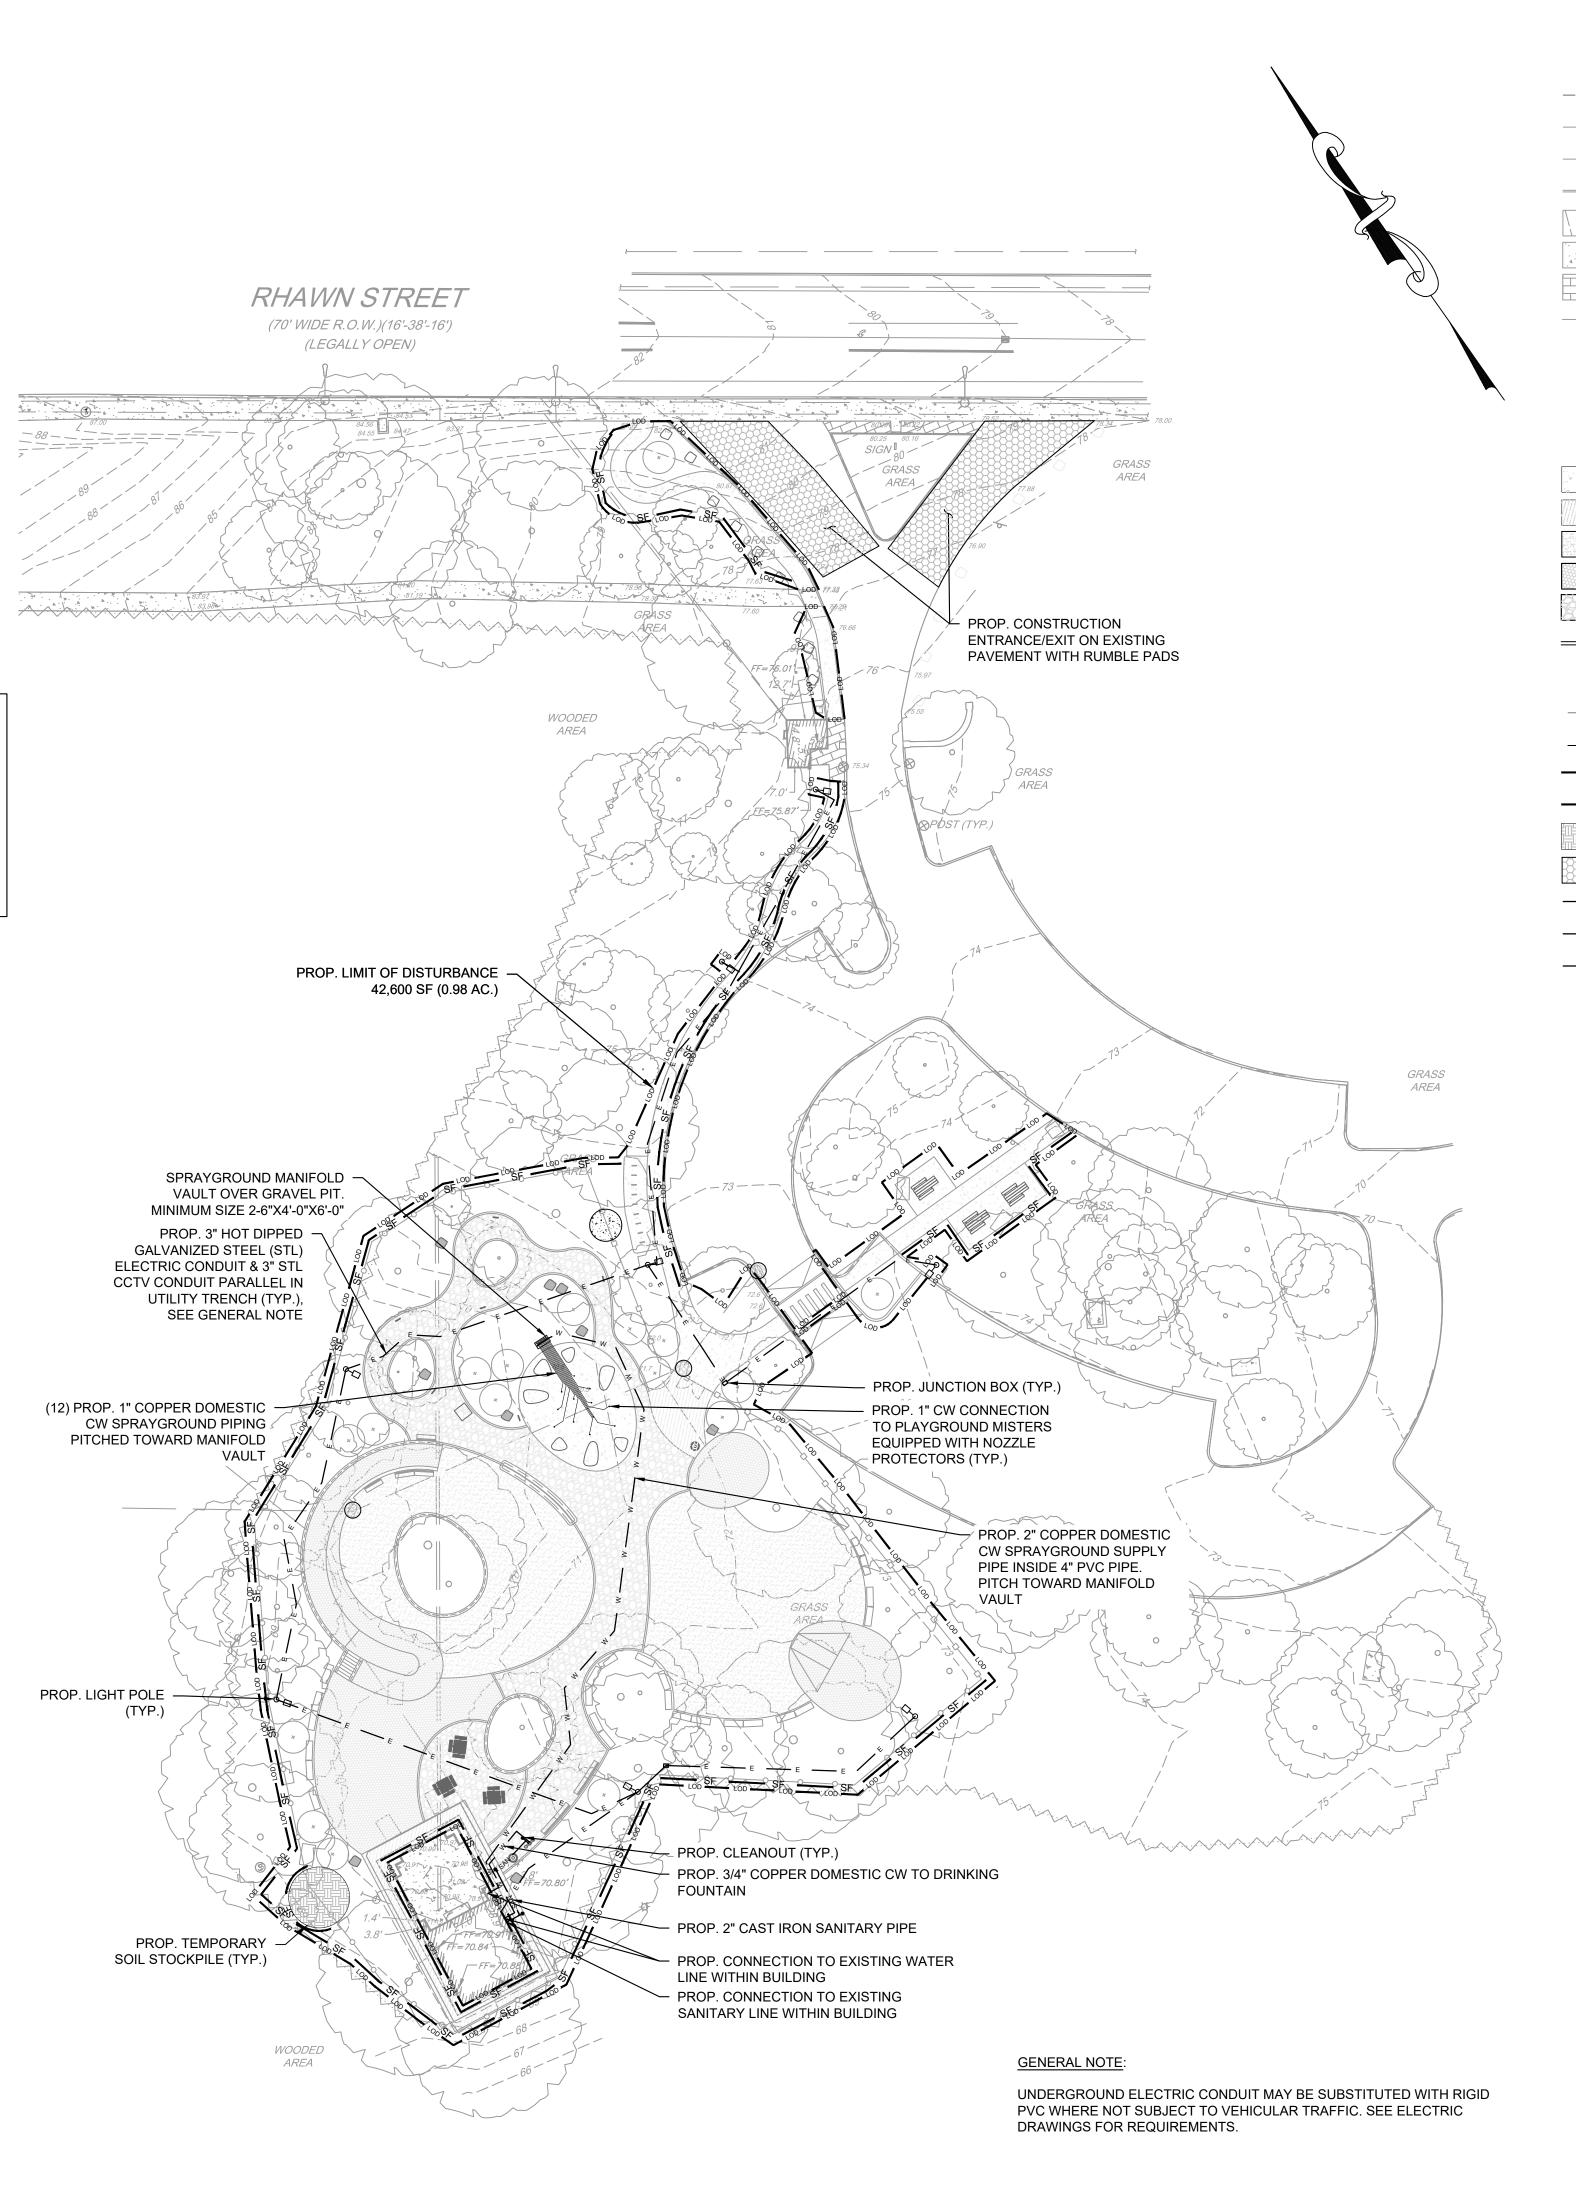

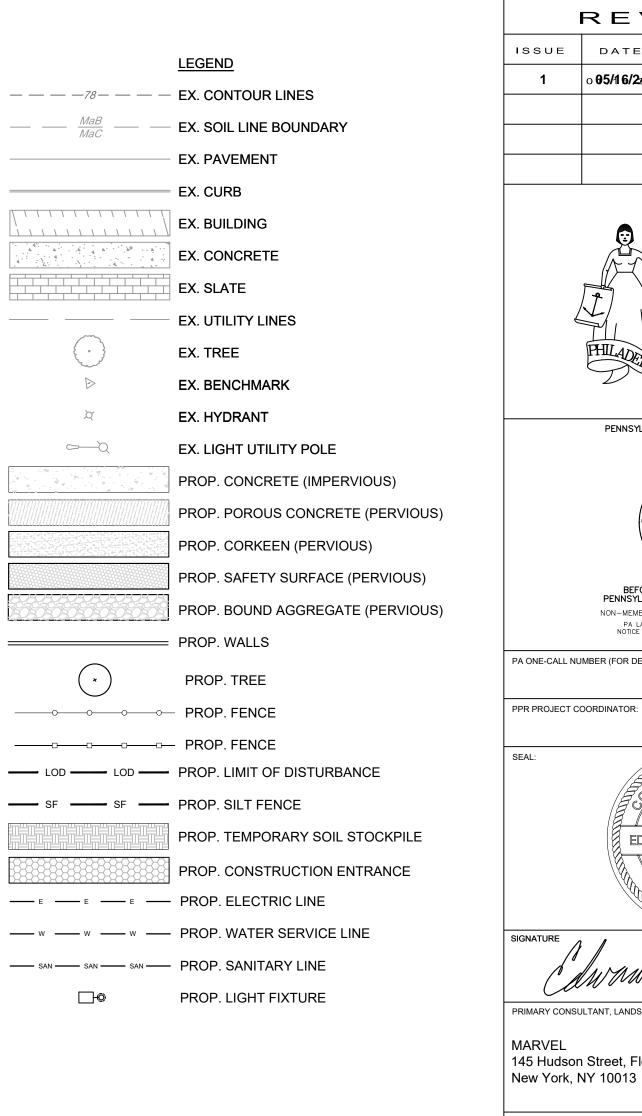


THE PROJECT SITE IS WITHIN PENNYPACK PARK SYSTEM AND DOES NOT HAVE IT'S OWN SITE ADDRESS. THEREFORE, THE PENNYPACK PARK SYSTEM'S ADDRESS AND OPA ACCOUNT NUMBER ARE ASSOCIATED WITH THIS PROJECT SITE. THE PROJECT SITE IS LOCATED JUST SOUTH OF THE INTERSECTION OF HOLMEHURST AVE AND RHAWN STREET. APPROXIMATE COORDINATES ARE 40°02'59" N, 75°02'09" W.

ADDRESS: 8300 FRANKFORD AVE PHILADELPHIA, PA 19136 BRT/OPA: 871402520


PHILADELPHIA WATER TRACKING NO.: FY22-PENN-6850-01

PENNSYLVANIA ONE CALL SYSTEM, INC. SITE IDENTIFICATION NO.: 20220322281 925 Irwin Run Road West Mifflin, Pennsylvania BEFORE YOU DIG ANYWHERE IN

PENNSYLVANIA! CALL 1-800-242-1776 NON-MEMBERS MUST BE CONTACTED DIRECTLY PA LAW REQUIRES THREE WORKING DAYS NOTICE TO UTILITIES BEFORE YOU EXCAVATE, DRILL, BLAST OR DEMOLISH

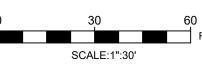

REVISIONS					
ISSUE DATE REVISIONS					
1	o <b>05/16/24</b> 4	PWD (ADDENDUM1ssion			
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PA ONE-CALL NUMBER (FOR DESIGN ONLY):

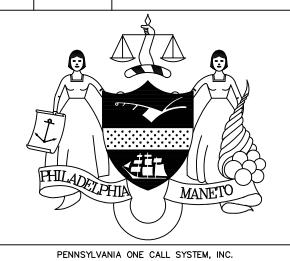MEGAN FUNK

04/04/2024

^PROFESSIONAL*|* EDWARD D. CONFAIR JR. \engineer /

PRIMARY CONSULTANT, LANDSCAPE ARCHITECT:

145 Hudson Street, Floor 3 New York, NY 10013

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CONSULTANT PROJECT NUMBER

CITY OF PHILADELPHIA PHILADELPHIA PARKS AND RECREATION

1515 ARCH STREET 11TH FLOOR, ONE PARKWAY BUILDING

PPR PROJECT NUMBER 16-21-7062-01

PENNYPACK PARK UNIVERSAL PLAYGROUND RHAWN ST. & HOLMEHURST AVE.

PHILADELPHIA, PA 19136

**UTILITY PLAN** 

PPR PROJECT NO.: 16-21-7062-01 CONSULTANT PROJECT NO .: 12/15/2023 AS NOTED

CHECKED BY

### **GENERAL**

- DO NOT SCALE DRAWINGS. CONSULT THE LANDSCAPE ARCHITECT FOR ANSWERS TO ALL QUESTIONS REGARDING DIMENSIONS. THE CONTRACTOR IS ADVISED THAT THIS INFORMATION IS DIAGRAMMATIC AND NOT NECESSARILY COMPLETE.
- 2. THE CONTRACTOR IS ADVISED THAT ALL UTILITY INFORMATION INDICATED HEREIN AND/OR AVAILABLE FROM AGENCIES, PRIVATE UTILITIES AND/OR THE OWNER MAY NOT BE COMPLETE.
- ALL EXISTING CONDITIONS INFORMATION SHOWN IS FOR REFERENCE ONLY. THE CONTRACTOR IS RESPONSIBLE FOR VERIFYING ALL EXISTING CONDITIONS. THE LANDSCAPE ARCHITECT ASSUMES NO RESPONSIBILITY FOR THE SURVEY INFORMATION SHOWN.
- PRIOR TO COMMENCEMENT OF THE WORK, THE CONTRACTOR SHALL VERIFY STATUS OF EXISTING UTILITIES WITHIN THE PROJECT AREA AS REQUIRED BY LOCAL LAW. ALL COMMUNICATIONS AND COORDINATION MEETINGS RELATIVE TO THE PROJECT BETWEEN THE CONTRACTOR AND ANY AGENCY, UTILITY COMPANY OR ORGANIZATION WILL BE CONDUCTED AND/OR APPROVED BY THE CLIENT. THE LANDSCAPE ARCHITECT SHALL RECEIVE NOTIFICATION OF ANY MEETINGS AND COPIES OF ANY AND ALL MINUTES OR COMMUNICATIONS AS A RESULT OF THOSE COMMUNICATIONS OR COORDINATION MEETINGS.
- THE CONTRACTOR SHALL MAKE TEST PITS AS REQUIRED TO VERIFY LOCATIONS AND ELEVATIONS OF UTILITIES AND OTHER SUBSURFACE ELEMENTS AS THE WORK PROGRESSES. SUCH WORK SHALL BE DEEMED TO BE INCLUDED IN THE LUMP SUM BUD FOR THE PROJECT. ALL WORK SHALL COMPLY WITH APPLICABLE **BUILDING CODE AND LOCAL LAWS.**
- 6. THE CONTRACTOR SHALL COORDINATE ALL WORK WITH THE CLIENT, PRIVATE UTILITY COMPANIES, AND THE CITY AGENCIES AS REQUIRED FOR THE EXPEDITIOUS **EXECUTION OF WORK.**
- IT IS THE CONTRACTOR'S RESPONSIBILITY TO FAMILIARIZE THEMSELVES WITH ALL THE EXISTING FIELD CONDITIONS ADJACENT TO THE SITE INCLUDING BUT NOT LIMITED TO ALL STRUCTURES, UTILITIES, FENCES, PAVEMENTS, SHRUBS, TREES, LIGHT POSTS. ETC. THROUGHOUT THE DURATION OF THE WORK. IT SHALL BE THE CONTRACTOR'S RESPONSIBILITY TO PROTECT AND MAINTAIN ALL EXISTING CONDITIONS ADJACENT TO THE SITE, OR AS INDICATED ON CONTRACT DRAWINGS. IN THE EVENT THE CONTRACTOR'S OPERATIONS RESULT IN DAMAGE TO EXISTING CONDITIONS ADJACENT TO THE SITE, OR CONDITIONS INDICATED TO REMAIN ON CONTRACT DRAWINGS, THE CONTRACTOR SHALL REPAIR AND CORRECT ALL DAMAGES TO THE SATISFACTION OF THE CLIENT AT NO EXTRA COST.
- CHANGES IN THE WORK; ALL REQUESTS FOR CHANGES AND/OR SUBSTITUTIONS IN THE WORK SHALL BE MADE IN WRITING TO THE PHILADELPHIA PARKS AND RECREATION DEPARTMENT (PPR) AND THE LANDSCAPE ARCHITECT.
- 9. THE CONTRACTOR SHALL STUDY THE INTERRELATIONSHIP OF ALL THE VARIOUS ELEMENTS OF CONSTRUCTION SHOWN ON THE CONTRACT DRAWINGS AND DESCRIBED IN THE PROJECT SPECIFICATIONS AND BULLETINS, AND SHALL COORDINATE THEIR CONSTRUCTION OPERATIONS ACCORDINGLY. ANY CONFLICTS WHICH MAY BECOME APPARENT FROM THE COORDINATION STUDY SHALL BE IMMEDIATELY BROUGHT TO THE ATTENTION OF THE LANDSCAPE ARCHITECT.
- ALL NEW AND EXISTING INLETS, BASINS, AND CONNECTIONS WITHIN THE LIMITS OF THIS CONTRACT ARE TO BE CLEANED, FLUSHED, AND OTHERWISE MADE OPERABLE TO THE SATISFACTION OF THE CLIENT AND ARE TO BE INCLUDED IN THE LUMP SUM BID.
- 11. PRIOR TO COMMENCEMENT OF WORK, THE CONTRACTOR SHALL BRING CONDITIONS WHICH CONFLICT WITH PROPOSED GRADING AND SITE CONSTRUCTION TO THE ATTENTION OF THE LANDSCAPE ARCHITECT AND THE
- 12. ANY COST CAUSED BY DEFECTIVE OR ILL-TIMED WORK, IMPROPER SCHEDULING OR DELINQUENT ORDERING SHALL BE BORNE BY THE CONTRACTOR.
- 13. ANY REQUIRED APPROVALS FROM ALL CITY AGENCIES HAVING JURISDICTION, AS WELL AS FROM PRIVATE UTILITY COMPANIES, MUST BE OBTAINED PRIOR TO ACCEPTANCE OF THE PROJECT BY THE CLIENT.
- 14. ALL MECHANICAL EQUIPMENT, CONCEALED WATER AND GAS VALVES, ETC. TO REMAIN UNLESS OTHERWISE SPECIFICALLY NOTED.
- MINOR DETAILS NOT USUALLY SHOWN OR SPECIFIED, BUT NECESSARY FOR PROPER CONSTRUCTION OF ANY PART OF THE WORK SHALL BE INCLUDED AS IF THEY WERE INDICATED ON THE DRAWINGS.
- 16. AT ALL TIMES, THE SITE SHALL BE KEPT NEAT, AND KEPT FREE OF DEBRIS LEFT FROM ALL CONSTRUCTION OPERATIONS. IT SHALL BE THE CONTRACTOR'S RESPONSIBILITY TO PRESERVE AND PROTECT ALL WORK FINISHED OR IN PROGRESS, AND TO PROTECT THE PUBLIC FROM ANY INJURY THAT MAY OCCUR AS A RESULT OF THE SITE BEING ACCESSIBLE DURING PROJECT CONSTRUCTION.
- 17. UNLESS OTHERWISE NOTED. DETAILED DRAWINGS AND PART PLANS SHALL HAVE PRECEDENCE OVER LAYOUT DRAWINGS (I.E. SITE PLAN) FOR ACCURACY OF INFORMATION.
- 18. SEE PROJECT SPECIFICATIONS FOR REQUIRED SUBMITTALS.
- 19. THE SHOP DRAWINGS SUBMITTED BY THE CONTRACTOR SHALL SHOW ALL FASTENING DEVICES AND LOCATIONS COMPLETE WITH FASTENINGS TO ALL FOUNDATION WALLS AND PAVEMENTS. THE SHOP DRAWINGS SHALL PROVIDE SUFFICIENT DETAIL TO ALLOW THE LANDSCAPE ARCHITECT TO REVIEW AND APPROVE THE SYSTEM AND PIECES.
- 20. IT SHALL BE THE CONTRACTOR'S RESPONSIBILITY TO GUARANTEE ANY AND ALL ANCHORING SYSTEMS FOR ALL WORK.
- 21. THE CONTRACTOR SHALL INSTALL GALVANIZED STEEL PIPE SLEEVES AS REQUIRED TO INSTALL UTILITY WORK THROUGH CONCRETE AND MASONRY FOOTINGS AND FOUNDATIONS. ALL PIPE SLEEVES SHALL BE SCHEDULE 40 PIPE AND BE TWICE THE DIAMETER OF THE UTILITY PIPE UNLESS OTHERWISE NOTED.
- CONCRETE FOR CURBS, FOOTINGS, AND WALLS COMPLY WITH STRUCTURAL AND ARCHITECTURAL SPECIFICATIONS FOR CAST-IN-PLACE CONCRETE WORK.
- 23. THE CONTRACTOR SHALL PROVIDE AND MAINTAIN SAFE ACCESS TO ALL BUILDING ENTRANCES AT ALL TIMES DURING THE CONSTRUCTION PERIOD.
- 24. PAVER SYSTEMS SHALL MEET (ADJACENT) ALTERNATE MATERIAL PAVEMENTS FLUSH. THE CONTRACTOR SHALL VERIFY THE INTERIOR GRADES AND THEIR RELATIONSHIP WITH THE PROPOSED GRADES. THE CLIENT SHALL BE NOTIFIED IF THERE ARE ANY DISCREPANCIES IN THE ELEVATIONS. ADJUSTMENTS SHALL BE MADE AS NECESSARY AND SHALL BE APPROVED BY THE OWNER PRIOR TO CONSTRUCTION.
- EXISTING DRAINS/VALVE COVERS, ETC. SHALL BE ADJUSTED AS NECESSARY IN AREAS WHERE PROPOSED WORK IS TO BE INSTALLED.
- 26. CONCRETE CURBS/FOOTINGS FOR ALL FENCING AND WALLS SHALL BRIDGE OVER ANY EXISTING DRAIN INLETS AND UTILITIES AND SHALL BE BROUGHT TO THE ATTENTION OF THE CLIENT AND THE LANDSCAPE ARCHITECT.
- 27. CONTRACTOR SHALL SUPPLY THE CLIENT WITH MANUFACTURER'S SHOP DRAWINGS AND INSTALLATION DRAWINGS PRIOR TO THE INSTALLATION OF ANY
- 28. CONTRACTOR IS REQUIRED TO OBTAIN ALL PERMITS FOR WORK UNDER THIS
- 29. CONTRACTOR IS RESPONSIBLE FOR SCHEDULING ALL NECESSARY INSPECTIONS WITH DEPARTMENT OF LICENSURE AND INSPECTIONS (L&I), INCLUDING FINAL INSPECTION AND PERMIT CLOSEOUT.

### DEMOLITION AND REMOVALS

1. THE CONTRACTOR IS RESPONSIBLE FOR COORDINATION BETWEEN THE EXISTING

CONDITIONS AND THE LANDSCAPE PLAN IN PREPARING BIDS AND EXECUTING

- 2. IT IS THE CONTRACTOR'S RESPONSIBILITY TO PRESERVE AND PROTECT ALL EXISTING FACILITIES NOT SPECIFICALLY STATED FOR REMOVAL WITHIN THE WORK
- 3. IT IS THE CONTRACTOR'S RESPONSIBILITY TO LOCATE AND VERIFY ELEVATIONS OF ALL UTILITY/MECHANICAL STRUCTURES, AND UTILITY LINES. IT IS THE CONTRACTOR'S RESPONSIBILITY TO PROTECT THE UTILITY/MECHANICAL LINES AND CONDUITS/PIPES DURING REMOVALS AND CONSTRUCTION. DAMAGE TO UTILITIES SHALL BE REPAIRED AT THE CONTRACTOR'S EXPENSE SUBJECT TO LANDSCAPE ARCHITECT AND THE CLIENT'S APPROVAL.
- 4. THE CONTRACTOR SHALL, AS PART OF THEIR CONTRACTUAL OBLIGATIONS, REMOVE AS DIRECTED, ALL BALLAST AGGREGATE AND OTHER ENCROACHMENTS THAT INTERFERE WITH LANDSCAPE WORK.
- 5. ALL REMOVED MATERIAL NOT STATED FOR REUSE SHALL BE REMOVED FROM THE SITE AND SHALL NOT BE MIXED WITH NEW FILL OR GRAVEL TO BE BROUGHT ON
- 6. REMOVE ALL EXISTING RUBBLE, DEBRIS, AND ENCROACHMENT FROM THE SITE AND DISPOSE OF LEGALLY. EVIDENCE OF LEGAL DISPOSAL SHALL BE GIVEN BY THE CONTRACTOR TO THE LANDSCAPE ARCHITECT AND THE CLIENT.
- 7. IT SHALL BE THE CONTRACTOR'S RESPONSIBILITY AS PART OF THIS CONTRACT TO DETERMINE THE MOST APPROPRIATE METHOD OF REMOVALS OF EXCAVATED AND/OR DEMOLITION MATERIALS FROM THE SITE WITHIN THE CONTRACT LIMIT REMOVALS WHETHER BY MACHINE OR BY HAND SHALL BE INCLUDED IN THE CONTRACTOR'S PROPOSAL. STRIP EXISTING BALLAST AGGREGATE IN AREAS OF CONSTRUCTION AND STOCKPILE FOR FUTURE RE-USE, IF APPROVED, AS MAY BE REQUIRED.

### WATER SUPPLY / MAINTENANCE WORK

- 1. THE CONTRACTOR SHALL LOCATE ALL EXISTING VALVE BOXES WITHIN THE CONTRACT LIMIT LINES AND SHALL INDICATED THEM IN THE FIELD TO THE SATISFACTION OF THE LANDSCAPE ARCHITECT. FURTHERMORE. THE CONTRACTOR'S ATTENTION IS DIRECTED TO THE FACT THAT THEY WILL BE RESPONSIBLE FOR THE REPLACEMENT AND RESETTING OF ALL VALVE BOXES NOT STATED FOR REMOVAL WHICH, ARE DAMAGED OR DISTURBED AS A RESULT OF THEIR OPERATIONS, SUBJECT TO APPROVAL OF THE LANDSCAPE ARCHITECT.
- ALL EXISTING DRAIN AND WATER SUPPLY CONNECTIONS SHOULD BE CONTINUOUSLY MAINTAINED DURING CONSTRUCTION OF ANY WATER LINES. IF ANY HOUSE CONNECTION MUST BE DISCONNECTED FOR CONSTRUCTION PURPOSES, FLOW MUST BE MAINTAINED BY PLUMBING OR OTHER SUITABLE MEANS AS DIRECTED BY THE LANDSCAPE ARCHITECT, AND IN SUCH A MANNER THAT NO BACK-UPS OCCUR. ANY AND ALL EXISTING HOUSE CONNECTIONS OR OTHER SEWER APPURTENANCES WHICH ARE TO REMAIN AND WHICH MUST BE DISTURBED FOR CONSTRUCTION PURPOSES SHALL BE RESTORED TO THEIR PRESENT CONNECTIONS AFTER COMPLETION OF THE WORK SUBJECT TO APPROVAL OF LANDSCAPE ARCHITECT AND THE CLIENT. ANY DAMAGE DONE AS A RESULT OF THE WORK SHALL BE REPAIRED AT NO COST TO THE CLIENT.

### DRAINAGE WORK

- 1. ALL PROPOSED DRAINAGE WORK SHALL BE DONE IN CONFORMANCE WITH THE LATEST STANDARDS ANY OTHER APPLICABLE CODES.
- ALL AREA DRAINS WITHIN THE CONTRACT LIMITS SHALL BE ADJUSTED AS NECESSARY, SO THAT THEY WILL BE OPERATIONAL, ACCESSIBLE, AND CONCEALED FROM PROJECTS OCCUPANTS AFTER THE COMPLETION OF THE
- ANY DAMAGE TO EXISTING AREA DRAINS, AND CONNECTIONS CAUSED BY THE CONTRACTOR'S WORK SHALL BE REPAIRED OR REPLACED BY THE CONTRACTOR, AT NO COST TO THE CLIENT, SUBJECT TO THE APPROVAL OF THE LANDSCAPE ARCHITECT AND THE CLIENT.
- 4. ALL EXISTING AREA DRAINS AND CONNECTIONS WITHIN THE LIMITS OF THIS CONTRACT AND CONTIGUOUS ARE TO BE CLEANED OUT, REPAIRED, AND OTHERWISE MADE OPERABLE TO THE SATISFACTION OF THE LANDSCAPE

### LAYOUT PLANS, L-100 SERIES

- 1. CONTRACTOR SHALL LAYOUT AND STAKE IN THE FIELD THE ALIGNMENT AND GRADE OF ALL CURBS, PAVEMENTS AND ALL OTHER SITE ELEMENTS FOR REVIEW AND APPROVAL BY THE LANDSCAPE ARCHITECT PRIOR TO THE INSTALLATION.
- 2. THE CONTRACTOR SHALL VERIFY ALL EXISTING SITE CONDITIONS, BOTH ABOVE AND BELOW THE SURFACE. ANY DISCREPANCIES BETWEEN INFORMATION SHOWN ON THE DRAWINGS AND ACTUAL FIELD CONDITIONS SHALL BE BROUGHT TO THE ATTENTION OF THE LANDSCAPE ARCHITECT IN WRITING, PRIOR TO COMMENCEMENT OF WORK.
- NO CHANGES SHALL BE MADE TO THE DESIGN OR LAYOUT WITHOUT THE WRITTEN APPROVAL OF THE LANDSCAPE ARCHITECT. THE CONTRACTOR SHALL LAYOUT THE WORK AS DIMENSIONED ON THE PLANS. WRITTEN DIMENSIONS SHALL **GOVERN. DO NOT SCALE DISTANCES.**

### PAVING PLANS, L-200 SERIES

- 1. THE CONTRACTOR SHALL USE CARE DURING CONSTRUCTION TO AVOID DISTURBING OR DAMAGING ADJACENT STRUCTURES, EITHER SUB-GRADE OR ABOVE-GRADE. THE CONTRACTOR SHALL NOTIFY THE CLIENT OF DAMAGE IMMEDIATELY. CLIENT APPROVAL IS REQUIRED PRIOR TO PERFORMING ANY REPAIRS, REPLACEMENTS, OR RESTORATIONS. ANY DAMAGE TO EXISTING STRUCTURES RESULTING FROM CONSTRUCTION SHALL BE THE CONTRACTOR'S RESPONSIBILITY AND SHALL BE RESTORED AT THE CONTRACTOR'S EXPENSE TO THE SATISFACTION OF THE OWNER.
- THE CONTRACTOR SHALL BE RESPONSIBLE FOR COORDINATING WORK WITH THE WORK OF OTHER CONTRACTORS AND SUBCONTRACTORS ON SITE, SUCH AS IRRIGATION, ELECTRICIAN, CARPENTERS, PLUMBERS, AND SPECIALTY TRADES. COMPLY WITH REQUIREMENTS AND SCHEDULE OF GENERAL CONTRACTOR.
- WORK SHALL INCLUDE, BUT NOT BE LIMITED TO CONSTRUCTION OF PAVEMENTS, CURBS, WALKS, STEPS, WALLS, RAILINGS, FENCING, STRUCTURES, LIGHTING, MANUFACTURED SOILS AND OTHER ELEMENTS, DAILY CLEAN-UP, MAINTENANCE AND GUARANTEE.
- 4. VERIFY ALL DIMENSIONS AND GRADES IN THE FIELD AND NOTIFY LANDSCAPE ARCHITECT OF ANY DISCREPANCIES IMMEDIATELY.
- 5. SECURE ALL REQUIRED PERMITS AND APPROVALS FROM LOCAL OR SUPERVISORY AUTHORITIES. POST ON THE SITE OR HAVE AVAILABLE FOR REVIEW BY
- 6. KEEP THE SITE CLEAN AND NEAT; REGULARLY WATER DOWN WORK ROADS AND AREAS ADJACENT TO THE SITE TO KEEP THEM FREE OF DUST AND AIR-BORNE POLLUTANTS.
- 7. DECISIONS REGARDING ALL QUESTIONS WHICH MAY ARISE AS TO THE QUALITY OF ACCEPTABILITY OF MATERIALS FURNISHED. WORK PERFORMED. PROGRESS OF THE WORK, INTERPRETATION OF DRAWINGS AND SPECIFICATIONS, AND ALL QUESTIONS AS TO ACCEPTABLE FULFILLMENT OF THE CONTRACT BY THE CONTRACTOR SHALL BE MADE BY THE LANDSCAPE ARCHITECT.
- ALL WORK AND MATERIALS REJECTED BY THE LANDSCAPE ARCHITECT AS FAILING TO COMPLY WITH THE CONTRACT DOCUMENTS SHALL BE PROMPTLY REMOVED, REPLACED, AND/OR RE-EXECUTED BY THE CONTRACTOR TO BRING IT INTO COMPLIANCE WITH THE REQUIREMENTS. THIS SHALL BE DONE AT THE EXPENSE OF THE CONTRACTOR WITHOUT COST TO THE OWNER AND SHALL INCLUDE MAKING

GOOD ALL WORK OF THE CONTRACTOR AND OTHER CONTRACTORS DESTROYED.

### PLANTING PLAN, L-600

- 1. SEE L-910 FOR PLANTING DETAILS.
- 2. PLANT GROUPINGS AND LOCATIONS ARE DIAGRAMMATIC THE LOCATION OF PLANTS SHALL BE APPROVED IN THE FIELD BY THE LANDSCAPE ARCHITECT.
- 3. ALL PLANTS SHALL BE PLANTED AT THE TIME OF DELIVERY DUE TO LIMITED STORAGE ON SITE. PLANTS IN THE SAME PLANTING BED SHALL BE PLANTED AT THE SAME TIME. ANY PLANTS REMAINING UNPLANTED ON THE SITE FOR MORE THAN 24 HOURS SHALL BE PROTECTED AND MAINTAINED INCLUDING BUT NOT LIMITED TO WATER AND SHADE. ANY DAMAGED PLANTS SHALL BE REPLACED AS DIRECTED, AT THE CONTRACTOR'S EXPENSE.
- THERE WILL BE NO SUBSTITUTIONS OF PLANT MATERIAL WITHOUT PRIOR WRITTEN APPROVAL BY THE LANDSCAPE ARCHITECT.
- CONTRACTOR SHALL IMPLEMENT THE PLANTING PLAN AS SHOWN. PLANTS SHALL BE LOCATED AS CLOSE AS POSSIBLE TO LAYOUT PROVIDED OR AS DIRECTED IN THE FIELD BY THE LANDSCAPE ARCHITECT.
- 6. PLANTING BEDS SHALL RECEIVE A MIN. 2" THICK LAYER OF SHREDDED HARDWOOD MULCH, AS INDICATED ON THE PLANTING DETAILS AND SPECS.
- PRIOR TO COMMENCING PLANTING, THE CONTRACTOR SHALL STAKE OUT THE EXACT LOCATION OF THE ALL TREES FOR THE LANDSCAPE ARCHITECT'S APPROVAL. ALL PLANTING OPERATIONS AND LAYOUT SHALL PROCEED UNDER CLOSE COORDINATION WITH THE LANDSCAPE ARCHITECT. TREE LOCATIONS MAY VARY AS DIRECTED BY THE LANDSCAPE ARCHITECT IN THE FIELD. THE ACTUAL LOCATION OF PLANT MATERIALS MAY VARY DUE TO FIELD CONDITIONS. FINAL PLACEMENT OF PLANT MATERIAL SHALL BE APPROVED BEFORE PITS ARE DUG. IF INITIAL PLACEMENT IS NOT SATISFACTORY, PLANTS SHALL BE RELOCATED IN THE FIELD AT THE DIRECTION OF THE LANDSCAPE ARCHITECT, AT NO ADDITIONAL COST TO THE OWNER.
- MATERIAL WILL BE INSPECTED AND APPROVED AT PLACE OF GROWTH BY THE LANDSCAPE ARCHITECT. HOWEVER, PLANT MATERIAL WHICH HAS BECOME DAMAGED OR DISEASED OR WHICH IS UNACCEPTABLE TO THE LANDSCAPE ARCHITECT MAY BE REJECTED UPON DELIVERY TO THE SITE.
- 9. SHOULD THERE BE ANY DISCREPANCIES BETWEEN THE QUANTITIES CALLED FOR ON THE PLANT LIST AND THOSE INDICATED ON THE PLAN, THE GREATER QUANTITY
- 10. AT ALL TIMES, THE SITE SHALL BE KEPT NEAT AND FREE OF DEBRIS LEFT FROM THE PLANTING OPERATION.
- 11. ALL PLANT MATERIAL TO BE VIGOROUS, AND FREE OF INJURY OR DEFECTS. ALL PLANT MATERIAL TO BE TRUE REPRESENTATIVES OF THEIR SPECIES.
- 12. ALL PLANT TAGS MUST REMAIN ON THE PLANT MATERIAL UNTIL THE LANDSCAPE ARCHITECT REVIEWS THE LAYOUT AND APPROVES QUANTITIES.
- 13. ALL TREES TO INCLUDE A 1 YEAR FULL REPLACEMENT WARRANTY.

- ALL LIGHTING FIXTURES, LAMPS AND RELATED DEVICES FURNISHED UNDER THIS CONTRACT SHALL CARRY THE APPROVAL LABEL OF UL OR ETL FOR THE SPECIFIC APPLICATION IN WHICH THEY ARE USED.
- 2. THE STATEMENT "FINISH TO BE SELECTED BY DESIGN PROFESSIONAL" SHALL BE INTERPRETED TO MEAN THAT THE FINISH OF THE LUMINAIRE SHALL MATCH THE APPEARANCE OF A PAINT CHIP, COLOR NUMBER, OR METAL SWATCH FURNISHED BY THE DESIGN PROFESSIONAL DURING THE SUBMITTAL REVIEW PROCESS.
- CONTRACTOR SHALL CONFIRM FIXTURE VOLTAGES AND MOUNTING HARDWARE ARE COMPATIBLE WITH THEIR APPLICATION AS DETERMINED BY THE DESIGN PROFESSIONAL PRIOR TO ORDERING FIXTURES.
- CONTRACTOR SHALL PROVIDE ALL MOUNTING HARDWARE AS REQUIRED FOR FIXTURE
- DIMMING RANGES IDENTIFIED IN THE LIGHTING FIXTURES INDICATE THE REQUIRED LOW END DIMMING. ALL LIGHTING EQUIPMENT IDENTIFIED AS DIMMABLE SHALL PROVIDE SMOOTH, CONTINUOUS DIMMING FROM 100% POWER OUTPUT TO THE LOW-END PERCENTAGE OF POWER OUTPUT IDENTIFIED IN THE FIXTURE SCHEDULE.
- 6. LED CHROMATICITY AND COLOR RENDERING INDEX (CRI): WHITE LEDS SHALL MEET, AT A MINIMUM, CHROMATICITY STANDARDS SET BY ANSI/NEMA/ANSLG C78.377-2015.
- UNLESS OTHERWISE NOTED, THE COLOR RENDERING INDEX (CRI) FOR LED EQUIPMENT SHALL MEET THE FOLLOWING MINIMUM REQUIREMENTS: EXTERIOR LUMINAIRES >/ 70 CRI INTERIOR LUMINAIRES >/ 80 CRI
- LED LUMEN MAINTENANCE (L70): LED LUMEN MAINTENANCE SHALL BE MEASURED IN ACCORDANCE WITH IESNA LM-80 STANDARDS. PHOTOMETRIC TESTING FOR SOLID STATE LUMINAIRES SHALL BE IN ACCORDANCE WITH IESNA LM-79 STANDARDS.
- UNLESS OTHERWISE NOTED, THE LUMEN MAINTENANCE (L70) RATED LIFETIME FOR LED **EQUIPMENT SHALL MEET THE FOLLOWING MINIMUM REQUIREMENTS:**
- INTEGRATED LED CHIP-BASED LUMINAIRES >/ 50,000 HOURS LINEAR FLUORESCENT LED TUBES >/\_ 35,000 HOURS SCREW-BASE, GU10 BASE & PIN BASE LED LAMPS >/\_ 25,000 HOURS WEDGE-BASE LED LAMPS >/\_ 8,000 HOURS
- 8. LED WARRANTY: UNLESS OTHERWISE INDICATED, ALL LIGHTING EQUIPMENT WITH INTEGRATED LED LIGHT ENGINES SHALL PROVIDE A MINIMUM 5-YEAR MANUFACTURER WARRANTY ON THE LED LIGHT ENGINE AND ASSOCIATED DRIVER(S). ALL SELF-CONTAINED LED LAMPS (SCREW-BASE, PIN-BASE) SHALL PROVIDE A MINIMUM 3-YEAR WARRANTY ON THE LAMP MODULE.
- 9. CONTRACTOR SHALL SELECT, FURNISH AND INSTALL THE CORRECT SIZE OF SECONDARY WIRING FROM REMOTE TRANSFORMERS AND/OR REMOTE BALLASTS AS REQUIRED TO KEEP VOLTAGE DROP IN THE SECONDARY WIRING BELOW 3% OF RATED VOLTAGE.
- 10. CONTRACTOR SHALL PROVIDE LABOR AND EQUIPMENT FOR FOCUSING OF ADJUSTABLE FIXTURES AND PRESETTING OF LIGHTING CONTROL SYSTEMS. FOCUSING AND PRESETTING SHALL BE DONE IN THE PRESENCE OF THE DESIGN PROFESSIONAL. CONTRACTOR SHALL FOCUS LIGHTING AFTER DARK IF DIRECTED BY THE OWNER'S REPRESENTATIVE. UNLESS OTHERWISE NOTED, CONTRACTOR SHALL PROVIDE AT LEAST ONE DAY OF A FACTORY-TRAINED AND CERTIFIED TECHNICIAN TO PROVIDE WARRANTY START UP AND PROGRAMMING FOR ALL LIGHTING CONTROL SYSTEMS AND PROGRAMMABLE LIGHTING FIXTURES.
- 11. CONTRACTOR SHALL PROVIDE THE FOLLOWING WITH THEIR BID:
- 11.a. THE UNIT PRICE, WITHOUT LAMP, FOR EACH LIGHTING FIXTURE TYPE LISTED WITHIN THE LIGHTING FIXTURE SCHEDULE. THE UNIT PRICE SHALL BE FOR ONE OF THE LISTED MANUFACTURER'S FOR THAT PARTICULAR FIXTURE. THE MANUFACTURER SHALL BE IDENTIFIED. SUBSTITUTIONS FOR FIXTURES PROVIDED BY MANUFACTURERS NOT LISTED IN THE SCHEDULE ARE NOT ACCEPTABLE. SEE BELOW FOR REQUIREMENTS ASSOCIATED WITH SUBMITTING LIGHTING FIXTURE SUBSTITUTIONS.
- 11.b. THE TOTAL QUANTITY OF EACH FIXTURE TYPE WITH THE EXTENDED COST FOR THAT
- 11.c. THE UNIT PRICE, TYPE, AND QUANTITY OF LAMPS.
- 12. WITHIN 21 DAYS OF CONTRACT AWARD, THE CONTRACTOR SHALL FURNISH SUBMITTALS FOR ALL SPECIFIED LIGHTING FIXTURES FOR REVIEW BY THE DESIGN PROFESSIONAL. THE SUBMITTALS SHALL INCLUDE LUMINAIRE CATALOG CUTS, SUBMITTAL SHEETS, OR
- MANUFACTURERS SHOP DRAWINGS INDICATING THE FOLLOWING: 12.a. MANUFACTURER'S NAME AND COMPLETE CATALOG NUMBER
- 12.b. FIXTURE TYPE, DIMENSIONS AND FINISHES 12.c. FIXTURE PHOTOMETRIC TEST DATA FROM AN INDEPENDENT TEST LABORATORY

- 12.d. FIXTURE ACCESSORIES, COMPONENTS, AND HARDWARE WHEN SPECIFIED
- LAMP TYPE, QUANTITY, WATTAGE, LUMEN OUTPUT, RATED LIFE, COLOR TEMPERATURE, COLOR RENDERING INDEX AND BEAM SPREAD AS APPLICABLE
- BALLAST TYPE AND FIXTURE VOLTAGE
- 13. LIGHTING FIXTURE SUBSTITUTION REQUESTS MUST BE SENT TO AND RECEIVED BY THE LIGHTING DESIGNER FOR REVIEW 14 DAYS PRIOR TO BID DATE. FAILURE TO SUBMIT WITHIN THIS DEADLINE SHALL CONSTITUTE A GUARANTEE THAT THE SPECIFIED FIXTURES WILL BE SUPPLIED. THE SUBMITTAL SHALL INCLUDE THE FOLLOWING:
  - 13.a. SIX HARD COPIES OF THE SUBMITTALS REQUIRED ABOVE FOR BOTH THE SPECIFIED
- FIXTURE AND THE PROPOSED SUBSTITUTION.

OF THE PROPOSED SUBSTITUTION.

- 13.b. ONE NON-RETURNABLE WORKING SAMPLE OF THE PROPOSED SUBSTITUTE FIXTURE WITH CORD & PLUG CONNECTION FOR 120 VOLT OPERATION, AND SPECIFIED LAMP(S) 13.c. CONTRACTOR'S STATEMENT INDICATING THE EFFECT OF THE SUBSTITUTION ON THE CONSTRUCTION SCHEDULE COMPARED TO THE SCHEDULE WITHOUT THE APPROVAL
- 13.d. CONTRACTOR'S CERTIFICATION STATING THAT THE PROPOSED SUBSTITUTION CONFORMS TO THE REQUIREMENTS OF THE CONTRACT DOCUMENTS IN EVERY RESPECT AND IS APPROPRIATE FOR THE APPLICATIONS INDICATED IN THE
- 13.e. CONTRACTOR'S CERTIFICATION STATING THAT ANY MODIFICATIONS TO ANY BUILDING SYSTEM OR EQUIPMENT THAT MAY RESULT FROM THE PROPOSED LIGHTING FIXTURE SUBSTITUTION WILL BE DESIGNED AND CONSTRUCTED AT THE CONTRACTOR'S
- 13.f. CONTRACTOR'S WAIVER OF RIGHTS TO ADDITIONAL PAYMENT OR TIME THAT MAY BECOME NECESSARY SHOULD THE PROPOSED SUBSTITUTION FAIL TO PERFORM IN A
- MANNER THAT MATCHES THE SPECIFIED FIXTURE. 13.g. CONTRACTOR-NET UNIT PRICE FOR THE SPECIFIED FIXTURE AND FOR THE PROPOSED SUBSTITUTE FIXTURE.

THE LIGHTING DESIGNER SHALL BE REIMBURSED BY THE CONTRACTOR FOR ALL OF THE DESIGNER'S TIME ASSOCIATED WITH THE REVIEW OF THE PROPOSED FIXTURE SUBSTITUTION(S). PAYMENT SHALL BE MADE IN ADVANCE OF THE REVIEW, BASED ON THE DESIGNER'S ESTIMATE OF THE REQUIRED TIME. THE PAYMENT SHALL BE BASED ON THE DESIGNER'S STANDARD HOURLY RATES FOR THE PERSONNEL INVOLVED IN THE REVIEW.

### **LIGHTING DEFINITIONS:**

- CORRELATED COLOR TEMPERATURE (CCT): THE ABSOLUTE TEMPERATURE, MEASURED IN DEGREES KELVIN, OF A BLACKBODY RADIATOR HAVING CHROMATICITY RESEMBLING THAT OF AN ELECTRIC LIGHT SOURCE. FOR LED SOURCES CCT SHALL NOT DEVIATE FROM THE REFERENCE COLOR TEMPERATURE BY NO MORE THAN THREE MACADAM ELLIPSES, AS DEFINED BY NEMA/ANSI/ANSLG C78.377-2015.
- COLOR RENDERING INDEX (CRI): MEASURE OF COLOR SHIFT OBJECTS UNDERGO WHEN ILLUMINATED BY AN ELECTRIC LIGHT SOURCE AS COMPARED WITH THE COLOR OF THE SAME OBJECTS ILLUMINATED BY A REFERENCE SOURCE AT THE SAME COLOR TEMPERATURE. CRI VALUES FOR ELECTRIC LIGHT SOURCES RANGE FROM APPROXIMATELY 20 (LOW PRESSURE SODIUM) TO 99 (HALOGEN). CRI VALUES FOR LED SOURCES SHALL BE MEASURED AFTER 6000 HOURS AND SHALL NOT DEVIATE MORE THAN 3 POINTS FROM THE RATED VALUE.
- LED LIGHT ENGINE: THE COMBINED LED LIGHT SOURCE AND ITS ASSOCIATED ELECTRONIC DRIVER. THE LED LIGHT ENGINE MAY HAVE AN INTEGRAL DRIVER OR THE DRIVER MAY BE HOUSED IN A SEPARATE ENCLOSURE.
- LED DRIVER: CONTROL DEVICE THAT MAINTAINS CONSTANT AMOUNT OF CURRENT TO THE LED LIGHT SOURCE. LED DRIVERS GENERALLY OPERATE AT 12VDC OR 24VDC. SOME DRIVERS ARE DESIGNED TO ACCEPT BRANCH CIRCUIT VOLTAGE RANGING FROM 120VAC THROUGH 277VAC OR MAY REQUIRE A SEPARATE TRANSFORMER.
- 5. TRANSFORMER: ELECTROMAGNETIC OR ELECTRONIC DEVICE THAT STEPS DOWN PRIMARY VOLTAGE TO A LOWER SECONDARY VOLTAGE. GENERALLY SECONDARY **VOLTAGE WILL BE 12V OR 24V.**
- 6. DIMMING: THE REDUCTION OF LIGHT INTENSITY OF A LIGHT SOURCE. ALL SOURCES SHALL HAVE A SMOOTH, FLICKER-FREE AND CONTINUOUS DIMMING CURVE. LED SOURCES MAY BE DIMMED BY EITHER CONSTANT CURRENT REDUCTION (CCR) OR BY PULSE WIDTH MODULATION (PWM) DIMMING FOR CONSTANT CURRENT DRIVERS.

RATED LUMEN MAINTENANCE LIFE: THE ELAPSED OPERATING TIME OVER WHICH AN LED

LIGHT SOURCE WILL MAINTAIN THE PERCENTAGE OF ITS INITIAL LUMEN OUTPUT.

L70: TIME. IN HOURS. TO 70% LUMEN MAINTENANCI

L50: TIME, IN HOURS, TO 50% LUMEN MAINTENANCE

ISSUE REVISIONS 05/16/24 **ADDENDUM 1** 


REVISIONS



BEFORE YOU DIG ANYWHERE IN PENNSYLVANIA! CALL 1-800-242-1776 NON-MEMBERS MUST BE CONTACTED DIRECTLY

PPR PROJECT COORDINATOR

PA ONE-CALL NUMBER (FOR DESIGN ONLY)

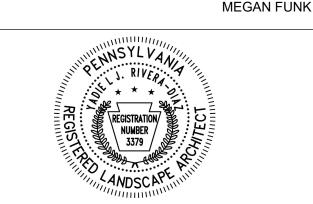

145 Hudson Street, Floor 3 New York, NY 10013

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LIGHTING DESIGN:

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ELLANA CONSTRUCTION CONSULTANTS

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christopher.noel@parks.nyc.gov 646.632.7344 PLAY CONSULTANT:

DRAWING TITLE

1313 S 33rd St, Unit A

Philadelphia, PA 19146

CONSULTANT PROJECT NUMBER

ACCESSIBILITY CONSULTANT

CITY OF PHILADELPHIA PHILADELPHIA PARKS AND RECREATION


1515 ARCH STREET 11TH FLOOR, ONE PARKWAY BUILDING


PPR PROJECT NUMBER 16-21-7062-01 PENNYPACK PARK

> UNIVERSAL PLAYGROUND RHAWN ST. & HOLMEHURST AVE. PHILADELPHIA, PA 19136


GENERAL NOTES

PPR PROJECT NO. 16-21-7062-01 CONSULTANT PROJECT NO 12/15/2023 SCALE: AS NOTED DRAWN BY SS, TW CHECKED BY

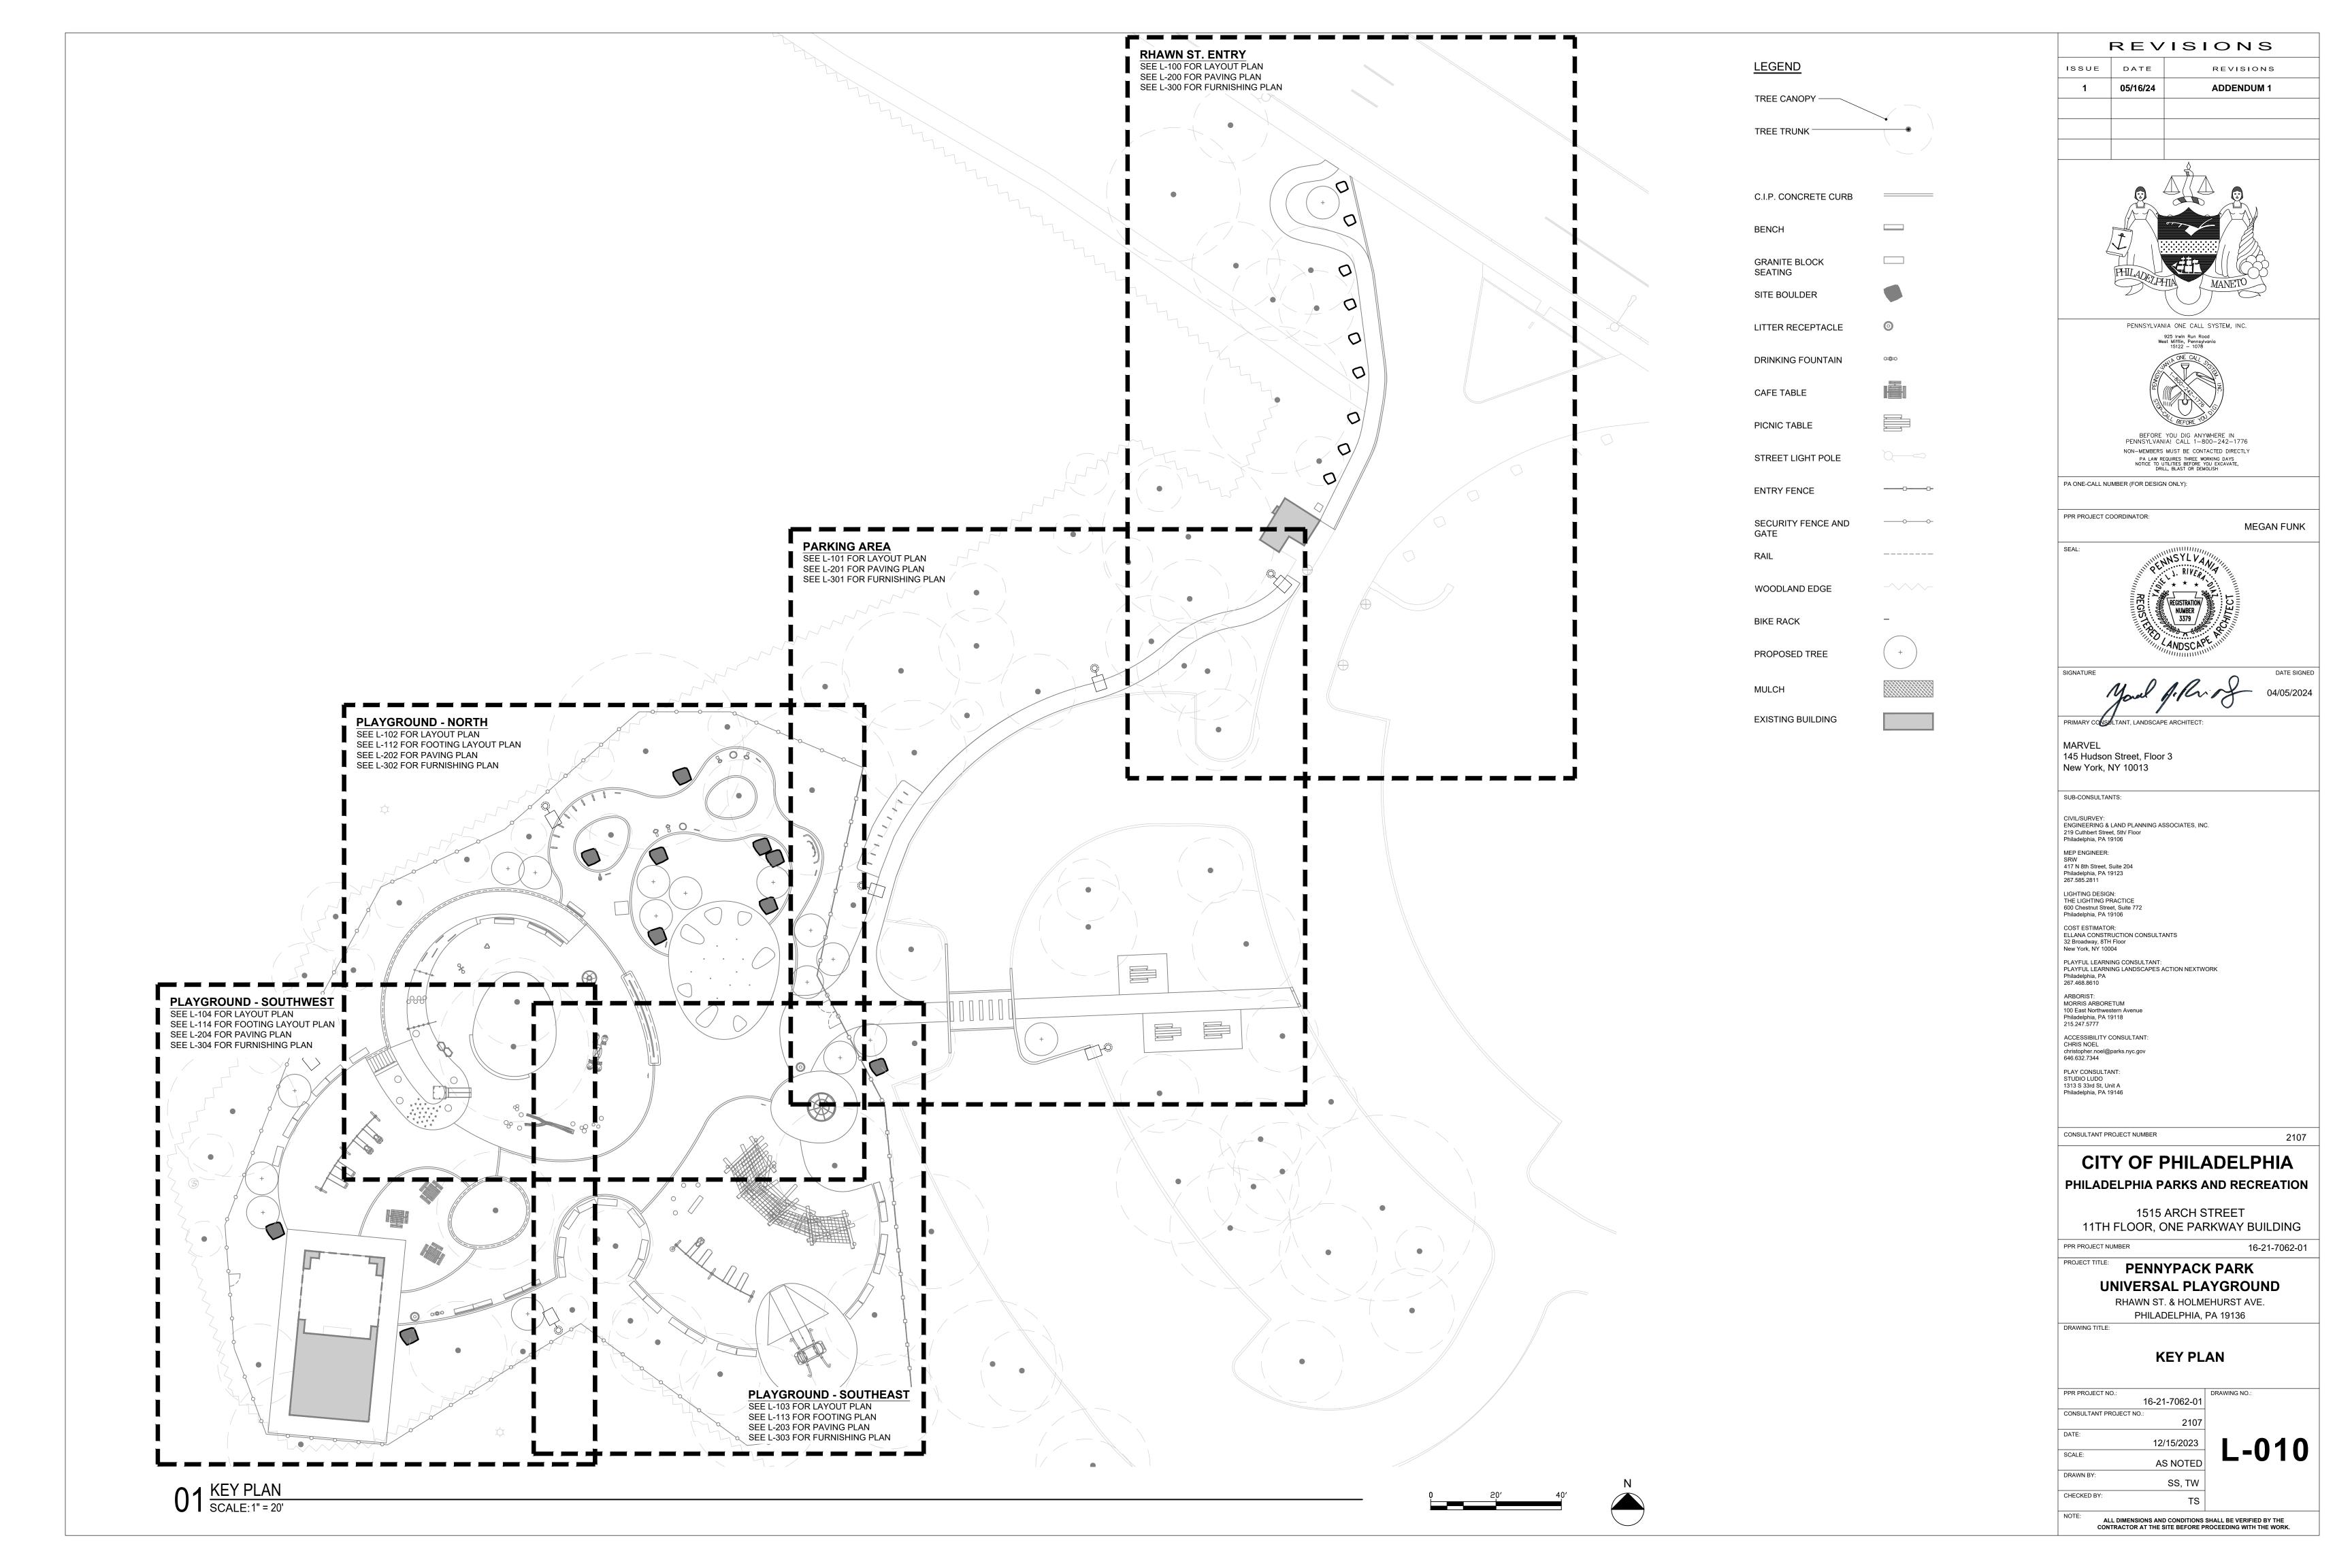

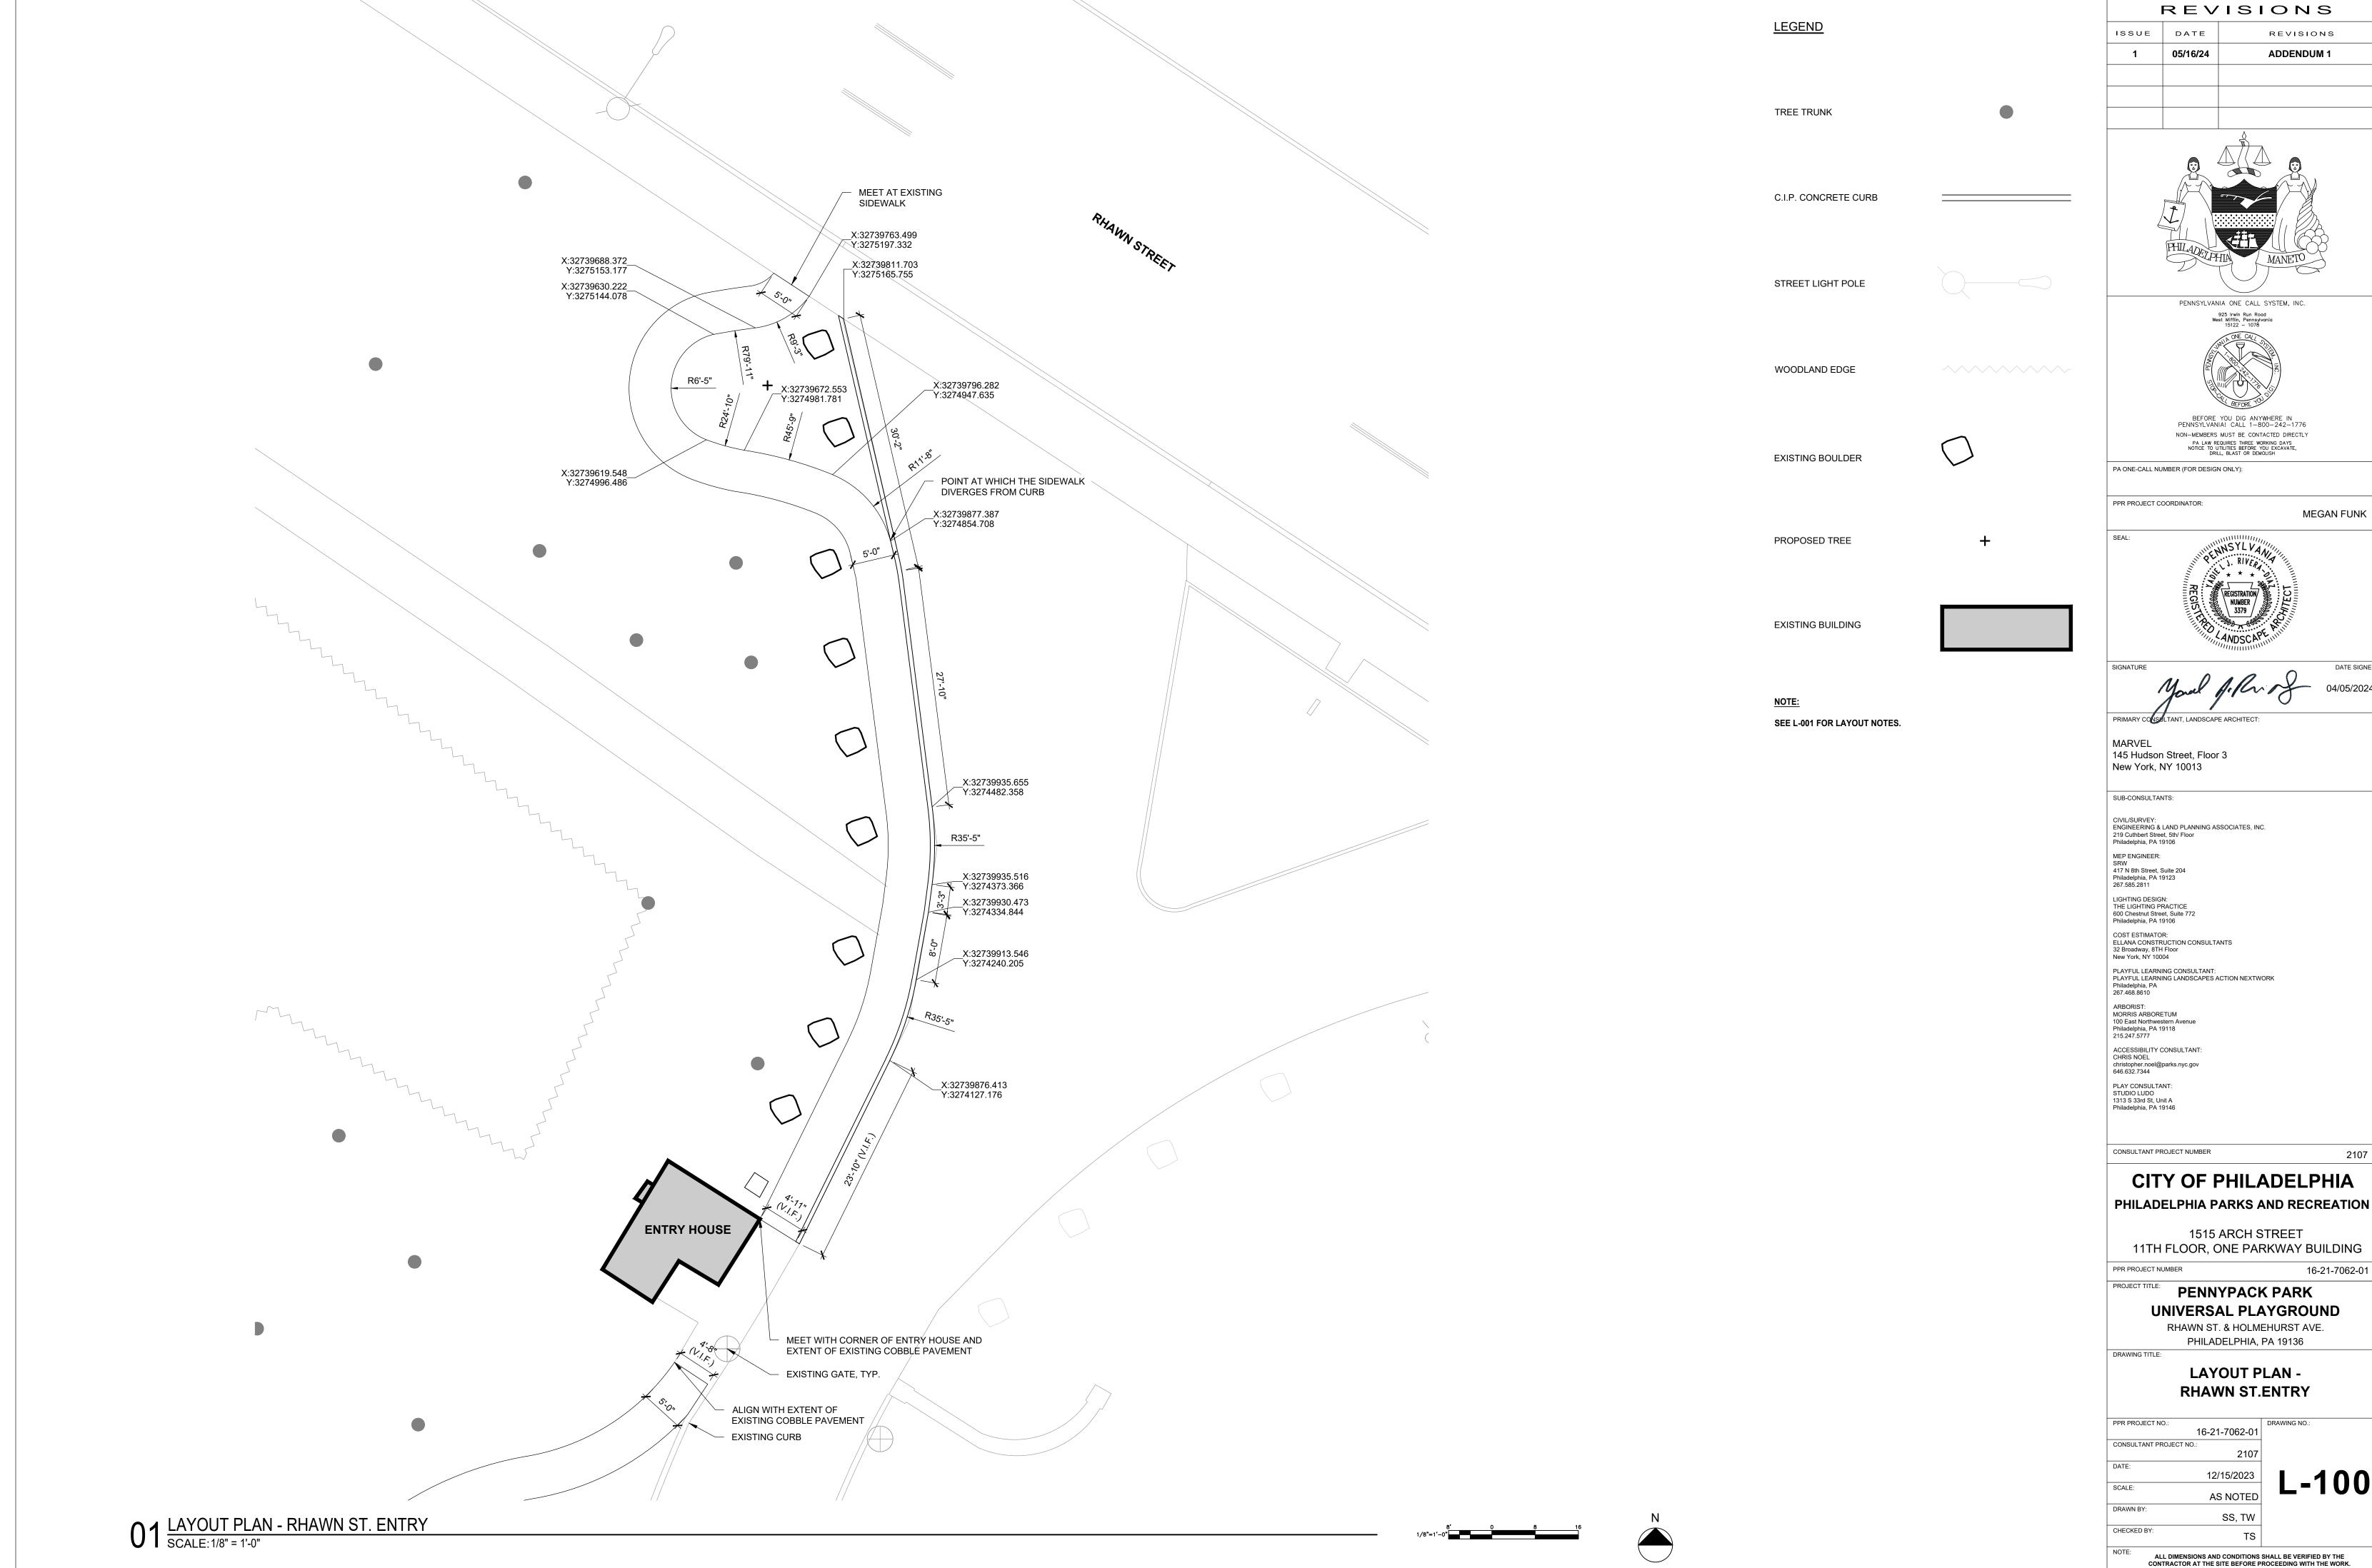




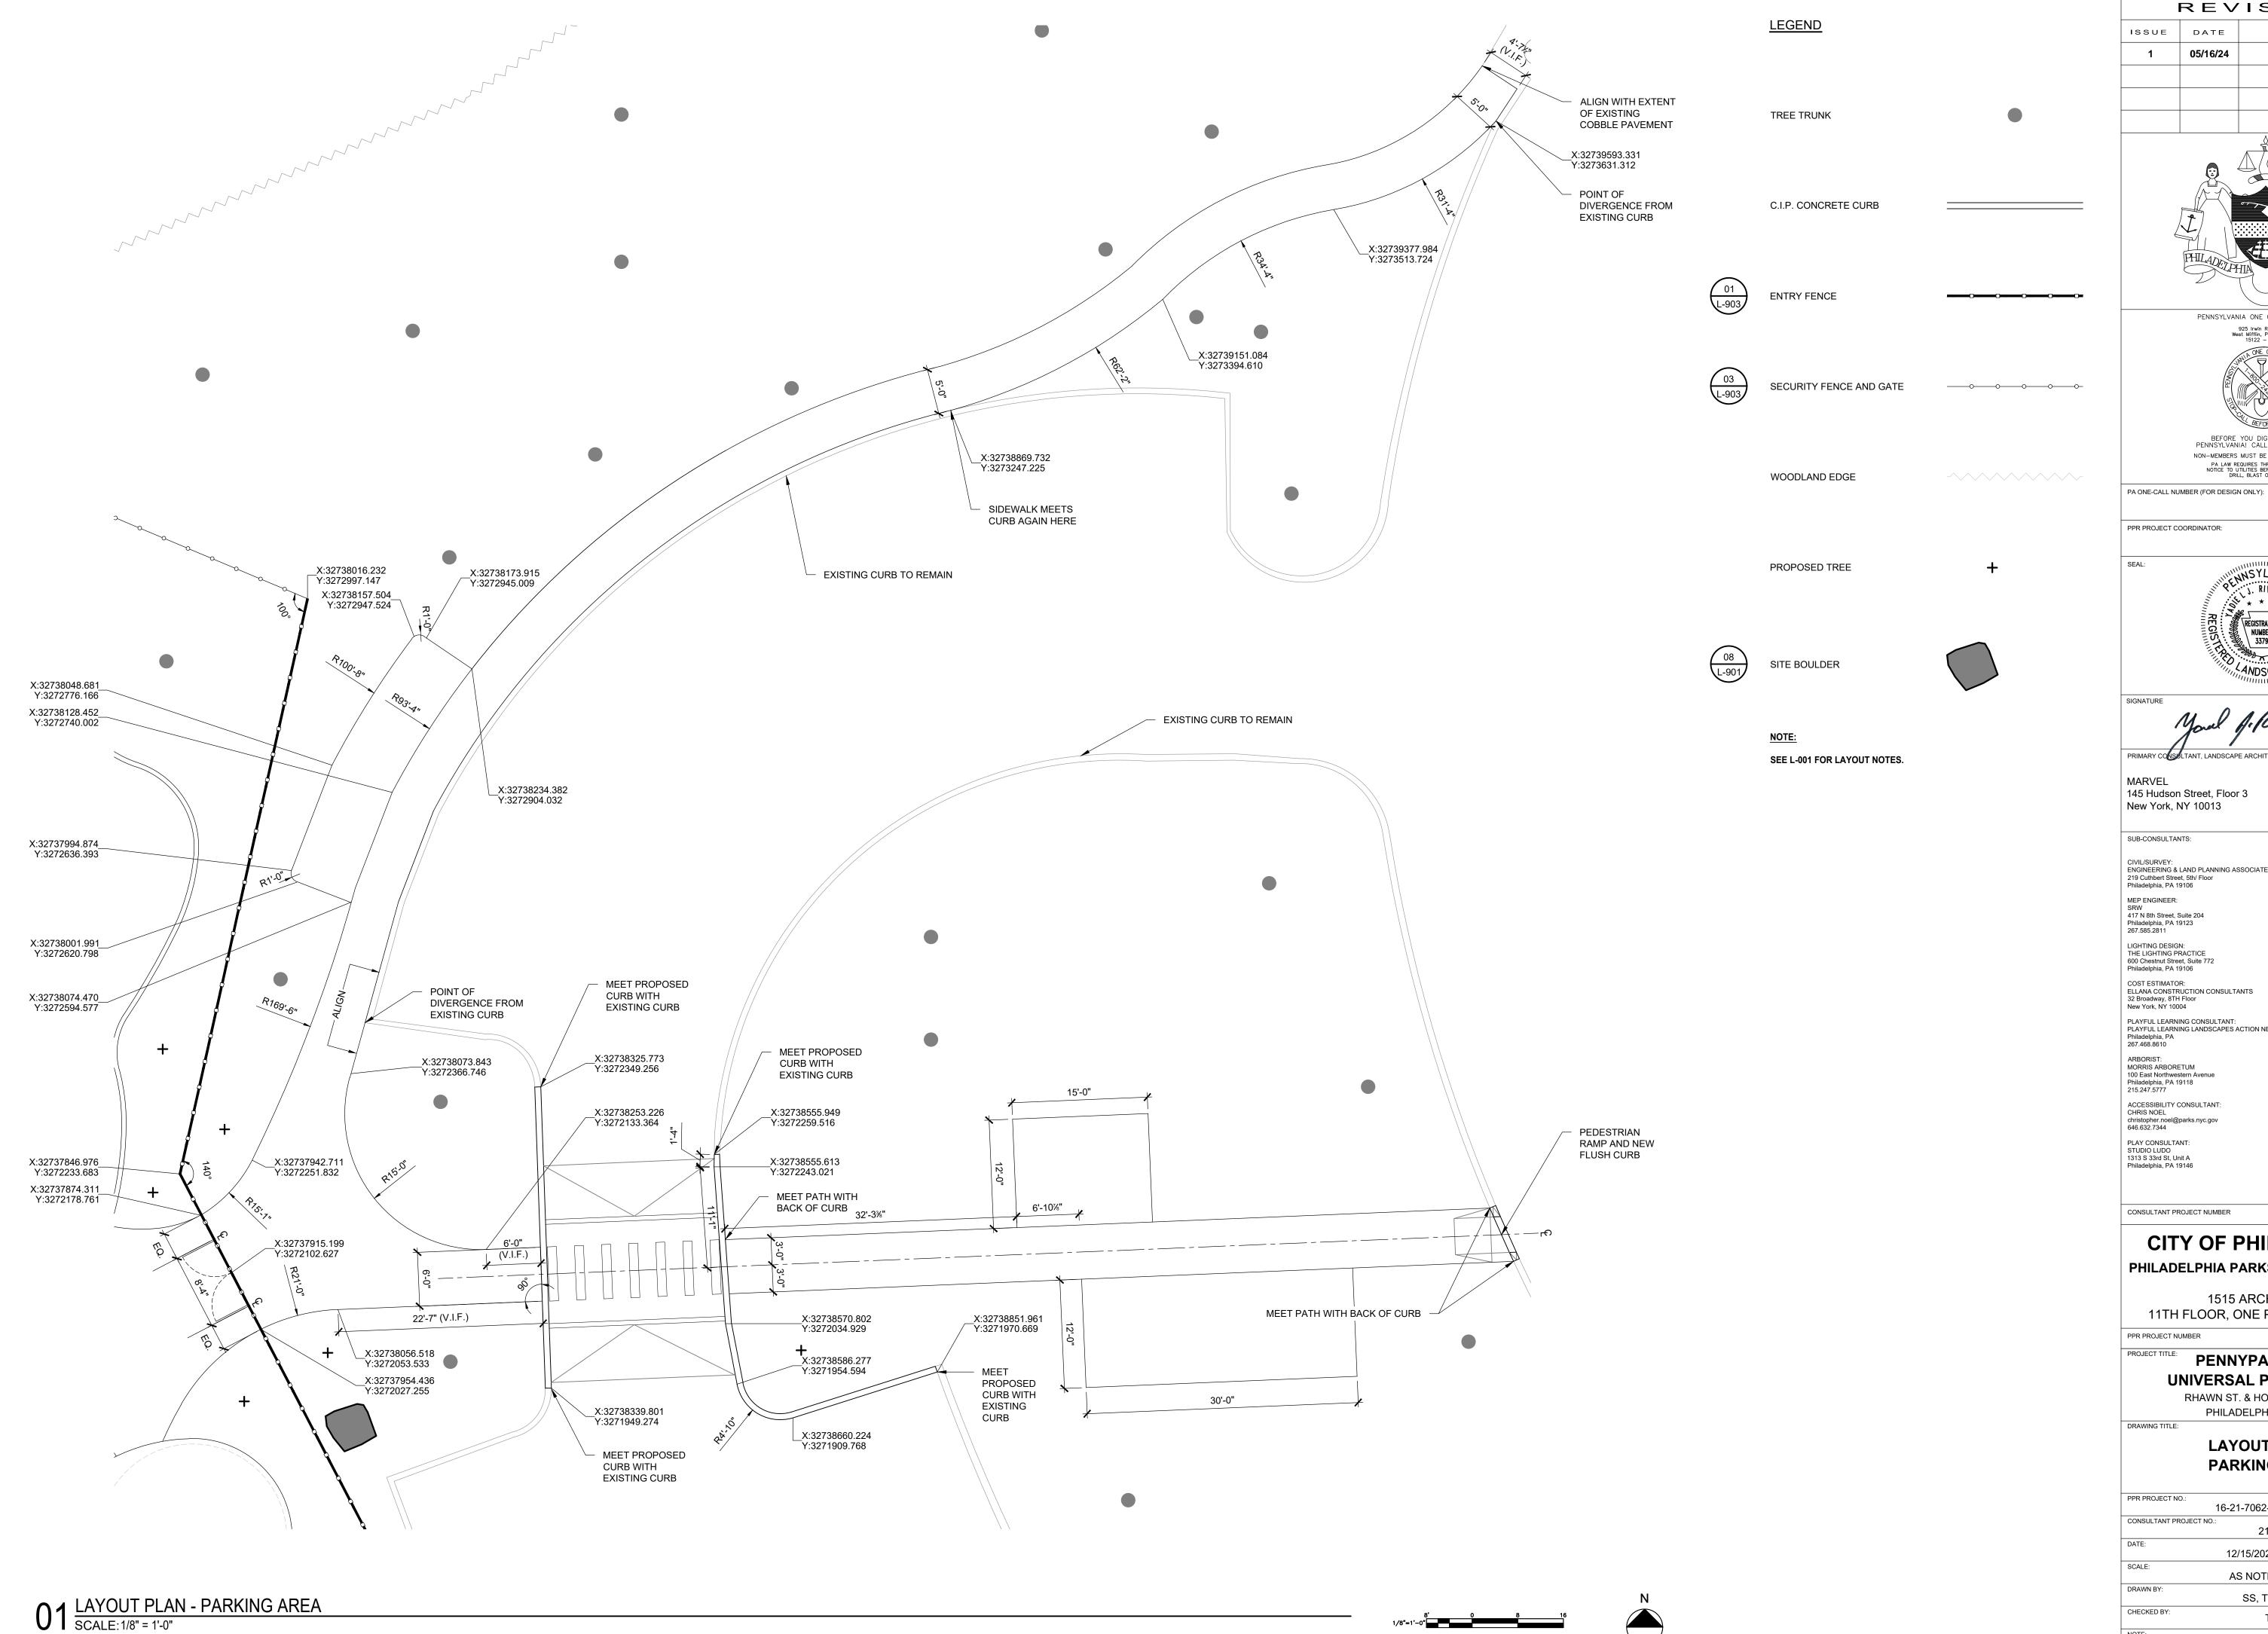


REVISIONS ISSUE DATE REVISIONS 05/16/24 ADDENDUM 1



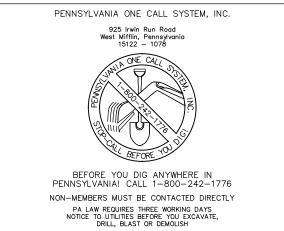

MEGAN FUNK

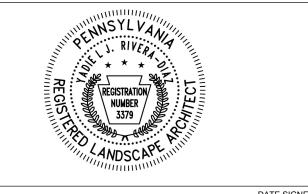

MARVEL 145 Hudson Street, Floor 3 New York, NY 10013

SUB-CONSULTANTS: CIVIL/SURVEY: ENGINEERING & LAND PLANNING ASSOCIATES, INC. 219 Cuthbert Street, 5th/ Floor Philadelphia, PA 19106 MEP ENGINEER:

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CITY OF PHILADELPHIA PHILADELPHIA PARKS AND RECREATION

1515 ARCH STREET 11TH FLOOR, ONE PARKWAY BUILDING


PPR PROJECT NUMBER 16-21-7062-01

PENNYPACK PARK UNIVERSAL PLAYGROUND RHAWN ST. & HOLMEHURST AVE.

PHILADELPHIA, PA 19136

**LAYOUT PLAN -PARKING AREA** 

PPR PROJECT NO.: 16-21-7062-01 CONSULTANT PROJECT NO.: 12/15/2023 AS NOTED DRAWN BY: SS, TW

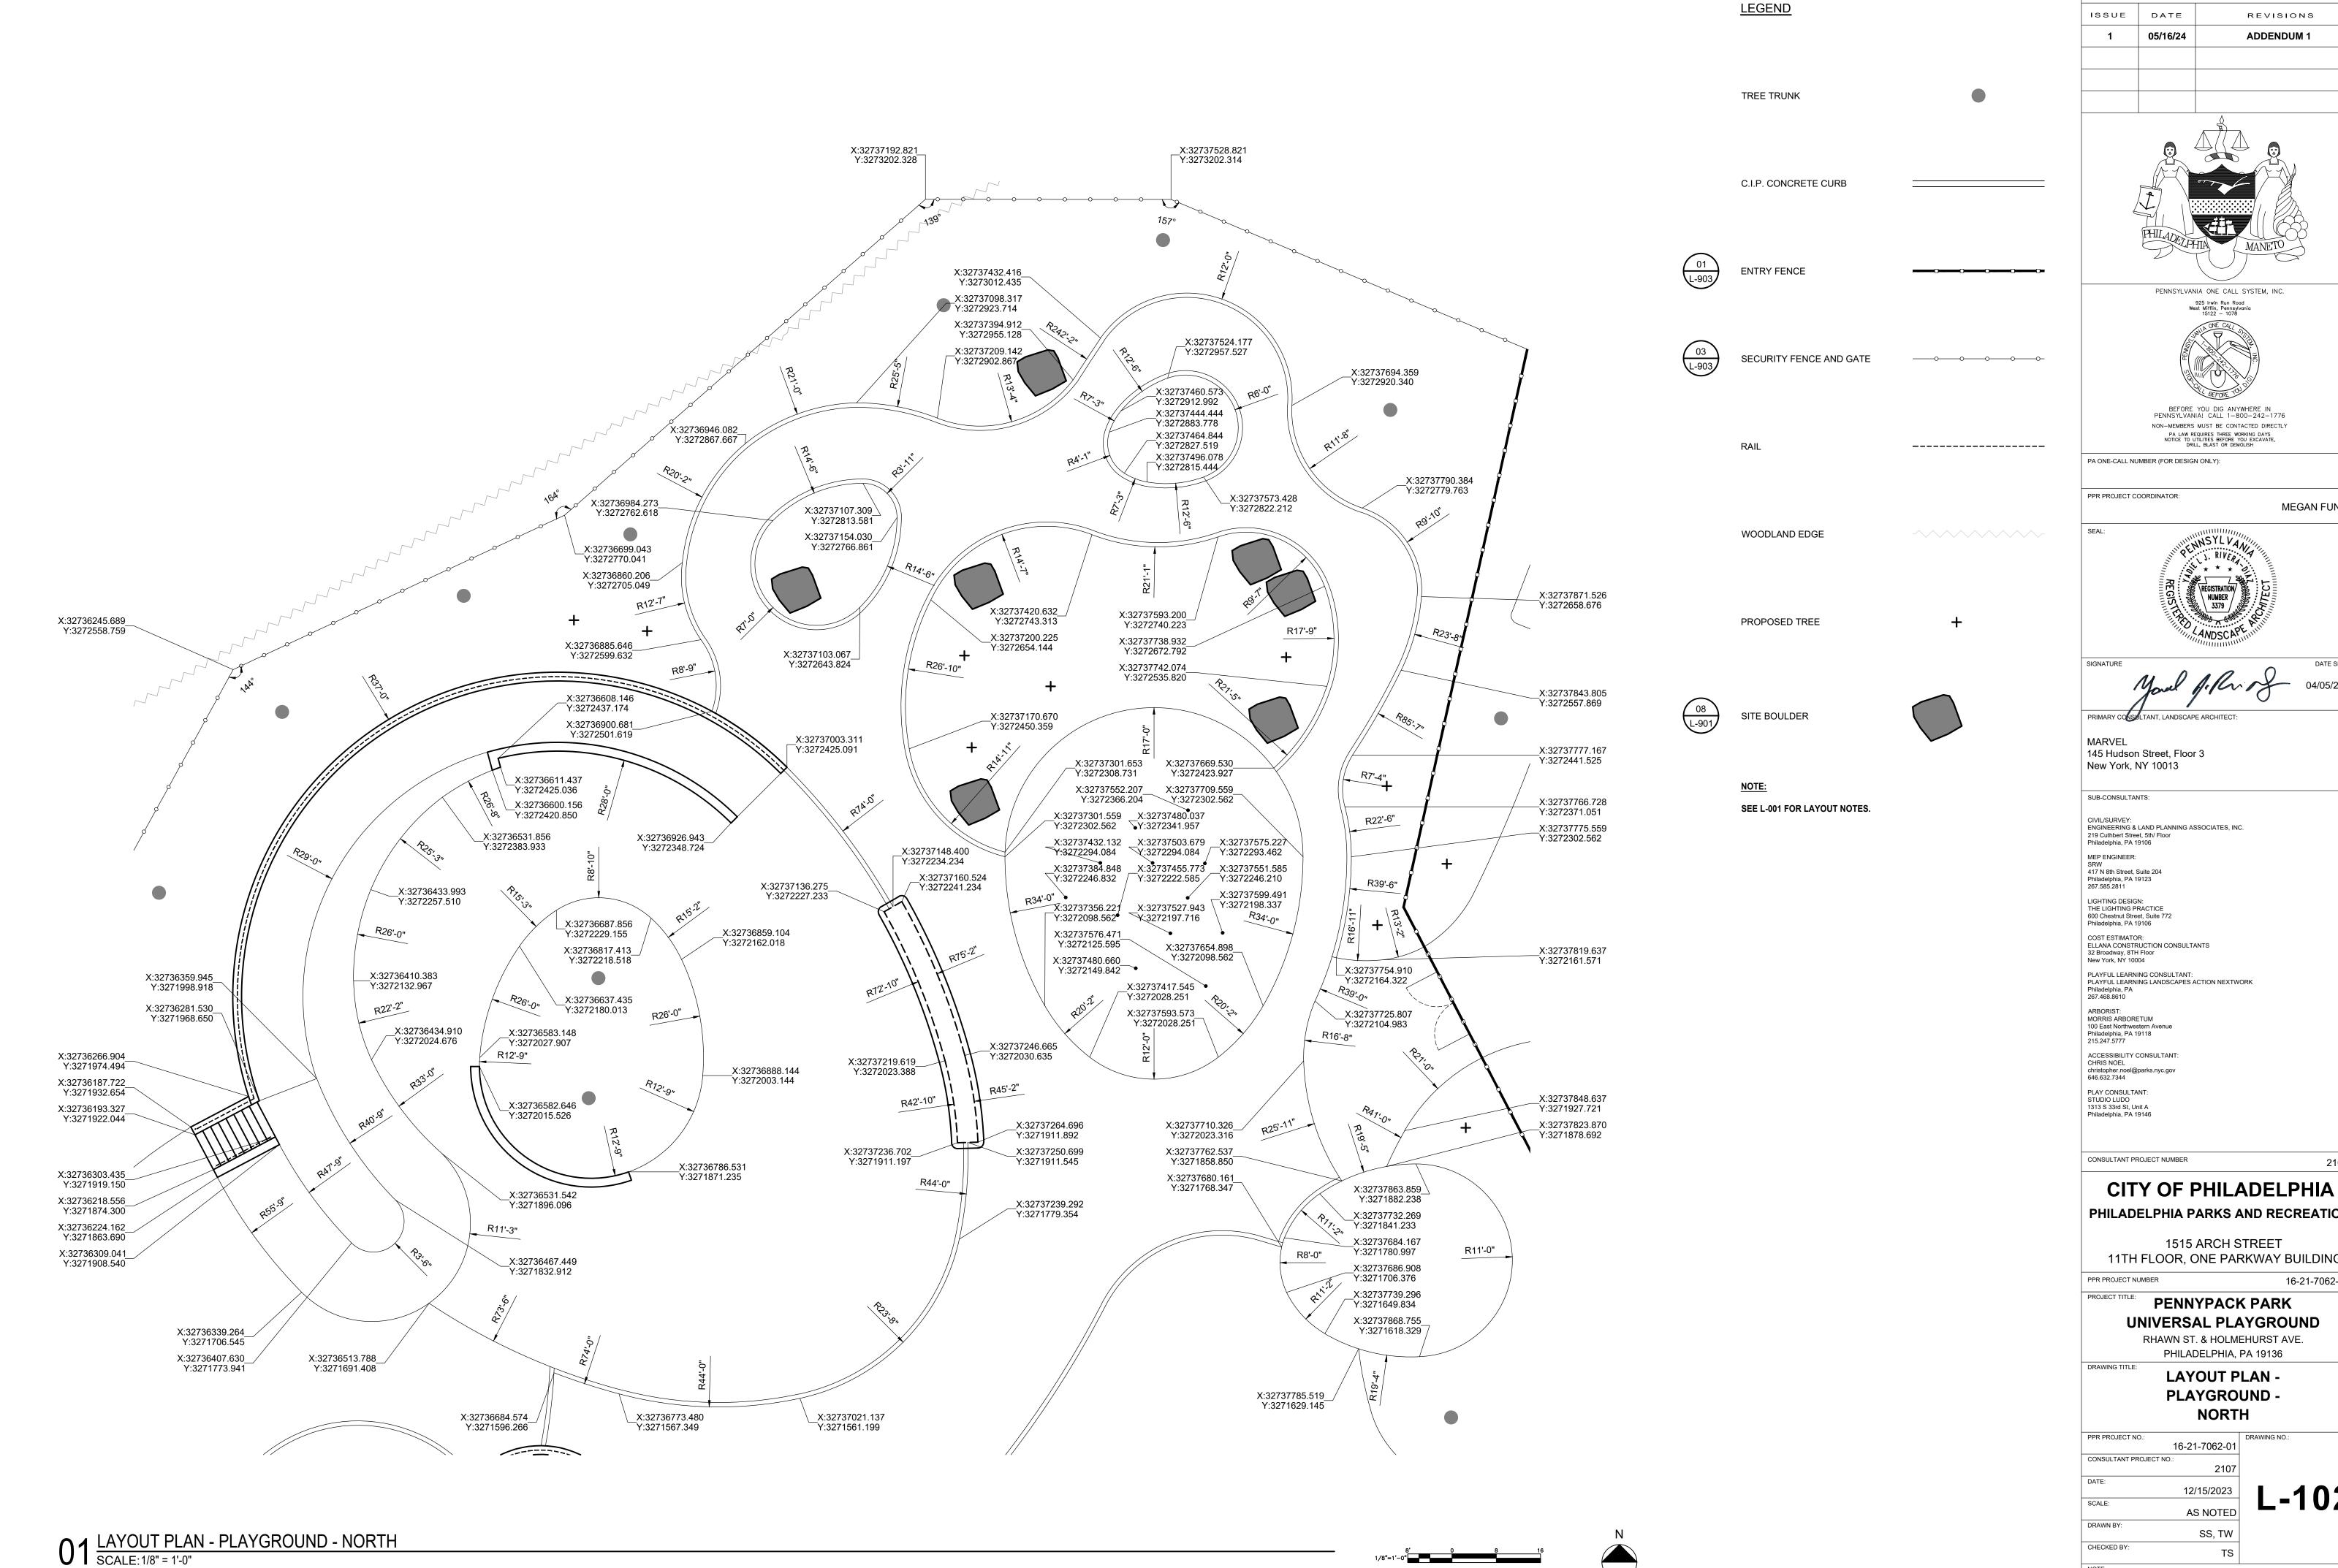


REVISIONS

MEGAN FUNK



# PHILADELPHIA PARKS AND RECREATION

11TH FLOOR, ONE PARKWAY BUILDING 16-21-7062-01

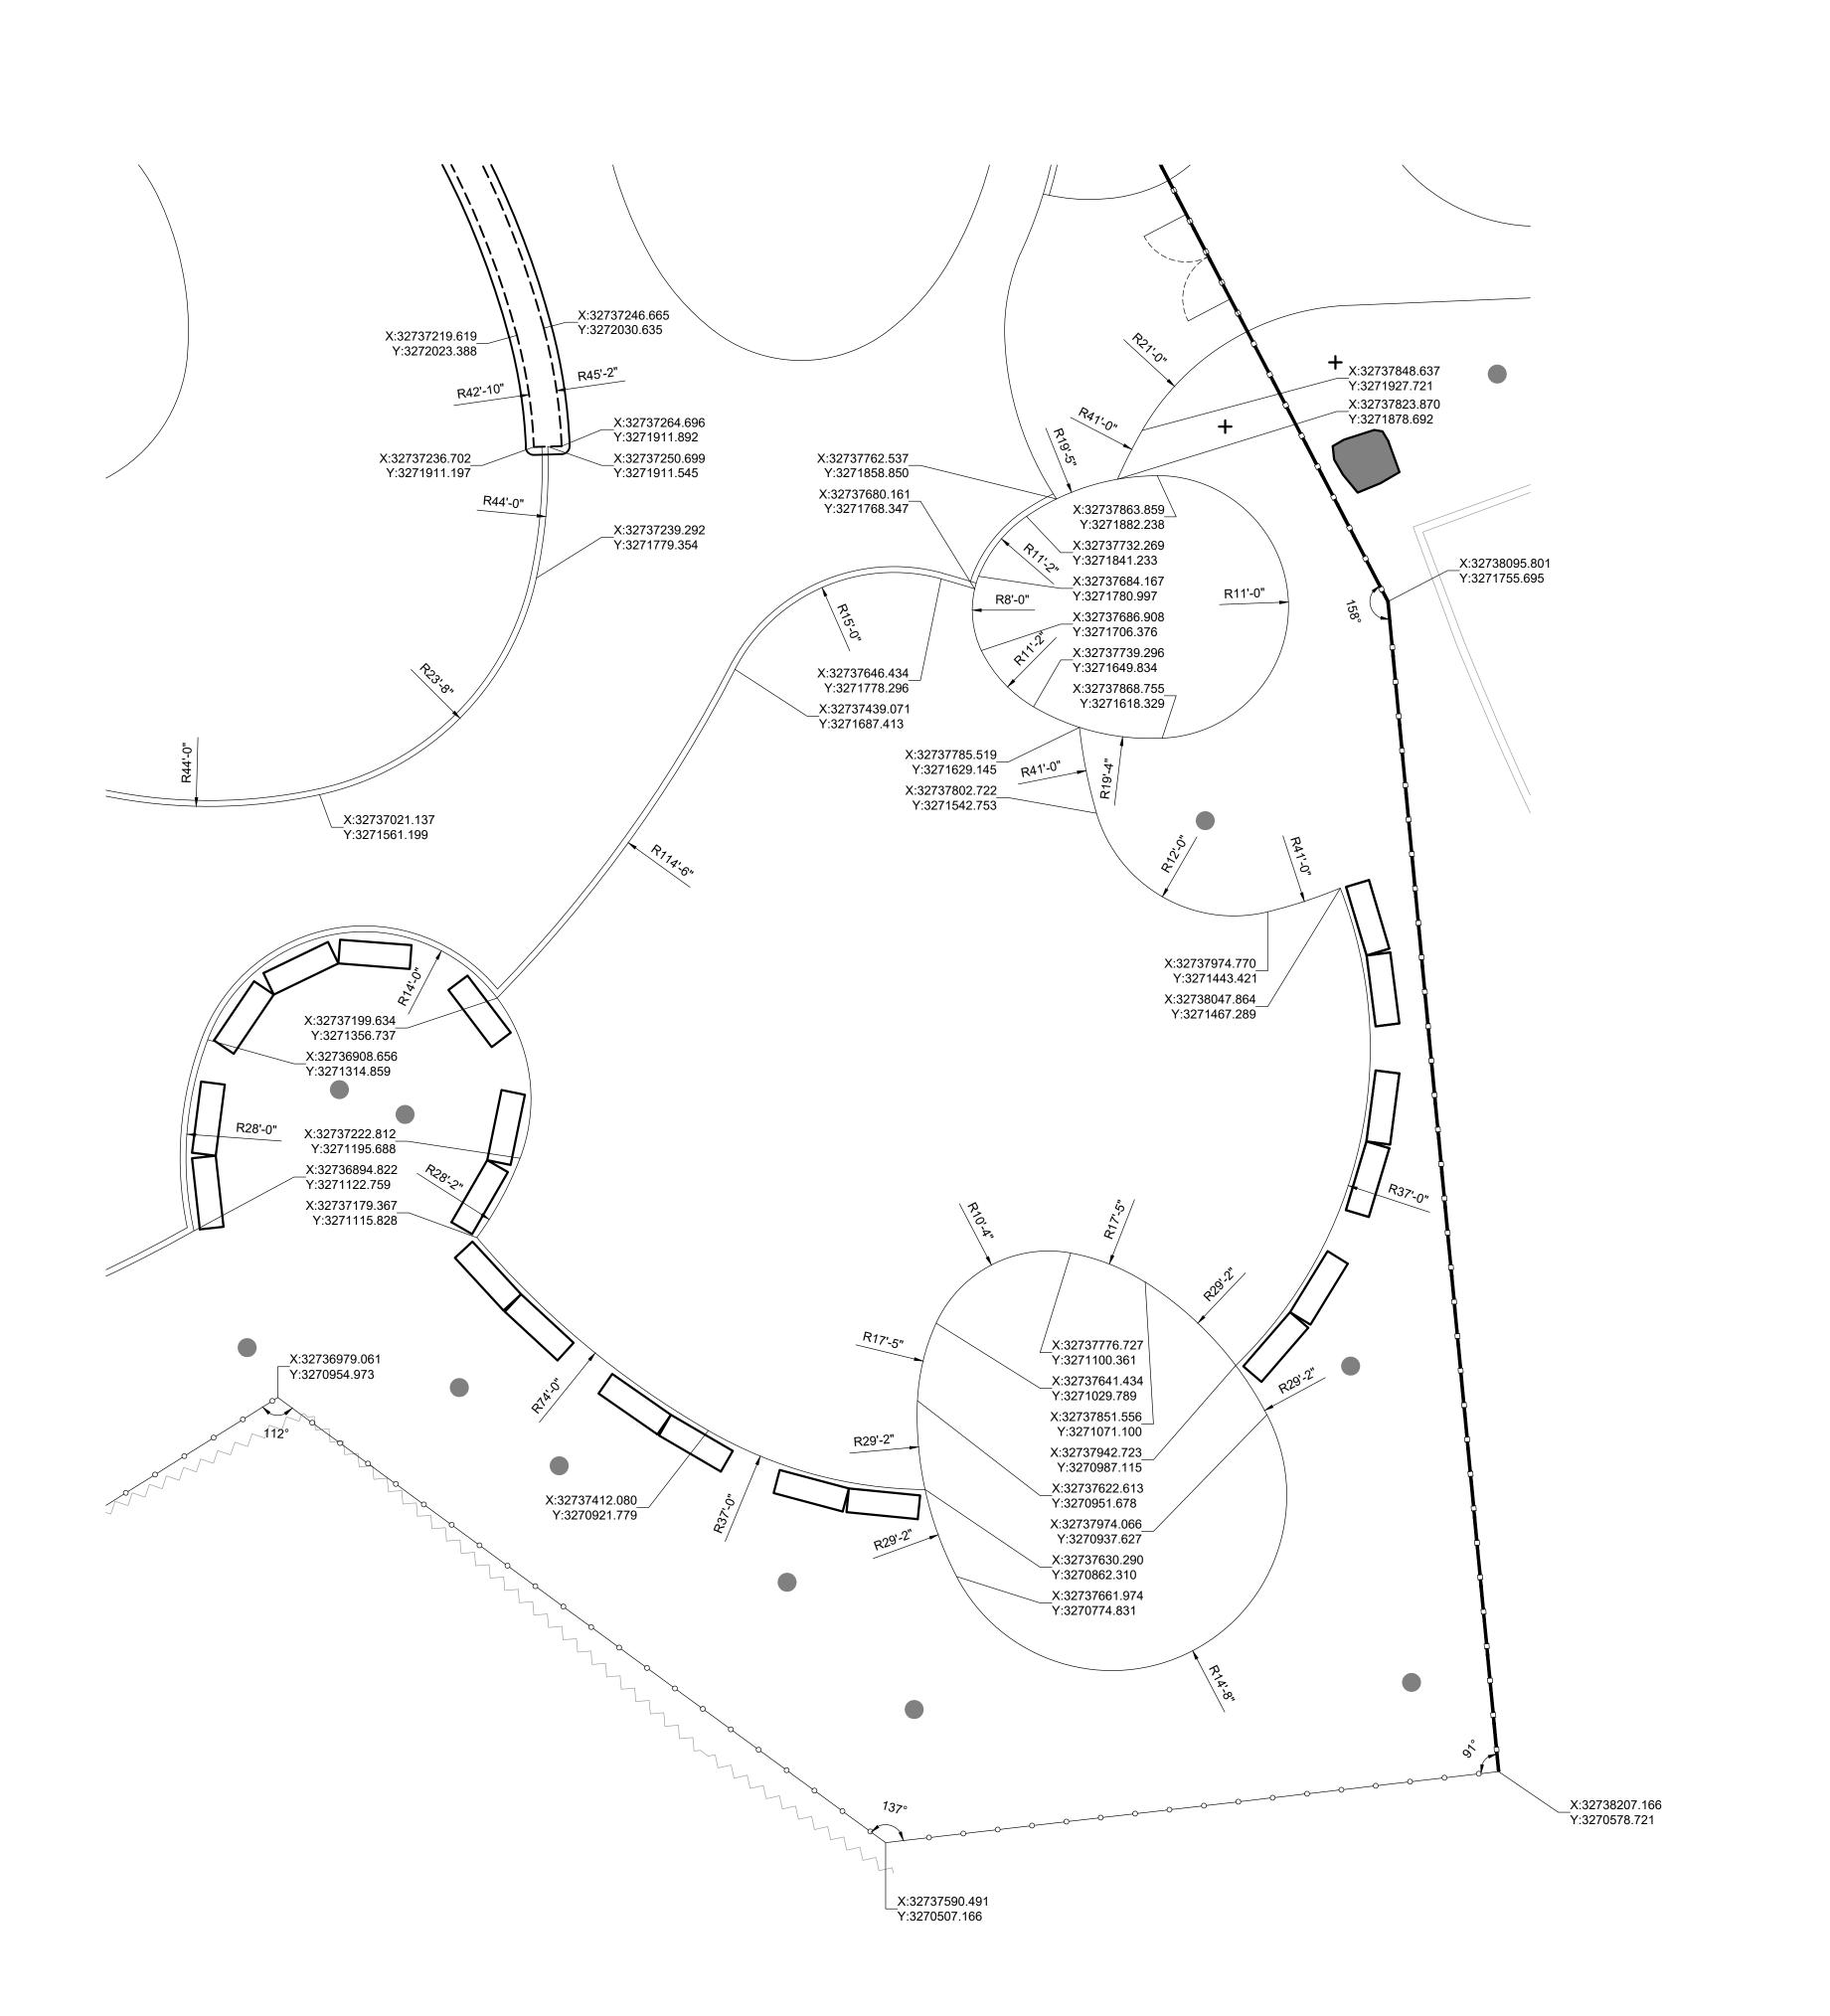

LEGEND Issu

C.I.P. CONCRETE CURB

01 L-903 ENTRY FENCE — 0— 0— 0— 0—

TREE TRUNK

O3 SECURITY FENCE AND GATE — O O O O O O

RAIL -----

WOODLAND EDGE

PROPOSED TREE +

SITE BOULDER


06, 07 L-901 GRANITE BLOCK SEATING


NOTE:
SEE L-001 FOR LAYOUT NOTES.

REVISIONS


ISSUE DATE REVISIONS

1 05/16/24 ADDENDUM 1

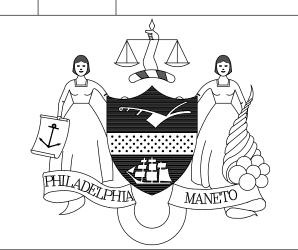

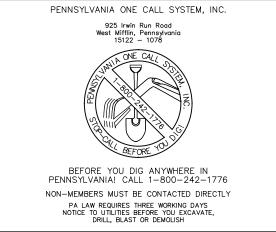

PPR PROJECT COORDINATOR:

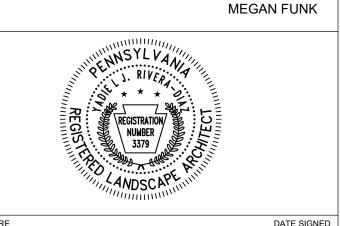

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PA ONE-CALL NUMBER (FOR DESIGN ONLY):

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CONSULTANT PROJECT NUMBER

CITY OF PHILADELPHIA

PHILADELPHIA PARKS AND RECREATION

1515 ARCH STREET
11TH FLOOR, ONE PARKWAY BUILDING

PPR PROJECT NUMBER 16-21-7062-01

PROJECT TITLE: PENNYPACK PARK
UNIVERSAL PLAYGROUND
RHAWN ST. & HOLMEHURST AVE.

PHILADELPHIA, PA 19136

LAYOUT PLAN -

ALL DIMENSIONS AND CONDITIONS SHALL BE VERIFIED BY THE

LAYOUT PLAN -PLAYGROUND -SOUTHEAST

PPR PROJECT NO.:

16-21-7062-01

CONSULTANT PROJECT NO.:

2107

DATE:

12/15/2023

SCALE:

AS NOTED


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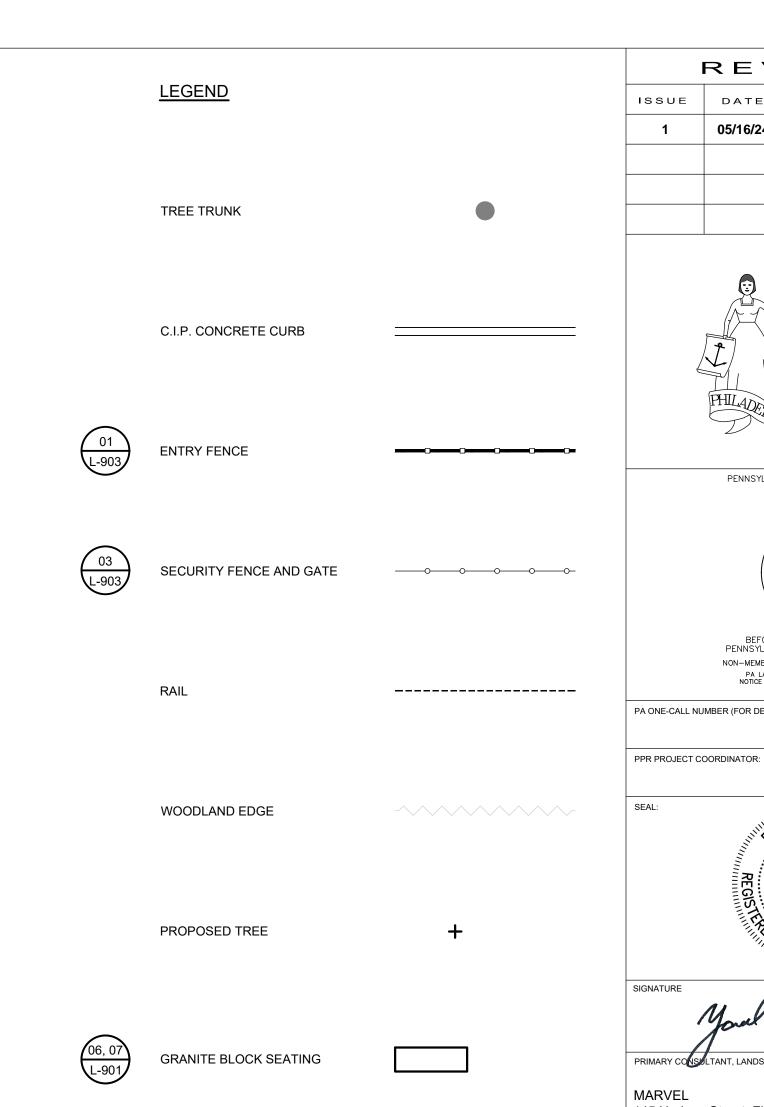
SS, TW


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L-103

1/8"=1'-0"





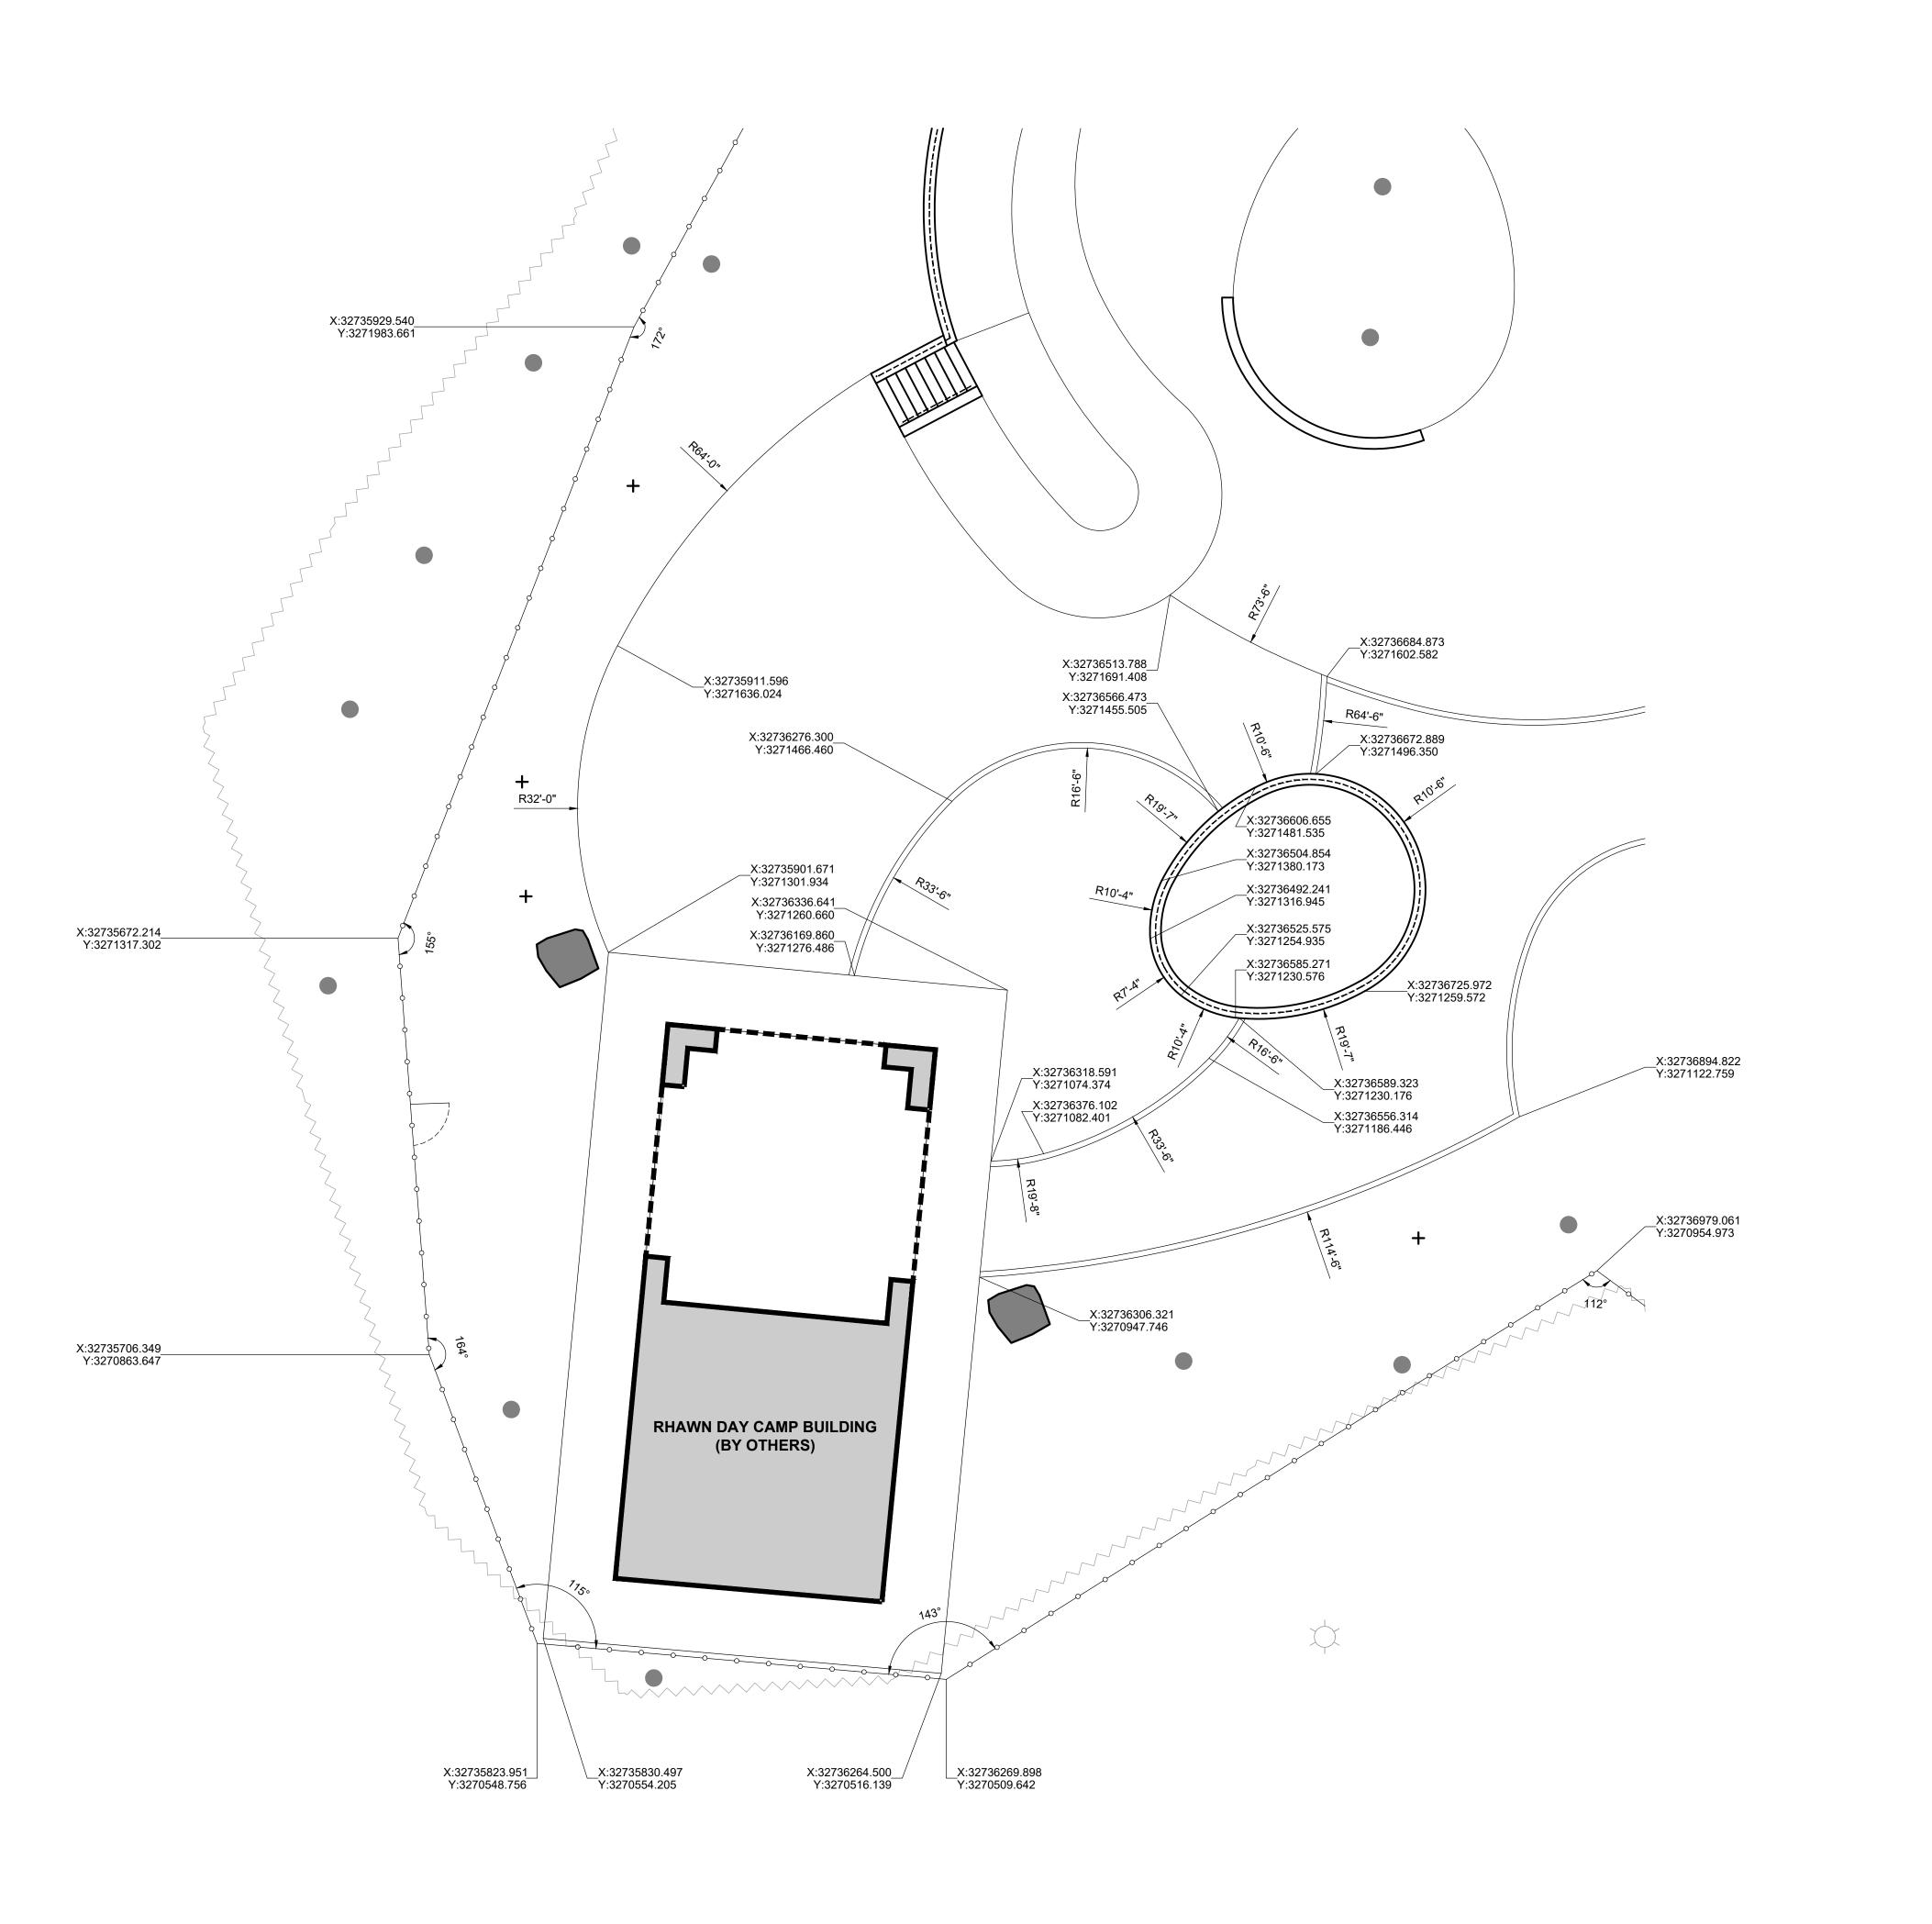

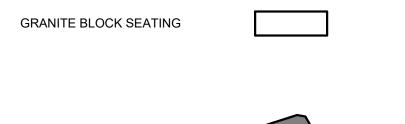08 L-901


SITE BOULDER

SEE L-001 FOR LAYOUT NOTES.



REVISIONS ISSUE DATE REVISIONS 05/16/24 ADDENDUM 1



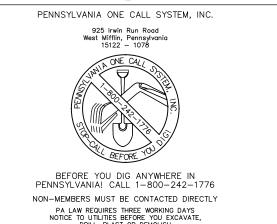

PA ONE-CALL NUMBER (FOR DESIGN ONLY):

MEGAN FUNK

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CHRIS NOEL christopher.noel@parks.nyc.gov 646.632.7344 PLAY CONSULTANT: STUDIO LUDO 1313 S 33rd St, Unit A Philadelphia, PA 19146

CONSULTANT PROJECT NUMBER CITY OF PHILADELPHIA

1515 ARCH STREET 11TH FLOOR, ONE PARKWAY BUILDING

PHILADELPHIA PARKS AND RECREATION

PPR PROJECT NUMBER 16-21-7062-01 PROJECT TITLE:


PENNYPACK PARK UNIVERSAL PLAYGROUND RHAWN ST. & HOLMEHURST AVE.

> PHILADELPHIA, PA 19136 **LAYOUT PLAN -**PLAYGROUND -SOUTHWEST

ALL DIMENSIONS AND CONDITIONS SHALL BE VERIFIED BY THE

PPR PROJECT NO.: 16-21-7062-01 CONSULTANT PROJECT NO.: 12/15/2023 SCALE: AS NOTED DRAWN BY: SS, TW

CHECKED BY:

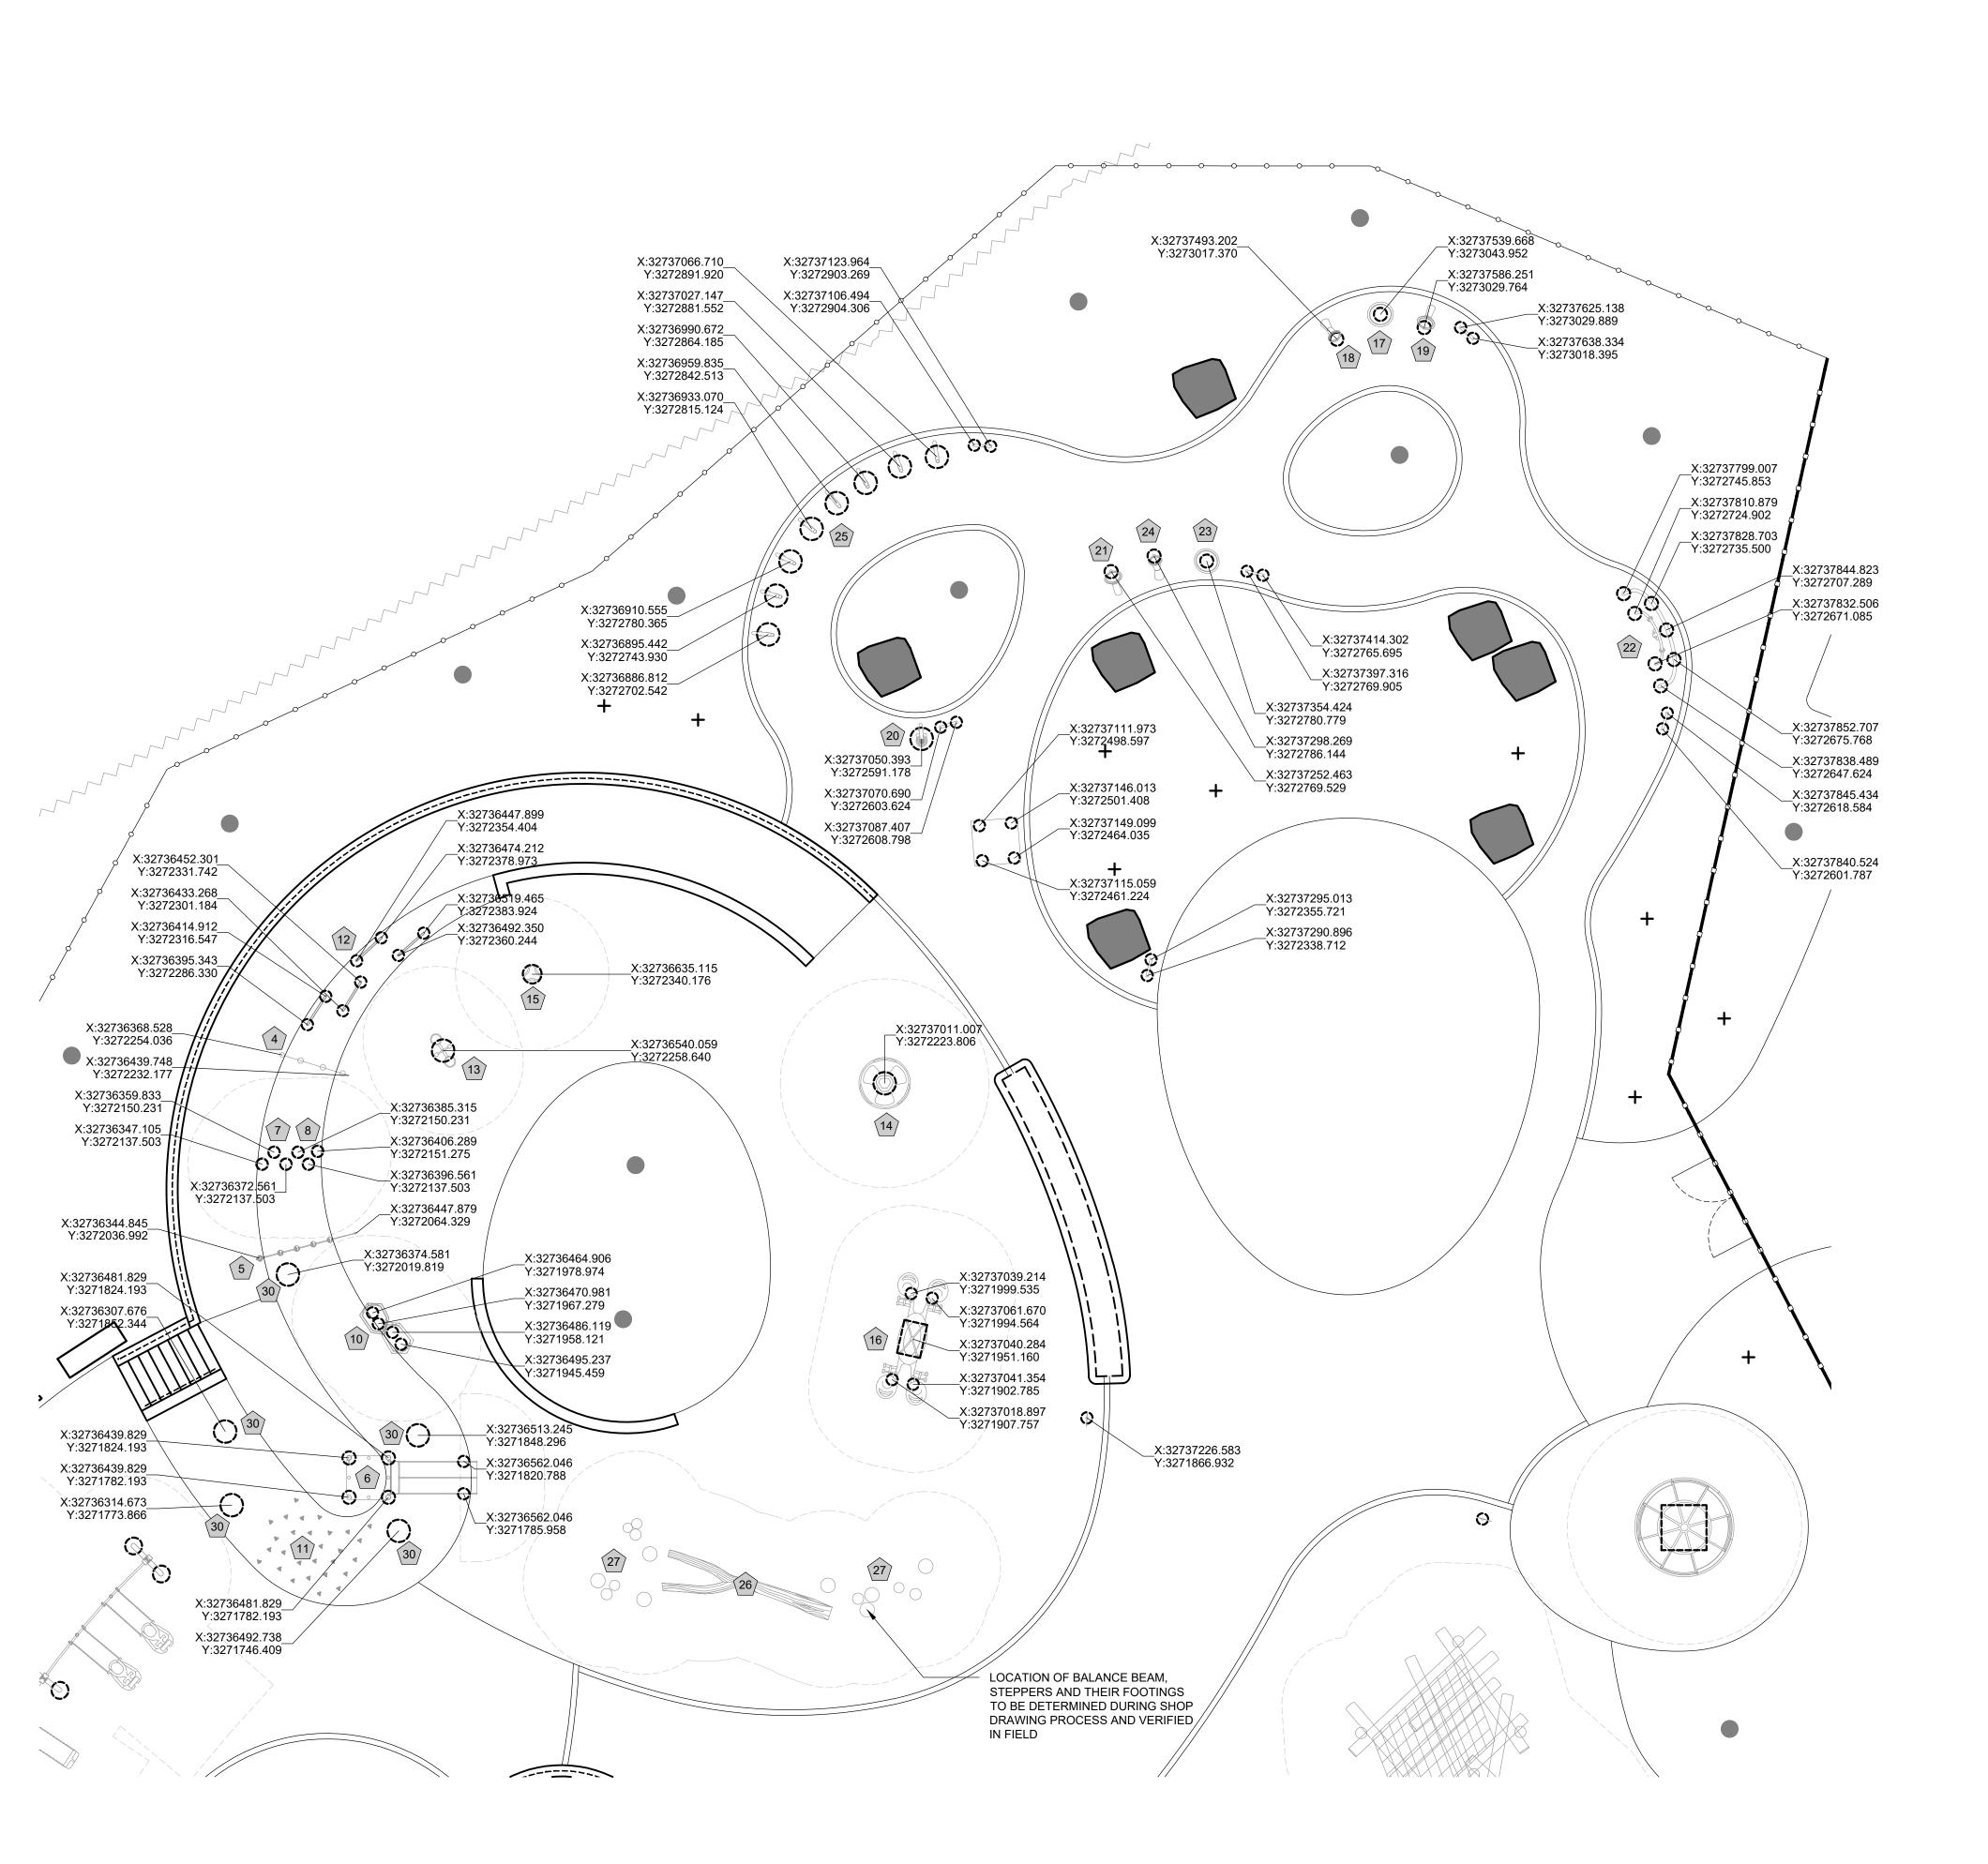

<u>LEGEND</u>

TREE TRUNK

C.I.P. CONCRETE CURB

01 L-903

SECURITY FENCE AND GATE

RAIL

\_\_\_\_\_\_

WOODLAND EDGE

PROPOSED TREE

SITE BOULDER


FOOTING

FALL ZONE


- 1. SEE L-001 FOR LAYOUT NOTES.
- 2. COORDINATES SHOWN ARE LOCATING CENTER POINTS OF EACH FOOTING. REFER TO MANUFACTURER INSTALLATION SPECIFICATIONS FOR FOOTING DIMENSIONS.
- 3. SEE L-120 FOR PLAY EQUIPMENT SCHEDULE.

REVISIONS ISSUE DATE REVISIONS 05/16/24 **ADDENDUM 1** 



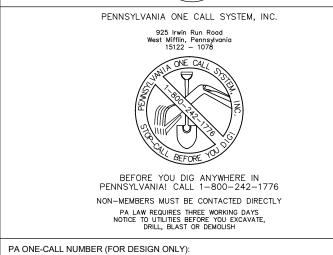

PPR PROJECT COORDINATOR:

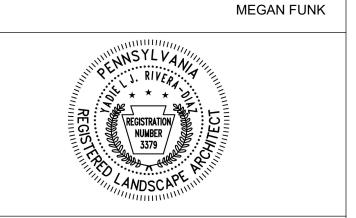

MARVEL 145 Hudson Street, Floor 3 New York, NY 10013

SUB-CONSULTANTS: CIVIL/SURVEY ENGINEERING & LAND PLANNING ASSOCIATES, INC. 219 Cuthbert Street, 5th/ Floor Philadelphia, PA 19106 MEP ENGINEER: 417 N 8th Street, Suite 204

Philadelphia, PA 19123 267.585.2811 LIGHTING DESIGN: THE LIGHTING PRACTICE 600 Chestnut Street, Suite 772 Philadelphia, PA 19106

COST ESTIMATOR: ELLANA CONSTRUCTION CONSULTANTS 32 Broadway, 8TH Floor New York, NY 10004 PLAYFUL LEARNING CONSULTANT: Philadelphia, PA

MORRIS ARBORETUM 100 East Northwestern Avenue Philadelphia, PA 19118 215.247.5777

CHRIS NOEL christopher.noel@parks.nyc.gov 646.632.7344 PLAY CONSULTANT: STUDIO LUDO 1313 S 33rd St, Unit A Philadelphia, PA 19146

ACCESSIBILITY CONSULTANT:

CONSULTANT PROJECT NUMBER

### CITY OF PHILADELPHIA PHILADELPHIA PARKS AND RECREATION

1515 ARCH STREET 11TH FLOOR, ONE PARKWAY BUILDING 16-21-7062-01

PPR PROJECT NUMBER

DRAWING TITLE:


PENNYPACK PARK UNIVERSAL PLAYGROUND RHAWN ST. & HOLMEHURST AVE.

PHILADELPHIA, PA 19136

ALL DIMENSIONS AND CONDITIONS SHALL BE VERIFIED BY THE

### **FOOTING LAYOUT** PLAN - NORTH

PPR PROJECT NO.: 16-21-7062-01 CONSULTANT PROJECT NO .: 12/15/2023 SCALE: AS NOTED DRAWN BY: SS, TW CHECKED BY

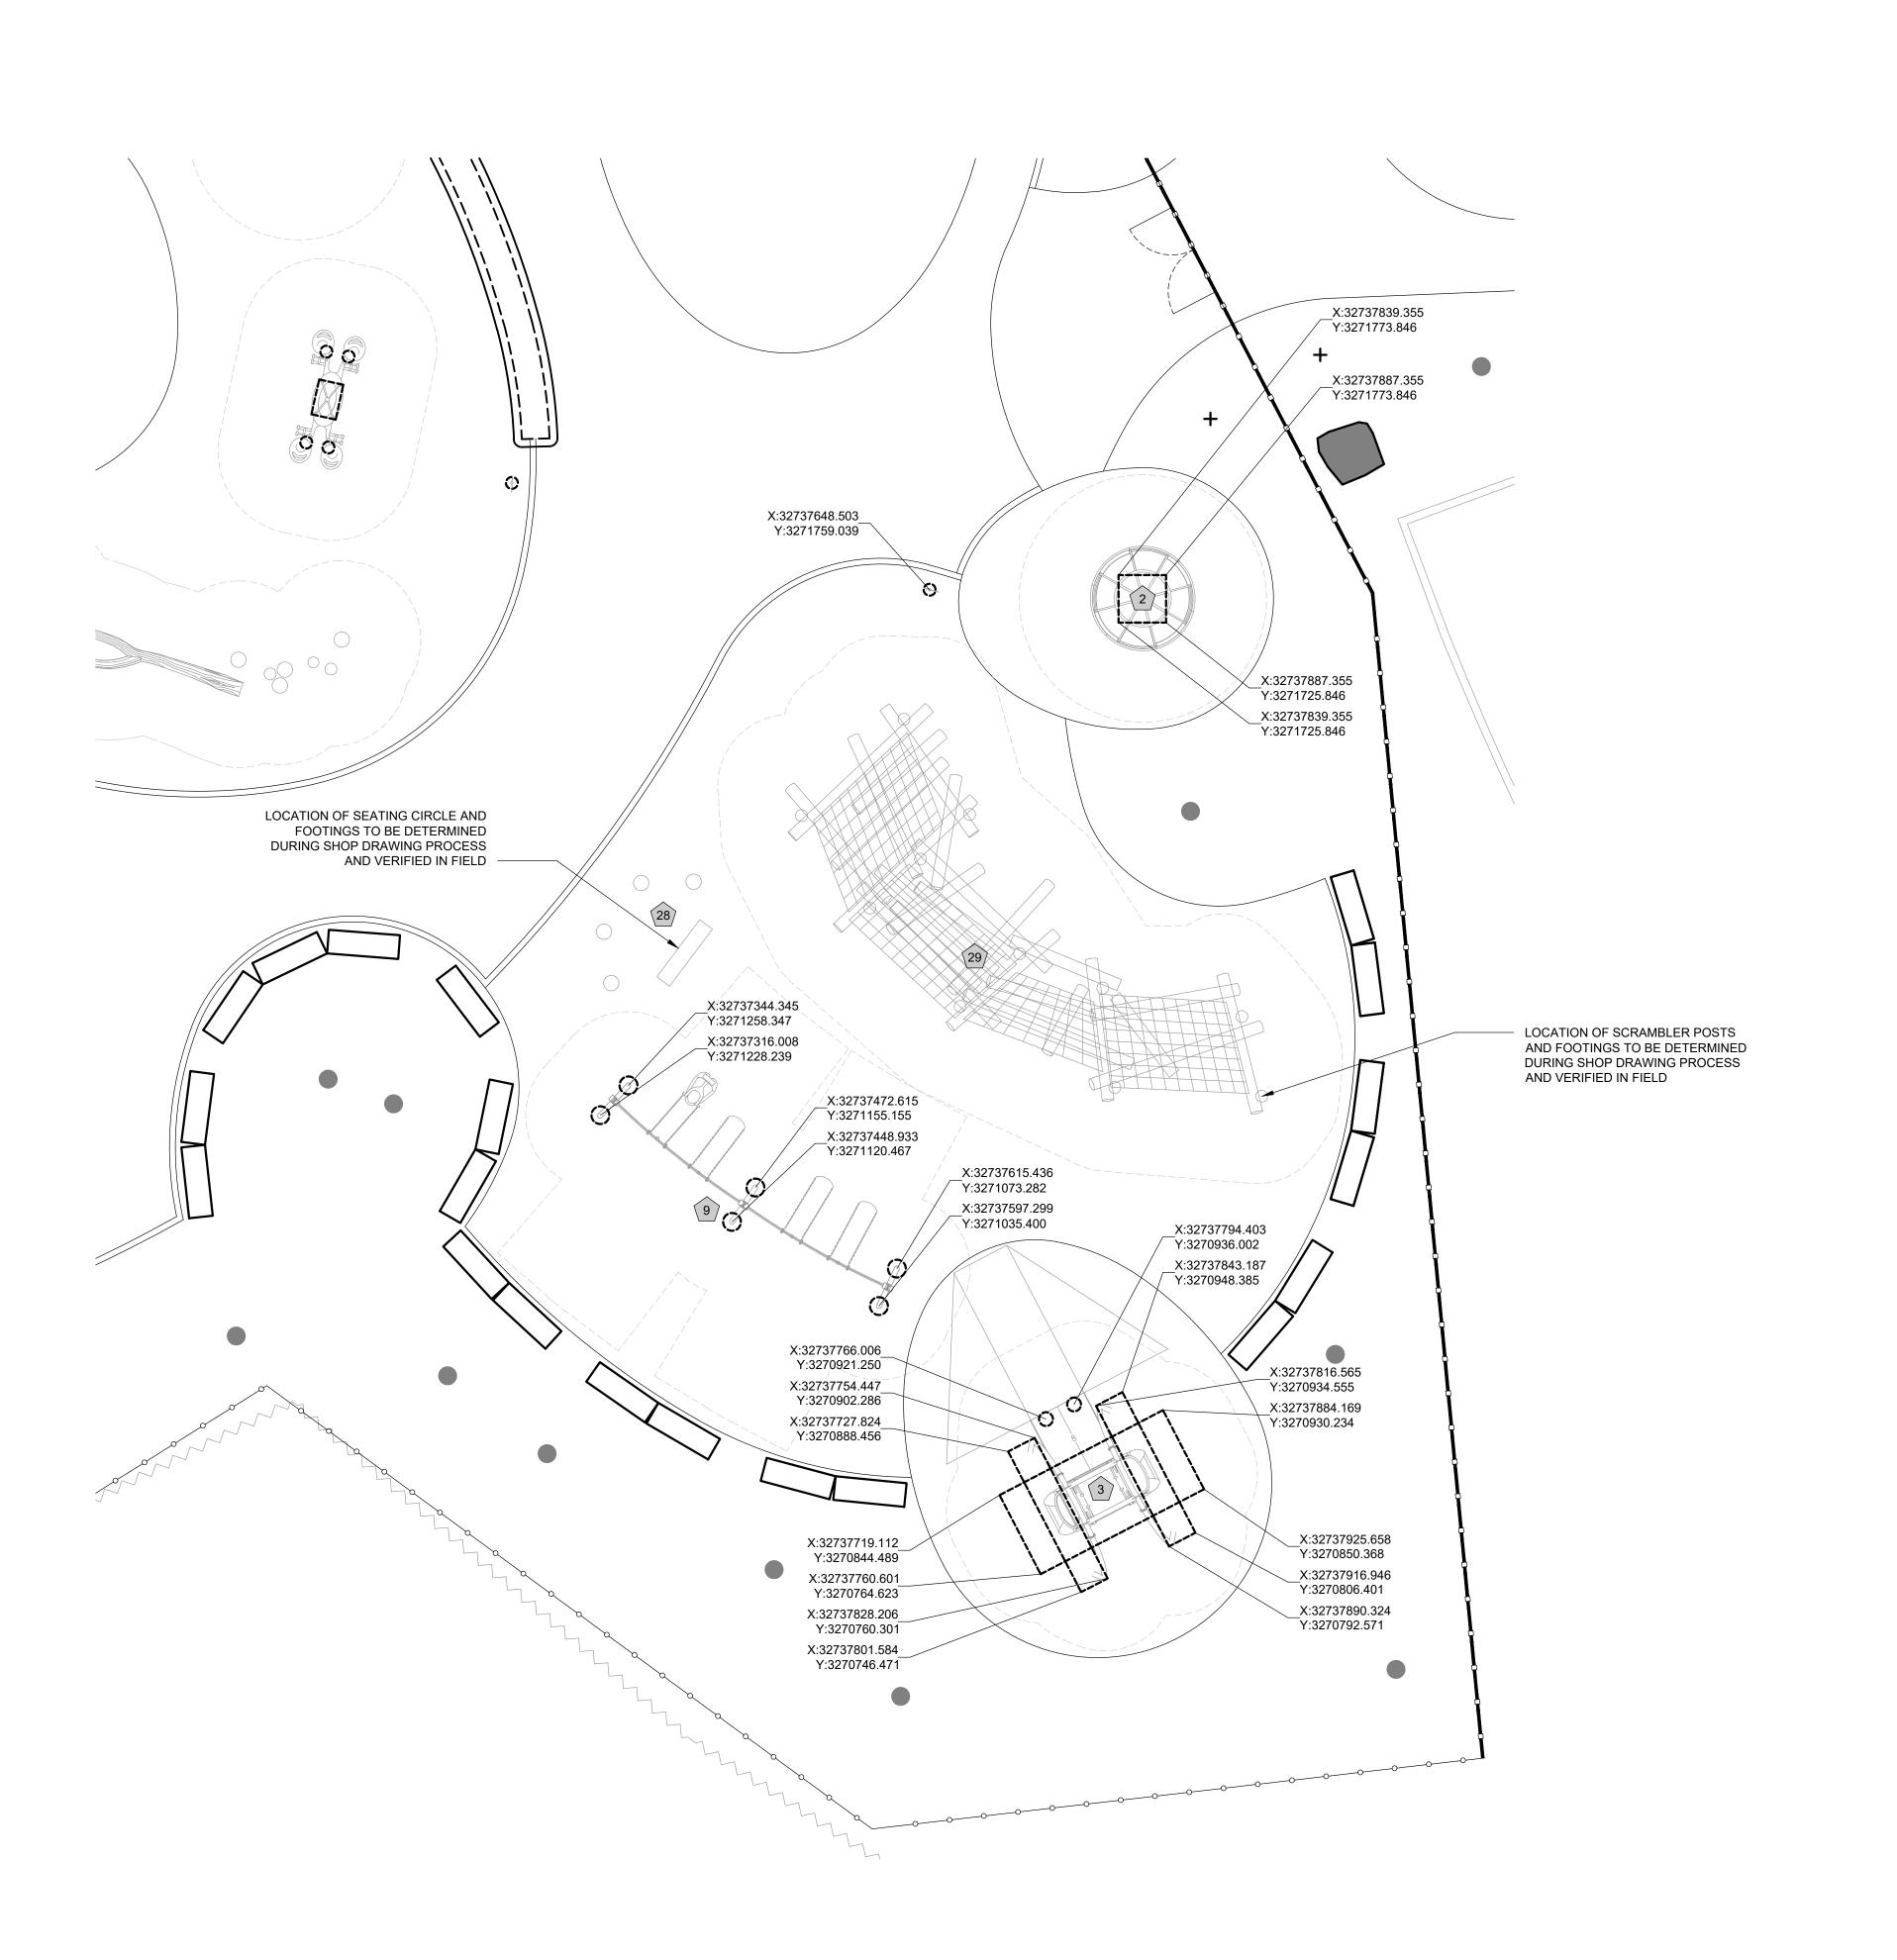

<u>LEGEND</u> TREE TRUNK C.I.P. CONCRETE CURB SECURITY FENCE AND GATE \_\_\_\_\_ WOODLAND EDGE PROPOSED TREE GRANITE BLOCK SEATING FALL ZONE

### NOTES:


- 1. SEE L-001 FOR LAYOUT NOTES.
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- 3. SEE L-120 FOR PLAY EQUIPMENT SCHEDULE.

REVISIONS

ISSUE DATE REVISIONS

1 05/16/24 ADDENDUM 1



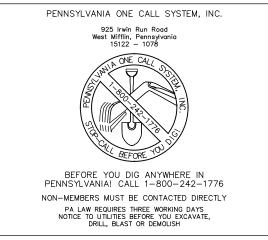

PA ONE-CALL NUMBER (FOR DESIGN ONLY):

PPR PROJECT COORDINATOR:

MEGAN FUNK

NEGAN FUNK

RIVER

REGISTRATION

GNATURE DAT

Morel follows:

O4/05

MARVEL 145 Hudson Street, Floor 3 New York, NY 10013

SUB-CONSULTANTS:

CIVIL/SURVEY:
ENGINEERING & LAND PLANNING ASSOCIATES, INC.

219 Cuthbert Street, 5th/ Floor Philadelphia, PA 19106 MEP ENGINEER: SRW 417 N 8th Street, Suite 204 Philadelphia, PA 19123 267.585.2811

LIGHTING DESIGN:
THE LIGHTING PRACTICE
600 Chestnut Street, Suite 772
Philadelphia, PA 19106

COST ESTIMATOR:
ELLANA CONSTRUCTION CONSULTANTS
32 Broadway, 8TH Floor
New York, NY 10004

PLAYFUL LEARNING CONSULTANT: PLAYFUL LEARNING LANDSCAPES ACTION NEXTWORK Philadelphia, PA 267.468.8610

ARBORIST:
MORRIS ARBORETUM
100 East Northwestern Avenue
Philadelphia, PA 19118
215.247.5777

ACCESSIBILITY CONSULTANT:
CHRIS NOEL
christopher.noel@parks.nyc.gov
646.632.7344

PLAY CONSULTANT: STUDIO LUDO 1313 S 33rd St, Unit A Philadelphia, PA 19146

CITY OF PHILADELPHIA

PHILADELPHIA PARKS AND RECREATION

1515 ARCH STREET

11TH FLOOR, ONE PARKWAY BUILDING

PPR PROJECT NUMBER

16-21-7062-01

PROJECT TITLE: DENING A CK DADK

PENNYPACK PARK
UNIVERSAL PLAYGROUND
RHAWN ST. & HOLMEHURST AVE.

FOOTING LAYOUT PLAN - SOUTHEAST

ALL DIMENSIONS AND CONDITIONS SHALL BE VERIFIED BY THE

PHILADELPHIA, PA 19136

PPR PROJECT NO.:

16-21-7062-01

CONSULTANT PROJECT NO.:

2107

DATE:

12/15/2023

SCALE:

AS NOTED


DRAWN BY:

SS, TW

DRAWING TITLE:

CHECKED BY:

L-113

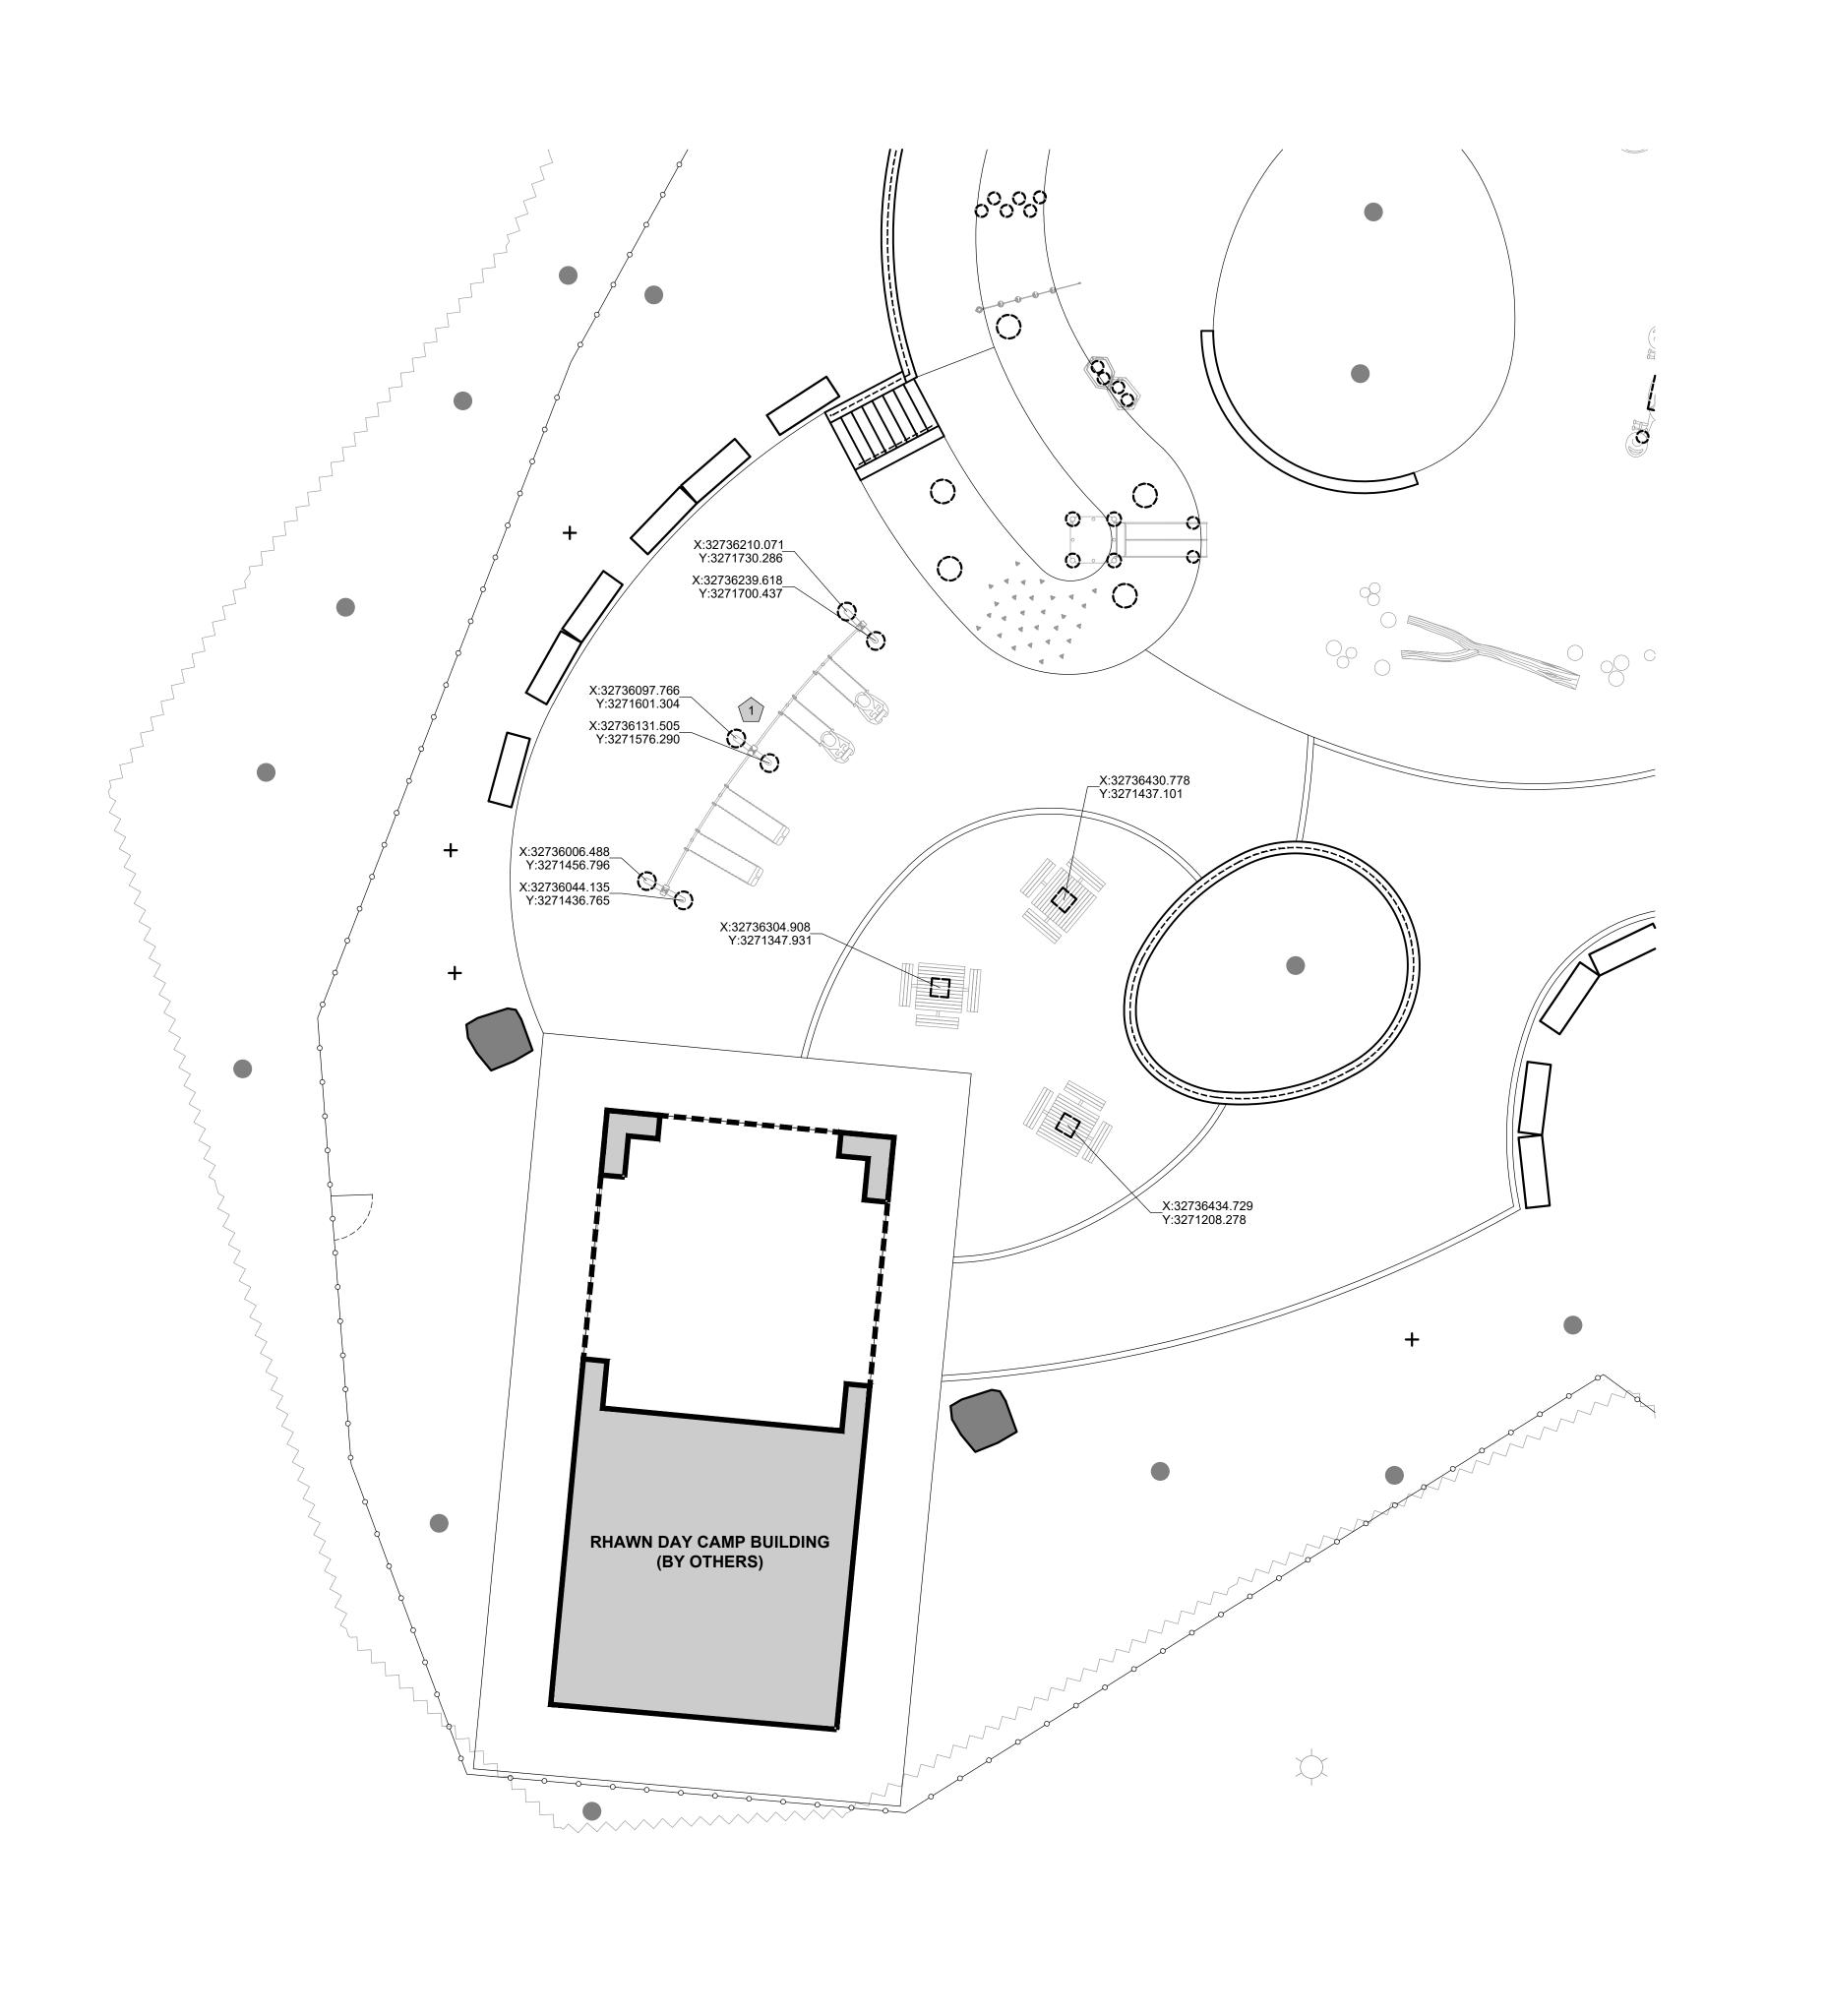



TREE TRUNK

C.I.P. CONCRETE CURB

RAIL -----

WOODLAND EDGE

PROPOSED TREE +

EXISTING BUILDING

GRANITE BLOCK SEATING

SITE BOULDER

FOOTING \_\_\_\_\_

FALL ZONE

L-901

NOTES:

1. SEE L-001 FOR LAYOUT NOTES.

 COORDINATES SHOWN ARE LOCATING CENTER POINTS OF EACH FOOTING. REFER TO MANUFACTURER INSTALLATION SPECIFICATIONS FOR FOOTING DIMENSIONS.


3. SEE L-120 FOR PLAY EQUIPMENT SCHEDULE.

REVISIONS

ISSUE DATE REVISIONS

1 05/16/24 ADDENDUM 1



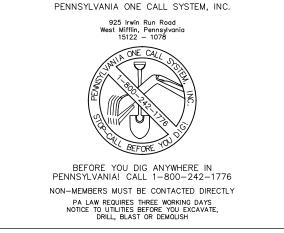

PA ONE-CALL NUMBER (FOR DESIGN ONLY):

PPR PROJECT COORDINATOR:

MEGAN FUNK

RIVERA

REGISTRATION

NUMBER

3379

PRIMARY CONSOLITANT, LANDSCAPE ARCHITECT:

MARVEL 145 Hudson Street, Floor 3 New York, NY 10013

SUB-CONSULTANTS:

CIVIL/SURVEY:
ENGINEERING & LAND PLANNING ASSOCIATES, INC.
219 Cuthbert Street, 5th/ Floor
Philadelphia, PA 19106

MEP ENGINEER: SRW 417 N 8th Street, Suite 204 Philadelphia, PA 19123 267.585.2811 LIGHTING DESIGN: THE LIGHTING PRACTICE 600 Chestnut Street, Suite 772 Philadelphia, PA 19106

COST ESTIMATOR:
ELLANA CONSTRUCTION CONSULTANTS
32 Broadway, 8TH Floor
New York, NY 10004

PLAYFUL LEARNING CONSULTANT:
PLAYFUL LEARNING LANDSCAPES ACTION NEXTWORK
Philadelphia, PA
267.468.8610

ARBORIST:
MORRIS ARBORETUM

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christopher.noel@parks.nyc.gov
646.632.7344

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PLAY CONSULTANT:
STUDIO LUDO
1313 S 33rd St, Unit A
Philadelphia, PA 19146

CONSULTANT PROJECT NUMBER

CITY OF PHILADELPHIA

PHILADELPHIA PARKS AND RECREATION

1515 ARCH STREET 11TH FLOOR, ONE PARKWAY BUILDING

PPR PROJECT NUMBER 16-21-7062-01

PROJECT TITLE: DENINO ACIO DA DIO

PENNYPACK PARK
UNIVERSAL PLAYGROUND
RHAWN ST. & HOLMEHURST AVE.

PHILADELPHIA, PA 19136

FOOTING LAYOUT
PLAN - SOUTHWEST

PPR PROJECT NO.:

16-21-7062-01

CONSULTANT PROJECT NO.:

2107

DATE:

12/15/2023

SCALE:

AS NOTED

DRAWN BY:

SS, TW

CHECKED BY:


SS, TW

DBY:
TS

ALL DIMENSIONS AND CONDITIONS SHALL BE VERIFIED BY THE

N

PLAY EQUIPMENT SCHEDULE							
TAG#	ITEM	QTY	MODEL#	PRODUCT DESCRIPTION	FOOTING TYPE	MANUFACTURER	INSTALLATION
1	Curved Swingset System - 2-5 Age Group	1	CP033846 (2-5)	2 Bay (2) 2-5 AG. ADA Seats, (2) Full Bucket Seats. Antiwrap Swing Hangers.	Direct Bury	Landscape Structures Inc.	Per Manufactures Instruction
2	Wheelchair Accessible Spinner	1	248819A	We-Go-Round w/Perf Panels - 2 seats	Direct Bury	Landscape Structures Inc.	Per Manufactures Instruction
3	Wheelchair Accessible Swing	1	277778A	We-Go-Swing w/1 Accessible Bay	Direct Bury	Landscape Structures Inc.	Per Manufactures Instruction
4	Hillside Rope Climber	1	CP033511	Rope Pull Climber for 24" Elevation	Direct Bury	Landscape Structures Inc.	Per Manufactures Instruction
5	Hillside Rope Climber	1	CP034448	Rope Pull Climber for 48" Elevation	Direct Bury	Landscape Structures Inc.	Per Manufactures Instruction
6	Hillside Stainless Steel Slide	1	190857B	S/S Double Slide w/SteelX Hood, Posts, Grab Bar & Deck	Direct Bury	Landscape Structures Inc.	Per Manufactures Instruction
7	Hillside Pod Climber	2	158997A	Pod Climber 10" Height	Direct Bury	Landscape Structures Inc.	Per Manufactures Instruction
8	Hillside Pod Climber	4	120711A	Pod Climber 16" Height	Direct Bury	Landscape Structures Inc.	Per Manufactures Instruction
9	Curved Swingset System -5-12 Age Group	1	CP033846 (5-12)	2 Bay (1) 5-12 AG. ADA Seats, (3) Belt Seats. Antiwrap Swing Hangers.	Direct Bury	Landscape Structures Inc.	Per Manufactures Instruction
10	Hillside Transfer Station	1	CP029500	Angular GripX Transfer Station & Pods	Direct Bury	Landscape Structures Inc.	Per Manufactures Instruction
11	Hillside Climbing Grips	1	CP033040	Tri-Handhold Handgrips - Set of 30	Surface Mount	Landscape Structures Inc.	Per Manufactures Instruction
12	Hillside Climbing Loop	4	CP001153	Single Hill Loop 36" OC	Direct Bury	Landscape Structures Inc.	Per Manufactures Instruction
13	Independent Spring Rider	1	164075B	Double Bobble Rider	Direct Bury	Landscape Structures Inc.	Per Manufactures Instruction
14	Independent Bouncer	1	295696A	ReviRock Bouncer	Direct Bury	Landscape Structures Inc.	Per Manufactures Instruction
15	Independent Spinner	1	152179A	Saddle Spinner DB 12"Height	Direct Bury	Landscape Structures Inc.	Per Manufactures Instruction
16	Accessible See-Saw	1	186490A	We-saw	Direct Bury	Landscape Structures Inc.	Per Manufactures Instruction
17	Musical Equipment - 2-5 Age Group	1	228217A	Rhapsody Kettle Drum Junior	Direct Bury	Landscape Structures Inc.	Per Manufactures Instruction
18	Musical Equipment - 2-5 Age Group	1	228218A	Rhapsody Kundu Drum Junior	Direct Bury	Landscape Structures Inc.	Per Manufactures Instruction
19	Musical Equipment - 2-5 Age Group	1	228215A	Rhapsody Goblet Drum Junior	Direct Bury	Landscape Structures Inc.	Per Manufactures Instruction
20	Musical Equipment - 5-12 Age Group	1	250340A	Rhapsody Cascata Bells	Direct Bury	Landscape Structures Inc.	Per Manufactures Instruction
21	Musical Equipment - 5-12 Age Group	1	214443A	Rhapsody Goblet Drum	Direct Bury	Landscape Structures Inc.	Per Manufactures Instruction
22	Musical Equipment - 5-12 Age Group	1	214442A	Rhapsody Grandioso Chimes	Direct Bury	Landscape Structures Inc.	Per Manufactures Instruction
23	Musical Equipment - 5-12 Age Group	1	214445A	Rhapsody Kettle Drum	Direct Bury	Landscape Structures Inc.	Per Manufactures Instruction
24	Musical Equipment - 5-12 Age Group	1	214444A	Rhapsody Kundu Drum	Direct Bury	Landscape Structures Inc.	Per Manufactures Instruction
25	Musical Equipment - 5-12 Age Group	1	251573A	Rhapsody Vibra Chimes - Full Set	Direct Bury	Landscape Structures Inc.	Per Manufactures Instruction
26	Log Balance Beam	1	Custom	Whole tree with branches laid horizontally	Surface Mount	Whole Trees	Per Manufactures Instruction
27	Log Steppers	8	Custom	Stumps at varrying heights	Direct Bury	Whole Trees	Per Manufactures Instruction
28	Seating Circle	1	Custom	Split log bench (1) w/ Stump Benches (4)	Direct Bury, Pinning	Whole Trees	Per Manufactures Instruction
29	Scrambler	1	Custom	Large lumber climber on posts (11) w/ Netting	Direct Bury	Whole Trees	Per Manufactures Instruction
30	Grove Sculpture	5	Custom	Large (25' ht.) whole trees with branching	Direct Bury	Whole Trees	Per Manufactures Instruction

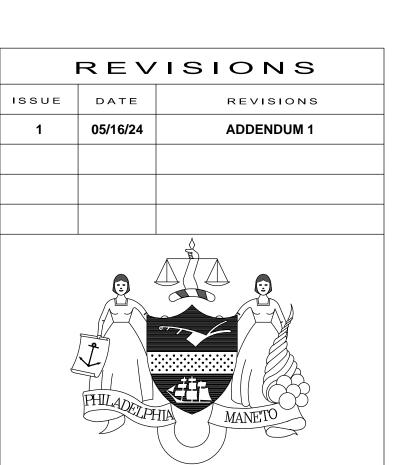


BEFORE YOU DIG ANYWHERE IN PENNSYLVANIA! CALL 1—800—242—1776

NON-MEMBERS MUST BE CONTACTED DIRECTLY PA LAW REQUIRES THREE WORKING DAYS NOTICE TO UTILITIES BEFORE YOU EXCAVATE, DRILL, BLAST OR DEMOLISH

PENNSYLVANIA ONE CALL SYSTEM, INC.

PA ONE-CALL NUMBER (FOR DESIGN ONLY):

PPR PROJECT COORDINATOR:

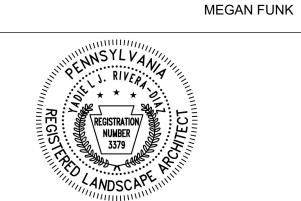

MARVEL 145 Hudson Street, Floor 3 New York, NY 10013

SUB-CONSULTANTS:

CIVIL/SURVEY: ENGINEERING & LAND PLANNING ASSOCIATES, INC. 219 Cuthbert Street, 5th/ Floor Philadelphia, PA 19106

MEP ENGINEER: SRW 417 N 8th Street, Suite 204 Philadelphia, PA 19123 267.585.2811

LIGHTING DESIGN: THE LIGHTING PRACTICE 600 Chestnut Street, Suite 772 Philadelphia, PA 19106

COST ESTIMATOR: ELLANA CONSTRUCTION CONSULTANTS 32 Broadway, 8TH Floor New York, NY 10004

PLAYFUL LEARNING CONSULTANT: PLAYFUL LEARNING LANDSCAPES ACTION NEXTWORK Philadelphia, PA 267.468.8610

ARBORIST: MORRIS ARBORETUM 100 East Northwestern Avenue Philadelphia, PA 19118 215.247.5777

ACCESSIBILITY CONSULTANT: CHRIS NOEL christopher.noel@parks.nyc.gov 646.632.7344

PLAY CONSULTANT: STUDIO LUDO 1313 S 33rd St, Unit A Philadelphia, PA 19146

CONSULTANT PROJECT NUMBER

CITY OF PHILADELPHIA

2107

PHILADELPHIA PARKS AND RECREATION 1515 ARCH STREET

11TH FLOOR, ONE PARKWAY BUILDING

DRAWING TITLE:

PPR PROJECT NUMBER 16-21-7062-01


PROJECT TITLE: PENNYPACK PARK UNIVERSAL PLAYGROUND


RHAWN ST. & HOLMEHURST AVE. PHILADELPHIA, PA 19136


### PLAY EQUIPMENT SCHEDULE

PPR PROJECT NO.:	
	16-21-7062-01
CONSULTANT PROJECT NO.	.:
	2107
DATE:	
	12/15/2023
SCALE:	
	AS NOTED
DRAWN BY:	
	SS, TW
CHECKED BY:	


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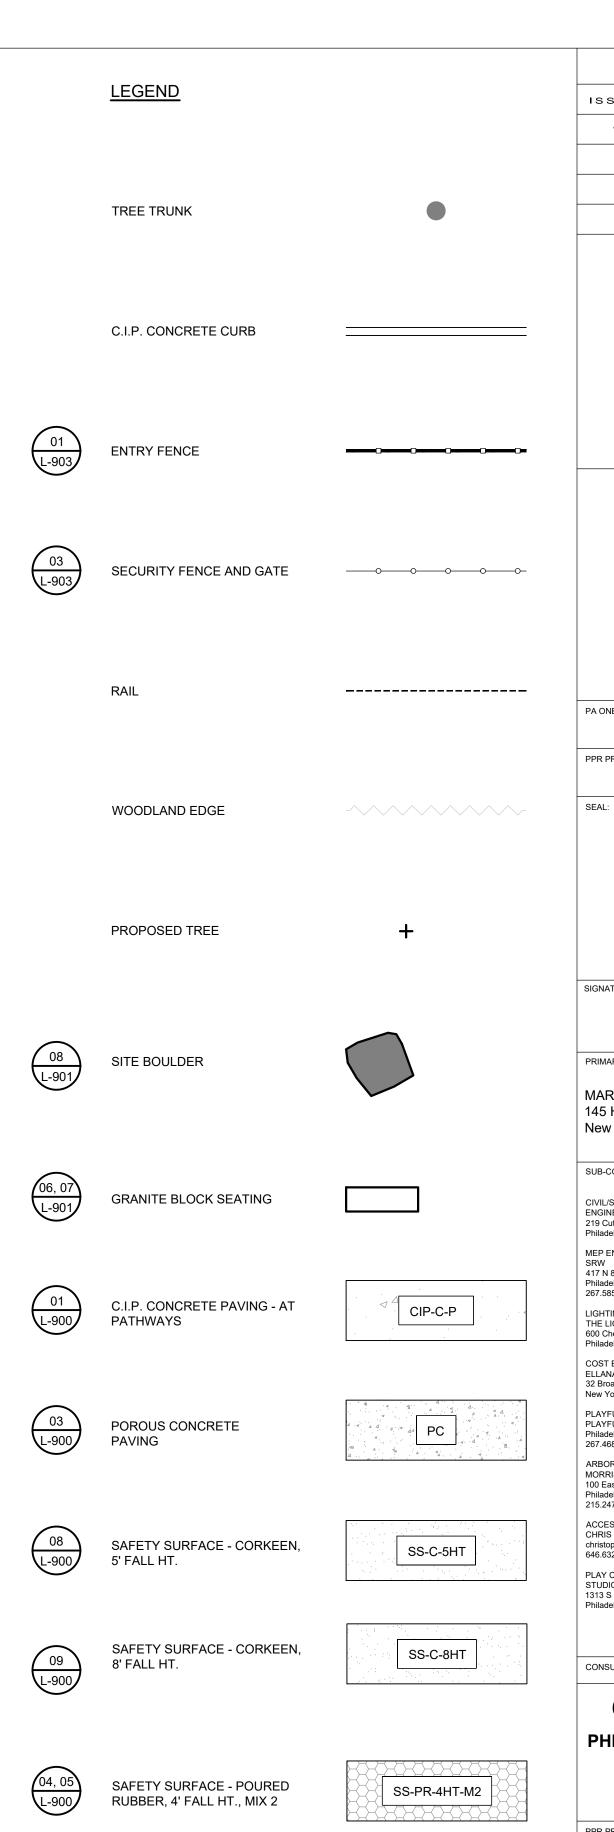
REVISIONS

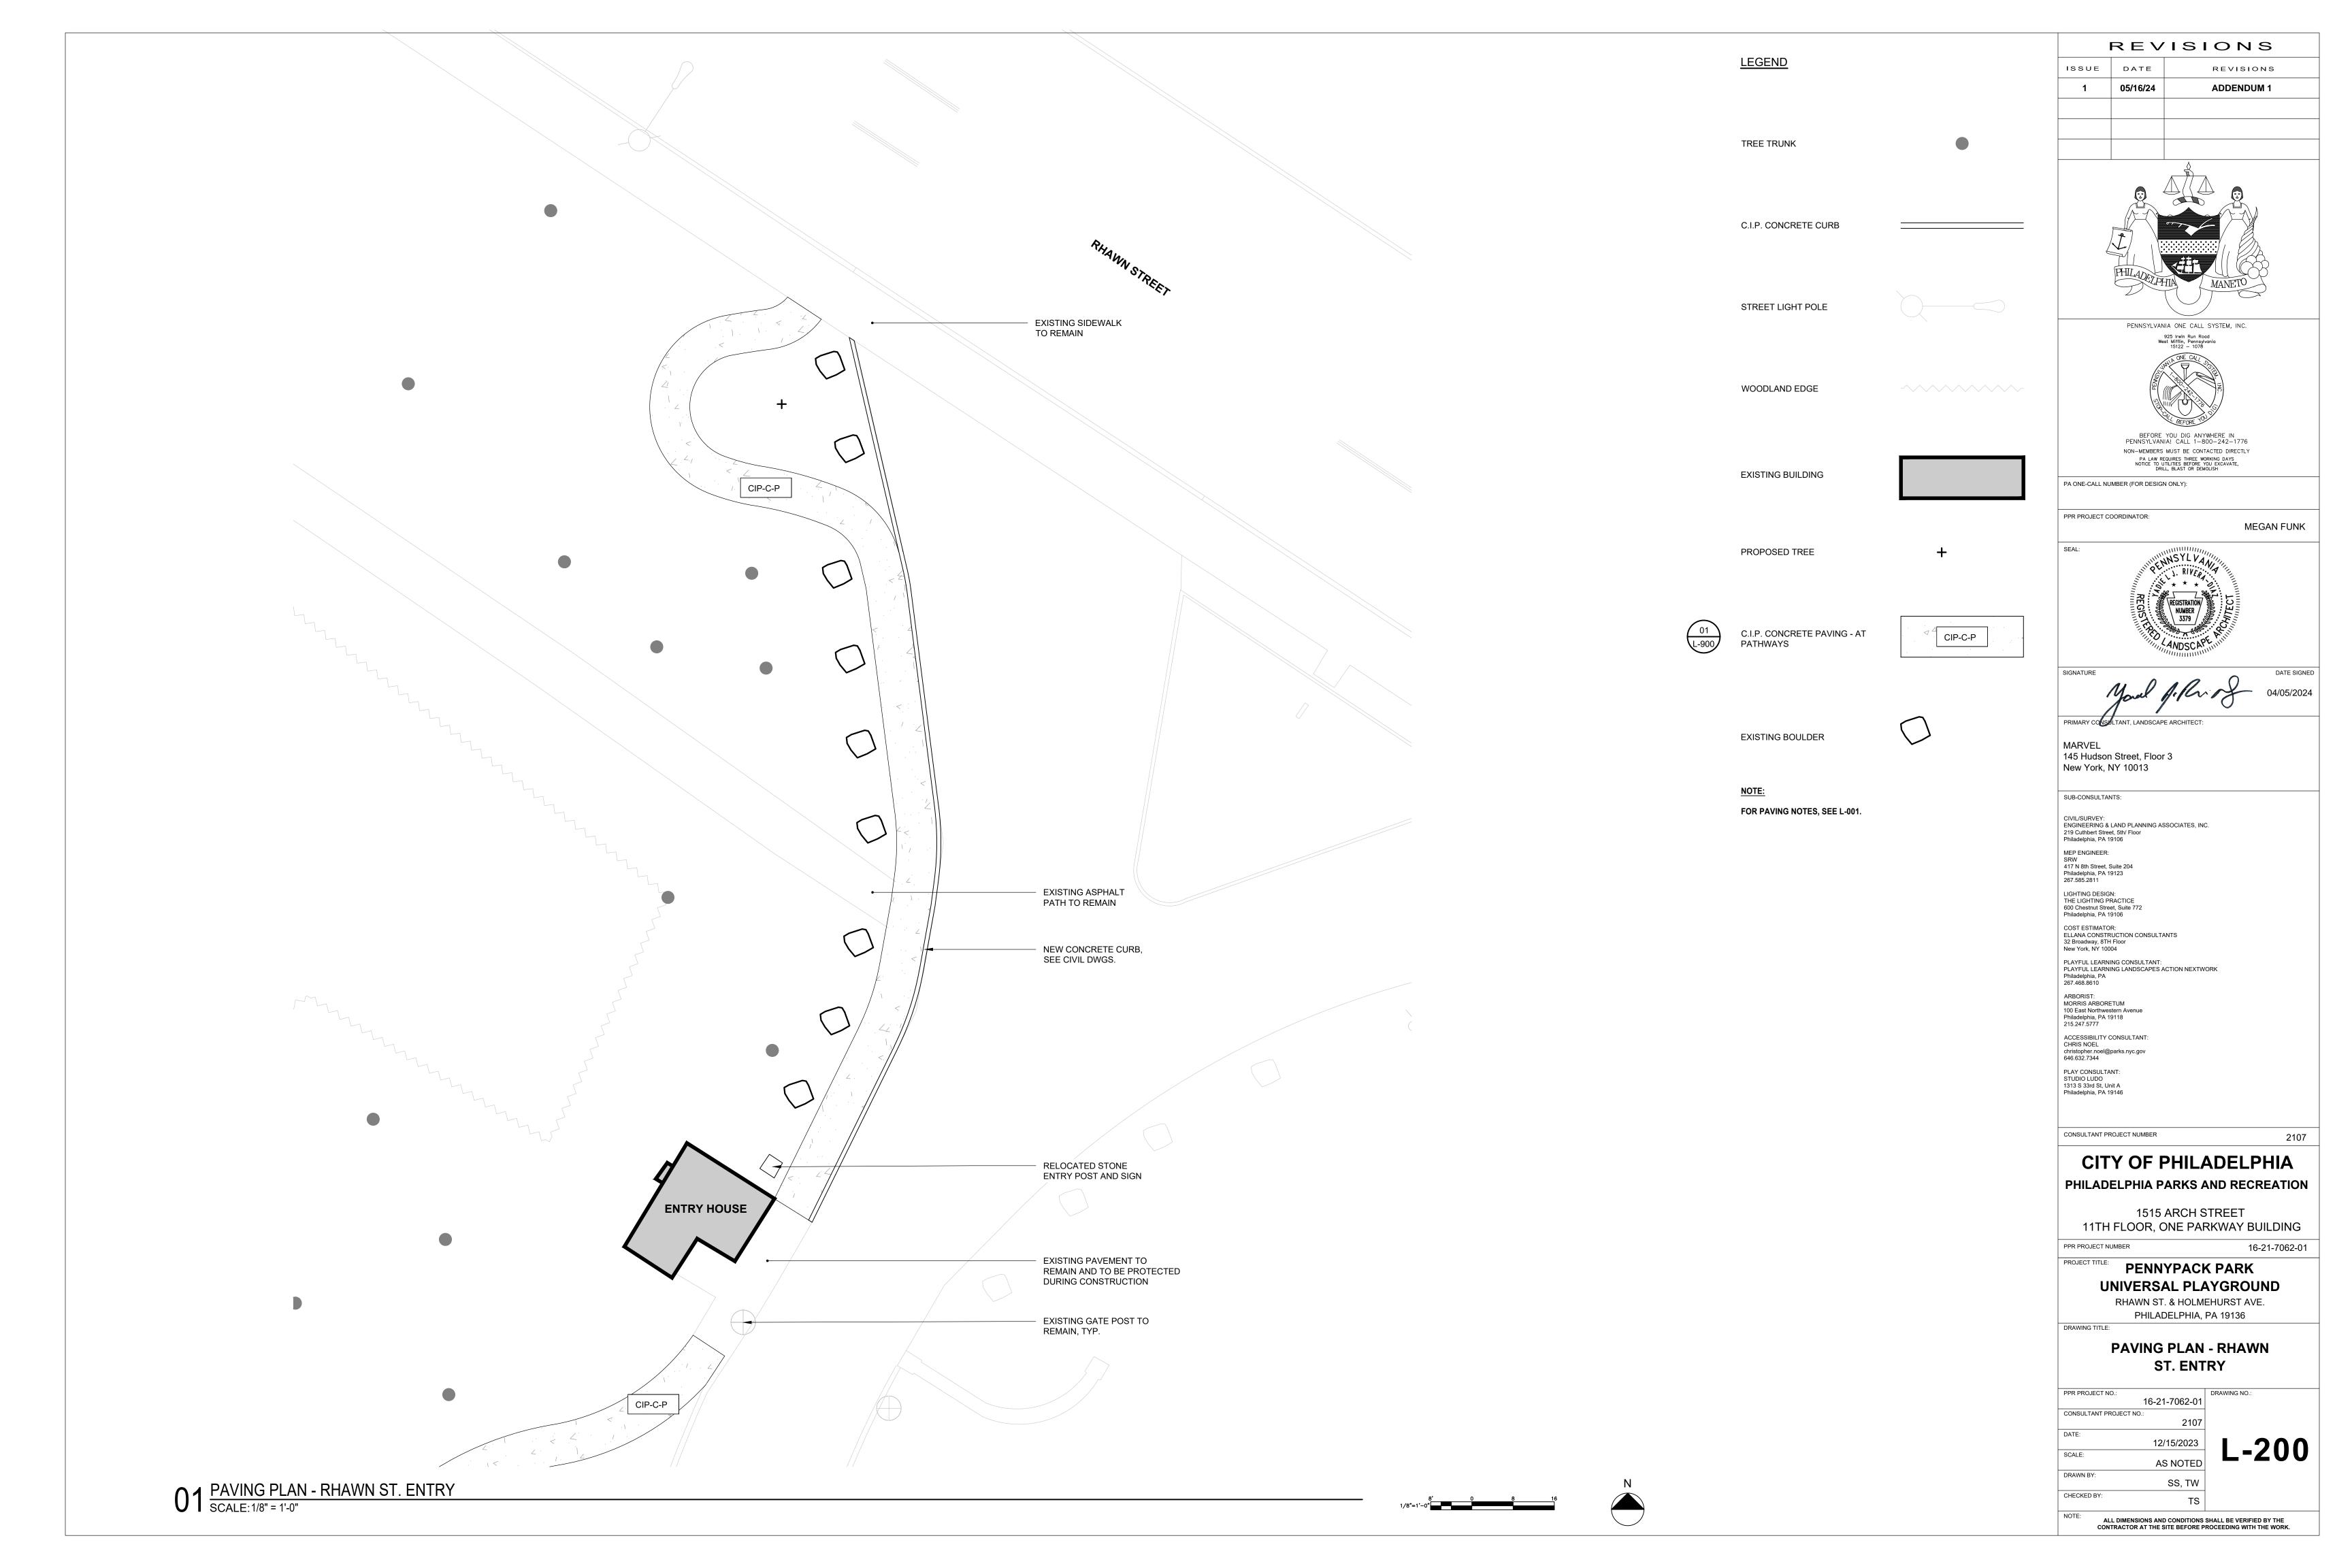

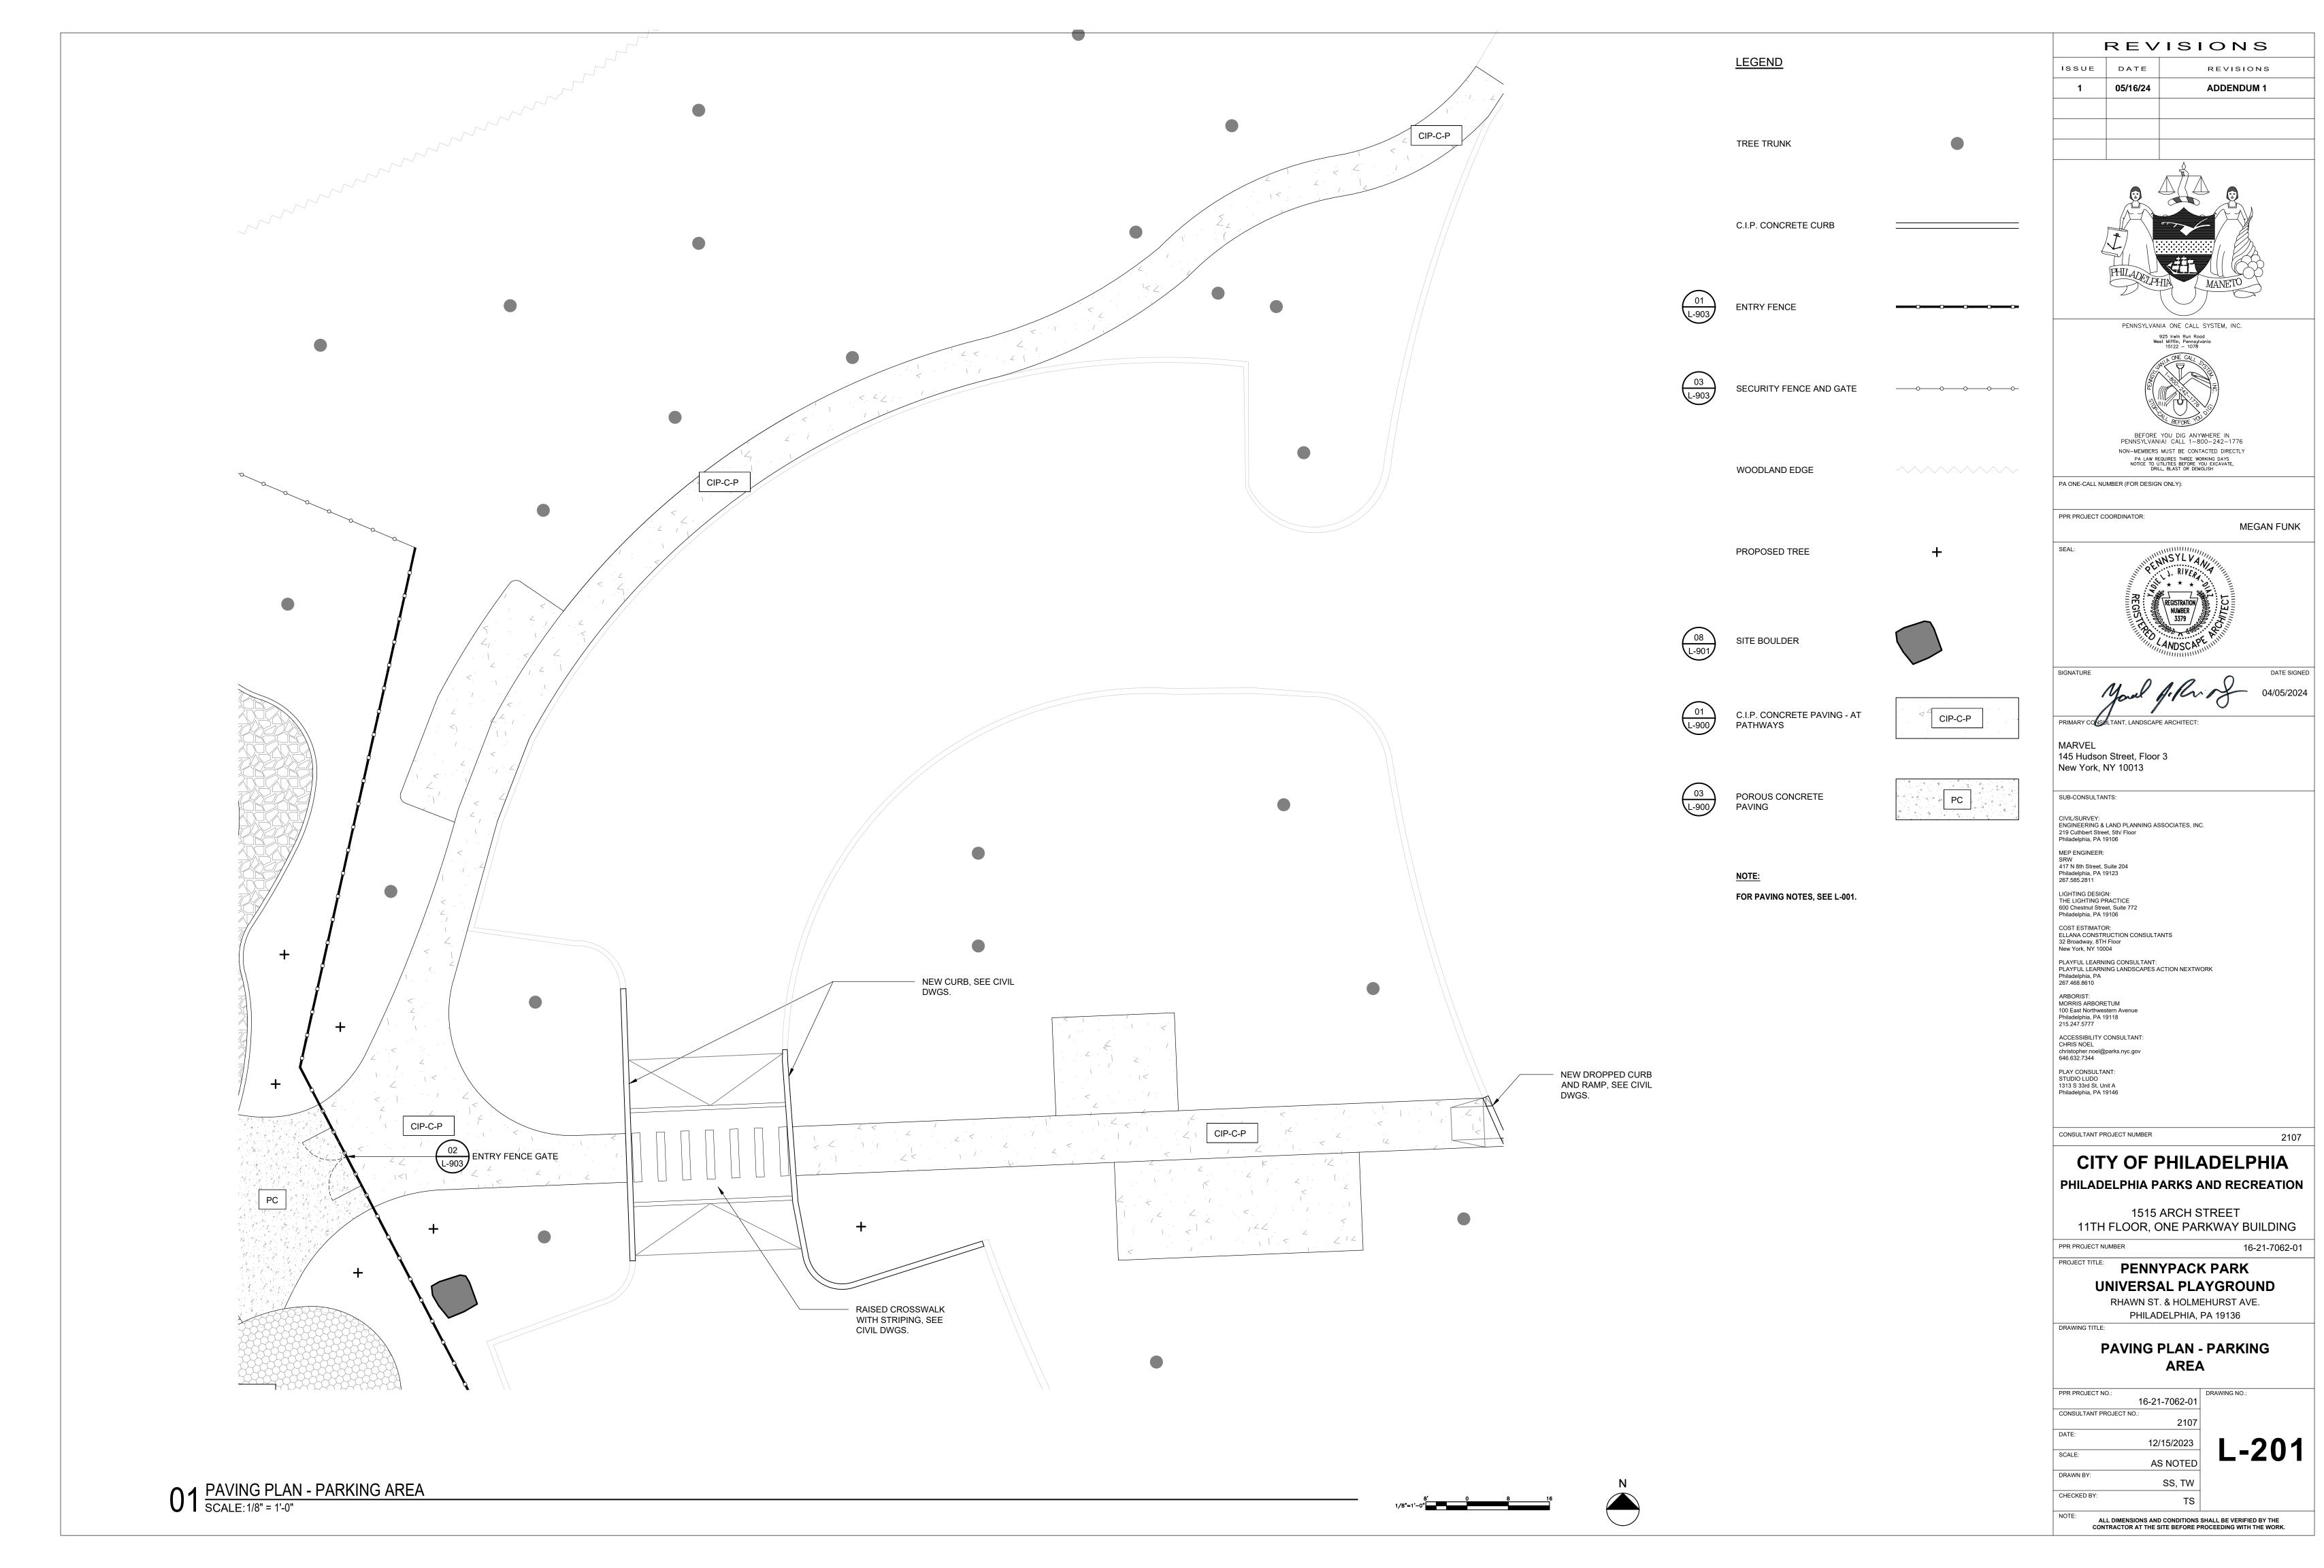PHILADELPHIA PARKS AND RECREATION

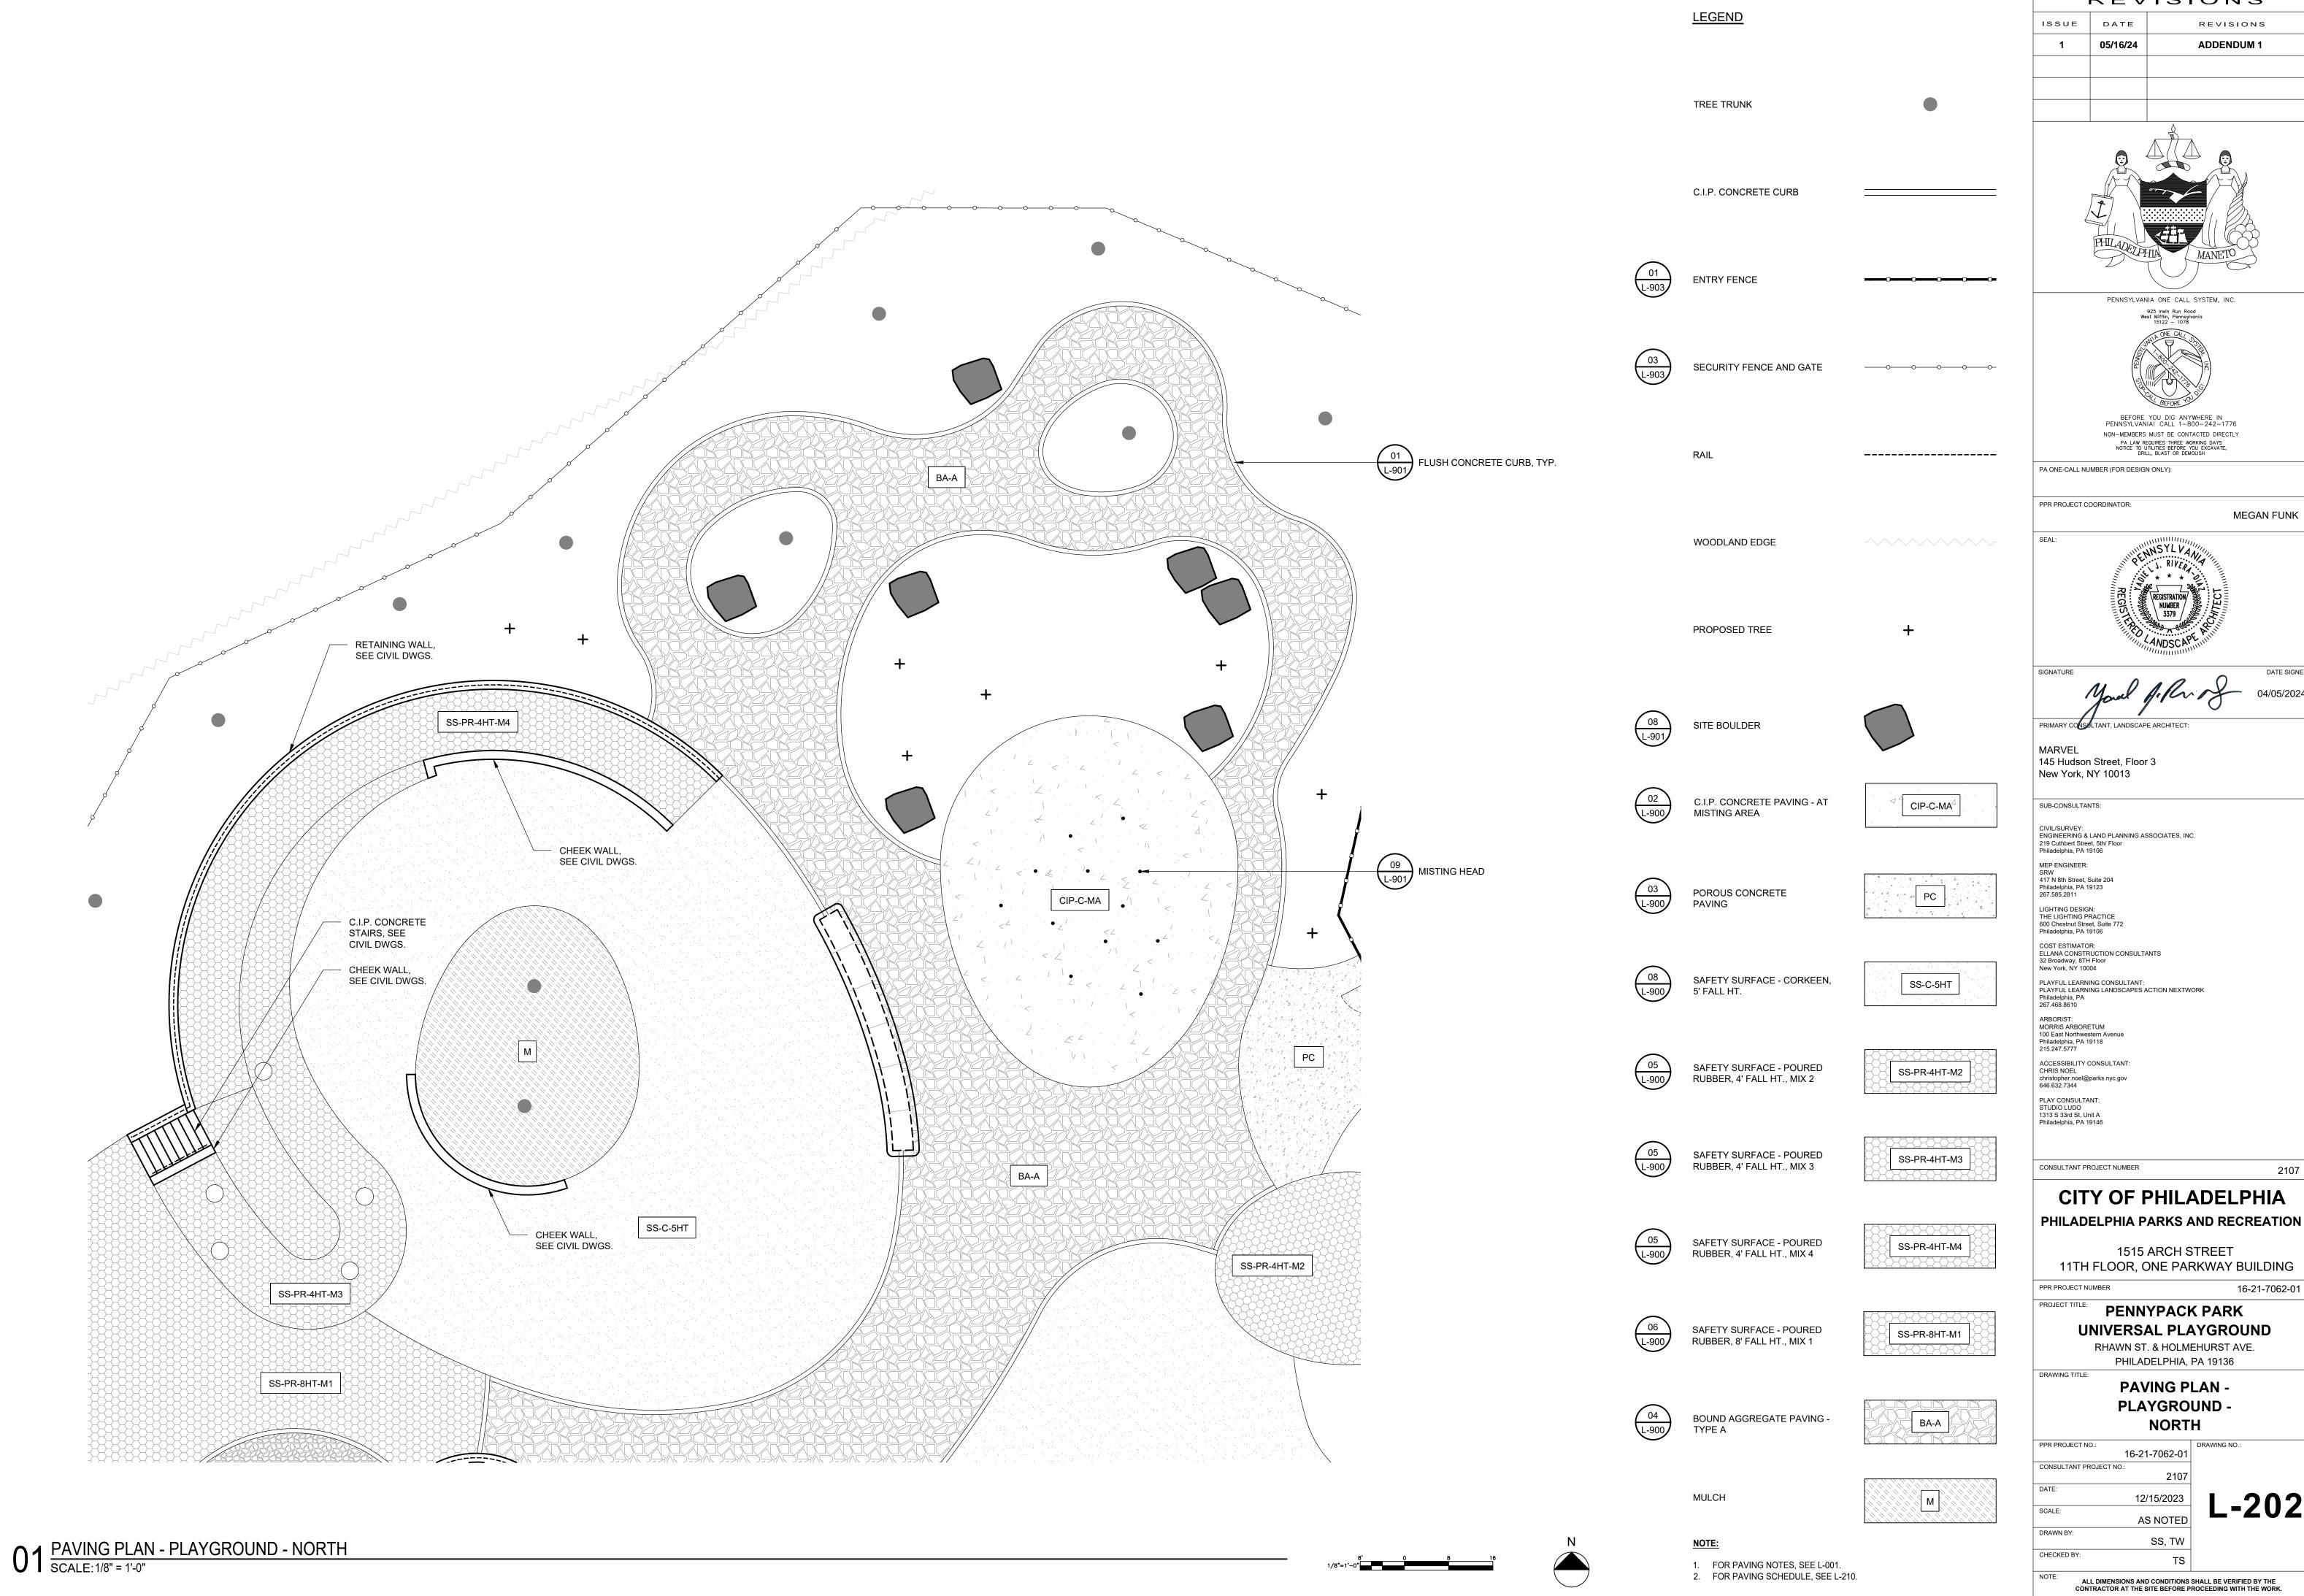16-21-7062-01



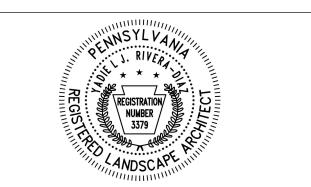

03 L-900

BOUND AGGREGATE PAVING -

FOR PAVING NOTES, SEE L-001.

BA-A




PHILADELPHIA PARKS AND RECREATION

UNIVERSAL PLAYGROUND RHAWN ST. & HOLMEHURST AVE. PHILADELPHIA, PA 19136


> **PAVING PLAN -**PLAYGROUND -SOUTHEAST


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PPR PROJECT NO.: 16-21-7062-01 CONSULTANT PROJECT NO.: 12/15/2023 SCALE: AS NOTED DRAWN BY: SS, TW CHECKED BY:

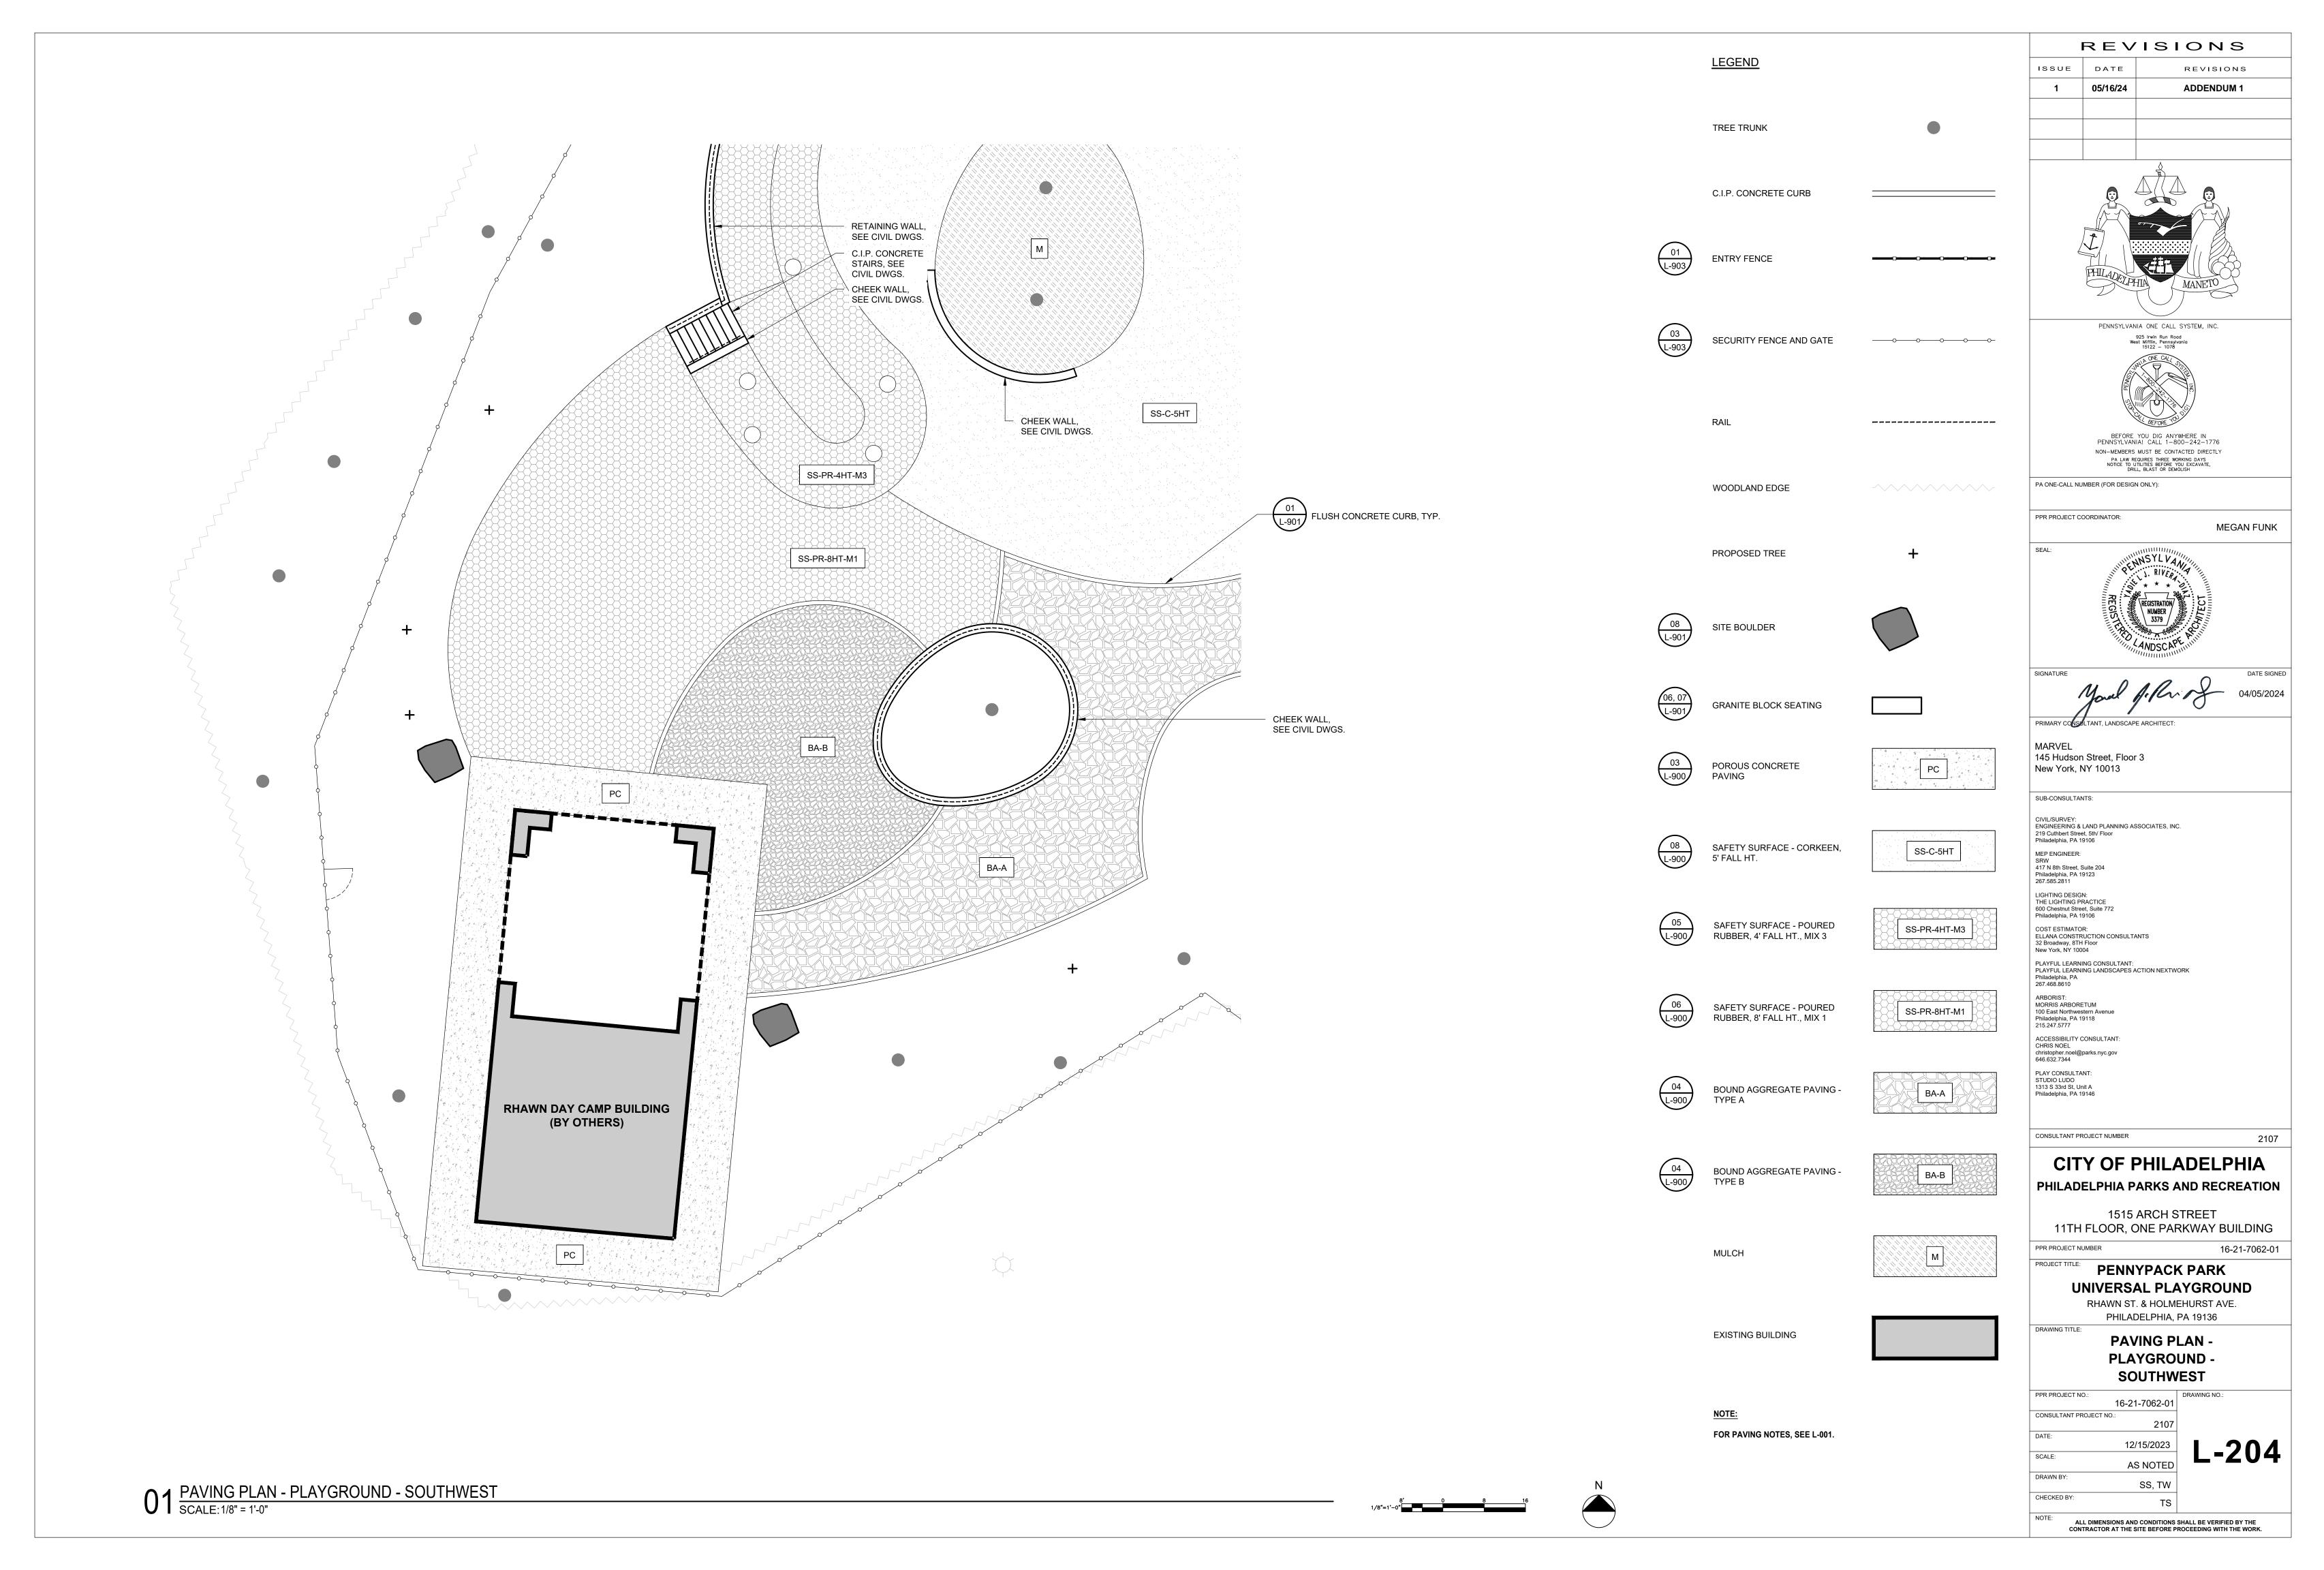


PAVING SCHEDULE					
SYM.	NAME	DETAIL NO.	SHEET NO.	FINISH/COLOR	QTY. (SF)
✓ △ CIP-C-P	C.I.P. CONCRETE PAVING - AT PATHWAYS	01	L-900	BROOM FINISH	3,133
✓ △ CIP-C-MA	C.I.P. CONCRETE PAVING · AT MISTING AREA	02	L-900	BROOM FINISH, PAINTED WITH SPORT COURT PAINT WITH GRIT	1,127
PC	POROUS CONCRETE PAVING	03	L-900	BROOM FINISH	1,383
BA-A	BOUND AGGREGATE PAVING - TYPE A	04	L-900	LIGHT GREY	4,777
BA-B	BOUND AGGREGATE PAVING - TYPE B	04	L-900	TAN	741
SS-PR-4HT-M2	SAFETY SURFACE - POURED RUBBER, 4' FALL HT.	05	L-900	MIX 2: 33% RED, 33% ORANGE, 33% PRIMARY RED	1,295
SS-PR-4HT-M3	SAFETY SURFACE - POURED RUBBER, 4' FALL HT.	05	L-900	MIX 3: 33% BRIGHT YELLOW, 33% EGGSHELL, 33% CREAM	757
SS-PR-4HT-M4	SAFETY SURFACE - POURED RUBBER, 4' FALL HT.	05	L-900	MIX 4: 33% BEIGE, 33% EARTH YELLOW, 33% ORANGE	578
SS-PR-8HT-M1	SAFETY SURFACE - POURED RUBBER, 8' FALL HT.	06	L-900	MIX 1: 50% RED, 50% BROWN	1,809
SS-C-5HT	SAFETY SURFACE - CORKEEN, 5' FALL HT.	08	L-900	N/A	3,285
SS-C-8HT	SAFETY SURFACE - CORKEEN, 8' FALL HT.	09	L-900	N/A	3,440
M	MULCH			SEE PPR STANDARD SPECS	638



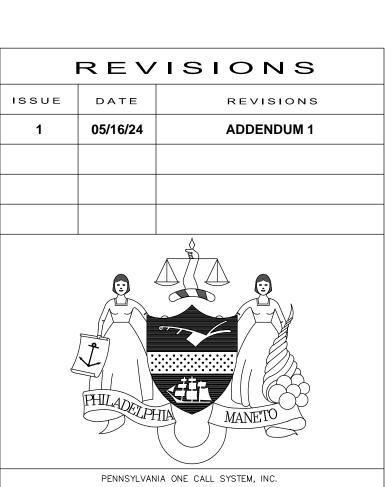

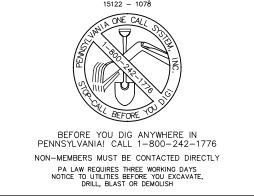PA ONE-CALL NUMBER (FOR DESIGN ONLY):

PPR PROJECT COORDINATOR:

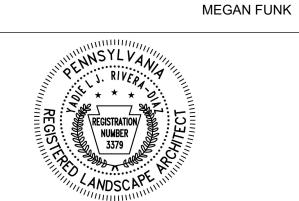

MARVEL 145 Hudson Street, Floor 3 New York, NY 10013

SUB-CONSULTANTS:

CIVIL/SURVEY: ENGINEERING & LAND PLANNING ASSOCIATES, INC. 219 Cuthbert Street, 5th/ Floor Philadelphia, PA 19106

MEP ENGINEER: SRW 417 N 8th Street, Suite 204 Philadelphia, PA 19123 267.585.2811

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PLAYFUL LEARNING CONSULTANT: PLAYFUL LEARNING LANDSCAPES ACTION NEXTWORK Philadelphia, PA 267.468.8610

ARBORIST: MORRIS ARBORETUM 100 East Northwestern Avenue Philadelphia, PA 19118 215.247.5777

ACCESSIBILITY CONSULTANT: CHRIS NOEL christopher.noel@parks.nyc.gov 646.632.7344

PLAY CONSULTANT: STUDIO LUDO 1313 S 33rd St, Unit A Philadelphia, PA 19146

CONSULTANT PROJECT NUMBER

CITY OF PHILADELPHIA

2107

16-21-7062-01

# PHILADELPHIA PARKS AND RECREATION

1515 ARCH STREET 11TH FLOOR, ONE PARKWAY BUILDING PPR PROJECT NUMBER

PROJECT TITLE:

PENNYPACK PARK UNIVERSAL PLAYGROUND RHAWN ST. & HOLMEHURST AVE.

PHILADELPHIA, PA 19136 DRAWING TITLE:

### **PAVING SCHEDULE**

PPR PROJECT NO.:	40.04.7000.04
	16-21-7062-01
CONSULTANT PROJECT NO.	.:
	2107
DATE:	
	12/15/2023
SCALE:	
	AS NOTED
DRAWN BY:	
	SS, TW
CHECKED BY:	TC

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