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# PELBANO PLAYGROUND CONSTRUCTION DOCUMENTATION-100% - 5/31/2023

CITY OF PHILADELPHIA PHILADELPHIA PARKS & RECREATION

MAYOR - JAMES F. KENNEY

MANAGING DIRECTOR - TUMAR ALEXANDER

COMMISSIONER - PHILADELPHIA PARKS AND **RECREATION - KATHRYN OTT LOVELL** 

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## PELBANO PLAYGROUND

8101 BUSTLETON AVENUE

## OLIN

LANDSCAPE ARCHITECTURE / URBAN DESIGN / PLANNING ONE PENN CENTER 1617 JOHN F. KENNEDY BOULEVARD, SUITE 1900 PHILADELPHIA, PA 19103 TEL 215.440.0030 / FAX 215.440.0041 WWW.THEOLINSTUDIO.COM OLIN PARTNERSHIP, LTD.

Playground Design: Studio Ludo 4800 Springfield Ave Philadelphia, PA 19143 (215) 454-6780

Civil Engineering: Sci Tek 1880 John F Kennedy Blvd #600, Philadelphia, PA 19103 (267) 314-5385


MEP: Mark Ulrick 30 N. 41ST SUITE 500 Philadelphia, PA 19104 (856) 320-8100

No.	Date	Description
1	10/12/2022	SD set
2	11/16/2022	SD set
3	2/21/2023	DD set
4	4/17/2023	75% CD set
5	5/31/2023	100% CD set

## COVER SHEET

Scale:	NA
Date:	5/31/2023
Drawn:	KMP
Checked:	TS
Project No.:	2224



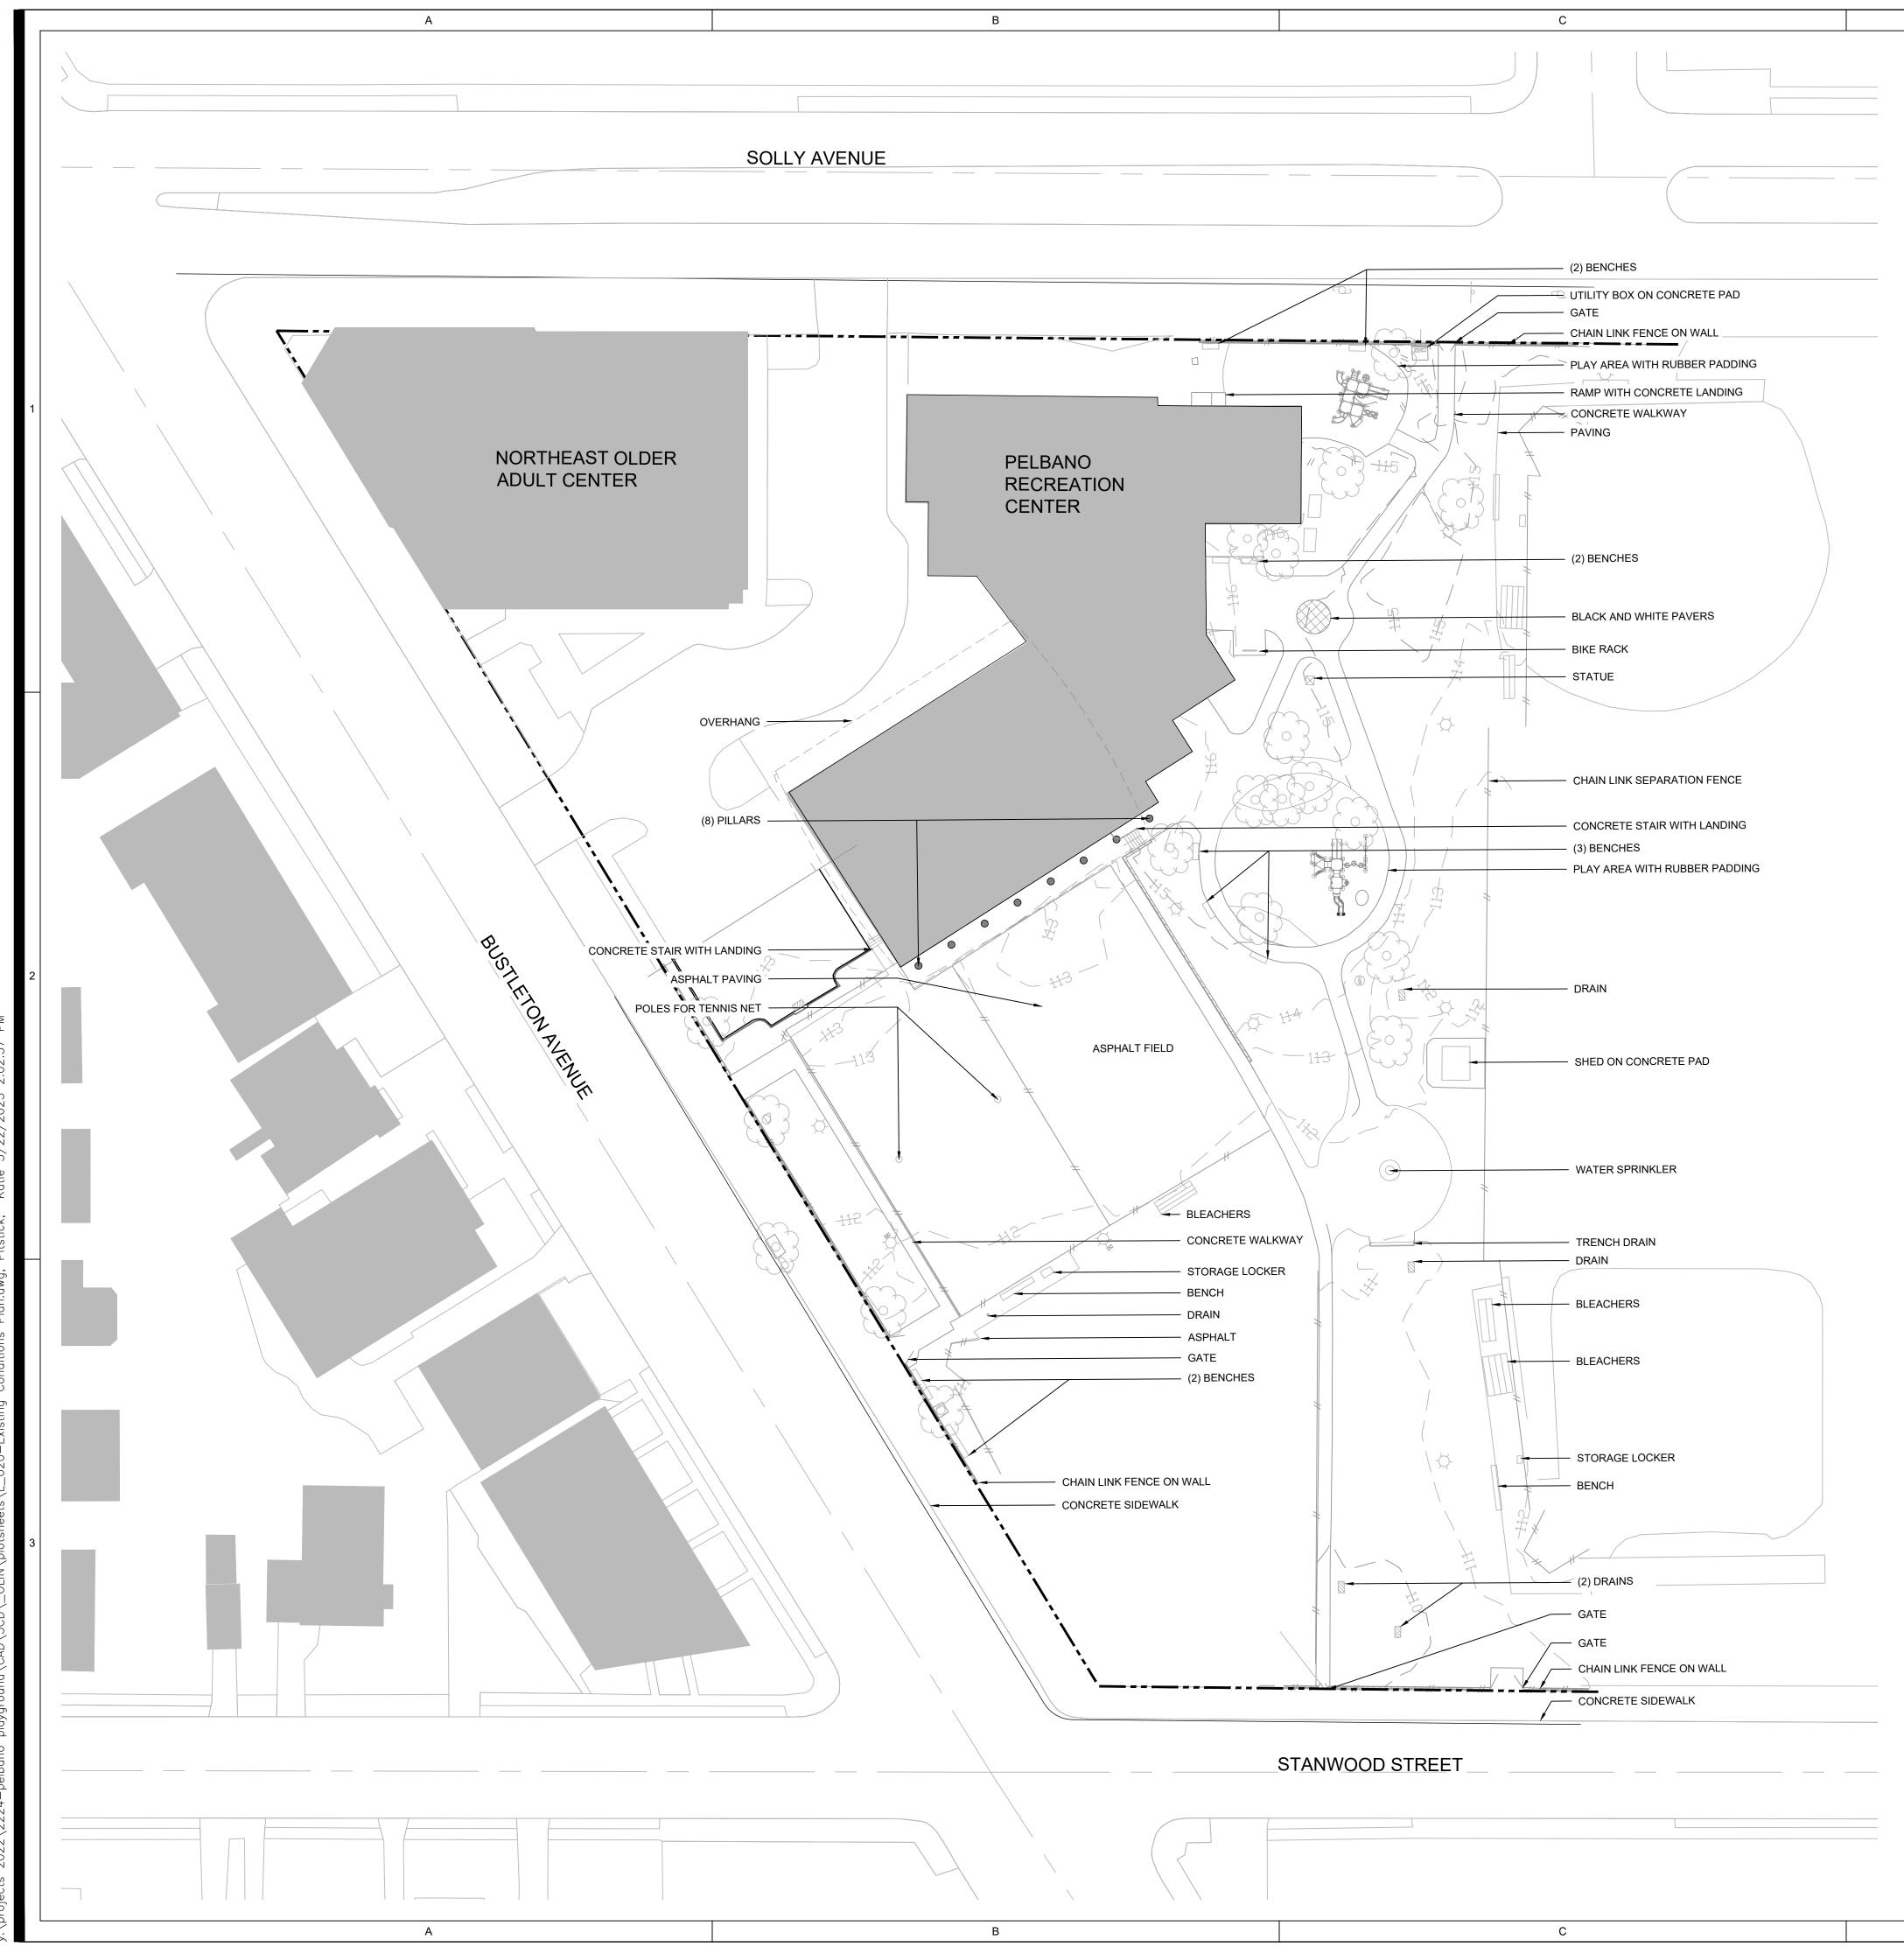

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EXISTING CONDITIONS PLAN LEGEND

	PROPERTY LINE
<u> </u>	TREE
لي ب	IREE
11/	GRASS AREA
MH	MANHOLE
_ <del>_</del>	SIGN
//	CHAIN LINK FENCE
	EXISTING CONTOUR
ф	LIGHT STANDARD
ДŶ	LIGHT STANDARD WITH ELECTRIC BOX
	UTILITY POLE

EXISTING CONDITIONS PLAN NOTES

- 1. HEAVY MACHINERY, MECHANICAL TRENCHING OR MATERIAL STORAGE IS NOT PERMITTED WITHIN THE TREE PROTECTION ZONES OR CRITICAL ROOT ZONES.
- 2. ANY SOIL DISTURBANCE WITHIN CRITICAL ROOT ZONES OR ANY CONSTRUCTION WORK OCCURRING WITHIN EXISTING TREE DRIP LINES TO BE COORDINATED WITH AND AGREED BY CLIENT'S NOMINATED ARBORIST
- 3. CORE AERATOR, TOP-DRESSING MACHINE, AIR SPADING, HAND DIGGING OR OTHER APPROVED METHOD OF DIGGING AND TRENCHING SHALL BE USED IN PLACE OF ROTOTILLER TO COMPLETE ALL WORK IN TREE PROTECTION ZONES. CARE MUST BE TAKEN TO AVOID DISTURBANCE TO ROOTS OF ALL EXISTING TREES, INCLUDING ROOTS EXTENDING OUTSIDE OF TREE PROTECTION ZONES.
- 4. PROTECTION BARRIERS SHALL BE MAINTAINED THROUGHOUT THE DURATION OF THE WORK AT THE SITE.
- 5. WARNING SIGNS SHOULD ALSO BE PLACED ON THE FENCING AND IN APPROPRIATE AREAS NEAR THE WORK ZONE.
- 6. DURING CONSTRUCTION WITHIN THE TREE PROTECTION ZONES OR CRITICAL ROOT ZONES, SOIL SHALL BE PROTECTED, SEE DETAIL 2/L960.
- 7. CRITICAL ROOT ZONE TO BE CONFIRMED ON SITE
- 8. PROTECTION BARRIER SHALL BE CONSTRUCTED OF DURABLE AND HIGHLY VISIBLE MATERIAL

8	8101 B	USTLE	TON	AVEN	JE

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PELBANO

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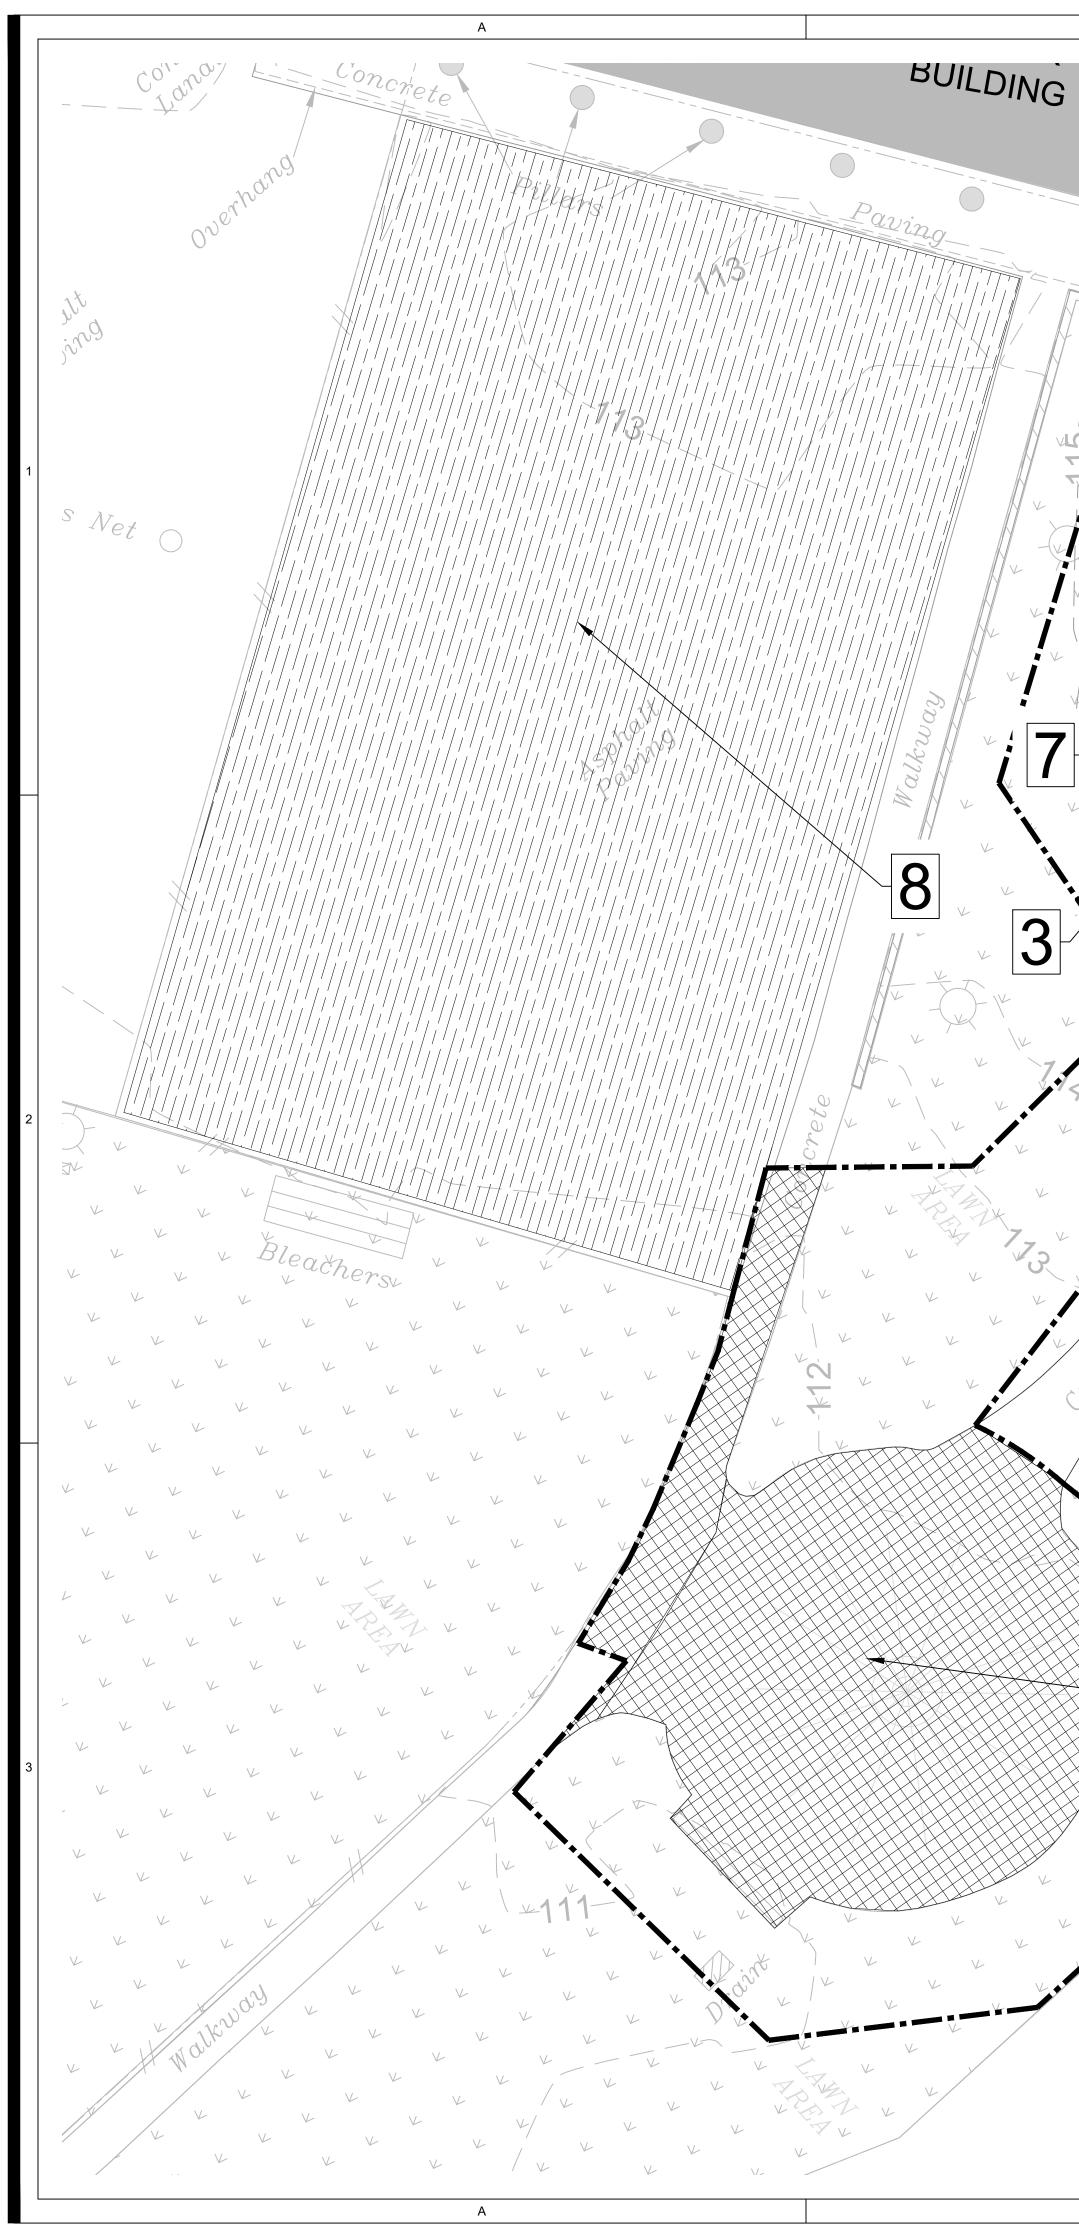
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### EXISTING CONDITIONS PLAN

Scale:	1"=30
Date:	5/31/202
Drawn:	KM
Checked:	T
Project No.:	222







## LEGEND (PROPOSED)

6

LIMIT OF DISTURBANCE (14,600 S.F.)

## LEGEND (EXISTING CONDITIONS)

MH MANHOLE

С

Walkway

2

2

3

2

3

2

4

6

LIGHT POLE

TREE/SHRUB

CATCH BASIN


UTILITY POLE

LAWN/GRASS AREAS

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PLAY SURFACE AREA REMOVAL



RECONSTRUCTED ASPHALT PLAY SURFACE AREA (MILL & OVERLAY)

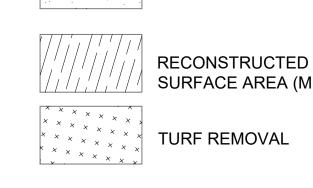-- 112' - Contour label


## **DEMOLITION KEYNOTES**

- 1 TREE PROTECTION
- 2 TREE REMOVAL
- 3 REMOVE BENCH AND FOUNDATION
- 4 RUBBER PLAY SURFACE REMOVAL
- 5 RELOCATE STATUE
- 6 REMOVE CONCRETE SURFACE
- 7 **REMOVE TURF**
- 8 MILL ASPHALT SURFACE TO 1.5" DEPTH
- 9 REMOVE AND RELOCATE SCULPTURE (TO BE HANDLED BY OACCE)

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6

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## PELBANO PLAYGROUND

## 8101 BUSTLETON AVENUE
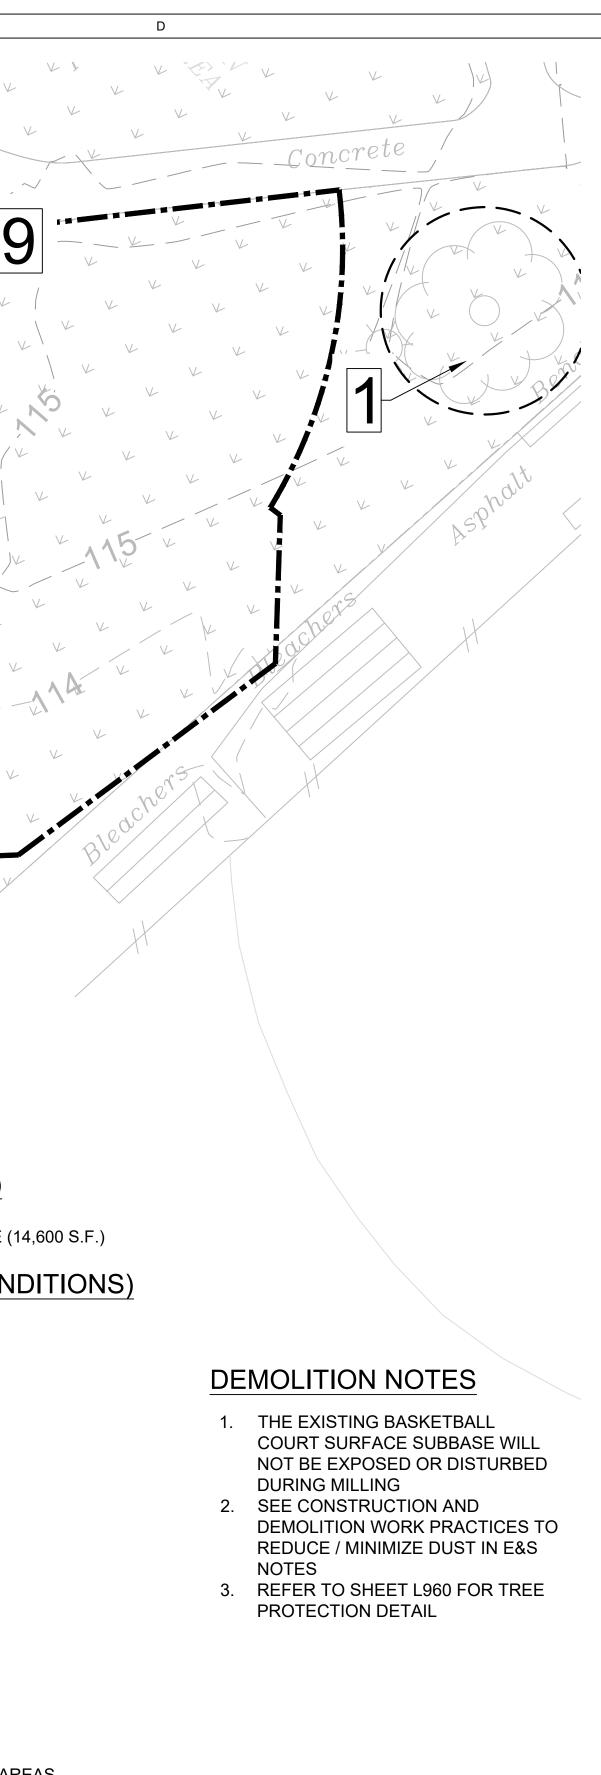
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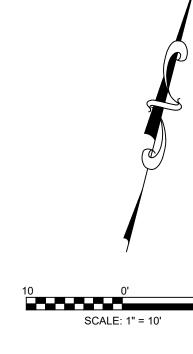
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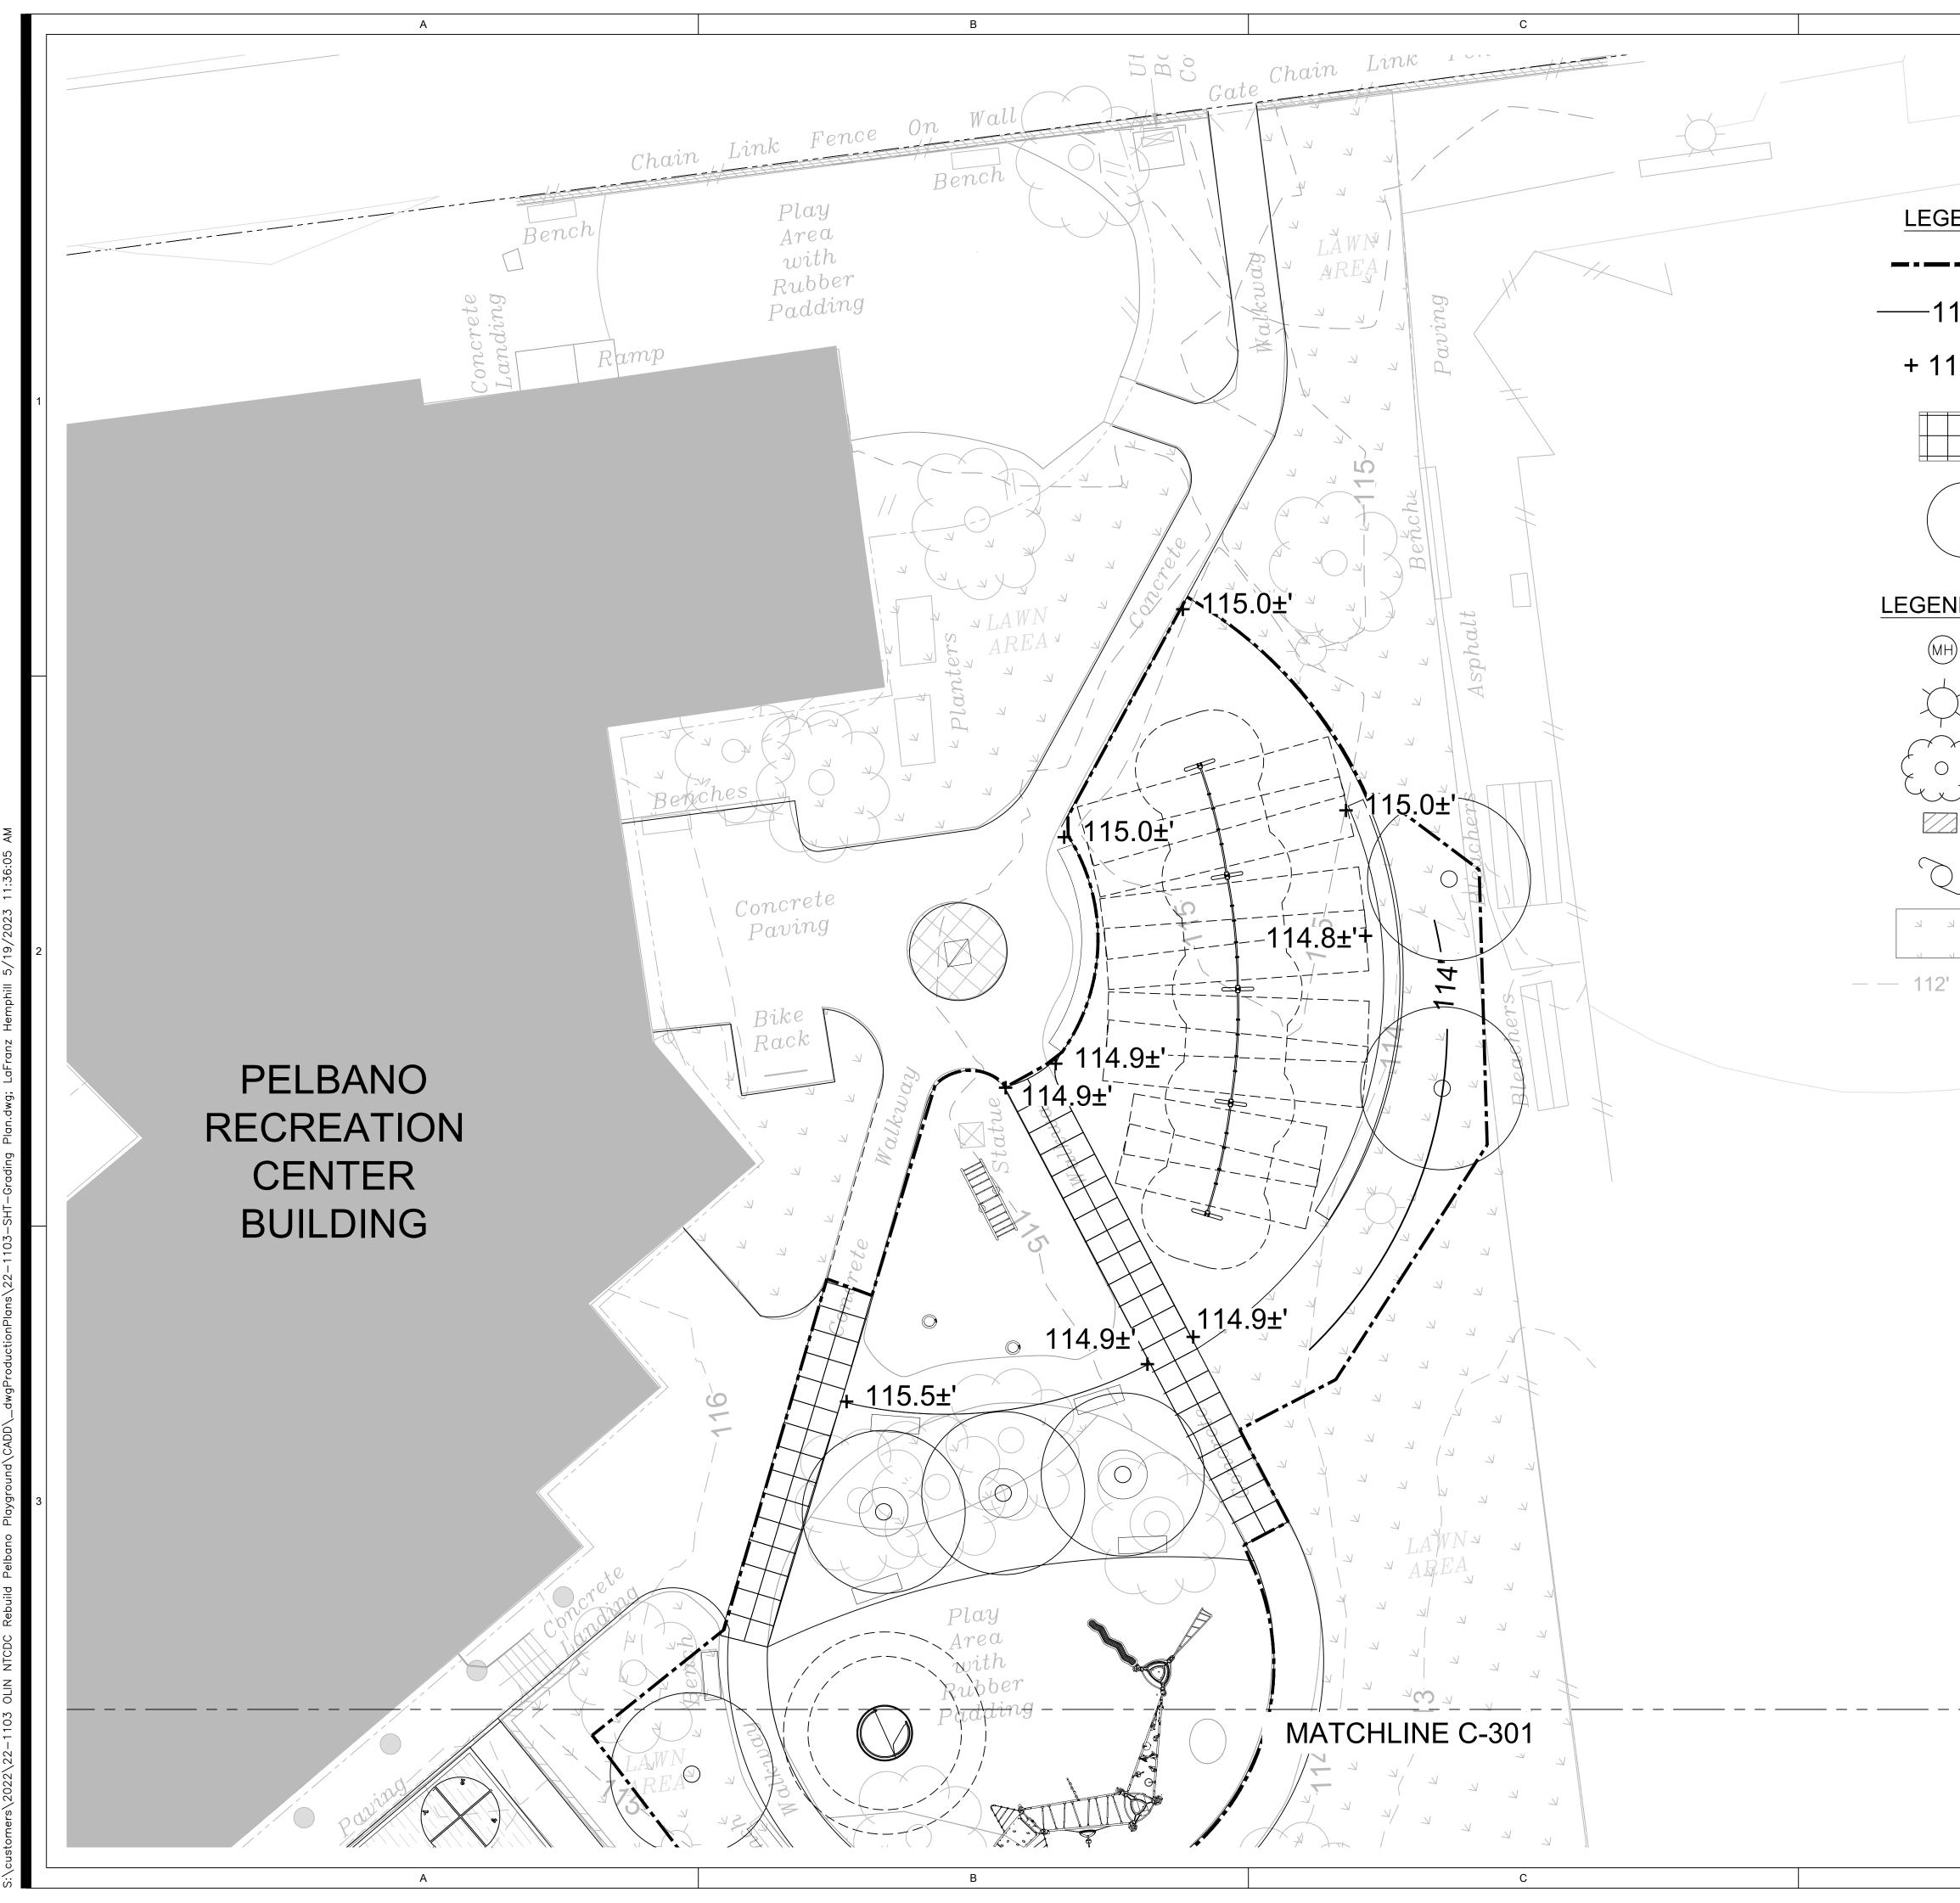
### DEMOLITION PLAN

Scale:	1" = 10'
Date:	5/31/2023
Drawn:	TPM
Checked:	AMH
Project No.:	2224



CONCRETE DEMOLITION AREAS





GEND (PR	OPOSED)
	LIMIT OF DISTURBANCE (14,600 S.F.)
112—	CONTOUR LABEL
12.0'	SPOT GRADE
	CONCRETE SIDEWALK REPLACEMENT (COORDINATE W/ LANDSCAPE ARCH. PLANS)
0	NEW TREE PLANTING (COORDINATE W/ LANDSCAPE ARCH. PLANS)
ND (EXIS	TING CONDITIONS)

D

LIGHT POLE

MANHOLE


TREE/SHRUB

CATCH BASIN

UTILITY POLE

LAWN/GRASS AREAS

— — 112' — CONTOUR LABEL

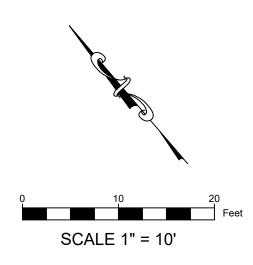

## PELBANO PLAYGROUND

### 8101 BUSTLETON AVENUE

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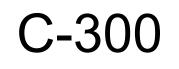
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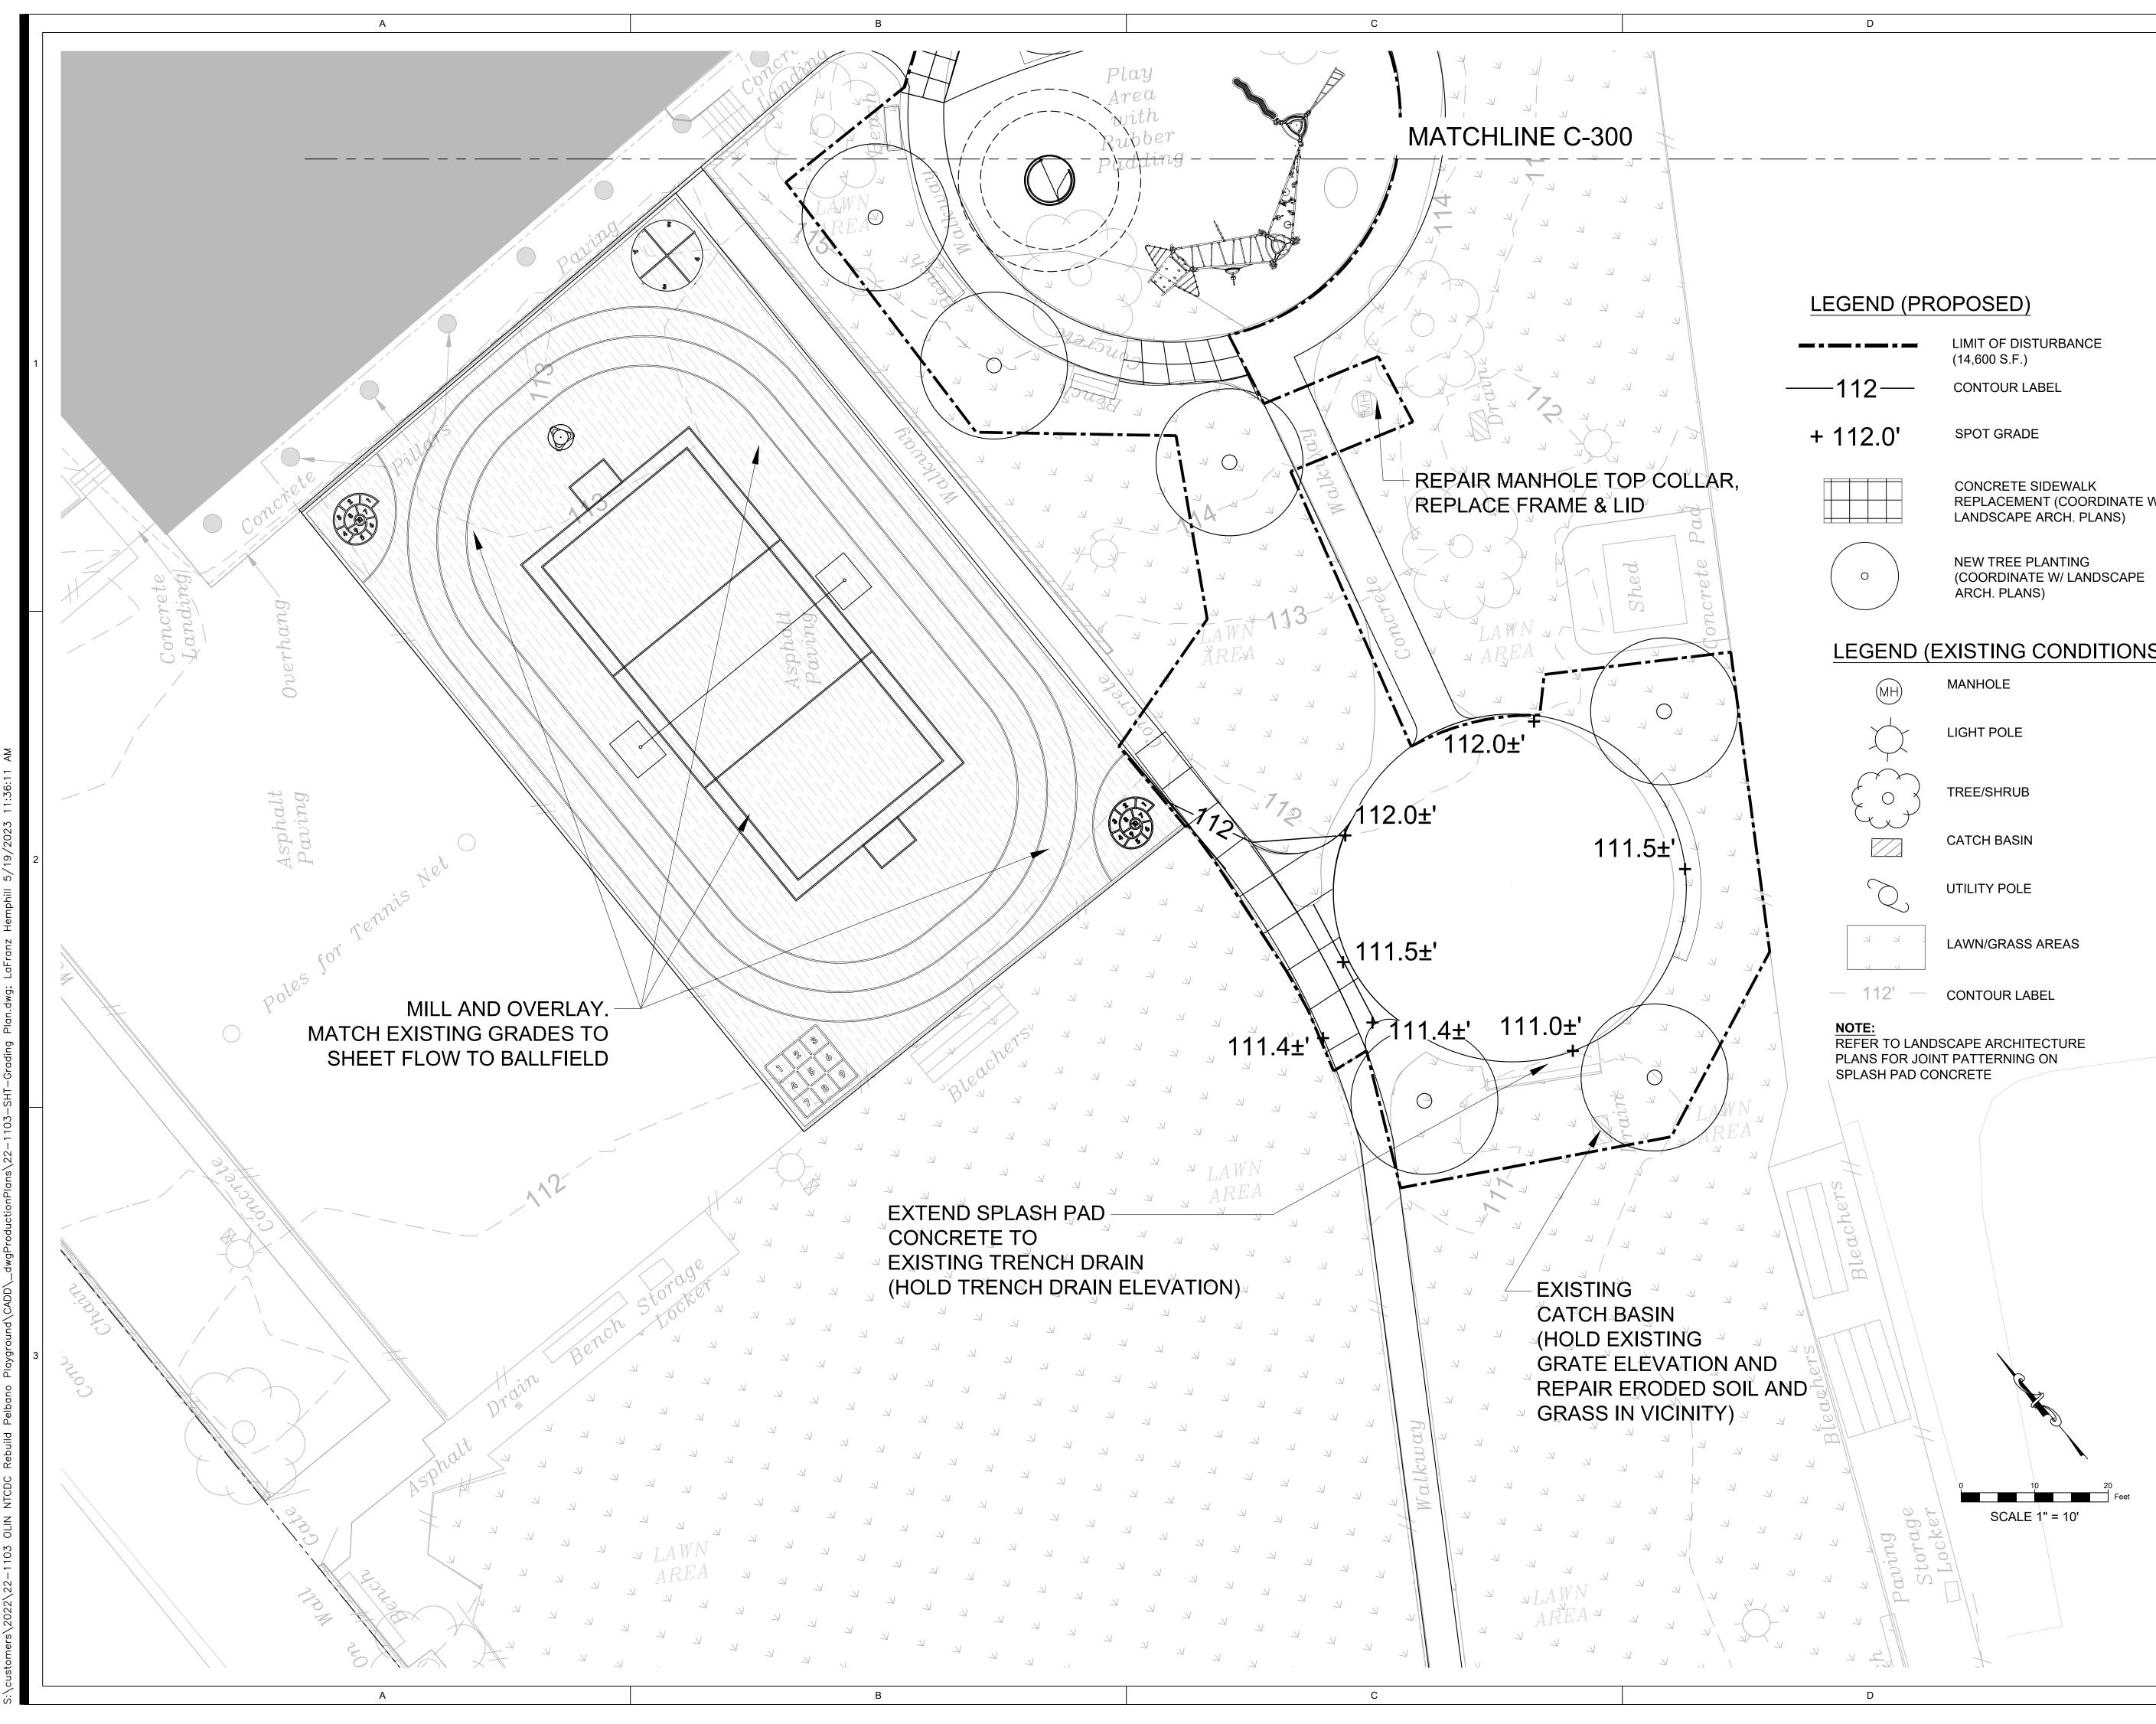
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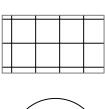
### GRADING PLAN (1 OF 2)

Scale:	1" = 10'
Date:	5/31/2023
Drawn:	TPM
Checked:	AMH
Project No.:	2224






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REPLACEMENT (COORDINATE W/

## LEGEND (EXISTING CONDITIONS)



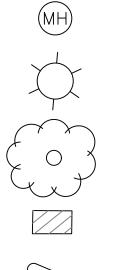

## PELBANO PLAYGROUND

### 8101 BUSTLETON AVENUE

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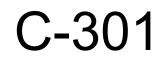
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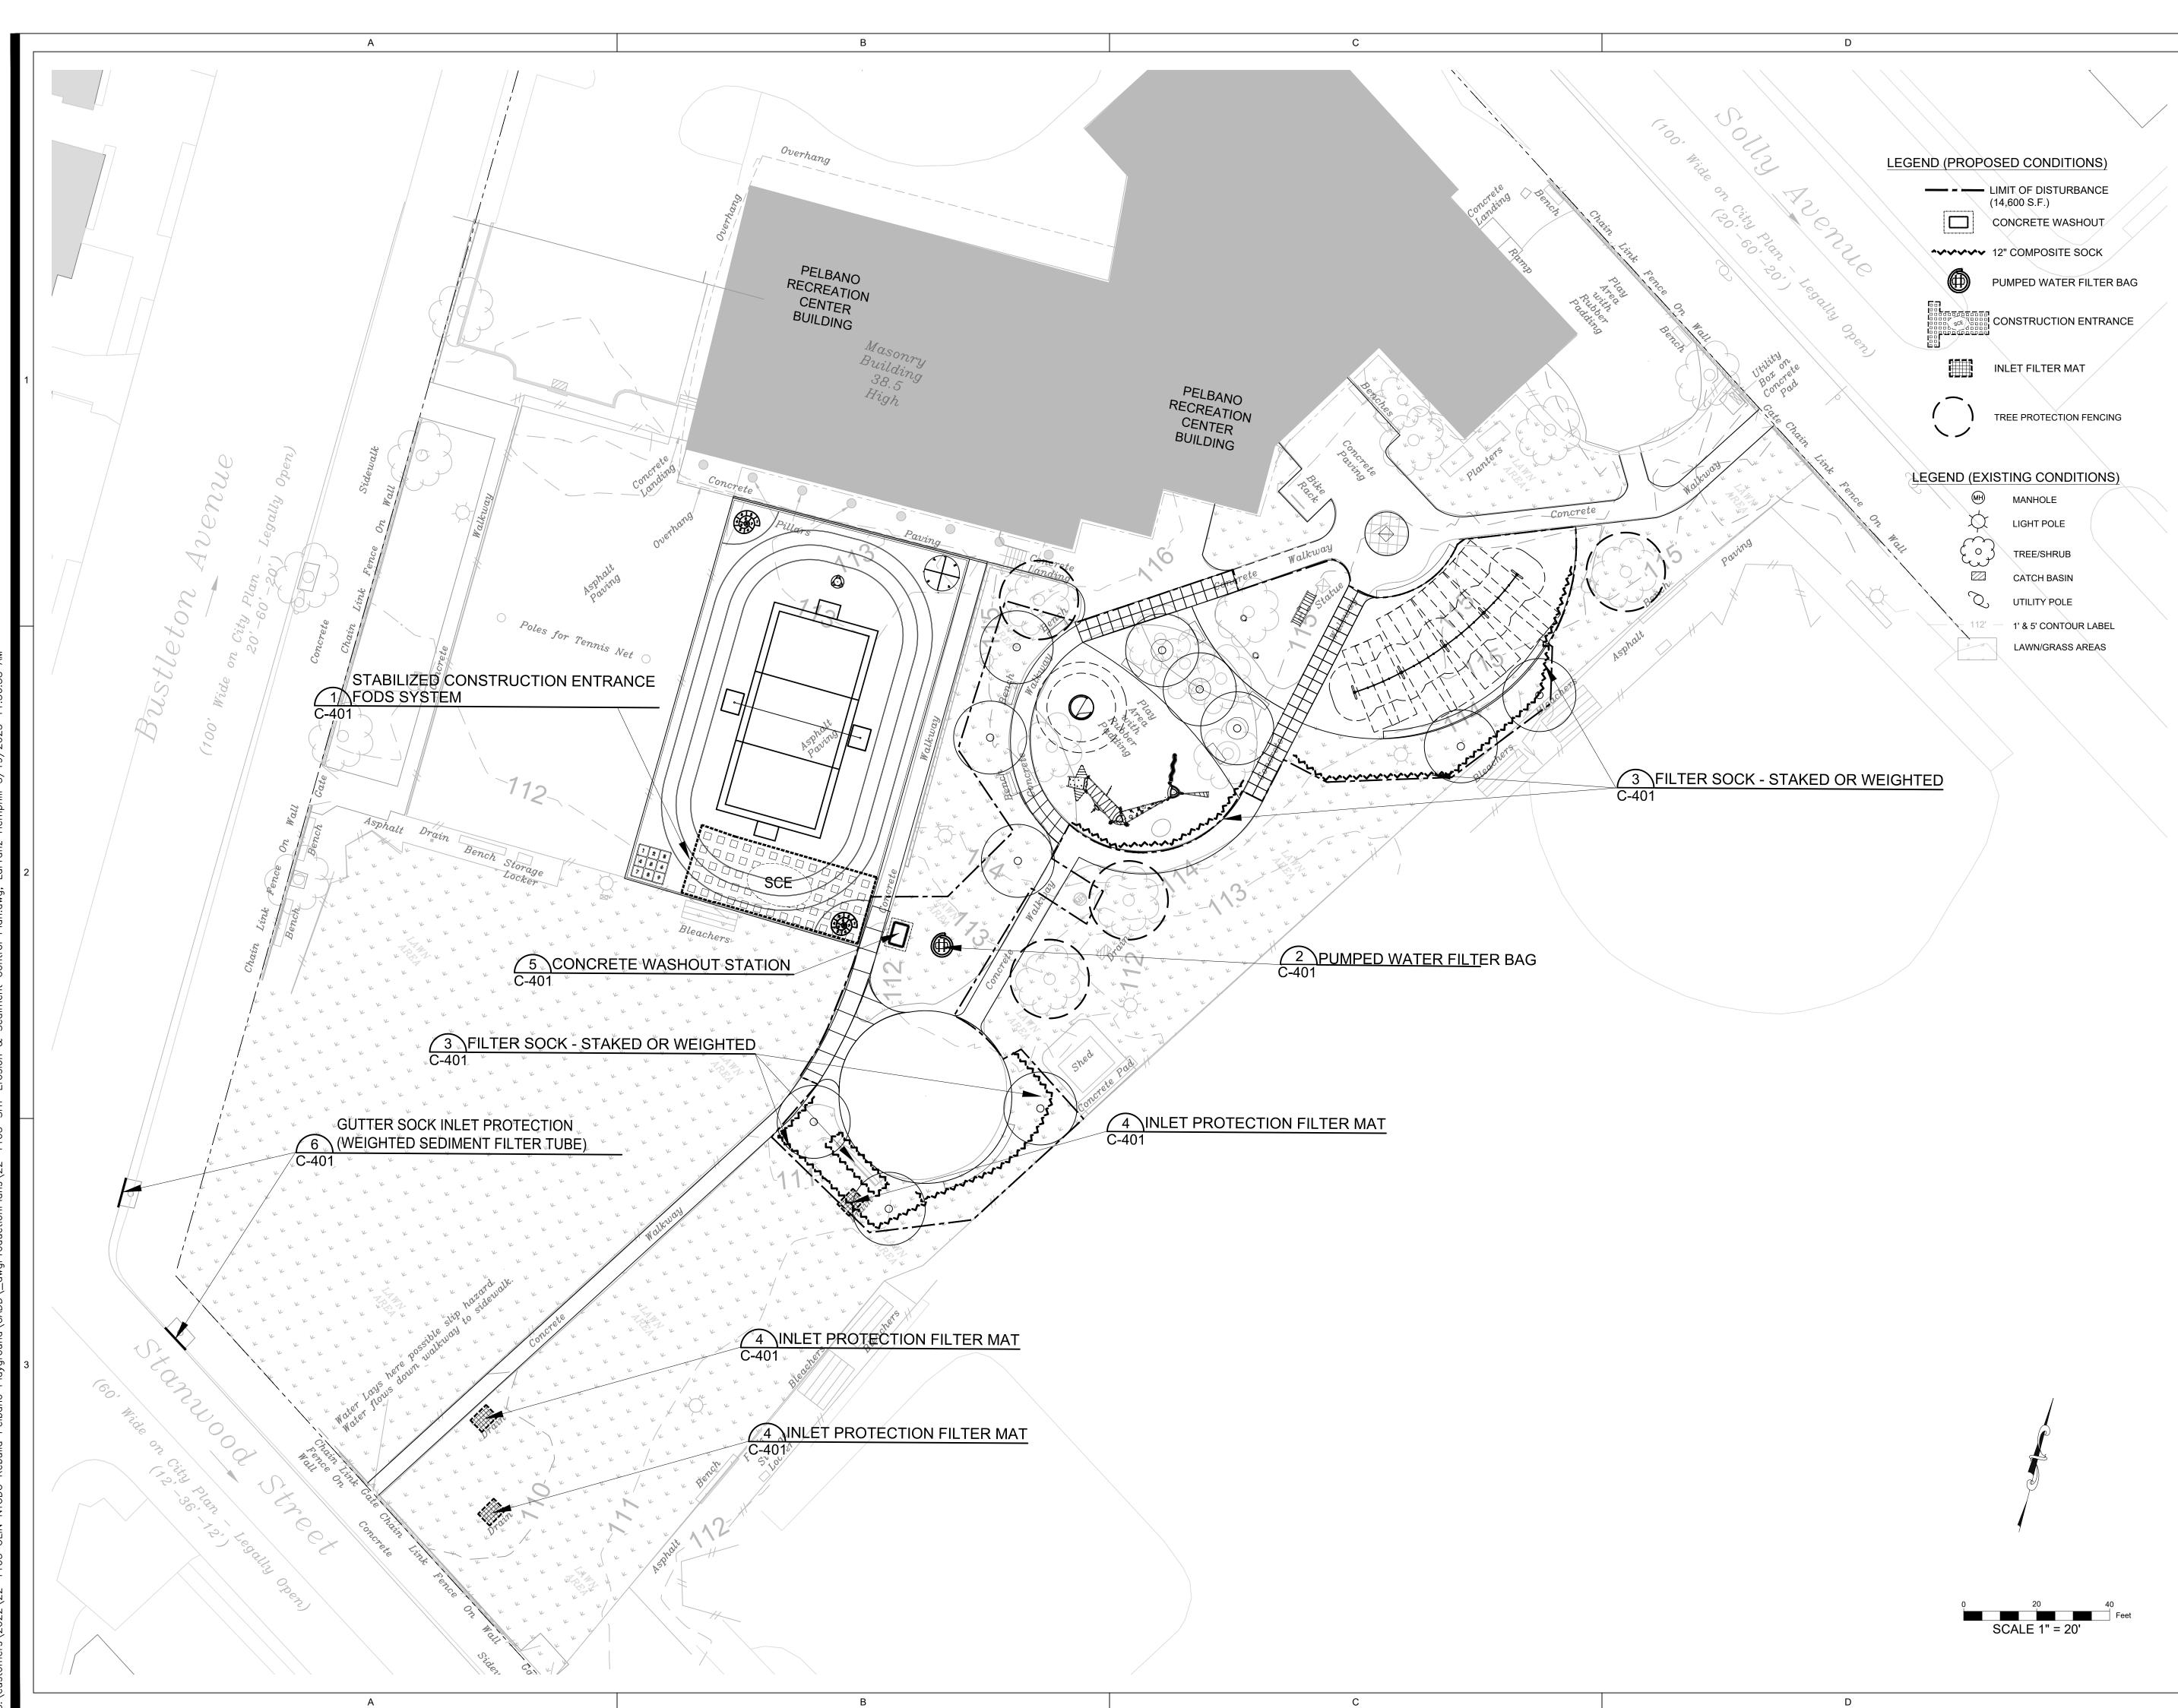
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### GRADING PLAN (2 OF 2)

1" = 10'
5/31/2023
TPM
AMH
2224





8101 BUSTLETON AVENUE

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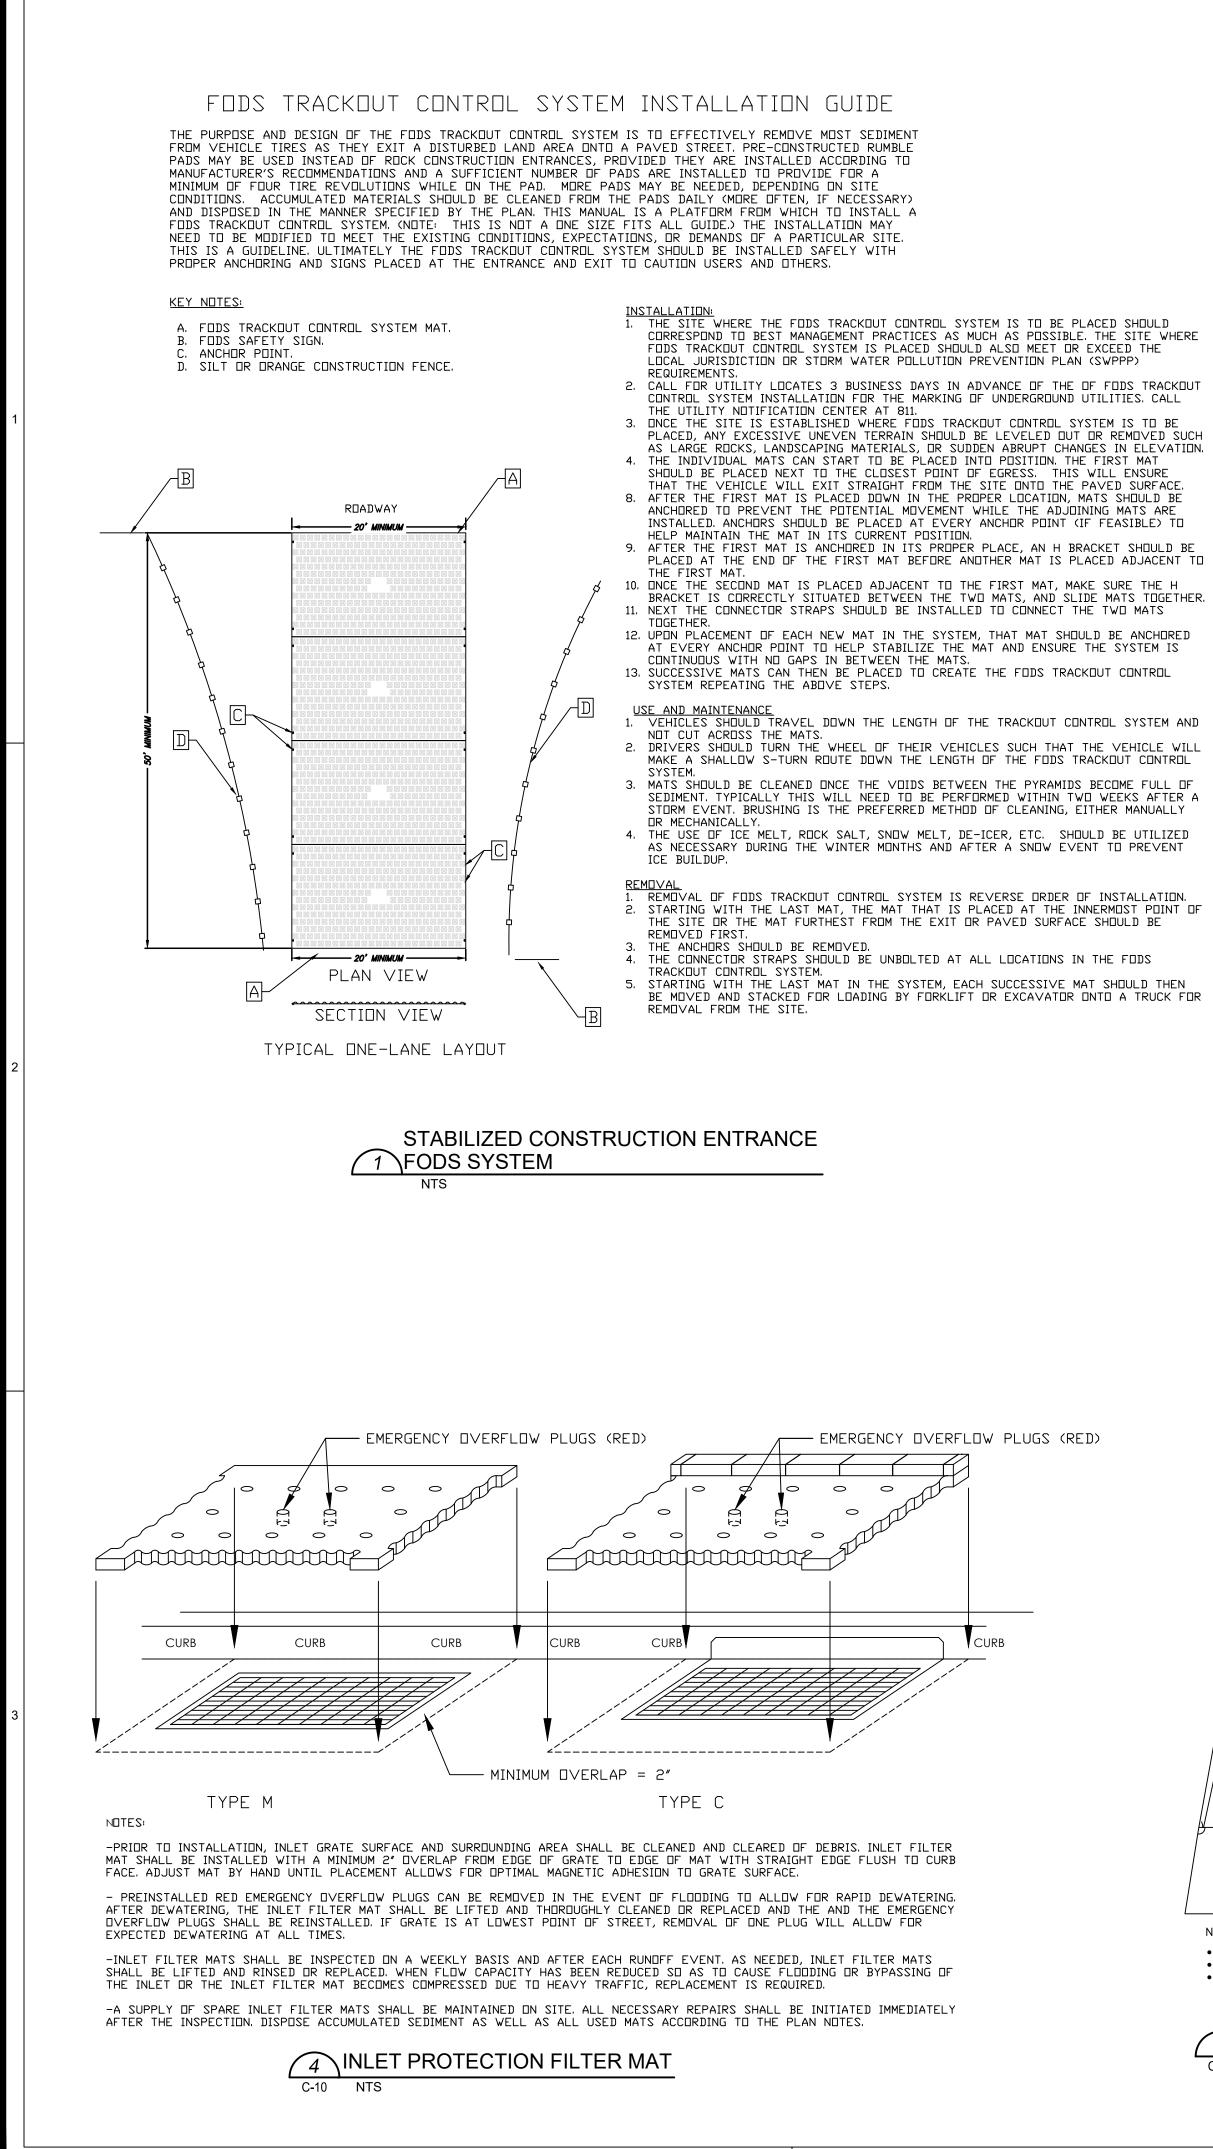
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EROSION AND SEDIMENT CONTROL PLAN

Scale:	1" = 10
Date:	5/31/2023
Drawn:	TPM
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Project No.:	2224





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FILTER BAG

PLAN VIEW

FILTER BAG

DISCHARGE HOSE

WELL VEGETATED, GRASSY AREA


HEAVY DUTY LIFTING STRAPS

(RECOMMENDED)

CLAMPS

PUMP

CLAMPS

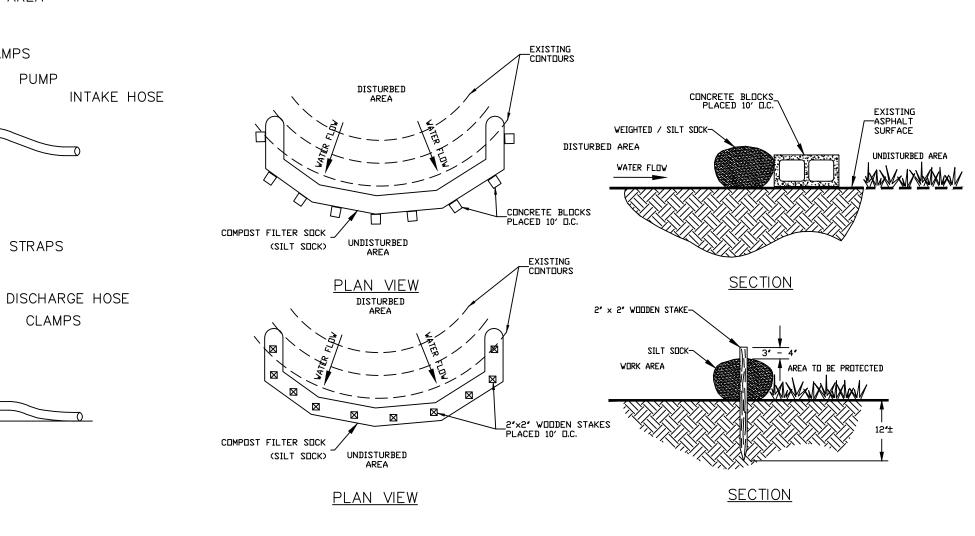

D

TO THE MAIN ALIGNMENT. FIGURE, BELOW.

- SUPPLEMENT.

C-10

### WELL VEGETATED, GRASSY AREA PUMP INTAKE HOSE ELEVATION VIEW NDTES:

LOW VOLUME FILTER BAGS SHALL BE MADE FROM NON-WOVEN GEDTEXTILE MATERIAL SEWN WITH HIGH STRENGTH. DOUBLE STITCHED "J" TYPE SEAMS, THEY SHALL BE CAPABLE OF TRAPPING PARTICLES LARGER THAN 150 MICRONS, HIGH VOLUME FILTER BAGS SHALL BE MADE FROM WOVEN GEDTEXTILES THAT MEET THE FOLLOWING STANDARDS:

PROPERTY	TEST METHOD	MINIMUM STANDARD
AVGAS. WIDE WIDTH STRENGTH	ATM D-4884	60 LB/IN
GRAB TENSILE	ATM D-4632	205 LB
PUNCTURE	ATM D-4833	110 LB
MULLEN BURST	ATM D-3786	350 PSI
UV RESISTANCE	ATM D-4355	70%
OAS % RETAINED	ATM D-4751	80 SIEVE


A SUITABLE MEANS OF ACCESSING THE BAG WITH MACHINERY REQUIRED FOR DISPOSAL PURPOSES SHALL BE PROVIDED. FILTER BAGS SHALL BE REPLACED WHEN THEY BECOME 1/2 FULL OF SEDIMENT. SPARE BAGS SHALL BE KEPT AVAILABLE FOR REPLACEMENT OF THOSE THAT HAVE FAILED OR ARE FILLED. BAGS SHALL BE PLACED ON STRAPS TO FACILITATE REMOVAL UNLESS BAGS COME WITH LIFTING STRAPS ALREADY ATTACHED.

BAGS SHALL BE LOCATED IN WELL-VEGETATED (GRASSY) AREA, AND DISCHARGE ONTO STABLE, EROSION RESISTANT AREAS. WHERE THIS IS NOT POSSIBLE, A GEDTEXTILE UNDERLAYMENT AND FLOW PATH SHALL BE PROVIDED, BAGS MAY BE PLACED ON FILTER STONE TO INCREASE DISCHARGE CAPACITY, BAGS SHALL NOT BE PLACED ON SLOPES GREATER THAN 5%. FOR SLOPES EXCEEDING 5%, CLEAN ROCK OR OTHER NON-ERODIBLE AND NON-POLLUTING MATERIAL MAY BE PLACED UNDER THE BAG TO REDUCE SLOPE STEEPNESS.


NO DOWNSLOPE SEDIMENT BARRIER IS REQUIRED FOR MOST INSTALLATIONS. COMPOST BERM OR COMPOST FILTER SOCK SHALL BE INSTALLED BELOW BAGS LOCATED IN HQ OR EV WATERSHEDS, WITHIN 50 FEET OF ANY RECEIVING SURFACE WATER OR WHERE GRASSY AREA IS NOT AVAILABLE. THE PUMP DISCHARGE HOSE SHALL BE INSERTED INTO THE BAGS IN THE MANNER SPECIFIED BY THE MANUFACTURER AND SECURELY CLAMPED. A PIECE OF PVC PIPE IS RECOMMENDED FOR THIS PURPOSE THE PUMPING RATE SHALL BE NO GREATER THAN 750 GPM OR 1/2 THE MAXIMUM SPECIFIED BY THE MANUFACTURER, WHICHEVER IS LESS. PUMP INTAKES SHALL BE FLOATING AND SCREENED. FILTER BAGS SHALL BE INSPECTED DAILY. IF ANY PROBLEM IS DETECTED, PUMPING SHALL CEASE IMMEDIATELY AND NOT RESUME UNTIL THE PROBLEM IS CORRECTED.

## 2 PUMPED WATER FILTER BAG

С

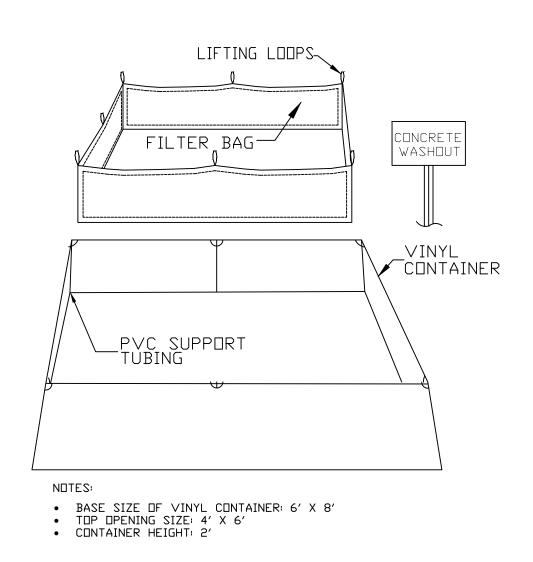

5 CONCRETE WASHOUT STATION C-10 NTS

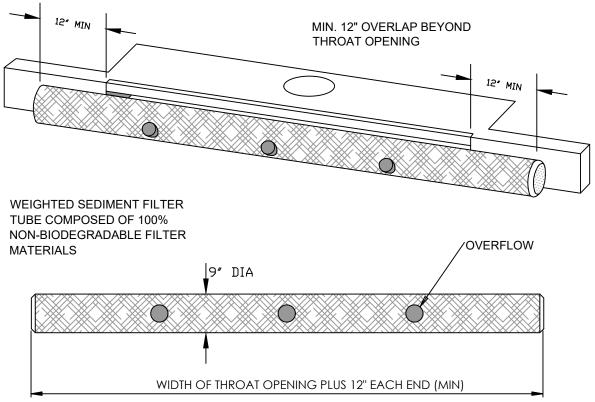

A SINGLE LENGTH OF WEIGHTED SEDIMENT FILTER TUBE SHALL BE USED AT EACH CURBED INLET LOCATION.

PLACE SEDIMENT FILTER TUBES ON A CLEAN (BROOM SWEPT) SURFACE. SEDIMENT TUBES SHALL BE INSPECTED WEEKLY AND AFTER EACH RUNOFF EVENT SEDIMENT DEPOSITS SHALL BE CLEANED FROM THE LOG WHEN IT REACHES HALF THE HEIGHT OF THE TUBE.

DAMAGED TUBES SHALL BE REPLACED WITHIN 24 HOURS OF INSPECTION. A SUPPLY OF TUBES SHALL BE MAINTAINED ON SITE FOR THIS PURPOSE.

> GUTTER SOCK INLET PROTECTION 6 (WEIGHTED SEDIMENT FILTER TUBE) C-10

• COMPOST FILTER SOCK MUST BE INSTALLED AT EXISTING LEVEL GRADE. BOTH ENDS OF EACH SILT SUCK SECTION MUST BE EXTENDED AT LEAST 8 FEET UPSLOPE AT 45 DEGREES • MAXIMUM SLOPE LENGTH ABOVE ANY SOCK SHALL NOT EXCEED THAT SHOWN ON THE • TRAFFIC SHALL NOT BE PERMITTED TO CROSS FILTER SOCKS.

• ACCUMULATED SEDIMENT SHALL BE REMOVED WHEN IT REACHES 1/2 THE ABOVE GROUND HEIGHT OF THE SOCK AND DISPOSED IN AN APPROVED MANNER. • SUCKS SHALL BE INSPECTED WEEKLY AND AFTER EACH RUNDFF EVENT. DAMAGED SDCKS SHALL BE REPAIRED ACCORDING TO MANUFACTURER'S SPECIFICATIONS OR REPLACED WITHIN 24 HOURS. BIDDEGRADABLE FILTER SOCKS SHALL BE REPLACED AFTER 6 MONTHS; PHOTODEGRADABLE SOCKS AFTER 1 YEAR. POLYPROPYLENE SOCKS SHALL BE REPLACED ACCORDING TO MANUFACTURER'S RECOMMENDATIONS. • UPON STABILIZATION OF THE AREA TRIBUTARY TO THE SOCK, STAKES SHALL BE REMOVED. THE SOCK MAY BE LEFT IN PLACE AND VEGETATED OR REMOVED. IN THE LATTER CASE, THE MESH SHALL BE CUT DPEN AND THE MULCH SPREAD AS A SDIL

> 3 FILTER SOCK - STAKED OR WEIGHTED NTS

## PELBANO PLAYGROUND

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### **EROSION AND SEDIMENT CONTROL** DETAILS

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### **EROSION AND SEDIMENTATION CONTROL NARRATIVE**

Α

REFERENCE SOURCE:

PENNSYLVANIA DEPARTMENT OF ENVIRONMENTAL PROTECTION (DEPARTMENT), "EROSION AND SEDIMENT POLLUTION CONTROL PROGRAM MANUAL" ISSUED MARCH 2012, WITH SUBSEQUENT CORRECTIONS AND ADDITIONS.

THE FOLLOWING E&S BEST MANAGEMENT PRACTICES (BMPS) WILL FUNCTION TO CONTROL RUNOFF AND PROVIDE SEDIMENT REMOVAL DURING DEVELOPMENT AT THE SUBJECT SITE AND CONSTRUCTION OF THE ASSOCIATED STORMWATER FACILITIES. THESE BMPS ARE:

- 1. FODS CONSTRUCTION ENTRANCE,
- 2. PUMPED WATER FILTER BAG, 3. COMPOST FILTER SOCK,
- 4. GUTTER SOCK INLET PROTECTION (WEIGHTED SEDIMENT FILTER TUBE),
- 5. FILTER MAT INLET PROTECTION,
- 6. CONCRETE WASHOUT STATION, 7. TEMPORARY AND PERMANENT SEEDING.

### STABILIZED CONSTRUCTION ENTRANCE (FODS)

A STABILIZED CONSTRUCTION ENTRANCE IS TO BE INSTALLED WHEREVER IT IS ANTICIPATED THAT CONSTRUCTION TRAFFIC WILL EXIT THE PROJECT SITE ONTO ANY ROADWAY, PUBLIC OR PRIVATE. ACCESS TO THE SITE WILL BE LIMITED TO A STABILIZED CONSTRUCTION ENTRANCE LOCATION.

LOCATION(S) OF THE CONSTRUCTION ENTRANCE(S) ARE SHOWN ON THE EROSION & SEDIMENT CONTROL PLAN AND SHALL BE CONSTRUCTED PER THE STABILIZED CONSTRUCTION ENTRANCE DETAIL.

A FOREIGN OBJECT DEBRIS SYSTEM (FODS) TRACKOUT CONTROL (OR APPROVED EQUAL) WILL BE UTILIZED FOR THIS SITE.

INSTALLATION:

- GENERAL DESIGN STANDARDS FOLLOWED ARE THOSE OF PADEP BUREAU OF WATER QUALITY PROTECTION.
- GENERAL DESIGN STANDARDS FOLLOWED ARE THOSE OF PADEP BUREAU OF WATER QUALITY PROTECTION.
- INSTALL FODS SYSTEM PER MANUFACTURER'S SPECIFICATION.
- DO NOT INSTALL FOD MATS AT A LOW POINT OF THE SITE WHERE WATER WILL POOL.

INSPECTION AND MAINTENANCE:

- MAINTAIN FODS IN A CONDITION THAT WILL PREVENT TRACKING OR FLOWING OF SEDIMENT ONTO THE PUBLIC RIGHT-OF-WAYS.
- CLEAN FOD MATS USING A SKID STEER BOOM ATTACHMENT WHEN SEDIMENT IS NEAR THE TOP OF THE PYRAMIDS IN THE LANE OF TRAVEL.
- ALL SEDIMENT SPILLED, WASHED OR TRACKED ONTO PUBLIC ROADWAYS WILL BE IMMEDIATELY REMOVED AND RETURNED TO THE CONSTRUCTION SITE.
- **PUMPED WATER FILTER BAG:**

WHENEVER WATER IS PUMPED FROM AN EXCAVATION OR DISTURBED AREA, IT WILL BE TREATED FOR SEDIMENT REMOVAL PRIOR TO DISCHARGE TO A SURFACE WATER.

THE TOPOGRAPHY AND CONDITIONS OF THE GROUND COVER BETWEEN THE DISCHARGE POINT AND THE RECEIVING SURFACE WATER WILL BE EVALUATED FOR POTENTIAL EROSION. APPROPRIATE STABILIZATION MEASURES WILL BE INCORPORATED TO PREVENT EROSION INCLUDING THE USE OF A SILT SOCK ENCIRCLING THE PUMPED WATER FILTER BAG TO ENHANCE SEDIMENT REMOVAL EFFICIENCY OF THE FILTER BAG.

PUMPED WATER FILTER BAGS WILL BE INSTALLED ACCORDING TO THE DETAILS SHOWN ON THE E&S DETAIL SHEET.

INSTALLATION:

- PUMPING RATES WILL VARY DEPENDING ON THE SIZE OF THE FILTER BAG, AND THE TYPE AND AMOUNT OF SEDIMENT DISCHARGED TO THE BAG.
- LOW VOLUME FILTER BAGS SHALL BE MADE FROM NON-WOVEN GEOTEXTILE MATERIAL SEWN WITH HIGH-STRENGTH, DOUBLE-STITCHED "J" TYPE SEAMS. THEY SHALL BE CAPABLE OF TRAPPING PARTICLES LARGER THAN 150 MICRONS. HIGH VOLUME FILTER BAGS MAY BE MADE FROM WOVEN GEOTEXTILES.
- PUMPED WATER FILTER BAGS SHALL BE LOCATED IN WELL-VEGETATED (GRASSY) AREAS AND DISCHARGED ONTO STABLE, EROSION-RESISTANT AREAS. WHERE THIS IS NOT POSSIBLE, A GEOTEXTILE UNDERLAYMENT AND FLOW PATH SHALL BE PROVIDED. BAGS MAY BE PLACED ON FILTER STONE TO INCREASE CAPACITY.

- TO REDUCE SLOPE STEEPNESS.
- INSTALLATIONS. COMPOST BERMS, COMPOST FILTER SOCKS, OR SILT SOCKS
- PIECE OF PVC PIPE IS RECOMMENDED.

INSPECTION AND MAINTENANCE

- FOR DISPOSAL PURPOSES.
- FULL.
- HAVE FAILED OR ARE FILLED.
- STRAPS TO FACILITATE REMOVAL.
- PUMPED WATER FILTER BAGS SHALL BE INSPECTED DAILY.
- IS CORRECTED.

### COMPOST FILTER SOCK:

FILTER SOCK IS USED TO CONTROL RUNOFF FROM DISTURBED AREAS WHEN THE RUNOFF IS IN THE FORM OF SHEET FLOW AND THE DISCHARGE IS TO A STABLE AREA. THIS BEST MANAGEMENT PRACTICE (BMP) IS ABACT (ANTIDEGRADATION BEST AVAILABLE COMBINATION OF TECHNOLOGIES) FOR HIGH QUALITY (HQ) AND EXCEPTIONAL VALUE (EV) WATERSHEDS. FILTER SOCK CONSISTS OF A BIODEGRADABLE OR PHOTODEGRADABLE MESH TUBE FILLED WITH A COARSE COMPOST FILTER MEDIA THAT MEETS CERTAIN PERFORMANCE CRITERIA (E.G., HYDRAULIC FLOW THROUGH RATE, TOTAL SOLIDS REMOVAL EFFICIENCY, TOTAL SUSPENDED SOLIDS REMOVAL EFFICIENCY, TURBIDITY REDUCTION, NUTRIENT REMOVAL EFFICIENCY, METALS REMOVAL EFFICIENCY, AND MOTOR OIL REMOVAL EFFICIENCY).

### DESIGN CRITERIA:

- THE SOCK AT IMPACT AND RELATIVELY UNCONCENTRATED.
- EVENTS.
- BE USED TO SELECT SOCK DIAMETER.

MATERIALS:

COMPOSTED PRODUCTS: COMPOST USED FOR FILTER SOCK SHALL BE WEED FREE AND DERIVED FROM A WELL-DECOMPOSED SOURCE OF ORGANIC MATERIAL. THE COMPOST SHALL BE PRODUCED USING AN AEROBIC COMPOSTING PROCESS MEETING CFR 503 REGULATIONS, INCLUDING TIME

### NO DOWNSLOPE SEDIMENT BARRIER IS REQUIRED FOR MOST

SHALL BE INSTALLED BELOW BAGS LOCATED WITHIN 50 FEET OF RECEIVING STREAM OR WHERE A GRASSY AREA IS NOT AVAILABLE. A COMPOST BERM OR COMPOST FILTER SOCK SHALL BE PLACED BELOW ANY BAG DISCHARGING TO A SPECIAL PROTECTION SURFACE WATER. PUMPED WATER FILTER BAGS SHALL NOT BE PLACED WITHIN 50 FEET OF A RECEIVING STREAM.

THE PUMP DISCHARGE HOSE SHALL BE INSERTED INTO THE BAGS IN THE MANNER SPECIFIED BY THE MANUFACTURER AND SECURELY CLAMPED. A

THE PUMPING RATE SHALL BE NO GREATER THAN 750 GALLONS PER MINUTE OR LESS THAN THE MAXIMUM SPECIFIED BY THE MANUFACTURER. WHICHEVER IS LESS. PUMP INTAKES SHALL BE FLOATING AND SCREENED.

A SUITABLE MEANS OF ACCESSING THE BAGS WITH MACHINERY IS REQUIRED

PUMPED WATER FILTER BAGS SHALL BE REPLACED WHEN THEY BECOME 1/2

SPARE BAGS SHALL BE KEPT AVAILABLE FOR REPLACEMENT OF THOSE THAT

• IT IS RECOMMENDED THAT THE PUMPED WATER FILTER BAGS BE PLACED ON

 IF ANY PROBLEM WITH THE PUMPED WATER FILTER BAG IS DETECTED. PUMPING SHALL CEASE IMMEDIATELY AND NOT RESUME UNTIL THE PROBLEM

## • THE SEDIMENTATION REMOVAL PROCESS ASSOCIATED WITH FILTER SOCK INVOLVES BOTH FILTERING AND DEPOSITION FROM SETTLING. THIS IS

DIFFERENT THAN OTHER METHODS USING ONLY PONDING FOR DEPOSITION OF SEDIMENT. PONDING OCCURS WHEN WATER FLOWING TO THE SOCK ACCUMULATES FASTER THAN IT CAN FLOW THROUGH THE SOCK.

 LEVEL CONTOUR: PLACE FILTER SOCK ON LEVEL CONTOURS TO ASSIST IN DISSIPATING FLOW INTO SHEET FLOW RATHER THAN CONCENTRATED FLOWS. DO NOT CONSTRUCT SOCK SUCH THAT IT CONCENTRATES RUNOFF OR CHANNEL WATER. SHEET FLOW OF WATER SHOULD BE PERPENDICULAR TO

• FLAT SLOPES: WHEN POSSIBLE, PLACE SOCK AT A FIVE (5) FEET OR GREATER DISTANCE AWAY FROM THE TOE OF SLOPE IN ORDER FOR THE WATER COMING FROM THE SLOPE TO MAXIMIZE SPACE AVAILABLE FOR SEDIMENT DEPOSIT.

FLOW AROUND ENDS: IN ORDER TO PREVENT WATER FLOWING AROUND THE ENDS OF FILTER SOCK, THE ENDS OF THE SOCK MUST BE CONSTRUCTED POINTING UPSLOPE SO THE ENDS ARE AT A HIGHER ELEVATION. BE SURE TO STAKE THE ENDS OF THE SOCK TO PREVENT MOVEMENT DURING HIGH FLOW

• RATIO OF SLOPE LENGTH TO FILTER SOCK SIZE: THE SIZE (DIAMETER) OF THE SILT SOCK IS DEPENDENT ON THE SLOPE OF THE GROUND AND THE SLOPE LENGTH ABOVE THE SOCK. FIGURE 4.2 (MAXIMUM PERMISSIBLE SLOPE LENGTH ABOVE COMPOST FILTER SOCKS) IN THE DEPARTMENT'S "EROSION AND SEDIMENT POLLUTION CONTROL PROGRAM MANUAL" (MARCH 2012) SHALL AND TEMPERATURE DATA INDICATING EFFECTIVE WEED SEED, PATHOGEN AND INSECT LARVAE KILL.

С

THE COMPOST SHALL BE FREE OF ANY REFUSE, CONTAMINANTS OR OTHER MATERIALS TOXIC TO PLANT GROWTH, NON-COMPOSTED PRODUCTS WILL NOT BE ACCEPTED. TEST METHODS FOR THE ITEMS BELOW SHOULD FOLLOW USCC TMECC GUIDELINES FOR LABORATORY PROCEDURES:

- PH 5.0 8.0 IN ACCORDANCE WITH TMECC 04.11-A, "ELECTROMETRIC a. PH DETERMINATIONS FOR COMPOST,"
- PARTICLE SIZE 99% PASSING A 2" SIEVE AND A MINIMUM OF 60% b. GREATER THAN THE 3/8" SIEVE, IN ACCORDANCE WITH TMECC 02.02-B, "SAMPLE SIEVING FOR AGGREGATE SIZE CLASSIFICATION." (NOTE - IN THE FIELD, PRODUCT COMMONLY IS BETWEEN 1/2" AND 2" PARTICLE SIZE.).
- MOISTURE CONTENT OF LESS THAN 60 PERCENT IN ACCORDANCE C. WITH STANDARDIZED TEST METHODS FOR MOISTURE DETERMINATION,
- MATERIAL SHALL BE RELATIVELY FREE (<1 PERCENT BY DRY WEIGHT) d. OF INERT OR FOREIGN MAN-MADE MATERIALS, AND
- A SAMPLE SHALL BE SUBMITTED TO THE ENGINEER FOR APPROVAL PRIOR TO BEING USED AND MUST COMPLY WITH ALL LOCAL, STATE AND FEDERAL REGULATIONS.

### INSTALLATION:

- DISPERSING FLOW: SHEET FLOW AND RUNOFF SHOULD NOT EXCEED HEIGHT OF THE SOCK CAPACITY IN MOST STORM EVENTS. IF OVERFLOW OF THE SOCK IS A POSSIBILITY, LARGER SOCK SHOULD BE CONSTRUCTED, OR OTHER POSSIBLE SEDIMENT CONTROL TOOLS MAY BE USED. ALTERNATIVELY, A SECOND SET OF SOCK MAY BE CONSTRUCTED OR USED IN COMBINATION WITH COMPOST BLANKETS TO PREVENT SEDIMENT FROM MOVING.
- STAKES SHALL BE INSTALLED / DRIVEN THROUGH THE MIDDLE OF THE FILTER SOCK ON 10-FOOT CENTERS USING 2" x 2" x 3' WOODEN STAKES.
- IN THE EVENT THAT STAKING IS NOT POSSIBLE (SUCH AS ON ASPHALT OR CONCRETE SURFACES), HEAVY CONCRETE BLOCKS SHALL BE USED BEHIND THE SILT SOCK TO HELP STABILIZE DURING RAINFALL RUNOFF EVENTS. STAKING DEPTH FOR SAND AND SILT LOAM SOILS SHALL BE 12 INCHES AND 8 INCHES FOR CLAY SOILS.
- LOOSE COMPOST MAY BE BACKFILLED ALONG THE UPSLOPE SIDE OF THE • FILTER SOCK, FILLING THE SEAM BETWEEN THE SOIL SURFACE AND THE DEVICE, IMPROVING FILTRATION AND SEDIMENT RETENTION.
- FILTER SOCK IS NOT TO BE USED IN PERENNIAL, INTERMITTENT OR EPHEMERAL STREAMS.

INSPECTION AND MAINTENANCE:

- FILTER SOCK WILL BE INSPECTED WEEKLY AND AFTER EVERY PRECIPITATION EVENT. ANY NECESSARY REPAIRS WILL BE MADE WITHIN 24 HOURS OF INSPECTION.
- ACCUMULATED SEDIMENTS WILL BE REMOVED AS REQUIRED TO KEEP THE • SOCK FUNCTIONAL. IN ALL CASES, DEPOSITS WILL BE REMOVED WHEN ACCUMULATIONS REACH 1/2 THE ABOVEGROUND HEIGHT OF THE SOCK.
- SEDIMENT ACCUMULATED BEHIND THE SOCK WILL BE PLACED IN A • TEMPORARY STOCKPILE AREA LOCATED UPSLOPE AND BEHIND A BARRIER OR SEDIMENT REMOVAL STRUCTURE. ALL SEDIMENT REMOVED FROM BEHIND THE FILTER SOCK WILL BE IMMEDIATELY HAULED TO THE ABOVE REFERENCED BARRIER OR SEDIMENT REMOVAL STRUCTURE.
- ONCE THE SEDIMENT (REMOVED FROM BEHIND THE SOCK) HAS DRIED, IT • SHALL BE SPREAD AND SEEDED ACCORDING TO THE APPROVED SEEDING AND MULCHING SPECIFICATIONS OUTLINED ELSEWHERE IN THESE E&S NOTES.
- ALL SEDIMENT REMOVED FROM BEHIND THE SOCK, THAT WILL NOT BE PLACED ON-SITE, WILL BE DISPOSED IN A DEPARTMENT-APPROVED LANDFILL OR A COUNTY CONSERVATION DISTRICT APPROVED SOIL / ROCK DISPOSAL AREA.
- BIODEGRADABLE FILTER SOCK SHALL BE REPLACED AFTER SIX (6) MONTHS • AND PHOTODEGRADABLE SILT SOCKS REPLACED AFTER ONE (1) YEAR.

VEGETATION:

• FOR PERMANENT AREAS, SEEDED FILTER SOCK ALLOWS VEGETATION TO BE ESTABLISHED DIRECTLY IN THE SOCK AND IMMEDIATELY IN FRONT AND BACK OF THE SOCK AT A DISTANCE OF FIVE (5) FEET. VEGETATION ON AND AROUND THE SOCK WILL ASSIST IN SLOWING DOWN WATER FOR FILTRATION. THE OPTION OF ADDING VEGETATION WILL BE AT THE DISCRETION OF THE ENGINEER. NO OTHER SOIL AMENDMENTS OR FERTILIZER ARE REQUIRED FOR VEGETATION ESTABLISHMENT.

С

INSTALL GUTTER SOCK AT LOCATIONS SHOWN ON THE E&S CONTROL PLAN AND PER E&S NOTES AND DETAILS - GUTTER SOCK INLET PROTECTION.

MATERIALS:

• 100% NON-BIODEGRADABLE (SYNTHETIC) MATERIALS - NO NATURAL FIBERS OR ABSORBENT MATERIAL.

MAINTAIN STRUCTURAL INTEGRITY DURING NORMAL RAINFALL AND WET CONDITIONS

• FILTER SOCK WILL BE INSPECTED WEEKLY AND AFTER EVERY PRECIPITATION EVENT. DAMAGED OR CLOGGED SOCK WILL BE REPLACED WITHIN 24 HOURS OF INSPECTION.

ACCUMULATED SEDIMENTS WILL BE REMOVED AS REQUIRED TO KEEP THE SOCK FUNCTIONAL. IN ALL CASES, DEPOSITS WILL BE REMOVED WHEN ACCUMULATIONS REACH 1/2 THE ABOVEGROUND HEIGHT OF THE SOCK.

CLOGGED GUTTER SOCK MAY BE RINSED FOR REUSE. RINSING MAY BE CARRIED OUT UPSTREAM OF ANOTHER BARRIER SYSTEM, OR AT A CONCRETE WASHOUT STATION.

SEDIMENT ACCUMULATED BEHIND THE SOCK WILL BE PLACED IN A TEMPORARY STOCKPILE AREA LOCATED UPSLOPE AND BEHIND A BARRIER OR SEDIMENT REMOVAL STRUCTURE. ALL SEDIMENT REMOVED FROM BEHIND THE FILTER SOCK WILL BE IMMEDIATELY HAULED TO THE ABOVE REFERENCED BARRIER OR SEDIMENT REMOVAL STRUCTURE.

ONCE THE SEDIMENT (REMOVED FROM BEHIND THE SOCK) HAS DRIED, IT SHALL BE SPREAD AND SEEDED ACCORDING TO THE APPROVED SEEDING AND MULCHING SPECIFICATIONS OUTLINED ELSEWHERE IN THESE E&S NOTES.

 ALL SEDIMENT REMOVED FROM BEHIND THE SOCK, THAT WILL NOT BE PLACED ON-SITE, WILL BE DISPOSED IN A DEPARTMENT-APPROVED LANDFILL OR COUNTY CONSERVATION DISTRICT APPROVED SOIL / ROCK DISPOSAL AREA.

• PHOTODEGRADABLE SILT SOCKS SHALL BE REPLACED AFTER ONE (1) YEAR. POLYPROPYLENE SOCKS SHALL BE REPLACED ACCORDING TO MANUFACTURER'S RECOMMENDATIONS

INLET FILTER MATS ARE SEDIMENT CONTROL DEVICES USED TO PREVENT SILT FROM ENTERING THE EXISTING AND PROPOSED CATCH BASINS BY PREVENTING THE SILT AND SEDIMENT WHILE ALLOWING WATER TO PASS THROUGH FREELY. THEY FUNCTION TO REDUCE THE SEDIMENT DISCHARGED INTO STORM DRAINS DURING CONSTRUCTION.

INLET FILTER MATS WILL BE USED AT THE SUBJECT SITE AND IN THE GENERAL VICINITY FOR ANY PROPOSED OR EXISTING STRUCTURE WHERE THERE IS POTENTIAL FOR SEDIMENT TO ENTER WATERS OF THE COMMONWEALTH.

A SECONDARY BARRIER (18-INCH SILT SOCK ENCIRCLING AN INLET (WITH THE ENDS OF THE SILT SOCK FORMING A CIRCLE FASTENED TOGETHER WITH POLYETHYLENE CORDAGE) MAY BE EMPLOYED TO INCREASE EFFECTIVENESS OF THIS PRACTICE.

INLET PROTECTION WILL BE INSTALLED WHERE SHOWN ON THE E&S PLAN, AND PER INLET PROTECTION FILTER MAT DETAIL.

INSTALLATION:

BEFORE COVERING, MAKE SURE GRATE AND SURROUNDING AREA ARE FREE OF ANY DEBRIS OR GRIT SO MAGNETIC BOTTOM CAN FULLY CONTACT GRATE.

### GUTTER SOCK INLET PROTECTION (WEIGHTED SEDIMENT FILTER TUBE)

GUTTER SOCK INLET PROTECTION IS SIMILAR TO A WEIGHTED SEDIMENT FILTER TUBE AND IS DESIGNED TO CONTROL SEDIMENT AND PREVENT WATER POLLUTION. GUTTER SOCK INLET PROTECTION WILL BE USED FOR OPEN-MOUTH STORMWATER COLLECTION STRUCTURES (INLETS) WITHOUT GRATES. THEY ARE DESIGNED FOR END-TO-END INSTALLATION. UNLIKE STONE AND CONCRETE BLOCK INLET PROTECTION, THE GUTTER SOCK DOES NOT EXTEND INTO PAVED ROADWAYS.

CONTAIN NO WEEDS OR INVASIVE PLANTS AND RESIST MILDEW OR MOLD

 MUST MEET THE EPA'S TOXICITY CHARACTERISTICS LEACHATE PROCEDURE (TCLP) STANDARDS

• MUST MEET ASTM STANDARDS 5141 AND 7351 FOR WATER FLOW RATES, FILTRATION EFFICIENCIES AND TURBIDITY REMOVAL

MAINTAIN STRUCTURAL INTEGRITY OVER THE LENGTH OF THE PROJECT.

**INSTALLATION:** 

INSTALL PER MANUFACTURER'S SPECIFICATIONS.

**INSPECTION AND MAINTENANCE:** 

### **INLET PROTECTION FILTER MAT:**

## PELBANO PLAYGROUND

8101 BUSTLETON AVENUE

## OLIN

LANDSCAPE ARCHITECTURE / URBAN DESIGN / PLANNING ONE PENN CENTER 1617 JOHN F. KENNEDY BOULEVARD, SUITE 1900 PHILADELPHIA, PA 19103 TEL 215.440.0030 / FAX 215.440.0041 WWW.THEOLINSTUDIO.COM OLIN PARTNERSHIP, LTD.

Playground Design: Studio Ludo 4800 Springfield Ave Philadelphia, PA 19143 (215) 454-6780

Civil Engineering: Sci Tek 1880 John F Kennedy Blvd #600, Philadelphia, PA 19103 (267) 314-5385

MEP: Mark Ulrick 30 N. 41ST SUITE 500 Philadelphia, PA 19104 (856) 320-8100

No.	Date	Description
1	10/12/2022	SD set
2	11/16/2022	SD set
3	2/21/2023	DD set
4	4/17/2023	75% CD set
5	5/31/2023	100% CD set

### **EROSION AND SEDIMENT CONTROL** NOTES (1 OF 3)

cale:	1" = 10'	
)ate:	5/31/2023	
)rawn:	TPM	
checked:	AMH	
roject No.:	2224	



	LAY INLET FILTER MAT OVER GRATE. SLIGHTLY ADJUST TO FIND SNUGGEST	PERMANENT SEEDING AND MULCH
•	CONTACT OF MAGNETIC BOTTOM. REMOVE AT LEAST ONE RED OVERFLOW PLUG IF GRATE IS AT LOW POINT INLET. IN THE EVENT OF FLOODING, PULL THE SECOND PLUG TO DE-WATER	UPON COMPLETION OF CONSTRUC PERMANENTLY STABILIZED TO PRI STABILIZATION, SUCH AS PERMAN
•	THE STREET. THOROUGHLY CLEAN OFF SEDIMENT, LEAVES, AND OTHER DEBRIS AFTER EVERY RAIN EVENT.	PRESERVATION OF NATURAL VEGI NEEDS TO BE IMPLEMENTED FOR I FLUCTUATING DRAINAGE PATTERI DISTURBED AREA SHOULD BE STA
•	ONCE FULL OF SEDIMENT, INLET FILTER MAT SHOULD BE SWAPPED OUT FOR	<ul><li>GRADE HAS BEEN COMPLETED. FII</li><li>ALL SOIL DISTURBING ACTIV</li></ul>
INS	CLEANING USING A GARDEN OR POWER WASHER. PECTION AND MAINTENANCE:	A UNIFORM PERENNIAL VEG
•	EACH INLET FILTER MAT SHALL BE INSPECTED WEEKLY AND AFTER EVERY PRECIPITATION EVENT.	WITHOUT LARGE BARE AREA COVER FOR THE AREA, HAS AREAS NOT COVERED BY PE STABILIZATION MEASURES (3
•	IF FILTER MAT IS RUN OVER OFTEN AND BEGINNING TO COMPRESS IT SHOULD BE REPLACED.	OR GEOTEXTILES) HAVE BEE     ALL TEMPORARY EROSION A
•	THE REMOVED SEDIMENT MUST BE PLACED WHERE IT CANNOT ENTER A STORM DRAIN OR STREAM OR BE WASHED OFF-SITE. ALL SEDIMENT REMOVED FROM FILTER MATS, THAT WILL NOT BE PLACED ON-SITE, WILL BE DISPOSED IN A DEPARTMENT-APPROVED LANDFILL OR COUNTY CONSERVATION DISTRICT	REMOVED AND DISPOSED AI STABILIZED TO PREVENT FU PERMANENT VEGETATIVE COVER
•	APPROVED SOIL / ROCK DISPOSAL AREA. DAMAGED OR CLOGGED MATS SHALL BE REPLACED IMMEDIATELY. ALL NEEDED REPAIRS SHALL BE INITIATED IMMEDIATELY AFTER INSPECTION. A SUPPLY SHALL BE MAINTAINED ON-SITE FOR REPLACEMENT MATS.	OF THE SITE. THE VEGETATIVE CO THE SURFACE LAYERS WILL BE LIN ACCORDANCE WITH SOIL TEST RE BE INCORPORATED INTO THE SOIL SEEDING METHODS MAY BE USED. A MULCH AND WILL BE APPLIED TO MULCH PER ACRE).
<u>CON</u>	CRETE WASHOUT STATION:	AREAS RECEIVING PERMANENT VE EITHER PENNDOT SEED MIXTURE
CAL	ICRETE WASHOUT WATER IS A SLURRY CONTAINING TOXIC METALS THAT IS STIC AND CORROSIVE. IF CONCRETE WASHOUT WATER IS SPILLED ONTO THE DUND, IT CAN RUN OFF THE CONSTRUCTION SITE AND ENTER STORM DRAINS OR	PERMANENT SEED MIXTURE, RATE PERCENT PURITY AND GERMINATI THE TABLE.
THE OBJ	FACE WATERS. CONCRETE WASHOUT WATER CAN ALSO PERCOLATE THROUGH SOIL AND ALTER SOIL CHEMISTRY AND CONTAMINATE GROUNDWATER. THE BMP ECTIVE FOR CONCRETE WASHOUT WATER IS TO COLLECT AND RETAIN ALL THE SHOUT WATER AND SOLIDS IN A LEAK-PROOF CONTAINER.	MINIMUM SEED SPECIFICATIONS A FOR REVEGETATION PURPOSES S COMMONLY, SEEDLOTS ARE AVAIL SPECIFICATIONS.
SITE	PROJECTS ON WHICH CONCRETE WILL BE POURED OR OTHERWISE FORMED ON-	TEMPORARY BMPS WILL NOT BE R HAVE ACHIEVED THIS REQUIREME
WAS	ERS, AND HOPPERS OF THE DELIVERY VEHICLES. DIFFERENT TYPES OF HOUT STRUCTURES ARE AVAILABLE FOR COLLECTING AND RETAINING HOUT WATER. A PORTABLE PRE-FABRICATED VINYL WASHOUT CONTAINER (OR	SOIL SUPPLEMENTS:
	ROVED EQUAL) WILL BE USED AT THE SUBJECT SITE.	PREPARE AREAS FOR SEEDING BY
PLA	ICRETE WASH WATER SHALL BE HANDLED IN THE MANNER DESCRIBED ON THE N DRAWINGS. IN NO CASE SHALL IT BE ALLOWED TO ENTER ANY SURFACE TERS OR GROUNDWATER SYSTEMS.	BLEND THE INITIAL SOIL SUP TOPSOILED AREAS, BY RAKII METHODS. BLEND THE SUPP
CON LOC DRA	VINYL CONCRETE WASHOUT CONTAINER SHALL BE INSTALLED AT A LOCATION VENIENT TO THE LOCATION WHERE CONCRETE IS BEING POURED. A TYPICAL ATION FOR THE VINYL CONCRETE WASHOUT CONTAINER IS SHOWN ON THE E&S WING. A VINYL CONCRETE WASHOUT CONTAINER DETAIL IS SHOWN ON THE	<ul> <li>OPERATIONS.</li> <li>APPLY SLOW-RELEASE NITR AREAS BEFORE PROJECT CO</li> <li>APPLY SOIL SUPPLEMENTS A</li> </ul>
	DETAIL SHEET. ALLATION:	PULVERIZED AGRICULTURAL 800 LB/1000 SY
	PRE-FABRICATED VINYL WASHOUT CONTAINERS SHALL BE INSTALLED PER THE MANUFACTURER'S RECOMMENDATION.	10-20-20 ANALYSIS COMMER LB/1000 SY
•		
	POSITION THE CONTAINER ON A FLAT GRADE (I.E., SLOPES NOT EXCEEDING 2 PERCENT) AT A LOCATION BEST SUITED FOR THE CONSTRUCTION PROJECT.	38-0-0 UREAFORM FERTILIZE 50 L
•	PERCENT) AT A LOCATION BEST SUITED FOR THE CONSTRUCTION PROJECT. THE WASHOUT CONTAINER SHALL NOT BE PLACED WITHIN 50 FEET OF STORM	50 L OR
•	PERCENT) AT A LOCATION BEST SUITED FOR THE CONSTRUCTION PROJECT. THE WASHOUT CONTAINER SHALL NOT BE PLACED WITHIN 50 FEET OF STORM DRAINS, OPEN DITCHES, OR WATERBODIES. IF HEAVY RAINS ARE ANTICIPATED, THE WASHOUT CONTAINER SHALL BE	50 L
•	PERCENT) AT A LOCATION BEST SUITED FOR THE CONSTRUCTION PROJECT. THE WASHOUT CONTAINER SHALL NOT BE PLACED WITHIN 50 FEET OF STORM DRAINS, OPEN DITCHES, OR WATERBODIES.	50 L OR 32-0-0 TO 38-0-0 SULFUR CO/ 50 LB/1000 SY OR
•	PERCENT) AT A LOCATION BEST SUITED FOR THE CONSTRUCTION PROJECT. THE WASHOUT CONTAINER SHALL NOT BE PLACED WITHIN 50 FEET OF STORM DRAINS, OPEN DITCHES, OR WATERBODIES. IF HEAVY RAINS ARE ANTICIPATED, THE WASHOUT CONTAINER SHALL BE COVERED TO AVOID OVERFLOW DURING THE STORM. PECTION AND MAINTENANCE: THE CONCRETE WASHOUT SHALL BE INSPECTED DAILY AND AFTER EVERY RAINFALL EVENT TO CHECK FOR LEAKS OR DAMAGE TO THE CONTAINER BY	50 L OR 32-0-0 TO 38-0-0 SULFUR CO/ 50 LB/1000 SY
• • INSI	PERCENT) AT A LOCATION BEST SUITED FOR THE CONSTRUCTION PROJECT. THE WASHOUT CONTAINER SHALL NOT BE PLACED WITHIN 50 FEET OF STORM DRAINS, OPEN DITCHES, OR WATERBODIES. IF HEAVY RAINS ARE ANTICIPATED, THE WASHOUT CONTAINER SHALL BE COVERED TO AVOID OVERFLOW DURING THE STORM. PECTION AND MAINTENANCE: THE CONCRETE WASHOUT SHALL BE INSPECTED DAILY AND AFTER EVERY	50 L OR 32-0-0 TO 38-0-0 SULFUR CO/ 50 LB/1000 SY OR 31-0-0-0 IBDU FERTILIZER
• • INSF	PERCENT) AT A LOCATION BEST SUITED FOR THE CONSTRUCTION PROJECT. THE WASHOUT CONTAINER SHALL NOT BE PLACED WITHIN 50 FEET OF STORM DRAINS, OPEN DITCHES, OR WATERBODIES. IF HEAVY RAINS ARE ANTICIPATED, THE WASHOUT CONTAINER SHALL BE COVERED TO AVOID OVERFLOW DURING THE STORM. PECTION AND MAINTENANCE: THE CONCRETE WASHOUT SHALL BE INSPECTED DAILY AND AFTER EVERY RAINFALL EVENT TO CHECK FOR LEAKS OR DAMAGE TO THE CONTAINER BY CONSTRUCTION ACTIVITIES. A DAMAGED CONTAINER SHALL BE REMOVED AND	50 L OR 32-0-0 TO 38-0-0 SULFUR COA 50 LB/1000 SY OR 31-0-0-0 IBDU FERTILIZER 61 L TEMPORARY SEEDING AND MULCH WHERE IT IS NOT POSSIBLE TO PE IMMEDIATELY AFTER THE FINAL EA
• • INSF	PERCENT) AT A LOCATION BEST SUITED FOR THE CONSTRUCTION PROJECT. THE WASHOUT CONTAINER SHALL NOT BE PLACED WITHIN 50 FEET OF STORM DRAINS, OPEN DITCHES, OR WATERBODIES. IF HEAVY RAINS ARE ANTICIPATED, THE WASHOUT CONTAINER SHALL BE COVERED TO AVOID OVERFLOW DURING THE STORM. PECTION AND MAINTENANCE: THE CONCRETE WASHOUT SHALL BE INSPECTED DAILY AND AFTER EVERY RAINFALL EVENT TO CHECK FOR LEAKS OR DAMAGE TO THE CONTAINER BY CONSTRUCTION ACTIVITIES. A DAMAGED CONTAINER SHALL BE REMOVED AND REPLACED IMMEDIATELY. DURING DAILY INSPECTION, DETERMINE IF THE FILTER BAG IN THE VINYL	50 L OR 32-0-0 TO 38-0-0 SULFUR COA 50 LB/1000 SY OR 31-0-0-0 IBDU FERTILIZER 61 L <u>TEMPORARY SEEDING AND MULCI</u> WHERE IT IS NOT POSSIBLE TO PE

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### HING:

CTION ACTIVITIES, THE PROJECT SITE MUST BE EVENT ACCELERATED EROSION. PERMANENT IENT SEEDING AND PLANTING, BUFFER ZONES, ETATION, AND STREAM BANK STABILIZATION, LONG-TERM BENEFITS TO REDUCE EROSION AND NS. ALL SLOPES, CHANNELS, DITCHES, OR ANY ABILIZED AS SOON AS POSSIBLE AFTER FINAL INAL STABILIZATION IS ACHIEVED WHEN:

VITIES AT THE SITES ARE COMPLETE.

SETATIVE COVER (E.G., EVENLY DISTRIBUTED, AS), WITH A DENSITY OF AT LEAST 70 PERCENT BEEN ESTABLISHED ON ALL UNPAVED AREAS AND ERMANENT STRUCTURES OR EQUIVALENT (SUCH AS THE USE OF MULCHES, RIPRAP, GABIONS EN EMPLOYED; AND

AND SEDIMENT CONTROL PRACTICES ARE ND ALL TRAPPED SEDIMENT ARE PERMANENTLY JRTHER EROSION.

WILL BE ESTABLISHED ON ALL DISTURBED AREAS OVER WILL BE ESTABLISHED ON THE FINAL GRADES. MED AND FERTILIZED (AS NECESSARY) IN ECOMMENDATIONS. THE LIME OR FERTILIZER WILL . HYDROSEEDING, DRILL AND BROADCAST GRASS HAY OR CEREAL STRAW WILL BE USED AS O PRODUCE A LAYER 3/4 INCHES THICK (3 TONS OF

EGETATION SHALL BE PLANTED ACCORDING TO 'B' OR 'L' AS SHOWN IN THE TABLE BELOW. E OF APPLICATION AND SEED QUALITY (I.E. ION RATE FOR EACH TYPE OF SEED) IS PROVIDED IN

ARE TRULY MINIMUM, AND SEEDLOTS TO BE USED SHOULD EQUAL OR EXCEED THESE STANDARDS. LABLE THAT EQUAL OR EXCEED THE MINIMUM

REMOVED UNTIL CONTRIBUTING WATERSHEDS INT

Y UNIFORMLY APPLYING SUPPLEMENTS.

PPLEMENTS INTO THE SOIL AT LEAST 2 INCHES, ON ING. DISKING, HARROWING, OR OTHER APPROVED PLEMENTS INTO THE SOIL DURING TILLAGE

ROGEN FERTILIZER TO THE SURFACE OF SEEDED OMPLETION. AS FOLLOWS:

L LIMESTONE

RCIAL FERTILIZER 140 \_B/1000 SY

ATED UREA FERTILIZER 59 TO

\_B/1000 SY

### HING:

ERMANENTLY STABILIZE A DISTURBED AREA ARTHMOVING HAS BEEN COMPLETED, OR WHERE RBANCE ACTIVITIES WILL EXCEED FOUR (4) DAYS, ORM OF TEMPORARY SEEDING AND MULCHING WILL OR THE AREA WILL BE OTHERWISE PROTECTED ND SEDIMENTATION PENDING FUTURE EARTH

MED AND FERTILIZED (AS NECESSARY) IN ECOMMENDATIONS. THE LIME OR FERTILIZER WILL HYDROSEEDING, DRILL AND BROADCAST HYDRO- SEEDING WILL BE USED ON STEEP

SLOPES AND INACCESSIBLE TERRAIN. GRASS HAY OR CEREAL STRAW WILL BE USED AS A MULCH AND WILL BE APPLIED TO PRODUCE A LAYER 3/4 INCHES THICK (3 TONS OF MULCH PER ACRE).

С

TEMPORARY SEED MIXTURE, RATE OF APPLICATION AND SEED QUALITY (I.E., PERCENT PURITY AND GERMINATION RATE FOR EACH TYPE OF SEED) IS PROVIDED IN THE TABLE BELOW.

TEMPORARY SEEDING SPECIFICATION				
SEED MIXTURE	RATE OF APPLICATION (LB/AC)	MIN. % GERMINATION	MIN. % PURITY	
SPRING SEEDING - UN	TIL JUNE 15			
ANNUAL RYEGRASS,	40	85	95	
OR SPRING OATS,	96	85	98	
OR SPRING OATS PLUS RYEGRASS,	64 OATS 20 RYEGRASS	85 85	98 98	
OR WINTER WHEAT,	180	85	95	
OR WINTER RYE	168	85	98	
LATE SPRING AND SUMMER SEEDING - JUNE 16 THRU AUG 15				
ANNUAL RYEGRASS,	40	85	95	
OR JAPANESE OR FOXTAIL MILLET,	35	80	98	
OR SUDANGRASS,	40	85	98	
OR SPRING OATS,	96	85	98	
OR WINTER WHEAT,	180	85	98	
OR WINTER RYE	168	85	98	
LATE SPRING SUMMER AND FALL SEEDING - AUG 16 & LATER				
ANNUAL RYEGRASS,	40	85	95	
OR WINTER RYE,	168	85	95	
OR WINTER WHEAT,	180	85	98	
OR SPRING OATS	96	85	98	

PERMANENT SEEDING SPECIFICATION					
FORMULA & SPECIES	% BY WEIGHT	MIN % PURITY	MIN % GERMINA- TION	MAX % WEED SEED	SEEDING RATE LB/1000 SF
FULL	SUN AF	REA			
CADET KENTUCKY BLUEGRASS (PDA PRATENSIS 'CADET')	40-60	97	80	0.15	
CHEWINGS FESCUE (FESTUCA RUBRA CDMMUTATA), CREEPING RED FESCUE (FESTUCA RUBRA 'PENNLAWN'), SHEEP FESCUE (FESTUCA DVINA), HARD FESCUE (FESTUCA BREVIPILA)	30-40	97	85	0.10	3-4
PERENNIAL RYE (LOLIUM PERENNE)	10-20	97	90	0.10	
SHADY AREAS					
CHEWINGS FESCUE (FESTUCA RUBRA CDMMUTATA), CREEPING RED FESCUE (FESTUCA RUBRA 'PENNLAWN'), SHEEP FESCUE (FESTUCA DVINA), HARD FESCUE (FESTUCA BREVIPILA)	50-60	97	85	0.10	3-4
CADET KENTUCKY BLUEGRASS (PDA PRATENSIS 'CADET')	30-40	97	80	0.15	
PERENNIAL RYE (LOLIUM PERENNE)	10-20	97	90	0.10	

TURF SEEDING SPECIFICATION (TURFGRASS SOD)				
FORMULA & SPECIES COOL-SEASON GRASS	% BY WEIGHT	MIN % PURITY	MIN % GERMINA- TIDN	MAX % WEED SEED
CHEWINGS FESCUE (FESTUCA RUBRA COMMUTATA)	40			
CREEPING RED FESCUE (FESTUCA RUBRA 'PENNLAWN')	30			
ANNUAL RYEGRASS (LOLIUM MULTIFLORUM - L. PERENNE VAR. ITALICUM)	20	95	85	0.5
R⊡UGH BLUEGRASS (P⊡A TRI∨IALIS)	10			
CADET KENTUCKY BLUEGRASS (PDA PRATENSIS 'CADET')	10			

### **GENERAL E&S MAINTENANCE**

IN ADDITION TO THE REQUIREMENTS FOR THE FREQUENCY OF INSPECTIONS INDICATED IN THE ABOVE SUBSECTIONS, INSPECTIONS OF ALL EROSION AND SEDIMENTATION CONTROL FACILITIES AND EQUIPMENT SHALL OCCUR AT LEAST WEEKLY AND AFTER EACH RAINFALL EVENT.

TO PERFORM AS DESIGNED, THE TEMPORARY AND PERMANENT EROSION AND SEDIMENT CONTROL DEVICES ARE TO BE MAINTAINED IN A SATISFACTORY CONDITION. MAINTENANCE SHALL BE PERFORMED AS SPECIFIED IN THE PLANS, REPORTS, AND AS DIRECTED BY THE APPROPRIATE REGULATING AGENCIES.

AN EROSION AND SEDIMENT CONTROL INSPECTION LOG WILL BE COMPLETED (AND MAINTAINED ON-SITE) FOR EACH INSPECTION CONDUCTED AT THE PROJECT DURING THE CONSTRUCTION PHASE. THE INSPECTION LOG WILL DOCUMENT EACH

### **RESPONSIBILITY FOR FILL MATERIALS**

THE CONTRACTOR SELECTED FOR CONSTRUCTION SHALL BE RESPONSIBLE TO PERFORM ENVIRONMENTAL DUE DILIGENCE AND DETERMINE THAT ALL FILL MATERIAL IMPORTED TO THE SITE OR EXPORTED FROM THE SITE MEETS THE DEPARTMENT OF ENVIRONMENTAL PROTECTION'S DEFINITION OF CLEAN FILL. CLEAN FILL IS DEFINED AS UNCONTAMINATED, NONWATER-SOLUBLE, NONDECOMPOSTABLE, INERT SOLID MATERIAL. THE TERM INCLUDES SOIL, ROCK, STONE, DREDGED MATERIAL, USED ASPHALT, AND BRICK, BLOCK OR CONCRETE FROM CONSTRUCTION AND DEMOLITION ACTIVITIES THAT IS SEPARATE FROM OTHER WASTE AND RECOGNIZABLE AS SUCH. THE TERM DOES NOT INCLUDE MATERIALS PLACED IN OR ON THE WATERS OF THE COMMONWEALTH UNLESS OTHERWISE AUTHORIZED. ENVIRONMENTAL DUE DILIGENCE IS DEFINED AS INVESTIGATIVE TECHNIQUES, INCLUDING, BUT NOT LIMITED TO, VISUAL PROPERTY INSPECTIONS, ELECTRONIC DATA BASE SEARCHES, REVIEW OF OWNERSHIP AND USE HISTORY OF PROPERTY, SANBORN MAPS, ENVIRONMENTAL QUESTIONNAIRES, TRANSACTION SCREENS, ANALYTICAL TESTING, ENVIRONMENTAL ASSESSMENTS OR AUDITS.

THE PROJECT SITE IS SITUATED IN AN URBAN SETTING AND THERE ARE NO SENSITIVE ENVIRONMENTAL RESOURCES / FEATURES ON THE PROPERTY. THERE ARE A FEW TREES ON THE SITE THAT WILL BE DISTURBED AS A RESULT OF THE RENOVATION WORK, BUT THE EXISTING TREES ARE NOT CONSIDERED WOODLANDS. ADDITIONALLY, TREES WILL BE PLANTED AS PART OF PLANNED LANDSCAPING FOR THE FINISHED SITE. NO UNNECESSARY DISTURBANCE OF TREES IS PLANNED AND ONLY THOSE TREES NECESSARY FOR SUCCESSFUL COMPLETION OF THE RENOVATION PROJECT WILL BE IMPACTED. THE ONLY SIGNIFICANT TYPE OF VEGETATION THAT WILL BE AFFECTED BY THE PROPOSED RENOVATION PROJECT IS THE NATURAL GRASS SURFACE (TURF) THAT CURRENTLY COVERS THE FIELD SITUATED WHERE THE MAJORITY OF THE PROPOSED PARKING LOT WILL BE LOCATED.

MINIMIZED.

THERE ARE NO STREAMS OR NATURAL DRAINAGE WAYS IN THE IMMEDIATE VICINITY OF PROJECT SITE. DRAINAGE FROM THE AREA IS COLLECTED IN THE SITE STORM SEWER AND DISCHARGES TO PWD'S COMBINED SEWER SYSTEM.

SINCE THE PROPOSED SITE CONSTRUCTION IS NOT WITHIN A RIPARIAN BUFFER, THE REQUIREMENT TO REQUEST A WAIVER FOR CONSTRUCTION ACTIVITY WITHIN A RIPARIAN BUFFER IS NOT APPLICABLE. LIKEWISE, THE REQUIREMENT TO SHOW AREAS PROPOSED TO BE WAIVED FROM RIPARIAN BUFFER OBLIGATIONS ON THE PLAN DRAWINGS IS ALSO NOT APPLICABLE. EXISTING RIPARIAN BUFFERS (IF PRESENT) ALONG THE PENNYPACK CREEK ARE BEING PROTECTED TO THE MAXIMUM EXTENT PRACTICABLE.

INSPECTION AND ALL E&S BMP REPAIR, OR REPLACEMENT AND MAINTENANCE ACTIVITIES. OTHER INFORMATION CONTAINED ON THE INSPECTION LOG WILL INCLUDE, DATE AND TIME OF THE INSPECTION, INSPECTION NUMBER, INSPECTOR NAME, TITLE, AND SIGNATURE OF THE INSPECTOR.

### MINIMIZE EXTENT AND DURATION OF EARTH DISTURBANCE

THE EROSION AND SEDIMENT CONTROL PLAN MINIMIZES THE EXTENT OF EARTH DISTURBANCE (LAND CLEARING AND GRADING) TO THE MAXIMUM EXTENT POSSIBLE SINCE ONLY THE SMALLEST FOOTPRINT NECESSARY TO ACCOMPLISH THE GOALS OF THE FACILITY WILL BE DISTURBED. ALSO (TO THE EXTENT PRACTICABLE) THE EXISTING VEGETATION (SENSITIVE RESOURCES SUCH AS THE TREES ON THE PROJECT PROPERTY) WILL BE PROTECTED. THE PROJECT WILL BE COMPLETED AS QUICKLY AS POSSIBLE (I.E., DURATION OF THE PROJECT MINIMIZED), AND ONLY THOSE AREAS NECESSARY FOR BUILDING CONSTRUCTION AND SITE ACCESS (AND ASSOCIATED STORMWATER CONTROLS) WILL BE DISTURBED. ANTICIPATED DURATION OF THE CONSTRUCTION IS APPROXIMATELY TWELVE (12) MONTHS.

MAXIMIZE PROTECTION OF EXISTING DRAINAGE FEATURES AND VEGETATION

THERE ARE NO NATURAL DRAINAGE FEATURES ON THE SUBJECT SITE. DRAINAGE FROM THE PROJECT AREA IS COLLECTED IN THE SITE STORM SEWER AND DISCHARGES TO PWD'S COMBINED SEWER SYSTEM. THE PRINCIPAL DRAINAGE FEATURE IN THE GENERAL VICINITY OF THE PROPOSED DEVELOPMENT IS THE PENNYPACK CREEK, LOCATED APPROXIMATELY 0.5 MILES TO THE NORTHEAST OF THE PROJECT SITE.

### MINIMIZE SOIL COMPACTION

TO MINIMIZE SOIL COMPACTION, THE EQUIPMENT USED FOR CONSTRUCTION WILL BE TAILORED TO THE SIZE OF THE JOB. NO UNNECESSARILY LARGE / HEAVY EQUIPMENT WILL BE USED, AND CONSTRUCTION SEQUENCING WILL BE SUCH THAT UNNECESSARY PASSES OF THE EQUIPMENT OVER THE GROUND SURFACE WILL BE

### **RIPARIAN FOREST BUFFERS**

THE PRINCIPAL DRAINAGE FEATURE IN THE GENERAL VICINITY OF THE PROPOSED DEVELOPMENT IS THE PENNYPACK CREEK LOCATED APPROXIMATELY 0.5 MILES TO THE NORTHEAST OF THE PROJECT SITE.

## PELBANO PLAYGROUND

### 8101 BUSTLETON AVENUE

## OLIN

LANDSCAPE ARCHITECTURE / URBAN DESIGN / PLANNING ONE PENN CENTER 1617 JOHN F. KENNEDY BOULEVARD, SUITE 1900 PHILADELPHIA, PA 19103 TEL 215.440.0030 / FAX 215.440.0041 WWW.THEOLINSTUDIO.COM OLIN PARTNERSHIP, LTD.

Playground Design:

Studio Ludo 4800 Springfield Ave Philadelphia, PA 19143 (215) 454-6780

Civil Engineering: Sci Tek 1880 John F Kennedy Blvd #600, Philadelphia, PA 19103 (267) 314-5385

MEP: Mark Ulrick 30 N. 41ST SUITE 500 Philadelphia, PA 19104 (856) 320-8100

No.	Date	Description
1	10/12/2022	SD set
2	11/16/2022	SD set
3	2/21/2023	DD set
4	4/17/2023	75% CD set
5	5/31/2023	100% CD set

### **EROSION AND SEDIMENT CONTROL** NOTES (2 OF 3)

cale:	1" = 10'	
ate:	5/31/2023	
rawn:	TPM	
hecked:	AMH	
roject No.:	2224	



	<b>RECYCLING AND</b>	DISPOSAL OF	MATERIALS
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ALL EXCAVATED MATERIALS RESULTING FROM CONSTRUCTION ACTIVITIES AT THE PROJECT SITE AND ACCUMULATED SEDIMENT THAT WILL NOT BE USED ON SITE SHALL BE REMOVED TO A DEPARTMENT AND/OR COUNTY CONSERVATION DISTRICT APPROVED LANDFILL OR SOIL/ROCK DISPOSAL AREA. LIKEWISE, ALL SOIL/FILL MATERIAL THAT ORIGINATES FROM OFF-SITE AREAS SHALL BE APPROVED BY THE DEPARTMENT AND/OR THE COUNTY CONSERVATION DISTRICT.

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THE CONTRACTOR SHALL DISPOSE OF ALL EXCESS BUILDING MATERIALS AND WASTES IN ACCORDANCE WITH DEPARTMENT SOLID WASTE MANAGEMENT REGULATIONS AT 25 PA. CODE 260.1 ET SEQ., 271.1 ET SEQ., AND 287.19 ET SEQ. THE CONTRACTOR SHALL NOT ILLEGALLY BURY, DUMP OR DISCHARGE ANY BUILDING MATERIAL OR WASTES AT THE SITE.

REGARDING ANTICIPATED CONSTRUCTION WASTE, ANY CONSTRUCTION DEBRIS (OR DEBRIS RESULTING FROM DEMOLITION OF EXISTING FACILITIES) SUCH AS SCRAP WOOD AND METAL, NAILS, BROKEN CONCRETE, ASPHALT, BRICK, PVC OR METAL PIPE, ETC., WILL BE REMOVED FROM THE SITE AND DISPOSED OF AT A DEPARTMENT AND/OR COUNTY CONSERVATION DISTRICT APPROVED LANDFILL OR SOIL/ROCK DISPOSAL SITE.

### **E&S CONTROL MANUAL APPENDIX C - STANDARD E&S PLAN NOTES**

- 1) ALL EARTH DISTURBANCES, INCLUDING CLEARING AND GRUBBING AS WELL AS CUTS AND FILLS SHALL BE DONE IN ACCORDANCE WITH THE APPROVED E&S PLAN. A COPY OF THE APPROVED DRAWINGS (STAMPED, SIGNED AND DATED BY THE REVIEWING AGENCY) MUST BE AVAILABLE AT THE PROJECT SITE AT ALL TIMES. THE REVIEWING AGENCY SHALL BE NOTIFIED OF ANY CHANGES TO THE APPROVED PLAN PRIOR TO IMPLEMENTATION OF THOSE CHANGES. THE REVIEWING AGENCY MAY REQUIRE A WRITTEN SUBMITTAL OF THOSE CHANGES FOR REVIEW AND APPROVAL AT ITS DISCRETION.
- 2) AT LEAST SEVEN (7) DAYS PRIOR TO STARTING ANY EARTH DISTURBANCE ACTIVITIES, INCLUDING CLEARING AND GRUBBING, THE OWNER AND/OR OPERATOR SHALL INVITE ALL CONTRACTORS, THE LANDOWNER, APPROPRIATE MUNICIPAL OFFICIALS, THE E&S PLAN PREPARER, THE PCSM PLAN PREPARER, THE LICENSED PROFESSIONAL RESPONSIBLE FOR OVERSIGHT OF CRITICAL STAGES OF IMPLEMENTATION OF THE PCSM PLAN, AND A REPRESENTATIVE FROM THE LOCAL CONSERVATION DISTRICT TO AN ON-SITE PRECONSTRUCTION MEETING.
- AT LEAST 3 DAYS PRIOR TO STARTING ANY EARTH DISTURBANCE ACTIVITIES. OR EXPANDING INTO AN AREA PREVIOUSLY UNMARKED, THE PENNSYLVANIA ONE CALL SYSTEM INC. SHALL BE NOTIFIED AT 1-800-242-1776 FOR THE LOCATION OF EXISTING UNDERGROUND UTILITIES.
- ALL EARTH DISTURBANCE ACTIVITIES SHALL PROCEED IN ACCORDANCE WITH THE SEQUENCE PROVIDED ON THE PLAN DRAWINGS. DEVIATION FROM THAT SEQUENCE MUST BE APPROVED IN WRITING FROM THE LOCAL CONSERVATION DISTRICT OR BY THE DEPARTMENT PRIOR TO IMPLEMENTATION.
- 5) AREAS TO BE FILLED ARE TO BE CLEARED, GRUBBED, AND STRIPPED OF TOPSOIL TO REMOVE TREES, VEGETATION, ROOTS AND OTHER OBJECTIONABLE MATERIAL.
- 6) CLEARING, GRUBBING, AND TOPSOIL STRIPPING SHALL BE LIMITED TO THOSE AREAS DESCRIBED IN EACH STAGE OF THE CONSTRUCTION SEQUENCE. GENERAL SITE CLEARING, GRUBBING AND TOPSOIL STRIPPING MAY NOT COMMENCE IN ANY STAGE OR PHASE OF THE PROJECT UNTIL THE E&S BMPS SPECIFIED BY THE BMP SEQUENCE FOR THAT STAGE OR PHASE HAVE BEEN INSTALLED AND ARE FUNCTIONING AS DESCRIBED IN THIS E&S PLAN.
- 7) AT NO TIME SHALL CONSTRUCTION VEHICLES BE ALLOWED TO ENTER AREAS OUTSIDE THE LIMIT OF DISTURBANCE BOUNDARIES SHOWN ON THE PLAN MAPS. THESE AREAS MUST BE CLEARLY MARKED AND FENCED OFF BEFORE CLEARING AND GRUBBING OPERATIONS BEGIN.
- 8) TOPSOIL REQUIRED FOR THE ESTABLISHMENT OF VEGETATION SHALL BE STOCKPILED AT THE LOCATION(S) SHOWN ON THE PLAN MAPS(S) IN THE AMOUNT NECESSARY TO COMPLETE THE FINISH GRADING OF ALL EXPOSED AREAS THAT ARE TO BE STABILIZED BY VEGETATION. EACH STOCKPILE SHALL BE PROTECTED IN THE MANNER SHOWN ON THE PLAN DRAWINGS. STOCKPILE HEIGHTS SHALL NOT EXCEED 35 FEET. STOCKPILE SLOPES SHALL BE 2H:1V OR FLATTER.
- IMMEDIATELY UPON DISCOVERING UNFORESEEN CIRCUMSTANCES POSING THE POTENTIAL FOR ACCELERATED EROSION AND / OR SEDIMENT POLLUTION. THE OPERATOR SHALL IMPLEMENT APPROPRIATE BEST MANAGEMENT PRACTICES TO MINIMIZE THE POTENTIAL FOR EROSION AND SEDIMENT POLLUTION AND NOTIFY THE LOCAL CONSERVATION DISTRICT AND / OR THE REGIONAL OFFICE OF THE DEPARTMENT.
- 10) ALL BUILDING MATERIALS AND WASTES SHALL BE REMOVED FROM THE SITE AND RECYCLED OR DISPOSED OF IN ACCORDANCE WITH THE DEPARTMENT'S SOLID WASTE MANAGEMENT REGULATIONS AT 25 PA. CODE 260.1 ET SEQ., 271.1, AND 287.1 ET. SEQ. NO BUILDING MATERIALS OR WASTES OR UNUSED BUILDING MATERIALS SHALL BE BURNED, BURIED, DUMPED, OR DISCHARGED AT THE SITE.

- FULLY IMPLEMENTED PRIOR TO BEING ACTIVATED.
- ANALYTICAL TESTING.
- VEGETATED AREAS.
- DIRECTLY FROM LOTS ONTO LOCAL ROADS.
- MODIFICATIONS OF THOSE INSTALLED WILL BE REQUIRED.
- OFFICIALS AT THE TIME OF INSPECTION.
- STORM SEWER, OR SURFACE WATER.
- DESCRIBED ON THE PLAN DRAWINGS AND NOTES.
- TOPSOIL.
- NINE (9) INCHES IN THICKNESS.
- SHALL NOT BE INCORPORATED INTO FILLS.
- SUBSURFACE DRAIN OR OTHER APPROVED METHOD.
- STABILIZATION SPECIFICATIONS.
- SLIDING, OR OTHER MOVEMENTS.
- DEPARTMENT.

### 11) ALL OFF-SITE WASTE AND BORROW AREAS MUST HAVE AN E&S PLAN APPROVED BY THE LOCAL CONSERVATION DISTRICT OR THE DEPARTMENT

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12) THE CONTRACTOR IS RESPONSIBLE FOR ENSURING THAT ANY MATERIAL BROUGHT ON SITE IS CLEAN FILL. FORM FP-001 MUST BE RETAINED BY THE PROPERTY OWNER FOR ANY FILL MATERIAL AFFECTED BY A SPILL OR RELEASE OF A REGULATED SUBSTANCE BUT QUALIFYING AS CLEAN FILL DUE TO

13) ALL PUMPING OF WATER FROM ANY WORK AREA SHALL BE DONE ACCORDING TO THE PROCEDURE DESCRIBED IN THIS PLAN. OVER UNDISTURBED

14) VEHICLES AND EQUIPMENT MAY NEITHER ENTER DIRECTLY NOR EXIT

15) UNTIL THE SITE IS STABILIZED, ALL EROSION AND SEDIMENT BMPS SHALL BE MAINTAINED PROPERLY. MAINTENANCE SHALL INCLUDE INSPECTIONS OF ALL EROSION AND SEDIMENT BMPS AFTER EACH RUNOFF EVENT AND ON A WEEKLY BASIS. ALL PREVENTATIVE AND REMEDIAL MAINTENANCE WORK, INCLUDING CLEAN OUT, REPAIR, REPLACEMENT, REGRADING, RESEEDING, REMULCHING AND RENETTING MUST BE PERFORMED IMMEDIATELY. IF THE E&S BMPS FAIL TO PERFORM AS EXPECTED, REPLACEMENT BMPS, OR

16) A LOG SHOWING DATES THAT E&S BMPS WERE INSPECTED AS WELL AS ANY DEFICIENCIES FOUND AND THE DATE THEY WERE CORRECTED SHALL BE MAINTAINED ON THE SITE AND BE MADE AVAILABLE TO REGULATORY AGENCY

17) SEDIMENT TRACKED ONTO ANY PUBLIC ROADWAY OR SIDEWALK SHALL BE RETURNED TO THE CONSTRUCTION SITE BY THE END OF EACH WORKDAY AND DISPOSED IN THE MANNER DESCRIBED IN THIS PLAN. IN NO CASE SHALL THE SEDIMENT BE WASHED, SHOVELED, OR SWEPT INTO ANY ROADSIDE DITCH,

18) ALL SEDIMENT REMOVED FROM BMPS SHALL BE DISPOSED OF IN THE MANNER

19) AREAS WHICH ARE TO RECEIVE TOPSOIL SHALL BE SCARIFIED TO A MINIMUM DEPTH OF THREE (3) TO FIVE (5) INCHES (6 TO 12 INCHES ON COMPACTED SOILS) PRIOR TO PLACEMENT OF TOPSOIL. AREAS TO BE VEGETATED SHALL HAVE A MINIMUM 4 INCHES OF TOPSOIL IN PLACE PRIOR TO SEEDING AND MULCHING. FILL OUTSLOPES SHALL HAVE A MINIMUM OF TWO (2) INCHES OF

20) ALL FILLS SHALL BE COMPACTED AS REQUIRED TO REDUCE EROSION, SLIPPAGE, SETTLEMENT, SUBSIDENCE OR OTHER RELATED PROBLEMS. FILL INTENDED TO SUPPORT BUILDINGS, STRUCTURES AND CONDUITS, ETC. SHALL BE COMPACTED IN ACCORDANCE WITH LOCAL REQUIREMENTS OR CODES.

21) ALL EARTHEN FILLS SHALL BE PLACED IN COMPACTED LAYERS NOT TO EXCEED

22) FILL MATERIALS SHALL BE FREE OF FROZEN PARTICLES, BRUSH, ROOTS, SOD, OR OTHER FOREIGN OR OBJECTIONABLE MATERIALS THAT WOULD INTERFERE WITH OR PREVENT CONSTRUCTION OF SATISFACTORY FILLS.

23) FROZEN MATERIALS OR SOFT, MUCKY, OR HIGHLY COMPRESSIBLE MATERIALS

24) FILL SHALL NOT BE PLACED ON SATURATED OR FROZEN SURFACES.

25) SEEPS OR SPRINGS ENCOUNTERED DURING CONSTRUCTION SHALL BE HANDLED IN ACCORDANCE WITH THE STANDARD AND SPECIFICATION FOR

26) ALL GRADED AREAS SHALL BE PERMANENTLY STABILIZED IMMEDIATELY UPON REACHING FINISHED GRADE. CUT SLOPES IN COMPETENT BEDROCK AND ROCK FILLS NEED NOT BE VEGETATED. SEEDED AREAS WITHIN 50 FEET OF A SURFACE WATER, OR AS OTHERWISE SHOWN ON THE PLAN DRAWINGS, SHALL BE BLANKETED ACCORDING TO THE STANDARDS OF THIS PLAN.

27) IMMEDIATELY AFTER EARTH DISTURBANCE ACTIVITIES CEASE IN ANY AREA OR SUBAREA OF THE PROJECT, THE OPERATOR SHALL STABILIZE ALL DISTURBED AREAS. DURING NON-GERMINATING MONTHS, MULCH OR PROTECTIVE BLANKETING SHALL BE APPLIED AS DESCRIBED IN THE PLAN. AREAS NOT AT FINISHED GRADE, WHICH WILL BE REACTIVATED WITHIN ONE (1) YEAR, MAY BE STABILIZED IN ACCORDANCE WITH THE TEMPORARY STABILIZATION SPECIFICATIONS. THOSE AREAS WHICH WILL NOT BE REACTIVATED WITHIN ONE (1) YEAR SHALL BE STABILIZED IN ACCORDANCE WITH THE PERMANENT

28) PERMANENT STABILIZATION IS DEFINED AS A MINIMUM UNIFORM, PERENNIAL 70% VEGETATIVE COVER OR OTHER PERMANENT NON-VEGETATIVE COVER WITH A DENSITY SUFFICIENT TO RESIST ACCELERATED EROSION. CUT AND FILL SLOPES SHALL BE CAPABLE OF RESISTING FAILURE DUE TO SLUMPING,

29) E&S BMPS SHALL REMAIN FUNCTIONAL AS SUCH UNTIL ALL AREAS TRIBUTARY TO THEM ARE PERMANENTLY STABILIZED OR UNTIL THEY ARE REPLACED BY ANOTHER BMP APPROVED BY THE LOCAL CONSERVATION DISTRICT OR THE

30) UPON COMPLETION OF ALL EARTH DISTURBANCE ACTIVITIES AND PERMANENT STABILIZATION OF ALL DISTURBED AREAS, THE OWNER AND / OR OPERATOR SHALL CONTACT THE LOCAL CONSERVATION DISTRICT FOR AN INSPECTION PRIOR TO REMOVAL / CONVERSION OF THE E&S BMPS.

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- 31) AFTER FINAL SITE STABILIZATION HAS BEEN ACHIEVED, TEMPORARY EROSION AND SEDIMENT BMPS MUST BE REMOVED OR CONVERTED TO PERMANENT POST CONSTRUCTION STORMWATER MANAGEMENT BMPS. AREAS DISTURBED DURING REMOVAL OR CONVERSION OF THE BMPS SHALL BE STABILIZED IMMEDIATELY. IN ORDER TO ENSURE RAPID REVEGETATION OF DISTURBED AREAS, SUCH REMOVAL / CONVERSIONS ARE TO BE DONE ONLY DURING THE GERMINATING SEASON.
- 32) FAILURE TO CORRECTLY INSTALL E&S BMPS, FAILURE TO PREVENT SEDIMENT-LADEN RUNOFF FROM LEAVING THE CONSTRUCTION SITE, OR FAILURE TO TAKE IMMEDIATE CORRECTIVE ACTION TO RESOLVE FAILURE OF E&S BMPS MAY RESULT IN ADMINISTRATIVE, CIVIL, AND / OR CRIMINAL PENALTIES BEING INSTITUTED BY THE DEPARTMENT AS DEFINED IN SECTION 602 OF THE PENNSYLVANIA CLEAN STREAMS LAW. THE CLEAN STREAMS LAW PROVIDES FOR UP TO \$10,000 PER DAY IN CIVIL PENALTIES, UP TO \$10,000 IN SUMMARY CRIMINAL PENALTIES, AND UP TO \$25,000 IN MISDEMEANOR CRIMINAL PENALTIES FOR EACH VIOLATION.

### SEQUENCE OF CONSTRUCTION AND BMP INSTALLATION

- 1. AT LEAST SEVEN (7) DAYS PRIOR TO ANY EARTH DISTURBANCE, THE INSPECTIONS COORDINATOR OF PWD (OFFICE: 215-685-6387) MUST BE CALLED TO SCHEDULE A PRECONSTRUCTION MEETING.PRIOR TO EARTH DISTURBANCE AND CONSTRUCTION, THE LIMITS OF EARTH DISTURBANCE SHALL BE CLEARLY MARKED IN THE FIELD
- 2. SINCE ALL CONSTRUCTION VEHICLES WILL OPERATE FROM STABILIZED SURFACES, ROCK CONSTRUCTION ENTRANCES WILL NOT BE REQUIRED AT THIS SITE.
- 3. INSTALL CATCH BASIN INLET PROTECTION IN EXISTING SITE CATCH BASINS / DROP INLETS WHEREEVER THERE IS THE POSSIBILITY FOR SEDIMENT-LADEN RUNOFF RESULTING FROM CONSTRUCTION ACTIVITIES TO ENTER THE CATCH BASIN.
- 4. INSTALL FILTER SOCK AT LOCATIONS SHOWN ON THE PLANS. FILTER SOCK MUST BE PLACED PRIOR TO THE PREPARATION FOR OR INSTALLATION OF CONCRETE WORK.
- 5. WHERE TOPSOIL OR SOD IS DISTURBED FOR SIDEWALK CONSTRUCTION, IT SHALL BE LAIN DIRECTLY ADJACENT TO THE WORK ON THE UPSLOPE SIDE OF THE FILTER SOCK AND REPLACED AS SOON AS THE CONCRETE FORMS ARE REMOVED.
- 6. ONCE INLET FILTERS AND FILTER SOCK IS IN PLACE, CLEAR AND GRUB BRUSH, TREE STUMPS, ETC. MINIMIZE THE LIMIT OF DISTURBANCE. PROTECT EXISTING VEGETATION THAT IS TO REMAIN ON SITE. NO STUMPS, TREES AND BRUSH WILL BE DISPOSED OF ON-SITE. ALL TREES NOT HARVESTED, STUMPS, AND BRUSH WILL BE MULCHED FOR ON-SITE USE. ANY TREES, BRUSH, STUMPS, OBSTRUCTIONS AND OTHER OBJECTIONABLE MATERIAL NOT USED IN THIS MANNER WILL BE REMOVED AND DISPOSED IN THE COUNTY CONSERVATION DISTRICT-APPROVED OR PADEP-APPROVED LANDFILL.
- 7. COINCIDENT WITH CONSTRUCTION AND PRIOR TO THE FIRST DELIVERY OF CONCRETE TO THE SITE, THE MANUFACTURED VINYL CONCRETE WASHOUT WILL BE INSTALLED AT THE LOCATIONS SHOWN ON THE E&S PLAN DRAWINGS, OR AS DIRECTED BY THE CONSTRUCTION MANAGER.
- 8. BEGIN ANY REQUIRED GRADING. AS SOON AS SLOPES, CHANNELS, DITCHES, AND OTHER DISTURBED AREAS REACH FINAL GRADE, THEY MUST BE STABILIZED. CESSATION OF ACTIVITY FOR FOUR (4) DAYS OR LONGER REQUIRES TEMPORARY STABILIZATION AS SIDEWALK INSTALLATION PROGRESSES, AND CONCRETE FORMS ARE REMOVED, BACKFILL DISTRUBED AREAS AND REPLACE RESERVED TOPSOIL. FERTILIZE, SEED AND MULCH ACCORDING TO THE PERMANENT SEEDING AND MULCHING SPECIFICATIONS SHOWN ON THE E&S NOTES.
- 9. IF GROUNDWATER IS ENCOUNTERED DURING EXCAVATION / RENOVATION ACTIVITIES OR IF RAINFALL EVENTS CAUSE EXCAVATION SITES TO BECOME FILLED WITH DIRTY / SEDIMENT-LADEN WATER, THE SEDIMENT LADEN WATER WILL BE PUMPED FROM THE EXCAVATION INTO A PUMPED WATER FILTER BAG.
- 10. REMOVE AND REPLACE INLET STRUCTURES AND PIPE CONNECTIONS AS SHOWN ON THE PLANS. INSTALL NEW INLETS AND PIPE CONNECTIONS AS SHOWN ON THE PLANS. INSTALL INLET PROTECTION AT EACH NEW INLET. THE LENGTH OF A TRENCH OPENING AT ANY GIVEN TIME SHALL BE HELD TO A MINIMUM. TRENCH EXCAVATIONS SHALL ONLY BE MADE FOR THE AMOUNT OF PIPE THAT CAN BE INSTALLED DURING THAT DAY'S ACTIVITY AND SHALL IMMEDIATELY BE BACKFILLED, COMPACTED AND STABILIZED.
- 11. AFTER INLETS AND CONCRETE CURBS ARE INSTALLED, MILLING OF THE EXISTING PAVED CARTWAY MAY BEGIN.
- 12. ASPHALT PAVING MAY BEGIN. MAINTAIN ALL INLET PROTECTION CONTROLS DURING ASPHALT SURFACING ACTIVITIES.

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13. ALL TEMPORARY EROSION CONTROL STRUCTURES (IDENTIFIED IN THIS CONSTRUCTION SEQUENCE) WILL BE REMOVED WITHIN TWENTY (20) DAYS AFTER THE CONSTRUCTION AREA HAS BEEN STABILIZED. THE STANDARD FOR

VEGETATIVE STABILIZATION IS DEFINED AS A "MINIMUM UNIFORM 70 PERCENT PERENNIAL VEGETATIVE COVER, WITH A DENSITY CAPABLE OF RESISTING ACCELERATED EROSION AND SEDIMENTATION." THIS INCLUDES REMOVAL OF THE COMPOST FILTER SOCK. BIODEGRADABLE SOCK MAY BE CUT OPEN AND FILLER MATERIAL SPREAD ONSITE AS VEGETATIVE GROWTH MEDIUM. NON-BIODEGRADABLE FABRIC, AS WELL AS STAKES AND HARDWARE MUST BE REMOVED TO A PADEP OR COUNTY APPROVED WASTE SITE.

14. SEED AND MULCH ALL REMAINING DISTURBED AREAS PER PERMANENT SEEDING SPECIFICATIONS.

15. THE CONSTRUCTION AREA WILL BE PERIODICALLY INSPECTED TO ENSURE THAT VEGETATION HAS BECOME WELL ESTABLISHED. CONTRACTOR TO INCLUDE A TWO-YEAR GUARANTEE ON ALL VEGETATION INSTALLED WITHIN A BMP FOOTPRINT. IF RILLS OR GULLIES (OR OTHER INDICATIONS OF EROSION) OCCUR, THE PROBLEM WILL BE REPAIRED IMMEDIATELY.

16. UPON COMPLETION OF ALL EARTH DISTURBANCE ACTIVITIES AND PERMANENT STABILIZATION OF ALL DISTURBED AREAS, THE OWNER AND/OR OPERATOR SHALL CONTACT INSPECTIONS COORDINATOR OF PWD (OFFICE: 215-685-6387) FOR A FINAL INSPECTION PRIOR TO REMOVAL/CONVERSION OF THE E&S BMPS.

### **CONSTRUCTION AND DEMOLITION WORK PRACTICES TO REDUCE / MINIMIZE DUST**

1. FUGITIVE DUST FORM CONSTRUCTION, DEMOLITION, AND EARTHWORKS ACTIVITIES MAY NOT BE VISIBLE AT THE POINT IT PASSES THE WORKSITE PROPERTY LINE.

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USE OF VACUUM OR SIMILAR SUCTION SYSTEMS TO CAPTURE DUST KICKED UP BY POWER TOOLS WHEN GRINDING / CUTTING.

3. APPLICATION OF WATER OR APPROVED DUST SUPPRESSANT TO A WORKSITE WITH ONGOING EXCAVATION, LAND CLEARING, DEMOLITION, OR OTHER EARTH DISTURBANCE RELATED ACTIVITIES TO SUPPRESS DUST FORMATION.

GENERAL PROHIBITION AGAINST DRY ABRASIVE BLASTING OF EXTERIOR SURFACES OPEN TO THE OUTSIDE AIR WHEN TEMPERATURE IS ABOVE FREEZING.

COVERING AND WETTING OF STOCKPILED EARTH, SAND, GRAVEL, AND OTHER SIMILAR CONSTRUCTION MATERIALS.

USE OF A MATERIAL CHUTE WHEN DROPPING MATERIAL OR DEBRIS MORE THAN 20 FT OUTSIDE OF THE EXTERIOR WALLS OF A BUILDING OR STRUCTURE. MATERIALS MUST BE WETTED WHEN DROPPED. AND / OR EXIT OF CHUTE MUST BE SEALED AGAINST THE TOP OF THE RECEIVING CONTAINER / DUMPSTER.

7. ALL TEMPORARY PERIMETER FENCING AROUND MUST HAVE DUST CONTROL FABRIC: MUST MEASURE A MINIMUM OF 5 FT IN HEIGHT FROM THE BOTTOM OF THE FENCING.

8. A 10 MILES PER HOUR SPEED LIMIT FOR ALL EQUIPMENT AND TRUCKS TRAVELING WITHIN THE WORKSITE.

9. WETTING AND SWEEPING OF ROADWAYS / ACCESS ROADS IN A WORKSITE TO PREVENT DUST FORMATION.

10. VEHICLE ACCESS POINTS MUST BE EQUIPPED WITH DUST SUPPRESSION MEASURES (I.E. WHEEL WASH SYSTEMS, RUMBLE GRATES, AND/OR GRAVEL PADS)

## PELBANO PLAYGROUND

8101 BUSTLETON AVENUE

## OLIN

LANDSCAPE ARCHITECTURE / URBAN DESIGN / PLANNING ONE PENN CENTER 1617 JOHN F. KENNEDY BOULEVARD, SUITE 1900 PHILADELPHIA, PA 19103 TEL 215.440.0030 / FAX 215.440.0041 WWW.THEOLINSTUDIO.COM OLIN PARTNERSHIP, LTD.

Playground Design: Studio Ludo 4800 Springfield Ave Philadelphia, PA 19143 (215) 454-6780


Civil Engineering: Sci Tek 1880 John F Kennedy Blvd #600, Philadelphia, PA 19103 (267) 314-5385


MEP: Mark Ulrick 30 N. 41ST SUITE 500 Philadelphia, PA 19104 (856) 320-8100

No.	Date	Description
1	10/12/2022	SD set
2	11/16/2022	SD set
3	2/21/2023	DD set
4	4/17/2023	75% CD set
5	5/31/2023	100% CD set

### **EROSION AND SEDIMENT CONTROL** NOTES (3 OF 3)

scale:	1" = 10'	
)ate:	5/31/2023	
)rawn:	TPM	
Checked:	AMH	
Project No.:	2224	

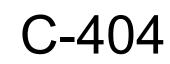

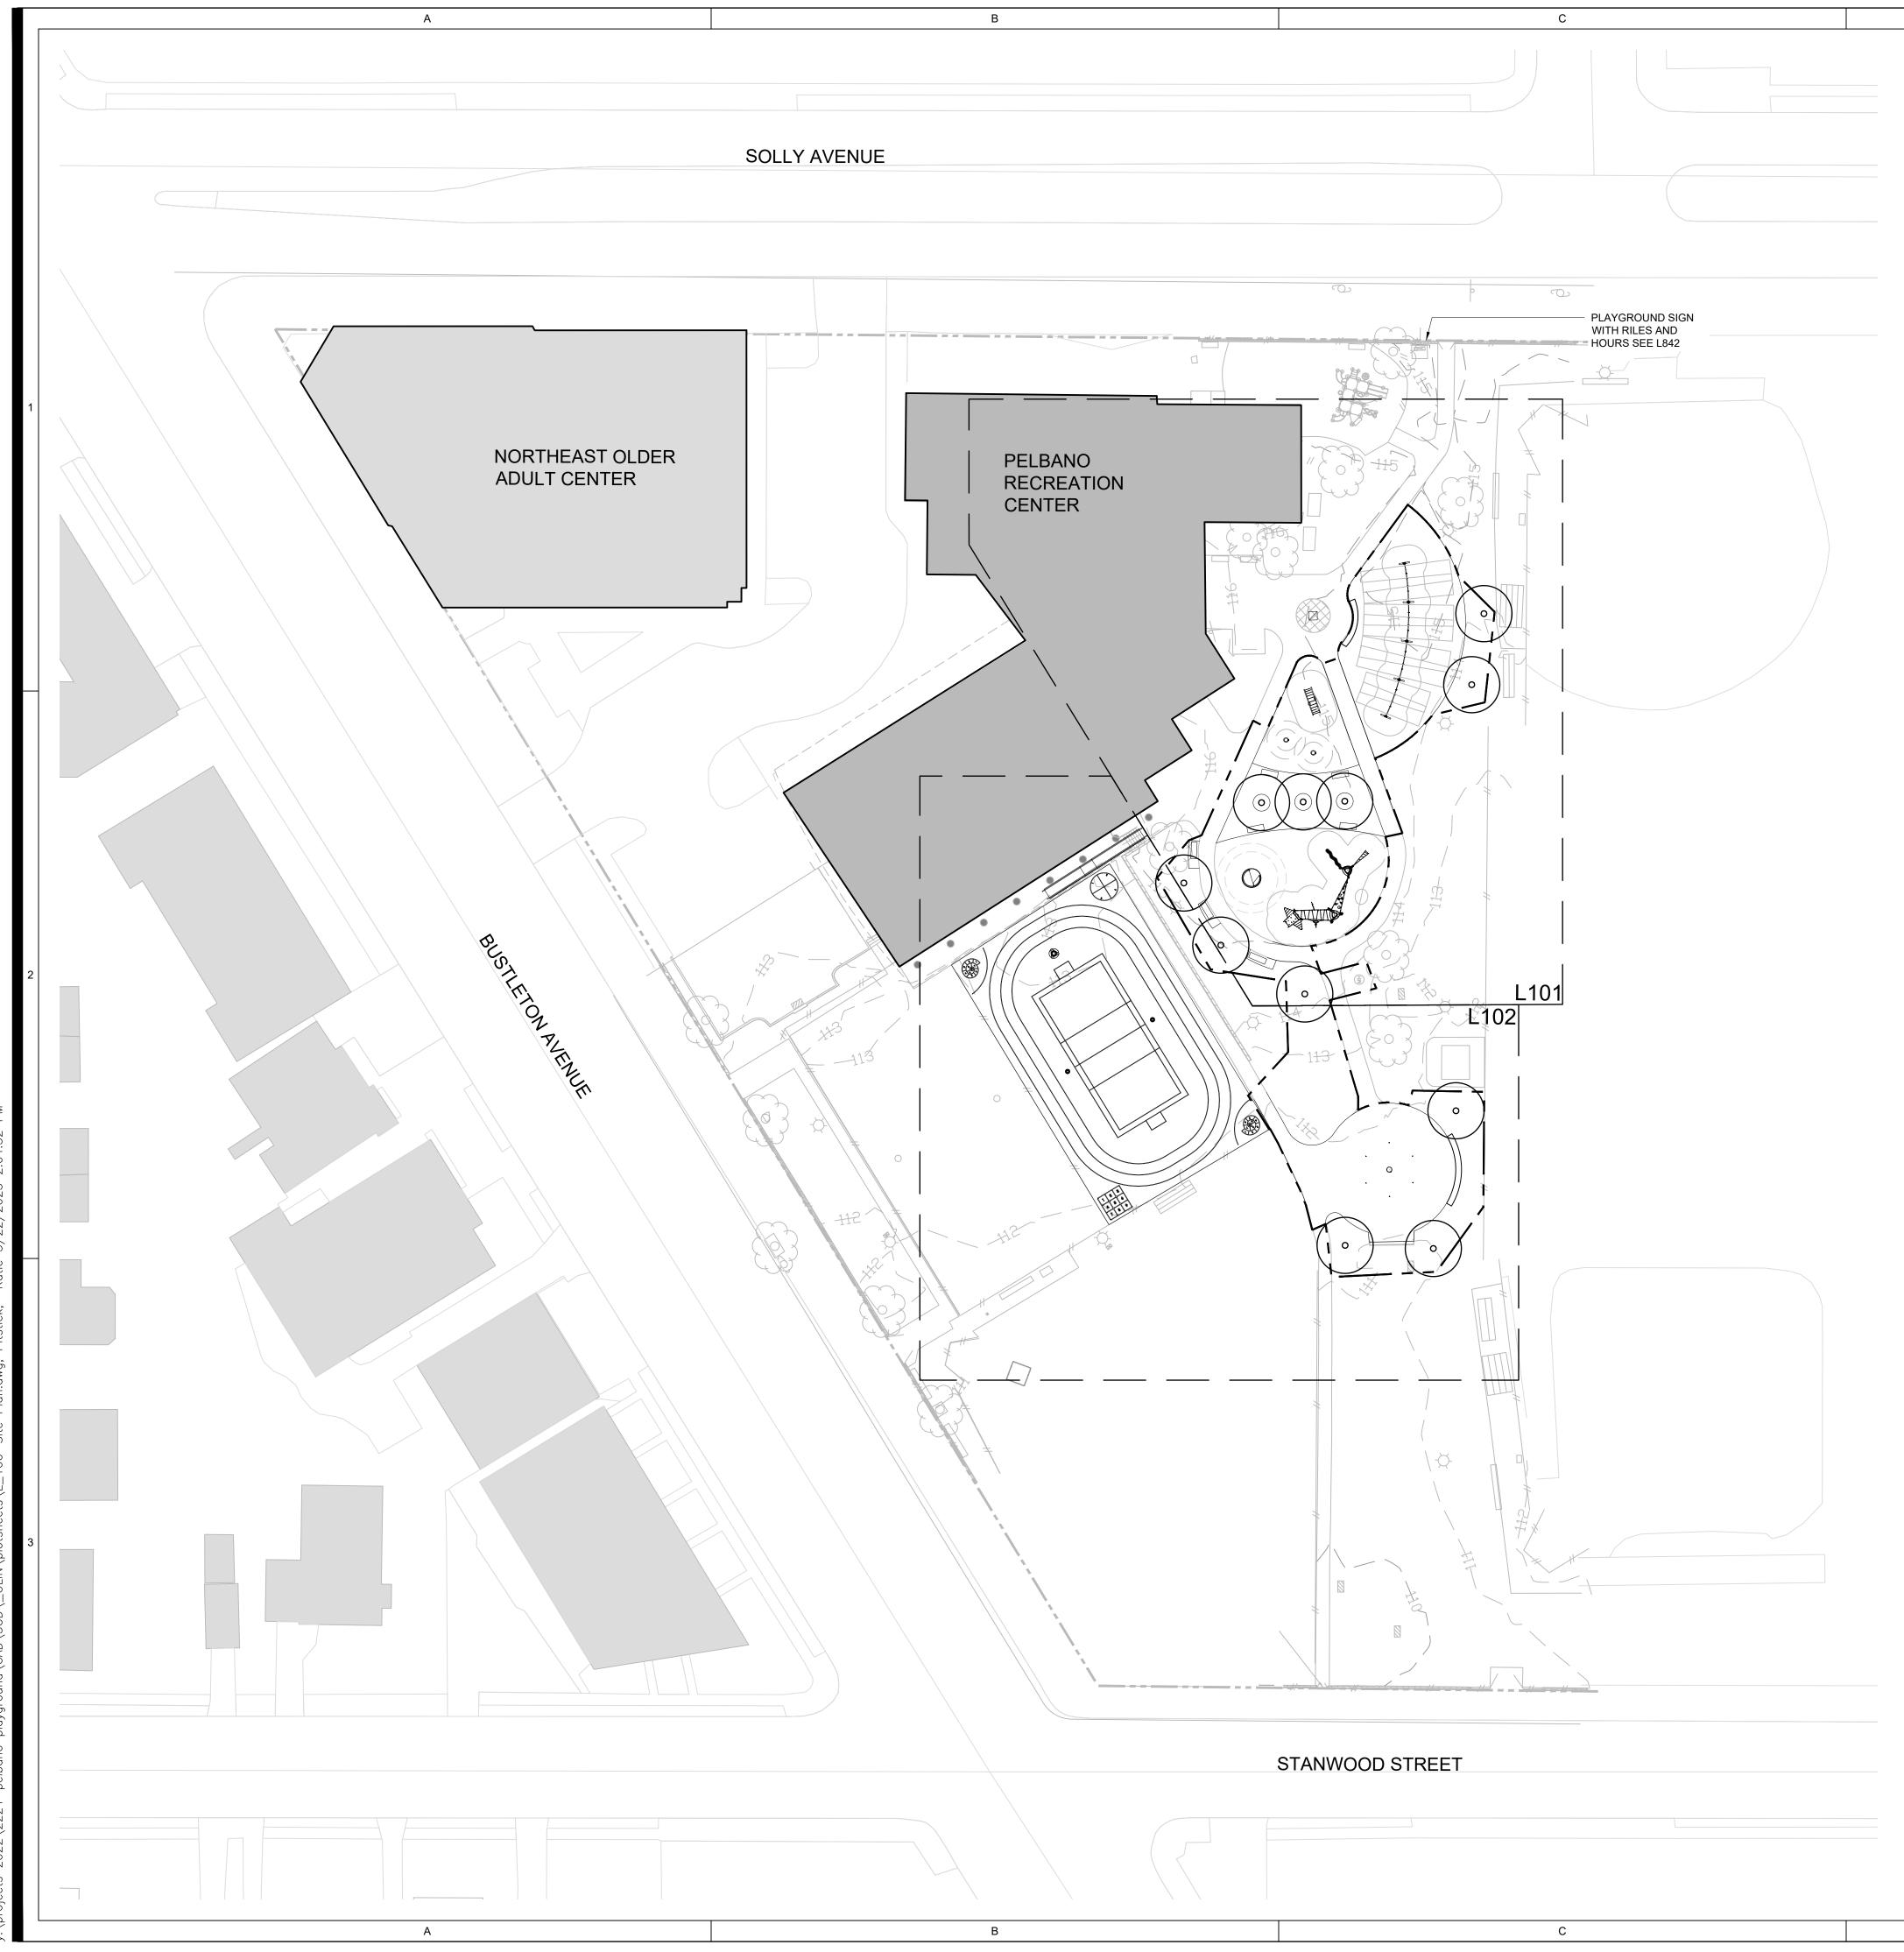

### SITE PLAN LEGEND

0

 PROJECT LIMIT LINE
 PROPERTY LINE
BUILDING
EXISTING TREE

PROPOSED TREE

	AREA OF DISTURBAN	NCE
WITHIN	PROJECT LIMIT LINE	14,200 SF

FOOTINGS IN SPORT COURT TOTAL

60 SF 14,260 SF

### SITE PLAN NOTES

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- 12. SEE CIVIL DWGS FOR DEMOLITION AND POLE, FIXTURES, AND DRAIN LOCATIONS.

SCALE: 1" = 30'-0"



### 8101 BUSTLETON AVENUE

## OLIN

LANDSCAPE ARCHITECTURE / URBAN DESIGN / PLANNING ONE PENN CENTER 1617 JOHN F. KENNEDY BOULEVARD, SUITE 1900 PHILADELPHIA, PA 19103 TEL 215.440.0030 / FAX 215.440.0041 WWW THEOLINSTUDIO COM OLIN PARTNERSHIP, LTD.

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### SITE PLAN

1"=30'
5/31/2023
KMP
TS
2224

## L100



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MATCH

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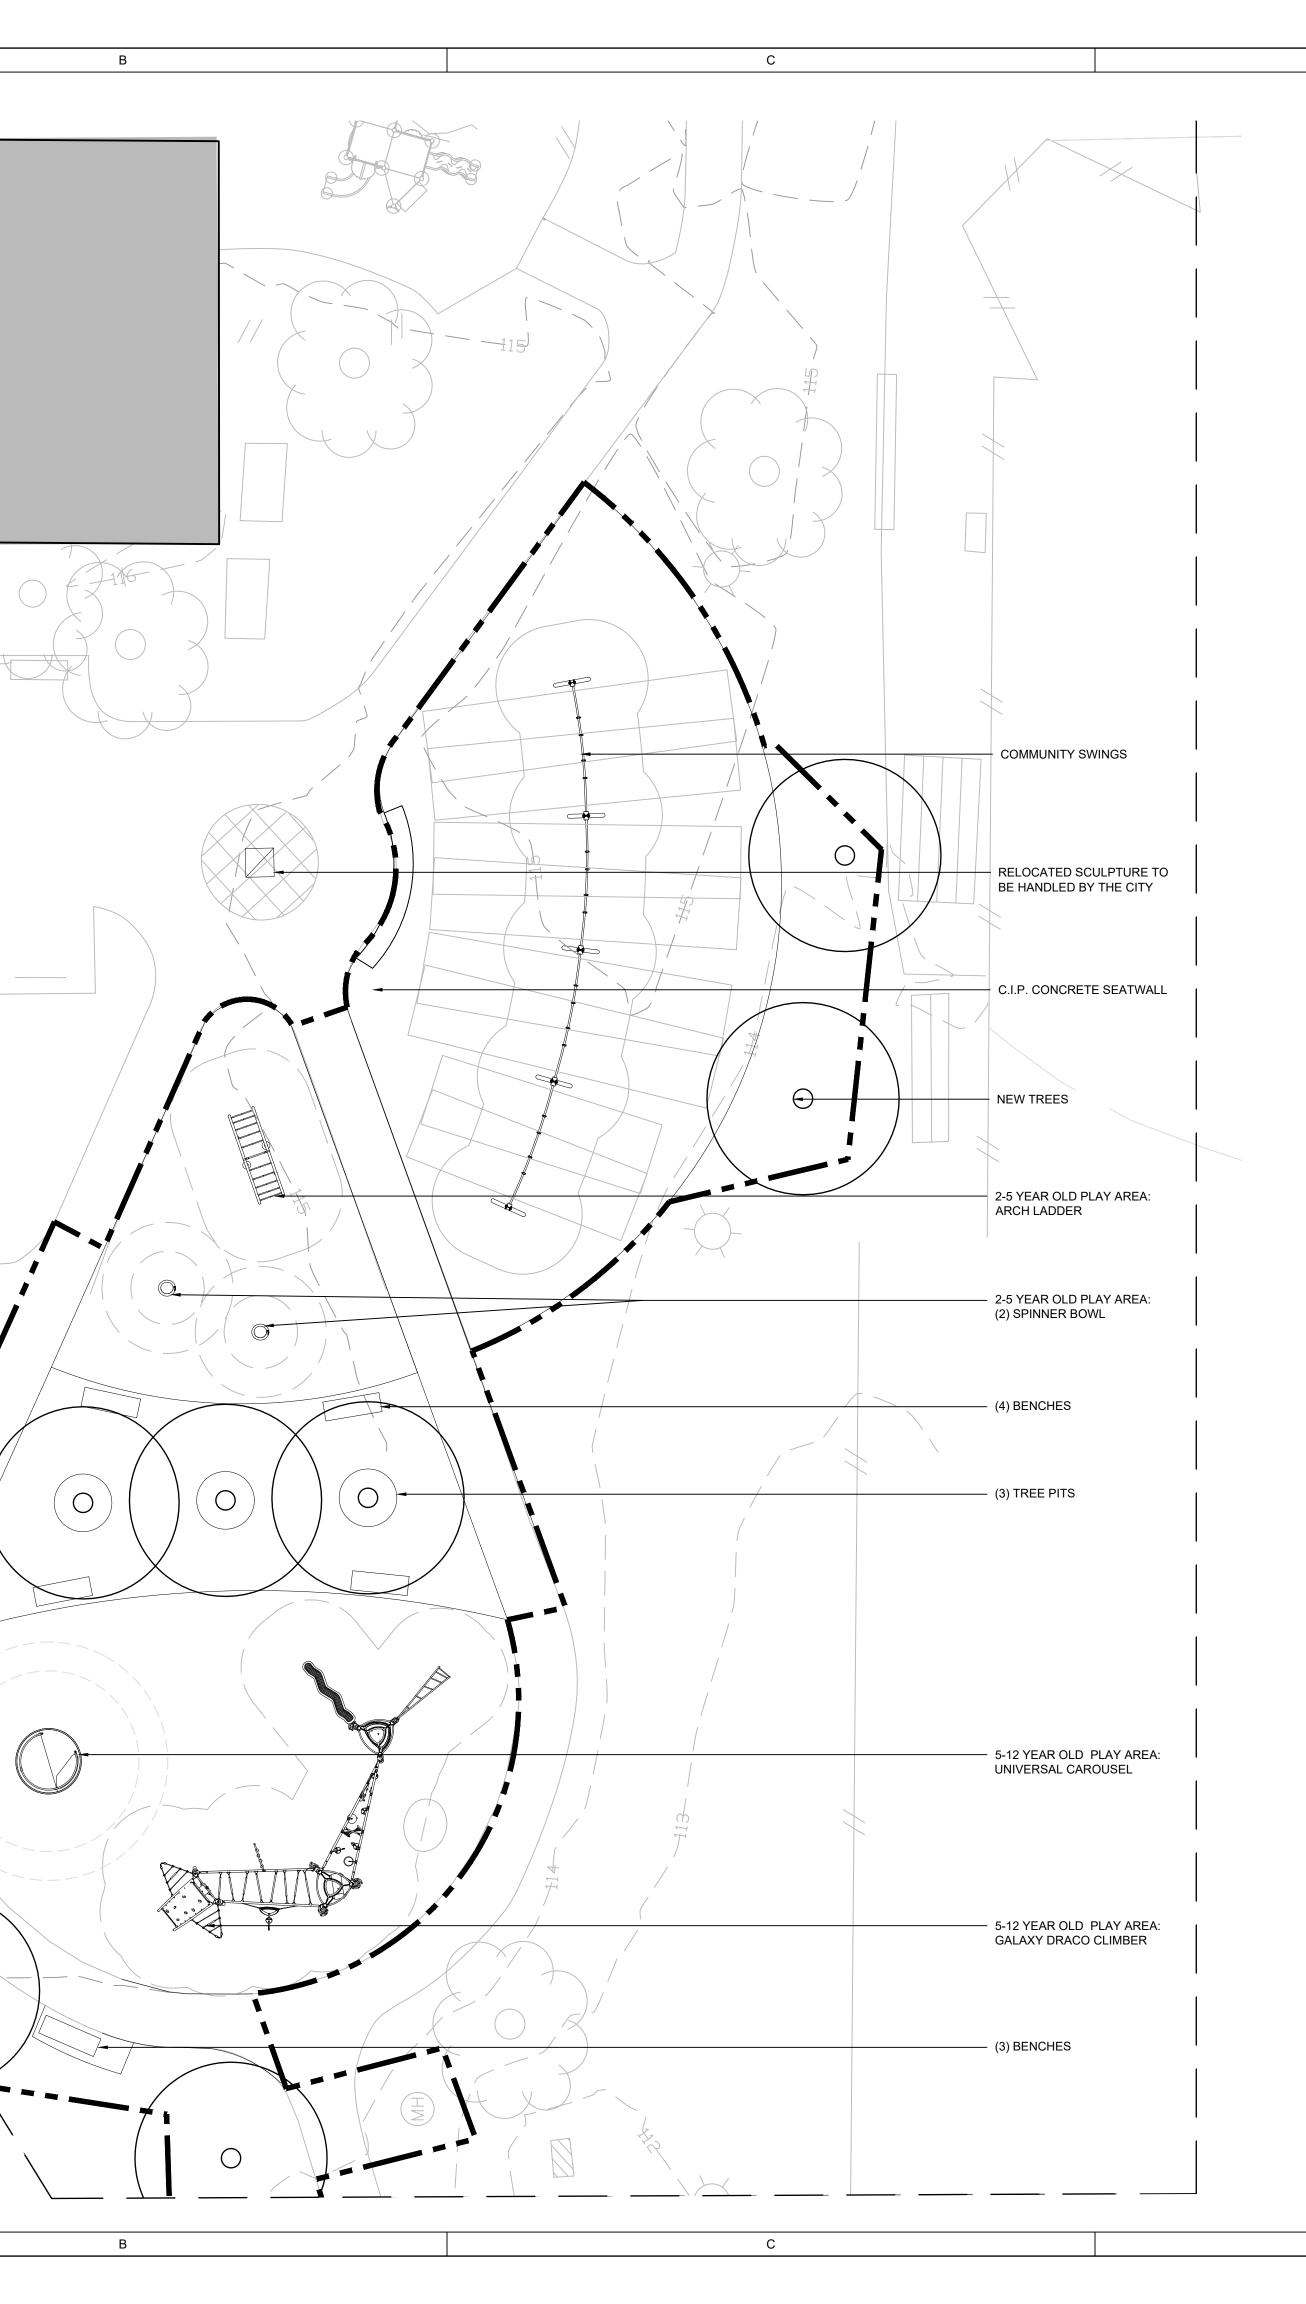
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PELBANO

CENTER

RECREATION



### SITE PLAN LEGEND

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0

PROJECT LIMIT LINE

BUILDING

EXISTING TREE

PROPOSED TREE

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# PLAYGROUND

8101 BUSTLETON AVENUE

PELBANO

## OLIN

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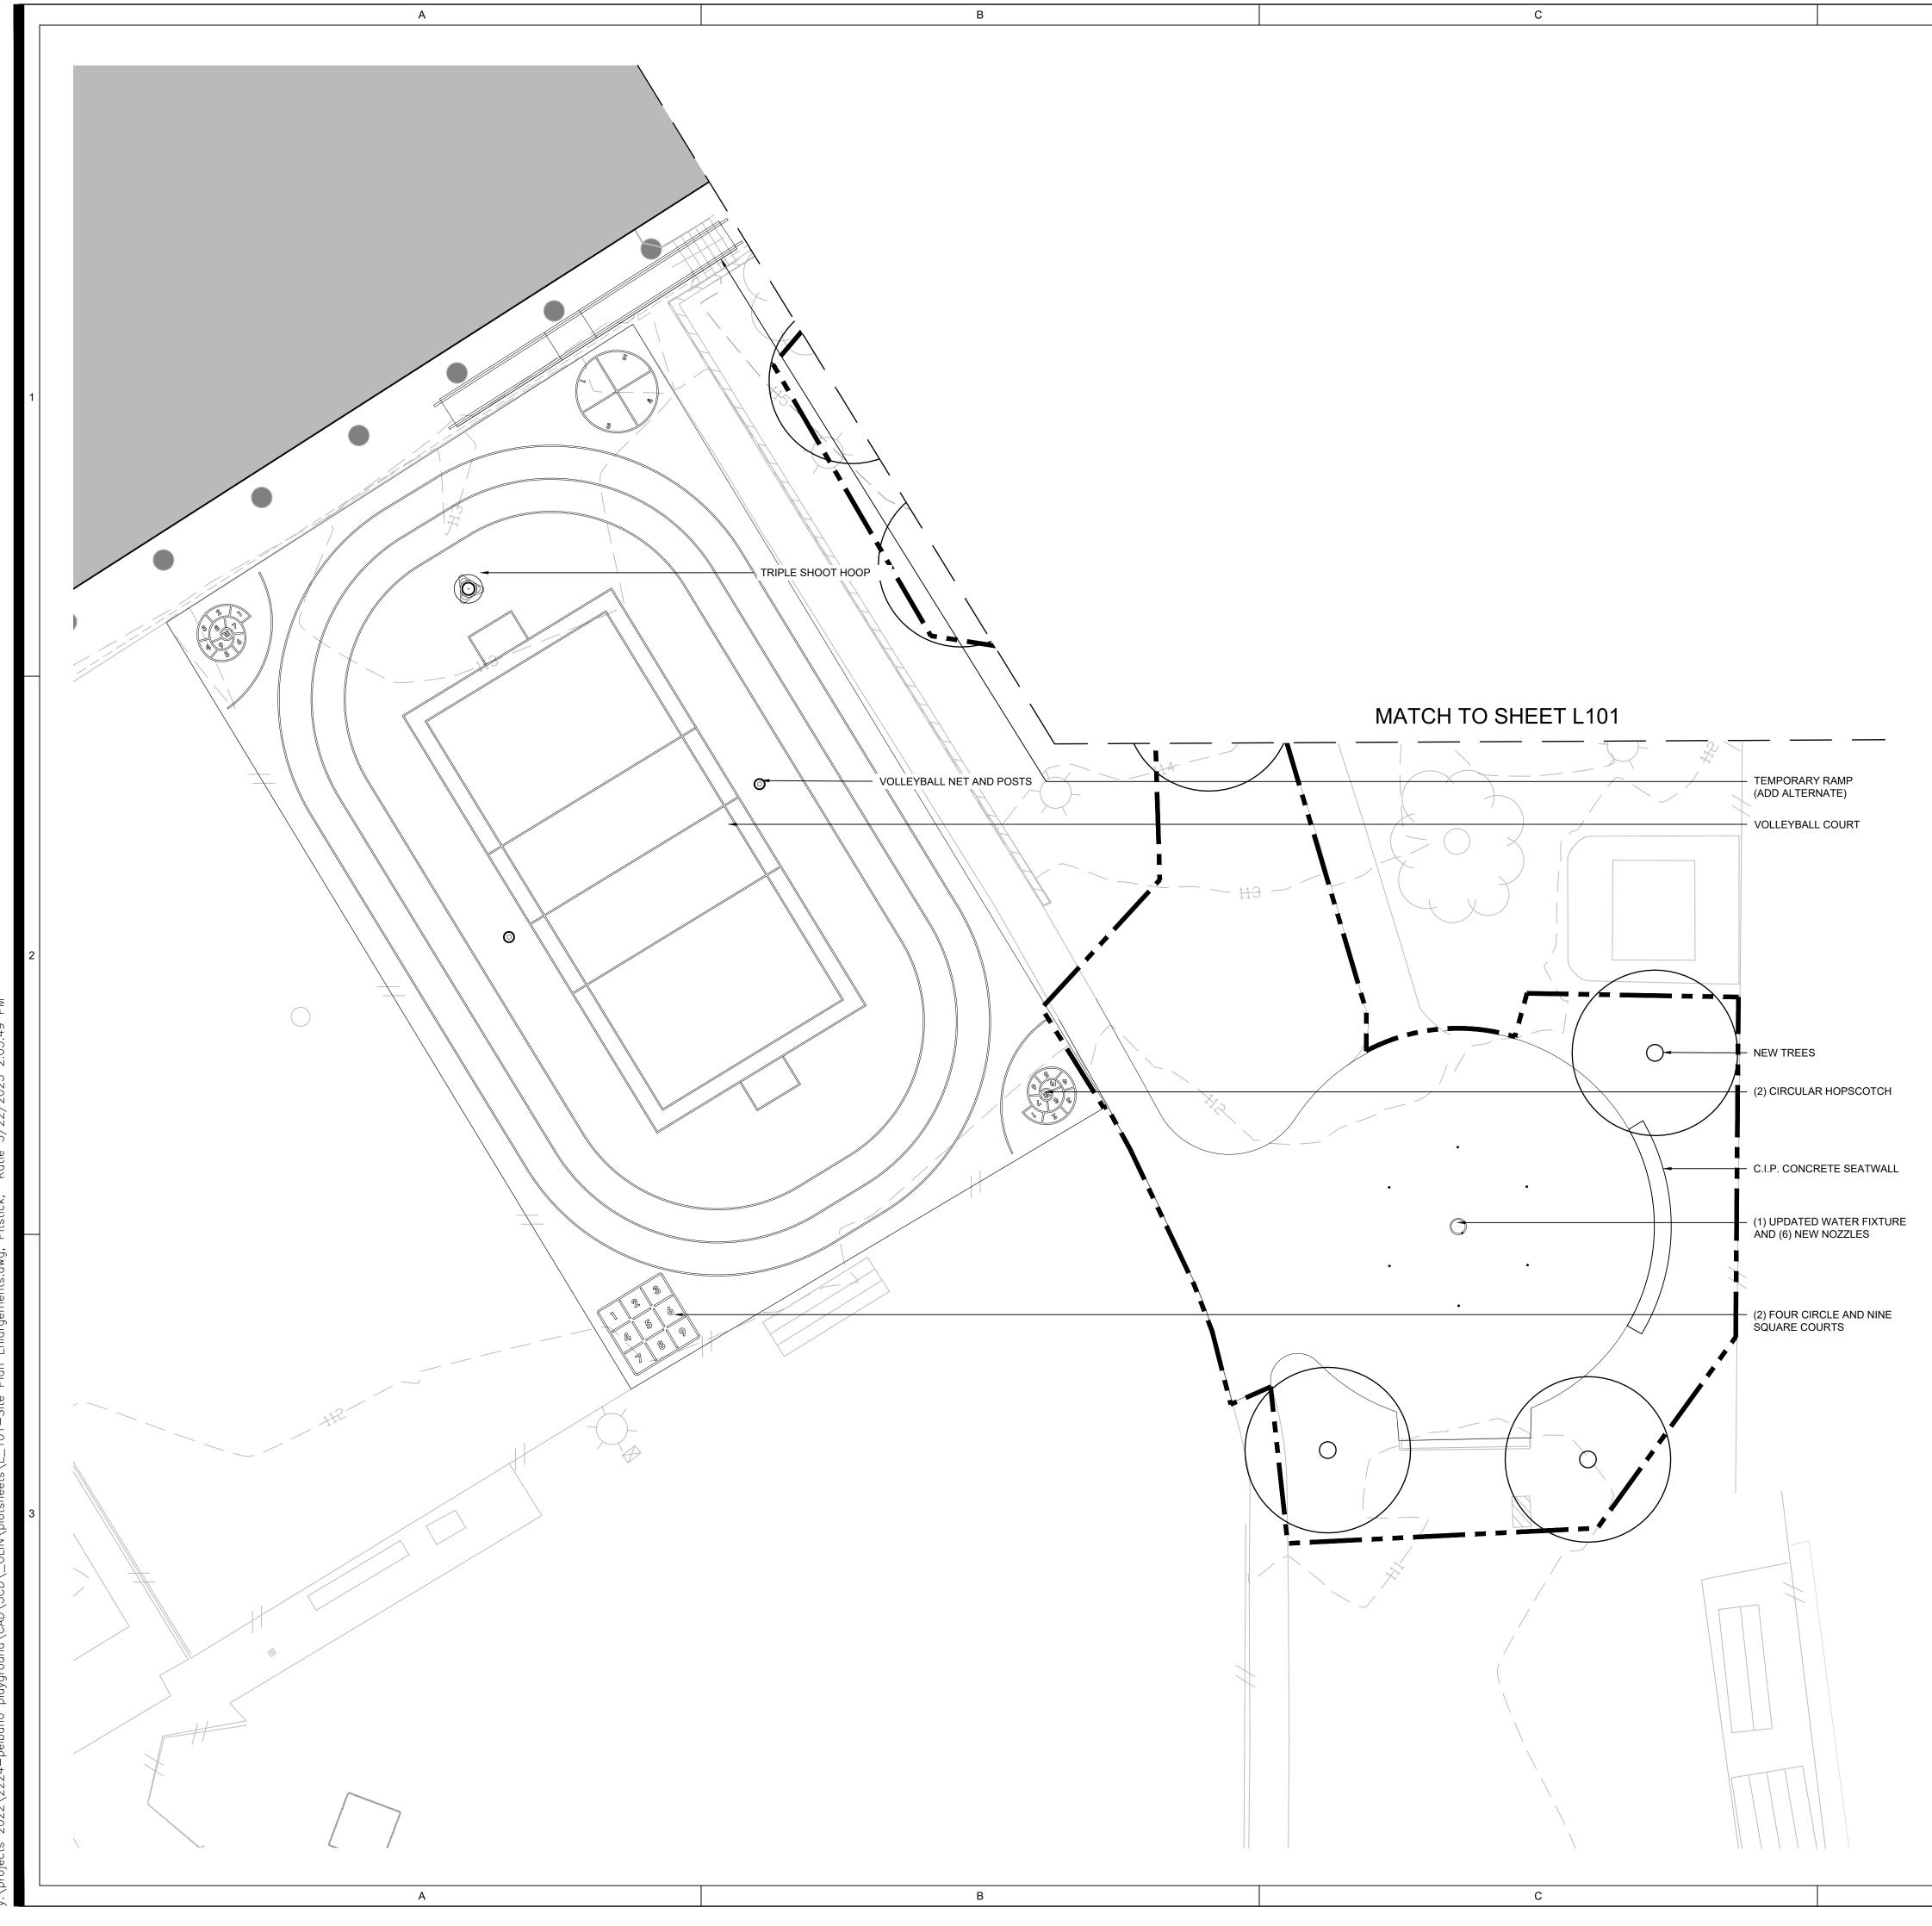
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	10/12/2022 11/16/2022 2/21/2023 4/17/2023

### SITE PLAN - AREA 1

Scale:	1"=10'
Date:	5/31/2023
Drawn:	KMP
Checked:	TS
Project No.:	2224





### SITE PLAN LEGEND

0

PROJECT LIMIT LINE

PROPERTY LINE BUILDING

EXISTING TREE

PROPOSED TREE

### SITE PLAN NOTES

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## PELBANO PLAYGROUND

### 8101 BUSTLETON AVENUE

## OLIN

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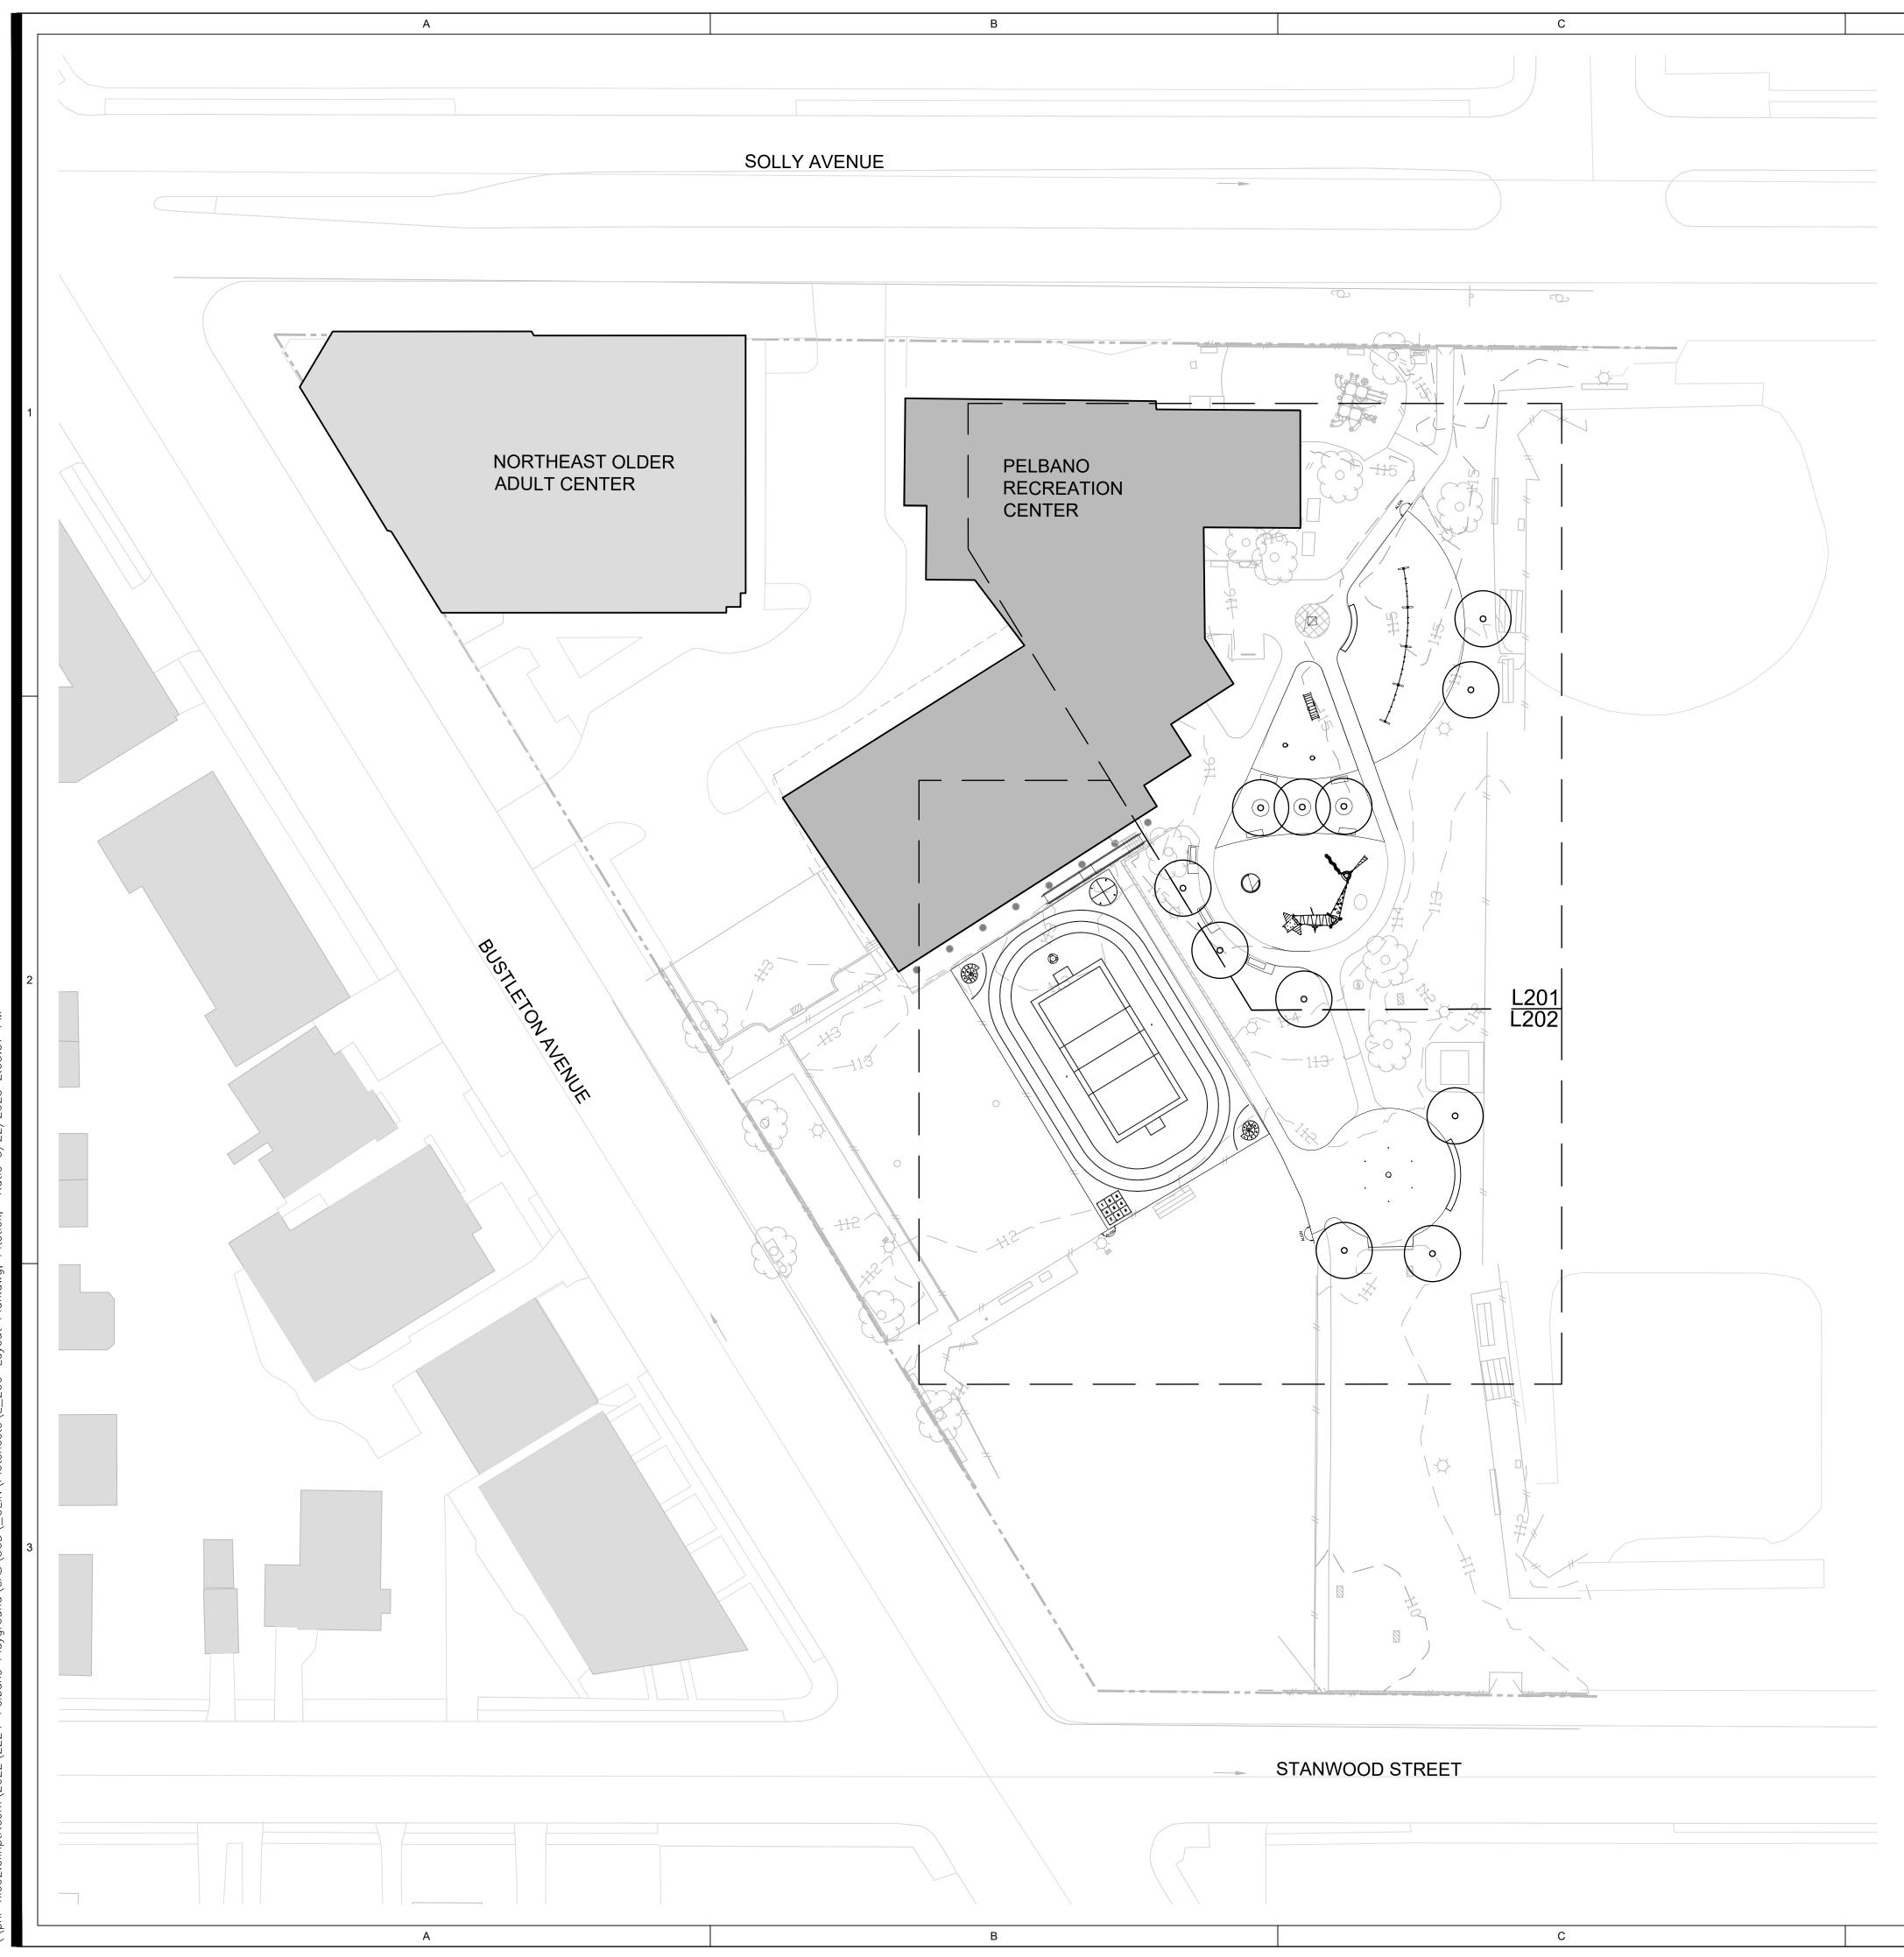
MEP: Mark Ulrick 30 N. 41ST SUITE 500 Philadelphia, PA 19104 (856) 320-8100

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4	4/17/2023	75% CD set
5	5/31/2023	100% CD set

### SITE PLAN - AREA 2

Scale:	1"=10'
Date:	5/31/2023
Drawn:	KMP
Checked:	TS
Project No.:	2224





### LAYOUT LEGEND

	PROJECT LIMIT LINE
	PROPERTY LINE
	BUILDING
·····	PROPOSED PLANTING
Ę xxxxxx	CENTERLINE
BL	BASELINE / LAYOUT LINE
DEG	DEGREE
DIA	DIAMETER
EL	EASEMENT LINE
EQ	EQUAL
FOC	FACE OF CURB
FOW	FACE OF WALL
L	LENGTH OF CURVE
OC	ON CENTER
R	RADIUS OF CURVE
Т	TANGENT LENGTH
VIF	VERIFY IN FIELD
ALIGN	
	ALIGN
РОВА	POINT OF BEGINNING

LAYOUT PLAN NOTES

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D



## PELBANO PLAYGROUND

### 8101 BUSTLETON AVENUE

## OLIN

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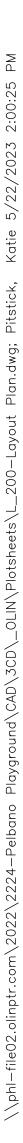
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## LAYOUT KEY PLAN

Scale:	1"=30'
Date:	5/31/2023
Drawn:	KMP
Checked:	TS
Project No.:	2224





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MACH

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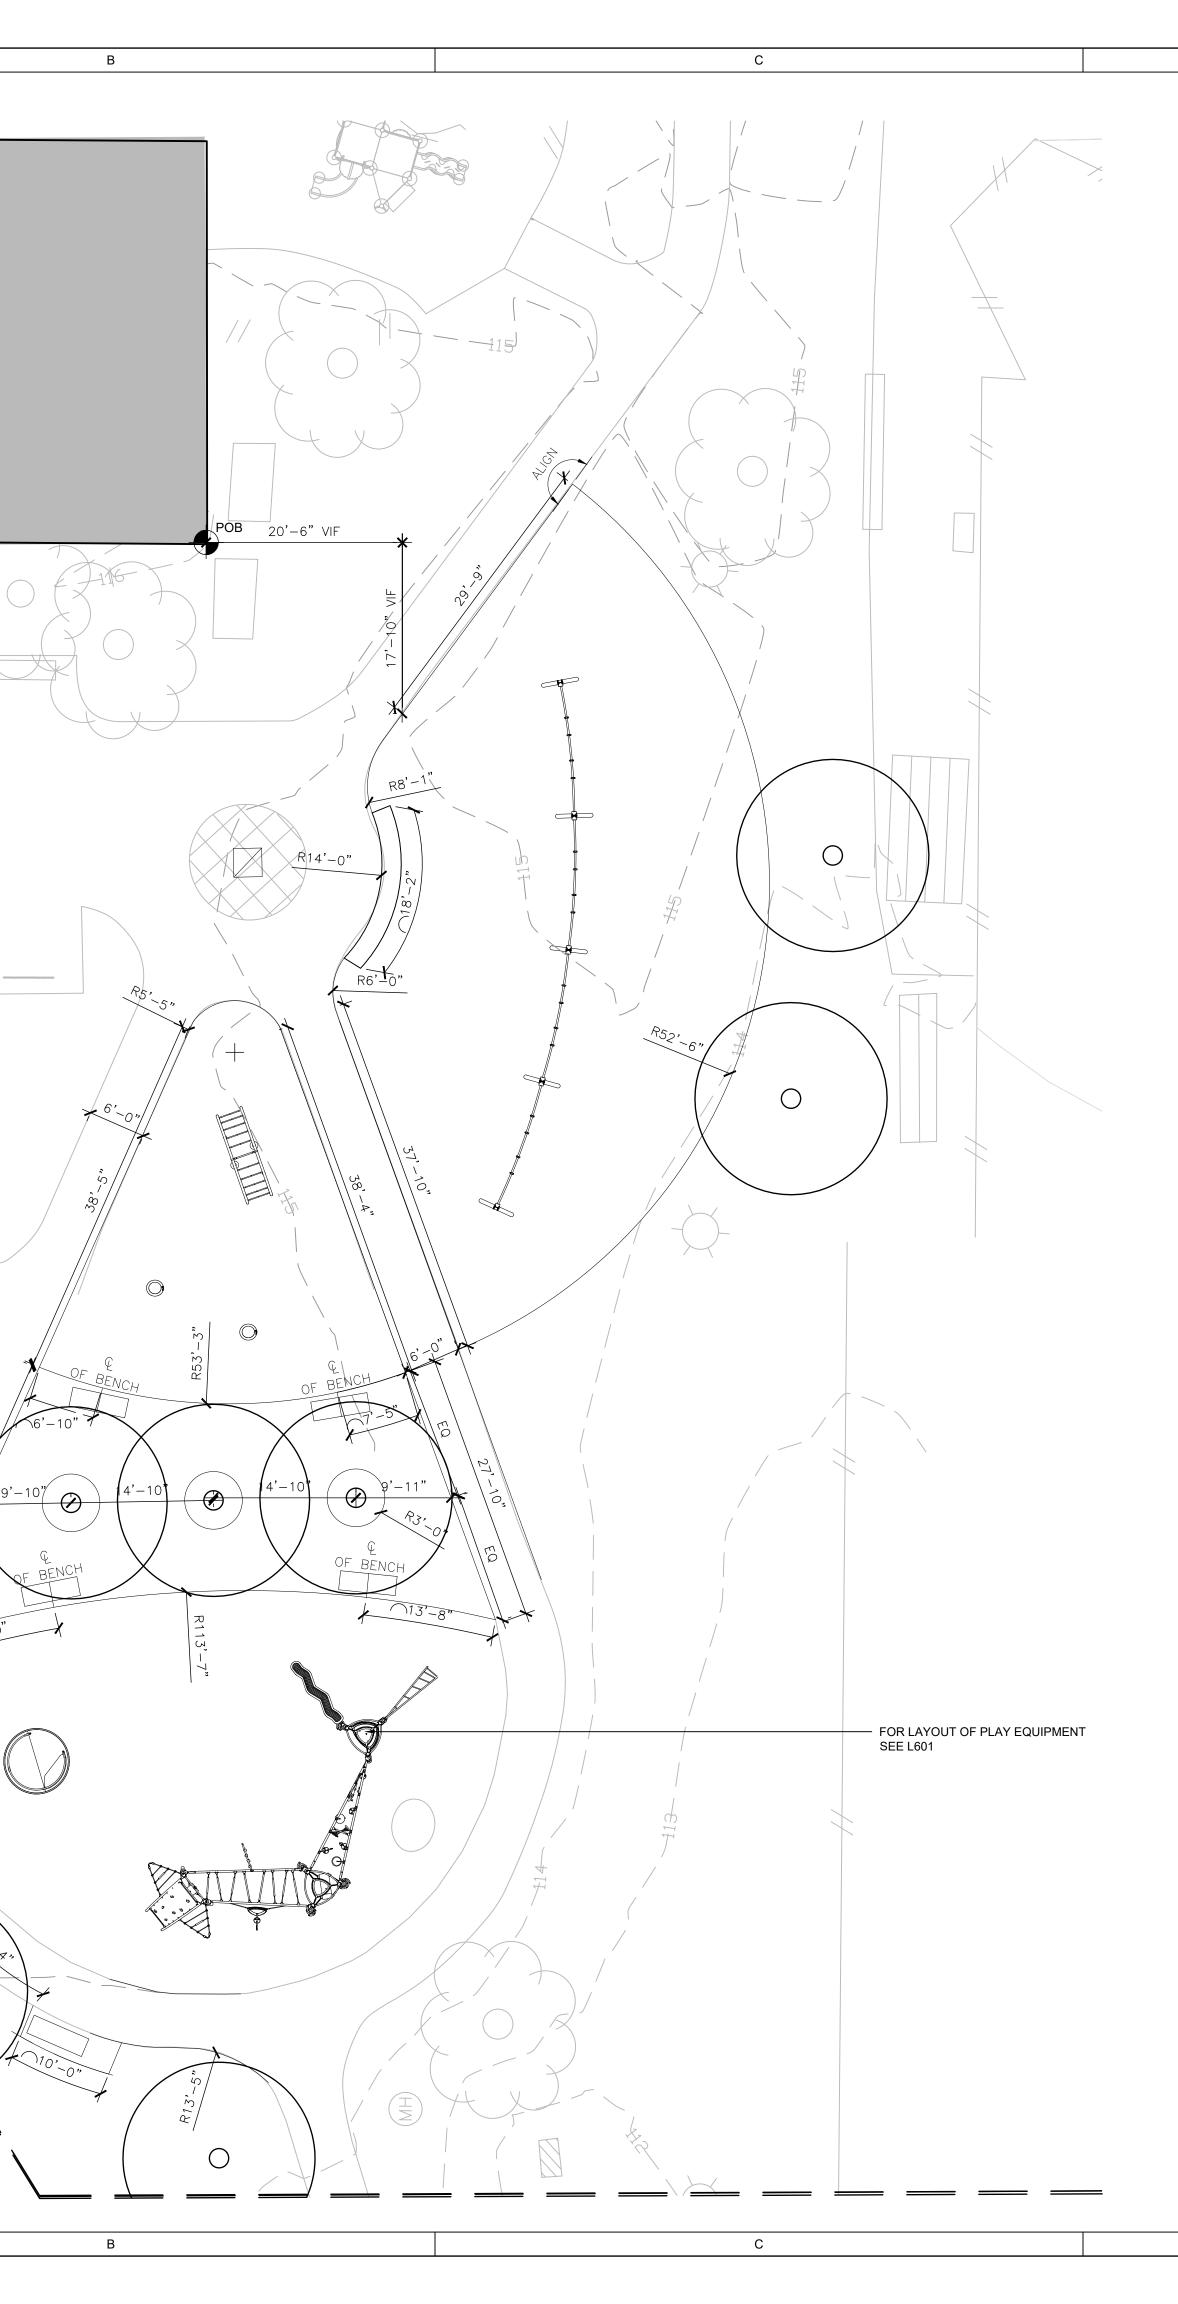
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HERT ISON

PELBANO

CENTER

RECREATION



### LAYOUT LEGEND

	PROJECT LIMIT LINE
	PROPERTY LINE
	BUILDING
·····	PROPOSED PLANTING
Ę xxxxxx	CENTERLINE
BL	BASELINE / LAYOUT LINE
DEG	DEGREE
DIA	DIAMETER
EL	EASEMENT LINE
EQ	EQUAL
FOC	FACE OF CURB
FOW	FACE OF WALL
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	ALIGN
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,	

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0' 10' SCALE: 1" = 10-0"

## PELBANO PLAYGROUND

### 8101 BUSTLETON AVENUE

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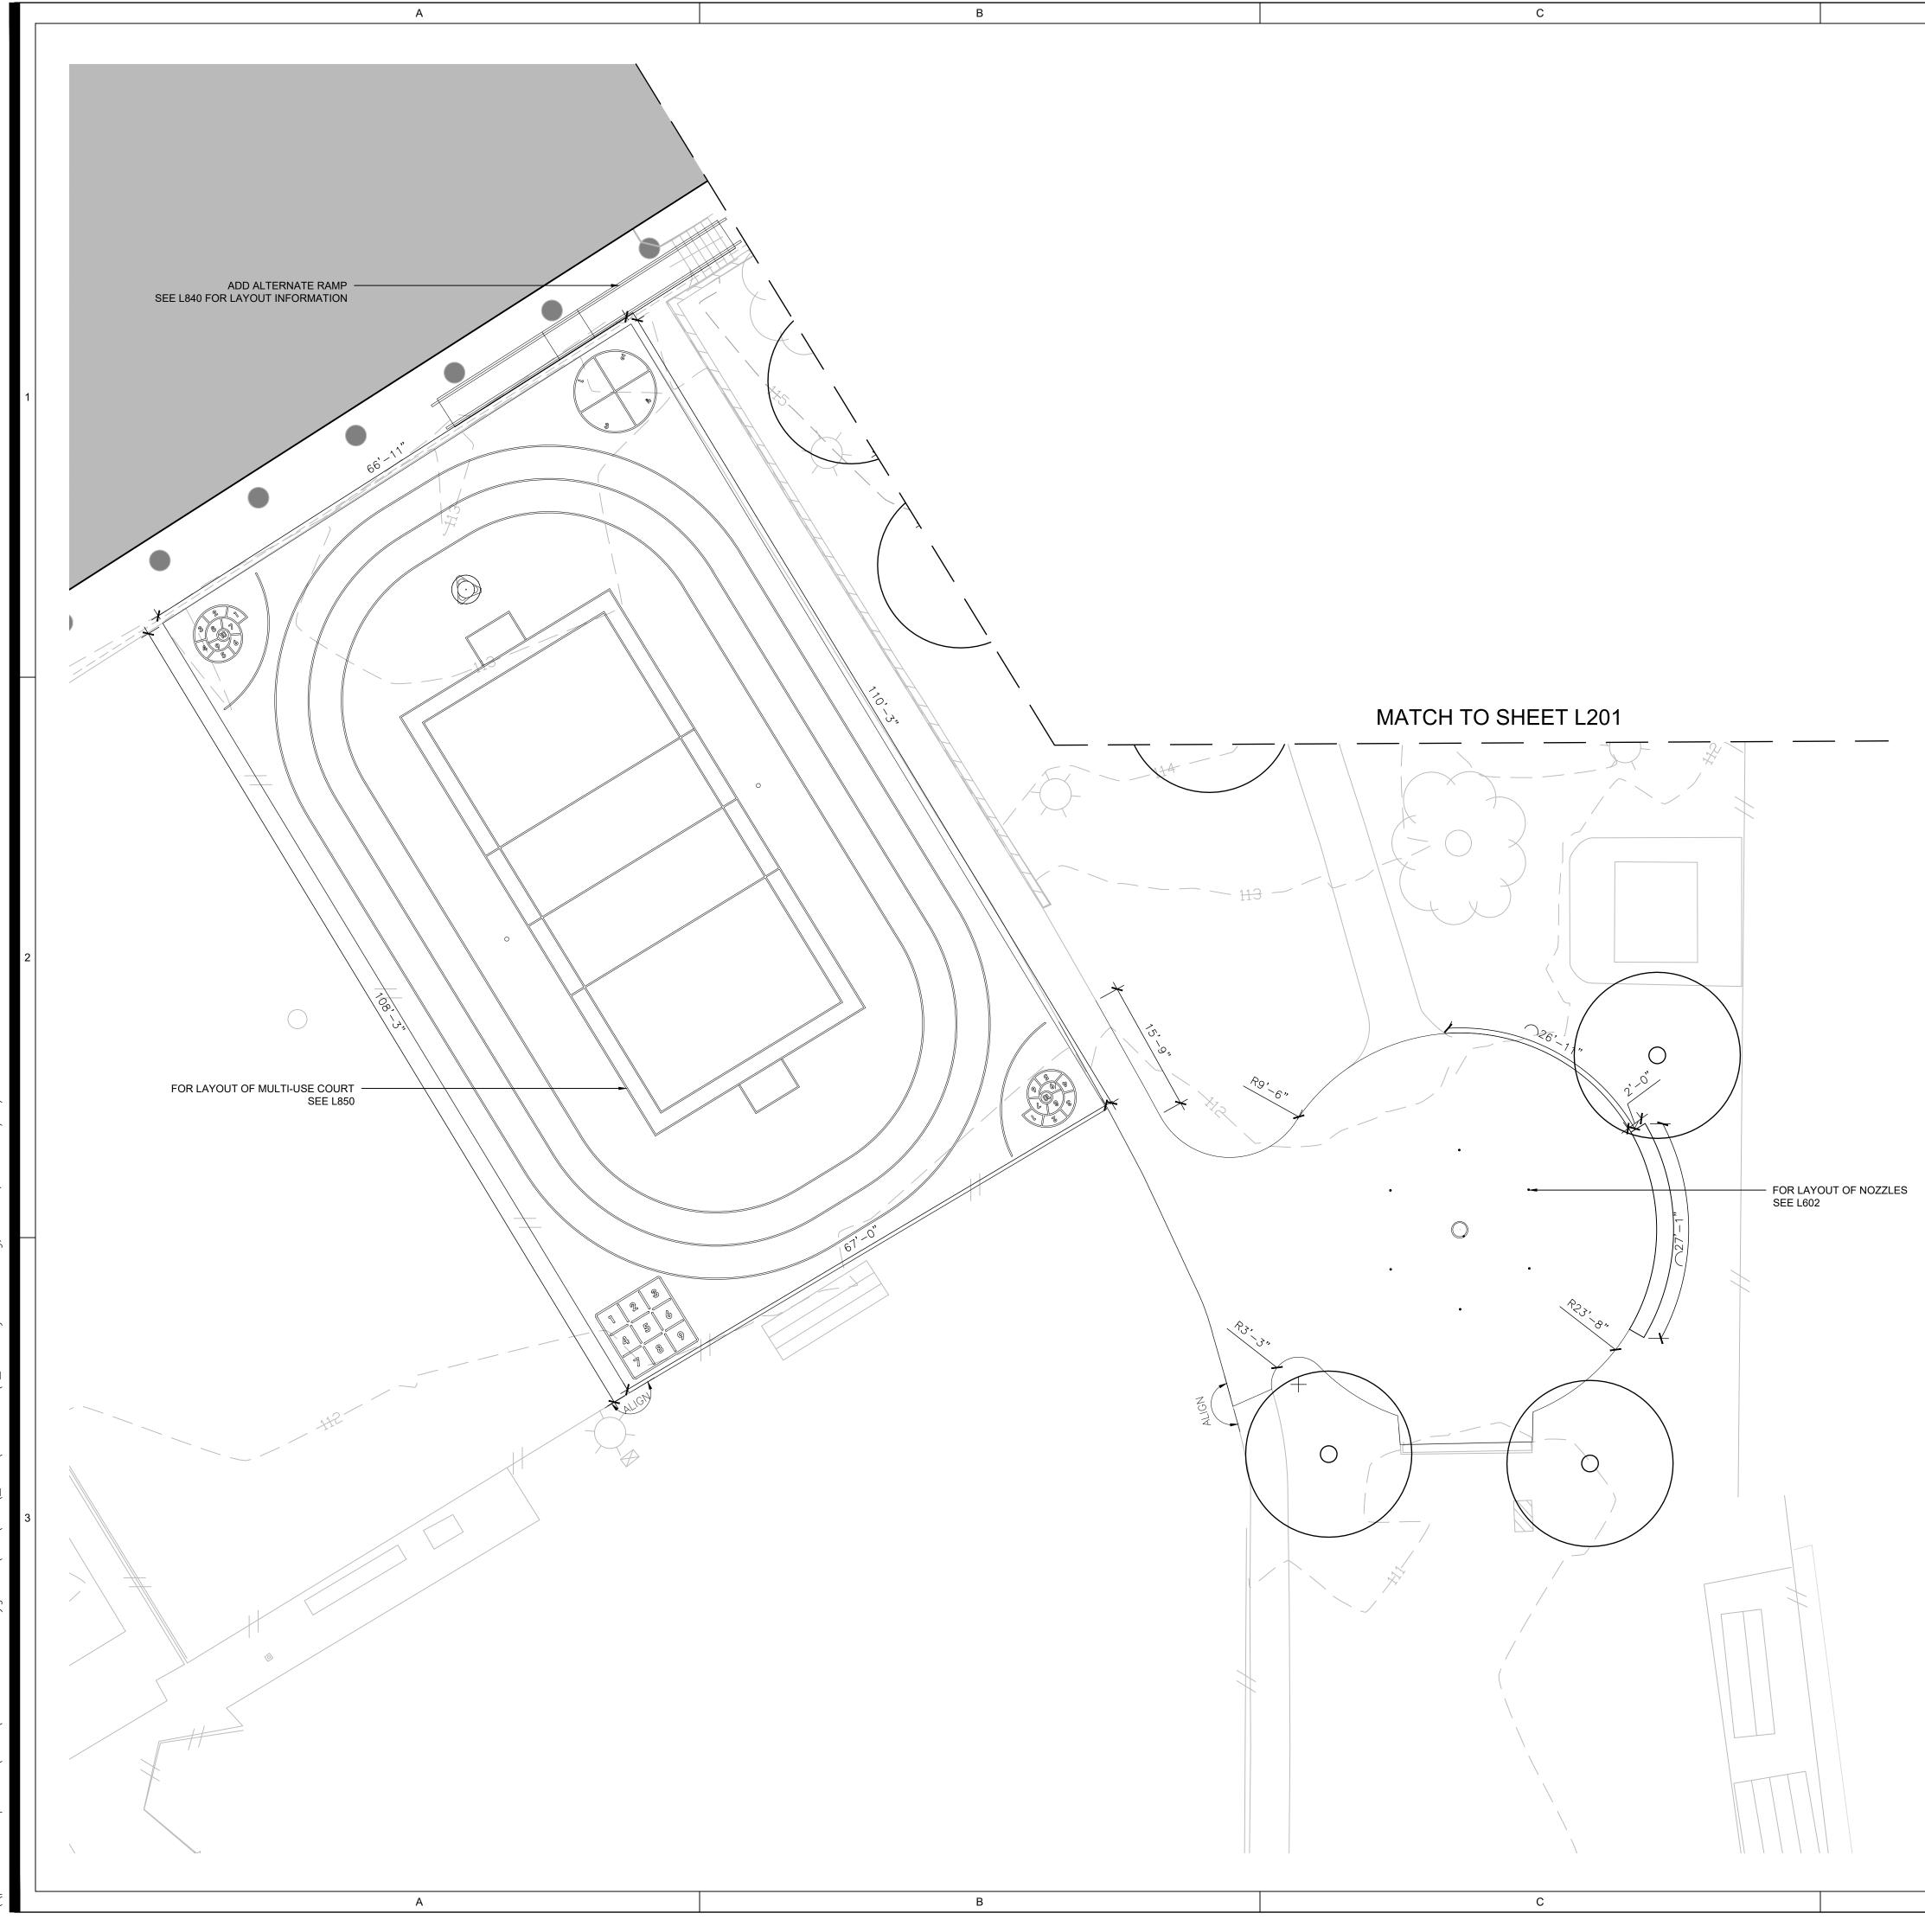
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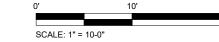


### LAYOUT LEGEND

	PROJECT LIMIT LINE
	PROPERTY LINE
	BUILDING
·····	PROPOSED PLANTING
Ę xxxxxx	CENTERLINE
BL	BASELINE / LAYOUT LINE
DEG	DEGREE
DIA	DIAMETER
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## PELBANO PLAYGROUND

### 8101 BUSTLETON AVENUE

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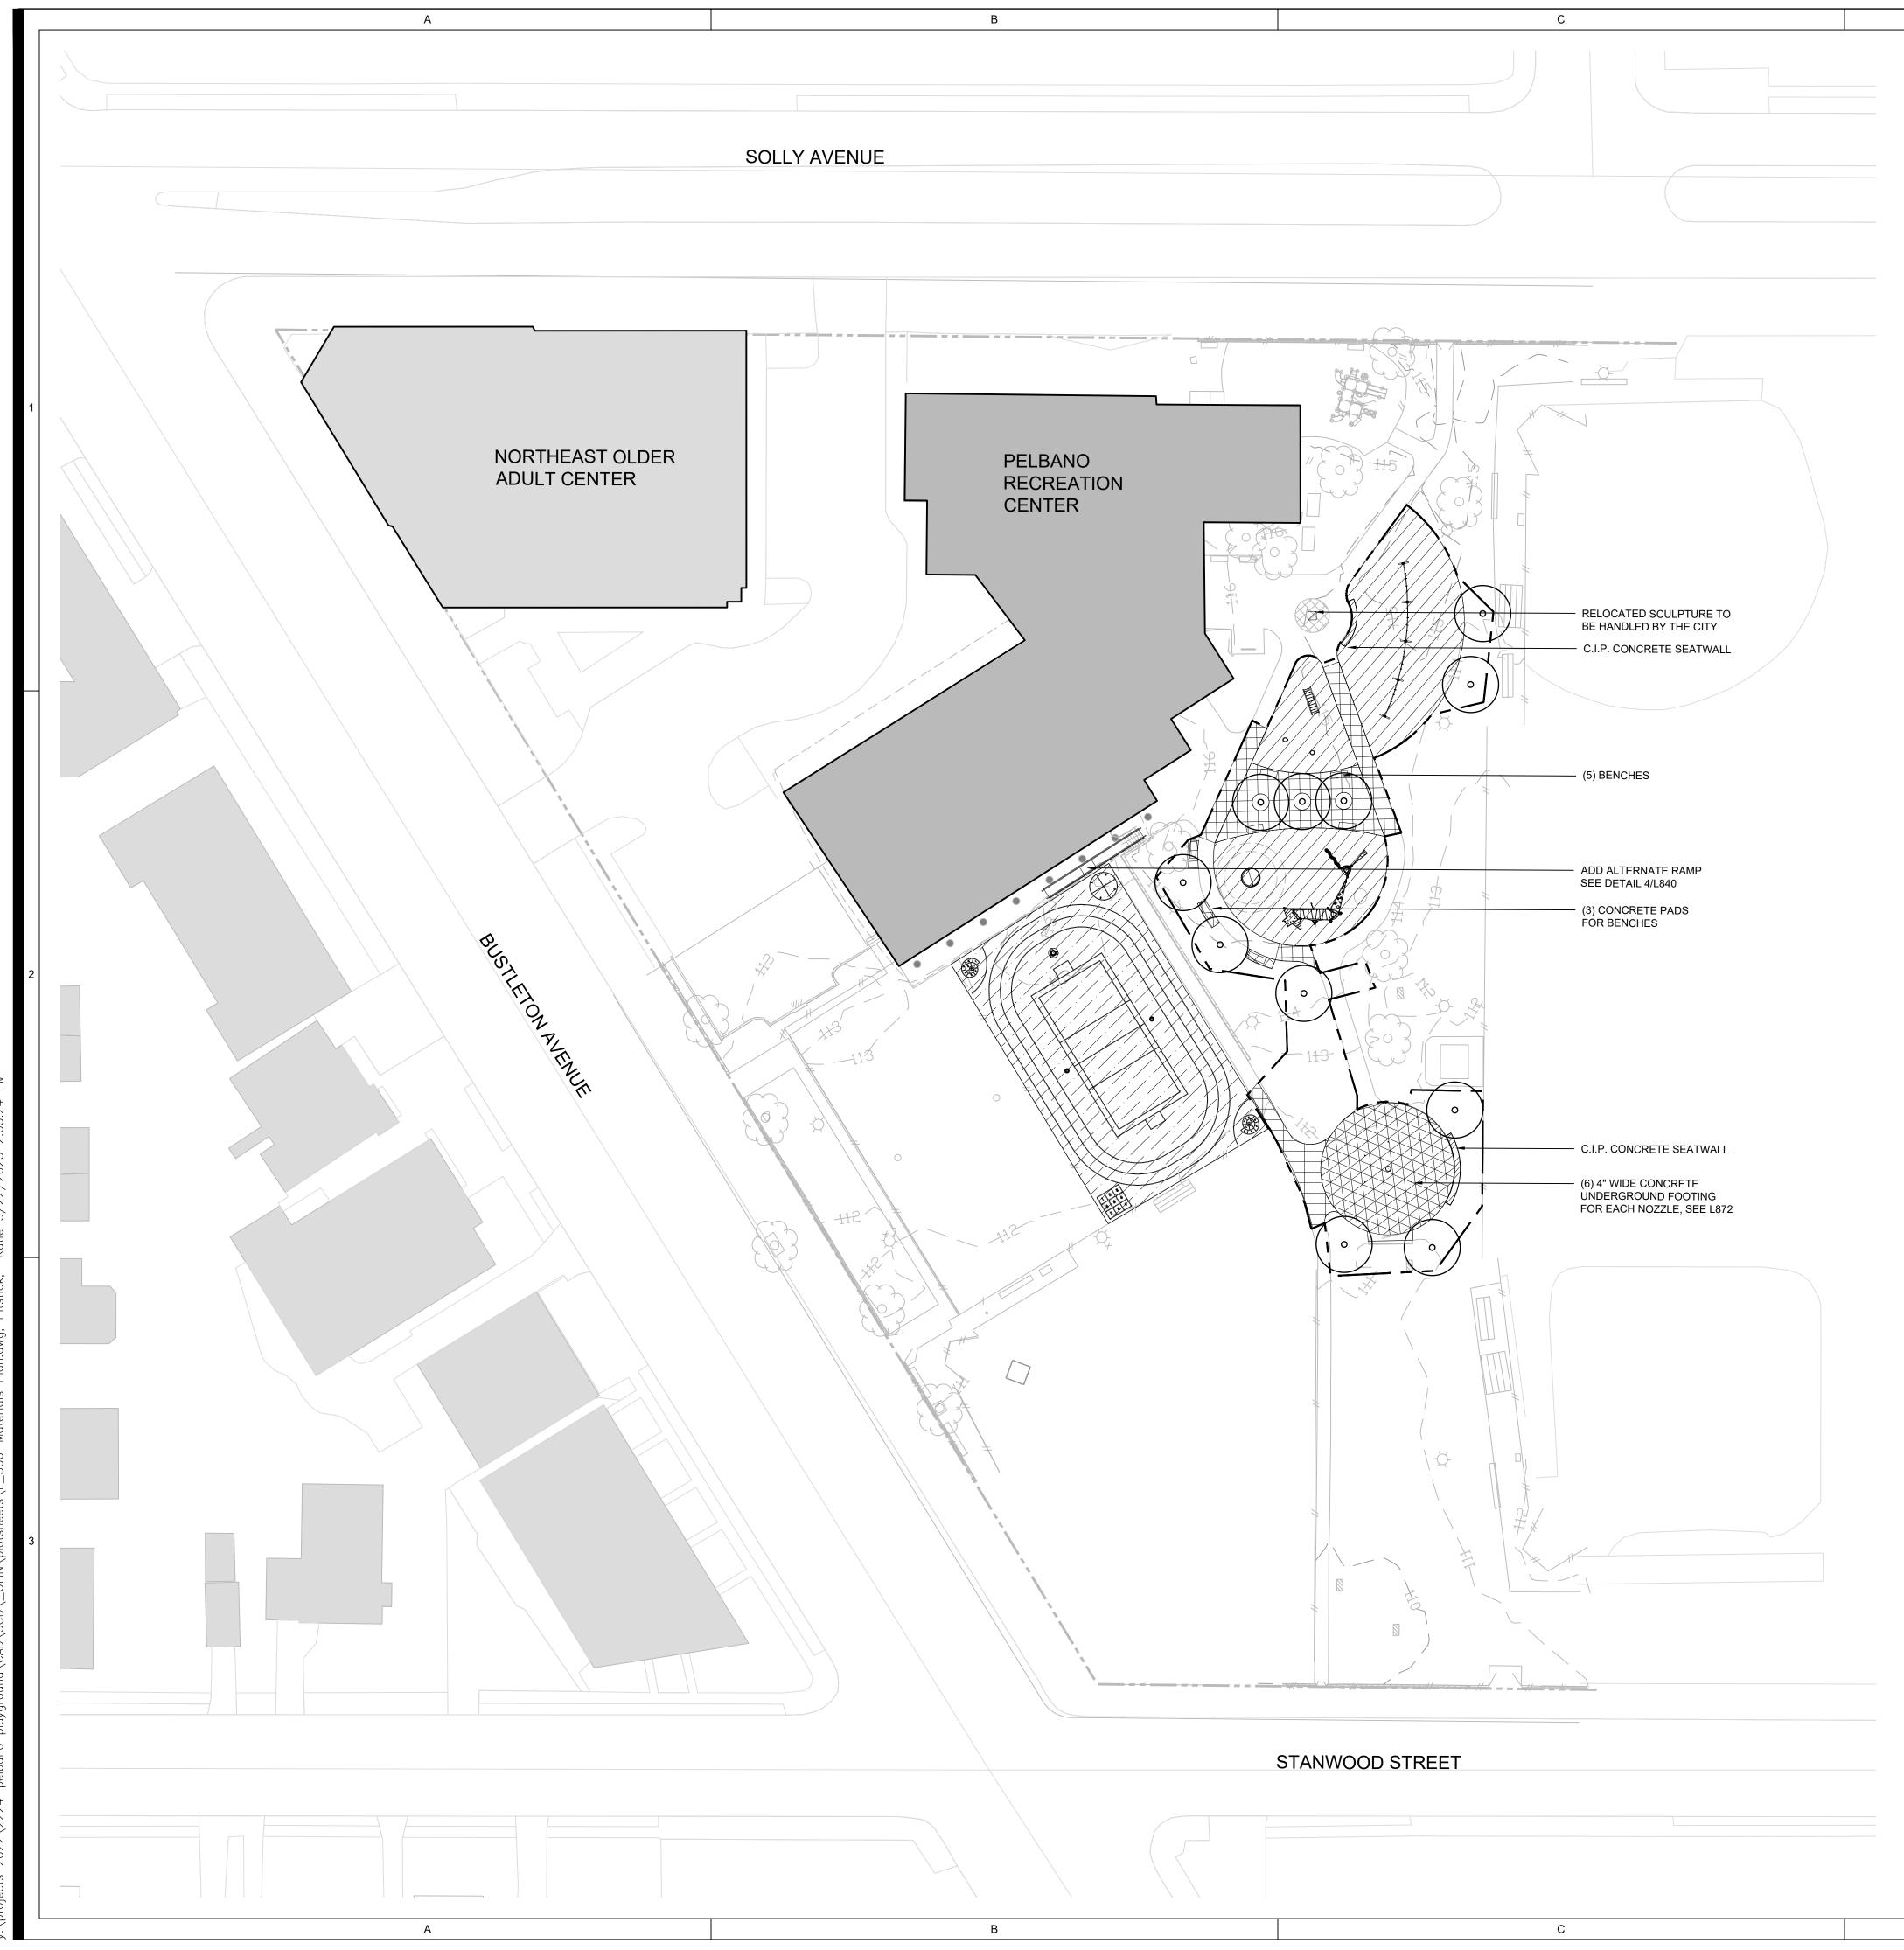
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### LAYOUT PLAN - AREA 2

Scale:	1"=10'
Date:	5/31/2023
Drawn:	KMP
Checked:	TS
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### D

### MATERIAL LEGEND

PROJECT LIMIT LINE
PROPERTY LINE
BUILDING
C.I.P. CONCRETE PAVING WITH BROOM FINISH SEE 1/L830
ASPHALT PAVING - MILL AND OVERLAY AND PAINTED SEE 2/L830
C.I.P. CONCRETE PAVING WITH BROOM FINISH FOR SPRAYGROND SEE 3/L830
PLAY SURFACING SEE L870/L871
CONCRETE SEATWALL SEE 2/L840

MATERIAL PLAN NOTES

1. FOR PAVING LAYOUT SEE PAVING PLAN

## PELBANO PLAYGROUND

8101 BUSTLETON AVENUE OLIN LANDSCAPE ARCHITECTURE / URBAN DESIGN / PLANNING ONE PENN CENTER 1617 JOHN F. KENNEDY BOULEVARD, SUITE 1900 PHILADELPHIA, PA 19103 TEL 215.440.0030 / FAX 215.440.0041 WWW.THEOLINSTUDIO.COM OLIN PARTNERSHIP, LTD. Playground Design: Studio Ludo 4800 Springfield Ave Philadelphia, PA 19143 (215) 454-6780 Civil Engineering: Sci Tek 1880 John F Kennedy Blvd #600, Philadelphia, PA 19103 (267) 314-5385 MEP: Mark Ulrick 30 N. 41ST SUITE 500 Philadelphia, PA 19104 (856) 320-8100


No.	Date	Description
1	10/12/2022	SD set
2	11/16/2022	SD set
3	2/21/2023	DD set
4	4/17/2023	75% CD set
5	5/31/2023	100% CD set

## MATERIALS PLAN

Scale:	1"=30'
Date:	5/31/2023
Drawn:	KMP
Checked:	TS
Project No.:	2224





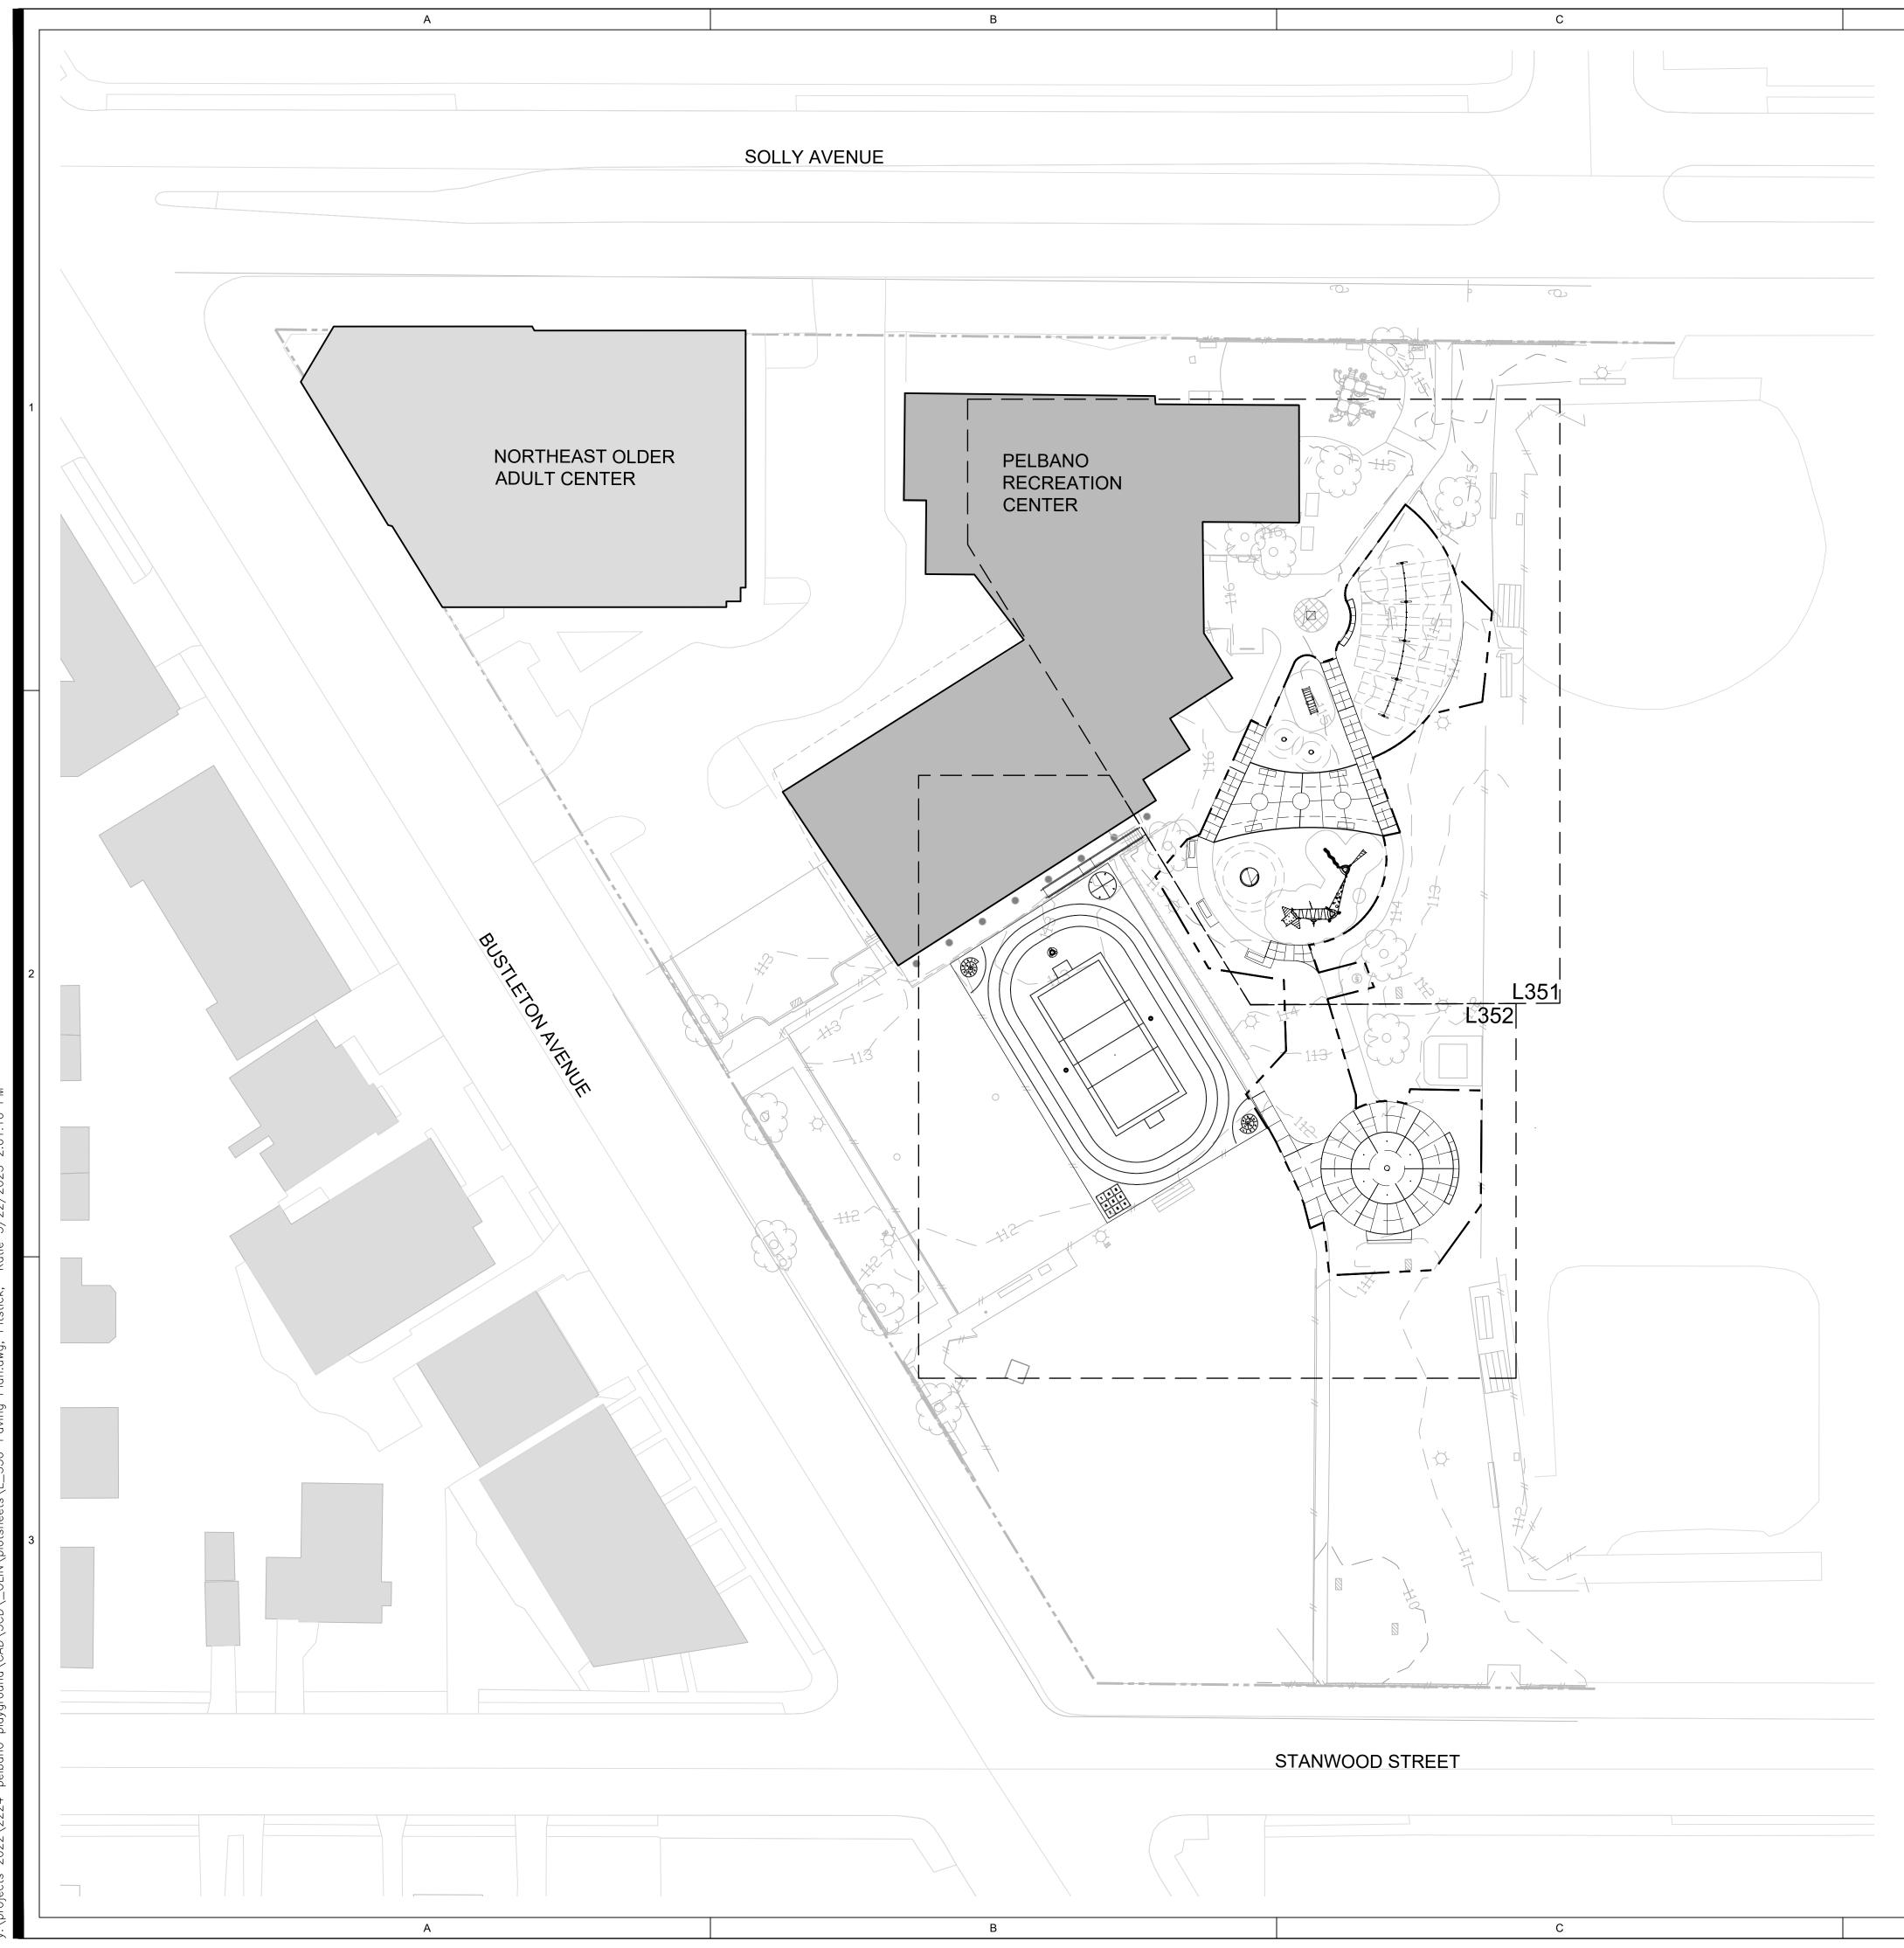

### PAVING LEGEND

PROJECT LIMIT LINE
BUILDING
EXPANSION JOINT, SEE L830
CONTROL JOINT, SEE L830

## PELBANO PLAYGROUND

8101 BUSTLETON AVENUE

## OLIN

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1.	ALL DIMENSIONS OF PAVING UNITS ARE NOMINAL

PAVING PLAN NOTES

TO CENTERLINE OF JOINT.
2. INSTALL EXPANSION FILL MATERIAL BETWEEN EDGES OF PAVING, INTERFACES WITH OTHER PAVEMENT, AND RIGID ELEMENTS SUCH AS STRUCTURES, WALLS, FOUNDATIONS AND CURBS.


No. Date Description 1 10/12/2022 SD set 2 11/16/2022 SD set 3 2/21/2023 DD set 4 4/17/2023 75% CD set

# 5 5/31/2023 100% CD set

### PAVING PLAN

Scale:	1"=30'
Date:	5/31/2023
Drawn:	KMP
Checked:	TS
Project No.:	2224



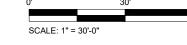


## PELBANO RECREATION CENTER


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MATCH TO SHEET 1352




### PAVING LEGEND

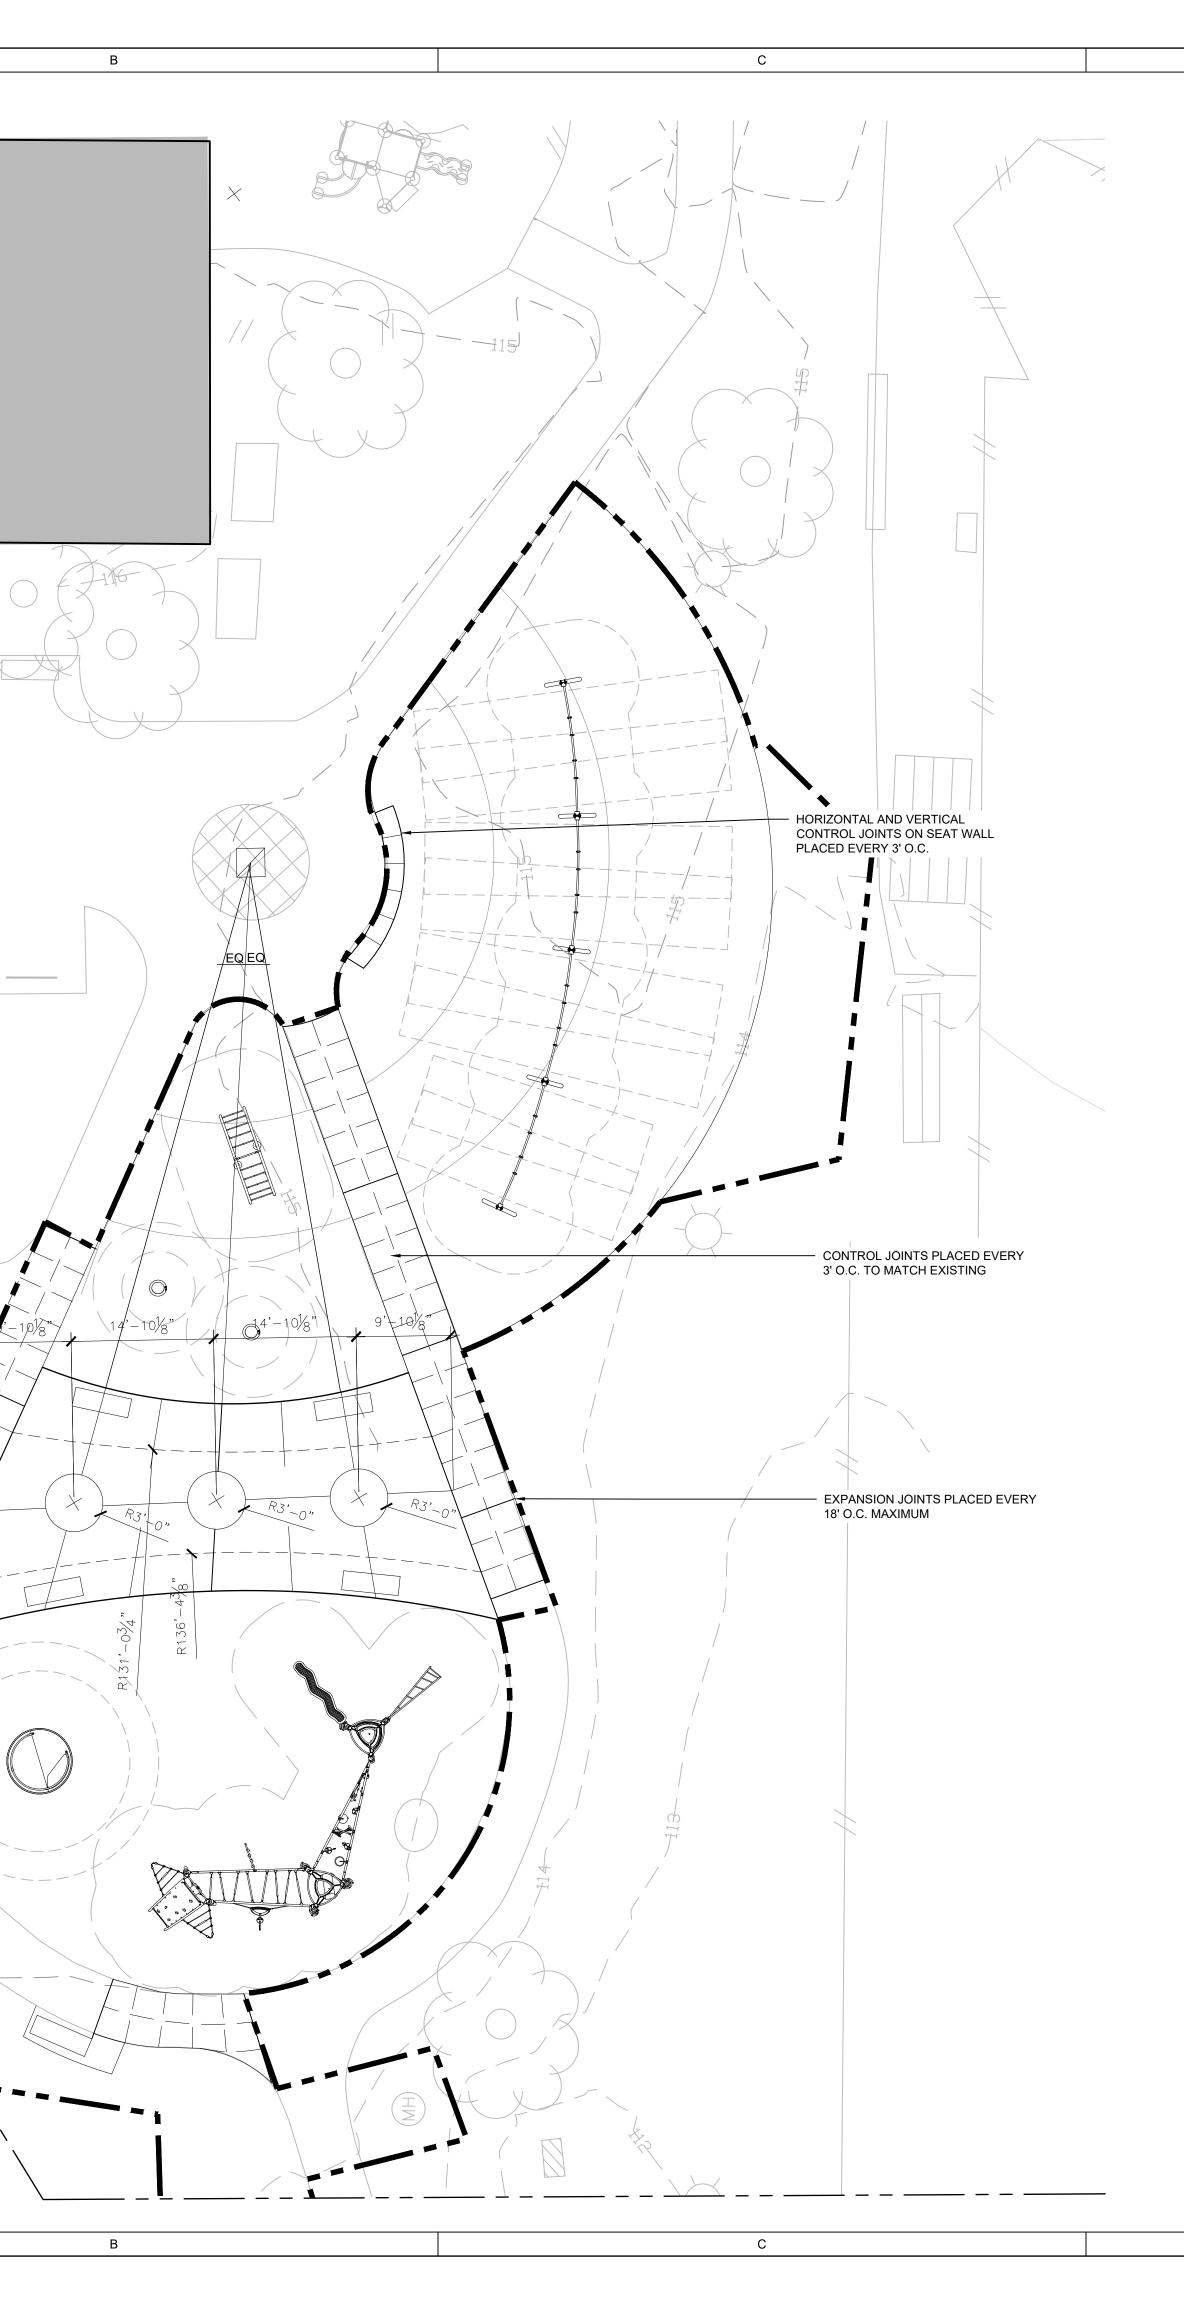

PAVING PLAN NOTES

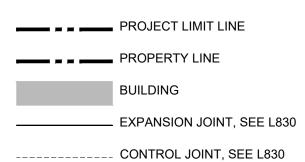 ALL DIMENSIONS OF PAVING UNITS ARE NOMINAL TO CENTERLINE OF JOINT.
 INSTALL EXPANSION FILL MATERIAL BETWEEN EDGES OF PAVING, INTERFACES WITH OTHER PAVEMENT, AND RIGID ELEMENTS SUCH AS STRUCTURES, WALLS, FOUNDATIONS AND CURPS. STRUCTURES, WALLS, FOUNDATIONS AND CURBS.

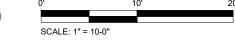

## PELBANO PLAYGROUND

### 8101 BUSTLETON AVENUE

## OLIN

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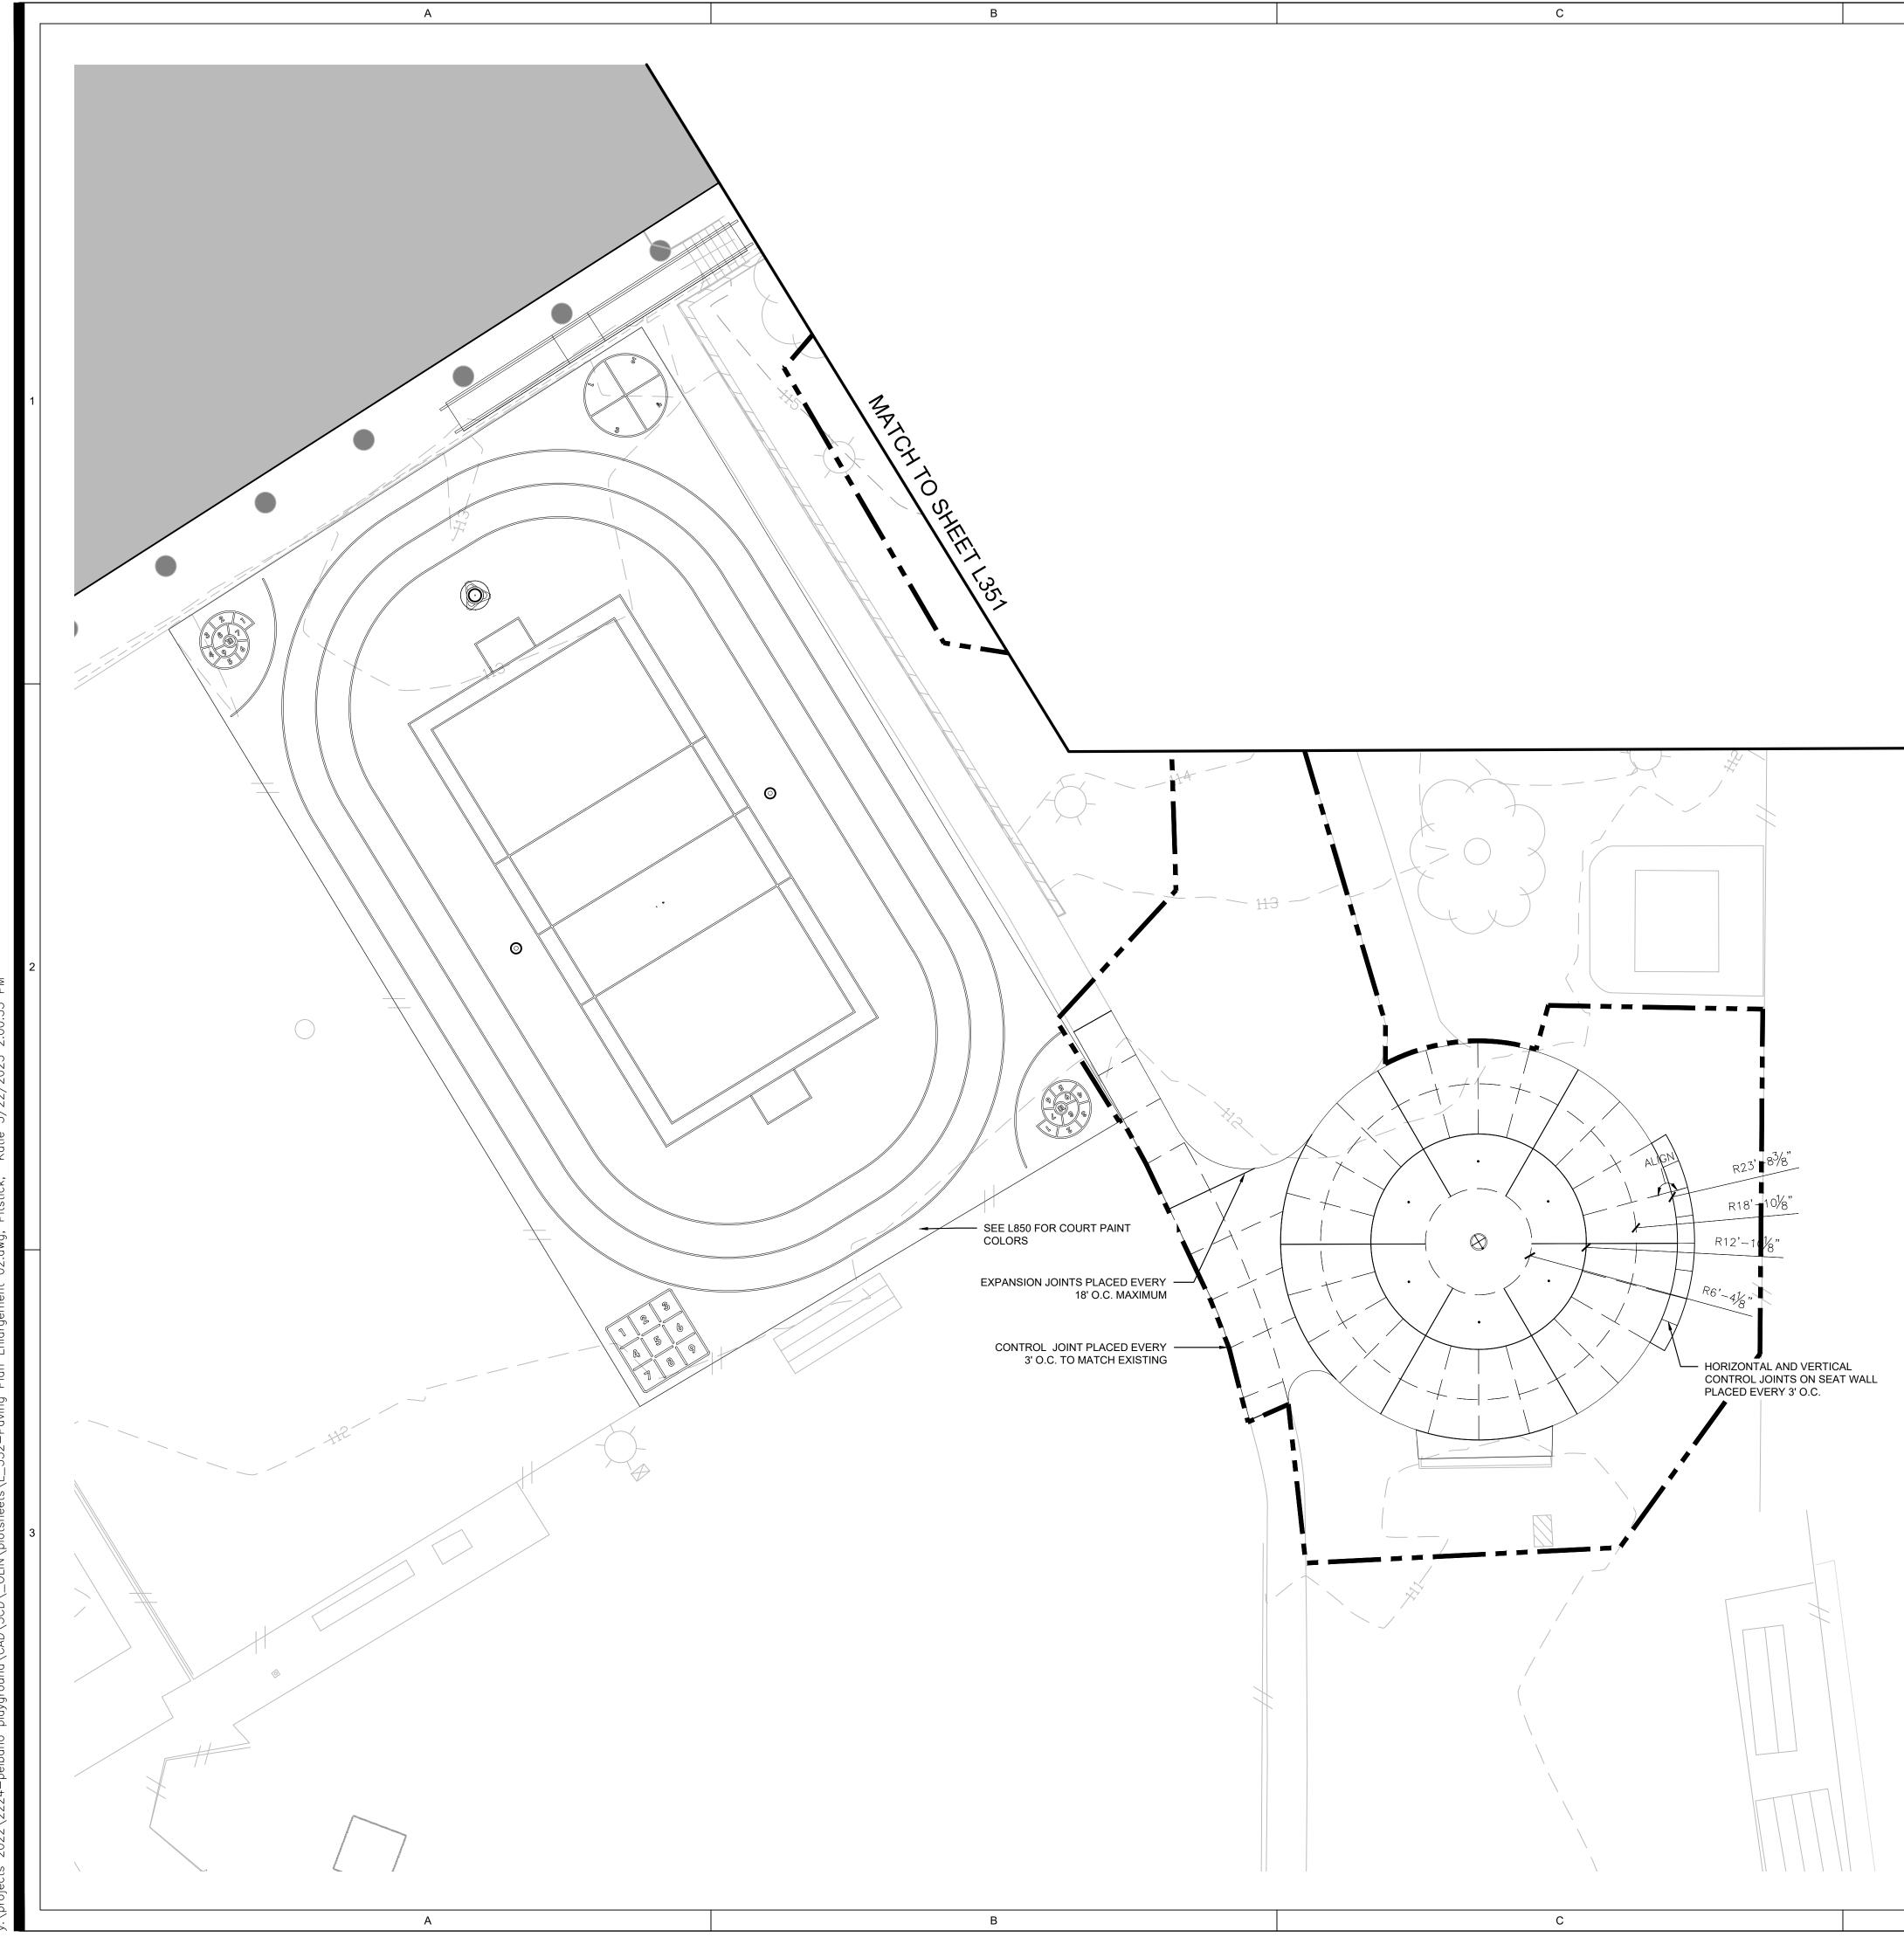
MEP: Mark Ulrick 30 N. 41ST SUITE 500 Philadelphia, PA 19104 (856) 320-8100

No.	Date	Description
1	10/12/2022	SD set
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3	2/21/2023	DD set
4	4/17/2023	75% CD set
5	5/31/2023	100% CD set


### PAVING PLAN - AREA 1

Scale:	1"=10'
Date:	5/31/2023
Drawn:	KMP
Checked:	TS
Project No.:	2224





### PAVING LEGEND

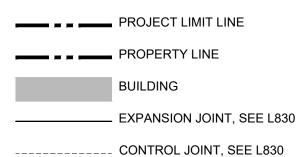

## PELBANO PLAYGROUND

8101 BUSTLETON AVENUE

## OLIN

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No	o. Date	Descri	ption
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2	11/16/20	)22 SD set	
3	2/21/20	DD set	i
4	4/17/20	)23 75% C	D se

5 5/31/2023 100% CD set

## PAVING PLAN - AREA 2


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Date:	5/31/2023
Drawn:	KMF
Checked:	Т
Project No.:	2224

L352


PAVING PLAN NOTES

- ALL DIMENSIONS OF PAVING UNITS ARE NOMINAL TO CENTERLINE OF JOINT.
   INSTALL EXPANSION FILL MATERIAL BETWEEN
- EDGES OF PAVING, INTERFACES WITH OTHER PAVEMENT, AND RIGID ELEMENTS SUCH AS STRUCTURES, WALLS, FOUNDATIONS AND CURBS.



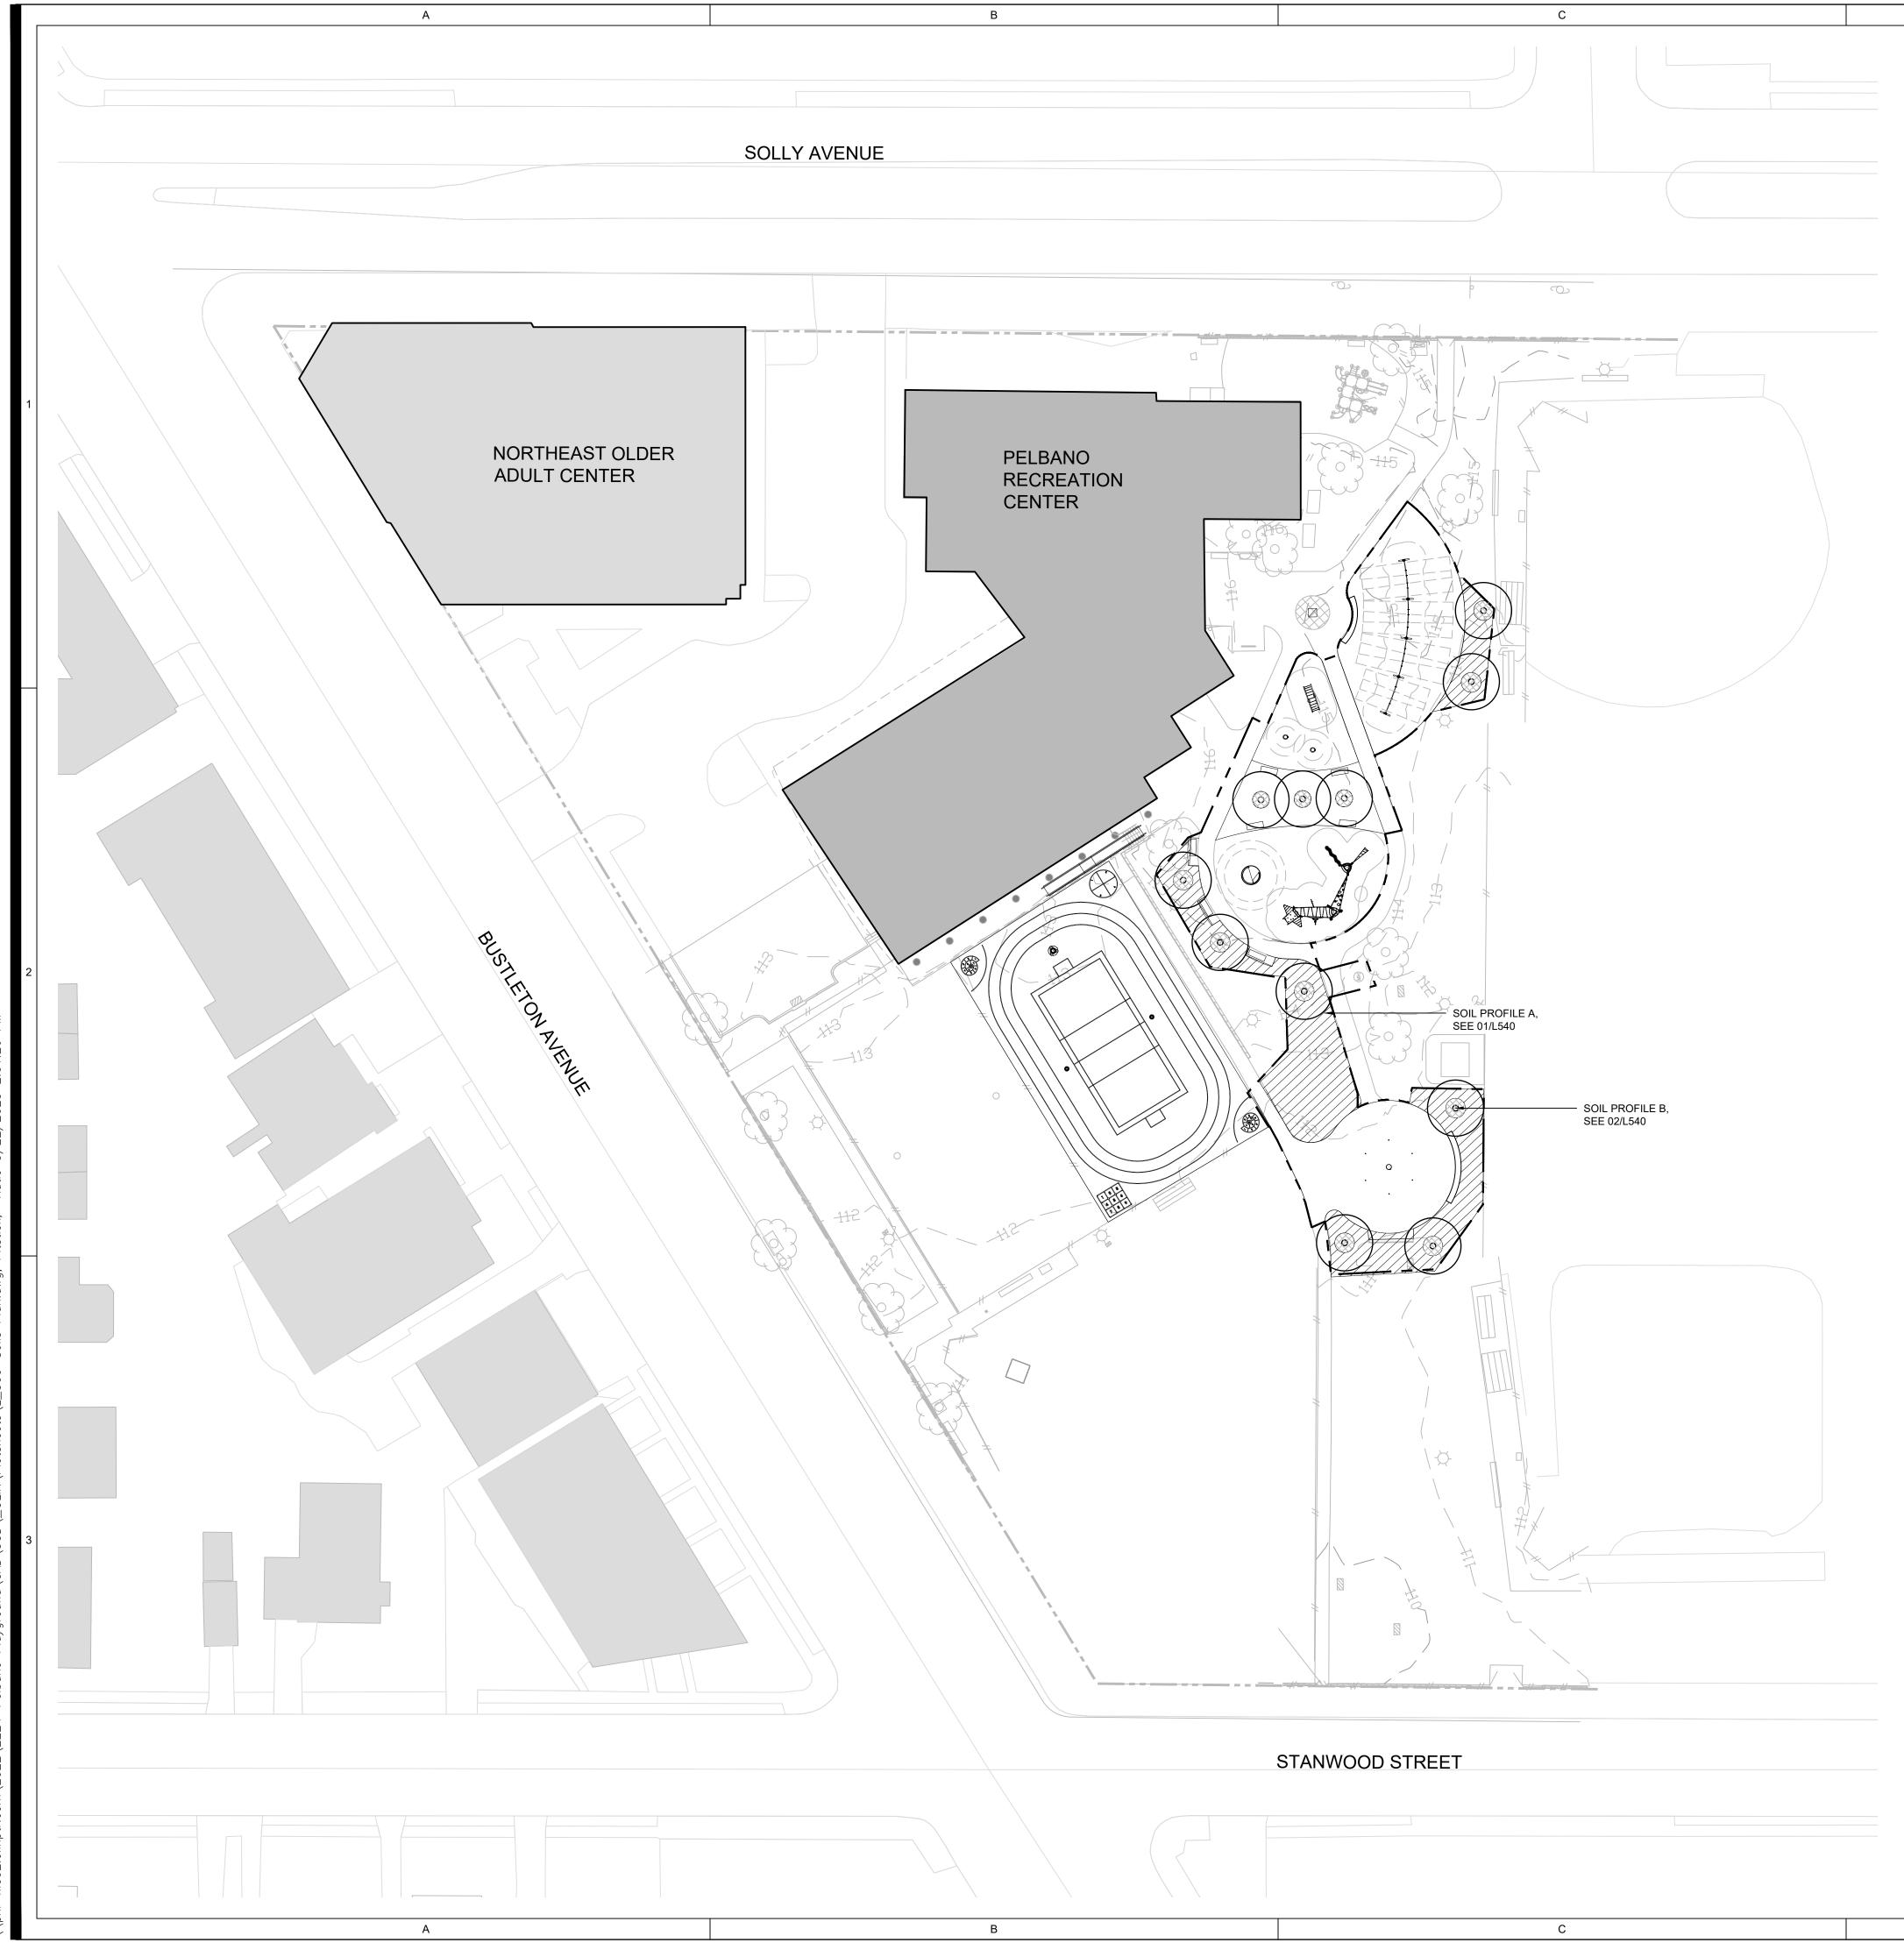

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SOIL PROFILE B, SEE 02/L540 
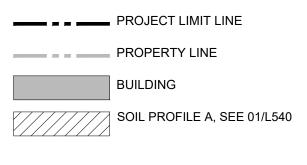
## SOIL PLAN NOTES

- ALL AMENDED SOIL MATERIAL SHOULD BE THOROUGHLY BLENDED AND BE CONSISTENT THROUGHOUT.
- 2. SOIL SHALL BE INSTALLED IN 6-8 INCH LIFTS AT 85% MAXIMUM COMPACTION
- 3. SCARIFY EXISTING SUBGRADE WHEN DRY AND PRIOR TO ADDING FILL

PELBANO PLAYGROUND

### 8101 BUSTLETON AVENUE

## OLIN

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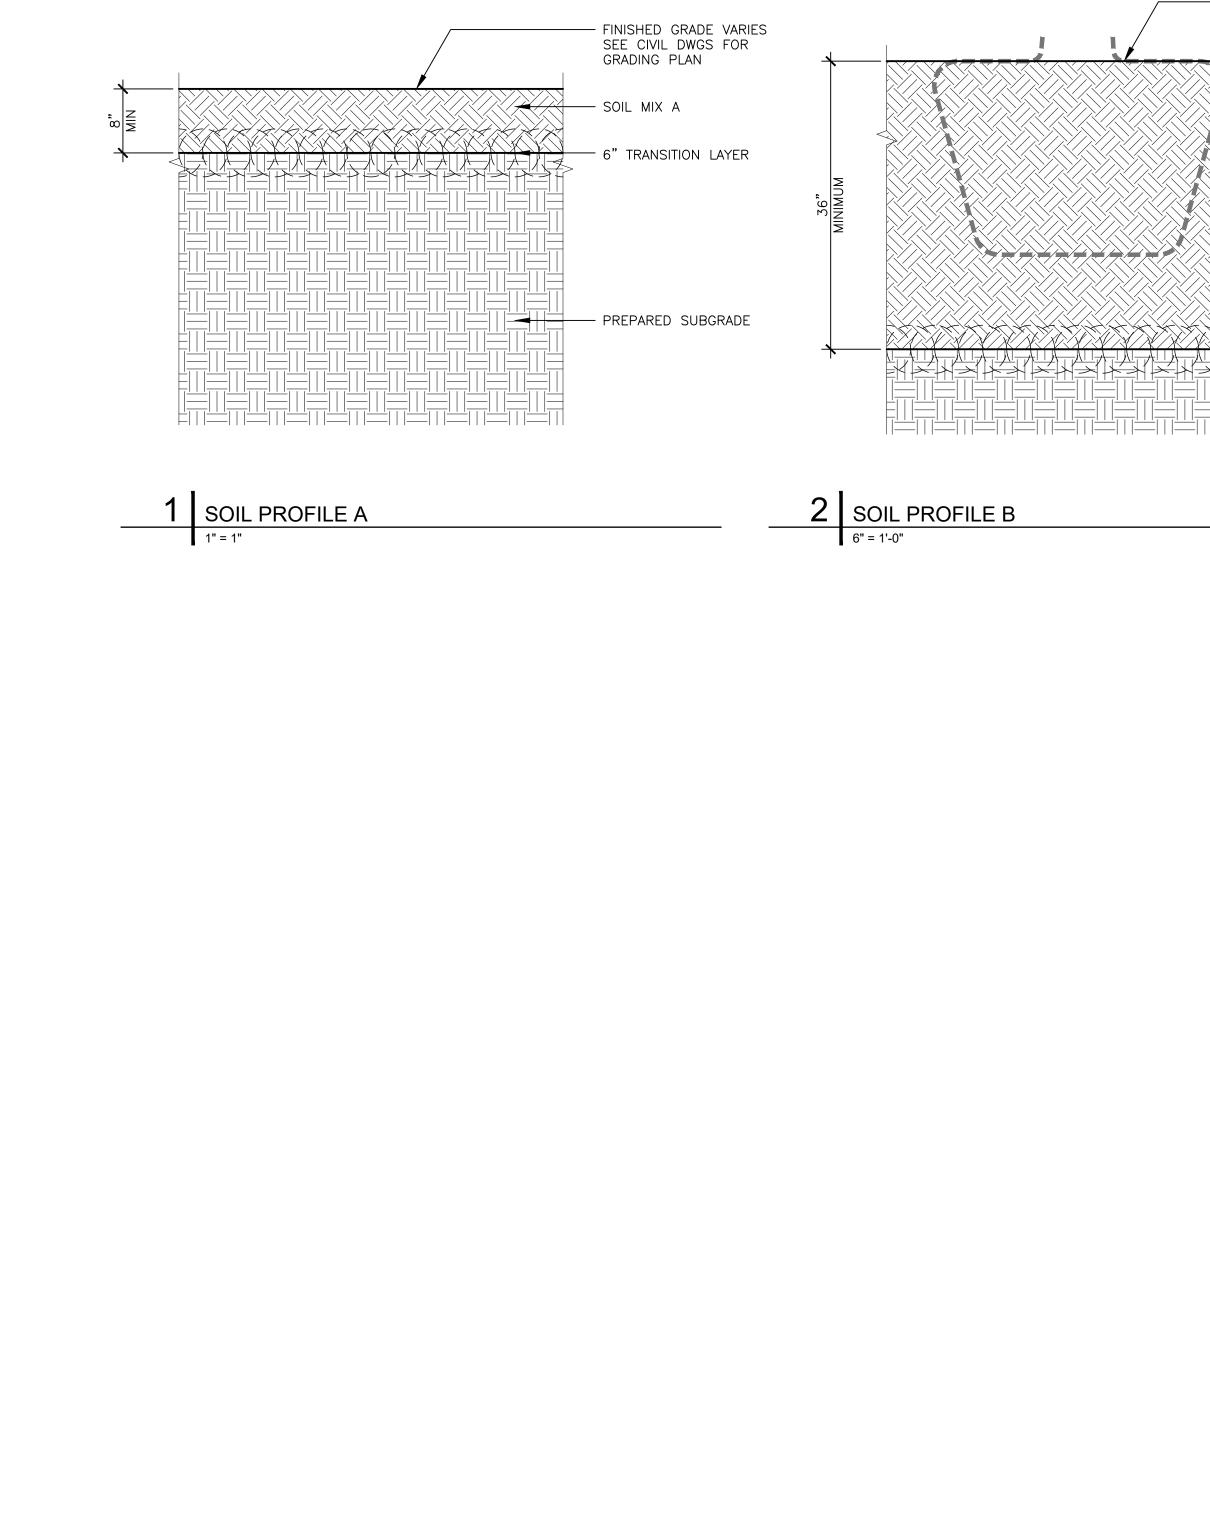
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## SOILS PLAN

Scale:	1"=30'
Date:	5/31/2023
Drawn:	KMP
Checked:	TS
Project No.:	2224
Project No.:	2224








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## SOIL MIX A

### - FINISHED GRADE VARIES SEE CIVIL DWGS FOR GRADING PLAN

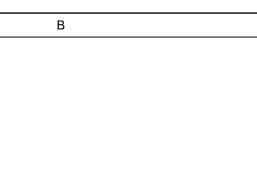- ROOTBALL

- 6" TRANSITION LAYER

PREPARED SUBGRADE

## PELBANO PLAYGROUND

8101 BUSTLETON AVENUE

## OLIN

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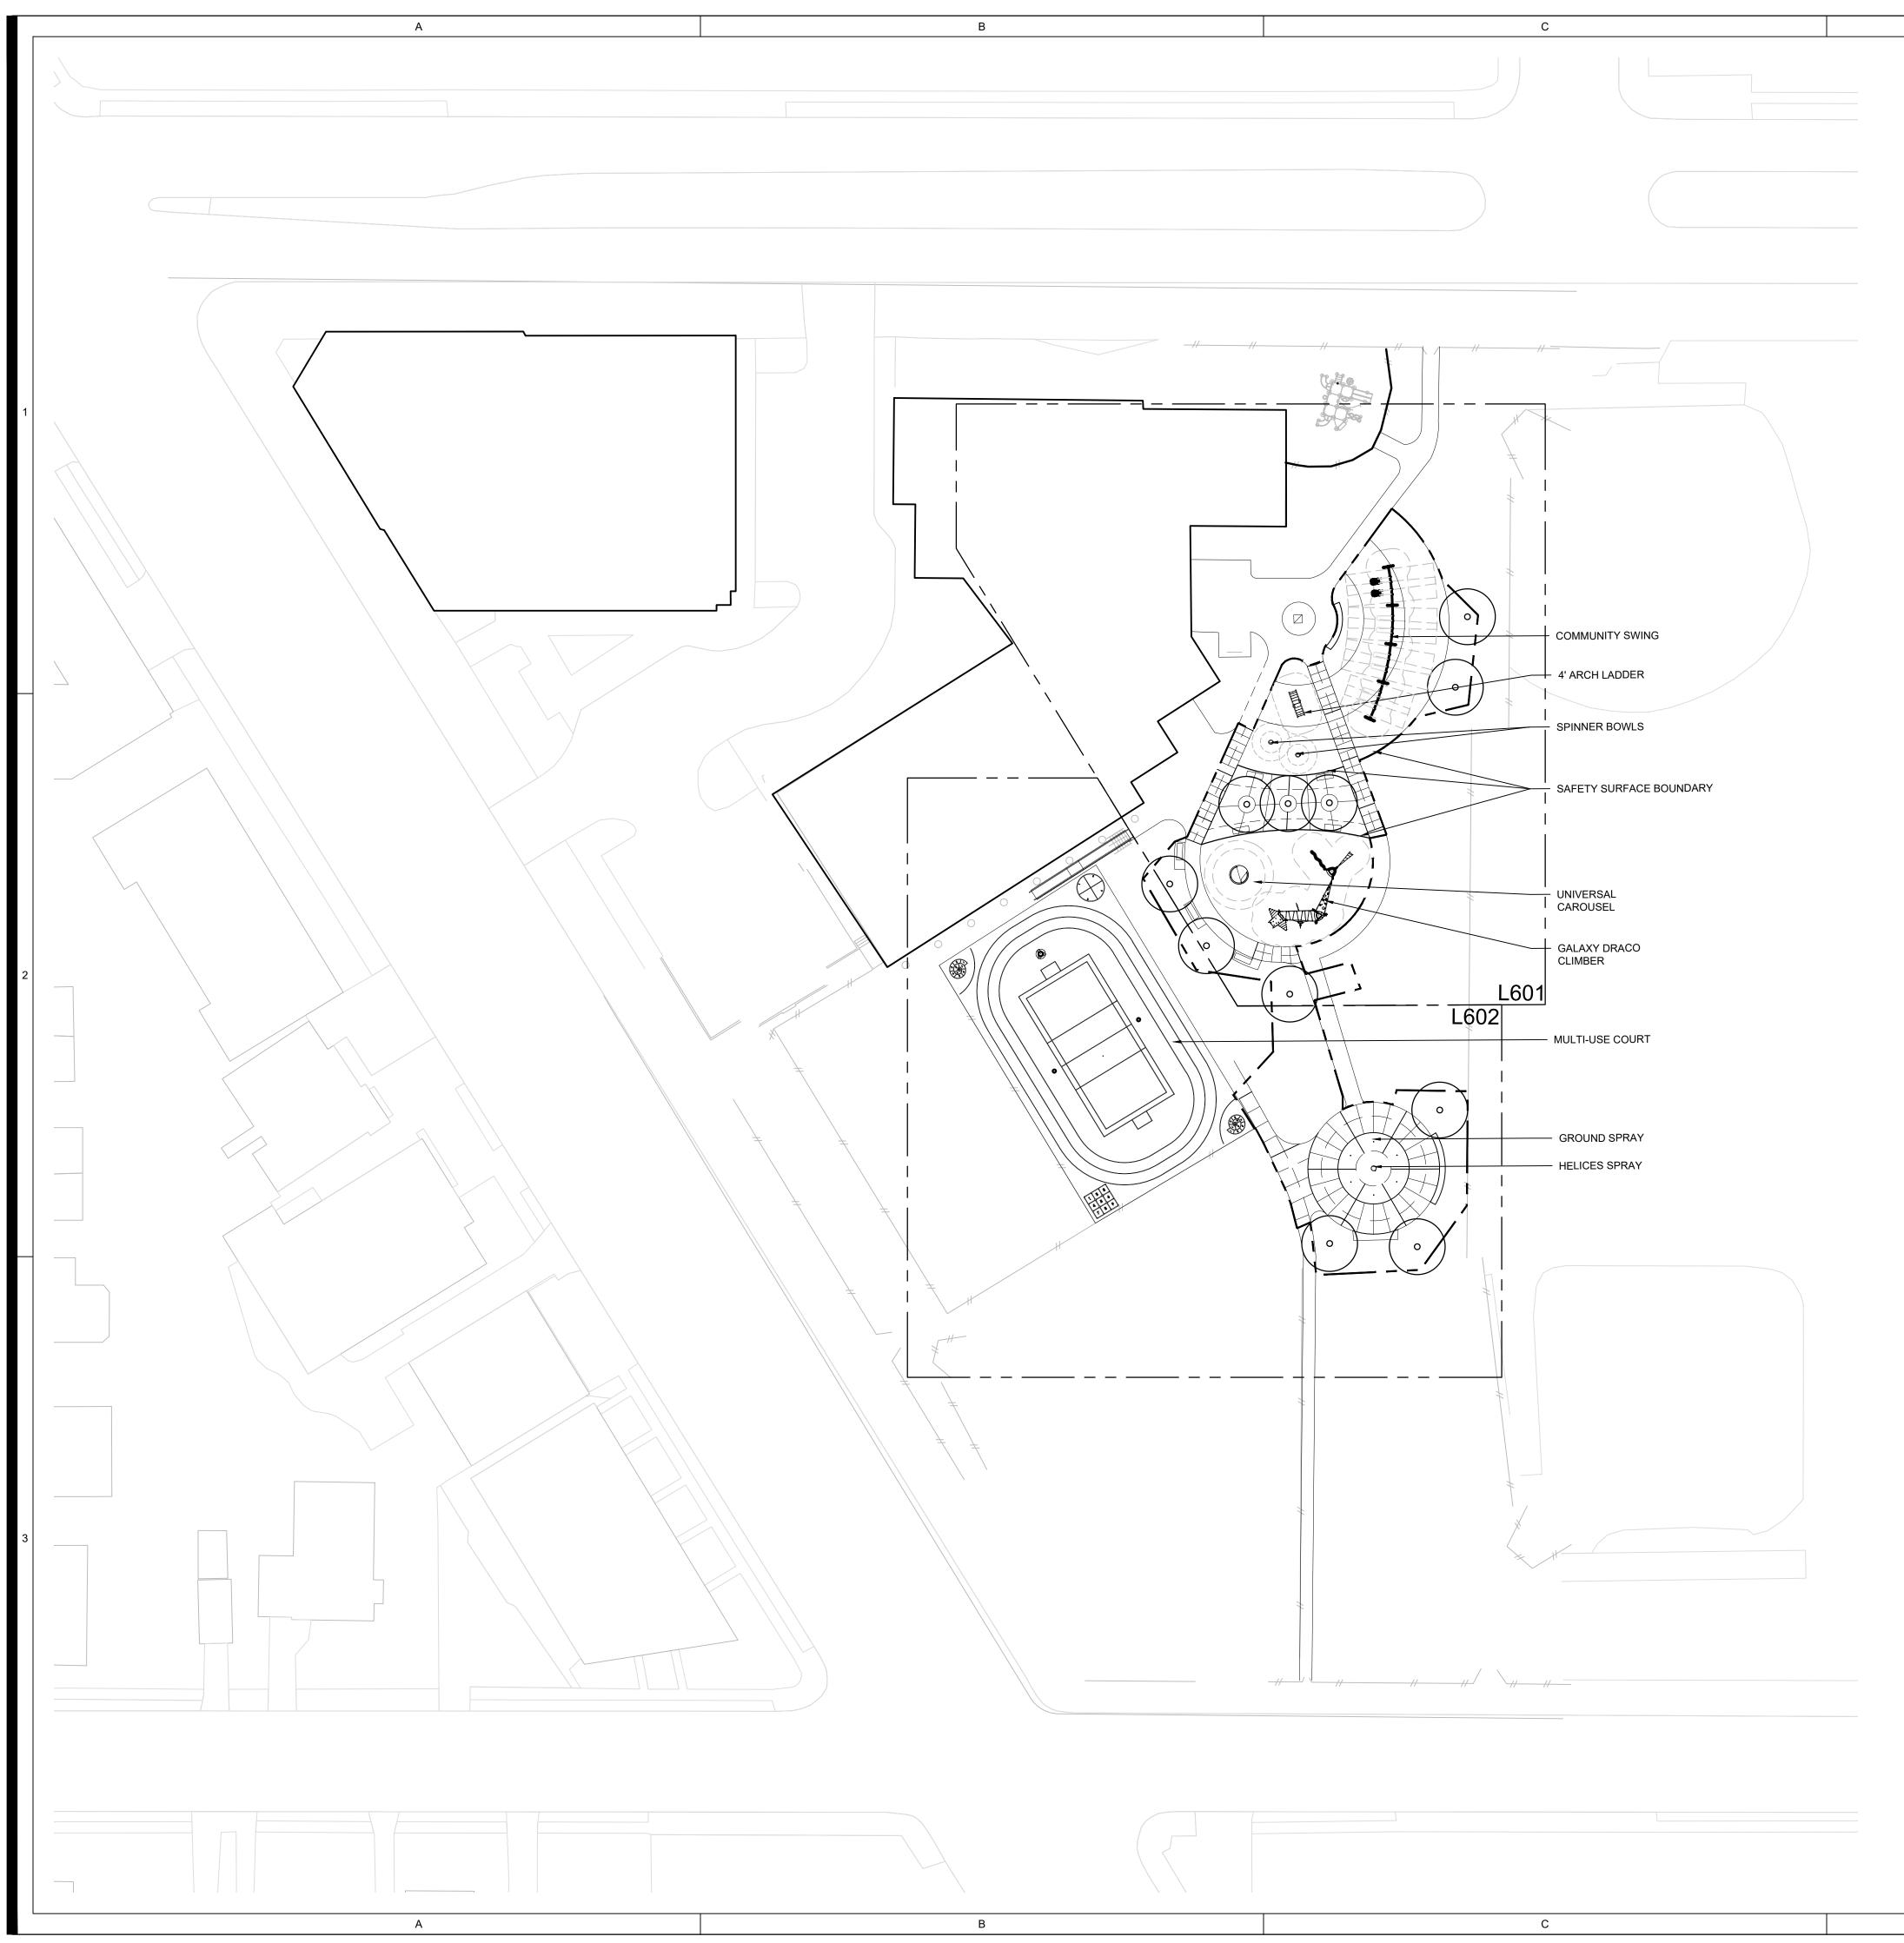
MEP: Mark Ulrick 30 N. 41ST SUITE 500 Philadelphia, PA 19104 (856) 320-8100

No.	Date	Descriptio
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3	2/21/2023	DD set
4	4/17/2023	75% CD
5	5/31/2023	100% CE

## SOILS PROFILES

Scale:	NA
Date:	5/31/2023
Drawn:	KMP
Checked:	TS
Project No.:	2224





8101 BUSTLETON AVENUE

## OLIN

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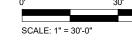
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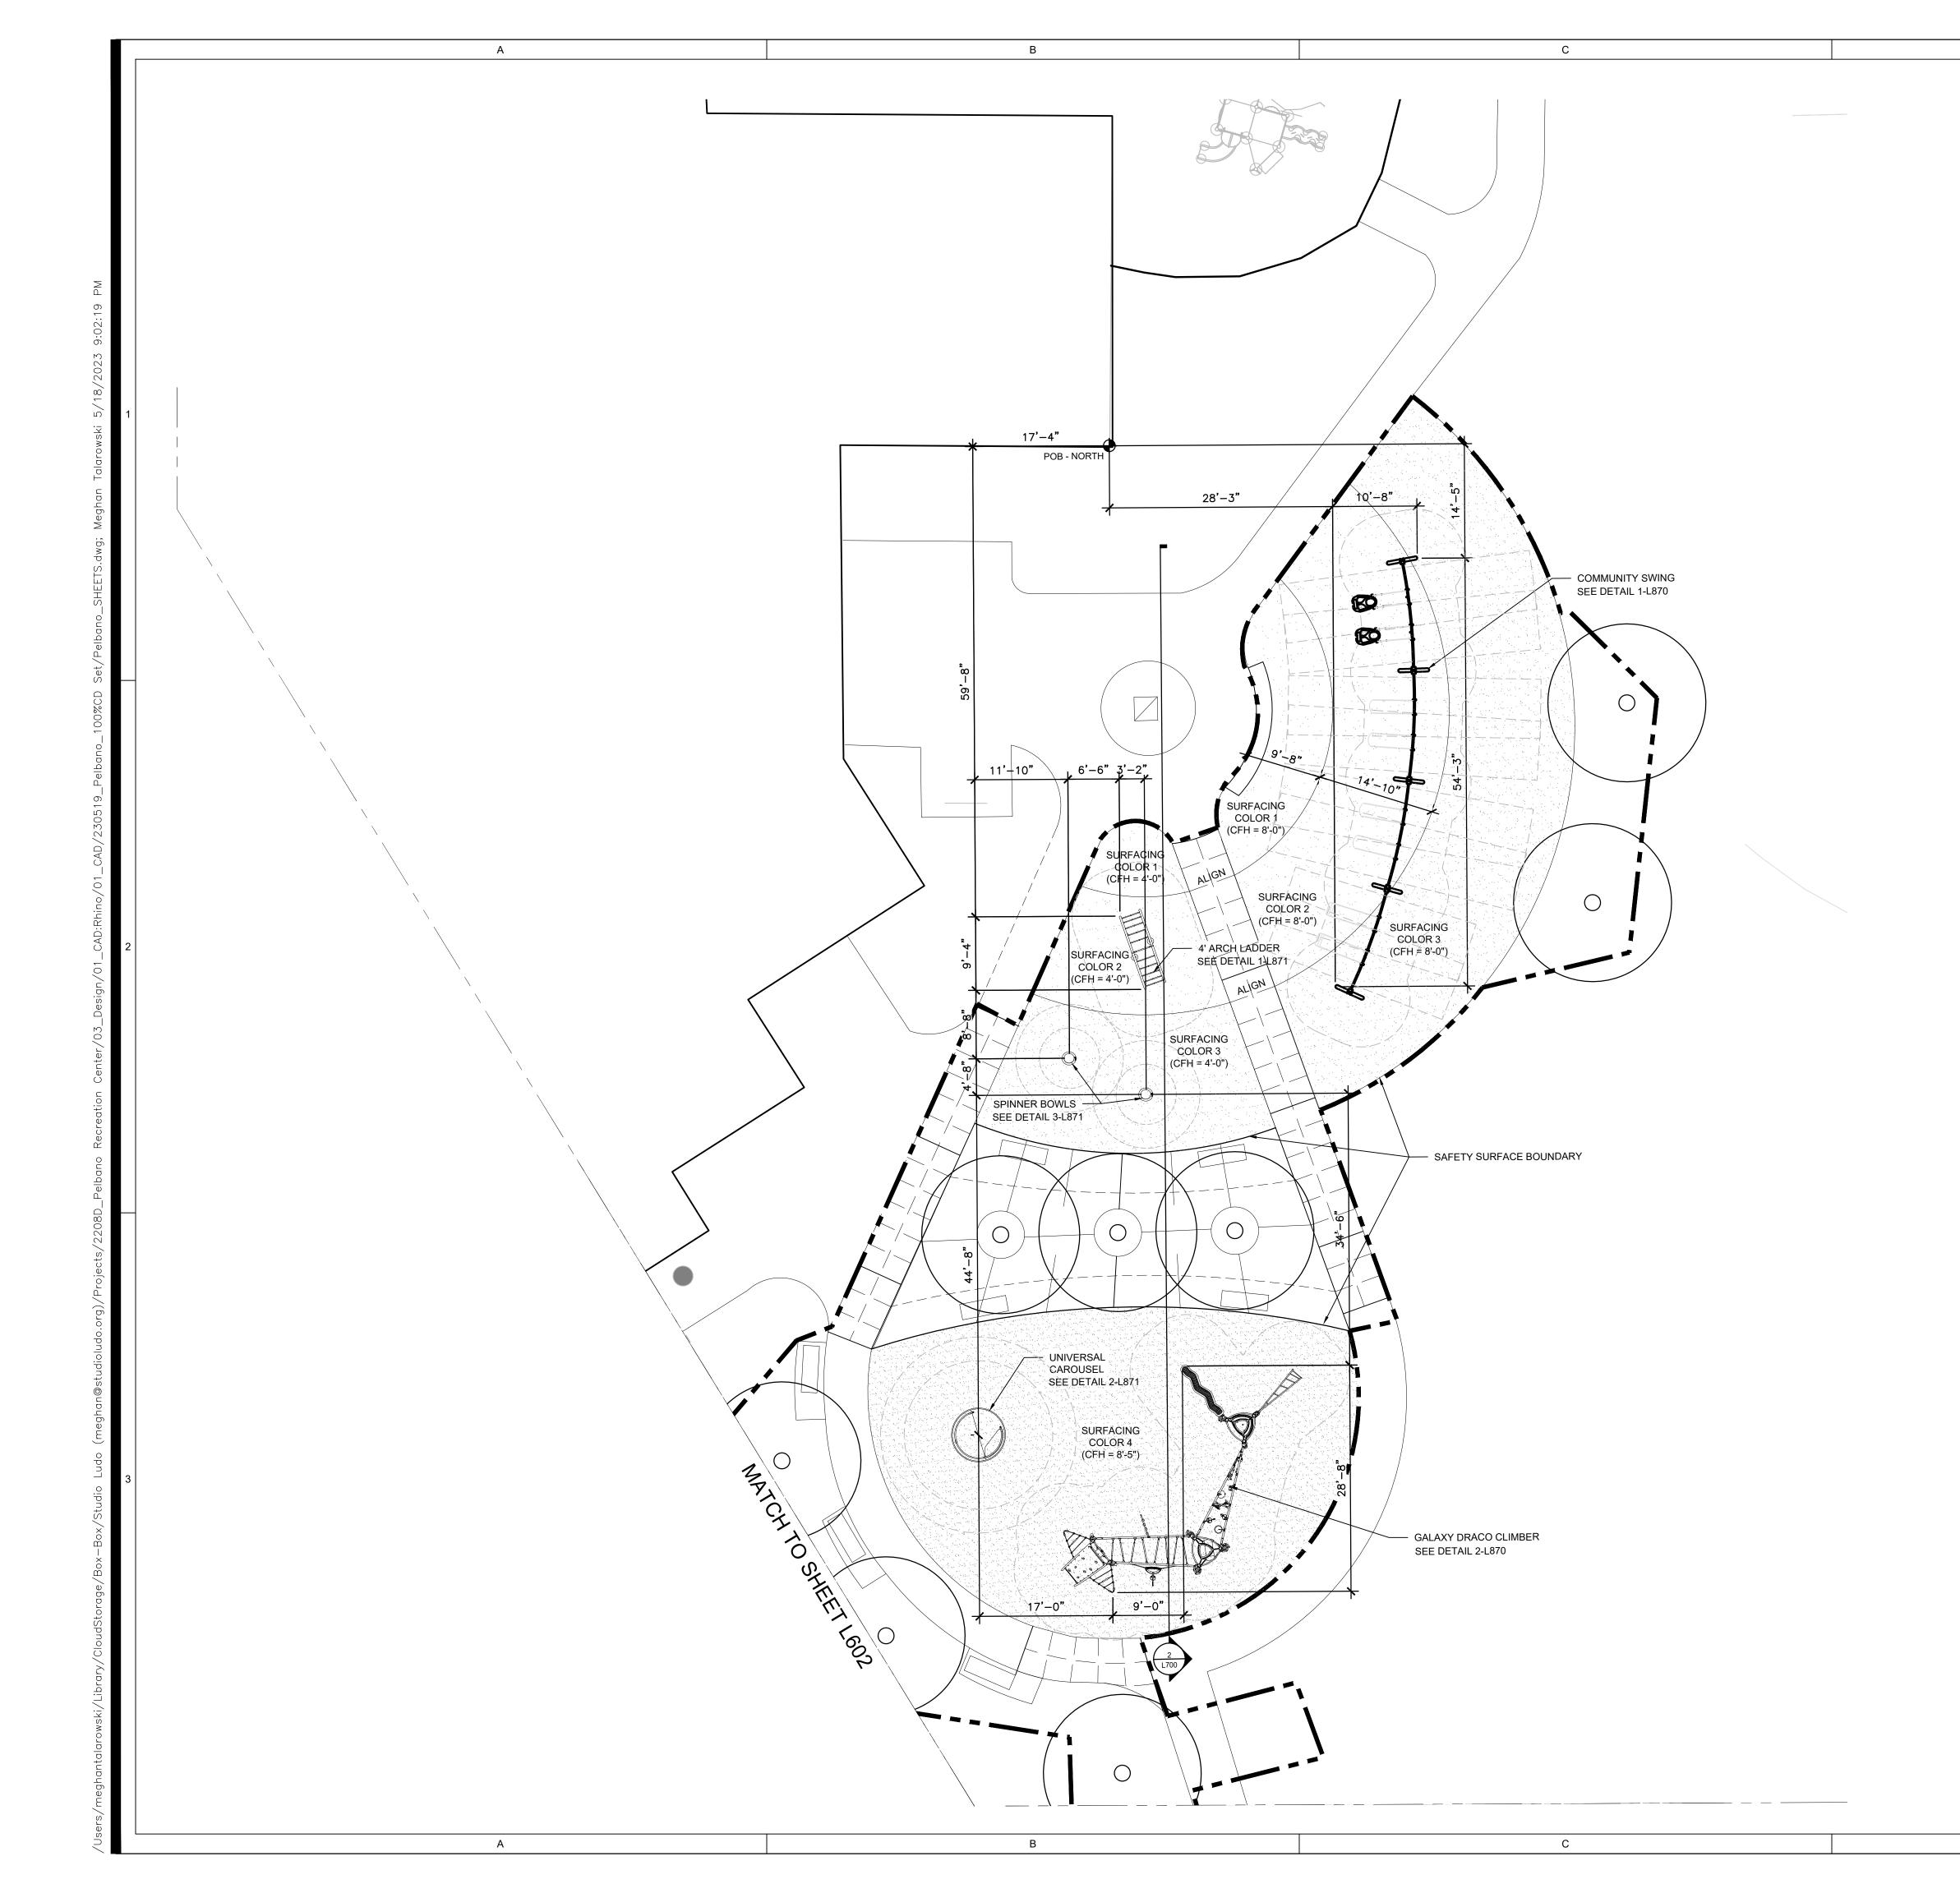
N	lo.	Date		Description
1		10/12/20	22	SD set
2		11/16/20	22	SD set
3		2/21/20	23	DD set
4		4/17/20	23	75% CD s
5		5/31/20	23	100% CD

## PLAY EQUIPMENT PLAN

Scale:	1" = 30'-0"
Date:	05-19-2023
Drawn:	MT
Checked:	
Project No.	: 2224







8101 BUSTLETON AVENUE

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	4	4/17/2023	75% CD s
ļ	5	5/31/2023	100% CD


## PLAY EQUIPMENT PLAN - AREA 1

Scale:	1" = 10'-0"
Date:	05-19-2023
Drawn:	MT
Checked:	
Project No.	: 2224



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SCALE: 1" = 10-0"

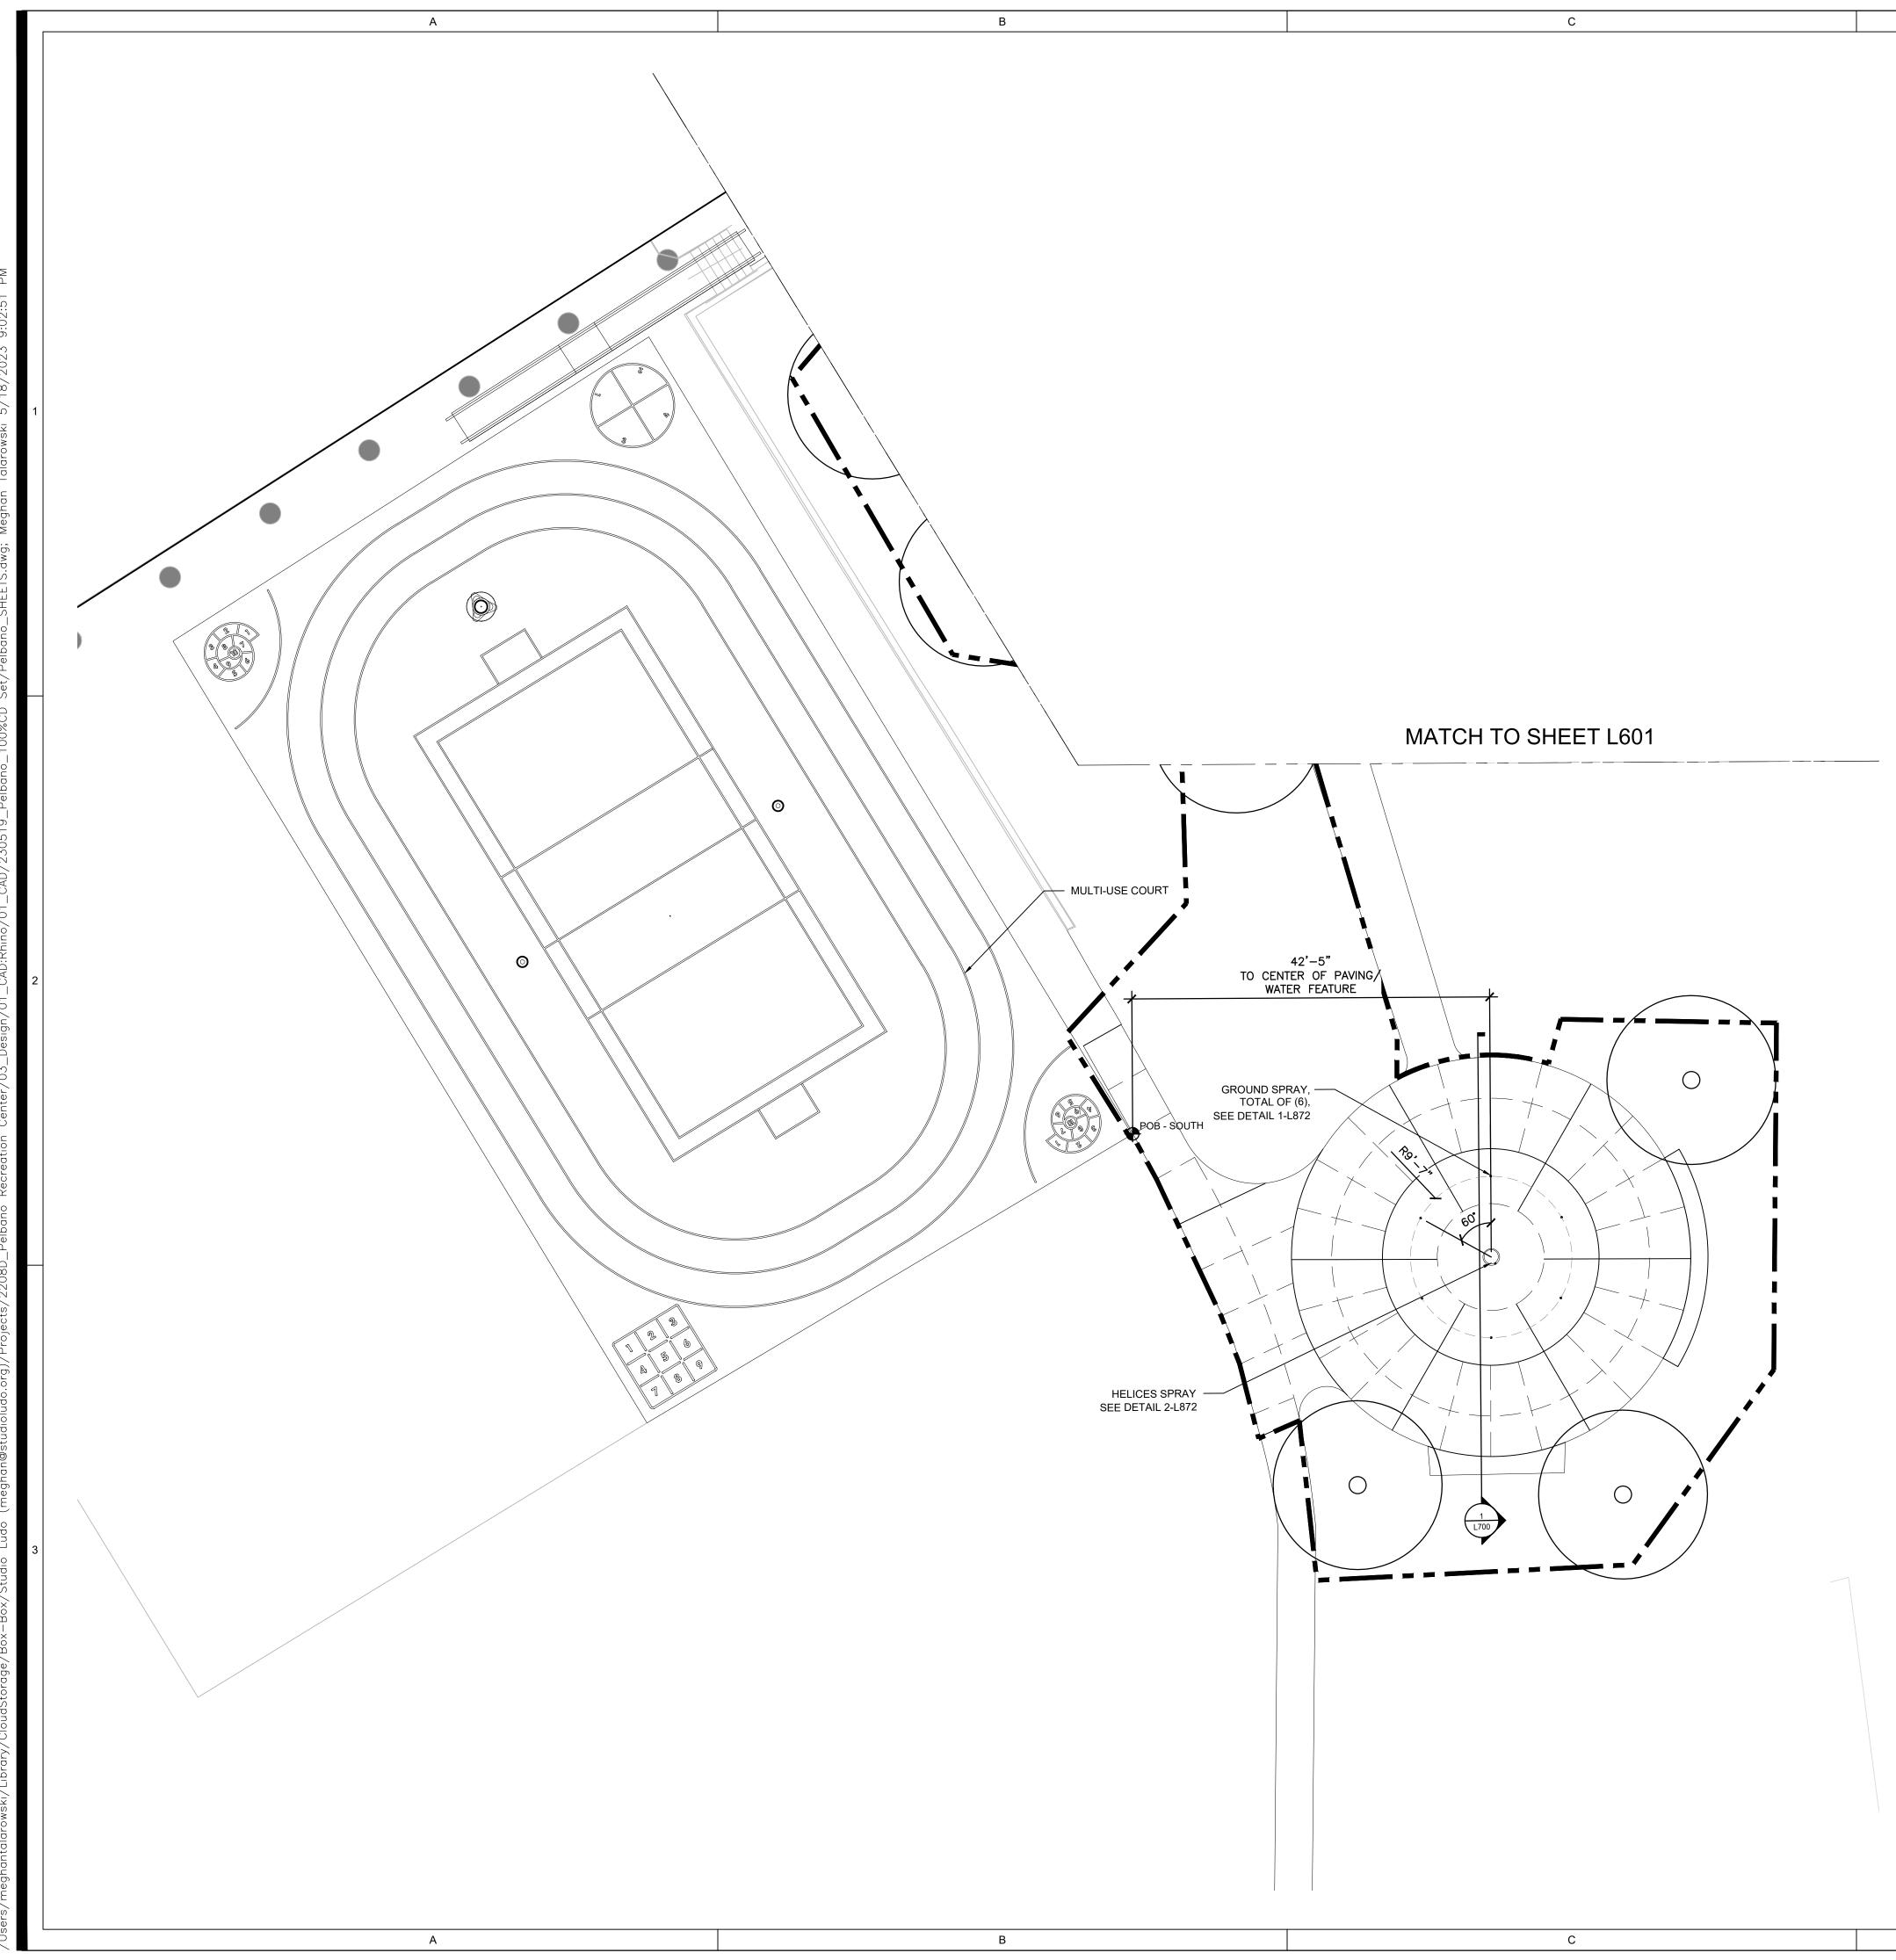

8101 BUSTLETON AVENUE

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ļ	5	5/31/2023	100% CD


## PLAY EQUIPMENT PLAN - AREA 2

Scale:	1" = 10'-0"
Date:	05-19-2023
Drawn:	MT
Checked:	
Project No.	: 2224





SCALE: 1" = 10-0"

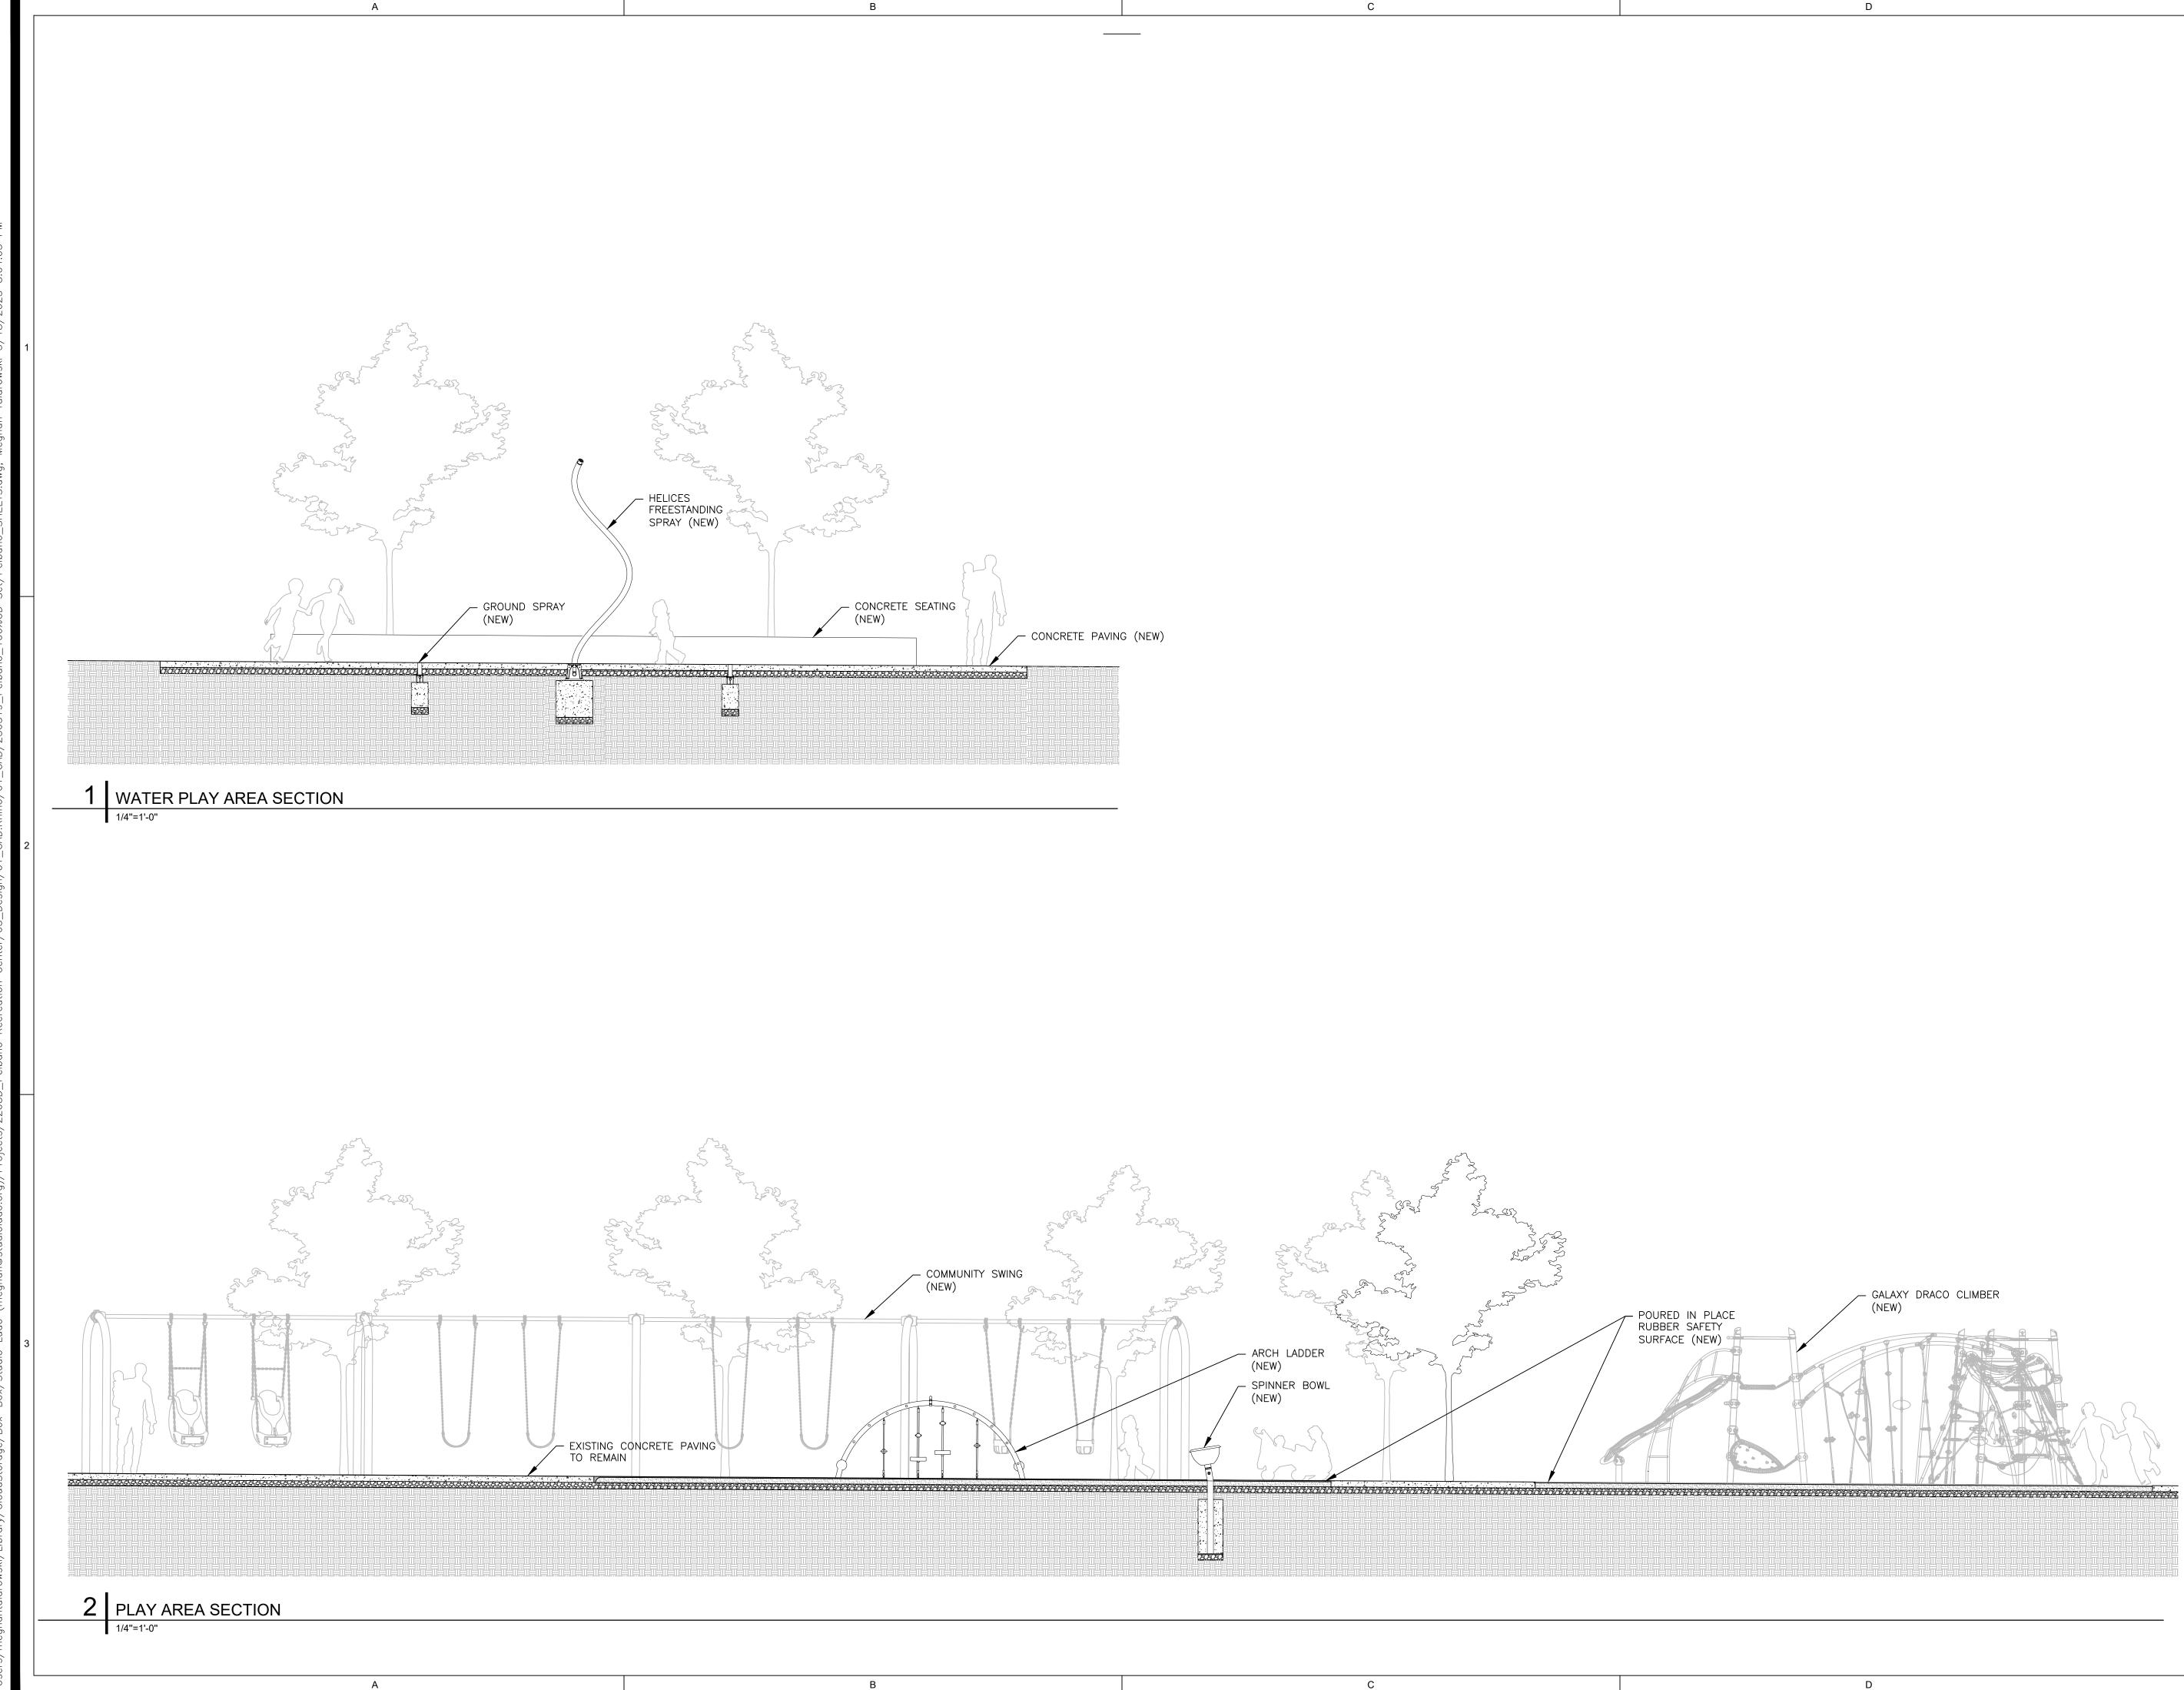

8101 BUSTLETON AVENUE

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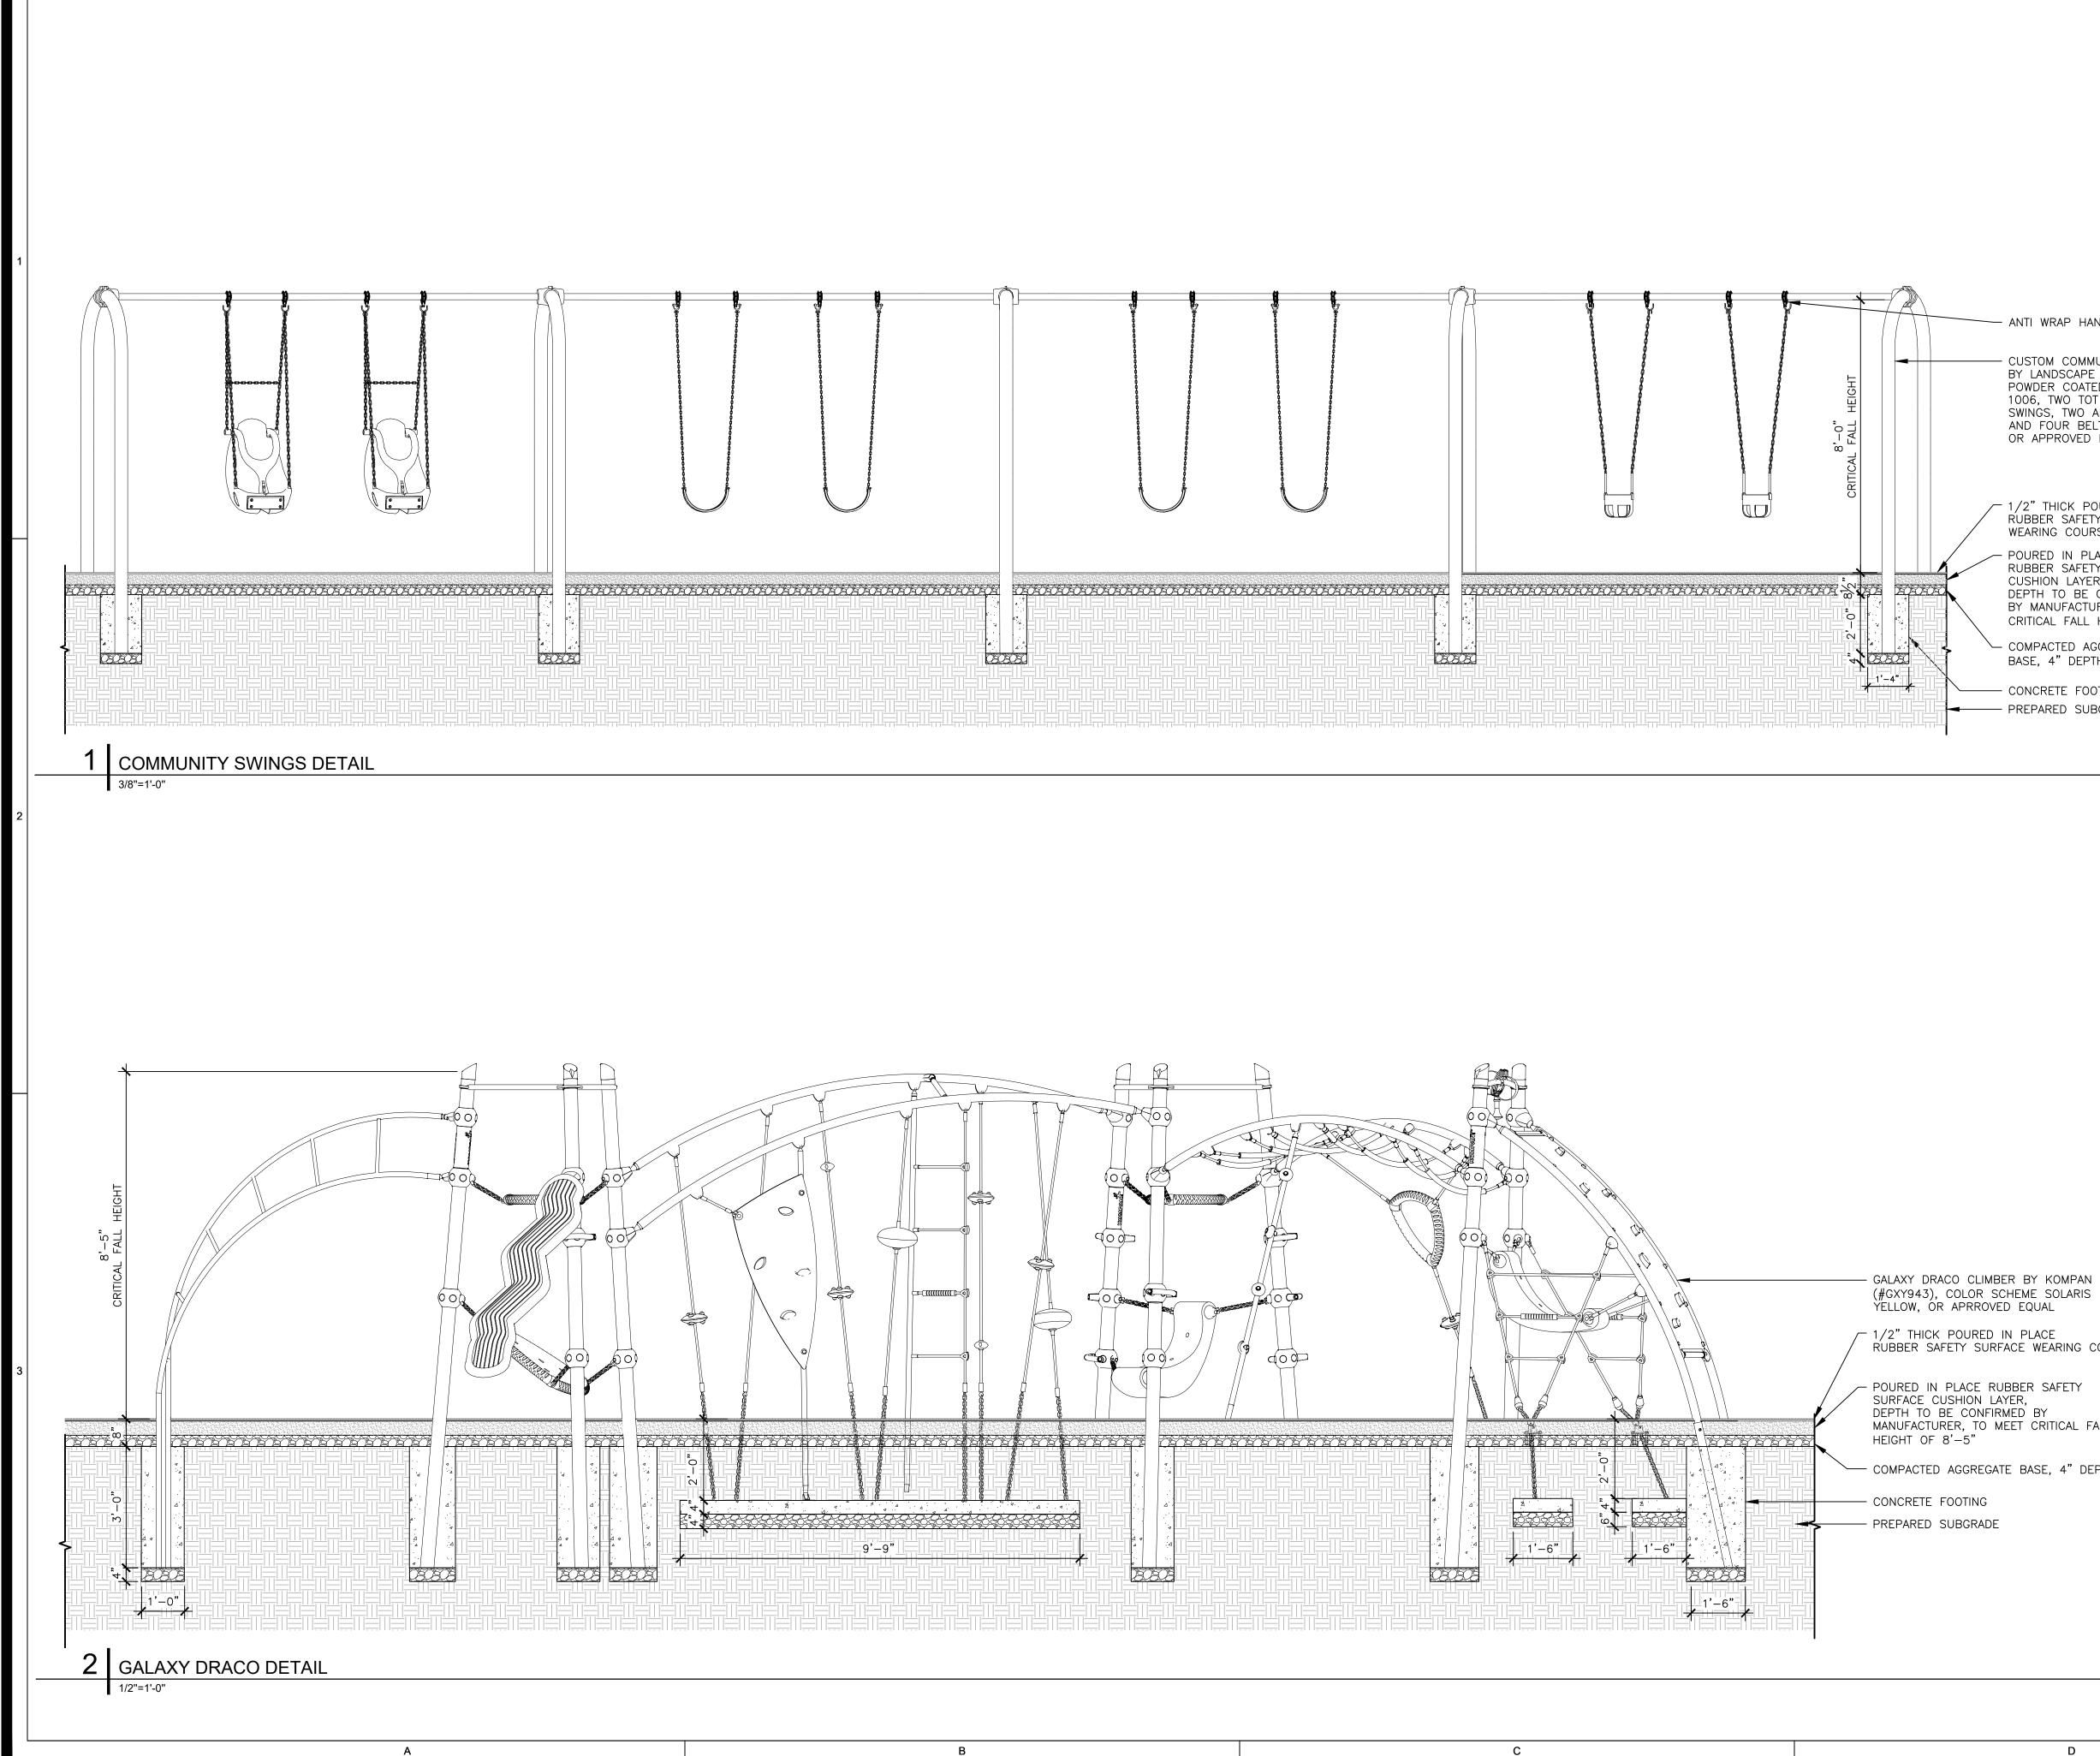
MEP: Mark Ulrick 30 N. 41ST SUITE 500 Philadelphia, PA 19104 (856) 320-8100

No.	Date	Description
1	10/12/2022	SD set
2	11/16/2022	SD set
3	2/21/2023	DD set
4	4/17/2023	75% CD set
5	5/31/2023	100% CD set

## SITE SECTIONS

Scale:	NA
Date:	05-19-2023
Drawn:	MT
Checked:	
Project No.	: 2224





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## PELBANO PLAYGROUND

### 8101 BUSTLETON AVENUE

## OLIN

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### PLAY EQUIPMENT DETAILS

Scale:	NA
Date:	05-19-2023
Drawn:	MT
Checked:	
Project No.	.: 2224

----- ANTI WRAP HANGER

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- CUSTOM COMMUNITY SWING BY LANDSCAPE STRUCTURES, POWDER COATED STEEL RAL 1006, TWO TOT BUCKET SWINGS, TWO ADA SWINGS, AND FOUR BELT SWINGS, OR APPROVED EQUAL

1/2" THICK POURED IN PLACE RUBBER SAFETY SURFACE WEARING COURSE

- POURED IN PLACE RUBBER SAFETY SURFACE CUSHION LAYER, DEPTH TO BE CONFIRMED BY MANUFACTURER, TO MEET

CRITICAL FALL HEIGHT OF 8'-0" - COMPACTED AGGREGATE

- PREPARED SUBGRADE

- CONCRETE FOOTING

BASE, 4"DEPTH

GALAXY DRACO CLIMBER BY KOMPAN


- 1/2" THICK POURED IN PLACE


RUBBER SAFETY SURFACE WEARING COURSE

– POURED IN PLACE RUBBER SAFETY


SURFACE CUSHION LAYER, DEPTH TO BE CONFIRMED BY MANUFACTURER, TO MEET CRITICAL FALL

COMPACTED AGGREGATE BASE, 4" DEPTH

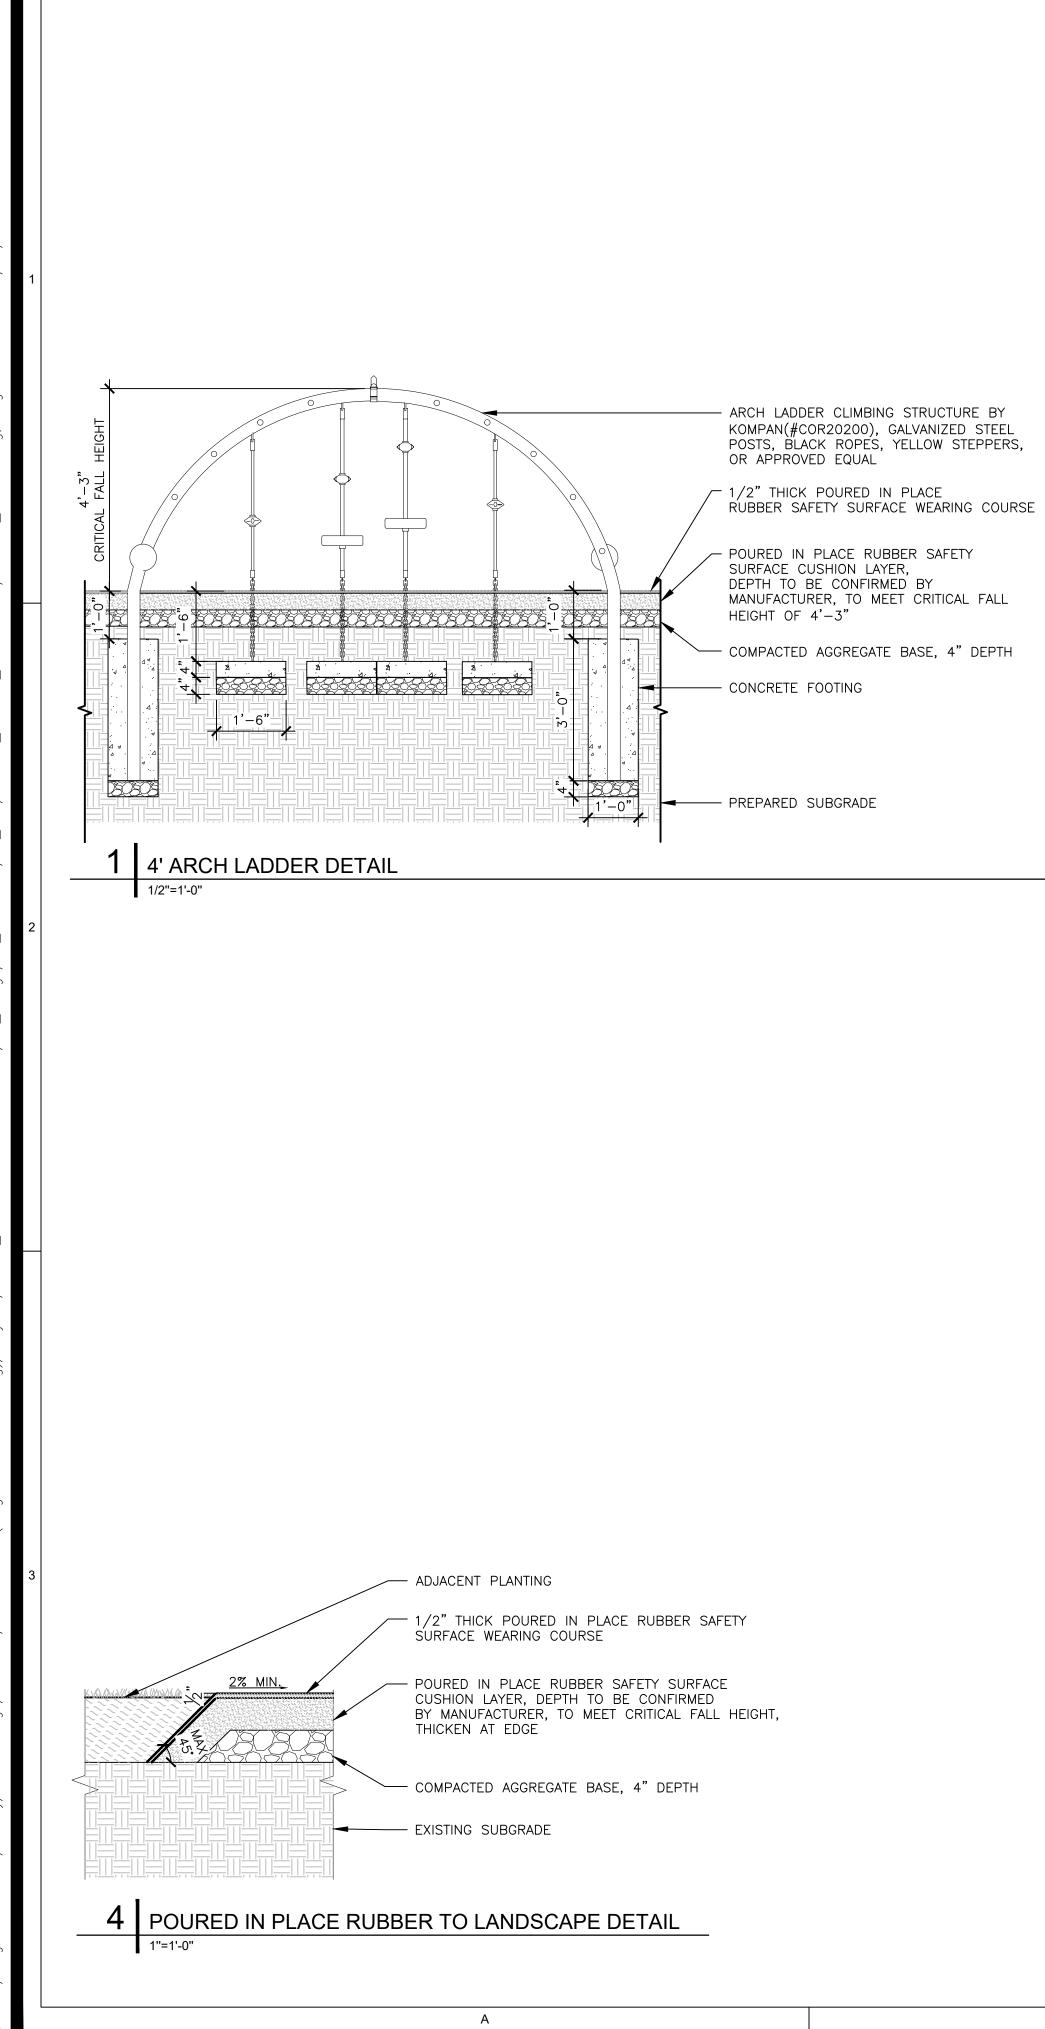

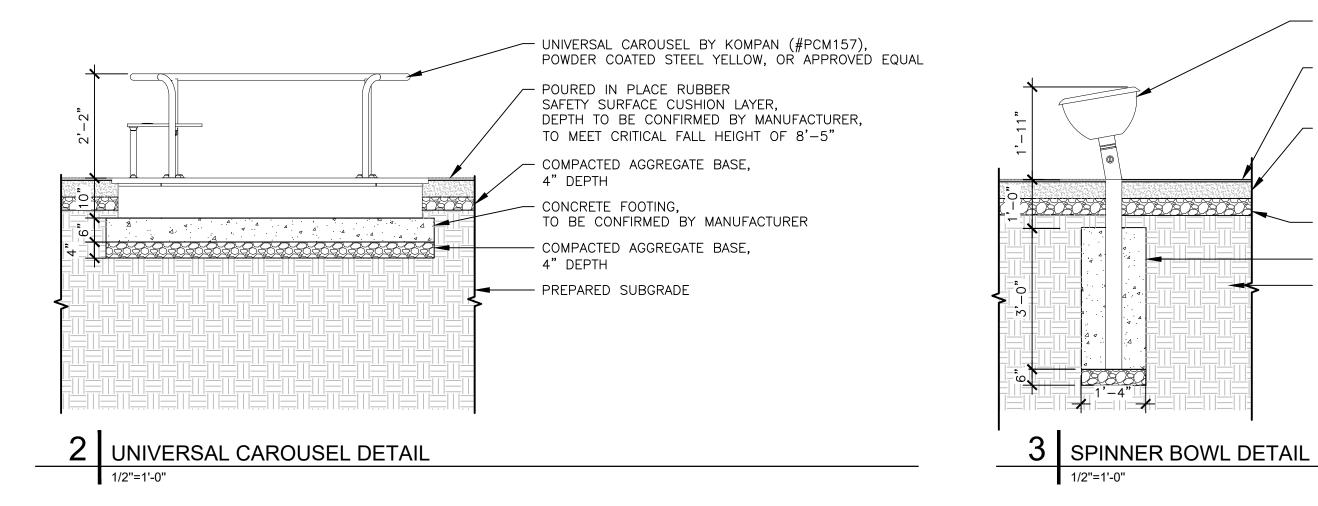

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5 POURED IN PLACE RUBBER TO CONCRETE PAVING DETAIL 1"=1'-0"
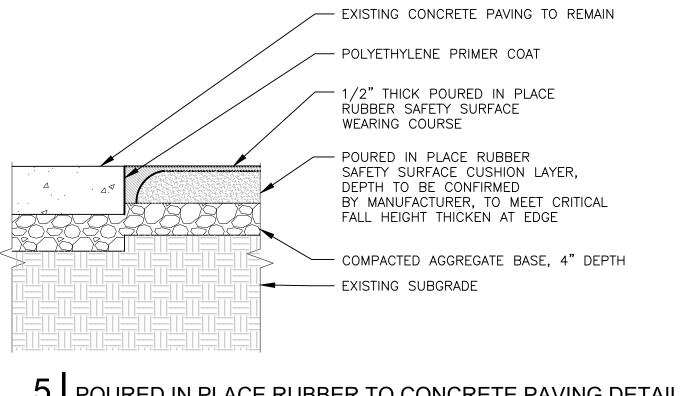
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## PELBANO PLAYGROUND

8101 BUSTLETON AVENUE

## OLIN

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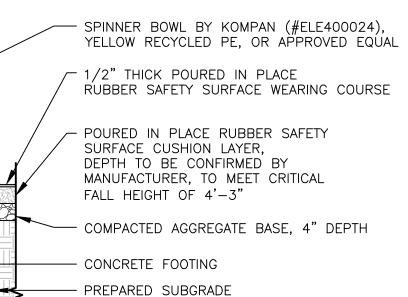
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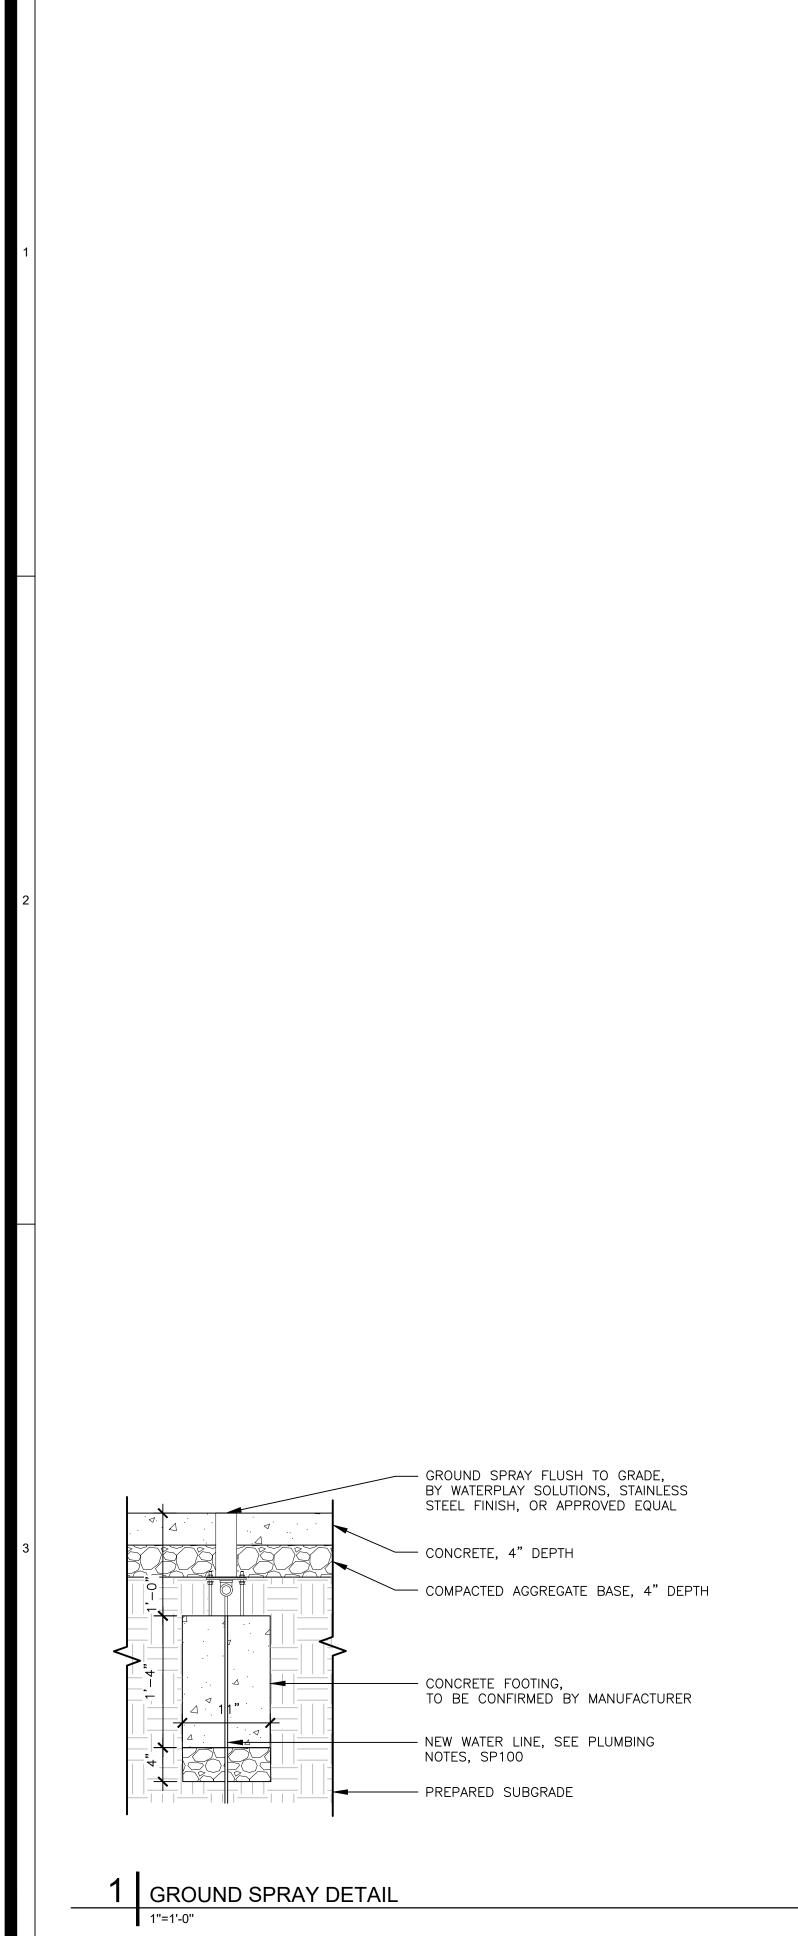
No.	Date	Description
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## PLAY EQUIPMENT DETAILS


Scale:	NA
Date:	05-19-2023
Drawn:	MT
Checked:	
Project No.	: 2224


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## PELBANO PLAYGROUND

8101 BUSTLETON AVENUE

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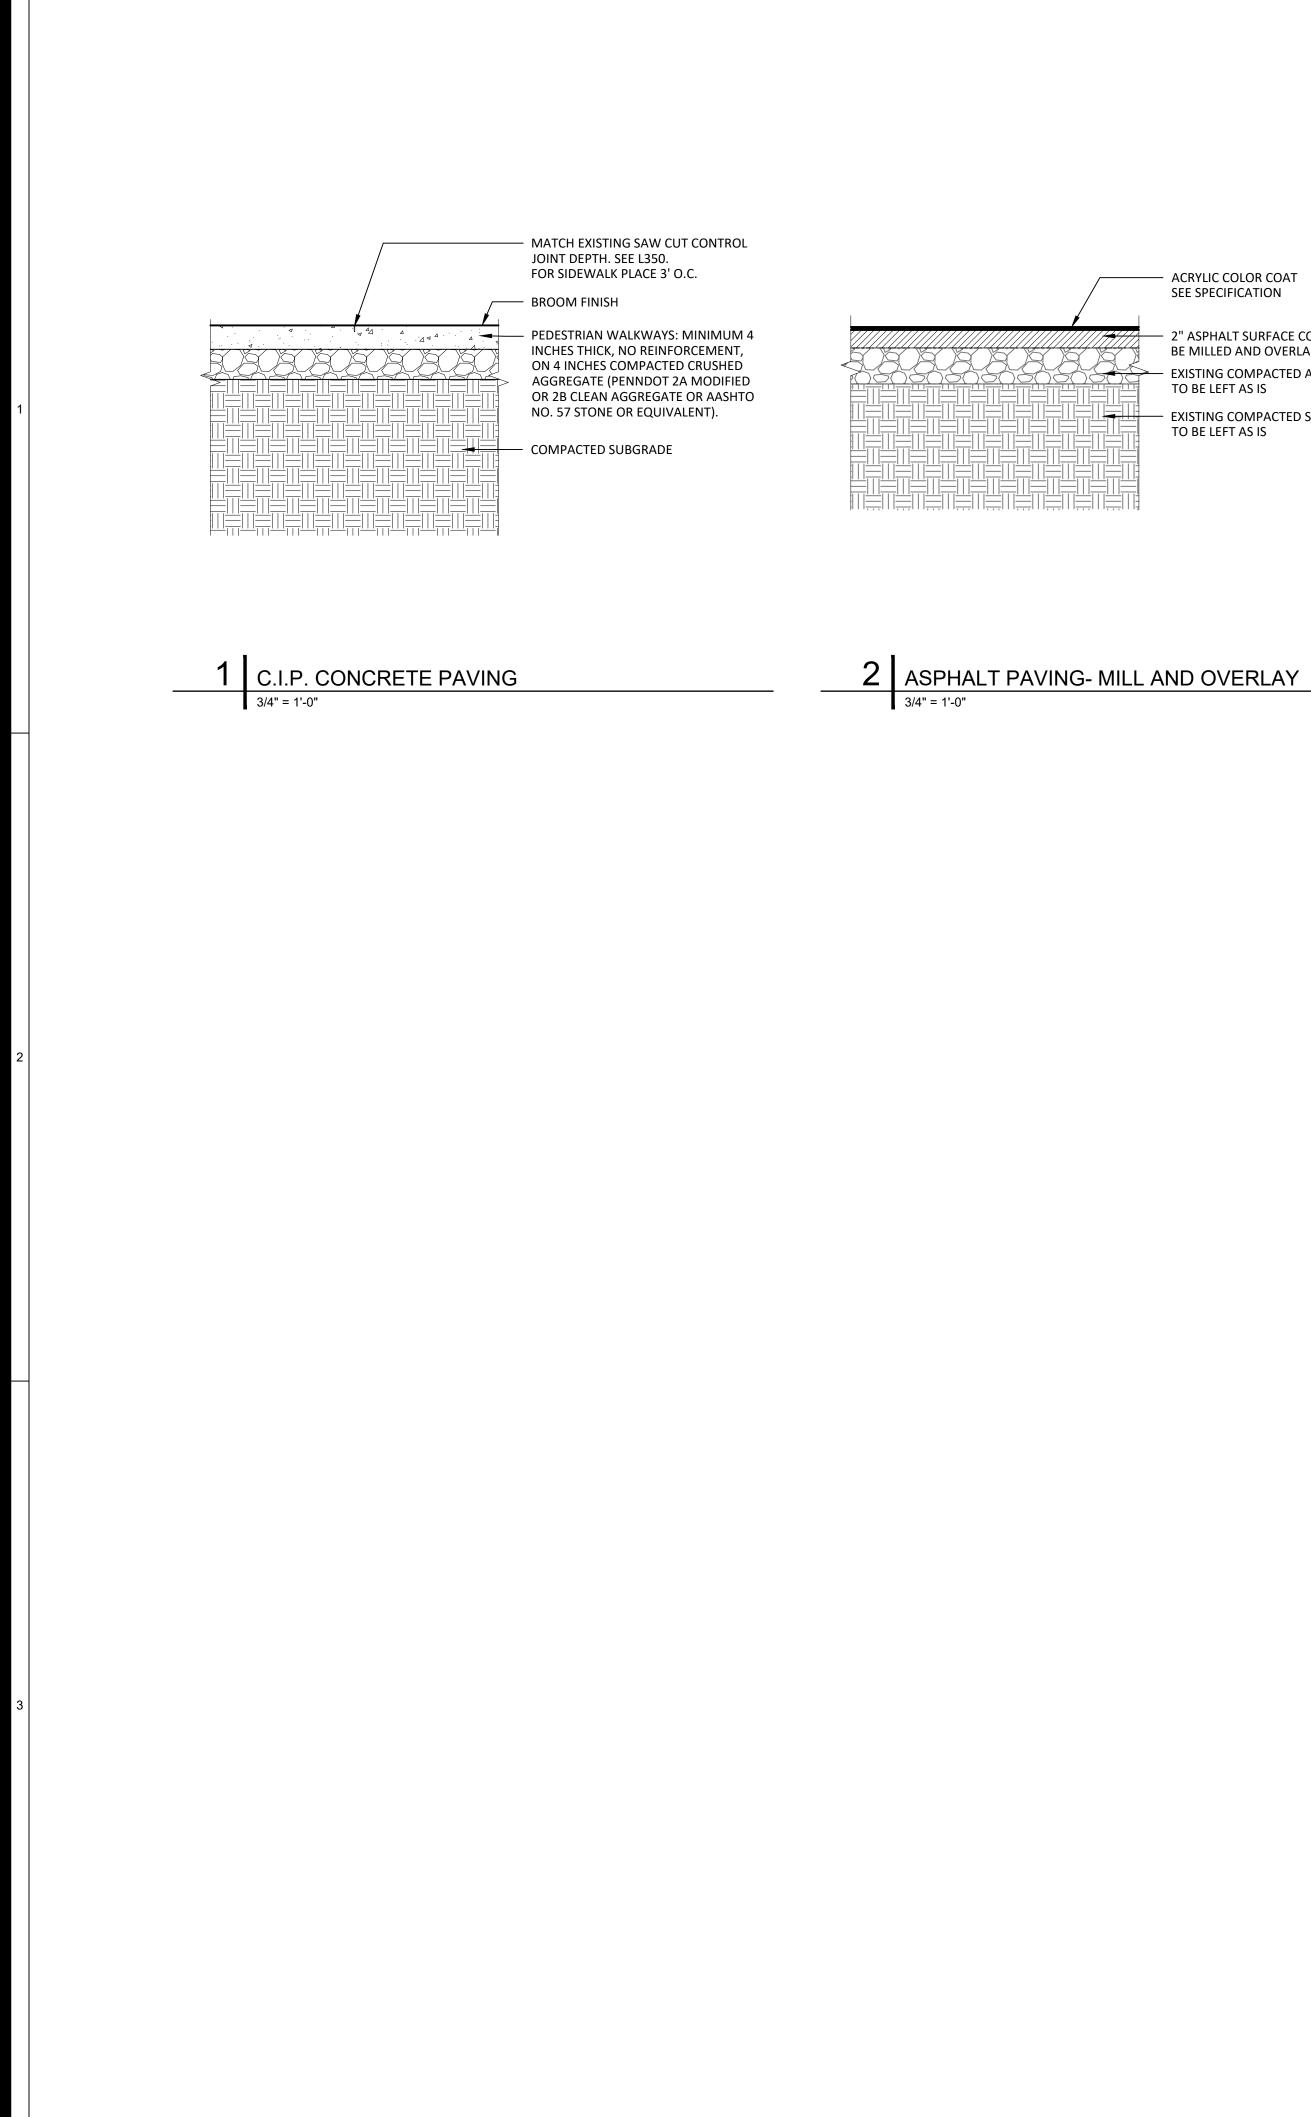
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3	2/21/2023	DD set
4	4/17/2023	75% CD s
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## PLAY EQUIPMENT DETAILS

NA
05-19-2023
MT
: 2224

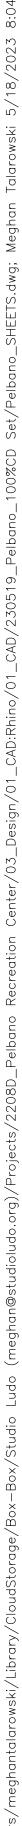

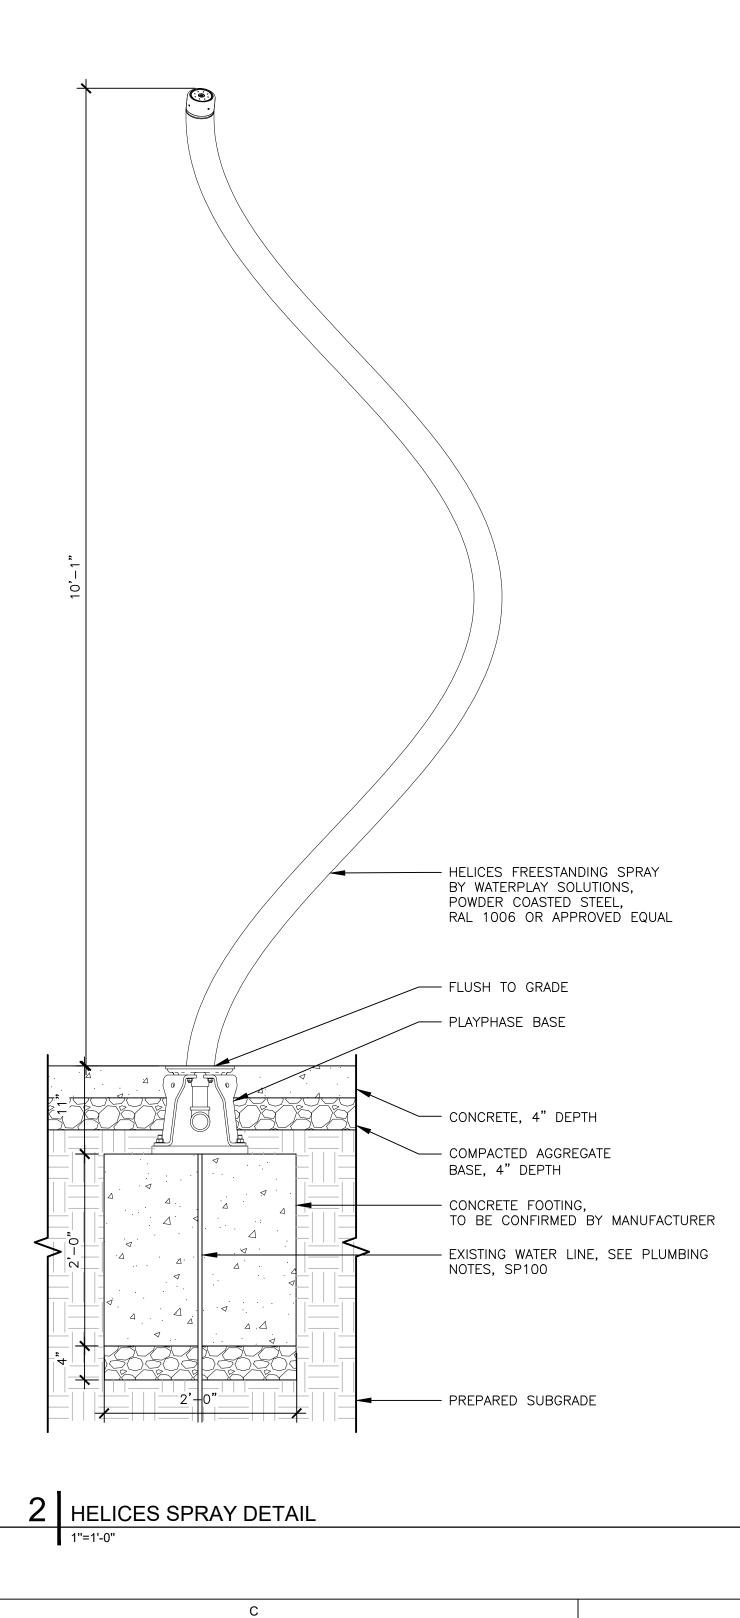

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ACRYLIC COLOR COAT

SEE SPECIFICATION

2" ASPHALT SURFACE COURSE, TO BE MILLED AND OVERLAID EXISTING COMPACTED AGGREGATE BASE TO BE LEFT AS IS

— EXISTING COMPACTED SUBGRADE TO BE LEFT AS IS

IN 4∆ 4 YLALI

- CONTROL JOINT. SEE L300. FOR SIDEWALK PLACE 3' O.C.

- BROOM FINISH

6 INCHES THICK ON 6 INCHES OF COMPACTED CRUSHED AGGREGATE (PENNDOT 2A MODIFIED OR 2B CLEAN AGGREGATE OR EQUIVALENT). REINFORCEMENT SHALL BE PER PROJECT ENGINEER'S RECOMMENDATIONS/SPECIFICATIONS. THICKENING OF SLABS AND OR FOUNDATIONS FOR SPRAYGROUND FEATURES SHALL BE PER PROJECT ENGINEER'S RECOMMENDATIONS/SPECIFICATIONS.

— COMPACTED SUBGRADE


3 C.I.P. CONCRETE PAVING FOR SPRAYGROUND 3/4" = 1'-0"

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- MATCH EXISTING CONCRETE PAVING JOINT

- EXPANSION JOINT MATERIAL. SEE SPECS

4 EXPANSION JOINT 6" = 1'-0"

## PELBANO PLAYGROUND

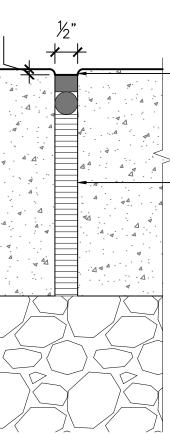8101 BUSTLETON AVENUE

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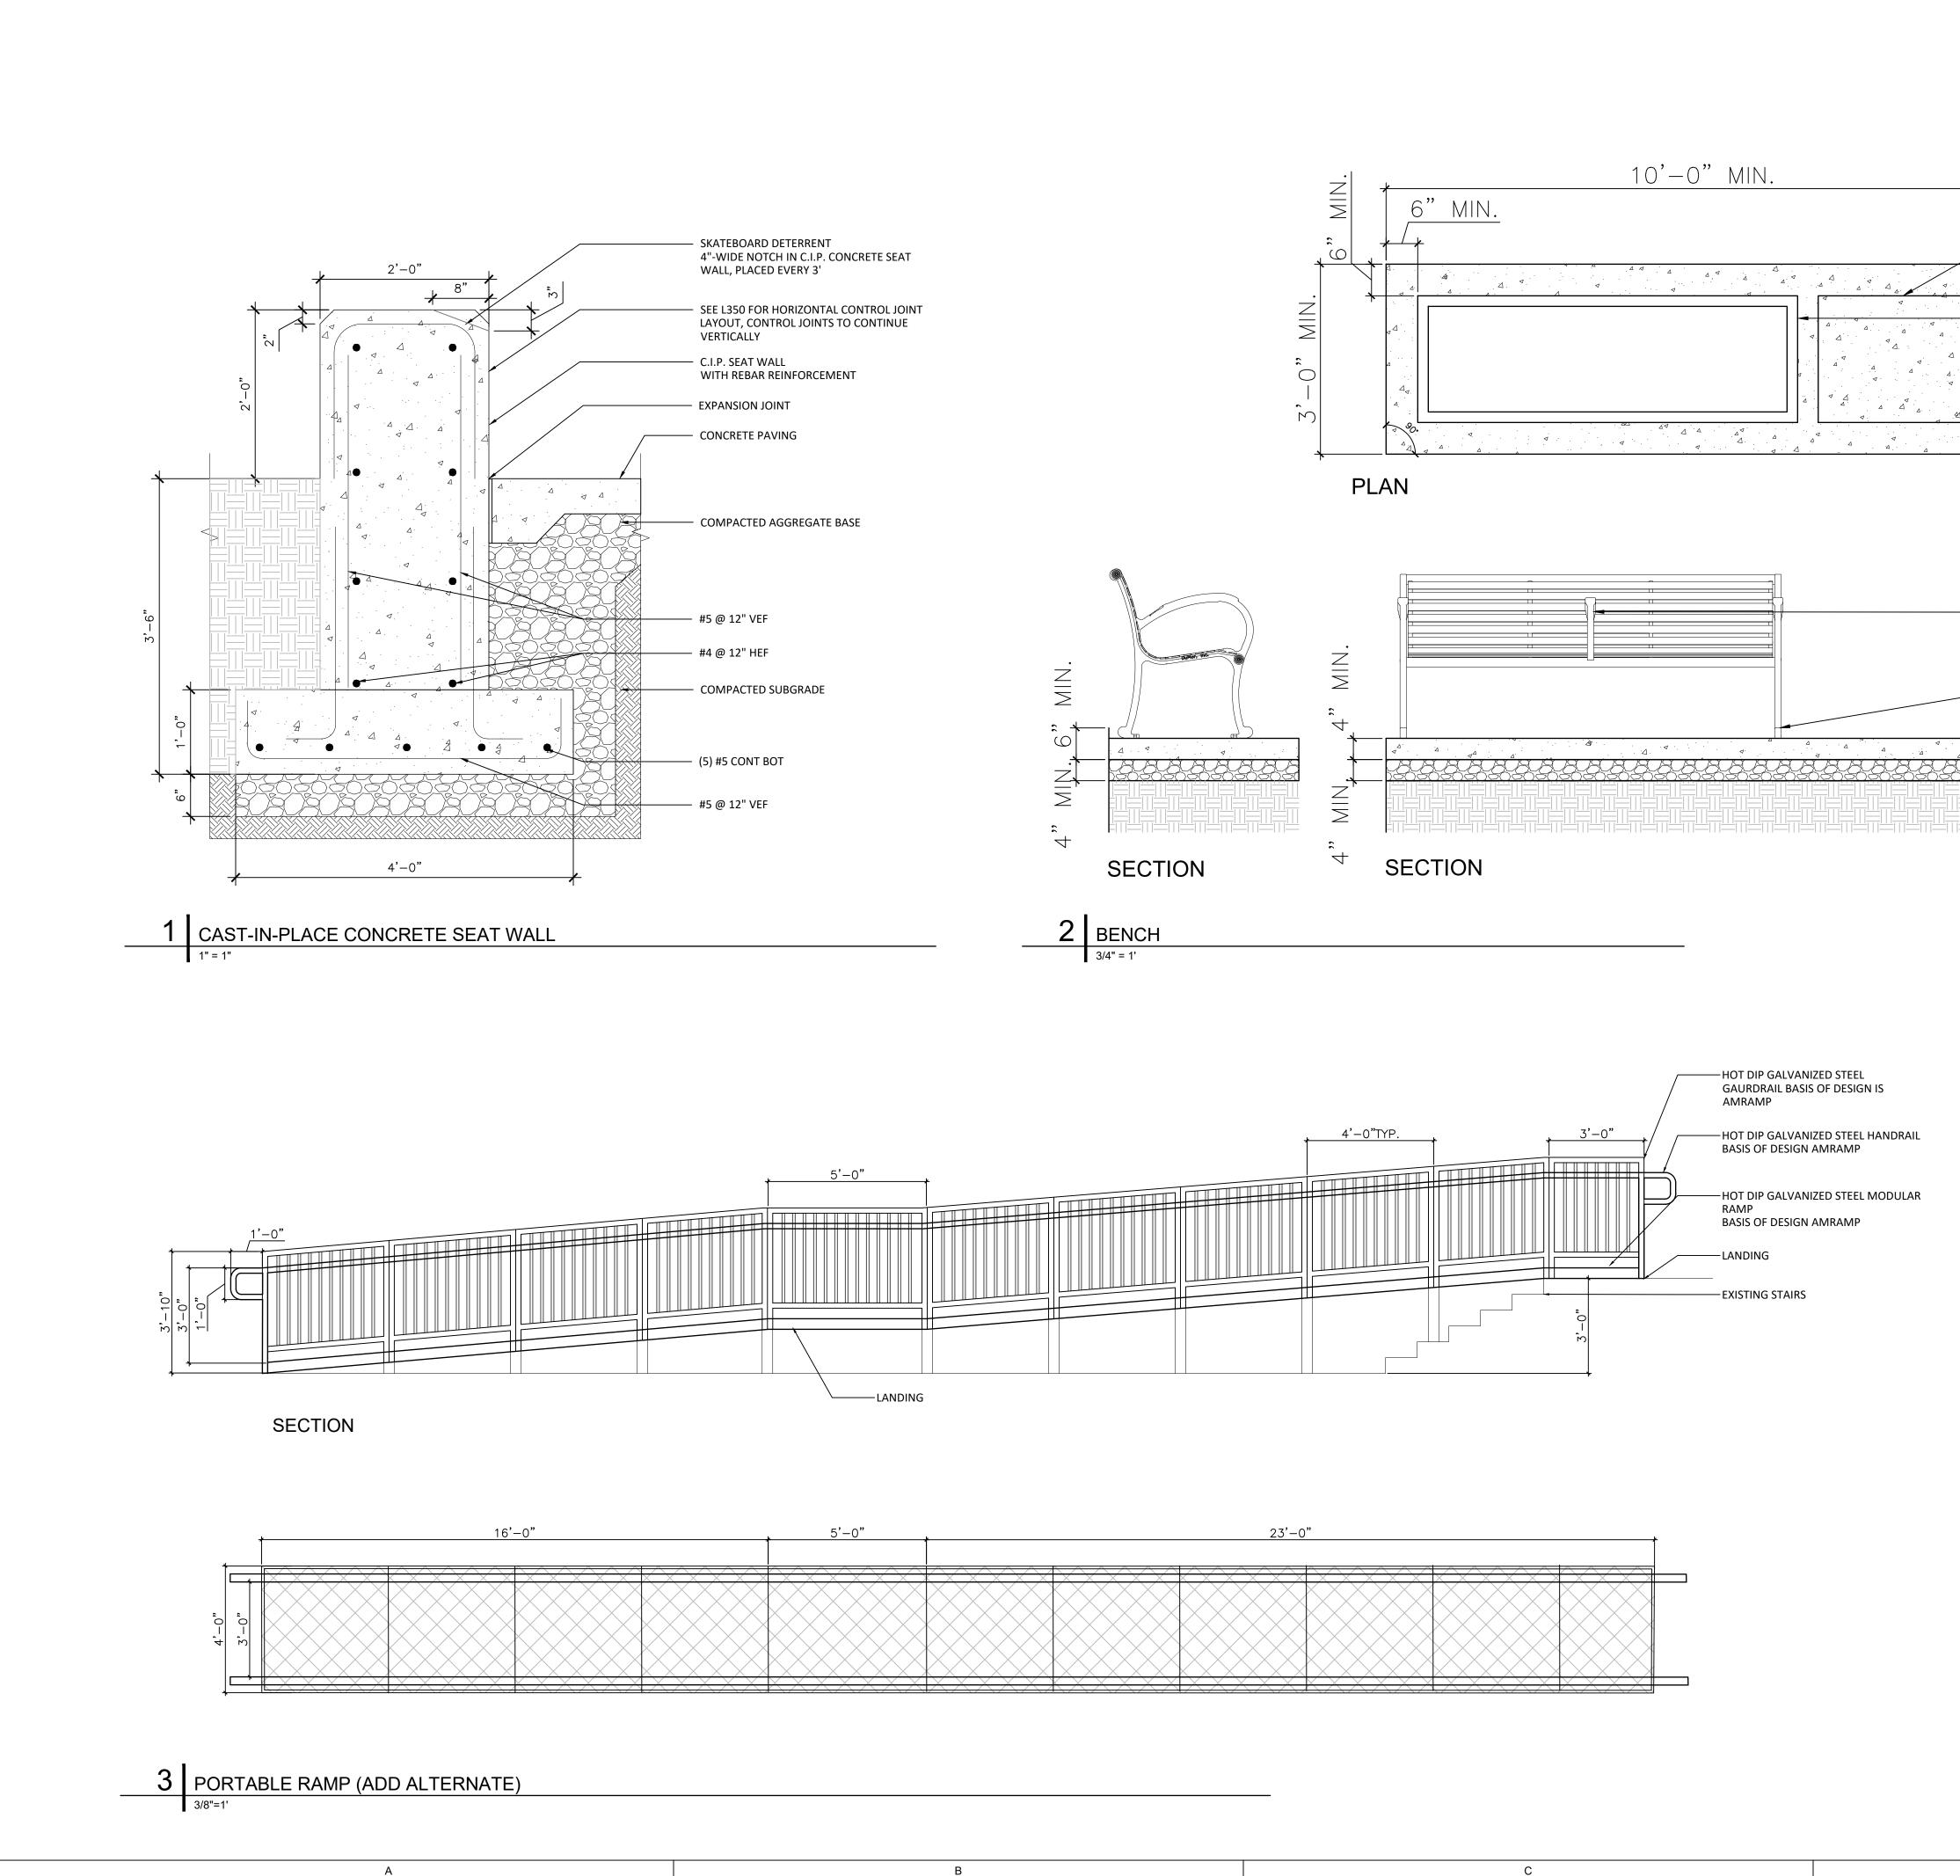
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## **DETAILS - PAVING**

Scale:	NA
Date:	5/31/2023
Drawn:	KMP
Checked:	TS
Project No.:	2224







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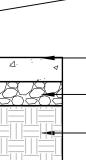
 ADA SPACE FOR WHEELCHAIR. AREA MUST MEET MOST CURRENT ADA STANDARDS (<2% SLOPE IN ANY DIRECTION)</li> 

 NEW BENCH(TYP). BENCH TO BE MOUNTED TO CONCRETE PAD AS PER MANUFACTURER'S INSTRUCTIONS

— 4" THICK CONCRETE PAD, 4000 PSI MIN (TYP).

- CENTER ARMREST WITH FAIRMOUNT PARK PANEL

- ANCHOR BOLTS PER MANUFACTURER'S INSTRUCTIONS



- CONCRETE PAD, 4000 PSI MIN (TYP).

- CRUSHED AGGREGATE BASE. – COMPACTED SUBGRADE (TYP). 8101 BUSTLETON AVENUE

## OLIN

LANDSCAPE ARCHITECTURE / URBAN DESIGN / PLANNING ONE PENN CENTER 1617 JOHN F. KENNEDY BOULEVARD, SUITE 1900 PHILADELPHIA, PA 19103 TEL 215.440.0030 / FAX 215.440.0041 WWW.THEOLINSTUDIO.COM OLIN PARTNERSHIP, LTD.

Playground Design: Studio Ludo 4800 Springfield Ave Philadelphia, PA 19143 (215) 454-6780

Civil Engineering: Sci Tek 1880 John F Kennedy Blvd #600, Philadelphia, PA 19103 (267) 314-5385


MEP: Mark Ulrick 30 N. 41ST SUITE 500 Philadelphia, PA 19104 (856) 320-8100

No.	Date	Description
1	10/12/2022	SD set
2	11/16/2022	SD set
3	2/21/2023	DD set
4	4/17/2023	75% CD s
5	5/31/2023	100% CD

### **DETAILS - SITE FURNISHINGS**

Scale:	N
Date:	5/31/202
Drawn:	KMI
Checked:	T
Project No.:	222



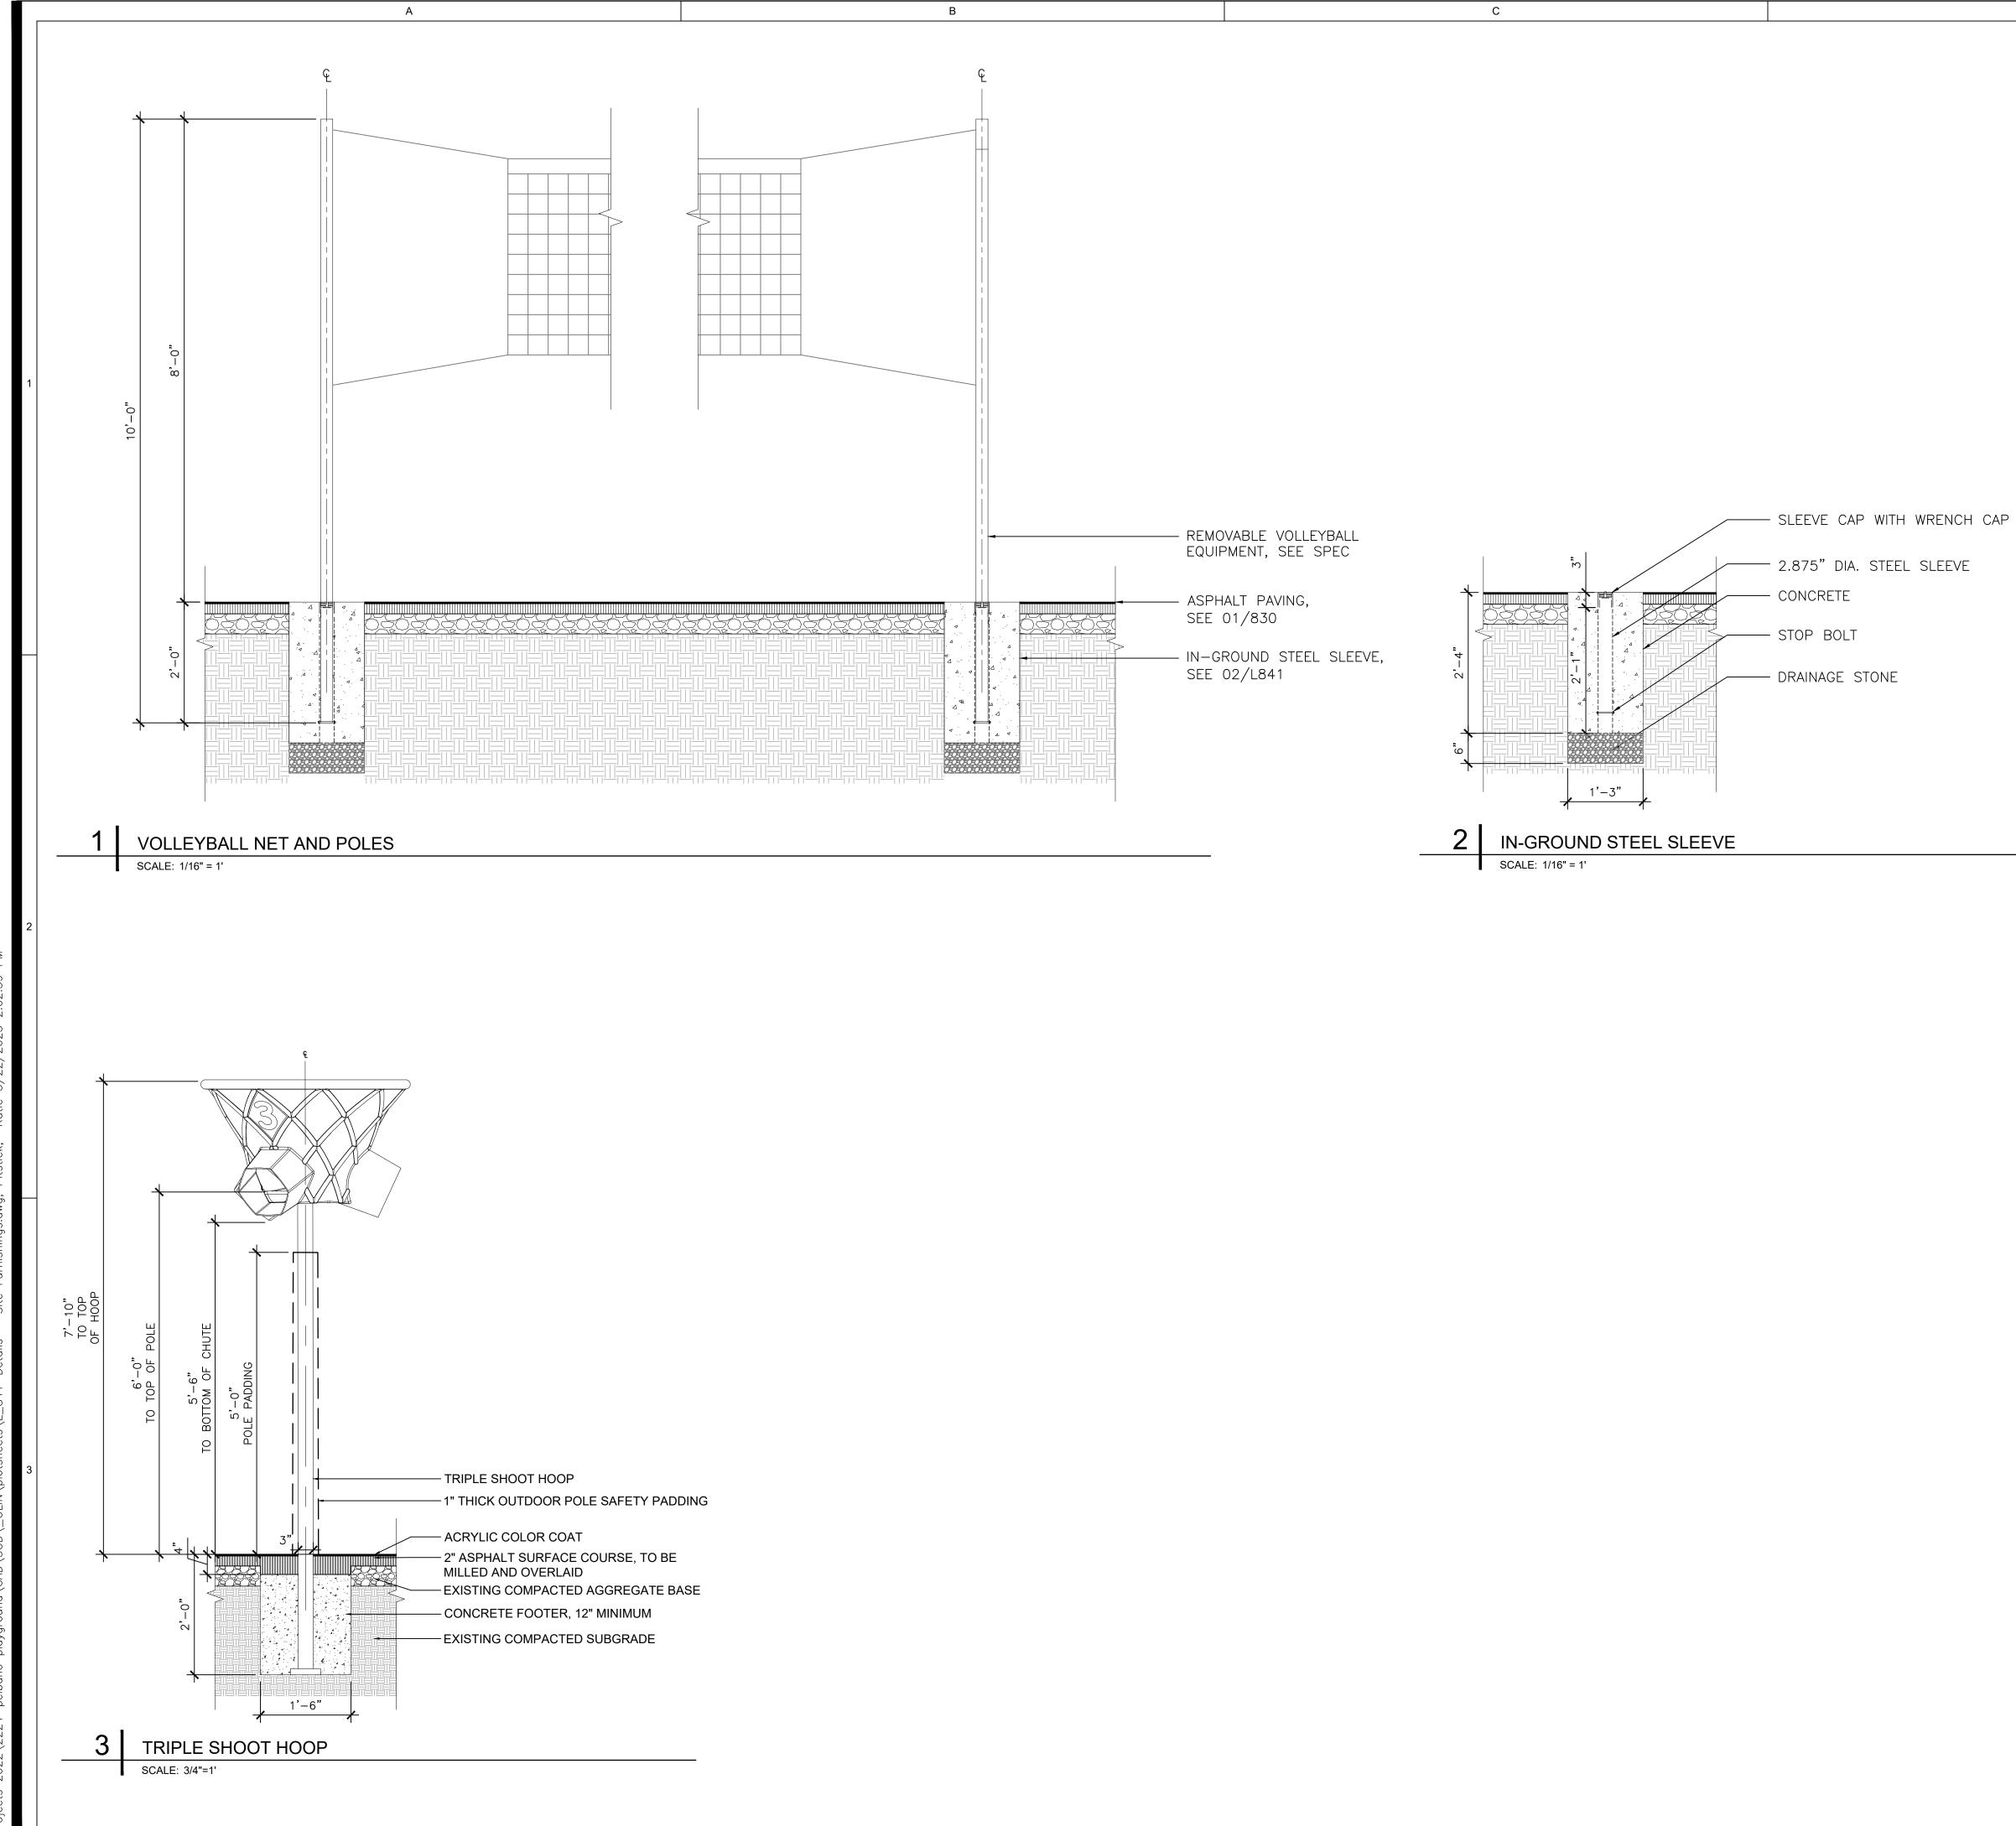

8101 BUSTLETON AVENUE

## OLIN

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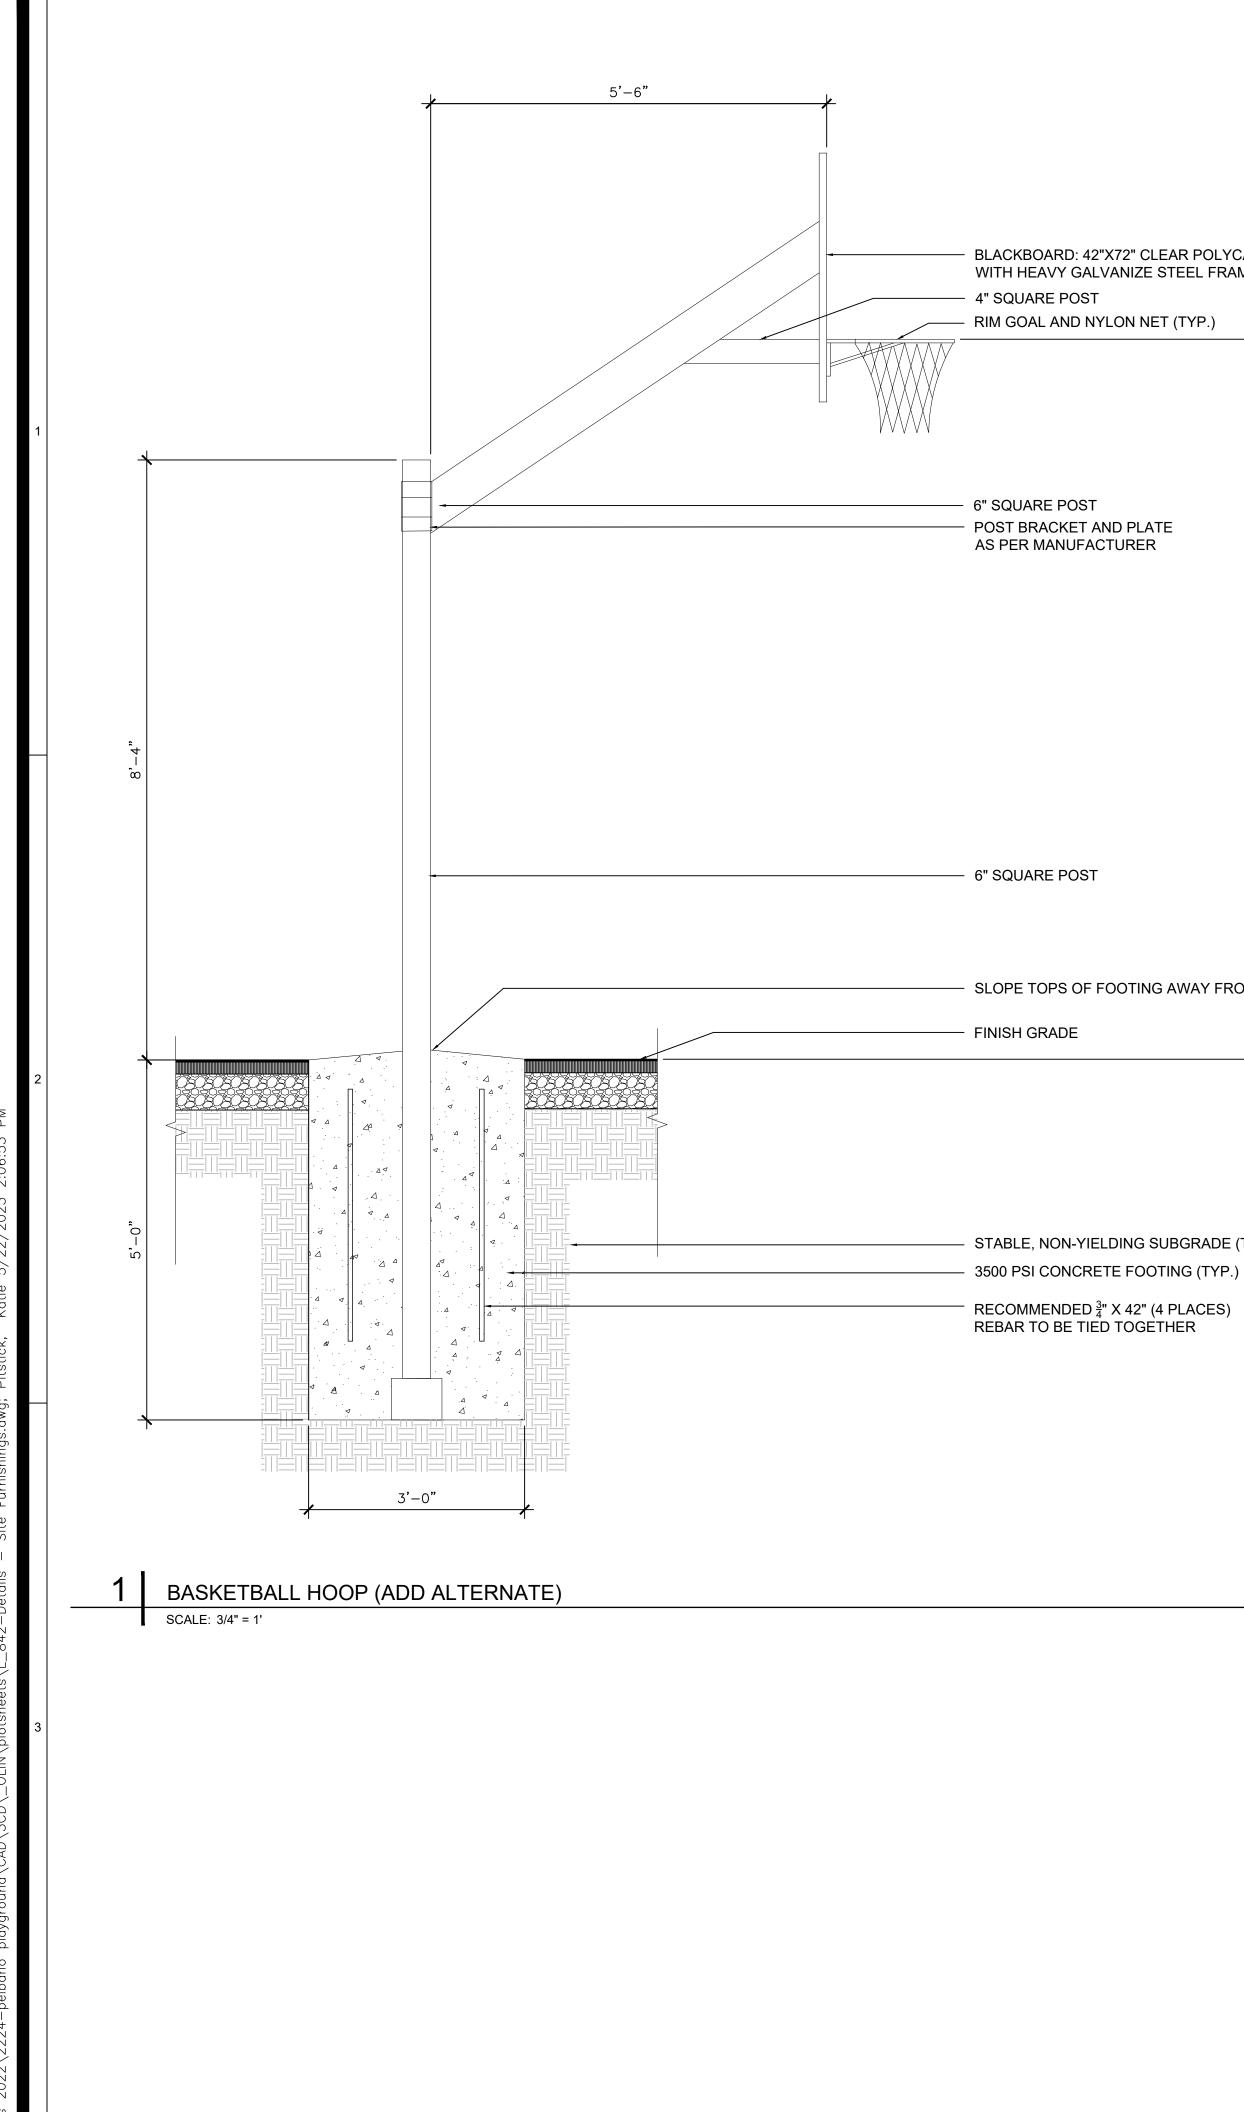
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DETAILS - SITE FURNISHINGS


Scale:	NA
Date:	5/31/2023
Drawn:	KMP
Checked:	TS
Project No.:	2224





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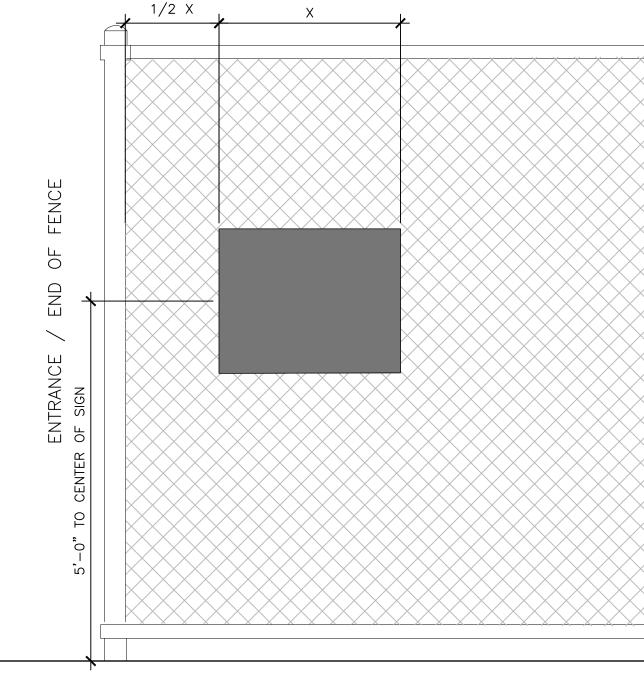


## - BLACKBOARD: 42"X72" CLEAR POLYCARBONATE WITH HEAVY GALVANIZE STEEL FRAME

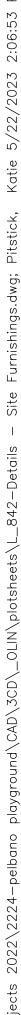В

- SLOPE TOPS OF FOOTING AWAY FROM POST

- STABLE, NON-YIELDING SUBGRADE (TYP.) 3500 PSI CONCRETE FOOTING (TYP.)



2

## PLAYGROUND RULES AND HOURS SIGN

С

С

SCALE: 3/4" = 1'

## PELBANO PLAYGROUND

8101 BUSTLETON AVENUE

## OLIN

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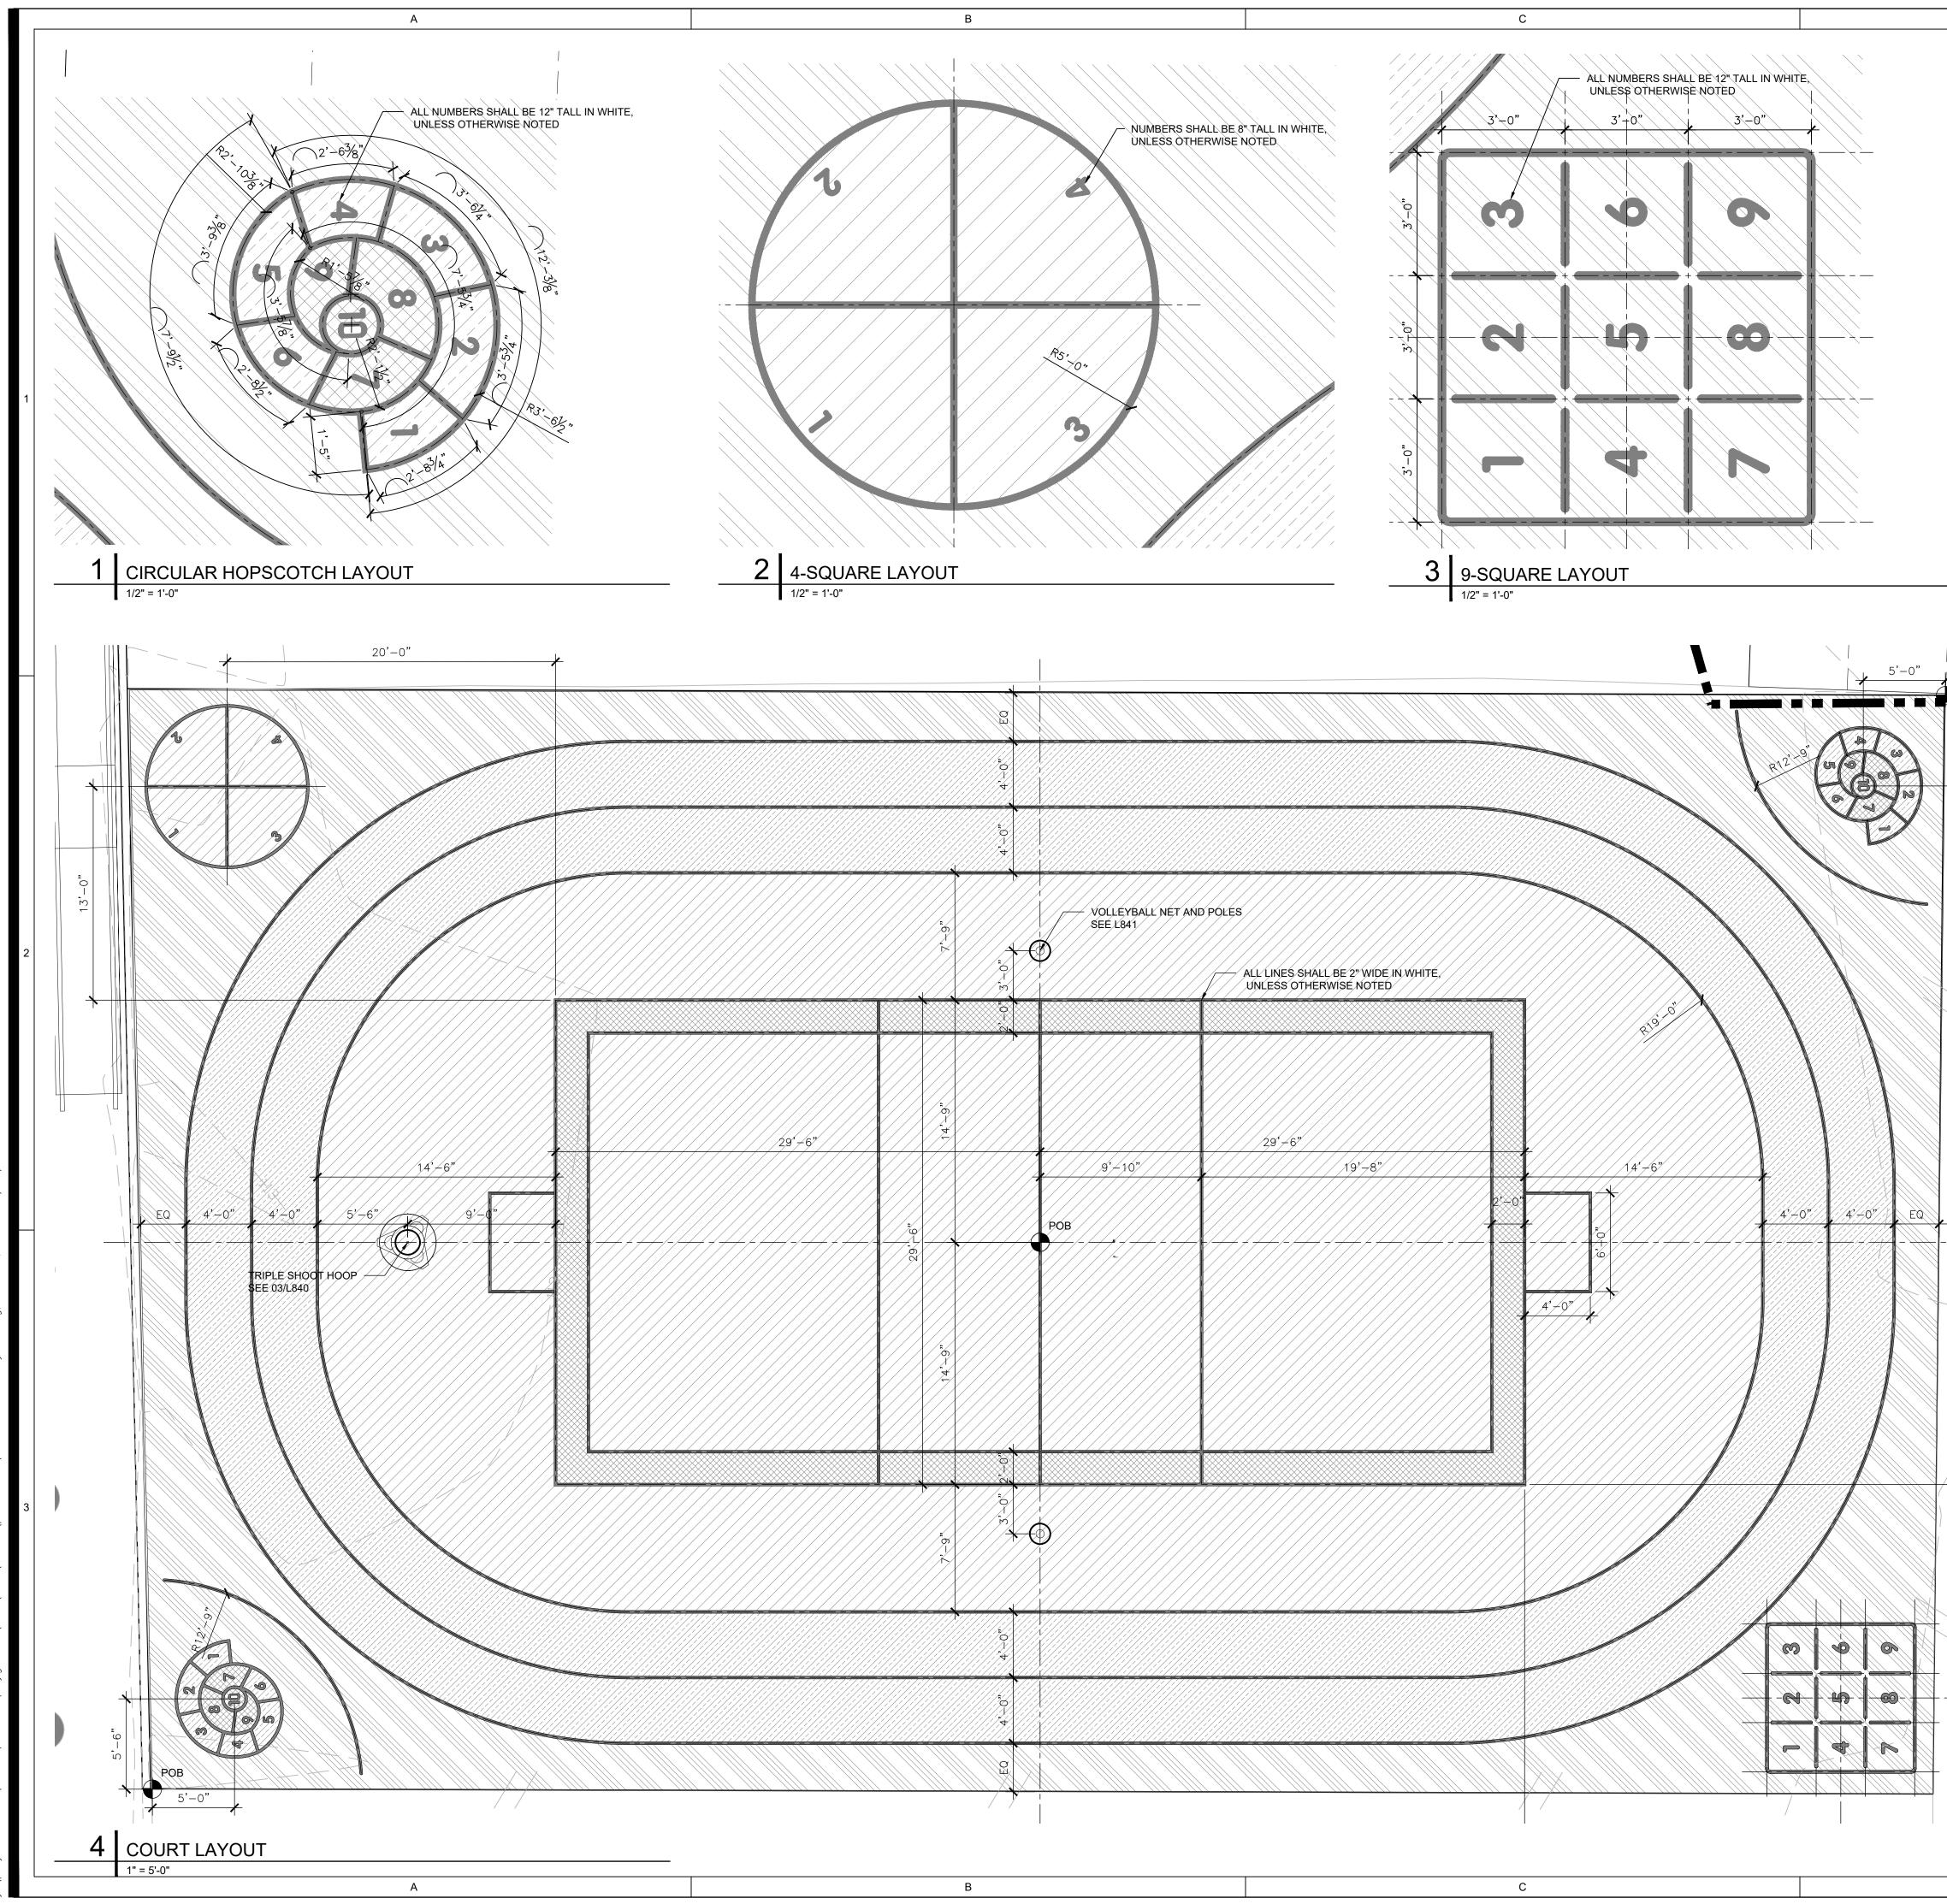
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DETAILS - SITE FURNISHINGS

Scale:	NA
Date:	5/31/2023
Drawn:	KMF
Checked:	Т
Project No.:	2224



### ASPHALT PAINT LEGEND

	PROJECT LIMIT LINE
	PROPERTY LINE
	BUILDING
☆■ © ●E ダ■ ⊗ ®-C- ◎ ^ <del>v</del> T ○	EXISTING UTILITY BOXES, SEE CIVIL DWGS



DARK BLUE - PANTONE 2131 U LIGHT BLUE - PANTONE 551 C

YELLOW - PANTONE P 7-13 C ORANGE - PANTONE 152 CP

WHITE - PANTONE P 179-1 C

PANTONE COLORS ARE DESIGN TARGET. ACTUAL COLOR SHALL BE SELECTED FROM PAINT MANUFACTURER'S STANDARD COLOR RANGE

### ASPHALT PAINT PLAN NOTES

1. ALL WIDTHS OF COURT LINES TO BE 2" O.C.

## PELBANO PLAYGROUND

### 8101 BUSTLETON AVENUE

## OLIN

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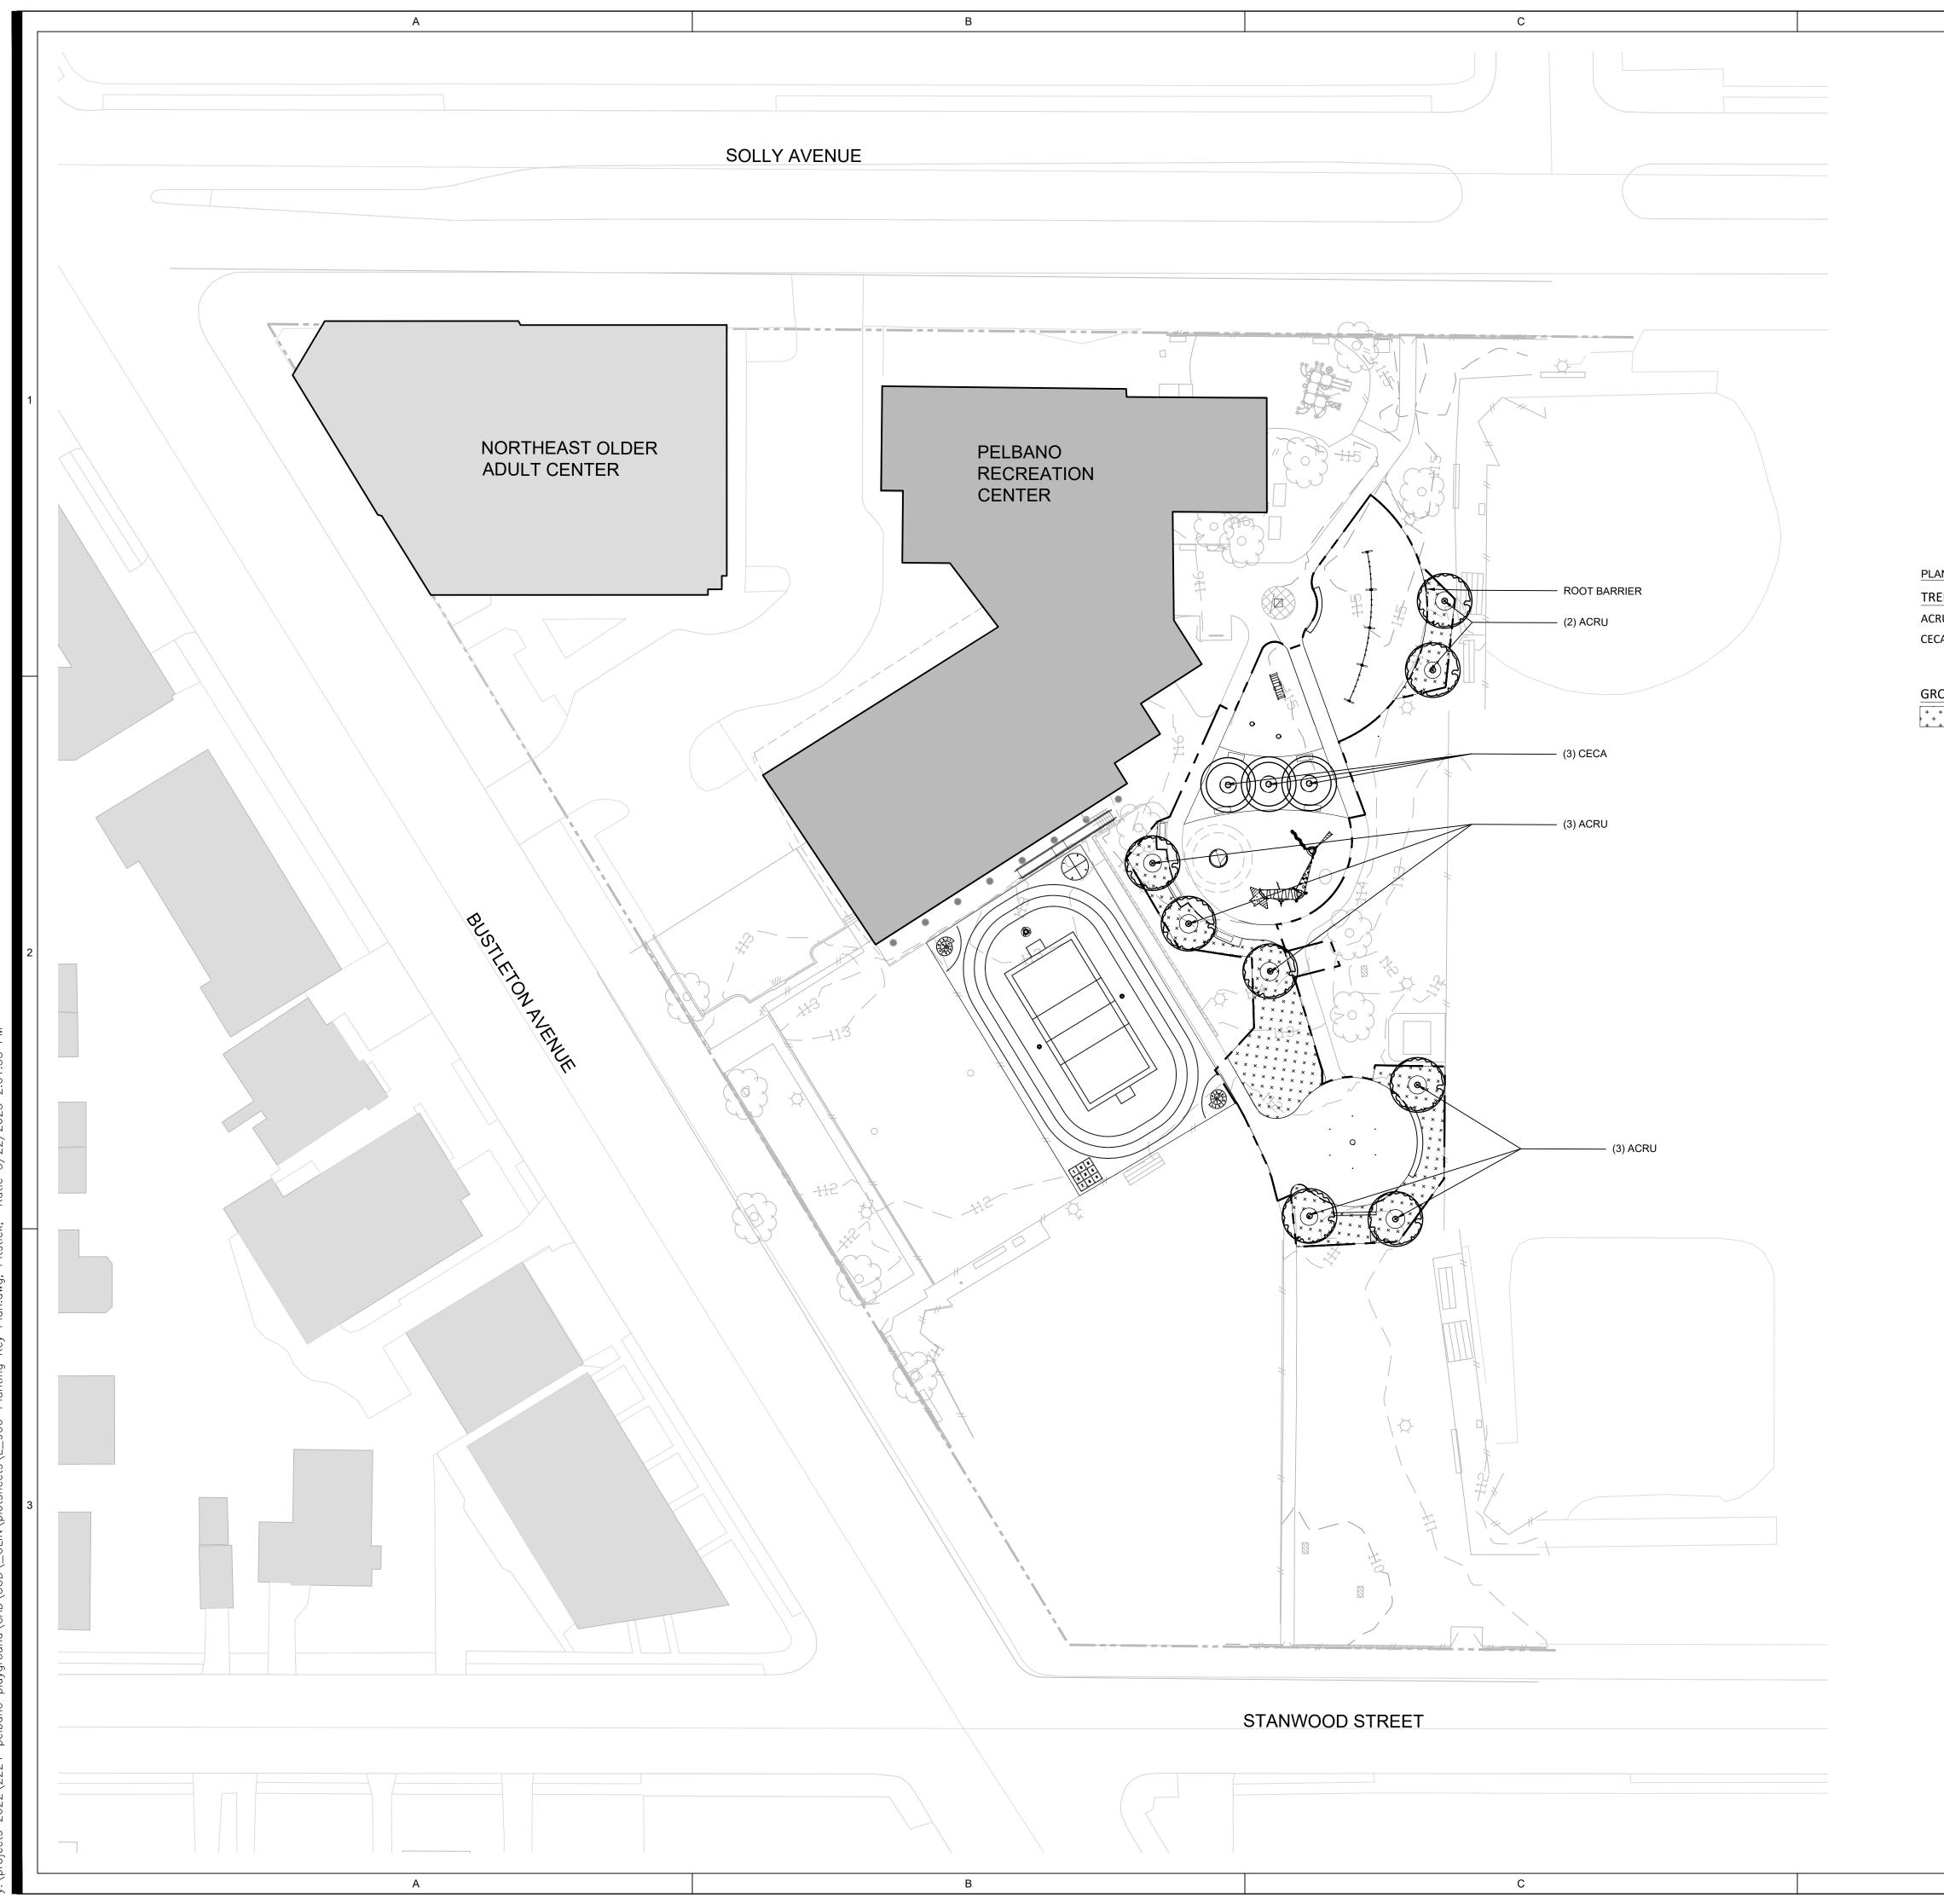
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4	4/17/2023	75% CD se
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### DETAILS - COURT LAYOUT


Scale:	NA
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Drawn:	KMF
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### PLANTING LEGEND



\_\_\_\_ ROOT BARRIER

### PLANTING SCHEDULE

EES	BOTANICAL/COMMON NAME	CONT	SOIL DEPTH	QTY
RU	ACER RUBRUM/RED MAPLE	4" CALIPER	3'	8
CA	CERCIS CANADENSIS/ EASTERN REDBUD MULTI-TRUNK	10-12' HEIGHT	3'	3
OUNDCOVER	BOTANICAL/COMMON NAME SODDED LAWN	CONT	SOIL DEPTH 8"	<u>QTY</u> 5,459 SF
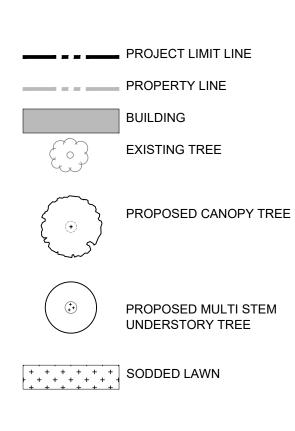
### PLANTING NOTES

- 1. ALL AREAS NOT COVERED BY BUILDINGS OR PAVEMENT AND WHICH HAVE BEEN GRADED OR OTHERWISE DISTURBED SHALL BE TOPSOILED AND SEEDED, UNLESS SHOWN OTHERWISE. 2. ALL TREES OUTSIDE THE BUILDING AND PAVED AREAS SHALL REMAIN AND BE PROTECTED DURING CONSTRUCTION, UNLESS SPECIFICALLY
- DESIGNATED TO BE REMOVED. PRIOR TO REMOVAL, THE CONTRACTOR SHALL ARRANGE AN ON-SITE MEETING WITH THE LANDSCAPE ARCHITECT TO REVIEW THE CLEARING LIMIT LINES. VERIFY LOCATIONS OF ALL UTILITIES PRIOR TO EXCAVATION OR PLANT PITS.
- 3. P.B. = PLANT BED. MULCH ALL PLANT BEDS TO A DEPTH OF 3-4". BEDS SHALL BE KEPT 1" MIN AWAY FROM TRUNK OF ALL TREES, SHRUBS, TREE FERNS, AND FOLIAGE OF ALL PERENNIALS.
- 4. THE CONTRACTOR SHALL SUPPLY ALL PLANT MATERIAL IN QUANTITIES SUFFICIENT TO COMPLETE THE PLANTING SHOWN IN THE DRAWINGS.
- 5. CONTRACTOR SHALL REMOVE ALL HARD LUMPS OF CLAY, STONES OVER 1" IN DIAMETER, AND ALL CONSTRUCTION DEBRIS INCLUDING GRAVEL, ROOTS, LIMBS AND OTHER DELETERIOUS MATTER WHICH WOULD BE HARMFUL, OR PREVENT PROPER ESTABLISHMENT AND/OR MAINTENANCE OF LAWN AND PLANTING AREAS.
- 6. ALL TREES SHALL CONFORM TO GUIDELINES ESTABLISHED BY "THE AMERICAN STANDARD FOR NURSERY STOCK" PUBLISHED BY THE AMERICAN ASSOCIATION OF NURSERYMEN (LATEST EDITION).
- 7. NO TREES SHALL BE PLANTED BEFORE ACCEPTANCE OF ROUGH GRADING. TREES SHALL BEAR SAME RELATIONSHIP TO FINISHED GRADE AS TO ORIGINAL GRADE PRIOR TO DIGGING.
- 8. ALL PLANTS SHALL BE BALLED IN BURLAP OR CONTAINER GROWN UNLESS OTHERWISE NOTED IN THE PLANTING SCHEDULE.
- 9. ALL PLANTS SHALL BE APPROVED BY THE LANDSCAPE ARCHITECT PRIOR TO THEIR ARRIVAL ON THE SITE
- 10. THE CONTRACTOR SHALL LOCATE AND VERIFY UTILITY LINE LOCATIONS PRIOR TO PLANTING AND REPORT ANY CONFLICTS TO THE LANDSCAPE ARCHITECT.
- 11. THE LAYOUT OF PLANTS IN THE FIELD IS TO BE APPROVED BY THE LANDSCAPE ARCHITECT PRIOR TO PLANTING.

SCALE: 1" = 30'-0"

# PLAYGROUND

PELBANO

8101 BUSTLETON AVENUE

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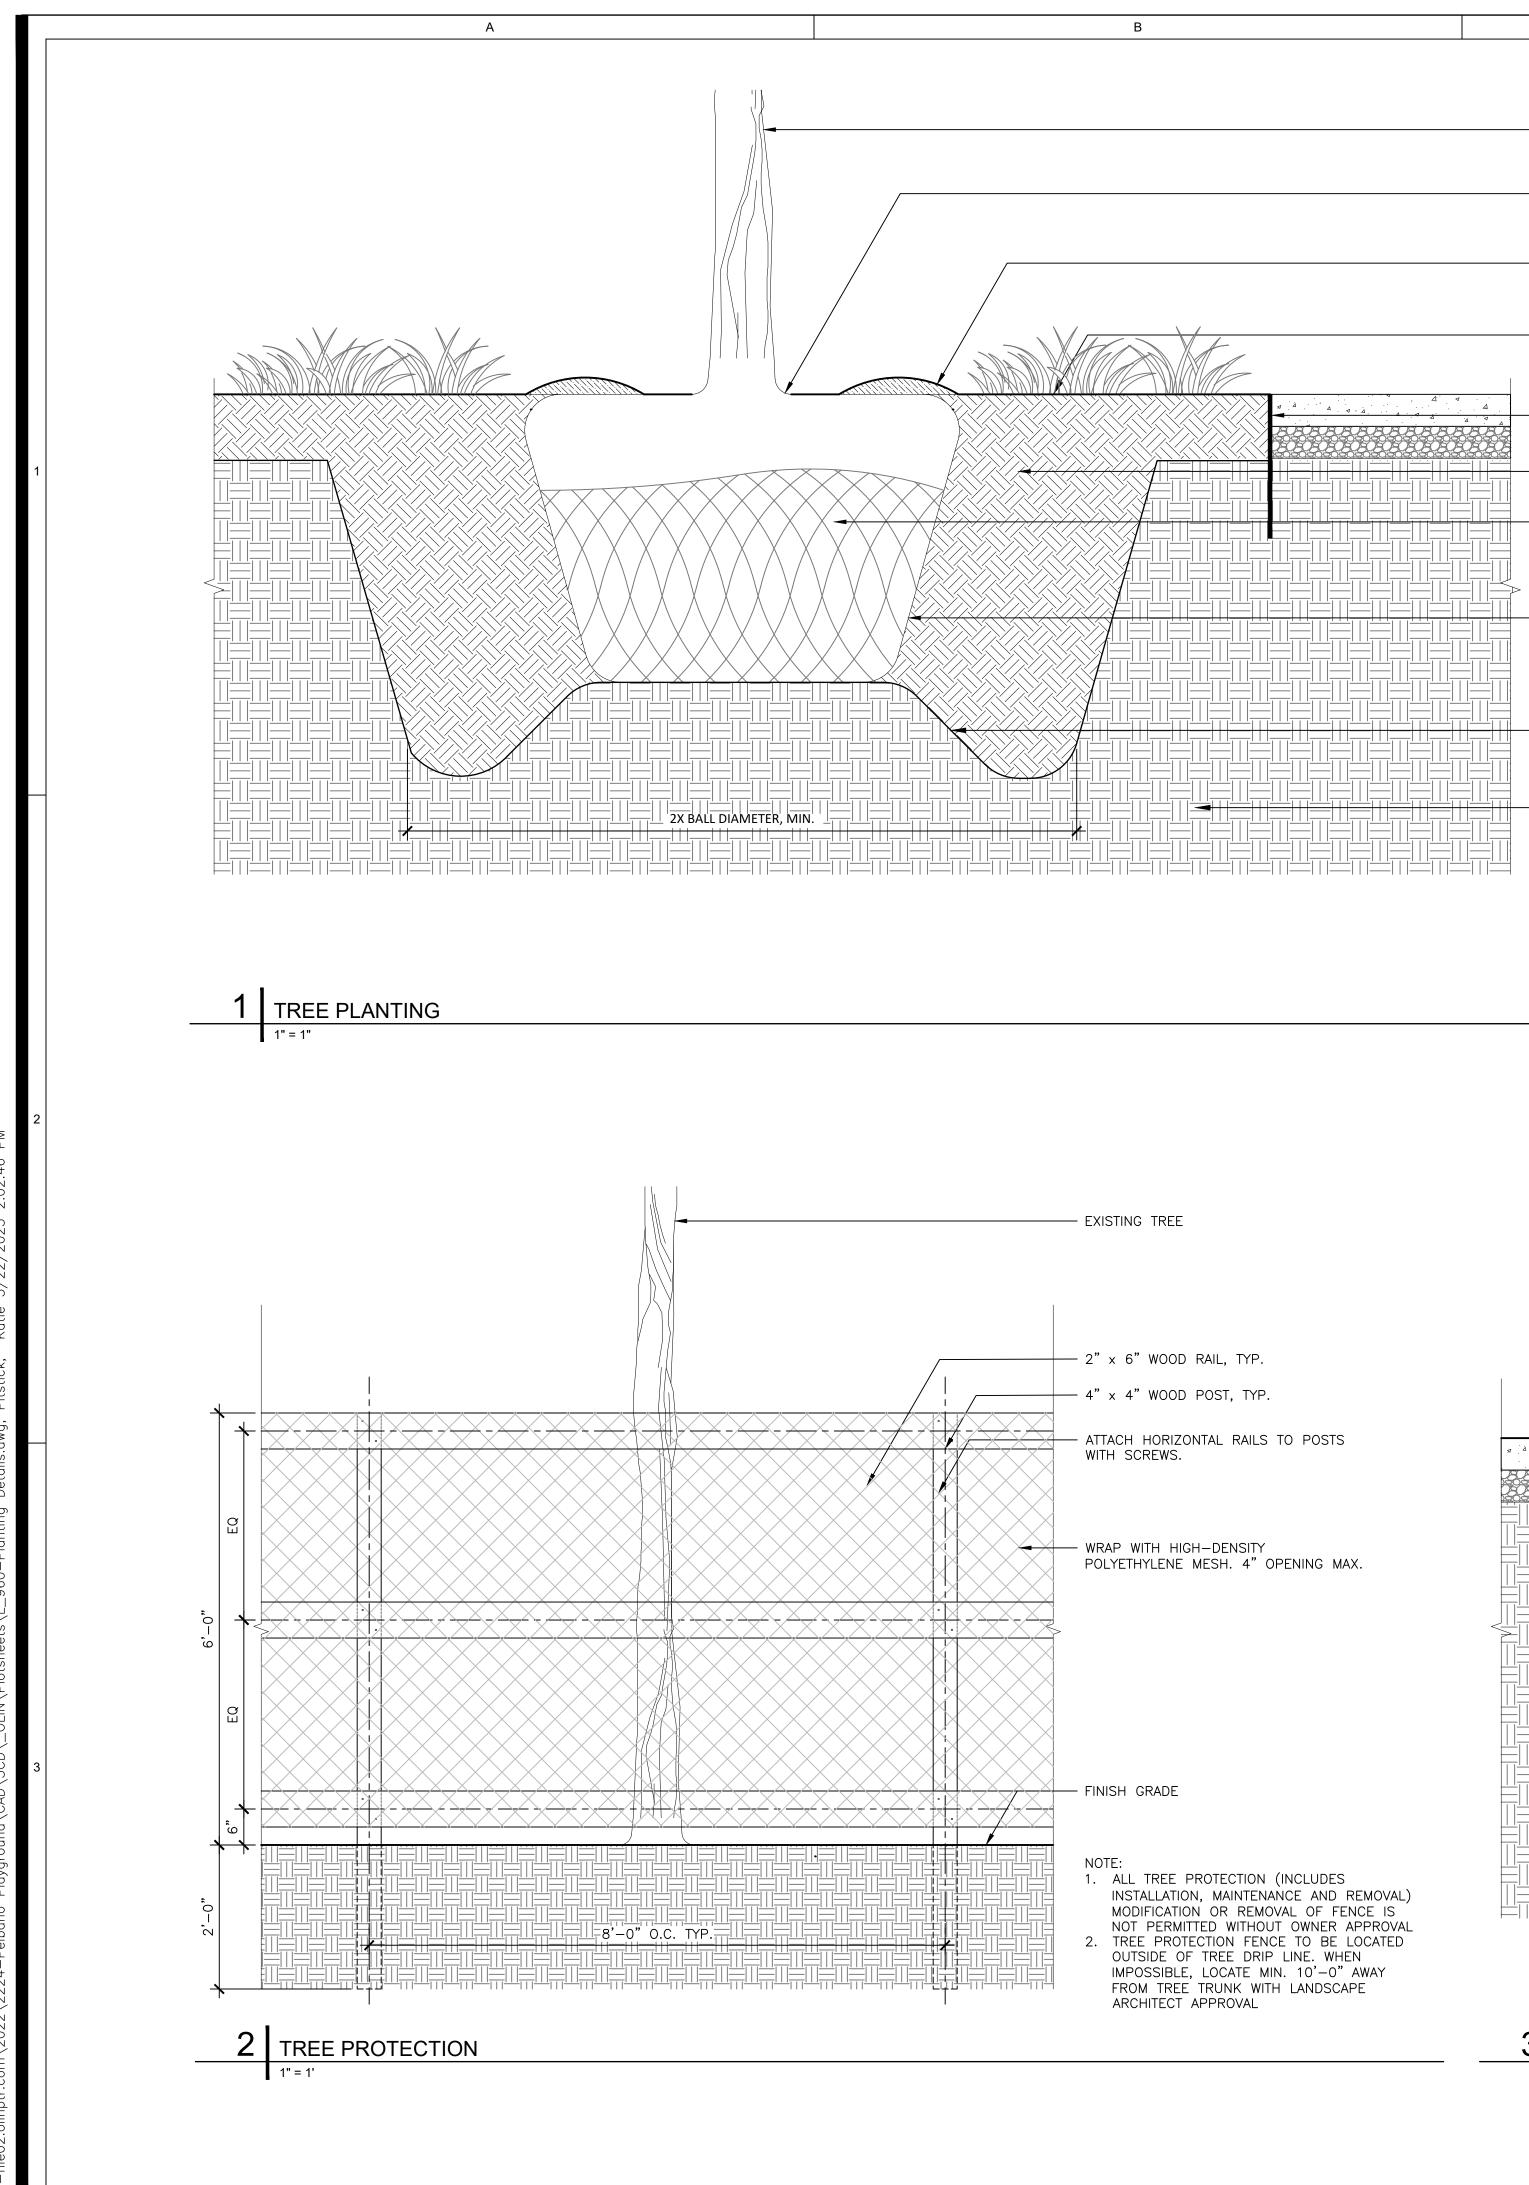
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### PLANTING KEY PLAN

Scale:	1"=30'
Date:	5/31/2023
Drawn:	KMP
Checked:	TS
Project No.:	2224





START OF ROOT FLARE TO ALIGN WITH TOP OF FINISH GRADE OR ABOVE. CONFIRM THAT ROOTBALL IS SOLID AND WILL NOT SETTLE FOLLOWING INSTALLATION, OTHERWISE PLANT SEVERAL INCHES ABOVE FINISH GRADE.

С

3-4" THICK MULCH RING LAYER. DO NOT PLACE MULCH WITHIN 6" OF TRUNK OR STEM

FINISHED GRADE VARIES SEE GRADING PLAN

18" ROOT BARRIER POSITION TOP OF ROOT BARRIER FLUSH WITH FINISH GRADE

– PLANTING SOIL, SEE L540

CUT AND REMOVE OR FOLD AWAY WIRE BASKET FROM ROOTBALL. REMOVE MOST OF BURLAP, DO NOT PULL BURLAP OUT FROM UNDER ROOTBALL. REMOVE PLATFORMS, WIRE, OR BINDINGS FROM TOPS AND SIDES OF ROOTBALL. REMOVE SOIL AS NECESSARY TO UNCOVER ROOT FLARE

· CLEANLY SHEAR 1-2" FROM THE EDGE OF ROOT MASS W/SHARP INSTRUMENT

- COMPACTED BASE TO SUPPORT ROOTBALL AND PREVENT SETTLING

— PREPARED SUBGRADE

6'-0"

> 3 TREE PIT 1" = 1'

> > С

## PELBANO PLAYGROUND

## 8101 BUSTLETON AVENUE

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## PLANTING DETAILS

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Project No.:	2224



 — 3-4" THICK ORGANIC MULCH


CIP CONCRETE PAVING, SEE 1/L830

- AGGREGATE BASE

— PLANTING SOIL, SEE L540

- COMPACTED BASE TO SUPPORT ROOTBALL AND PREVENT SETTLING

— COMPACTED SUBGRADE

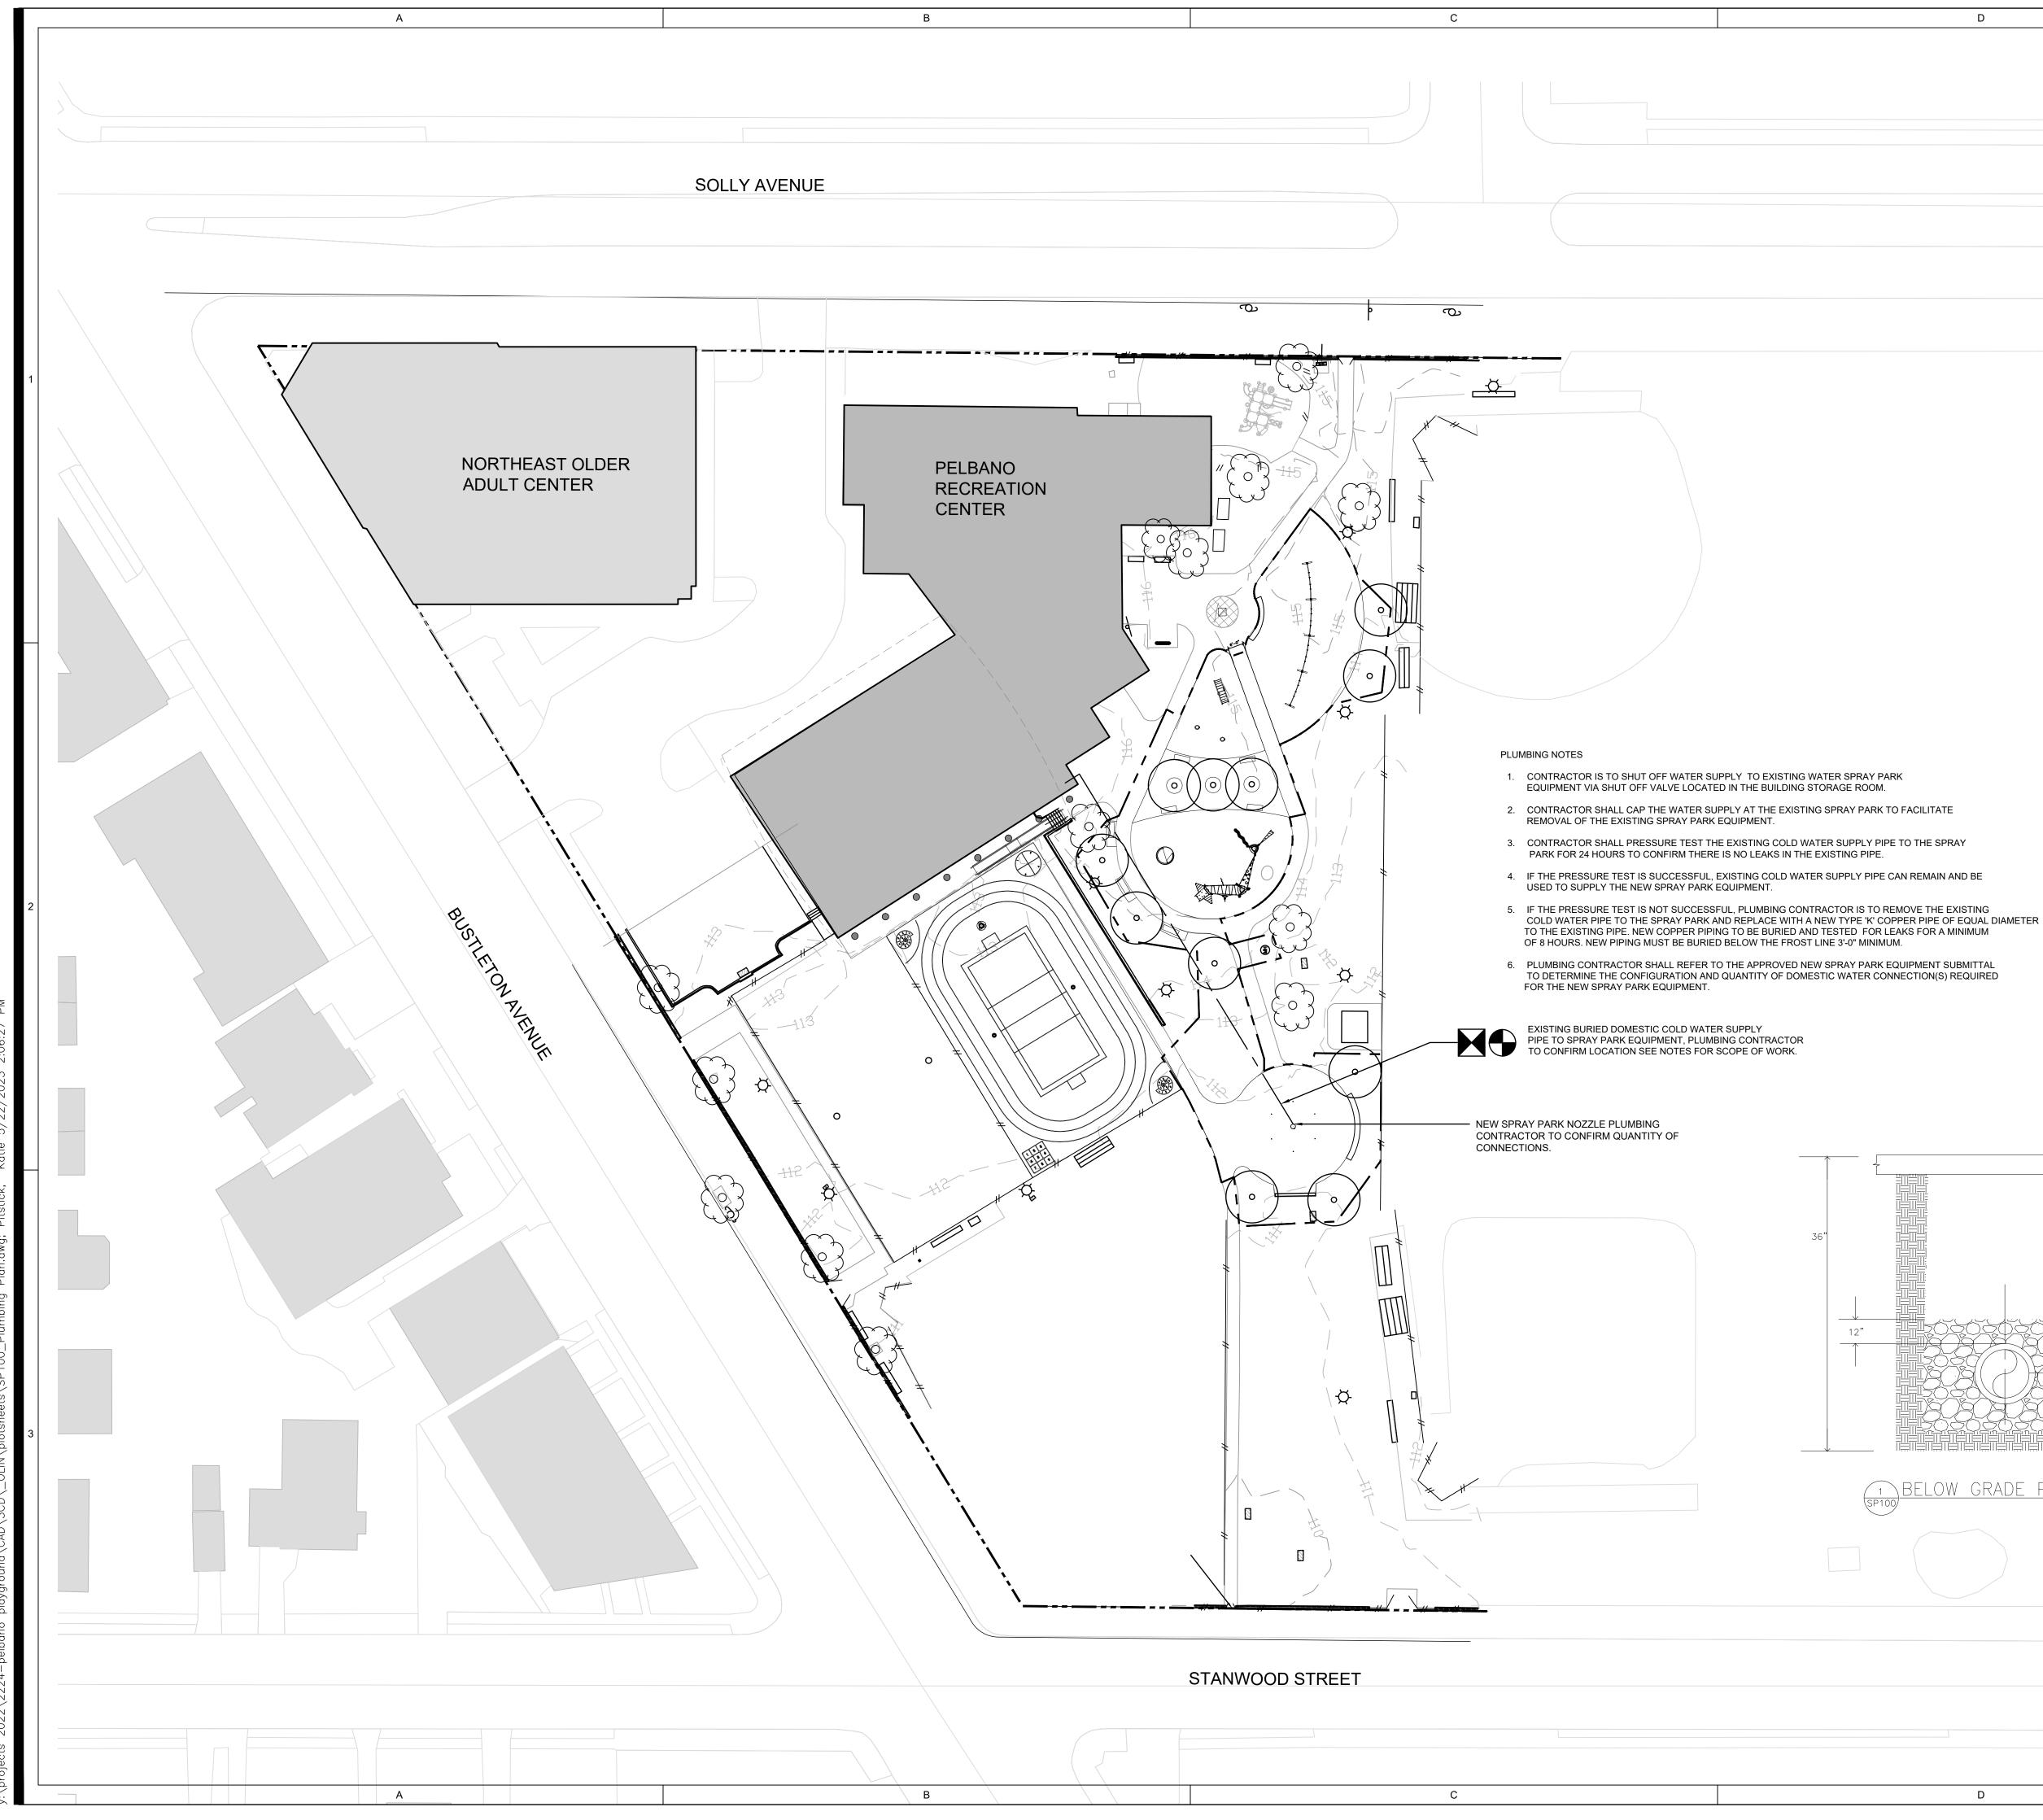

### 8101 BUSTLETON AVENUE

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### Plumbing Plan

1"=30'
5/31/2023
WJB
UJ
2224



D

— SURFACE -12" BANK RUN GRAVEL - FILL MATERIAL TO BE COMPACTED IN 12"LIFTS MAX - SELECT FILL SHALL BE THOROUGHLY COMPACTED - DOMESTIC COLD WATER PIPE

BELOW GRADE PIPE DETAIL

 $(\mathbf{N})$ SCALE: 1" = 30'-0"