

Addendum No. 02

Date: March 6, 2024

Project: Nicetown Park Renovations

GR Project No. 2009.05

ANSWERS TO QUESTIONS/RFIS:

See attached answers to the questions/RFIs submitted

SPECIFICATIONS

00411 Bid Proposal Form Added Allowance No. 2 PPR Signage: \$30,000.

Added Add Alternate 1 Furnish and Install Stage Canopy

012100 Allowances Removed 2.5% Allowance for Permit Fits for Electrical Bids to match Bid

Proposal Form which shows 2% for Permit and License fees.

012100 Allowances Added \$30,000 for PPR Signage

DRAWINGS

C-1.0 Existing Conditions Plan

Updated existing tree removals to match L-1.0

C-1.1 Drainage & Utility Plan

- Updated 196' segment of 12" HDPE storm pipe to a 100' 12" pipe segment and a 96 LF 15" pipe segment for required pipe capacity
- Updated sanitary sewer connection to 4" to match plumbing drawings
- Updated domestic service size and material to 1.5" copper to match plumbing drawings
- Removed floating callout for 120' of 12" pipe from old version of design

C-2.1 Stormwater Management Plan

- Updated 196' segment of 12" HDPE storm pipe to a 100' 12" pipe segment and a 96 LF
 15" pipe segment for required pipe capacity
- Removed floating callout for 120' of 12" pipe from old version of design

C-5.2 Construction Details

• Updated details for Outlet Control Structure

C-5.3 Construction Details

Updated notes for Stormwater Management Module detail, removed extraneous table

Reconsidered Ground

E-5.0

- Modified detail 2 to revise the electrical service feeder from 300A to 400A
 - o Modified Panel PP1 to 400A
 - o Modified electrical conductors from utility pole to Panel PP1

Sheet E-6.0

- Revised the panel schedule of Panel PP1 from 300A to 400A (both Bus and Main Amps)
- ➤ Bidders must acknowledge receipt of Addendum No. 2. The signed acknowledgement must be included in your bid proposal. Please sign below:

Acknowledgement of Addendum No. 2



Memorandum No. 01

Date: March 1, 2024

Project: Nicetown Park Renovations

GR Project No. 2009.05

To: Robert LaBrum, PHDC

From: Julie Bush, Ground Reconsidered

Distribution: Francesco Cerrai, PPR

Priyanka Malik, PPR

- 1. The tree removals on Sheet C-1.0 do not match watch is shown on Sheet L-1.0. Which sheet is correct?
 - Tree Removals shown on L-1.0 are correct.
- 2. Demolition Note 1 on Sheet L-1.0 says to excavate under demolished paving a minimum of 24 inches in proposed lawn areas. Detail 2/L-6.4 shows 10 inches of topsoil/compost in lawn areas. Are we to include 24 inches or 10 inches in our bid?
 - a. Include 24" where existing paving will be demolished. The intent is to decompact the soil in these locations. Include 10" in areas that currently have planting.
- 3. Does detail 3/L-6.4 only apply to the 2 perennial beds at St. Paul Street and Germantown Avenue? If not, can a soil plan be provided showing where the different depths of soil are to be placed?
 - a. Yes, detail 3/L6.4 only applies to the 2-plant beds at the Germantown entry.
- 4. Suppliers and PECO do not have a 300 Amp, three phase meter or meter socket. Technical Specifications do not have a section for metering. Can you provide a manu. And model number for this meter socket?
 - a. Drawings shall be updated to include 500kcmil from pole to meter. Panel and meter shall be updated to 400A. See revised drawings.
- 5. Is a CT Cabinet required for the service? Will the new 300A panel fit into the electrical shack or will it be mounted on the exterior? We could not access the shack at the pre-bid.
 - a. CT's shall fit within new panelboard and shall be mounted within shack interior.
- 6. Is this project tax exempt?
 - a. No. The Contractor purchasing the materials will be required to pay taxes on them.
- There is a label for 12" pipe and an arrow pointing to nothing. Assuming this was part of an old design and they
 missed deleting this note. Please confirm that this 120' of pipe is not in the job. (attachment)
 - a. The 120' segment of 12" pipe is no longer included in the design.
- 8. Storm Plans call for 24" RCP outflow pipe from the control structure. The Utility connection table calls for this to be 15" CIP. I am leaning towards the 24" since the control structure detail calls for a 24" HDPE outflow pipe (Street connections cannot be HDPE so I know that is out). It looks like we are tying into a 72" Brick Sewer, so both options would work. Please confirm size.
 - a. Please use the 24" RCP outflow pipe from the control structure.

Reconsidered Ground

- 9. Sanitary Civil plans call for a 5" CIP connection. Plumbing drawings call for 4" pipe. Assuming 5" as it is more detailed. Please confirm.
 - a. There are two (2) water closets, two (2) lavatories and two (2) emergency floor drains, for a total of 10 DFU. A 4" CI pipe will meet the plumbing code requirements. (Reference Table P-709.1 for fixture units and Table 710 for fixture DFU on a drainpipe, new installation).
- 10. Water Civils show 1" Ductile (which doesn't exist) assuming they meant 1" Copper. Plumbing shows 1-1/2" Water. Details show a meter pit with a 6" DIP connection. 1. Please confirm we are using 1" Copper and associated meter pit.
 - a. Copper Type K for underground is the correct material for plumbing. The GPM is increased due to the addition of lavatories in the proposed pre-fabricated building. Domestic water pipe to be 1-1/2".
- 11. Can you provide a pole base detail for the new walkway poles and fixtures?
 - a. Refer to Detail 6/L6.2

END OF MEMORANDUM cc: Project File

SECTION 00411 BID PROPOSAL FORM

PHILADELPHIA REDEVLOPMENT AUTHORITY

NICETOWN PARK RENOVATIONS 4301 GERMANTOWN AVENUE, PHILADELPHIA, PA 19140

FIRM NAME	
FIRM ADDRESS	
FEDERAL EIN	
PHILADELPHIA BUSINESS TAX ID	
TOTAL BASE BID (Base Bid Plus Allowances)	

To the Philadelphia Redevelopment Authority:

I, the undersigned Bidder, hereby propose to furnish all the labor, materials and equipment, perform the whole of the work, and submit to all conditions, as represented, intended and implied, both particularly and generally, by the Plans, Special Specifications, Standard Specifications, Standard Details, Standard Contract Requirements, Form of Agreement, the Ordinance authorizing the work and this bid at the prices herein stated, and agrees that each item bid shall be complete in itself, and the Philadelphia Redevelopment Authority may increase or diminish the amount of work thereunder, or omit the item without invalidating the unit price bid for it or any other item, on the following terms to wit:

base bid amount for payment of Permit fees to all regulatory agencies. Refer to Allowances,

ALLOWANCE AMOUNT _____

(2) ALLOWANCE No. 2 PPR Signage

Section 012100 for more details.

ALLOWANCE AMOUNT \$30,000

TOTAL BASE BID (Base Bid plus Allowance(s)).

ALTERNATES

ADD ALTERNATE No. 1 Furnish and Install Stage Canopy
ADD ALTERNATE No. 1 AMOUNT
DEDECOMANCE OF THE WORK BY CONTRACTOR.

B. PERFORMANCE OF THE WORK BY CONTRACTOR:

I, the undersigned Contracting Bidder, am required to perform work on the site with its own workforce equal to at least twenty percent (20%) of the original total contract price exclusive of profit, overhead and the costs of procuring insurance and bonds. I, the undersigned Contracting Bidder, shall submit with its bid a complete description of the work that will be performed (e.g., earthwork, paving, brickwork, roofing, etc.), the percentage of the total contract this work represents, and the estimated dollar value thereof.

I shall perform the following work:								
Percentage of the total contract to be performed by Contracting Bidder:								
Estimated cost of work to be performed by Contracting Bidder: \$								

C. COMPLETION

I will substantially complete the Work, ready for final payment, in accordance with the Contract Documents within 150 consecutive calendar days counting from the date stated in the Notice to Proceed.

D. ADDENDA

Bidder must attach Addendum Acknowledgement sheets for all Addenda, if applicable.

EXECUTION OF CONTRACT

This contract consists of the Standard Contract Requirements; the Department's Standard Details and Specifications, as they apply; the Department's General Bidding and Contract Requirements; the Technical Specifications; the Bid; the Plans with all of the notes thereon (excluding any records or reports of test borings, underground structures, and test piles); any additional exhibits or attachments to any of the foregoing; and any addenda thereto issued by the City (collectively, the "Contract").

NOTE: ANY CONTRACT THAT IS NOT EXECUTED IN ACCORDANCE WITH THE INSTRUCTIONS PROVIDED BELOW, MAY, IN THE SOLE DISCRETION OF THE PHILADELPHIA REDEVELOPMENT AUTHORITY, BE REJECTED.

SIGNING OF CONTRACT If Contractor is an INDIVIDUAL or a PARTNERSHIP, date and sign the Contract here, with original signatures, in ink. This day of 2024 (Signature of Owner, Partner) (Type or Print Name and Title) (Business Name of Bidder) If Contractor is a CORPORATION, date and sign the Contract here with original signatures, in ink, by (a) President or Vice-President of the corporation AND (b) Secretary, Assistant Secretary, Treasurer or Assistant Treasurer of the corporation; and (c) affix the seal of the corporation. If the Contract is not signed by the President or Vice-President; and Secretary, Assistant Secretary; Treasurer or Assistant Treasurer, attach a duly certified corporate resolution authorizing the person signing in place of such officers to execute this Contract for the corporation. This_____day of _____ 2024 (Corporate or Business Name of Bidder) CORPORATE SEAL (Address, Including Zip Code) (Telephone Number) (Signature of President or Vice President) (Signature of Secretary, Asst. Secretary, Treasurer or Assistant Treasurer

(Type or Print Name and Title)

(Type or Print Name and Title)

SECTION 01 21 00 ALLOWANCES

PART 1 GENERAL

1.1 DESCRIPTION OF WORK

A. This Section specifies each Prime Contractor's administrative and procedural requirements governing handling and processing allowances

1.2 RELATED WORK SPECIFIED ELSEWHERE

- A. Applicable provisions of Bidding Requirements, Contract Requirements in Division 0 and all applicable Division 1 sections.
- B. Each section of the specifications including an allowance.

1.3 COORDINATION

- A. Designate required selection and delivery dates for products under each allowance in the Contractor's Construction Schedule.
- B. Designate each allowance with extensions based on estimated quantities for unit price allowances on Contractor's Schedule of Values.

1.4 DEFINITIONS

A. Refer to Section 007200 Standard Contract Requirements.

1.5 ALLOWANCES

- A. Include in Total Base Bid Amount, an amount equal to Two Percent (2%) of the base bid amount for payment of permit fees. For Electrical Bids include in Total Base Bid Amount, an amount equal to Two and One Half Percent (2.5%). This is a direct cost; no mark-ups will be permitted.
- B. PPR Signage: \$30,000
- C. Amount of each allowance (excluding 1.5.A above) shall include:
 - 1. Net cost of product.
 - 2. Delivery to site.
 - 3. Applicable taxes.
 - 4. Preparing submittals.
- D. In addition to amounts of allowances (excluding 1.5.A above), include in the base bid amount, the Contractor's cost for:
 - 1. Assisting in selection and obtaining proposals from suppliers and subcontractors.
 - 2. Processing submittals.
 - 3. Handling at site, including unloading, uncrating and storage.
 - 4. Protection from elements and from damage.
 - 5. Labor, installation and finishing.

- 6. Other expenses required to complete installation.
- 7. Overhead and profit.

1.6 SELECTION OF PRODUCTS

- A. Design Professional shall issue by Change Order a full specification for the final selected product.
- B. Contractor's Duties
 - 1. Notify Design Professional of deadlines for specification of final products, allowing for Contractor's required submissions as required to meet Date of Completion.
 - 2. Provide cost proposals for products being considered when requested by Design Professional.
 - 3. Notify Design Professional of any effect anticipated by selection of product or supplier under consideration as it relates to:
 - a. Construction Schedule.
 - b. Contract Sum.
 - c. On notification of selection, enter into purchase agreement with designated supplier.

1.7 INSTALLATION


A. Comply with requirements of applicable specification section, including warranties/guarantees.

1.8 ADJUSTMENT OF COSTS

- A. Should actual purchase cost be more or less than specified amount of allowance,
 Contract Sum shall be adjusted by Change Order equal to amount of difference.
 A percentage to cover Contractor's overhead and profit, as stated in Standard
 Contract Requirements, will be applied to difference in cost.
- B. For products specified under unit cost allowance unit cost applies to quantity required to complete the Work as determined by the Contractor.
 - 1. Submit invoices or other data to substantiate quantity actually used.
- C. Submit request for other costs, claimed for additional work caused by increase over amount of allowance, prior to required submission for product.

PART 2 PRODUCTS Not Used


PART 3 EXECUTION Not Used

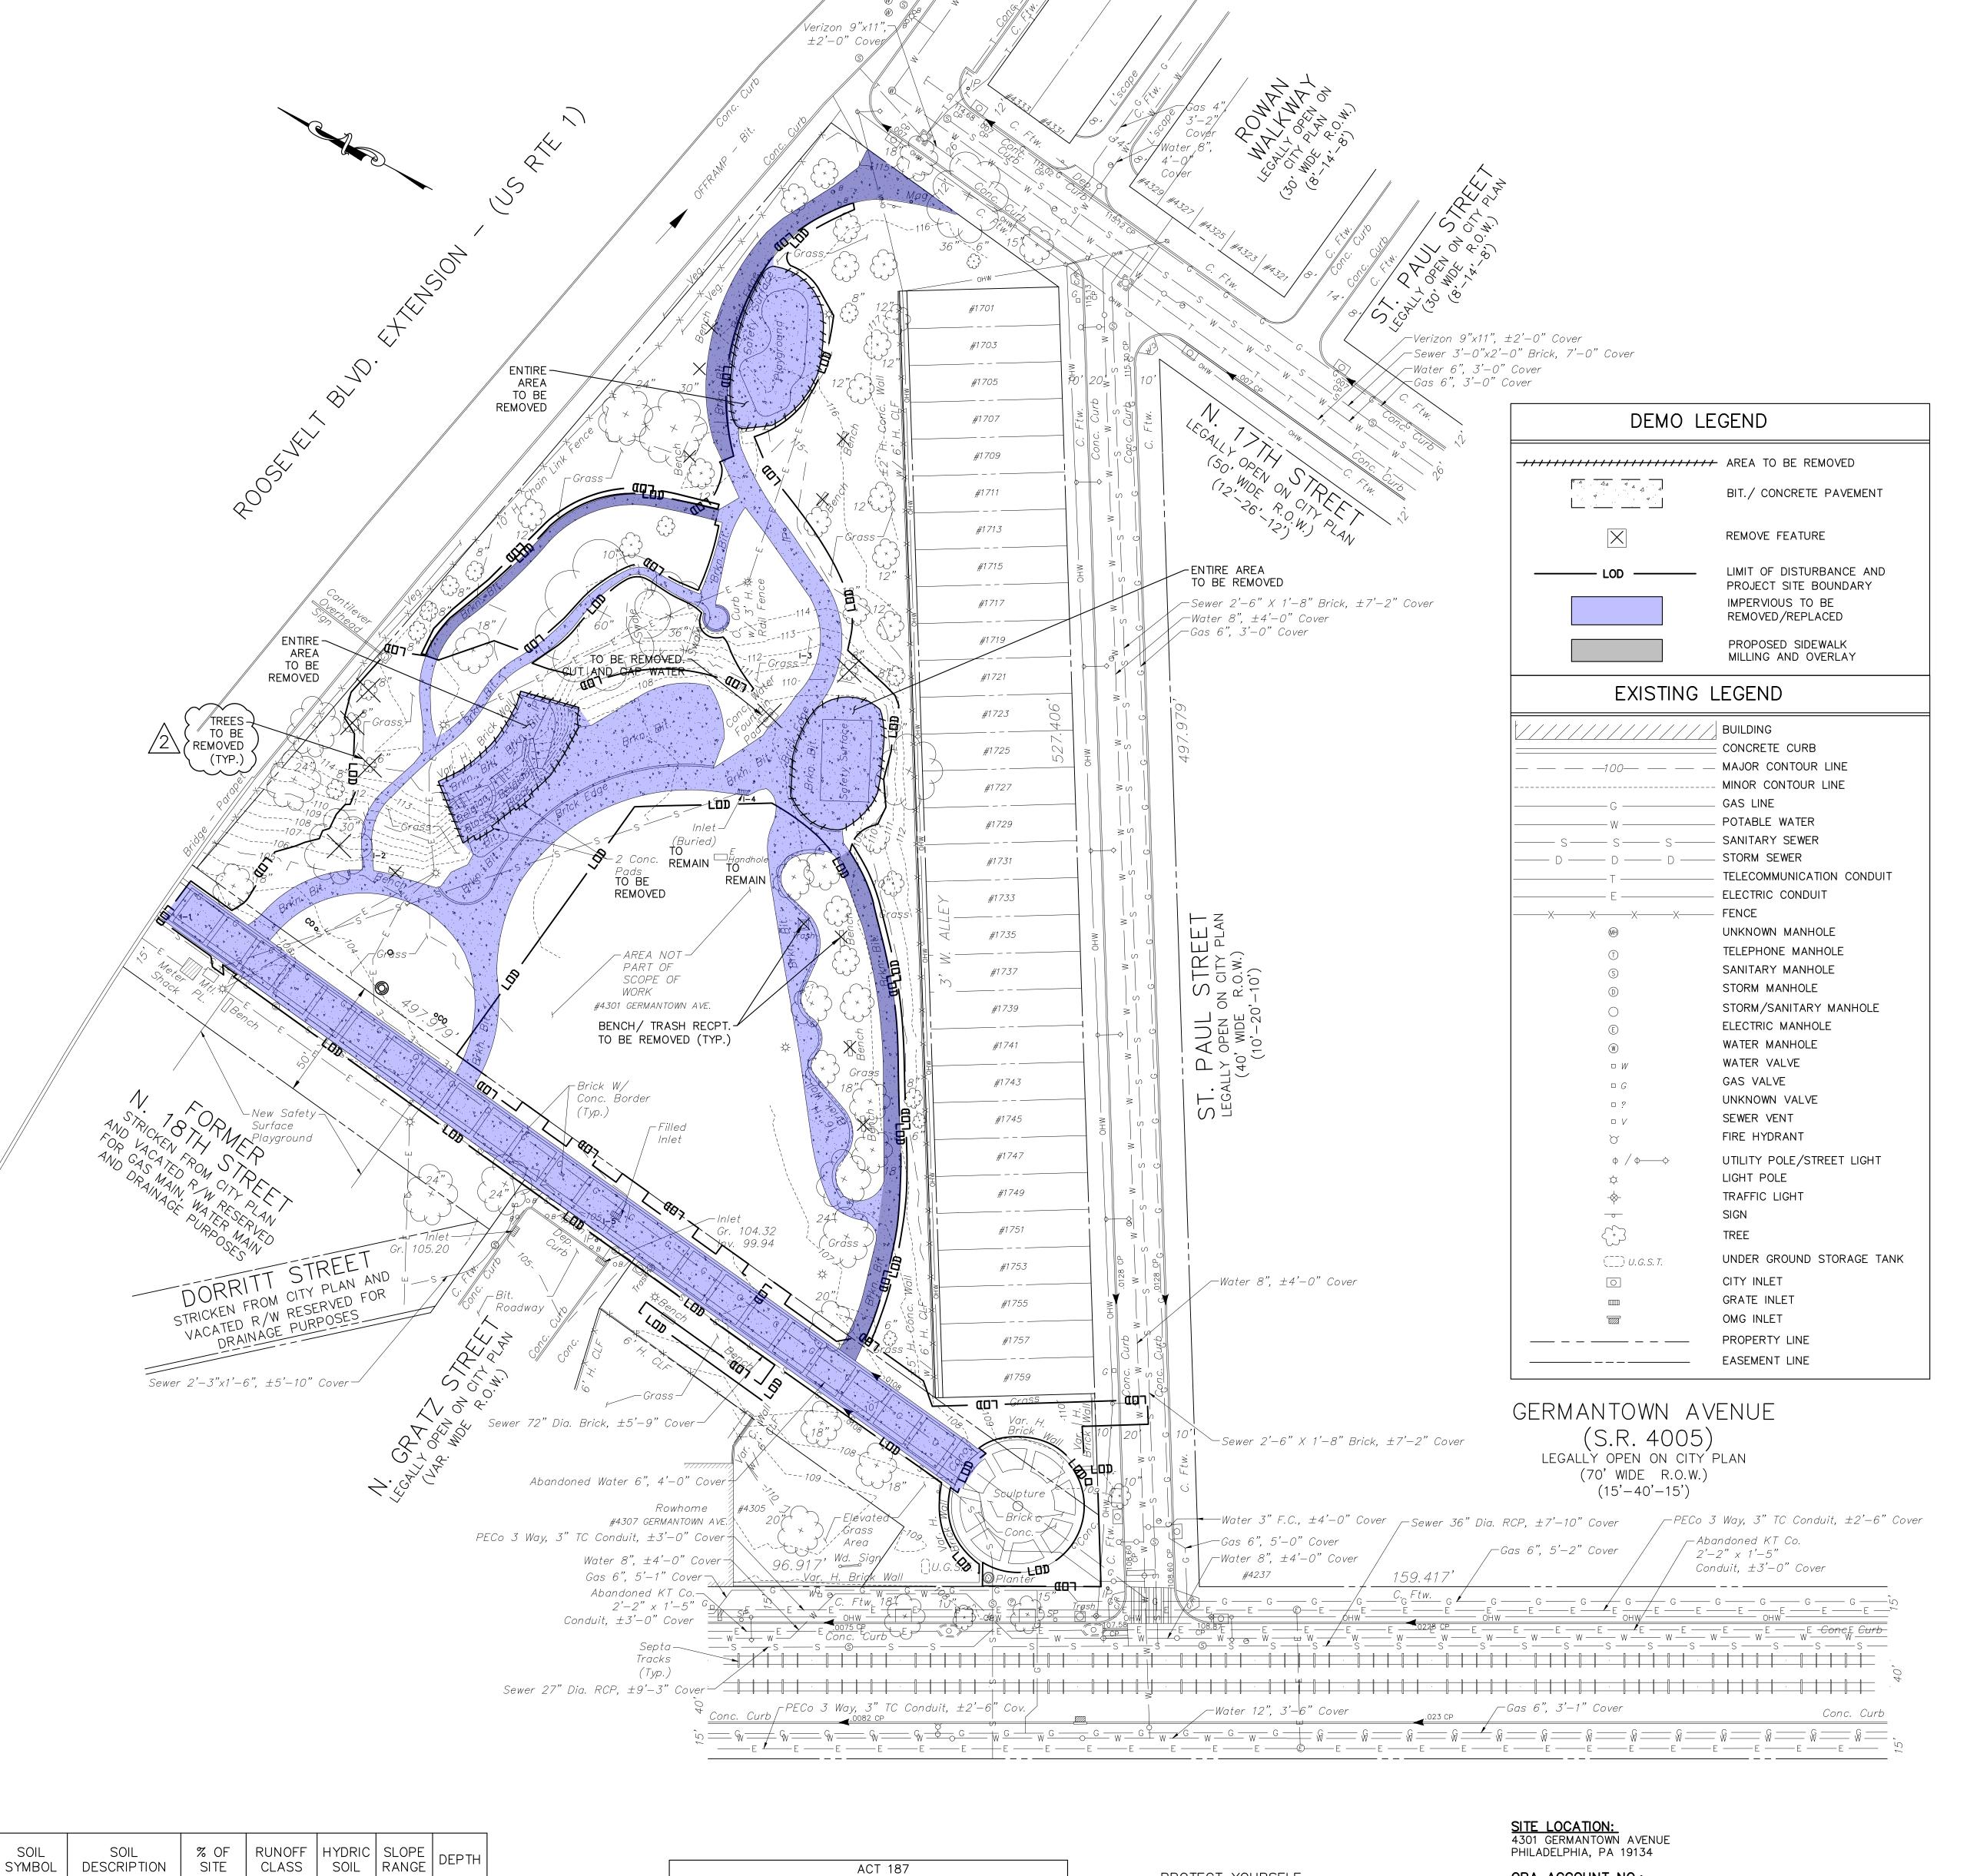


301L 301L	/0 Oi i	INDINOLL			
SYMBOL DESCRIPTION	SITE	CLASS	SOIL	RANGE	DEPTH
Ub URBAN-LAND	100.00%	VERY HIGH	NO	0-8%	0"-10"
LIMIT OF DISTURE	BANCE (L	_OD) :	SUMMA	ARY T	ABLE
TOTAL SITE AREA	96,462	S.F.	2.	.21 ACRI	ES
LOD ON SITE	41,737	S.F.	0.9	958 ACF	RES
LOD IN R.O.W.	213 S	S.F.	0.0	005 ACF	RES
·	44.050	S.F.	0.0	963 ACR	



OPA ACCOUNT NO.: 132257005 PROPERTY OWNER: CITY OF PHILADELPHIA PROPERTY OWNER ADDRESS: NICETOWN PARK 1401 JOHN F. KENNEDY BLVD PHILADELPHIA, PA 19102-1617 APPLICANT GROUND RECONSIDERED **ZONING** SPPOA-RECREATION **WARD** #13

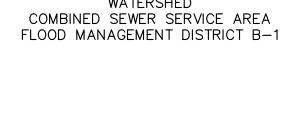

VICINITY MAP 1" = 2000'TOOKANY/TACONY-FRANKFORD CREEK

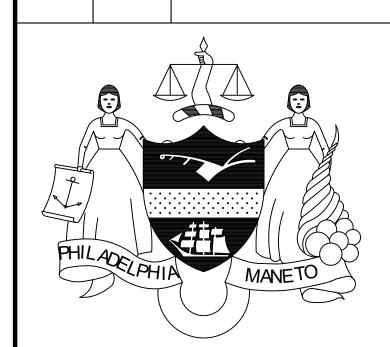

RICHARD STARR BURRELL, JR., P.E

REVISIONS

ADDENDUM 2

REVISED PER PWD PCSM REVIEW COMME

02.09.2024

03.01.2024

PROJECT COORDINATOR Philadelphia Parks & Recreation and Department of Public Property 1515 Arch Street, 11th Floor

Philadelphia, PA 19102

GENERAL NOTES:

- 1. EXISTING TOPOGRAPHY AND OTHER SURFACE INFORMATION BASED ON FIELD SURVEY CONDUCTED BY KS ENGINEERS IN OCTOBER 2021. VERTICAL DATUM: PHILADELPHIA CITY DATUM. CONTROLLING BENCHMARK HYDRANT RIM LOCATED ON THE NORTHEAST CORNER OF DALKEITH ST. AND GERMANTOWN AVE. ELEV. =
- 2. MERIDIANS AND BEARINGS ARE REFERENCED TO CITY PLAN NO. 171 DATED MARCH 31ST, 1971. LOT BEARINGS AND DISTANCES ARE SHOWN IN PHILADELPHIA DISTRICT STANDARD (D.S.). ALL OTHER DIMENSIONS ARE SHOWN IN U.S. SURVEY FEET.
- 3. SUBJECT TO ALL RESTRICTIONS, EASEMENTS AND/OR COVENANTS OF RECORD EITHER WRITTEN OR IMPLIED THAT MAY NOT APPEAR ON THIS PLAN.
- 4. IF BUILDINGS ARE ON THIS PLAN. BUILDING OFFSET DISTANCES SHOWN ARE FOR THE PURPOSE OF CHECKING COMPLIANCE WITH ZONING AND DEED RESTRICTIONS ONLY. NO LIABILITY WILL BE ACCEPTED IF THESE DISTANCES ARE USED FOR ANY OTHER PURPOSES.
- 5. UNDERGROUND UTILITIES AS SHOWN HEREON, GAS ELECTRIC, TELEPHONE AND WATER ALIGNMENTS ARE BASED ON A "BEST FIT" OF UTILITY PLANS PROVIDED BY UTILITY COMPANIES AND SURVEYED LOCATIONS OF EXISTING HARDWARE FEATURES SUCH AS VALVES AND MANHOLES.
- 6. THE ACCURACY REGARDING LOCATION AND DEPTH OF ALL UTILITIES CANNOT BE GUARANTEED PRIOR TO ANY DIGGING, DRILLING, TRENCHING OR OTHER EARTHMOVING ACTIVITIES. THE CONTRACTOR SHALL VERIFY DIMENSIONS AND EXISTING CONDITIONS AT THE SITE. FOR INFORMATION REGARDING UTILITIES CONTACT PENNSYLVANIA ONE CALL 1-800-242-1776.
- 7. INFORMATION PERTAINING TO LOTS OTHER THAN THE SUBJECT PARCEL IS SHOWN FOR INFORMATIONAL PURPOSES ONLY.
- 8. THIS SITE IS LOCATED WITHIN THE SPECIAL PURPOSE PARKS AND OPEN SPACE ACTIVE (SP-PO-A) ZONING DISTRICT.

LANDSCAPE ARCHITECT: Ground Reconsidered

SPACE FOR CONSULTANT RECOGNITION

CIVIL ENGINEERS: KS Engineers, P.C. 530 Walnut Street, Suite 460 Philadelphia, PA 19106

203 S. Broad Street

www.kseng.com

Philadelphia PA 19102 www.groundreconsidered.com

ELECTRICAL and PLUMBING ENGINEERS: Arora Engineering, Inc.

61 Wilmington-West Chester Pike, Chadds Ford, PA 19317 www.AroraEngineers.com

STRUCTURAL ENGINEERS: David Mason and Associates 123 S. Broad Street, Suite 1130 Philadelphia, PA 19109 www.DavidMason.com

PWD TRACKING No. FY22-NICE-6841-01

DEPARTMENT OF PUBLIC PROPERTY


CITY OF PHILADELPHIA


1515 ARCH STREET 11TH FLOOR, ONE PARKWAY BUILDING PHILADELPHIA, PENNSYLVANIA


NICETOWN PARK 4301 GERMANTOWN AVENUE PHILADELPHIA, PA 19134

EXISTING CONDITIONS PLAN

KSE PROJE	CT NO	DRAWING NO.
KSE PROJE	2471-02	DRAWING NO.
DATE	01.19.2024	C-1.0
SCALE	1" = 30'-0"	C-1.0
DRAWN BY	KSE]
CHECKED B	Y RSB	
NOTE:	ALL DIMENSIONS AND CONDITIONS SHALL BE VERIFIED BY THE CONTRACTOR AT THE SITE BEFORE PROCEEDING WITH THE WORK.	

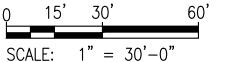

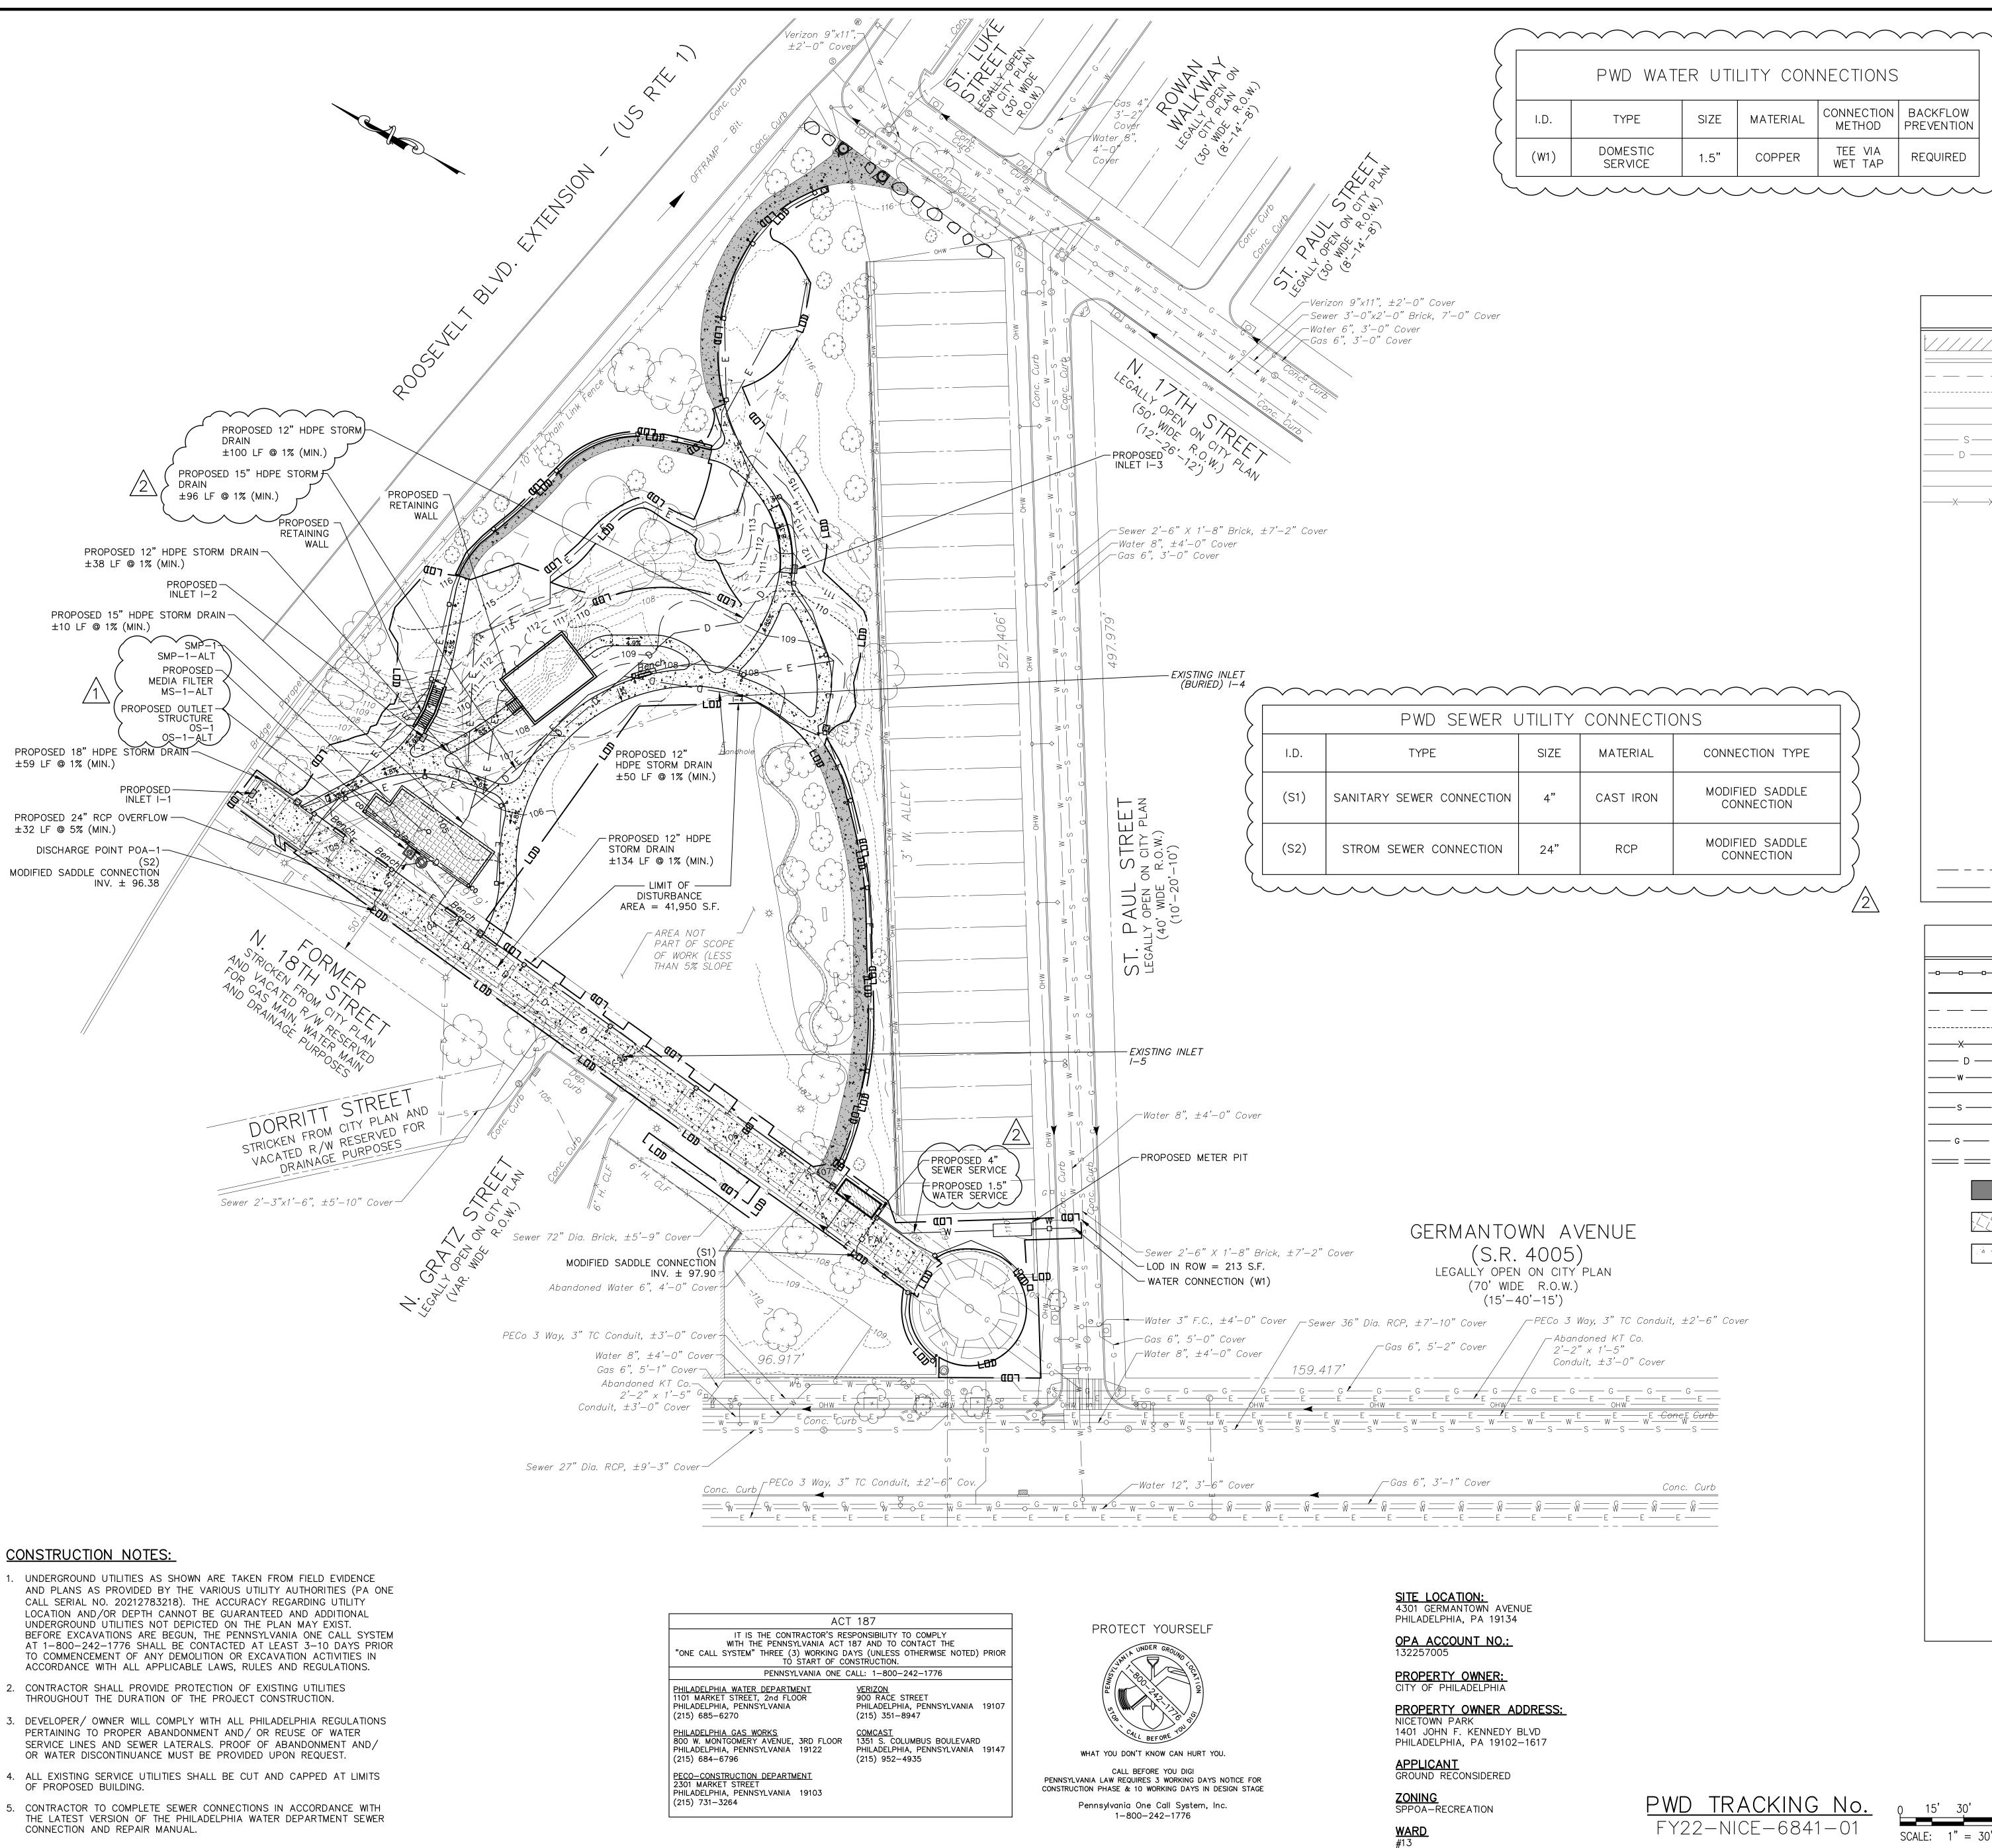

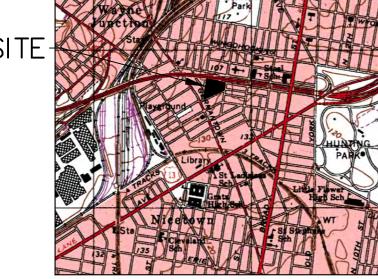


VICINITY MAP 1" = 1000'TOOKANY-TACONY/ FRANKFORD CREÉK WATERSHED

EXISTING L	EGEND
	CONCRETE CURB MAJOR CONTOUR LINE MINOR CONTOUR LINE GAS LINE POTABLE WATER SANITARY SEWER STORM SEWER TELECOMMUNICATION CONDUIT ELECTRIC CONDUIT
① ① ② ② ② ② ② ② ② ② ② ② ② ② ② ② ② ② ② ②	STORM MANHOLE STORM/SANITARY MANHOLE ELECTRIC MANHOLE WATER MANHOLE WATER VALVE GAS VALVE UNKNOWN VALVE SEWER VENT FIRE HYDRANT
	UTILITY POLE/STREET LIGHT LIGHT POLE TRAFFIC LIGHT SIGN TREE UNDER GROUND STORAGE TANK CITY INLET GRATE INLET
	OMG INLET PROPERTY LINE EASEMENT LINE

PROPOSED	LEGEND
0 0 0 0 0 0	— GUIDE RAIL
LOD	— LIMIT OF DISTURBANCE
_	— MAJOR CONTOUR LINE
	MINOR CONTOUR LINE
XXX	— PROPOSED FENCE
D D D	— PROPOSED STORM SEWER LINE
wwwww	
	— PROPOSED FIRE SERVICE LINE — PROPOSED SANITARY SEWER LINE
	— PROPOSED SANITARY SEWER LINE — PROPOSED ELECTRICAL CONDUIT
G G G G	
: : :	
	PROPOSED SIDEWALK MILLING AND OVERLAY
	PROPOSED SUBSURFACE STORMWATER MANAGEMENT
	BITUMINOUS PAVEMENT
○ MH−1	PROPOSED MANHOLE
0	PROPOSED CLEANOUT
□□□□□ I−1	PROPOSED HIGHWAY GRATE INLET
W/W YD-1	PROPOSED YARD DRAIN
TD-1	PROPOSED TRENCH DRAIN
	PROPOSED OUTLET STRUCTURE
←	PROPOSED FLOW ARROW
← □	PROPOSED LIGHT POLE
<u> </u>	PROPOSED BOLLARD
	PROPOSED TABLE
<u>Bench</u>	PROPOSED BENCH
	PROPOSED PORTLAND LOO (BATHROOM)
0	PROPOSED TRASH RECEPTACLE
(+)	PROPOSED TREE
⊕	PROPOSED SHRUB

SCALE: 1" = 30' - 0"

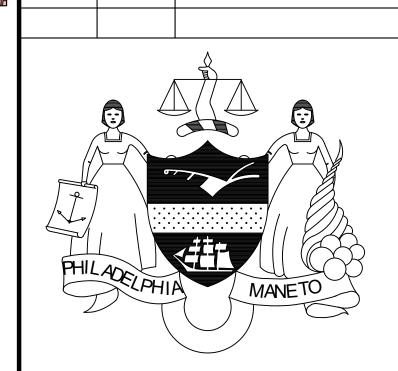


REVISIONS

REVISED PER PWD PCSM REVIEW COMME

02.09.2024

03.01.2024

PROJECT COORDINATOR Philadelphia Parks & Recreation and Department of Public Property 1515 Arch Street, 11th Floor Philadelphia, PA 19102

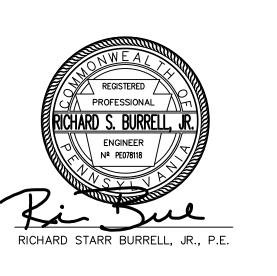

SPACE FOR CONSULTANT RECOGNITION

LANDSCAPE ARCHITECT: Ground Reconsidered 203 S. Broad Street Philadelphia PA 19102 www.groundreconsidered.com

CIVIL ENGINEERS: KS Engineers, P.C. 530 Walnut Street, Suite 460 Philadelphia, PA 19106 www.kseng.com

Chadds Ford, PA 19317

www.DavidMason.com

ELECTRICAL and PLUMBING ENGINEERS: Arora Engineering, Inc. 61 Wilmington-West Chester Pike,

www.AroraEngineers.com STRUCTURAL ENGINEERS: David Mason and Associates 123 S. Broad Street, Suite 1130 Philadelphia, PA 19109


> CITY OF PHILADELPHIA DEPARTMENT OF PUBLIC PROPERTY

11TH FLOOR, ONE PARKWAY BUILDING PHILADELPHIA, PENNSYLVANIA

NICETOWN PARK 4301 GERMANTOWN AVENUE PHILADELPHIA, PA 19134


> DRAINAGE & **UTILITY PLAN**

KSE PROJE	CT NO.	DRAWING NO.
	2471-02	
DATE	01.19.2024	C-1 1
SCALE	1" = 30'-0"	C-1.1
DRAWN BY	KSE	
CHECKED I	RSB	
NOTE:	ALL DIMENSIONS AND CONDITIONS SHALL BE VERIFIED BY THE CONTRACTOR AT THE SITE BEFORE PROCEEDING WITH THE WORK.	

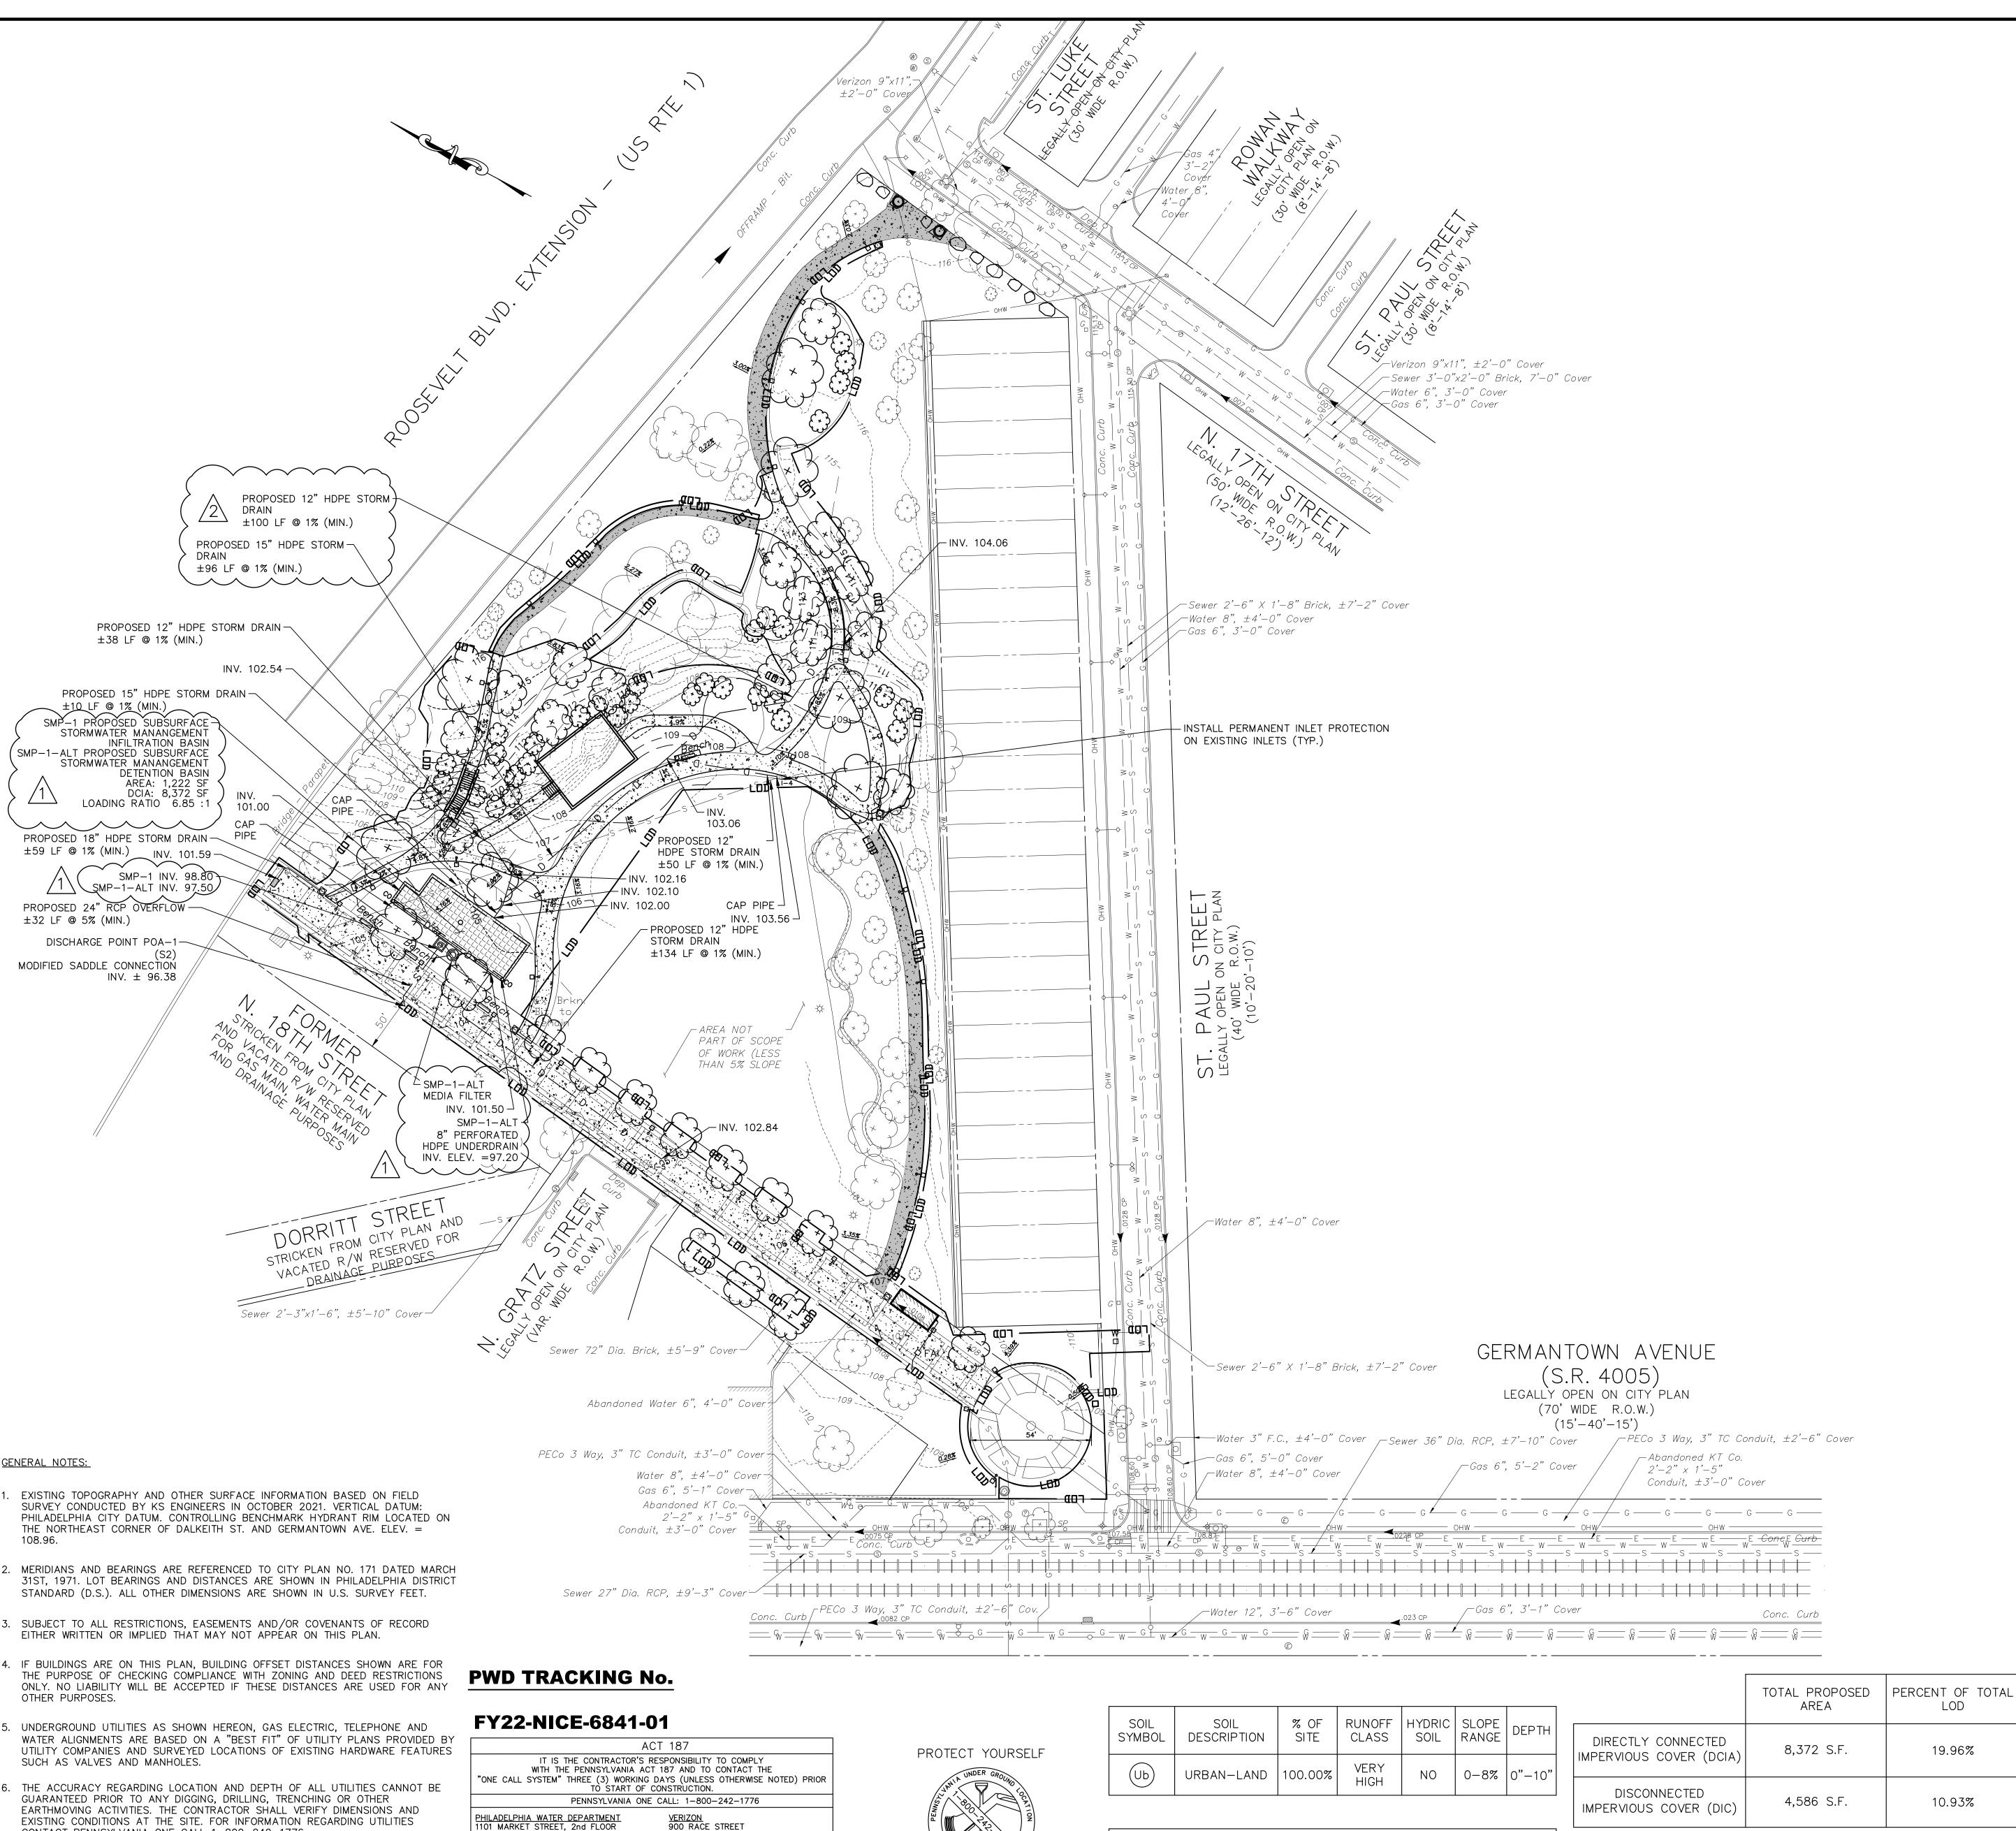

VICINITY MAP 1" = 1000'

TOOKANY/TACONY-FRANKFORD CREEK WATERSHED COMBINED SEWER SERVICE AREA FLOOD MANAGEMENT DISTRICT B-1

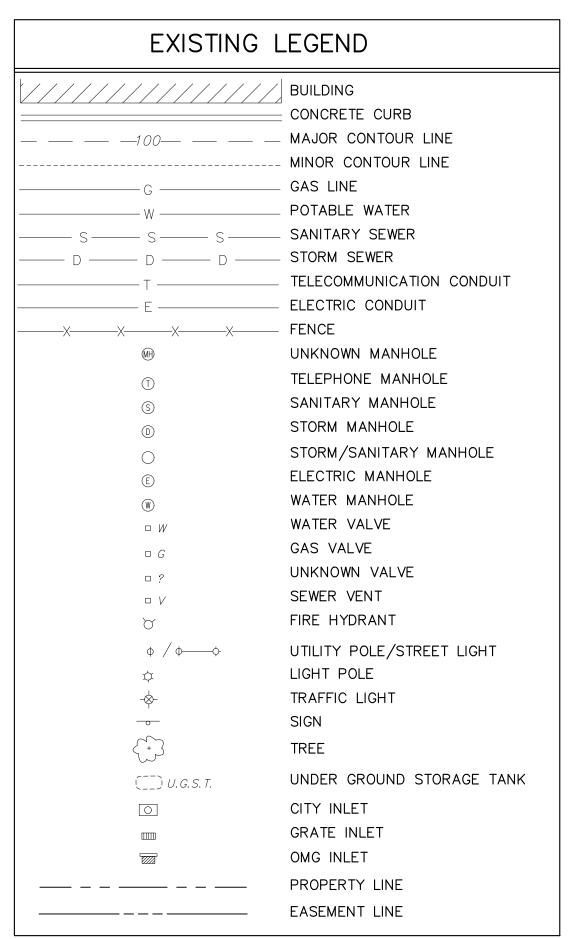

PROPOSEI) LEGEND
 0 0 0 0	GUIDE RAIL
— LOD —	LIMIT OF DISTURBANCE
 - - 100— — —	- MAJOR CONTOUR LINE
 	MINOR CONTOUR LINE
	PROPOSED STORM SEWER LINE
	PROPOSED WATER LINEPROPOSED FIRE SERVICE LINE
	— PROPOSED FIRE SERVICE LINE — PROPOSED SANITARY SEWER LINE
	PROPOSED GAS LINE
 = : :	= PROPOSED SWALE
	PROPOSED SIDEWALK MILLING AND OVERLAY
	PROPOSED SUBSURFACE STORMWATER MANAGEMENT
 Δ Δ Δ Δ	BITUMINOUS PAVEMENT
○ MH-1	PROPOSED MANHOLE
0	PROPOSED CLEANOUT
ⅢⅢ I−1	PROPOSED HIGHWAY GRATE INLET
YD-1	PROPOSED YARD DRAIN
TD-1	PROPOSED TRENCH DRAIN
	PROPOSED OUTLET STRUCTURE
←	PROPOSED FLOW ARROW
○ —□	PROPOSED LIGHT POLE
•BL	PROPOSED BOLLARD
	PROPOSED TABLE
Bench	PROPOSED BENCH
	PROPOSED PORTLAND LOO (BATHROOM)
O	PROPOSED TRASH RECEPTACLE
(+)	PROPOSED TREE

PROPOSED SHRUB



REVISIONS

02.09.2024

02.23.2024

03.01.2024

REVISED PER PWD PCSM REVIEW COMMENT

PROJECT COORDINATOR Philadelphia Parks & Recreation

and Department of Public Property 1515 Arch Street, 11th Floor Philadelphia, PA 19102



SPACE FOR CONSULTANT RECOGNITION

LANDSCAPE ARCHITECT: **Ground Reconsidered** 203 S. Broad Street Philadelphia PA 19102

www.groundreconsidered.com

www.kseng.com

CIVIL ENGINEERS: KS Engineers, P.C. 530 Walnut Street, Suite 460 Philadelphia, PA 19106

ELECTRICAL and PLUMBING ENGINEERS: Arora Engineering, Inc. 61 Wilmington-West Chester Pike,

Chadds Ford, PA 19317 www.AroraEngineers.com STRUCTURAL ENGINEERS:

David Mason and Associates 123 S. Broad Street, Suite 1130 Philadelphia, PA 19109 www.DavidMason.com

CITY OF PHILADELPHIA

DEPARTMENT OF PUBLIC PROPERTY

1515 ARCH STREET 11TH FLOOR, ONE PARKWAY BUILDING PHILADELPHIA, PENNSYLVANIA

ALL DIMENSIONS AND CONDITIONS SHALL BE VERIFIED BY THE CONTRACTOR AT THE SITE BEFORE PROCEEDING WITH THE WORK.

ROJECT TITLE NICETOWN PARK 4301 GERMANTOWN AVENUE PHILADELPHIA, PA 19134

STORMWATER MANAGEMENT PLAN

KSE PROJECT NO.	DRAWING NO.
2471-02	
DATE 01.19.2024	C-2.1
SCALE 1" = 30'-0"	
DRAWN BY KSE	
CHECKED BY RSB	

<u>VERIZON</u> 900 RACE STREET PHILADELPHIA, PENNSYLVANIA 19107 (215) 351-8947 COMCAST 1351 S. COLUMBUS BOULEVARD PHILADELPHIA, PENNSYLVANIA 19147 (215) 952-4935

PHILADELPHIA, PENNSYLVANIA

PECO-CONSTRUCTION DEPARTMENT 2301 MARKET STREET

PHILADELPHIA, PENNSYLVANIA 19103

PHILADELPHIA GAS WORKS 800 W. MONTGOMERY AVENUE, 3RD FLOOR PHILADELPHIA, PENNSYLVANIA 19122

(215) 685-6270

(215) 684-6796

(215) 731-3264

CONTACT PENNSYLVANIA ONE CALL 1-800-242-1776.

BRICK PAVER REPLACEMENT PORTION OF THE PROJECT.

FOR INFORMATIONAL PURPOSES ONLY.

ACTIVE (SP-PO-A) ZONING DISTRICT.

INFORMATION PERTAINING TO LOTS OTHER THAN THE SUBJECT PARCEL IS SHOWN

THIS SITE IS LOCATED WITHIN THE SPECIAL PURPOSE PARKS AND OPEN SPACE

. PAVEMENT SUBBASE WILL NOT BE EXPOSED DURING THE MILLING PROCESS OF THE


LIMIT OF DISTURBANCE (LOD) SUMMARY TABLE TOTAL SITE AREA 96,462 S.F. 2.21 ACRES WHAT YOU DON'T KNOW CAN HURT YOU. LOD ON SITE 41,737 S.F. 0.958 ACRES CALL BEFORE YOU DIG! PENNSYLVANIA LAW REQUIRES 3 WORKING DAYS NOTICE FOR CONSTRUCTION PHASE & 10 WORKING DAYS IN DESIGN STAGE LOD IN R.O.W. 213 S.F. 0.005 ACRES Pennsylvania One Call System, Inc. 41,950 S.F. 0.963 ACRES TOTAL LOD 1-800-242-1776

IMPERVIOUS COVER WITHIN LOD PRE DEVELOPMENT 20,982 S.F. 12,958 S.F. POST DEVELOPMENT IMPERVIOUS COVER REDUCTION 38.24%

15' 30' SCALE: 1" = 30' - 0"

كريها


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REVISED PER PWD PCSM REVIEW COMMENT ADDENDUM 1 ADDENDUM 2

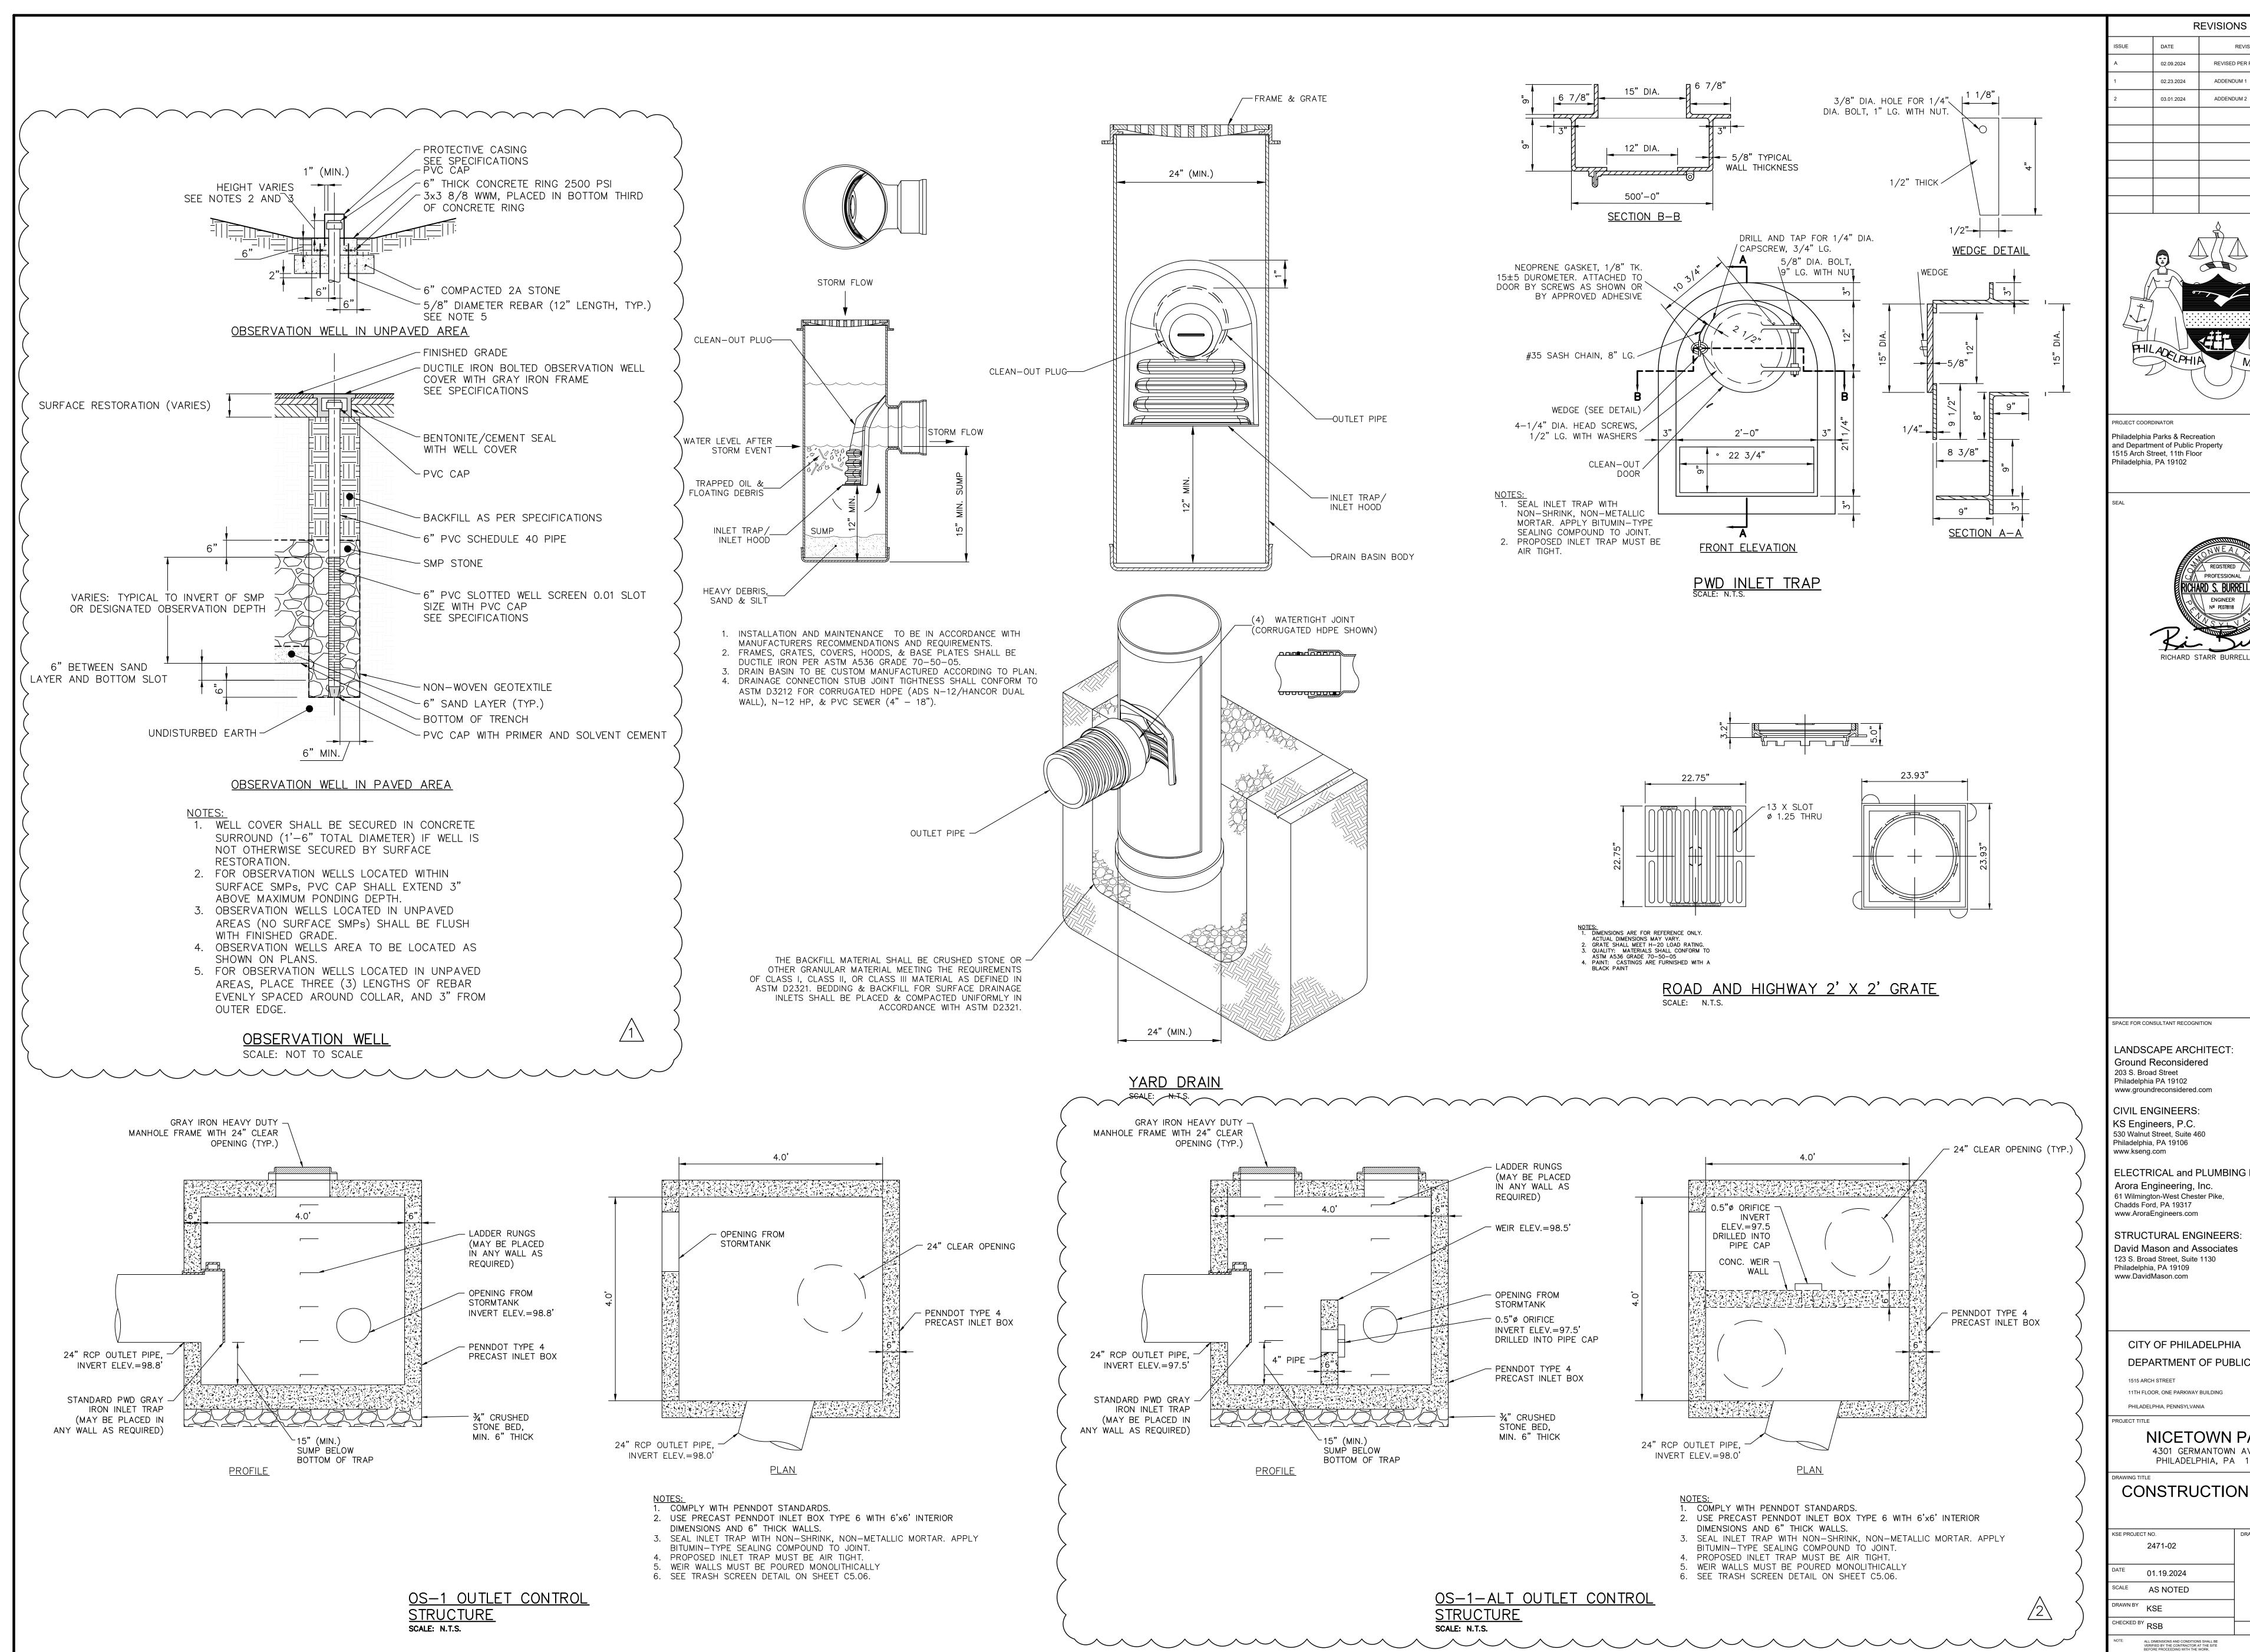

and Department of Public Property



LANDSCAPE ARCHITECT:

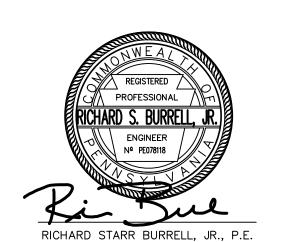ELECTRICAL and PLUMBING ENGINEERS:


STRUCTURAL ENGINEERS: David Mason and Associates 123 S. Broad Street, Suite 1130

> CITY OF PHILADELPHIA DEPARTMENT OF PUBLIC PROPERTY

NICETOWN PARK 4301 GERMANTOWN AVENUE PHILADELPHIA, PA 19134

CONSTRUCTION DETAILS

KSE PROJEC	T NO.	DRAWING NO.
	2471-02	
DATE	01.19.2024	C-5.2
SCALE	AS NOTED	
DRAWN BY	KSE	

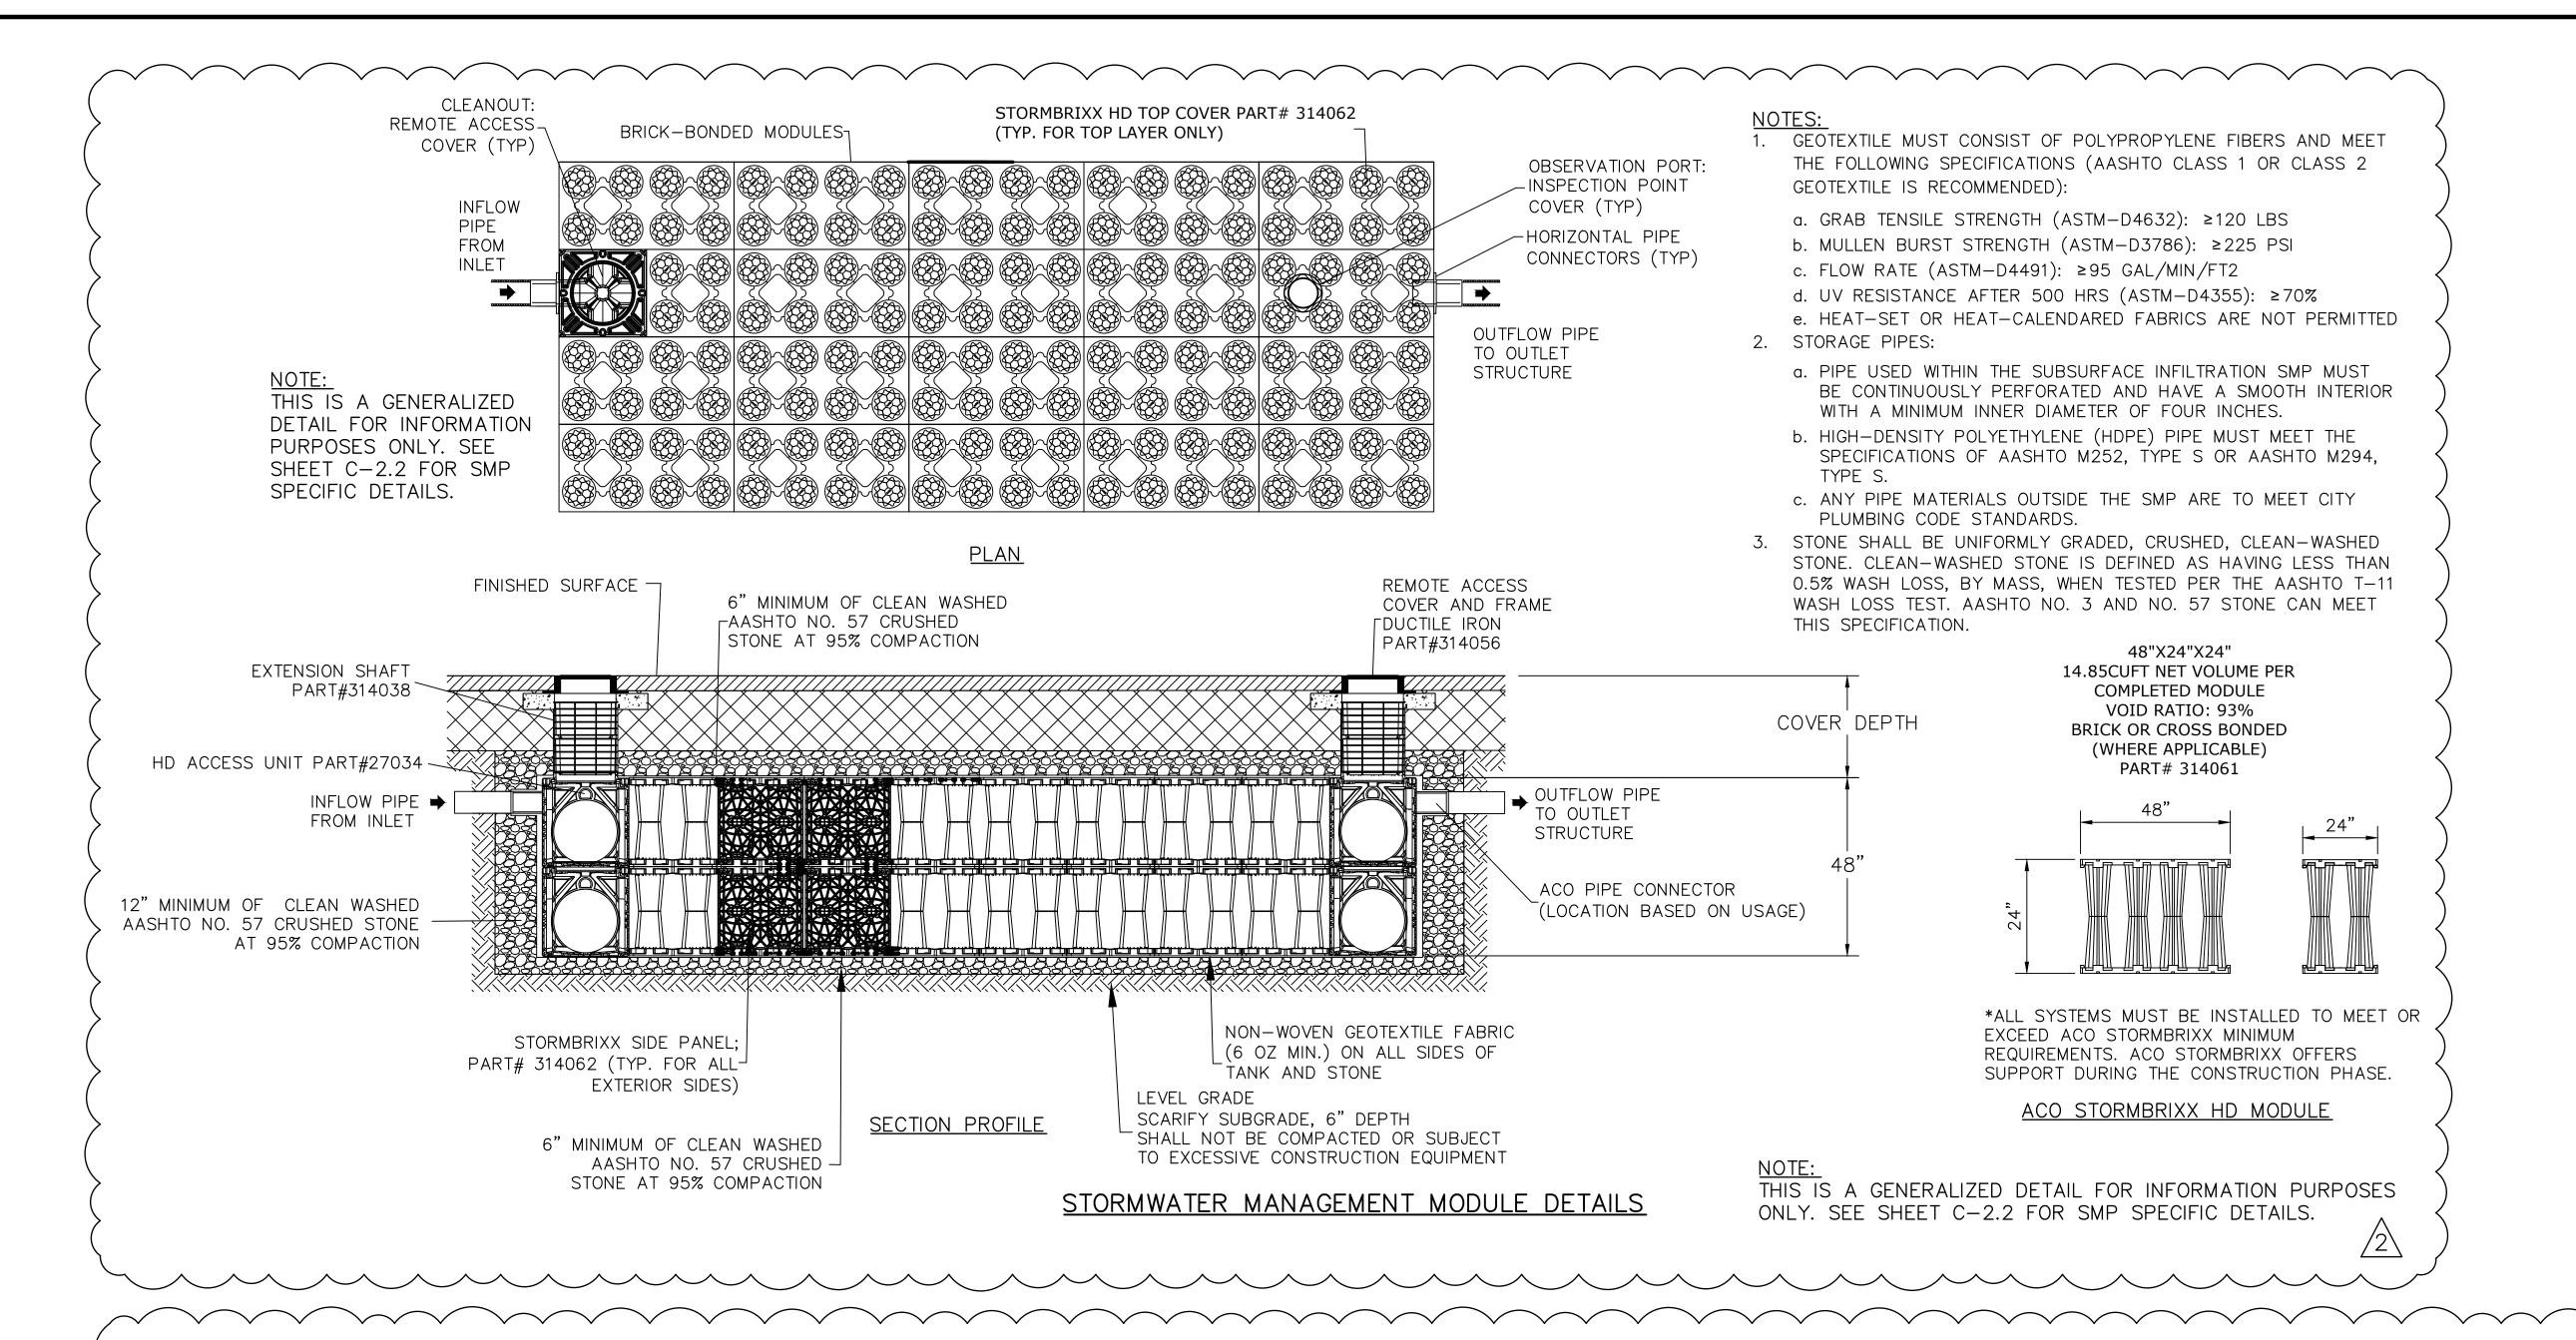


NOTES:

- 1. MEDIA FILTER SHALL BE IN ACCORDANCE WITH ALL DESIGN DATA AND INFORMATION CONTAINED IN THIS DRAWING. CONTRACTOR TO CONFIRM STRUCTURE MEETS REQUIREMENTS OF PROJECT.
- 2. STRUCTURE SHALL MEET AASHTO HS-20 OR PER APPROVING JURISDICTION REQUIREMENTS, WHICHEVER IS MORE STRINGENT, ASSUMING EARTH COVER OF 0'-3'. AND GROUNDWATER ELEVATION AT, OR BELOW THE OUTLET PIPE INVERT ELEVATION. ENGINEER OF RECORD TO CONFIRM ACTUAL GROUNDWATER ELEVATION. CASTINGS SHALL MEET AASHTO M306 LOAD FACTOR DESIGN METHOD.
- 3. STRUCTURE SHALL BE PRECAST CONCRETE CONFORMING TO ASTM C-478 AND AASHTO LOAD FACTOR DESIGN METHOD.

CONTECH INSTALLATION NOTES:

- A. ANY SUB-BASE, BACKFILL DEPTH, AND/OR ANTI-FLOTATION PROVISIONS ARE SITE-SPECIFIC DESIGN CONSIDERATIONS AND SHALL BE SPECIFIED BY ENGINEER OF RECORD.
- B. CONTRACTOR TO PROVIDE EQUIPMENT WITH SUFFICIENT LIFTING AND REACH CAPACITY TO LIFT AND SET THE STRUCTURE (LIFTING CLUTCHES PROVIDED)
- C. CONTRACTOR WILL INSTALL AND LEVEL THE STRUCTURE, SEALING THE JOINTS, LINE ENTRY AND EXIT POINTS (NON-SHRINK GROUT WITH APPROVED WATERSTOP OR FLEXIBLE BOOT)
- D. WHEN ACTIVATED PRIOR TO SITE STABILIZATION, CONTRACTOR TO PROTECT CARTRIDGES FROM CONSTRUCTION-RELATED EROSION RUNOFF.
- E. CARTRIDGE INSTALLATION, BY CONTECH, SHALL OCCUR ACCORDING TO THE PROVISIONS IN THE ACTIVATION CHECKLIST AND THE QUOTED SCOPE OF WORK. CONTACT CONTECH TO COORDINATE CARTRIDGE INSTALLATION WITH SITE STABILIZATION AT (800) 338-1122

MEDIA FILTER SITE SPECIFIC DESIGN DATA									
SMP NO.	FILTER NO.	WATER QUALITY FLOW RATE (CFS)	BRAND/MODEL	NUMBER OF CARTRIDGES REQUIRED (DD/HD)	CARTRIDGE SIZE	UNDERDRAIN INV. IN	ORIFICE SIZE, D, (INCH)	ORIFICE INV. IN	INV. OUT
SMP-1-ALT	MF-1-ALT	0.010	4' JELLYFISH CONTECH FILTER MANHOLE HOUSING 1 HF AND 1 DD	1 / 1	54"	97.00	0.75	97.27	96.50

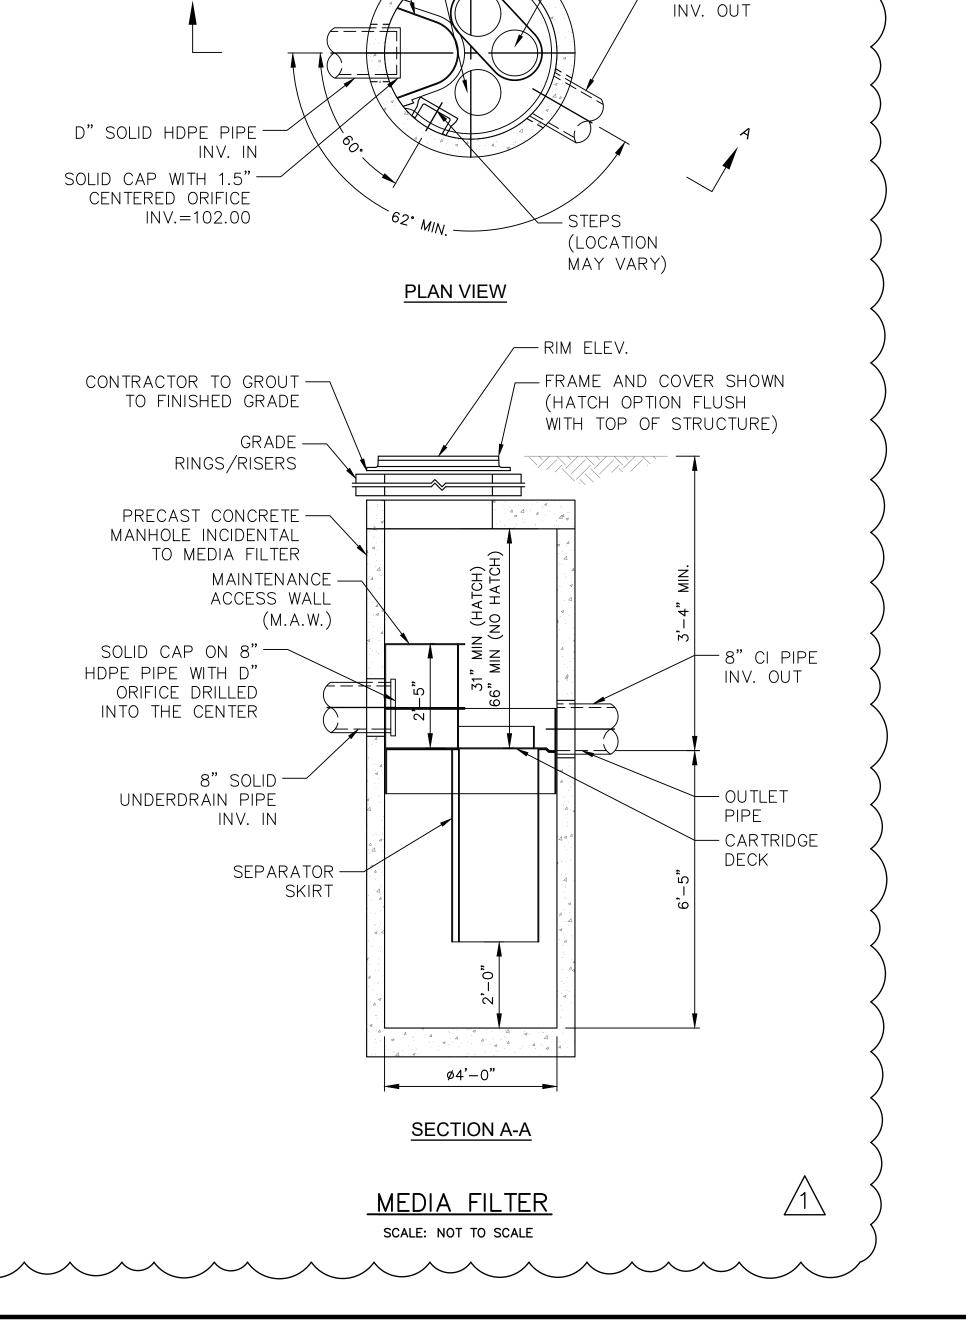

DRAINDOWN -

CARTRIDGE

MAINTENANCE —

ACCESS WALL


- CARTRIDGE


— HI-FLO

CARTRIDGE

─ D"CI PIPE

DECK

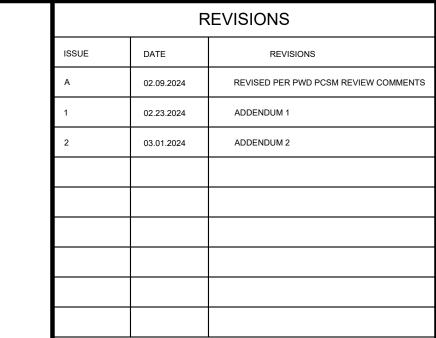

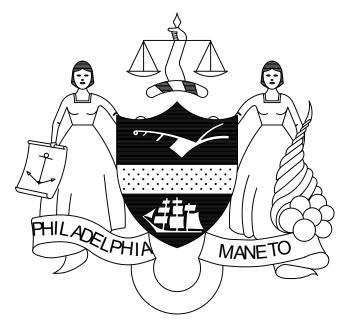

PROJECT COORDINATOR Philadelphia Parks & Recreation and Department of Public Property 1515 Arch Street, 11th Floor Philadelphia, PA 19102



SPACE FOR CONSULTANT RECOGNITION

LANDSCAPE ARCHITECT: Ground Reconsidered 203 S. Broad Street Philadelphia PA 19102 www.groundreconsidered.com

CIVIL ENGINEERS KS Engineers, P.C. 530 Walnut Street, Suite 460 Philadelphia, PA 19106 www.kseng.com

Chadds Ford, PA 19317

www.AroraEngineers.com

ELECTRICAL and PLUMBING ENGINEERS: Arora Engineering, Inc. 61 Wilmington-West Chester Pike,

STRUCTURAL ENGINEERS: David Mason and Associates 123 S. Broad Street, Suite 1130 Philadelphia, PA 19109 www.DavidMason.com


CITY OF PHILADELPHIA DEPARTMENT OF PUBLIC PROPERTY

PHILADELPHIA, PENNSYLVANIA

NICETOWN PARK 4301 GERMANTOWN AVENUE PHILADELPHIA, PA 19134

CONSTRUCTION DETAILS

KSE PROJE	CT NO.	DRAWING NO.
	2471-02	
DATE	01.19.2024	C-5.3
SCALE	AS NOTED	
DRAWN BY	KSE	
CHECKED B	Y RSB	
NOTE:	ALL DIMENSIONS AND CONDITIONS SHALL BE VERIFIED BY THE CONTRACTOR AT THE SITE BEFORE PROCEEDING WITH THE WORK.	

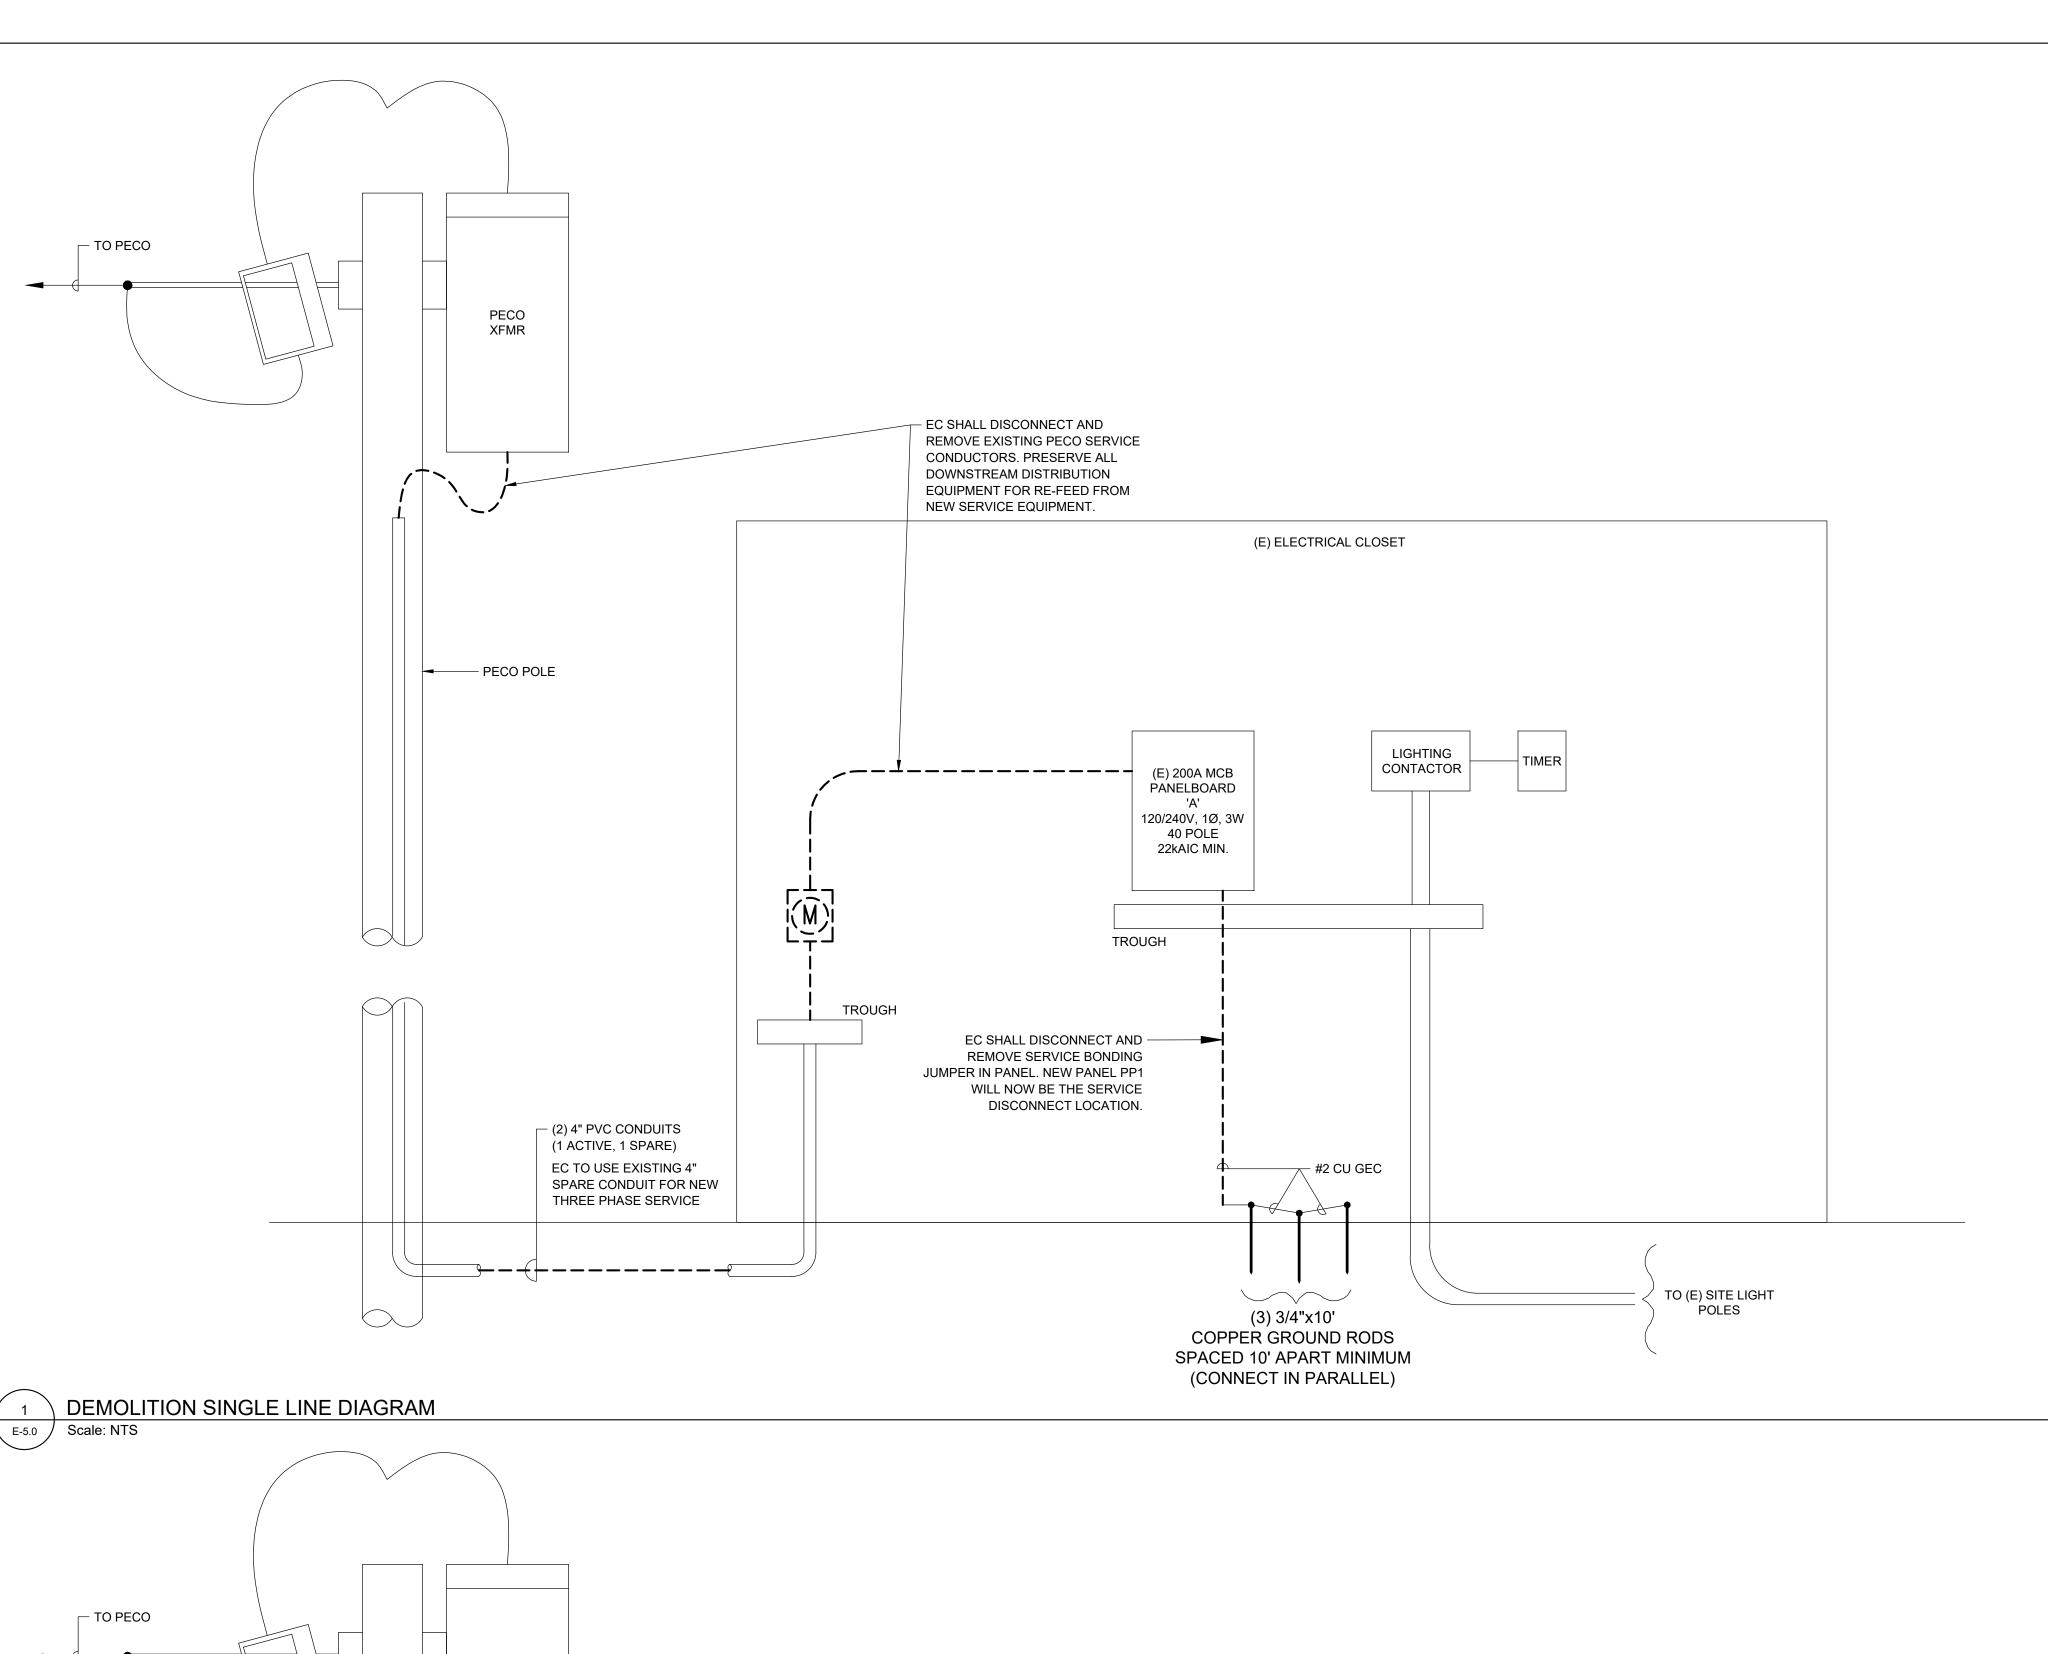


SPACED 10' APART MINIMUM (CONNECT IN PARALLEL)

PROPOSED SINGLE LINE DIAGRAM

E-5.0 Scale: NTS

GENERAL NOTES:

- 1. REFER TO DRAWING E-1.0 FOR GENERAL NOTES, SYMBOLS AND ABBREVIATIONS.
- 2. COORDINATE ALL NEW WORK WITH OWNER PRIOR TO START OF WORK.
- 3. EC SHALL FURNISH AND INSTALL ELECTRONIC TIMER CONTROL FOR EACH OF THE TWO NEW SITE LIGHTING CIRCUITS IN THE UTILITY SHACK. BASIS OF DESIGN: - ASTRONOMIC 7-DAY 2-CIRCUIT ELECTRONIC CONTROL, 120-277 VAC, 2-SPST, INDOOR METAL ENCLOSURE INTERMATIC ITEM # ET8215C.
- 4. SEE SITE PLAN ON SHEET E-3.0 FOR CONTINUATION OF CIRCUITING TO SUPPLIED EQUIPMENT.

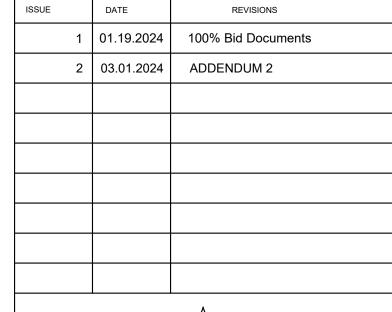

REVISIONS



PROJECT COORDINATOR Philadelphia Parks & Recreation and Department of Public Property 1515 Arch Street, 10th Floor Philadelphia, PA 19102 Contact: Nancy Q. O'Donnell, 215.832.2174

SPACE FOR CONSULTANT RECOGNITION

LANDSCAPE ARCHITECT: Ground Reconsidered 915 Spring Garden Street Suite 403

www.groundreconsidered.com CIVIL ENGINEERS: KSE Engineering

Philadelphia PA 19123

530 Walnut Street Suite 460

www.kseng.com

Philadelphia, PA 19106

www.AroraEngineers.com

ELECTRICAL and PLUMBING ENGINEERS: Arora Engineering, Inc. 61 Wilmington-West Chester Pike, Chadds Ford, PA 19317

STRUCTURAL ENGINEERS: David Mason and Associates 123 S. Broad Street, Suite 1130 Philadelphia, PA 19109 www.DavidMason.com

CITY OF PHILADELPHIA DEPARTMENT OF PUBLIC PROPERTY


PHILADELPHIA, PENNSYLVANIA

NICETOWN PARK

ELECTRICAL DETAILS

PROJECT NO	D.	DRAWING NO.
	2009.05	
DATE	01.19.2024	E-5.0
SCALE		
DRAWN BY	AT	
CHECKED B	YPL	

ALL DIMENSIONS AND CONDITIONS SHALL BE VERIFIED BY THE CONTRACTOR AT THE SITE BEFORE PROCEEDING WITH THE WORK.

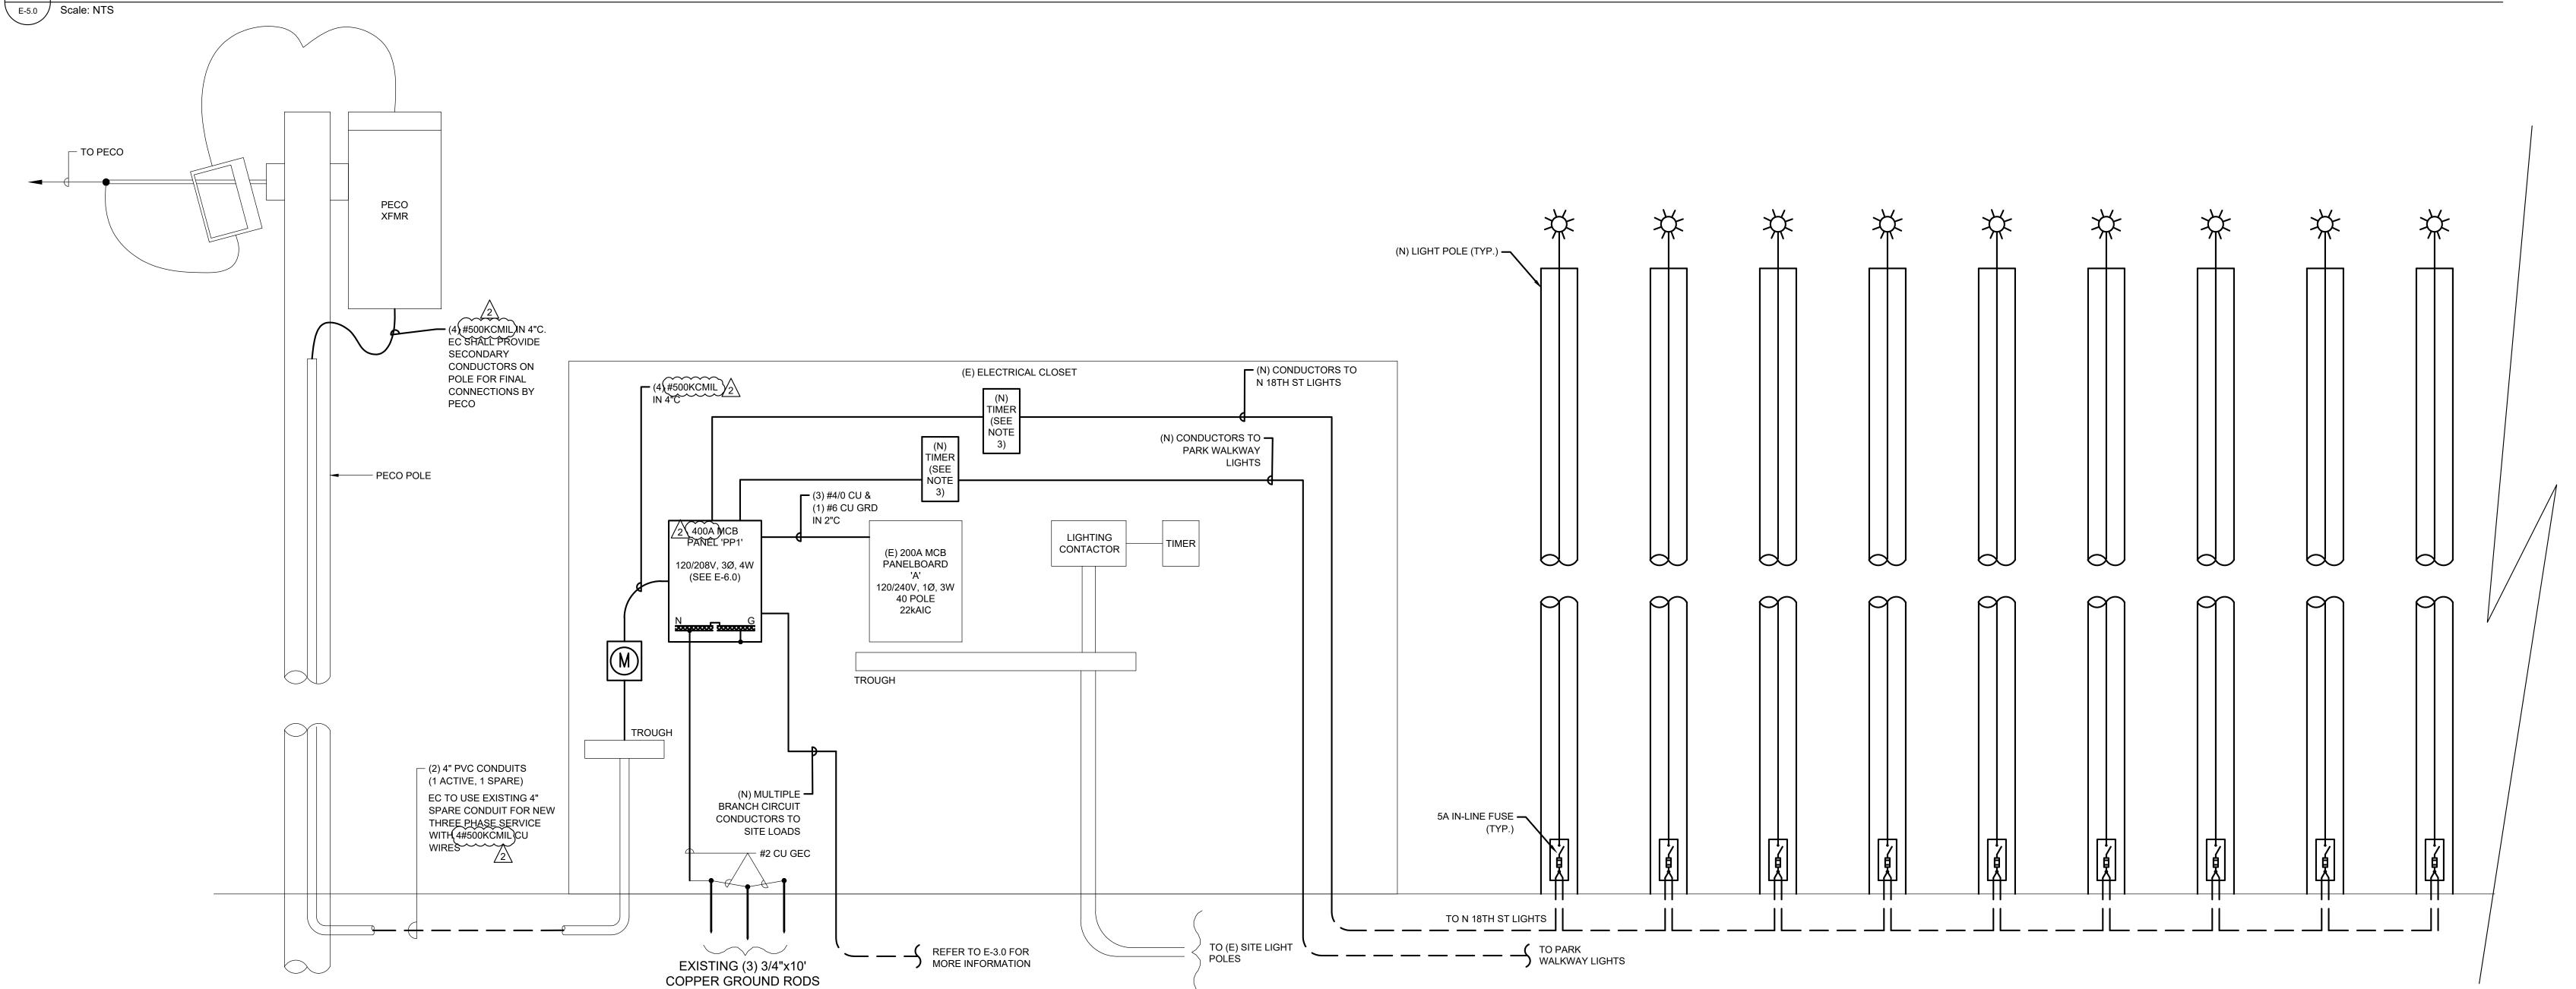


			LUMI	NAIRE SCHEDULE						
FIXTURE TYPE	DESCRIPTION	MOUNTING	MANUFACTURER	CATALOG NUMBER	POLE DESCRIPTION	POLE HEIGHT	POLE CATALOG	TYPE	TOTAL WATTS	VOLTS
А	SINGLE HEAD POLE MOUNTED PEDESTRIAN LIGHT FIXTURE WITH PHOTOCELL	POLE	DISCERA 4 LED SELUX	DSC4L-R2-S1-5G350-35-BK-UNV-TLRP	TAPERED POLE	14'	AT535-14-BK	LED	32	208

GENERAL NOTES:

- 1. REFER TO DRAWING E-1.0 FOR GENERAL NOTES, SYMBOLS AND ABBREVIATIONS.
- 2. COORDINATE ALL NEW WORK WITH OWNER PRIOR TO START OF WORK.
- 3. ALL CONDUCTORS INCREASED IN SIZE FOR VOLTAGE DROP CONSIDERATION SHALL BE SPLICED TO APPROPRIATE SIZE CONDUCTORS FOR TERMINATING ONTO EQUIPMENT AND DEVICES. SPLICES SHALL BE MADE INSIDE THE EQUIPMENT AS ALLOWED BY THE NEC OR AT THE CLOSEST JUNCTION BOX TO THE EQUIPMENT OR DEVICE. THE SPLICED CONDUCTOR SHALL BE SIZED AS THE LARGEST ACCEPTABLE CONDUCTOR BASE ON THE TERMINATION OF THE EQUIPMENT OR DEVICE.

PANEL: PP1			INTE	RRUPTING	G RATING:	22	KAIC				MC	DUNTING: SURFACE
VOLTAGE: 208Y/120V	PHASE	•	3			WIRE:	4	BUS A	MPS	400	A /2\	MAIN: 400 A /2
NEMA 3R	NEUTRAL		00%								\sim	DCATION: ELEC CLOSET
CIRCUIT DESCRIPTION	BRANCH CIRCUIT CONDUCTORS AND	POLES	BKR SIZE	VA	V	/A / PHAS	E	VA	SIZE	POLES	BRANCH CIRCUIT CONDUCTORS AND	CIRCUIT DESCRIPTION
SINGOTI BEGONII TION	CONDUIT	PO	BKR	V/ (Α	В	С	V / X	BKR	PO	CONDUIT	Ontoon Bloom non
	AUA 0 4U00			7000	7000			0				
DISTRO BOX - STAGE	4#1 & 1#8G (NOTE 3)	3	100	7000		7000		0	30	3	4#10 & 1#10G IN 3/4"C	SPD
	(**************************************			7000			7000	0				
DISTRO BOY MORTH	4#1/0 & 1#6G			7000	16115			9115	200	2	SEE SINGLE LINE	
DISTRO BOX - NORTH PARK (NOTE 2)	(NOTE 3)	3	100	7000		16115		9115	200		SEE SINGLE LINE	
,	,			7000			7192	192	20	2	2#10 & 1#10G	LIGHTS - N 18TH ST
DISTRO BOX - SOUTH	4#1/0 & 1#6G			7000	7192			192			(NOTE 3)	(NOTE 1)
PARK (NOTE 2)	(NOTE 3)	3	100	7000		7384		384	20	2	2#10 & 1#10G	LIGHTS - PARK WALKWAY
` ,	· ,			7000			7384	384		_	(NOTE 3)	(NOTE 1)
PREFABRICATED RESTROOM (NOTE 1)	3#1/0 & 1#4G (NOTE 3)	2	80	6700	7400			700	20	1	2#8 & 1#8G (NOTE 3)	HOT BOX (NOTE 1)
TRESTROOM (NOTE 1)	(NOTE 3)			6700		6700		0	-	-	-	-
-	-	-	-	0			0	0	-	-	-	-
-	-	-	-	0	0			0	-	-	-	-
-	-	-	-	0		0		0	-	-	-	-
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-	-	-	-	0			0	0	-	-	-	-
NOTES:						TOTALS	1					
1. CONDUCTORS SIZED FOR 2. CONDUCTORS ADJUSTE		NUCT	ODE	IN I	37707	37199	21576					
CONDUIT.	DI OK NOWIDEK OF COND	,001		1 V		96482 VA						267.80 CONNECTED


) (OL TA	.: (E) A	FED FROM: PANEL PP1	IN	ITERI	RUPTING	RATING:	22 KAI	3			M	OUNTING: SURFACE	
VOLTA	GE: 208/120V	PHASE:		1		V	/IRE: 3	BUS AN	MPS:	200	4	MAIN: 200A MCB	
NEMA	(E)	NEUTRAL:	10	0%							L	OCATION: ELEC CLOSET	
CII	RCUIT DESCRIPTION	BRANCH CIRCUIT CONDUCTORS AND CONDUIT	POLES	BKR SIZE	VA	VA / F	PHASE B	VA	BKR SIZE	POLES	BRANCH CIRCUIT CONDUCTORS AND CONDUIT	CIRCUIT DESCRIPTION	
SDADE	E (ON POSITION)	-		100	0	50		50	20	1	(E)	CLOSET LIGHT & TIME CLOCK	
JOPANE	(ON POSITION)	-	2	100	0		180	180	20	1	(E)	RECEPTACLES	
SPARE	(ON POSITION)	-	1	20	0	0		0	50	2 -	(E)	EXISTING LOAD	
ARCH		(E)	1	20	0		0	0	30	_	(E)	(OFF POSITION)	
-		-	-	-	0	0		0	-	-	-	-	
-		-	-	-	0		0	0	-	-	-	-	
-		-	-	-	0	0		0	-	-	-	-	
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-		-	-	-	0		0	0			-	-	
SITE LI	IGHTS	(E)	2	60	4500	4500		0			-	-	
		(E)	<u> </u>		4500		4500	0			-	-	
SITE LI	IGHTS	(E)	2	60	4500	4500		0			-	-	
		(E)			4500		4500 ALS	0			-	-	

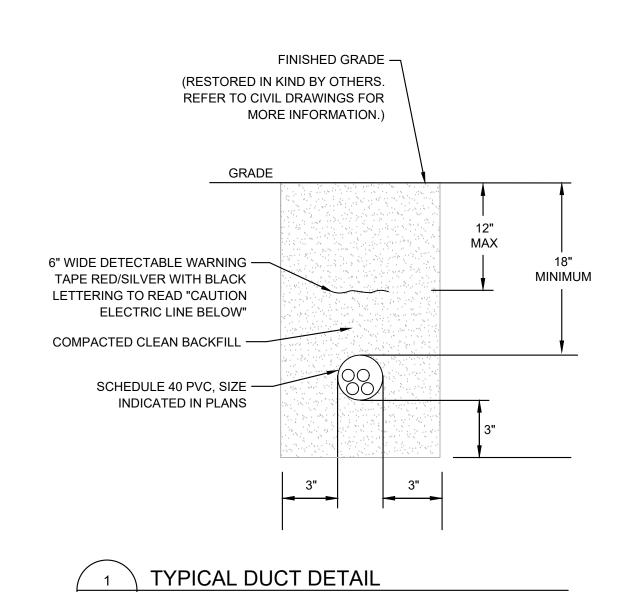

DUCT BANK NOTES:

E-6.0 Scale: NTS


- 1. EC SHALL TAKE EXTREME CARE IN EXCAVATING AREA. HAND-DIG IF NECESSARY. MODIFY/RE-ROUTE DUCT BANK AS REQUIRED TO MINIMIZE CONFLICT WITH EXISTING UTILITIES.
- 2. COORDINATE ALL CONDUIT ROUTING WITH EXISTING CONDITIONS AND ROADWAY CUTTING AND TRENCHING.
- 3. ADJUST TRENCH DETAIL FOR MULTIPLE CONDUITS WHEN REQUIRED. OBTAIN ENGINEER'S APPROVAL.
- 4. REMOVE ALL SHARP STONES AND OBJECTS FROM COMPACTED BEDDING, SIDE SUPPORTS, AND FILL.

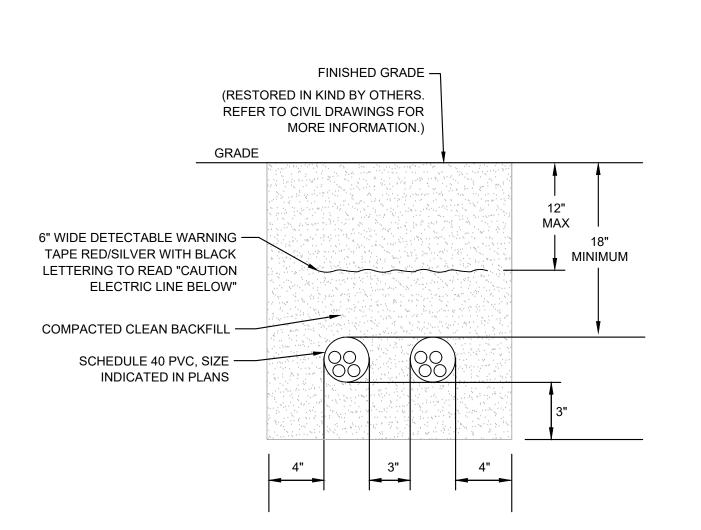

2 TYPICAL 2 WAY DUCT BANK DETAIL E-6.0 Scale: NTS

DUCT BANK NOTES:

- 1. EC SHALL TAKE EXTREME CARE IN EXCAVATING AREA. HAND-DIG IF NECESSARY. MODIFY/RE-ROUTE DUCT BANK AS REQUIRED TO MINIMIZE CONFLICT WITH EXISTING UTILITIES.
- 2. COORDINATE ALL CONDUIT ROUTING WITH EXISTING CONDITIONS AND ROADWAY CUTTING AND TRENCHING.
- 3. ADJUST TRENCH DETAIL FOR MULTIPLE CONDUITS WHEN REQUIRED. OBTAIN ENGINEER'S APPROVAL.
- 4. REMOVE ALL SHARP STONES AND OBJECTS FROM COMPACTED BEDDING, SIDE SUPPORTS, AND FILL.

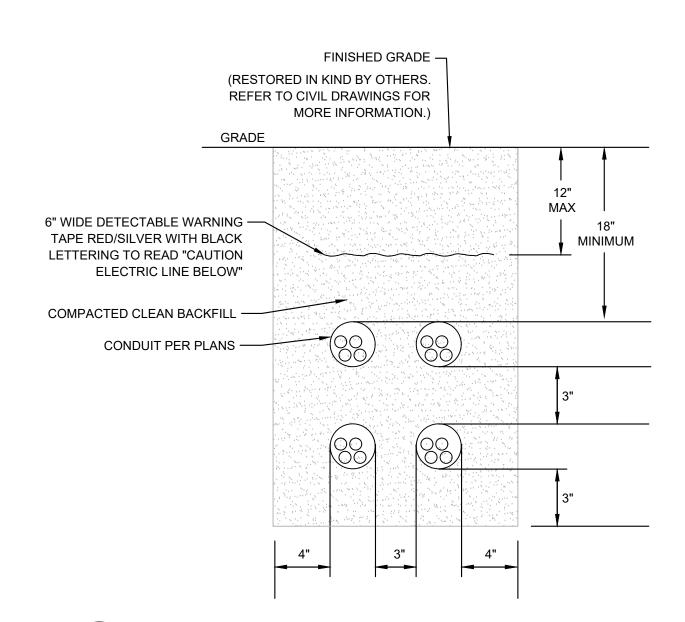

TYPICAL 4 WAY DUCT BANK DETAIL E-6.0 | Scale: NTS

DUCT BANK NOTES

- 1. EC SHALL TAKE EXTREME CARE IN EXCAVATING AREA. HAND-DIG IF NECESSARY. MODIFY/RE-ROUTE DUCT BANK AS REQUIRED TO MINIMIZE CONFLICT WITH EXISTING UTILITIES.
- 2. COORDINATE ALL CONDUIT ROUTING WITH EXISTING CONDITIONS AND ROADWAY CUTTING AND TRENCHING.
- 3. ADJUST TRENCH DETAIL FOR MULTIPLE CONDUITS WHEN REQUIRED. OBTAIN ENGINEER'S APPROVAL.
- 4. REMOVE ALL SHARP STONES AND OBJECTS FROM COMPACTED BEDDING, SIDE SUPPORTS, AND FILL.

	RE'	VISIONS	
ISSUE		DATE	REVISIONS
	1	01.19.2024	100% Bid Documents
	2	03.01.2024	ADDENDUM 2



PROJECT COORDINATOR Philadelphia Parks & Recreation and Department of Public Property 1515 Arch Street, 10th Floor Philadelphia, PA 19102 Contact: Nancy Q. O'Donnell, 215.832.2174

SPACE FOR CONSULTANT RECOGNITION

LANDSCAPE ARCHITECT: Ground Reconsidered 915 Spring Garden Street Suite 403 Philadelphia PA 19123

www.groundreconsidered.com CIVIL ENGINEERS: KSE Engineering
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www.AroraEngineers.com

CITY OF PHILADELPHIA DEPARTMENT OF PUBLIC PROPERTY

PHILADELPHIA, PENNSYLVANIA

NICETOWN PARK

PROJECT TITLE

ELECTRICAL SCHEDULES

PROJECT N	0.	DRAWING NO.
	2009.05	
DATE	01.19.2024	E-6.0
SCALE		
DRAWN BY	AT	
CHECKED B	^Y PL	
NOTE:	ALL DIMENSIONS AND CONDITIONS SHALL BE VERIFIED BY THE CONTRACTOR AT THE SITE BEFORE PROCEEDING WITH THE WORK.	•