

# **MILES MACK BUILDING RENOVATION**

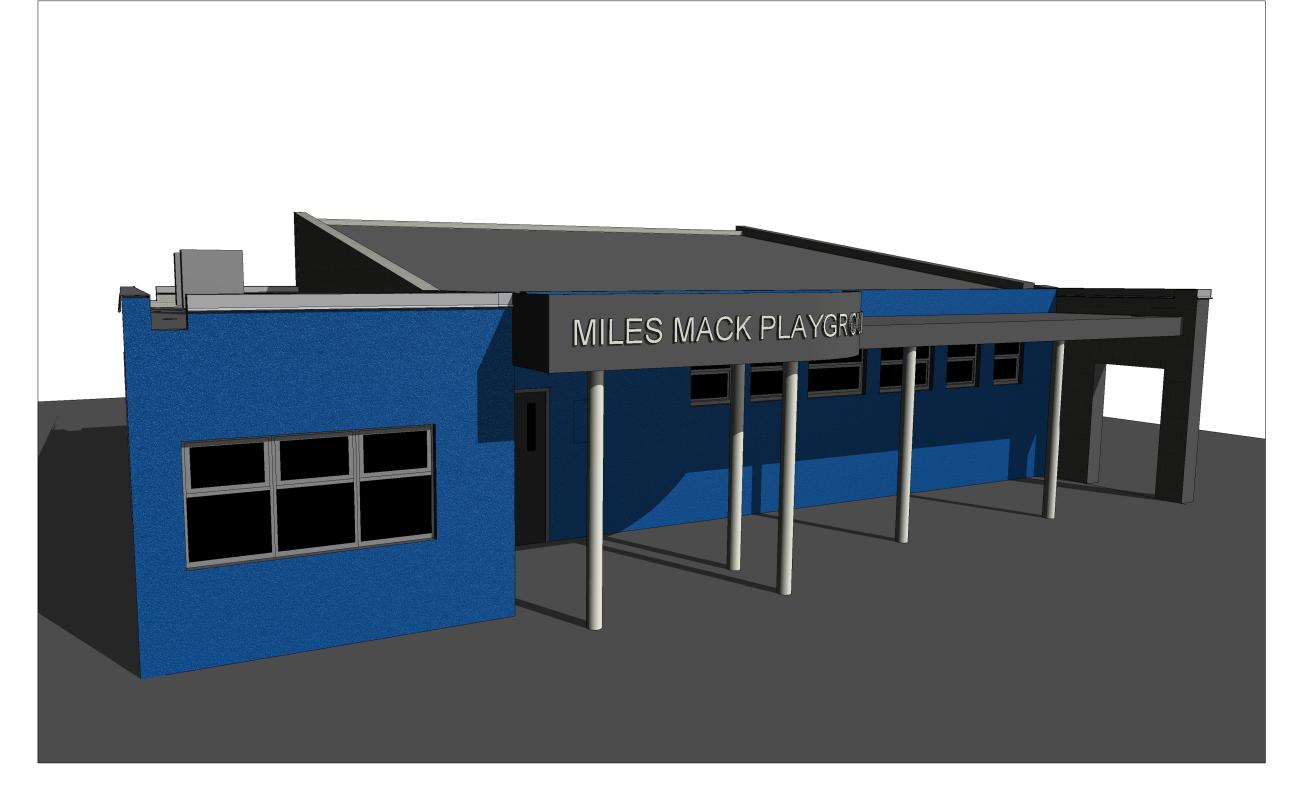

## 732 N 36th St #66, Philadelphia, PA 19104

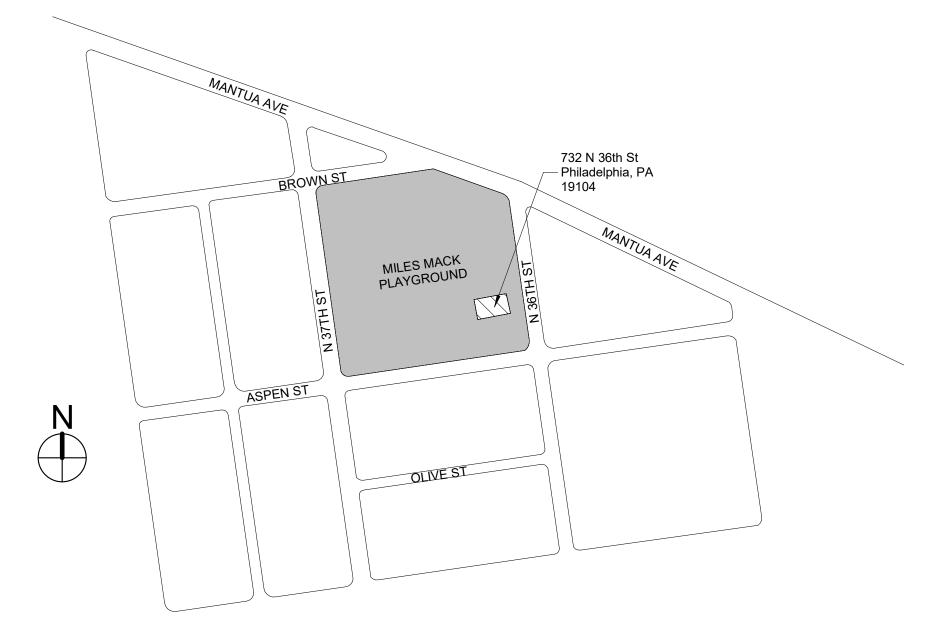

## **ARCHITECTURAL & SYSTEMS**

Addendum #2 - 3/6/20

	SHEET	
	NUMBER	SHEET NAME
		•
	G0.0	COVER SHEET
	G0.1	REFERENCE PLAN
	G0.2	SYMBOLS & ABBREVIATIONS
	G0.3	LIFE SAFETY PLAN & CODE ANALYSIS
	S1.1	STRUCTURAL PLANS
	S5.1	CONCRETE DETAILS & NOTES
	S5.2	CMU DETAILS
	S5.3	STEEL DETAILS
	A1.0	DEMOLITION PLANS
	A1.1	DEMOLITION RCP
	A1.2	DEMOLITION ELEVATIONS
	A2.0	FLOOR PLAN AND WALL TYPES
	A2.1	ROOF PLAN & DETAILS
	A3.0	REFLECTED CEILING PLANS
	A4.0	EXTERIOR ELEVATIONS
	A4.1	ILLUSTRATIVE EXTERIOR ELEVATIONS
	A5.0	WALL SECTIONS & DETAILS
	A5.1	MISCELANEOUS DETAILS
	A6.0	ENLARGED KITCHENETTE PLAN AND DETAIL
~~	A6.1	ENLARGED FLOOR PLANS & ELEVATIONS
	A7.0	DOOR, WINDOW, EQUIPMENT & TOILET ACC
	A8.0	FINISH PLAN & SCHEDULE
L	~	
	M0.01	SYMBOLS, NOTES, DETAILS & ABBREVIATIO
	MD1.01	FLOOR PLAN - MECHANICAL DEMOLITION
	M1.01	FLOOR PLAN - MECHANICAL
	M1.02	ROOF PLAN - MECHANICAL
	M6.01	SCHEDULES - MECHANICAL
	M7.01	CONTROLS - MECHANICAL
	P0.01	SYMBOLS NOTES, SCHEDULES, DETAILS, &
	PD1.01	FLOOR PLAN - PLUMBING DEMOLITION
	P1.01	FOUNDATION PLAN - PLUMBING
	P1.02	FLOOR PLAN - PLUMBING
	P1.03	ROOF PLAN - PLUMBING
	50.04	
	E0.01	SYMBOLS, SCHEDULES, NOTES, AND ABBRE
	E1.01	FLOOR PLAN ELECTRICAL DEMOLITION FLOOR PLAN - ELECTRICAL
	E2.01	
	E2.02	
	E2.03	
	E2.04	FLOOR PLAN - ELECTRICAL
	E3.01	PANEL SCHEDULES & ONE-LINE DIAGRAMS

	-
SHEET NAME	
	1
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NOTES	
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PMENT & TOILET ACCESSORIES SCHEDULES	<u> </u>
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IG DEMOLITION	
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IG	
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, NOTES, AND ABBREVIATIONS	1
CAL DEMOLITION	
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ISSUE	DATE 3/6/20		CRIPTION	
	3/0/20	Aude		
	HILADELPHIA		MANETO	
Philadelph and Depar 1515 Arch Philadelph	COORDINAT ia Parks & Rec tment of Public Street, 11th Fl ia, PA 19102 charles Motters	reatior Prope oor	erty	
SEAL				
	ALL		ALLER DE LE	
PROJECT	TEAM			
ARCHITE				
1600 MAR PHILADEL	I, MIRMIRAN & KET ST, SUIT PHIA, PA 1910	E 520	MPSON, INC	
267.256.03 <u>STRUCTL</u>	300 IRAL ENGINE	<u>=R:</u>		
1600 MAR	I, MIRMIRAN 8 KET ST, SUIT PHIA, PA 1910	E 520	MPSON, INC	
SYSTEMS	ENGINEER:	) <del></del>		
1600 MAR PHILADEL	I, MIRMIRAN & KET ST, SUIT PHIA, PA 1910	E 520	MPSON, INC	
267.256.03	300			
REBUILD RECREAT			HILADELPHIA PAR	KS
11TH FLO PHILADEL	OR, ONE PAR PHIA, PENNS.			
PROJECT MILES MA	TITLE CK BUILDING	RENC	OVATION	
DRAWING	G TITLE COVER S	SHEET	r	
PROJECT	NO.		DRAWING NO.	
10-20-XXX DATE: 02				<b>^</b>
SCALE: A	S NOTED		G0.(	J
DRAWN E	BY:			

CHECKED BY:


WORK.

FILE:

NOTE: ALL DIMENSIONS AND CONDITIONS SHALL BE VERIFIED BY THE CONTRACTOR AT THE SITE BEFORE PROCEEDING WITH THE

REVISIONS

## BROWN ST

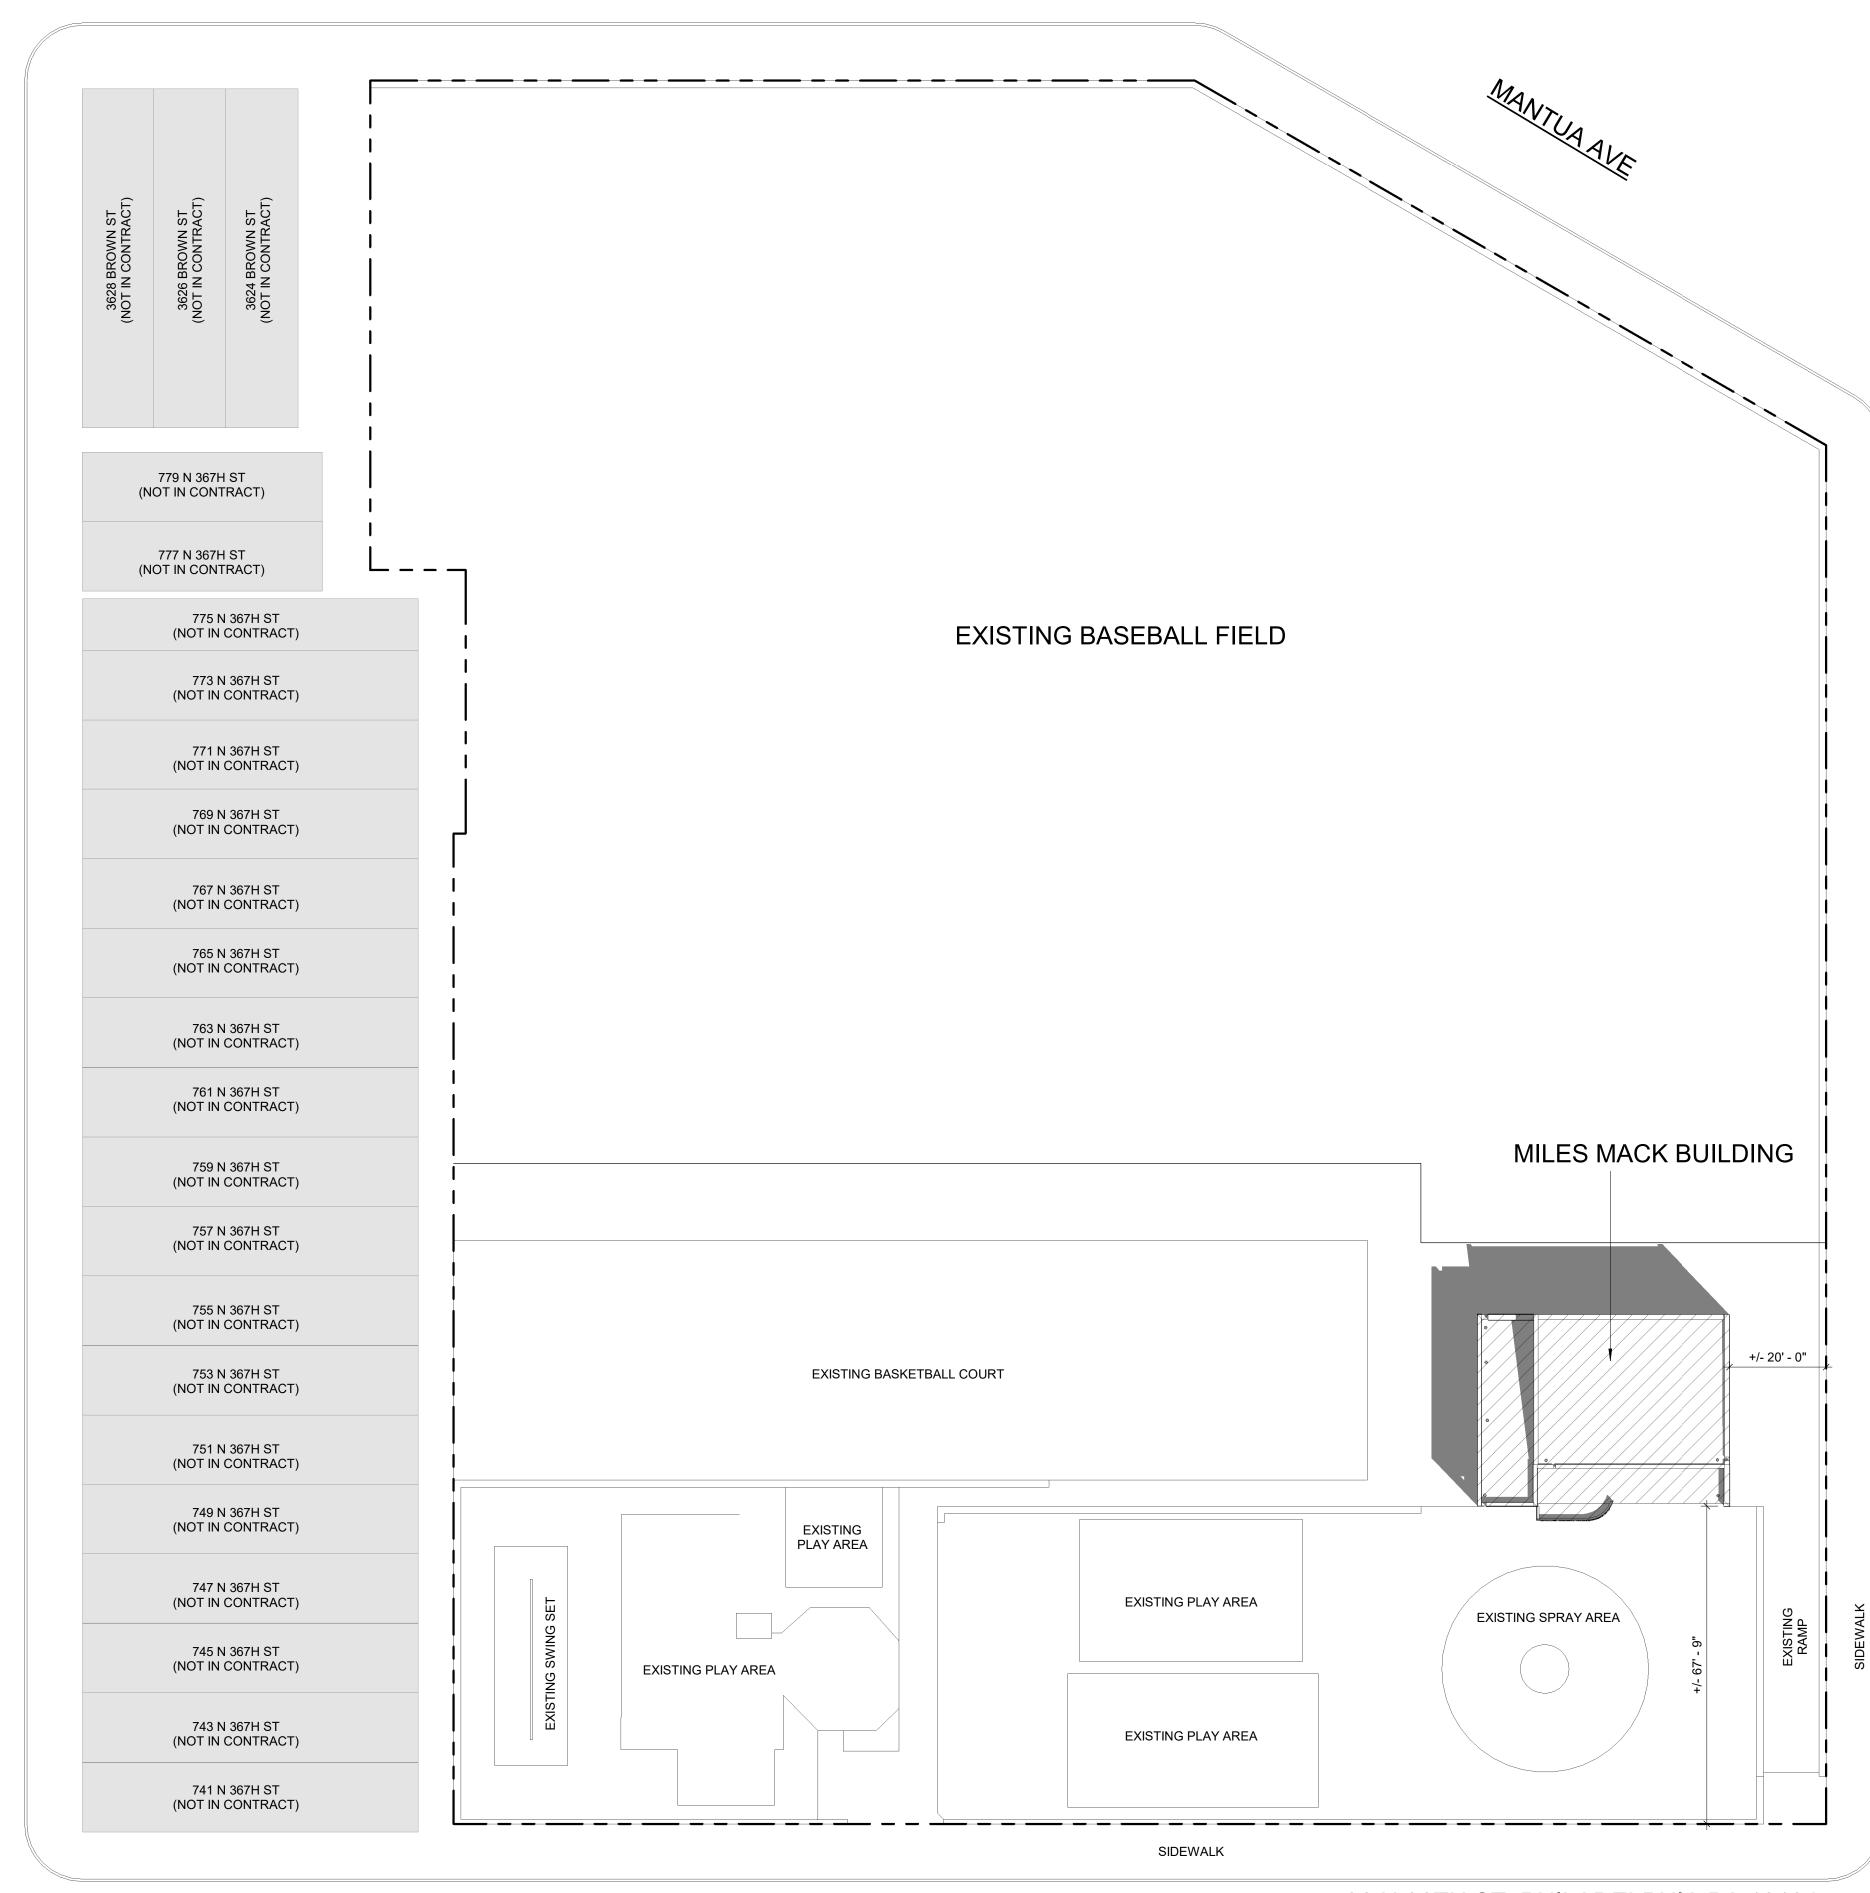

ST N 37TH

> **SITE PLAN** 1" = 20'-0" 20' 10' 0' 20'

40'

736 N 36TH ST, PHILADELPHIA PA 19104

<u>ASPEN ST</u>

### GENERAL NOTES:


N 36TH ST

 $\bigcirc$ 

- 1. COORDINATE LAYDOWN SPACE, STAGING AREA, AND SITE ACCESS WITH OWNER. 2. PROVIDE 8' HIGH CHAIN LINK FENCE WITH PAIR OF 3' WIDE GATES WITH LOCK AT
- PROVIDE & HIGH CHAIN LINK FENCE WITT FAIL OF SWIDE GATES WITH LOCK AT PERIMETER OF BUILDING. COORDINATE EXTENTS WITH OWNER.
   CONTRACTOR IS RESPONSIBLE FOR SECURING CONSTRUCTION SITE AT ALL TIMES.
   SITE WORK ON PROPERTY WILL BE OCCURRING SIMULTANEOUSLY UNDER SEPERATE CONTRACT. CONTRACTOR TO COORDINATE WORK WITH OWNER.

REVISIONS				
ISSUE DATE	DESCRIPTION			
PHILADEL PHIA MANETO				
PROJECT COORDINATO	DR			
Philadelphia Parks & Recr and Department of Public	eation Property			
1515 Arch Street, 11th Flo				
Philadelphia, PA 19102 Contact: Sara Nordstrom,	215-683-0253			
SEAL				
BOORE HILL AND STEINROOM WE WANTED				
PROJECT TEAM				
ARCHITECT: JOHNSON, MIRMIRAN &	THOMPSON, INC			
1600 MARKET ST, SUITE PHILADELPHIA, PA 1910	520			
267.256.0300	5			
STRUCTURAL ENGINEE	<u>R:</u>			
JOHNSON, MIRMIRAN &	THOMPSON, INC			
1600 MARKET ST, SUITE PHILADELPHIA, PA 1910	3			
267.256.0300				
SYSTEMS ENGINEER:	SYSTEMS ENGINEER:			
JOHNSON, MIRMIRAN & THOMPSON, INC				
1600 MARKET ST, SUITE	520			
	520			
1600 MARKET ST, SUITE PHILADELPHIA, PA 1910	520			
1600 MARKET ST, SUITE PHILADELPHIA, PA 1910	520			
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1600 MARKET ST, SUITE PHILADELPHIA, PA 1910 267.256.0300 CITY OF PHILADELPHIA REBUILD PHILADELPHIA PHILADELPHIA PARKS & 1515 ARCH STREET 11TH FLOOR, ONE PARK PHILADELPHIA, PENNSY	A AND RECREATION KWAY BUILDING			
1600 MARKET ST, SUITE PHILADELPHIA, PA 1910 267.256.0300 CITY OF PHILADELPHIA REBUILD PHILADELPHIA PHILADELPHIA PARKS & 1515 ARCH STREET 11TH FLOOR, ONE PARH	A AND RECREATION WAY BUILDING (LVANIA			
1600 MARKET ST, SUITE PHILADELPHIA, PA 1910 267.256.0300 CITY OF PHILADELPHIA REBUILD PHILADELPHIA PHILADELPHIA PARKS & 1515 ARCH STREET 11TH FLOOR, ONE PARI PHILADELPHIA, PENNSY PROJECT TITLE	A AND RECREATION WAY BUILDING (LVANIA			
1600 MARKET ST, SUITE PHILADELPHIA, PA 1910 267.256.0300 CITY OF PHILADELPHIA REBUILD PHILADELPHIA PHILADELPHIA PARKS & 1515 ARCH STREET 11TH FLOOR, ONE PARH PHILADELPHIA, PENNSY PROJECT TITLE MILES MACK BUILDING	A AND RECREATION WAY BUILDING (LVANIA			
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1600 MARKET ST, SUITE PHILADELPHIA, PA 1910 267.256.0300 CITY OF PHILADELPHIA REBUILD PHILADELPHIA PHILADELPHIA PARKS & 1515 ARCH STREET 11TH FLOOR, ONE PARI PHILADELPHIA, PENNSY PROJECT TITLE MILES MACK BUILDING DRAWING TITLE REFERENC PROJECT NO.	SE PLAN			
1600 MARKET ST, SUITE PHILADELPHIA, PA 1910 267.256.0300 CITY OF PHILADELPHIA REBUILD PHILADELPHIA PHILADELPHIA PARKS 8 1515 ARCH STREET 11TH FLOOR, ONE PARH PHILADELPHIA, PENNSY PROJECT TITLE MILES MACK BUILDING DRAWING TITLE REFERENC PROJECT NO. 10-20-XXXX-01 DATE: 02.07.2020	A AND RECREATION WAY BUILDING (LVANIA RENOVATION E PLAN DRAWING NO.			
1600 MARKET ST, SUITE PHILADELPHIA, PA 1910 267.256.0300 CITY OF PHILADELPHIA REBUILD PHILADELPHIA PHILADELPHIA PARKS & 1515 ARCH STREET 11TH FLOOR, ONE PARH PHILADELPHIA, PENNSY PROJECT TITLE MILES MACK BUILDING DRAWING TITLE REFERENC PROJECT NO. 10-20-XXXX-01 DATE: 02.07.2020 SCALE: AS NOTED	A AND RECREATION WAY BUILDING (LVANIA RENOVATION E PLAN DRAWING NO.			
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WORK.

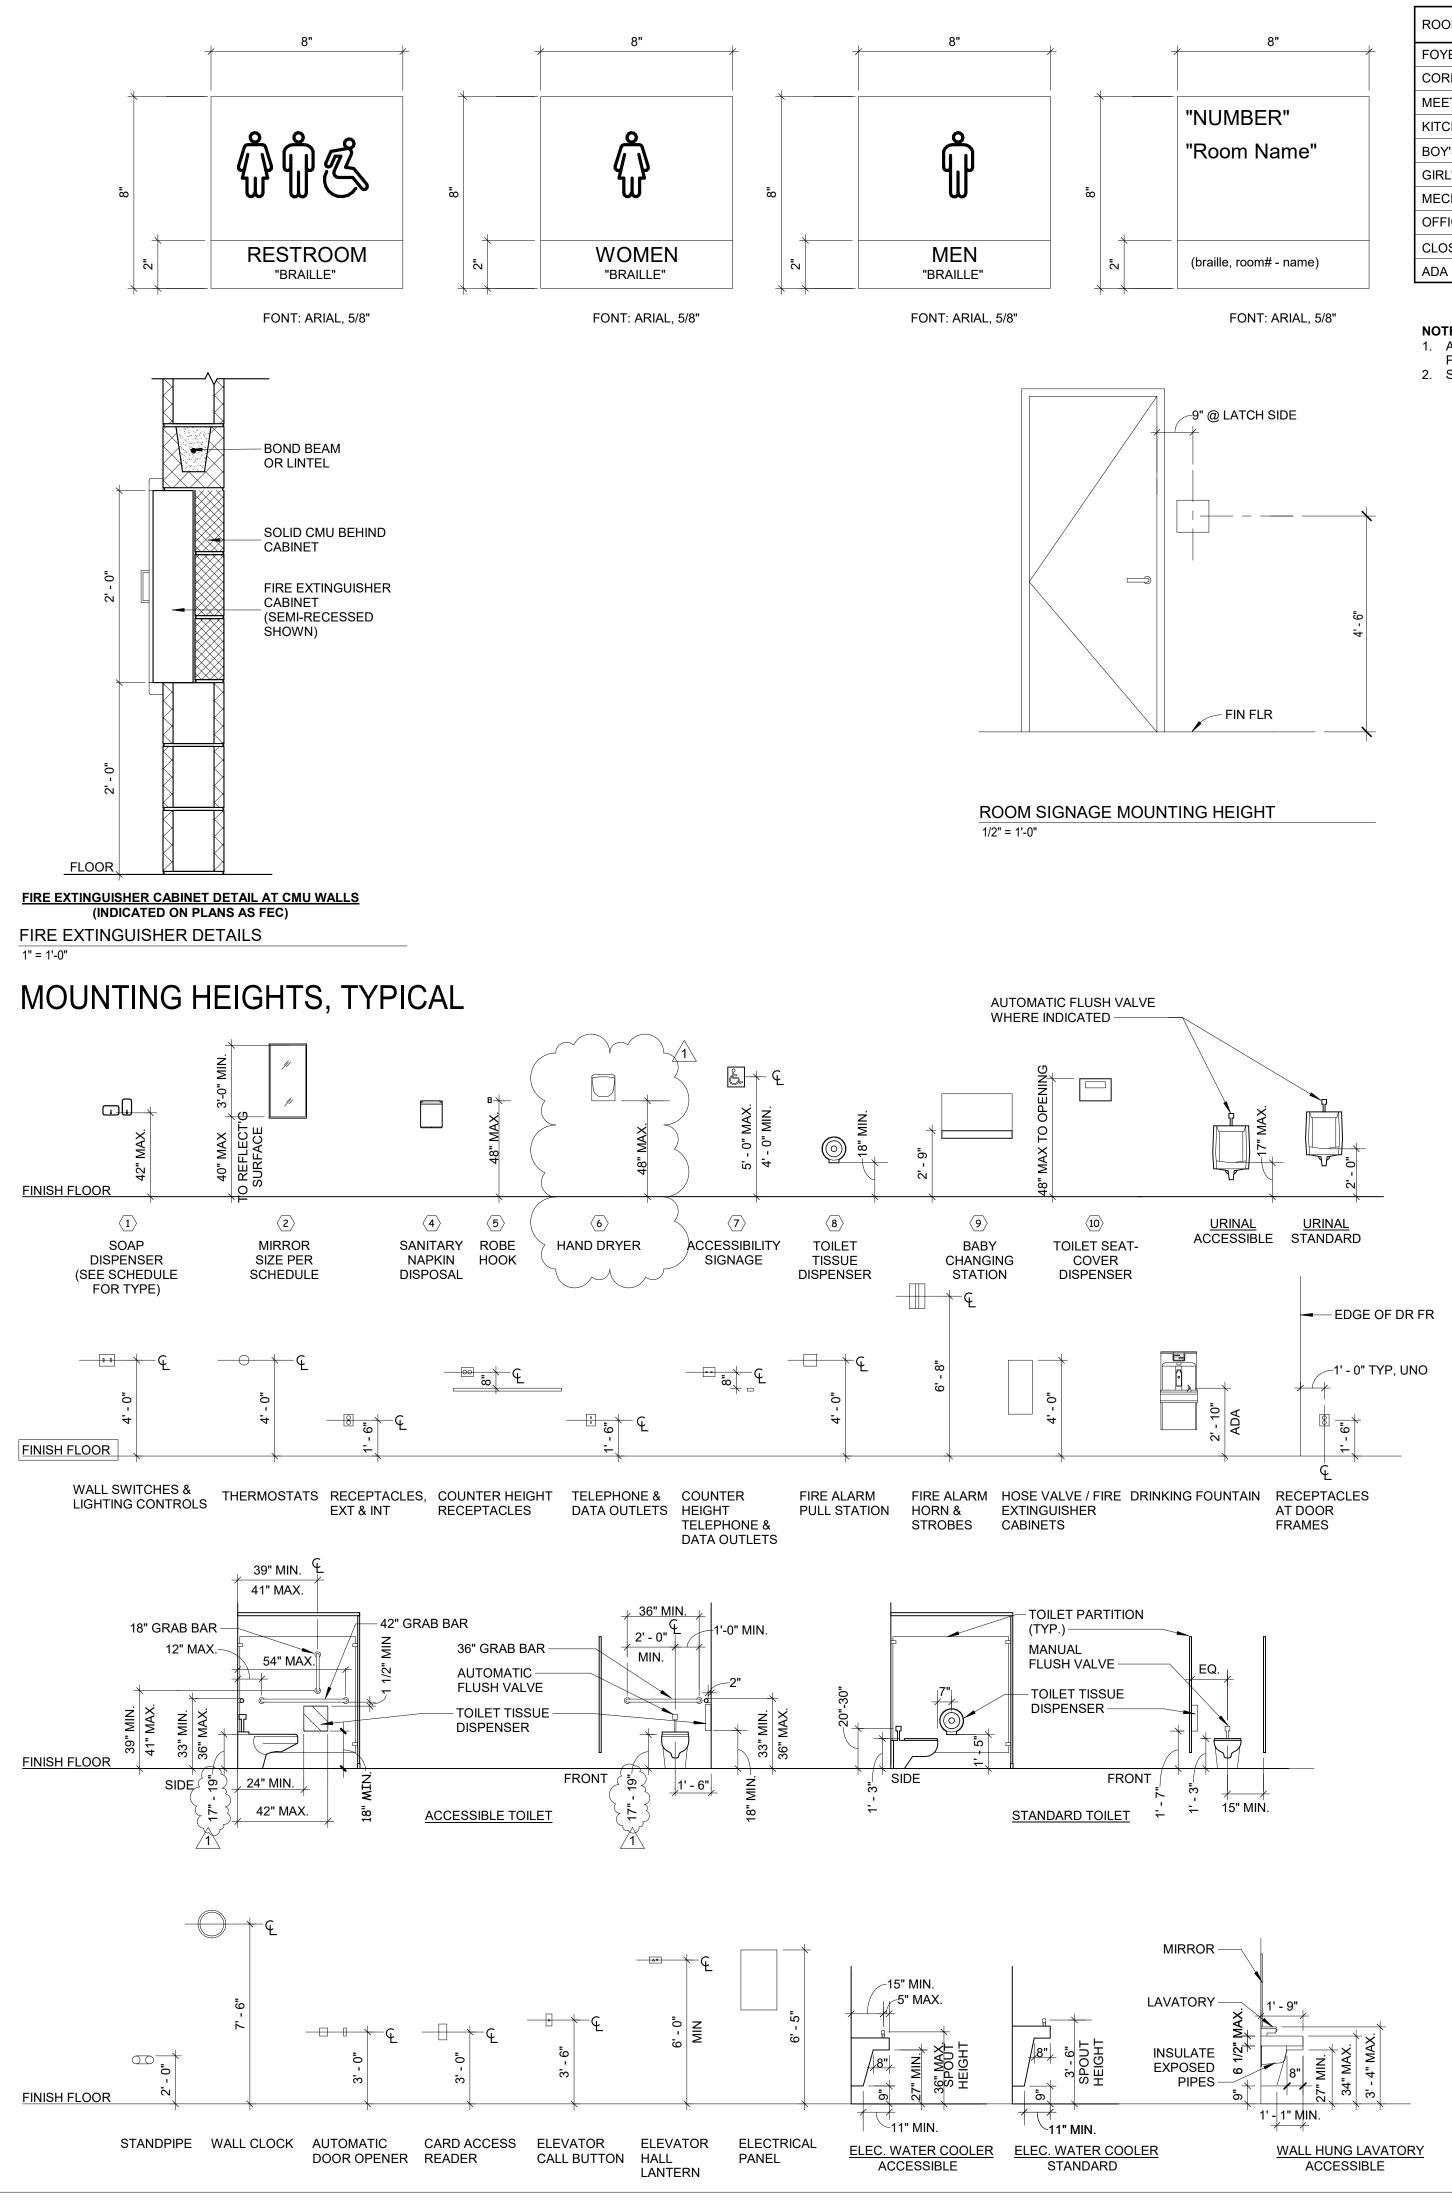

ROOM NAME	ROOM NO.
FOYER	1
CORRIDOR	2
MEETING/CONFERENCE ROOM	3
KITCHEN	4
BOY'S RESTROOM	5
GIRL'S RESTROOM	6
MECH ROOM	7
OFFICE	8
CLOSET	9
ADA UNISEX TOILET	10

NOTES: 1. ALL ROOM NUMBERS ARE TO BE REVIEWED BY PPR PRIOR TO FABRICATION AND INSTALLATION 2. SIGNS TO BE MECHANICALLY FASTENED

## ABBREVIATIONS

0	AT	СТ
А.В.	ANCHOR BOLT	CW
4.F.F.	ABOVE FINISHED FLOOR	
ACP	ACOUSTICAL CEILING	D
	PANEL	DBL
ADA	AMERICANS WITH	DET
	DISABILITIES ACT	DIA
	COMPLIANT	DIM
ADJ	ADJUSTABLE	DN
AHU	AIR HANDLING UNIT	DS
ALT	ALTERNATE	DW
ALUM	ALUMINUM	DWG
APPROX	APPROXIMATE	Dire
ARCH	ARCHITECTURAL	(E)
		EA
3.0.	BOTTOM OF	EIFS
3KHD	BULKHEAD	
BLDG	BUILDING	ELEC
BLKG	BLOCKING	EMER
BOT	BOTTOM	ENCL
BTWN	BETWEEN	EPS
BUR	BUILT UP ROOF	
		EQ
C.O.	CLEAN OUT	EQUIP
CAB	CABINET	ETR
CL	CENTER LINE	EXIST
CLG	CEILING	EXP JT
CLOS	CLOSET	EXT
CLR	CLEAR, CLEARANCE	
CM	CONSTRUCTION MANAGER	F.O.
CMU	CONCRETE MASONRY	FAB
	UNIT	FD
COL	COLUMN	FE(C)
	CONCRETE	
CONST	CONSTRUCTION	FIN
CONT	CONTINUOUS	FLR(G)
CONTR	CONTRACTOR	FLUOR


	CERAMIC TILE COLD WATER	FC
	DEEP, DEPTH DOUBLE DETAIL	F1 G/ G/
	DIAMETER DIMENSION	G/
	DOWN	G
	DOWN SPOUT	GI G\
	DISH WASHER DRAWING	G
	EXISTING	H H(
	EACH EXTERIOR INSULATION	H
	FINISH SYSTEM	H
	ELECTRICAL	H
	EMERGENCY	H
	ENCLOSURE EXPANDED	H. H
	POLYSTYRENE	
	EQUAL	H١
)	EQUIPMENT	H١
	EXISTING TO REMAIN	1.0
т	EXISTING EXPANSION JOINT	I.L IN
I	EXTERIOR	IN
	FACE OF	JA JT
	FABRICATED FLOOR DRAIN	JI
	FIRE EXTINGUISHER	L
	(CABINET)	LA
	FINISH	LE
i) 7	FLOOR(ING) FLUORESCENT	LL LT
`		LI

EXIT

(BRAILLE)

**EXIT IDENTIFICATION SIGN** 

( E )

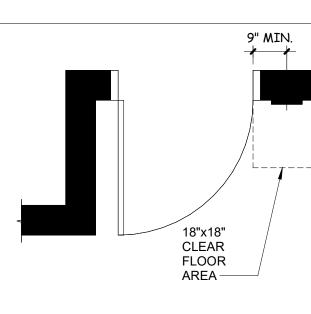


**INTERIOR SIGNAGE LOCATION NOTES:** 

- 1. ALL WALL MOUNTED SIGNAGE TO BE MOUNTED AT 48" MIN. AND 60" MAX. ABOVE THE CHARACTERS AND IN COMPLIANCE WITH 'ICC/ANSI A117.1-1998' REQUIREMENTS.

FOIC	FURNISHED BY OWNER, INSTALLED BY	MAS MATL	MASONRY MATERIAL	QT	QUARRY / QUA	
FT(G)	CONTRACTOR FOOT(ING)	MDF	MEDIUM DENSITY FIBERBOARD	R R&R	RADIUS REVISE AND R	
ga gal galv gc	GAUGE GALLON GALVANIZED GENERAL CONTRACTOR	MDO MECH MEMB MFR	MEDIUM DENSITY OVERLAY MECHANICAL MEMBRANE MANUFACTURER	rd f Ref f Reinf f Req'd f	RD REF REINF REQ'D	ROOF DRAIN REFRIGERATO REINFORCED REQUIRED
GL GWB GYP	GLASS / GLAZING GYPSUM WALL BOARD GYPSUM	MIN MISC MO MTD	MINIMUM MISCELLANEOUS MASONRY OPENING MOUNTED	rev RM RO RTU	REVISED, REV ROOM ROUGH OPENI ROOF TOP UNI	
H HDR	HIGH HEADER	MTL	METAL	SAN SC	SANITARY SOLID CORE	
HDWD HDWR HM	HARDWOOD HARDWARE HOLLOW METAL	(N) NIC NO.	NEW NOT IN CONTRACT NUMBER	SECT SG SGL	SECTION SEMI-GLOSS SINGLE	
HORIZ HT HVAC	HORIZONTAL HEIGHT HEATING VENTILATING &	NOM NTS	NOMINAL NOT TO SCALE	SHT SIM SPEC(S)	SHEET SIMILAR SPECIFICATIO	
HW HWH	AIR CONDITIONING HOT WATER HOT WATER HEATER	O.A. O.C. O.D.	OVERALL ON CENTER OUTSIDE DIAMETER	SQ SS STD	SQUARE STAINLESS ST STANDARD	
I.D. INSUL INT	INSIDE DIAMETER INSULATION INTERIOR	oh opng opp (HD)	OVERHEAD OPENING OPPOSITE (HAND)	STL STOR STRUCT	STEEL STORAGE STRUCTURAL	
JAN JT	JANITOR JOINT	PART PLAM	PARTITION PLASTIC LAMINATE	SVC SW	SERVICE STORM WATER	
L LAM	LONG, LENGTH LAMINATE	Plywd Pnl(G) Pr Pt	PLYWOOD PANEL(ING) PAIR PRESSURE TREATED	T T&G T.O.	TALL TONGUE & GR TOP OF	
LB(S) LLV LT(G)	POUND(S) LONG LEG VERTICAL LIGHT(ING)	PTD PVF	PRESSURE TREATED PAINTED POLYVINYLFLUORIDE	T.O. Tel Temp	TOP OF TELEPHONE TEMPORARY	

## ARCHITECTURAL GRAPHIC SYMBOLS

	COLUMN GRID LINE		WINDOW TAG
1 NUMBER		G2 —	PARTITION TYPE
	ELEVATION REFERENCE	$\langle ? \rangle$	DEMO KEYNOTE
SHEET NUMBER		$\langle \overline{?} \rangle$	KEYNOTE
DRAWING		1i 8'-0" A.F.F.	CEILING TYPE AND HEIGHT
1 NUMBER			CENTER LINE
1 A101 1 SHEET	REFERENCE		PROJECTION ABOVE / HIDDEN LINE
SIM			DIMENSIONS GIVEN IN FEET AND INCHES
	DETAIL REFERENCE		PLAN DIMENSION TO CENTER LINE
1 A101 SIM	BUILDING SECTION REFERENCE		PLAN DIMENSION TO FACE OF WALL OR OPENING
1 SIM A101	WALL SECTION REFERENCE		PLAN DIMENSION TO FACE OF FINISH
	ELEVATION MARKER		NORTH ARROW
<b>↔</b>	SPOT ELEVATION	<b>ROOM NAME</b>	ROOM IDENTIFICATION
100-00	DOOR NUMBER	AREA TYPE <u>AREA NAME</u> 150 SF	AREA IDENTIFICATION

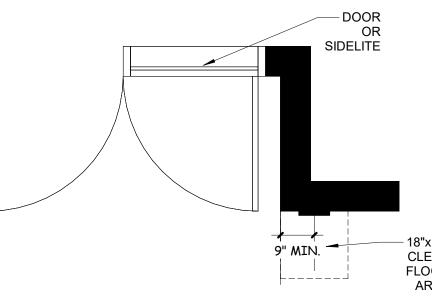

GENERAL SIGNAGE NOTES: 1. ALL SIGNAGE MOUNTED ON GLASS SHALL HAVE A FINISHED BACK PANEL

THE ADJACENT FLOOR OR GROUND SURFACE MEASURED FROM THE BASELINE OF

2. MOUNTING LOCATIONS SHOWN HERE ARE GENERAL CONDITIONS. SPECIAL CONDITIONS SHALL BE BROUGHT TO THE ATTENTION OF THE ARCHITECT FOR MOUNTING LOCATIONS.

SIGNAGE SHOWN HERE MAY NOT REPRESENT ALL TYPES REQUIRED FOR THIS PROJECT. REFER TO DRAWINGS AND SPECIFICATIONS FOR ADDITIONAL REQUIREMENTS


> ARRY / QUARTZ TILE DIUS VISE AND RESUBMIT OF DRAIN FRIGERATOR INFORCED QUIRED VISED, REVISION DM UGH OPENING OF TOP UNIT NITARY LID CORE CTION MI-GLOSS GLE ILAR ECIFICATION(S) UARE AINLESS STEEL ANDARD ORAGE RUCTURAL RVICE ORM WATER NGUE & GROOVE P OF EPHONE

TEMPORARY THICK THICK TYPICAL
UNDERCUT
UNDERCUT
UNLESS NOT OTHERWISE
UTILITY
VARIES
VINYL COMPO
VERTICAL
VERIFY IN FIE
WIDE
WITH
WITHOUT

PICAL DERCUT DERCUT LESS NOTED IERWISE ITY

RIES IYL COMPOSITION TILE RTICAL RIFY IN FIELD

ITHOUT WD WOOD WIN WINDOW WEIGHT WT

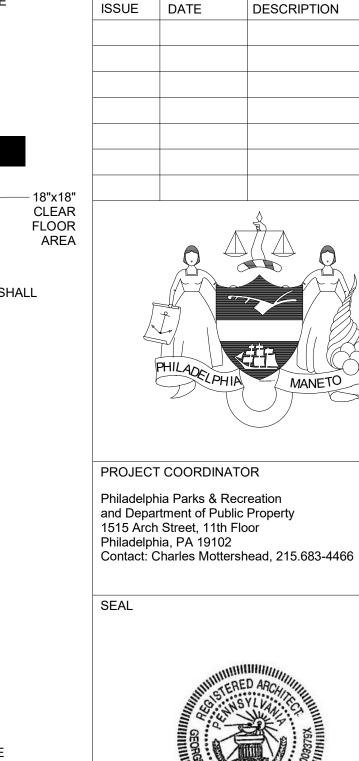

REVISIONS

PROJECT TEAM

ARCHITECT:

JOHNSON, MIRMIRAN & THOMPSON, INC 1600 MARKET ST, SUITE 520 PHILADELPHIA, PA 19103 267.256.0300

STRUCTURAL ENGINEER:

JOHNSON, MIRMIRAN & THOMPSON, INC 1600 MARKET ST, SUITE 520 PHILADELPHIA, PA 19103 267.256.0300

SYSTEMS ENGINEER:

JOHNSON, MIRMIRAN & THOMPSON, INC 1600 MARKET ST, SUITE 520 PHILADELPHIA, PA 19103 267.256.0300

MATERIA (SECTIO		IGNATION	S	
	EARTH		ROUGH CARPENTRY, SHIM	
	POROUS FILL		BATT INSULATION	
	CONCRETE		RIGID INSULATION	
	СМИ		PLASTER, SAND, GROUT, MORTAR	
	STONE		TILE	(
	STEEL		GYPSUM WALL BOARD	()
	ALUMINUM		GLASS	(
	WOOD		ACOUSTICAL CEILING TILE	
	PLYWOOD		PARTICLE BOARD / MDF	•

CITY OF PHILADELPHIA DEPARTMENT OF PUBLIC PR	OPERTY
1515 ARCH STREET 11TH FLOOR, ONE PARKWAY PHILADELPHIA, PENNSYLVAN	
PROJECT TITLE MILES MACK PLAYGROUND E RENOVATION	BUILDING
DRAWING TITLE	
SYMBOLS & ABBRE	VIATIONS
PROJECT NO.	DRAWING NO.
10-20-XXXX-01	
DATE: 02.07.2020	G0.2

3/6/20

#2

ndum

dden

SCALE: AS NOTED DRAWN BY: CHECKED BY: FILE: NOTE: ALL DIMENSIONS AND CONDITIONS SHALL BE VERIFIED BY THE CONTRACTOR AT THE

SITE BEFORE PROCEEDING WITH THE WORK.

## CODE SUMMARY

BUILDING CODE CONSTRUCTION CLASSIFICATION PRIMARY USE GROUP

TYPE V-B A-3

IEBC 2018, IBC 2018

## CODE ANALYSIS

### JURISDICTION:

- CITY: PHILADELPHIA, PENNSYLVANIA
- ADDRESS: DEPARTMENT OF LICENSES AND INSPECTIONS 1401 JOHN F. KENNEDY BOULEVARD
  - PHILADELPHIA, PA 19102 (215) 686-8686
  - WWW.PHILA.GOV

## LISTING OF APPLICABLE CODES

### PHILADELPHIA CODE

- THE PHILADELPHIA ADMINISTRATIVE CODE
- PHILADELPHIA BUILDING CODE PHILADELPHIA MECHANICAL CODE
- PHILADELPHIA ELECTRICAL CODE
- PHILADELPHIA PERFORMANCE CODE PHILADELPHIA ENERGY CONSERVATION CODE
- PHILADELPHIA FIRE CODE
- PHILADELPHIA FUEL GAS CODE PHILADELPHIA ZONING CODE
- PHILADELPHIA PLUMBING CODE

### INTERNATIONAL CODE COUNCIL

- 2018 INTERNATIONAL BUILDING CODE (IBC)
- 2012 INTERNATIONAL BUILDING CODE (CHAPTER 11) 2012 INTERNATIONAL BUILDING CODE (APPENDIX E)
- 2018 ICC A117.1
- 2018 INTERNATIONAL MECHANICAL CODE 2018 INTERNATIONAL ENERGY CONSERVATION CODE (IECC)
- 2018 INTERNATIONAL FUEL GAS CODE
- 2018 ICC PERFORMANCE CODE
- AMERICANS WITH DISABILITIES ACT ACCESSIBILITY GUIDELINES (ADAAG)
- STANDARD FOR THE INSTALLATION OF SPRINKLER SYSTEMS (NFPA-13)

### USE AND OCCUPANCY CLASSIFICATION (IBC CHAPTER 3, SECTION 304.1):

PRIMARY USE: A-3 (IBC SECTION 303.4)

IEBC 2018

### SECTION 603, ALTERATION—LEVEL 2

603.1 SCOPE. INCLUDE THE RECONFIGURATION OF SPACE, THE ADDITION OR ELIMINATION OF ANY DOOR OR WINDOW, THE RECONFIGURATION OR EXTENSION OF ANY SYSTEM, OR THE INSTALLATION OF ANY ADDITIONAL EQUIPMENT.

### **GENERAL BUILDING HEIGHTS AND AREAS (IBC CHAPTER 5):**

ALLOWABLE BUILDING HEIGHT AND AREAS:

- TYPE VB (IBC SECTION 503) - HEIGHT: 40 FEET; AREA: 6,000 SF

EXISTING BUILDING HEIGHT AND AREAS:

- NO. OF EXISTING STORIES = 1 STORY

- MAXIMUM BUILDING HEIGHT = 15'-0" - BUILDING SQUARE FOOTAGE = 1,781 SF

## TYPES OF CONSTRUCTION (IBC CHAPTER 6):

- CONSTRUCTION TYPE 5B (IBC SECTION 602.2)

- 602.5 TYPE 5B IS ANY TYPE OF CONSTRUCTION IN WHICH THE STRUCTURAL ELEMENTS, EXTERIOR WALLS AND INTERIOR WALLS ARE OF ANY MATERIALS PERMITTED BY THIS CODE.

- FIRE-RESISTANCE RATING REQUIREMENTS FOR BUILDING ELEMENTS (HOURS) (TABLE 601) =

PRIMARY STRUCTURAL FRAME:	0 HOURS
EXTERIOR BEARING WALLS:	0 HOURS
INTERIOR BEARING WALLS:	0 HOURS
EXTERIOR NONBEARING WALLS AND PARTITIONS:	0 HOURS
INTERIOR NONBEARING WALLS AND PARTITIONS:	0 HOURS
FLOOR CONSTRUCTION AND SECONDARY MEMBERS:	0 HOURS
ROOF CONSTRUCTION AND SECONDARY MEMBERS:	0 HOURS

FIRE RESISTANCE RATING OF EXTERIOR WALLS BASED ON FIRE SEPARATION DISTANCE (TABLE 602)=

-EXTERIOR WALLS < 5 =	1 HOUR	
-EXTERIOR WALLS $5 \le X < 10 =$	1 HOUR	
-EXTERIOR WALLS $10 \le X < 30 =$	0 HOUR	
-EXTERIOR WALLS X ≥ 30 =	0 HOUR	

THIS IS A FREE STANDING BUILDING WITH NO OTHER BUILDINGS CLOSER THAN 10'

### MEANS OF EGRESS (IBC CHAPTER 10): 1

**CEILING HEIGHT:** 

- THE MEANS OF EGRESS SHALL HAVE A CEILING HEIGHT OF NOT LESS THAN 7 FEET 6 INCHES (SECTION 1003.2). BUILDING IS IN COMPLIANCE

### HEADROOM:

- PROTRUDING OBJECTS ARE PERMITTED TO EXTEND BELOW THE MINIMUM CEILING HEIGHT REQUIRED BY SECTION 1003.2 PROVIDED A MINIMUM HEADROOM OF 80 INCHES SHALL BE PROVIDED FOR ANY WALKING SURFACE, INCLUDING WALKS, CORRIDORS, AISLES AND PASSAGEWAYS. NOT MORE THAN 50 PERCENT OF THE CEILING AREA OF A MEANS OF EGRESS SHALL BE REDUCED IN HEIGHT BY PROTRUDING OBJECTS (SECTION 1003.3.1). BUILDING IS IN COMPLIANCE

### HORIZONTAL PROJECTIONS:

- STRUCTURAL ELEMENTS, FIXTURES OR FURNISHINGS SHALL NOT PROJECT HORIZONTALLY FROM EITHER SIDE MORE THAN 4 INCHES OVER ANY WALKING SURFACE BETWEEN THE HEIGHTS OF 27 INCHES AND 80 INCHES ABOVE THE WALKING SURFACE (SECTION 1003.3.3). **BUILDING IS IN COMPLIANCE** 

CLEAR WIDTH:

- PROTRUDING OBJECTS SHALL NOT REDUCE THE MINIMUM CLEAR WITH OF ACCESSIBLE ROUTES (SECTION 1003.3.4).

### OCCUPANT LOAD (IBC SECTION 1004, IBC TABLE 1004.5):

- ACCESSORY STORAGE AREAS

BUILDING IS IN COMPLIANCE

- BUSINESS AREAS: - ASSEMBLY AREAS:

- TOTAL OCCUPANTS:

, MECHANICAL EQUIPMENT ROOM: 300 GROSS / OCCUPANT = 2 OCCUPANTS 150 GROSS / OCCUPANT = 1 OCCUPANTS 5 NET / OCCUPANT

- = 167 OCCUPANTS
- = 170 OCCUPANTS

### LIFE SAFETY LEGEND

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### EGRESS WIDTH (IBC SECTION 1005.3.1-1005.3.2):

### - 0.3 INCHES PER OCCUPANT FOR STAIRWAYS

### DOOR ENCROACHMENT (IBC SECTION 1005.7):

PROJECT INTO THE REQUIRED WIDTH A MAXIMUM OF 1 1/2 INCHES ON EACH SIDE.

### NUMBER OF EXITS AND CONTINUITY (IBC SECTION 1006.3.2):

## SIZE OF DOORS (IBC SECTION 1008.1.1):

EXIT ACCESS (IBC SECTION 1016):

1. EGRESS FROM A ROOM OR SPACE SHALL NOT PASS THROUGH ADJOINING OR INTERVENING ROOMS OR AREAS, EXCEPT WHERE SUCH ADJOINING ROOMS OR AREAS AND THE AREA SERVED ARE ACCESSORY TO ONE OR THE OTHER, ARE NOT A GROUP H OCCUPANCY AND PROVIDE A DISCERNIBLE PATH OF EGRESS TRAVEL TO AN EXIT.


PURPOSES.

## ACCORDANCE WITH SECTION 903.3.1.1 (TABLE 1014.3)

EXIT ACCESS TRAVEL DISTANCE (IBC SECTION 1017): ACCORDANCE WITH SECTION 903.3.1.1 (TABLE 1017.2)

## CORRIDORS (IBC SECTION 1020) - TABLE 1020.1:

- THE MINIMUM CORRIDOR WIDTH SHALL BE 44". -1 HR FIRE RESISTANCE RATING IN CORRIDORS, FOR OCCUPANT LOAD GREATER THAN 30. (TABLE 1020.1)

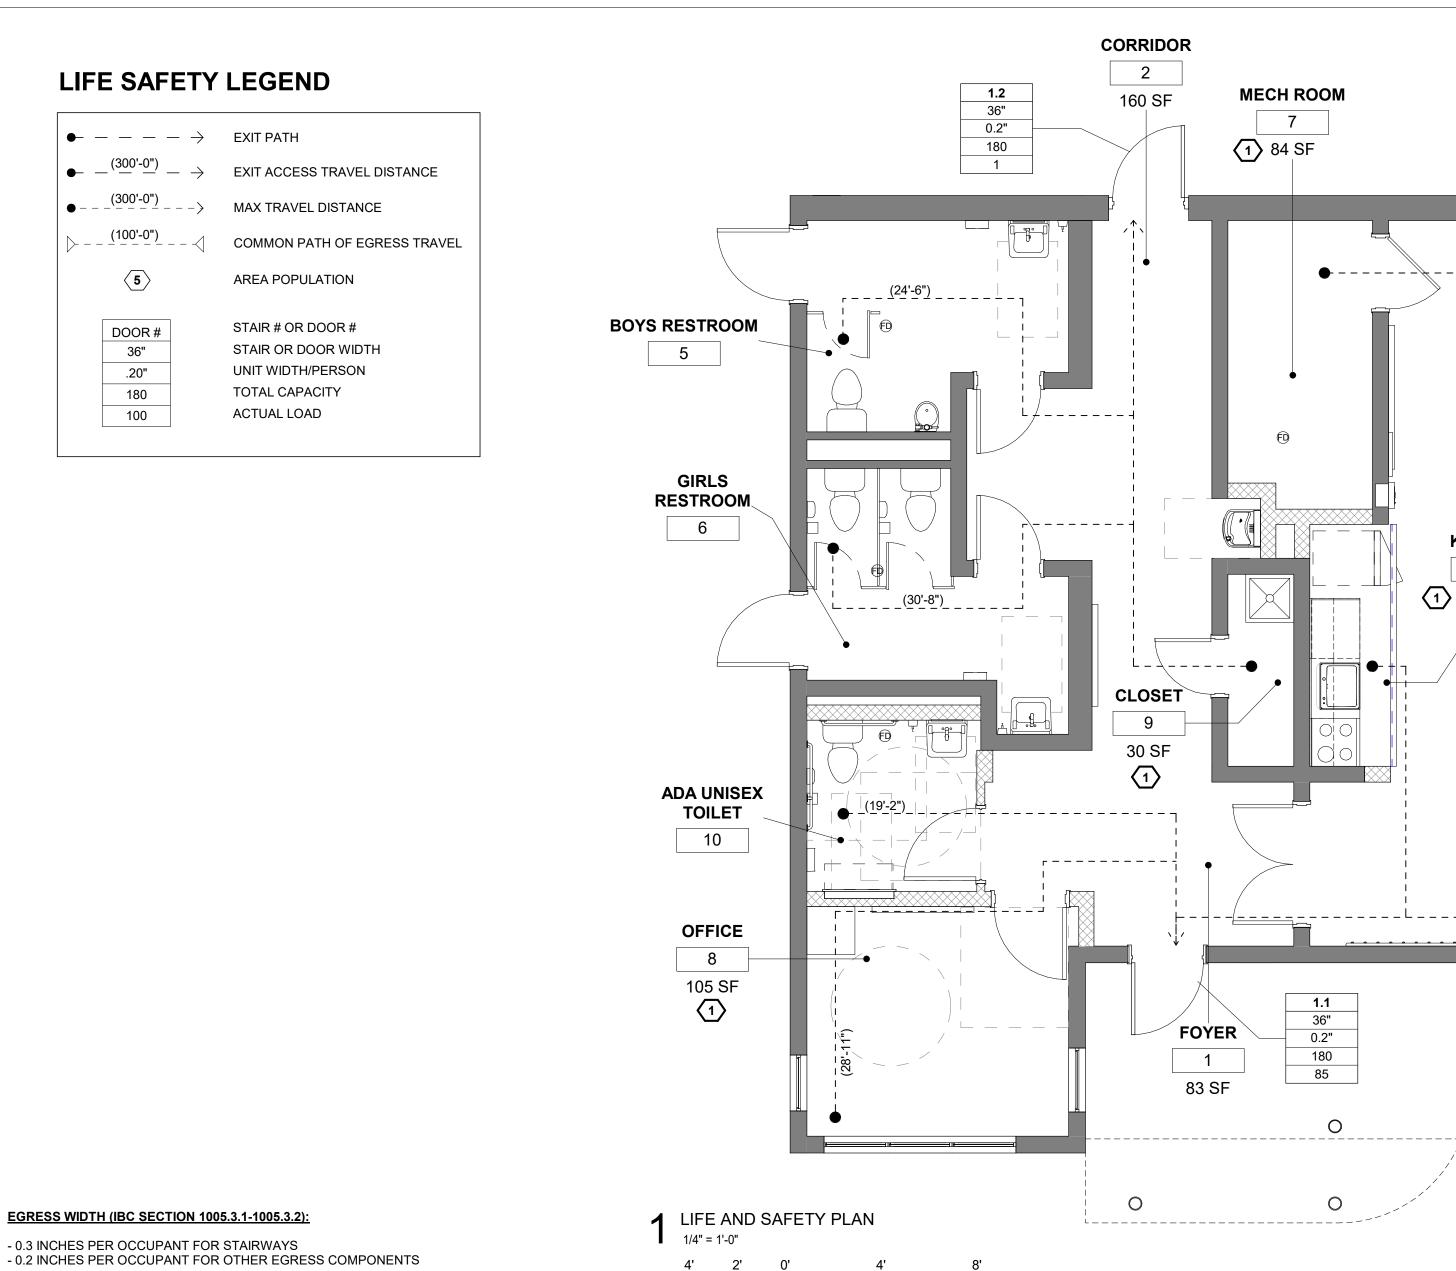

- DOORS , WHEN FULLY OPENED, AND HANDRAILS SHALL NOT REDUCE THE REQUIRED MEANS OF EGRESS WIDTH BY MORE THAN 7 INCHES. DOORS IN ANY POSITION SHALL NOT REDUCE THE REQUIRED WIDTH BY MORE THAN ONE-HALF. OTHER NONSTRUCTURAL PROJECTIONS SUCH AS TRIM AND SIMILAR DECORATIVE FEATURES SHALL BE PERMITTED TO

- THE MINIMUM NUMBER OF EXITS FOR OCCUPANT LOAD = 2 EXITS (OCCUPANT LOAD 1 -500) (TABLE 1021.1)

- THE MINIMUM WIDTH OF EACH DOOR OPENING SHALL BE SUFFICIENT FOR THE OCCUPANT LOAD THEREOF AND SHALL PROVIDE A CLEAR WIDTH OF 32 INCHES. THE MAXIMUM WIDTH OF A SWINGING DOOR LEAF SHALL BE 48 INCHES NOMINAL. THE HEIGHT OF DOOR OPENINGS SHALL NOT BE LESS THAN 80 INCHES.

- EGRESS THROUGH INTERVENING SPACES SHALL COMPLY WITH THIS SECTION (1014.2):

2. AN EXIT ACCESS SHALL NOT PASS THROUGH A ROOM THAT CAN BE LOCKED TO PREVENT EGRESS.


3. EGRESS SHALL NOT PASS THROUGH KITCHENS, STORAGE ROOMS, CLOSETS OR SPACES USED FOR SIMILAR

- COMMON PATH OF EGRESS TRAVEL SHALL NOT EXCEED 100 FEET IN B OCCUPANCY WITH SPRINKLER SYSTEM IN

- EXIT ACCESS TRAVEL DISTANCE SHALL NOT EXCEED 200 FEET IN A OCCUPANCY WITHOUT A SPRINKLER SYSTEM IN

- WHERE MORE THAN ONE EXIT OR EXIT ACCESS DOORWAY IS REQUIRED, THE EXIT ACCESS SHALL BE ARRANGED SUCH THAT THERE ARE NO DEAD ENDS IN CORRIDORS MORE THAN 20 FEET IN LENGTH (SECTION 1018.4).

	3.1			REVISION	IS DATE	DESCRIPTION
MEETING/CONFERENCE ROOM 3 (166) 825 NET SF	36" 0.2" 180 84					
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KITCHEN 4 33 SF				Philadelph and Depar 1515 Arch Philadelph	COORDINATC ia Parks & Recr tment of Public Street, 11th Flo ia, PA 19102 ara Nordstrom,	reation Property oor
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DEFINITIONS: REMOVE: REMOVE AND LEGALLY DISPOSE OF ITEMS EXCEPT THOSE INDICATED TO BE REINSTALLED, SALVAGED, OR TO REMAIN THE OWNER'S PROPERT EXISTING TO REMAIN: PROTECT CONSTRUCTION INDICATED TO REMAIN AGAINST DAMAGE AND SOILING DURING DEMOLITION AND NEW CONSTRUCTION.

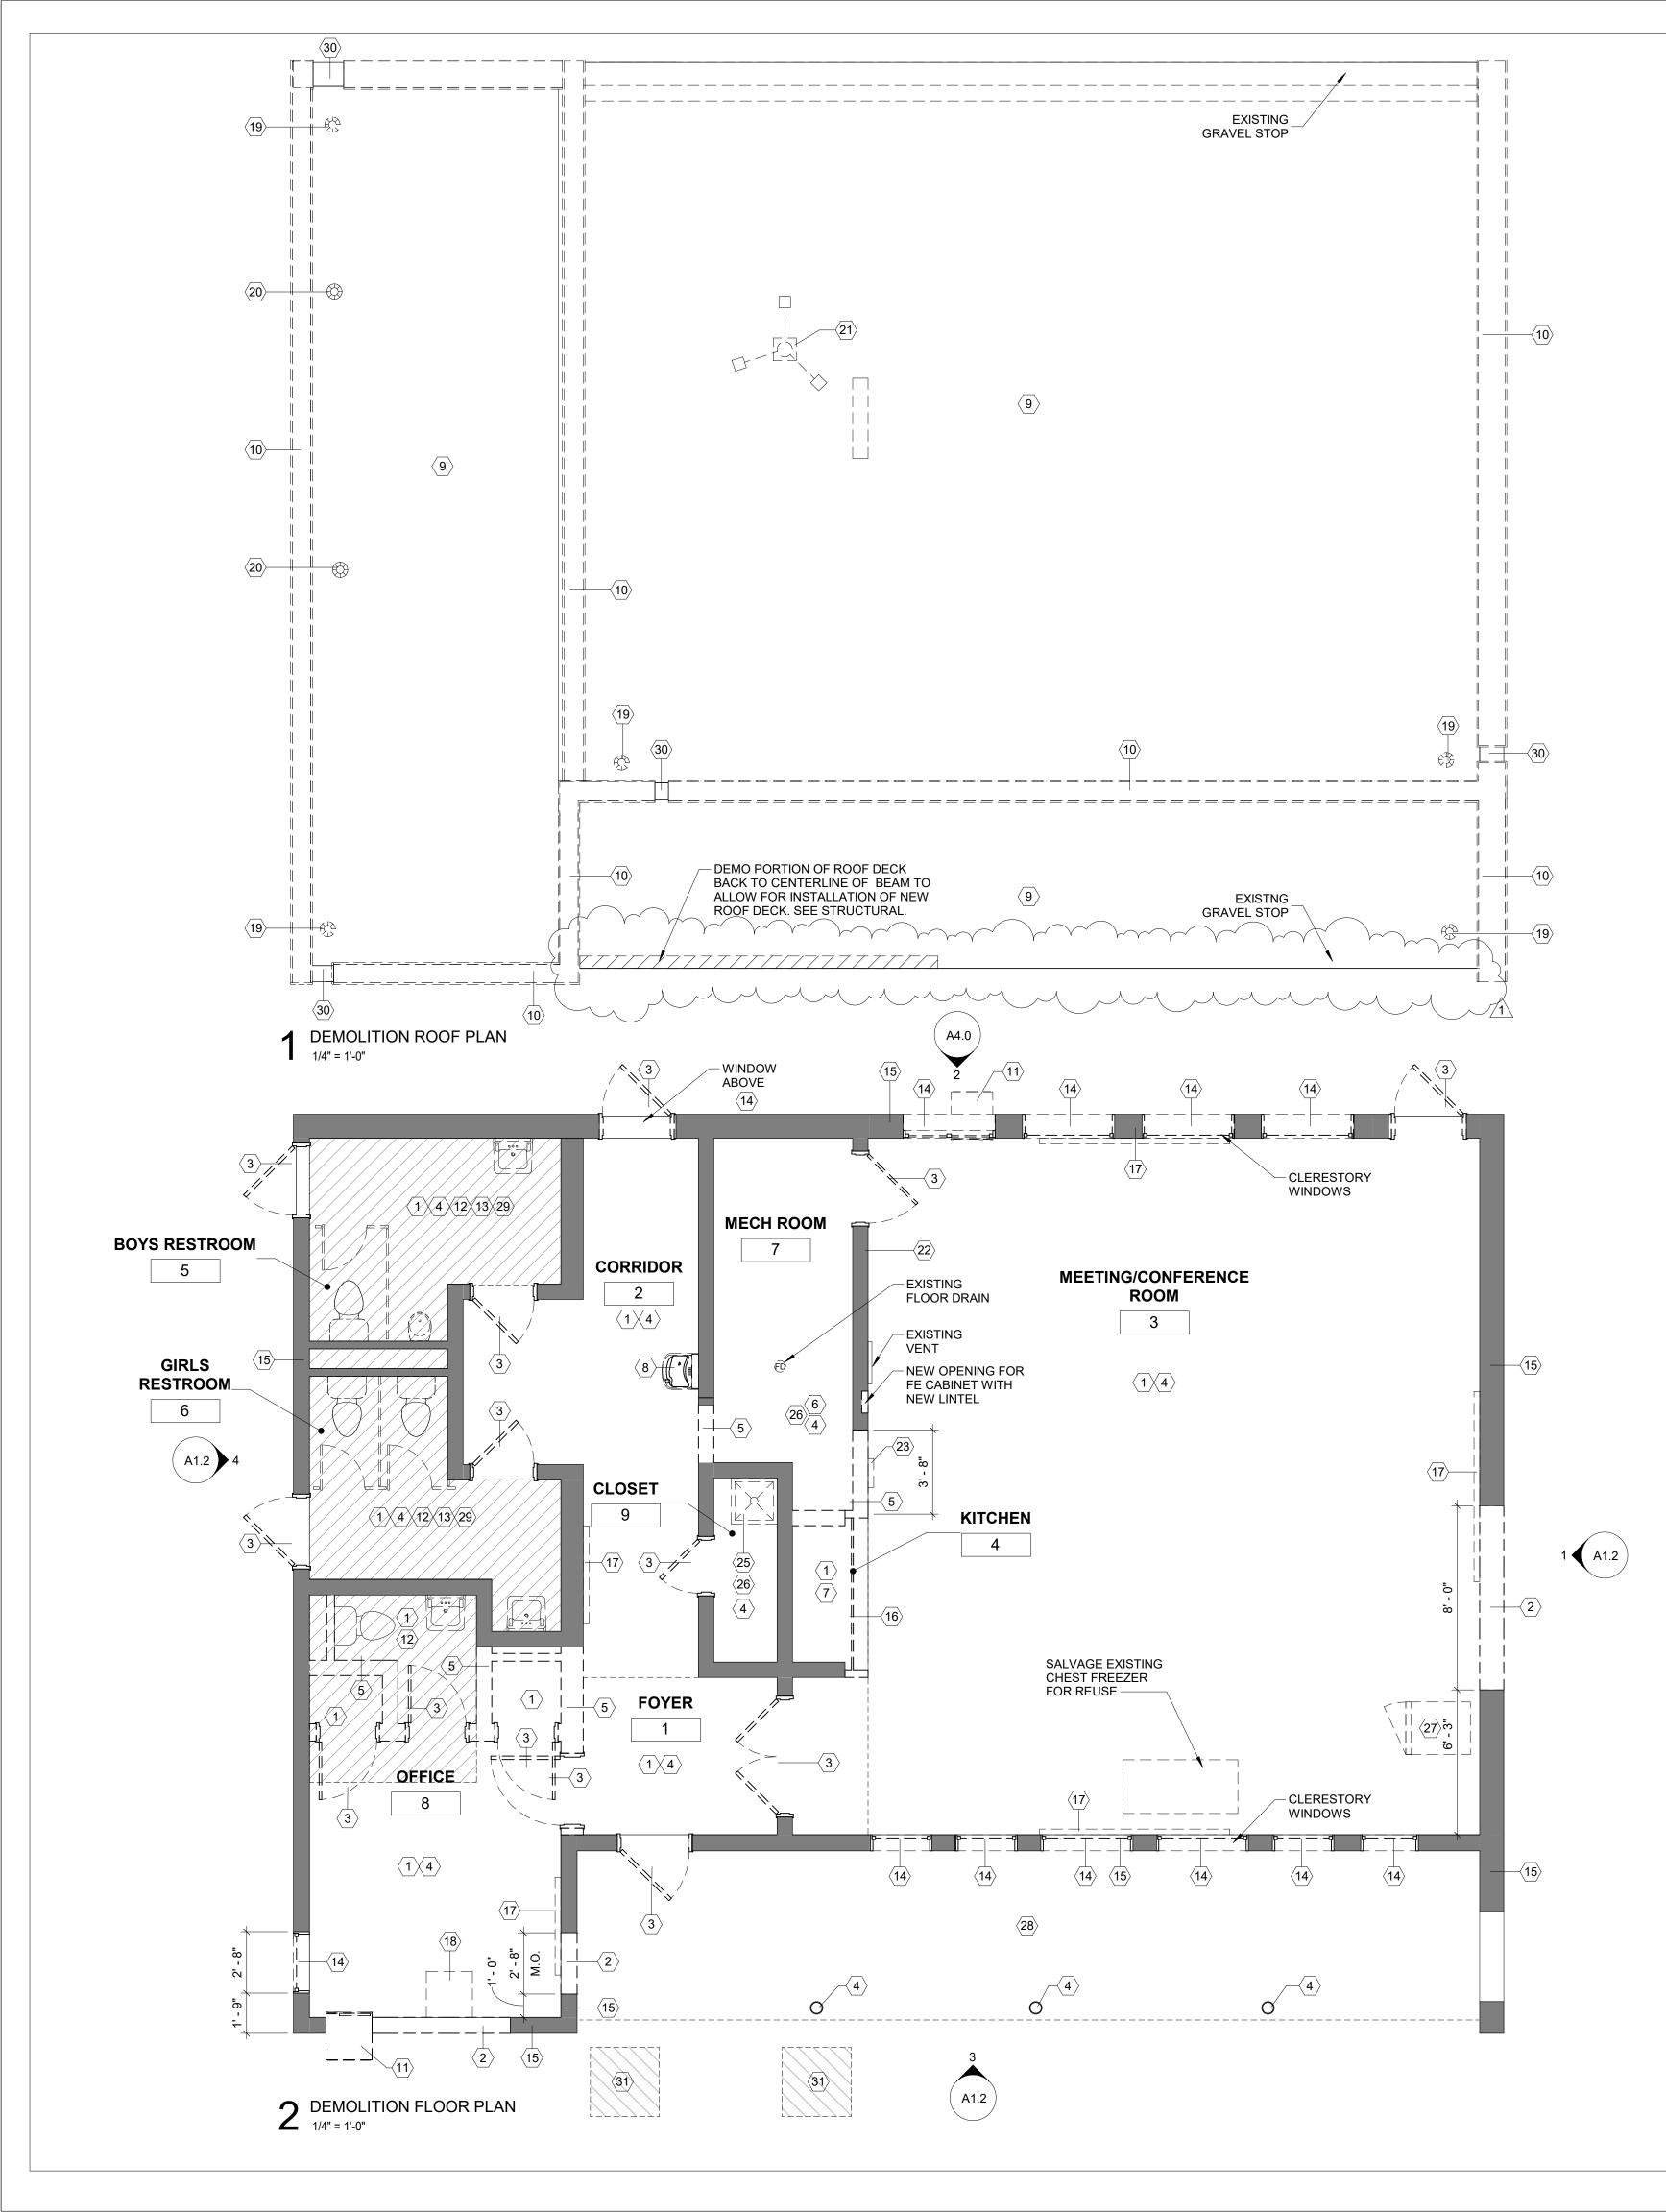GENERAL CONTRACTOR SHALL INCLUDE COSTS FOR ALL DEMOLITION INCLUDING BUT NOT NECESSARILY LIMITED TO THE FOLLOWING:

- ELECTRICAL, AND PLUMBING DRAWINGS FOR ADDITIONAL INFORMATION.
- ALL ITEMS DESIGNATED AS 'SALVAGED' SHALL BE COORDINATED WITH OWNER.
- LOCATIONS.
- THE ARCHITECT, IN WRITING, PRIOR TO PROCEEDING WITH DEMOLITION.
- TOOTH IN NEW MASONRY CONSTRUCTION TO MATCH ADJACENT COURSING. PARTITION OR ANY OTHER STRUCTURAL ELEMENT.
- 9. REMOVE ALL EXISTING LIGHT FIXTURES, EMERGENCY LIGHT FIXTURES, AND EXIT SIGNS AND SET ASIDE FOR REUSE. 10. PREP ALL INTERIOR WALL AND CEILING SURFACES FOR PAINT INCLUDING UNDERSIDE OF EXPOSED ROOF DECK AND ROOF TRUSSES.
- 11. PREP EXTERIOR COLUMNS FOR PAINT. 12. PREP UNDERSIDE OF EXERIOR ROOF ENTRY CANOPY AND PREP FOR PAINT.
- MECHANICAL, ELECTRICAL, AND PLUMBING DRAWINGS.

## KEYNOTE

1	REMOVE EXISTING FLOORING AND BASE DO' SCHEDULED FINISH.
2	REMOVE PORTIONS OF EXISTING WALL TO IN TO RECEIVE SCHEDULED FINISH.
3	REMOVE EXISTING DOOR, FRAME AND ASSO DOOR OPENINGS AT HEAD, JAMB & SILLS. SE MASONRY OPENING SIZE.
4	PREP EXISTING INTERIOR CMU WALLS & STE
5	REMOVE EXISTING MASONRY WALL FROM FI
6	REMOVE EXISTING MECHANICAL EQUIPMEN
7	REMOVE EXISTING KITCHEN CABINETS, EQU
8	REMOVE EXISTING DRINKING FOUNTAIN AND
9	REMOVE ROOFING MATERIAL AND INSULATION PREPARE ROOF FOR NEW ROOFING MATERI AND NEW WORK.
10	REMOVE EXISTING METAL COPING AND FLAS
11	REMOVE EXISTING AIR CONDITIONING UNIT.
12	REMOVE ALL EXISTING PLUMBING FIXTURES
13	REMOVE EXISTING TOILET PARTITION AND A
14	REMOVE EXISTING WINDOW, FRAME, SECUR REPAIR TO WINDOW OPENINGS AT HEAD, JA
15	REMOVE AND REPLACE EXISTING COMPRES
16	REMOVE EXISTING ROLL DOWN GATE, TRAC COORDINATE WITH STRUCTURAL. PREP FOR
17	REMOVE EXISTING BULLETIN BOARD.
18	EXISTING SERVER ENCLOSURE TO BE REMO
19	EXISTING ROOF DRAIN TO BE REMOVED, V.I.
20	EXISTING VENT AND VENT CAP TO REMAIN.
21	REMOVE EXISTING FLUE AND SUPPORTS.
22	REMOVE EXISTING COAT HOOKS.
23	DEMOLISH EXISTING FE CABINET.
25	REMOVE EXISTING UTILITY SINK AND ASSOC
26	PATCH AND REPAIR AFFECTED SURFACES A
27	SALVAGE REFRIGERATOR FOR REUSE.
28	PREPARE CONCRETE SURFACE FOR NEW PA
29	DEMOLISH EXISTING CONCRETE SLAB FOR N
30	DEMO EXISTING SCUPPERS, TYP.
31	REMOVE SLAB FOR NEW FOUNDATIONS. CO

### **GENERAL DEMO NOTES**

1. DEMOLITION WORK INCLUDES, BUT NOT LIMITED TO THE WORK INDICATED, AS COORDINATED WITH WORK OF ALL OTHER TRADES, AS INDICATED ELSEWHERE, AND AS REQUIRED TO ACCOMMODATE CONSTRUCTION. ALL DEMOLITION REQUIRED SHALL BE INCLUDED IN EACH CONTRACTOR'S BASE TO PERFORM AND COMPLETE CONSTRUCTION UNLESS OTHERWISE INDICATED. REFER TO ASBESTOS ABATEMENT REPORT AND MECHANICAL,

3. ITEMS TO BE SALVAGED, RELOCATED, OR REINSTALLED SHALL BE AS INDICATED. SPECIAL CARE IS TO BE TAKEN SO AS NOT TO DAMAGE THESE ITEMS THE G.C. SHALL COORDINATE THE STORAGE OF ALL SALVAGED ITEMS TO BE EITHER RELOCATED OR REINSTALLED WITH THE OWNER. 4. LOCATIONS AND/OR ELEVATIONS OF EXISTING ITEMS, AS SHOWN ON THE DRAWINGS, ARE APPROXIMATE. RESPECTIVE TRADES SHALL FIELD VERIFY

5. WHEN A NEW WALL, CEILING, ROOF, OR FLOOR ASSEMBLY IS INDICATED WHERE AN EXISTING WALL, CEILING, ROOF, OR FLOOR ASSEMBLY EXISTS, TH EXISTING SHALL BE COMPLETELY REMOVED, WITH ASSOCIATED UTILITIES REMOVED AND CAPPED BEHIND THE SURFACE OF THE REMAINING SUBSTR UNLESS NOTED OTHERWISE. ALL DEPRESSIONS, INDENTS, OR PROTRUSIONS ETC.. LEFT AFTER THE REMOVAL OF ITEMS WHICH WILL INTERFERE WITH THE CONSTRUCTION SHALL BE REPAIRED, REPLACE OR REMOVED TO PROVIDE A SMOOTH TRANSITION BETWEEN NEW AND OLD SURFACES. 6. THE CONTRACTORS SHALL VERIFY ALL CONDITIONS PRIOR TO COMMENCING DEMOLITION. SHOULD QUESTIONS ARISE, THE CONTRACTOR SHALL NOT . WHERE OPENINGS ARE INDICATED TO BE MADE IN EXISTING MASONRY WALLS, OR EXISTING OPENINGS ARE TO BE INFILLED, THE CONTRACTOR SHALL

8. CONTRACTORS ARE RESPONSIBLE FOR SHORING, BRACING, AND UNDERPINNING RELATED TO THE DEMOLITION, REMOVAL OR CUTTING OF ANY WALL

13. OPEN AND PARTIALLY DEMO WALLS, CEILINGS, AND FLOORS AS REQUIRED FOR MECHNICAL, ELECTRICAL, AND PLUMBING WORK. COORDINATE WITH

DEMOLITION PLAN KEYNOTES

1 REMOVE EXISTING FLOORING AND BASE DOWN TO SOUND SUBSTRATE. PATCH AND REPAIR AFFECTED SURFACES AND PREPARE TO RECEIVE

INSTALL OPENING SCHEDULED. PATCH AND REPAIR AFFECTED ADJACENT SURFACES AND PREPARE

OCIATED HARDWARE. PREPARE OPENING FOR NEW DOOR. ALLOW FOR MISCELLANEOUS REPAIR TO SEE STRUCTURAL DRAWINGS FOR REINFORCING REQUIREMENTS. SEE DOOR SCHEDULE FOR NEW EEL COLUMNS TO RECEIVE NEW PAINT, TYP. AT ALL LOCATIONS.

FLOOR TO UNDERSIDE OF STRUCTURE.

NT. SEE MECHANICAL DRAWINGS. UIPMENT, APPLIANCES & COUNTERTOP. COORDINATE WITH PLUMBING AND ELECTRICAL DRAWINGS. ID ASSOCIATED HARDWARE. COORDINATE WITH PLUMBING DRAWINGS. ION DOWN TO ROOF SUBSTRATE. ALLOW FOR MISC REPAIR TO ROOF SUBSTRATE AS NEEDED.

RIAL. CONTRACTOR SHALL PROTECT EXISTING ROOF ASSESMBLIES FROM DAMAGE DURING DEMOLTIO ASHING, TYP. ENTIRE ROOF.

ALLOW FOR MISC REPAIR TO OPENINGS AT HEAD, JAMB, AND SILLS.

S IN THEIR ENTIRETY. COORDINATE WITH PLUMBING DRAWINGS. ALL ASSOCIATED HARDWARE. JRITY SCREEN, AND ASSOCIATED HARDWARE. PREPARE OPENING FOR NEW WINDOW. ALLOW FOR MIS JAMB & SILLS. SEE WINDOW SCHEDULE.

SSIVE FILLER AT BOTTOM OF EXTERIOR WALL & CONCRETE PAD. CK AND ALL ASSOCIATED HARDWARE. ENLARGE OPENING WITH NEW LINTEL FOR NEW KITCHENETTE R NEW ROLL DOWN DOOR.

OVED AND RELOCATED BY OWNER


CIATED PLUIMBING. SEE PLUMBING DRAWINGS. AND PREPARE TO RECEIVE SCHEDULED FINISH.


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NEW FLOOR DRAINS AND PIPING. SEE STRUCTURAL DRAWINGS.

OORDINATE WITH STRUCTURAL DRAWINGS.

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- 12. PREP UNDERSIDE OF EXERIOR ROOF ENTRY CANOPY AND PREP FOR PAINT. MECHANICAL, ELECTRICAL, AND PLUMBING DRAWINGS.

KEYNOTE	
1	REMOVE EXISTING LIGHT FIXTURES AND SET A FOR MORE DETAIL. PATCH AND REPAIR AFFEC
2	REMOVE EXISTING CEILING ASSEMBLY AND AL ADDITIONAL INFORMATION. PATCH AND REPAIL
3	REMOVE EXISTING GWB SOFFIT AS NEEDED FO
4	DEMOVE EVISTING CEILING AS DECITIDED FOR
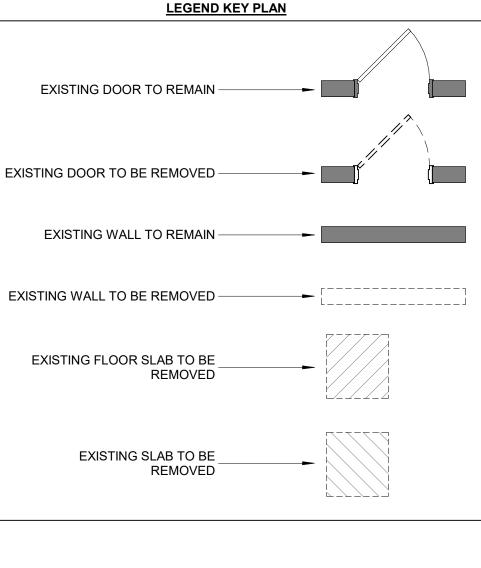
### **GENERAL DEMO NOTES**

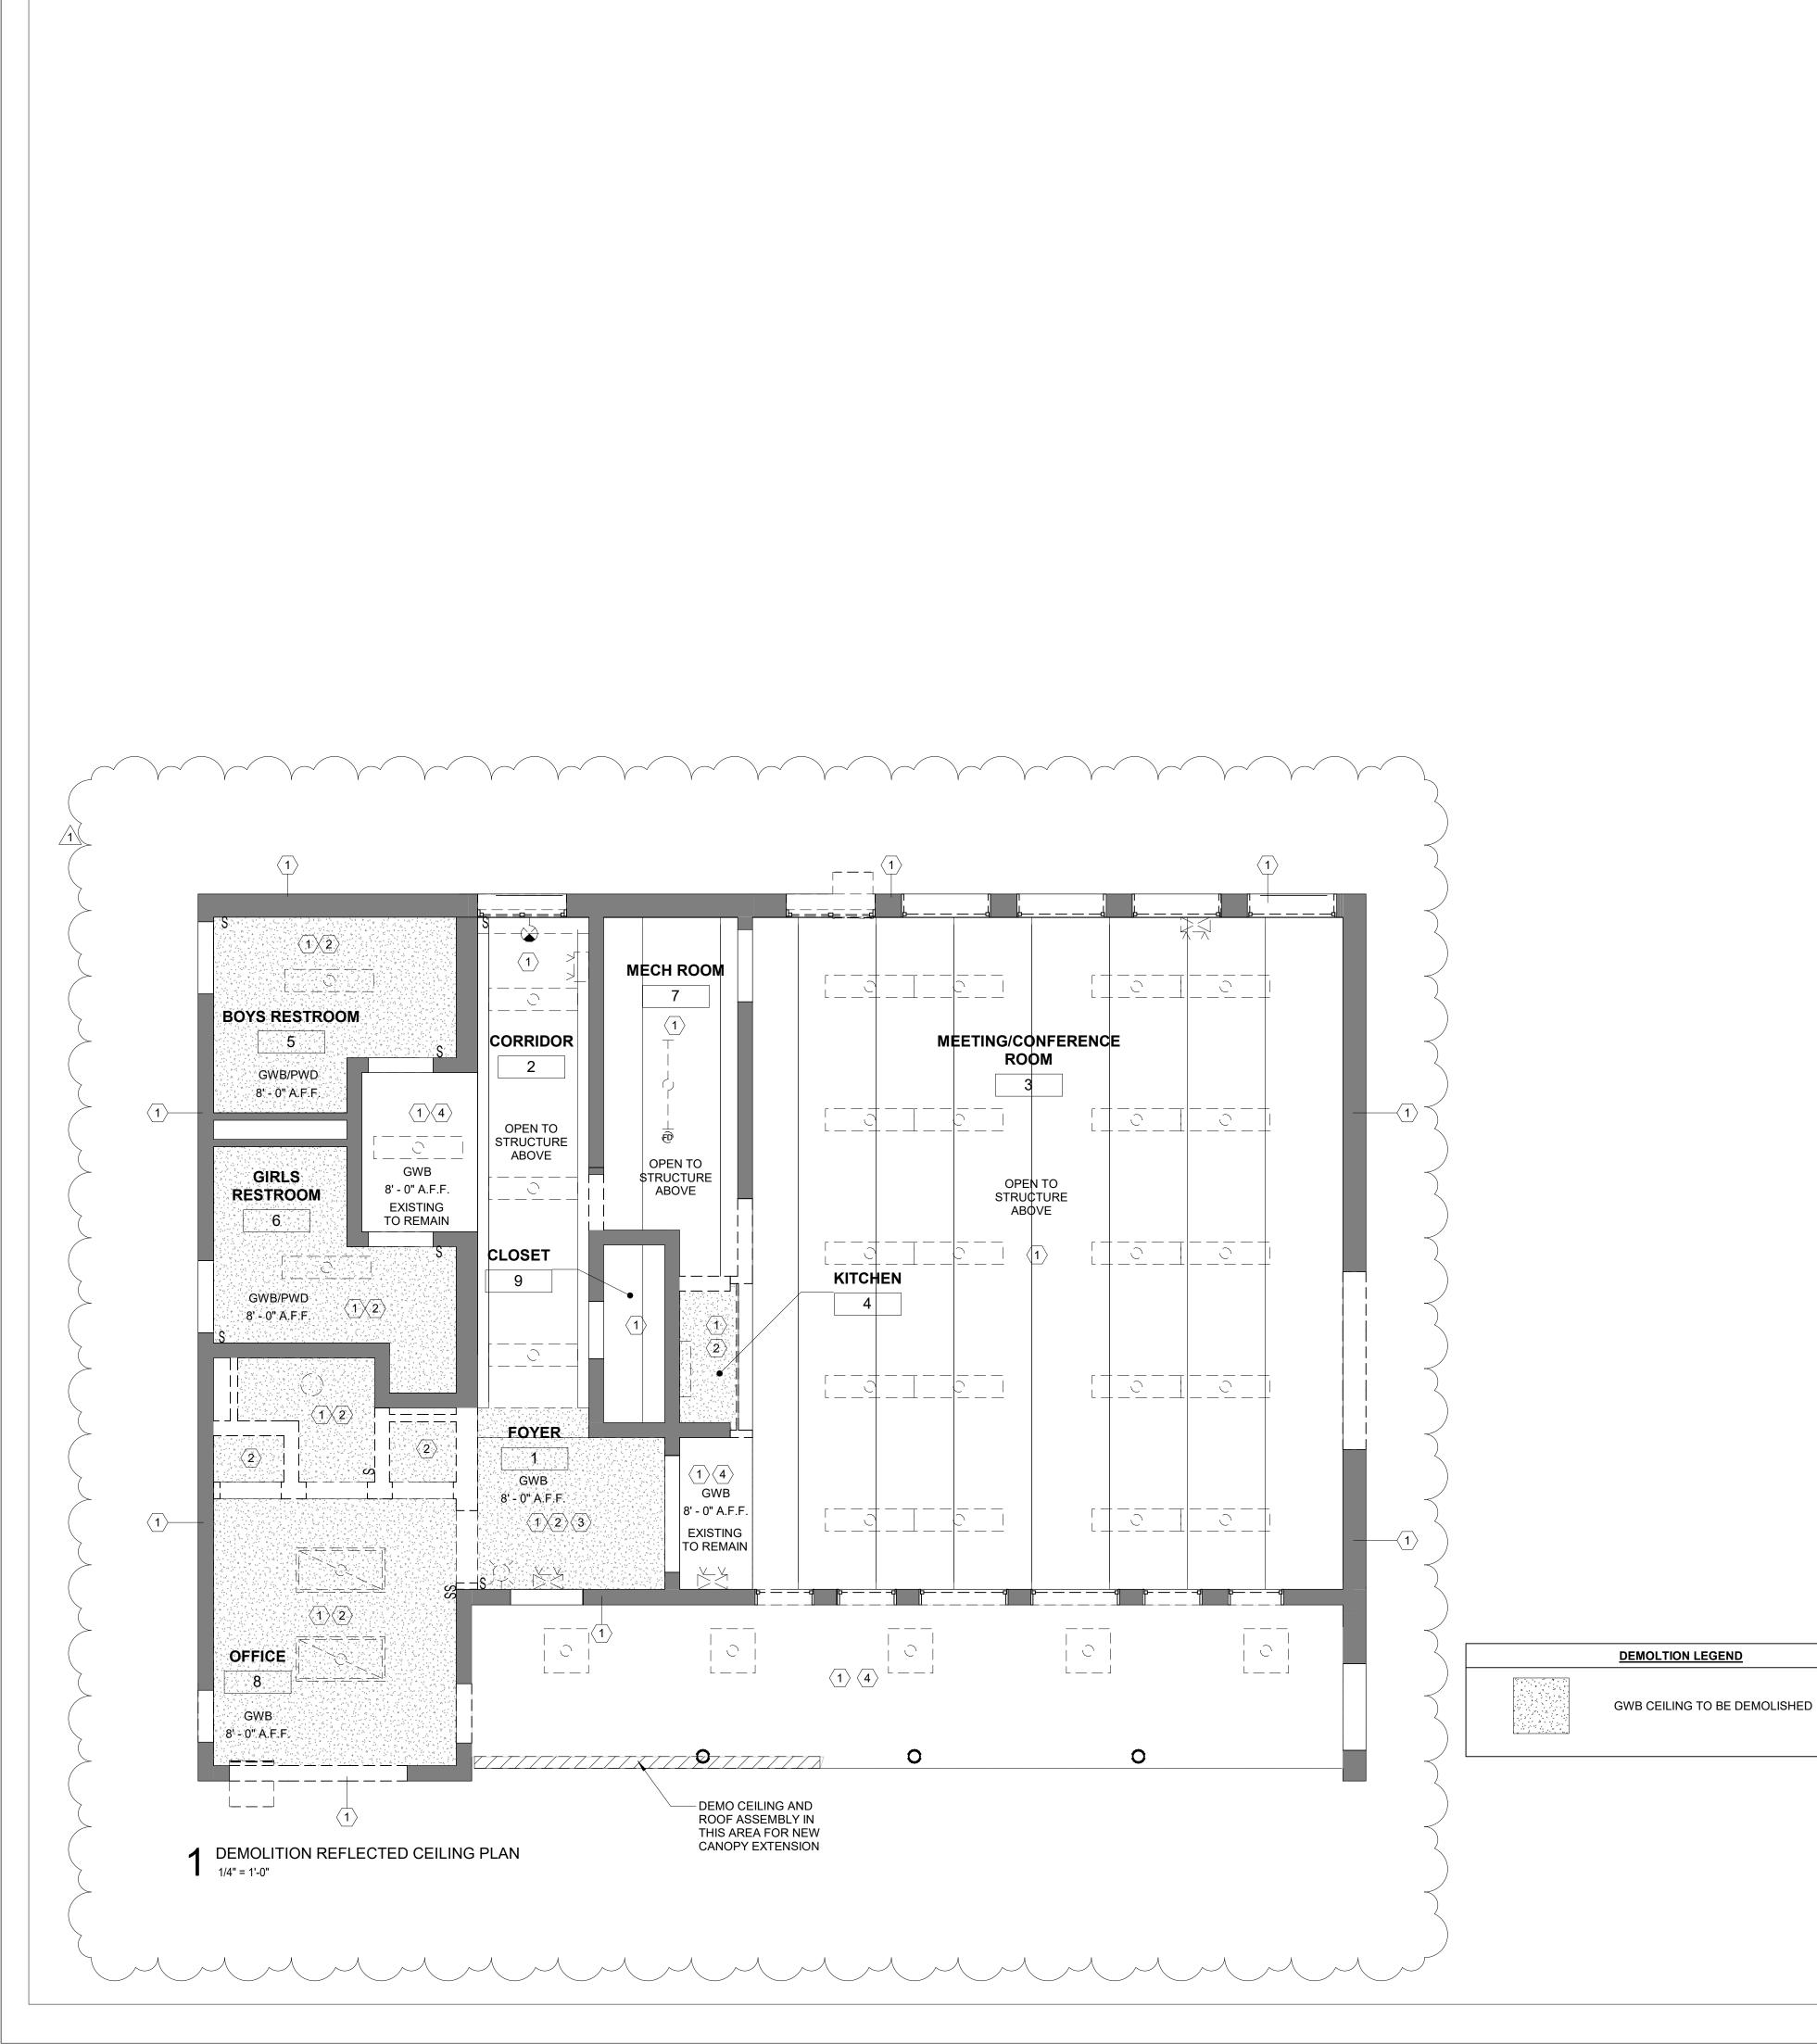GENERAL CONTRACTOR SHALL INCLUDE COSTS FOR ALL DEMOLITION INCLUDING BUT NOT NECESSARILY LIMITED TO THE FOLLOWING:

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5. WHEN A NEW WALL, CEILING, ROOF, OR FLOOR ASSEMBLY IS INDICATED WHERE AN EXISTING WALL, CEILING, ROOF, OR FLOOR ASSEMBLY EXISTS, THE EXISTING SHALL BE COMPLETELY REMOVED, WITH ASSOCIATED UTILITIES REMOVED AND CAPPED BEHIND THE SURFACE OF THE REMAINING SUBSTRATE, UNLESS NOTED OTHERWISE. ALL DEPRESSIONS, INDENTS, OR PROTRUSIONS ETC.. LEFT AFTER THE REMOVAL OF ITEMS WHICH WILL INTERFERE WITH THE CONSTRUCTION SHALL BE REPAIRED, REPLACE OR REMOVED TO PROVIDE A SMOOTH TRANSITION BETWEEN NEW AND OLD SURFACES. 6. THE CONTRACTORS SHALL VERIFY ALL CONDITIONS PRIOR TO COMMENCING DEMOLITION. SHOULD QUESTIONS ARISE, THE CONTRACTOR SHALL NOTIFY

7. WHERE OPENINGS ARE INDICATED TO BE MADE IN EXISTING MASONRY WALLS, OR EXISTING OPENINGS ARE TO BE INFILLED, THE CONTRACTOR SHALL

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DEMOLITION RCP KEYNOTES


ASIDE FOR REUSE. CONTRACTOR TO VERIFY EXISTING LIGHTING LAYOUT. SEE ELECTRICAL DWGS CTED ADJACENT SURFACES TO MATCH EXISTING TO REMAIN. ALL ASSOCIATED HARDWARE. REFER TO MECHANICAL, ELECTRICAL, AND PLUMBING DRAWINGS FOR AIR AFFECTED ADJACENT SURFACES TO MATCH EXISTING TO REMAIN. FOR DEMOLITION OF ADJACENT WALLS. PREPARE AREA TO RECEIVE NEW GWB AND PLYWOOD

4 REMOVE EXISTING CEILING AS REQUIRED FOR DEMOLITION AND NEW WORK IN THIS AREA.

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WORK.




### TOOTH IN NEW MASONRY CONSTRUCTION TO MATCH ADJACENT COURSING. PARTITION OR ANY OTHER STRUCTURAL ELEMENT. 9. REMOVE ALL EXISTING LIGHT FIXTURES, EMERGENCY LIGHT FIXTURES, AND EXIT SIGNS AND SET ASIDE FOR REUSE 11. PREP EXTERIOR COLUMNS FOR PAINT. 12. PREP UNDERSIDE OF EXERIOR ROOF ENTRY CANOPY AND PREP FOR PAINT. MECHANICAL, ELECTRICAL, AND PLUMBING DRAWINGS.

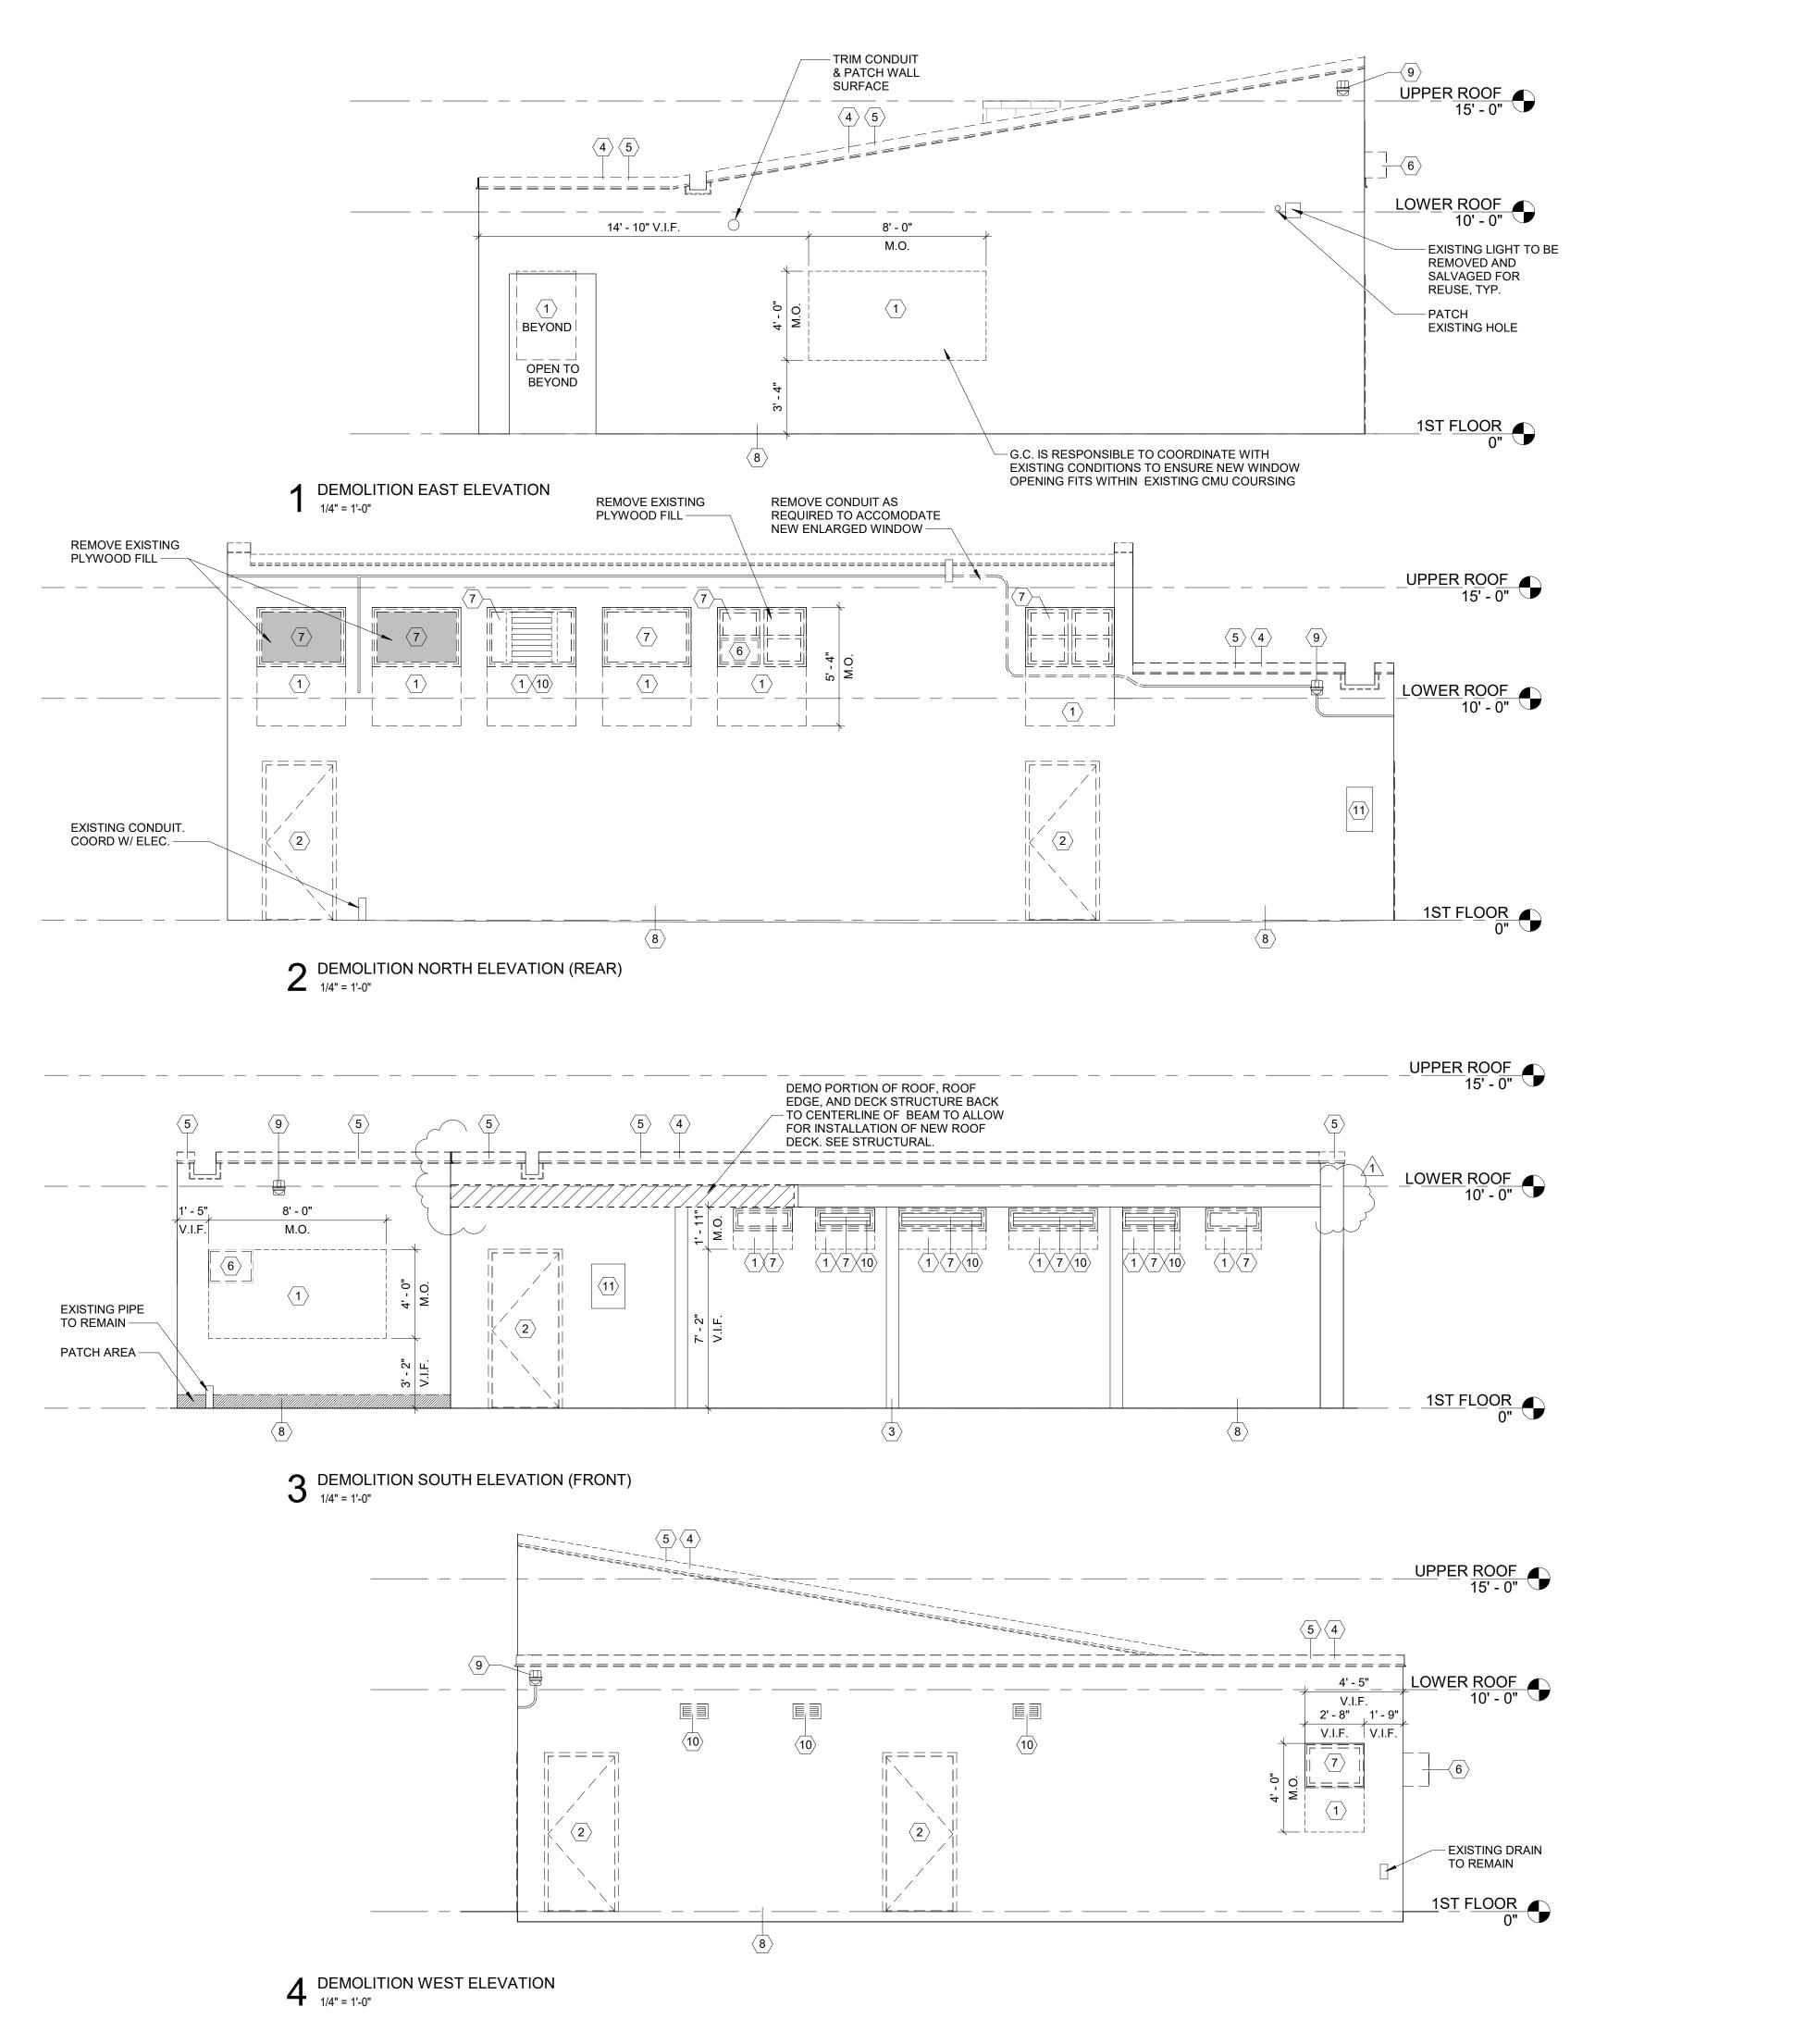DEFINITIONS:

LOCATIONS.

KEYNOTE DOOR OPENINGS AT HEAD, JAMB & SILLS. SEE STRUCTURAL DRAWINGS FOR REINFORCING REQUIREMENTS. SEE DOOR SCHEDULE FOR NEW MASONRY OPENING SIZE ROOF FOR NEW ROOFING MATERIAL. REMOVE EXISTING METAL COPING AND FLASHING TYP. ENTIRE ROOF. WINDOW OPENINGS AT HEAD, JAMB & SILLS. SEE WINDOW SCHEDULE. REMOVE AND REPLACE EXISTING COMPRESSIVE FILLER AT BOTTOM OF EXTERIOR WALL & CONCRETE PAD. EXISTING CCTV DEVICE TO REMAIN. COORDINATE WITH OWNER. 10 EXISTING VENT/LOUVER TO BE REMOVED. COORDINATE WITH MECHANICAL 11 PROTECT EXISTING SIGNAGE TO REMAIN

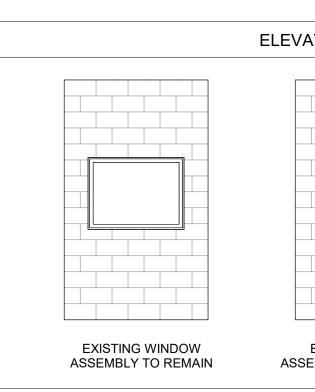

### **GENERAL DEMO NOTES**

REMOVE: REMOVE AND LEGALLY DISPOSE OF ITEMS EXCEPT THOSE INDICATED TO BE REINSTALLED, SALVAGED, OR TO REMAIN THE OWNER'S PROPERTY. EXISTING TO REMAIN: PROTECT CONSTRUCTION INDICATED TO REMAIN AGAINST DAMAGE AND SOILING DURING DEMOLITION AND NEW CONSTRUCTION.

GENERAL CONTRACTOR SHALL INCLUDE COSTS FOR ALL DEMOLITION INCLUDING BUT NOT NECESSARILY LIMITED TO THE FOLLOWING:

1. DEMOLITION WORK INCLUDES, BUT NOT LIMITED TO THE WORK INDICATED, AS COORDINATED WITH WORK OF ALL OTHER TRADES, AS INDICATED ELSEWHERE, AND AS REQUIRED TO ACCOMMODATE CONSTRUCTION. ALL DEMOLITION REQUIRED SHALL BE INCLUDED IN EACH CONTRACTOR'S BASE BID TO PERFORM AND COMPLETE CONSTRUCTION UNLESS OTHERWISE INDICATED. REFER TO ASBESTOS ABATEMENT REPORT AND MECHANICAL, ELECTRICAL, AND PLUMBING DRAWINGS FOR ADDITIONAL INFORMATION. 2. ALL ITEMS DESIGNATED AS 'SALVAGED' SHALL BE COORDINATED WITH OWNER.

. ITEMS TO BE SALVAGED, RELOCATED, OR REINSTALLED SHALL BE AS INDICATED. SPECIAL CARE IS TO BE TAKEN SO AS NOT TO DAMAGE THESE ITEMS. THE G.C. SHALL COORDINATE THE STORAGE OF ALL SALVAGED ITEMS TO BE EITHER RELOCATED OR REINSTALLED WITH THE OWNER. 4. LOCATIONS AND/OR ELEVATIONS OF EXISTING ITEMS, AS SHOWN ON THE DRAWINGS, ARE APPROXIMATE. RESPECTIVE TRADES SHALL FIELD VERIFY ALL

5. WHEN A NEW WALL, CEILING, ROOF, OR FLOOR ASSEMBLY IS INDICATED WHERE AN EXISTING WALL, CEILING, ROOF, OR FLOOR ASSEMBLY EXISTS, THE EXISTING SHALL BE COMPLETELY REMOVED, WITH ASSOCIATED UTILITIES REMOVED AND CAPPED BEHIND THE SURFACE OF THE REMAINING SUBSTRATE, UNLESS NOTED OTHERWISE. ALL DEPRESSIONS, INDENTS, OR PROTRUSIONS ETC.. LEFT AFTER THE REMOVAL OF ITEMS WHICH WILL INTERFERE WITH THE CONSTRUCTION SHALL BE REPAIRED, REPLACE OR REMOVED TO PROVIDE A SMOOTH TRANSITION BETWEEN NEW AND OLD SURFACES. 6. THE CONTRACTORS SHALL VERIFY ALL CONDITIONS PRIOR TO COMMENCING DEMOLITION. SHOULD QUESTIONS ARISE, THE CONTRACTOR SHALL NOTIFY THE ARCHITECT, IN WRITING, PRIOR TO PROCEEDING WITH DEMOLITION. 7. WHERE OPENINGS ARE INDICATED TO BE MADE IN EXISTING MASONRY WALLS, OR EXISTING OPENINGS ARE TO BE INFILLED, THE CONTRACTOR SHALL

8. CONTRACTORS ARE RESPONSIBLE FOR SHORING, BRACING, AND UNDERPINNING RELATED TO THE DEMOLITION, REMOVAL OR CUTTING OF ANY WALL,

10. PREP ALL INTERIOR WALL AND CEILING SURFACES FOR PAINT INCLUDING UNDERSIDE OF EXPOSED ROOF DECK AND ROOF TRUSSES.

13. OPEN AND PARTIALLY DEMO WALLS, CEILINGS, AND FLOORS AS REQUIRED FOR MECHNICAL, ELECTRICAL, AND PLUMBING WORK. COORDINATE WITH


DEMOLITION ELEVATION KEYNOTES

REMOVE PORTIONS OF EXISTING WALL TO INSTALL OPENING SCHEDULED. PATCH AND REPAIR AFFECTED ADJACENT SURFACES AND PREPARE TO RECEIVE SCHEDULED FINISH. COORDINATE WITH STRUCTURAL FOR NEW ENLARGED OPENINGS. REMOVE EXISTING DOOR, FRAME AND ASSOCIATED HARDWARE. PREPARE OPENING FOR NEW DOOR. ALLOW FOR MISCELLANEOUS REPAIR TO

PREP EXISTING CMU WALLS & STEEL COLUMNS TO RECEIVE NEW PAINT, TYP. AT ALL LOCATIONS. REMOVE ROOFING MATERIAL AND INSULATION DOWN TO ROOF SUBSTRATE. ALLOW FOR MISC REPAIR TO ROOF SUBSTRATE AS NEEDED. PREPARE

REMOVE EXISTING AIR CONDITIONING UNIT. ALLOW FOR MISC REPAIR TO OPENINGS AT HEAD, JAMB, AND SILLS REMOVE EXISTING WINDOW, FRAME, SCREEN, AND ASSOCIATED HARDWARE. PREPARE OPENING FOR NEW WINDOW. ALLOW FOR MISC REPAIR TO


### ELEVATION LEGEND KEY

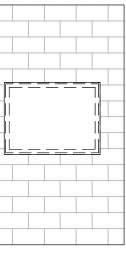

EXISTING WINDOW ASSEMBLY TO BE REMOVED

 $|_{E} = |_{=} = |_{=} |_{=}$ 

EXISTING DOOR ASSEMBLY TO BE REMOVED

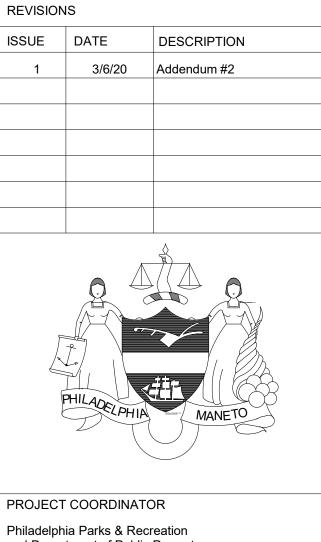

and Department of Public Property 1515 Arch Street, 11th Floor Philadelphia, PA 19102 Contact: Sara Nordstrom, 215-683-0253

SEAL



PROJECT TEAM

ARCHITECT:

JOHNSON, MIRMIRAN & THOMPSON, INC 1600 MARKET ST, SUITE 520 PHILADELPHIA, PA 19103 267.256.0300

STRUCTURAL ENGINEER:

JOHNSON, MIRMIRAN & THOMPSON, INC 1600 MARKET ST, SUITE 520 PHILADELPHIA, PA 19103 267.256.0300

SYSTEMS ENGINEER:

JOHNSON, MIRMIRAN & THOMPSON, INC 1600 MARKET ST, SUITE 520 PHILADELPHIA, PA 19103 267.256.0300


CITY OF PHILADELPHIA REBUILD PHILADELPHIA AND PHILADELPHIA PARKS & RECREATION 1515 ARCH STREET 11TH FLOOR, ONE PARKWAY BUILDING PHILADELPHIA, PENNSYLVANIA

PROJECT TITLE MILES MACK BUILDING RENOVATION

DRAWING TITLE

DEMOLITION ELEVATIONS


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NOTE: ALL DIMENSIONS AN BE VERIFIED BY THE THE SITE BEFORE PF WORK	

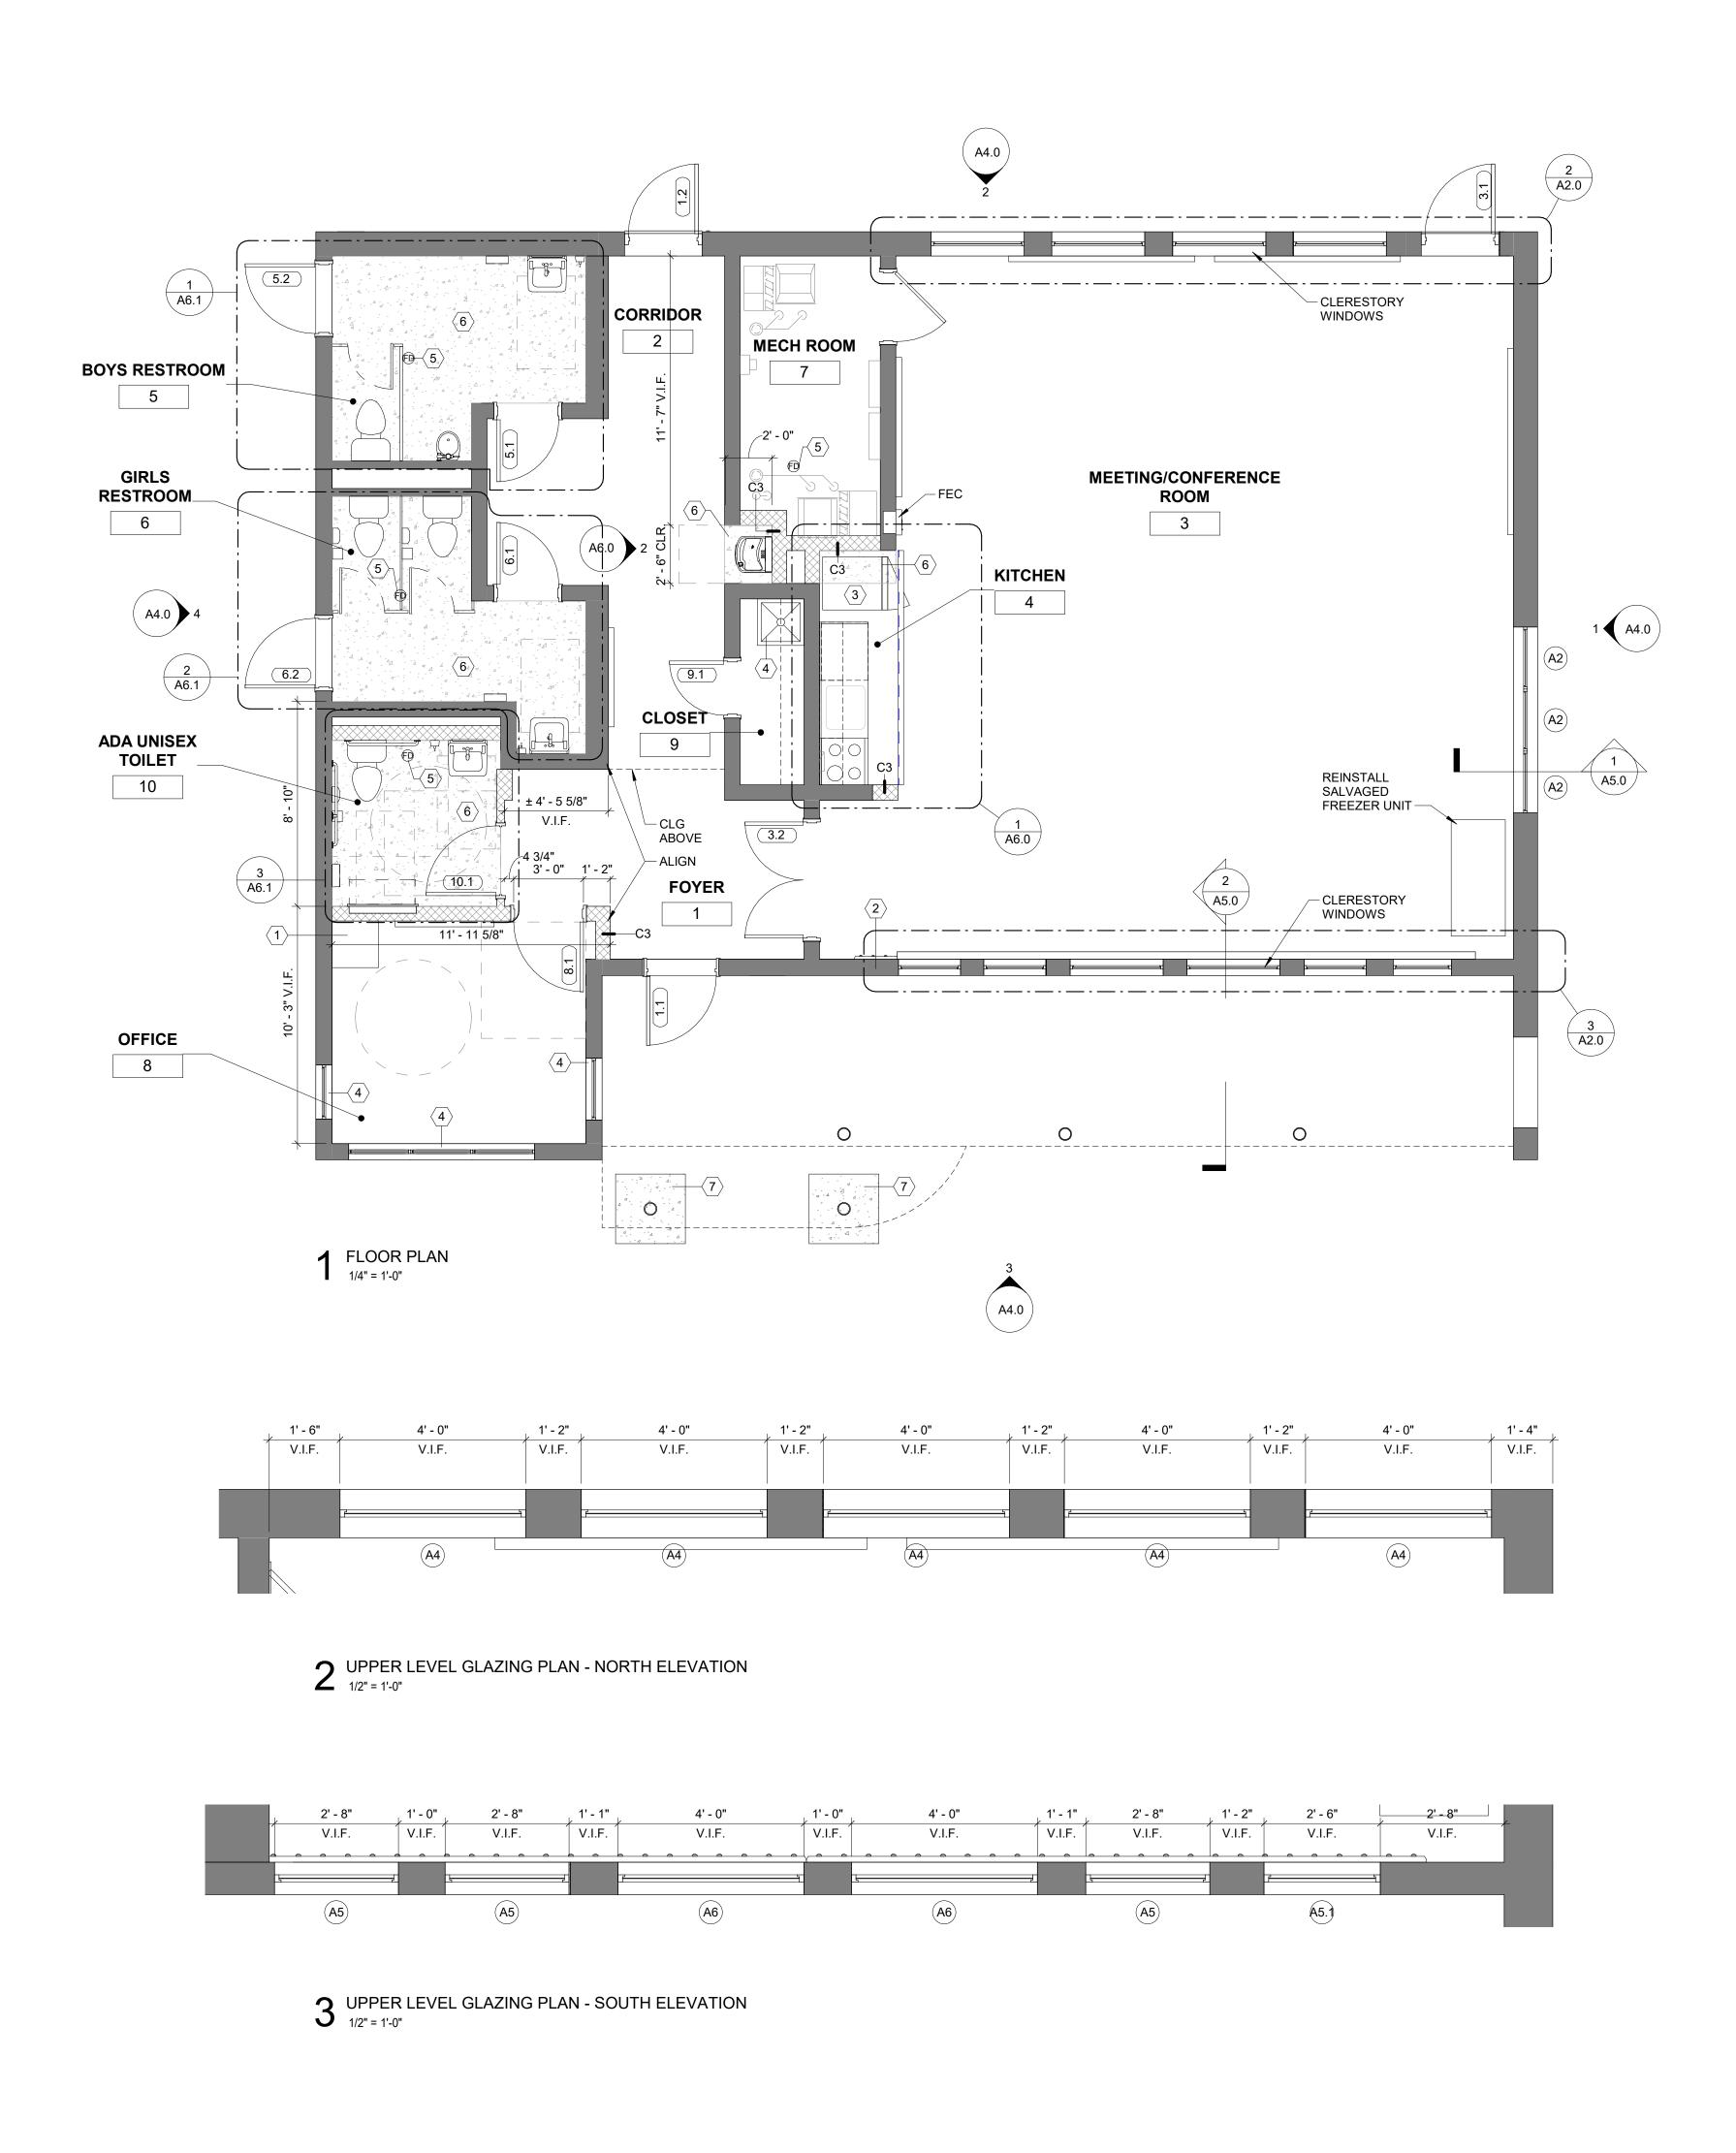

 CONTRACTOR SHALL FIELD VERIFY ALL DIMENSIONS E START OF WORK.

- INTERIOR DIMENSIONS ARE TO FINISHED FACE OF WA
   ALL DOOR JAMBS AT HINGE SIDE TO BE SET 6" FROM A
   ALL FLOORING TRANSITIONS SHALL OCCUR AT CENTE
   REFERENCE FINISH SCHEDULE FOR FINISH SPECIFICA
- CONTRACTOR SHALL PROVIDE AND INSTALL WALL BL COUNTERTOPS, SHELVING, AND ACCESSORIES. CONTRACTOR SHELVING, AND ACCESSORIES.
- CONFIRM ALL MEASUREMENTS. ALIGN FACE OF NEW
   FLUSH LEVER ON TOILET TO BE LOCATED ON LAVATORIAN
- 9. REFER TO SHEET G0.2, FOR ALL PLUMBING FIXTURES 10. PROTECT ALL EXISTING ITEMS TO REMAIN DURING AL
- 11. SEE PLUMBING DRAWINGS FOR TOILET ROOM FIXTUF 12. REFER TO SHEET A7.0 FOR TOILET ROOM ACCESSOR
- 12. NET EN TO SHEET AT U FOR TOILET ROOM ACCESSOR
   13. PATCH AND REPAIR EXTERIOR MASONRY WALL SURF
   14. PRIME ALL NEW AND PATCHED EXTERIOR WALL SURF
- 14. PRIVIE ALL NEW AND PATCHED EXTERIOR WALL SU 15. FOR WINDOW AND DOOR TYPES SEE SHEET A7.0.
- 16. COORDINATE ALL OPENINGS IN CMU WALLS WITH MED 17. VERIFY STRUCTURAL JOIST DIMENSIONS.

KEYNOTES	
1	RELOCATED SERVER EQUIPMENT BY OTHE
2	NEW COAT HANGER.
3	REINSTALL EXISTING REFRIGERATOR.
4	NEW ROLL DOWN PRIVACY SHADES.
5	NEW FLOOR DRAIN. SEE PLUMBING DRAW
6	NEW CONCRETE FLOOR SLAB OVER VAPO
7	NEW CONCRETE SLAB ON GRADE. SEE ST

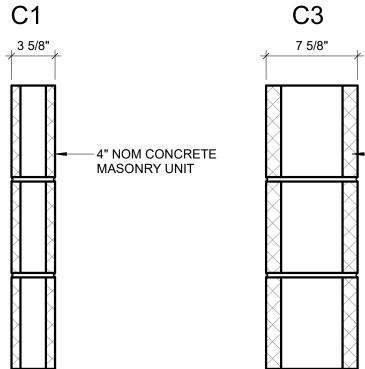


PARTITION TYPES-INTERIOR-CMU


## PARTITION TYPE NOTES:


SEE SPEC SECTION 04 FOR INFORMATION ON CONCRE
ALL PARTITIONS MUST FIT TIGHT TO STRUCTURAL SLAF
GWB IS 5/8", U.O.N.

GENERAL CONSTRUCTION NOTES	REVISIONS	
GENERAL CONSTRUCTION NOTES BEFORE START OF WORK. NOTIFY ARCHITECT IN WRITING OF ALL DISCREPANCIES BEFORE	ISSUE DATE	DESCRIPTION
ALL SURFACE. ADJACENT WALL (MIN.) OR AS OTHERWISE NOTED.		
ERLINE OF CLOSED DOOR, TYPICAL UNO. ATIONS.		
OCKING AS REQUIRED TO SUPPORT ALL WALL HUNG CABINETRY, WALL-HUNG FIXTURES, FRACTOR TO COORDINATE CLEARANCES FOR ALL BACK TO BACK FIXTURES. CONSTRUCTION WITH FACE OF EXISTING CONSTRUCTION UNO.		
DRY SIDE. AND ACCESSORIES MOUNTING HEIGHTS. L PHASES OF DEMOLITION AND CONSTRUCTION.		
E SCHEDULE. IES SCHEDULE.		
ACES AND FINISH SURFACES WITH CEMENT PLASTER TO MATCH EXISTING. ACES TO RECEIVE FINISH COATS. FINISH COATS BY OTHERS, UNO.	A	
CHANICAL AND STRUCTURAL.		
KEYNOTES	PHILADO	
	PHILADEL	PHIA MANETO
ERS. COORDINATE ELECITRCAL WITH ELECTRICAL CONTRACTOR AND OWNER.		
	PROJECT COORD	INATOR
INGS. R BARRIER, THIS AREA. SEE STRUCTURAL DRAWINGS.	Philadelphia Parks & and Department of F	
RUCTURAL DRAWINGS.	1515 Arch Street, 1 Philadelphia, PA 19	1th Floor 102
	Contact: Sara Nords	strom, 215-683-0253
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	A STATE	STERED ARCHING
	EEO CEO	
	Berry	M STEINROOK
	U	
	PROJECT TEAM	
	ARCHITECT:	
		RAN & THOMPSON, INC
	PHILADELPHIA, PA 267.256.0300	
	STRUCTURAL ENG	SINEER:
	1600 MARKET ST,	
	PHILADELPHIA, PA 267.256.0300	19103
	SYSTEMS ENGINE	<u>ER:</u> RAN & THOMPSON, INC
	1600 MARKET ST, PHILADELPHIA, PA	SUITE 520
	267.256.0300	
— 8" NOM CONCRETE MASONRY UNIT		
	CITY OF PHILADEL REBUILD PHILADE	LPHIA AND
	1515 ARCH STREE	
	PHILADELPHIA, PE	PARKWAY BUILDING NNSYLVANIA
	PROJECT TITLE MILES MACK BUILI	DING RENOVATION
	DRAWING TITLE	
	FLOOR PLA	N AND WALL TYPES
	PROJECT NO.	DRAWING NO.
ETE MASONRY UNIT ASSEMBLIES	10-20-XXXX-01	
AB, DECK, OR PLANK, U.O.N.	DATE: 02.07.2020 SCALE: AS NOTEI	A2.0
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4' 2' 0' 4' 8'	BE VERIFI THE SITE I	ED BY THE CONTRACTOR AT BEFORE PROCEEDING WITH TH
	WORK.	

- 4. ALL FLOORING TRANSITIONS SHALL OCCUR AT CENTERLINE OF CLOSED DOOR, TYPICAL UNO.
- 6. CONTRACTOR SHALL PROVIDE AND INSTALL WALL BLOCKING AS REQUIRED TO SUPPORT ALL WALL HUNG CABINETRY, WALL-HUNG FIXTURES,

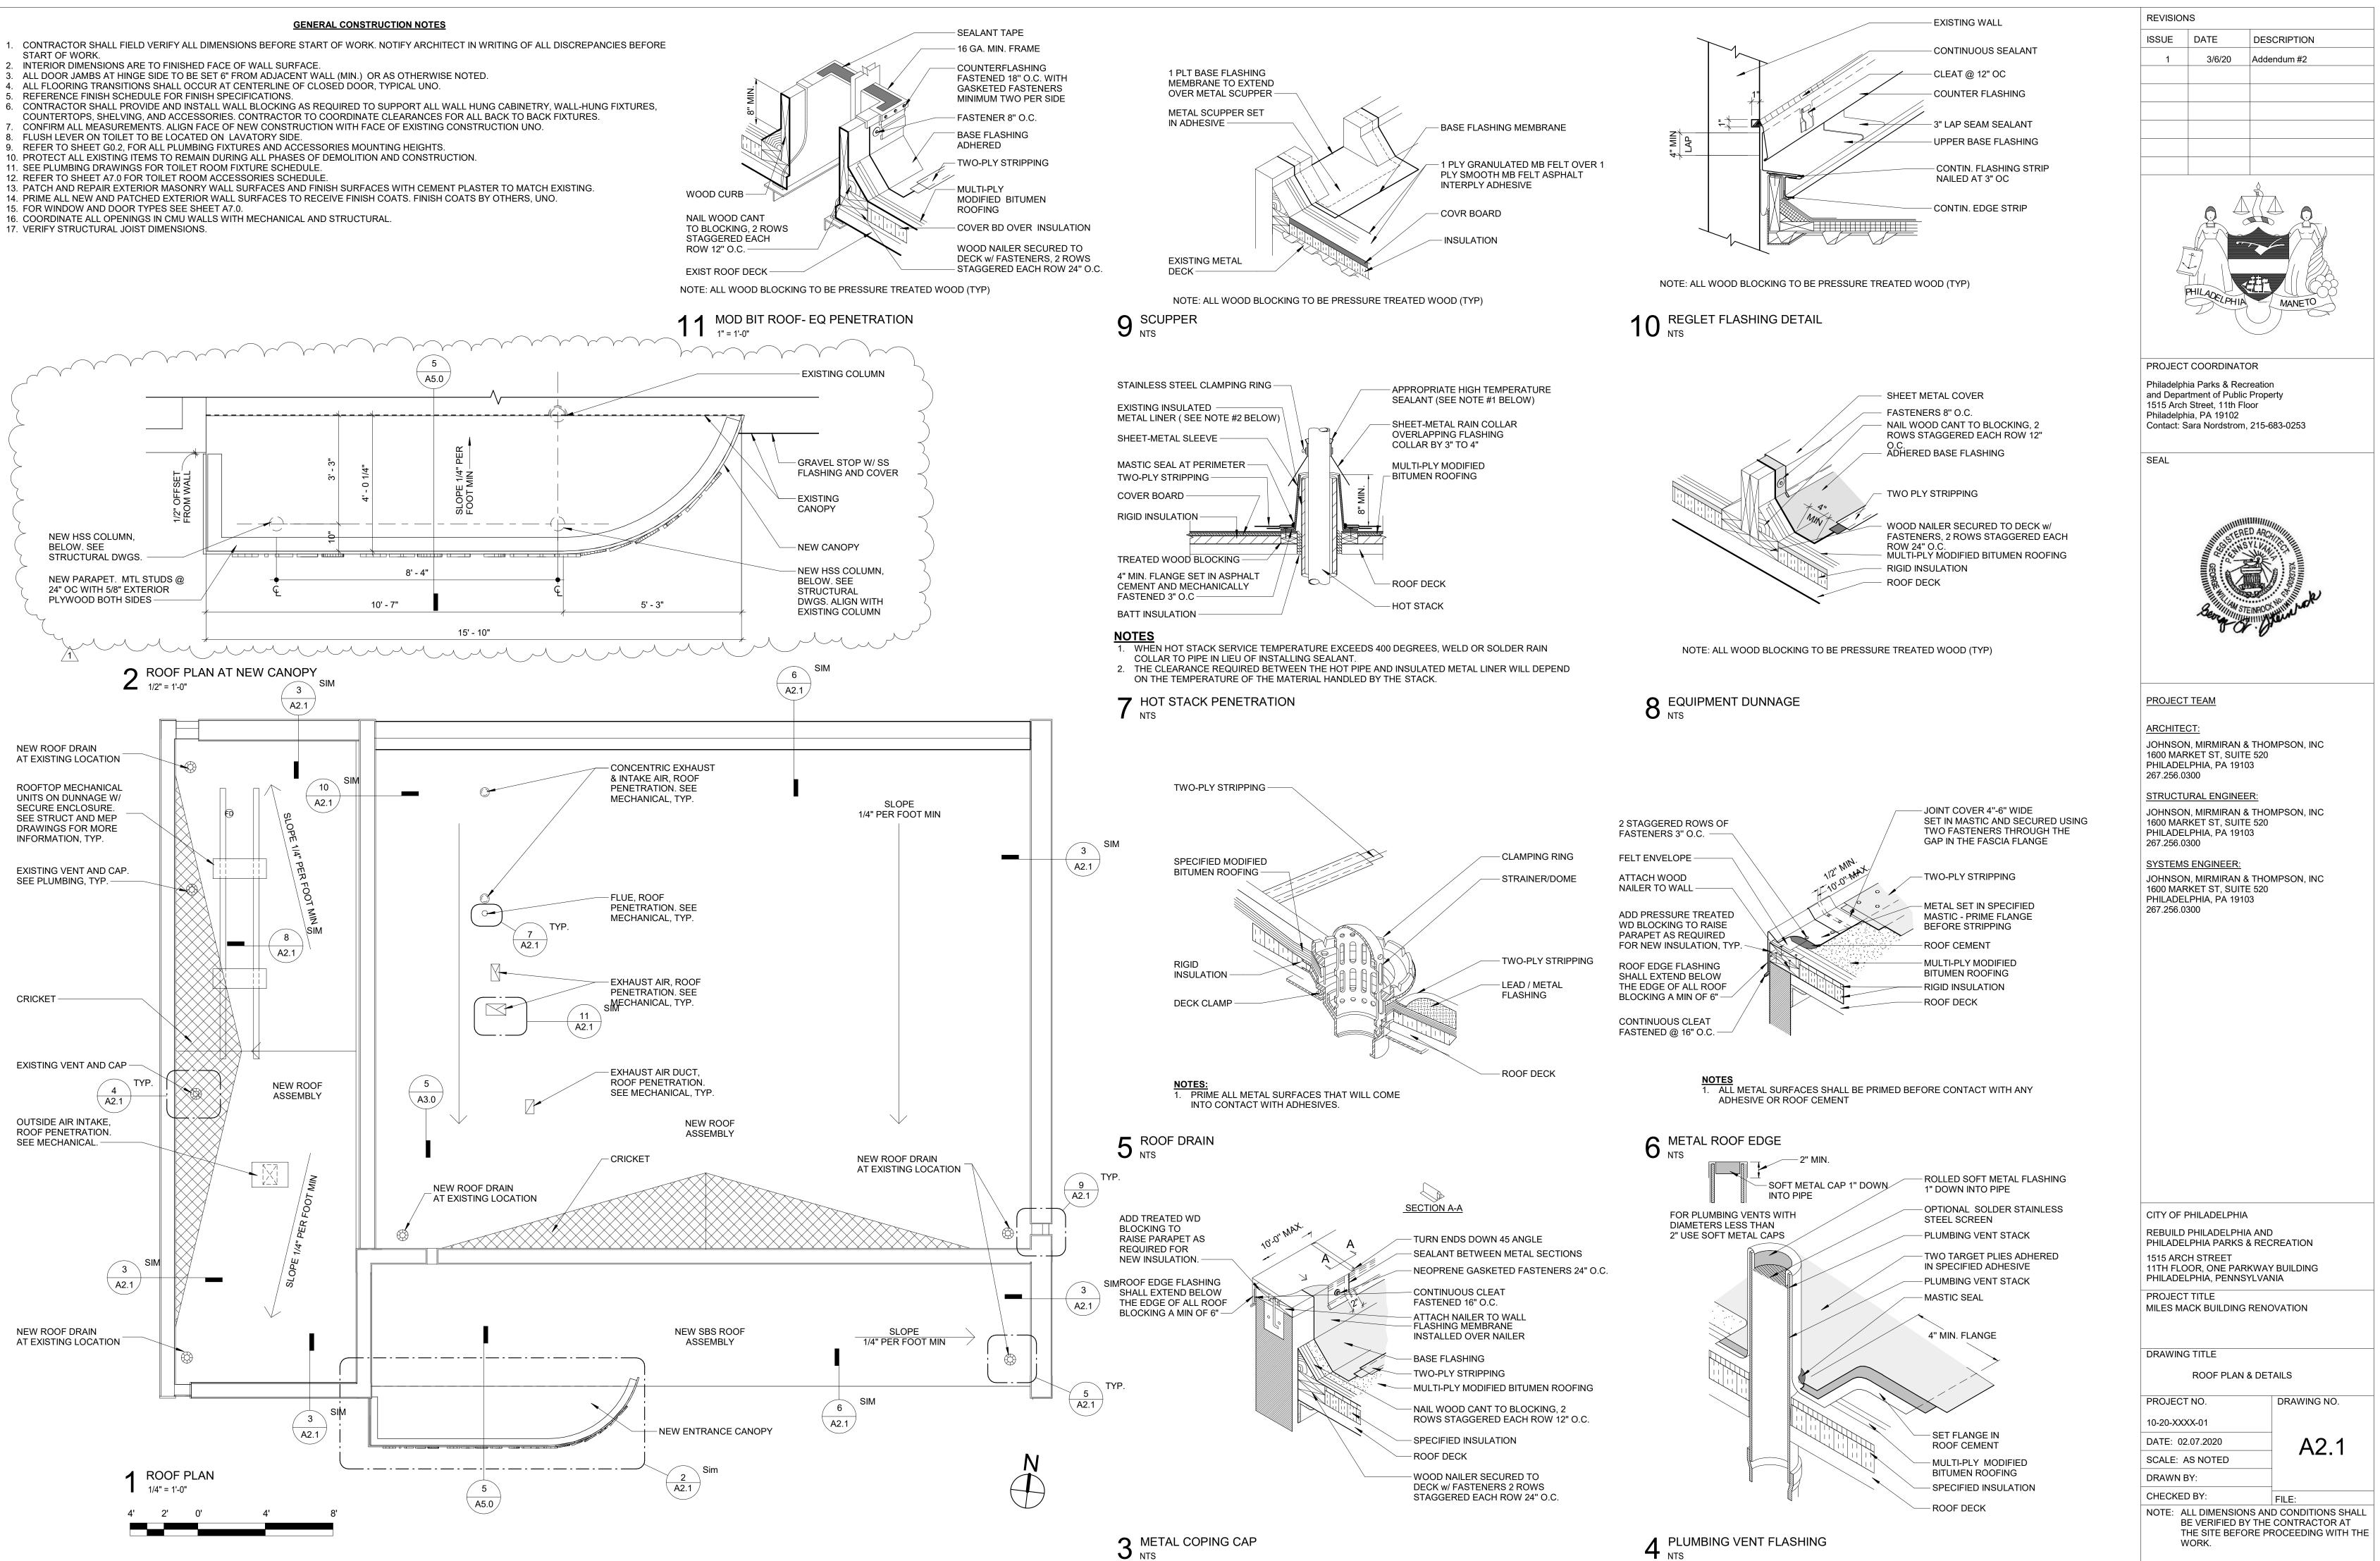

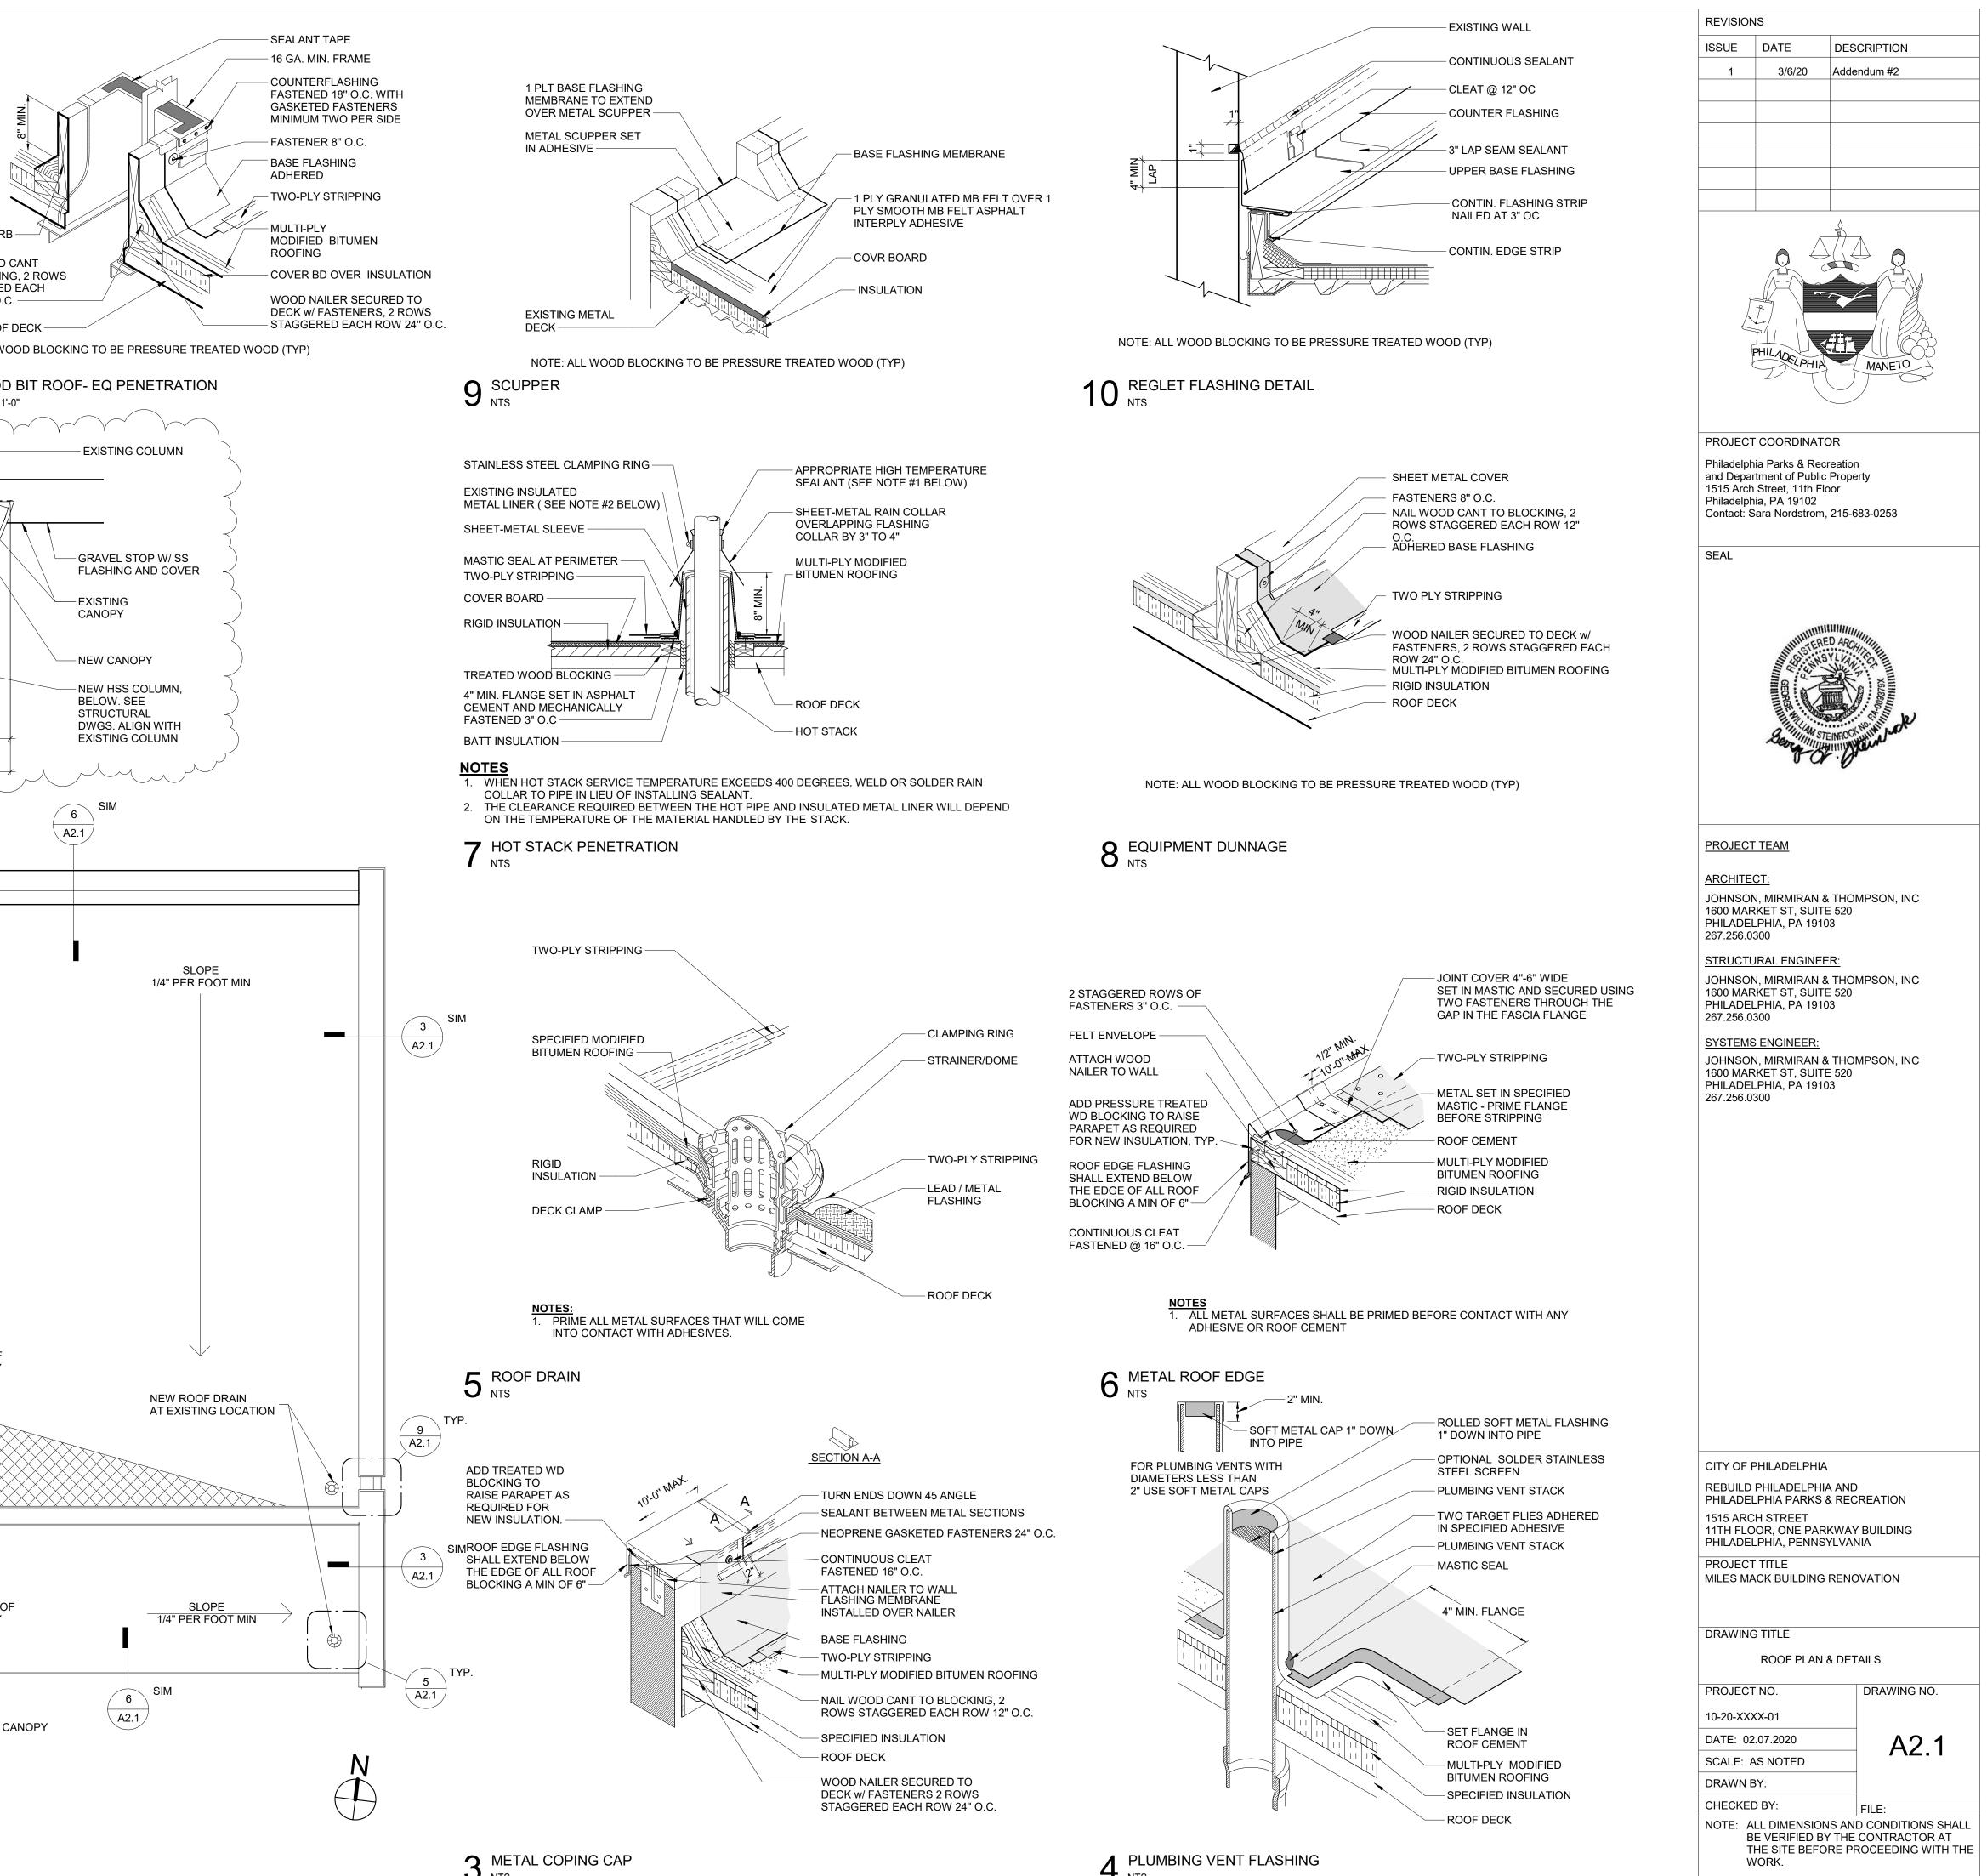

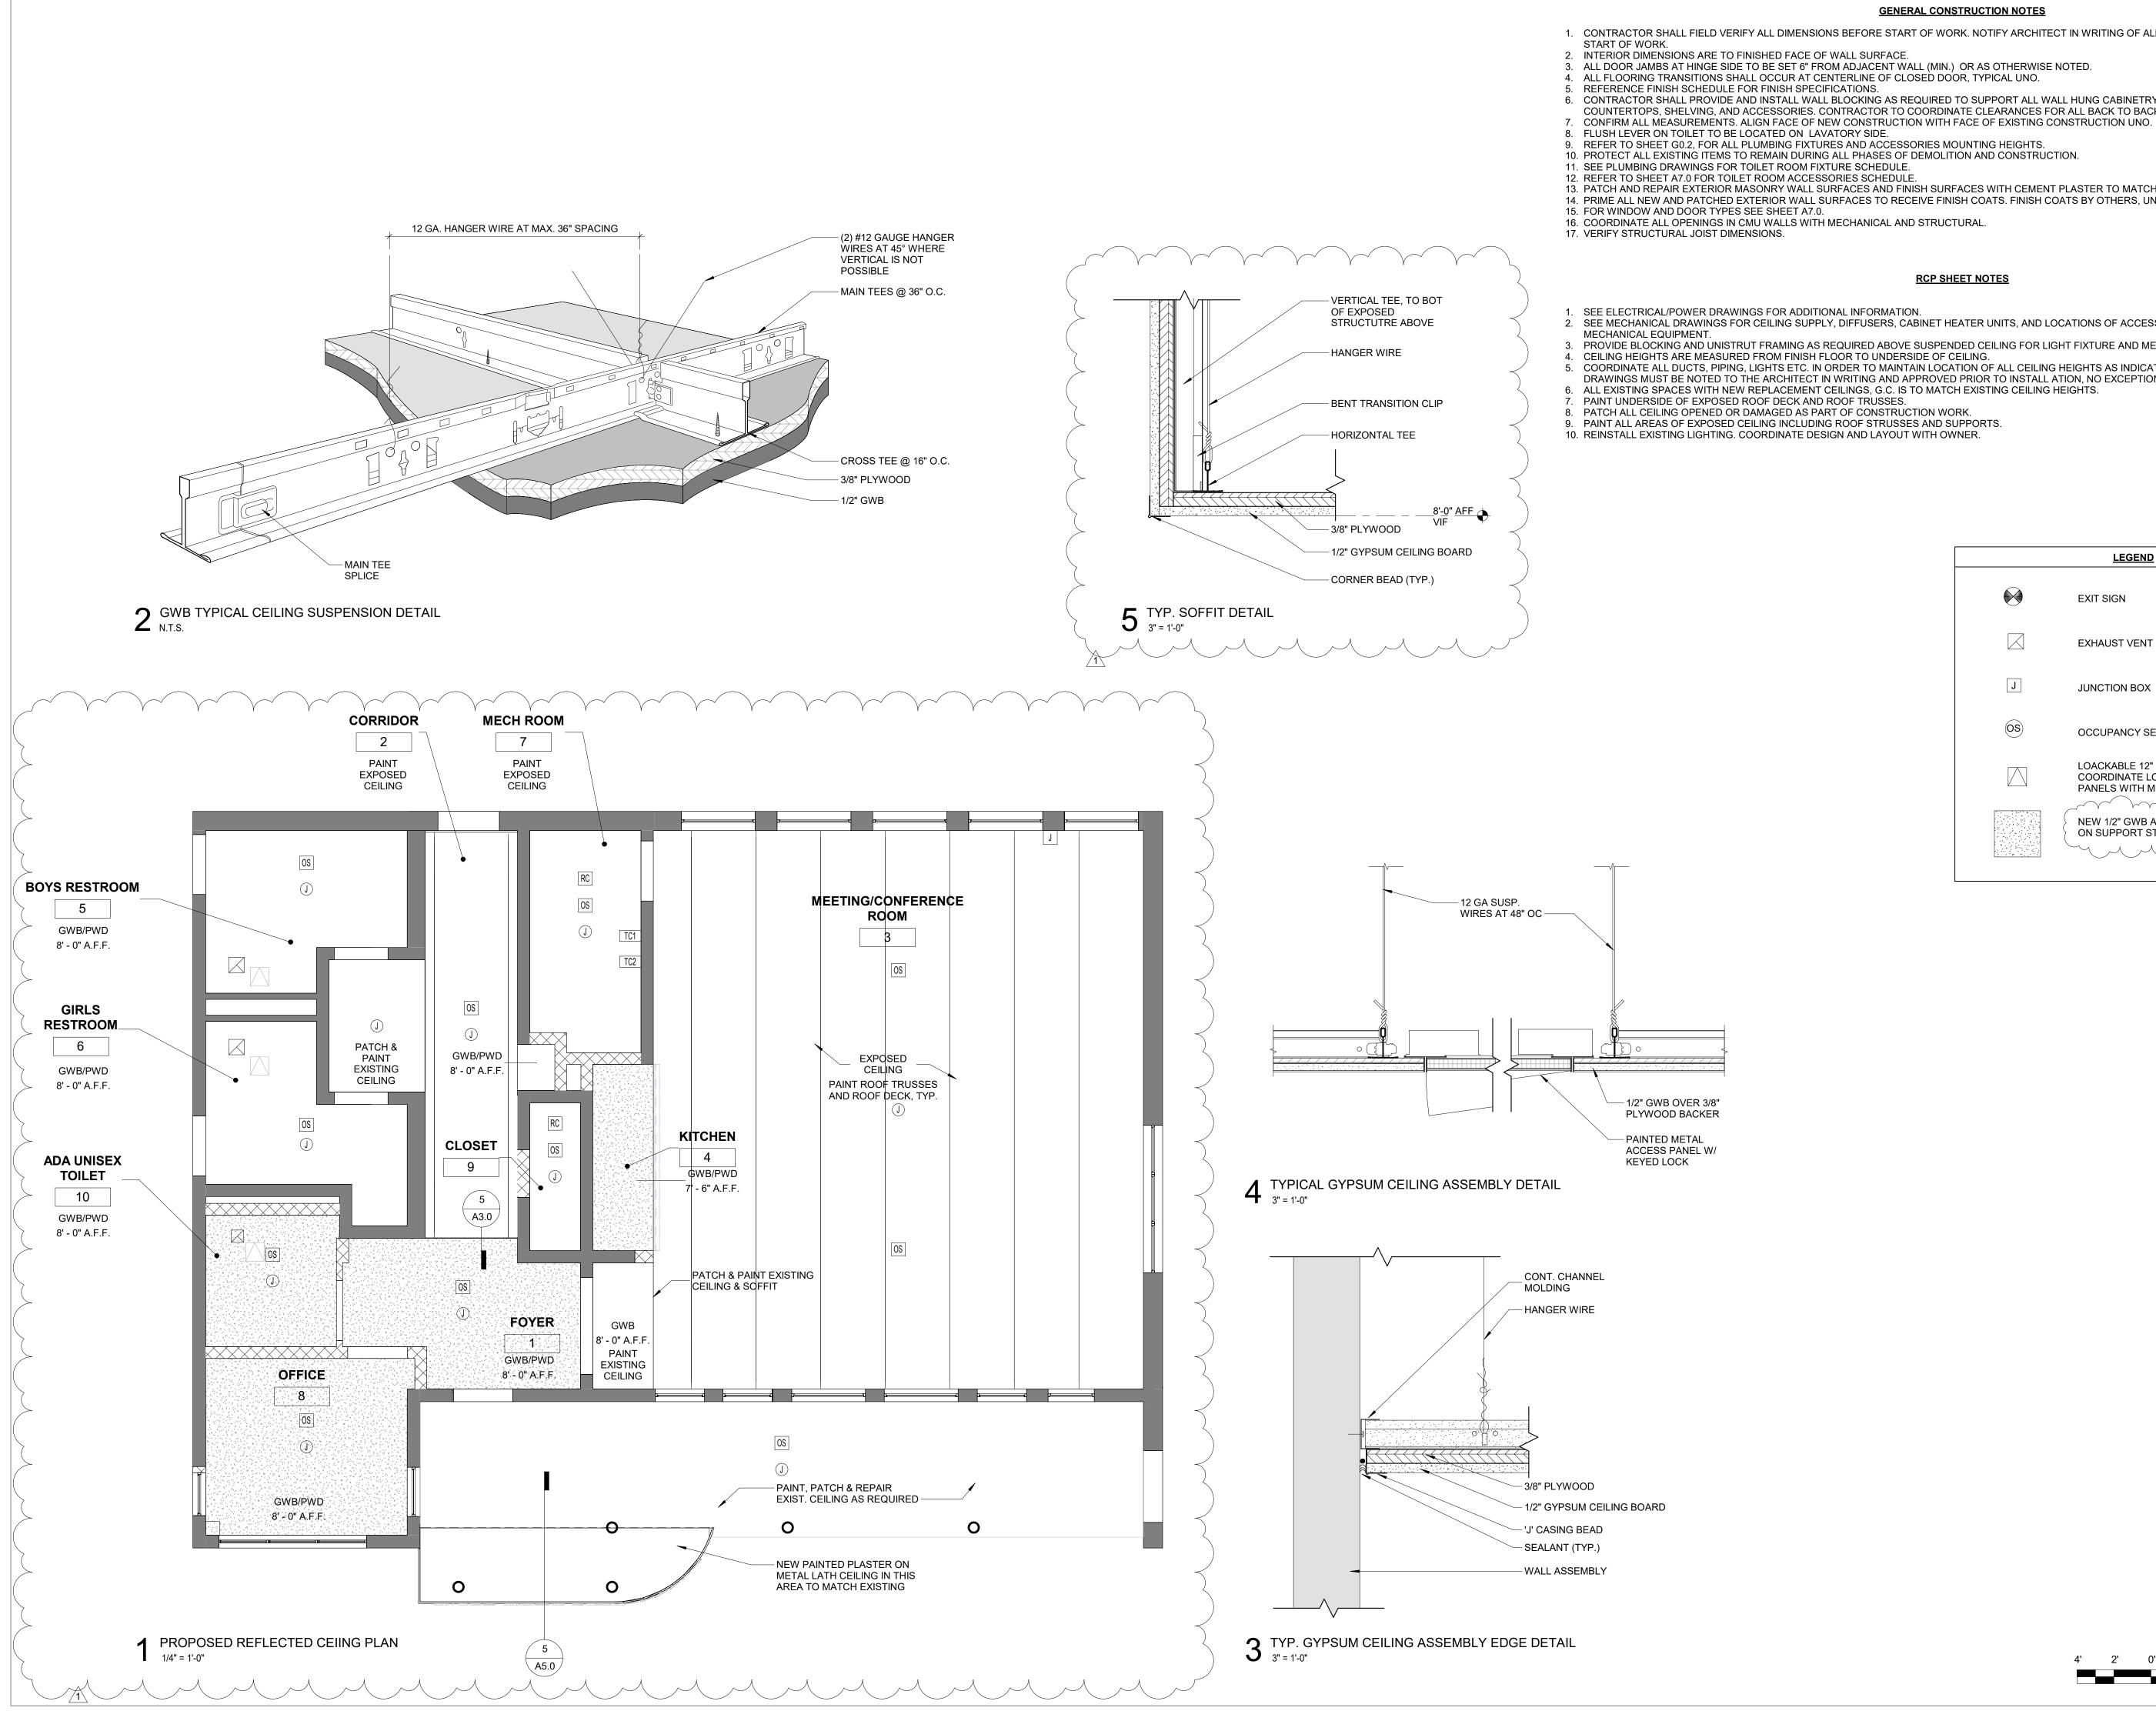

9. REFER TO SHEET G0.2, FOR ALL PLUMBING FIXTURES AND ACCESSORIES MOUNTING HEIGHTS. 10. PROTECT ALL EXISTING ITEMS TO REMAIN DURING ALL PHASES OF DEMOLITION AND CONSTRUCTION.

11. SEE PLUMBING DRAWINGS FOR TOILET ROOM FIXTURE SCHEDULE. 12. REFER TO SHEET A7.0 FOR TOILET ROOM ACCESSORIES SCHEDULE.

### **GENERAL CONSTRUCTION NOTES**

1. CONTRACTOR SHALL FIELD VERIFY ALL DIMENSIONS BEFORE START OF WORK. NOTIFY ARCHITECT IN WRITING OF ALL DISCREPANCIES BEFORE

6. CONTRACTOR SHALL PROVIDE AND INSTALL WALL BLOCKING AS REQUIRED TO SUPPORT ALL WALL HUNG CABINETRY, WALL-HUNG FIXTURES, COUNTERTOPS, SHELVING, AND ACCESSORIES. CONTRACTOR TO COORDINATE CLEARANCES FOR ALL BACK TO BACK FIXTURES.

13. PATCH AND REPAIR EXTERIOR MASONRY WALL SURFACES AND FINISH SURFACES WITH CEMENT PLASTER TO MATCH EXISTING. 14. PRIME ALL NEW AND PATCHED EXTERIOR WALL SURFACES TO RECEIVE FINISH COATS. FINISH COATS BY OTHERS, UNO.

### RCP SHEET NOTES

2. SEE MECHANICAL DRAWINGS FOR CEILING SUPPLY, DIFFUSERS, CABINET HEATER UNITS, AND LOCATIONS OF ACCESS PANELS REQUIRED FOR


3. PROVIDE BLOCKING AND UNISTRUT FRAMING AS REQUIRED ABOVE SUSPENDED CEILING FOR LIGHT FIXTURE AND MECHANICAL SUPPORTS.

5. COORDINATE ALL DUCTS, PIPING, LIGHTS ETC. IN ORDER TO MAINTAIN LOCATION OF ALL CEILING HEIGHTS AS INDICATED. ANY DEVICATION FROM THE DRAWINGS MUST BE NOTED TO THE ARCHITECT IN WRITING AND APPROVED PRIOR TO INSTALL ATION, NO EXCEPTIONS.


	LEGEND				
	EXIT SIGN				
	EXHAUST VENT				
J	JUNCTION BOX				
OS	OCCUPANCY SENSOR				
	LOACKABLE 12" X 12" ACCESS PANEL. COORDINATE LOCATION OF ALL ACCESS PANELS WITH MECHANICAL.				
	NEW 1/2" GWB AND 3/8" PLYWOOD CEILING ON SUPPORT STRUCTURE, PAINTED				

4' 2' 0'


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JOHNSON		& THOMPSON, INC
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JOHNSON 1600 MAR PHILADEL 267.256.03	KET ST, SUIT PHIA, PA 191 300	TE 520 103
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2 PROPOSED NORTH ELEVATION 1/4" = 1'-0"

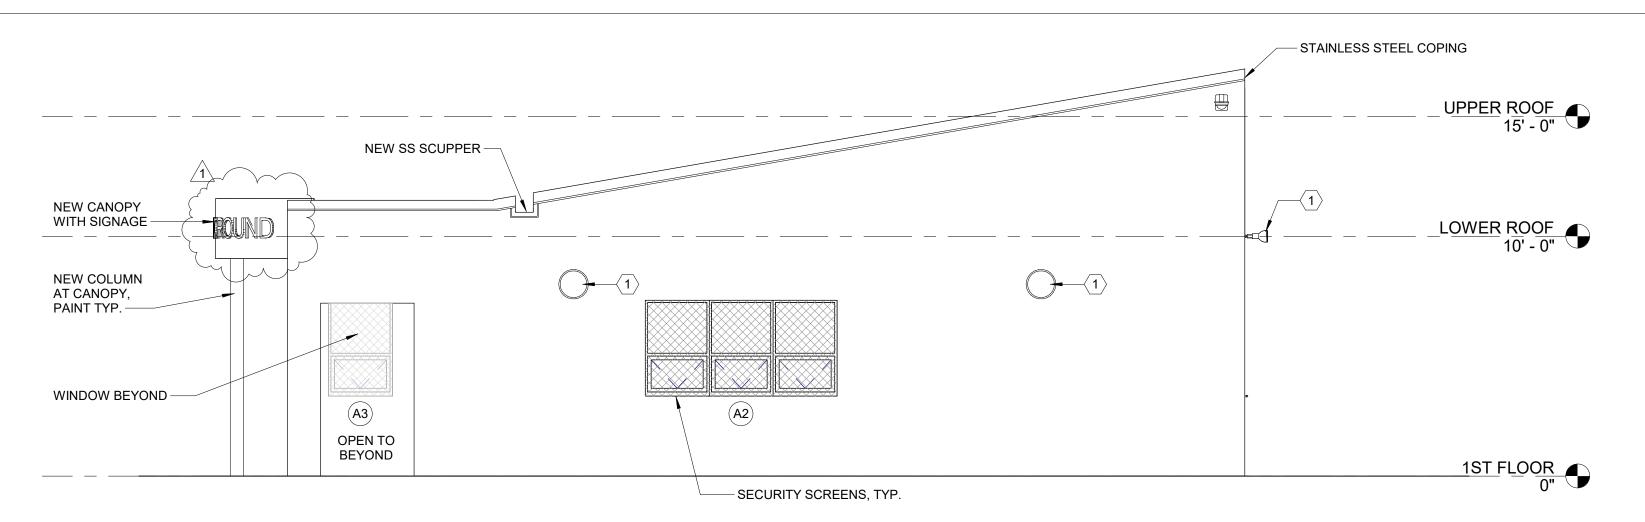

4 PROPOSED WEST ELEVATION 1/4" = 1'-0"

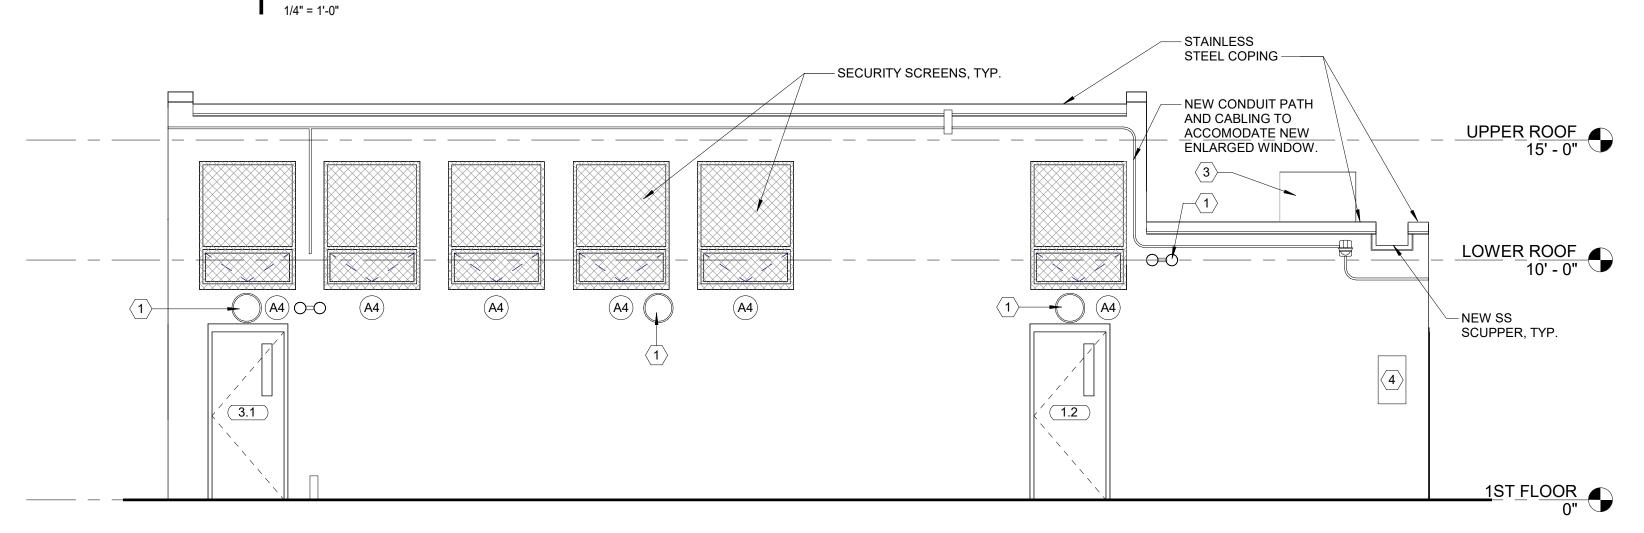1.	CONTRACTOR SHALL FIELD VERIFY ALL DIMENSION
	START OF WORK.
2.	INTERIOR DIMENSIONS ARE TO FINISHED FACE OF
3	ALL DOOD JAMES AT HINGE SIDE TO BE SET 6" EPC

- ALL DOOR JAMBS AT HINGE SIDE TO BE SET 6" FRO
   ALL FLOORING TRANSITIONS SHALL OCCUR AT CEN
   REFERENCE FINISH SCHEDULE FOR FINISH SPECIF
- CONTRACTOR SHALL PROVIDE AND INSTALL WALL COUNTERTOPS, SHELVING, AND ACCESSORIES. CC
   CONFIRM ALL MEASUREMENTS. ALIGN FACE OF NE
- FLUSH LEVER ON TOILET TO BE LOCATED ON LAVA
   REFER TO SHEET G0.2, FOR ALL PLUMBING FIXTURI
- 10. PROTECT ALL EXISTING ITEMS TO REMAIN DURING 11. SEE PLUMBING DRAWINGS FOR TOILET ROOM FIX
- 12. REFER TO SHEET A7.0 FOR TOILET ROOM ACCESS 13. PATCH AND REPAIR EXTERIOR MASONRY WALL SU
- 14. PRIME ALL NEW AND PATCHED EXTERIOR WALL SU 15. FOR WINDOW AND DOOR TYPES SEE SHEET A7.0.
- 16. COORDINATE ALL OPENINGS IN CMU WALLS WITH 17. VERIFY STRUCTURAL JOIST DIMENSIONS.
- PAINT COLUMNS, TYP. AT ALL EXISTING COLUMNS
   ALL NEW STEEL LINTELS TO BE HOT DIP GALVANIZ

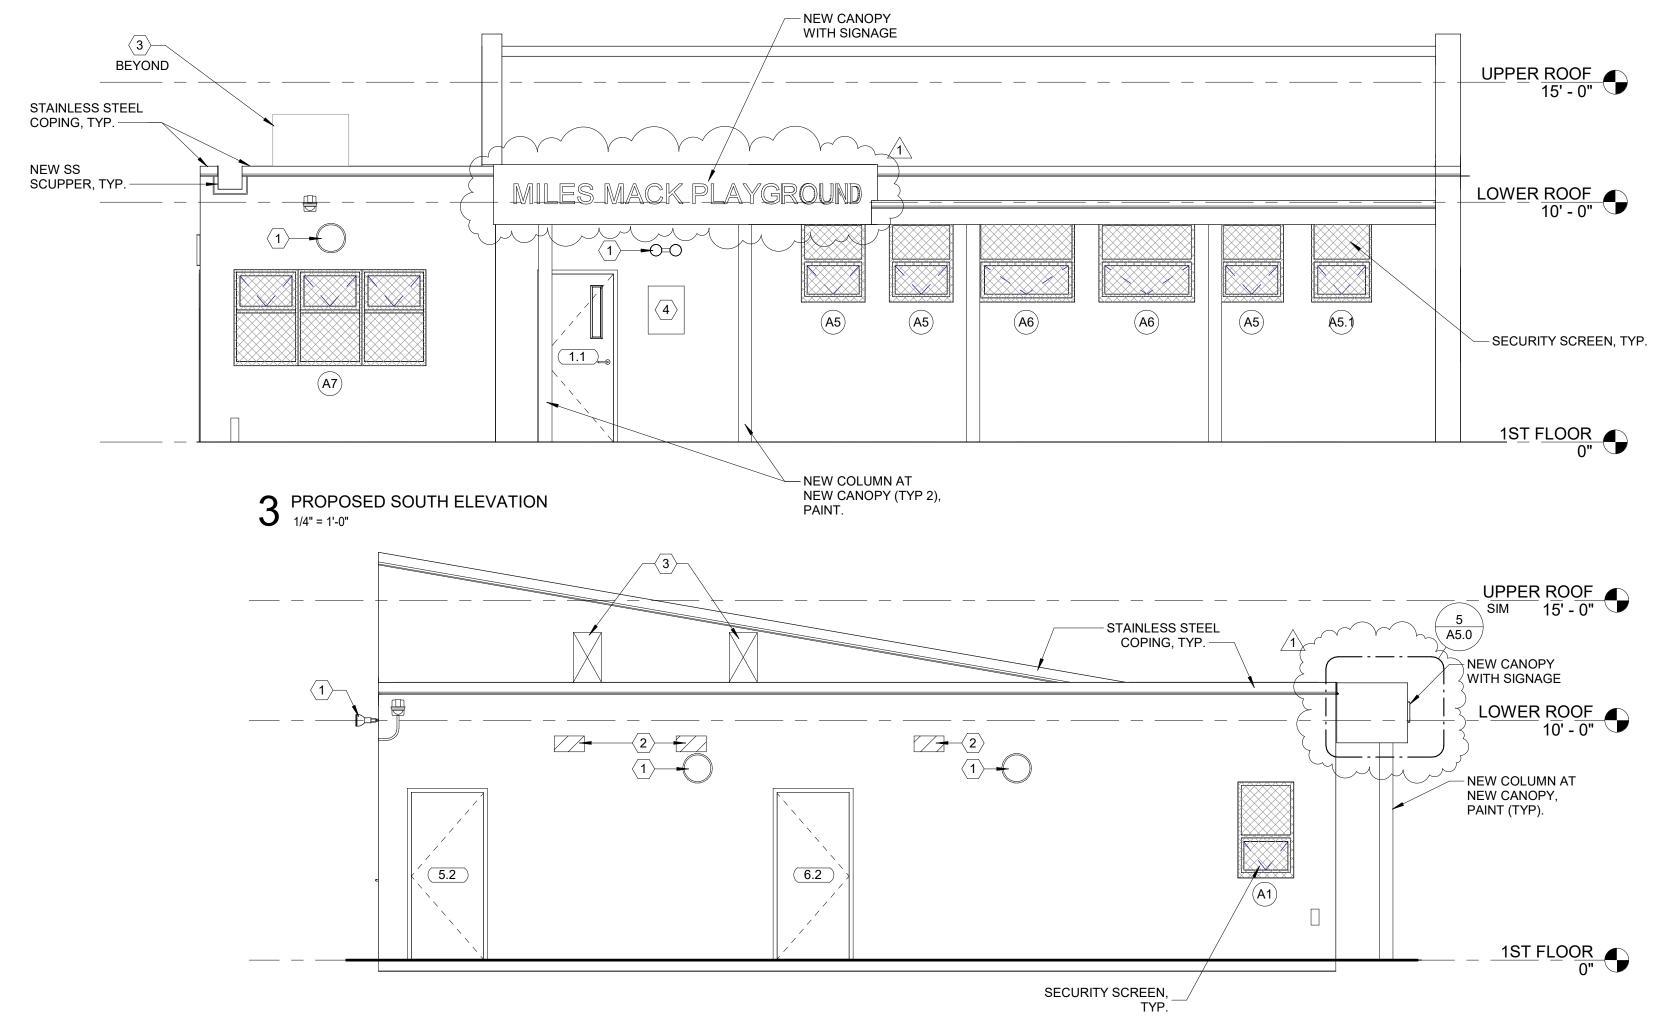Note	
1	REINSTALL SALVAGED LIGHT FIXTURES, S
2	INFILL ABANDONED VENT OPENINGS, TO
3	MECHANICAL EQUIPMENT WITH SECURIT
4	EXISTING SIGNAGE TO REMAIN.

GENERAL CONSTRUCTION NOTES	REVISIO	NS	
	ISSUE	DATE	DESCRIPTION
ONS BEFORE START OF WORK. NOTIFY ARCHITECT IN WRITING OF ALL DISCREPANCIES BEFORE	1	3/6/20	Addendum #2
F WALL SURFACE. COM ADJACENT WALL (MIN.) OR AS OTHERWISE NOTED. ENTERLINE OF CLOSED DOOR, TYPICAL UNO. IFICATIONS. L BLOCKING AS REQUIRED TO SUPPORT ALL WALL HUNG CABINETRY, WALL-HUNG FIXTURES, CONTRACTOR TO COORDINATE CLEARANCES FOR ALL BACK TO BACK FIXTURES. IEW CONSTRUCTION WITH FACE OF EXISTING CONSTRUCTION UNO.			
ATORY SIDE.			
RES AND ACCESSORIES MOUNTING HEIGHTS. G ALL PHASES OF DEMOLITION AND CONSTRUCTION. (TURE SCHEDULE.			
SORIES SCHEDULE. URFACES AND FINISH SURFACES WITH CEMENT PLASTER TO MATCH EXISTING. SURFACES TO RECEIVE FINISH COATS. FINISH COATS BY OTHERS, UNO.			
MECHANICAL AND STRUCTURAL.			
S U.N.O ZED, PRIMED AND PREPARED TO RECEIVE NEW PAINT IN FIELD BY OTHERS.		PHILADELPHI	ANE TO
ELEVATION KEYNOTES			MANEIO
, SEE ELECTRICAL DRAWINGS. COORDINATE DESIGN AND LAYOUT WITH OWNER.			
O MATCH EXISTING ADJACENT. COORDINATE W/ MECH.	PROJEC	I COORDINA I	IUK
ITY ENCLOSURE ON NEW DUNNAGE, SEE MECHANICAL DWGS.	and Depa 1515 Arcl	hia Parks & Re Irtment of Publi n Street, 11th F hia, PA 19102	c Property

	GEORGE MILLING	RED ARCHIN NSYLVAN STEINROOM	MILLIN NUMBER OF STATES
PROJE	CT TEAM		
1600 M	SON, MIRMIRAN ARKET ST, SU DELPHIA, PA 19	ITE 520	PSON, INC
JOHNS 1600 M	CTURAL ENGIN SON, MIRMIRAI ARKET ST, SU DELPHIA, PA 19 5.0300	N & THOMI ITE 520	PSON, INC
JOHNS 1600 M	MS ENGINEEF GON, MIRMIRAI IARKET ST, SU DELPHIA, PA 19 3.0300	- N & THOMI IITE 520	PSON, INC
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REBUIL PHILAD 1515 AI 11TH F	F PHILADELPH LD PHILADELP DELPHIA PARK RCH STREET LOOR, ONE P/ DELPHIA, PENI	HIA AND S & RECR ARKWAY E	UILDING
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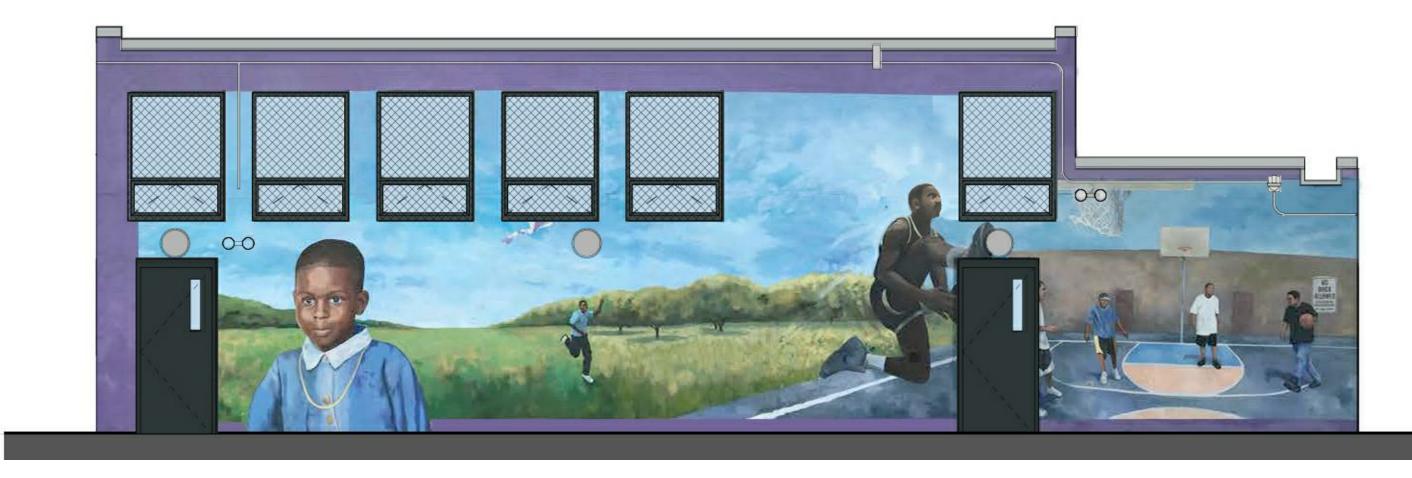





**3** SOUTH ELEVATION 1/4" = 1'-0"



 $2 \text{ NORTH ELEVATION}_{1/4" = 1'-0"}$ 



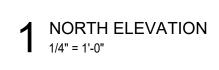






1. THESE ELEVATIONS ARE INCLUDED TO ILLUSTRATE EXISTING MURAL TO BE PAINTED/REPAINTED BY OTHERS.

OTHERS.
 CONTRACTOR IS TO PROTECT MURAL FROM DAMAGE DURING CONSTRUCTION.
 ALL NEW, REPAIRED, AND PATCHES AREAS ARE TO BE PRIMED AND READY FOR FINISH PAINTING.
 FINISH PAINTING OF EXTERIOR SURFACES ARE BY OTHERS WITH THE EXCEPTION OF COLUMNS, DOORS, FRAMES, CONCRETE FLOOR SLAB AT ENTRY CANOPY, UNDERSIDE OF ENTRY CANOPY, AREAS OF NEW CONSTRUCTION, STEEL LINTELS, AND OTHER AREAS AS NOTED.


ISSUE DATE DESCRIPTION								
PHILADELPHIA MANETO								
PROJECT COORDINATOR Philadelphia Parks & Recreation and Department of Public Property 1515 Arch Street, 11th Floor Philadelphia, PA 19102 Contact: Sara Nordstrom, 215-683-0253								
SEAL								
GEORGE HILL STEINROCK NO.								
PROJECT TEAM								
ARCHITECT:								
JOHNSON, MIRMIRAN & THOMPSON, INC								
1600 MARKET ST, SUITE 520 PHILADELPHIA, PA 19103								
267.256.0300								
<u>STRUCTURAL ENGINEER:</u> JOHNSON, MIRMIRAN & THOMPSON, INC								
1600 MARKET ST, SUITE 520 PHILADELPHIA, PA 19103								
267.256.0300								
<u>SYSTEMS ENGINEER:</u> JOHNSON, MIRMIRAN & THOMPSON, INC 1600 MARKET ST, SUITE 520								
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1600 MARKET ST, SUITE 520         PHILADELPHIA, PA 19103         267.256.0300         CITY OF PHILADELPHIA         REBUILD PHILADELPHIA         REBUILD PHILADELPHIA AND         PHILADELPHIA PARKS & RECREATION         1515 ARCH STREET         11TH FLOOR, ONE PARKWAY BUILDING         PHILADELPHIA, PENNSYLVANIA         PROJECT TITLE         MILES MACK BUILDING RENOVATION         DRAWING TITLE         ILLUSTRATIVE EXTERIOR ELEVATIONS         PROJECT NO.         10-20-XXXX-01         DATE: 02.07.2020         SCALE: AS NOTED         DRAWN BY:         OUTCOVER DIV								
1600 MARKET ST, SUITE 520         PHILADELPHIA, PA 19103         267.256.0300         CITY OF PHILADELPHIA         REBUILD PHILADELPHIA         REBUILD PHILADELPHIA AND         PHILADELPHIA PARKS & RECREATION         1515 ARCH STREET         11TH FLOOR, ONE PARKWAY BUILDING         PHILADELPHIA, PENNSYLVANIA         PROJECT TITLE         MILES MACK BUILDING RENOVATION         DRAWING TITLE         ILLUSTRATIVE EXTERIOR ELEVATIONS         PROJECT NO.         DATE: 02.07.2020         SCALE: AS NOTED								

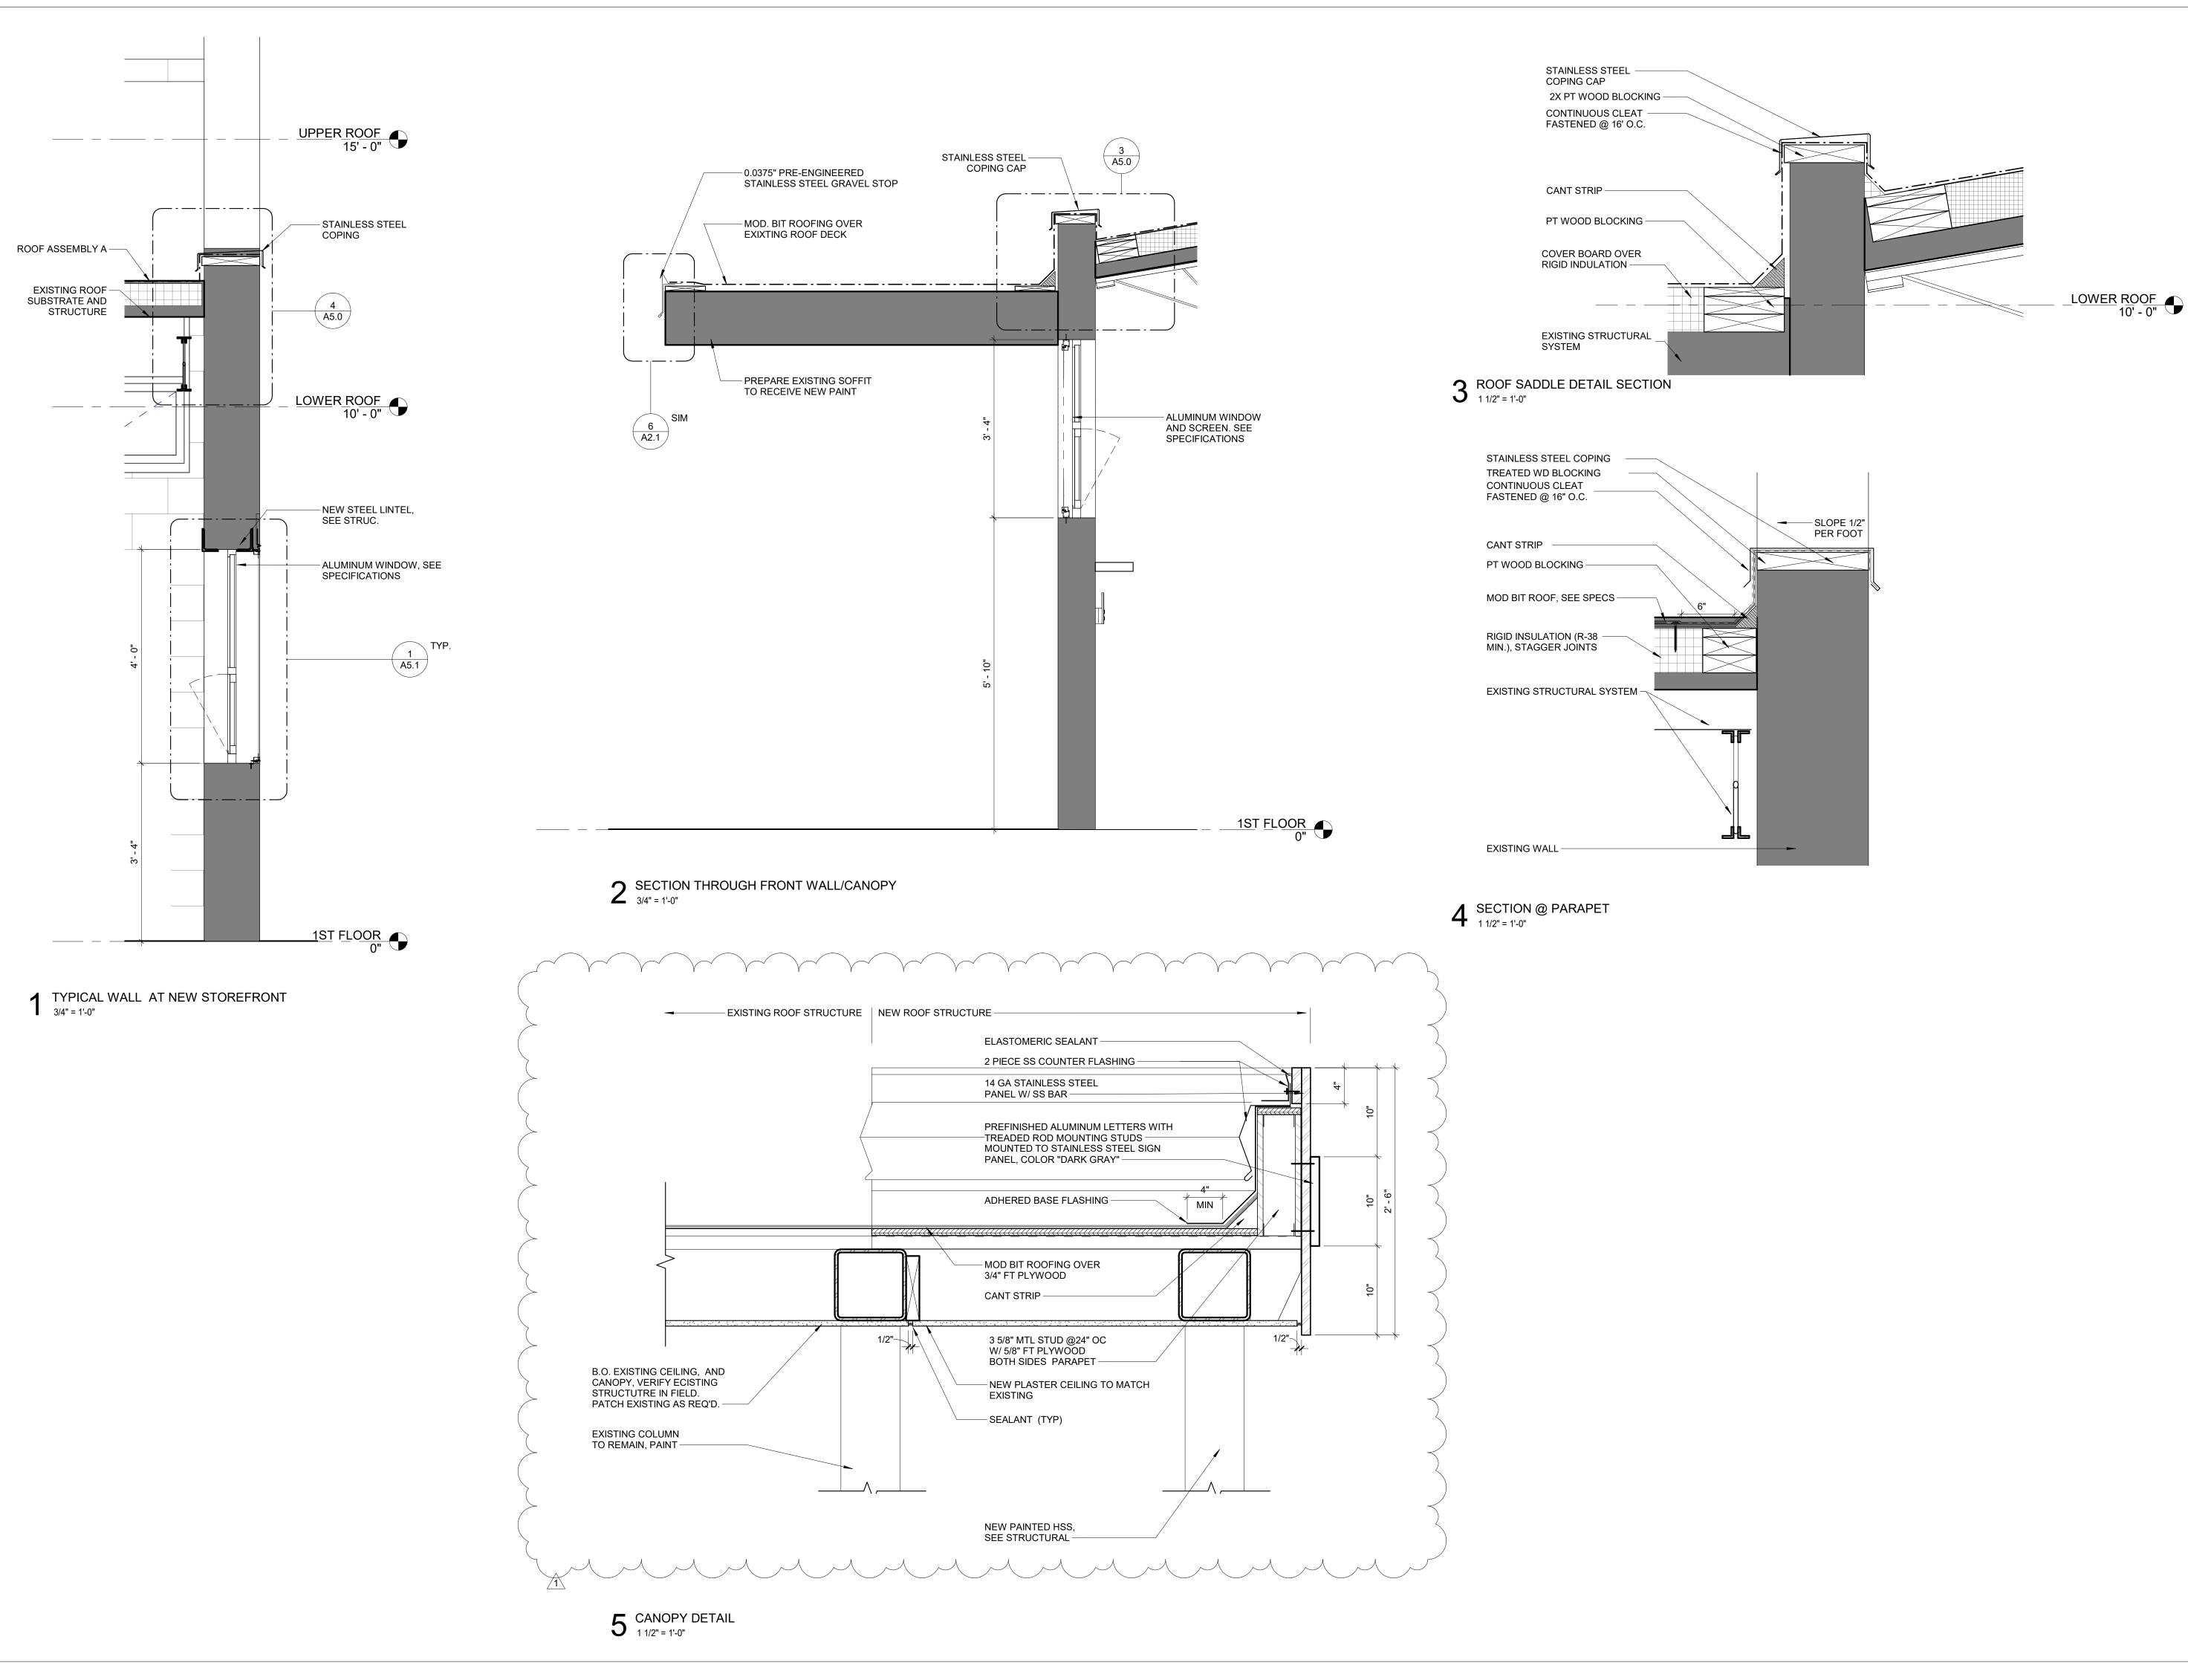


NEW ROOF STRUCTU	
I	
	2 PIECE SS COUNTER FLASHING
	14 GA STAINLESS STEEL
/ 	PREFINISHED ALUMINUM LETTERS WITH TREADED ROD MOUNTING STUDS MOUNTED TO STAINLESS STEEL SIGN PANEL, COLOR "DARK GRAY"
	ADHERED BASE FLASHING
	- MOD BIT ROOFING OVER 3/4" FT PLYWOOD CANT STRIP
1/2"	3 5/8" MTL STUD @24" OC W/ 5/8" FT PLYWOOD BOTH SIDES PARAPET
	— SEALANT (TYP)
\	
	NEW PAINTED HSS,
	NEW PAINTED HSS, SEE STRUCTURAL


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PROJECT	COORDINAT	OR
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1515 Arch	Street, 11th Fl ia, PA 19102	
		, 215-683-0253
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	<u>ENGINEER:</u>	& THOMPSON, INC
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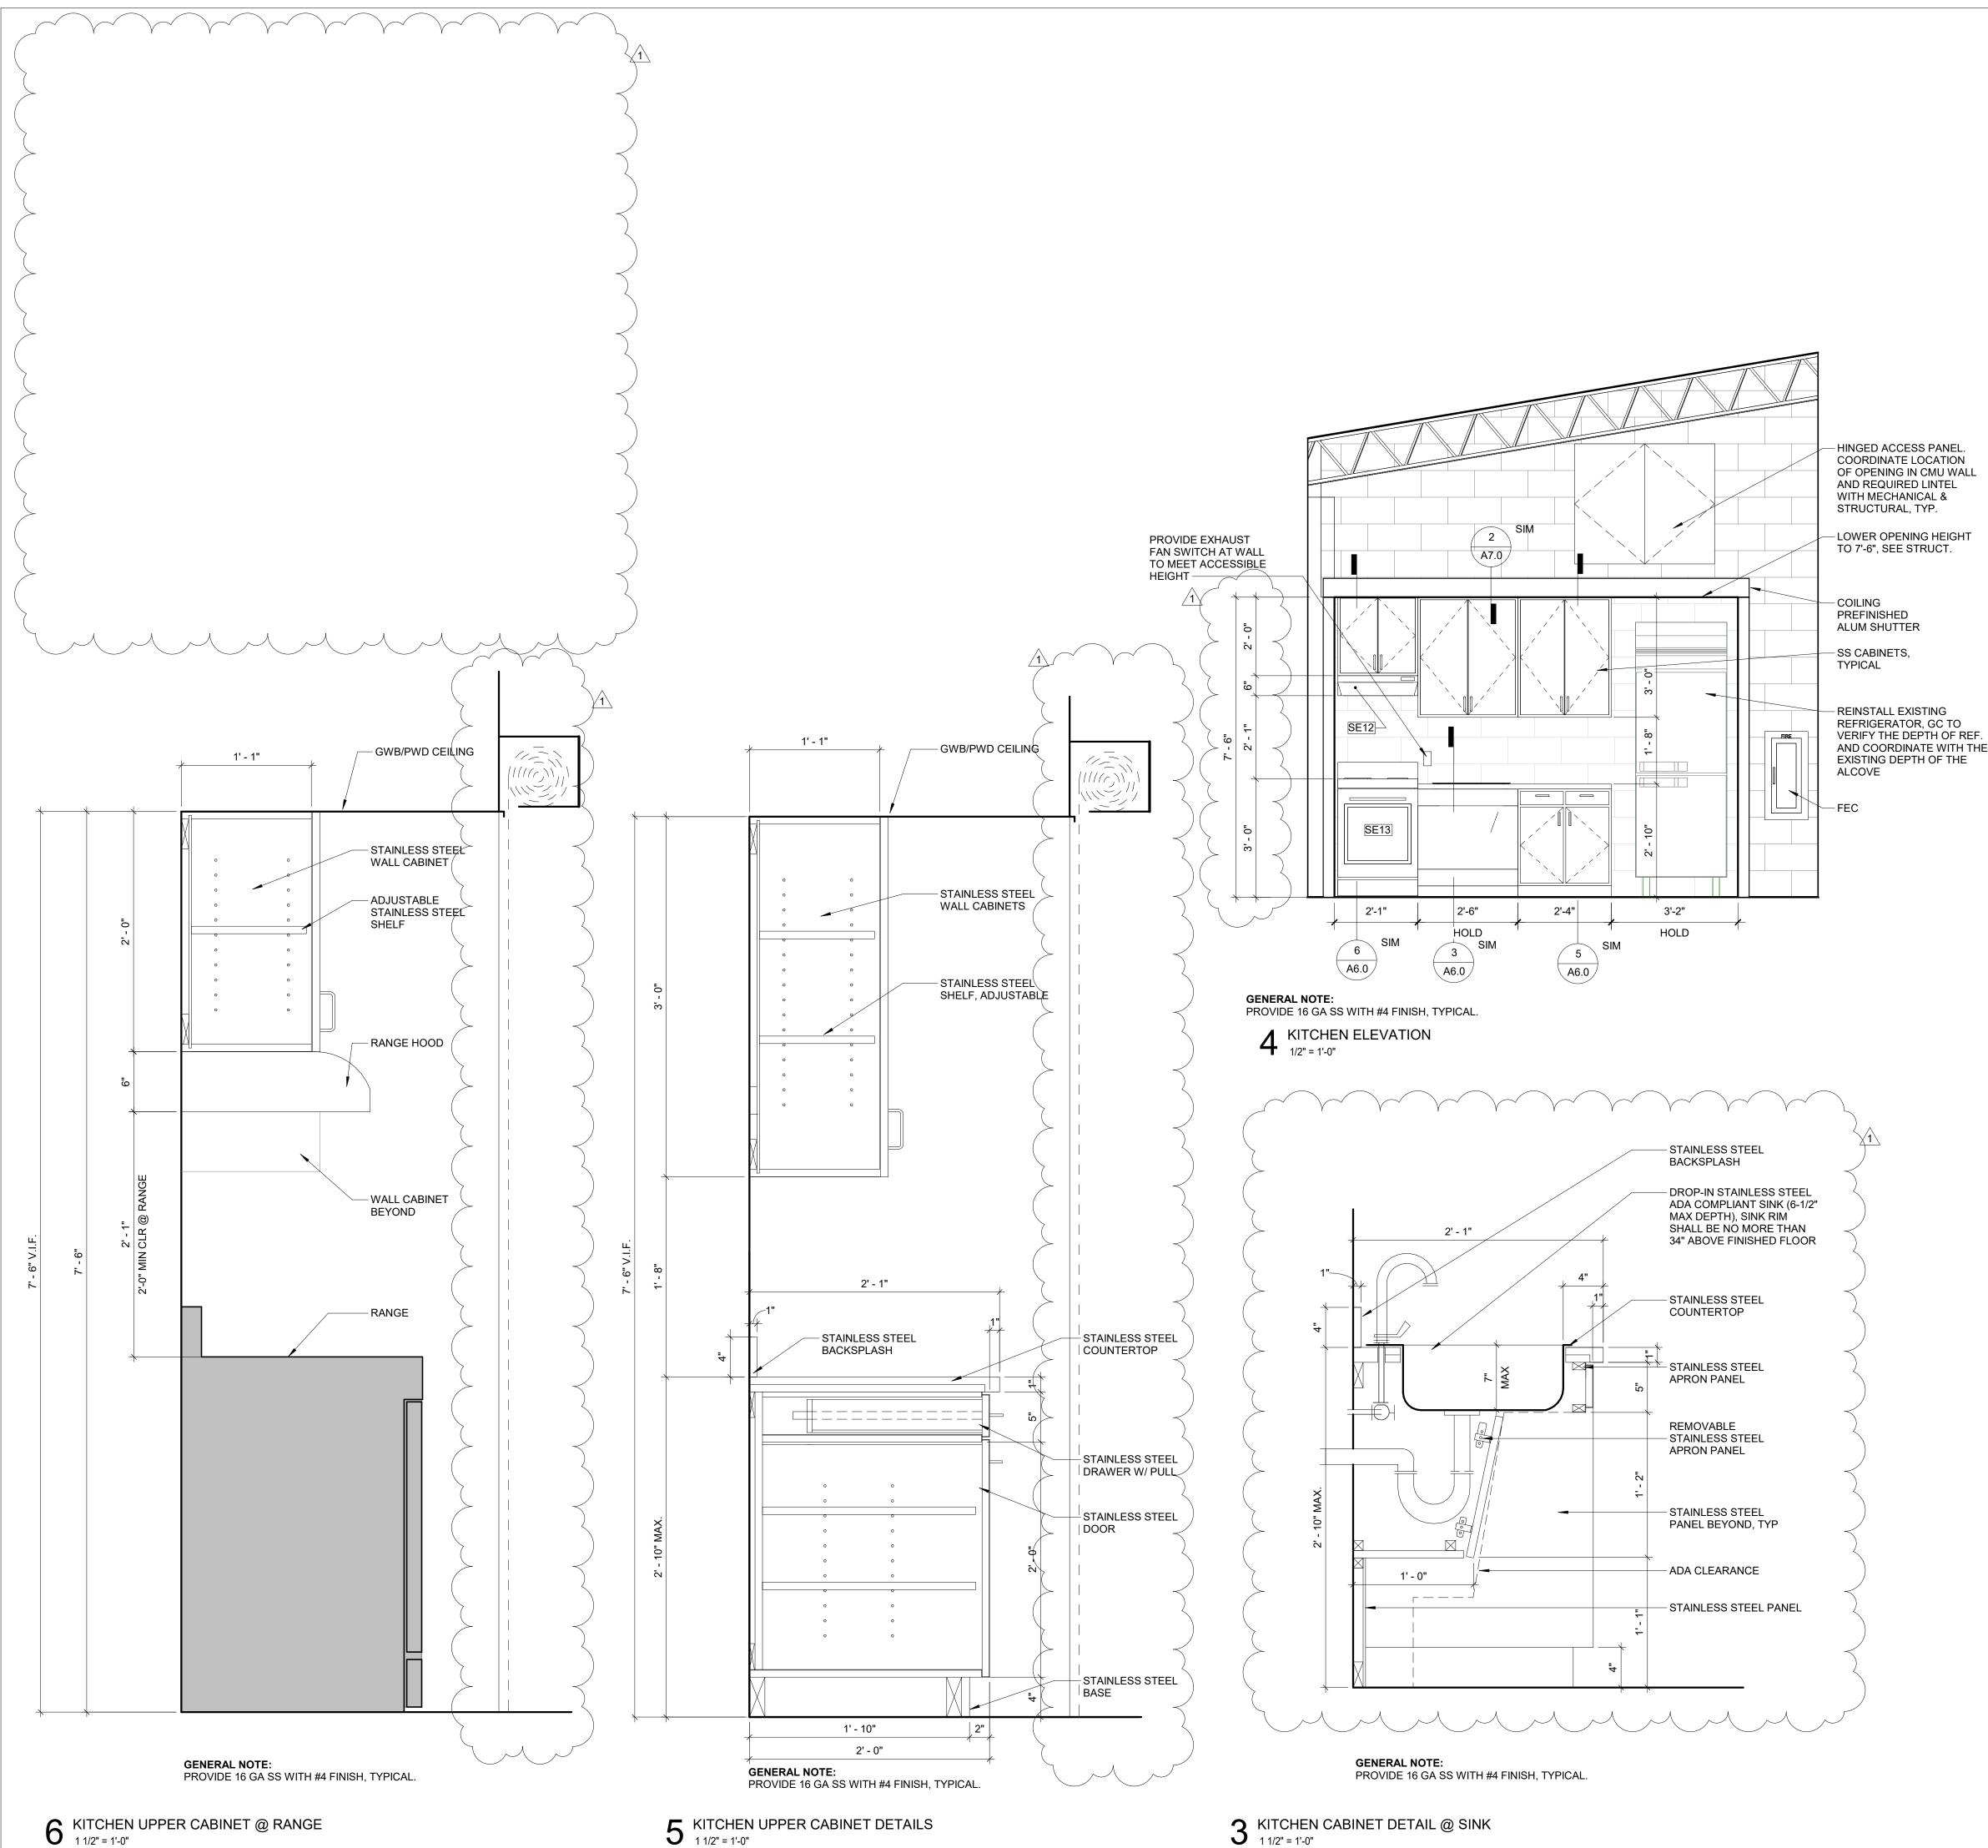


**INTERIOR** 

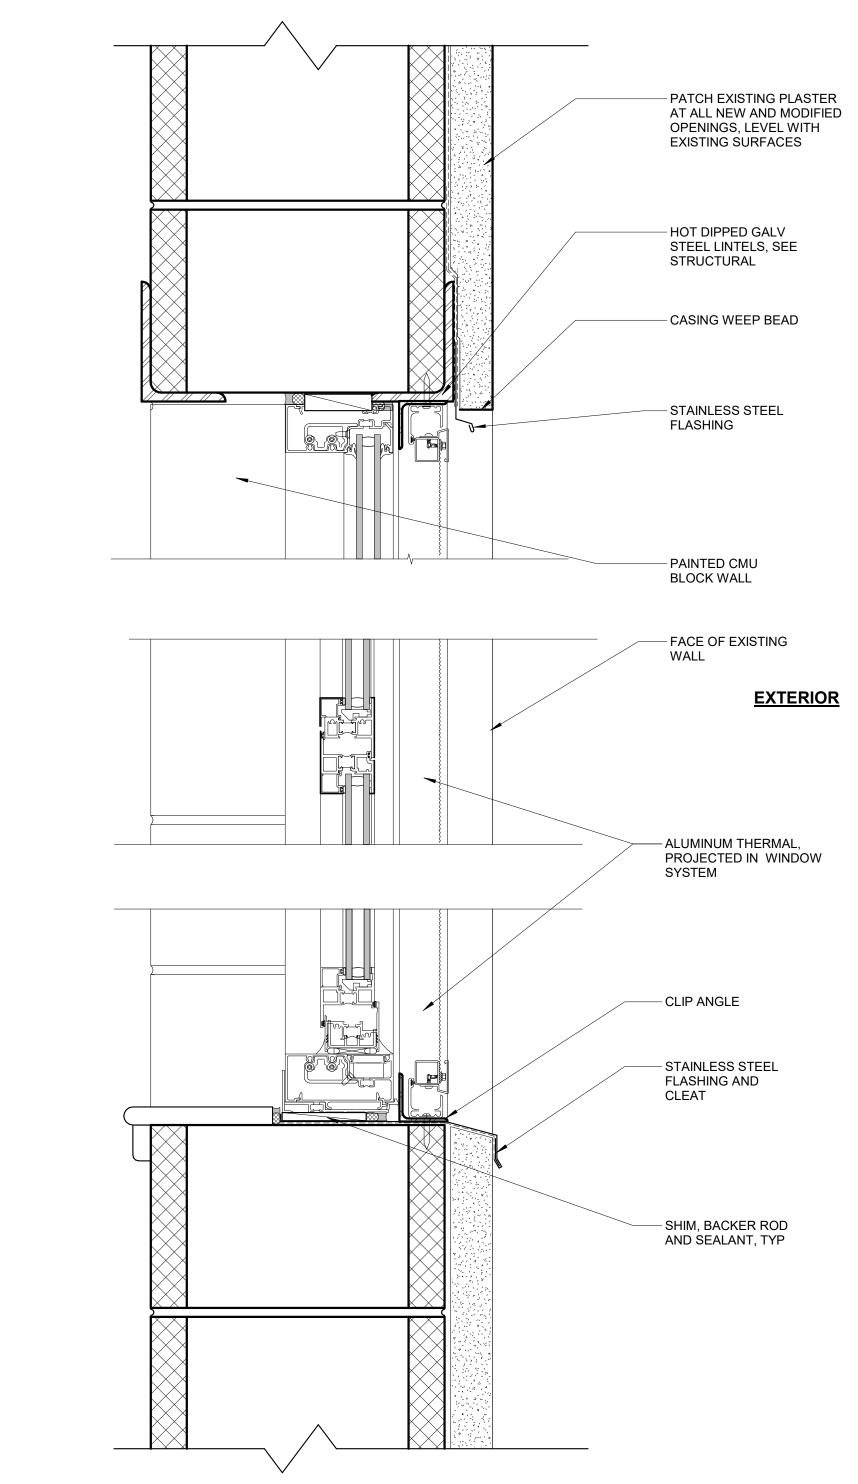


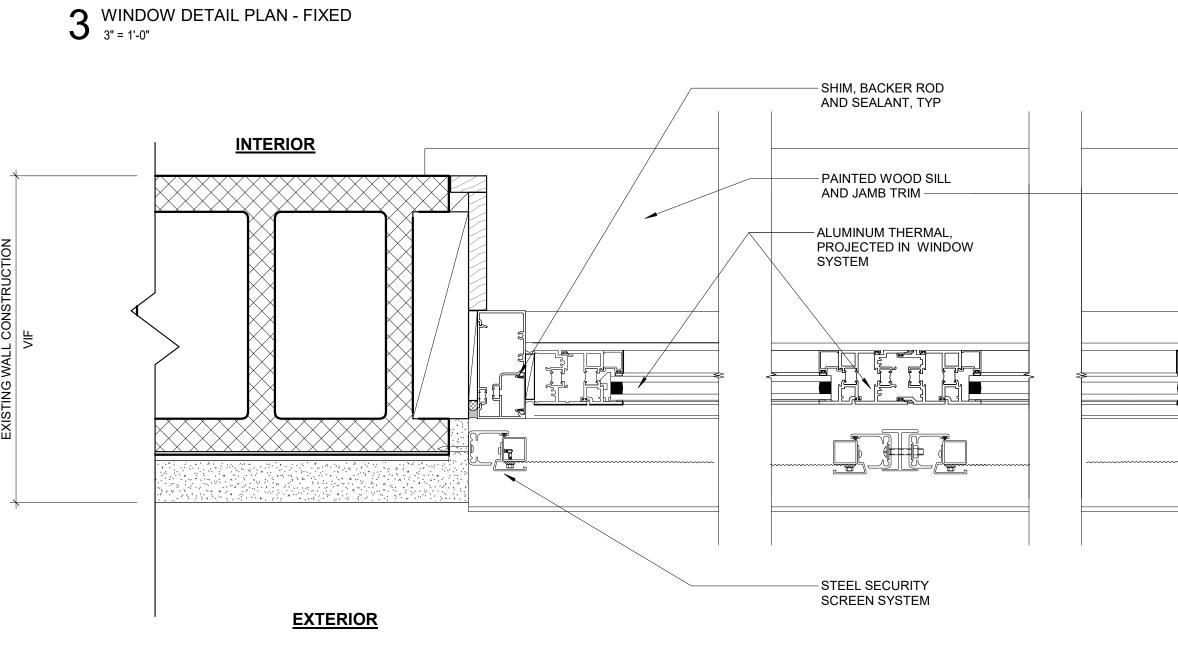


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INTERIOR			
	PROJECT		
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	1600 MAR PHILADEL	RKET ST, SUITE PHIA, PA 1910	E 520
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	1600 MAR PHILADEL 267.256.03	RKET ST, SUITE _PHIA, PA 1910	E 520 )3
		<u>SENGINEER:</u>	
	JOHNSON		THOMPSON, INC
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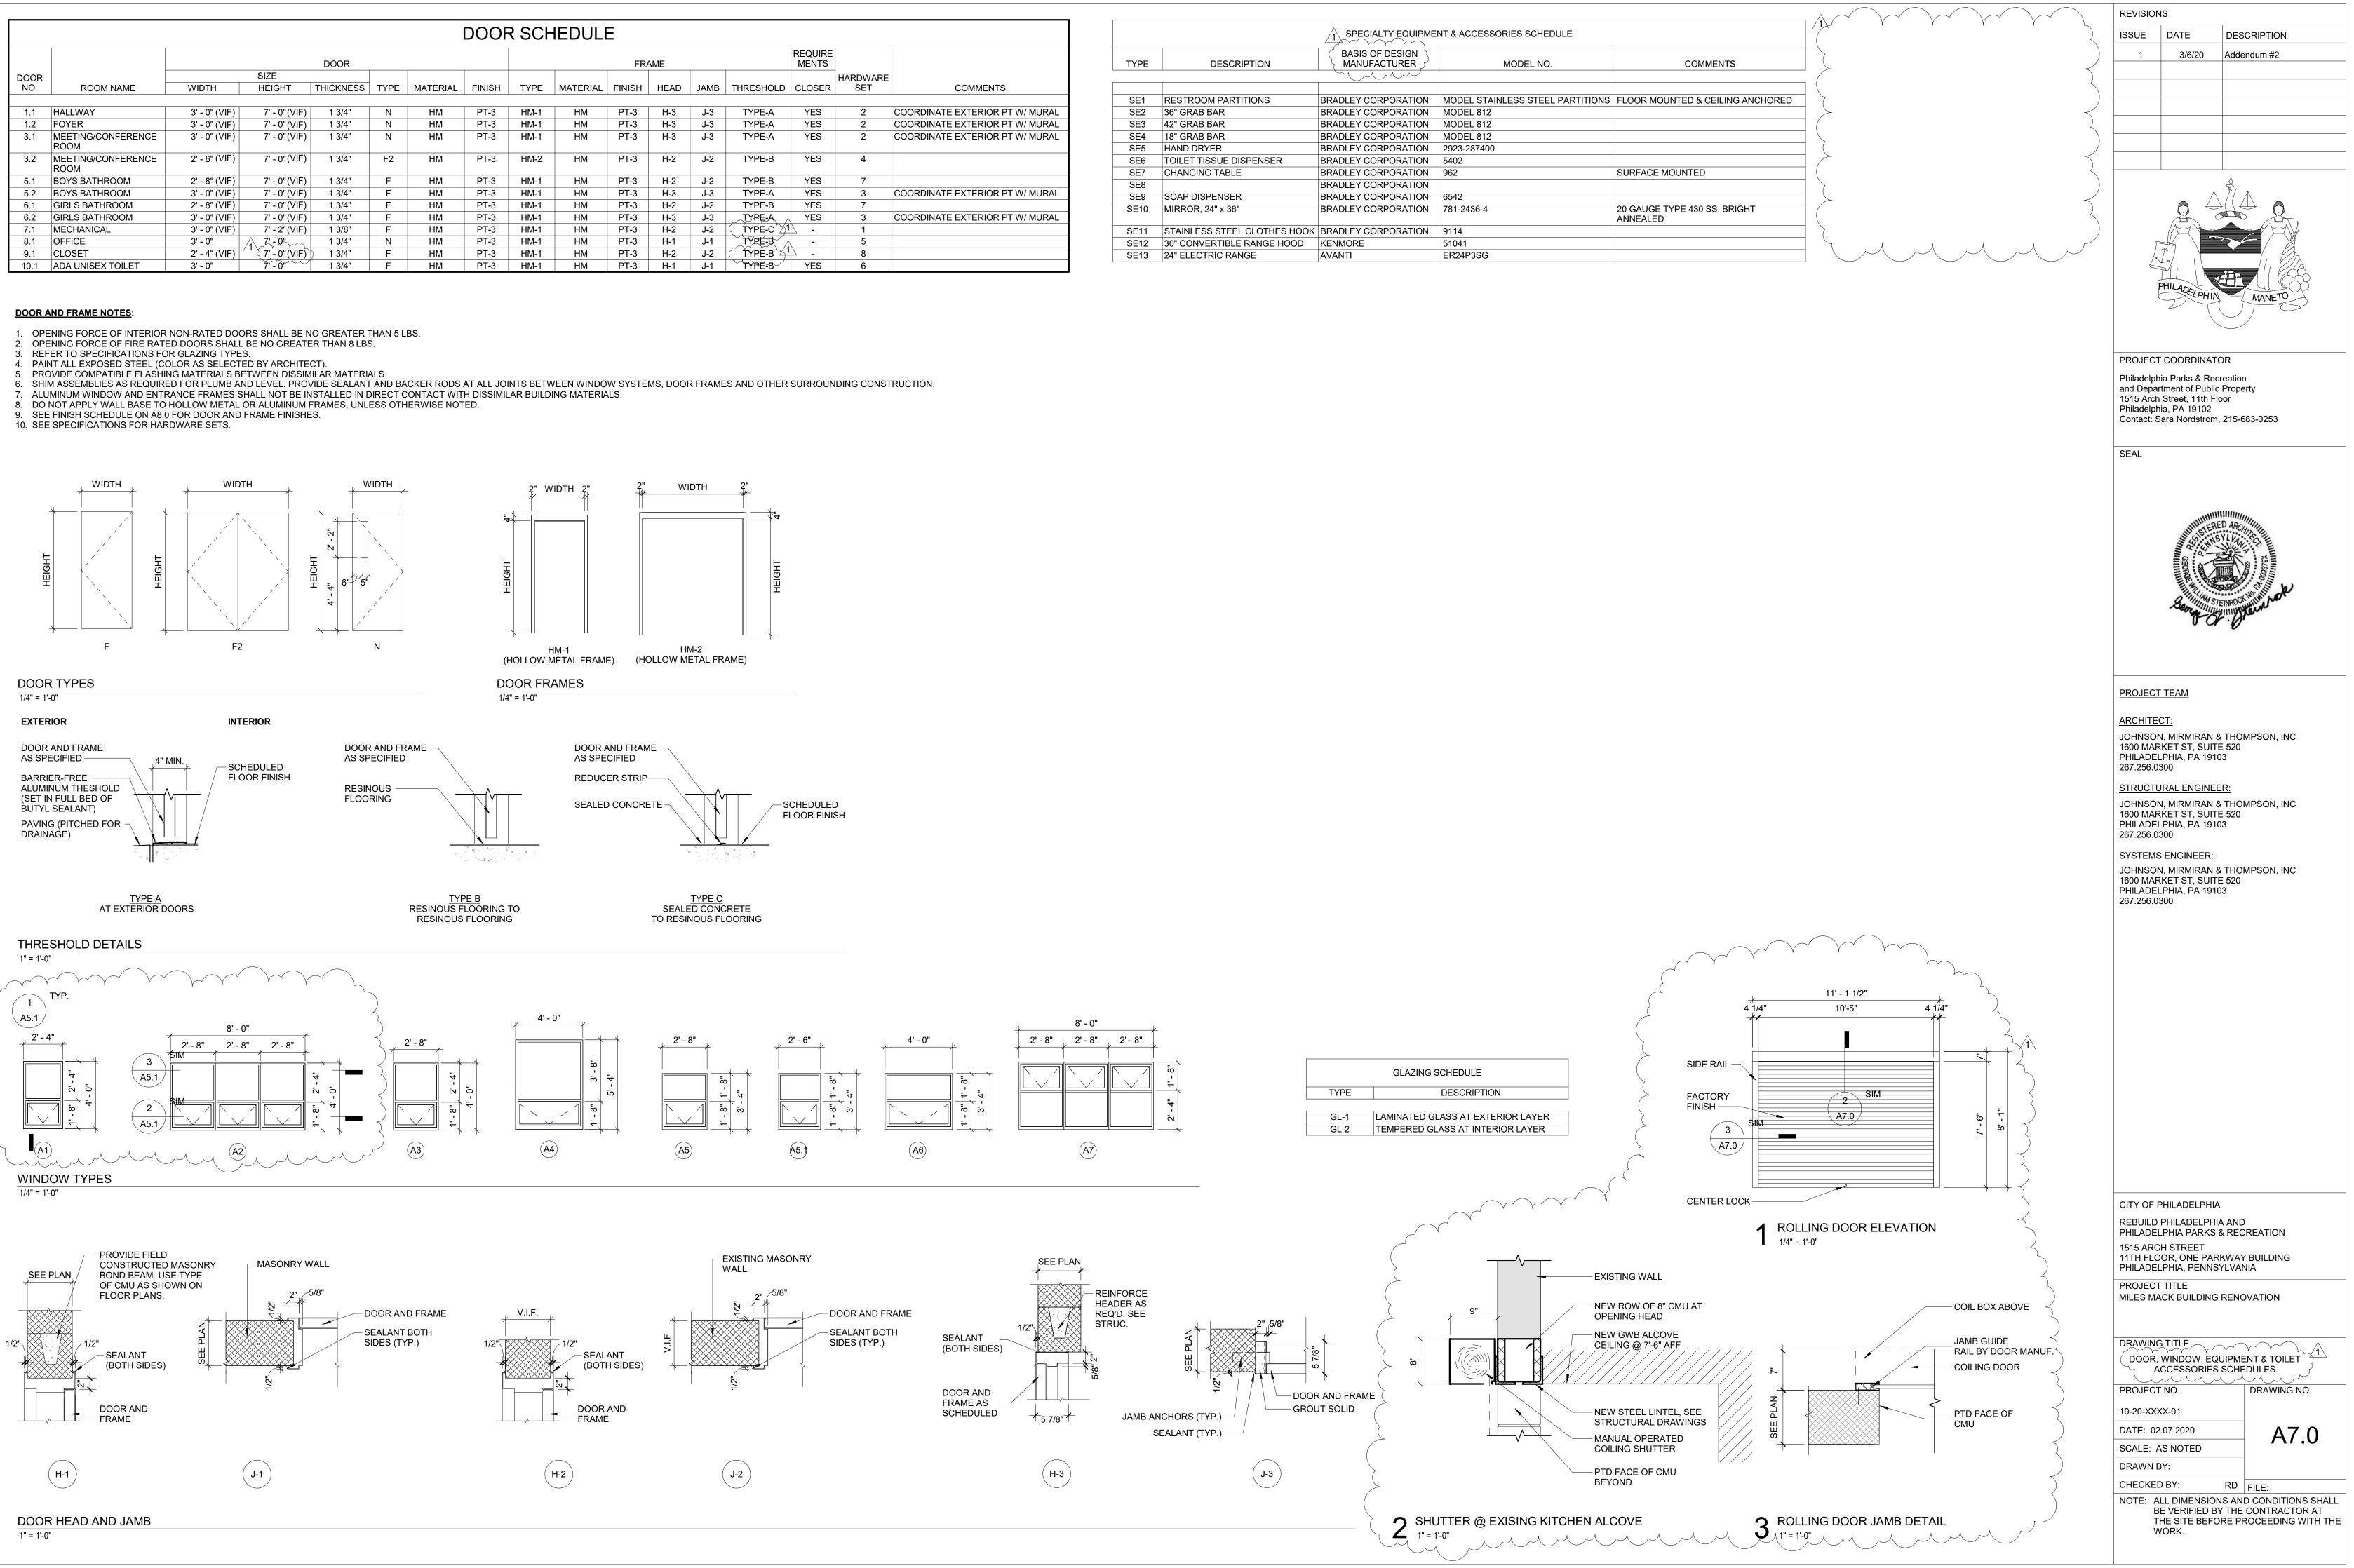


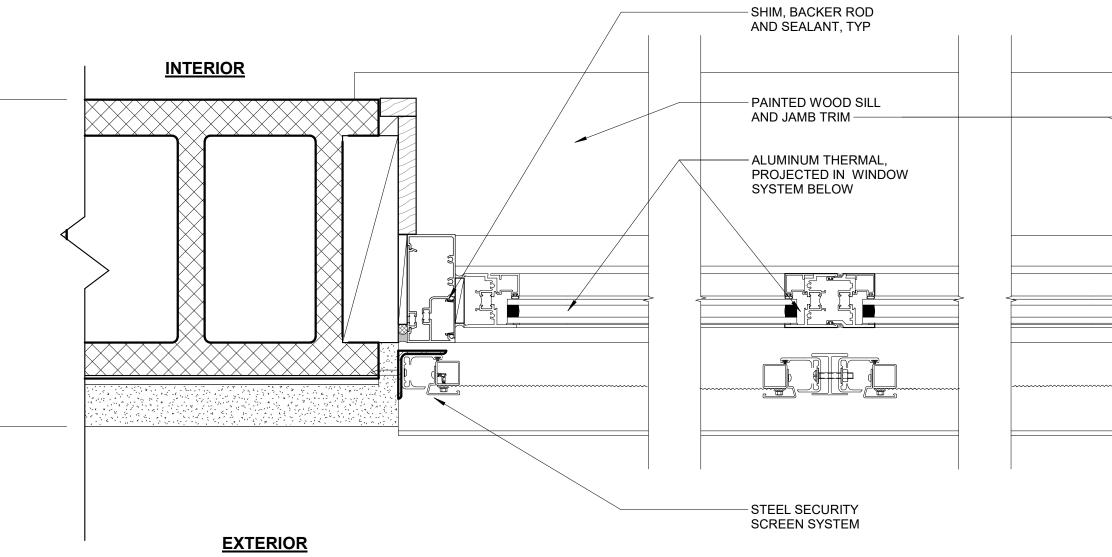

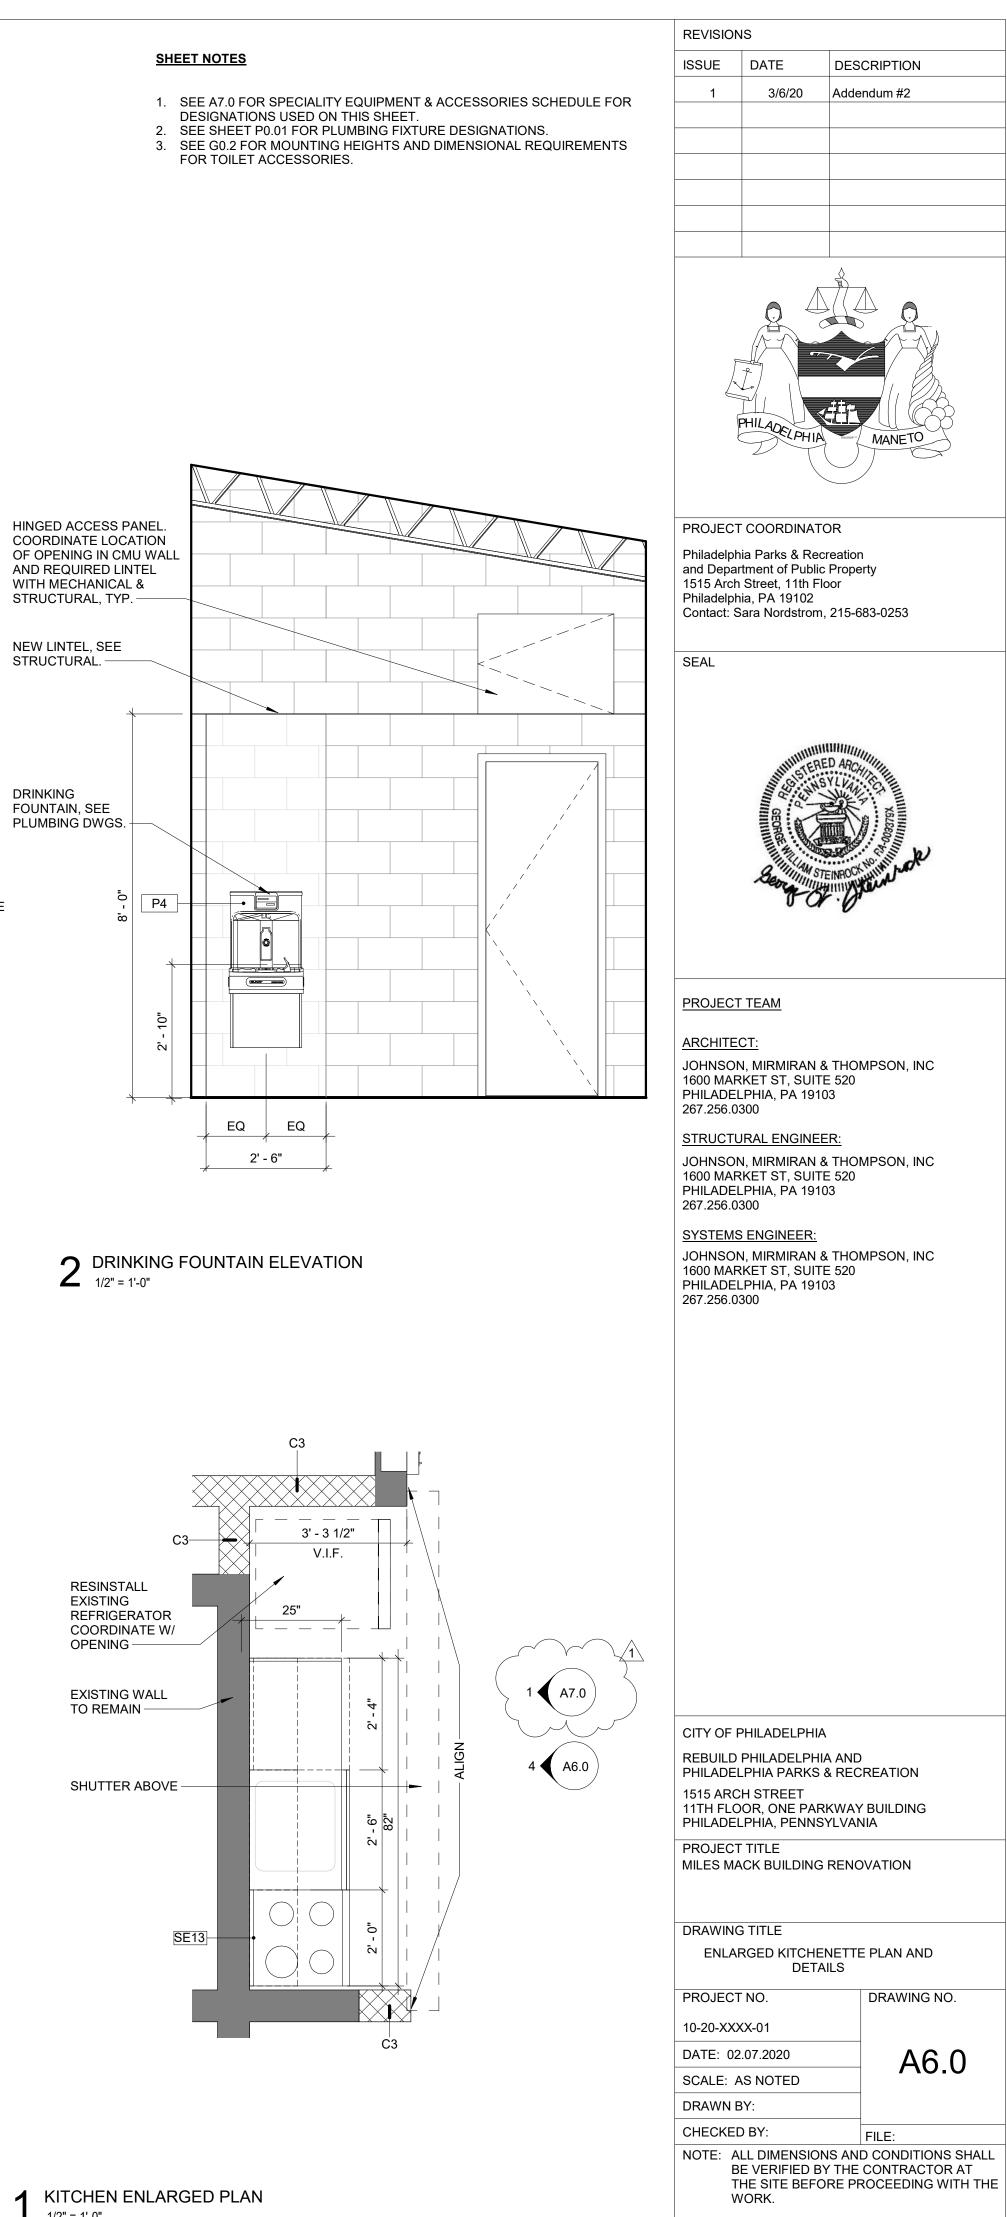


REVISIONS

							DOOF	R SCH	IEDUL	E						
DOOR					FRAME				REQUIRE MENTS							
DOOR			SIZE												HARDWARE	
NO.	ROOM NAME	WIDTH	HEIGHT	THICKNESS	TYPE	MATERIAL	FINISH	TYPE	MATERIAL	FINISH	HEAD	JAMB	THRESHOLD	CLOSER	SET	COMMENTS
1.1	HALLWAY	3' - 0" (VIF)	7' - 0"(VIF)	1 3/4"	Ν	HM	PT-3	HM-1	HM	PT-3	H-3	J-3	TYPE-A	YES	2	COORDINATE EXTERIOR PT W/ MUR
1.2	FOYER	3' - 0" (VIF)	7' - 0"(VIF)	1 3/4"	N	HM	PT-3	HM-1	HM	PT-3	H-3	J-3	TYPE-A	YES	2	COORDINATE EXTERIOR PT W/ MUR
3.1	MEETING/CONFERENCE ROOM	3' - 0" (VIF)	7' - 0"(VIF)	1 3/4"	N	HM	PT-3	HM-1	HM	PT-3	H-3	J-3	TYPE-A	YES	2	COORDINATE EXTERIOR PT W/ MUR
3.2	MEETING/CONFERENCE ROOM	2' - 6" (VIF)	7' - 0"(VIF)	1 3/4"	F2	HM	PT-3	HM-2	HM	PT-3	H-2	J-2	TYPE-B	YES	4	
5.1	BOYS BATHROOM	2' - 8" (VIF)	7' - 0"(VIF)	1 3/4"	F	HM	PT-3	HM-1	HM	PT-3	H-2	J-2	TYPE-B	YES	7	
5.2	BOYS BATHROOM	3' - 0" (VIF)	7' - 0"(VIF)	1 3/4"	F	HM	PT-3	HM-1	HM	PT-3	H-3	J-3	TYPE-A	YES	3	COORDINATE EXTERIOR PT W/ MUR
6.1	GIRLS BATHROOM	2' - 8" (VIF)	7' - 0"(VIF)	1 3/4"	F	HM	PT-3	HM-1	HM	PT-3	H-2	J-2	TYPE-B	YES	7	
6.2	GIRLS BATHROOM	3' - 0" (VIF)	7' - 0"(VIF)	1 3/4"	F	HM	PT-3	HM-1	HM	PT-3	H-3	J-3	TYRE-A	YES	3	COORDINATE EXTERIOR PT W/ MUR
7.1	MECHANICAL	3' - 0" (VIF)	7' - 2"(VIF)	1 3/8"	F	HM	PT-3	HM-1	HM	PT-3	H-2	J-2		<u> </u>	1	
8.1	OFFICE	3' - 0"	1 7'-0"	1 3/4"	N	HM	PT-3	HM-1	HM	PT-3	H-1	J-1	TYPE-B	-	5	
9.1	CLOSET	2' - 4" (VIF)	7' - 0"(VIF)	1 3/4"	F	HM	PT-3	HM-1	HM	PT-3	H-2	J-2	ŢŤŶPĚ-B 5	- 4	8	
10.1	ADA UNISEX TOILET	3' - 0"	7' - 0"	1 3/4"	F	HM	PT-3	HM-1	HM	PT-3	H-1	J-1	TYPE-B	YES	6	

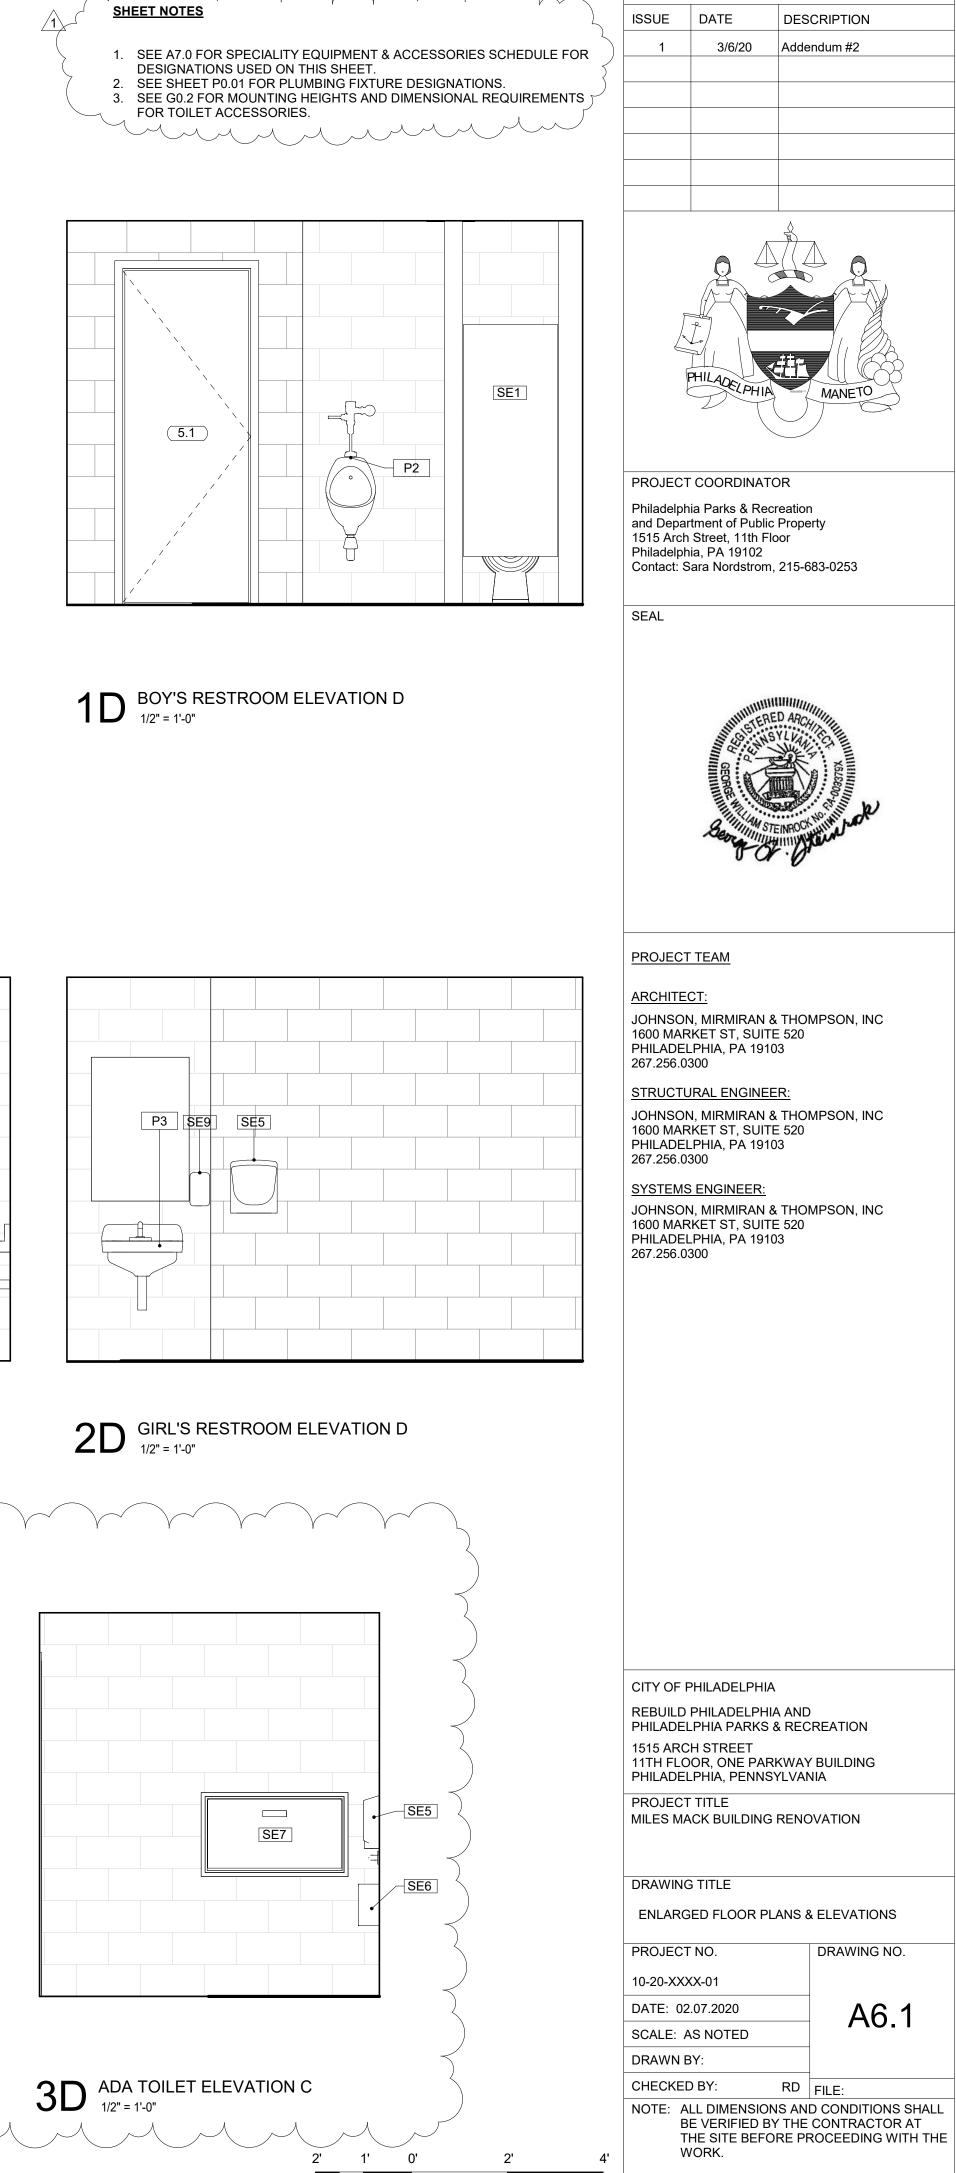

			NT & ACCESSORIES SCHEDULE		
TYPE	DESCRIPTION	DESCRIPTION			
SE1	RESTROOM PARTITIONS	BRADLEY CORPORATION	MODEL STAINLESS STEEL PARTITIONS	FLOOF	
SE2	36" GRAB BAR	BRADLEY CORPORATION	MODEL 812		
SE3	42" GRAB BAR	BRADLEY CORPORATION	MODEL 812		
SE4	18" GRAB BAR	BRADLEY CORPORATION	MODEL 812		
SE5	HAND DRYER	BRADLEY CORPORATION	2923-287400		
SE6	TOILET TISSUE DISPENSER	BRADLEY CORPORATION	5402		
SE7	CHANGING TABLE	BRADLEY CORPORATION	962	SURF	
SE8		BRADLEY CORPORATION			
SE9	SOAP DISPENSER	BRADLEY CORPORATION	6542		
SE10	MIRROR, 24" x 36"	BRADLEY CORPORATION	781-2436-4	20 GA ANNE	
SE11	STAINLESS STEEL CLOTHES HOOK	BRADLEY CORPORATION	9114		
SE12	30" CONVERTIBLE RANGE HOOD	KENMORE	51041		
SE13	24" ELECTRIC RANGE	AVANTI	ER24P3SG		

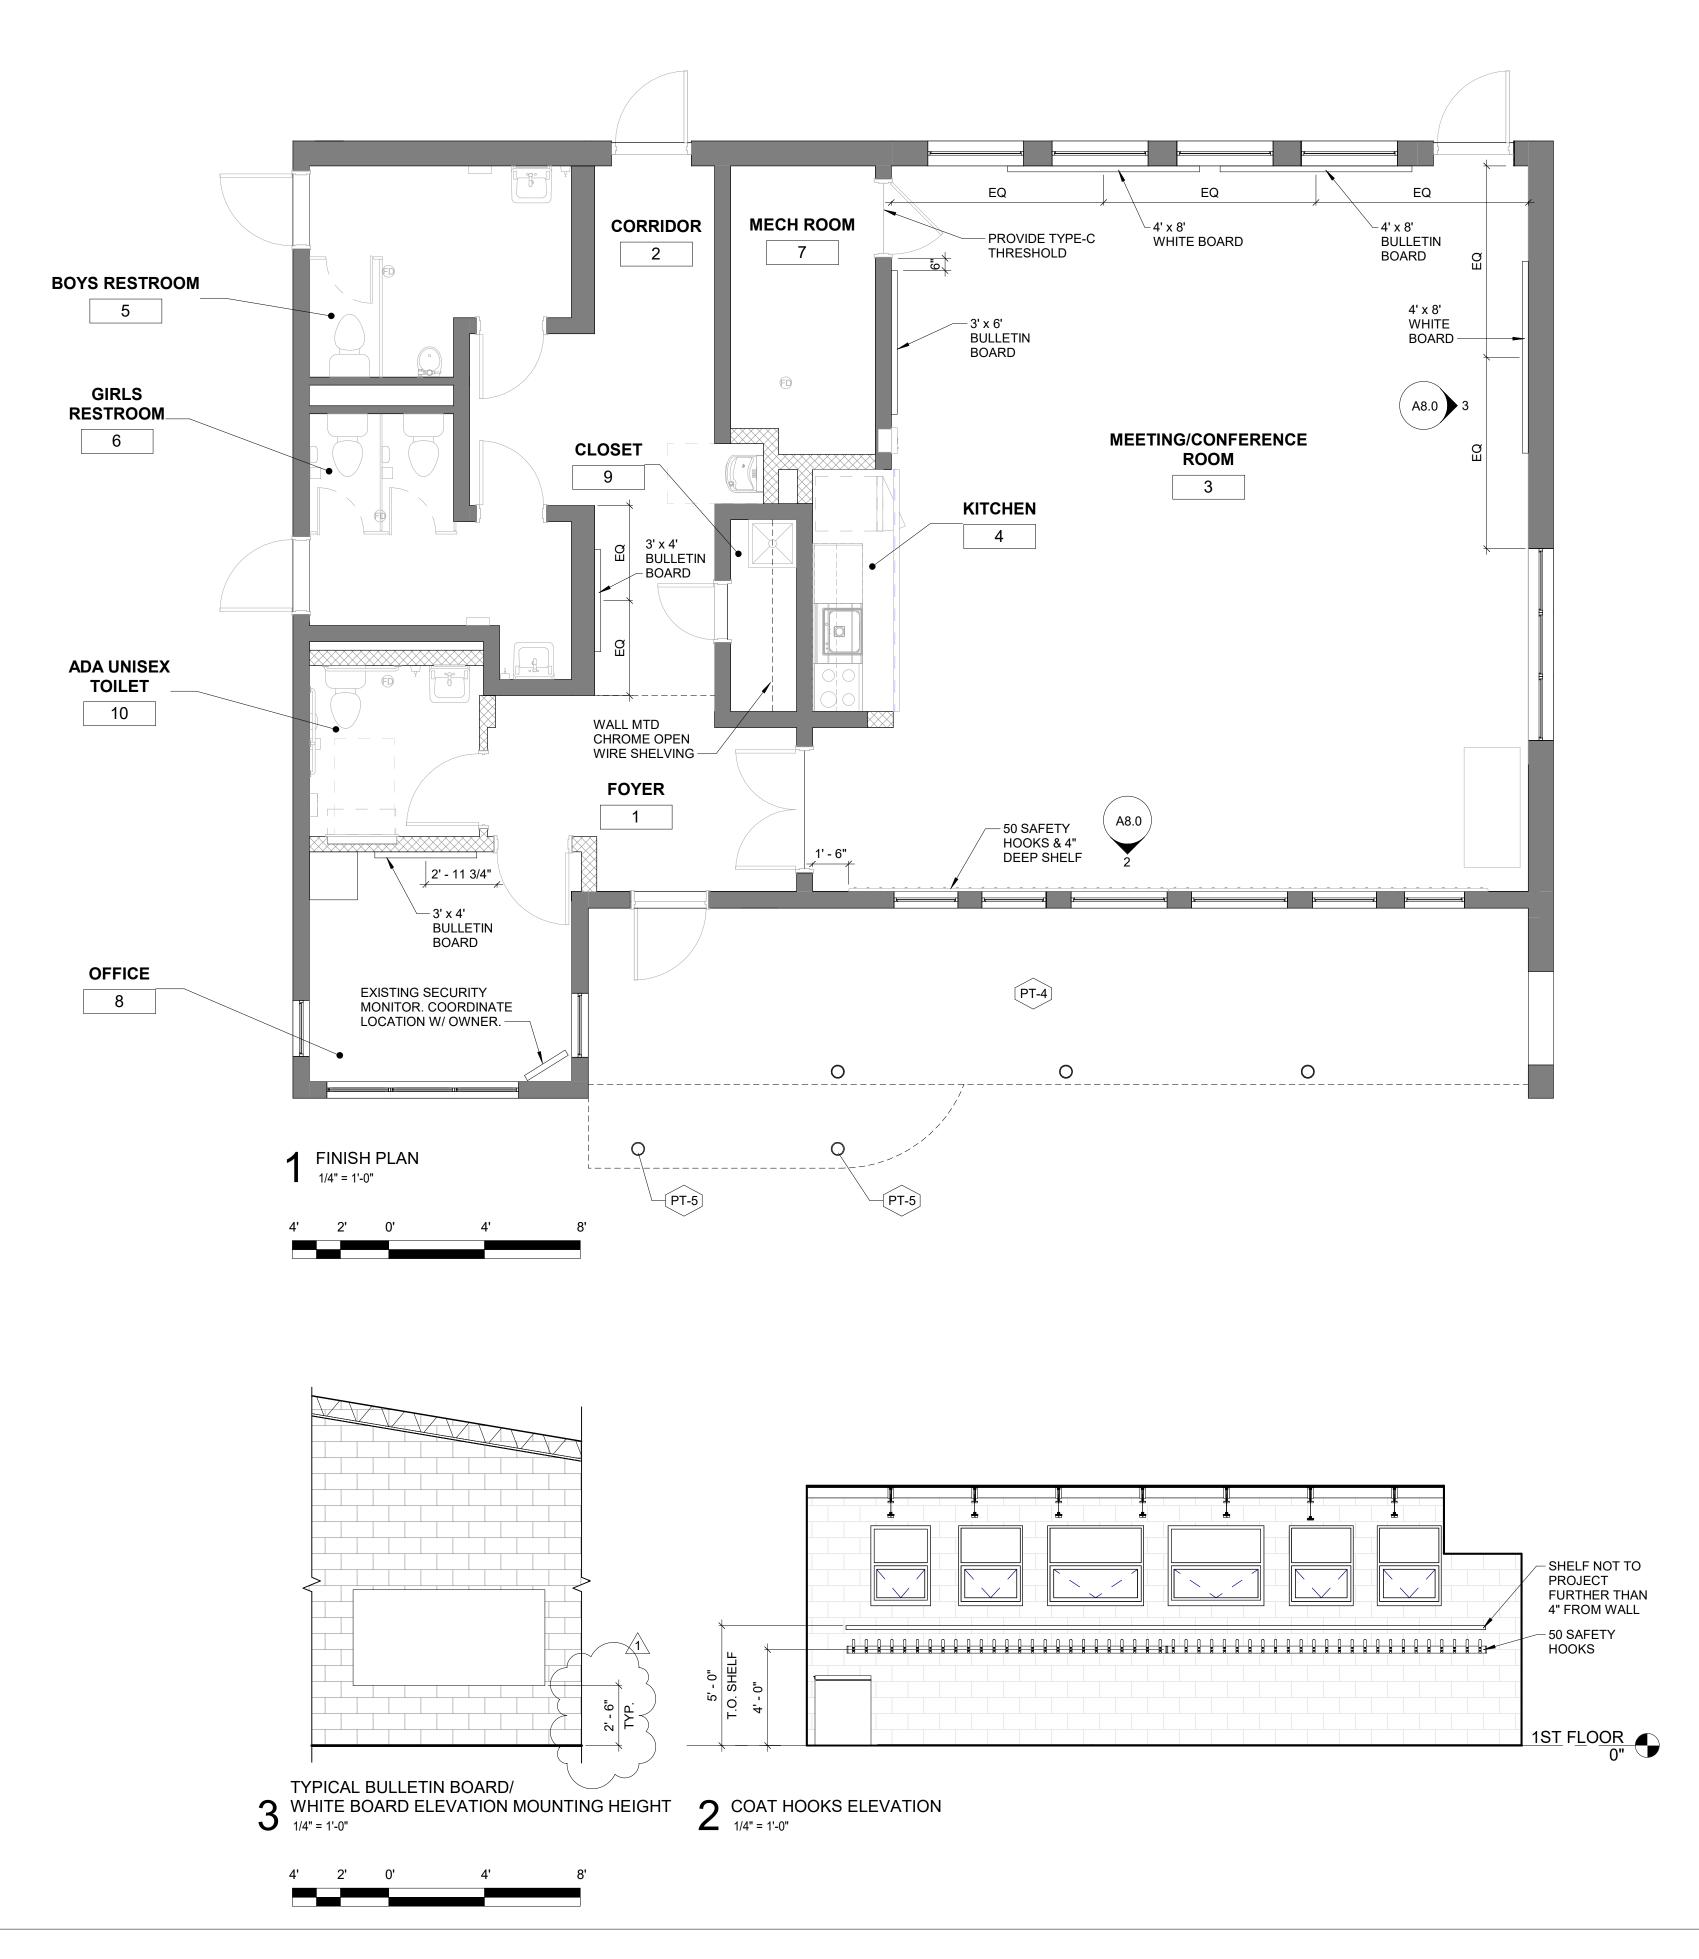


	ROOM FINISH SCHEDULE					
	WTWT		FI	NISH		
NO.	NAME	FLOOR	BASE	WALL	CEILING	COMMENTS
1	FOYER	F-1	B-1	PT-2	PT-1	
2	CORRIDOR	F-1	B-1	PT-2	PT-1	PAINT EXPOSED SECTIONS OF UNDERSIDE OF ROOF DECK AND EXPOSED ROOF TRUSSES TO MATCH CEILING FINISH
3	MEETING/CONFERENCE ROOM	F-2	B-2	PT-2	PT-1	PAINT EXPOSED SECTIONS OF UNDERSIDE OF ROOF DECK AND EXPOSED ROOF TRUSSES TO MATCH CEILING FINISH
4	KITCHEN	F-2	B-2	PT-2	PT-1	
5	BOYS RESTROOM	F-1	B-1	PT-2	PT-1	
6	GIRLS RESTROOM	F-1	B-1	PT-2	PT-1	(
7	MECH ROOM	F-3	-	PT-2	PT-1	
8	OFFICE	F-1	B-1	PT-2	PT-1	
9	CLOSET	F-1	B-1	PT-2	PT-1	
10	ADA UNISEX TOILET	F-1	B-1	PT-2	PT-1	

SHEET NOTES:

1. PAINT ALL METAL FACEPLATES

	FINISH SCHEDULE					
FINISH TYPE	CODE	MANUF. / STYLE / SERIES	COLOR	REMARKS		
FLOORING	F-I	STONHARD STONETEC TRF	SMOKY MOUNTAINS	RESINOUS FLOOR APPLICATION		
FLOORING	F-2	STONHARD STONTEC TRF	GLACIER PEAK	RESINOUS FLOOR APPLICATION WITH INTERGRAL BASE		
FLOORING	F-3	SEALED CONCRETE				
BASE	B-I	STONHARD STONTEC TRF	SMOKY MOUNTAINS INTEGRATED EPOXY FLOOR BASE	THROUGHOUT ALL SPACES WITH		
BASE	B-2	STONHARD STONTEC TRF	GLACIER PEAK	JHROUGHOUT ALL SPACES WITH F-2 FLOOR FINISH		
PAINT	PT-I	SHERWIN WILLIAMS	CEILING BRIGHT WHITE	ALL EXPOSED AND GWB CEILINGS		
PAINT	PT-2	SHERWIN WILLIAMS LATEX SEMI-GLOSS ENAMEL	OLYMPUS WHITE SW-6253	THROUGHOUT ALL INTERIOR SPACES		
PAINT	PT-3	SHERWIN WILLIAMS LATEX SEMI-GLOSS ENAMEL	SOFTWARE SW-7074	ALL INTERIOR DOORS & FRAMES		
PAINT	PT-4			MATCH EXISTING		
PAINT	PT-5			PAINT COLUMNS TO MATCH EXISTING		

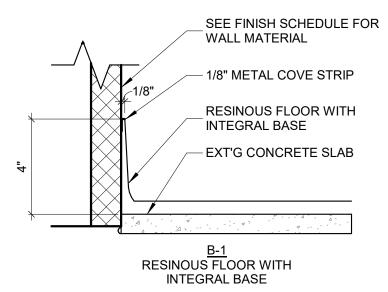

WALL BASE DETAIL 3" = 1'-0"


- 1/8" METAL COVE STRIP

- EXT'G CONCRETE SLAB

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ISSUE	DATE	DESCRIPTION		
1	3/6/20	Addendum #2		
PROJECT Philadelph and Depar 1515 Arch Philadelph	COORDINATO ia Parks & Recu tment of Public Street, 11th Flo ia, PA 19102 ara Nordstrom,	reation Property por		
	E. S. C.	D ARCHINE CT. YELGOOD		
PROJECT	TEAM			
ARCHITE	<u>CT:</u>			
1600 MAR	RKET ST, SUITE			
PHILADEL 267.256.03	_PHIA, PA 1910 300	)3		
JOHNSON 1600 MAR PHILADEL	KET ST, SUITE PHIA, PA 1910	THOMPSON, INC 520		
267.256.03 SYSTEMS				
SYSTEMS ENGINEER: JOHNSON, MIRMIRAN & THOMPSON, INC 1600 MARKET ST, SUITE 520 PHILADELPHIA, PA 19103 267.256.0300				
CITY OF PHILADELPHIA REBUILD PHILADELPHIA AND PHILADELPHIA PARKS & RECREATION 1515 ARCH STREET 11TH FLOOR, ONE PARKWAY BUILDING PHILADELPHIA, PENNSYLVANIA PROJECT TITLE MILES MACK BUILDING RENOVATION				
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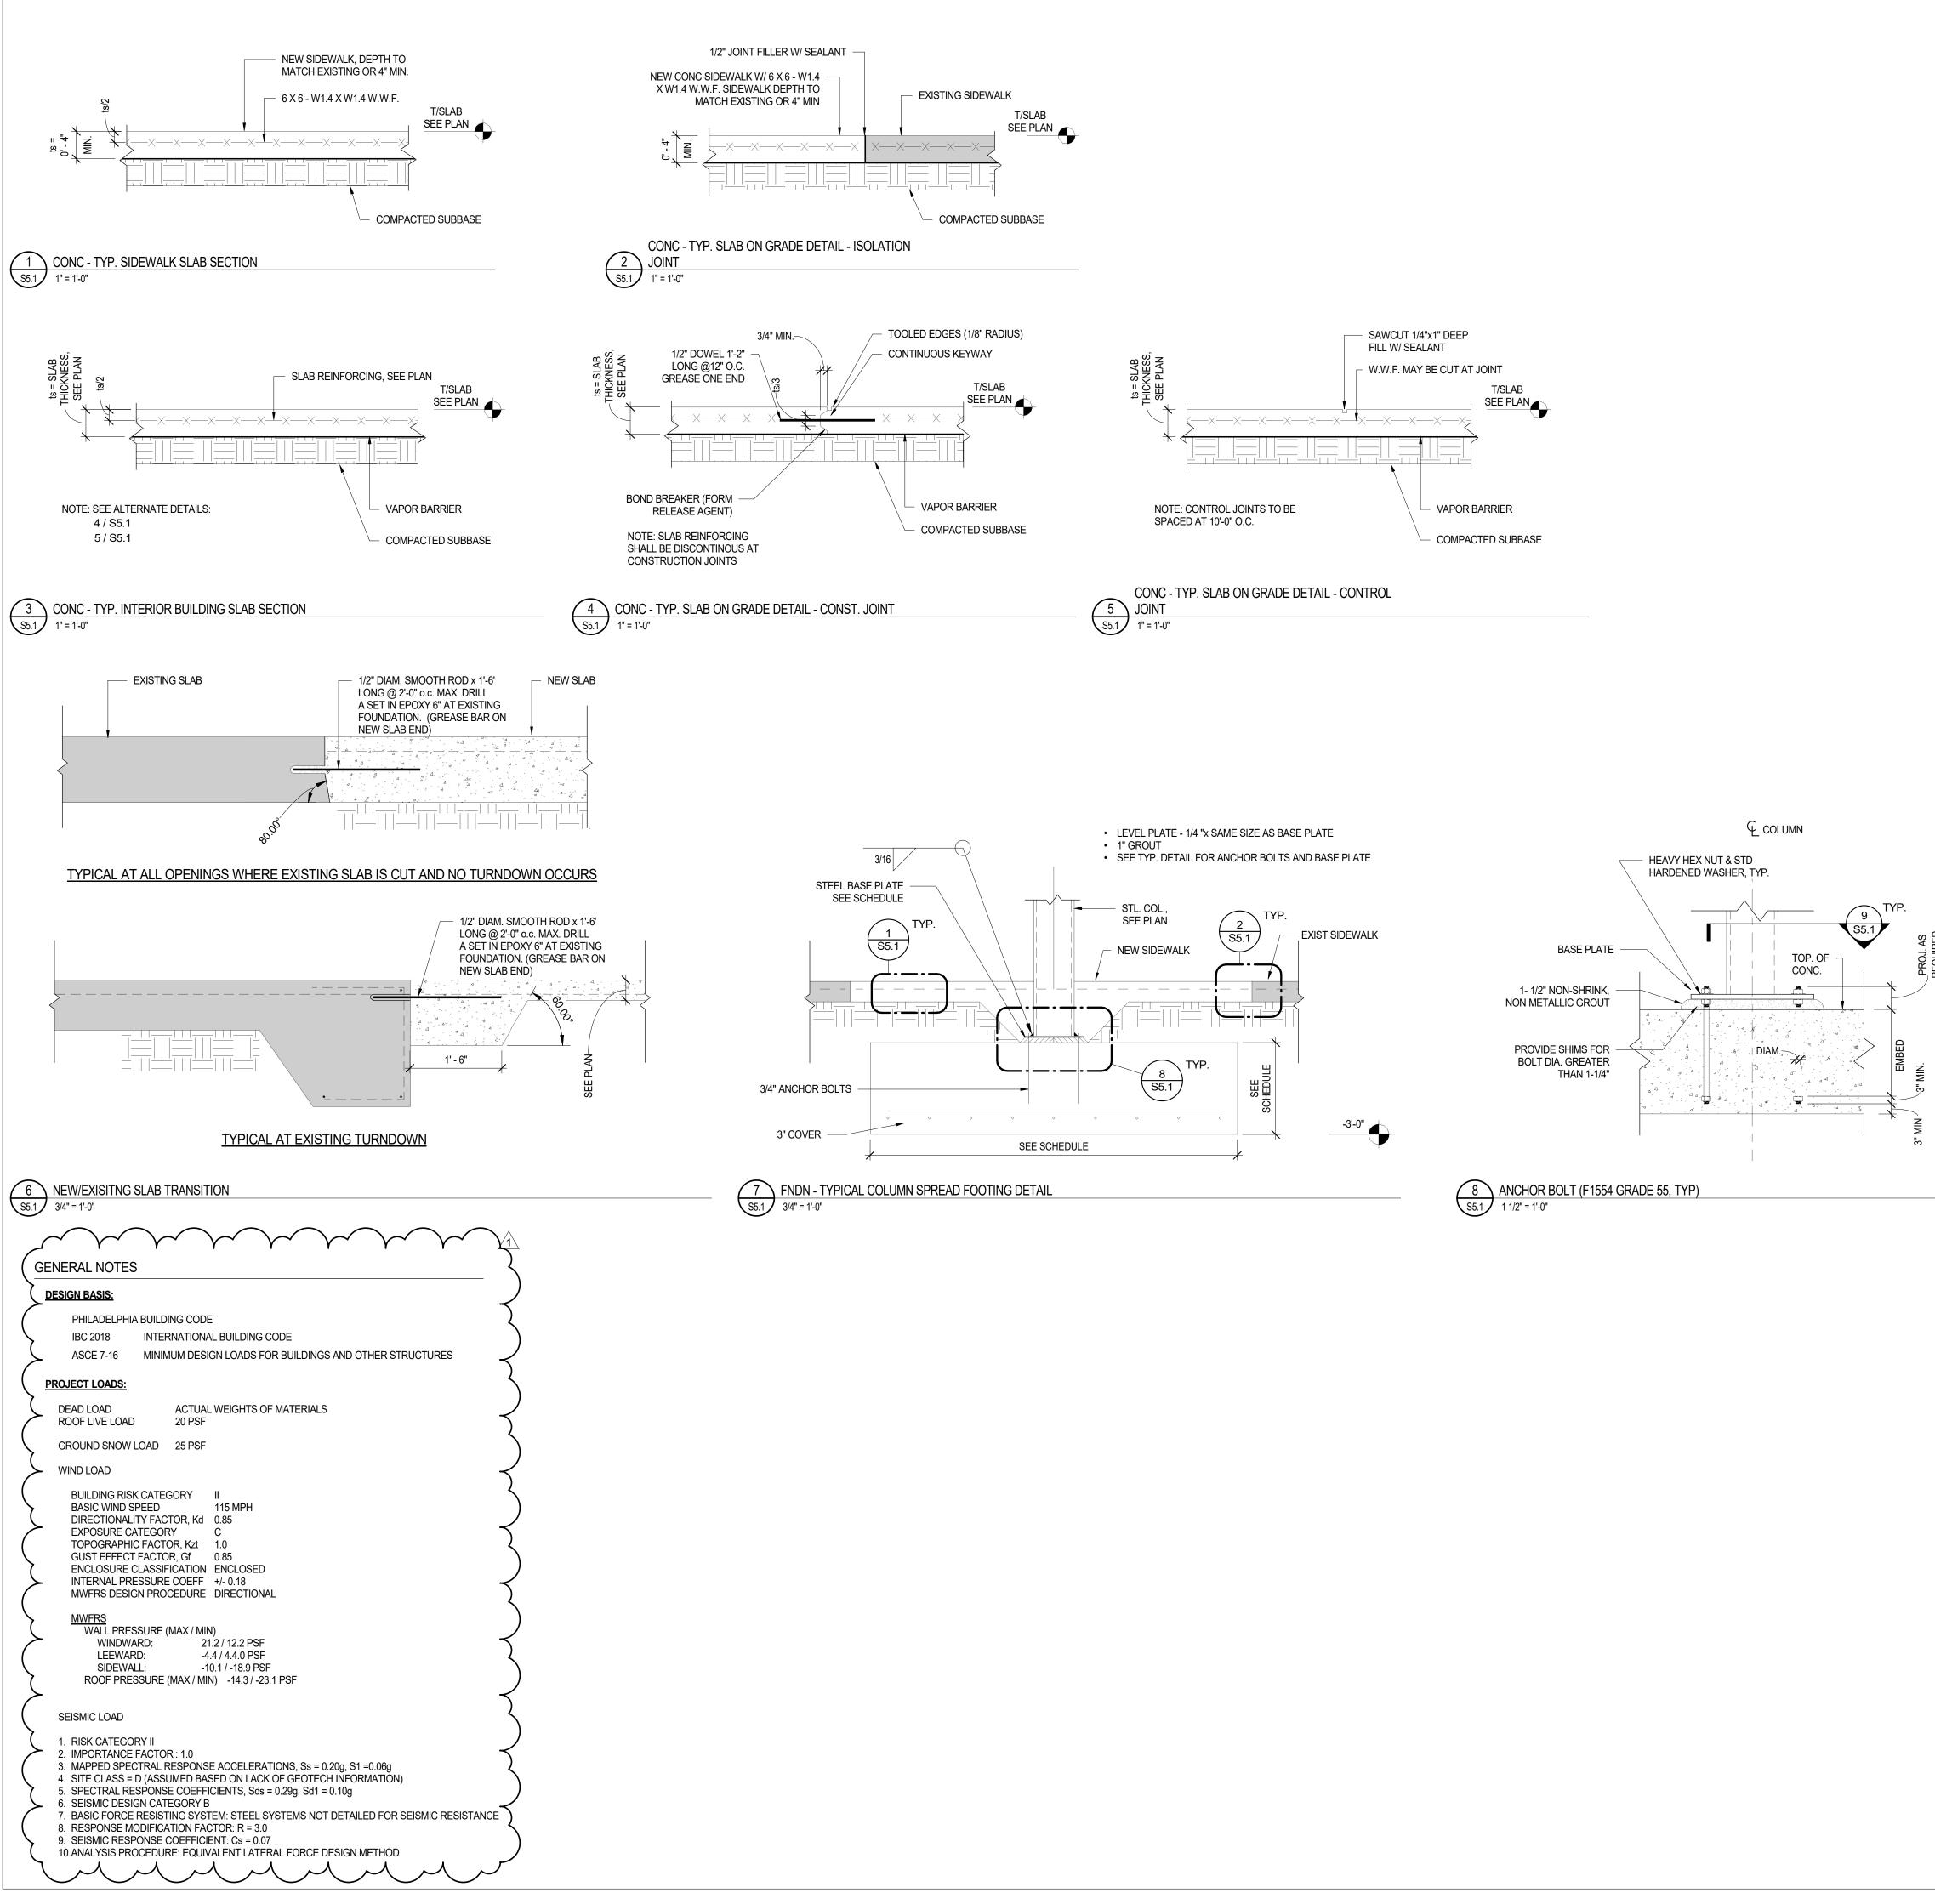
NOTE: ALL DIMENSIONS AND CONDITIONS SHALL BE VERIFIED BY THE CONTRACTOR AT THE SITE BEFORE PROCEEDING WITH THE WORK.




SPREAD FOOTING SCHEDULE					
MARK	LENGTH	WIDTH	THICKNESS	BOTTOM REINFORCEMENT	COUNT
F3.0	3' - 0"	3' - 0"	2' - 0"	3#6 O.C. E.W.	2

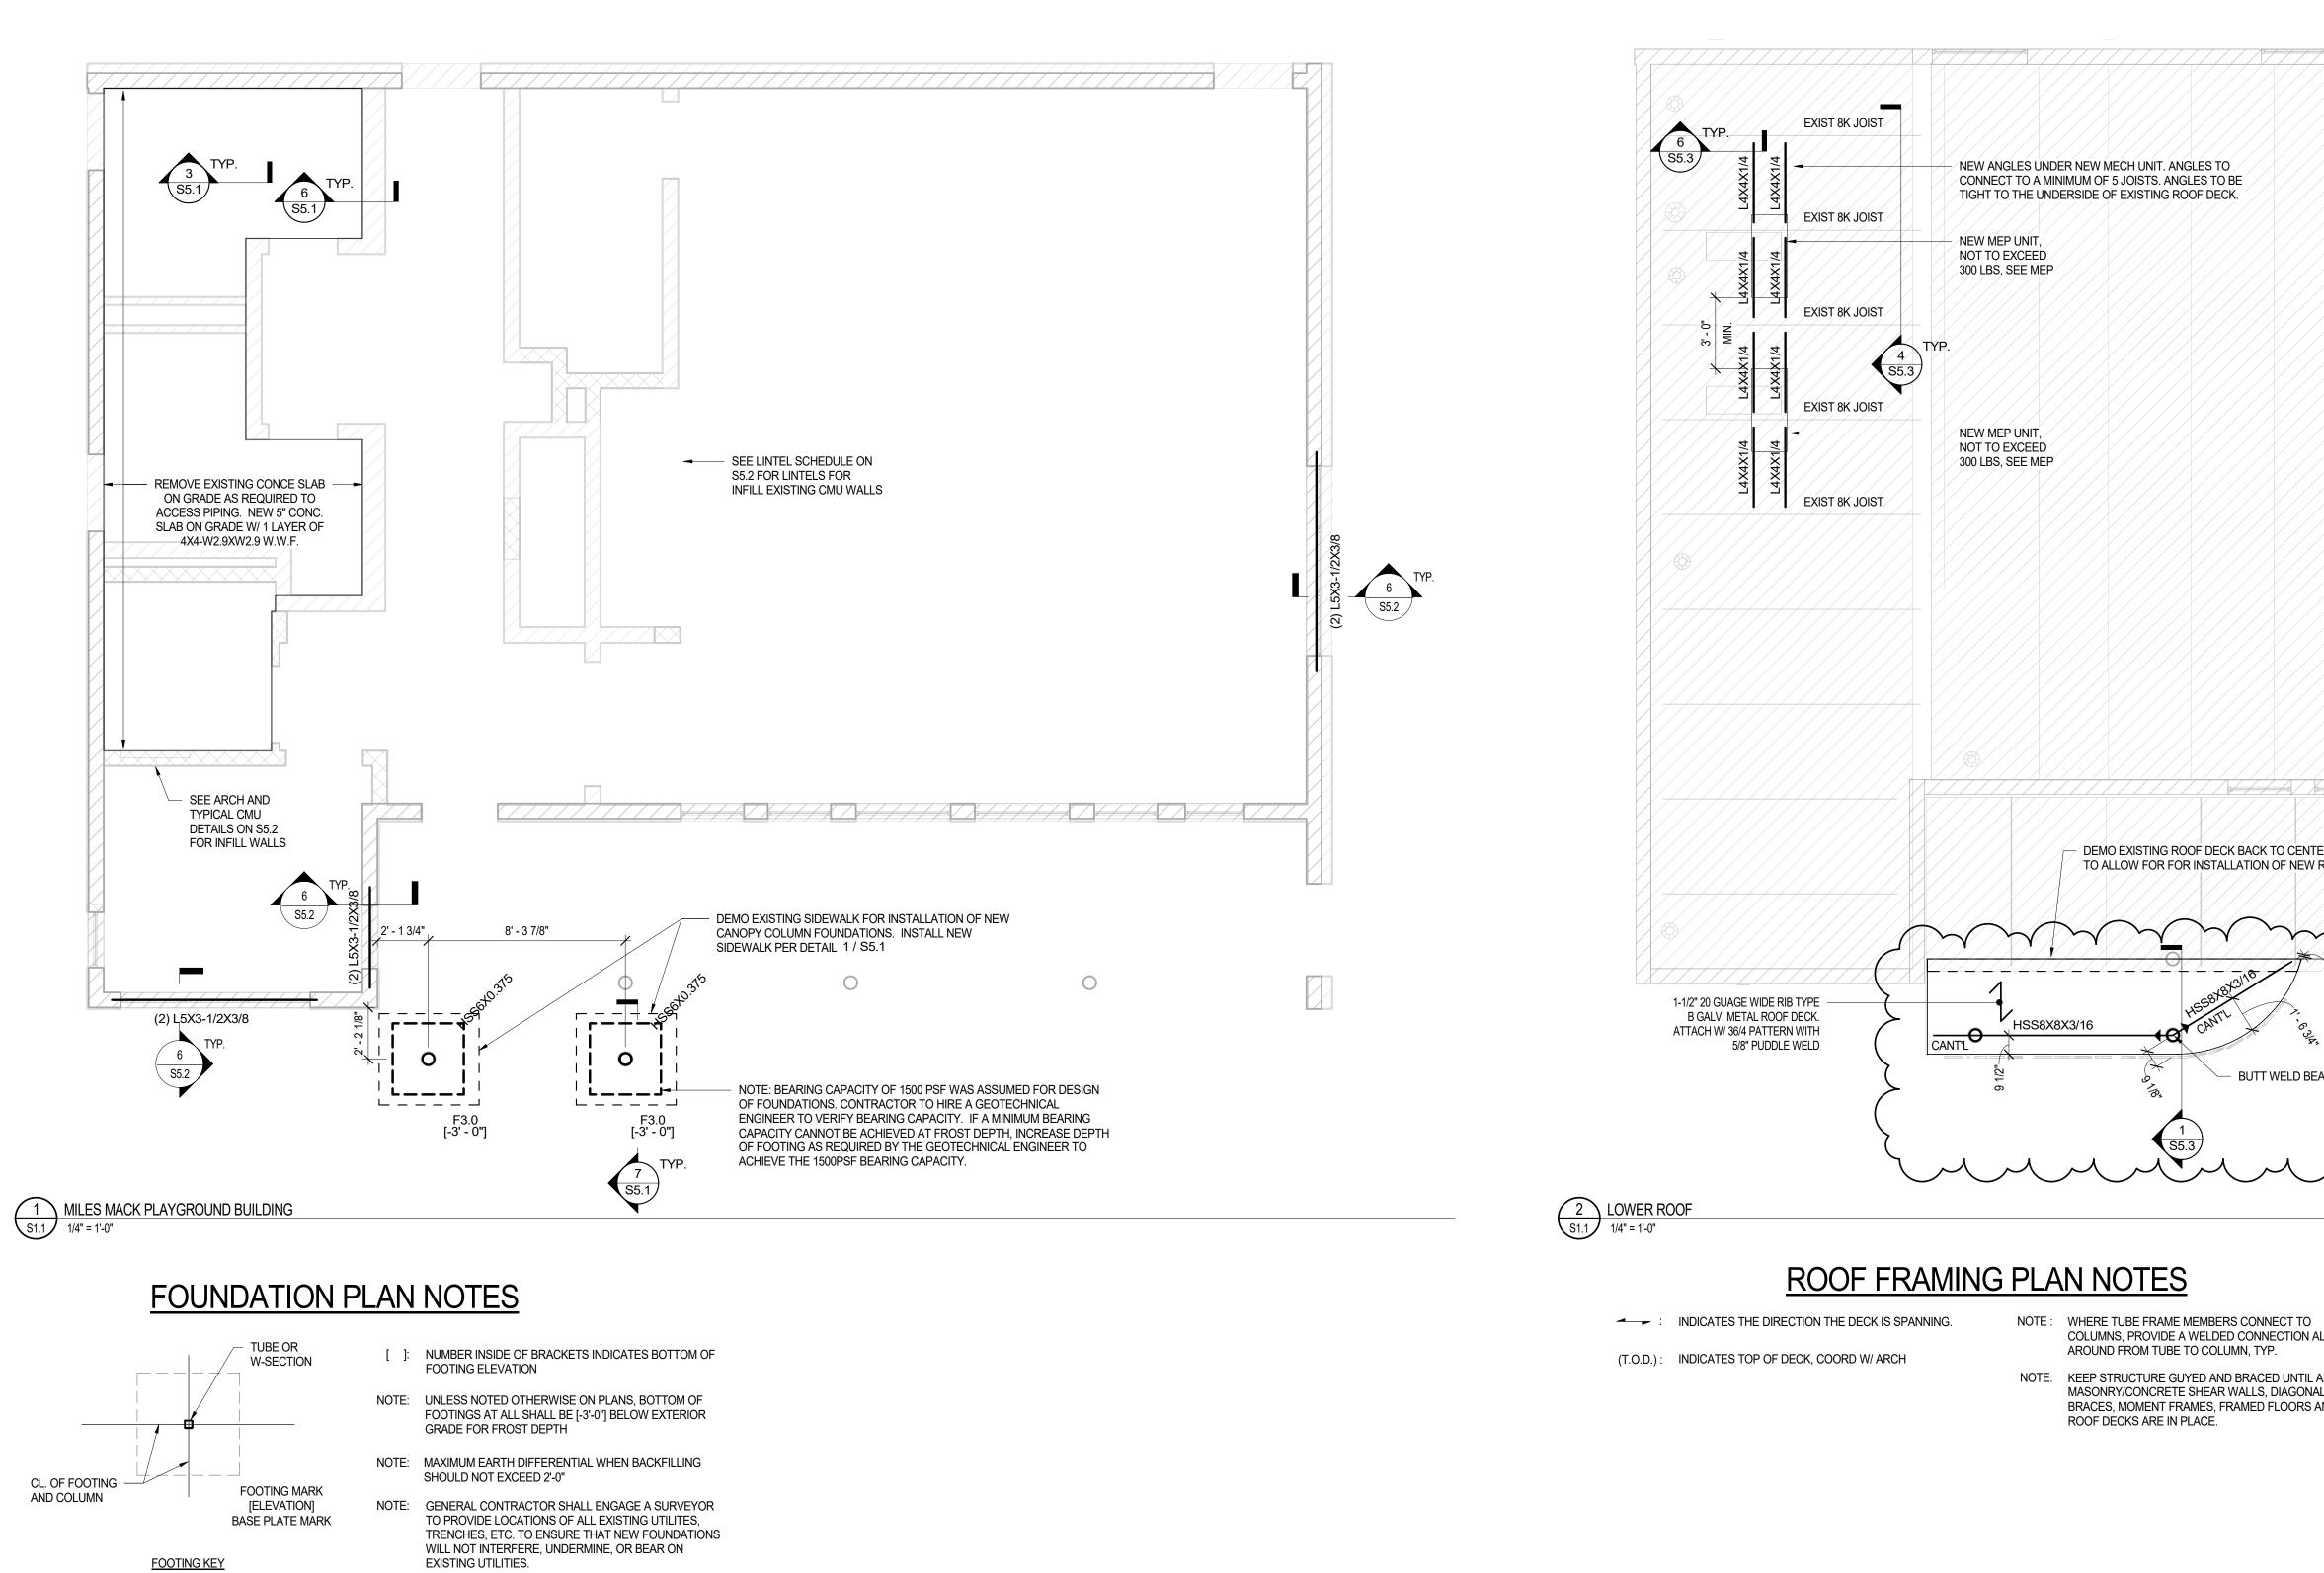
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PROJECT TEAM     P		REVISIONS
		1 3/6/20 Addendum #2
		PHILADELPHIA MANETO
		PROJECT COORDINATOR
		and Department of Public Property 1515 Arch Street, 11th Floor Philadelphia, PA 19102 Contact: Sara Nordstrom, 215-683-0253
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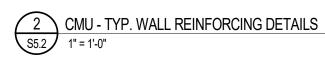


	REVISIONS         ISSUE       DATE       DESCRIPTION         1       3/6/20       Addendum #2
	PROJECT COORDINATOR PROJECT COORDINATOR Philadelphia Parks & Recreation and Department of Public Property 1515 Arch Street, 11th Floor Philadelphia, PA 19102 Contact: Sara Nordstrom, 215-683-0253 SEAL
Image: Provide the provided the provide	PROJECT TEAM   ARCHITECT:   STRUCTURAL ENGINEER:   SYSTEMS ENGINEER:
	CITY OF PHILADELPHIA         REBUILD PHILADELPHIA AND         PHILADELPHIA PARKS & RECREATION         1515 ARCH STREET         11TH FLOOR, ONE PARKWAY BUILDING         PHILADELPHIA, PENNSYLVANIA         PROJECT TITLE         MILES MACK BUILDING RENOVATION         DRAWING TITLE         CONC DETAILS AND NOTES         PROJECT NO.         DATE:       02.07.2020         SCALE: AS NOTED         DRAWIN BY:       SB         CHECKED BY:       CR         FILE:         NOTE:       ALL DIMENSIONS AND CONDITIONS SHALL         BE VERIFIED BY THE CONTRACTOR AT         THE SITE BEFORE PROCEEDING WITH THE         WORK.



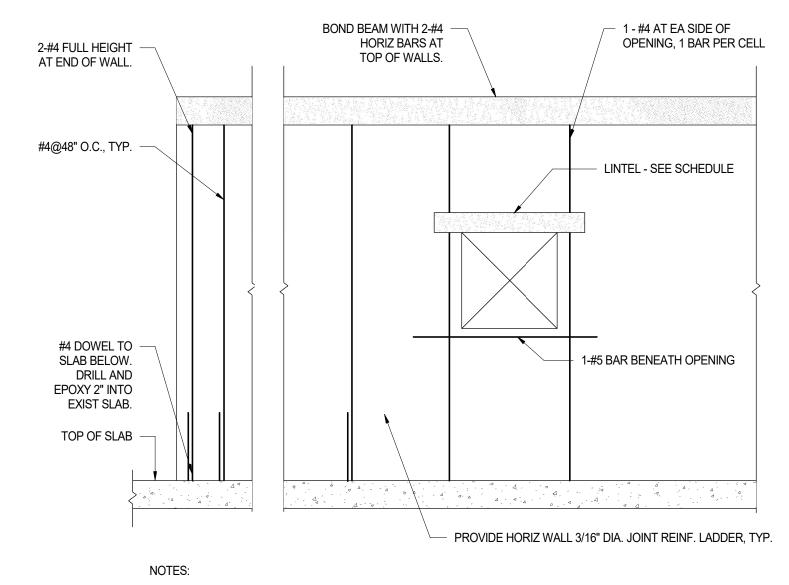

ENDS OF WALLS AT OPENINGS

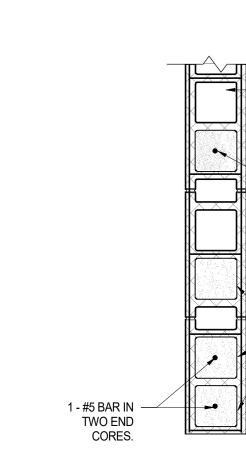

1. INSTALL JOINT REINFORCEMENT IN THE FIRST AND SECOND BED JOINT ABOVE LINTELS AND BELOW SILLS AT OPENINGS.

BEAM

W8X24

W8X31

2. EXTEND REINFORCEMENT IN THE SECOND BED JOINT BELOW OPENING 2'-0" BELOW JAMBS.

3. GROUT CELLS WITH REINFORCING SOLID.

4. SEE ARCHITECTURAL DRAWINGS FOR CONTROL JOINT LOCATIONS.



BL	OCK LINTEL SCHED	STEEL BEA SCHE		
SPAN	8" WYTHE	12" WYTHE	SPAN	BEAN
0' TO 4'	2-#4 (8x8)	2-#4 (12x8)	8' TO 10'	W8X24
4' TO 6'	2-#5 (8x8)	2-#5 (12x8)	10' TO 15'	W8X31
6' TO 8'	1-#4 TOP 2-#5 BOT(8x16)	2-#4 TOP 2-#5 (12x16)		
8' TO 10'	2-#4 TOP 2-#6 BOT (8x16)	2-#4 TOP 2-#7 (12x16)		

## 4 CMU - LINTEL SCHEDULE S5.2 12" = 1'-0"

LINTEL SCHEDULE AT EXISTING INFILL CMU WALLS					
SPAN	4" WYTHE	6" WYTHE	8" WYTHE		
0' TO 4'	L3-1/2x3-1/2x1/4	L5x5x5/16	(2) L3-1/2x3-1/2x1/4		
4' TO 6'	L3-1/2x3-1/2x1/4	L5x5x5/16	(2) L3-1/2x3-1/2x1/4		
6' TO 8'	L4x3-1/2x3/8	L5x5x5/16	(2)L4x3-1/2x3/8		
8' TO 10'-6"	L5x3-1/2x1/2	L5x5x1/2	(2)L5x3-1/2x1/2		

7 CMU - LINTEL AT EXISTING WALL SCHEDULE S5.2 12" = 1'-0"

NOTES:

1. PROVIDE LINTELS, AS LISTED ABOVE, OVER ALL OPENINGS IN MASONRY WALLS, UNLESS OTHERWISE SHOWN ON THE DRAWINGS.

2. MINIMUM 8" END BEARING.

NOTES:

DRAWINGS.

BE GROUTED SOLID.

LATERALLY STABLE) HAS HARDENED.

1. PROVIDE LINTELS, AS LISTED ABOVE, OVER ALL OPENINGS IN MASONRY WALLS, UNLESS OTHERWISE SHOWN ON THE

BEARING FROM 8' TO 15' SPAN. CELLS BEARED ON ARE TO BE REINFORCED WITH SIMILAR VERTICAL WALL REBAR AND TO

3. BEAMS, LINTELS, SHELF ANGLES, ETC. SUPPORTING MASONRY

SHALL BE TEMPORARILY BRACED AND/OR SHORED UNTIL MASONRY FOR ONE STORY (OR MORE, AS REQ'D. TO MAKE IT

4. REINFORCING STEEL TO HAVE 3" MIN. BOTTOM COVER.

5. IF THE DISTANCE BETWEEN TWO ADJACENT OPENINGS IS LESS THAN 2'-0", THE LINTEL IS TO SPAN OVER BOTH

OPENINGS. THE SPAN SHALL BE THE SUM OF WIDTH OF BOTH OPENINGS AND THE DISTANCE BETWEEN THEM.


2. MINIMUM 8" END BEARING TO 8' SPAN. 16" MIN. END


3. WALLS TO BE TEMPORARILY BRACED AND /OR SHORED UNTIL LINTEL IS INSTALLED.


4. IF THE DISTANCE BETWEEN TWO ADJACENT OPENINGS IS LESS THAN 2'-0", THE LINTEL IS TO SPAN OVER BOTH OPENINGS. THE SPAN SHALL BE THE SUM OF WIDTH OF BOTH OPENINGS AND THE DISTANCE BETWEEN THEM.

5. FOR DOUBLE ANGLE LINTELS, SEE DETAIL 6 / S5.2



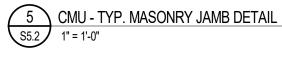


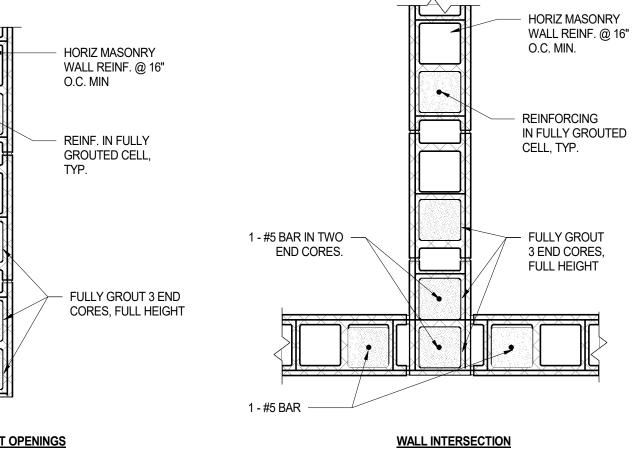

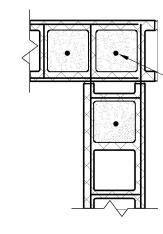

#5 REBAR IN FULLY GROUTED CELL, TYP.


CORNER OF WALL

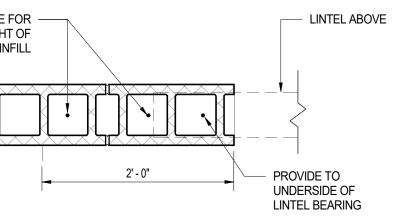


- 3#5 AT CENTER OF WALL

- PROVIDE 3'-0" LAP SPLICE FOR ALL REBAR


- FILL MASONRY SOLID WITH 3000 PSI GROUT

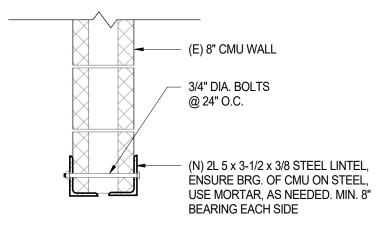



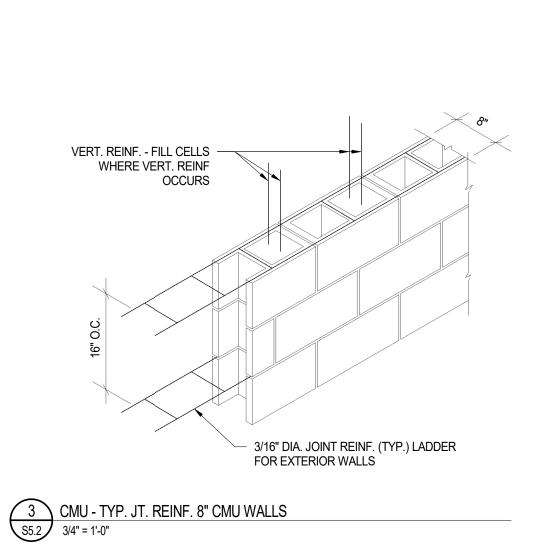

ISSUE DATE DESCRIPTION
PHLADSLPHIA MANETO
PROJECT COORDINATOR Philadelphia Parks & Recreation and Department of Public Property 1515 Arch Street, 11th Floor Philadelphia, PA 19102 Contact: Sara Nordstrom, 215-683-0253
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PROJECT TEAM ARCHITECT:
STRUCTURAL ENGINEER:
SYSTEMS ENGINEER:
CITY OF PHILADELPHIA
CITY OF PHILADELPHIA REBUILD PHILADELPHIA AND PHILADELPHIA PARKS & RECREATION
REBUILD PHILADELPHIA AND PHILADELPHIA PARKS & RECREATION 1515 ARCH STREET 11TH FLOOR, ONE PARKWAY BUILDING
REBUILD PHILADELPHIA AND PHILADELPHIA PARKS & RECREATION 1515 ARCH STREET
REBUILD PHILADELPHIA AND PHILADELPHIA PARKS & RECREATION 1515 ARCH STREET 11TH FLOOR, ONE PARKWAY BUILDING PHILADELPHIA, PENNSYLVANIA
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REBUILD PHILADELPHIA AND PHILADELPHIA PARKS & RECREATION 1515 ARCH STREET 11TH FLOOR, ONE PARKWAY BUILDING PHILADELPHIA, PENNSYLVANIA PROJECT TITLE MILES MACK BUILDING RENOVATION DRAWING TITLE CMU DETAILS PROJECT NO. 10-20-XXXX-01 DATE: 02.07.2020 SCALE: AS NOTED
REBUILD PHILADELPHIA AND PHILADELPHIA PARKS & RECREATION 1515 ARCH STREET 11TH FLOOR, ONE PARKWAY BUILDING PHILADELPHIA, PENNSYLVANIA PROJECT TITLE MILES MACK BUILDING RENOVATION DRAWING TITLE CMU DETAILS PROJECT NO. 10-20-XXXX-01 DATE: 02.07.2020 SCALE: AS NOTED DRAWN BY: SB
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DECKING OPENING FRAMING SCHEDULE		
LENGTH "L" x WIDTH "W"	FRAMING AT SLAB EDGE	
0" < L < 13" 0" < W < 13"	16 GAGE PLATE, MINIMUM OF 6" BEYOND EACH SIDE OF OPENING	
13" < L < 4'-0" 13" < W < 4'-0"	L4x4x1/4"	
4'-0" < L < 6'-6" 4'-0" < W < 9'-0"	L5x3x5/16"	
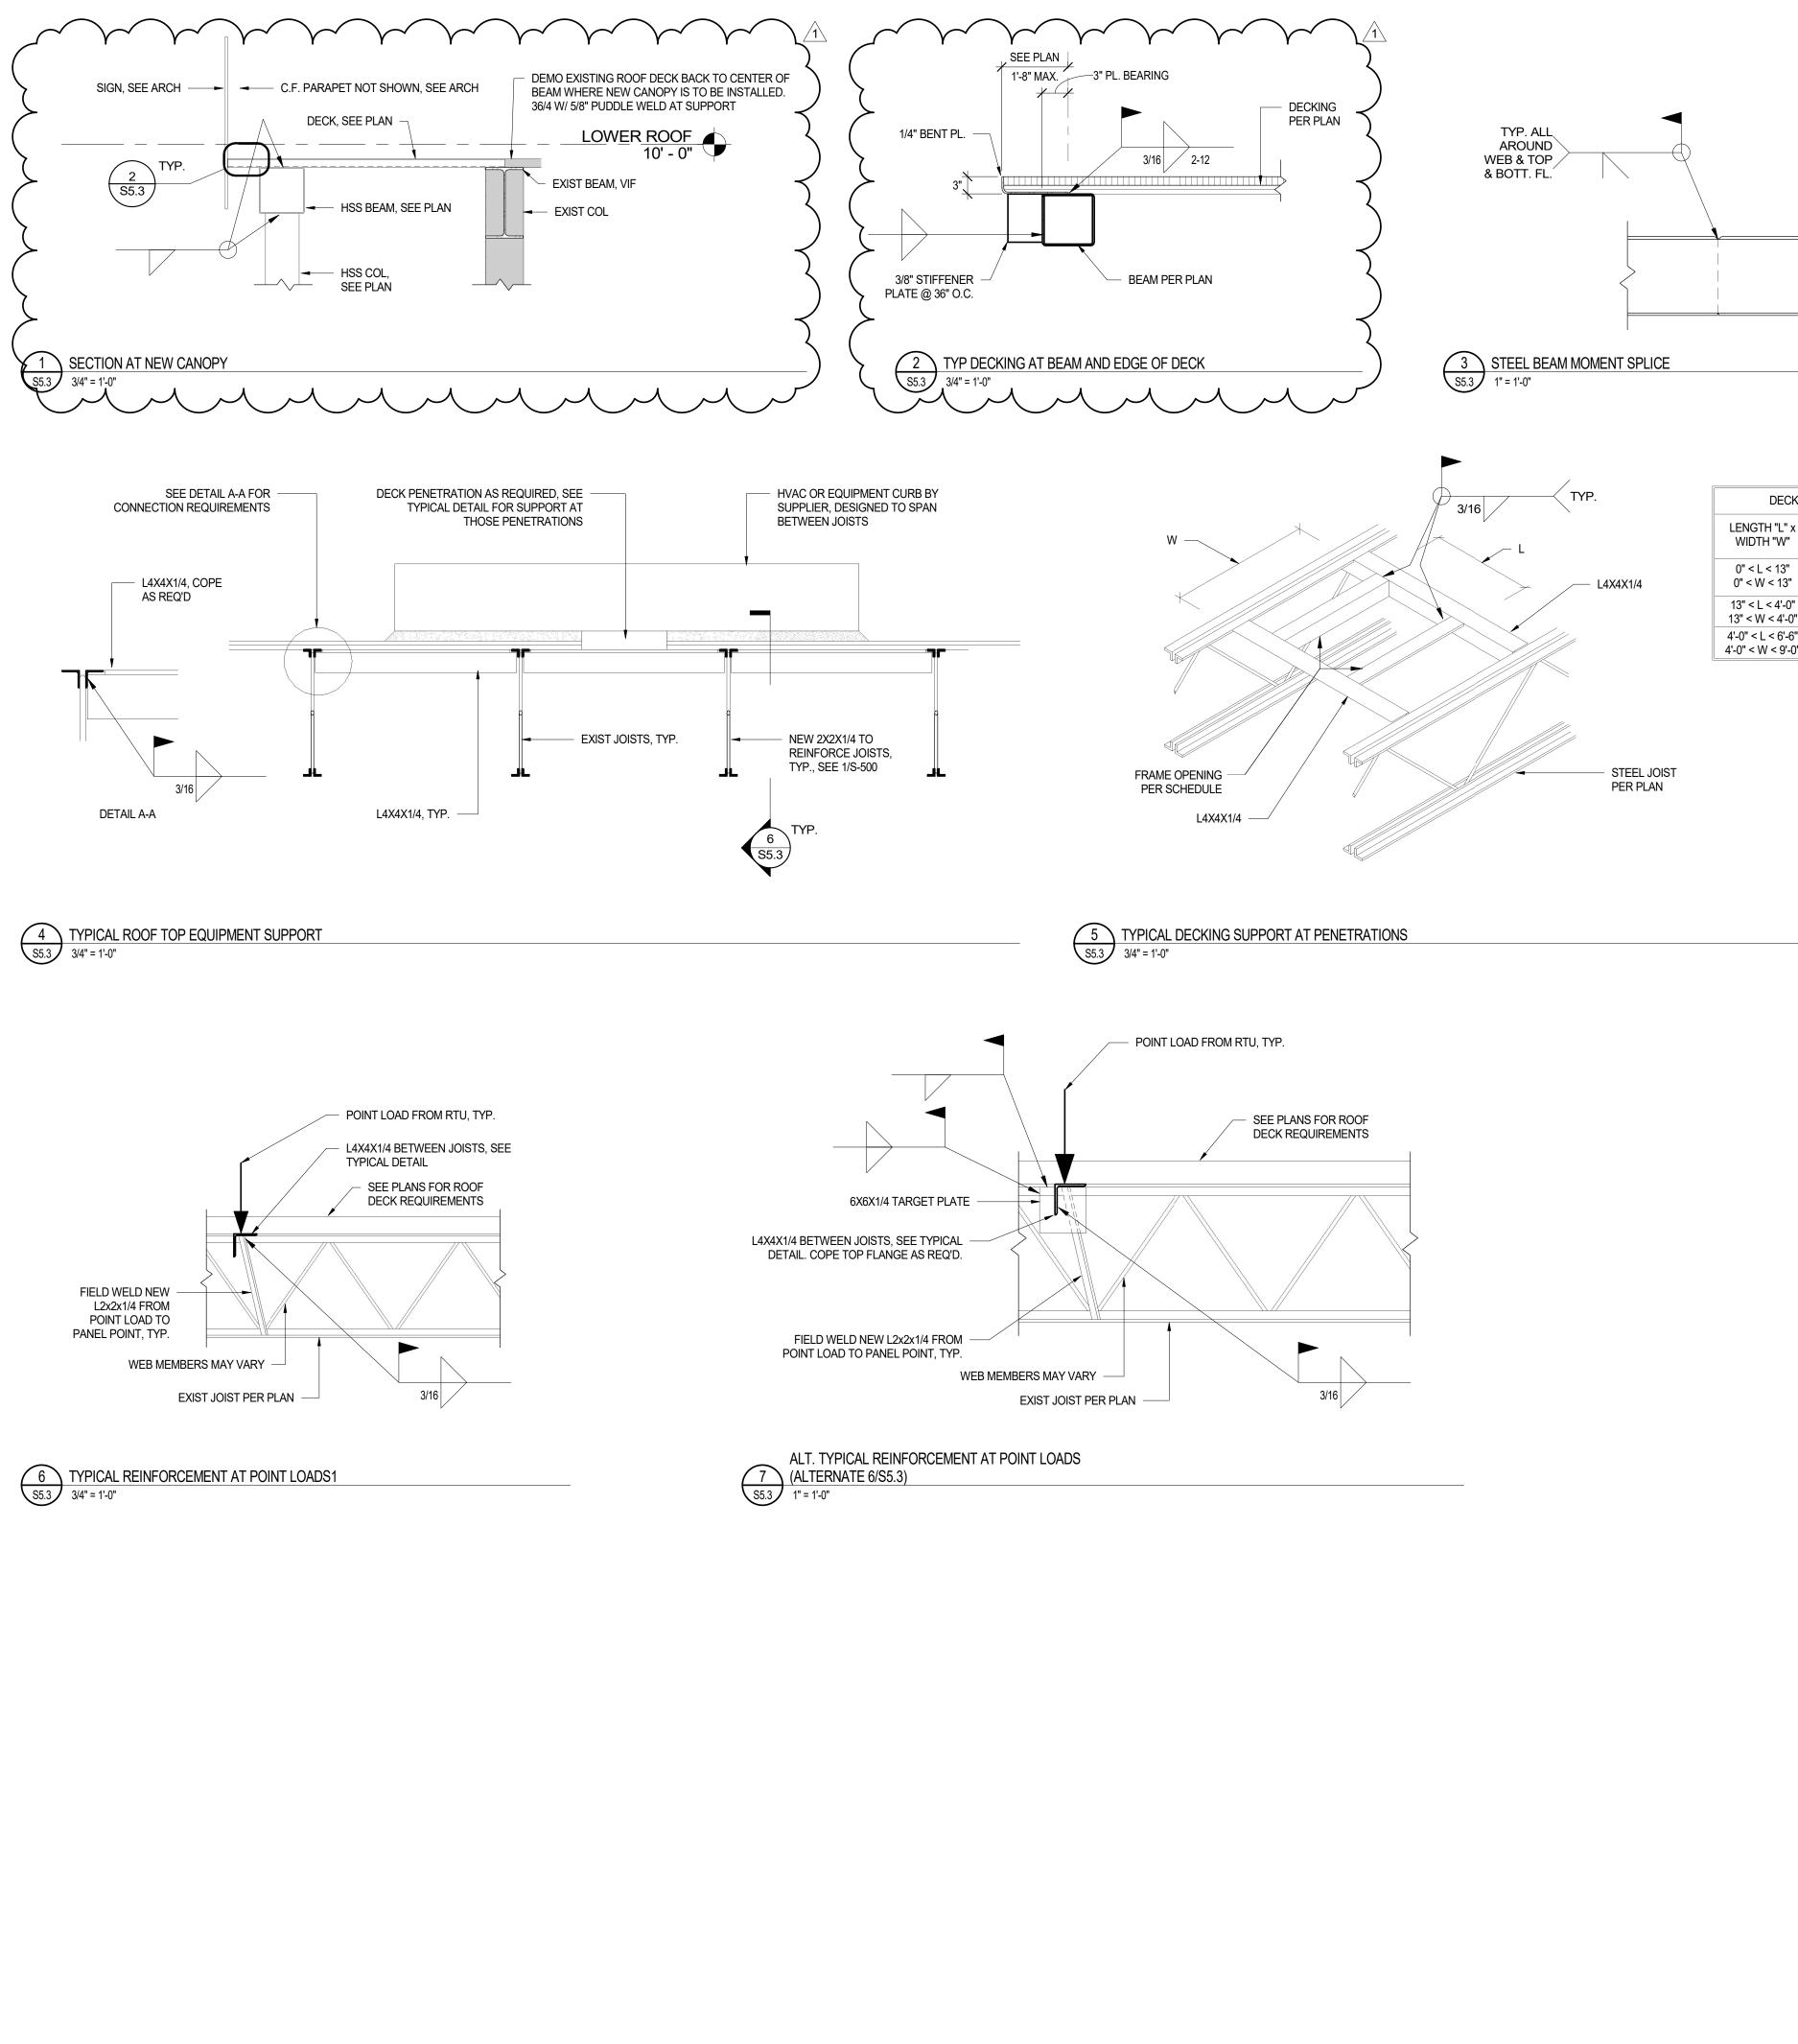
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PROJECT		
		RENOVATION
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PROJECT	NO.	DRAWING NO.
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NOTE: A	LL DIMENSION	NS AND CONDITIONS SHALL
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