
# MILES MACK BUILDING RENOVATION

732 N 36th St #66, Philadelphia, PA 19104

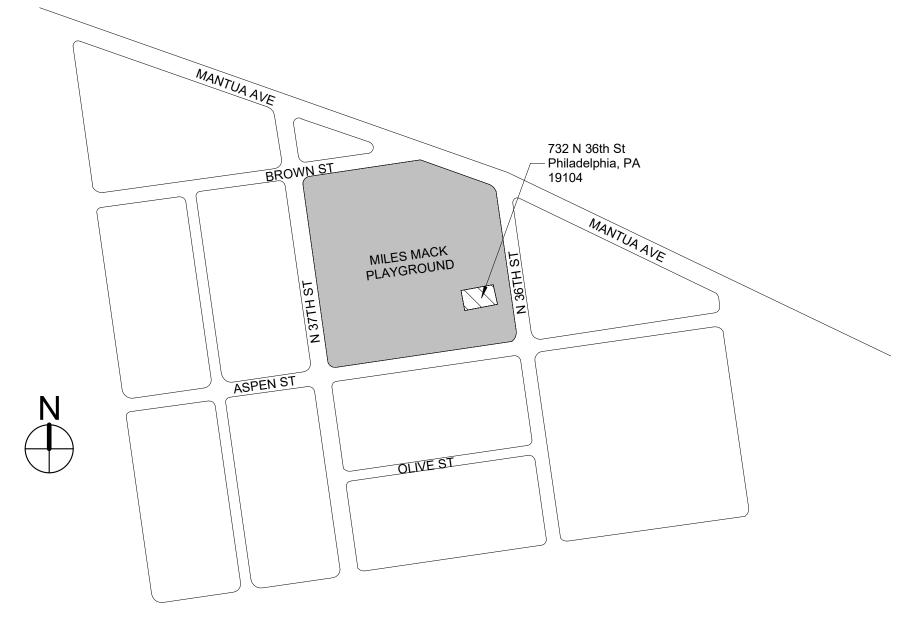



ARCHITECTURAL & SYSTEMS

100% Submission - 2/7/20

SHEET NUMBER	SHEET NAME
G0.0	COVER SHEET
G0.1	REFERENCE PLAN
G0.2	SYMBOLS & ABBREVIATIONS
G0.3	LIFE SAFETY PLAN & CODE ANALYSIS
S1.1	STRUCTURAL PLANS
S5.1	CONCRETE DETAILS & NOTES
S5.2	CMU DETAILS
S5.3	STEEL DETAILS
	DEMOLITION BLANC
A1.0	DEMOLITION PLANS
A1.1	DEMOLITION RCP
A1.2	DEMOLITION ELEVATIONS
A2.0	FLOOR PLAN AND WALL TYPES
A2.1	ROOF PLAN & DETAILS
A3.0	REFLECTED CEILING PLANS
A4.0	EXTERIOR ELEVATIONS
A4.1	ILLUSTRATIVE EXTERIOR ELEVATIONS
A5.0	WALL SECTIONS & DETAILS
A5.1	MISCELANEOUS DETAILS
A6.0	ENLARGED KITCHENETTE PLAN AND DETAILS
A6.1 A7.0	ENLARGED FLOOR PLANS & ELEVATIONS SCHEDULES
A7.0 A8.0	FINISH PLAN
M0.01	SYMBOLS, NOTES, DETAILS & ABBREVIATIONS
MD1.01	FLOOR PLAN - MECHANICAL DEMOLITION
M1.01	FLOOR PLAN - MECHANICAL
M1.02	ROOF PLAN - MECHANICAL
M6.01	SCHEDULES - MECHANICAL
M7.01	CONTROLS - MECHANICAL
P0.01	SYMBOLS NOTES, SCHEDULES, DETAILS, & ABBREVIATIONS
PD1.01	FLOOR PLAN - PLUMBING DEMOLITION
P1.01	FOUNDATION PLAN - PLUMBING
P1.02	FLOOR PLAN - PLUMBING
P1.03	ROOF PLAN - PLUMBING
E0.04	CVMPOLE COLEDINES NOTES AND ADDRESMATIONS
E0.01	SYMBOLS, SCHEDULES, NOTES, AND ABBREVIATIONS
E1.01	FLOOR PLAN ELECTRICAL DEMOLITION
E2.01	FLOOR PLAN - ELECTRICAL
E2.02	FLOOR PLAN - ELECTRICAL
E2.03	FLOOR PLAN - ELECTRICAL
E2.04 E3.01	FLOOR PLAN - ELECTRICAL PANEL SCHEDULES & ONE-LINE DIAGRAMS

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		JOHNSON 1600 MAR PHILADEL	I, MIRMIRAN KET ST, SUI PHIA, PA 19	& THOMPSON, INC TE 520

CITY OF PHILADELPHIA

REBUILD PHILADELPHIA & PHILADELPHIA PARKS &
RECREATION

1515 ARCH STREET 11TH FLOOR, ONE PARKWAY BUILDING PHILADELPHIA, PENNSYLVANIA

PROJECT TITLE
MILES MACK BUILDING RENOVATION

DRAWING TITLE

COVER SHEET

PROJECT NO.

10-20-XXXX-01

DATE: 02.07.2020


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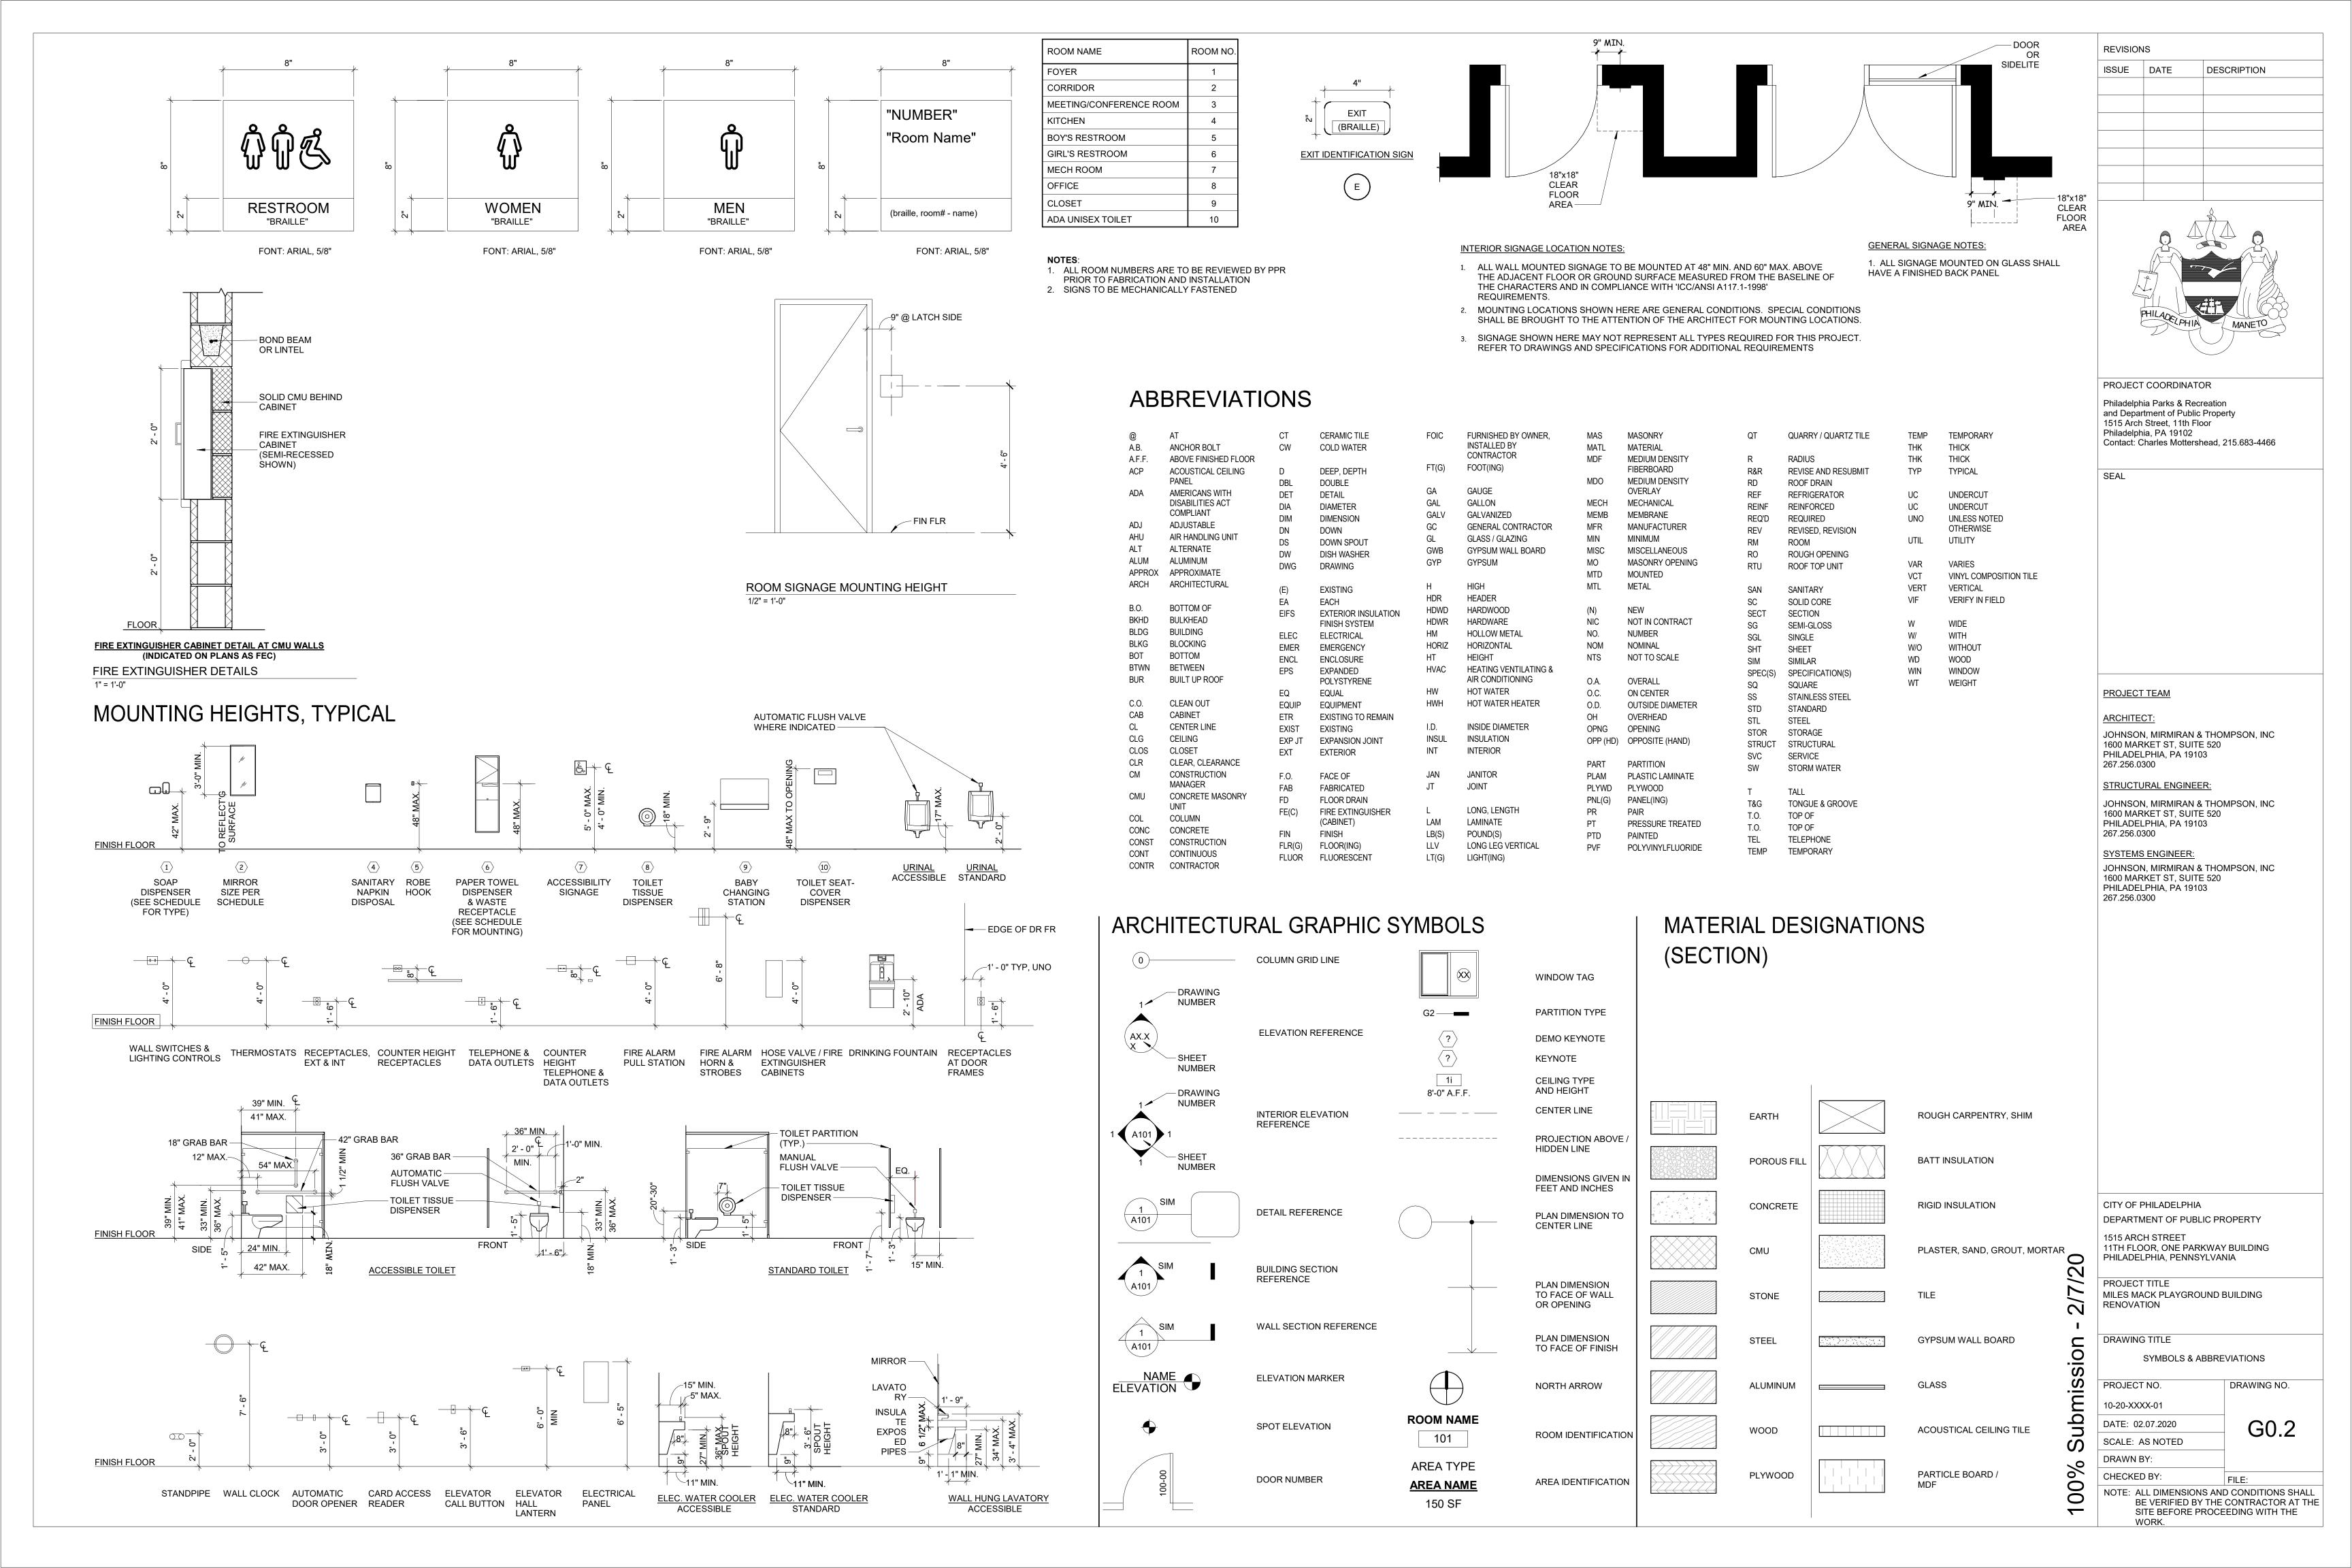
SCALE: AS NOTED DRAWN BY:

CHECKED BY: FILE:

NOTE: ALL DIMENSIONS AND CONDITIONS SHALL BE VERIFIED BY THE CONTRACTOR AT

THE SITE BEFORE PROCEEDING WITH THE



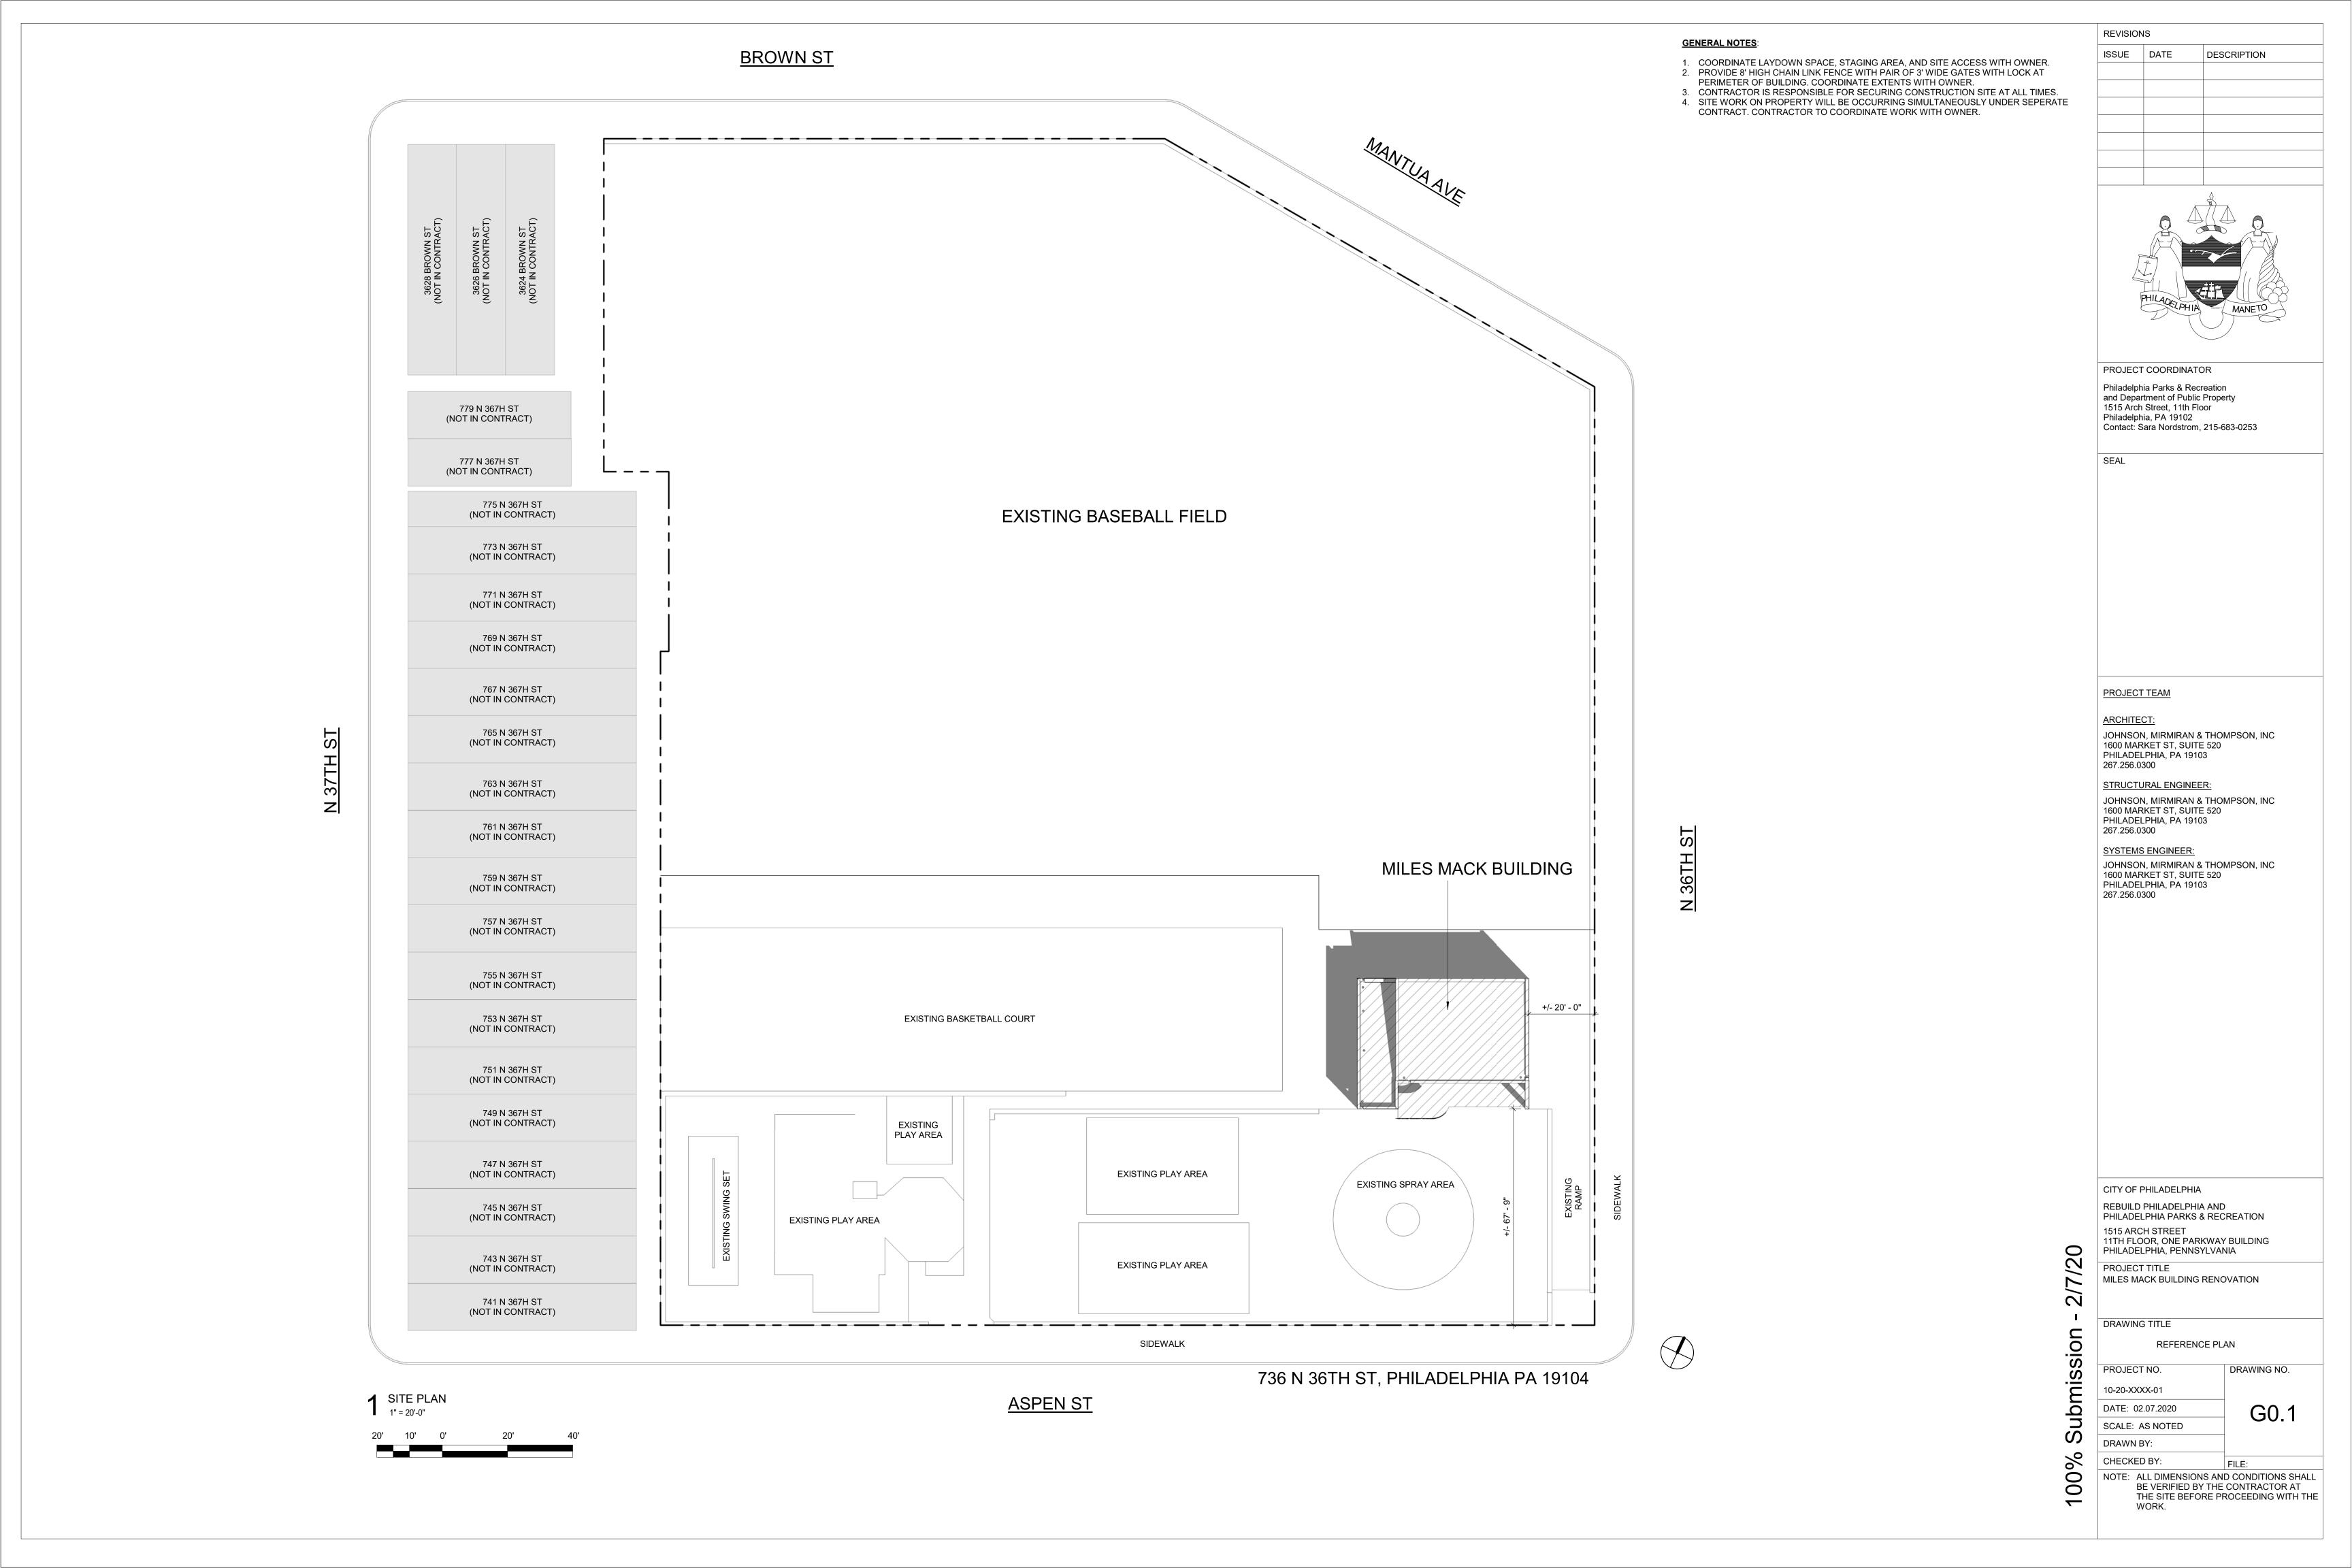

CODE SUMMARY					
BUILDING CODE	IEBC 2018, IBC 2018				
CONSTRUCTION CLASSIFICATION PRIMARY USE GROUP  A-3					

### CODE ANALYSIS

### **JURISDICTION:**

CITY: PHILADELPHIA, PENNSYLVANIA

WWW.PHILA.GOV

ADDRESS: DEPARTMENT OF LICENSES AND INSPECTIONS 1401 JOHN F. KENNEDY BOULEVARD PHILADELPHIA, PA 19102 (215) 686-8686

### **LISTING OF APPLICABLE CODES**

PHILADELPHIA CODE

 THE PHILADELPHIA ADMINISTRATIVE CODE PHILADELPHIA BUILDING CODE PHILADELPHIA MECHANICAL CODE

 PHILADELPHIA ELECTRICAL CODE PHILADELPHIA PERFORMANCE CODE PHILADELPHIA ENERGY CONSERVATION CODE PHILADELPHIA FIRE CODE PHILADELPHIA FUEL GAS CODE

### INTERNATIONAL CODE COUNCIL

 PHILADELPHIA ZONING CODE PHILADELPHIA PLUMBING CODE

 2018 INTERNATIONAL BUILDING CODE (IBC) 2012 INTERNATIONAL BUILDING CODE (CHAPTER 11) 2012 INTERNATIONAL BUILDING CODE (APPENDIX E)

 2018 ICC A117.1 2018 INTERNATIONAL MECHANICAL CODE 2018 INTERNATIONAL ENERGY CONSERVATION CODE (IECC)

 2018 INTERNATIONAL FUEL GAS CODE 2018 ICC PERFORMANCE CODE AMERICANS WITH DISABILITIES ACT ACCESSIBILITY GUIDELINES

 STANDARD FOR THE INSTALLATION OF SPRINKLER SYSTEMS (NFPA-13)

### USE AND OCCUPANCY CLASSIFICATION (IBC CHAPTER 3, SECTION 304.1):

PRIMARY USE: A-3 (IBC SECTION 303.4)

### <u>IEBC 2018</u>

### SECTION 603, ALTERATION—LEVEL 2

**603.1 SCOPE.** INCLUDE THE RECONFIGURATION OF SPACE, THE ADDITION OR ELIMINATION OF ANY DOOR OR WINDOW. THE RECONFIGURATION OR EXTENSION OF ANY SYSTEM, OR THE INSTALLATION OF ANY ADDITIONAL EQUIPMENT.

### **GENERAL BUILDING HEIGHTS AND AREAS (IBC CHAPTER 5):**

ALLOWABLE BUILDING HEIGHT AND AREAS:

- TYPE VB (IBC SECTION 503) - HEIGHT: 40 FEET; AREA: 6,000 SF

### EXISTING BUILDING HEIGHT AND AREAS:

- NO. OF EXISTING STORIES = 1 STORY - MAXIMUM BUILDING HEIGHT = 15'-0" - BUILDING SQUARE FOOTAGE = 1.781 SF

### **TYPES OF CONSTRUCTION (IBC CHAPTER 6):**

### - CONSTRUCTION TYPE 5B (IBC SECTION 602.2)

- 602.5 TYPE 5B IS ANY TYPE OF CONSTRUCTION IN WHICH THE STRUCTURAL ELEMENTS, EXTERIOR WALLS AND INTERIOR WALLS ARE OF ANY MATERIALS PERMITTED BY THIS CODE.

- FIRE-RESISTANCE RATING REQUIREMENTS FOR BUILDING ELEMENTS (HOURS) (TABLE 601) =

PRIMARY STRUCTURAL FRAME: 0 HOURS **EXTERIOR BEARING WALLS:** 0 HOURS INTERIOR BEARING WALLS: 0 HOURS **EXTERIOR NONBEARING WALLS AND PARTITIONS:** 0 HOURS INTERIOR NONBEARING WALLS AND PARTITIONS: 0 HOURS FLOOR CONSTRUCTION AND SECONDARY MEMBERS: 0 HOURS ROOF CONSTRUCTION AND SECONDARY MEMBERS: 0 HOURS

### FIRE RESISTANCE RATING OF EXTERIOR WALLS BASED ON FIRE SEPARATION DISTANCE (TABLE 602)=

-EXTERIOR WALLS < 5 = 1 HOUR -EXTERIOR WALLS 5 ≤ X < 10 = 1 HOUR -EXTERIOR WALLS 10 ≤ X < 30 = 0 HOUR -EXTERIOR WALLS X ≥ 30 = 0 HOUR

### THIS IS A FREE STANDING BUILDING WITH NO OTHER BUILDINGS CLOSER THAN 10'

### MEANS OF EGRESS (IBC CHAPTER 10): 1

**CEILING HEIGHT:** 

- THE MEANS OF EGRESS SHALL HAVE A CEILING HEIGHT OF NOT LESS THAN 7 FEET 6 INCHES (SECTION 1003.2). **BUILDING IS IN COMPLIANCE** 

### HEADROOM:

- PROTRUDING OBJECTS ARE PERMITTED TO EXTEND BELOW THE MINIMUM CEILING HEIGHT REQUIRED BY SECTION 1003.2 PROVIDED A MINIMUM HEADROOM OF 80 INCHES SHALL BE PROVIDED FOR ANY WALKING SURFACE, INCLUDING WALKS. CORRIDORS, AISLES AND PASSAGEWAYS. NOT MORE THAN 50 PERCENT OF THE CEILING AREA OF A MEANS OF EGRESS SHALL BE REDUCED IN HEIGHT BY PROTRUDING OBJECTS (SECTION 1003.3.1). **BUILDING IS IN COMPLIANCE** 

HORIZONTAL PROJECTIONS:

- STRUCTURAL ELEMENTS, FIXTURES OR FURNISHINGS SHALL NOT PROJECT HORIZONTALLY FROM EITHER SIDE MORE THAN 4 INCHES OVER ANY WALKING SURFACE BETWEEN THE HEIGHTS OF 27 INCHES AND 80 INCHES ABOVE THE WALKING SURFACE (SECTION 1003.3.3).

### **BUILDING IS IN COMPLIANCE**


### CLEAR WIDTH:


- PROTRUDING OBJECTS SHALL NOT REDUCE THE MINIMUM CLEAR WITH OF ACCESSIBLE ROUTES (SECTION 1003.3.4). BUILDING IS IN COMPLIANCE

### OCCUPANT LOAD (IBC SECTION 1004, IBC TABLE 1004.5):

- ACCESSORY STORAGE AREAS , MECHANICAL EQUIPMENT ROOM: 300 GROSS / OCCUPANT = 2 OCCUPANTS 150 GROSS / OCCUPANT = 1 OCCUPANTS - BUSINESS AREAS: 5 NET / OCCUPANT - ASSEMBLY AREAS: = 167 OCCUPANTS - TOTAL OCCUPANTS: = 170 OCCUPANTS

### LIFE SAFETY LEGEND

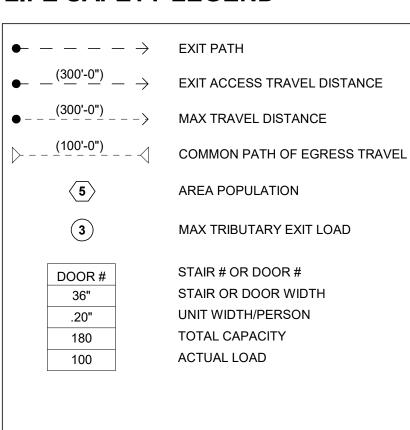

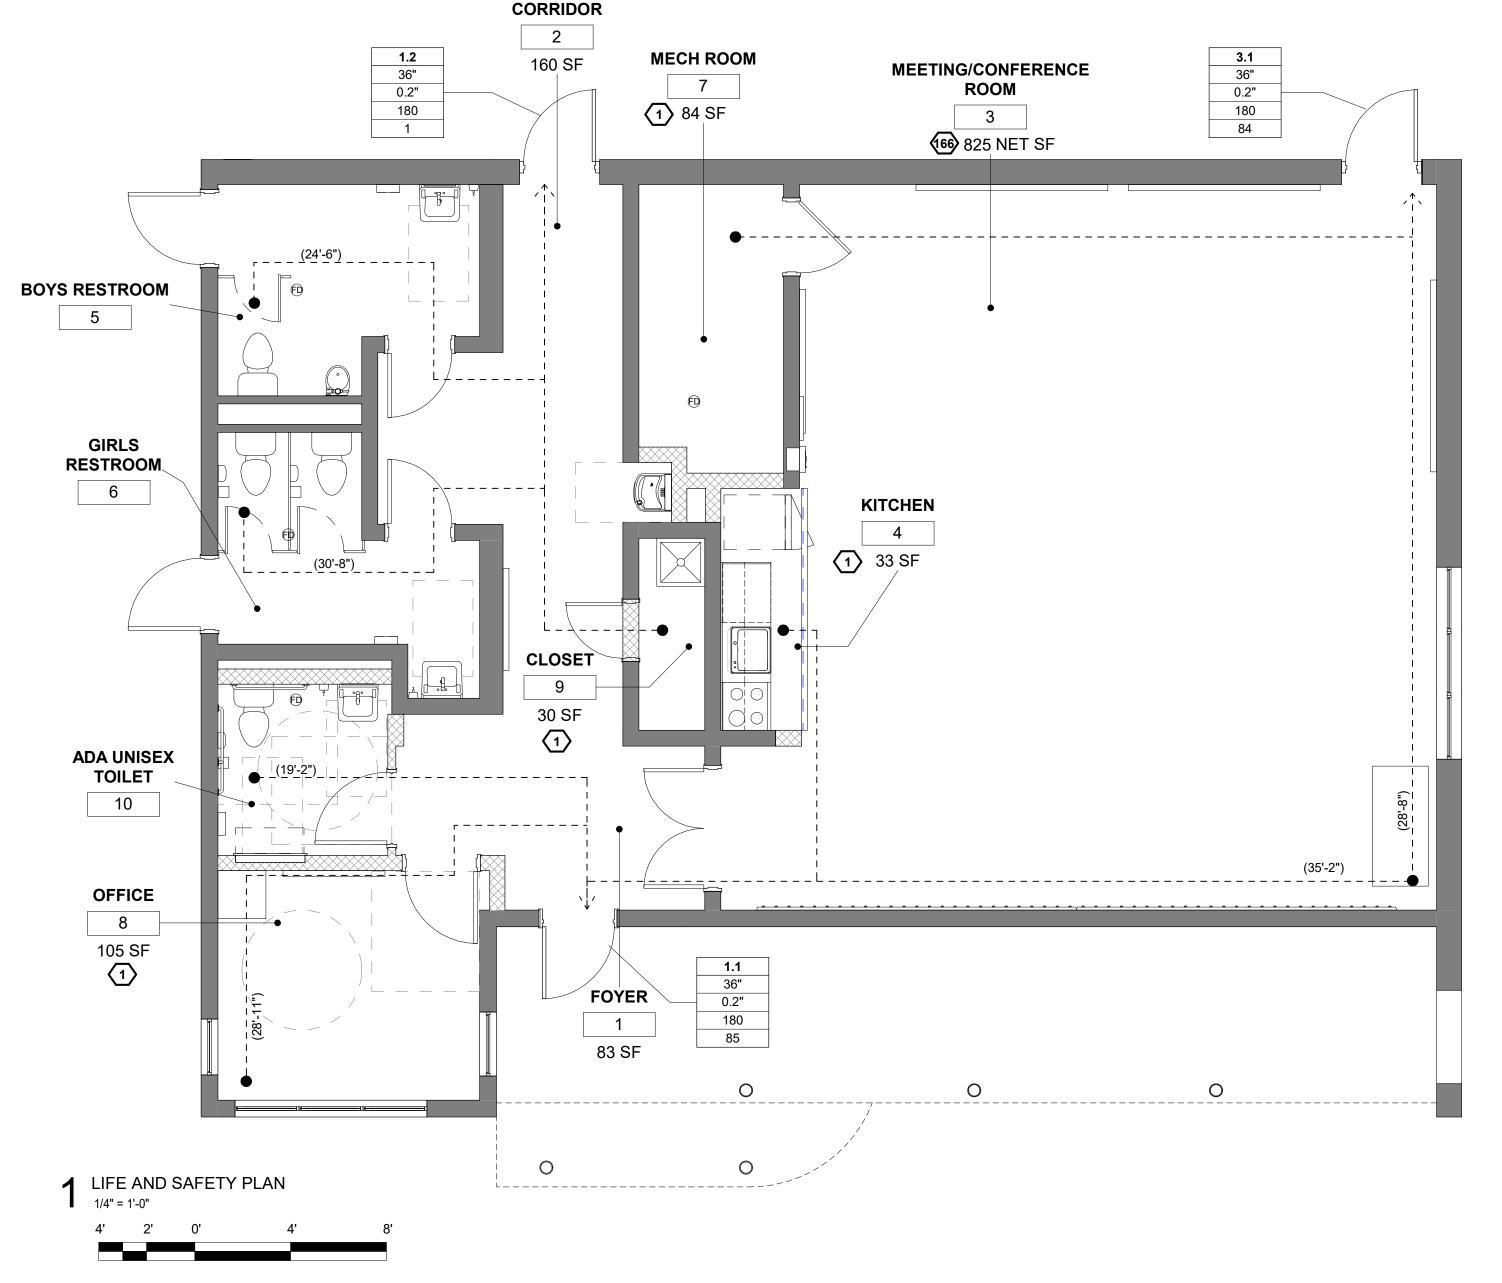

### EGRESS WIDTH (IBC SECTION 1005.3.1-1005.3.2):

- 0.3 INCHES PER OCCUPANT FOR STAIRWAYS - 0.2 INCHES PER OCCUPANT FOR OTHER EGRESS COMPONENTS

### **DOOR ENCROACHMENT (IBC SECTION 1005.7):**

- DOORS , WHEN FULLY OPENED, AND HANDRAILS SHALL NOT REDUCE THE REQUIRED MEANS OF EGRESS WIDTH BY MORE THAN 7 INCHES. DOORS IN ANY POSITION SHALL NOT REDUCE THE REQUIRED WIDTH BY MORE THAN ONE-HALF. OTHER NONSTRUCTURAL PROJECTIONS SUCH AS TRIM AND SIMILAR DECORATIVE FEATURES SHALL BE PERMITTED TO PROJECT INTO THE REQUIRED WIDTH A MAXIMUM OF 1 1/2 INCHES ON EACH SIDE.

### NUMBER OF EXITS AND CONTINUITY (IBC SECTION 1006.3.2):

- THE MINIMUM NUMBER OF EXITS FOR OCCUPANT LOAD = 2 EXITS (OCCUPANT LOAD 1 -500) (TABLE 1021.1)

### SIZE OF DOORS (IBC SECTION 1008.1.1):

- THE MINIMUM WIDTH OF EACH DOOR OPENING SHALL BE SUFFICIENT FOR THE OCCUPANT LOAD THEREOF AND SHALL PROVIDE A CLEAR WIDTH OF 32 INCHES. THE MAXIMUM WIDTH OF A SWINGING DOOR LEAF SHALL BE 48 INCHES NOMINAL. THE HEIGHT OF DOOR OPENINGS SHALL NOT BE LESS THAN 80 INCHES.

- EGRESS THROUGH INTERVENING SPACES SHALL COMPLY WITH THIS SECTION (1014.2):

1. EGRESS FROM A ROOM OR SPACE SHALL NOT PASS THROUGH ADJOINING OR INTERVENING ROOMS OR AREAS, EXCEPT WHERE SUCH ADJOINING ROOMS OR AREAS AND THE AREA SERVED ARE ACCESSORY TO ONE OR THE OTHER, ARE NOT A GROUP H OCCUPANCY AND PROVIDE A DISCERNIBLE PATH OF EGRESS TRAVEL TO AN EXIT.

2. AN EXIT ACCESS SHALL NOT PASS THROUGH A ROOM THAT CAN BE LOCKED TO PREVENT EGRESS.

3. EGRESS SHALL NOT PASS THROUGH KITCHENS, STORAGE ROOMS, CLOSETS OR SPACES USED FOR SIMILAR PURPOSES.

- COMMON PATH OF EGRESS TRAVEL SHALL NOT EXCEED 100 FEET IN B OCCUPANCY WITH SPRINKLER SYSTEM IN ACCORDANCE WITH SECTION 903.3.1.1 (TABLE 1014.3)

### EXIT ACCESS TRAVEL DISTANCE (IBC SECTION 1017):

- EXIT ACCESS TRAVEL DISTANCE SHALL NOT EXCEED 200 FEET IN A OCCUPANCY WITHOUT A SPRINKLER SYSTEM IN ACCORDANCE WITH SECTION 903.3.1.1 (TABLE 1017.2)

### CORRIDORS (IBC SECTION 1020) - TABLE 1020.1:

- THE MINIMUM CORRIDOR WIDTH SHALL BE 44".

-1 HR FIRE RESISTANCE RATING IN CORRIDORS, FOR OCCUPANT LOAD GREATER THAN 30. (TABLE 1020.1)

- WHERE MORE THAN ONE EXIT OR EXIT ACCESS DOORWAY IS REQUIRED, THE EXIT ACCESS SHALL BE ARRANGED SUCH THAT THERE ARE NO DEAD ENDS IN CORRIDORS MORE THAN 20 FEET IN LENGTH (SECTION 1018.4).

# REBUILD PHILADELPHIA AND PHILADELPHIA PARKS & RECREATION

11TH FLOOR, ONE PARKWAY BUILDING PHILADELPHIA, PENNSYLVANIA PROJECT TITLE MILES MACK BUILDING RENOVATION 0

N

DRAWING TITLE LIFE SAFETY PLAN & CODE ANALYSIS DATE: 02.07.2020

REVISIONS

PROJECT COORDINATOR

1515 Arch Street, 11th Floor

Philadelphia, PA 19102

PROJECT TEAM

JOHNSON, MIRMIRAN & THOMPSON, INC

JOHNSON, MIRMIRAN & THOMPSON, INC

JOHNSON, MIRMIRAN & THOMPSON, INC

1600 MARKET ST, SUITE 520

PHILADELPHIA, PA 19103

STRUCTURAL ENGINEER:

SYSTEMS ENGINEER:

1600 MARKET ST, SUITE 520 PHILADELPHIA, PA 19103

1600 MARKET ST. SUITE 520 PHILADELPHIA, PA 19103

**ARCHITECT:** 

267.256.0300

267.256.0300

267.256.0300

Philadelphia Parks & Recreation

and Department of Public Property

Contact: Sara Nordstrom, 215-683-0253

DESCRIPTION

PROJECT NO. DRAWING NO. 10-20-XXXX-01


SCALE: AS NOTED DRAWN BY:

CITY OF PHILADELPHIA


1515 ARCH STREET

CHECKED BY: NOTE: ALL DIMENSIONS AND CONDITIONS SHALL BE VERIFIED BY THE CONTRACTOR AT THE SITE BEFORE PROCEEDING WITH THE WORK.


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# FOUNDATION PLAN NOTES

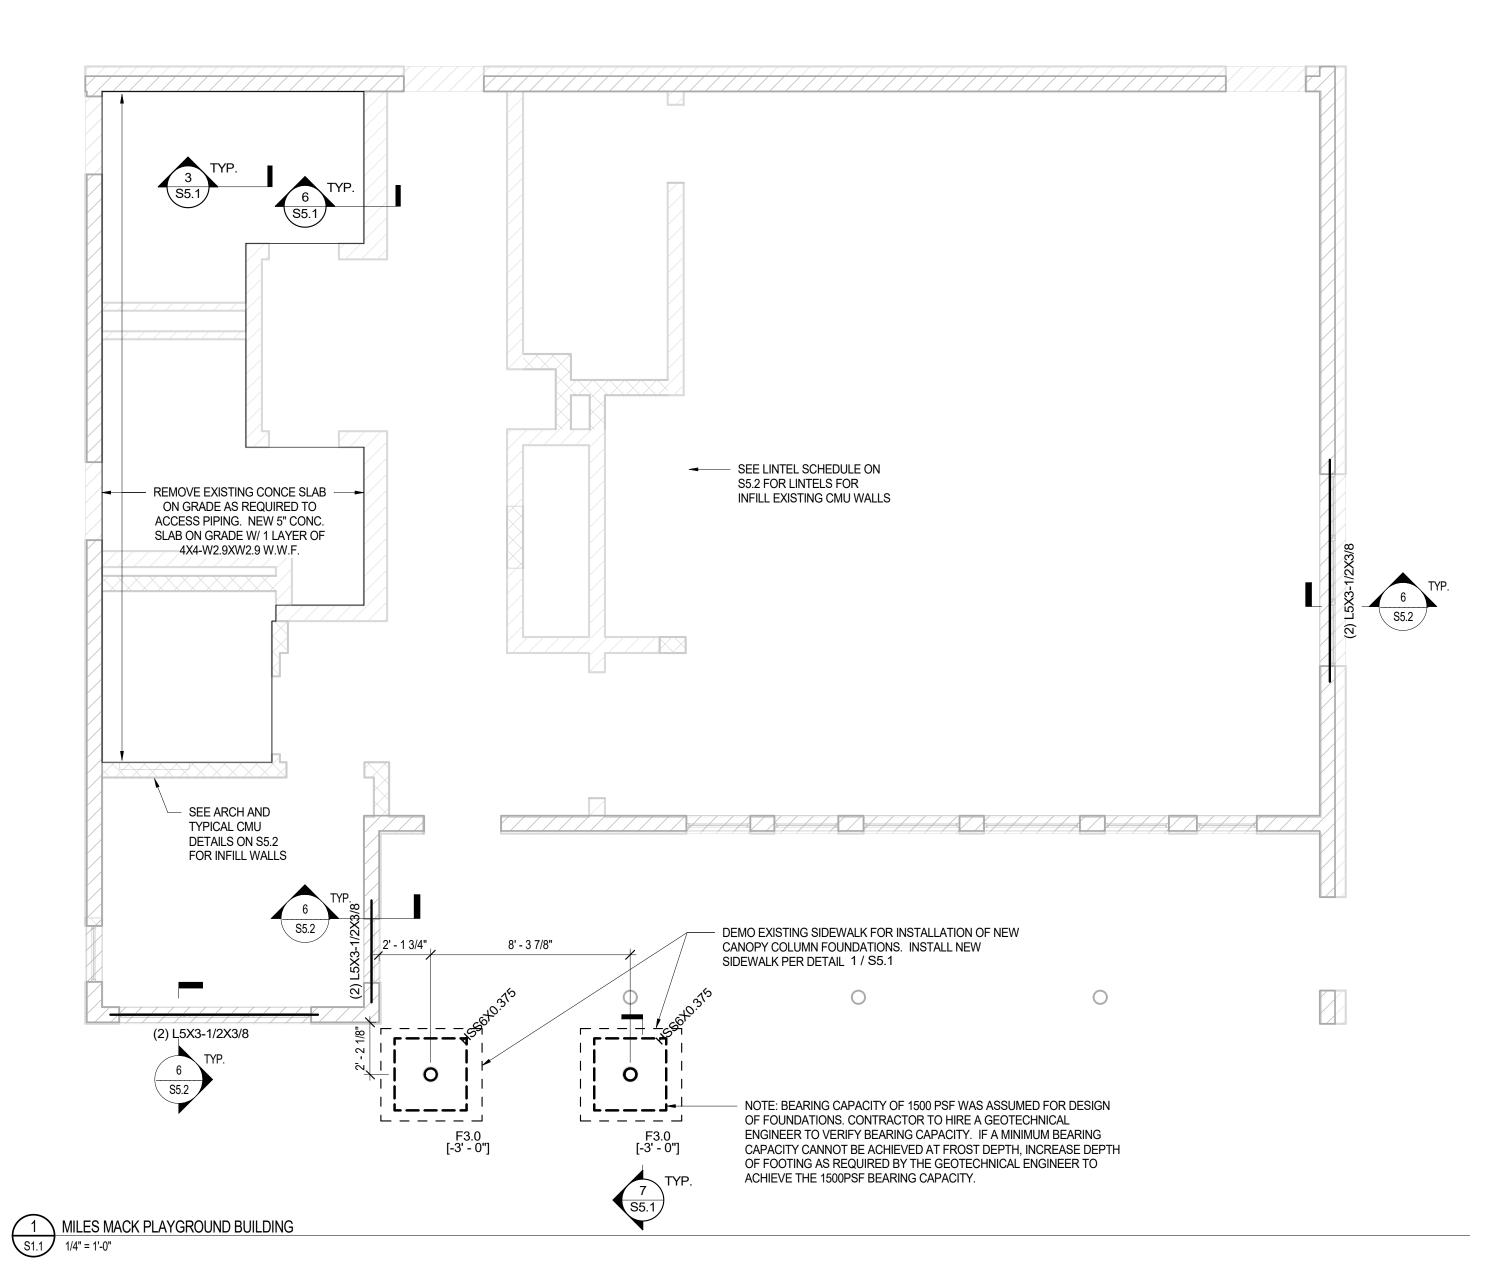

SPREAD FOOTING SCHEDULE									
MARK	LENGTH	WIDTH	THICKNESS	BOTTOM REINFORCEMENT	COUNT				
F3.0	3' - 0"	3' - 0"	2' - 0"	3#6 O.C. E.W.	2				

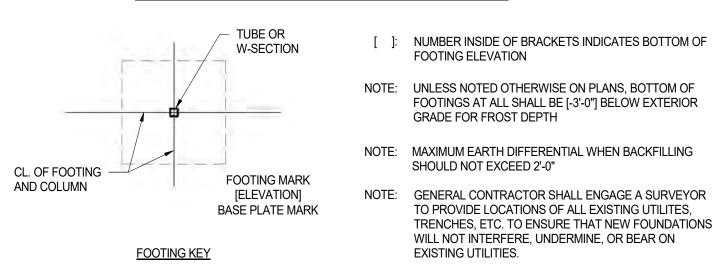

### **ROOF FRAMING PLAN NOTES**

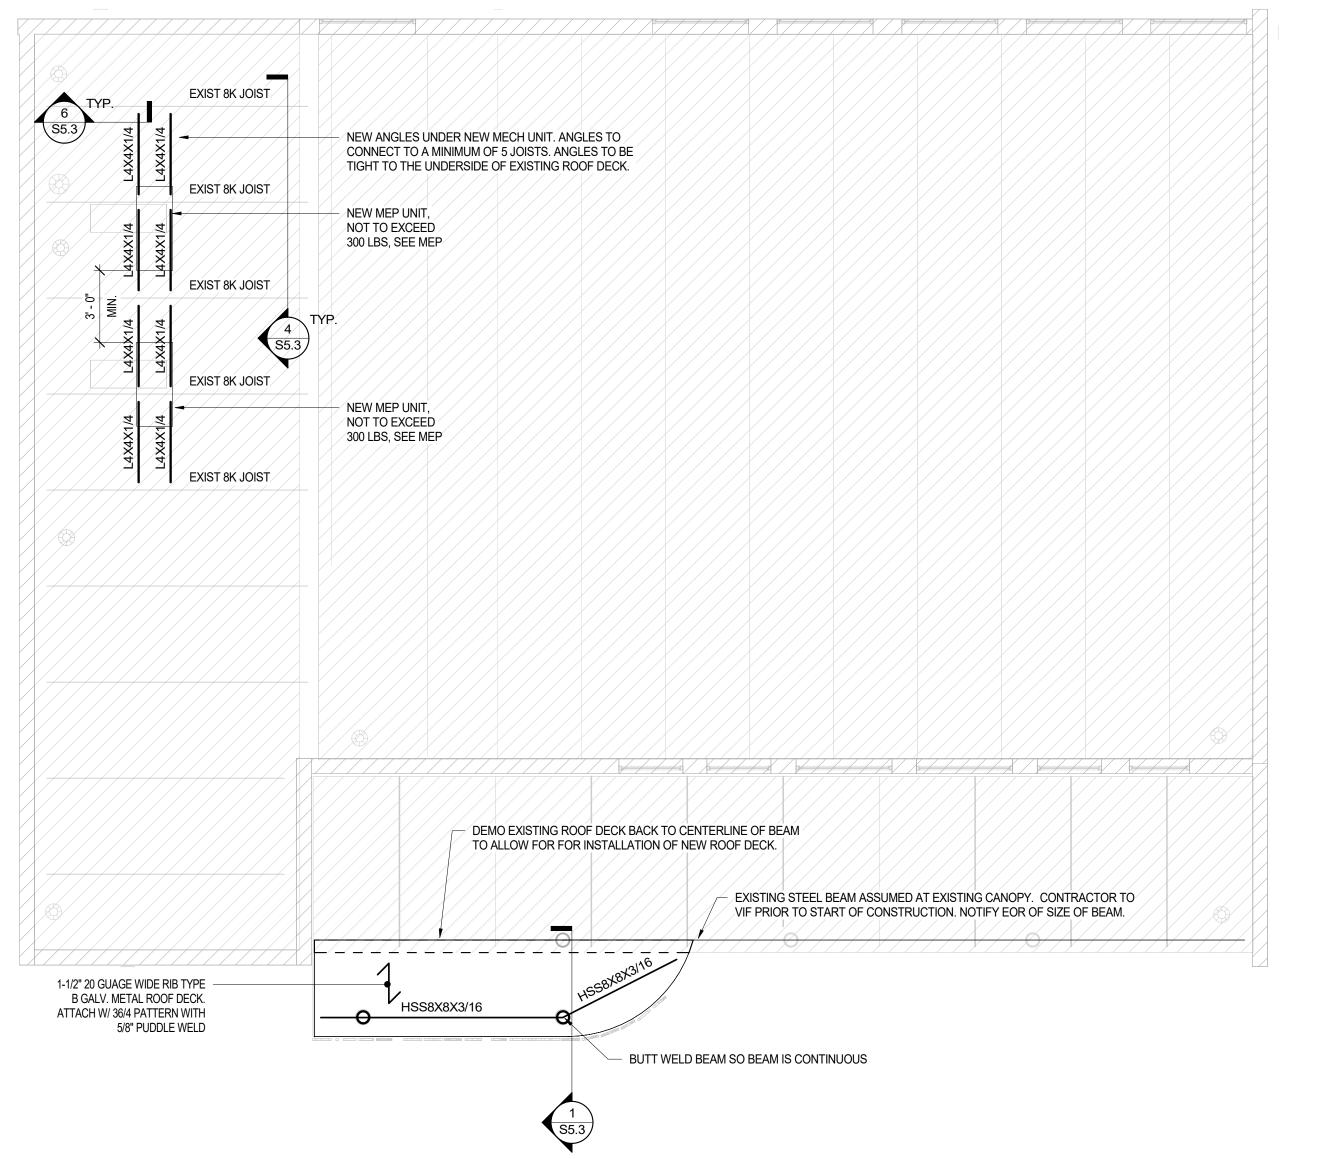
: INDICATES THE DIRECTION THE DECK IS SPANNING.

(T.O.D.): INDICATES TOP OF DECK, COORD W/ ARCH

2 S1.1 LOWER ROOF 1/4" = 1'-0"

NOTE: WHERE TUBE FRAME MEMBERS CONNECT TO COLUMNS, PROVIDE A WELDED CONNECTION ALL AROUND FROM TUBE TO COLUMN, TYP.

NOTE: KEEP STRUCTURE GUYED AND BRACED UNTIL ALL MASONRY/CONCRETE SHEAR WALLS, DIAGONAL BRACES, MOMENT FRAMES, FRAMED FLOORS AND ROOF DECKS ARE IN PLACE.

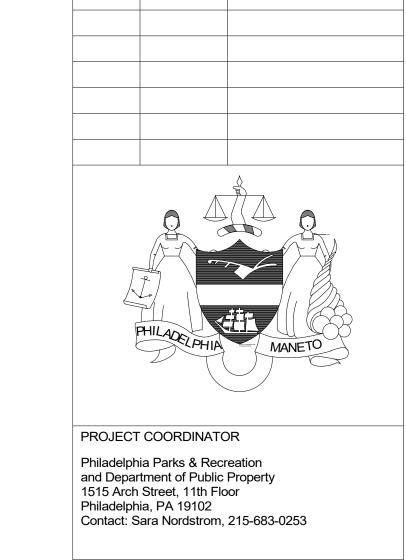

DESCRIPTION

REVISIONS



### PROJECT TEAM

JOHNSON, MIRMIRAN & THOMPSON, INC 1600 MARKET ST, SUITE 520 PHILADELPHIA, PA 19103 267.256.0300

JOHNSON, MIRMIRAN & THOMPSON, INC 1600 MARKET ST, SUITE 520 PHILADELPHIA, PA 19103 267.256.0300

SYSTEMS ENGINEER: JOHNSON, MIRMIRAN & THOMPSON, INC 1600 MARKET ST, SUITE 520 PHILADELPHIA, PA 19103 267.256.0300

CITY OF PHILADELPHIA REBUILD PHILADELPHIA AND

PHILADELPHIA PARKS & RECREATION 1515 ARCH STREET 11TH FLOOR, ONE PARKWAY BUILDING

PHILADELPHIA, PENNSYLVANIA PROJECT TITLE

MILES MACK BUILDING RENOVATION

DRAWING TITLE

WORK.

PLANS


DRAWING NO. 10-20-XXXX-01 DATE: 02.07.2020 **S1.1** 


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THE SITE BEFORE PROCEEDING WITH THE

PROJECT NO. SCALE: AS NOTED DRAWN BY:

SION



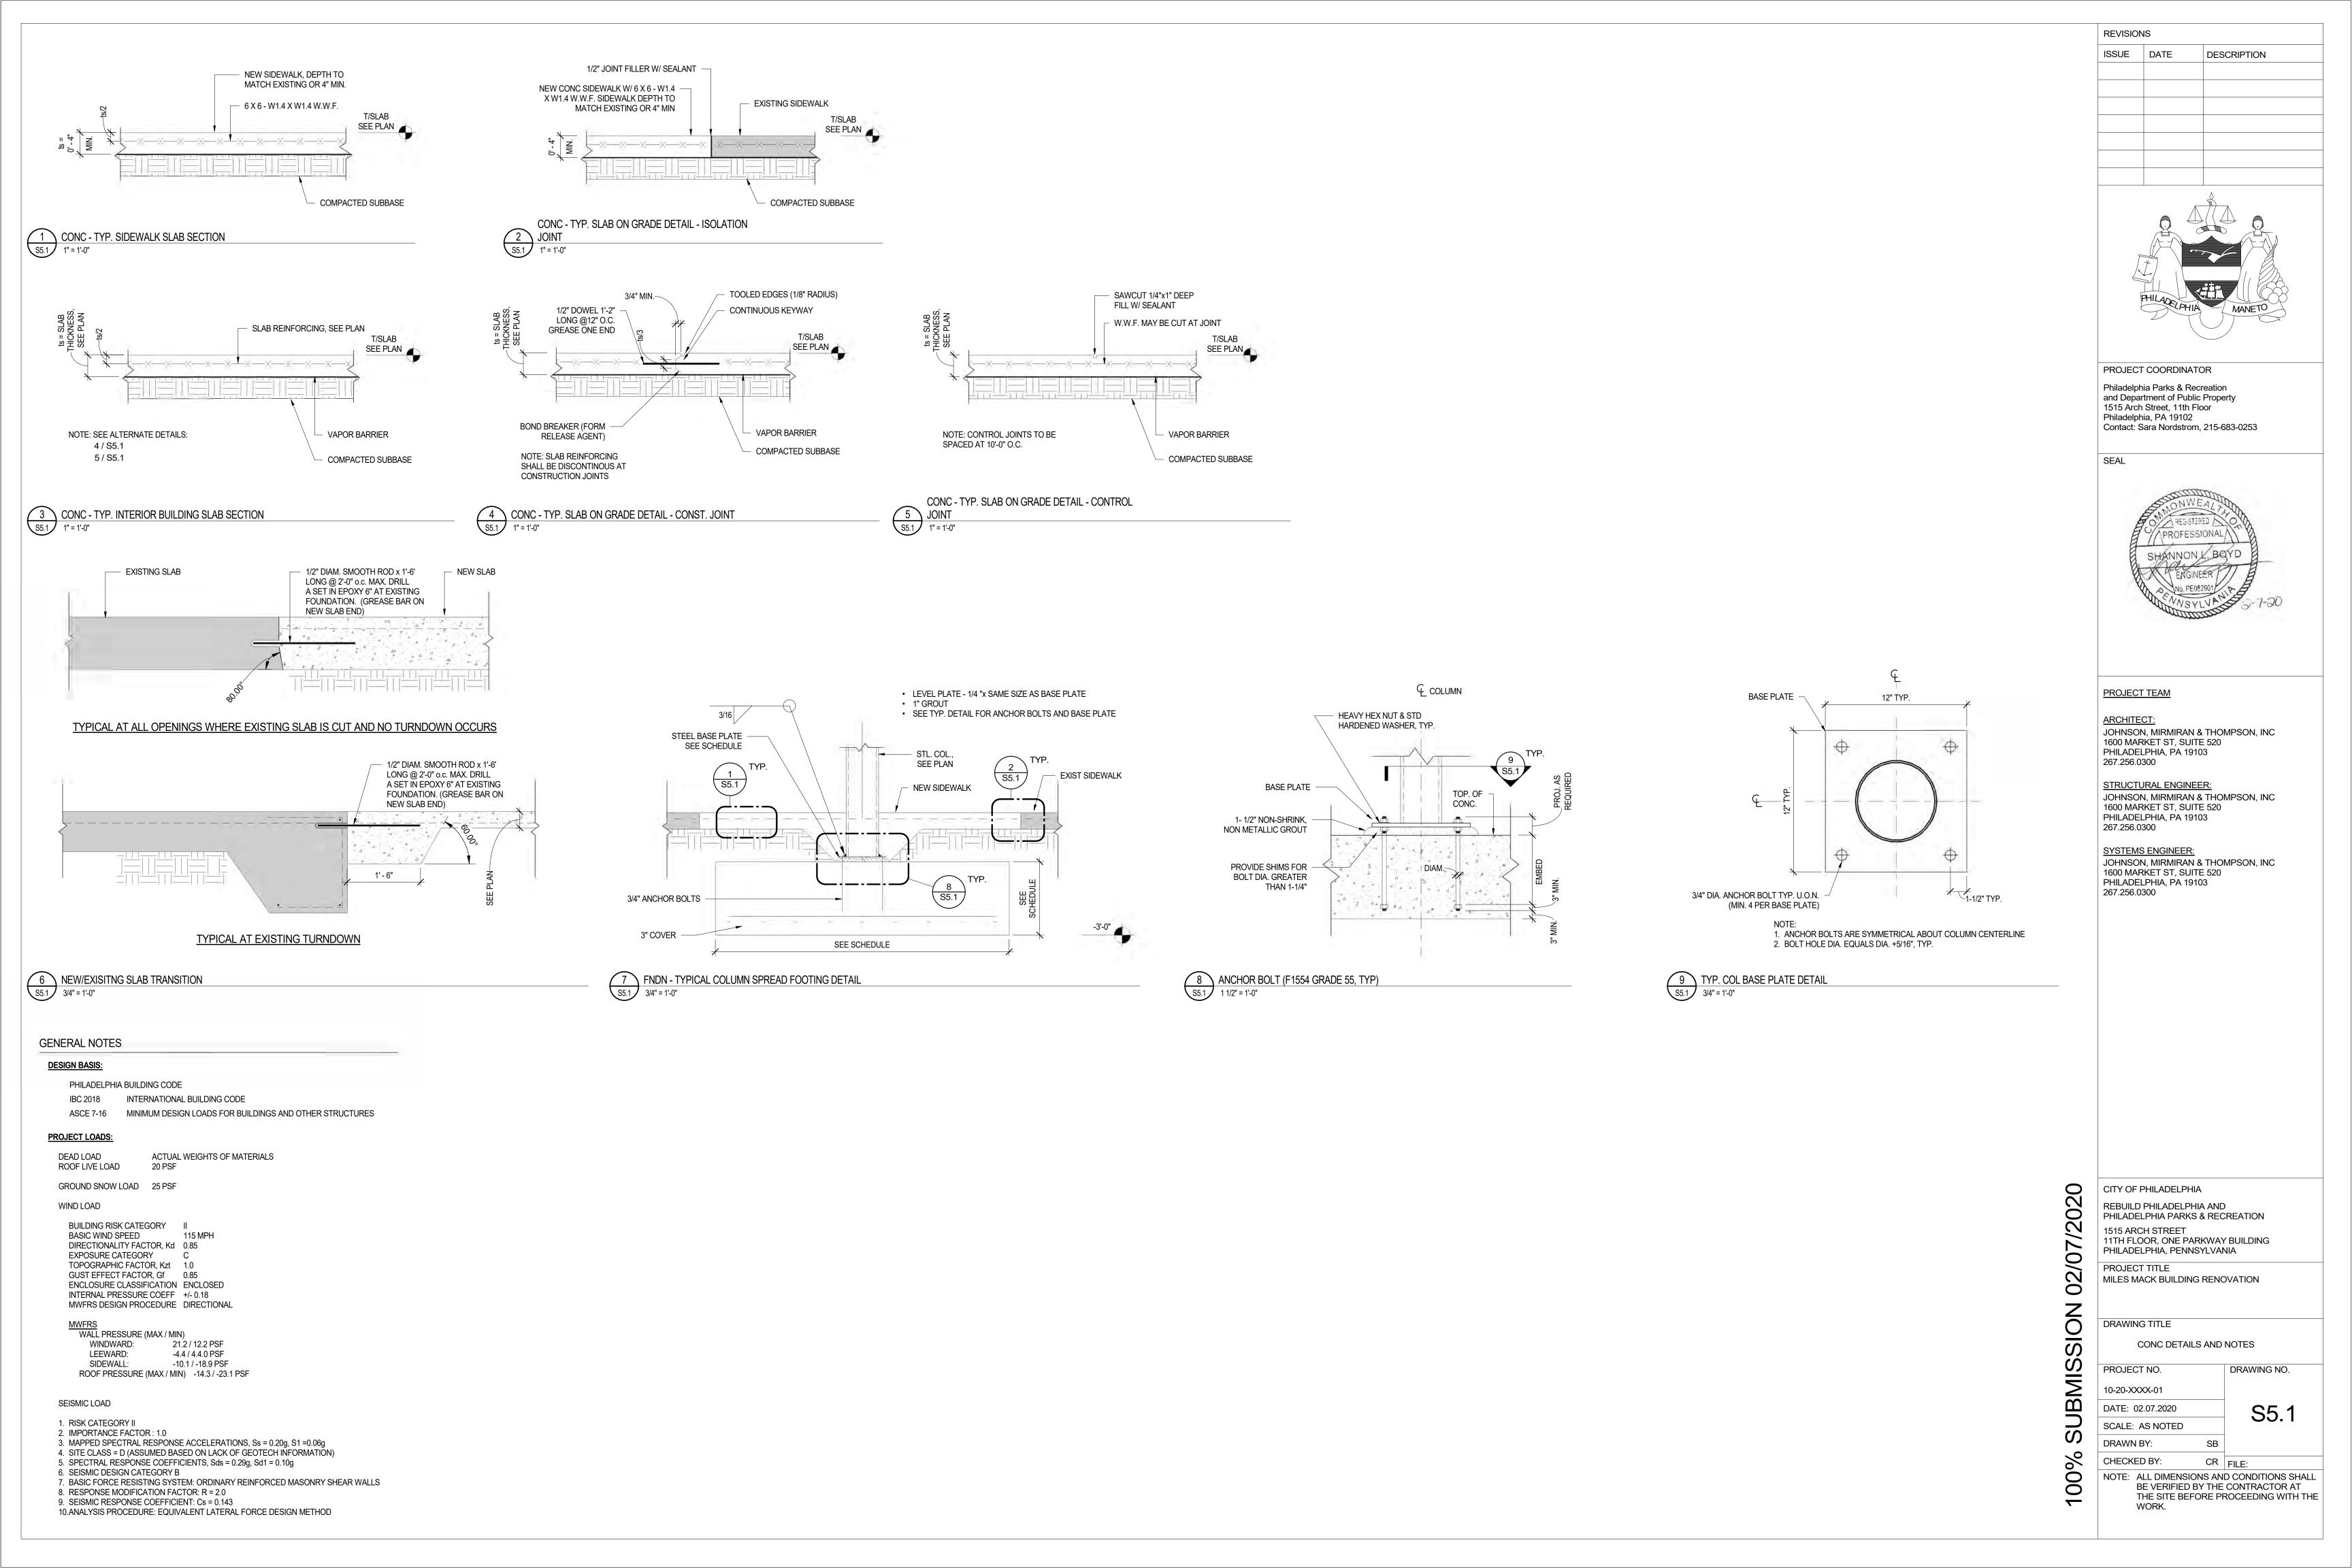

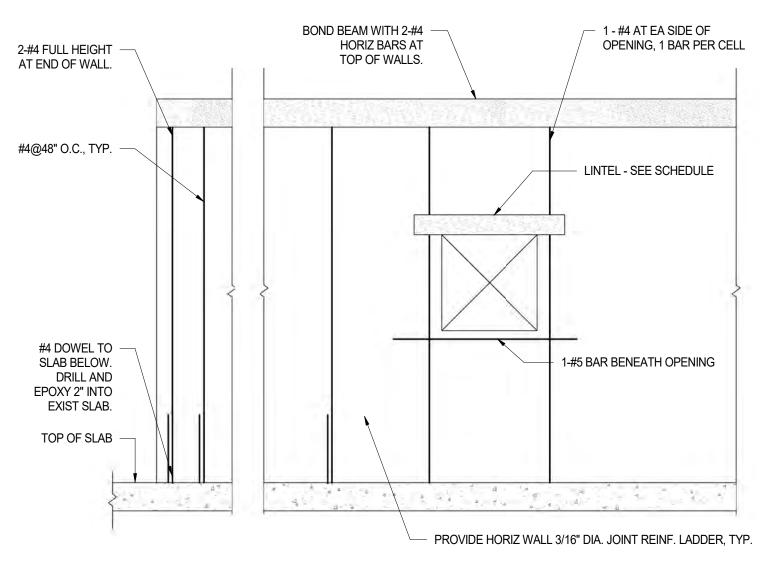NOTES:

- 1. INSTALL JOINT REINFORCEMENT IN THE FIRST AND SECOND BED JOINT ABOVE LINTELS AND BELOW SILLS AT OPENINGS.
- 2. EXTEND REINFORCEMENT IN THE SECOND BED JOINT BELOW OPENING 2'-0" BELOW JAMBS.

STEEL BEAM LINTEL

SCHEDULE

BEAM

W8X24

W8X31

SPAN

8' TO 10'

10' TO 15'


- 3. GROUT CELLS WITH REINFORCING SOLID.
- 4. SEE ARCHITECTURAL DRAWINGS FOR CONTROL JOINT LOCATIONS.

1 CMU - TYP. BLOCK WALL ELEVATION
1/2" = 1'-0"

BLOCK LINTEL SCHEDULE										
SPAN	8" WYTHE	12" WYTHE								
0' TO 4'	2 <del>-#</del> 4 (8x8)	2-#4 (12x8)								
4' TO 6'	2-#5 (8x8)	2-#5 (12x8)								
6' TO 8'	1-#4 TOP 2-#5 BOT(8x16)	2-#4 TOP 2-#5 (12x16)								
8' TO 10'	2-#4 TOP 2-#6 BOT (8x16)	2-#4 TOP 2-#7 (12x16)								

### NOTES:

- 1. PROVIDE LINTELS, AS LISTED ABOVE, OVER ALL OPENINGS IN MASONRY WALLS, UNLESS OTHERWISE SHOWN ON THE DRAWINGS.
- 2. MINIMUM 8" END BEARING TO 8' SPAN. 16" MIN. END BEARING FROM 8' TO 15' SPAN. CELLS BEARED ON ARE TO BE REINFORCED WITH SIMILAR VERTICAL WALL REBAR AND TO BE GROUTED SOLID.
- 3. BEAMS, LINTELS, SHELF ANGLES, ETC. SUPPORTING MASONRY SHALL BE TEMPORARILY BRACED AND/OR SHORED UNTIL MASONRY FOR ONE STORY (OR MORE, AS REQ'D. TO MAKE IT LATERALLY STABLE) HAS HARDENED.
- 4. REINFORCING STEEL TO HAVE 3" MIN. BOTTOM COVER.
- 5. IF THE DISTANCE BETWEEN TWO ADJACENT OPENINGS IS LESS THAN 2'-0", THE LINTEL IS TO SPAN OVER BOTH OPENINGS. THE SPAN SHALL BE THE SUM OF WIDTH OF BOTH OPENINGS AND THE DISTANCE BETWEEN THEM.

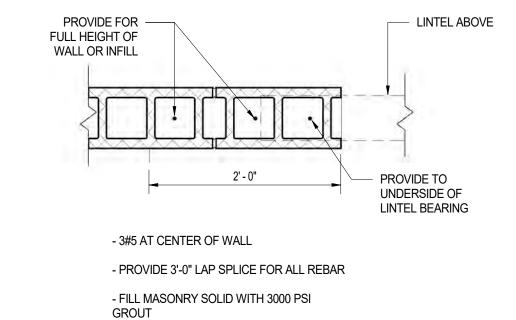

HORIZ MASONRY WALL REINF. @ 16"

REINF. IN FULLY

GROUTED CELL,

- FULLY GROUT 3 END

CORES, FULL HEIGHT

1 - #5 BAR IN -

TWO END CORES.


2 CMU - TYP. WALL REINFORCING DETAILS
1" = 1'-0"


**ENDS OF WALLS AT OPENINGS** 

1 - #5 BAR IN TWO

END CORES.

O.C. MIN

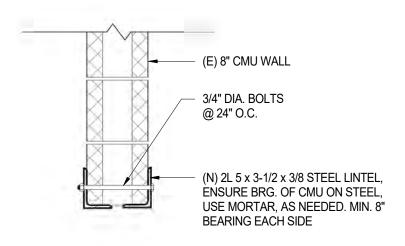

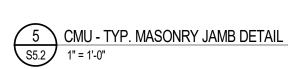



HORIZ MASONRY WALL REINF. @ 16"

O.C. MIN.

REINFORCING

CELL, TYP.

IN FULLY GROUTED

**FULLY GROUT** 

3 END CORES,

FULL HEIGHT

WALL INTERSECTION



LIN	LINTEL SCHEDULE AT EXISTING INFILL CMU WALLS										
SPAN	4" WYTHE	6" WYTHE	8" WYTHE								
0' TO 4'	L3-1/2x3-1/2x1/4	L5x5x5/16	(2) L3-1/2x3-1/2x1/4								
4' TO 6'	L3-1/2x3-1/2x1/4	L5x5x5/16	(2) L3-1/2x3-1/2x1/4								
6' TO 8'	L4x3-1/2x3/8	L5x5x5/16	(2)L4x3-1/2x3/8								
8' TO 10'-6"	L5x3-1/2x1/2	L5x5x1/2	(2)L5x3-1/2x1/2								

### NOTES:

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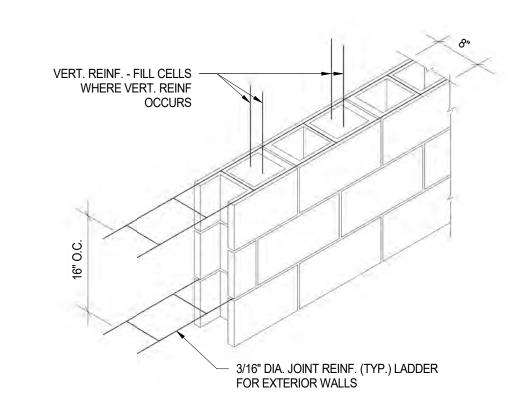
### 2. MINIMUM 8" END BEARING.

3. WALLS TO BE TEMPORARILY BRACED AND /OR SHORED UNTIL LINTEL IS INSTALLED.

4. IF THE DISTANCE BETWEEN TWO ADJACENT OPENINGS IS LESS THAN 2'-0", THE LINTEL IS TO SPAN OVER BOTH OPENINGS. THE SPAN SHALL BE THE SUM OF WIDTH OF BOTH OPENINGS AND THE DISTANCE BETWEEN THEM.

5. FOR DOUBLE ANGLE LINTELS, SEE DETAIL 6 / S5.2

7 CMU - LINTEL AT EXISTING WALL SCHEDULE 12" = 1'-0"



3 CMU - TYP. JT. REINF. 8" CMU WALLS 3/4" = 1'-0"

#5 REBAR IN

**CORNER OF WALL** 

FULLY GROUTED CELL, TYP.



DESCRIPTION

PROJECT COORDINATOR

Philadelphia Parks & Recreation and Department of Public Property 1515 Arch Street, 11th Floor Philadelphia, PA 19102

Contact: Sara Nordstrom, 215-683-0253

SEAL

REVISIONS



### PROJECT TEAM

ARCHITECT:

JOHNSON, MIRMIRAN & THOMPSON, INC 1600 MARKET ST, SUITE 520 PHILADELPHIA, PA 19103 267.256.0300

STRUCTURAL ENGINEER:

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SYSTEMS ENGINEER:
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CITY OF PHILADELPHIA

REBUILD PHILADELPHIA AND PHILADELPHIA PARKS & RECREATION 1515 ARCH STREET

11TH FLOOR, ONE PARKWAY BUILDING PHILADELPHIA, PENNSYLVANIA

PROJECT TITLE

PROJECT TITLE
MILES MACK BUILDING RENOVATION

DRAWING TITLE

CMU DETAILS

PROJECT NO. DRAWING NO. 10-20-XXXX-01

DATE: 02.07.2020

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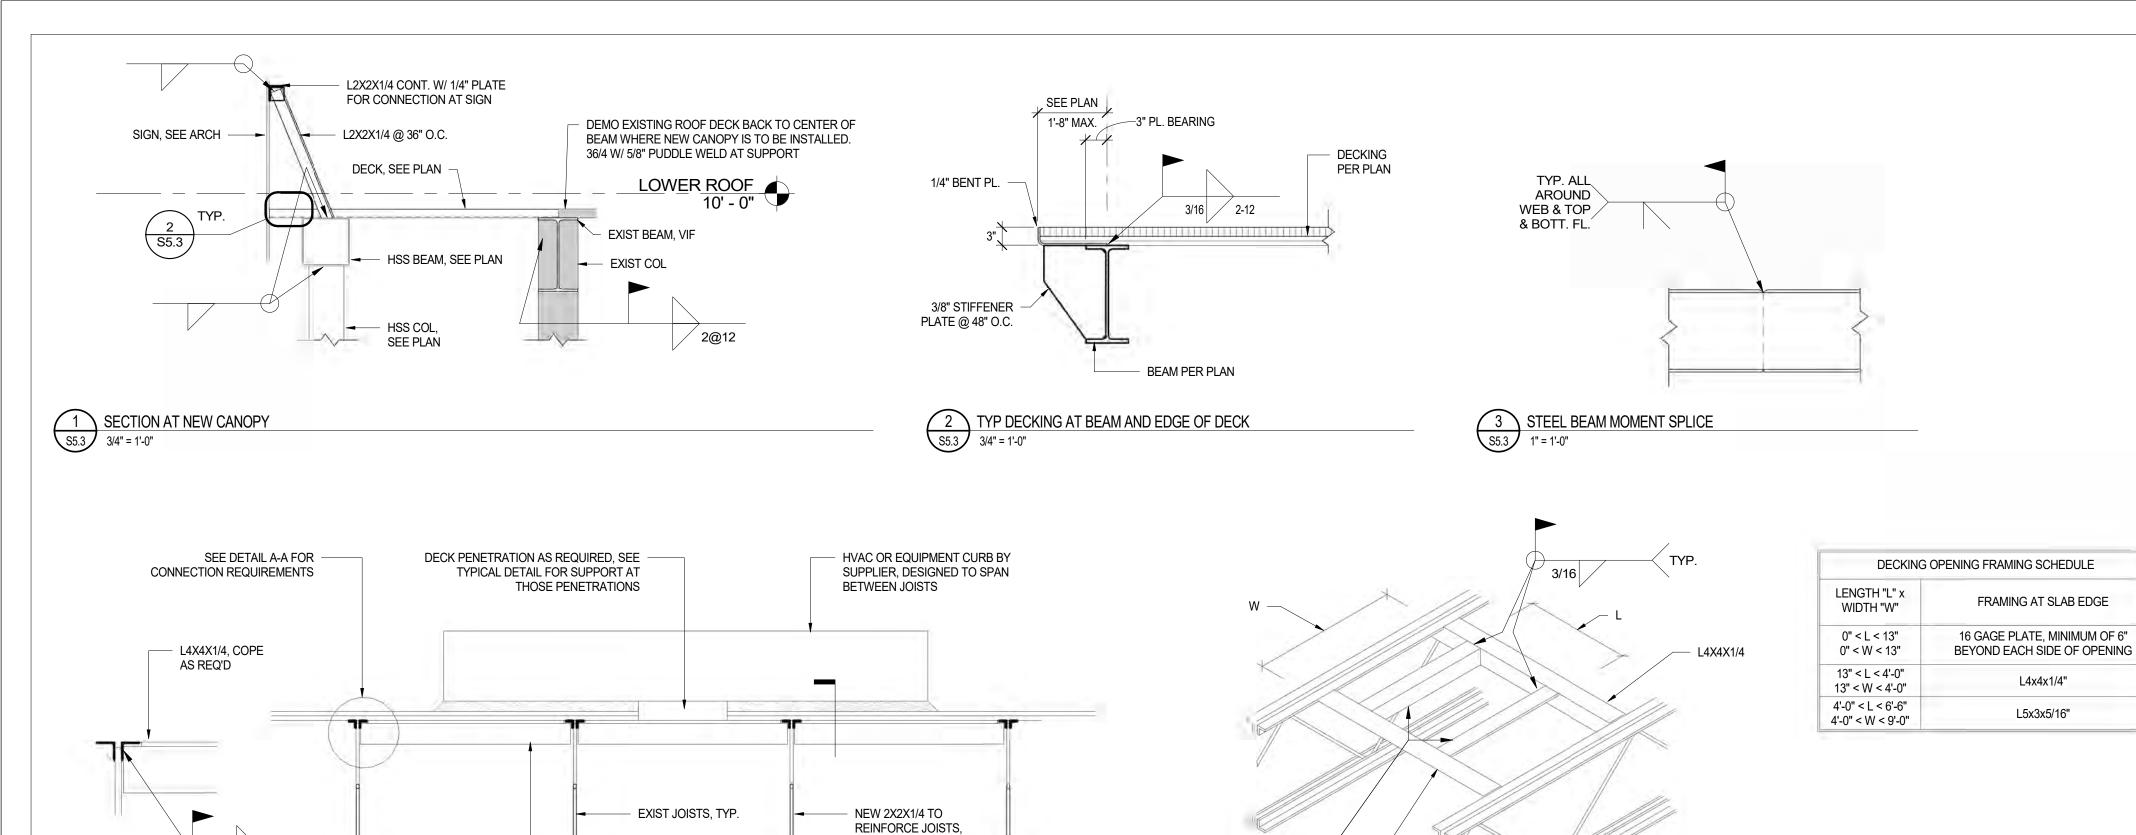
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00% SUBMISSION



TYP., SEE 1/S-500




DETAIL A-A




- POINT LOAD FROM RTU, TYP.

L4X4X1/4 -

FRAME OPENING -PER SCHEDULE - STEEL JOIST PER PLAN

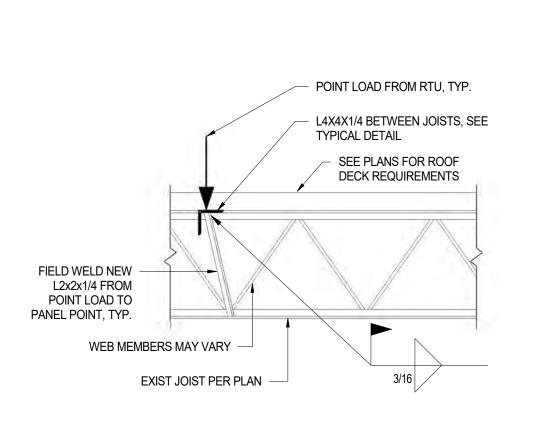

L4X4X1/4, TYP. -

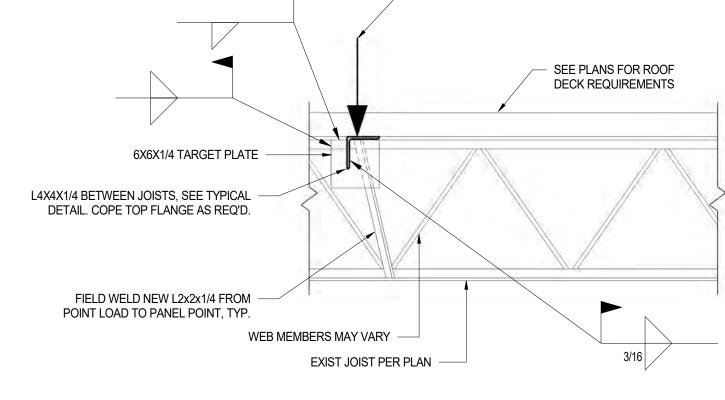

6 TYPICAL REINFORCEMENT AT POINT LOADS1 3/4" = 1'-0"

ALT. TYPICAL REINFORCEMENT AT POINT LOADS

(ALTERNATE 6/S5.3)

1" = 1'-0"

PHILACE PHIA MANE TO

DESCRIPTION

PROJECT COORDINATOR


Philadelphia Parks & Recreat

Philadelphia Parks & Recreation and Department of Public Property 1515 Arch Street, 11th Floor Philadelphia, PA 19102 Contact: Sara Nordstrom, 215-683-0253

SEAL

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ISSUE DATE

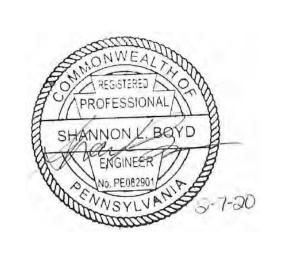

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CITY OF PHILADELPHIA

REBUILD PHILADELPHIA AND PHILADELPHIA PARKS & RECREATION

1515 ARCH STREET 11TH FLOOR, ONE PARKWAY BUILDING

PHILADELPHIA, PENNSYLVANIA
PROJECT TITLE

PROJECT TITLE
MILES MACK BUILDING RENOVATION

DRAWING TITLE

OTEEL DETAIL

STEEL DETAILS

DRAWING NO.

S5.3

PROJECT NO.


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GENERAL CONTRACTOR SHALL INCLUDE COSTS FOR ALL DEMOLITION INCLUDING BUT NOT NECESSARILY LIMITED TO THE FOLLOWING:

DEMOLITION WORK INCLUDES, BUT NOT LIMITED TO THE WORK INDICATED, AS COORDINATED WITH WORK OF ALL OTHER TRADES, AS INDICATED
ELSEWHERE, AND AS REQUIRED TO ACCOMMODATE CONSTRUCTION. ALL DEMOLITION REQUIRED SHALL BE INCLUDED IN EACH CONTRACTOR'S BASE BID
TO PERFORM AND COMPLETE CONSTRUCTION UNLESS OTHERWISE INDICATED. REFER TO ASBESTOS ABATEMENT REPORT AND MECHANICAL,
ELECTRICAL, AND PLUMBING DRAWINGS FOR ADDITIONAL INFORMATION.

2. ALL ITEMS DESIGNATED AS 'SALVAGED' SHALL BE COORDINATED WITH OWNER.

ITEMS TO BE SALVAGED, RELOCATED, OR REINSTALLED SHALL BE AS INDICATED. SPECIAL CARE IS TO BE TAKEN SO AS NOT TO DAMAGE THESE ITEMS.
 THE G.C. SHALL COORDINATE THE STORAGE OF ALL SALVAGED ITEMS TO BE EITHER RELOCATED OR REINSTALLED WITH THE OWNER.
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LOCATIONS.

5. WHEN A NEW WALL, CEILING, ROOF, OR FLOOR ASSEMBLY IS INDICATED WHERE AN EXISTING WALL, CEILING, ROOF, OR FLOOR ASSEMBLY EXISTS, THE

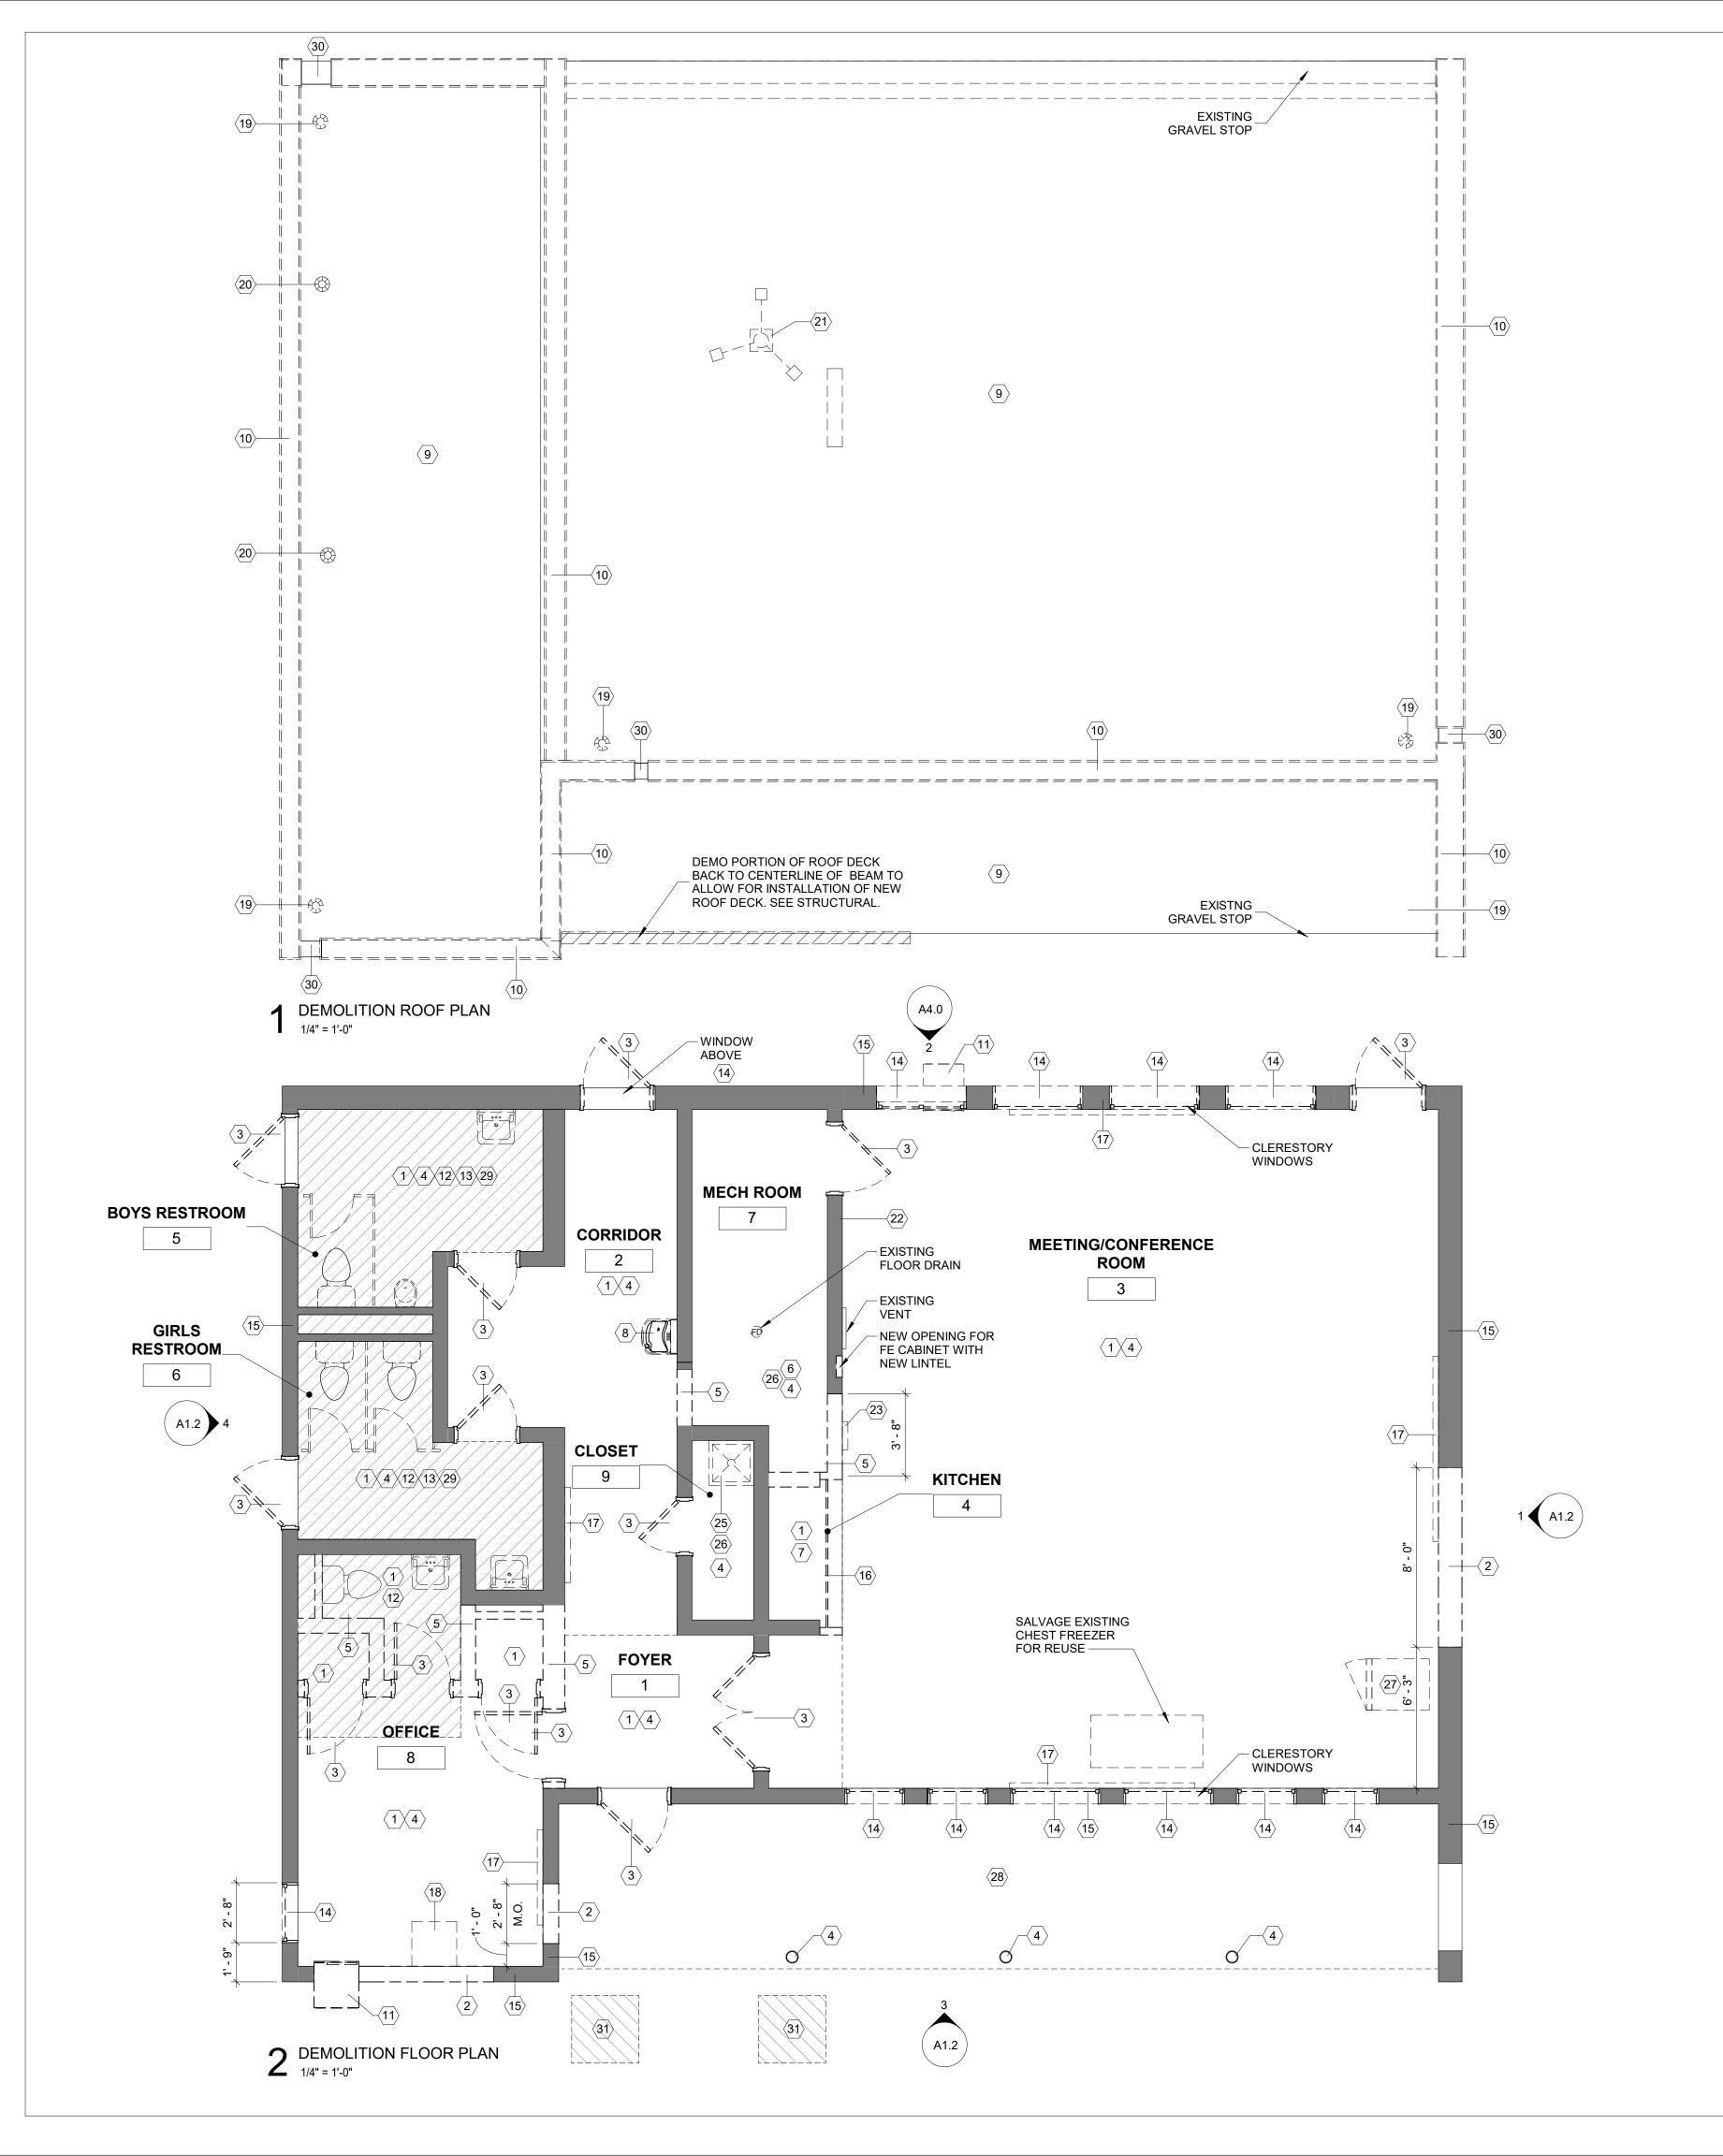EXISTING SHALL BE COMPLETELY REMOVED, WITH ASSOCIATED UTILITIES REMOVED AND CAPPED BEHIND THE SURFACE OF THE REMAINING SUBSTRATE, UNLESS NOTED OTHERWISE. ALL DEPRESSIONS, INDENTS, OR PROTRUSIONS ETC.. LEFT AFTER THE REMOVAL OF ITEMS WHICH WILL INTERFERE WITH THE CONSTRUCTION SHALL BE REPAIRED, REPLACE OR REMOVED TO PROVIDE A SMOOTH TRANSITION BETWEEN NEW AND OLD SURFACES.

6. THE CONTRACTORS SHALL VERIFY ALL CONDITIONS PRIOR TO COMMENCING DEMOLITION. SHOULD QUESTIONS ARISE, THE CONTRACTOR SHALL NOTIFY THE ARCHITECT, IN WRITING, PRIOR TO PROCEEDING WITH DEMOLITION.

WHERE OPENINGS ARE INDICATED TO BE MADE IN EXISTING MASONRY WALLS, OR EXISTING OPENINGS ARE TO BE INFILLED, THE CONTRACTOR SHALL TOOTH IN NEW MASONRY CONSTRUCTION TO MATCH ADJACENT COURSING.

 CONTRACTORS ARE RESPONSIBLE FOR SHORING, BRACING, AND UNDERPINNING RELATED TO THE DEMOLITION, REMOVAL OR CUTTING OF ANY WALL, PARTITION OR ANY OTHER STRUCTURAL ELEMENT.

REMOVE ALL EXISTING LIGHT FIXTURES, EMERGENCY LIGHT FIXTURES, AND EXIT SIGNS AND SET ASIDE FOR REUSE.
 PREP ALL INTERIOR WALL AND CEILING SURFACES FOR PAINT INCLUDING UNDERSIDE OF EXPOSED ROOF DECK AND ROOF TRUSSES.


11. PREP EXTERIOR COLUMNS FOR PAINT.

12. PREP UNDERSIDE OF EXERIOR ROOF ENTRY CANOPY AND PREP FOR PAINT.

13. OPEN AND PARTIALLY DEMO WALLS, CEILINGS, AND FLOORS AS REQUIRED FOR MECHNICAL, ELECTRICAL, AND PLUMBING WORK. COORDINATE WITH MECHANICAL, ELECTRICAL, AND PLUMBING DRAWINGS.

MANINGS.

DEMOLITION PLAN KEYNOTES KEYNOTE REMOVE EXISTING FLOORING AND BASE DOWN TO SOUND SUBSTRATE. PATCH AND REPAIR AFFECTED SURFACES AND PREPARE TO RECEIVE REMOVE PORTIONS OF EXISTING WALL TO INSTALL OPENING SCHEDULED. PATCH AND REPAIR AFFECTED ADJACENT SURFACES AND PREPARE REMOVE EXISTING DOOR, FRAME AND ASSOCIATED HARDWARE. PREPARE OPENING FOR NEW DOOR. ALLOW FOR MISCELLANEOUS REPAIR TO DOOR OPENINGS AT HEAD, JAMB & SILLS. SEE STRUCTURAL DRAWINGS FOR REINFORCING REQUIREMENTS. SEE DOOR SCHEDULE FOR NEW MASONRY OPENING SIZE. 4 PREP EXISTING INTERIOR CMU WALLS & STEEL COLUMNS TO RECEIVE NEW PAINT, TYP. AT ALL LOCATIONS. REMOVE EXISTING MASONRY WALL FROM FLOOR TO UNDERSIDE OF STRUCTURE. REMOVE EXISTING MECHANICAL EQUIPMENT. SEE MECHANICAL DRAWINGS. REMOVE EXISTING KITCHEN CABINETS, EQUIPMENT, APPLIANCES & COUNTERTOP. COORDINATE WITH PLUMBING AND ELECTRICAL DRAWINGS. REMOVE EXISTING DRINKING FOUNTAIN AND ASSOCIATED HARDWARE. COORDINATE WITH PLUMBING DRAWINGS. REMOVE ROOFING MATERIAL AND INSULATION DOWN TO ROOF SUBSTRATE. ALLOW FOR MISC REPAIR TO ROOF SUBSTRATE AS NEEDED. PREPARE ROOF FOR NEW ROOFING MATERIAL. CONTRACTOR SHALL PROTECT EXISTING ROOF ASSESMBLIES FROM DAMAGE DURING DEMOLTION AND NEW WORK. 10 REMOVE EXISTING METAL COPING AND FLASHING, TYP. ENTIRE ROOF. 11 REMOVE EXISTING AIR CONDITIONING UNIT. ALLOW FOR MISC REPAIR TO OPENINGS AT HEAD, JAMB, AND SILLS. 12 REMOVE ALL EXISTING PLUMBING FIXTURES IN THEIR ENTIRETY. COORDINATE WITH PLUMBING DRAWINGS. 13 REMOVE EXISTING TOILET PARTITION AND ALL ASSOCIATED HARDWARE. REMOVE EXISTING WINDOW, FRAME, SECURITY SCREEN, AND ASSOCIATED HARDWARE. PREPARE OPENING FOR NEW WINDOW. ALLOW FOR MISC REPAIR TO WINDOW OPENINGS AT HEAD, JAMB & SILLS. SEE WINDOW SCHEDULE. 15 REMOVE AND REPLACE EXISTING COMPRESSIVE FILLER AT BOTTOM OF EXTERIOR WALL & CONCRETE PAD. REMOVE EXISTING ROLL DOWN GATE, TRACK AND ALL ASSOCIATED HARDWARE. ENLARGE OPENING WITH NEW LINTEL FOR NEW KITCHENETTE. COORDINATE WITH STRUCTURAL. PREP FOR NEW ROLL DOWN DOOR. REMOVE EXISTING BULLETIN BOARD. 18 EXISTING SERVER ENCLOSURE TO BE REMOVED AND RELOCATED BY OWNER. EXISTING ROOF DRAIN TO BE REMOVED, V.I.F. EXISTING VENT AND VENT CAP TO REMAIN. REMOVE EXISTING FLUE AND SUPPORTS. REMOVE EXISTING COAT HOOKS. DEMOLISH EXISTING FE CABINET. REMOVE EXISTING UTILITY SINK AND ASSOCIATED PLUIMBING. SEE PLUMBING DRAWINGS. PATCH AND REPAIR AFFECTED SURFACES AND PREPARE TO RECEIVE SCHEDULED FINISH. SALVAGE REFRIGERATOR FOR REUSE. PREPARE CONCRETE SURFACE FOR NEW PAINT. DEMOLISH EXISTING CONCRETE SLAB FOR NEW FLOOR DRAINS AND PIPING. SEE STRUCTURAL DRAWINGS. DEMO EXISTING SCUPPERS, TYP REMOVE SLAB FOR NEW FOUNDATIONS. COORDINATE WITH STRUCTURAL DRAWINGS.

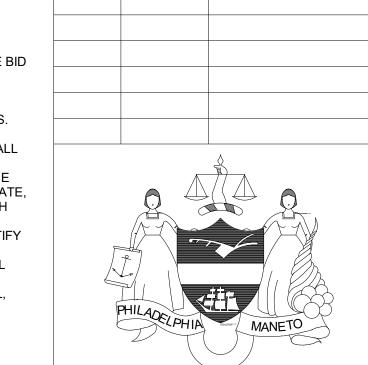

DESCRIPTION

REVISIONS

PROJECT COORDINATOR

Philadelphia Parks & Recreation and Department of Public Property 1515 Arch Street, 11th Floor Philadelphia, PA 19102

Contact: Sara Nordstrom, 215-683-0253

L

EXISTING DOOR TO REMAIN

EXISTING DOOR TO BE REMOVED

EXISTING WALL TO REMAIN

EXISTING WALL TO BE REMOVED

EXISTING FLOOR SLAB TO BE REMOVED

EXISTING SLAB TO BE REMOVED

1600 MARKET ST, SUITE 520 PHILADELPHIA, PA 19103 267.256.0300 STRUCTURAL ENGINEER:

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CITY OF PHILADELPHIA

REBUILD PHILADELPHIA AND PHILADELPHIA PARKS & RECREATION 1515 ARCH STREET

11TH FLOOR, ONE PARKWAY BUILDING

PHILADELPHÍA, PENNSYLVANIA

PROJECT TITLE

MILES MACK BUILDING RENOVATION

DRAWING TITLE

2

DEMOLITION PLANS

PROJECT NO.

10-20-XXXX-01

DATE: 02.07.2020

A1.0


SCALE: AS NOTED
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WORK.

CHECKED BY:

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4' 2' 0' 4' 8'



GWB CEILING TO BE DEMOLISHED
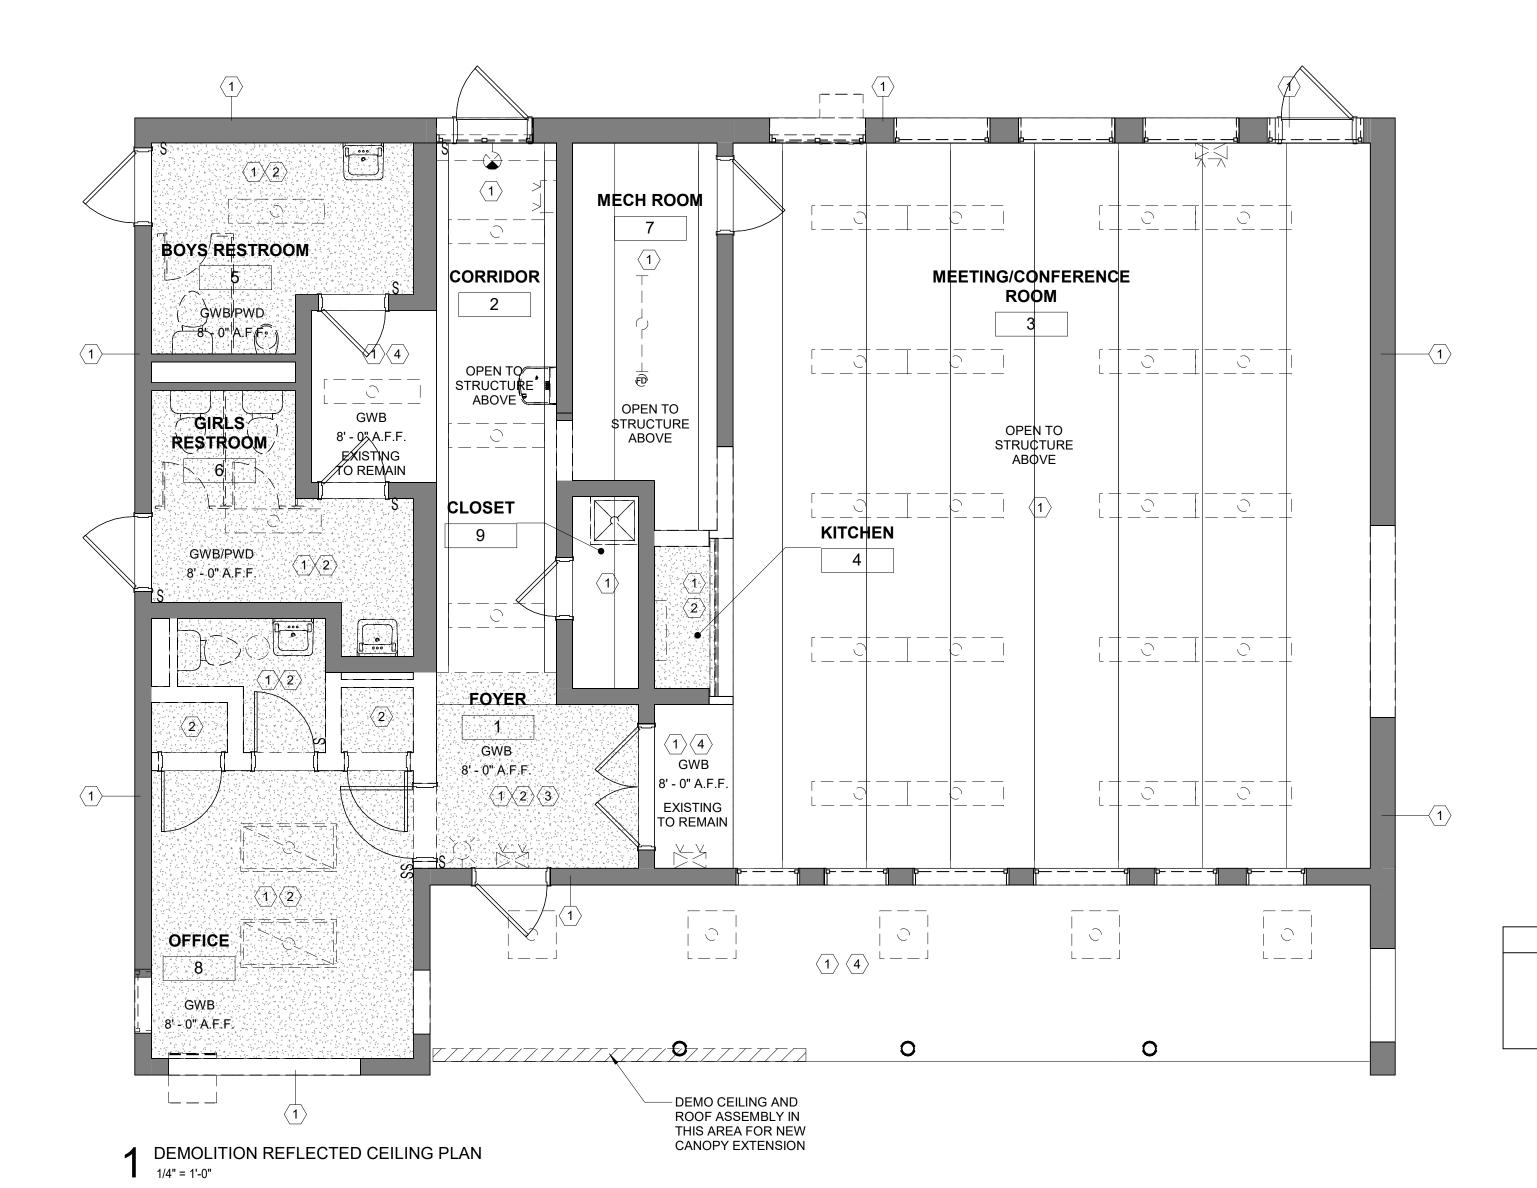
### GENERAL DEMO NOTES

### DEEINITIONS

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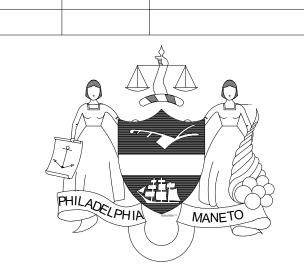
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- THE CONSTRUCTION SHALL BE REPAIRED, REPLACE OR REMOVED TO PROVIDE A SMOOTH TRANSITION BETWEEN NEW AND OLD SURFACES.

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- 8. CONTRACTORS ARE RESPONSIBLE FOR SHORING, BRACING, AND UNDERPINNING RELATED TO THE DEMOLITION, REMOVAL OR CUTTING OF ANY WALL, PARTITION OR ANY OTHER STRUCTURAL ELEMENT.
- 9. REMOVE ALL EXISTING LIGHT FIXTURES, EMERGENCY LIGHT FIXTURES, AND EXIT SIGNS AND SET ASIDE FOR REUSE.
  10. PREP ALL INTERIOR WALL AND CEILING SURFACES FOR PAINT INCLUDING UNDERSIDE OF EXPOSED ROOF DECK AND ROOF TRUSSES.
- 11. PREP EXTERIOR COLUMNS FOR PAINT.12. PREP UNDERSIDE OF EXERIOR ROOF ENTRY CANOPY AND PREP FOR PAINT.
- 13. OPEN AND PARTIALLY DEMO WALLS, CEILINGS, AND FLOORS AS REQUIRED FOR MECHNICAL, ELECTRICAL, AND PLUMBING WORK. COORDINATE WITH MECHANICAL, ELECTRICAL, AND PLUMBING DRAWINGS.

	DEMOLITION RCP KEYNOTES
KEYNOTE	
1	REMOVE EXISTING LIGHT FIXTURES AND SET ASIDE FOR REUSE. CONTRACTOR TO VERIFY EXISTING LIGHTING LAYOUT. SEE ELECTRICAL DWGS FOR MORE DETAIL. PATCH AND REPAIR AFFECTED ADJACENT SURFACES TO MATCH EXISTING TO REMAIN.
2	REMOVE EXISTING CEILING ASSEMBLY AND ALL ASSOCIATED HARDWARE. REFER TO MECHANICAL, ELECTRICAL, AND PLUMBING DRAWINGS FOR ADDITIONAL INFORMATION. PATCH AND REPAIR AFFECTED ADJACENT SURFACES TO MATCH EXISTING TO REMAIN.
3	REMOVE EXISTING GWB SOFFIT AS NEEDED FOR DEMOLITION OF ADJACENT WALLS. PREPARE AREA TO RECEIVE NEW GWB AND PLYWOOD SOFFIT.
4	REMOVE EXISTNG CEILING AS REQUIRED FOR DEMOLITION AND NEW WORK IN THIS AREA.



DESCRIPTION

PROJECT COORDINATOR

Philadelphia Parks & Recreation and Department of Public Property 1515 Arch Street, 11th Floor Philadelphia, PA 19102

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SEAL

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DRAWING TITLE

7

DEMOLITION RCP

DRAWING NO.

A1.1

PROJECT NO.


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REMOVE: REMOVE AND LEGALLY DISPOSE OF ITEMS EXCEPT THOSE INDICATED TO BE REINSTALLED, SALVAGED, OR TO REMAIN THE OWNER'S PROPERTY. EXISTING TO REMAIN: PROTECT CONSTRUCTION INDICATED TO REMAIN AGAINST DAMAGE AND SOILING DURING DEMOLITION AND NEW CONSTRUCTION.

GENERAL CONTRACTOR SHALL INCLUDE COSTS FOR ALL DEMOLITION INCLUDING BUT NOT NECESSARILY LIMITED TO THE FOLLOWING:

 DEMOLITION WORK INCLUDES, BUT NOT LIMITED TO THE WORK INDICATED, AS COORDINATED WITH WORK OF ALL OTHER TRADES, AS INDICATED ELSEWHERE, AND AS REQUIRED TO ACCOMMODATE CONSTRUCTION. ALL DEMOLITION REQUIRED SHALL BE INCLUDED IN EACH CONTRACTOR'S BASE BID TO PERFORM AND COMPLETE CONSTRUCTION UNLESS OTHERWISE INDICATED. REFER TO ASBESTOS ABATEMENT REPORT AND MECHANICAL, ELECTRICAL, AND PLUMBING DRAWINGS FOR ADDITIONAL INFORMATION.

2. ALL ITEMS DESIGNATED AS 'SALVAGED' SHALL BE COORDINATED WITH OWNER.

ITEMS TO BE SALVAGED, RELOCATED, OR REINSTALLED SHALL BE AS INDICATED. SPECIAL CARE IS TO BE TAKEN SO AS NOT TO DAMAGE THESE ITEMS.
 THE G.C. SHALL COORDINATE THE STORAGE OF ALL SALVAGED ITEMS TO BE EITHER RELOCATED OR REINSTALLED WITH THE OWNER.
 LOCATIONS AND/OR ELEVATIONS OF EXISTING ITEMS, AS SHOWN ON THE DRAWINGS, ARE APPROXIMATE. RESPECTIVE TRADES SHALL FIELD VERIFY ALL

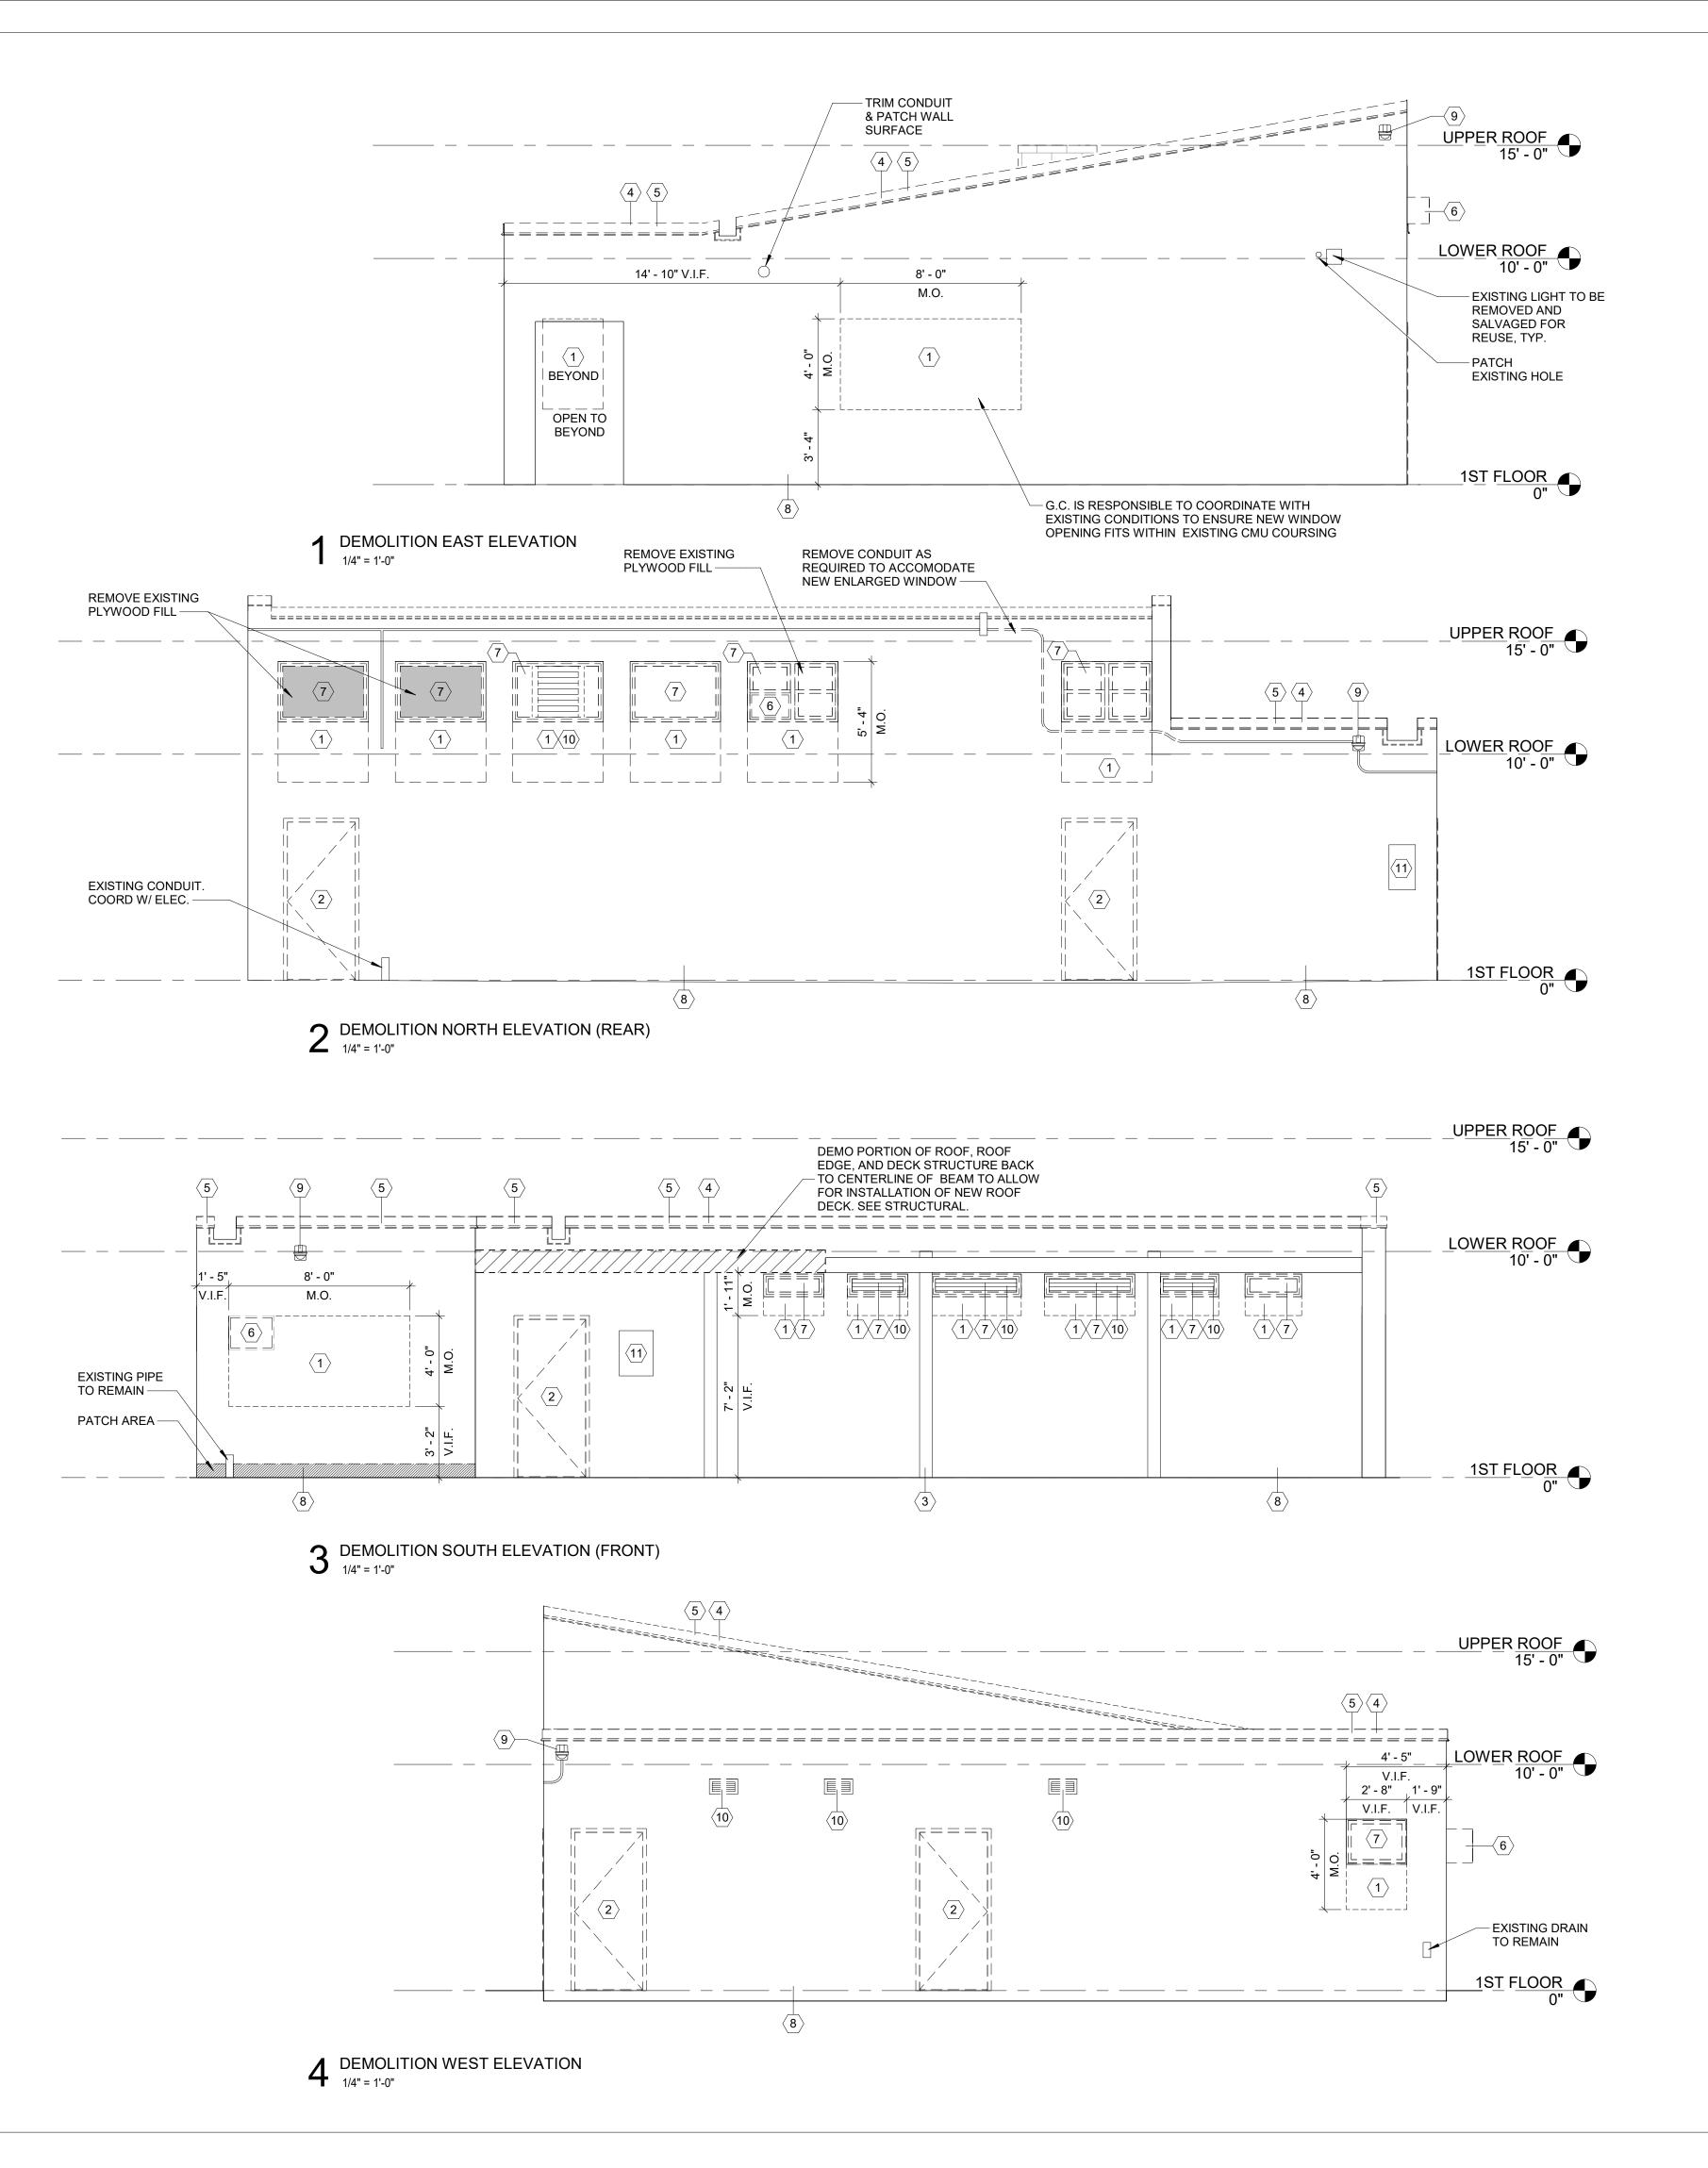LOCATIONS AND/OR ELEVATIONS OF EXISTING ITEMS, AS SHOWN ON THE DRAWINGS, ARE APPROXIMATE. RESPECTIVE TRADES SHALL FIELD VERIF LOCATIONS.

5. WHEN A NEW WALL, CEILING, ROOF, OR FLOOR ASSEMBLY IS INDICATED WHERE AN EXISTING WALL, CEILING, ROOF, OR FLOOR ASSEMBLY EXISTS, THE EXISTING SHALL BE COMPLETELY REMOVED, WITH ASSOCIATED UTILITIES REMOVED AND CAPPED BEHIND THE SURFACE OF THE REMAINING SUBSTRATE, UNLESS NOTED OTHERWISE. ALL DEPRESSIONS, INDENTS, OR PROTRUSIONS ETC.. LEFT AFTER THE REMOVAL OF ITEMS WHICH WILL INTERFERE WITH THE CONSTRUCTION SHALL BE REPAIRED, REPLACE OR REMOVED TO PROVIDE A SMOOTH TRANSITION BETWEEN NEW AND OLD SURFACES.

6. THE CONTRACTORS SHALL VERIFY ALL CONDITIONS PRIOR TO COMMENCING DEMOLITION. SHOULD QUESTIONS ARISE, THE CONTRACTOR SHALL NOTIFY THE ARCHITECT, IN WRITING, PRIOR TO PROCEEDING WITH DEMOLITION.

7. WHERE OPENINGS ARE INDICATED TO BE MADE IN EXISTING MASONRY WALLS, OR EXISTING OPENINGS ARE TO BE INFILLED, THE CONTRACTOR SHALL TOOTH IN NEW MASONRY CONSTRUCTION TO MATCH ADJACENT COURSING.

8. CONTRACTORS ARE RESPONSIBLE FOR SHORING, BRACING, AND UNDERPINNING RELATED TO THE DEMOLITION, REMOVAL OR CUTTING OF ANY WALL, PARTITION OR ANY OTHER STRUCTURAL ELEMENT.

9. REMOVE ALL EXISTING LIGHT FIXTURES, EMERGENCY LIGHT FIXTURES, AND EXIT SIGNS AND SET ASIDE FOR REUSE.

10. PREP ALL INTERIOR WALL AND CEILING SURFACES FOR PAINT INCLUDING UNDERSIDE OF EXPOSED ROOF DECK AND ROOF TRUSSES.

11. PREP EXTERIOR COLUMNS FOR PAINT.12. PREP UNDERSIDE OF EXERIOR ROOF ENTRY CANOPY AND PREP FOR PAINT.

EXISTING CCTV DEVICE TO REMAIN. COORDINATE WITH OWNER.

11 PROTECT EXISTING SIGNAGE TO REMAIN

EXISTING VENT/LOUVER TO BE REMOVED. COORDINATE WITH MECHANICAL

13. OPEN AND PARTIALLY DEMO WALLS, CEILINGS, AND FLOORS AS REQUIRED FOR MECHNICAL, ELECTRICAL, AND PLUMBING WORK. COORDINATE WITH MECHANICAL FLECTRICAL AND PLUMBING DRAWINGS

DEMOLITION ELEVATION KEYNOTES

KEYNOTE

REMOVE PORTIONS OF EXISTING WALL TO INSTALL OPENING SCHEDULED. PATCH AND REPAIR AFFECTED ADJACENT SURFACES AND PREPARE TO RECEIVE SCHEDULED FINISH. COORDINATE WITH STRUCTURAL FOR NEW ENLARGED OPENINGS.

REMOVE EXISTING DOOR, FRAME AND ASSOCIATED HARDWARE. PREPARE OPENING FOR NEW DOOR, ALLOW FOR MISCELLANEOUS REPAIR TO DOOR OPENINGS AT HEAD, JAMB & SILLS. SEE STRUCTURAL DRAWINGS FOR REINFORCING REQUIREMENTS. SEE DOOR SCHEDULE FOR NEW MASONRY OPENING SIZE.


PREP EXISTING CMU WALLS & STEEL COLUMNS TO RECEIVE NEW PAINT, TYP. AT ALL LOCATIONS.


REMOVE ROOFING MATERIAL AND INSULATION DOWN TO ROOF SUBSTRATE. ALLOW FOR MISC REPAIR TO ROOF SUBSTRATE AS NEEDED. PREPARE ROOF FOR NEW ROOFING MATERIAL.

REMOVE EXISTING METAL COPING AND FLASHING TYP. ENTIRE ROOF.

REMOVE EXISTING AIR CONDITIONING UNIT. ALLOW FOR MISC REPAIR TO OPENINGS AT HEAD, JAMB, AND SILLS.

REMOVE EXISTING WINDOW, FRAME, SCREEN, AND ASSOCIATED HARDWARE. PREPARE OPENING FOR NEW WINDOW. ALLOW FOR MISC REPAIR TO WINDOW OPENINGS AT HEAD, JAMB & SILLS. SEE WINDOW SCHEDULE.

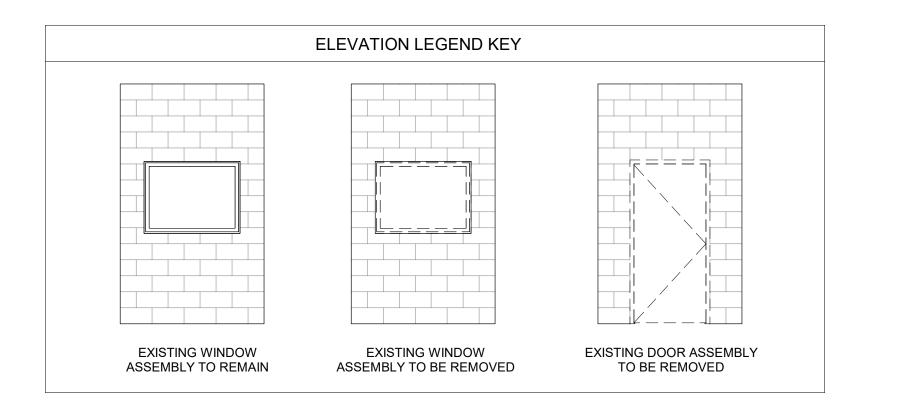

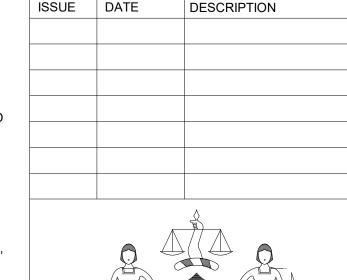



PROJECT COORDINATOR

Philadelphia Parks & Recreation and Department of Public Property 1515 Arch Street, 11th Floor Philadelphia, PA 19102

Contact: Sara Nordstrom, 215-683-0253

EAL

REVISIONS

ARCHITECT:

PROJECT TEAM

ARCHITEC

JOHNSON, MIRMIRAN & THOMPSON, INC 1600 MARKET ST, SUITE 520 PHILADELPHIA, PA 19103 267.256.0300

STRUCTURAL ENGINEER:

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SYSTEMS ENGINEER:

267.256.0300

267.256.0300

JOHNSON, MIRMIRAN & THOMPSON, INC 1600 MARKET ST, SUITE 520 PHILADELPHIA, PA 19103

CITY OF PHILADELPHIA

REBUILD PHILADELPHIA AND PHILADELPHIA PARKS & RECREATION

1515 ARCH STREET 11TH FLOOR, ONE PARKWAY BUILDING

PHILADELPHIA, PENNSYLVANIA

PROJECT TITLE
MILES MACK BUILDING RENOVATION

DRAWING TITLE

S

DEMOLITION ELEVATIONS

PROJECT NO. DRAWING NO.

10-20-XXXX-01

DATE: 02.07.2020 SCALE: AS NOTED

DRAWN BY:


WORK.

CHECKED BY: FILE:

NOTE: ALL DIMENSIONS AND CONDITIONS SHALL
BE VERIFIED BY THE CONTRACTOR AT
THE SITE BEFORE PROCEEDING WITH THE

A1.2



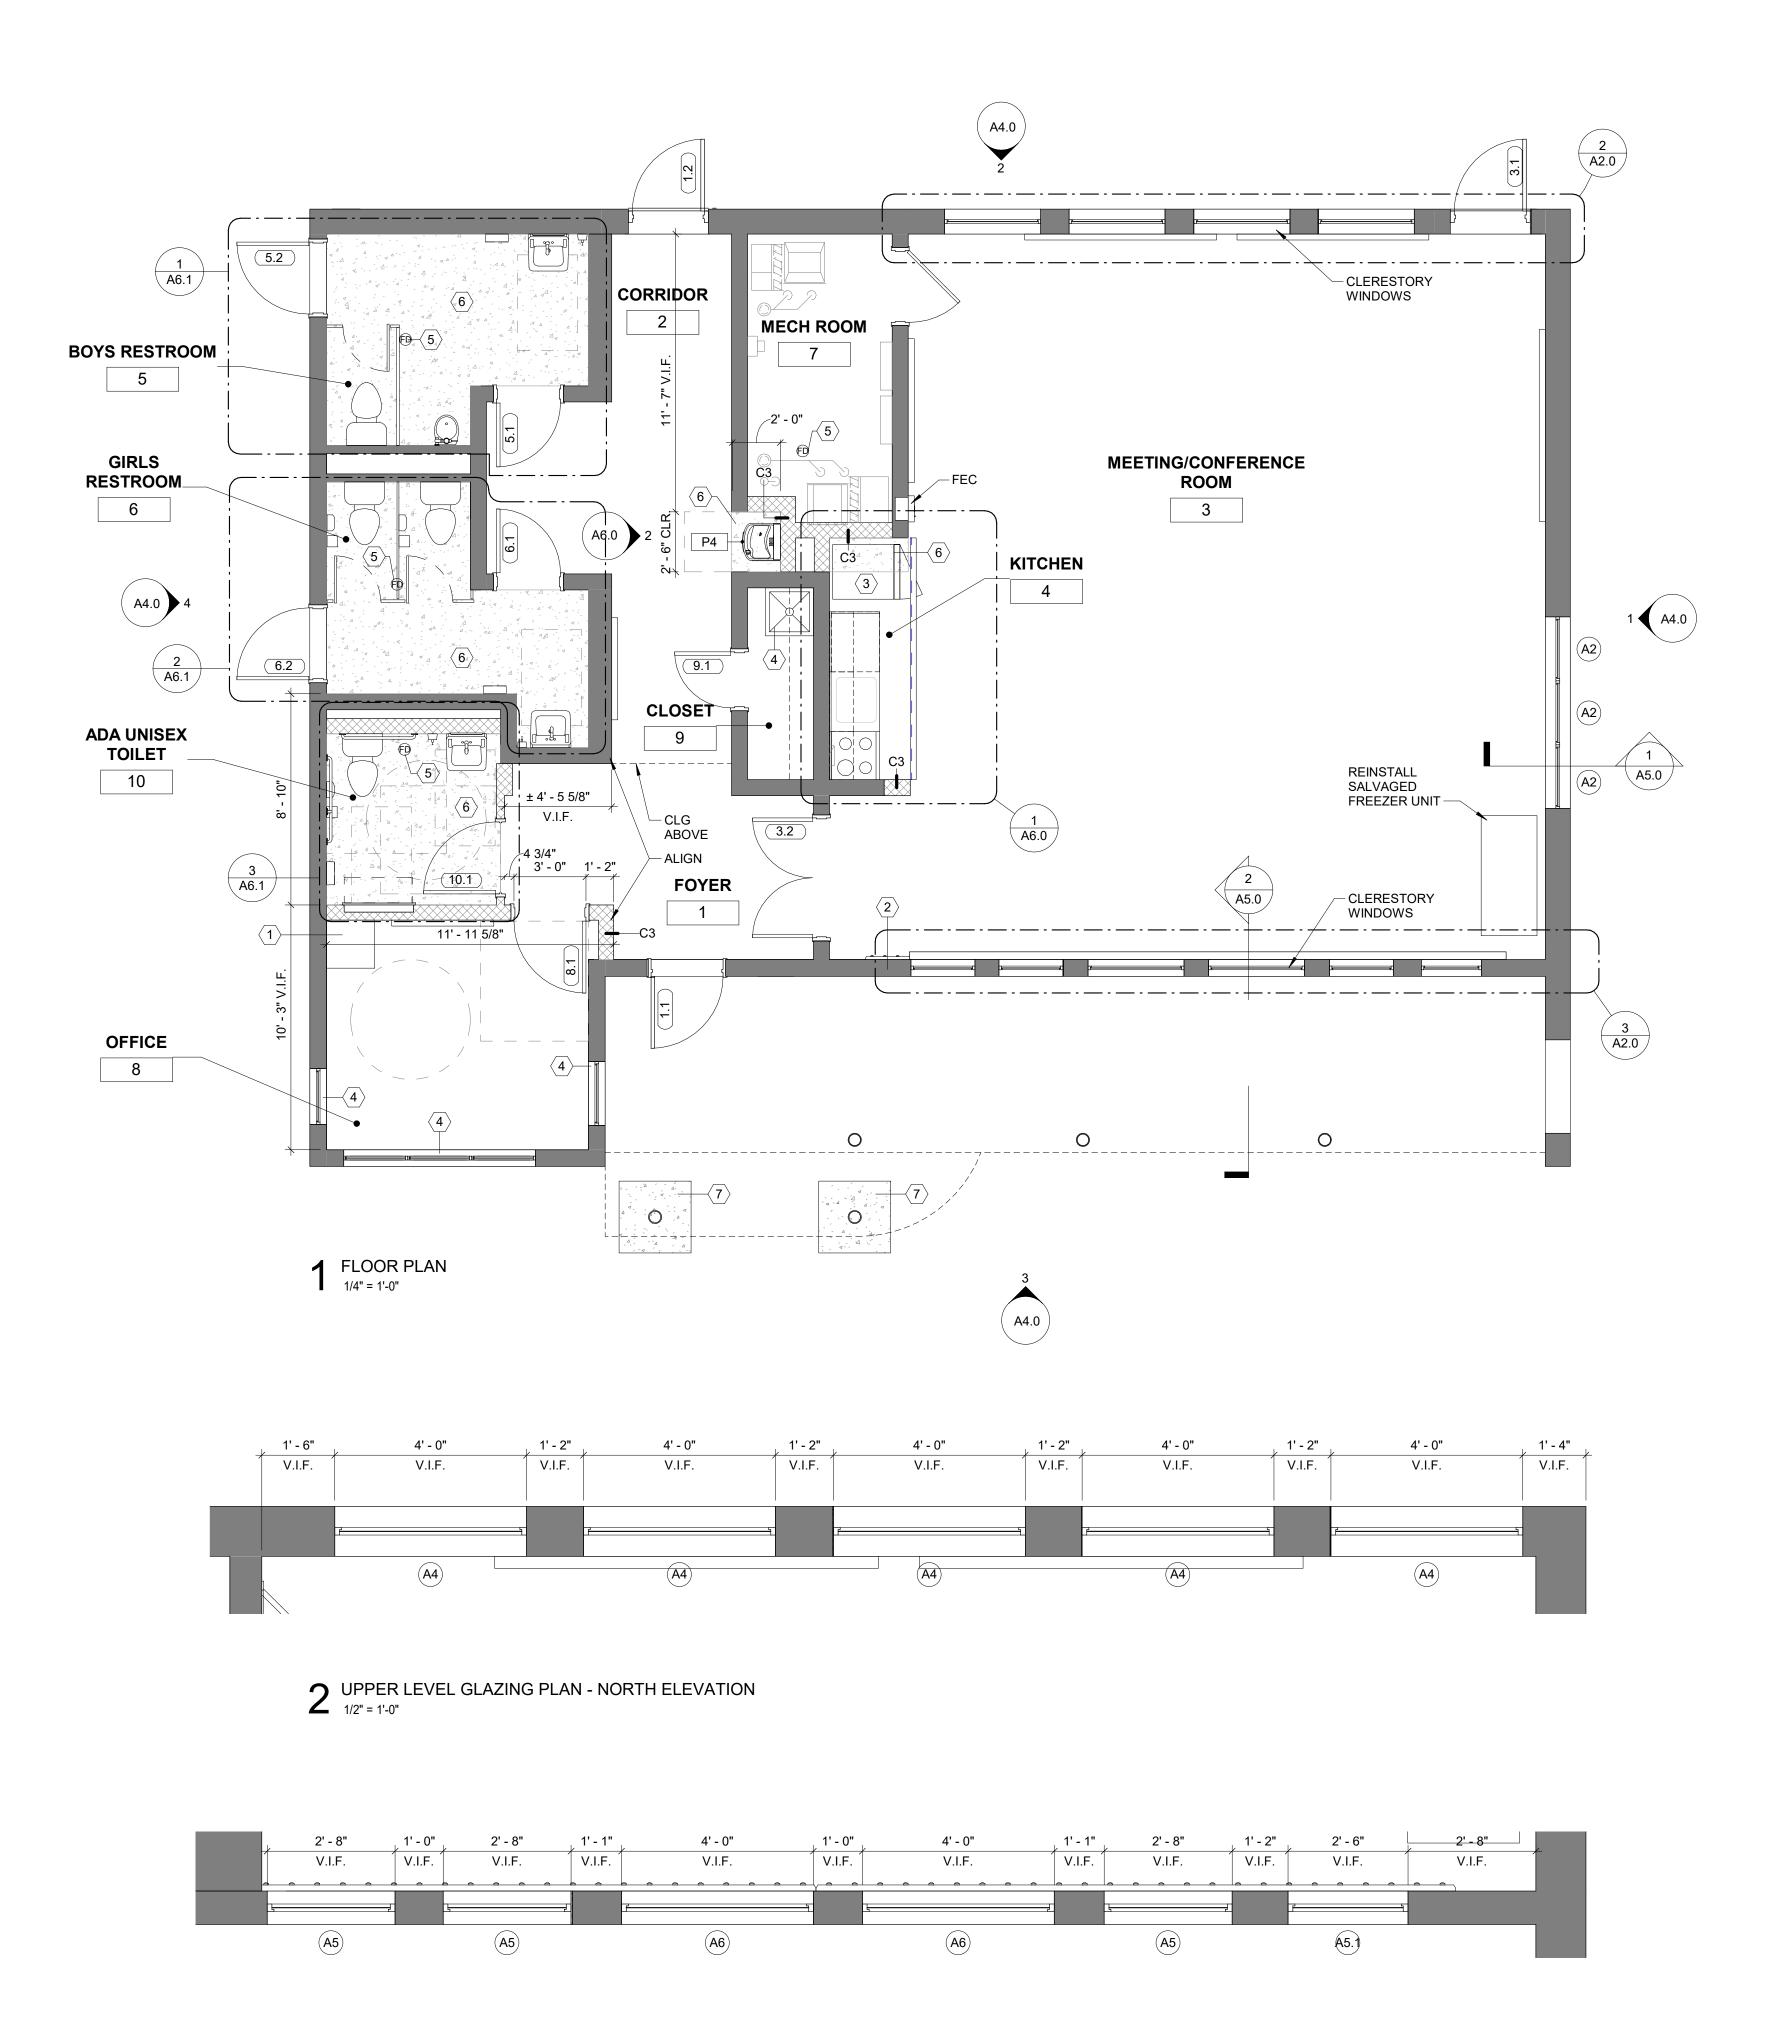

3 UPPER LEVEL GLAZING PLAN - SOUTH ELEVATION 1/2" = 1'-0"


### **GENERAL CONSTRUCTION NOTES**

- 1. CONTRACTOR SHALL FIELD VERIFY ALL DIMENSIONS BEFORE START OF WORK. NOTIFY ARCHITECT IN WRITING OF ALL DISCREPANCIES BEFORE
- 2. INTERIOR DIMENSIONS ARE TO FINISHED FACE OF WALL SURFACE.
- 3. ALL DOOR JAMBS AT HINGE SIDE TO BE SET 6" FROM ADJACENT WALL (MIN.) OR AS OTHERWISE NOTED.
- 4. ALL FLOORING TRANSITIONS SHALL OCCUR AT CENTERLINE OF CLOSED DOOR, TYPICAL UNO. REFERENCE FINISH SCHEDULE FOR FINISH SPECIFICATIONS.
- CONTRACTOR SHALL PROVIDE AND INSTALL WALL BLOCKING AS REQUIRED TO SUPPORT ALL WALL HUNG CABINETRY, WALL-HUNG FIXTURES, COUNTERTOPS, SHELVING, AND ACCESSORIES. CONTRACTOR TO COORDINATE CLEARANCES FOR ALL BACK TO BACK FIXTURES.
- CONFIRM ALL MEASUREMENTS. ALIGN FACE OF NEW CONSTRUCTION WITH FACE OF EXISTING CONSTRUCTION UNO.
- FLUSH LEVER ON TOILET TO BE LOCATED ON LAVATORY SIDE. REFER TO SHEET G0.2, FOR ALL PLUMBING FIXTURES AND ACCESSORIES MOUNTING HEIGHTS.
- 10. PROTECT ALL EXISTING ITEMS TO REMAIN DURING ALL PHASES OF DEMOLITION AND CONSTRUCTION.
- 11. SEE PLUMBING DRAWINGS FOR TOILET ROOM FIXTURE SCHEDULE. 12. REFER TO SHEET A7.0 FOR TOILET ROOM ACCESSORIES SCHEDULE.
- 13. PATCH AND REPAIR EXTERIOR MASONRY WALL SURFACES AND FINISH SURFACES WITH CEMENT PLASTER TO MATCH EXISTING.
- 14. PRIME ALL NEW AND PATCHED EXTERIOR WALL SURFACES TO RECEIVE FINISH COATS. FINISH COATS BY OTHERS, UNO. 15. FOR WINDOW AND DOOR TYPES SEE SHEET A7.0.
- 16. COORDINATE ALL OPENINGS IN CMU WALLS WITH MECHANICAL AND STRUCTURAL.

NEW CONCRETE SLAB ON GRADE. SEE STRUCTURAL DRAWINGS.

17. VERIFY STRUCTURAL JOIST DIMENSIONS.

	KEYNOTES
KEYNOTES	
1	RELOCATED SERVER EQUIPMENT BY OTHERS. COORDINATE ELECITRCAL WITH ELECTRICAL CONTRACTOR AND OWNER.
2	NEW COAT HANGER.
3	REINSTALL EXISTING REFRIGERATOR.
4	NEW ROLL DOWN PRIVACY SHADES.
5	NEW FLOOR DRAIN. SEE PLUMBING DRAWINGS.
6	NEW CONCRETE FLOOR SLAB OVER VAPOR BARRIER, THIS AREA. SEE STRUCTURAL DRAWINGS.

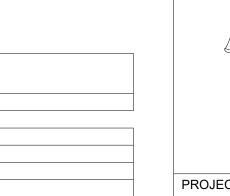

PROJECT COORDINATOR

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SEAL

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**SYSTEMS ENGINEER:** 


JOHNSON, MIRMIRAN & THOMPSON, INC 1600 MARKET ST, SUITE 520 PHILADELPHIA, PA 19103 267.256.0300

C3 7 5/8" -4" NOM CONCRETE - 8" NOM CONCRETE MASONRY UNIT MASONRY UNIT

PARTITION TYPES-INTERIOR-CMU 1 1/2" = 1'-0"

### **PARTITION TYPE NOTES**:

- SEE SPEC SECTION 04 FOR INFORMATION ON CONCRETE MASONRY UNIT ASSEMBLIES
- ALL PARTITIONS MUST FIT TIGHT TO STRUCTURAL SLAB, DECK, OR PLANK, U.O.N.
- GWB IS 5/8", U.O.N.

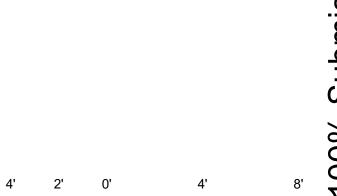

CITY OF PHILADELPHIA REBUILD PHILADELPHIA AND PHILADELPHIA PARKS & RECREATION 1515 ARCH STREET 11TH FLOOR, ONE PARKWAY BUILDING PHILADELPHÍA, PENNSYLVANIA

PROJECT TITLE MILES MACK BUILDING RENOVATION 7


DRAWING TITLE

FLOOR PLAN AND WALL TYPES

PROJECT NO. DRAWING NO. 10-20-XXXX-01 DATE: 02.07.2020


SCALE: AS NOTED DRAWN BY:

CHECKED BY: NOTE: ALL DIMENSIONS AND CONDITIONS SHALL BE VERIFIED BY THE CONTRACTOR AT THE SITE BEFORE PROCEEDING WITH THE WORK.

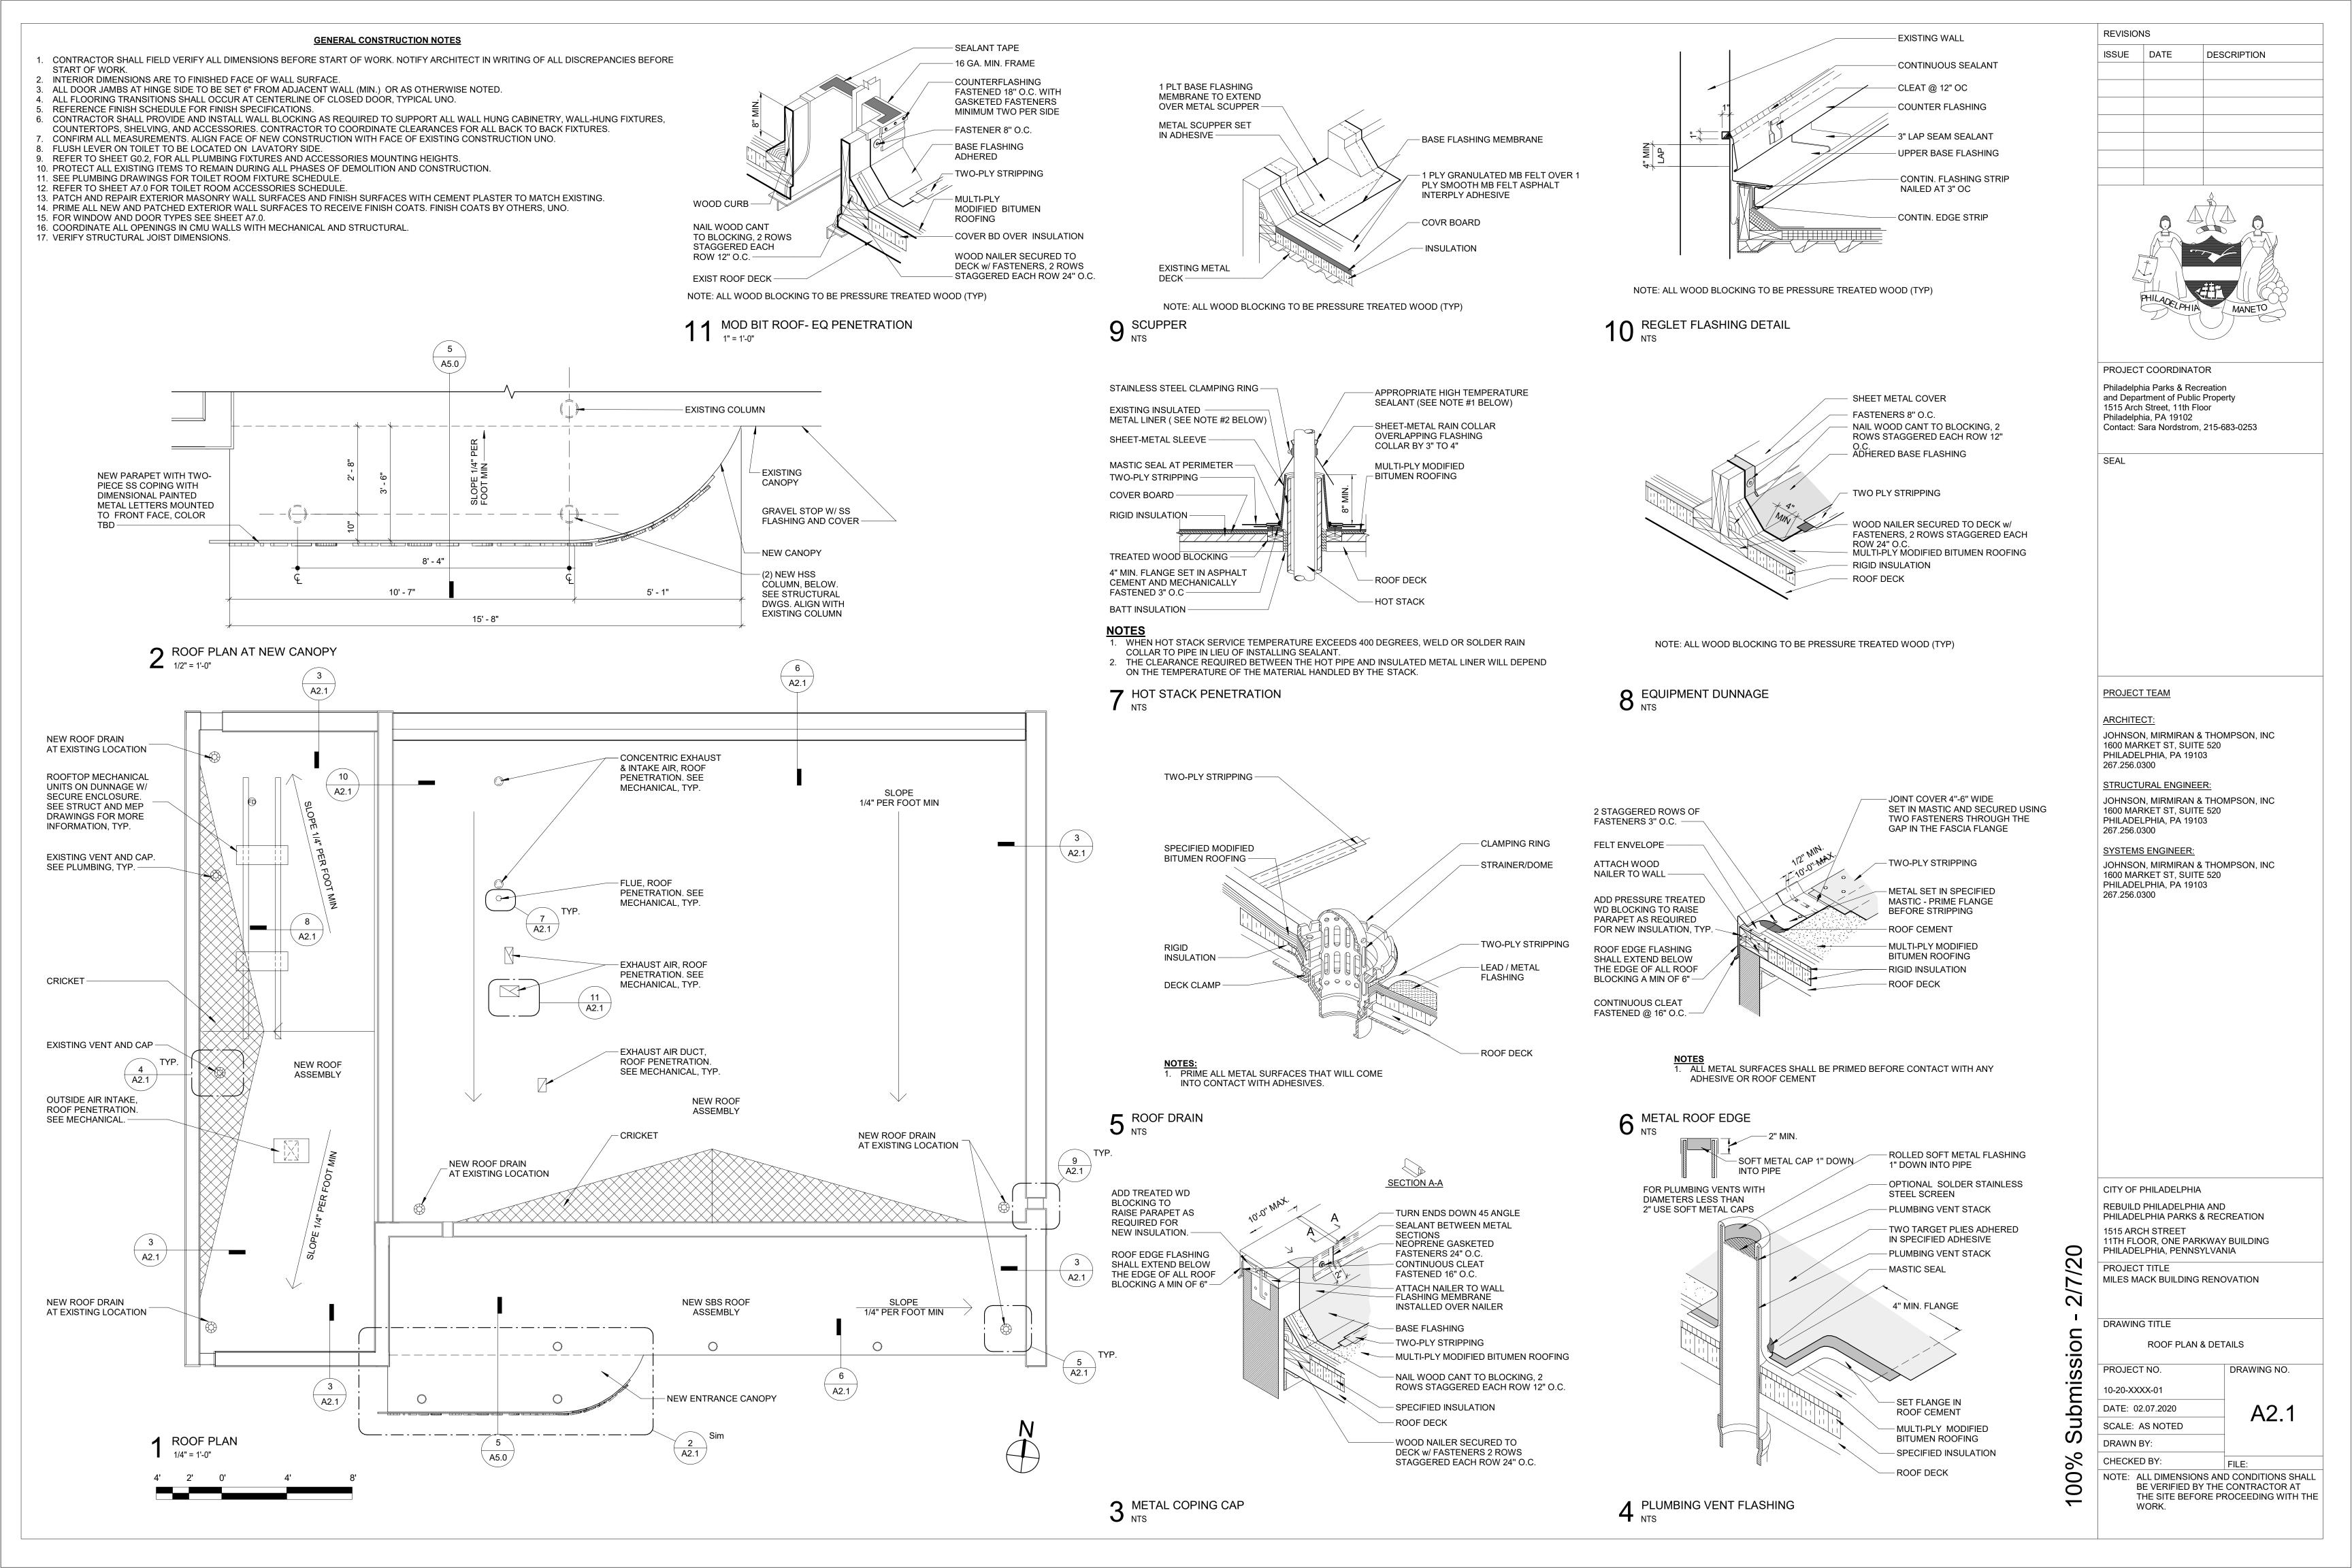

# 12 GA. HANGER WIRE AT MAX. 36" SPACING (2) #12 GAUGE HANGER WIRES AT 45° WHERE VERTICAL IS NOT POSSIBLE - MAIN TEES @ 36" O.C. - CROSS TEE @ 16" O.C. - 3/8" PLYWOOD - 1/2" GWB - MAIN TEE SPLICE

# 2 GWB TYPICAL CEILING SUSPENSION DETAIL N.T.S.

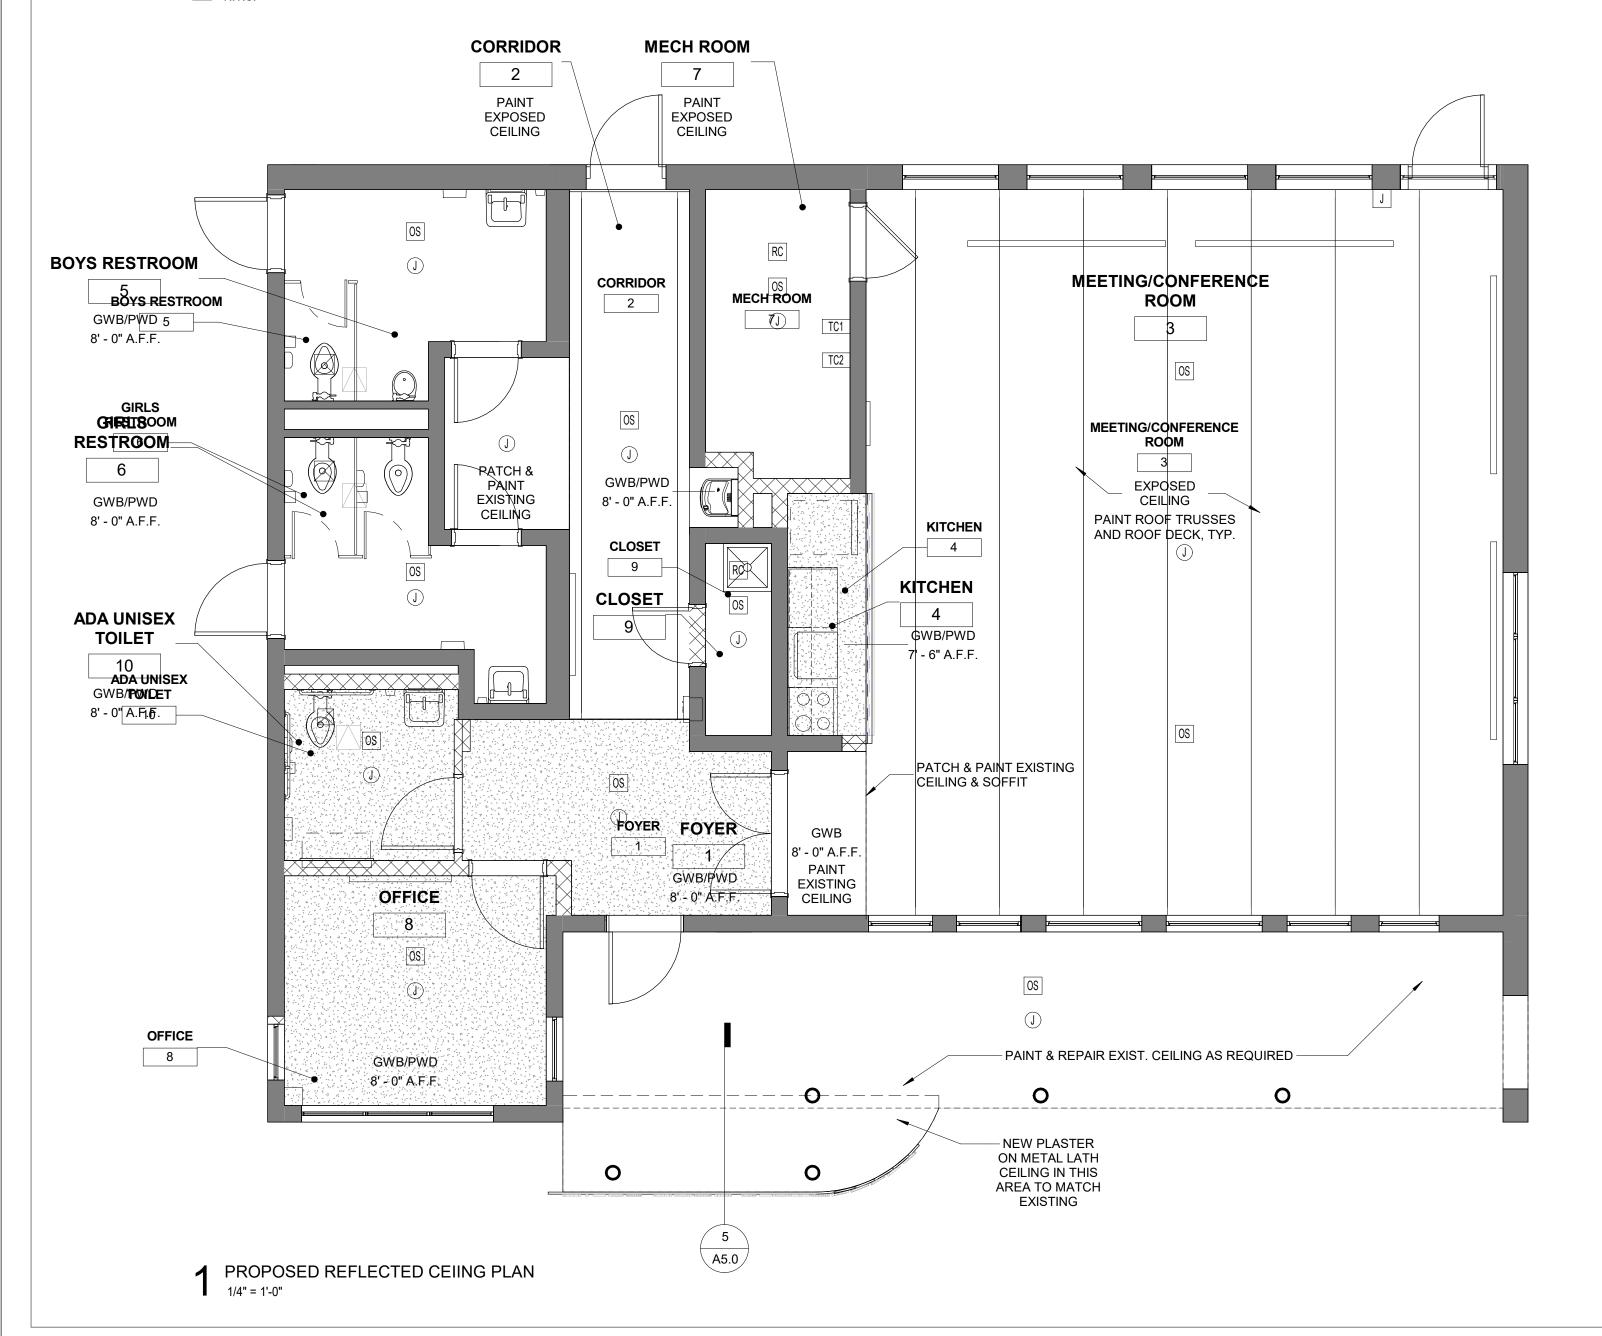



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- 5. REFERENCE FINISH SCHEDULE FOR FINISH SPECIFICATIONS.
- 6. CONTRACTOR SHALL PROVIDE AND INSTALL WALL BLOCKING AS REQUIRED TO SUPPORT ALL WALL HUNG CABINETRY, WALL-HUNG FIXTURES, COUNTERTOPS, SHELVING, AND ACCESSORIES. CONTRACTOR TO COORDINATE CLEARANCES FOR ALL BACK TO BACK FIXTURES.
- 7. CONFIRM ALL MEASUREMENTS. ALIGN FACE OF NEW CONSTRUCTION WITH FACE OF EXISTING CONSTRUCTION UNO. 8. FLUSH LEVER ON TOILET TO BE LOCATED ON LAVATORY SIDE.
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- 10. PROTECT ALL EXISTING ITEMS TO REMAIN DURING ALL PHASES OF DEMOLITION AND CONSTRUCTION.
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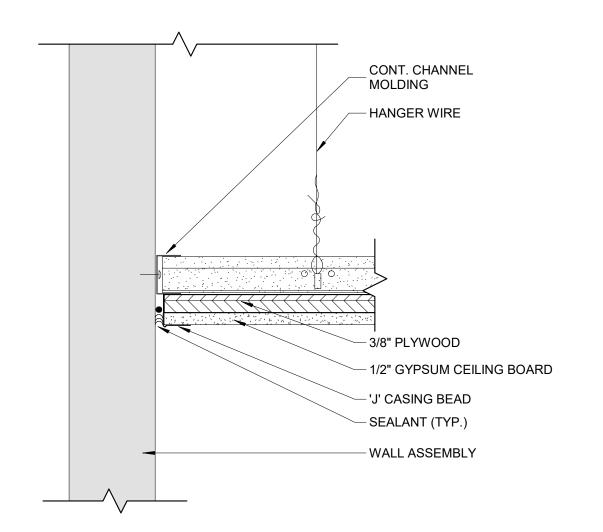
### **RCP SHEET NOTES**

- 1. SEE ELECTRICAL/POWER DRAWINGS FOR ADDITIONAL INFORMATION.
- 2. SEE MECHANICAL DRAWINGS FOR CEILING SUPPLY, DIFFUSERS, CABINET HEATER UNITS, AND LOCATIONS OF ACCESS PANELS REQUIRED FOR
- MECHANICAL EQUIPMENT. 3. PROVIDE BLOCKING AND UNISTRUT FRAMING AS REQUIRED ABOVE SUSPENDED CEILING FOR LIGHT FIXTURE AND MECHANICAL SUPPORTS.
- 4. CEILING HEIGHTS ARE MEASURED FROM FINISH FLOOR TO UNDERSIDE OF CEILING. 5. COORDINATE ALL DUCTS, PIPING, LIGHTS ETC. IN ORDER TO MAINTAIN LOCATION OF ALL CEILING HEIGHTS AS INDICATED. ANY DEVICATION FROM THE
- DRAWINGS MUST BE NOTED TO THE ARCHITECT IN WRITING AND APPROVED PRIOR TO INSTALL ATION, NO EXCEPTIONS. 6. ALL EXISTING SPACES WITH NEW REPLACEMENT CEILINGS, G.C. IS TO MATCH EXISTING CEILING HEIGHTS.
- 7. PAINT UNDERSIDE OF EXPOSED ROOF DECK AND ROOF TRUSSES.
- 8. PATCH ALL CEILING OPENED OR DAMAGED AS PART OF CONSTRUCTION WORK. 9. PAINT ALL AREAS OF EXPOSED CEILING INCLUDING ROOF STRUSSES AND SUPPORTS.
- 10. REINSTALL EXISTING LIGHTING. COORDINATE DESIGN AND LAYOUT WITH OWNER.



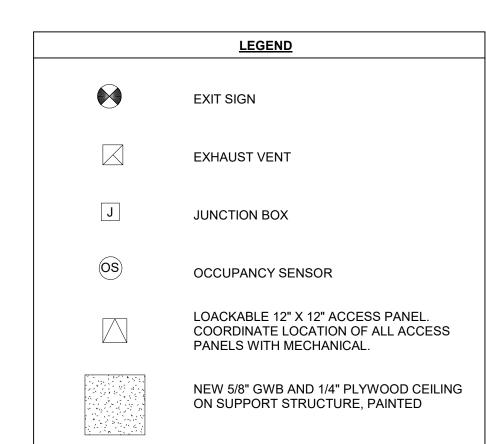

TYPICAL GYPSUM CEILING ASSEMBLY DETAIL
3" = 1'-0"

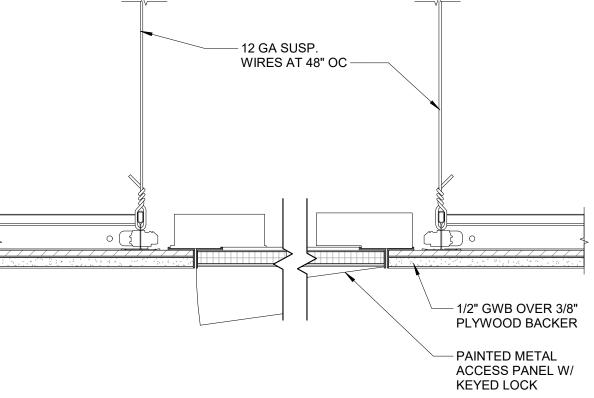


3" = 1'-0"



ΉE	PROJECT Philadelphi and Depar 1515 Arch Philadelphi	COORDINATO a Parks & Recr tment of Public Street, 11th Flo a, PA 19102 ara Nordstrom,	eation Property or	
	PROJECT  ARCHITEC  JOHNSON 1600 MAR PHILADEL 267.256.03  STRUCTU  JOHNSON 1600 MAR PHILADEL 267.256.03  SYSTEMS JOHNSON 1600 MAR	CT:  I, MIRMIRAN & KET ST, SUITE PHIA, PA 1910 B00  RAL ENGINEE I, MIRMIRAN & KET ST, SUITE PHIA, PA 1910 B00  ENGINEER: I, MIRMIRAN & KET ST, SUITE PHIA, PA 1910 BOO  ENGINEER: I, MIRMIRAN & KET ST, SUITE PHIA, PA 1910	R: THOMPSON, INC 520 3 THOMPSON, INC 520	
100% Submission - 2/7/20	REBUILD PHILADEL 1515 ARCI 11TH FLO PHILADEL PROJECT MILES MA  DRAWING RI PROJECT 10-20-XXX DATE: 02 SCALE: A DRAWN B CHECKED NOTE: AI BI TH	H STREET OR, ONE PARP PHIA, PENNSY  TITLE CK BUILDING I  TITLE FLECTED CE NO. X-01 07.2020 S NOTED Y: BY: L DIMENSION E VERIFIED BY	RECREATION  (WAY BUILDING /LVANIA  RENOVATION	S SHALL

REVISIONS

DESCRIPTION

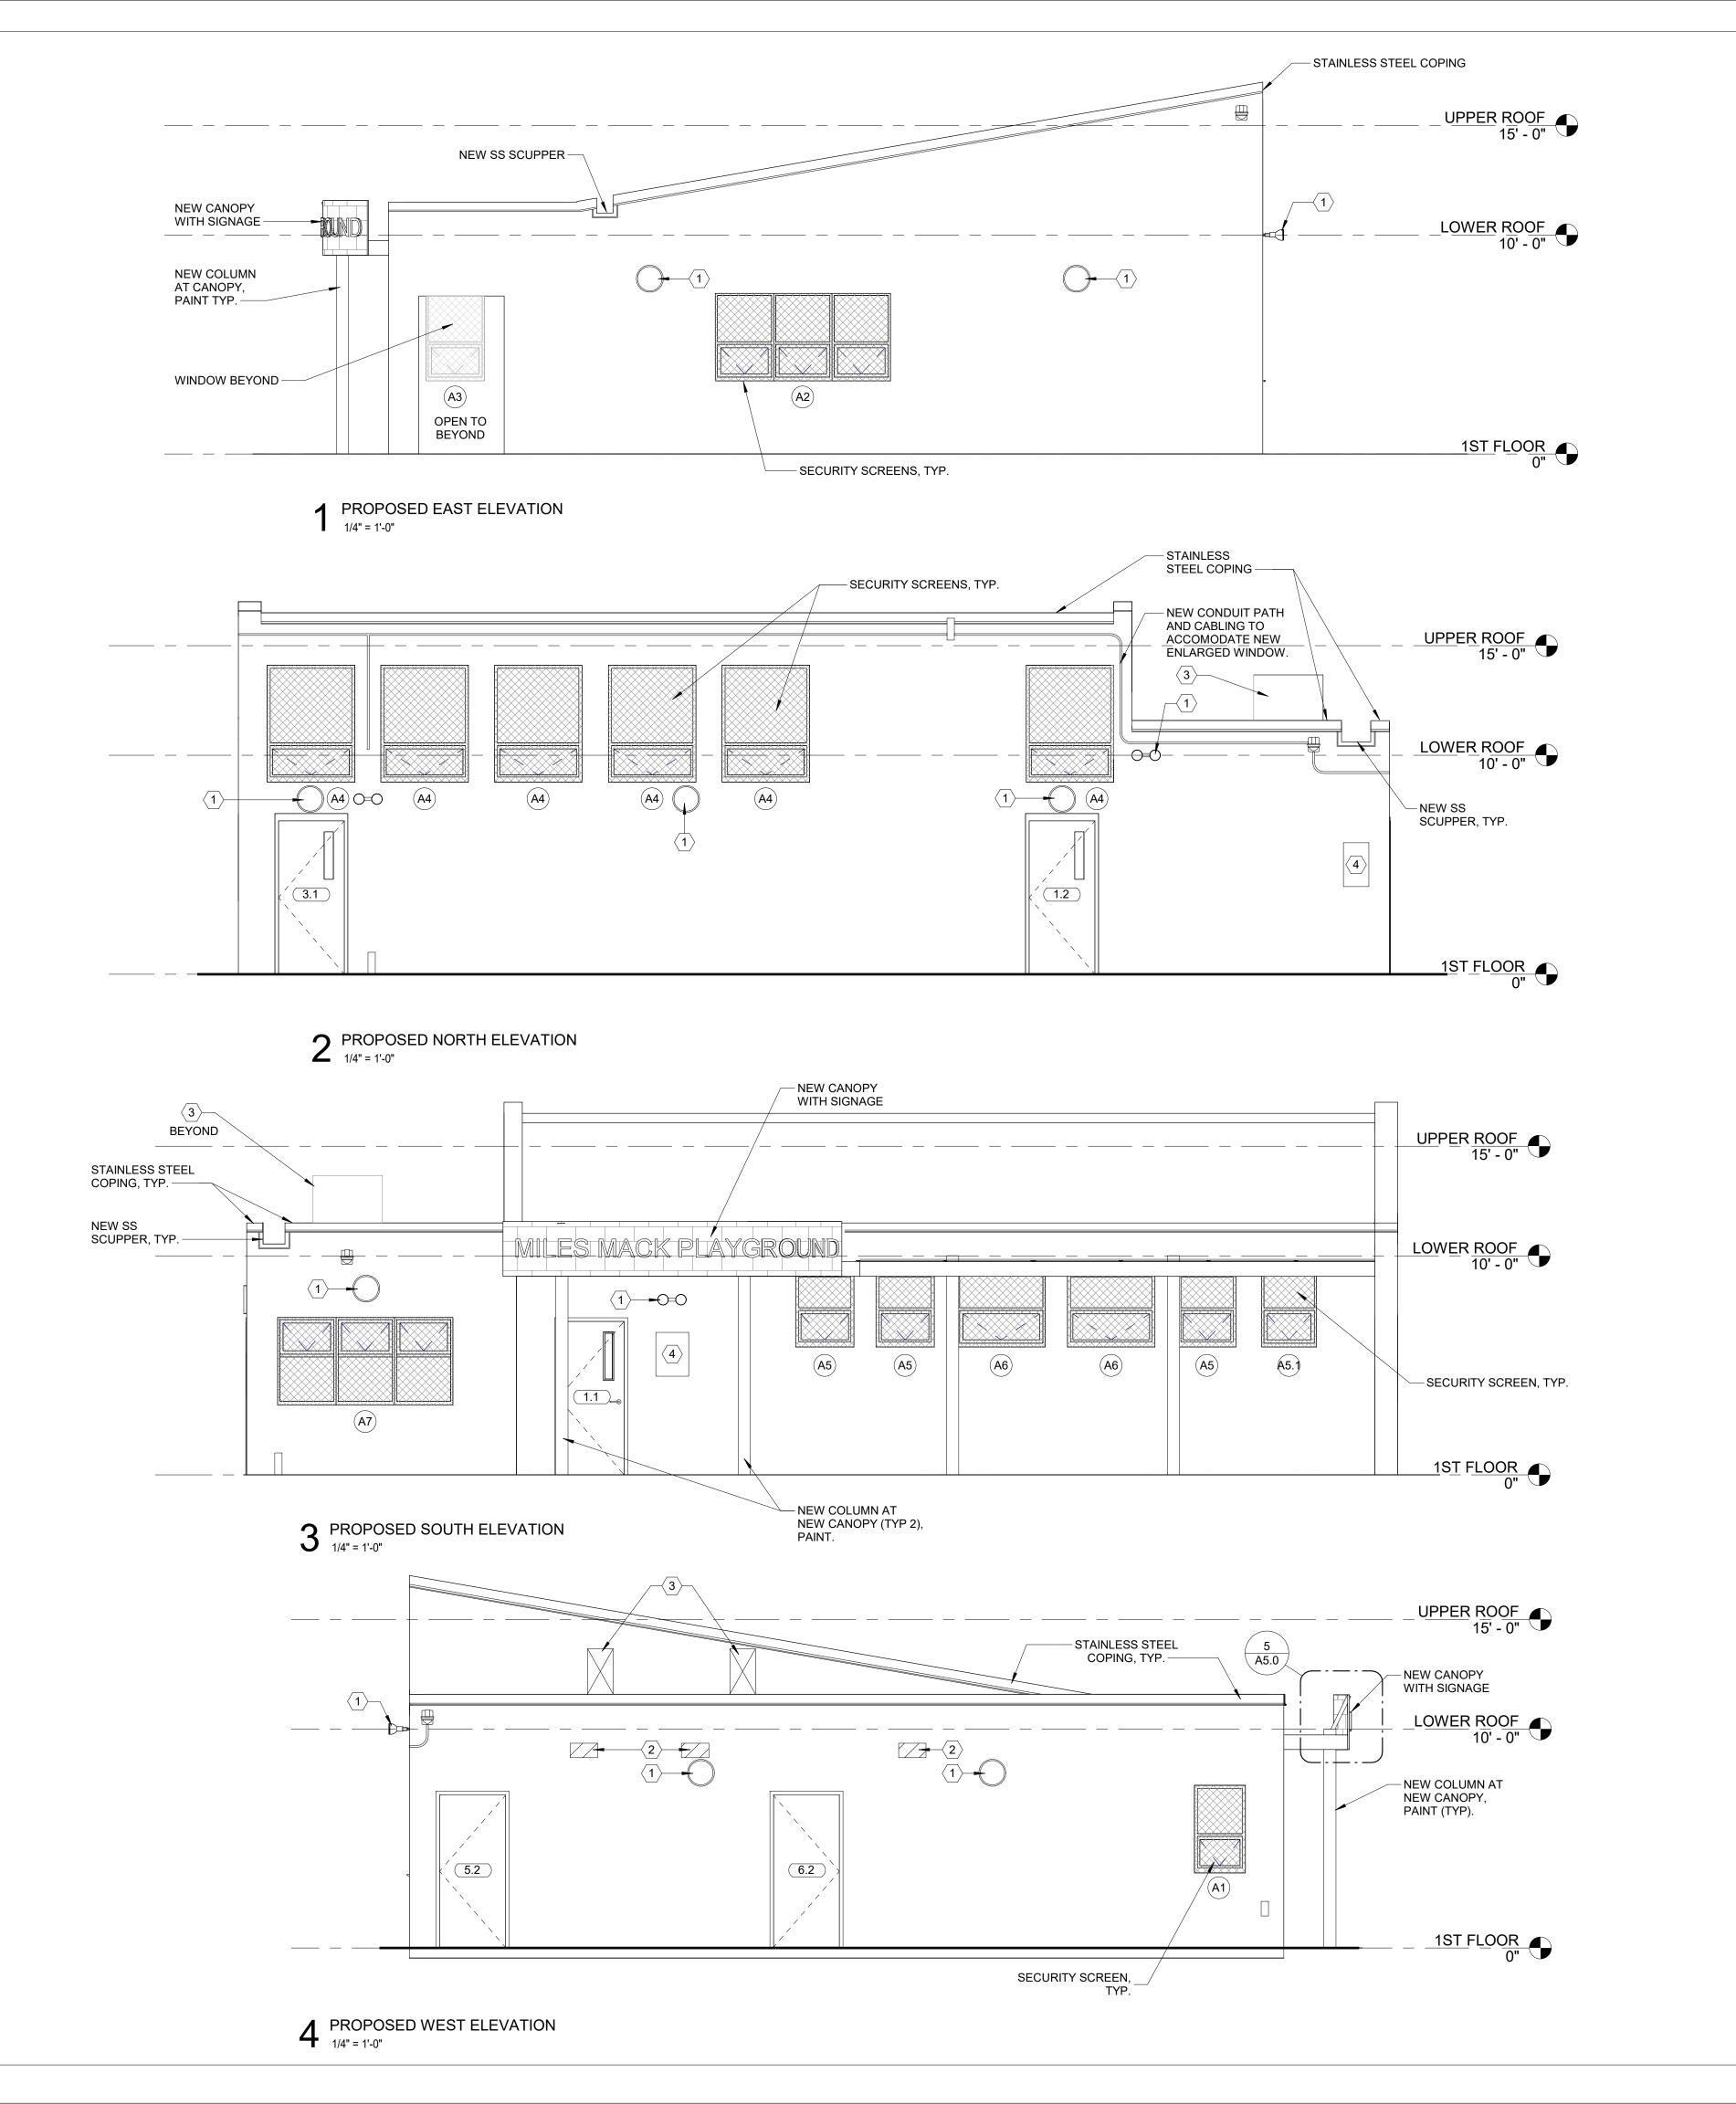

### **GENERAL CONSTRUCTION NOTES**

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- 4. ALL FLOORING TRANSITIONS SHALL OCCUR AT CENTERLINE OF CLOSED DOOR, TYPICAL UNO. 5. REFERENCE FINISH SCHEDULE FOR FINISH SPECIFICATIONS.
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- 15. FOR WINDOW AND DOOR TYPES SEE SHEET A7.0. 16. COORDINATE ALL OPENINGS IN CMU WALLS WITH MECHANICAL AND STRUCTURAL.
- 17. VERIFY STRUCTURAL JOIST DIMENSIONS. EXTERIOR ELEVATIONS GENERAL NOTES
- 1. PAINT COLUMNS, TYP. AT ALL EXISTING COLUMNS U.N.O

EXISTING SIGNAGE TO REMAIN.

2. ALL NEW STEEL LINTELS TO BE HOT DIP GALVANIZED, PRIMED AND PREPARED TO RECEIVE NEW PAINT IN FIELD BY OTHERS.

	ELEVATION KEYNOTES
Note	
1	REINSTALL SALVAGED LIGHT FIXTURES, SEE ELECTRICAL DRAWINGS. COORDINATE DESIGN AND LAYOUT WITH OWNER.
2	INFILL ABANDONED VENT OPENINGS, TO MATCH EXISTING ADJACENT. COORDINATE W/ MECH.
3	MECHANICAL EQUIPMENT WITH SECURITY ENCLOSURE ON NEW DUNNAGE, SEE MECHANICAL DWGS.

DESCRIPTION



PROJECT COORDINATOR

Philadelphia Parks & Recreation and Department of Public Property 1515 Arch Street, 11th Floor Philadelphia, PA 19102 Contact: Sara Nordstrom, 215-683-0253

SEAL

REVISIONS

PROJECT TEAM

JOHNSON, MIRMIRAN & THOMPSON, INC 1600 MARKET ST, SUITE 520 PHILADELPHIA, PA 19103 267.256.0300

STRUCTURAL ENGINEER:

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**SYSTEMS ENGINEER:** 

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CITY OF PHILADELPHIA

REBUILD PHILADELPHIA AND

PHILADELPHIA PARKS & RECREATION

1515 ARCH STREET 11TH FLOOR, ONE PARKWAY BUILDING

PHILADELPHÍA, PENNSYLVANIA

PROJECT TITLE MILES MACK BUILDING RENOVATION

DRAWING TITLE

2

EXTERIOR ELEVATIONS

PROJECT NO. DRAWING NO.

10-20-XXXX-01 DATE: 02.07.2020

A4.0 SCALE: AS NOTED


DRAWN BY: CHECKED BY:

NOTE: ALL DIMENSIONS AND CONDITIONS SHALL BE VERIFIED BY THE CONTRACTOR AT THE SITE BEFORE PROCEEDING WITH THE WORK.





NORTH ELEVATION
1/4" = 1'-0"

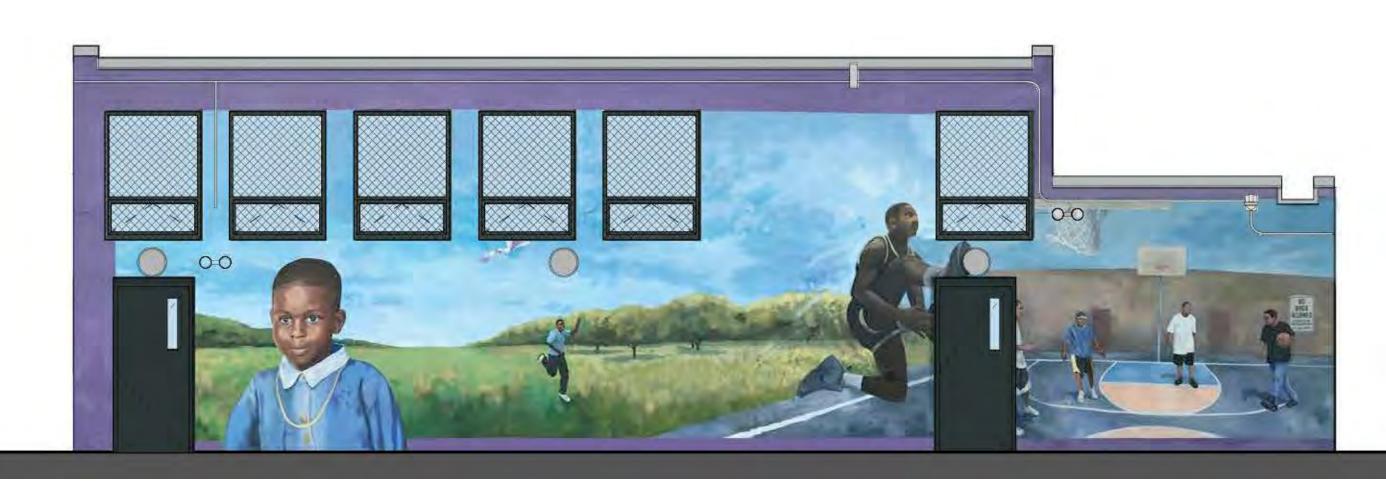

2 NORTH ELEVATION 1/4" = 1'-0"



3 SOUTH ELEVATION 1/4" = 1'-0"



**4** WEST ELEVATION 1/4" = 1'-0"


### **GENERAL SHEET NOTES:**

- 1. THESE ELEVATIONS ARE INCLUDED TO ILLUSTRATE EXISTING MURAL TO BE PAINTED/REPAINTED BY
- CONTRACTOR IS TO PROTECT MURAL FROM DAMAGE DURING CONSTRUCTION.
   ALL NEW, REPAIRED, AND PATCHES AREAS ARE TO BE PRIMED AND READY FOR FINISH PAINTING.
   FINISH PAINTING OF EXTERIOR SURFACES ARE BY OTHERS WITH THE EXCEPTION OF COLUMNS, DOORS, FRAMES, CONCRETE FLOOR SLAB AT ENTRY CANOPY, UNDERSIDE OF ENTRY CANOPY,

AREAS OF NEW CONSTRUCTION, STEEL LINTELS, AND OTHER AREAS AS NOTED.

	<u></u>

DESCRIPTION

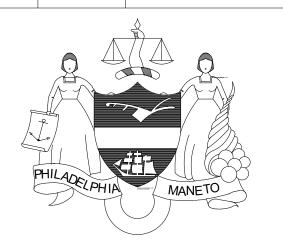

PROJECT COORDINATOR

Philadelphia Parks & Recreation and Department of Public Property 1515 Arch Street, 11th Floor Philadelphia, PA 19102 Contact: Sara Nordstrom, 215-683-0253

SEAL

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ARCHITECT:

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CITY OF PHILADELPHIA

REBUILD PHILADELPHIA AND PHILADELPHIA PARKS & RECREATION

1515 ARCH STREET 11TH FLOOR, ONE PARKWAY BUILDING PHILADELPHIA, PENNSYLVANIA

PROJECT TITLE MILES MACK BUILDING RENOVATION

7

DRAWING TITLE ILLUSTRATIVE EXTERIOR ELEVATIONS

PROJECT NO. DRAWING NO.

10-20-XXXX-01


DATE: 02.07.2020


SCALE: AS NOTED


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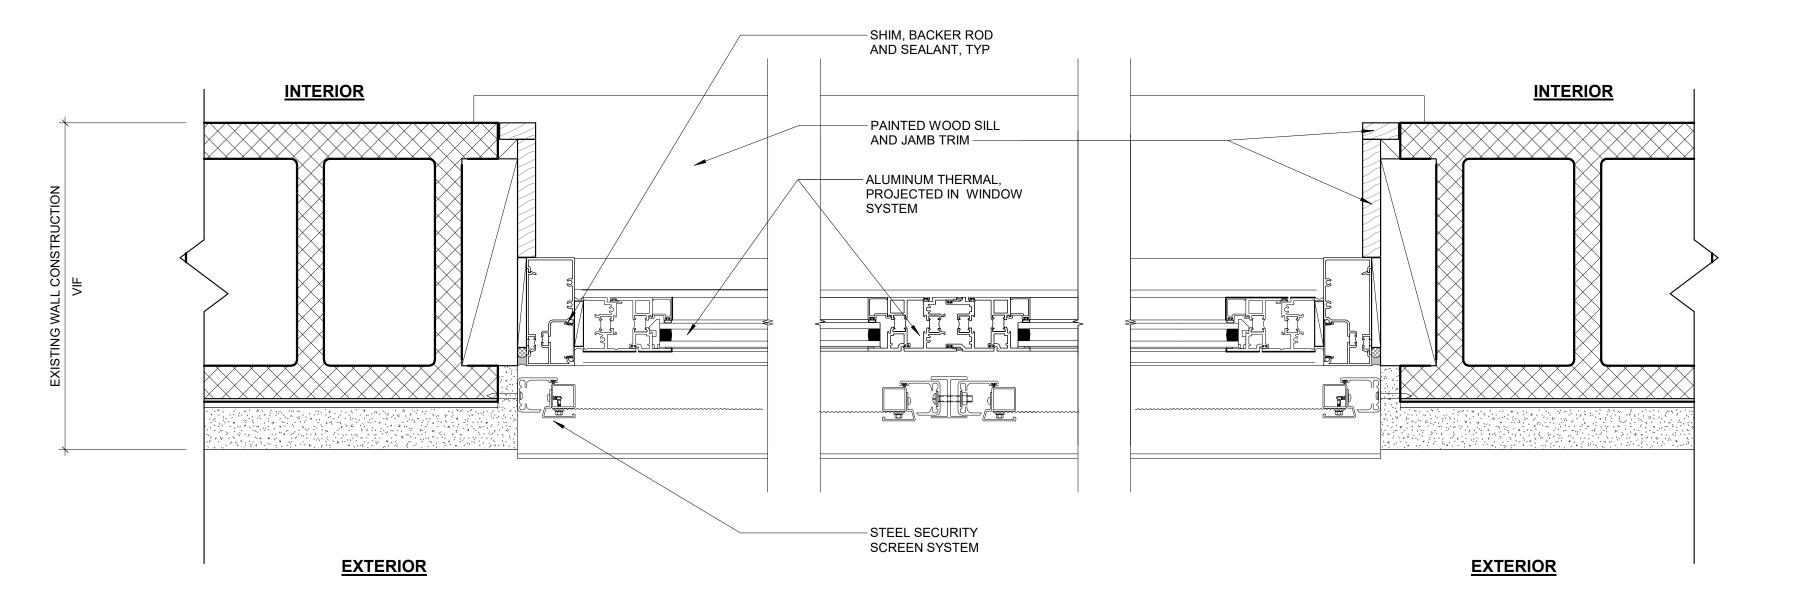
NOTE: ALL DIMENSIONS AND CONDITIONS SHALL
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3 WINDOW DETAIL PLAN - FIXED 3" = 1'-0"



2 WINDOW DETAIL PLAN - OPERABLE 3" = 1'-0"

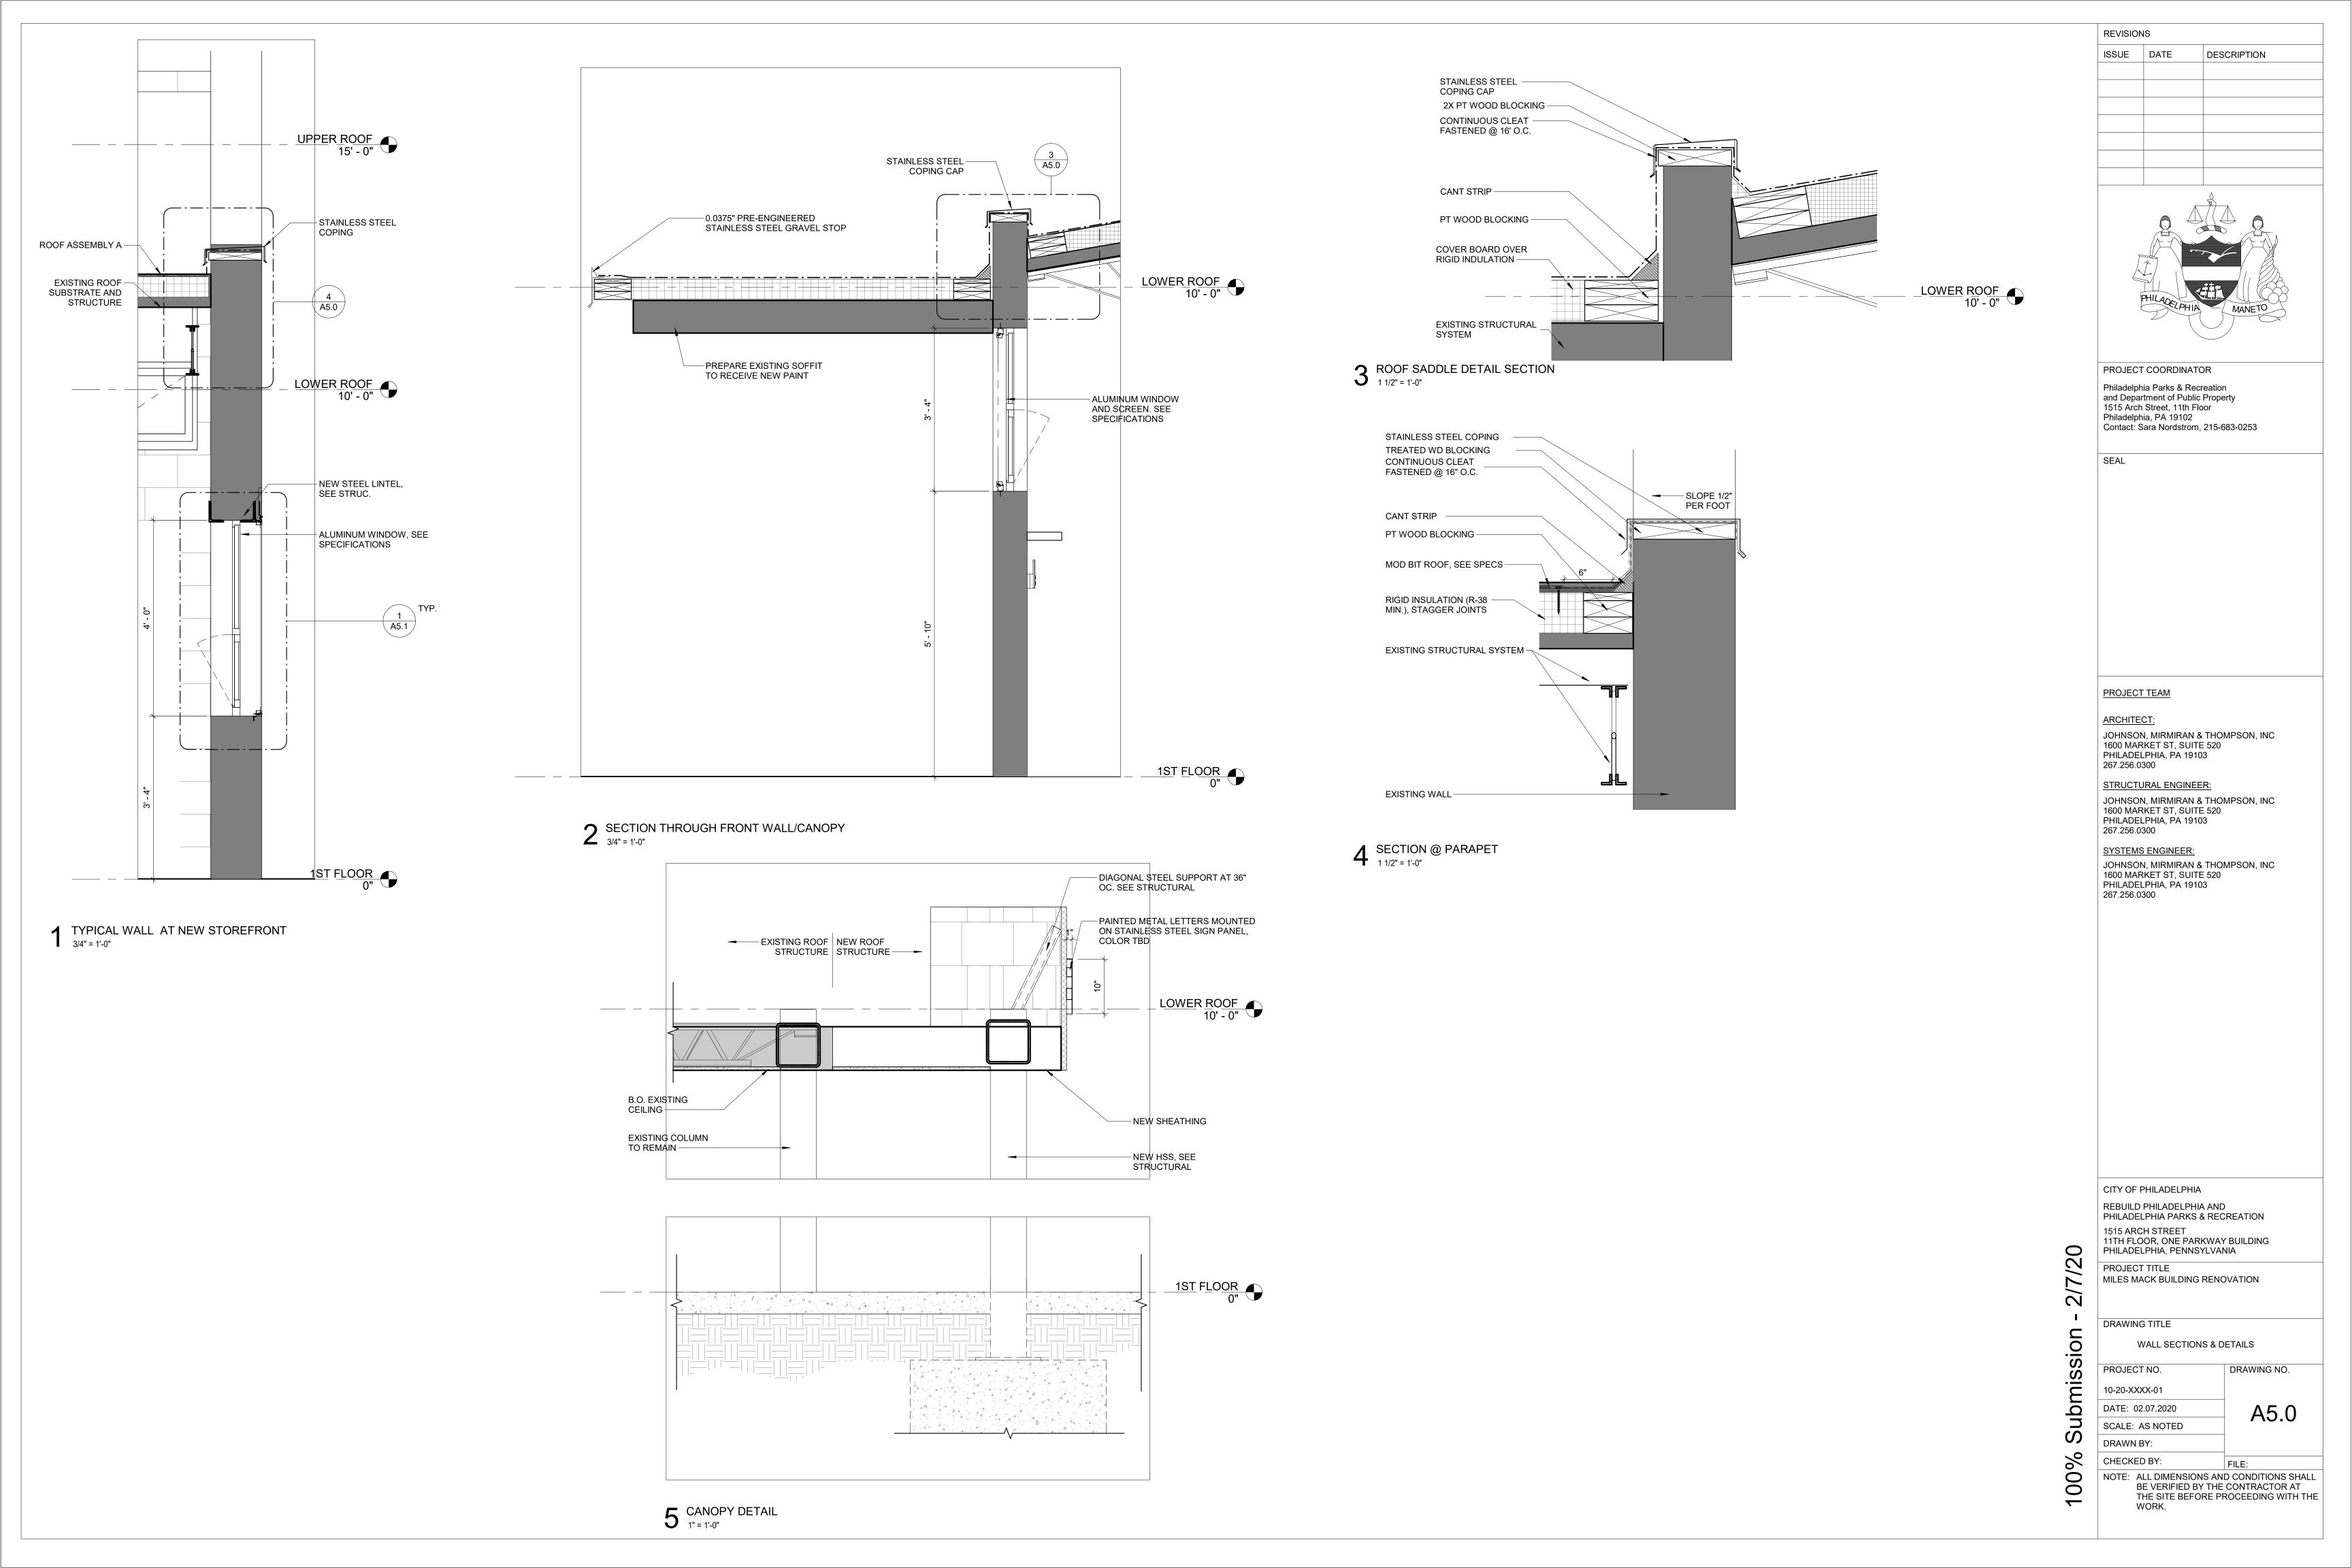7 %00

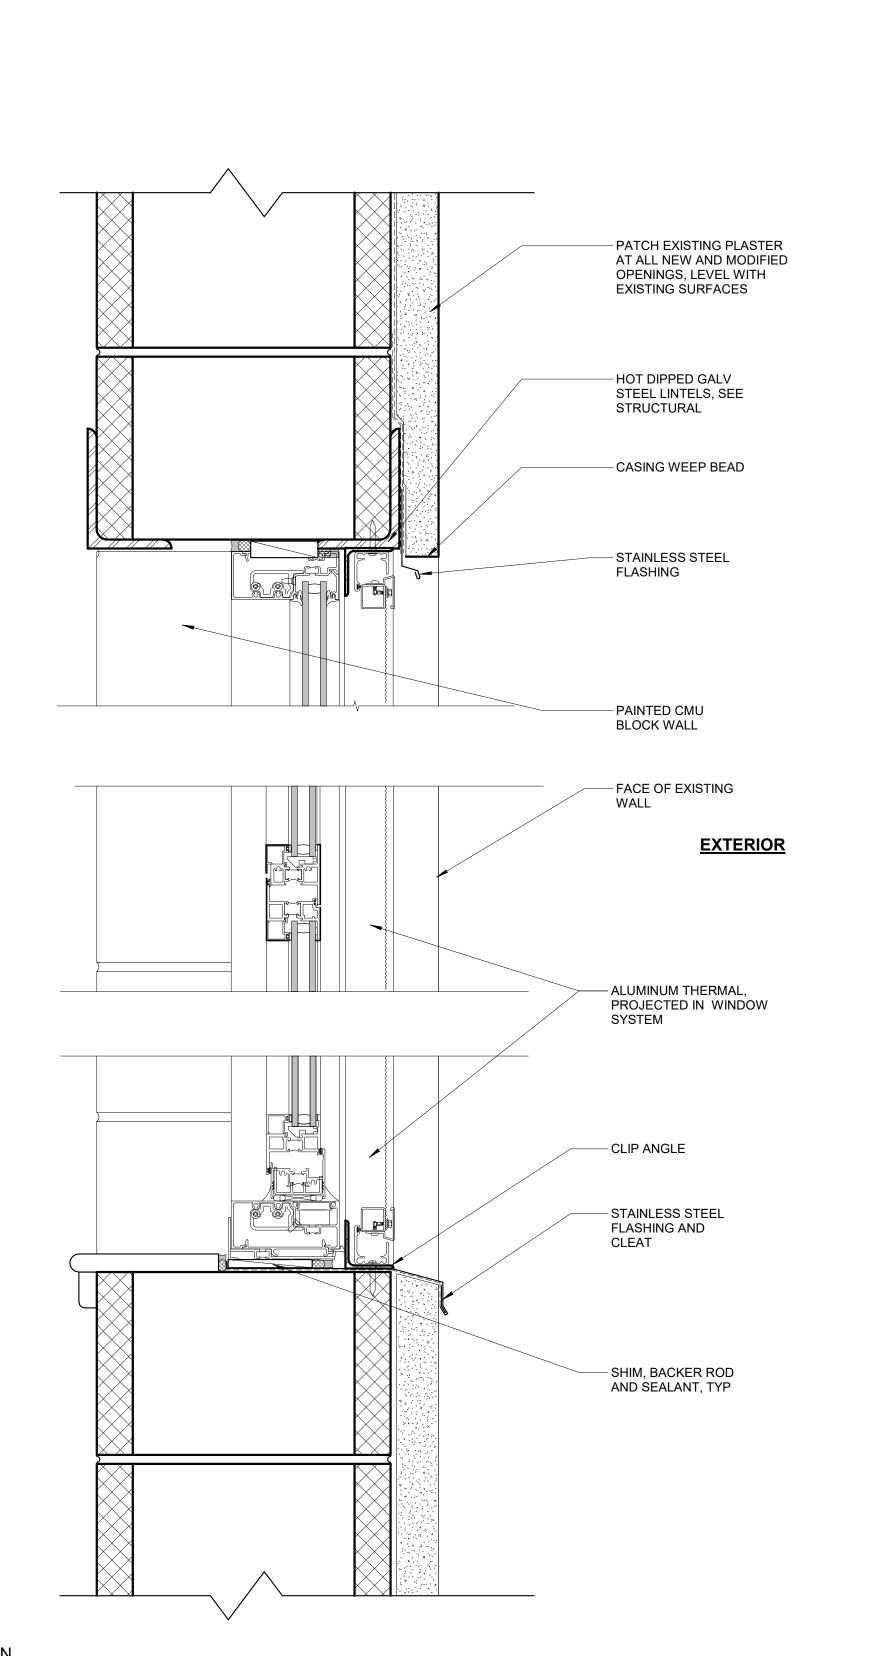CITY OF PHILADELPHIA REBUILD PHILADELPHIA AND PHILADELPHIA PARKS & RECREATION 1515 ARCH STREET 11TH FLOOR, ONE PARKWAY BUILDING PHILADELPHIA, PENNSYLVANIA PROJECT TITLE MILES MACK BUILDING RENOVATION DRAWING TITLE

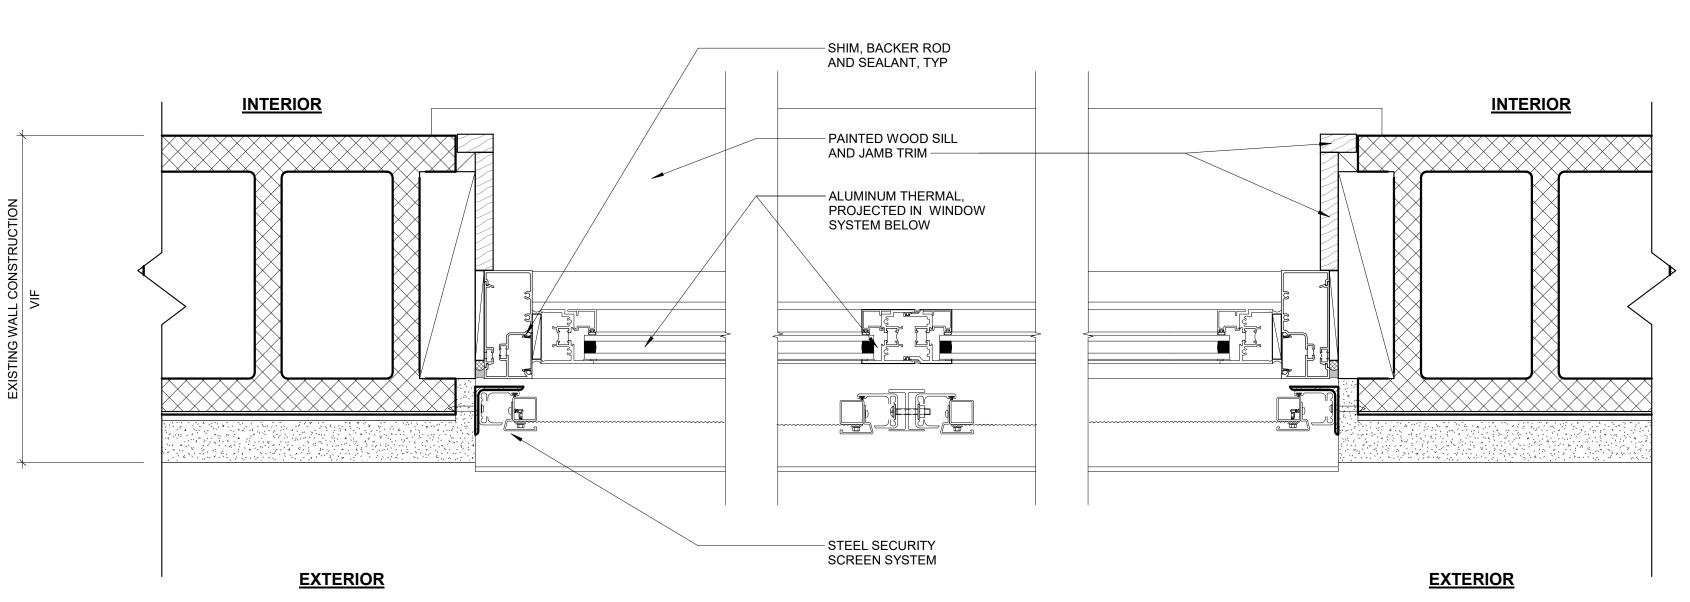REVISIONS

PROJECT COORDINATOR

Philadelphia, PA 19102

SEAL

PROJECT TEAM

267.256.0300

267.256.0300

PHILADELPHIA, PA 19103

STRUCTURAL ENGINEER:

SYSTEMS ENGINEER:

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JOHNSON, MIRMIRAN & THOMPSON, INC 1600 MARKET ST, SUITE 520 PHILADELPHIA, PA 19103 267.256.0300

Philadelphia Parks & Recreation and Department of Public Property 1515 Arch Street, 11th Floor

Contact: Sara Nordstrom, 215-683-0253

DESCRIPTION

MISCELANEOUS DETAILS

PROJECT NO. DRAWING NO. 10-20-XXXX-01

DATE: 02.07.2020 SCALE: AS NOTED


DRAWN BY:

WORK.

CHECKED BY: Checker FILE: NOTE: ALL DIMENSIONS AND CONDITIONS SHALL
BE VERIFIED BY THE CONTRACTOR AT
THE SITE BEFORE PROCEEDING WITH THE

A5.1

<u>INTERIOR</u>

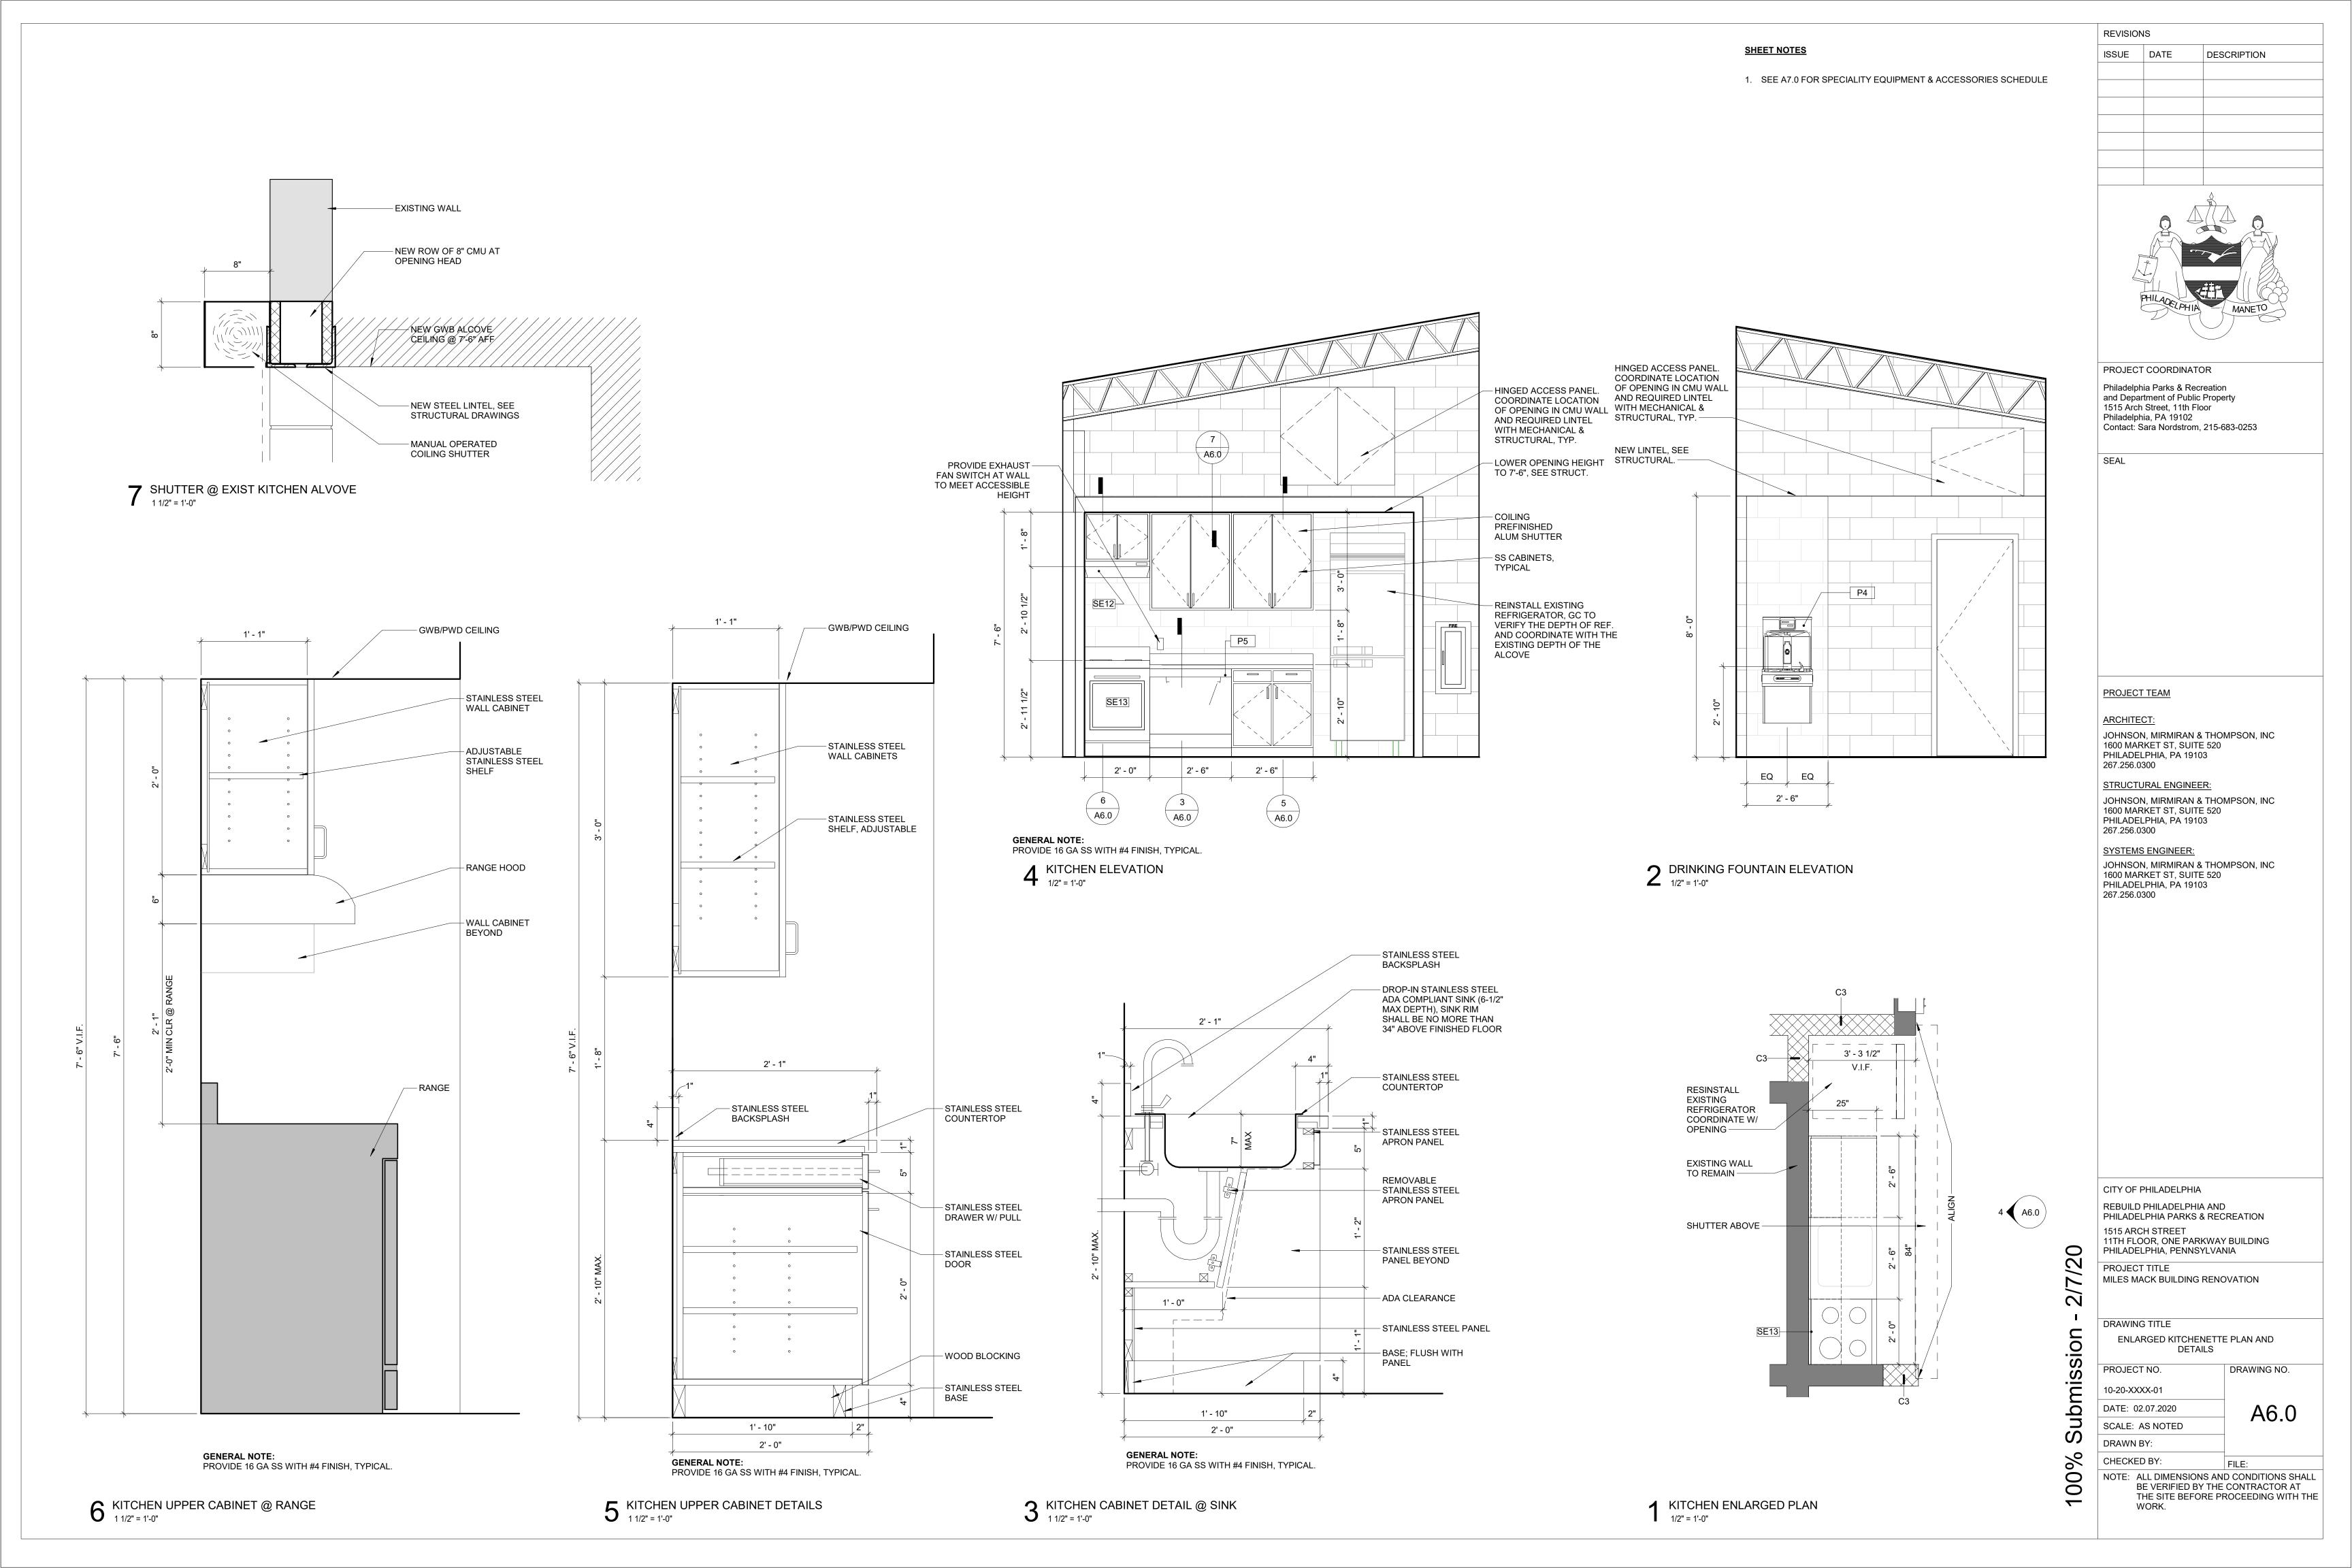



							DOOF	R SCH	HEDULI	<b>=</b>						
	DOOR FRAME REQUIRE MENTS															
DOOR			SIZE												HARDWARE	
NO.	ROOM NAME	WIDTH	HEIGHT	THICKNESS	TYPE	MATERIAL	FINISH	TYPE	MATERIAL	FINISH	HEAD	JAMB	THRESHOLD	CLOSER	SET	COMMENTS
1.1	HALLWAY	3' - 0" (VIF)	7' - 0" (VIF)	1 3/4"	N	НМ	PT-3	HM-1	HM	PT-3	H-3	J-3	TYPE-A	YES	2	COORDINATE EXTERIOR PT W/ MURAI
1.2	FOYER	3' - 0" (VIF)	7' - 0" (VIF)		N	НМ	PT-3	HM-1	НМ	PT-3	H-3	J-3	TYPE-A	YES	2	COORDINATE EXTERIOR PT W/ MURAL
3.1	MEETING/CONFERENCE ROOM	3' - 0" (VIF)	7' - 0" (VIF)		N	НМ	PT-3	HM-1	НМ	PT-3	H-3	J-3	TYPE-A	YES	2	COORDINATE EXTERIOR PT W/ MURAL
3.2	MEETING/CONFERENCE ROOM	2' - 6" (VIF)	7' - 0" (VIF)	1 3/4"	F2	НМ	PT-3	HM-2	НМ	PT-3	H-2	J-2	TYPE-B	YES	4	
5.1	BOYS BATHROOM	2' - 8" (VIF)	7' - 0" (VIF)	1 3/4"	F	НМ	PT-3	HM-1	НМ	PT-3	H-2	J-2	TYPE-B	YES	7	
5.2	BOYS BATHROOM	3' - 0" (VIF)	7' - 0" (VIF)	1 3/4"	F	HM	PT-3	HM-1	HM	PT-3	H-3	J-3	TYPE-A	YES	3	COORDINATE EXTERIOR PT W/ MURAL
6.1	GIRLS BATHROOM	2' - 8" (VIF)	7' - 0" (VIF)	1 3/4"	F	HM	PT-3	HM-1	HM	PT-3	H-2	J-2	TYPE-B	YES	7	
6.2	GIRLS BATHROOM	3' - 0" (VIF)	7' - 0" (VIF)	1 3/4"	F	HM	PT-3	HM-1	HM	PT-3	H-3	J-3	TYPE-A	YES	3	COORDINATE EXTERIOR PT W/ MURAL
7.1	MECHANICAL	3' - 0" (VIF)	7' - 2" (VIF)	1 3/8"	F	HM	PT-3	HM-1	HM	PT-3	H-2	J-2	TYPE-B	-	1	
8.1	OFFICE	3' - 0"	7' - 0"	1 3/4"	N	HM	PT-3	HM-1	HM	PT-3	H-1	J-1	TYPE-B	-	5	
9.1	CLOSET	2' - 4" (VIF)	6' - 8" (VIF)	1 3/4"	F	HM	PT-3	HM-1	HM	PT-3	H-2	J-2	TYPE-C	-	8	
10.1	ADA UNISEX TOILET	3' - 0"	7' - 0"	1 3/4"	F	HM	PT-3	HM-1	HM	PT-3	H-1	J-1	TYPE-B	YES	6	

T) (DE	DECORIDETON	MANUEACTURED	MODELNIO	COMMENTO
TYPE	DESCRIPTION	MANUFACTURER	MODEL NO.	COMMENTS
SE1	RESTROOM PARTITIONS	BRADLEY CORPORATION	MODEL STAINLESS STEEL PARTITIONS	FLOOR MOUNTED & CEILING AN
SE2	36" GRAB BAR	BRADLEY CORPORATION	MODEL 812	
SE3	42" GRAB BAR	BRADLEY CORPORATION	MODEL 812	
SE4	18" GRAB BAR	BRADLEY CORPORATION	MODEL 812	
SE5	HAND DRYER	BRADLEY CORPORATION	2923-287400	
SE6	TOILET TISSUE DISPENSER	BRADLEY CORPORATION	5402	
SE7	CHANGING TABLE	BRADLEY CORPORATION	962	SURFACE MOUNTED
SE8		BRADLEY CORPORATION		
SE9	SOAP DISPENSER	BRADLEY CORPORATION	6542	
SE10	MIRROR, 24" x 36"	BRADLEY CORPORATION	781-2436-4	20 GAUGE TYPE 430 SS, BRIGH ANNEALED
SE11	STAINLESS STEEL CLOTHES HOOK	BRADLEY CORPORATION	9114	
SE12	30" CONVERTIBLE RANGE HOOD	KENMORE	51041	
SE13	24" ELECTRIC RANGE	AVANTI	ER24P3SG	

PLUMBII	NG FIXTURE SCHEDULE
TYPE	FIXTURE
P1	
P1A	
P2	URINAL (ADA)
P3	LAVATORY SINK
P3A	LAVATORY SINK (ADA)
P4	DRINKING FOUNTAIN
P5	KITCHEN SINK (ADA)
	P1 P1A P2 P3 P3A P4

REVISIONS

PROJECT COORDINATOR

1515 Arch Street, 11th Floor

Philadelphia, PA 19102

PROJECT TEAM

267.256.0300

267.256.0300

267.256.0300

JOHNSON, MIRMIRAN & THOMPSON, INC

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JOHNSON, MIRMIRAN & THOMPSON, INC

1600 MARKET ST, SUITE 520

PHILADELPHIA, PA 19103

STRUCTURAL ENGINEER:

PHILADELPHIA, PA 19103

SYSTEMS ENGINEER:

CITY OF PHILADELPHIA

REBUILD PHILADELPHIA AND PHILADELPHIA PARKS & RECREATION

1600 MARKET ST, SUITE 520

1600 MARKET ST, SUITE 520 PHILADELPHIA, PA 19103

Philadelphia Parks & Recreation

and Department of Public Property


Contact: Sara Nordstrom, 215-683-0253

DESCRIPTION

### **DOOR AND FRAME NOTES**:


- 1. OPENING FORCE OF INTERIOR NON-RATED DOORS SHALL BE NO GREATER THAN 5 LBS.
- OPENING FORCE OF FIRE RATED DOORS SHALL BE NO GREATER THAN 8 LBS. REFER TO SPECIFICATIONS FOR GLAZING TYPES.
- PAINT ALL EXPOSED STEEL (COLOR AS SELECTED BY ARCHITECT).
- PROVIDE COMPATIBLE FLASHING MATERIALS BETWEEN DISSIMILAR MATERIALS. SHIM ASSEMBLIES AS REQUIRED FOR PLUMB AND LEVEL. PROVIDE SEALANT AND BACKER RODS AT ALL JOINTS BETWEEN WINDOW SYSTEMS, DOOR FRAMES AND OTHER SURROUNDING CONSTRUCTION.
- 7. ALUMINUM WINDOW AND ENTRANCE FRAMES SHALL NOT BE INSTALLED IN DIRECT CONTACT WITH DISSIMILAR BUILDING MATERIALS.
- 8. DO NOT APPLY WALL BASE TO HOLLOW METAL OR ALUMINUM FRAMES, UNLESS OTHERWISE NOTED.
- 9. SEE FINISH SCHEDULE ON A8.0 FOR DOOR AND FRAME FINISHES. 10. SEE SPECIFICATIONS FOR HARDWARE SETS.



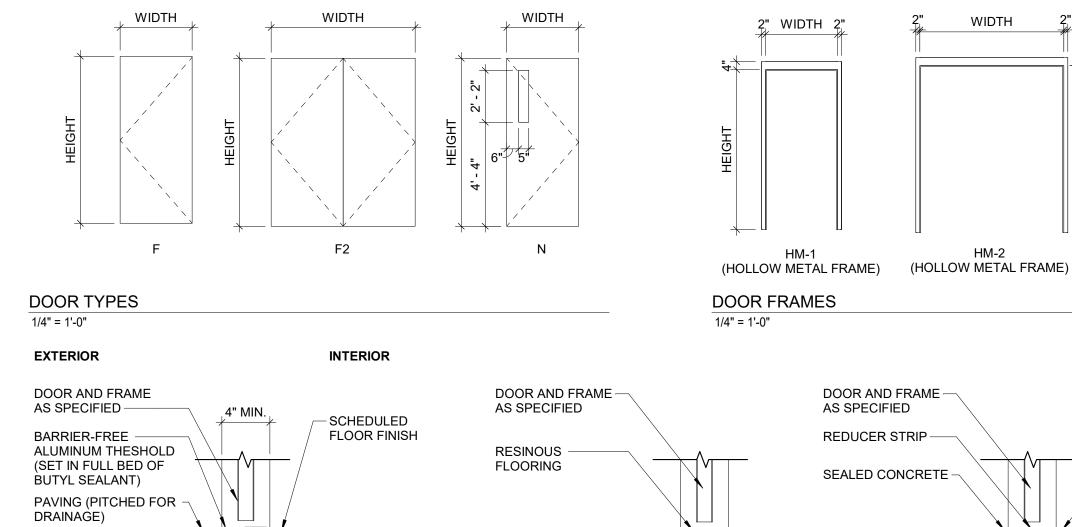



<u>TYPE A</u> AT EXTERIOR DOORS
THRESHOLD DETAILS

1" = 1'-0"

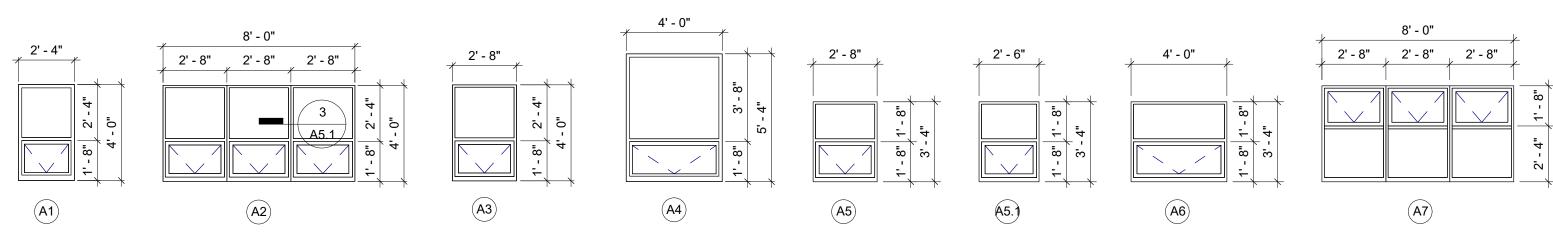

	GLAZING SCHEDULE
TYPE	DESCRIPTION
GL-1	LAMINATED GLASS AT EXTERIOR LAYER
GL-2	TEMPERED GLASS AT INTERIOR LAYER

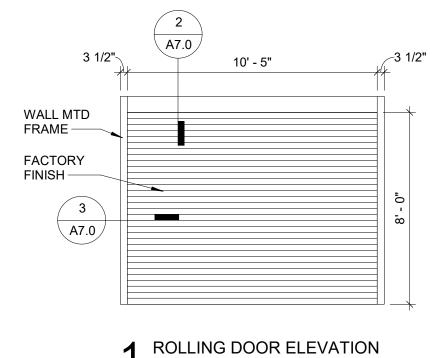

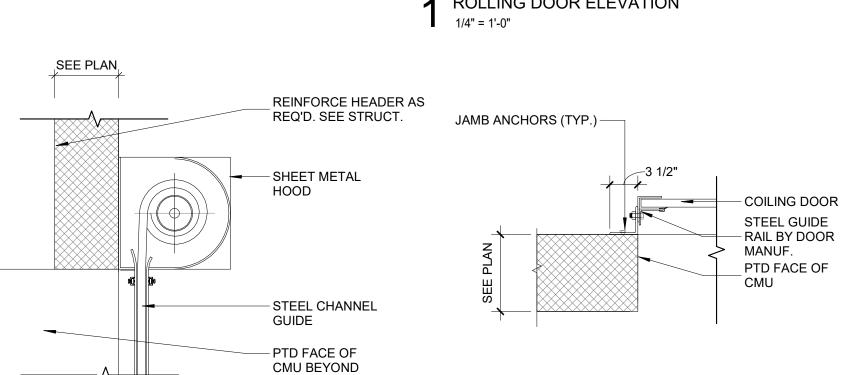

? ROLLING DOOR HEAD DETAIL

ROLLING DOOR JAMB DETAIL

1" = 1'-0"

1515 ARCH STREET 11TH FLOOR, ONE PARKWAY BUILDING PHILADELPHÍA, PENNSYLVANIA PROJECT TITLE MILES MACK BUILDING RENOVATION 7


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DRAWING TITLE SCHEDULES DRAWING NO. PROJECT NO. 10-20-XXXX-01 DATE: 02.07.2020

A7.0 SCALE: AS NOTED DRAWN BY:

RD FILE: NOTE: ALL DIMENSIONS AND CONDITIONS SHALL BE VERIFIED BY THE CONTRACTOR AT THE SITE BEFORE PROCEEDING WITH THE WORK.

SEE PLAN - MASONRY WALL CONSTRUCTED MASONRY WALL BOND BEAM. USE TYPE OF CMU AS SHOWN ON FLOOR PLANS. DOOR AND FRAME — DOOR AND FRAME SEALANT BOTH - SEALANT BOTH SEALANT \_1/2" SIDES (TYP.) SIDES (TYP.) (BOTH SIDES) - SEALANT -SEALANT (BOTH SIDES) (BOTH SIDES) DOOR AND FRAME AS DOOR AND DOOR AND SCHEDULED FRAME FRAME

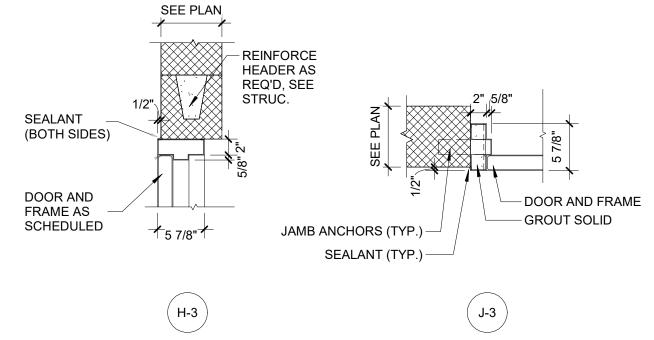

TYPE B RESINOUS FLOORING TO

RESINOUS FLOORING

WINDOW TYPES 1/4" = 1'-0"

- PROVIDE FIELD — EXISTING MASONRY **J-1** H-2 (H-1) **J-2** 


<u>TYPE C</u> SEALED CONCRETE

TO RESINOUS FLOORING

— SCHEDULED

FLOOR FINISH

DOOR HEAD AND JAMB 1" = 1'-0"

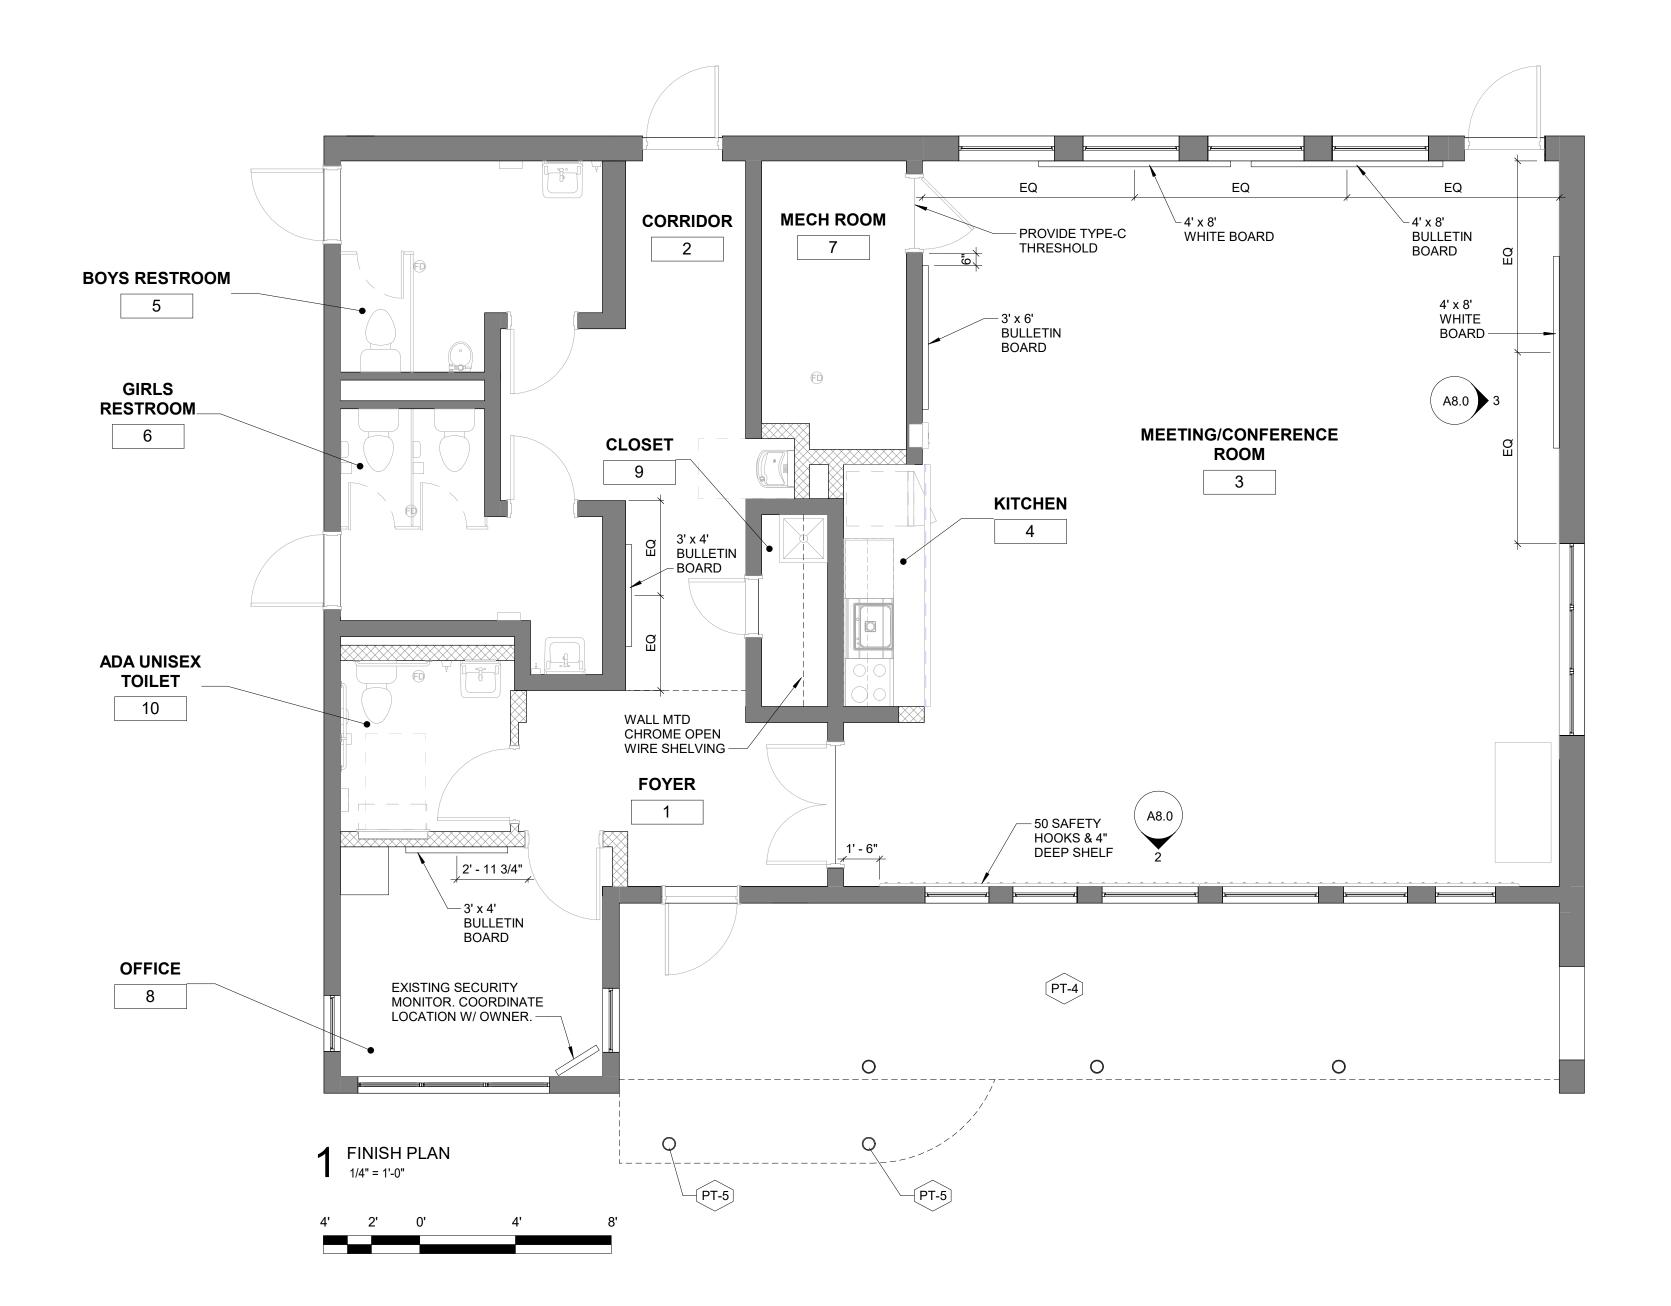



			ROOM	<b>FINISH</b>	SCHED	ULE
	WTWT		FII	NISH		
NO.	NAME	FLOOR	BASE	WALL	CEILING	COMMENTS
1	FOYER	F-1	B-1	PT-2	PT-1	
2	CORRIDOR	F-1	B-1	PT-2	PT-1	PAINT EXPOSED SECTIONS OF UNDERSIDE OF ROOF DECKAND EXPOSED ROOF TRUSSES TO MATCH CEILING FINISH
3	MEETING/CONFERENCE ROOM	F-2	B-2	PT-2	PT-1	PAINT EXPOSED SECTIONS OF UNDERSIDE OF ROOF DECK AND EXPOSED ROOF TRUSSES TO MATCH CEILING FINISH
4	KITCHEN	F-2	B-2	PT-2	PT-1	
5	BOYS RESTROOM	F-1	B-1	PT-2	PT-1	PT EXISTING GWB CLG
6	GIRLS RESTROOM	F-1	B-1	PT-2	PT-1	PT EXISTING GWB CLG
7	MECH ROOM	F-3	-	PT-2	PT-1	
8	OFFICE	F-1	B-1	PT-2	PT-1	
9	CLOSET	F-1	B-1	PT-2	PT-1	
10	ADA UNISEX TOILET	F-1	B-1	PT-2	PT-1	

### **SHEET NOTES:**

1. PAINT ALL METAL FACEPLATES

		FINISH	H SCHEDULE	
FINISH TYPE	CODE	MANUF. / STYLE / SERIES	COLOR	REMARKS
FLOORING	F-I	STONEHARD STONE CLAD	STEEL GREY	EPOXY FLOOR APPLICATION WITH INTERGRAL BASE
FLOORING	F-2	STONEHARD STONE CLAD		EPOXY FLOOR APPLICATION WITH INTERGRAL BASE
FLOORING	F-3	SEALED CONCRETE		
BASE	B-I	STONE HARD STONE CLAD	STEEL GREY INTEGRATED EPOXY FLOOR BASE	THROUGHOUT ALL SPACES WITH F-I FLOOR FINISH
BASE	B-2	STONE HARD STONE CLAD		THROUGHOUT ALL SPACES WITH F-2 FLOOR FINISH
PAINT	PT-I	SHERWIN WILLIAMS  LATEX SEMI-GLOSS ENAMEL	CEILING BRIGHT WHITE SW-7007	ALL EXPOSED AND GWB CEILINGS
PAINT	PT-2	SHERWIN WILLIAMS  LATEX SEMI-GLOSS ENAMEL	PORCELAIN SW-0053	THROUGHOUT ALL INTERIOR SPACES
PAINT	PT-3	SHERWIN WILLIAMS  LATEX SEMI-GLOSS ENAMEL	SOFTWARE SW-7074	ALL INTERIOR DOORS \$ FRAMES
PAINT	PT-4			MATCH EXISTING
PAINT	PT-5			PAINT COLUMNS TO MATCH EXISTING

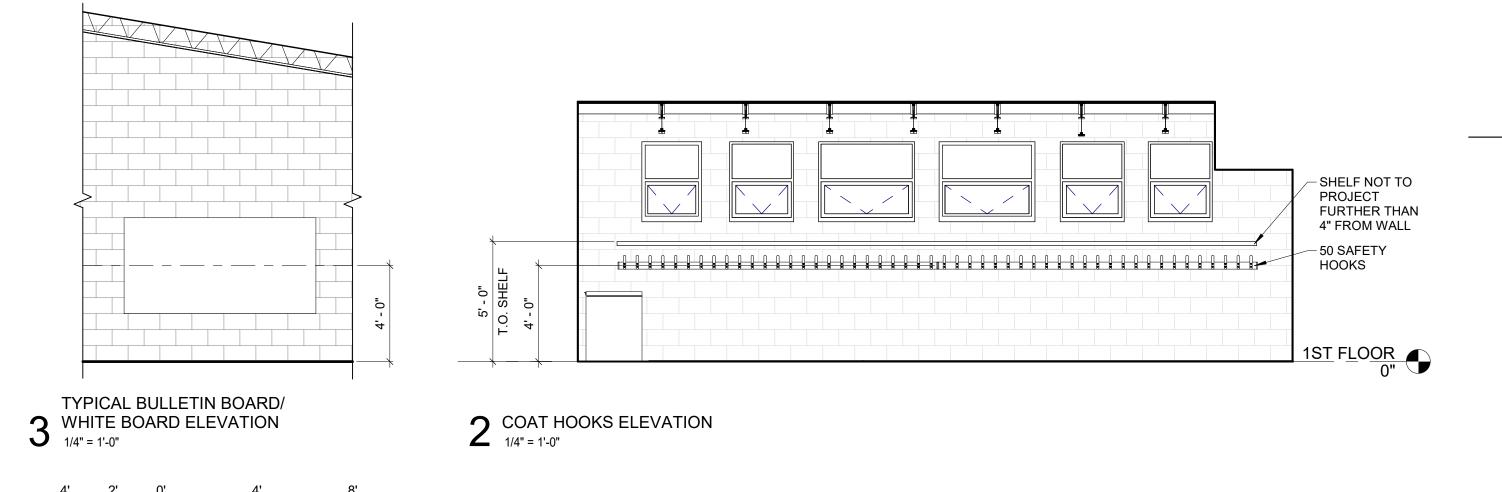

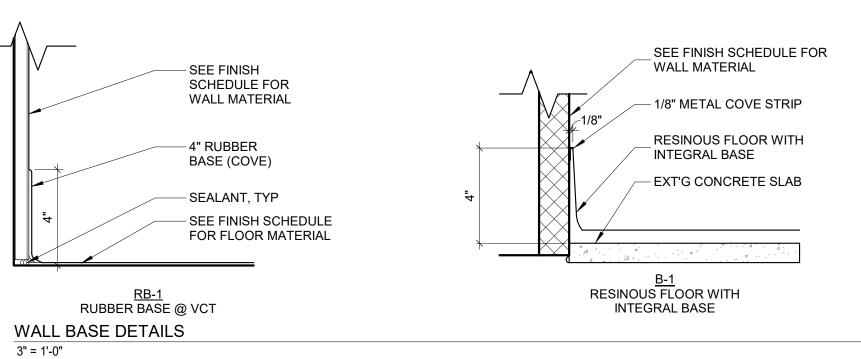

CITY OF PHILADELPHIA REBUILD PHILADELPHIA AND PHILADELPHIA PARKS & RECREATION 1515 ARCH STREET 11TH FLOOR, ONE PARKWAY BUILDING PHILADELPHIA, PENNSYLVANIA PROJECT TITLE MILES MACK BUILDING RENOVATION DRAWING TITLE FINISH PLAN PROJECT NO. 10-20-XXXX-01 DATE: 02.07.2020 SCALE: AS NOTED DRAWN BY: CHECKED BY: THE SITE BEFORE PROCEEDING WITH THE WORK.

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PROJECT COORDINATOR Philadelphia Parks & Recreation and Department of Public Property 1515 Arch Street, 11th Floor Philadelphia, PA 19102 Contact: Sara Nordstrom, 215-683-0253 PROJECT TEAM JOHNSON, MIRMIRAN & THOMPSON, INC 1600 MARKET ST, SUITE 520 PHILADELPHIA, PA 19103 267.256.0300 JOHNSON, MIRMIRAN & THOMPSON, INC 1600 MARKET ST, SUITE 520 PHILADELPHIA, PA 19103 267.256.0300 SYSTEMS ENGINEER: JOHNSON, MIRMIRAN & THOMPSON, INC 1600 MARKET ST, SUITE 520 PHILADELPHIA, PA 19103 267.256.0300

REVISIONS

SEAL

DESCRIPTION

DRAWING NO. A8.0 NOTE: ALL DIMENSIONS AND CONDITIONS SHALL BE VERIFIED BY THE CONTRACTOR AT

### MECHANICAL LEGEND

### SYMBOL DESCRIPTION SYMBOL DESCRIPTION SOIL, WASTE, OR SANITARY PIPE DUCT (SOLID) OVER DUCT (BROKEN) ——— VENT PIPE — STORM WATER PIPE ——CD—— CONDENSATE DRAIN PIPE ——PC—— PUMPED CONDENSATE PIPE DUCT (SOLID) OVER PIPE (BROKEN) DOMESTIC COLD WATER PIPE ———— DOMESTIC HOT WATER PIPE DOMESTIC HOT WATER RETURN PIPE PIPE (SOLID) OVER DUCT (SOLID) T DOMESTIC TEMPERED WATER PIPE SPRINKLER SUPPLY PIPE FIRE LINE PIPE PIPE (SOLID) OVER PIPE (BROKEN) CLEANOUT (WALL/INLINE & FLOOR) CHECK VALVE (ARROW INDICATES FLOW DIRECTION) 7 18"x12" 7 DUCT (FIRST FIGURE SIDE SHOWN) SHUT-OFF OR GATE VALVE (NO/NC) BALL VALVE (NO/NC) DROP IN DIRECTION OF ARROW GLOBE VALVE (NO/NC) RISE IN DIRECTION OF ARROW BUTTERFLY VALVE SUPPLY/OUTSIDE AIR DUCT RISER RETURN AIR DUCT RISER PIPE REDUCER; ECCENTRIC PIPE REDUCER; CONCENTRIC EXHAUST/RELIEF AIR DUCT RISER SPRINKLER HEAD ELBOW WITH DOUBLE THICKNESS TURNING VANES ── BRANCH TAKE OFF ROUND DUCT RISER PIPE DROP END —— PIPE DROP TEE SMOKE DETECTOR ——O—— PIPE RISE TEE SUPPLY AIR DIFFUSER PIPE WITH CAP RETURN AIR GRILLE PIPE WITH OPEN END DIAGRAMMATICAL PIPE CONTINUATION EXHAUST AIR GRILLE BREAK SYMBOL; FOR DRAWING CLARITY VENT THRU ROOF FIRE DAMPER Ø FLOOR DRAIN SMOKE DAMPER HUMIDISTAT ← − ← F/S COMBINATION FIRE/SMOKE DAMPER THERMOSTAT OR TEMPERATURE SENSOR REMOTE TEMPERATURE SENSOR MANUAL VOLUME DAMPER CO2 SENSOR (48" AFF) MOTOR OPERATED DAMPER UNDERCUT DOOR SQUARE TO ROUND DUCT TRANSITION DOOR LOUVER FLEXIBLE CONNECTION → AIR FLOW (RETURN) DUCTWORK SOUND LINING AIR FLOW (SUPPLY) ACCESS DOOR DIAGRAMMATICAL PIPE SYSTEM FLOW SYMBOL; FOR DRAWING CLARITY DUCT TRANSITION POINT OF CONNECTION, NEW TO EXISTING RECTANGULAR BRANCH TAKE-OFF POINT OF DISCONNECTION FROM EXISTING BELL MOUTH BRANCH TAKE-OFF KEY NOTE SYMBOL FOR SPECIFIC NOTE; APPLIES TO DRAWING ON WHICH IT OCCURS ROUND BRANCH TAKE-OFF CIRCULAR AIR DIFFUSER CIRCULAR DUCT DROP OFF BOTTOM SUPPLY AIR DEVICE WITH 2'x2' LAY-IN PANEL RETURN AIR DEVICE WITH 2'x2' LAY-IN PANEL

### **ABBREVIATIONS**

@ A	AT COMPRESSED AIR PIPE	INV ISOL	INVERT ISOLATION
AAV ABV	AUTOMATIC AIR VENT ABOVE	IW	INDUSTRIAL WASTE
ACV AD	AUTOMATIC CONTROL VALVE ACCESS DOOR	KW	KILOWATTS
ADR AFF	AREA DRAIN ABOVE FINISHED FLOOR	L LAT	LONG, LENGTH LEAVING AIR TEMPERATURE
 AHU LUM	AIR HANDLING UNIT ALUMINUM	LBS LBS/HR	POUNDS POUNDS PER HOUR
AMD	AIR MONITORING DEVICE	LDB	LEAVING DRY BULB
APD PROX	AIR PRESSURE DROP APPROXIMATELY	LF LPC	LINEAR FEET LOW PRESSURE CONDENSATE PIPE
AR ATC	ACID RESISTANT AUTOMATIC TEMPERATURE CONTROL	LPS LRA	LOW PRESSURE STEAM PIPE LOCKED ROTOR AMPERES
TTEN AWT	ATTENUATOR AVERAGE WATER TEMPERATURE	LSD LWB	LINEAR SLOT DIFFUSER LEAVING WET BULB
		LWT	LEAVING WATER TEMPERATURE
BDD BFP	BACKDRAFT DAMPER BACKFLOW PREVENTOR	MA	MIXED AIR
BHP LDG	BRAKE HORSEPOWER BUILDING	MAV MAX	MANUAL AIR VENT MAXIMUM
BLW BP	BELOW BYPASS	MBH MECH	ONE THOUSAND BTU/HR MECHANICAL
BTM	BOTTOM	MFD	MOTORIZED FIRE DAMPER
U/HR BV	BRITISH THERMAL UNITS PER HOUR BALANCING VALVE	MFR MIN	MANUFACTURER MINIMUM
₿₩V	BACKWATER VALVE	MOD MTD	MOTOR OPERATED DAMPER MOUNTED
°C	COMMON DEGREES CELSIUS	MVD	MANUAL VOLUME DAMPER
CA CC	CONDITIONED OUTDOOR AIR COOLING COIL	NC NIC	NOISE CRITERIA OR NORMALLY CLOSED NOT IN CONTRACT
CCP	COOLING COIL PUMP	NOM	NOMINAL
CD CDR	CONDENSATE DRAIN CONDENSER WATER RETURN PIPE	NO No	NORMALLY OPEN NUMBER
CDS CFM	CONDENSER WATER SUPPLY PIPE CUBIC FEET PER MINUTE	OA	OUTDOOR AIR
CHR CHS	CHILLED WATER RETURN PIPE CHILLED WATER SUPPLY PIPE	OAI OAT	OUTDOOR AIR INTAKE OUTDOOR AIR TEMPERATURE
CI	CAST IRON	OC	ON CENTER
CLG CO	CEILING CLEANOUT	OED OFD	OPEN END DUCT WITH 1/2" FRAMED WMS OVERFLOW DRAIN
ONC ONN	CONCRETE CONNECT, CONNECTION	OI OS&Y	OIL INTERCEPTOR OUTSIDE STEM & YOKE VALVE
ONT'N CV	CONTINUATION CHECK VALVE	%	PERCENT
CW	DOMESTIC COLD WATER	PC	PUMPED CONDENSATE PIPE
CX	CONNECT TO EXISTING	PD PH	PRESSURE DROP OR PUMP DISCHARGE PHASE
D DAM	SUPPLY AIR DIFFUSER OR DEEP, DEPTH DUCT AIR MONITOR	POD PR	POINT OF DISCONNECTION PRESSURE RELIEF
DB DC	DECIBEL OR DRY BULB DIRECT DIGITAL CONTROL	PRESS, P PRG	PRESSURE PRESSURE RELIEF GRILLE
ESG	DESIGNATION	PRV	PRESSURE REDUCING VALVE
DF DHC	DRINKING FOUNTAIN DUCT HEATING COIL	PS PSI	PRESSURE SENSOR POUNDS PER SQUARE INCH POUNDS
IA, Ø DIFF	DIAMETER DIFFERENTIAL	PSIG PUH	PER SQUARE INCH GAUGE PROPELLER UNIT HEATER
DL DN	DOOR LOUVER DOWN	R	RETURN/EXHAUST/SUPPLY AIR REGISTER
PR	DAMPER	RA	RETURN AIR
DPS DR	DIFFERENTIAL PRESSURE SENSOR MISCELLANEOUS DRAINAGE	RDR REQ'D	ROOF DRAIN REQUIRED
OTR OTS	DUAL TEMPERATURE RETURN DUAL TEMPERATURE SUPPLY	RF RH	RETURN FAN RELATIVE HUMIDITY
WG	DRAWING	RL RLA	REFRIGERANT LIQUID RUNNING LOAD AMPERES
EA EAT	EXHAUST AIR	RM RPM	ROOM
ECM	ENTERING AIR TEMPERATURE ELECTRONICALLY COMMUTATED MOTOR	RS	REVOLUTIONS PER MINUTE REFRIGERANT SUCTION
EDB EFF	ENTERING DRY BULB EFFICIENCY	RV RX	RELIEF VENT REMOVE EXISTING
EF EJ	EXHAUST FAN EXPANSION JOINT	S	SPRINKLER SUPPLY PIPE
LEC LEV	ELECTRIC ELEVATION OR ELEVATOR	SA SAN	SUPPLY AIR SANITARY, SOIL, WASTE
ESP	EXTERNAL STATIC PRESSURE	SAT	SATURATED
EWB EWT	ENTERING WET BULB ENTERING WATER TEMPERATURE	SD SENS	SMOKE DAMPER SENSIBLE
EX EXH	EXISTING EXHAUST	SEP SF	SEPARATOR SUPPLY FAN OR SQUARE FEET
EXP	EXPANSION	SL S/M	SOUND LINING, SOUND LINED SHEET METAL
F	FILTER	SP	STATIC PRESSURE
°F -&T	DEGREES FAHRENHEIT FLOAT & THERMOSTATIC	SPD SPEC	STATIC PRESSURE DROP SPECIFICATION
FC FD	FLEXIBLE CONNECTION FIRE DAMPER OR FOUNDATION DRAINAGE	SQ SQ FT	SQUARE DROP SQUARE FOOT
DC DR	FIRE DEPARTMENT CONNECTION FLOOR DRAIN	SPR SS	SPRINKLER LINE START/STOP
DV HC	FIRE DEPARTMENT VALVE FIRE HOSE CABINET	S/S STL	STAINLESS STEEL STEEL
FL	FLOOR	SW	STORM WATER
-LA -OB	FULL LOAD AMPERES FLAT ON BOTTOM	ΔΤ	TEMPERATURE DROP
OT PM	FLAT ON TOP FEET PER MINUTE	TEMP, T TG	TEMPERATURE TRANSFER GRILLE
PS SP	FEET PER SECOND FIRE STANDPIPE	TS TSP	TAMPER SWITCH TOTAL STATIC PRESSURE
FT, '	FOOT, FEET OR FLASH TANK	TYP	TYPICAL
Γ HD FZ	FEET OF HEAD FREEZE STAT	TW	DOMESTIC TEMPERED WATER PIPE
FU	FIXTURE UNITS	UC UH	UNDERCUT DOOR UNIT HEATER
G GAL	RETURN/EXHAUST GRILLE GALLON, GALLONS	UON	UNLESS OTHERWISE NOTED
ALV SEN	GALVANIZED GENERATOR	V VCP	VOLTS, VACUUM PIPE VITRIFIED CLAY PIPE
GI	GREASE INTERCEPTOR	VCPX	VITRIFIED CLAY PIPE-EXTRA STRENGTH
SPM .	GALLONS PER MINUTE	VD VEL	VOLUME DAMPER VELOCITY
H 120	HIGH, HEIGHT WATER	VENT VF	VENTILATION VENTILATION FAN
HB HED	HOSE BIBB HOSE END DRAIN VALVE	VFD VG	VARIABLE FREQUENCY DRIVE VARI-GREEN® ECM
HP	HORSEPOWER	VIB	VIBRATION
HPC HPS	HIGH PRESSURE CONDENSATE PIPE HIGH PRESSURE STEAM PIPE	ISOL VLV VP	ISOLATION VALVE SANITARY VENT PIPE
HW IWC	DOMESTIC HOT WATER DOMESTIC HOT WATER CIRCULATING	VTR	VENT THROUGH ROOF
IWR IWS	HEATING WATER RETURN HEATING WATER SUPPLY	W W/	WIDTH WITH
HZ	HERTZ	WB	WET BULB
GV	INLET GUIDE VANE	WC WH	WATER COLUMN WALL HYDRANT
N, "	INCH, INCHES	WMS	WIRE MESH SCREEN
		ZN	ZONE


### **GENERAL NOTES**

- 1. WORK SHALL CONFORM TO THE CONTRACT DRAWINGS, SPECIFICATIONS AND THE LATEST APPLICABLE INTERNATIONAL MECHANICAL AND PLUMBING CODE AND THE NATIONAL ELECTRIC CODE AND THE PHILADELPHIA PLUMBING CODE... WORK SHALL BE PERFORMED IN ACCORDANCE WITH NFPA 70, THE NATIONAL ELECTRICAL CODE, THE NATIONAL ELECTRICAL SAFETY CODE, OSHA AND NATIONAL SAFETY
- 2. THE SCOPE OF WORK INDICATED IN THESE DOCUMENTS SHALL INCLUDE MECHANICAL AND ELECTRICAL SYSTEMS, FULLY ADJUSTED, TESTED AND READY TO USE. PROVIDE ITEMS NECESSARY TO COMPLETE THE SYSTEMS. EXAMINE WORK INDICATED FOR TRADES IN ORDER TO DETERMINE THE EXTENT OF THE WORK REQUIRED TO BE COMPLETED.
- 3. IT IS THE INTENTION OF THESE DRAWINGS TO CALL FOR FINISHED WORK. TESTED AND READY FOR OPERATION. WHEREVER THE WORD "PROVIDE" IS USED, IT SHALL MEAN "FURNISH AND INSTALL COMPLETE, TESTED AND READY FOR USE."
- 4. THE DRAWINGS ARE DIAGRAMMATIC AND DO NOT SHOW EVERY COMPONENT AND/OR ACCESSORY REQUIRED FOR A COMPLETE INSTALLATION. THE CONTRACTOR SHALL PROVIDE ITEMS NECESSARY FOR A PROPERLY WORKING SYSTEM IN COMPLIANCE WITH ACCEPTED INDUSTRY STANDARDS AND MANUFACTURER'S RECOMMENDATIONS.
- 5. PRIOR TO BID, THE CONTRACTOR SHALL VISIT THE SITE AND IDENTIFY ITEMS THAT MAY AFFECT THEIR BID. PRIOR TO THE INSTALLATION, FABRICATION, REMOVAL, OR RELOCATION OF ANY WORK, THE CONTRACTORS SHALL REVIEW THE ACTUAL CONDITIONS UNDER WHICH THE WORK IS TO BE PERFORMED AND SHALL COORDINATE WORK WITH THE PLANS, EXISTING EQUIPMENT AND SYSTEMS, BUILDING STRUCTURE AND WORK OF OTHER TRADES. WHERE CONFLICTS OCCUR, OR IF CONNECTIONS THERETO CAN NOT BE MADE, THE CONTRACTOR SHALL IMMEDIATELY NOTIFY THE ENGINEER PRIOR TO MATERIAL FABRICATION OR INSTALLATION.
- 6. WHERE THE WORK OF VARIOUS TRADES WILL BE INSTALLED IN CLOSE PROXIMITY TO ONE ANOTHER OR WHERE THERE IS EVIDENCE THAT THE WORK OF ONE TRADE WILL INTERFERE WITH WORK OF ANOTHER, THE CONTRACTOR SHALL WORK OUT SPACE CONDITIONS TO MAKE A SATISFACTORY ADJUSTMENT. IF THE CONTRACTOR ALLOWS ONE TRADE TO INSTALL HIS WORK BEFORE COORDINATING WITH WORK OF OTHER TRADES THE CONTRACTOR SHALL MAKE NECESSARY CHANGES TO CORRECT THE CONDITIONS IN A MANNER ACCEPTABLE TO THE OWNER AND THE CONTRACTOR SHALL BEAR THE COST OF SUCH CORRECTIONS.
- 7. THE CONTRACTOR SHALL LOCATE EQUIPMENT WHICH MUST BE SERVICED, OPERATED, OR MAINTAINED IN FULLY ACCESSIBLE POSITION. EQUIPMENT SHALL INCLUDE, BUT NOT BE LIMITED TO, VALVES, MOTORS, CONTROLLERS, DRAIN PANS, ETC. IF REQUIRED FOR ACCESSIBILITY, FURNISH ACCESS DOORS FOR THE PURPOSE. MINOR DEVIATIONS FROM DRAWINGS MAY BE MADE TO ALLOW FOR
- 8. WORK IN OCCUPIED SPACE SHALL BE COORDINATED WITH THE OWNER. SHOULD ANY OUTAGES BE REQUIRED IN THE COURSE OF THIS PROJECT, THE CONTRACTOR SHALL COORDINATE SUCH OUTAGES WITH THE OWNER'S DESIGNATED REPRESENTATIVE, SCHEDULING ANY OUTAGES DURING THE NON WORKING HOURS, SO AS NOT TO EFFECT FACILITY OPERATIONS, 72 HOURS NOTICE WILL BE REQUIRED PRIOR TO ANY OUTAGE. NO OUTAGE MAY BE EXECUTED PRIOR TO APPROVAL OF THE OWNER'S DESIGNATED REPRESENTATIVE AND THE FACILITY MANAGER.
- 9. THE CONTRACTOR SHALL LEAVE THE ENTIRE MECHANICAL SYSTEM INSTALLED UNDER THIS CONTRACT IN PROPER WORKING ORDER AND SHALL, WITHOUT CHARGE, REPLACE ANY WORK OR MATERIALS WHICH DEVELOP DEFECTS, EXCEPT FROM ORDINARY WEAR AND TEAR, WITHIN ONE YEAR FROM THE DATE OF FINAL ACCEPTANCE.
- 10. THE CONTRACTOR SHALL, DURING THE ONE YEAR WARRANTY PERIOD, BE RESPONSIBLE FOR PROPER REPAIR AND ADJUSTMENTS OF MECHANICAL SYSTEMS AND EQUIPMENT, APPARATUS, DEVICES ETC. INSTALLED BY HIM, AND DO WORK NECESSARY TO ENSURE EFFICIENT AND PROPER FUNCTIONING.
- 11. THE CONTRACTOR SHALL BE RESPONSIBLE FOR, AND SHALL INCUR FINANCIAL RESPONSIBILITIES FOR, ANY DAMAGES CAUSED BY OR RESULTING FROM DEFECTS IN HIS WORK.
- 12. DEMOLITION SHALL INCLUDE REMOVAL AND OFF-SITE DISPOSAL OF MATERIALS. DO NOT ABANDON IN PLACE ANY MECHANICAL AND RELATED ELECTRICAL COMPONENTS UNLESS OTHERWISE NOTED ON DRAWINGS.
- 13. WHEREVER PIPES, CONDUITS, OR OTHER ITEMS PASS THROUGH FIRE RATED WALLS AND FLOORS, THE SPACE BETWEEN THE ITEM AND THE MASONRY OR THE SPACE BETWEEN THE ITEM AND THE SLEEVE SHALL BE ADEQUATELY FIRE STOPPED WITH A NON COMBUSTIBLE, NON MELTING MATERIAL IN ACCORDANCE WITH NFPA STANDARDS.
- 14. DUCTWORK OR PIPING SHALL NOT BE INSTALLED ABOVE ELECTRICAL PANELS OR EQUIPMENT.
- 15. WALL OPENINGS RESULTING FROM DEMOLITION SHALL BE CLOSED AND FINISHED TO MATCH EXISTING.
- 16. FINISHES DAMAGED DURING THE PROJECTS SHALL BE REPAIRED TO MATCH EXISTING.
- 17. INFORMATION SHOWN ON DRAWINGS PERTAINING TO EXISTING CONDITIONS HAS BEEN OBTAINED FROM AVAILABLE BUILDING DRAWINGS OR GENERAL FIELD OBSERVATIONS AND MAY NOT INDICATE ACTUAL EXISTING CONDITIONS IN DETAIL OR DIMENSION. THE CONTRACTOR IS RESPONSIBLE FOR DETERMINING THE ACTUAL EXISTING CONDITIONS PRIOR TO FABRICATION OR PERFORMANCE OF ANY WORK. SHOULD CONDITIONS BE DISCOVERED THAT PREVENT EXECUTION OF THE WORK AS INDICATED, THE CONTRACTOR SHALL IMMEDIATELY NOTIFY THE ARCHITECT IN WRITING AND AWAIT DIRECTION BEFORE PROCEEDING WITH THE WORK.

### **EQUIPMENT/DEVICE DESIGNATIONS**

BRV-	BAROMETRIC RELIEF VENT	P-	PUMP
CAV-	CONSTANT AIR VOLUME BOX	RF-	RETURN FAN
DFC-	DUCTLESS FAN COIL	RH-	RANGE HOOD
DOAS-	DIRECT OUTSIDE AIR SYSTEM	SF-	SUPPLY FAN
DSSC-	DUCTLESS SPLIT SYSTEM CONDENSER	UH-	UNIT HEATER
DSSE-	DUCTLESS SPLIT SYSTEM EVAPORATOR	V-	VALVE
DWH-	DOMESTIC WATER HEATER	VAV-	VARIABLE AIR VOLUME BOX
EF-	EXHAUST FAN	VRF-	VARIABLE REFRIGERANT FLOW
EUH-	ELECTRIC UNIT HEATER	WFS-	WATER FILTRATION SYSTEM
F-	FILTER		- AIR DEVICE DESIG (D/R/G)
FPB-	FAN POWERED BOX	A 100	
	,		- AIR FLOW
			(TO BE BALANCED)

### SHEET DESIGNATIONS

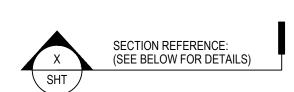

**\DRAWING TITLE** 

DETAIL IS DRAWN

SHT /SCALE: 1/4" = 1'-0"

- DETAIL = LETTER/SECTION = NUMBER

SHEET NUMBER FROM WHICH THE

PARTIAL, SECTION, ELEVATION, OR


AHU- AIR HANDLING UNIT



HRV- HEAT/ENERGY RECOVERY VENTILATOR

TRUE NORTH -

REVISIONS ISSUE DATE DESCRIPTION

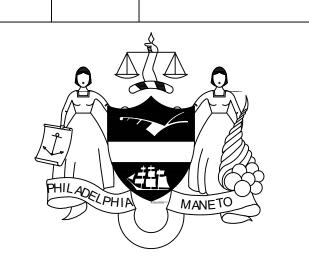

PROJECT COORDINATOR

Philadelphia Parks & Recreation and Department of Public Property 1515 Arch Street, 11th Floor Philadelphia, PA 19102 Contact: Charles Mottershead, 215.683-4466

SEAL



### **PROJECT TEAM**

### ARCHITECT:

JMT I ARCHITECTURE JOHNSON, MIRMIRAN, AND THOMPSON, INC. 1600 MARKET STREET, SUITE 520 PHILADELPHIA, PA 19103 267.256.0300 I WWW.JMT.COM

### STRUCTURAL ENGINEER:

JOHNSON, MIRMIRAN, AND THOMPSON, INC. 1600 MARKET STREET, SUITE 520 PHILADELPHIA, PA 19103 267.256.0300 I WWW.JMT.COM

### SYSTEMS ENGINEER:

JOHNSON, MIRMIRAN, AND THOMPSON, INC. 1600 MARKET STREET, SUITE 520 PHILADELPHIA, PA 19103 267.256.0300 I WWW.JMT.COM

CITY OF PHILADELPHIA

DEPARTMENT OF PUBLIC PROPERTY 1515 ARCH STREET 11TH FLOOR, ONE PARKWAY BUILDING PHILADELPHIA, PENNSYLVANIA

PROJECT TITLE MILES MACK PLAYGROUND BUILDING RENOVATION

### DRAWING TITLE

CHECKED BY:

N

0

SYMBOLS, GENERAL NOTES, AND ABBREVIATIONS - MECHANICAL

PROJECT NO. DRAWING NO. ubmis 18-00355-001 DATE: 02.07.2020

SCALE: AS NOTED DRAWN BY: MMB

GSC | FILE: NOTE: ALL DIMENSIONS AND CONDITIONS SHALL BE VERIFIED BY THE CONTRACTOR AT THE SITE BEFORE PROCEEDING WITH THE WORK.



PHOTOGRAPH #1 SCALE: NOT TO SCALE



PHOTOGRAPH #2



PHOTOGRAPH #3 SCALE: NOT TO SCALE





PHOTOGRAPH #4 SCALE: NOT TO SCALE








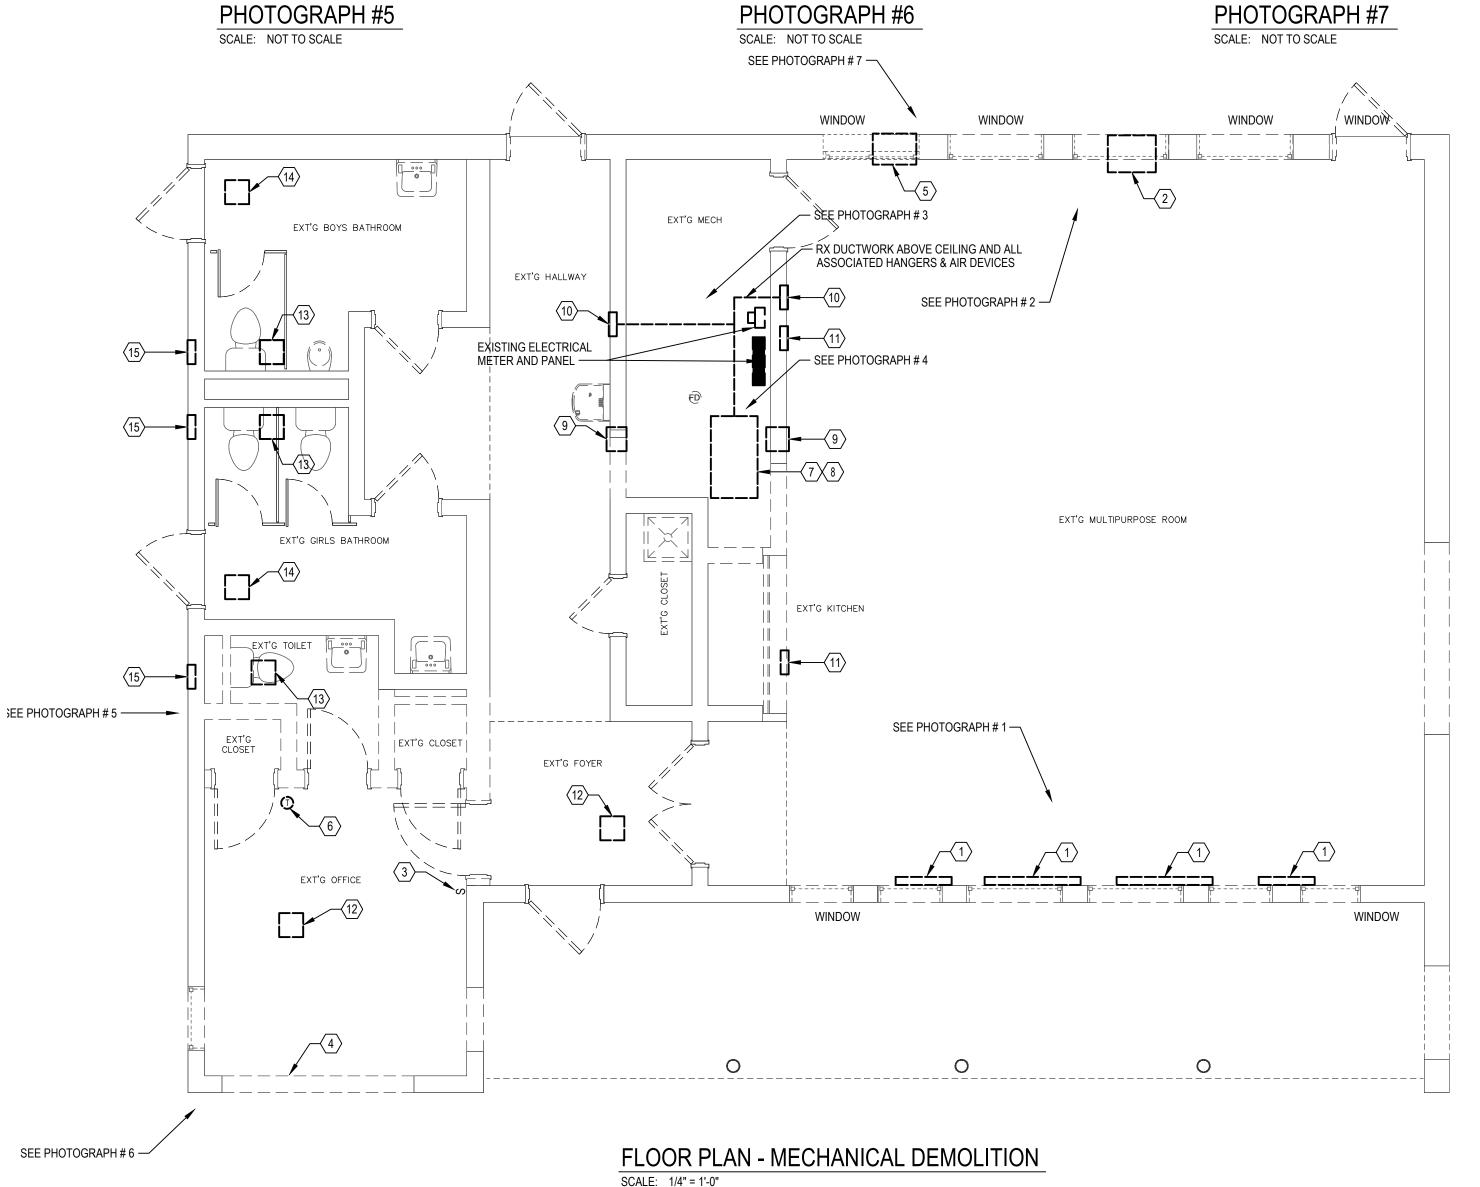

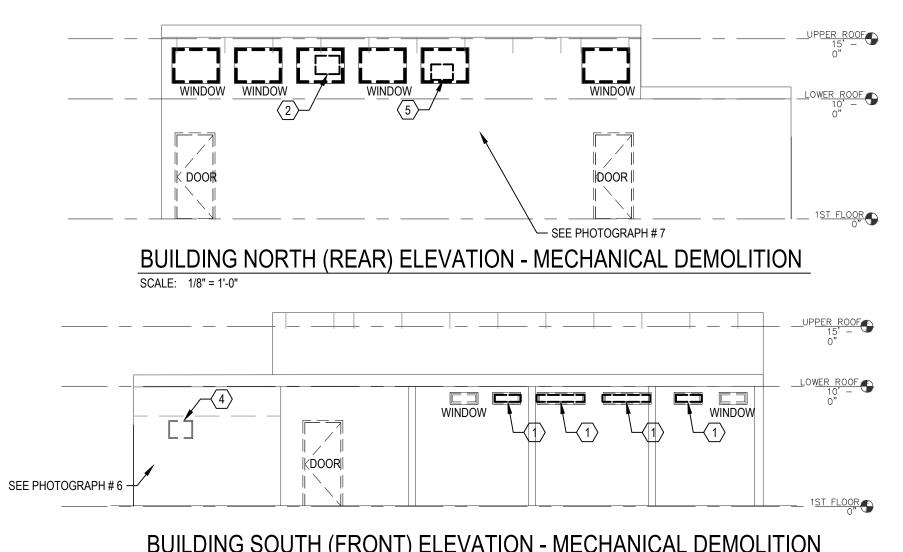

BUILDING SOUTH (FRONT) ELEVATION - MECHANICAL DEMOLITION

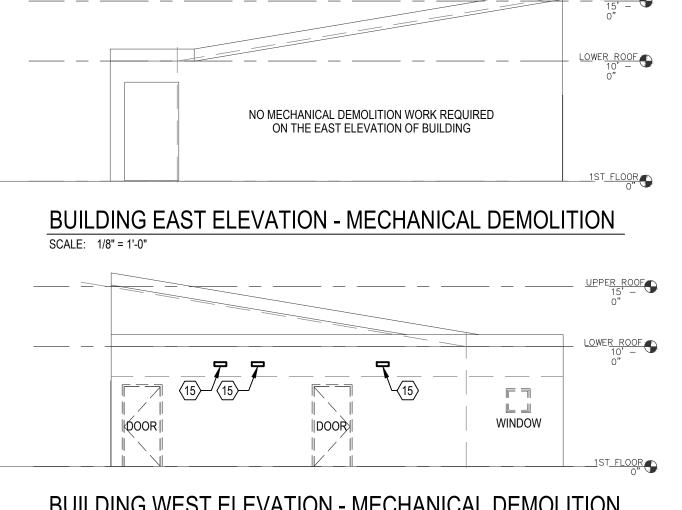

**BUILDING WEST ELEVATION - MECHANICAL DEMOLITION** 

SCALE: 1/8" = 1'-0"

### **GENERAL SHEET NOTES:**

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- 2. DEMOLITION SHALL INCLUDE REMOVAL AND OFF-SITE DISPOSAL OF MATERIALS. DO NOT ABANDON IN PLACE ANY MECHANICAL AND RELATED ELECTRICAL COMPONENTS UNLESS OTHERWISE NOTED ON
- 3. UNLESS OTHERWISE NOTED, MECHANICAL/PLUMBING ITEMS SHOWN HEAVY DASHED (---) SHALL BE REMOVED AND MECHANICAL/PLUMBING ITEMS SHOWN LIGHT SOLID ( ——— ) SHALL REMAIN.
- 4. ALL EQUIPMENT SHOULD BE ELECTRICALLY ISOLATED AND SAFED OFF PRIOR TO REMOVAL.

### SHEET KEYNOTES:

- REMOVE EXISTING LOUVER, DAMPER AND CONTROLS ASSOCIATED WITH EXHAUST AIR INLET SYSTEM. COORDINATE WITH ELECTRICAL CONTRACTOR.
- (2) REMOVE EXISTING EXHAUST FAN AND ASSOCIATED POWER AND CONTROLS. FAN IS CONTROLLED VIA SWITCH LOCATED IN OFFICE. COORDINATE WITH ELECTRICAL CONTRACTOR.
- REMOVE EXISTING POWER ON/OFF SWITCH THAT CONTROLS THE MULTIPURPOSE ROOM EXHAUST
- (4) REMOVE EXISTING WINDOW AIR CONDITIONING UNIT LOCATED IN OFFICE. COORDINATE WITH GENERAL CONTRACTOR FOR PATCHING/INFILL OF EXISTING WALL OPENING.

FAN SYSTEM. COORDINATE WITH ELECTRICAL CONTRACTOR.

- REMOVE EXISTING WINDOW AIR CONDITIONING UNIT LOCATED IN MULTIPURPOSE ROOM. COORDINATE WITH GENERAL CONTRACTOR FOR WINDOW REPLACEMENT.
- (6) REMOVE EXISTING THERMOSTAT LOCATED IN OFFICE AND ALL ASSOCIATED CONTROL WIRING.
- 7 REMOVE EXISTING NATURAL GAS FIRED HOT AIR FURNACE AND ALL ASSOCIATED DUCTWORK, CONTROLS AND AIR DEVICES.
- 8 REMOVE EXISTING EXHAUST FLUE WALL/ROOF SERVING FURNACE. COORDINATE WITH GENERAL CONTRACTOR FOR PATCHING OF EXISTING WALL/ROOF.
- (9) REMOVE EXISTING AIR TRANSFER GRILLE. COORDINATE WITH GENERAL CONTRACTOR FOR PATCHING/INFILL OF EXISTING WALL OPENING.
- (10) REMOVE EXISTING SUPPLY AIR GRILLE AND ALL ASSOCIATED DUCTWORK. COORDINATE WITH GENERAL CONTRACTOR FOR PATCHING/INFILL OF EXISTING WALL OPENING.
- (11) REMOVE EXISTING RETURN AIR GRILLE AND ALL ASSOCIATED DUCTWORK. COORDINATE WITH

GENERAL CONTRACTOR FOR PATCHING/INFILL OF EXISTING WALL OPENING.

- REMOVE EXISTING CEILING DIFFUSER AND ALL ASSOCIATED DUCTWORK. COORDINATE WITH GENERAL CONTRACTOR FOR PATCHING/INFILL OF EXISTING CEILING OPENING.
- $\langle$ 13 $\rangle$  REMOVE EXISTING EXHAUST REGISTER AND ALL ASSOCIATED DUCTWORK AND EXHAUST FAN. COORDINATE WITH GENERAL CONTRACTOR FOR PATCHING/INFILL OF EXISTING CEILING AND/OR
- (14) REMOVE EXISTING OUTSIDE AIR REGISTER AND ALL ASSOCIATED DUCTWORK. COORDINATE WITH

GENERAL CONTRACTOR FOR PATCHING/INFILL OF EXISTING CEILING OPENING.

(15) REMOVE EXISTING OUTSIDE AIR LOUVER AND SCREEN. COORDINATE WITH GENERAL CONTRACTOR FOR PATCHING/INFILL OF EXISTING WALL.



DESCRIPTION

PROJECT COORDINATOR

Philadelphia Parks & Recreation and Department of Public Property 1515 Arch Street, 11th Floor Philadelphia, PA 19102 Contact: Charles Mottershead, 215.683-4466

SEAL

REVISIONS

ISSUE DATE



### **PROJECT TEAM**

### ARCHITECT:

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### **SYSTEMS ENGINEER:**

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CITY OF PHILADELPHIA

DEPARTMENT OF PUBLIC PROPERTY 1515 ARCH STREET 11TH FLOOR, ONE PARKWAY BUILDING

PROJECT TITLE MILES MACK PLAYGROUND BUILDING RENOVATION

PHILADELPHIA, PENNSYLVANIA

DRAWING TITLE


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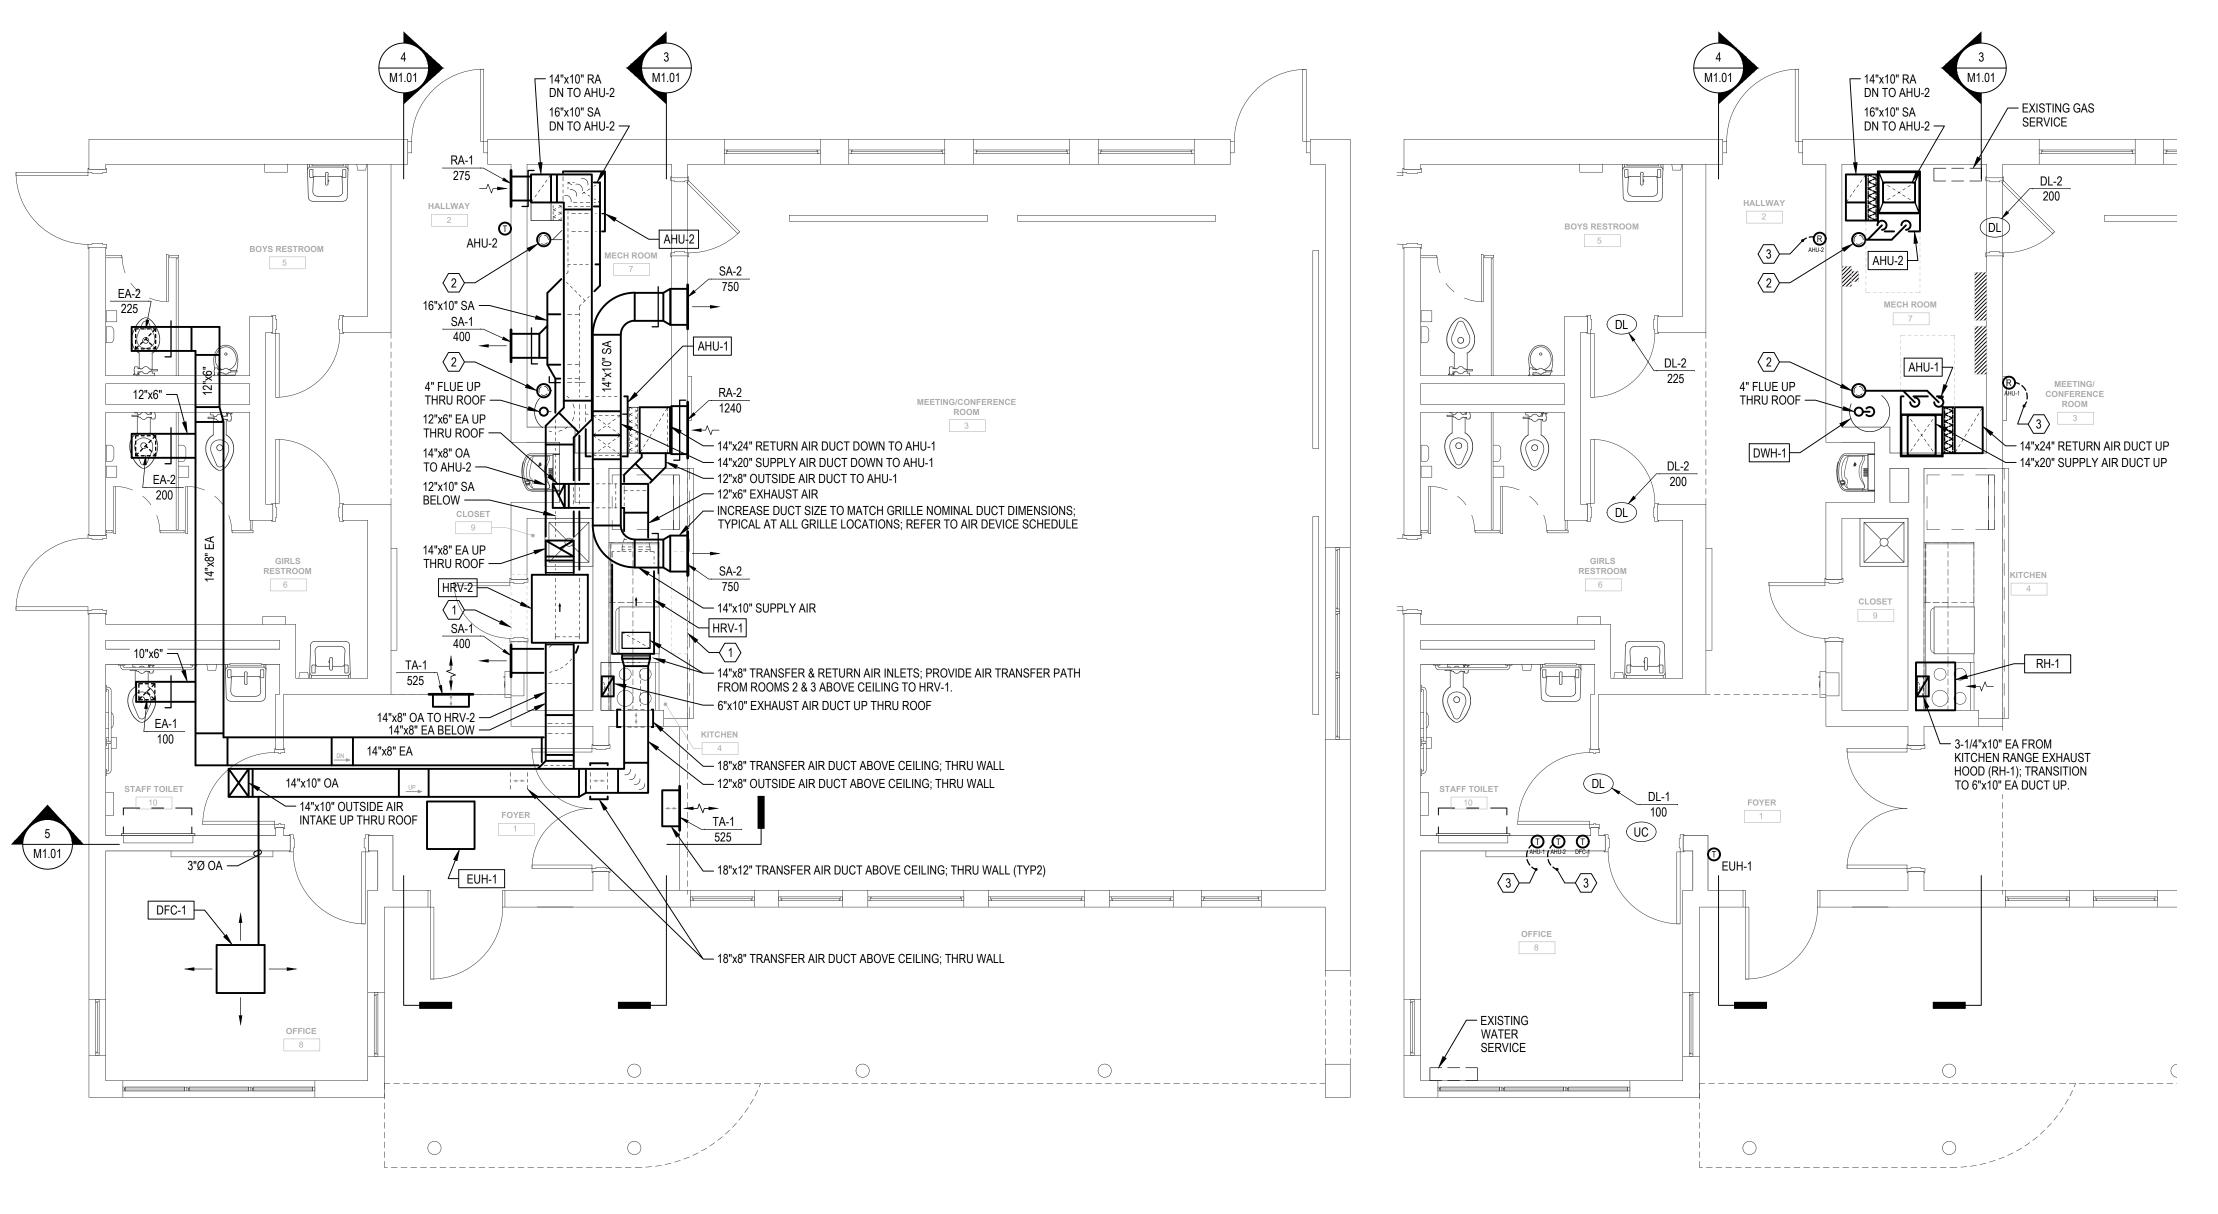
FLOOR PLAN - MECHANICAL DEMOLITION

PROJECT NO. DRAWING NO. 18-00355-001 MD1.01 DATE: 02.07.2020

SCALE: AS NOTED GSC FILE

NOTE: ALL DIMENSIONS AND CONDITIONS SHALL BE VERIFIED BY THE CONTRACTOR AT
THE SITE BEFORE PROCEEDING WITH THE



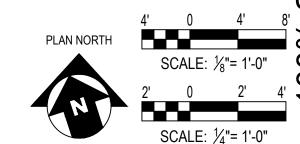

M1.01 SCALE: 1/4" = 1'-0"


M1.01 | SCALE: 1/4" = 1'-0"

### **GENERAL SHEET NOTES:**

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- 3. DO NOT LOCATE DUCTWORK OR PIPING ABOVE ELECTRICAL PANELS OR EQUIPMENT.
- 4. ALL EXPOSED DUCTWORK PROPOSED SHALL BE INSULATED AND WRAPPED WITH AN ALUMINUM JACKET; REFER TO SPECIFICATIONS FOR DETAILS.
- 5. COORDINATE DUCTWORK INSTALLATION WITH LIGHT FIXTURES; SEE ELECTRICAL DRAWINGS FOR PROPOSED LIGHT LOCATIONS.

### SHEET KEYNOTES:

- 1 PROVIDE ACCESS THRU EXISTING WALL FOR EQUIPMENT MAINTENANCE; COORDINATE OPENING LOCATION AND SIZE WITH APPROVED EQUIPMENT SELECTION AND STRUCTURAL; PROVIDE REMOVABLE PANEL; COORDINATE PANEL CONSTRUCTION WITH ARCHITECT.
- 2 PROVIDE DIRECT VENT EXHAUST & INTAKE AIR CONCENTRIC ROOFTOP TERMINATION FOR AHU; COORDINATE SIZE WITH APPROVED EQUIPMENT SELECTION. INSTALL EXHAUST AND INTAKE AIR PIPING FROM AHU TO TERMINATION PER MANUFACTURERS INSTALLATION MANUAL.
- (3) PROVIDE REMOTE TEMPERATURE SENSOR WITH LOCKABLE COVER; CONNECT TO THERMOSTAT LOCATED IN OFFICE (ROOM 8).

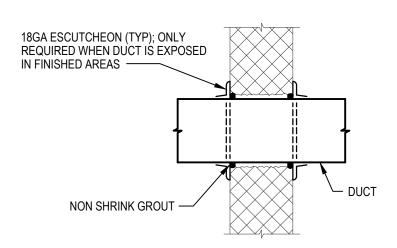

NOTES: 1. THIS DETAIL APPLIES TO BOTH INSULATED AND NON-INSULATED DUCT.


UPPER ROOF

LOWER ROOF

15' - 0"

DUCT THROUGH MASONRY WALL M1.01 SCALE: NTS



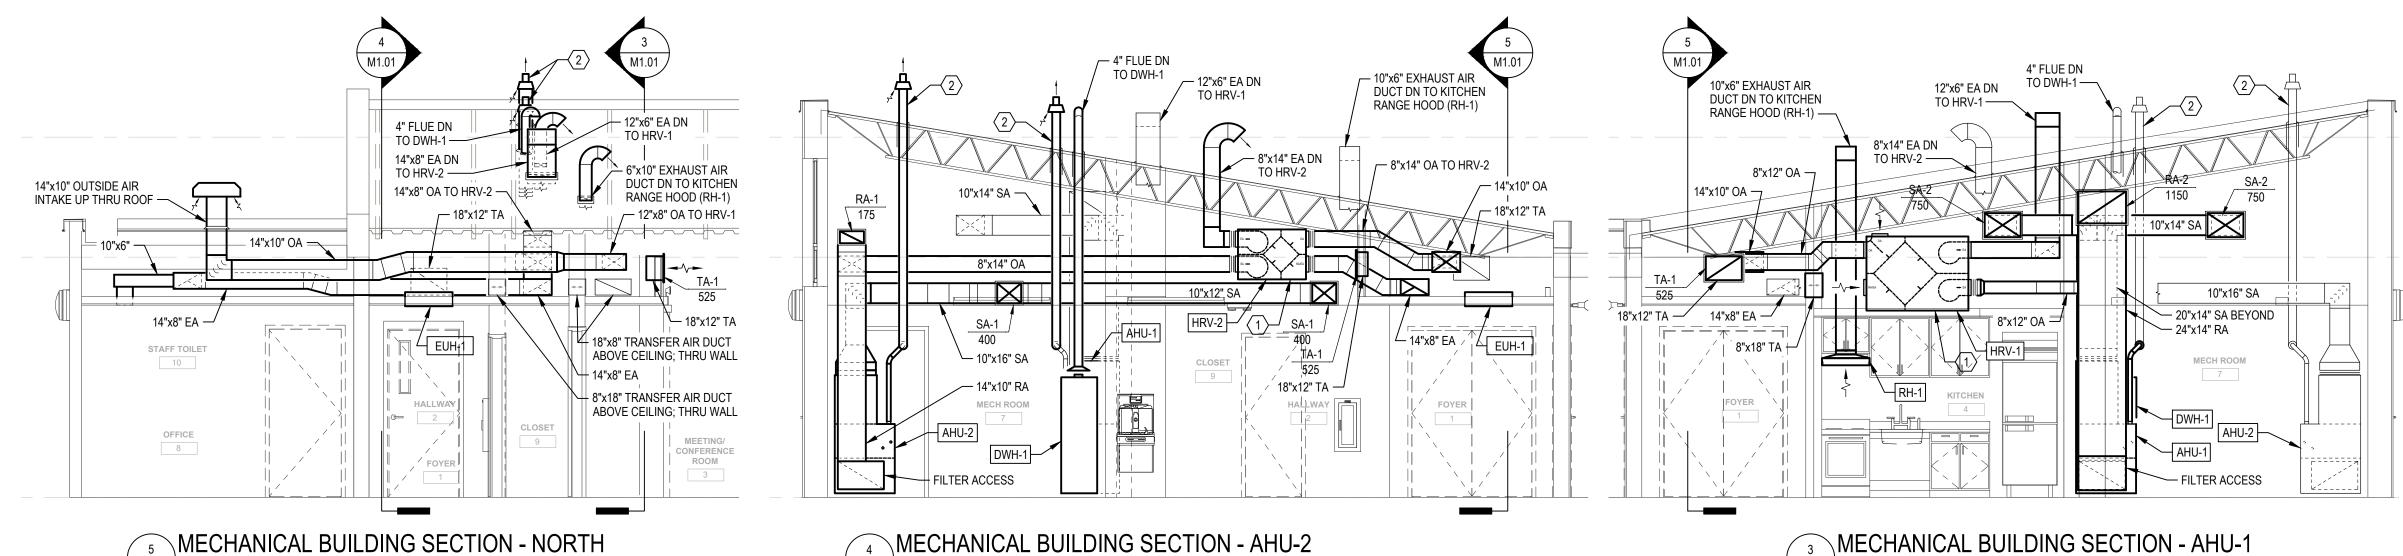

M1.01 | SCALE: 1/4" = 1'-0"

MECHANICAL BUILDING SECTION - AHU-1 M1.01 | SCALE: 1/4" = 1'-0"





DESCRIPTION

PROJECT COORDINATOR

Philadelphia Parks & Recreation and Department of Public Property 1515 Arch Street, 11th Floor Philadelphia, PA 19102 Contact: Charles Mottershead, 215.683-4466

SEAL

REVISIONS

ISSUE DATE



### **PROJECT TEAM**

### ARCHITECT:

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### **SYSTEMS ENGINEER:**

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CITY OF PHILADELPHIA DEPARTMENT OF PUBLIC PROPERTY

1515 ARCH STREET 11TH FLOOR, ONE PARKWAY BUILDING PHILADELPHIA, PENNSYLVANIA

PROJECT TITLE MILES MACK PLAYGROUND BUILDING RENOVATION

DRAWING TITLE


7

FLOOR PLAN - MECHANICAL


PROJECT NO. DRAWING NO. 18-00355-001 M1.01DATE: 02.07.2020


SCALE: AS NOTED DRAWN BY:

CHECKED BY: GSC | FILE: NOTE: ALL DIMENSIONS AND CONDITIONS SHALL BE VERIFIED BY THE CONTRACTOR AT THE SITE BEFORE PROCEEDING WITH THE

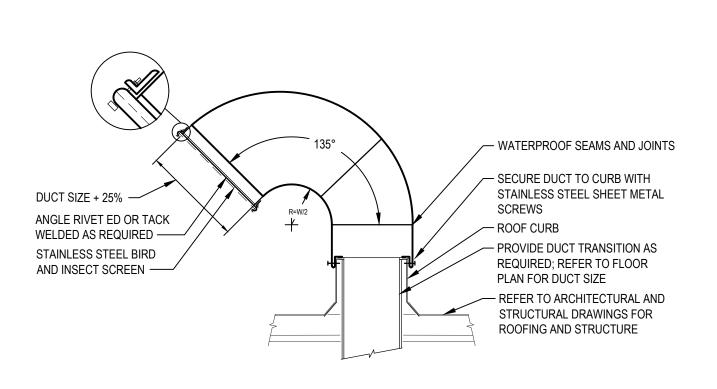



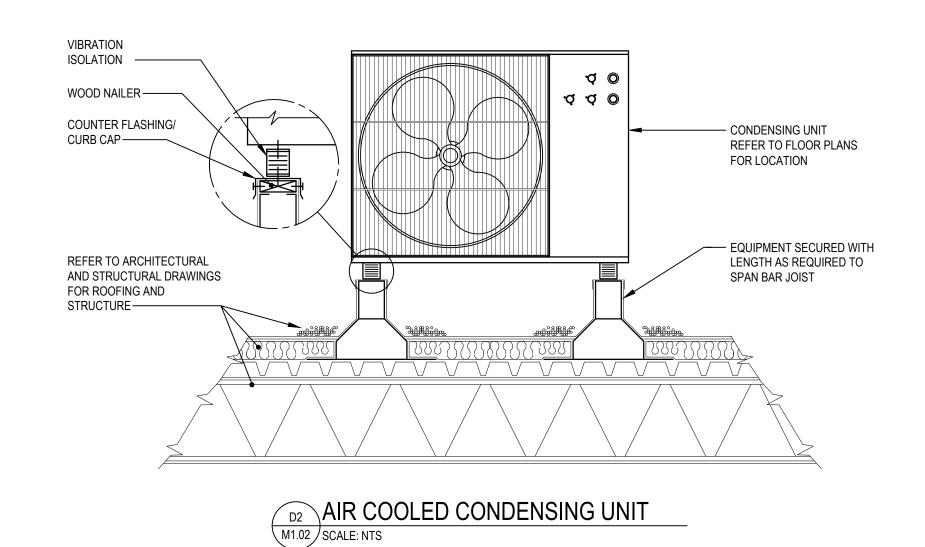

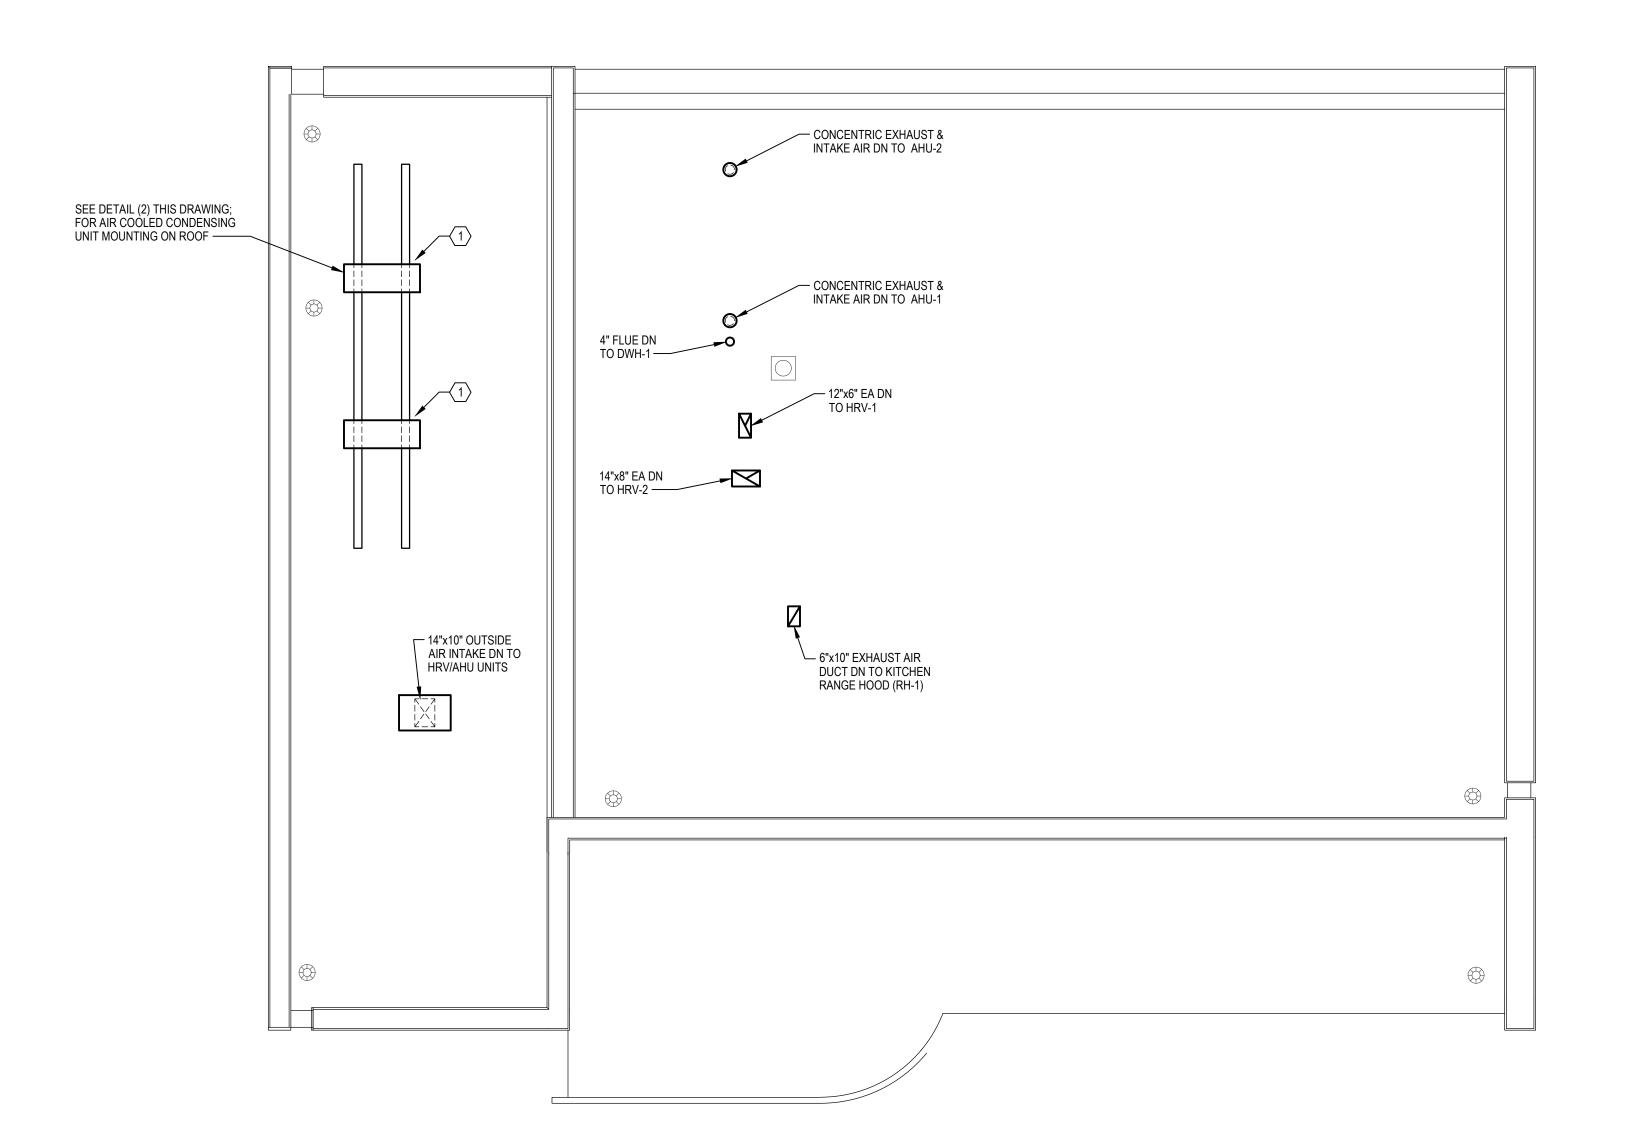





### **GENERAL SHEET NOTES:**

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- 5. COORDINATE DUCTWORK INSTALLATION WITH LIGHT FIXTURES; SEE ELECTRICAL DRAWINGS FOR PROPOSED LIGHT LOCATIONS.

### SHEET KEYNOTES:

1 PROVIDE ROOF PENETRATION HOUSING FOR ALL REFRIGERANT PIPING PENETRATING ROOF.

DESCRIPTION

PROJECT COORDINATOR

REVISIONS

ISSUE DATE

Philadelphia Parks & Recreation and Department of Public Property 1515 Arch Street, 11th Floor Philadelphia, PA 19102 Contact: Charles Mottershead, 215.683-4466

SEAL



### PROJECT TEAM

### ARCHITECT:

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CITY OF PHILADELPHIA

DEPARTMENT OF PUBLIC PROPERTY 1515 ARCH STREET 11TH FLOOR, ONE PARKWAY BUILDING

PHILADELPHIA, PENNSYLVANIA PROJECT TITLE MILES MACK PLAYGROUND BUILDING

DRAWING TITLE

RENOVATION

2

ROOF PLAN - MECHANICAL

DRAWING NO.

M1.02

PROJECT NO. 18-00355-001

DATE: 02.07.2020

SCALE: AS NOTED DRAWN BY:

GSC FILE: CHECKED BY: NOTE: ALL DIMENSIONS AND CONDITIONS SHALL BE VERIFIED BY THE CONTRACTOR AT THE SITE BEFORE PROCEEDING WITH THE WORK.

												IN	DOOF	AIR H	AND	LING	UNI	TSC	HEDU	LE													
				SUPPL	Y FAN		HEATIN	G CHARAC	ERISTICS		N	ATURAL GAS					COOLI	ING CHAF	RACTERIST	ICS			FILTE	,	DIMEN	SIONS	SHIPPING	Е	LECTRICA	AL		INTEGRATE W	
DESIG.	SERVES	LOCATION	CFM	OA	ESP	MOTOR	OAT	EAT LAT	MBH	MBH	THERMAL	SUPPLY	INTAKE	EXHAUST	OAT	(°F)	EAT (°	°F)	LAT (°F)	ME	ВН	SEER	FILICI	` [	H W	/ D	WEIGHT	V/PH	MCA	MOCP	BASIS	CONDENSING	NOTES
			CFIVI	CFM	IN H <sub>2</sub> 0	HP	(°F)	(°F) (°F)	SENS	INPUT	EFFICENCY	PRESSURE	(DIA)	(DIA)	DB	WB	DB	WB [	OB WB	SENS	TOTAL		TYPE	SIZE	(IN) (IN	1) (IN) [	(LBS)	7 V/FN	IVICA	IVIOCE		UNIT	
AHU-1	MEETING ROOM	MECHANICAL RM	1,500	260	0.43	1	11	30 115	29	132	98%	7" - 12"	2"	2"	92	75	77	68 5	55 -	31	53	15	MERV 16	4"	60 25	5 30	350	230/1	35.6	60	LENNOX CBX	ACCU-1	1, 2, 3
AHU-2	RESTROOMS	MECHANICAL RM	800	525	0.48	3/4	11	45 120	17	88	98%	7" - 12"	2"	2"	92	75	78	68 5	55 -	28	35	15	MERV 16	4"	59 2 <sup>-</sup>	1 30	250	230/1	20.8	35	LENNOX CBX	ACCU-2	1, 2, 3
NOTEO:	·																																

1.) REFER TO CONTROLS SEQUENCE AND SPECIFICATIONS FOR MORE INFORMATION.

2.) OUTSIDE AIR TEMPERATURES ARE PROVIDED BY HEAT RECOVERY VENTILATOR DATA.

3.) PROVIDE MANUFACTURERS STANDARD WIRED WALL THERMOSTAT AND REMOTE TEMPERATURE SENSOR FOR EACH UNIT AS SHOWN ON THE DRAWINGS.

										HE	AT R	ECO'	VERY	/ VEN	NTILATO	R S	CHE	DUL	E											
DEGIC	CEDVEC	LOCATION	SL	JPPLY FA	١N	SUPP FILTE		EXI	HAUST F	AN			E POINT TRICAL				NTHALF RECOVE			1		NTHALF RECOVER			DIME	ENSION	S	SHIPPING WEIGHT	DACIC	NOTEC
DESIG.	SERVES	LOCATION	OEM	ESP	MOTOR	1 1616	.1\	OEM	ESP	MOTOR		CONN	ECTION		THERMAL	OAT	(°F)	LAT	(°F)	THERMAL	OAT	(°F)	LAT	(°F)	L	D	Н	WEIGHT	BASIS	NOTES
			CFM	IN H₂0	TYPE	TYPE	SIZE	CFM	IN H <sub>2</sub> 0	TYPE	V/PH	MCA	MOP	WATTS	EFFICIENCY	DB	WB	DB	WB	EFFICIENCY	DB	WB	DB	WB	(IN)	(IN) (	IN)	(LBS)		
HRV-1	AHU-1	ABOVE KITCHENET	260	0.25	PSC	MERV 7	1"	260	0.12	PSC	120/1	6.63	9.13	330	40%	35	-	11	-	18%	95	75	92	75	51	21	41	225	BROAN B1600705	1, 2, 3, 4, 5, 6, 7, 8
HRV-2	AHU-2	ABOVE CLOSET	525	0.12	PSC	MERV 8	1"	252	0.33	PSC	120/1	9.50	12.00	640	36%	35	-	11	-	20%	95	75	92	75	34	29	25	180	BROAN B6LC	1, 2, 3, 4, 5, 6, 7, 8

1.) REFER TO CONTROLS SEQUENCE AND SPECIFICATIONS FOR MORE INFORMATION.

2.) PROVIDE FACTORY INSTALLED SPEED CONTROLLER ON EACH MOTOR.

3.) PROVIDE FACTORY INSTALLED FREEZE-STAT. REFER TO CONTROLS DRAWING M7.01 FOR FREEZE-STAT LOCATION.

4.) PROVIDE FACTORY INSTALLED ENTHALPIC PLATE HEAT EXCHANGER.

5.) PROVIDE VIBRATION ISOLATION.

6.) SIZE HEAT EXCHANGER USING THE CRITERIA INDICATED IN THE "ENTHALPIC ENERGY RECOVERY" COLUMNS.

7.) LEAVING AIR TEMPERATURE OF THE HEAT EXCHANGER IS PURPOSELY AT VARIANCE WITH THE ENTERING AIR TEMPERATURE OF THE COIL TO ACCOUNT FOR HEAT EXCHANGE INEFFICIENCIES DEVELOPED OVER THE LIFE OF THE UNIT.

8.) DISCONNECT PROVIDED UNDER DIVISION 26.

								AIR C	OOLED	CON	DENSI	NG U	NIT S	SCHE	DULE				
DESIG.   COMPRESSOR   FAN   RANGE   INDOOR   OUTDOOR   CAPACITY   RANGE   INDOOR   DB   DB   DB   DB   DB   DB   DB   D					C00	LING			HEA	TING							ASHRAE 15/34 C	COMPLIANCE <sup>3</sup>	
RANGE   INDOOR   OUTDOOR   CAPACITY   RANGE   INDOOR   OUTDOOR   CAPACITY   RANGE   INDOOR   OUTDOOR   CAPACITY   CAPACITY   RANGE   INDOOR   OUTDOOR   CAPACITY   CAPACITY   CAPACITY   CAPACITY   VOLUME   CAPACITY   VOLUME   CAPACITY   CAPA	DESIG.	COMPRESSOR	FAN	OPER								EI	ECTRICA	AL.					
(No.)         (No.)         (°F)         (°F)         (MBH)         (°F)         (°F)         (°F)         (°F)         (MBH)         V/PH         MOCP         MCA         (LBS)         (LBS)         (CU FT)           ACCU-1         1         2         23 - 122         80/67         95         60         (-13) - 61         70         47/43         64         240/1         40         25.4         300         LG MULTI V S (ARUN060GSS4)         7.7         296         1, 2, 3, 4, 5, 6, 7, 8			. ,				CAPACITY				CAPACITY				WEIGHT	BASIS			NOTES
ACCU-1 1 2 23 - 122 80/67 95 60 (-13) - 61 70 47/43 64 240/1 40 25.4 300 LG MULTI V S (ARUN060GSS4) 7.7 296 1, 2, 3, 4, 5, 6, 7, 8				DB	DB/WB	DB		WB	DB	DB/WB							CAPACITY	VOLUME	
		(No.)	(No.)	(°F)	(°F)	(°F)	(MBH)	(°F)	(°F)	(°F)	(MBH)	V/PH	MOCP	MCA	(LBS)		(LBS)	(CU FT)	
ACCU2 1 0 00 100 0007 05 00 (10) 04 70 $A7/42$ 04 040/4 40 054 000 LCMIITIV C (ADUNOCOCCA) 77 000 1.0.2.4.5.6.7.0	ACCU-1	1	2	23 - 122	80/67	95	60	(-13) - 61	70	47/43	64	240/1	40	25.4	300	LG MULTI V S (ARUN060GSS4)	7.7	296	1, 2, 3, 4, 5, 6, 7, 8
ACCU-2 1 2 23 - 122 80/07 95 60 (-13) - 61 70 47/43 64 240/1 40 25.4 300 LG MULTIV S (ARUN000GSS4) 7.7 296 1, 2, 3, 4, 5, 6, 7, 6	ACCU-2	1	2	23 - 122	80/67	95	60	(-13) - 61	70	47/43	64	240/1	40	25.4	300	LG MULTI V S (ARUN060GSS4)	7.7	296	1, 2, 3, 4, 5, 6, 7, 8

1.) VRF HEAT PUMP UNIT; REFER TO CONTROL SEQUENCE AND SPECIFICATIONS FOR MORE INFORMATION.

2.) CONDENSATE SHALL DRAIN TO ROOF.

3.) INTEGRATE WITH INDOOR UNIT CONTROL SYSTEM AND PROVIDE CENTRAL ACCESS THROUGH OFFICE COMPUTER.

4.) MINIMUM ROOM VOLUME CALCULATION BASED ON 26 LBS/1000 CU FT (ASHRAE 34 MAXIMUM RCL)

5.) PROVIDE HAIL GUARD KIT, LOW AMBIENT BAFFLE KIT, AND DRAIN PAN HEATER.

6.) CONTRACTOR IS RESPONSIBLE FOR VERIFICATION OF PIPING ROUTING AND REQUIRED LENGTHS.

7.) CONFIRM REFRIGERANT VOLUME WITH FINAL LAYOUT AND VERIFY ASHRAE 15/34 COMPLIANCE. 8.) ESTIMATED MAXIMUM SYSTEM LENGTHS: 1/4:1/2 - 64 FT; 3/8:5/8 - 26; 3/8:3/4 - 30

					DU	ICTL	ES	SF	AN C	COIL	_ UN	NIT S	CHE	DULE			
DESIG	S. SERVICE	STYLE	AIRFLOW (CFM)	SENSIBLE (MBH)	COOL TOTAL (MBH)		` '		TOTAL		LAT	ELECT V/PH		REFRIG	BASIS	NOTES	INTEGRATE W/ CONDENSING UNIT
DFC-	1 OFFICE	CEILING CASSETTE	283	6.0	7.4	72	60	52	9.8	68	100	240/1	0.20	R-410A	LG MULTI V S 4-WAY (ARNU093TRD4)	1, 2, 3, 4, 5, 6, 7	ACCU-2

NOTES: 1.) REFER TO CONTROL SEQUENCE AND SPECIFICATIONS FOR MORE INFORMATION.

2.) PROVIDE TRIM RING FOR RECESSED MOUNTING ON PERMANENT CEILING.

3.) PROVIDE FIELD INSTALLED POWER DISCONNECT SWITCH.

2.) PROVIDE UNIT WITH INTEGRAL CONDENSATE PUMP AND 3"DIA. OUTSIDE AIR CONNECTION.

3.) PROVIDE MANUFACTURERS STANDARD WIRED WALL THERMOSTAT FOR EACH UNIT AS SHOWN ON THE DRAWINGS.

4.) INTEGRATE WITH OUTDOOR UNIT CONTROL SYSTEM AND PROVIDE CENTRAL ACCESS THROUGH OFFICE COMPUTER.

5.) REFER TO ACCU SCHEDULE FOR MINIMUM ROOM VOLUME CALCULATION BASED ON ASHRAE 34 MAXIMUM RCL. 6.) CONTRACTOR IS RESPONSIBLE FOR VERIFICATION OF PIPING ROUTING AND REQUIRED LENGTHS.

7.) CONFIRM REFRIGERANT VOLUME WITH FINAL LAYOUT AND VERIFY ASHRAE 15/34 COMPLIANCE.

DESIG.	NOMINAL CFM	BTU/H	RPM	ELECTRICAL VOLT/PH	KW	AMPS	TYPE	BASIS	NOTE
EUH-1	300	13,700	1,400	240/1	4	19.2	CEILING	QMARK CDF 500 SERIES	1, 2, 3

MISCELLANEOUS EQUIPMENT SCHEDULE									
DESIG.	DESIG. DESCRIPTION								
<u>EEVP</u>	ELECTRONIC EXPANSION VALVE PANEL AHU COMMUNICATIONS KIT; POWERED BY ICP (12 VDC)	LG PRLK048A0							
<u>ICP</u>	INTERFACE CONTROLLER PANEL AHU COMMUNICATIONS KIT; 230V/1PH	LG PAHCMR000							
<u>RH-1</u>	RANGE HOOD  24" STAINLESS STEEL RANGE HOOD WITH INTERGRAL LIGHTS AND EXHAUST FAN;  120V/1Ø, 1.40 AMPS, 230 CFM (HIGH) / 110 CFM (LOW), 3 1/4" x 10" HORIZONTAL DUCT  CONNECTION. HOOD WILL BE OPERATED BY UNIT MOUNTED SWITCH; DAMPER  ASSEMBLY INCLUDED; PROVIDE ROOF PENETRATION AND TERMINATE ABOVE ROOF  WITH GOOSENECK; REFER TO DRAWINGS FOR LOCATION AND DUCT SIZE.	BROAN BCSEK130SS							

	AIR DEVICE SCHEDULE													
DESIG.	DUTY	TYPE	NECK SIZE	CFM RANGE	MAX NOISE CRITERIA	BASIS	NOTES							
SA-1	SUPPLY	GRILLE	12 x 10	400	25	TITUS 271RL	1, 2, 3							
SA-2	SUPPLY	GRILLE	18 x 12	750	25	TITUS 271RL	1, 2, 3							
RA-1	RETURN	GRILLE	12 x 8	275	20	TITUS 350FL	1, 2							
RA-2	RETURN	GRILLE	24 x 16	1240	20	TITUS 350FL	1, 2							
EA-1	EXHAUST	GRILLE	8 x 8	100	20	TITUS 350FL	1, 2							
EA-2	EXHAUST	GRILLE	10 x 10	200 - 225	20	TITUS 350FL	1, 2							
TA-1	TRANSFER	GRILLE	18 x 12	525	20	TITUS 350FL	1, 2							
DL-1	TRANSFER	DOOR LOUVER	14 x 6	100	20	TITUS CT-700	1, 2							
DL-2	TRANSFER	DOOR LOUVER	14 x 14	200 - 225	20	TITUS CT-700	1, 2							

1.) REFER TO SPECIFICATIONS FOR OPTIONS AND ACCESSORIES.

2.) COORDINATE SURFACE MOUNTING OF AIR DEVICE WITH EXISTING CEILING.

3.) PROVIDE WITH ZERO DEGREE DEFLECTION.

DESCRIPTION



PROJECT COORDINATOR

Philadelphia Parks & Recreation and Department of Public Property 1515 Arch Street, 11th Floor Philadelphia, PA 19102 Contact: Charles Mottershead, 215.683-4466

REVISIONS

ISSUE DATE



### PROJECT TEAM

JMT I ARCHITECTURE JOHNSON, MIRMIRAN, AND THOMPSON, INC. 1600 MARKET STREET, SUITE 520 PHILADELPHIA, PA 19103 267.256.0300 I WWW.JMT.COM

### STRUCTURAL ENGINEER:

JOHNSON, MIRMIRAN, AND THOMPSON, INC. 1600 MARKET STREET, SUITE 520 PHILADELPHIA, PA 19103 267.256.0300 I WWW.JMT.COM

### SYSTEMS ENGINEER:

JOHNSON, MIRMIRAN, AND THOMPSON, INC. 1600 MARKET STREET, SUITE 520 PHILADELPHIA, PA 19103 267.256.0300 I WWW.JMT.COM

CITY OF PHILADELPHIA DEPARTMENT OF PUBLIC PROPERTY

1515 ARCH STREET 11TH FLOOR, ONE PARKWAY BUILDING PHILADELPHIA, PENNSYLVANIA

PROJECT TITLE MILES MACK PLAYGROUND BUILDING

### DRAWING TITLE


WORK.


SCHEDULES - MECHANICAL

PROJECT NO.		DRAWING NO.
18-00355-001		
DATE: 02.07.2020		M6.01
SCALE: AS NOTED		1010.01
DDAWN DV:	MMR	

GSC FILE: CHECKED BY: NOTE: ALL DIMENSIONS AND CONDITIONS SHALL BE VERIFIED BY THE CONTRACTOR AT THE SITE BEFORE PROCEEDING WITH THE

RENOVATION 7 00

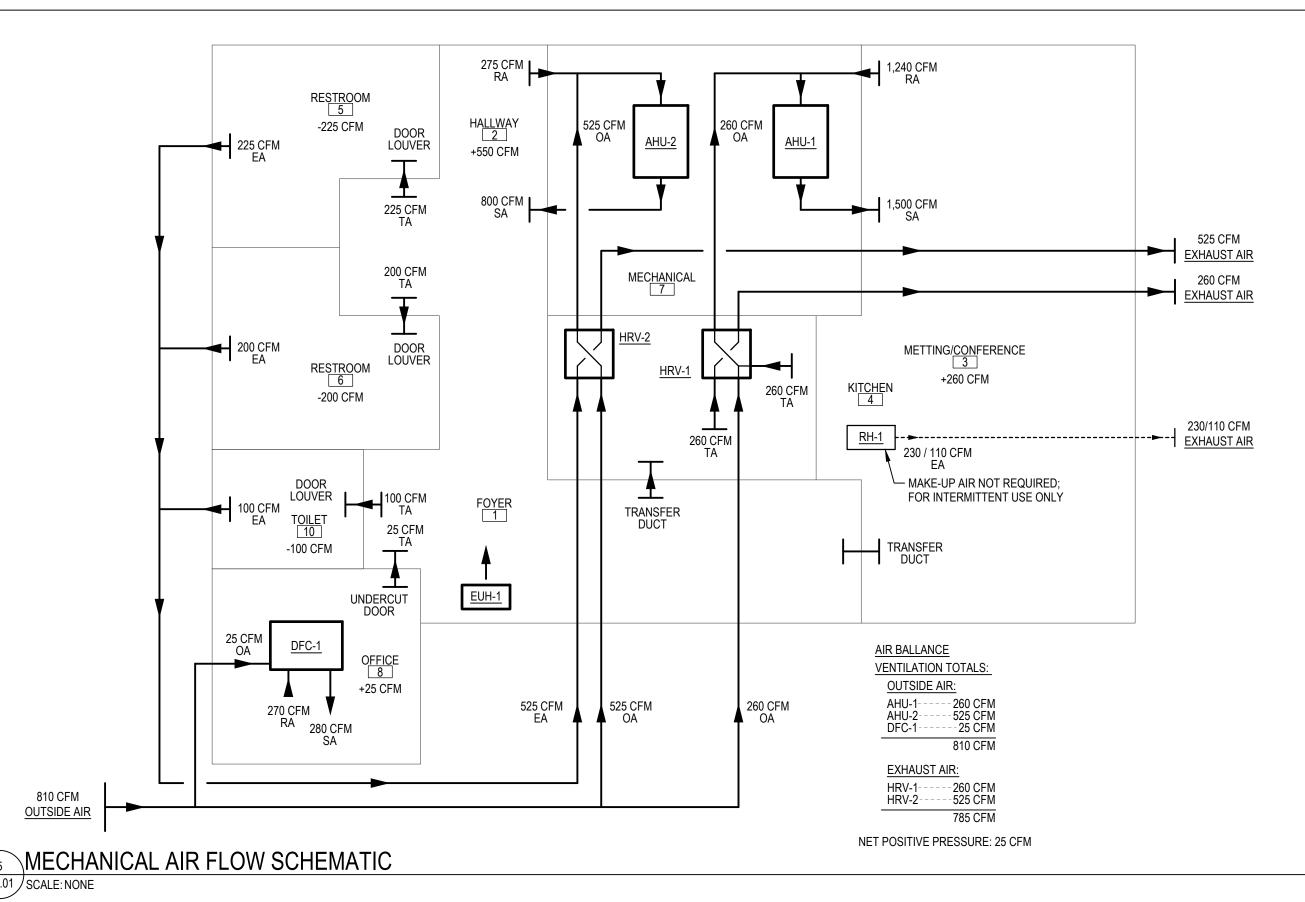

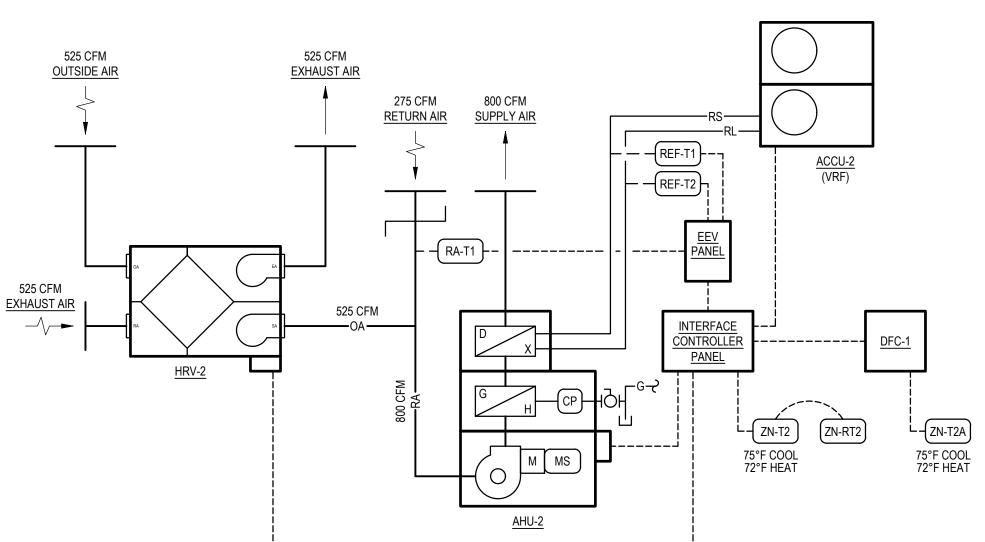

# VRF AIR HANDLING UNIT (AHU-1) WITH HEAT RECOVERY (HRV-1)

-----

260 CFM

OUTSIDE AIR

260 CFM

EXHAUST AIR

DEFROST AIR

A.1. THIS SEQUENCE APPLIES TO AHU-1, HRV-1, AND VRF-1. CONTROL OF THIS SYSTEM WILL BE THROUGH THE WALL MOUNTED CONTROLLER/THERMOSTAT (ZN-T1) WHICH IS A SELF-CONTAINED CONTROLLER TYPICALLY PROVIDED BY THE VRF SYSTEM MANUFACTURER. REFER TO THE VRF SYSTEM MANUFACTURERS PRODUCTS AND THEIR INSTALLATION REQUIREMENTS FOR VARIATIONS ON THE BELOW SEQUENCE. AHU-1 IS CONNECTED TO THE SYSTEM THROUGH AN ELECTRONIC EXPANSION VALVE (EEV) AND A VRF SYSTEM CONTROL GATEWAY ADAPTOR. THIS BUILDING DOES NOT HAVE A COMMERCIAL BUILDING AUTOMATION SYSTEM.

260 CFM

EXHAUST AIR

260 CFM

1,240 CFM

RETURN AIR

- RA-T1 -

1,500 CFM

SUPPLY AIR

\_\_\_\_\_

B.1. VRF SYSTEM EQUIPMENT COMMUNICATION IS ACCOMPLISHED THROUGH A TWO-WIRE, TWISTED, STRANDED, AND SHIELDED CONDUCTOR SYSTEM. DAISY CHANIED FROM COMPONENT TO COMPONENT AND TO THE CONTROLLER/THERMOSTAT AS A LOCAL

B. SYSTEM ARCHITECTURE (GENERAL LAYOUT)

BUS. THE OUTDOOR UNIT TYPICALLY FUNCTIONS AS THE MASTER AND ALL OTHER COMPONENTS ARE SET AS SLAVES. THE CONTROLLER/THERMOSTAT CONTAINS AN ETHERNET/IP OR BACnet CONNECTION FOR SERVICE OR FUTURE CONNECTION TO PPR'S CITY NETWORK FOR REMOTE MONITORING.

B.2. AHU-1 IS CONNECTED TO THE VRF SYSTEM THROUGH AN INTERFACE ADAPTION CONTROLLER TO MATE THE UNITS CONTROLS WITH THE VRF SYSTEM PROTOCOL AND THROUGH AN ELECTRONIC EXPANSION VALVE KIT TO MATE THE REFRIGERANT SYSTEM WITH THE VRF SYSTEM CONFIGURATION AND CONTROL.

C.1. THE VRF SYSTEM AND/OR ZONE THERMOSTAT SHALL DETERMINE OCCUPIED/UNOCCUPIED STATUS AS SCHEDULED (OCCUPIED 5:00 AM TO 8:00 PM, SEVEN DAYS A WEEK (ADJ.)) OR THORUGH MANUAL ACTIVATION (OVERRIDE) PERFORMED AT THE ZONE THERMOSTAT. HRV-1 SHALL BE ENABLED WITH AHU-1 TO PROVIDE VENTILATION THROUGH THE VRF SYSTEMS STANDARD VENTILATION PROGRAM. REFER TO VENTILATION PARAGRAPH FOR REQUIRED SEQUENCES OF HRV-1. SIMULTANEOUS HEATING AND COOLING OF THE SPACES MUST NOT BE PERMITTED.

### D. OCCUPIED/UNOCCUPIED MODE

INTERFACE

D.1. DURING OCCUPIED MODE, THE VRF SYSTEM AND/OR ZONE THERMOSTAT SHALL MONITOR ZONE TEMPERATURE (ZN-T1) AND COMPARE TO THE ZONE SETPOINT AND THE OUTDOOR TEMPERATURE (OD-T).

72°F HEAT

D.2. DURING OCCUPIED PERIOD, THE VRF SYSTEM AND/OR ZONE THERMOSTAT SHALL OPERATE IN AUTO MODE (DUAL SET POINT FUNCTION) TO AUTOMATICALLY SWITCH BETWEEN COOLING AND HEATING SERVICE. ALL SYSTEM SETPOINTS SHALL BE SET AS FOLLOWS:

D.2.1. COOLING SERVICE SETPOINT - 72 °F (ADJ., PPR STANDARD) D.2.2. HEATING SERVICE SETPOINT - 70 °F (ADJ., PPR STANDARD) D.2.3. OUTDOOR TEMPERATURE FOR 2nd HEATING STATGE (NATURAL GAS, AHU-1 ONLY) - 30 °F (ADJ.)

D.3. DURING UNOCCUPIED PERIOD, THE VRF SYSTEM AND/OR ZONE THERMOSTAT SHALL OPERATE IN AUTO MODE (DUAL SET POINT FUNCTION) TO AUTOMATICALLY SWITCH BETWEEN COOLING AND HEATING SERVICE. ALL SYSTEM SETPOINTS SHALL BE SET TO A SETBACK TEMPERATURE AS FOLLOWS:

D.3.1. COOLING SETBACK SERVICE SETPOINT - 76 °F (ADJ.) D.3.2. HEATING SETBACK SERVICE SETPOINT - 68 °F (ADJ.) D.3.3. OUTDOOR TEMPERATURE FOR 2nd HEATING STAGE (NATURAL GAS, AHU-1 ONLY) - 30 °F (ADJ.)

VENTILATION SYSTEM OPERATION (AHU-1 AND HRV-1 ONLY) E.1. HEAT RECOVERY VENTILATOR (HRV-1) SHALL BE ACTIVATED DURING OPERATION OF AHU-1. HRV-1 SHALL OPERATE THROUGH INTERNAL CONTROLS TO MAINTAIN RELIABLE OPERATION. HRV-1 SHALL ACTIVATE DEFROST MODE WHEN REQUIRED. THE DESIGN PERMITS DEFROST MODE TO MAINTAIN EXHAUST AIR OPERATION WHILE SHUTTING OFF FRESH AIR SUPPLY FOR 6 MINUTES (ADJ.)

ALARMS/EMERGENCY OPERATION PROVIDE STANDARD VRF SYSTEM AND/OR ZONE THERMOSTAT ALARMS, PROGRAMMED AND COORDINATED WITH THE SETPOINTS AND DESIRED OPERATION ABOVE.

G.1. COORDINATE CONTROL REQUIREMENTS WITH SPECIFIC

SUPPLIER/MANUFACTURER OF VRF SYSTEM.

G.2. PROVIDE DRY CONTACTS IN UNIT CONTROLS FOR SIGNAL FROM FIRE ALARM PANEL TO SHUT UNIT DOWN. G.3. OUTDOOR UNIT IS PROVIDED WITH LOW AMBIENT BAFFLE AND CONTROL KIT. COORDINATE LOW AMBIENT OPERATION SEQUENCE AS REQUIRED FOR PROPER UNIT OPERATION

### VRF AIR HANDLING UNIT (AHU-2) WITH HEAT RECOVERY (HRV-2)

L\_\_\_\_\_\_

A.1. THIS SEQUENCE APPLIES TO AHU-2, DFC-1, HRV-2, AND VRF-2. CONTROL OF THIS SYSTEM WILL BE THROUGH THE WALL MOUNTED CONTROLLER/THERMOSTAT (ZN-T2) WHICH IS A SELF-CONTAINED CONTROLLER TYPICALLY PROVIDED BY THE VRF SYSTEM MANUFACTURER. REFER TO THE VRF SYSTEM MANUFACTURERS PRODUCTS AND THEIR INSTALLATION REQUIREMENTS FOR VARIATIONS ON THE BELOW SEQUENCE. AHU-2 IS CONNECTED TO THE SYSTEM THROUGH AN ELECTRONIC EXPANSION VALVE (EEV) AND A VRF SYSTEM CONTROL GATEWAY ADAPTOR. THIS BUILDING DOES NOT HAVE A COMMERCIAL **BUILDING AUTOMATION SYSTEM.** 

SYSTEM ARCHITECTURE (GENERAL LAYOUT) B.1. VRF SYSTEM EQUIPMENT COMMUNICATION IS ACCOMPLISHED

THROUGH A TWO-WIRE, TWISTED, STRANDED, AND SHEILDED CONDUCTOR SYSTEM, DAISY CHANIED FROM COMPONENT TO COMPONENT AND TO THE CONTROLLER/THERMOSTAT AS A LOCAL BUS. THE OUTDOOR UNIT TYPICALLY FUNCTIONS AS THE MASTER AND ALL OTHER COMPONENTS ARE SET AS SLAVES. THE CONTROLLER/THERMOSTAT CONTAINS AN ETHERNET/IP OR BACnet CONNECTION FOR SERVICE OR FUTURE CONNECTION TO PPR'S CITY NETWORK FOR REMOTE MONITORING.

B.2. DUCTLESS FAN COILS (DFC-1) ARE CONTROLLED LOCALLY BY ZONE THERMOSTATS (ZN-T2A), WHICH ARE WIRED THERMOSTATS CONNECTED DIRECTLY TO EACH DFC. EACH DFC IS ALSO CONNECTED TO THE MAIN COMMUNICATION BUS FOR THE VRF SYSTEM TO INTERFACE WITH THE OUTDOOR UNIT.

B.3. AHU-2 IS CONNECTED TO THE VRF SYSTEM THROUGH AN INTERFACE ADAPTION CONTROLLER TO MATE THE UNITS CONTROLS WITH THE VRF SYSTEM PROTOCOL AND THROUGH AN ELECTRONIC EXPANSION VALVE KIT TO MATE THE REFRIGERANT SYSTEM WITH THE VRF SYSTEM CONFIGURATION AND CONTROL.

C.1. THE VRF SYSTEM AND/OR ZONE THERMOSTAT SHALL DETERMINE OCCUPIED/UNOCCUPIED STATUS AS SCHEDULED (OCCUPIED 5:00 AM TO 8:00 PM, SEVEN DAYS A WEEK (ADJ.)) OR THORUGH MANUAL ACTIVATION (OVERRIDE) PERFORMED AT THE ZONE THERMOSTAT. HRV-2 SHALL BE ENABLED WITH AHU-2 TO PROVIDE VENTILATION THROUGH THE VRF SYSTEMS STANDARD VENTILATION PROGRAM. REFER TO VENTILATION PARAGRAPH FOR REQUIRED SEQUENCES OF HRV-2. SIMULTANEOUS HEATING AND COOLING OF THE SPACES MUST NOT BE PERMITTED.

### D. OCCUPIED/UNOCCUPIED MODE

D.1. DURING OCCUPIED MODE, THE VRF SYSTEM AND/OR ZONE THERMOSTAT SHALL MONITOR ZONE TEMPERATURE (ZN-T2) AND COMPARE TO THE ZONE SETPOINT AND THE OUTDOOR TEMPERATURE (OD-T).

**\ELECTRIC UNIT HEATER (EUH-1** 

M ├ MS ON/OFF

RANGE HOOD (RH-1)

TO OPERATE CONTINUOUSLY.

WHENEVER THE ON/OFF SWITCH IS ENABLED.

**B. EXHAUST FAN OPERATION** 

THE ELECTRIC UNIT HEATER (EUH) IS A CONSTANT VOLUME UNIT EQUIPPED

WITH A CONSTANT VOLUME FAN AND AN ELECTRIC HEATING COIL.

THE EUH SHALL OPERATE THROUGH AN EXTERNAL THERMOSTAT.

THE CONSTANT VOLUME EXHAUST FAN SHALL BE CONTROLLED

HE FAN SHALL OPERATE THROUGH AN INTERNAL ON/OFF SWITCH.

THE FAN SHALL BE MANUALLY CONTROLLED AND ENABLED DIRECTLY

THE EUH SHALL CYCLE THROUGH INTERNAL CONTROLS TO MAINTAIN A ZONE TEMPERATURE SETPOINT OF 70°F (ADJ, +/- 2°F DEADBAND).

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D.2. DURING OCCUPIED PERIOD, THE VRF SYSTEM AND/OR ZONE THERMOSTAT SHALL OPERATE IN AUTO MODE (DUAL SET POINT FUNCTION) TO AUTOMATICALLY SWITCH BETWEEN COOLING AND HEATING SERVICE. ALL SYSTEM SETPOINTS SHALL BE SET AS

D.2.1. COOLING SERVICE SETPOINT - 72 °F (ADJ., PPR STANDARD) D.2.2. HEATING SERVICE SETPOINT - 70 °F (ADJ., PPR STANDARD) D.2.3. OUTDOOR TEMPERATURE FOR 2nd HEATING STATGE (NATURAL GAS, AHU-2 ONLY) - 30 °F (ADJ.)

D.3. DURING UNOCCUPIED PERIOD, THE VRF SYSTEM AND/OR ZONE THERMOSTAT SHALL OPERATE IN AUTO MODE (DUAL SET POINT FUNCTION) TO AUTOMATICALLY SWITCH BETWEEN COOLING AND HEATING SERVICE. ALL SYSTEM SETPOINTS SHALL BE SET TO A SETBACK TEMPERATURE AS FOLLOWS:

D.3.1. COOLING SETBACK SERVICE SETPOINT - 76 °F (ADJ.) D.3.2. HEATING SETBACK SERVICE SETPOINT - 68 °F (ADJ.) D.3.3. OUTDOOR TEMPERATURE FOR 2nd HEATING STAGE (NATURAL GAS, AHU-2 ONLY) - 30 °F (ADJ.)

E. VENTILATION SYSTEM OPERATION (AHU-2 AND HRV-2 ONLY E.1. HEAT RECOVERY VENTILATOR (HRV-2) SHALL BE ACTIVATED DURING OPERATION OF AHU-2. HRV-2 SHALL OPERATE THROUGH INTERNAL CONTROLS TO MAINTAIN RELIABLE OPERATION. HRV-2 SHALL ACTIVATE DEFROST MODE WHEN REQUIRED. THE DESIGN PERMITS DEFROST MODE TO MAINTAIN EXHAUST AIR OPERATION WHILE SHUTTING OFF FRESH AIR SUPPLY FOR 6 MINUTES (ADJ.)

F. ALARMS/EMERGENCY OPERATION F.1. PROVIDE STANDARD VRF SYSTEM AND/OR ZONE THERMOSTAT ALARMS, PROGRAMMED AND COORDINATED WITH THE SETPOINTS AND DESIRED OPERATION ABOVE.

G.1. COORDINATE CONTROL REQUIREMENTS WITH SPECIFIC SUPPLIER/MANUFACTURER OF VRF SYSTEM. 2. PROVIDE DRY CONTACTS IN UNIT CONTROLS FOR SIGNAL FROM

FIRE ALARM PANEL TO SHUT UNIT DOWN. G.3. OUTDOOR UNIT IS PROVIDED WITH LOW AMBIENT BAFFLE AND CONTROL KIT. COORDINATE LOW AMBIENT OPERATION SEQUENCE AS REQUIRED FOR PROPER UNIT OPERATION.

### GENERAL CONTROL NOTES AND REQUIREMENTS:

1. THESE CONTROL DRAWINGS INDICATE SYSTEMS TO BE CONTROLLED BY BAS AND/OR STANDALONE MEANS AS WELL AS INTENDED SEQUENCES OF OPERATION.

2. THE CONTROL SYSTEM SHALL BE FULLY INSTALLED, CALIBRATED, AND ADJUSTED TO PROVIDE ACCURATE AND STABLE SYSTEM OPERATION. CONTROLLED PARAMETERS SHALL BE MAINTAINED WITHIN ACCEPTABLE RANGES AND PID TUNING SHALL BE PERFORMED TO PROVIDE STABLE OPERATION WITHIN 2 MINUTES OF A PARAMETER CHANGE. THE ENGINEER WILL EVALUATE THE SYSTEM TO VERIFY THAT PROPER INSTALLATION AND SYSTEM SETUP/TUNING HAS BEEN PERFORMED ONLY AFTER WRITTEN DOCUMENTATION FROM THE CONTROLS CONTRACTOR, INCLUDING TRENDING DATA, HAS BEEN SUBMITTED INDICATING THAT THE CONTROL INSTALLATION

3. CONTROL SUBMITTALS SHALL INCLUDE SYSTEM SCHEMATICS. WIRING DIAGRAMS, AND CONTROL LOGIC TO BE USED TO ACHIEVE INTENDED SEQUENCES OF OPERATION - SIMPLY REPRODUCING SEQUENCES AS PROVIDED IN THESE DRAWINGS OR SUBMITTING CONTROL SEQUENCES DIRECTLY FROM EQUIPMENT SUBMITTALS WILL NOT BE

4. CONTROLLERS INTEGRATED TO THE BAS SHALL BE NATIVE BACNET.

5. UNLESS OTHERWISE NOTED, MECHANICAL EQUIPMENT SHOWN HEAVY SOLID (——) SHALL BE NEW WORK AND 

6. CONTROL DEVICES SHALL BE INSTALLED IN BOTH NEW AND EXISTING PIPING. COORDINATE WITH MECHANICAL CONTRACTOR TO PROVIDE NECESSARY FITTINGS AND ACCESSORIES.

7. SYSTEMS ARE COMPOSED OF NEW AND EXISTING EQUIPMENT. COORDINATE WITH CONTRACT DOCUMENTS.

8. FINAL POINTS LISTS SHALL BE DEVELOPED BY THE BAS SUPPLIER, BASED ON THE POINTS TABLE, SCHEMATICS, AND SEQUENCES PROVIDED HERE, AND SUBMITTED TO THE ENGINEER FOR REVIEW.

WITH DIVISION 26 REQUIREMENTS. ALL POWER FOR CONTROL SYSTEMS SHALL BE INDEPENDENT OF EQUIPMENT LOW VOLTAGE DC SERVICE UNLESS OTHERWISE DIRECTED.

10. LOW VOLTAGE AND LINE VOLTAGE POWER FOR CONTROL SYSTEMS AND EQUIPMENT SHALL BE PROVIDED BY

ELECTRICAL CONTRACTOR. COORDINATE WITH ELECTRICAL CONTRACTOR FOR ACCESS TO POWER.

CONTRACTOR. SUCH DEVICES ARE SHOWN HERE FOR INDICATION OF CONTROLS INTERLOCKS.

9. POWER FOR CONTROL SYSTEMS AND EQUIPMENT SHALL BE PROVIDED BY BAS CONTRACTOR IN ACCORDANCE

11. ADDRESSABLE DEVICES BEING CONNECTED TO THE FIRE ALARM SYSTEM SHALL BE PROVIDED BY THE FIRE ALARM

12. IN ADDITION TO THE BACNET INTERFACE, VARIABLE FREQUENCY DRIVES SHALL BE HARD WIRED FOR START/STOP, SPEED, AND STATUS.

13. CONTROL END DEVICES FOR AHU'S SHALL BE FACTORY MOUNTED.

ELIMINATE EXCESSIVE START/STOP OR OSCILLATION OF THE EQUIPMENT.

FINAL FAN BALANCING.

14. ACTUATORS, VARIABLE FREQUENCY DRIVES (MOTOR CURRENT), TEMPERATURE SENSORS, HUMIDITY SENSORS AND CURRENT SENSORS SHALL PROVIDE ANALOG INPUTS TO THE BAS.

15. VALVE AND DAMPER ACTUATORS ARE NOTED WITH "NO" AND "NC" FOR NORMALLY OPEN AND NORMALLY CLOSED, INDICATING SPRING RETURN ORIENTATION.

16. WHERE ADJUSTABLE TEMPERATURE SETPOINTS ARE NOT IDENTIFIED, A +/- 2°F DEADBAND (ADJUSTABLE) SHALL BE

17. HEATING SEASON AND COOLING SEASON SHALL BE CALENDAR BASED. HEATING SEASON SHALL BE DECEMBER 1 THROUGH MARCH 31 (ADJUSTABLE). COOLING SEASON SHALL BE APRIL 1 THROUGH NOVEMBER 30 (ADJUSTABLE).

18. ALL SETPOINTS, RESET SCHEDULES AND DEADBANDS IDENTIFIED HEREIN SHALL BE ADJUSTABLE BY THE BUILDING


OPERATOR THROUGH THE BAS INTERFACE ASSOCIATED WITH EACH SYSTEM. 19. VARIABLE FREQUENCY DRIVES SHALL BE HARD WIRED FOR START/STOP, SPEED, STATUS AND SHALL BE USED FOR


20. SETPOINT SHALL BE DEFINED AS A PERFORMANCE STANDARD FOR A COMPONENT OR SYSTEM UNDER CONTROL, WHICH IS ESTABLISHED BY THE CONTROL SYSTEM USER. TYPICALLY, A SETPOINT IS DEFINED WITH AN ACCEPTABLE DEADBAND, TO ALLOW THE MECHANICAL OR ELECTRICAL SYSTEM THE OPPORTUNITY TO DAMPEN OR

21. DEADBAND IS THE ACCEPTABLE RANGE ASSOCIATED WITH THE SETPOINT, IN WHICH THE CONTROL SYSTEM IS SATISFIED WITH NO MECHANICAL OR ELECTRICAL SYSTEM MODULATION NECESSARY FROM THE CONTROL SYSTEM. TYPICALLY, A DEADBAND IS EXPRESSED AS A + AND - RANGE AROUND THE NUMERICAL VALUE OF THE SETPOINT


22. CONTROL SYSTEM PERFORMANCE SHALL BE MEASURED BY THE ENGINEER AND/OR COMMISSIONING AUTHORITY, AND SHALL BE DEFINED AS THE ABILITY OF THE CONTROL SYSTEM TO MEET THE ESTABLISHED SETPOINT WITHIN THE ALLOWABLE DEADBAND WITH STABLE PARAMETER (I.E. TEMPERATURE, POSITION, ETC.) PERFORMANCE. THE CONTROL SYSTEM INSTALLER SHALL PERFORM PROPER LOOP TUNING, IN WHICH THE PROPORTIONAL AND INTEGRAL SETTINGS OF THE CONTROL LOGIC ARE ESTABLISHED WITH THE ACTUAL SYSTEM IN OPERATIONS, TO ACHIEVE THE STABLE PERFORMANCE. THE CONTROL SYSTEM INSTALLER SHALL ALSO ACCEPT THAT EACH CONTROL LOOP SHALL BE TUNED WITH RESPECT TO BOTH UPSTREAM AND DOWNSTREAM CONTROL LOOPS, WHICH MAY AFFECT TUNING REQUIRED TO ACHIEVE THE REQUIRED PERFORMANCE AND STABILITY.

### **CONTROLS ABBREVIATIONS**

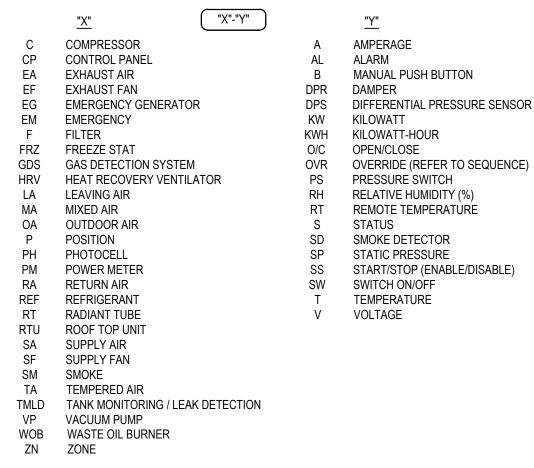

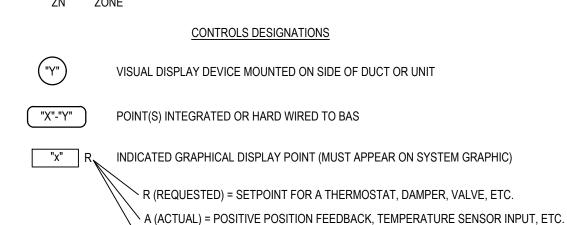

O (ORIGINAL) = VALUE ESTABLISHED DURING INITIAL SYSTEM COMMISSIONING.

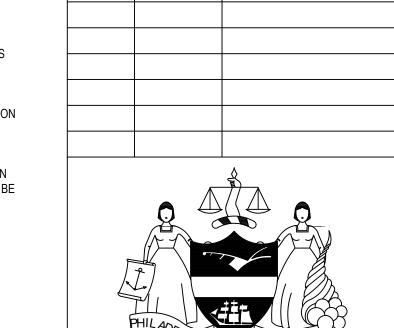

DESCRIPTION

REVISIONS

ISSUE DATE

PROJECT COORDINATOR Philadelphia Parks & Recreation

and Department of Public Property 1515 Arch Street, 11th Floor Philadelphia, PA 19102 Contact: Charles Mottershead, 215.683-4466

SEAL



### **PROJECT TEAM**

### ARCHITECT:

JMT I ARCHITECTURE JOHNSON, MIRMIRAN, AND THOMPSON, INC. 1600 MARKET STREET, SUITE 520 PHILADELPHIA, PA 19103 267.256.0300 I WWW.JMT.COM

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### SYSTEMS ENGINEER:

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CITY OF PHILADELPHIA DEPARTMENT OF PUBLIC PROPERTY

1515 ARCH STREET 11TH FLOOR, ONE PARKWAY BUILDING PHILADELPHIA, PENNSYLVANIA

PROJECT TITLE MILES MACK PLAYGROUND BUILDING RENOVATION

**DRAWING TITLE** 

DRAWN BY:

 $\sim$ 

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CONTROLS - MECHANICAL


PROJECT NO. DRAWING NO.

18-00355-001 DATE: 02.07.2020 M7.01SCALE: AS NOTED


CHECKED BY: GSC | FILE:

NOTE: ALL DIMENSIONS AND CONDITIONS SHALL BE VERIFIED BY THE CONTRACTOR AT THE SITE BEFORE PROCEEDING WITH THE WORK.

MMB

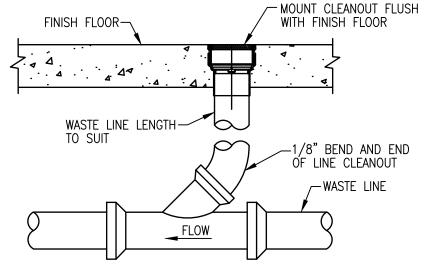

ackslashFLOOR (INTERIOR) CLEANOUT DETAIL P0.01 / SCALE: NOT TO SCALE

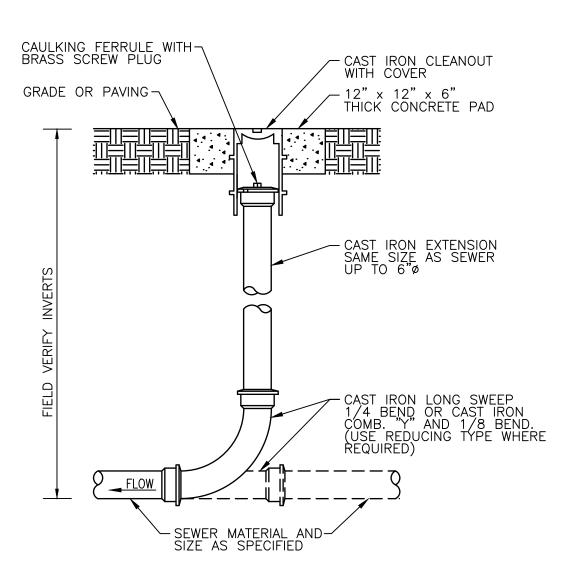



\_\_\_\_

¬GAS FIRED DOMESTIC WATER HEATER DETAIL

SHUT OFF VALVE -

SHUT OFF VALVE -

UNION -

UNION -

THERMOSTATIC MIXING VALVE —

1" HW -

3/4" G ─

P0.01 / SCALE: NOT TO SCALE

4" DIAMETER FLUE EXTEND UP

- SHUT OFF VALVE

— T&P VALVE

-TO NEAREST FLOOR DRAIN

· 4" CONCRETE HOUSEKEEPING PAD


THROUGH ROOF AND TERMINATE

AS REQUIRED BY MANUFACTURER

WATER PIPING. SEE PLANS FOR

EXISTING PIPING

-EXPANSION TANK

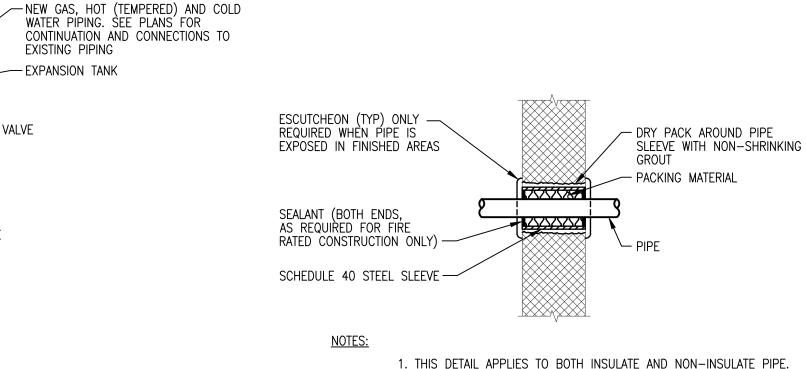

CONDENSATE (SAFEWASTE) DRAIN DETAIL

1. THIS DETAIL APPLIES TO BOTH INSULATE AND NON-INSULATE PIPE.

- FLOOR DRAIN

BALL VALVE

- TRAP PRIMER

WATER LINE

- FINISH FLOOR

— WASTE LINE

FLOOR DRAIN WITH TRAP GUARD DETAIL

PROSET TRAF

GUARD

P-TRAP-

CONDENSATE DRAIN LINE-

VENT LINE-

WASTE LINE —

NOT TO SCALE

NOT TO SCALE

- 2. FOR FIRE RATED CONSTRUCTION PROVIDE APPROPRIATE APPROVED THROUGH-PENETRATION FIRESTOP ASSEMBLY TO MAINTAIN THE FIRE RATING OF THE WALL
- 3. FOR ADDITIONAL REQUIREMENTS REFER TO UL SYSTEM NO. C-AJ-1149



### **ABBREVIATIONS**

APPROX APPROXIMATELY BLDG BUILDING BELOW BTU/HR BRITISH THERMAL UNITS PER HOUR CO CLEANOUT DOMESTIC COLD WATER CW CONNECT TO EXISTING DESG DESIGNATION DRINKING FOUNTAIN DIA, Ø DIAMETER DOWN EX **EXISTING** EXISTING TO REMAIN DEGREES FAHRENHEIT FLOOR DRAIN FEET OF HEAD FIXTURE UNITS NATURAL GAS PIPE GALLON, GALLONS GPM GALLONS PER MINUTE GPH GALLONS PER HOUR HOSE BIBB HORSEPOWER DOMESTIC HOT WATER HW INCH, INCHES KILOWATTS MAX MAXIMUM THOUSAND BRITISH THERMAL UNITS PER HOUR MBH MECH MECHANICAL NOISE CRITERIA OR NORMALLY CLOSED NOM NOT IN CONTRACT NFWH NON-FREEZE WALL HYDRANT NORMALLY OPEN PERCENT PHASE

PSI

POUNDS PER SQUARE INCH POUNDS

REVOLUTIONS PER MINUTE

SANITARY, SOIL, WASTE

VOLTS, VACUUM PIPE

SANITARY VENT PIPE

VENT THROUGH ROOF

STORMWATER

TYPICAL

WIDTH

WALL HYDRANT

WITH

## PLUMBING LEGEND

<u>SYMBOL</u>	<u>DESCRIPTION</u>
	SOIL, WASTE, OR SANITARY PIPE
	VENT PIPE
	STORM WATER PIPE
——CD——	CONDENSATE DRAIN PIPE
——PC——	PUMPED CONDENSATE PIPE
	DOMESTIC COLD WATER PIPE
	DOMESTIC HOT WATER PIPE
	DOMESTIC HOT WATER RETURN PIP
——-G——	DOMESTIC HOT WATER RETURN PIP
<del></del> T	DOMESTIC TEMPERED WATER PIPE
<del></del> s	SPRINKLER SUPPLY PIPE
——F——	FIRE LINE PIPE
$\leftarrow 1$	PIPE (SOLID) OVER PIPE (BROKEN)
co—co	CLEANOUT (WALL/INLINE & FLOOR)
<b>-▶-</b>	SHUT-OFF OR GATE VALVE (NO/NC)
—lợ⊢ l <b>ị</b>	BALL VALVE (NO/NC)
— <del>já já</del>	GLOBE VALVE (NO/NC)
— <b>D</b> —	PIPE REDUCER; ECCENTRIC
—— <b>P</b> ——	PIPE REDUCER; CONCENTRIC
	SPRINKLER HEAD
	BRANCH TAKE OFF
<del></del> ാ	PIPE DROP END
	PIPE DROP TEE
<b>—</b> o—	PIPE RISE TEE
<del></del>	PIPE WITH CAP
	PIPE WITH OPEN END
<b>&gt;</b>	PIPE CONTINUATION, BEAK SYMBOL
┙┞┖	VENT THRU ROOF
HB/NFWH +	HOSE BIBB / NON-FREEZE WALL HYDRANT

### FD−X 🙋 FLOOR DRAIN

PIPE SYSTEM FLOW SYMBOL POINT OF CONNECTION, NEW TO EXISTING


POINT OF DISCONNECTION FROM EXISTING KEY NOTE SYMBOL FOR SPECIFIC NOTE; APPLIES TO DRAWING ON WHICH IT OCCURS

### **DESIGNATIONS**


### **EQUIPMENT & FIXTURE DESIGNATIONS**

DOMESTIC WATER HEATER PLUMBING FIXTURE

DRAWING & PLAN DESIGNATIONS

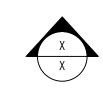

SECTION REFERENCE: (SEE DATA BELOW FOR DETAILS)

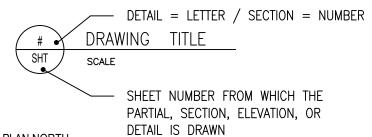


PLAN NORTH NORTH ARROW -TRUE NORTH

# **GENERAL NOTES**

- 1. WORK SHALL CONFORM TO THE CONTRACT DRAWINGS, SPECIFICATIONS AND THE LATEST APPLICABLE INTERNATIONAL MECHANICAL AND PLUMBING CODE AND THE NATIONAL ELECTRIC CODE AND THE PHILADELPHIA PLUMBING CODE. WORK SHALL BE PERFORMED IN ACCORDANCE WITH NFPA 70, THE NATIONAL ELECTRICAL CODE, THE NATIONAL ELECTRICAL SAFETY CODE, OSHA AND NATIONAL SAFETY CODE REQUIREMENTS.
- THE SCOPE OF WORK INDICATED IN THESE DOCUMENTS SHALL INCLUDE ALL PLUMBING SYSTEMS, FULLY ADJUSTED, TESTED AND READY TO USE. PROVIDE ITEMS NECESSARY TO COMPLETE THE SYSTEMS. EXAMINE WORK INDICATED FOR TRADES IN ORDER TO DETERMINE THE EXTENT OF THE WORK REQUIRED TO BE
- IT IS THE INTENTION OF THESE DRAWINGS TO CALL FOR FINISHED WORK, TESTED AND READY FOR OPERATION. WHEREVER THE WORD "PROVIDE" IS USED, IT SHALL MEAN "FURNISH AND INSTALL COMPLETE, TESTED AND READY FOR USE."
- 4. THE DRAWINGS ARE DIAGRAMMATIC AND DO NOT SHOW EVERY COMPONENT AND/OR ACCESSORY REQUIRED FOR A COMPLETE INSTALLATION. THE CONTRACTOR SHALL PROVIDE ITEMS NECESSARY FOR A PROPERLY WORKING SYSTEM IN COMPLIANCE WITH ACCEPTED INDUSTRY STANDARDS AND MANUFACTURER'S RECOMMENDATIONS.
- 5. PRIOR TO BID, THE CONTRACTOR SHALL VISIT THE SITE AND IDENTIFY ITEMS THAT MAY AFFECT THEIR BID. PRIOR TO THE INSTALLATION, FABRICATION, REMOVAL, OR RELOCATION OF ANY WORK, THE CONTRACTORS SHALL REVIEW THE ACTUAL CONDITIONS UNDER WHICH THE WORK IS TO BE PERFORMED AND SHALL COORDINATE WORK WITH THE PLANS, EXISTING EQUIPMENT AND SYSTEMS, BUILDING STRUCTURE AND WORK OF OTHER TRADES. WHERE CONFLICTS OCCUR, OR IF CONNECTIONS THERETO CAN NOT BE MADE, THE CONTRACTOR SHALL IMMEDIATELY NOTIFY THE ENGINEER PRIOR TO MATERIAL FABRICATION OR INSTALLATION.
- WHERE THE WORK OF VARIOUS TRADES WILL BE INSTALLED IN CLOSE PROXIMITY TO ONE ANOTHER OR WHERE THERE IS EVIDENCE THAT THE WORK OF ONE TRADE WILL INTERFERE WITH WORK OF ANOTHER, THE CONTRACTOR SHALL WORK OUT SPACE CONDITIONS TO MAKE A SATISFACTORY ADJUSTMENT. IF THE CONTRACTOR ALLOWS ONE TRADE TO INSTALL HIS WORK BEFORE COORDINATING WITH WORK OF OTHER TRADES THE CONTRACTOR SHALL MAKE NECESSARY CHANGES TO CORRECT THE CONDITIONS IN A MANNER ACCEPTABLE TO THE OWNER AND THE CONTRACTOR SHALL BEAR THE COST OF SUCH CORRECTIONS.
- 7. THE CONTRACTOR SHALL LOCATE EQUIPMENT WHICH MUST BE SERVICED, OPERATED, OR MAINTAINED IN FULLY ACCESSIBLE POSITION. EQUIPMENT SHALL INCLUDE, BUT NOT BE LIMITED TO VALVES, MOTORS, CONTROLLERS, DRAIN PANS, ETC. IF REQUIRED FOR ACCESSIBILITY, FURNISH ACCESS DOORS FOR THE PURPOSE. MINOR DEVIATIONS FROM DRAWINGS MAY BE MADE TO ALLOW FOR BETTER ACCESSIBILITY.
- WORK IN OCCUPIED SPACE SHALL BE COORDINATED WITH THE OWNER. SHOULD ANY OUTAGES BE REQUIRED IN THE COURSE OF THIS PROJECT, THE CONTRACTOR SHALL COORDINATE SUCH OUTAGES WITH THE OWNER'S DESIGNATED REPRESENTATIVE, SCHEDULING ANY OUTAGES DURING THE NON WORKING HOURS. SO AS NOT TO EFFECT FACILITY OPERATIONS, 72 HOURS NOTICE WILL BE REQUIRED PRIOR TO ANY OUTAGE. NO OUTAGE MAY BE EXECUTED PRIOR TO APPROVAL OF THE OWNER'S DESIGNATED REPRESENTATIVE AND THE FACILITY MANAGER.
- THE CONTRACTOR SHALL LEAVE THE ENTIRE PLUMBING SYSTEM INSTALLED UNDER THIS CONTRACT IN PROPER WORKING ORDER AND SHALL, WITHOUT CHARGE, REPLACE ANY WORK OR MATERIALS WHICH DEVELOP DEFECTS, EXCEPT FROM ORDINARY WEAR AND TEAR, WITHIN ONE YEAR FROM THE DATE OF FINAL ACCEPTANCE.
- 10. THE CONTRACTOR SHALL, DURING THE ONE YEAR WARRANTY PERIOD, BE RESPONSIBLE FOR PROPER REPAIR AND ADJUSTMENTS OF PLUMBING SYSTEMS AND EQUIPMENT, APPARATUS, DEVICES ETC. INSTALLED BY HIM, AND DO WORK NECESSARY TO ENSURE EFFICIENT AND PROPER FUNCTIONING.
- 11. THE CONTRACTOR SHALL BE RESPONSIBLE FOR, AND SHALL INCUR FINANCIAL RESPONSIBILITIES FOR, ANY DAMAGES CAUSED BY OR RESULTING FROM DEFECTS IN HIS WORK.
- 12. WALL OPENINGS RESULTING FROM DEMOLITION SHALL BE CLOSED AND FINISHED TO MATCH EXISTING.
- 13. FINISHES DAMAGED DURING THE PROJECTS SHALL BE REPAIRED TO MATCH EXISTING.
- 14. REFER TO ARCHITECTURAL DRAWING GO.2 FOR PLUMBING FIXTURES INSTALLATION DETAILS.
- 15. REFER TO ARCHITECTURAL DRAWING A2.0 FLOOR PLAN FOR FINAL LOCATIONS OF PLUMBING FIXTURES.
- 16. REFER TO ARCHITECTURAL DRAWING A6.1 ENLARGED PLANS AND ELEVATIONS OF PLUMBING FIXTURES.

NO.	FIXTURE	REMARKS					
.,,	·····	CW	HW	SAN	VENT	REMARKS	
P-1	WATER CLOSET	1"		4"	2"	NOTE 2	
P-1A	WATER CLOSET	1"		4"	2"	ADA COMPLIANT, NOTE 2	
P-2	URINAL	3/4"		2"	1-1/2"	ADA COMPLIANT, NOTE 1, 2	
P-3	LAVATORY SINK	1/2"	1/2"	2"	1-1/2"	NOTE 2	
P-3A	LAVATORY SINK	1/2"	1/2"	2"	1-1/2"	ADA COMPLIANT, NOTE 2	
P-4	WATER COOLER	1/2"	-	1 1/2"	1 1/2"	NOTE 2	
P-5	KITCHEN SINK	1/2"	1/2"	1 1/2"	1 1/2"	ADA COMPLIANT, NOTE 2	
P-6	SERVICE BASIN (MOP)	3/4"	3/4"	3"	2"	NOTE 2	

DOMESTIC WATER HEATER SCHEDULE											
DESIG.	CAPACITY (GAL)	BTU/HR. INPUT	GAS SUPPLY PRESSURE	FLUE SIZE	RECOVERY RATE (GPH)	TEMP RISE (F°)	VOLTAGE	PHASE	BASIS	SHIPPING WEIGHT	REMARKS
GWH-1	40	40,000	5"-14" W.C.	4"	43	90	120	1	BRADFORD WHITE RG240L6N	134 Lbs.	SEE DETAIL

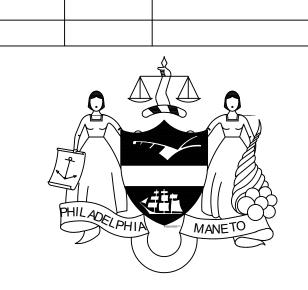

DESCRIPTION

PROJECT COORDINATOR

Philadelphia Parks & Recreation and Department of Public Property 1515 Arch Street, 11th Floor Philadelphia, PA 19102 Contact: Charles Mottershead, 215.683-4466

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### **PROJECT TEAM**

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CITY OF PHILADELPHIA

DEPARTMENT OF PUBLIC PROPERTY 1515 ARCH STREET 11TH FLOOR, ONE PARKWAY BUILDING

PROJECT TITLE MILES MACK PLAYGROUND BUILDING RENOVATION

PHILADELPHIA, PENNSYLVANIA

DRAWING TITLE

SYMBOLS, SCHEDULES, NOTES, DETAILS AND ABBREVIATIONS - PLUMBING

PROJECT NO. DRAWING NO. 18-00355-001 DATE: 02.07.2020

SCALE: AS NOTED DRAWN BY: BFL

WORK.

CHECKED BY: GSC NOTE: ALL DIMENSIONS AND CONDITIONS SHALL BE VERIFIED BY THE CONTRACTOR AT THE SITE BEFORE PROCEEDING WITH THE

0



PHOTOGRAPH # 1 SCALE: NOT TO SCALE



PHOTOGRAPH # 5 SCALE: NOT TO SCALE



PHOTOGRAPH # 6 SCALE: NOT TO SCALE



PHOTOGRAPH # 7 SCALE: NOT TO SCALE



PHOTOGRAPH # 8 SCALE: NOT TO SCALE






PHOTOGRAPH # 2

SCALE: NOT TO SCALE


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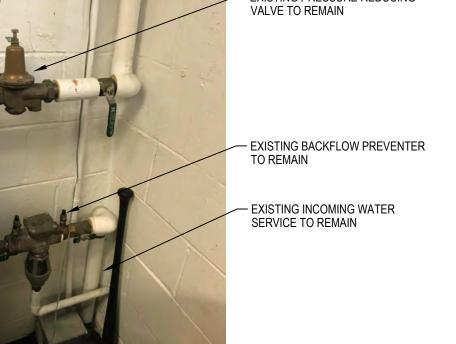
PHOTOGRAPH#4 SCALE: NOT TO SCALE



FLOOR PLAN - PLUMBING DEMOLITION SCALE: 1/4" = 1'-0"

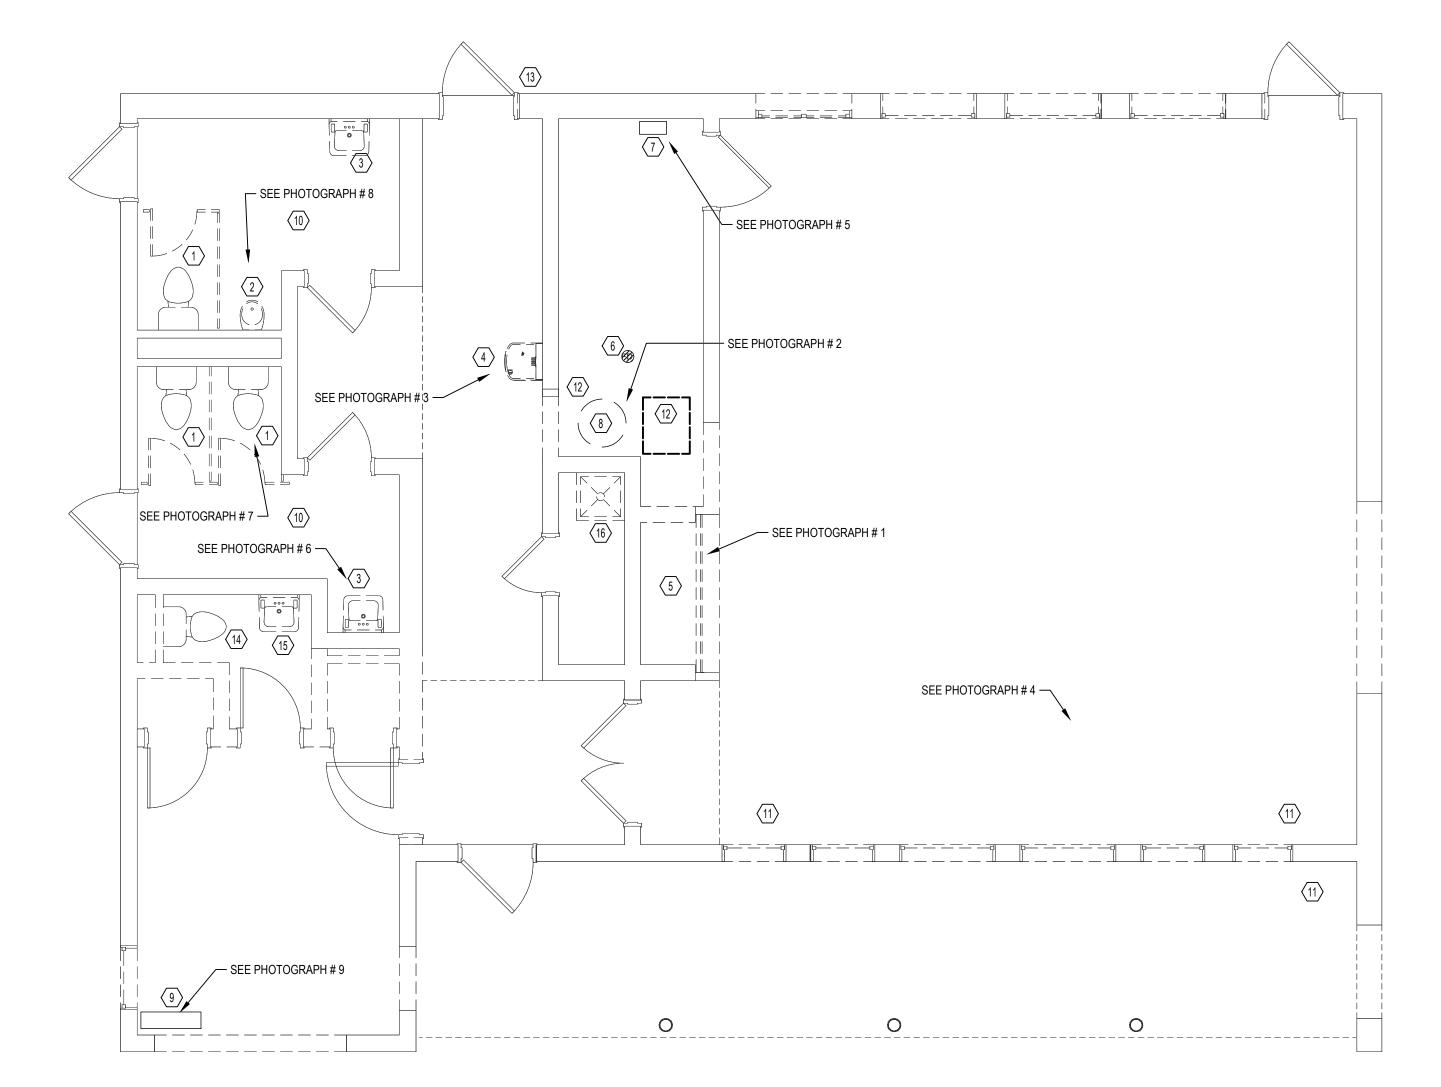

PHOTOGRAPH # 9 SCALE: NOT TO SCALE

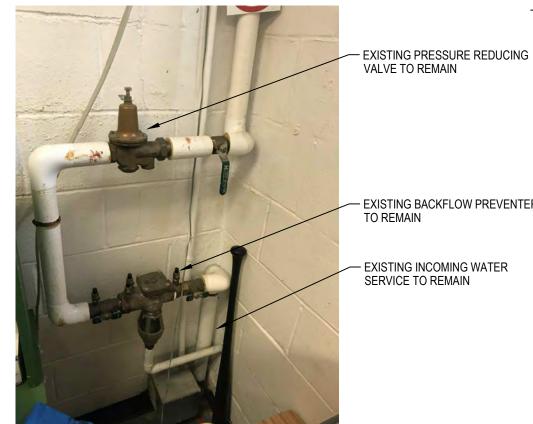

**GENERAL SHEET NOTES:** 


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- 2. DEMOLITION SHALL INCLUDE REMOVAL AND OFF-SITE DISPOSAL OF MATERIALS. DO NOT ABANDON IN PLACE ANY MECHANICAL AND RELATED ELECTRICAL COMPONENTS UNLESS OTHERWISE NOTED ON DRAWINGS.
- 3. ALL EXISTING SANITARY SEWER, WASTE, VENT, STORMWATER, AND DOMESTIC WATER PIPING SHALL REMAIN UNLESS NOTED OTHERWISE. DESIGN INTENT IS TO UTILIZE AS MUCH OF THE EXISTING PIPING AS POSSIBLE.

### SHEET KEYNOTES: DEMOLITION

- DISCONNECT AND REMOVE EXISTING WATER CLOSET AND SUPPLY LINE. CLEAN AND PREP EXISTING PIPING FOR INSTALLATION OF NEW FIXTURE. CUT AND REMOVE EXISTING CLOSET FLANGE AND REPLACE.
- $\langle 2 \rangle$  DISCONNECT AND REMOVE EXISTING URINAL AND FLUSH VALVE. CLEAN AND PREP EXISTING PIPING FOR INSTALLATION
- 3 DISCONNECT AND REMOVE EXISTING LAVATORY AND ALL ASSOCIATED TRIM. CLEAN AND PREP EXISTING PIPING FOR
- INSTALLATION OF NEW FIXTURE. 4) DISCONNECT AND REMOVE EXISTING ELECTRIC WATER COOLER AND ALL ASSOCIATED PIPING. REMOVE WASTE

CONNECTION AND CAP BEHIND FINISH WALL CONSTRUCTION. REMOVE WATER LINE BACK TO MAIN AND CAP.

- 5 DISCONNECT AND REMOVE EXISTING KITCHEN SINK AND ALL ASSOCIATED TRIM. CLEAN AND PREP EXISTING PIPING FOR INSTALLATION OF NEW FIXTURE.
- 6 DISCONNECT AND REMOVE EXISTING FLOOR DRAIN. CAP WASTE LINE BELOW FINISH FLOOR CONSTRUCTION.
- (7) EXISTING GAS SERVICE ENTRANCE AND METER LOCATION TO REMAIN.
- (8) DISCONNECT AND REMOVE EXISTING GAS FIRED WATER HEATER AND ALL ASSOCIATED PIPING.
- (9) EXISTING DOMESTIC WATER SERVICE ENTRANCE AND BACKFLOW PREVENTER ASSEMBLIES TO REMAIN.
- (10) EXISTING SANITARY, WASTE, VENT AND DOMESTIC WATER PIPING SERVING TOILET ROOM TO REMAIN.
- (11) EXISTING STORM DRAIN AND/OR PIPING TO REMAIN.
- DISCONNECT AND REMOVE ALL EXISTING GAS PIPING BACK TO EXISTING METER/REGULATOR LOCATED IN MECHANICAL
- 13 DISCONNECT AND REMOVE EXISTING NON-FREEZE WALL HYDRANT AND RELATED PIPING. COORDINATE WILL PATCH/INFILL WITH GENERAL CONTRACTOR.
- (14) DISCONNECT AND REMOVE EXISTING WATER CLOSET AND ALL ASSOCIATED PIPING. REMOVE FLOOR CLOSET FLANGE AND CAP SANITARY LINE BELOW FINISH FLOOR. REMOVE COLD WATER LINE BACK TO MAIN AND CAP.
- DISCONNECT AND REMOVE EXISTING LAVATORY AND ALL ASSOCIATED PIPING. REMOVE WASTE LINE AND CAP BELOW FINISH FLOOR. REMOVE HOT AND COLD WATER PIPING BACK TO MAINS AND CAP.
- (16) DISCONNECT AND REMOVE EXISTING SERVICE BASIN (MOP) AND ALL RELATED TRIM. CLEAN AND PREP EXISTING PIPING FOR INSTALLATION OF NEW FIXTURE.

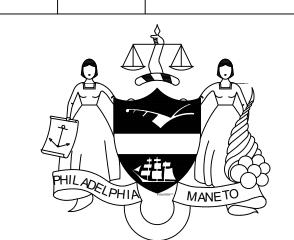

DESCRIPTION

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PHILADELPHIA, PENNSYLVANIA

PROJECT TITLE MILES MACK PLAYGROUND BUILDING

### DRAWING TITLE


RENOVATION


FLOOR PLAN - PLUMBING DEMOLITION

PROJECT NO.	DRAWING NO.
18-00355-001	
DATE: 02.07.2020	PD1.0
SCALE: AS NOTED	1 0 1.0

### DRAWN BY: BFL CHECKED BY: GSC

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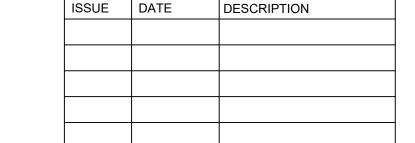


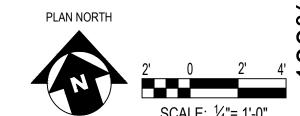FOUNDATION PLAN - PLUMBING

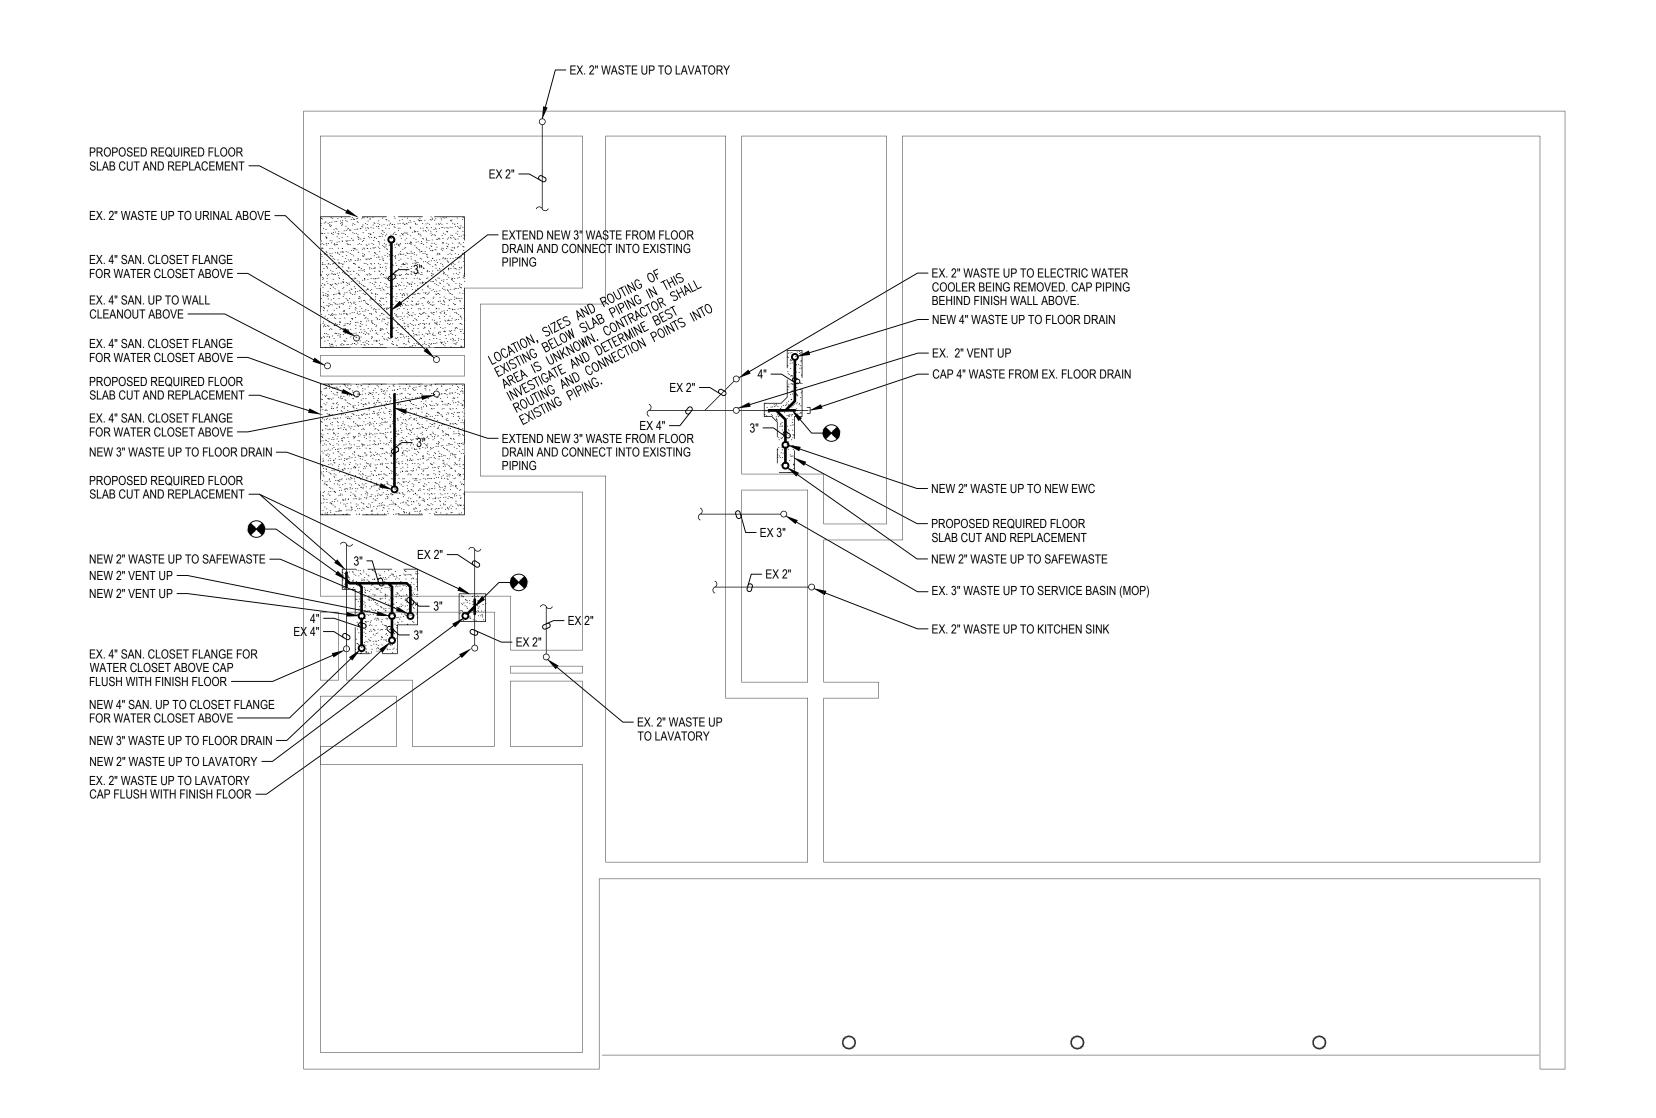
SCALE: 1/4" = 1'-0"

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- 2. DO NOT LOCATE DUCTWORK OR PIPING ABOVE ELECTRICAL PANELS OR EQUIPMENT.



REVISIONS

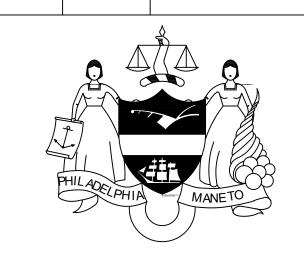

PROJECT COORDINATOR

Philadelphia Parks & Recreation and Department of Public Property 1515 Arch Street, 11th Floor Philadelphia, PA 19102 Contact: Charles Mottershead, 215.683-4466

SEAL



### PROJECT TEAM

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DEPARTMENT OF PUBLIC PROPERTY

1515 ARCH STREET 11TH FLOOR, ONE PARKWAY BUILDING PHILADELPHIA, PENNSYLVANIA

PROJECT TITLE
MILES MACK PLAYGROUND BUILDING

DRAWING TITLE

2

RENOVATION

FOUNDATION PLAN - PLUMBING

DRAWING NO.

PROJECT NO. 18-00355-001

WORK.


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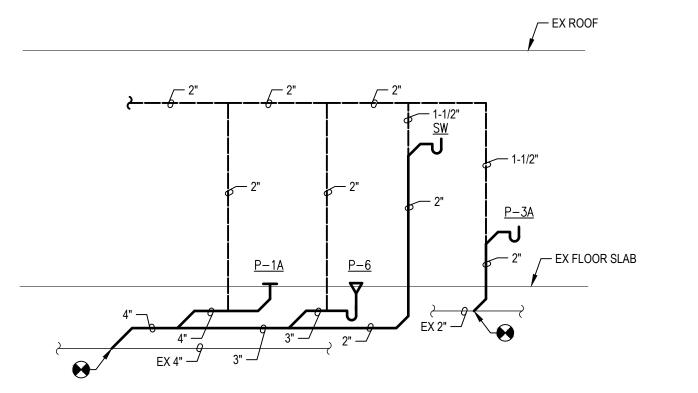
SCALE: AS NOTED

DRAWN BY: BFL


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NOTE: ALL DIMENSIONS AND CONDITIONS SHALL BE VERIFIED BY THE CONTRACTOR AT THE SITE BEFORE PROCEEDING WITH THE



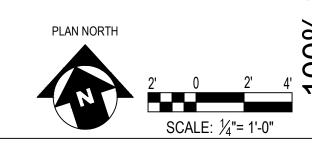

RISER DIAGRAM - PLUMBING

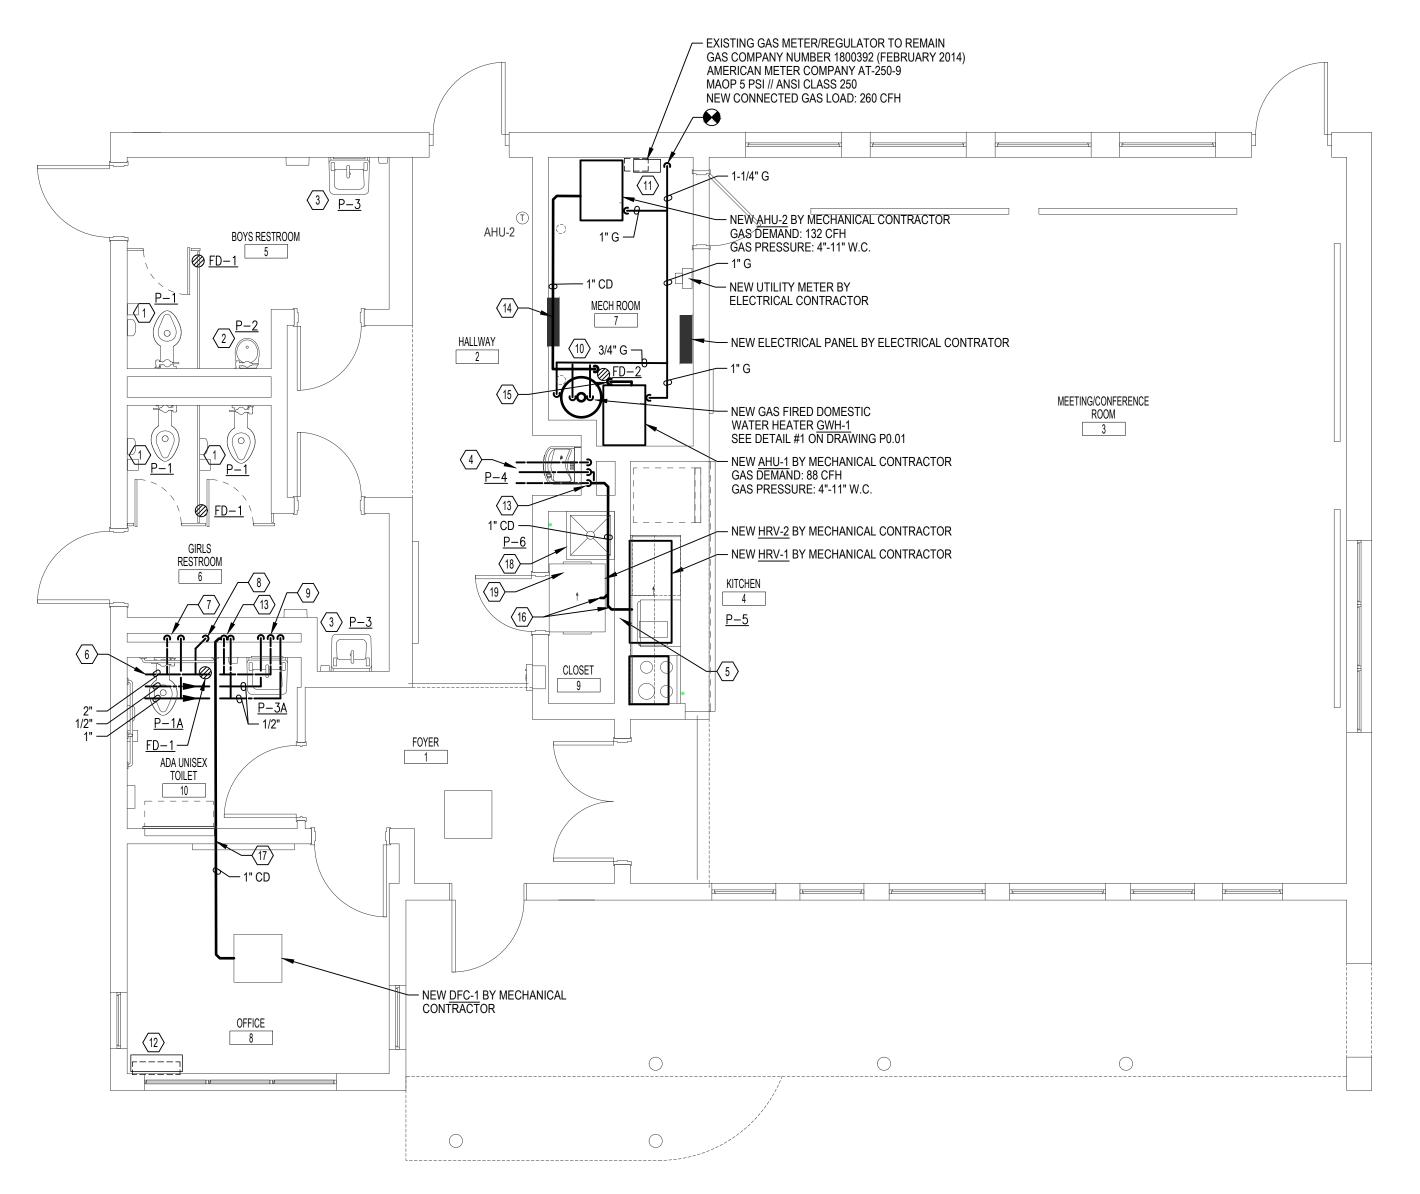

FLOOR PLAN - PLUMBING SCALE: 1/4" = 1'-0"

### **GENERAL SHEET NOTES:**

- 1. INFORMATION SHOWN ON THIS DRAWING PERTAINING TO EXISTING CONDITIONS HAS BEEN OBTAINED FROM AVAILABLE BUILDING DRAWINGS OR GENERAL FIELD OBSERVATIONS AND MAY NOT INDICATE ACTUAL EXISTING CONDITIONS IN DETAIL OR DIMENSION. THE CONTRACTOR IS RESPONSIBLE FOR DETERMINING THE ACTUAL EXISTING CONDITIONS PRIOR TO FABRICATION OR PERFORMANCE OF ANY WORK. SHOULD CONDITIONS BE DISCOVERED THAT PREVENT EXECUTION OF THE WORK AS INDICATED, THE CONTRACTOR SHALL IMMEDIATELY NOTIFY THE ARCHITECT IN WRITING AND AWAIT DIRECTION BEFORE PROCEEDING WITH THE WORK.
- 2. DO NOT LOCATE DUCTWORK OR PIPING ABOVE ELECTRICAL PANELS OR EQUIPMENT.

### SHEET KEYNOTES:

- 1) INSTALL NEW FLOOR MOUNTED WATER CLOSET AT ORIGINAL FIXTURE LOCATION. MODIFY EXISTING SANITARY AND WATER PIPING AS REQUIRED TO MAKE CONNECTIONS TO NEW FIXTURE.
- $\langle 2 \rangle$  INSTALL NEW WALL MOUNTED URINAL AT ORIGINAL FIXTURE LOCATION. MODIFY EXISTING WASTE AND WATER PIPING AS REQUIRED TO MAKE CONNECTIONS TO NEW FIXTURE.
- 3 INSTALL NEW WALL MOUNTED LAVATORY AT ORIGINAL FIXTURE LOCATION. MODIFY EXISTING WASTE AND WATER PIPING AS REQUIRED TO MAKE CONNECTIONS TO NEW FIXTURE.
- 4 NEW 1-1/2" VENT DN., 1/2" CW DN. TO NEW ELECTRIC WATER COOLER.
- (5) INSTALL NEW DROP-IN COUNTERTOP KITCHEN SINK. MODIFY EXISTING WASTE AND WATER PIPING AS REQUIRED TO MAKE CONNECTIONS TO NEW FIXTURE.
- 6 NEW 2" VENT, 1" COLD WATER AND 1/2" HOT WATER FOR ADA UNISEX TOILET #10. EXTEND NEW PIPING AND CONNECT TO EXISTING MAINS.
- $\langle 7 \rangle$  NEW 2" VENT DN., 1" COLD WATER DN. TO NEW WATER CLOSET.
- (8) NEW 2" VENT DN. TO FLOOR DRAIN WASTE LINE.
- 9 NEW 1/2" HOT WATER, 1-1/2" VENT DN. AND 1/2" COLD WATER DN. TO NEW LAVATORY.
- (10) NEW 1" COLD WATER AND 1" HOT WATER FOR CONNECTION TO WATER HEATER. EXTEND NEW PIPING AND CONNECT TO EXISTING MAINS.
- (11) EXISTING GAS METER/REGULATOR TO REMAIN. NEW GAS PIPING SHALL BE EXTENDED AND CONNECTED INTO DEMAND SIDE OF DEVICE.
- (12) EXISTING DOMESTIC WATER SERVICE AND BACKFLOW PREVENTER ASSEMBLY TO REMAIN.
- $\bigcirc$  FURNISH AND INSTALL NEW 1-1/2" SAFEWASTE CONNECTION WITH AIR GAP FITTING AND TRAP PRIMER VALVE TO RECEIVE CONDENSATE WASTE FROM NEW MECHANICAL EQUIPMENT. INSTALL AS HIGH AS POSSIBLE AND COORDINATE WITH MECHANICAL CONTRACTOR. SEE DETAIL ON PO.01.
- 14 NEW 1" CONDENSATE WASTE PIPING FROM AHU-1. RUN ALONG WALL AND DISCHARGE INTO NEW FUNNEL FLOOR DRAIN. COORDINATE WITH MECHANICAL CONTRACTOR.
- (15) NEW 1" CONDENSATE WASTE PIPING FROM AHU-2. RUN LOW AND DISCHARGE INTO NEW FUNNEL FLOOR DRAIN. COORDINATE WITH MECHANICAL CONTRACTOR.
- (16) NEW 1" CONDENSATE WASTE PIPING FROM HRV-1 AND HRV-2 LOCATED ABOVE CEILING. RUN HIGH AS POSSIBLE AND DISCHARGE INTO NEW SAFEWASTE. COORDINATE WITH MECHANICAL CONTRACTOR.
- 17 NEW 1" CONDENSATE WASTE PIPING FROM DFC-1 LOCATED AT CEILING HEIGHT. RUN AS HIGH AS POSSIBLE AND DISCHARGE INTO NEW SAFEWASTE. COORDINATE WITH MECHANICAL
- (18) INSTALL NEW SERVICE BASIN (MOP) AT ORIGINAL FIXTURE LOCATION. MODIFY EXISTING WASTE AND WATER PIPING AS REQUIRED TO MAKE CONNECTIONS TO NEW FIXTURE.
- (19) NOTE: DUE TO THE SIZE AND QUANTITY OF NEW MECHANICAL EQUIPMENT AND DUCTWORK TO BE INSTALLED UNDER THIS PROJECT THE PLUMBING CONTRACTOR MAY BE REQUIRED TO RELOCATE EXISTING PLUMBING PIPING. COORDINATE REQUIRED RELOCATION WITH MECHANICAL CONTRACTOR.



DESCRIPTION



### PROJECT COORDINATOR

Philadelphia Parks & Recreation and Department of Public Property 1515 Arch Street, 11th Floor Philadelphia, PA 19102 Contact: Charles Mottershead, 215.683-4466

SEAL

REVISIONS

ISSUE DATE



### PROJECT TEAM

### ARCHITECT:

JMT I ARCHITECTURE JOHNSON, MIRMIRAN, AND THOMPSON, INC. 1600 MARKET STREET, SUITE 520 PHILADELPHIA, PA 19103 267.256.0300 I WWW.JMT.COM

### STRUCTURAL ENGINEER:

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### SYSTEMS ENGINEER:

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CITY OF PHILADELPHIA DEPARTMENT OF PUBLIC PROPERTY

1515 ARCH STREET 11TH FLOOR, ONE PARKWAY BUILDING PHILADELPHIA, PENNSYLVANIA

PROJECT TITLE MILES MACK PLAYGROUND BUILDING

DRAWING TITLE

7

RENOVATION

FLOOR PLAN - PLUMBING


PROJECT NO. 18-00355-001 DATE: 02.07.2020


SCALE: AS NOTED DRAWN BY: BFL

CHECKED BY: GSC

DRAWING NO.

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ROOF PLAN - PLUMBING

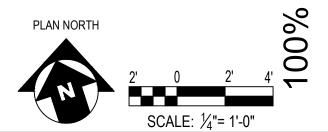SCALE: 1/4" = 1'-0"
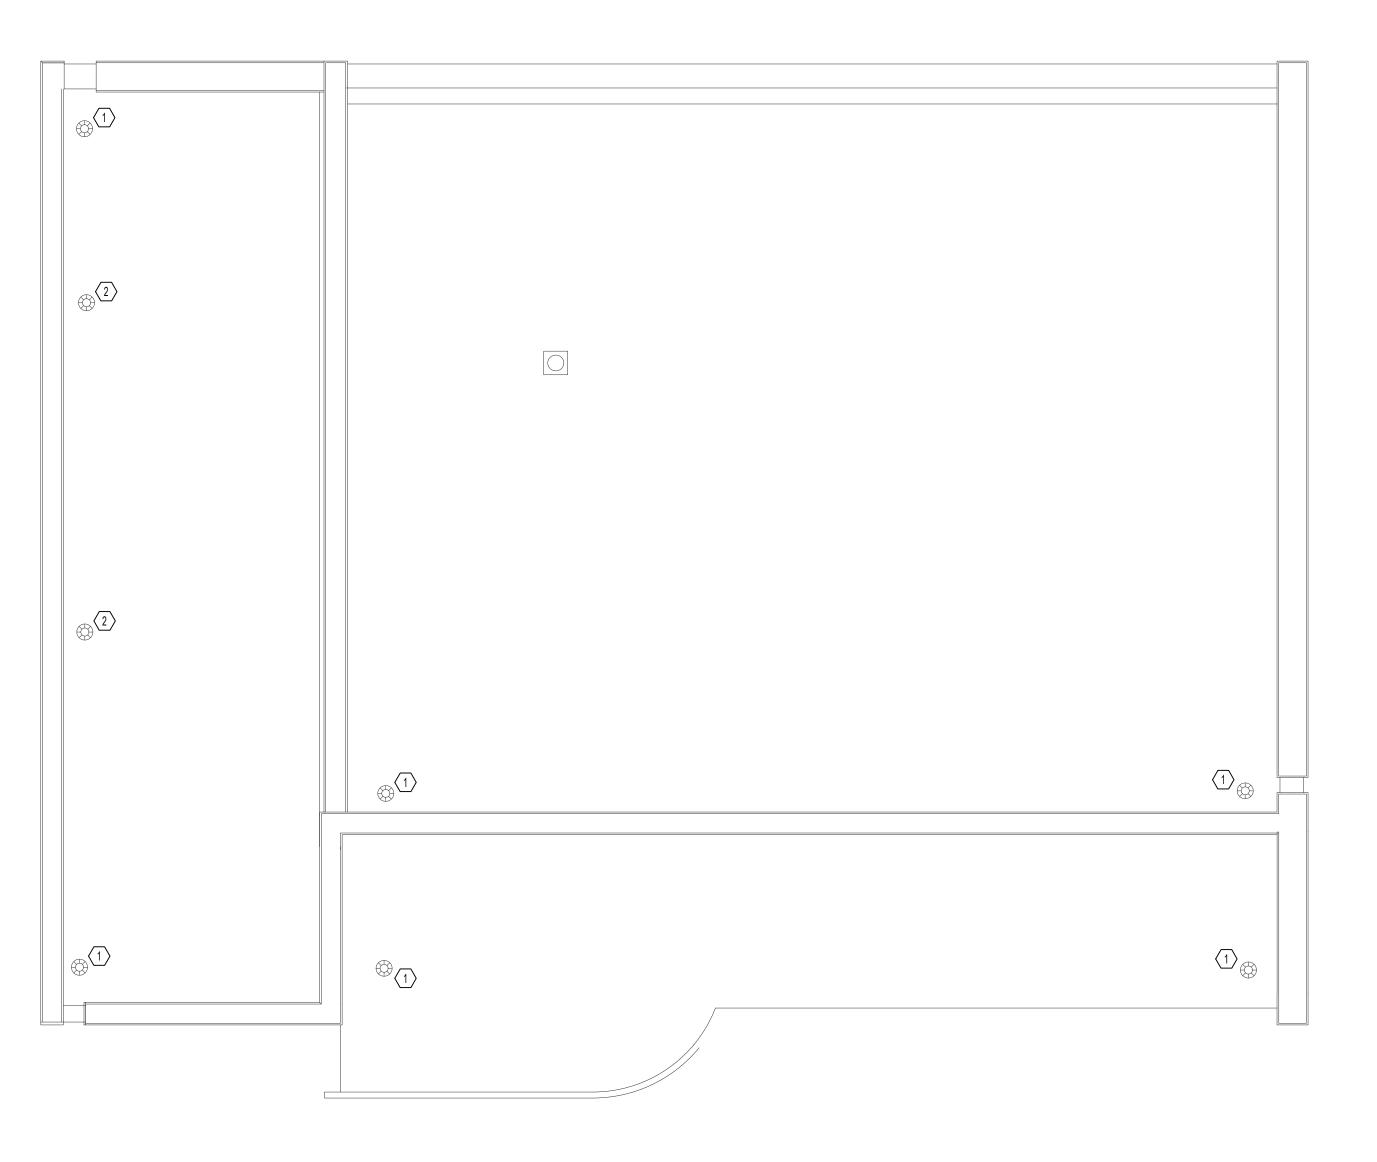
### GENERAL SHEET NOTES:

- 1. INFORMATION SHOWN ON THIS DRAWING PERTAINING TO EXISTING CONDITIONS HAS BEEN OBTAINED FROM AVAILABLE BUILDING DRAWINGS OR GENERAL FIELD OBSERVATIONS AND MAY NOT INDICATE ACTUAL EXISTING CONDITIONS IN DETAIL OR DIMENSION. THE CONTRACTOR IS RESPONSIBLE FOR DETERMINING THE ACTUAL EXISTING CONDITIONS PRIOR TO FABRICATION OR PERFORMANCE OF ANY WORK. SHOULD CONDITIONS BE DISCOVERED THAT PREVENT EXECUTION OF THE WORK AS INDICATED, THE CONTRACTOR SHALL IMMEDIATELY NOTIFY THE ARCHITECT IN WRITING AND AWAIT DIRECTION BEFORE PROCEEDING WITH THE WORK.
- 2. DO NOT LOCATE DUCTWORK OR PIPING ABOVE ELECTRICAL PANELS OR EQUIPMENT.


### SHEET KEYNOTES:

- EXISTING ROOF DRAIN AND ALL ASSOCIATED PIPING TO REMAIN. COORDINATE ANY REQUIRED REMOVAL AND RE-INSTALLATION OF ROOF DRAIN FOR NEW ROOF INSTALLATION WITH GENERAL CONTRACTOR.
- 2 EXISTING PIPING VENT AND ALL ASSOCIATED PIPING TO REMAIN. COORDINATE ANY REQUIRED MODIFICATIONS AND/OR FLASHING REPLACEMENT FOR NEW ROOF INSTALLATION WITH GENERAL CONTRACTOR.



ISSUE DATE DESCRIPTION

REVISIONS

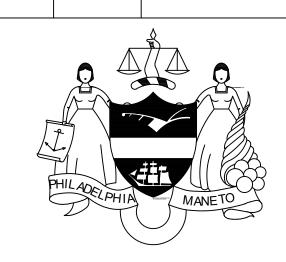

PROJECT COORDINATOR

Philadelphia Parks & Recreation and Department of Public Property 1515 Arch Street, 11th Floor Philadelphia, PA 19102 Contact: Charles Mottershead, 215.683-4466

SEAL



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CITY OF PHILADELPHIA

DEPARTMENT OF PUBLIC PROPERTY

1515 ARCH STREET 11TH FLOOR, ONE PARKWAY BUILDING PHILADELPHIA, PENNSYLVANIA

PROJECT TITLE
MILES MACK PLAYGROUND BUILDING
RENOVATION

DRAWING TITLE

7

ROOF PLAN - PLUMBING

DRAWING NO.


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WORK.

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CHECKED BY: GSC

NOTE: ALL DIMENSIONS AND CONDITIONS SHALL
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### **GENERAL NOTES:**

- 1. PROVIDE ALL LABOR, MATERIALS, TOOLS, EQUIPMENT, COORDINATION, ADDITIONAL DESIGN AND ALL INCIDENTALS NECESSARY TO PROVIDE A COMPLETE AND OPERABLE SYSTEM AS DETAILED ON PLANS TO THE SATISFACTION OF THE ENGINEER AND THE OWNER.
- 2. CONTRACTOR SHALL INCLUDE IN THEIR BID ALL MATERIAL, LABOR AND ALL INCIDENTALS FOR A COMPLETE INSTALLATION WHETHER SPECIFICALLY CALLED FOR OR NOT. ALL ERRORS, DISCREPANCIES AND MISSED ITEMS SHALL BE BROUGHT TO THE ATTENTION OF THE ENGINEER DURING THE BIDDING PROCESS BY THE CONTRACTOR. THESE ITEMS SHALL BE INCLUDED IN THE BID PRICE.
- 3. PERFORM WORK AS REQUIRED BY APPLICABLE CODES, REGULATIONS AND LAWS OF LOCAL, STATE AND FEDERAL GOVERNMENTS AND OTHER AUTHORITIES WITH LAWFUL JURISDICTION. ALL WORK SHALL BE IN ACCORDANCE WITH THE 2017 EDITION OF THE NATIONAL ELECTRICAL CODE.
- 4. MATERIAL AND EQUIPMENT SHALL BE UL, NEMA, ANSI, IEEE, ADA & CBM APPROVED FOR INTENDED SERVICE. MATERIAL AND INSTALLATION SHALL MEET REQUIREMENTS OF NATIONAL AND STATE ELECTRICAL CODE.
- 5. COORDINATE ALL ELECTRICAL ITEMS WITH EXISTING FIELD CONDITIONS. LOCATIONS SHOWN ARE APPROXIMATE AND MAY REQUIRE MINOR ADJUSTMENT IN THE FIELD TO SATISFY THE DESIGN INTENT.
- 6. DAMAGE TO EXISTING FACILITIES AND EQUIPMENT SHALL BE REPAIRED OR REPLACED IMMEDIATELY BY THE CONTRACTOR AT NO ADDITIONAL EXPENSE TO THE OWNER.
- 7. THE LOCATIONS SHOWN ON THESE PLANS ARE APPROXIMATE AND REQUIRE COORDINATION WITH ALL OTHER TRADES AND VERIFICATION OF EXISTING CONDITIONS. ROUTING OF CONDUIT IS DIAGRAMMATIC IN NATURE AND NOT INTENDED TO SHOW ALL REQUIRED OFFSETS AND DETAILS. THE CONTRACTOR IS RESPONSIBLE FOR FIELD VERIFICATION OF ALL EXISTING ASSOCIATED EQUIPMENT AND CONDITIONS. COORDINATE THE LOCATION OF ALL EQUIPMENT WITH THE ENGINEER AND THE OWNER. CONTRACTOR IS RESPONSIBLE FOR OBTAINING ALL OTHER TRADES' DRAWINGS AND SPECIFICATIONS AND COORDINATING WITH ALL OTHER TRADES DURING CONSTRUCTION.
- 8. CONTRACTOR SHALL BE RESPONSIBLE FOR MAINTAINING CONTINUITY OF ALL POWER, CONTROL, AND COMMUNICATION FUNCTIONS TO ALL AREAS AFFECTED BY DEMOLITION AND/OR NEW CONSTRUCTION.
- 9. CONTRACTOR SHALL NOT CUT ANY ACTIVE ELECTRICAL OR COMMUNICATIONS LINES DURING CONSTRUCTION. IF THE CONTRACTOR ACCIDENTALLY CUTS A LINE, THEN THEY SHALL CONTACT THE ENGINEER IMMEDIATELY BEFORE PROCEEDING WITH FURTHER WORK.
- 10. CONTRACTOR SHALL SUBMIT FOR APPROVAL, SHOP DRAWINGS FOR ALL EQUIPMENT AND MATERIALS USED ON THE PROJECT. SUBMITTALS SHALL BE APPROVED BY THE ENGINEER BEFORE PURCHASE OF MATERIALS.
- 11. PROVIDE TEMPORARY POWER AND LIGHTING FOR ALL TRADES AS REQUIRED TO COMPLETE THE PROJECT. ALL TEMPORARY AND INTERIM EQUIPMENT SHALL BE INSTALLED IN ACCORDANCE WITH ALL APPLICABLE CODES AND STANDARDS INCLUDING, BUT NOT LIMITED TO, NFPA 110 AND NFPA 70.
- 12. PROVIDE FIRE SEALANT FOR PENETRATIONS THROUGH FIRE RATED FLOORS AND WALLS TO MAINTAIN THE APPLICABLE FIRE RATING. ALL FIREPROOFING FOR ELECTRICAL PENETRATION SHALL BE PROVIDED BY THE ELECTRICAL CONTRACTOR.

Α	AMPERES	IEEE	INSTITUTE OF ELECTRICAL AND ELECTRONIC ENGINEERS
A/C	ABOVE COUNTER	IMC	INTERMEDIATE METAL CONDUIT
ADA	AMERICANS WITH DISABILITIES ACT	INT	INTERLOCK
AFF	ABOVE FINISHED FLOOR	KCMIL	THOUSAND CIRCULAR MILS
AFG	ABOVE FINISH GRADE	KVA	KILOVOLT AMPERES
AHJ	AUTHORITY HAVING JURISDICTION	KW	KILOWATTS
AHU	AIR HANDLING UNIT	LTG	LIGHTING
AIC	AMPERE INTERRUPTING CAPACITY	LFMC	LIQUID TIGHT FLEXIBLE METAL CONDUIT
AL	ALUMINUM	MAU	MAKE-UP AIR UNIT
ANSI	AMERICAN NATIONAL STANDARDS INSTITUTE	MC	METAL CLAD CABLE
ARCH	ARCHITECT	MCB	MAIN CIRCUIT BREAKER
ATC	AUTOMATIC TEMPERATURE CONTROL	MCC	MOTOR CONTROL CENTER
ATS	AUTOMATIC TRANSFER SWITCH	MCP	MOROT CIRCUIT PROTECTOR
AWG	AMERICAN WIRE GAUGE	MISC	MISCELLANEOUS
BFG	BELOW FINISH GRADE	MLO	MAIN LUG ONLY
BLDG	BUILDING	NC	NORMALLY CLOSED
BN	BUILDING NETWORK	NEC	NATIONAL ELECTRIC CODE
С	CONDUIT	NEMA	NATIONAL ELECTRICAL MANUFACTURERS ASSOCIATION
CAT	CATALOG	NFPA	NATIONAL FIRE PROTECTION ASSOCIATION
CB	CIRCUIT BREAKER	NO	NORMALLY OPEN OR NUMBER
CBM	CERTIFIED BALLAST MANUFACTURERS	NTS	NOT TO SCALE
CKT	CIRCUIT	Р	POLE
CL	CENTERLINE	PB	PUSH BUTTON
CLF	CURRENT LIMITING FUSE	PNL	PANEL
COL	COLUMN	POS	PROVIDED UNDER OTHER SECTIONS
CPT	CONTROL POWER TRANSFORMER	PVC	POLYVINYL CHLORIDE
CT	CURRENT TRANSFORMER	PWR	POWER
CU	COPPER	QTY	QUANTITY
DWG	DRAWING	REL	RELOCATE
EC	ELECTRICAL CONTRACTOR	REQ'D	REQUIRED
ECB	ENCLOSED CIRCUIT BREAKER	REX	REPLACE EXISTING
EF	EXHAUST FAN	RMC	RIGID METAL CONDUIT
ELEV	ELEVATOR	RMS	ROOT MEAN SQUARED
EM	EMERGENCY	RNMC	RIGID NON-METALLIC CONDUIT
EMT	ELECTRICAL METALLIC TUBING	RTU	ROOF TOP UNIT
EPO	EMERGENCY POWER OFF	RX	REMOVE EXISTING
ETR	EXISTING TO REMAIN	SP	SPARE
ETBR	EXISTING TO BE RELOCATED	SW	SWITCH
EWC	ELECTRIC WATER COOLER	SYM	SYMMETRICAL
EX	EXISTING	TEL	TELEPHONE
F	FUSE	TGB	TELECOMMUNICATION GROUNDING BAR
F	FUSE	TMCB	THERMAL MAGNETIC CIRCUIT BREAKER
FA	FIRE ALARM	TMGB	TELECOMMUNICATION MAIN GROUNDING BAR
FAAP	FIRE ALARM ANNUNCIATOR PANEL	TYP	TYPICAL
FACP	FIRE ALARM CONTROL PANEL	UG	UNDERGROUND OR UNDERGRADE
FLA	FULL LOAD AMPERES	UL	UNDERWRITERS LABORATORIES
FMC	FLEXIBLE METAL CONDUIT	V	VOLT
FT	FEET	VT	VOLTAGE TRANSFORMER
GND, G	GROUND OR GROUNDING	W	WIRE
GRMC	GALVANIZED RIGID METALLIC CONDUIT	WH	WATER HEATER
HOA	HAND, OFF, AUTOMATIC SWITCH	WP	WEATHER PROOF
	. ,	WR	WEATHER RESISTANT
		XFMR	TRANSFORMER
		Δ	DELTA
		Y	WYE
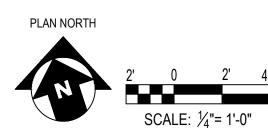
### SYMBOL LEGEND

SYMBOL	DESCRIPTION
	NORMAL LIGHT FIXTURE
Ţ Ā	WALL MOUNTED LIGHT
	INDUSTRIAL LIGHT FIXTURE
O 🗆 T . <u>.</u> .	DOWN LIGHT FIXTURE  EXIT LIGHT - WALL OR CEILING MOUNTED
₩ <b>†</b> ₩ <b>†</b>	(COORDINATE MOUNTING, FACES, AND ARROWS WITH DRAWINGS)  PHOTOCELL
TC	TIMECLOCK
DH	DAYLIGHT HARVEST
S	MOTION SENSOR
os	OCCUPANCY SENSOR
RC	ROOM CONTROLLER
CS	CONTROL SWITCH
CCTV K	SECURITY CAMERA
X x X X X X X X X X X X X X X X X X X X	TYPICAL LIGHT FIXTURE DESIGNATION, CIRCUIT AND CONTROL  X = DESIGNATION (REFER TO LIGHTING FIXTURE SCHEDULE)  XX-XX = PANEL AND CIRCUIT NUMBER  x = SWITCH LEG OR ZONE IF NOTHING LISTED  LIGHT FIXTURE CONTROLLED BY LOCAL SWITCH,  REFER TO LIGHTING CONTROL DETAILS
	125 VOLT, 20 AMP DUPLEX RECEPTACLE. "R" DENOTES RECESSED " DENOTES SURFACE MOUNTED
<b>#</b>	125 VOLT, 20 AMP DOUBLE DUPLEX RECEPTACLE
⊕ <sup>GFI</sup>	125 VOLT, 20 AMP DUPLEX RECEPTACLE EQUIPPED WITH INTEGRAL GROUND FAULT INTERRUPTER.
	125 VOLT, 20 AMP, DUPLEX RECEPTACLE OUTLET FLOOR/CEILING MOUNTED.
abla	SPECIAL PURPOSE RECEPTACLE, WALL MOUNTED
\$	LOW-VOLTAGE SWITCH
S <sub>M</sub>	MOTOR RATED SWITCH
<u> </u>	JUNCTION BOX
<b>▼</b>	TELEPHONE JACK
WAP	WIRELESS ACCESS POINT
F	FIRE ALARM MANUAL PULL STATION
abla 75cd $ abla$ $ abla$ $ abla$	FIRE ALARM AUDIO/VISUAL SIGNALING DEVICE FLUSH CEILING MOUNTED, 75cd - DENOTES CANDELA RATING
▼ 75cd ○	FIRE ALARM AUDIO/VISUAL SIGNALING DEVICE WALL MOUNTED 75cd - DENOTES CANDELA RATING
75cd	FIRE ALARM VISUAL SIGNALING DEVICE WALL MOUNTED 75cd - DENOTES CANDELA RATING
F	FIRE ALARM AUDIBLE SIGNALING DEVICE WALL MOUNTED
,75cd	FIRE ALARM AUDIO/VISUAL SIGNALING DEVICE FLUSH CEILING MOUNTED 75cd - DENOTES CANDELA RATING
FAAP	FIRE ALARM ANNUNCIATOR PANEL
FACP	FIRE ALARM SYSTEM CONTROL PANEL
⟨S⟩ <sub>WG</sub>	SMOKE DETECTOR "WG" DENOTES WIREGUARD
⟨C⟩ <sub>WG</sub>	CARBON MONOXIDE DETECTOR "WG" DENOTES WIREGUARD
(DD)	DUCT DETECTOR
	CIRCUIT BREAKER
AF OR P OR AF/NF/P/3R	NON-FUSED DISCONNECT SWITCH, SIZE AS INDICATED WHERE: "AF" - INDICATES AMPERE SWITCH SIZE "NF" - DENOTES NON-FUSED "P" - DENOTES POLE "3R" - DENOTES NEMA TYPE ENCLOSURE
AF OR AT AF/AT/P/3R T 3P L2	FUSED DISCONNECT SWITCH, SIZE AS INDICATED WHERE: "AF" - INDICATES AMPERE SWITCH SIZE "AT" - INDICATES AMPERE FUSE SIZE "P" - DENOTES POLE "3R" - DENOTES NEMA TYPE ENCLOSURE
þ	FUSE
<del>_</del> +	CONTACTOR

PANELBOARD

	HILADELPHIA	MANETO

DESCRIPTION

REVISIONS

ISSUE DATE

PROJECT COORDINATOR

Philadelphia Parks & Recreation and Department of Public Property 1515 Arch Street, 11th Floor Philadelphia, PA 19102 Contact: Charles Mottershead, 215.683-4466

SEAL



### PROJECT TEAM

### ARCHITECT:

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CITY OF PHILADELPHIA DEPARTMENT OF PUBLIC PROPERTY

1515 ARCH STREET 11TH FLOOR, ONE PARKWAY BUILDING PHILADELPHIA, PENNSYLVANIA

PROJECT TITLE MILES MACK PLAYGROUND BUILDING RENOVATION

DRAWING TITLE

SYMBOLS, SCHEDULES, NOTES, AND ABBREVIATIONS


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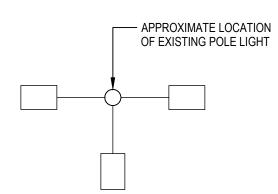
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DATE: 02.07.2020 SCALE: AS NOTED DRAWN BY: CHECKED BY: WORK.

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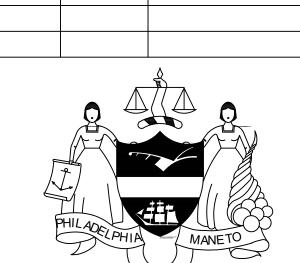




FLOOR PLAN - ELECTRICAL DEMOLITION SCALE: 1/4" = 1'-0"

### **DEMOLITION NOTES:**

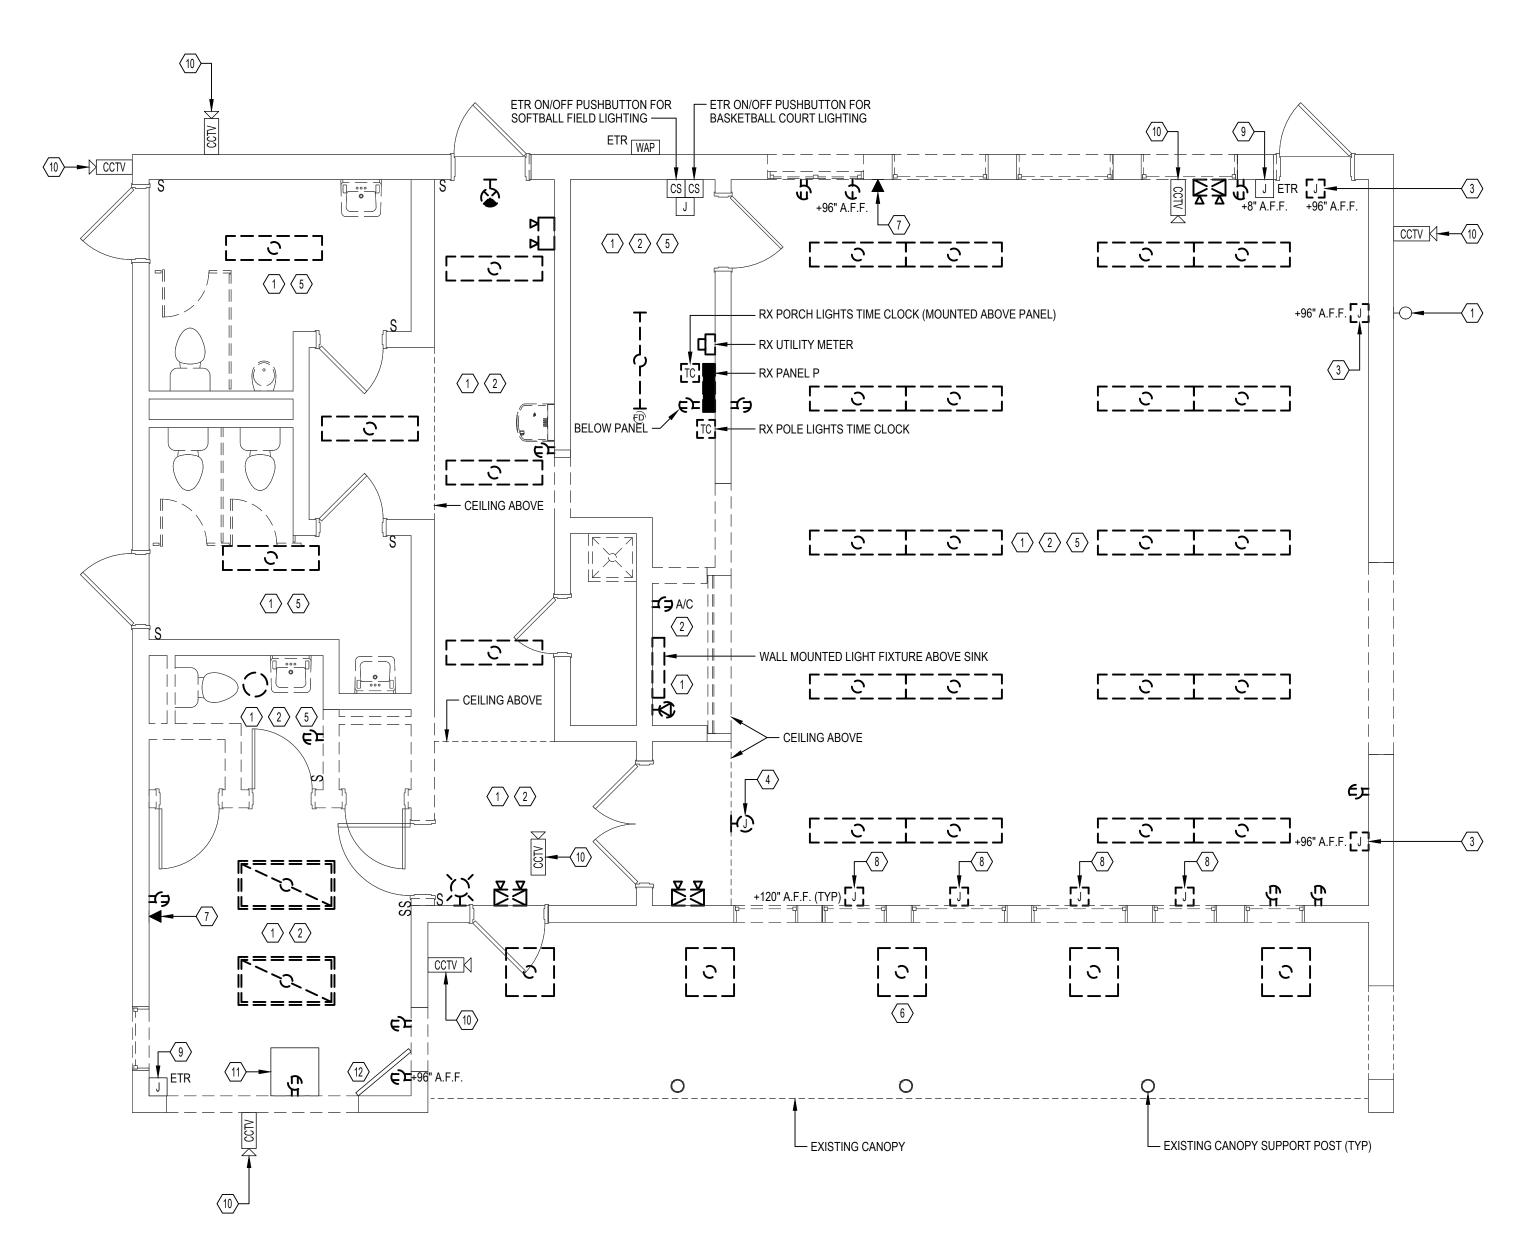- REMOVE ALL LIGHT FIXTURES, LIGHT SWITCHES, EXIT SIGNS, EMERGENCY LIGHTS, AND ASSOCIATED CONDUCTORS. RECESSED BACKBOXES AND CONCEALED RACEWAYS SHALL BE ABANDONED IN PLACE. PROVIDE BLANK STAINLESS STEEL FACEPLATE FOR ABANDONED RECESSED BACKBOXES.
- 2 REMOVE RECEPTACLES, RACEWAY, CONDUCTORS, AND ASSOCIATED ACCESSORIES BACK TO SOURCE. RECESSED BACKBOXES AND CONCEALED RACEWAYS SHALL BE ABANDONED IN PLACE. PROVIDE BLANK STAINLESS STEEL FACEPLATE FOR ABANDONED RECESSED BACKBOXES.
- REMOVE EXISTING BACKBOXES, RACEWAY, AND ASSOCIATED ACCESSORIES. PATCH AND REPAIR AFFECTED SURFACES TO MATCH EXISTING.
- REMOVE RECESSED BACKBOX AND BLANK FACEPLATE. PATCH AND REPAIR AFFECTED SURFACES TO MATCH EXISTING.
- REMOVE RACEWAYS, CONDUCTORS, SWITCHES, AND COMPONENTS ASSOCIATED WITH MECHANICAL EQUIPMENT SCHEDULED TO BE REMOVED.
- REMOVE ALL EXTERIOR CANOPY LIGHT FIXTURES, CONDUCTORS, AND BACKBOXES BACK TO SOURCE. EXISTING CONCEALED RACEWAY TO BE ABANDONED IN PLACE. PATCH AND REPAIR AFFECTED SURFACES TO MATCH EXISTING.
- (7) EXISTING TELECOMMUNICATION CABLING AND DATA JACK TO REMAIN.
- (8) REMOVE RACEWAY, CONDUCTORS, AND ALL ACCESSORIES ASSOCIATED WITH ACTUATED LOUVERS BACK TO SOURCE.
- 9 EXISTING JUNCTION BOX, RACEWAYS, AND CONDUCTORS TO BE MAINTAINED DURING CONSTRUCTION.
- (10) EXISTING CAMERAS, RACEWAYS, AND CONDUCTORS TO REMAIN, UNLESS OTHERWISE NOTED.
- RELOCATE EXISTING CCTV HEADEND UNIT. REFER TO NEW WORK DRAWINGS FOR NEW LOCATION.
- RELOCATE EXISTING CCTV MONITOR. REFER TO NEW WORK DRAWINGS FOR NEW LOCATION.



PROJECT COORDINATOR

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CITY OF PHILADELPHIA DEPARTMENT OF PUBLIC PROPERTY

1515 ARCH STREET 11TH FLOOR, ONE PARKWAY BUILDING PHILADELPHIA, PENNSYLVANIA

PROJECT TITLE

MILES MACK PLAYGROUND BUILDING RENOVATION

DRAWING TITLE

7

FLOOR PLAN - ELECTRICAL DEMOLITION


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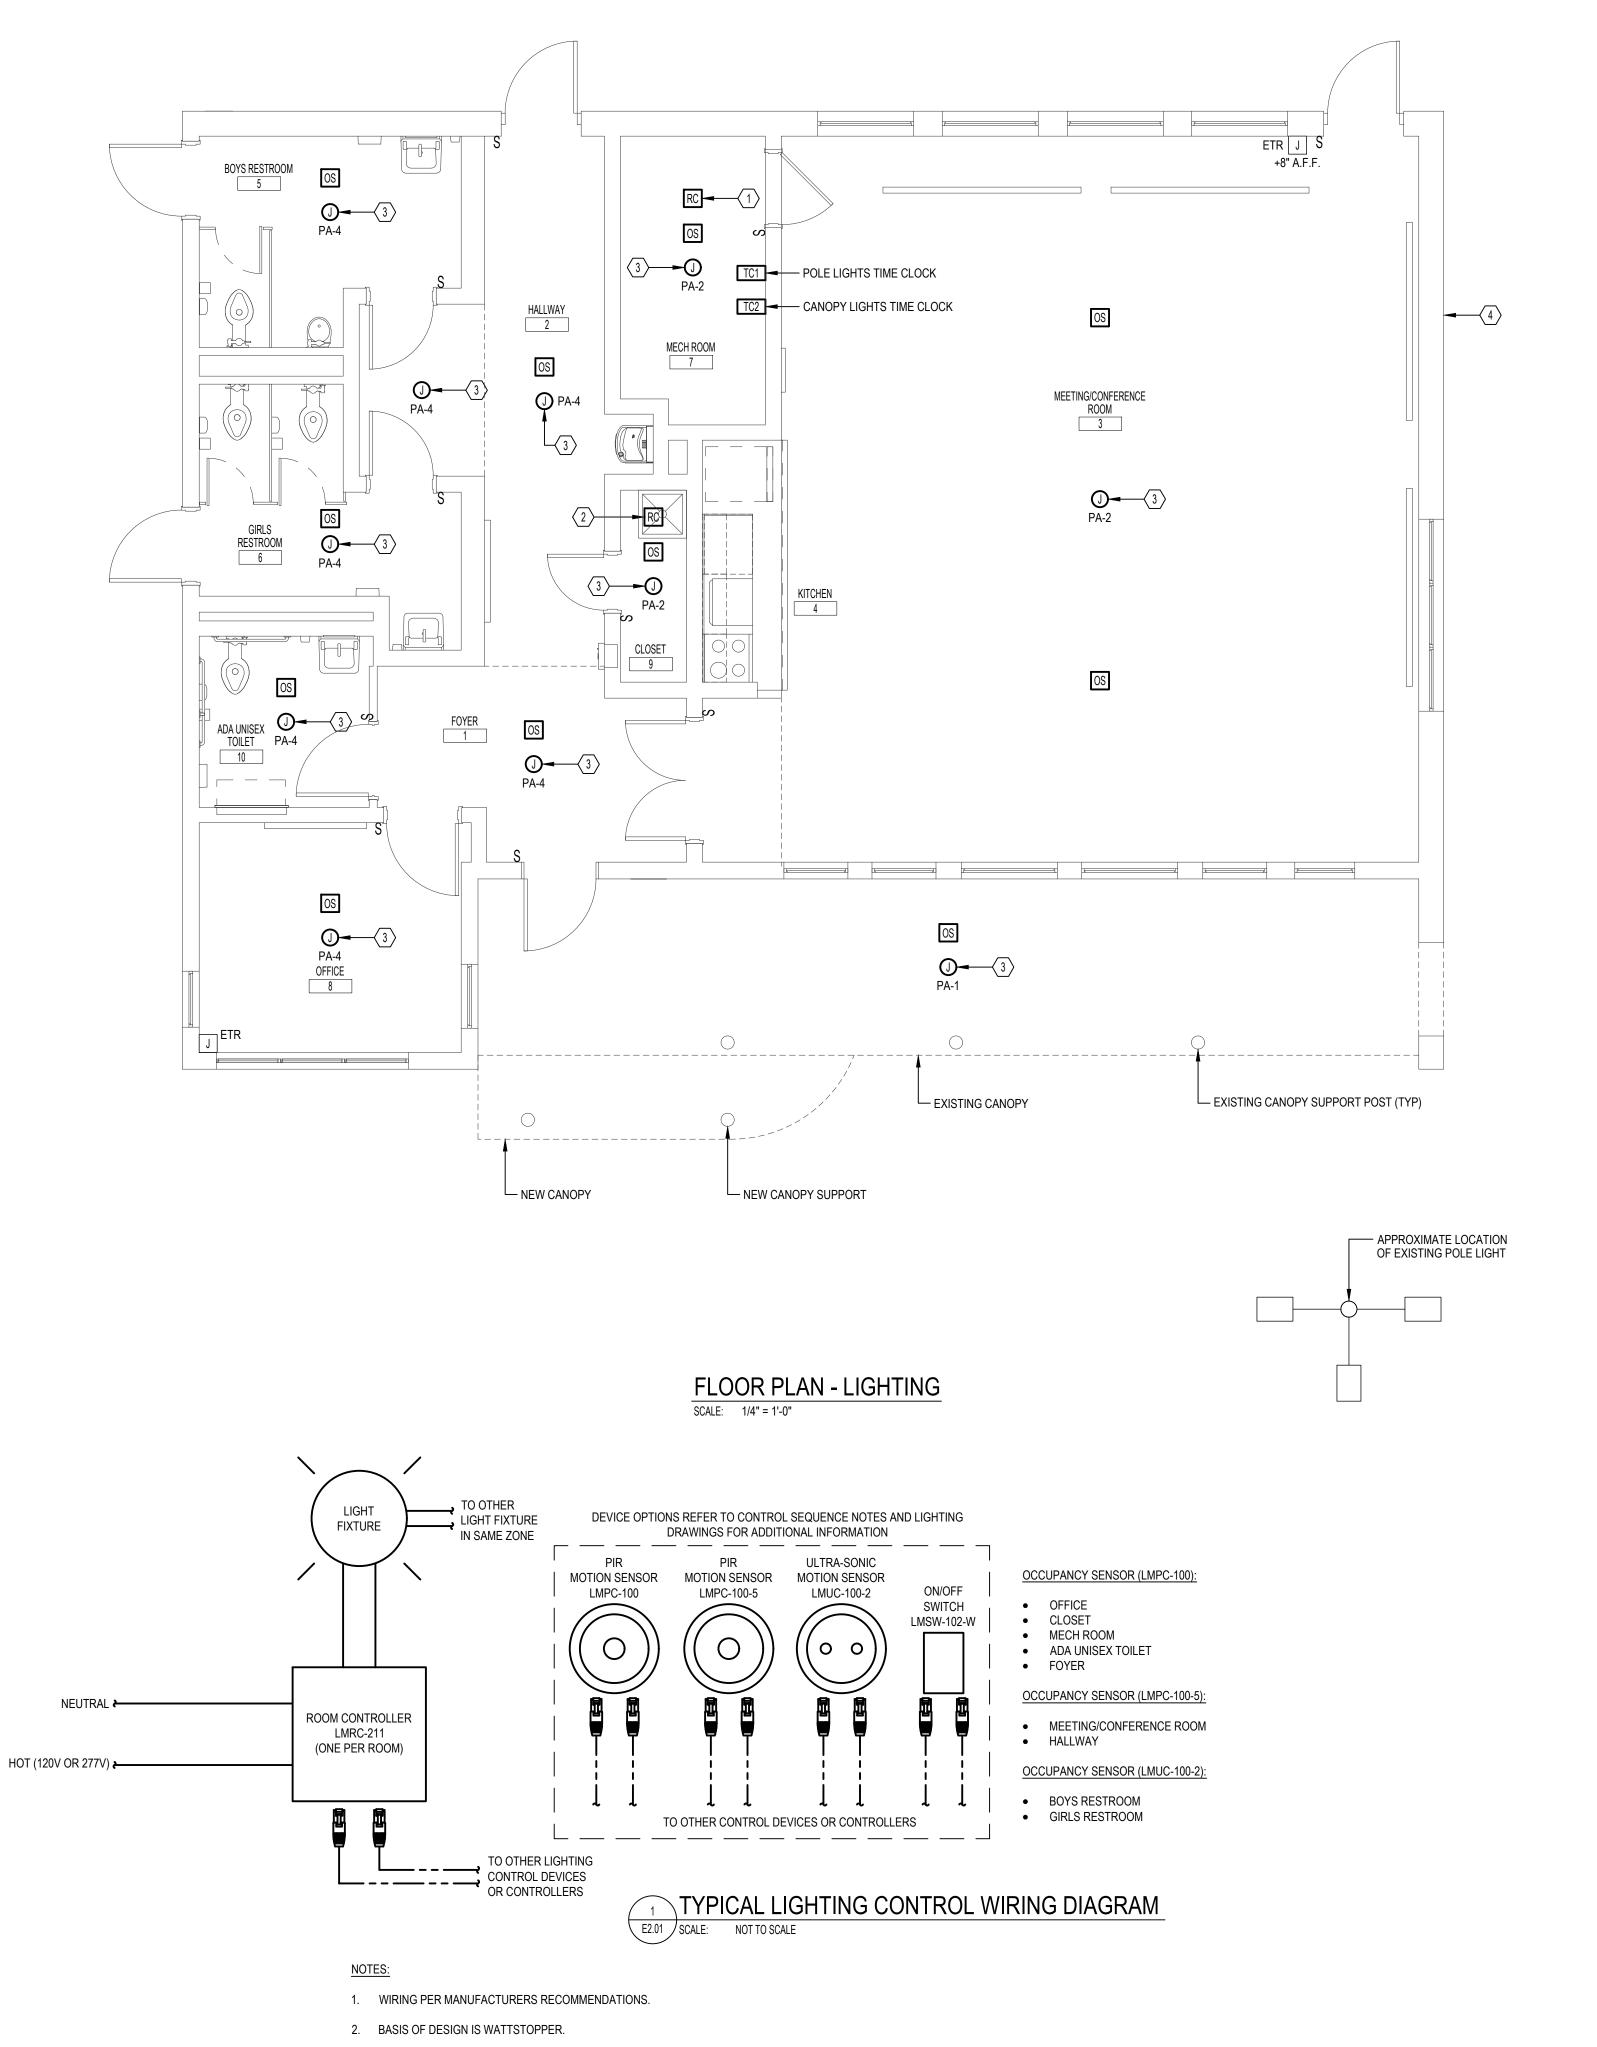
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E1.01 SCALE: AS NOTED DRAWN BY:

TDB FILE: CHECKED BY: NOTE: ALL DIMENSIONS AND CONDITIONS SHALL BE VERIFIED BY THE CONTRACTOR AT THE SITE BEFORE PROCEEDING WITH THE





3. ROOM CONTROLLER SHALL BE MOUNTED AS INDICATED ON

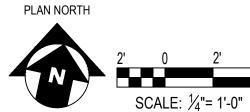4. COORDINATE QUANTITY OF DEVICE PER CONTROLLER.

### **GENERAL NOTES:**

- 1. CONDUIT SHALL BE ROUTED ABOVE NEW CEILING AND ON THE SURFACE OF EXISTING CEILINGS AND WALLS.
- 2. DEVICES AND EQUIPMENT MOUNTED ON EXISTING WALLS SHALL BE SURFACE MOUNTED.
- 3. CONTRACTOR SHALL TEST FOR WIRE MAP AND CONTINUITY FOR ALL NEW CAT 5E CABLES.

### **DRAWING NOTES:**

- (1) WALL MOUNT ROOM CONTROLLERS. ROOM CONTROLLERS FOR:
  - MEETING/CONFERENCE ROOM MECH ROOM
- CLOSET
- 2 WALL MOUNT ROOM CONTROLLERS. ROOM CONTROLLERS FOR:
  - HALLWAYBOYS RESTROOM
  - GIRLS RESTROOM
  - ADA UNISEX TOILET OFFICE
- 3 INTERIOR LIGHT FIXTURES, LAYOUT, PHOTOMETRICS, AND COMCHECK PROVIDED BY OWNER.
- EXTERIOR LIGHT FIXTURES, LAYOUT, PHOTOMETRICS, AND COMCHECK PROVIDED BY OWNER.

### LIGHTING CONTROL SEQUENCE:

CONTROLLER: ROOM CONTROLLER
MOTION SENSOR: PIR OR ULTRA-SONIC (PERMISSIVE)
MANUAL CONTROL: SWITCHES (MASTER)
CONTROL SEQUENCE:

OCCUPIED: ON (MANUAL)VACANT: OFF (AUTO/MANUAL)

REGISTERED
PROFESSIONALO
THOMASIO. BLISS
ENGINEER
PEO77256
PO7-7250
SYLV

Contact: Charles Mottershead, 215.683-4466

PROJECT COORDINATOR

Philadelphia Parks & Recreation and Department of Public Property 1515 Arch Street, 11th Floor Philadelphia, PA 19102

### PROJECT TEAM

SEAL

REVISIONS

ISSUE DATE

DESCRIPTION

### ARCHITECT:

JMT I ARCHITECTURE JOHNSON, MIRMIRAN, AND THOMPSON, INC. 1600 MARKET STREET, SUITE 520 PHILADELPHIA, PA 19103 267.256.0300 I WWW.JMT.COM

### STRUCTURAL ENGINEER:

JOHNSON, MIRMIRAN, AND THOMPSON, INC. 1600 MARKET STREET, SUITE 520 PHILADELPHIA, PA 19103 267.256.0300 I WWW.JMT.COM

### SYSTEMS ENGINEER:

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CITY OF PHILADELPHIA

DEPARTMENT OF PUBLIC PROPERTY

1515 ARCH STREET

11TH FLOOR, ONE PARKWAY BUILDING

PHILADELPHIA, PENNSYLVANIA

PROJECT TITLE
MILES MACK PLAYGROUND BUILDING

### DRAWING TITLE

RENOVATION

7

FLOOR PLAN - LIGHTING

DRAWING NO.

E2.01

PROJECT NO. 18-00355-001

18-00355-001 DATE: 02.07.2020


WORK.

SCALE: AS NOTED

DRAWN BY: MJC

CHECKED BY: TDB FILE:

NOTE: ALL DIMENSIONS AND CONDITIONS SHALL
BE VERIFIED BY THE CONTRACTOR AT
THE SITE BEFORE PROCEEDING WITH THE

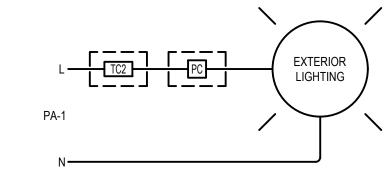


TYPICAL CANOPY / BUILDING MOUNTED LIGHTING CONTROL WIRING DIAGRAM

SCALE: NOT TO SCALE

### NOTES:


- PHOTOCELL SHALL FAIL CLOSED.
- 2. AUTO: PHOTOCELL ( PC ) PERMISSIVE WITH TIME CLOCK ( TC ) ON/OFF.

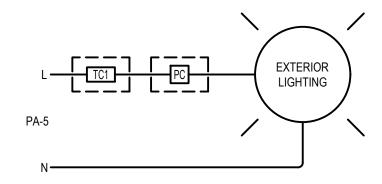


3 TYPICAL POLE LIGHTING CONTROL WIRING DIAGRAM
E2.01 SCALE: NOT TO SCALE

### NOTES:

- 1. PHOTOCELL SHALL FAIL CLOSED.
- 2. AUTO: PHOTOCELL ( PC ) PERMISSIVE WITH TIME CLOCK ( TC ) ON/OFF.

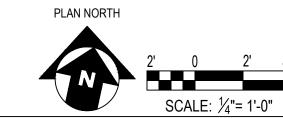

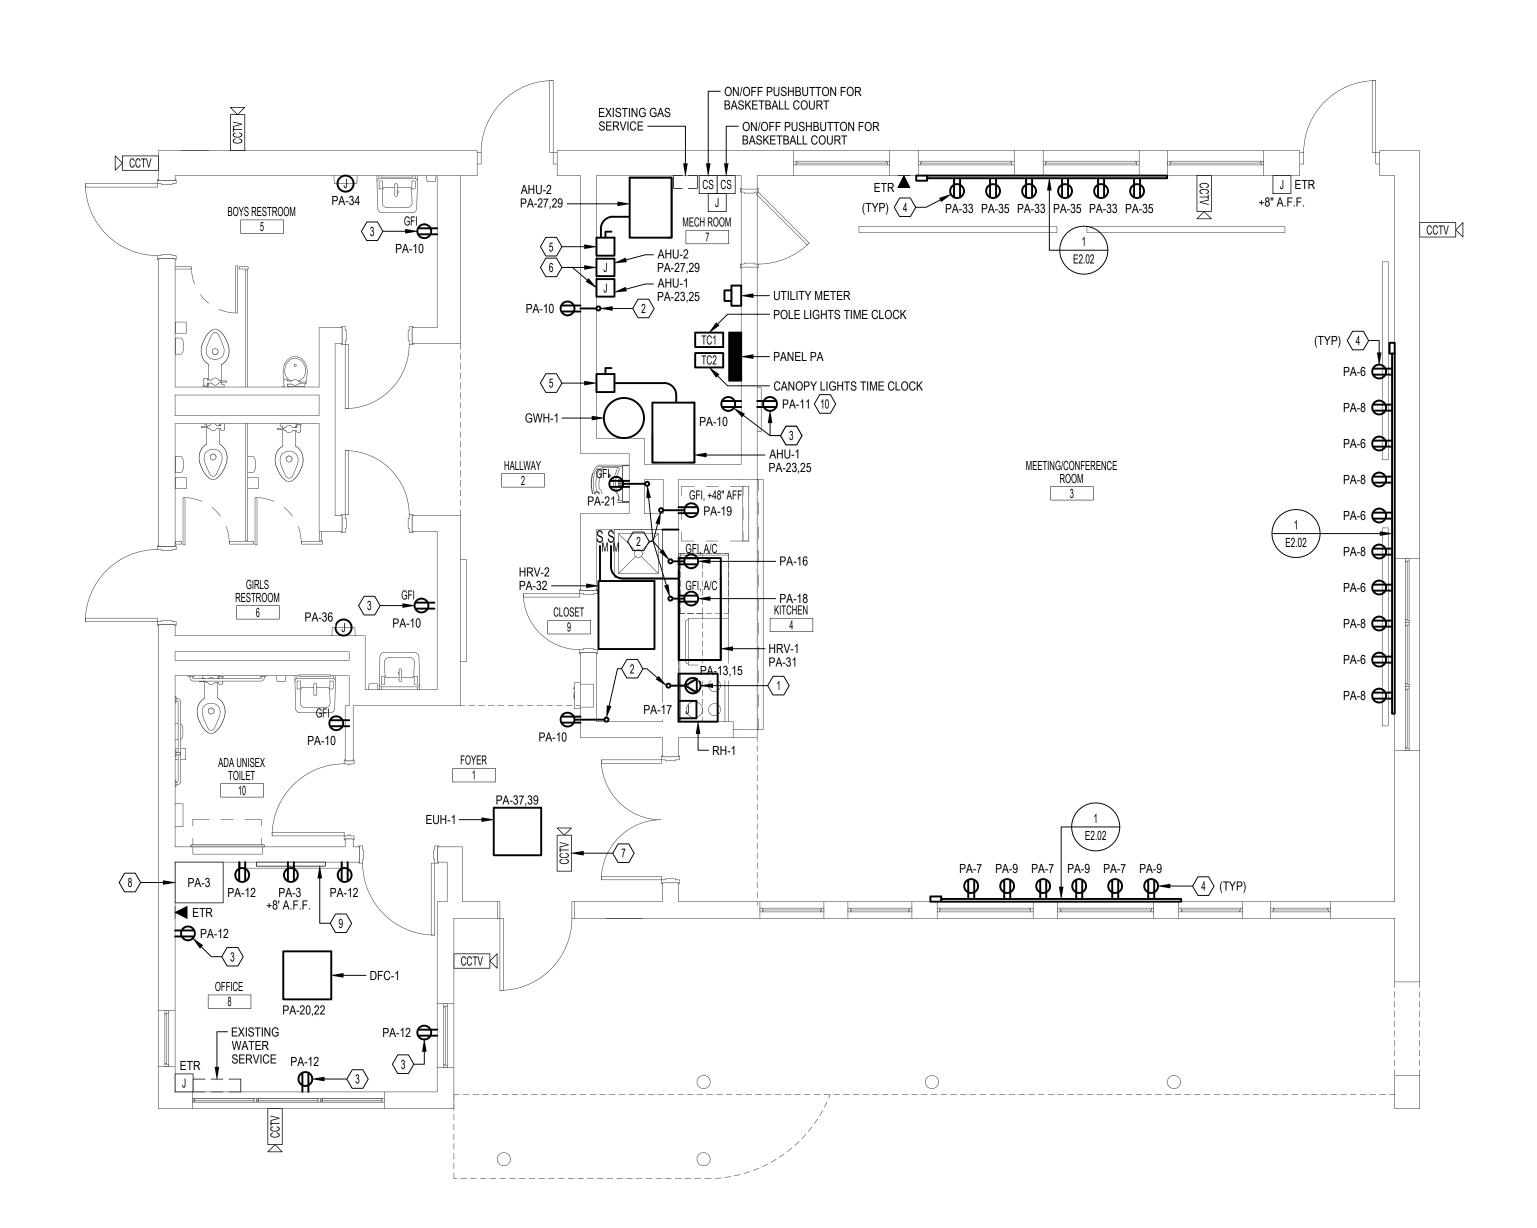


FLOOR PLAN - ELECTRICAL E2.02 | SCALE: 1/4" = 1'-0"

### **GENERAL NOTES:**


- 1. CONDUIT SHALL BE ROUTED ABOVE NEW CEILING AND ON THE SURFACE OF EXISTING CEILINGS AND WALLS.
- 2. DEVICES AND EQUIPMENT MOUNTED ON EXISTING WALLS SHALL BE SURFACE MOUNTED.
- 3. CONTRACTOR SHALL TEST FOR WIRE MAP AND CONTINUITY FOR ALL NEW CAT 5E CABLES.

### **DRAWING NOTES:**

- (1) COORDINATE EXACT LOCATION AND SPECIAL RECEPTACLE TYPE WITH MAKE AND MODEL OF RANGE.
- 2 RECESSED RECEPTACLE (NEW). PENETRATE WALL TO CONDUIT ON OPPOSITE SIDE OF WALL.
- PROVIDE SURFACE MOUNTED BACKBOX AND CONDUIT FOR NEW RECEPTACLE ON EXISTING WALL.
- ELECTRICAL RECEPTACLE TO BE MOUNTED IN TWO CHANNEL RACEWAY.
- 5 60A, NEMA 1, DISCONNECT SWITCH.
- 6 INTERFACE CONTROLLER PANELS FOR AHU-1 & AHU-2.
- 7 REINSTALL CAMERA TO ORIGINAL LOCATION AND RECONNECT CABLING.
- 8 REINSTALL CCTV HEADEND UNIT AND EXTEND/RECONNECT CABLING.
- 9 REINSTALL TELEVISION AND RECONNECT CABLING.
- 10 FIELD COORDINATE FINAL LOCATION OF CHEST FREEZER RECEPTACLE.

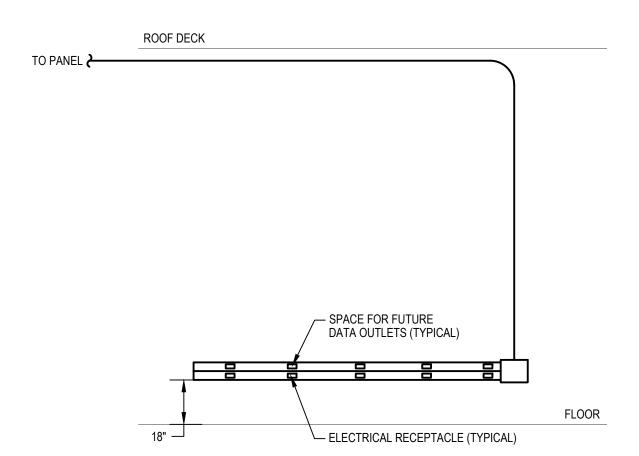

TYPICAL TWO CHANNEL METALLIC SURFACE MOUNT RACEWAY E2.02 | SCALE: NOT TO SCALE

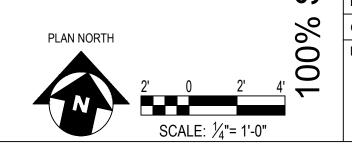

DESCRIPTION

PROJECT COORDINATOR

Philadelphia Parks & Recreation and Department of Public Property 1515 Arch Street, 11th Floor Philadelphia, PA 19102 Contact: Charles Mottershead, 215.683-4466

SEAL

REVISIONS

ISSUE DATE



### PROJECT TEAM

### ARCHITECT:

JMT I ARCHITECTURE JOHNSON, MIRMIRAN, AND THOMPSON, INC. 1600 MARKET STREET, SUITE 520 PHILADELPHIA, PA 19103 267.256.0300 I WWW.JMT.COM

### STRUCTURAL ENGINEER:

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CITY OF PHILADELPHIA

DEPARTMENT OF PUBLIC PROPERTY 1515 ARCH STREET 11TH FLOOR, ONE PARKWAY BUILDING

PHILADELPHIA, PENNSYLVANIA

PROJECT TITLE

MILES MACK PLAYGROUND BUILDING RENOVATION 2

DRAWING TITLE

FLOOR PLAN - POWER

PROJECT NO.

18-00355-001 DATE: 02.07.2020


E2.02 SCALE: AS NOTED DRAWN BY: MJC

CHECKED BY: TDB FILE: NOTE: ALL DIMENSIONS AND CONDITIONS SHALL

DRAWING NO.

BE VERIFIED BY THE CONTRACTOR AT THE SITE BEFORE PROCEEDING WITH THE

### **DRAWING NOTES:**

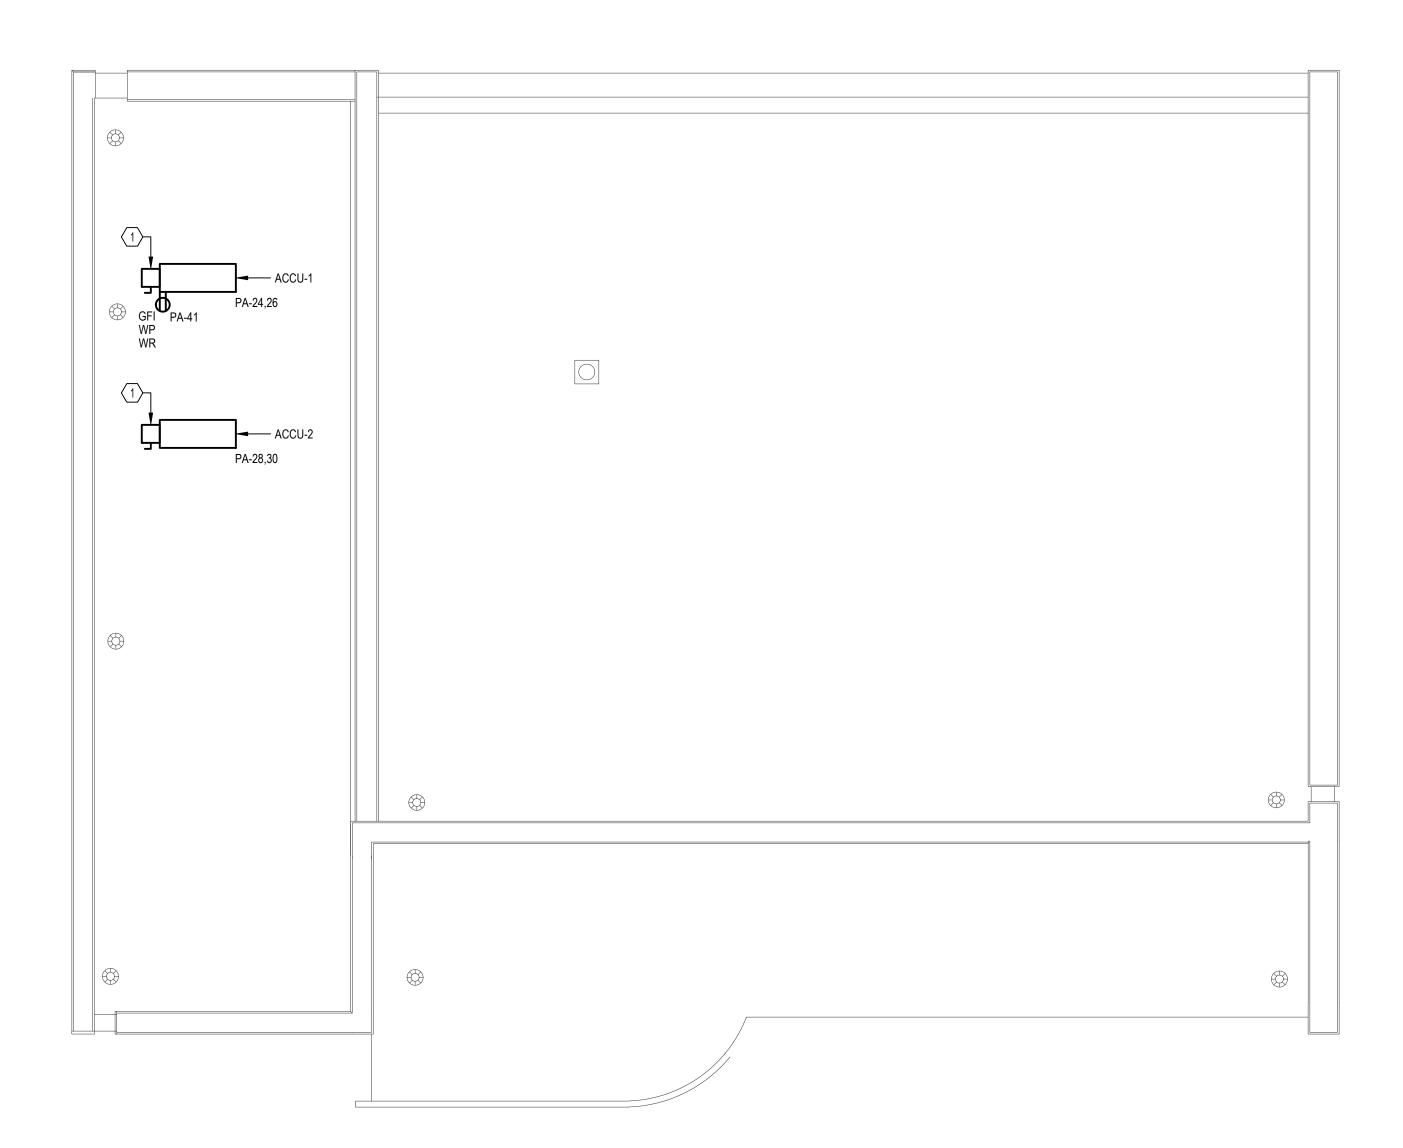

ROOF PLAN - ELECTRICAL SCALE: 1/4" = 1'-0"

60A, NEMA 3R, DISCONNECT SWITCH.



DESCRIPTION

PROJECT COORDINATOR

Philadelphia Parks & Recreation and Department of Public Property 1515 Arch Street, 11th Floor Philadelphia, PA 19102 Contact: Charles Mottershead, 215.683-4466

REVISIONS

ISSUE DATE



### PROJECT TEAM

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CITY OF PHILADELPHIA DEPARTMENT OF PUBLIC PROPERTY

1515 ARCH STREET 11TH FLOOR, ONE PARKWAY BUILDING PHILADELPHIA, PENNSYLVANIA

PROJECT TITLE MILES MACK PLAYGROUND BUILDING RENOVATION

DRAWING TITLE

2

Submission

**ROOF PLAN - POWER** 


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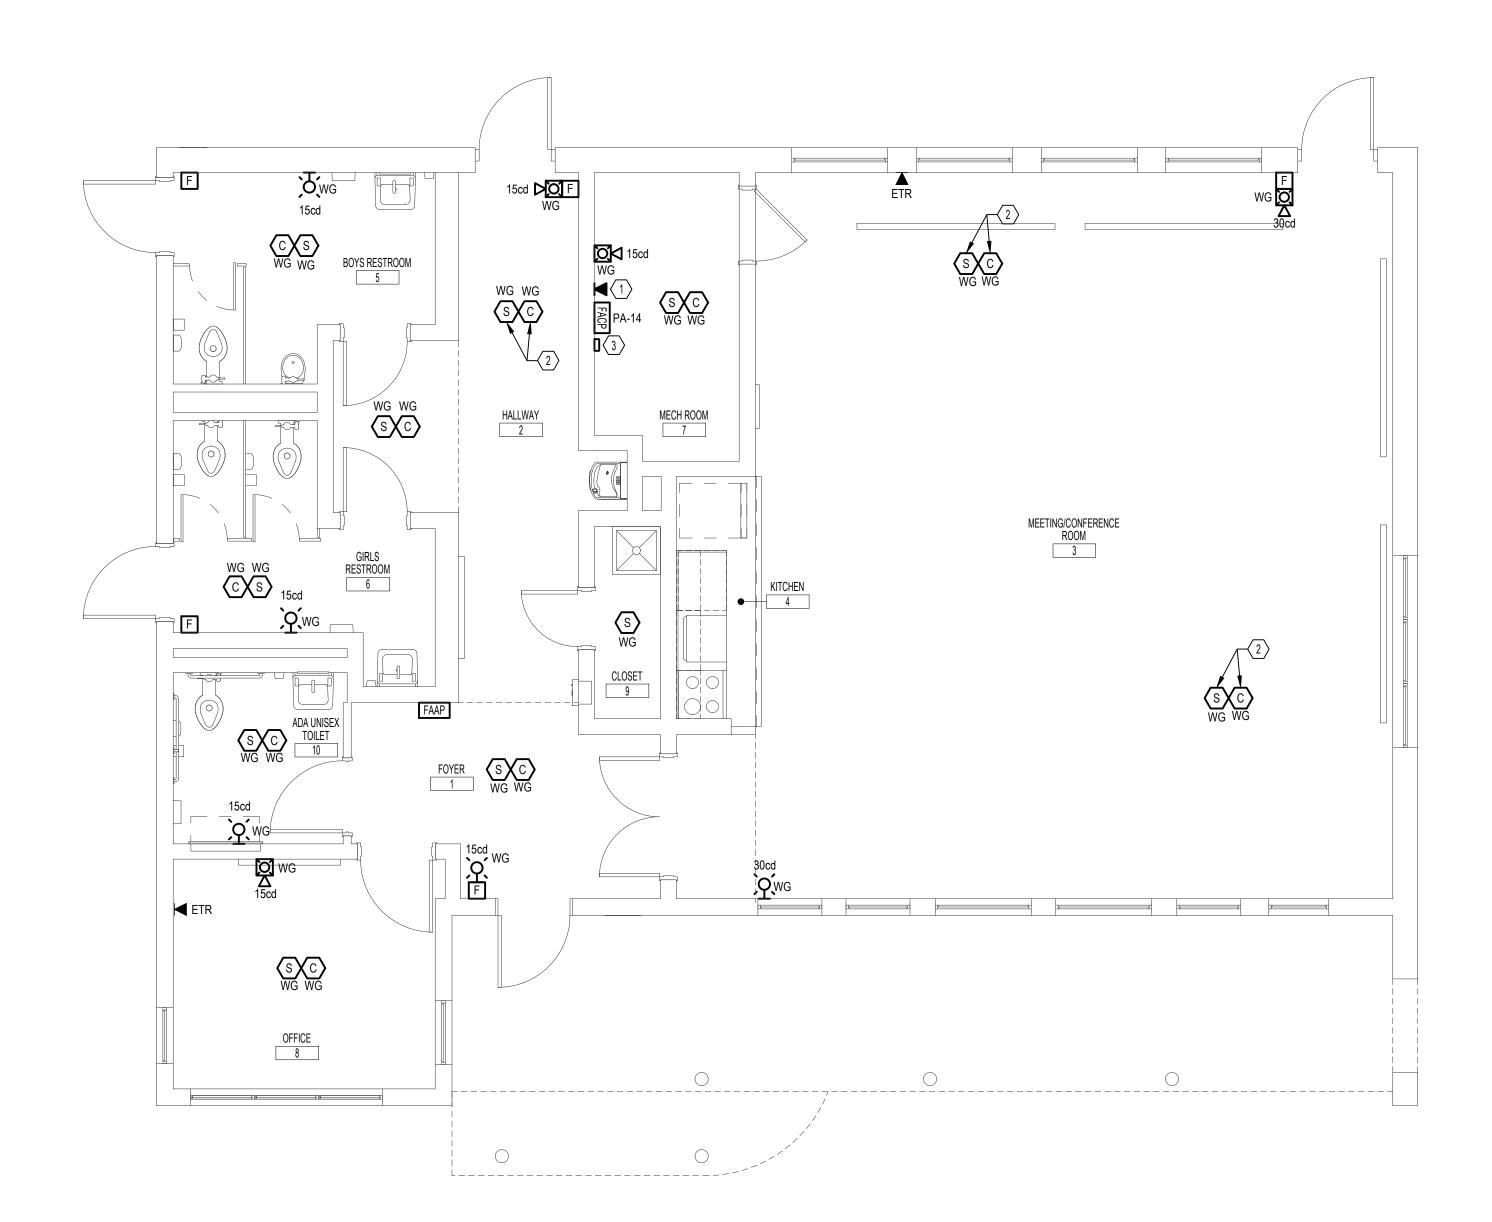
PROJECT NO. 18-00355-001

DATE: 02.07.2020 SCALE: AS NOTED

DRAWN BY: TDB FILE: CHECKED BY:

NOTE: ALL DIMENSIONS AND CONDITIONS SHALL
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THE SITE BEFORE PROCEEDING WITH THE WORK.



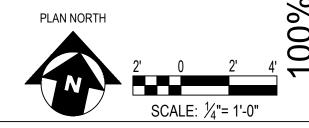

FLOOR PLAN - ELECTRICAL SCALE: 1/4" = 1'-0"

### **GENERAL NOTES:**

- 1. CONDUIT SHALL BE ROUTED ABOVE NEW CEILING AND ON THE SURFACE OF EXISTING CEILINGS AND WALLS.
- 2. DEVICES AND EQUIPMENT MOUNTED ON EXISTING WALLS SHALL BE SURFACE MOUNTED.
- 3. CONTRACTOR SHALL TEST FOR WIRE MAP AND CONTINUITY FOR ALL NEW CAT 5E CABLES.

### **DRAWING NOTES:**


- VOICE OUTLET FOR FIRE ALARM CONTROL PANEL. CONTRACTOR TO INSTALL TWO CAT 5E CABLES IN 3/4"C. FROM VOICE OUTLET TO BUILDING PUNCH-DOWN BLOCKS.
- 2 MOUNT FIRE ALARM DEVICE TO BOTTOM CHORD OF BEAM.
- PROVIDE CROSS CONNECT PUNCH DOWN BLOCKS AND SURGE PROTECTION FOR INCOMING PHONE LINES. CONTRACTOR TO REROUTE EXISTING TELECOM UTILITY CABLES TO NEW SURGE PROTECTION AND PUNCH DOWN



DESCRIPTION

REVISIONS

ISSUE DATE

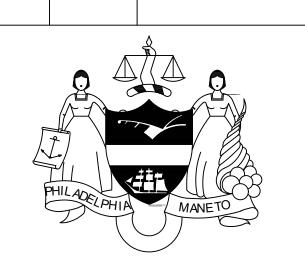

PROJECT COORDINATOR

Philadelphia Parks & Recreation and Department of Public Property 1515 Arch Street, 11th Floor Philadelphia, PA 19102 Contact: Charles Mottershead, 215.683-4466



### PROJECT TEAM

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CITY OF PHILADELPHIA DEPARTMENT OF PUBLIC PROPERTY

1515 ARCH STREET 11TH FLOOR, ONE PARKWAY BUILDING PHILADELPHIA, PENNSYLVANIA

PROJECT TITLE MILES MACK PLAYGROUND BUILDING RENOVATION

DRAWING TITLE

7

FLOOR PLAN - SPECIAL SYSTEMS

PROJECT NO. 18-00355-001

DATE: 02.07.2020 SCALE: AS NOTED DRAWN BY:


CHECKED BY: TDB FILE:

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DRAWING NO.


E2.04



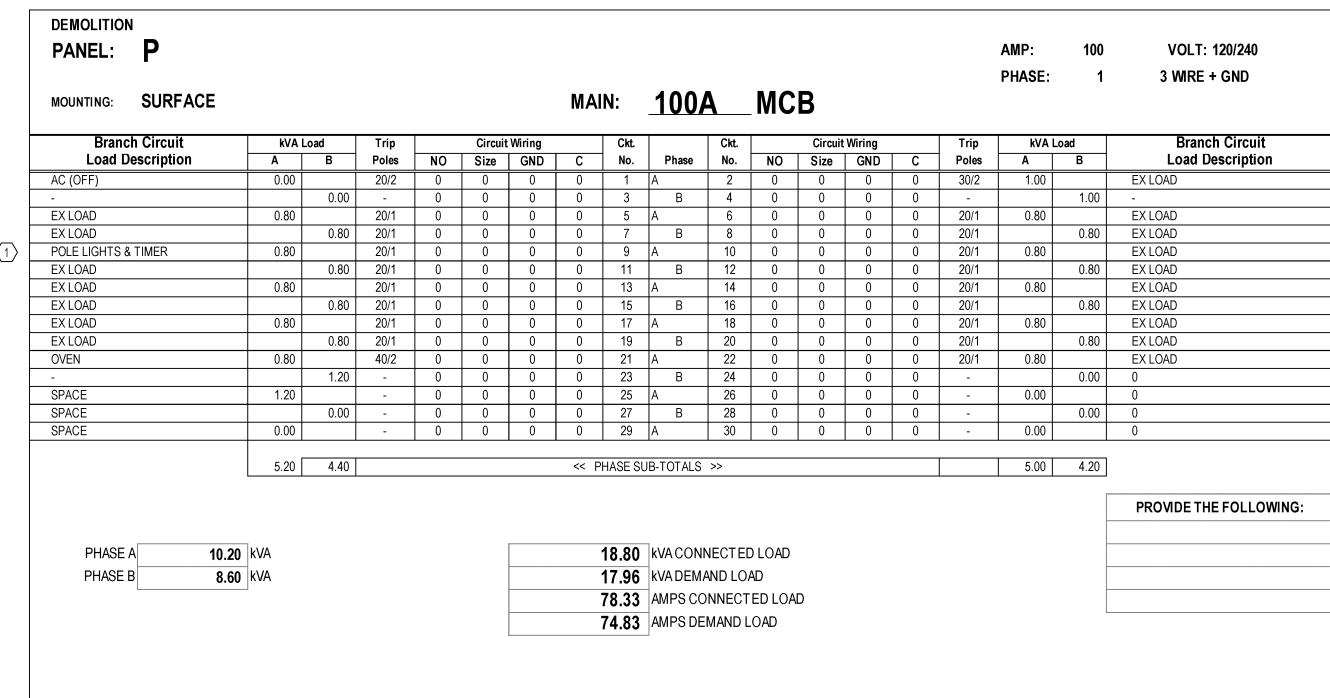

### PANEL SCHEDULE NOTES:

(1) EXISTING LIGHTING CIRCUIT TO BE REROUTED TO NEW PANELBOARD.

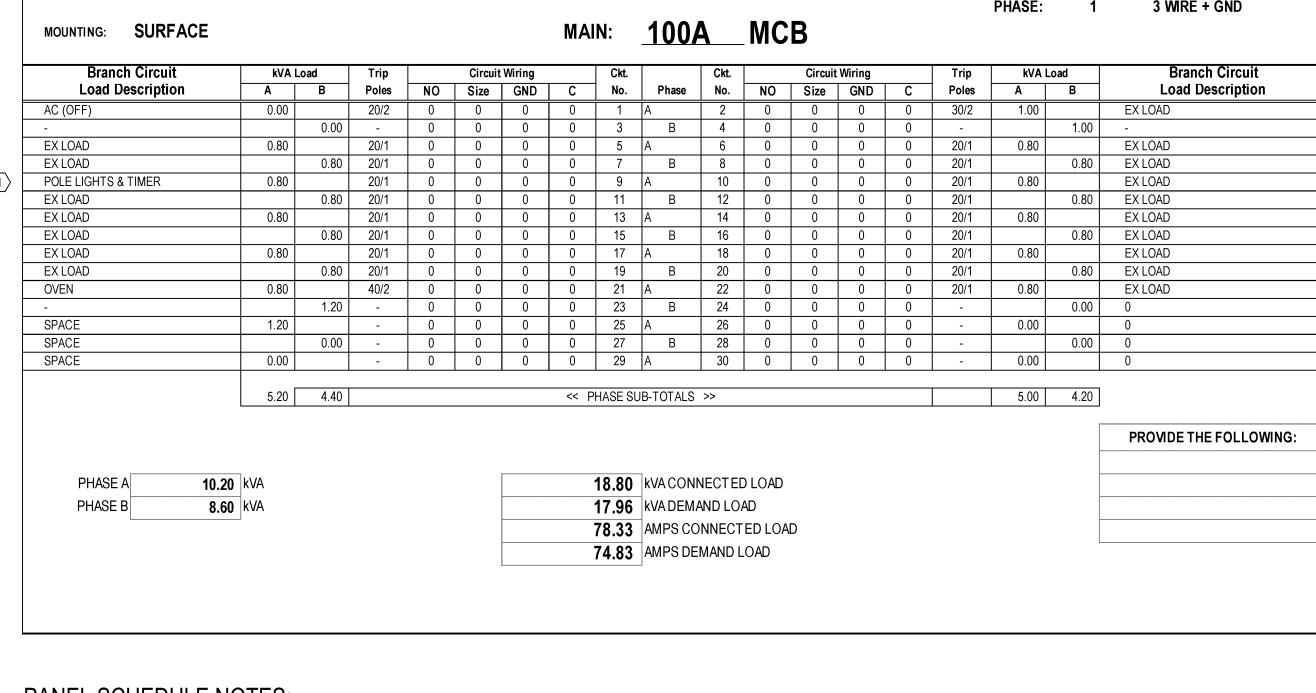

NEW PANEL: PA VOLT: 120/240 3 WRE + GND MOUNTING: SURFACE 22k AMPS RMS SYM

<< PHASE SUB-TOTALS >>

Branch Circuit	kVA I	Load	Trip		Circuit	Wiring		Ckt.		Ckt		Circuit	Wiring		Trip	kVA I	_oad	Branch Circuit
Load Description	A	В	Poles	NO	Size	GND	С	No.	Phase	No.	NO	Size	GND	С	Poles	A	В	Load Description
EXTERIOR LIGHTING	0.80		20/1 *	2	12	12	3/4	1	A	2	2	12	12	3/4	20/1	0.80		INTERIOR LIGHTING
HEADEND UNIT & RECEPTACLE		0.80	20/1	2	12	12	3/4	3	В	4	2	12	12	3/4	20/1		0.80	INTERIOR LIGHTING
EXISTING POLE LIGHTS	0.80		20/1 *	2	12	12	3/4	5	A	6	2	12	12	3/4	20/1	0.90		MEETING/CONFERENCE ROOM RECEPTS.
MEETING/CONFERENCE ROOM RECEPTS.		0.54	20/1	2	12	12	3/4	7	В	8	2	12	12	3/4	20/1		0.90	MEETING/CONFERENCE ROOM RECEPTS.
MEETING/CONFERENCE ROOM RECEPTS.	0.54		20/1	2	12	12	3/4	9	A	10	2	12	12	3/4	20/1	1.08		RESTROOM, HALLWAY, MECH ROOM, TOILET RECEPTS.
CHEST FREEZER		3.00	20/1	2	12	12	3/4	11	В	12	2	12	12	3/4	20/1		0.72	OFFICE RECEPTS.
RANGE	2.00		50/2	2	8	10	3/4	13	A	14	2	12	12	3/4	20/1 *	0.50		FIRE ALARM CONTROL PANEL
-		2.00	-	-	-	-	-	15	В	16	2	12	12	3/4	20/1		0.50	KITCHEN COUNTERTOP RECEPT.
RANGE HOOD	0.17		20/1	2	12	12	3/4	17	A	18	2	12	12	3/4	20/1	0.50		KITCHEN COUNTERTOP RECEPT.
KITCHEN REFRIGERATOR RECEPT.		1.00	20/1	2	12	12	3/4	19	В	20	2	12	12	3/4	15/2		0.08	DFC-1
WATER FOUNTAIN RECEPT.	1.00		20/1	2	12	12	3/4	21	A	22	-	-	-	1	-	0.02		-
AHU-1		3.42	60/2	2	6	10	1	23	В	24	2	8	10	3/4	40/2		2.44	ACCU-1
-	3.42		-	] -	-	[ -	-	25	]A	26	-	-	-		-	2.44		•
AHU-2		2.02	35/2	2	10	10	3/4	27	В	28	2	8	10	3/4	40/2		2.44	ACCU-2
-	2.02		ī	-	-	-	-	29	A	30	-	-	-	ı	-	2.44		-
HRV-1		0.63	15/1	2	12	12	3/4	31	В	32	2	12	12	3/4	15/1		0.90	HRV-2
MEETING/CONFERENCE ROOM RECEPTS.	0.54		20/1	2	12	12	3/4	33	A	34	2	12	12	3/4	20/1	0.95		HAND DRYER
MEETING/CONFERENCE ROOM RECEPTS.		0.54	20/1	2	12	12	3/4	35	В	36	2	12	12	3/4	20/1		0.95	HAND DRYER
EUH-1	2.30		30/2	2	10	10	3/4	37	A	38	0	0	0	0	20/1	0.00		SPARE
-		2.30	-	-	-	-	-	39	В	40	0	0	0	0	20/1		0.00	SPARE
ROOFTOP RECEPTACLE	0.18		20/1	2	12	12	3/4	41	A	42	-	-	- [	,	20/1	0.00		SPARE
SPARE			20/1	-	-	-	-	43	В	44	-	-	-		20/1			SPARE
SPARE	0.00		20/1	-	-	-	-	45	A	46	-	-	-	-	20/1	0.00		SPARE
SPARE		0.00	20/1	] -		-	-	47	В	48	-	-	-	-	20/1		0.00	SPARE
SPARE	0.00		20/1	-	-	-	-	49	A	50	0	0	0	0	20/1	0.00		SPARE
SPARE		0.00	20/1	-	-	-	-	51	В	52	-	-	-	-	30/2**		0.00	SURGE PROTECTION
SPARE	0.00		20/1	-	-	-	-	53	A	54	-	-	-	-	-	0.00		•

PHASE A 49.38 kVA CONNECTED LOAD 25.84 kVA PHASE B 47.83 kVA DEMAND LOAD 25.98 kVA 205.74 AMPS CONNECTED LOAD 199.30 AMPS DEMAND LOAD


13.77 16.25

PROVIDE THE FOLLOWING: = LOCK OUT \*\* = PRE-INSTALLED CONDUCTORS

12.07 9.73

RX CANOPY LIGHTS TIME CLOCK RX UTILITY METER RX ELECTRICAI PANEL P RX POLE LIGHTS TIME CLOCK RX INCOMING UTILITY 🗲 — —



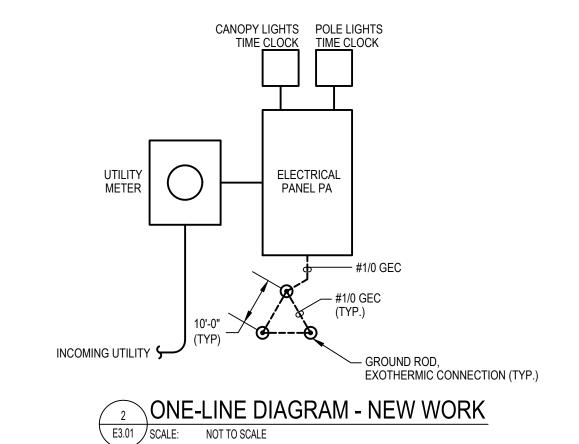

CONTRACTOR / UTILITY COORDINATION:

1. NEW ELECTRIC SERVICE SHALL BE OBTAINED FROM PECO ENERGY COMPANY AND SHALL BE IN STRICT COMPLIANCE WITH THE REQUIREMENTS OF THE POWER COMPANY AND SHALL INCLUDE ALL REQUIRED METERING FACILITIES.

2. THE CONTRACTOR SHALL SUBMIT A SERVICE AND METER APPLICATION ON THE FORM FURNISHED BY PECO ENERGY COMPANY PRIOR TO THE START OF WORK.

3. THE CONTRACTOR SHALL PLACE "ONE-CALL" TO DETERMINE THE LOCATIONS OF UTILITIES, IN THE AREA OF THE WORK, THAT MAY BE COMPROMISED OR OTHERWISE INTERFERE WITH THE WORK OF THIS CONTRACT. ANY CONFLICT FOUND SHALL BE IMMEDIATELY BE REPORTED TO THE DEPARTMENT.

4. CONFER AND COOPERATE WITH PECO ENERGY COMPANY IN ARRANGING FOR THE INSTALLATION, LOCATION AND DETAILS OF THE INCOMING SERVICE. PAY ALL CHARGES THAT MAY BE LEVIED BY THE POWER COMPANY FOR EXTRAORDINARY WORK THAT THEY MAY BE REQUIRED TO PERFORM IN CONJUNCTION WITH SUPPLYING SERVICE TO THE PROJECT.

5. OBTAIN APPROVAL OF METERING LOCATION AND DETAILS FROM POWER COMPANY, PRIOR TO INSTALLATION.

6. PROVIDE ALL REQUIRED EXCAVATION, BACKFILLING AND RESTORATION REQUIRED FOR THE INSTALLATION OF THE ELECTRIC SERVICE. IF REQUIRED, BACKFILLING SHALL BE DONE UNDER THE DIRECTION OF A PECO ENERGY COMPANY FIELD INSPECTOR.

7. PROVIDE UNDERGROUND RACEWAYS, CONDUCTORS, HAND HOLES, AND OTHER EQUIPMENT AND APPURTENANCES REQUIRED FOR A COMPLETE ELECTRIC SERVICE INSTALLATION.

8. PROVIDE ALL REQUIRED METERING FACILITIES, WHERE INDICATED, INCLUDING METER SOCKETS, TROUGHS, JUNCTION BOXES, CURRENT TRANSFORMER ENCLOSURES, SPECIAL CHANNELS AND ALL ACCESSORIES REQUIRED BY THE POWER COMPANY FOR THE INSTALLATION OF THEIR METERING INSTRUMENTS. CONFER WITH PECO ENERGY COMPANY TO ASCERTAIN ALL ITEMS REQUIRED FOR METERING INSTALLATION, PRIOR TO SUBMITTING BID.

DESCRIPTION

PROJECT COORDINATOR

Philadelphia Parks & Recreation and Department of Public Property 1515 Arch Street, 11th Floor Philadelphia, PA 19102 Contact: Charles Mottershead, 215.683-4466

SEAL

REVISIONS

ISSUE DATE



### **PROJECT TEAM**

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CITY OF PHILADELPHIA DEPARTMENT OF PUBLIC PROPERTY

1515 ARCH STREET 11TH FLOOR, ONE PARKWAY BUILDING PHILADELPHIA, PENNSYLVANIA

PROJECT TITLE MILES MACK PLAYGROUND BUILDING RENOVATION

DRAWING TITLE

PANEL SCHEDULES AND ONE-LINE DIAGRAMS

DRAWING NO.

PROJECT NO. 18-00355-001

DATE: 02.07.2020

SCALE: AS NOTED DRAWN BY:

WORK.

TDB | FILE: CHECKED BY: NOTE: ALL DIMENSIONS AND CONDITIONS SHALL BE VERIFIED BY THE CONTRACTOR AT THE SITE BEFORE PROCEEDING WITH THE

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