





LOCATION PLAN

# CITY OF PHILADELPHIA FREE LIBRARY OF PHILADELPHIA

MAYOR - CHERELLE L. PARKER PRESIDENT AND DIRECTOR - FREE LIBRARY - KELLY RICHARDS

# MCPHERSON SQUARE LIBRARY

## PROJECT NO.: 52025E-05-01

601 E Indiana Ave, Philadelphia, PA 19134

## **CONSTRUCTION DOCUMENTATION**

SMPARCHITECTS 1600 Walnut Street, 2nd Floor Philadelphia, Pennsylvania 19103 215 985 4410

<u>CIVIL ENGINEER:</u> KS ENGINEERS, P.C. 530 Walnut Street, Suite 460 Philadelphia, Pennsylvania 19106 215 925 0425

STRUCTURAL ENGINEER: ANN ROTHMANN STRUCTURAL ENGINEERING 100 East Lancaster Avenue, Suite 203 Wayne, Pennsylvania 19087 610 213 3657

ROOFING CONSULTANT STEVE MCLAUGHLIN Steve McLaughlin 210 Garden Avenue Somerdale, NJ 08083 856 287 242

DRAWING LIST

PROJECT USER: FREE LIBRARY OF PHILADELPHIA 1901 Vine Street, Philadelphia, Pennsylvania 19103

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GENERAL CS 1 COVER SHEET GENERAL NOTES, ABBREVIATIONS, MATERIALS, REFERENCE SYMBOLS CIVIL C1.0 C2.0 C3.0 C6.0 C6.1 EXISTING SITE PLAN DEMOLITION PLAN PROPOSED SITE PLAN EROSION AND SEDIMENT CONTROL PLAN EROSION AND SEDIMENT CONTROL DETAILS C6.2 EROSION AND SEDIMENT CONTROL NOTES C7.0 CONSTRUCTION DETAILS C8.0 UTILITY DETAILS C8.1 UTILITY DETAILS ARCHITECTURAL D2.0 **DEMOLITION BASEMENT & ROOF PLAN** DEMOLITION EXTERIOR ELEVATIONS D3.0 DEMOLITION EXTERIOR ELEVATIONS A2.0 FLOOR PLANS ROOF PLAN A2.1 A3.0 EXTERIOR ELEVATIONS A3.1 EXTERIOR ELEVATIONS A8.0 ROOF DETAILS A8.1 CORNICE DETAILS A10.0 DOME INTERIOR PHOTOS STRUCTURAL ROOF FRAMING PLAN, SECTIONS AND NOTES

PROJECT ADMINISTRATO REBUILD PHILADELPHIA Cassie O'Connell, Project Manad 1515 Arch Street, Mezzanine Level Philadelphia, Pennsylvania 19107

PROJECT APPROVED
PROJECT MANAGER/PUBLIC PROPERTY
PROJECT MANAGER/REBUILD
ART COMMISSION
SEALS
CITY OF PHILADELPHIA
DEPARTMENT OF PUBLIC PROPERTY
ROOM 709
PHILADELPHIA PENNSYLVANIA
PROJECT NO. DRAWING NO.
52025E-05-01
DATE 04/15/2024 CS-1
SCALE AS NOTED
DRAWN BY JS
CHECKED BY
NOTE: ALL DIMENSIONS AND CONDITIONS SHALL BE
VERIFIED BY THE CONTRACTOR AT THE SITE BEFORE PROCEEDING WITH THE WORK

### **GENERAL NOTES:**

#### 1. DO NOT SCALE DRAWINGS.

2. THE CONTRACTOR SHALL OBTAIN ALL REQUIRED PERMITS PRIOR TO THE START	
OF CONSTRUCTION.	

3. THE CONTRACTOR SHALL COMPLY WITH ALL FEDERAL, STATE AND LOCAL REGULATIONS, CODES AND ORDINANCES.

4. THE CONTRACTOR SHALL CONFIRM, LOCATE AND COORDINATE WORK WITH HIDDEN MECHANICAL, PLUMBING AND ELECTRICAL CONDITIONS.

5. THE CONTRACTOR SHALL BE RESPONSIBLE FOR ANY DAMAGE TO THE EXISTING BUILDING, SITE AND EQUIPMENT DURING CONSTRUCTION, INCLUDING DAMAGE FROM THE ELEMENTS. THE CONTRACTOR SHALL EXERCISE CARE SO AS NOT TO DAMAGE EXISTING BUILDING DURING CONSTRUCTION. THE CONTRACTOR SHALL REPAIR ANY DAMAGE IMMEDIATELY AND TO THE SATISFACTION OF THE OWNER.

6. THE CONTRACTOR SHALL VERIFY EXISTING CONDITIONS AND DIMENSIONS ON THE JOB SITE. IF EXISTING CONDITIONS DO NOT PERMIT INSTALLATION OF WORK IN ACCORDANCE WITH THE DRAWINGS AND SPECIFICATIONS, NOTIFY THE ARCHITECT AND PROVIDE A SKETCH OF THE CONDITION.

7. DIMENSIONS ARE TO FINISH FACE OF WALL UNLESS NOTED OTHERWISE.

8. THE CONTRACTOR SHALL COORDINATE LOCATION AND SIZE OF ALL OPENINGS WITH ALL TRADES PRIOR TO INSTALLATION.


9. DETAILS SHOWN ARE INTENDED FOR SPECIFIC LOCATIONS AND CONDITIONS. MINOR MODIFICATIONS MAY BE REQUIRED TO SUIT SIMILAR CONDITIONS AND SHALL BE CONSIDERED PART OF THE WORK.

10. UNLESS OTHERWISE INDICATED ON THE DRAWINGS OR IN THE SPECIFICATIONS AS BEING NIC, ALL ITEMS, MATERIALS, ETC. AND INSTALLATION OF SAME ARE A PART OF THE CONTRACT WORK.

11. THE GENERAL CONTRACTOR SHALL COORDINATE ALL SLEEVING WORK, UNO. COORDINATE LOCATION AND SIZE OF ALL OPENINGS, INTERIOR AND/OR EXTERIOR WITH ALL TRADES PRIOR TO INSTALLATION.

#### MATERIAL SYMBOLS:

(LARGE SCALE)

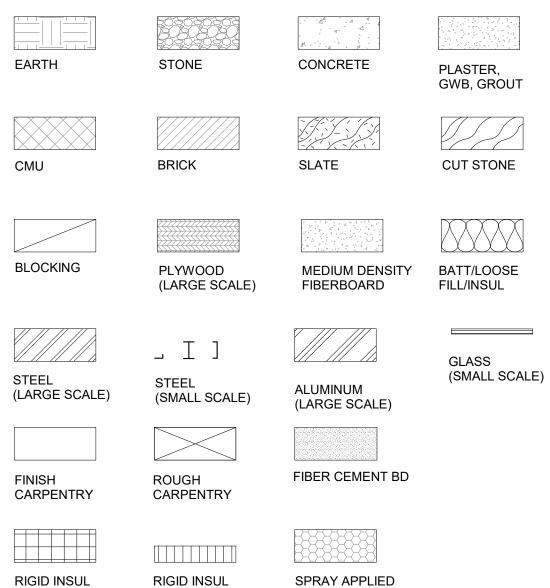

INSUL

(SMALL SCALE)

ALSF ALW ANOD AP APPROX ARCH	ALUMINUM STOREFRONT ALUMINUM WINDOW ANODIZED ACCESS PANEL APPROXIMATE ARCHITECTURAL	FLR FND F.O. FP FT FTG FTR
B B&B BCAB BD BLDG BLKG BLW B.O. BC	BOARD AND BATTEN BASE CABINET BOARD BUILDING BLOCKING BELOW BOTTOM OF BROADLOOM CARPET	<b>G</b> GA GALV GF GLAZ GRG GWB
BM BRK BTW	BEAM BRICK BETWEEN	<b>H</b> HDPE HM HOR
<b>C</b> CAB CB CERT CFMF CJ	CABINET CEMENTBOARD CERTIFIED COLD FORMED METAL FRAMING CONSTRUCTION/CONTROL JOINT	HR HRWD HSS HT HVAC
CL CLG CLR CMU	CENTERLINE CEILING CLEAR/ CLEARANCE CONCRETE MASONRY UNIT	HWH I IGU
COL COMP CONC CONT COORD	COLUMN COMPOSITE CONCRETE CONTINUOUS COORDINATE	INCL INFO INSUL INT
COR CPT CT CUH CW	CORRUGATED CARPET TILE CERAMIC TILE CABINET UNIT HEATER CURTAINWALL	J JT L
<b>D</b> DEMO DIA DIM DN DR	DEMOLISH/DEMOLITION DIAMETER DIMENSION DOWN DOOR	LF LG LIN LLV LTL LT LOUV
DS DTL DWG(S)	DOWNSPOUT DETAIL DRAWING(S)	<b>M</b> MAS MAS DIM
E E EA EJ EL ELEC ELEV EMER EoR EP EPX EQ EQPM	EAST EACH EXPANSION JOINT ELEVATION ELECTRICAL ELEVATOR EMERGENCY ENGINEER OF RECORD ELECTRICAL PANEL EPOXY EQUAL EQUIPMENT	MAS DIM MATL MAX MDF MECH MFR MIN M.O. MR MTD MTL MULL <b>N</b>
ES ETR EWC EXP	EXPOSED STRUCTURE EXISTING TO REMAIN ELECTRIC WATER COOLER EXPOSED	N NA NAT

#### ABBREVIATIONS:

A/E

AB

ABV

ACT ADJ

AFF

AGG

ALCW

AL(ALUM) ALSF

ARCHITECT/ENGINEER

ACOUSTIC CEILING TILE

ADJACENT/ADJUSTABLE

ALUMINUM CURTAINWALL

ALUMINUM STOREFRONT

ABOVE FINISH FLOOR

ANCHOR BOLT

AGGREGATE

ALUMINUM

ABOVE

FD FEC FF FIN FLG FLR FND F.O. FP FT FTG FTR	FLOOR DRAIN FIRE EXTINGUISHEF FACTORY FINISH FINISHED FLOOR EL FINISH(ED) FLASHING FLOOR(ING) FOUNDATION FACE OF FILLER PANEL FOOT (FEET) FOOTING FIN TUBE RADIATOF
<b>G</b> GA GALV GF GLAZ GRG GWB	GAUGE GALVANIZED GROUND FACE GLAZED, GLAZING, ( GLASS REINFORCEI GYPSUM WALLBOAI
H HDPE HM HOR HR HRWD HSS HT HVAC HWH	HIGH DENSITY POLY HOLLOW METAL HORIZONTAL HOUR HARDWOOD HOLLOW STEEL SEC HIGH TEMPERATUR HEAVING/VENTILAT CONDITIONING HOT WATER HEATE
I IGU INCL INFO INSUL INT	INSULATED GLAZING INCLUDING/INCLUDI INFORMATION INSULATED, INSULA INTERIOR
<b>J</b> JT	JOINT
LAM LF LG LIN LLV LTL LT LOUV	LAMINATED LINEAR FEET LONG LINOLEUM LONG LEG VERTICA LINTEL LIGHT LOUVER
M MAS MAS DIM MATL MAX MDF MECH MFR MIN MFR MIN M.O. MR MTD MTL MULL	MASONRY MASONRY DIMENSION MATERIAL MAXIMUIM MEDIUM DENSITY FOU MECHANICAL MANUFACTURER MINIMUM MASONRY OPENING MOISTURE RESISTA MOUNTED METAL MULLION
N NA NAT NIC NIS NOM NTS	NORTH NOT APPLICABLE NATURAL NOT IN CONTRACT NOT IN SCOPE NOMINAL NOT TO SCALE
0	

FA

FCB

FCU

FD

ON CENTER OWNER FURNISHE **OPPOSITE HAND** OPPOSITE OPENING ORIENTED STRAND OUTLINE

OC


OFE

OH

OPP OPG

OSB

OTLN

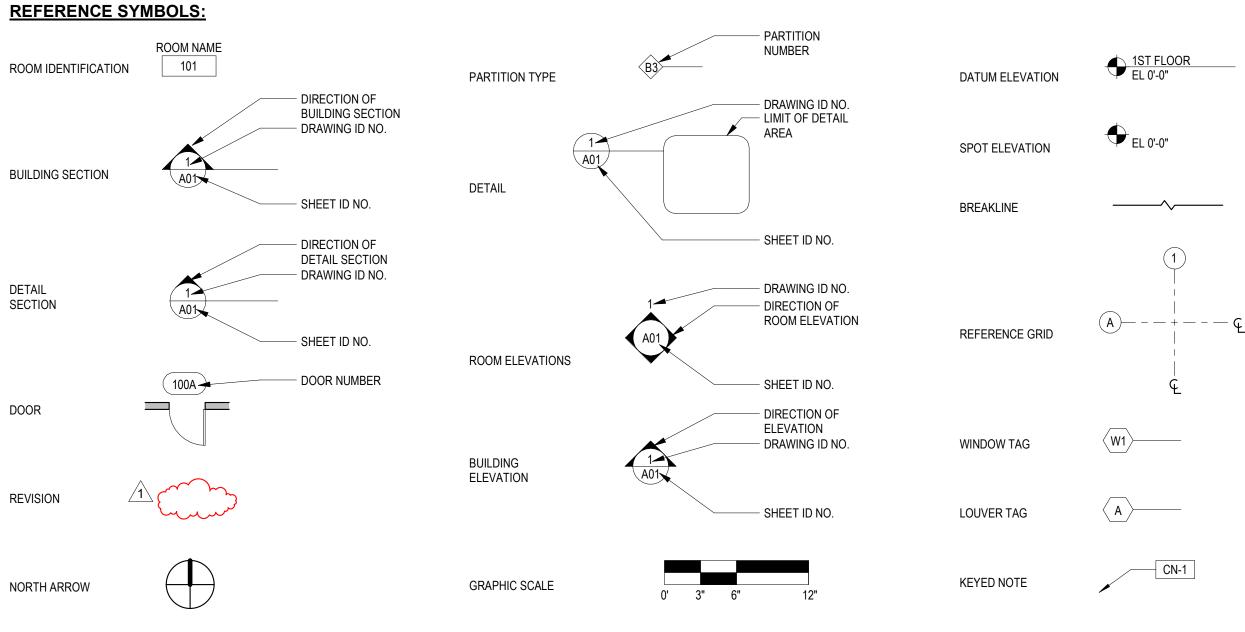

EXP

EXG EXT

EXPOSED

EXISTING

EXTERIOR

FIRE ALARM FIBER CEMENT BOARD FAN COIL UNIT FLOOR DRAIN FIRE EXTINGUISHER CABINET FACTORY FINISH FINISHED FLOOR ELEVATION FINISH(ED) FLASHING FLOOR(ING) FOUNDATION FACE OF FILLER PANEL	P PAC PERF PLAM PLAS PNL PNLG PNT POL PROJ P.T. PT PTN PTN PWD	PRECAST ARCHITECTURAL CONCRETE PERFORATED PLASTIC LAMINATE PLASTER PANEL PANELING PAINT(ED) POLISHED PROJECTION PRESSURE TREATED PORCELAIN TILE PARTITION PLYWOOD
FOOT (FEET) FOOTING FIN TUBE RADIATOR GAUGE GALVANIZED GROUND FACE GLAZED, GLAZING, GLASS GLASS REINFORCED GYPSUM GYPSUM WALLBOARD HIGH DENSITY POLYETHYLENE HOLLOW METAL HORIZONTAL	PV R RA RAD RB RBT RCP RD REF REQ'D REV RSF RT RM R.O.	PIPE VENT RETURN AIR RADIUS RUBBER BASE RUBBER STAIR TREAD REFLECTED CEILING PLAN ROOF DRAIN REFER; REFERENCE REQIURED REVISION, REVISE(D) RESILIENT FLOORING RESILIENT TILE FLOORING ROOM ROUGH OPENING
HOUR HARDWOOD HOLLOW STEEL SECTION HIGH TEMPERATURE HEAVING/VENTILATION/AIR CONDITIONING HOT WATER HEATER INSULATED GLAZING UNIT INCLUDING/INCLUDED INFORMATION INSULATED, INSULATION INTERIOR	RTF RWC S SA SBC SBO SFI SGT SIM SIP SL SOG SSTL STD STL	RESILIENT RUBBER TILE FLOORING RAINWATER CONDUCTOR SOUTH SUPPLY AIR SINK BASE CABINET SUPPLIED BY OTHERS SPRAY FOAM INSULATION STRUCTURAL GLAZED TILE SIMILAR STRUCTURAL INSULATED PANEL SLOPED/SLOPE SLAB ON GRADE STAINLESS STEEL STANDARD STEEL
LAMINATED LINEAR FEET LONG LINOLEUM LONG LEG VERTICAL LINTEL LIGHT LOUVER	STN STRUC SUSP TER TF THK TLT TPTN T.O. TYP T&G	STAIN(ED) STRUCTURAL SUSPENDED TERRAZZO TRANSPARENT FINISH THICKNESS TOILET TOILET PARTITION TOP OF TYPICAL TONGUE AND GROOVE
MASONRY DIMENSION MATERIAL MAXIMUIM MEDIUM DENSITY FIBERBOARD MECHANICAL MANUFACTURER MINIMUM MASONRY OPENING MOISTURE RESISTANT MOUNTED METAL MULLION	UUNO VVAR VERT VEST VIF VTR W	UNLESS NOTED OTHERWISE VARIES/VARIOUS VERTICAL VESTIBULE VERIFY IN FIELD VENT THROUGH ROOF WEST
NORTH NOT APPLICABLE NATURAL NOT IN CONTRACT NOT IN SCOPE NOMINAL NOT TO SCALE ON CENTER OWNER FURNISHED EQUIPMENT	W W/ W/O WB WC WD WDP WF WIN WOM WSCT X	WEST WITH WITHOUT WALL BASE WATER CLOSET WALL CABINET WOOD WOOD PANEL WIDE FLANGE WINDOW WALK OFF MAT WAINSCOT
OPPOSITE HAND OPPOSITE OPENING ORIENTED STRAND BOARD OUTLINE	XPS	EXTRUDED POLYSTYRENE

CODE:

ALTERNATES:

A. ALTERNATE 1(ADD):

HEIGHT AND AREA OR EGRESS.



(ASSUMED) AT DOME INTERIOR. REPAINT INTERIOR DOME SURFACE. B. ALTERNATE 2: FOR REPLACEMENT TERRA COTTA UNITS, CONTRACTOR MAY CONSIDER ALTERNATIVE MATERIALS, SUCH AS GLASS FIBER REINFORCED CONCRETE (GFRC) AS AN ALTERNATE FOR CONSIDERATION BY OWNER. PROVIDE PRODUCT DATA FOR ALTERNATIVE PRODUCT FOR REVIEW, IN ADDITION TO PROPOSED DEDUCT ALTERNATE COST. IDENTIFY AND QUANTIFY SCHEDULE IMPROVEMENTS AVAILABLE TO THE PROJECT IF THIS ALTERNATE IS

THIS RENOVATION DOES NOT IMPACT ISSUES OF OCCUPANCY,

SELECTED BY THE OWNER.

REPAIR AND RESTORE EXISTING PLASTER AND LATH CEILING







MCPHERSON SQUARE LIBRARY 601 E INDIANA AVE, PHILADELPHIA, PA 19134

ARCHITECTS: SMP Architects 1600 Walnut Street, 2nd Floor Philadelphia, PA 19103 215 985 4410 www.smparchitects.com

CIVIL ENGINEER: KS Engineers 530 Walnut Street, Suite 460 Philadelphia, PA 19106 215 616 3060

STRUCTURAL ENGINEER: Ann Rothmann 100 E Lancaster Avenue, Suite 203 Wayne, PA 19087 610 688 2566

ROOFING CONSULTANT: Steve McLaughlin 210 Garden Avenue Somerdale, NJ 08083 856 287 2424

Seal:

By: JS Checked: JGH Scale: AS NOTED Date: 04/15/2024


No. Date Revision

Drawing Title: GENERAL NOTES, ABBREVIATIONS, MATERIALS, REFERENCE SYMBOLS

Drawing No.:

A0.1


## LEGEND

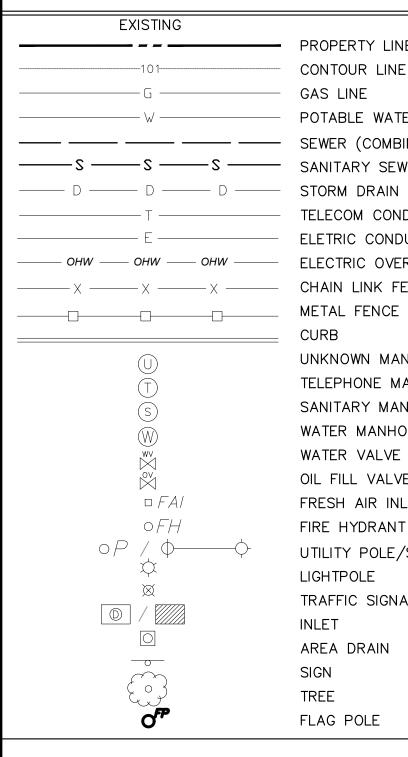


PROPERTY LINES CONTOUR LINE POTABLE WATER SEWER (COMBINED) SANITARY SEWER TELECOM CONDUIT ELETRIC CONDUIT ELECTRIC OVERHEAD LINE CHAIN LINK FENCE METAL FENCE UNKNOWN MANHOLE TELEPHONE MANHOLE SANITARY MANHOLE WATER MANHOLE WATER VALVE OIL FILL VALVE FRESH AIR INLET FIRE HYDRANT UTILITY POLE/STREET LIGHT TRAFFIC SIGNAL AREA DRAIN


GENERAL NOTES:

- PROPERTY DIMENSIONS ARE PER DEEDS OF RECORD AND STREET WIDTHS AS PER CITY PLAN NO. 18 AND ARE SHOWN IN PHILADELPHIA DISTRICT STANDARD. ALL OTHER DIMENSIONS ARE SHOWN IN U.S. SURVEY FEET.
- 2. SURVEY INFORMATION OBTAINED FROM A FIELD SURVEY PERFORMED BY RODRIGUEZ CONSULTING, LLC ON 02/19/2020. SURVEY BASED ON P.A.S.P.C.S. (SOUTH ZONE) NAD83. BEARINGS SHOWN ARE PER CITY PLAN AND DEED OF RECORD. ELEVATIONS ARE REFERENCED TO CITY VERTICAL DATUM.
- EXISTING SITE CONDITIONS AND PROPERTY LINE ARE BASED ON PLAN AND SURVEY BY OTHERS: PLAN REFERENCE:
- #1 PWD GSI PROJECT #50120, RECEIVED 11/26/2019
- 4. SUBJECT TO ALL RESTRICTIONS, EASEMENTS AND/OR COVENANTS OF RECORD EITHER WRITTEN OR IMPLIED THAT MAY NOT APPEAR OF THIS PLAN.
- 5. IF BUILDINGS ARE ON THIS PLAN, BUILDING OFFSET DISTANCES SHOWN ARE FOR THE PURPOSE OF CHECKING COMPLIANCE WITH ZONING AND DEED RESTRICTIONS ONLY. NO LIABILITY WILL BE ACCEPTED IF THESE DISTANCES ARE USED FOR ANY OTHER PURPOSES.
- . UNDERGROUND UTILITIES AS SHOWN TAKEN FROM FIELD EVIDENCE AND PLANS AS PROVIDED BY THE VARIOUS UTILITY AUTHORITIES (PA ONE CALL SERIAL NO. 20200520979). THE ACCURACY REGARDING UTILITY LOCATION AND/OR DEPTH CANNOT BÉ GUARANTEED AND ADDITIONAL UNDERGROUND UTILITIES NOT DEPICTED ON THIS PLAN MAY EXIST. BEFORE EXCAVATIONS ARE BEGUN, THE PENNSYLVANIA ONE CALL SYSTEM AT 1-800-242-1776 SHALL BE CONTACTED AT LEAST 3-10 DAYS PRIOR TO COMMENCEMENT OF ANY DEMOLITION OR EXCAVATION ACTIVITIES IN ACCORDANCE WITH ALL APPLICABLE LAWS, RULES AND REGULATIONS.
- INFORMATION PERTAINING TO LOTS OTHER THAN THE SUBJECT PARCEL IS SHOWN FOR INFORMATIONAL PURPOSES ONLY.
- 8. PROJECT SITE IS LOCATED WITHIN THE SP-PO-A DISTRICT.

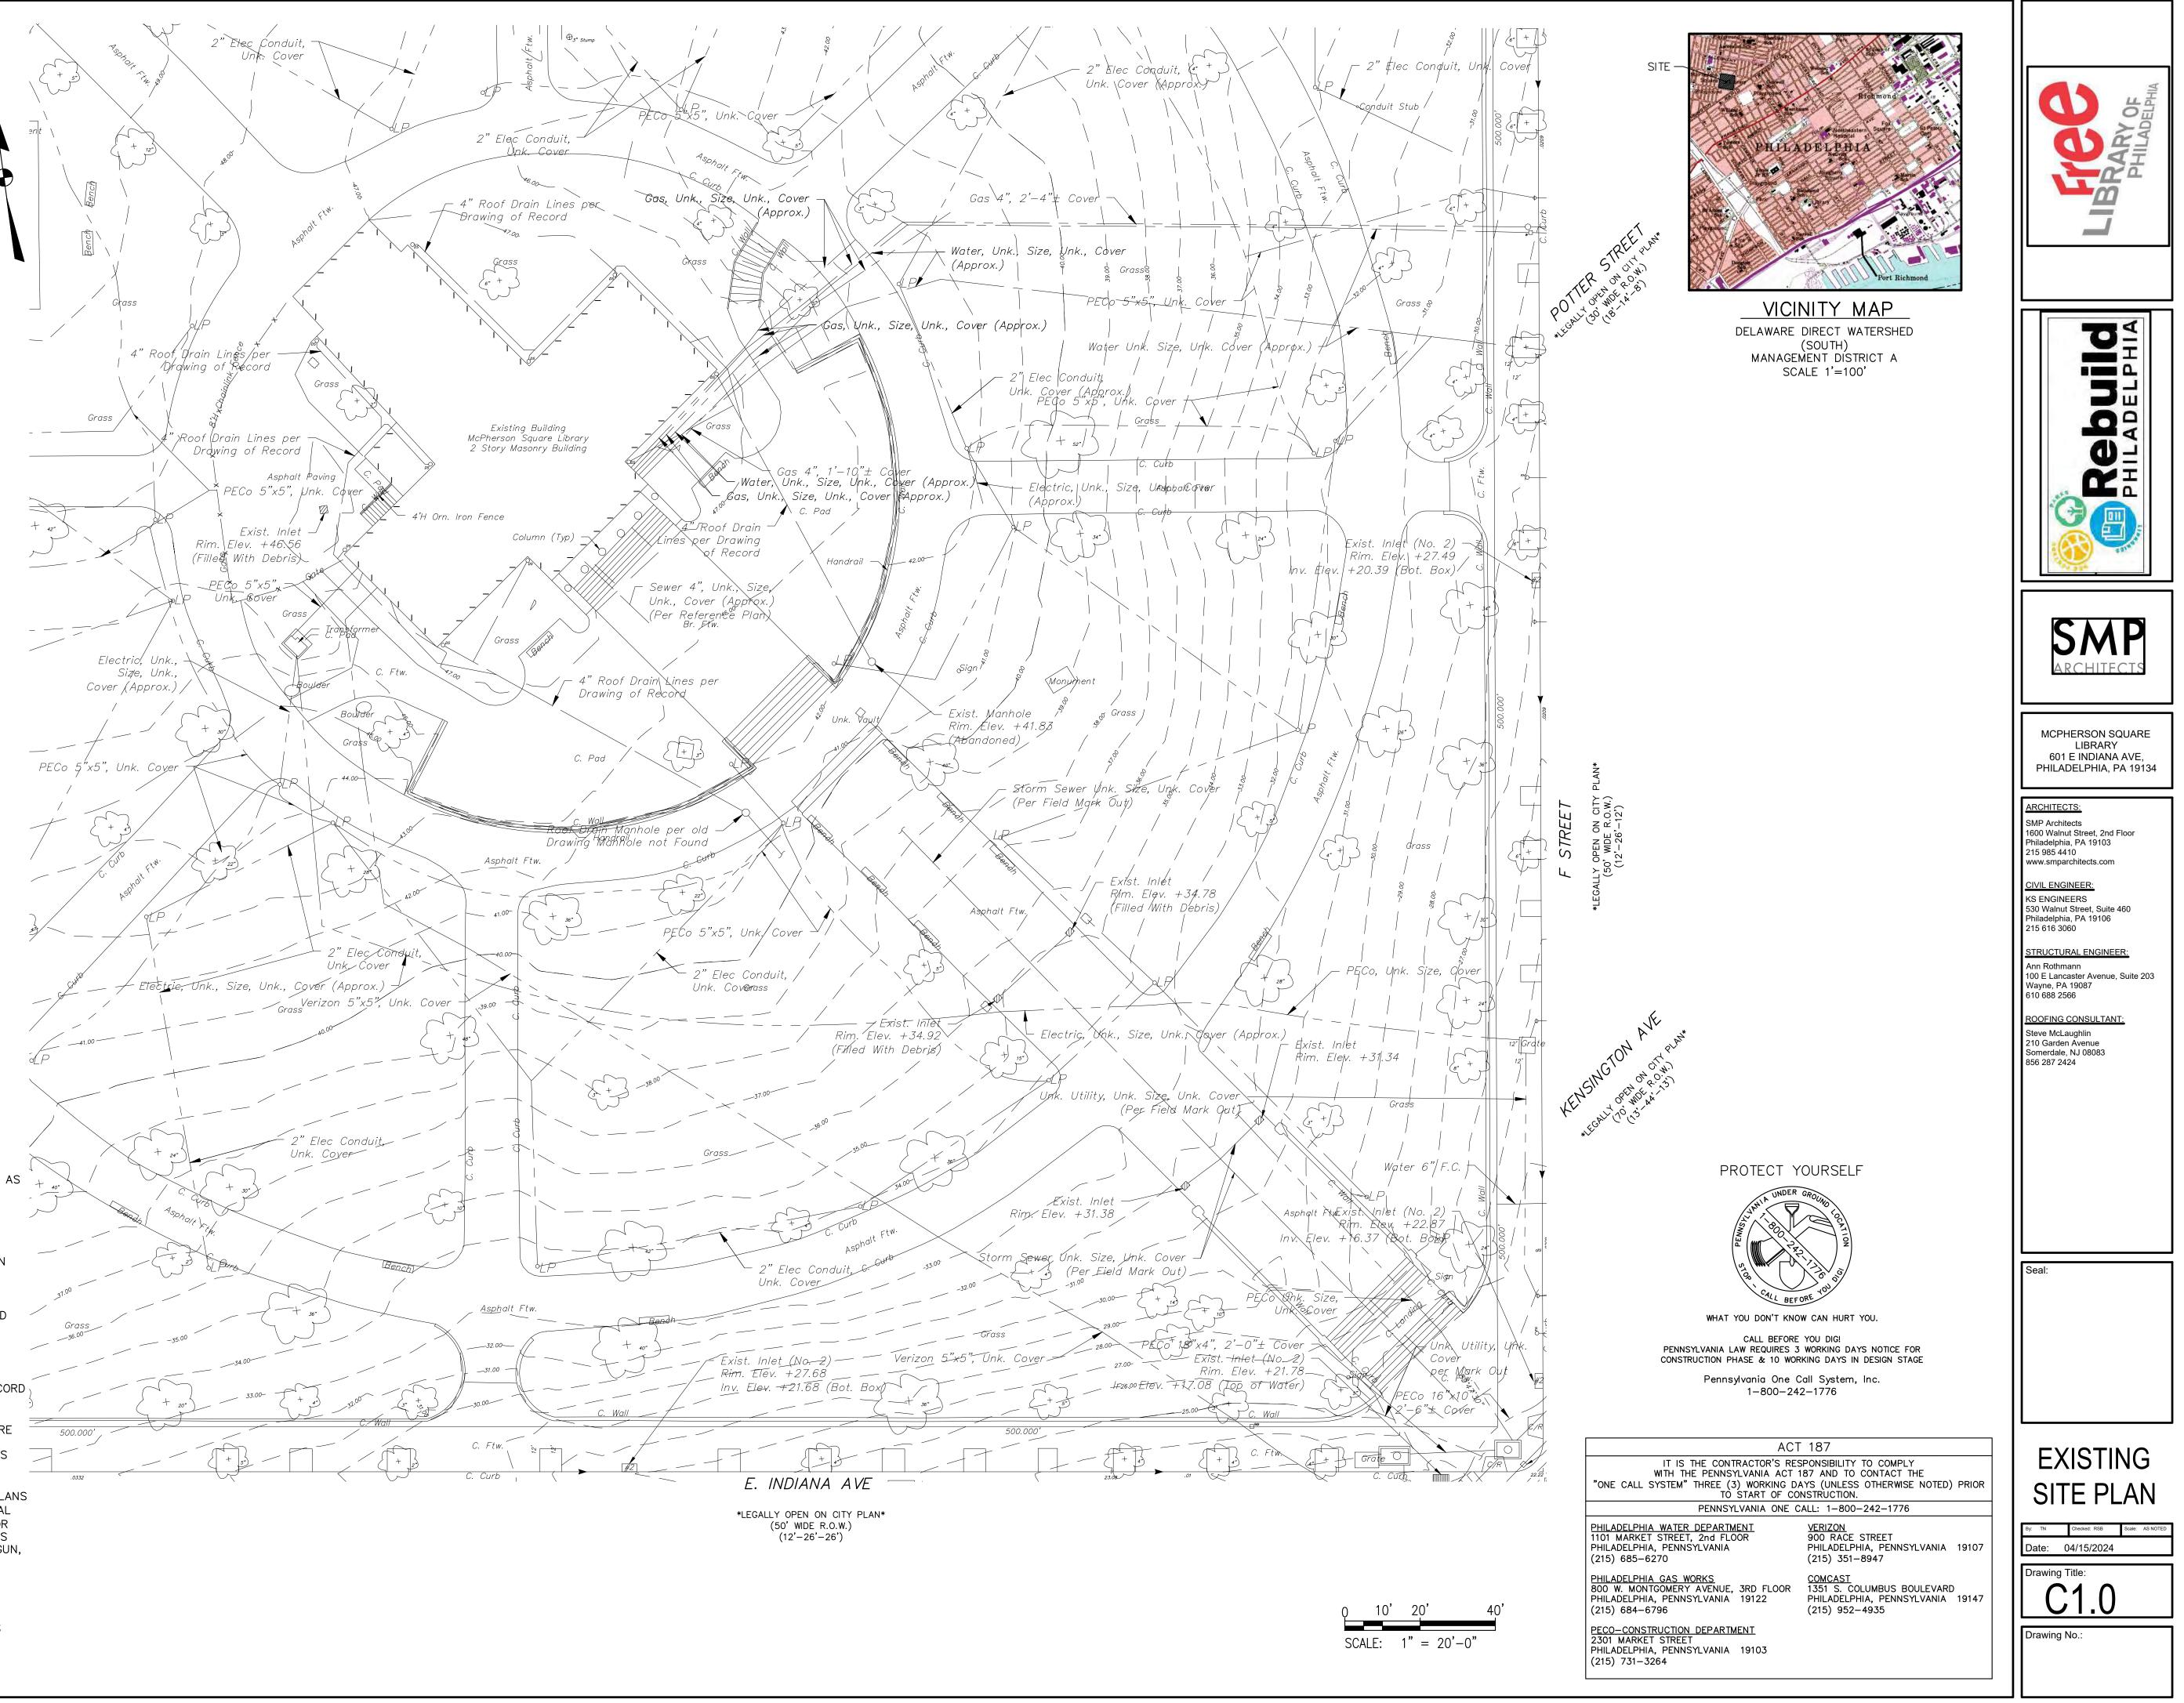

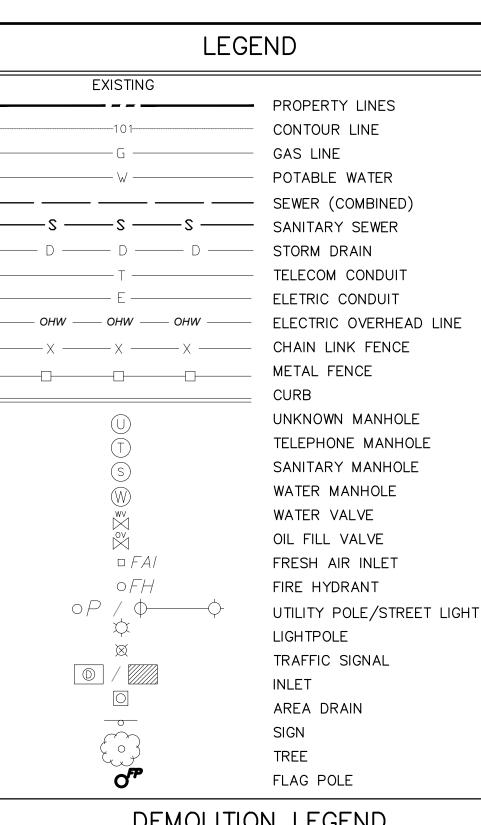


## DEMOLITION LEGEND

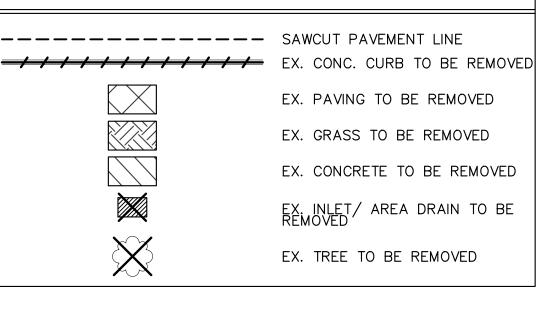


DEMOLITION NOTES:

- . PRIOR TO STARTING ANY DEMOLITION WORK, CONTRACTOR TO DOCUMENT EXISTING SITE CONDITIONS WITH PHOTOS.
- 2. PRIOR TO STARTING ANY EXCAVATION, CONTRACTOR TO HAVE UNDERGROUND UTILITY LOCATION SERVICES COMPLETED WITHIN THE LIMIT OF DISTURBANCE.
- 3. EXISTING CONCRETE AND BITUMINOUS PAVING TO BE SAW-CUT WITH A CLEAN CUT LINE TO A SUFFICIENT DEPTH TO ALLOW THE REMOVAL OF PAVING WITHOUT DISTURBING THE EXISTING PAVING THAT IS TO REMAIN
- 4. ALL EXISTING FILL TO BE REMOVED FROM SITE IN ACCORDANCE WITH THE PA DEP MANAGEMENT OF FILL POLICY AND REGULATIONS.
- 5. TEMPORARY 8' HIGH LOCKABLE CHAINLINK CONSTRUCTION FENCE TO BE UTILIZED IN SECURING THE WORK AREA AND BLOCK OFF ENTRANCES TO WORK AREA. CONSTRUCTION FENCE TO BE SECURED WITH THE USE OF CONCRETE BLOCKS AND TO BE LOCKED WHEN NOT IN USE. ALL CONSTRUCTION VEHICLES, EQUIPMENT, AND MATERIALS ARE TO BE KEPT INSIDE LOCKED AREA WHEN NOT IN USE.
- 5. CONTRACTOR TO MONITOR EXISTING PARKING LOT AND PLAYGROUND AREA AT ALL TIMES TO PREVENT CONFLICT BETWEEN CONSTRUCTION VEHICLES, STAFF VEHICLES, DELIVERY TRUCKS AND PEDESTRIANS. CONTRACTOR TO REPAIR/REPLACE ANY CONCRETE, ASPHALT, LAWN OR PLANTED AREAS WITHIN THIS AREA AND WITHIN THE PUBLIC ROW THAT IS DAMAGED BY CONSTRUCTION VEHICLES DURING CONSTRUCTION.
- . REMOVAL OF EXISTING TREES TO INCLUDE ALL MAJOR ROOT STRUCTURES, LOCATIONS TO BE TEMPORARILY BACKFILLED IN ACCORDANCE WITH SPECIFICATIONS.

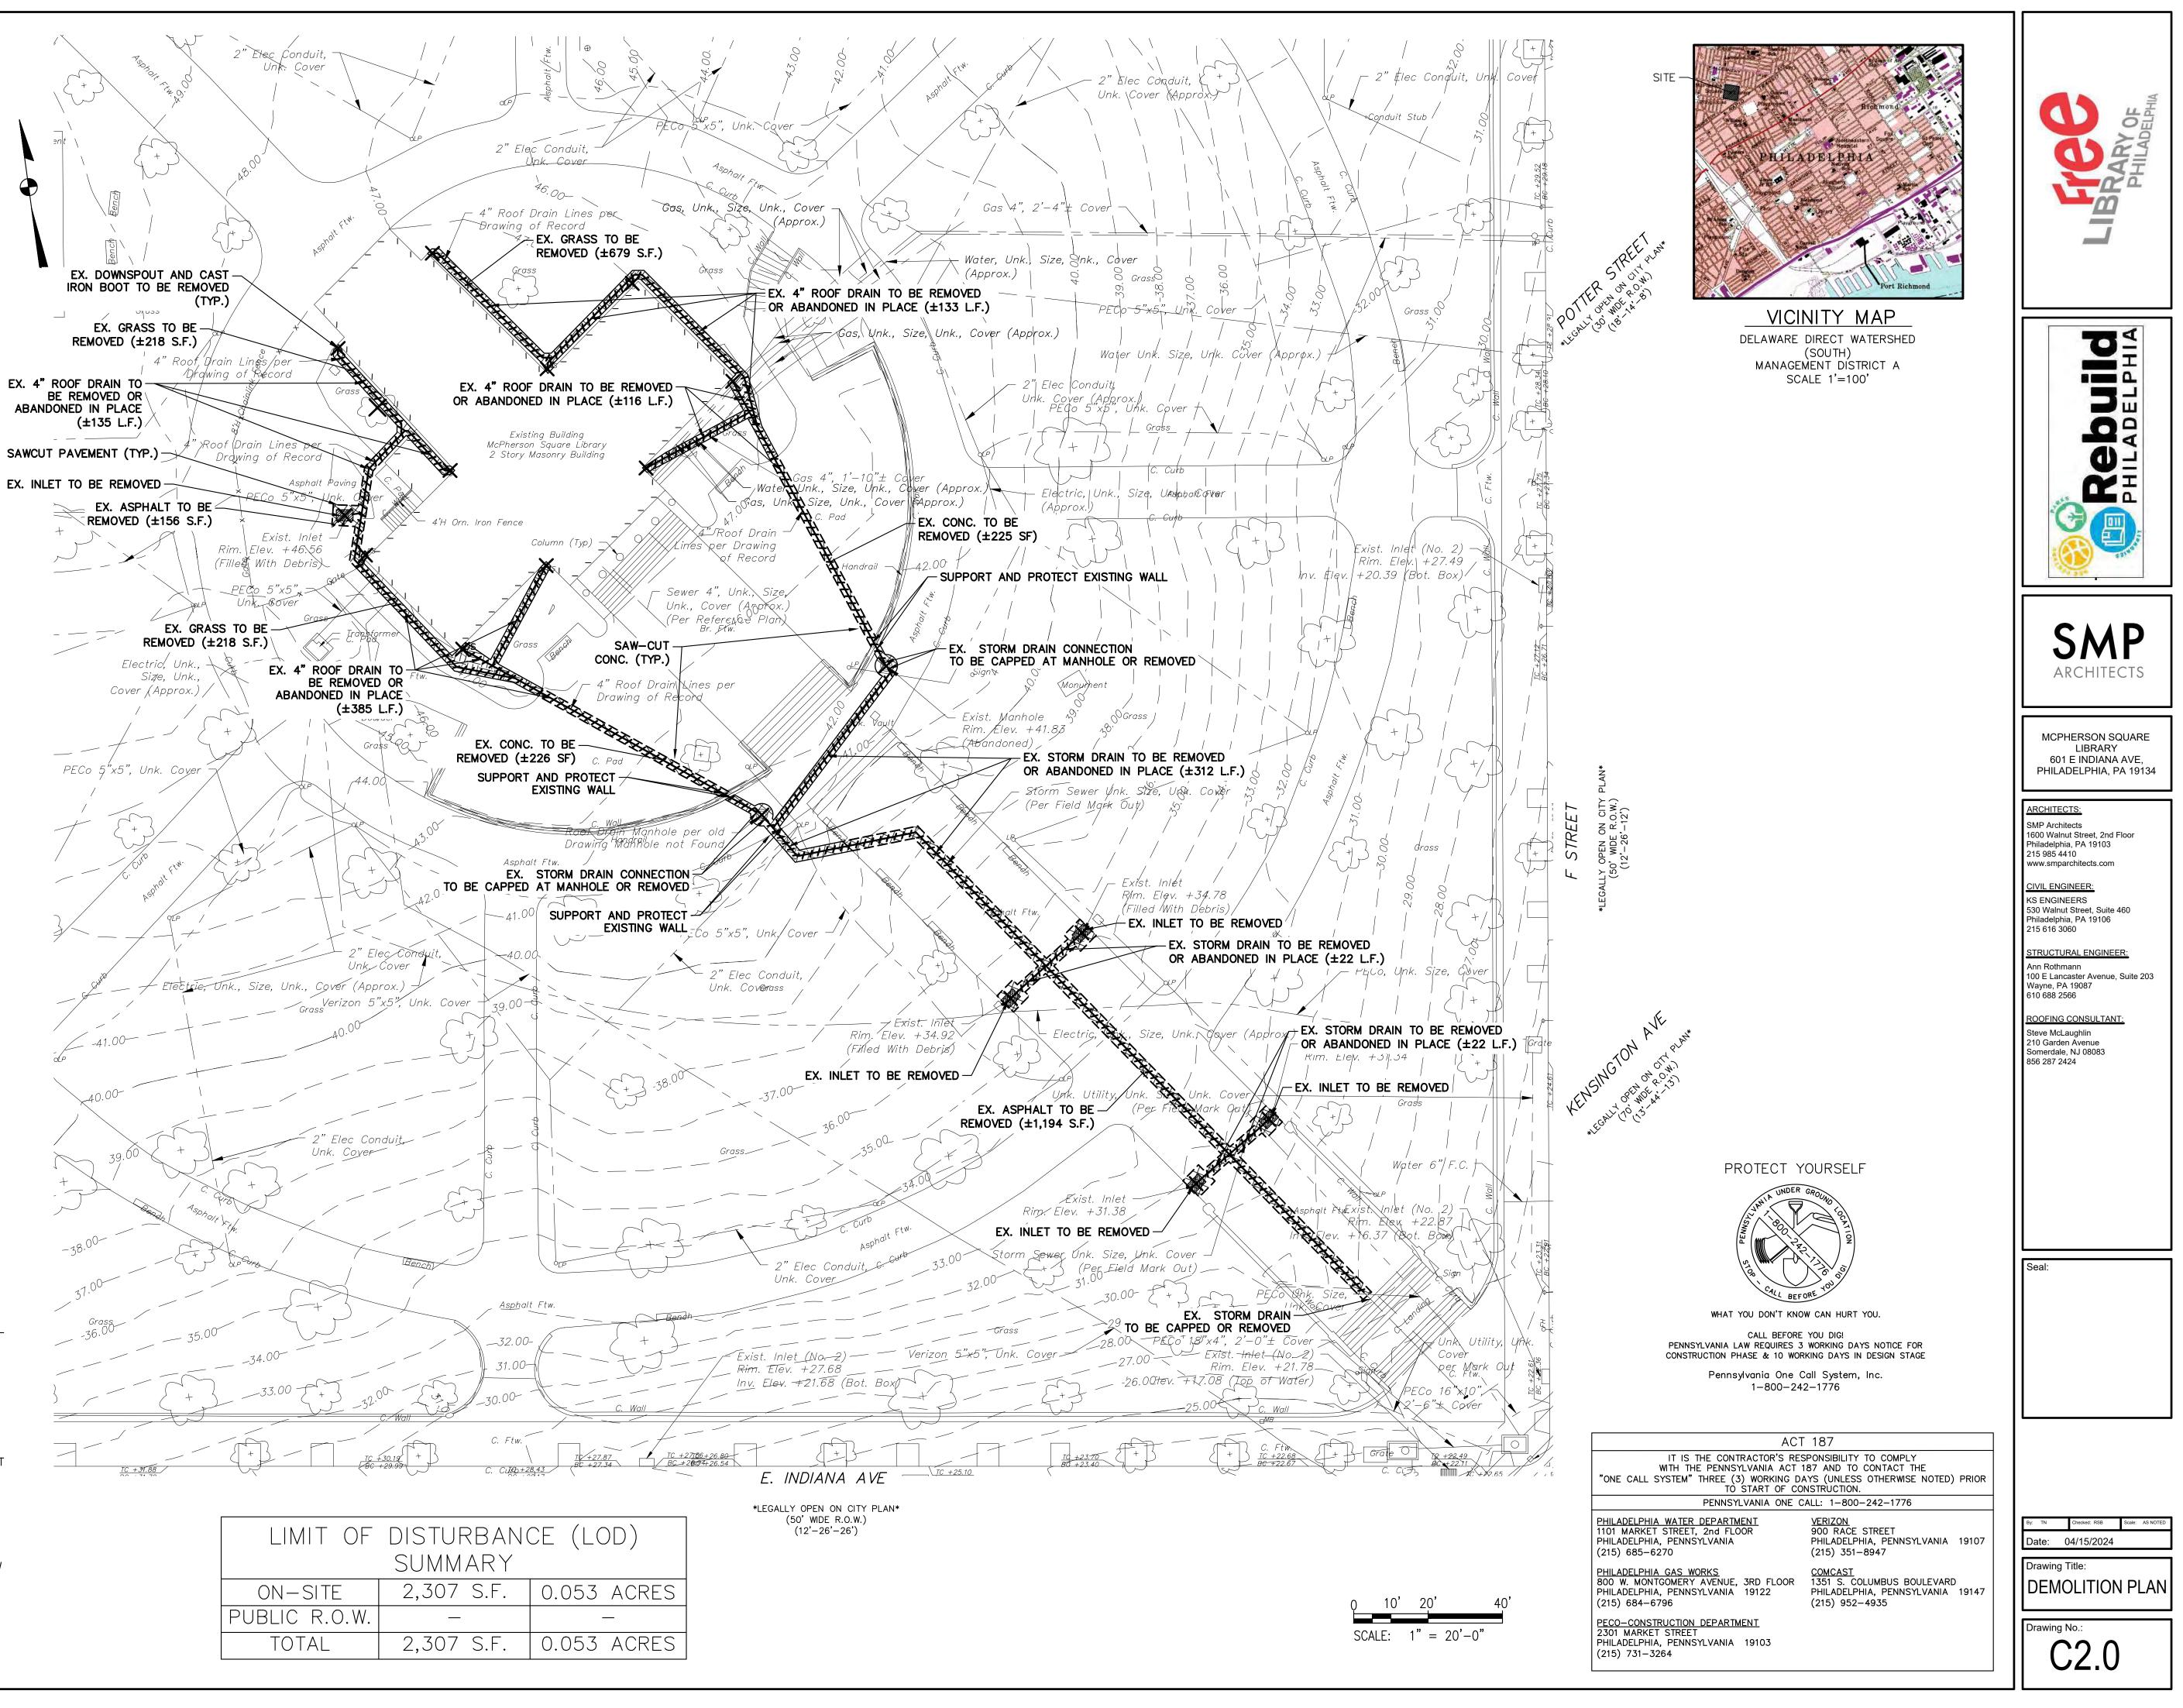


LIMIT OF	DISTU
	SUMM
ON-SITE	2,307
PUBLIC R.O.W.	
TOTAL	2,307



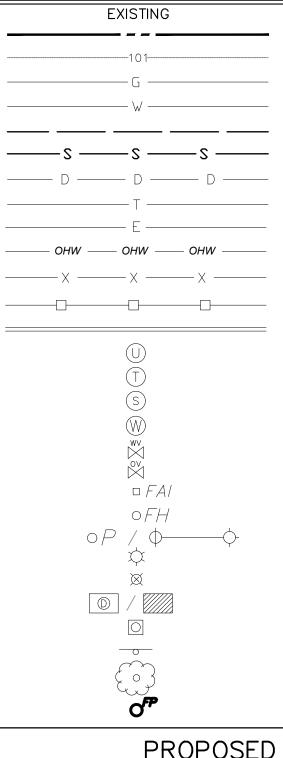


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## PROPOSED LEGEND

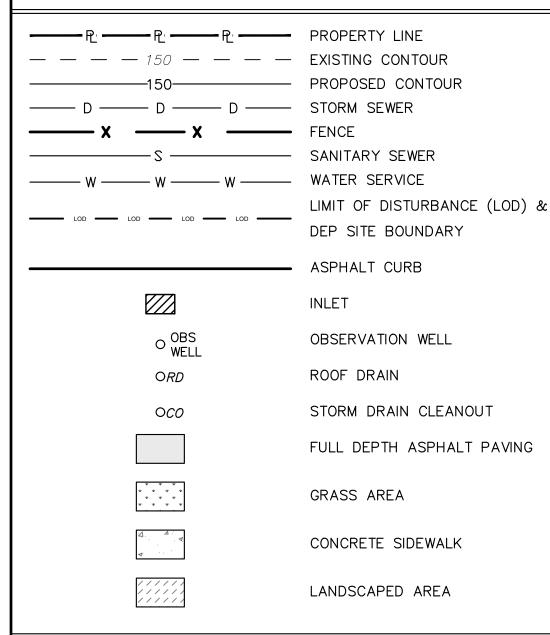


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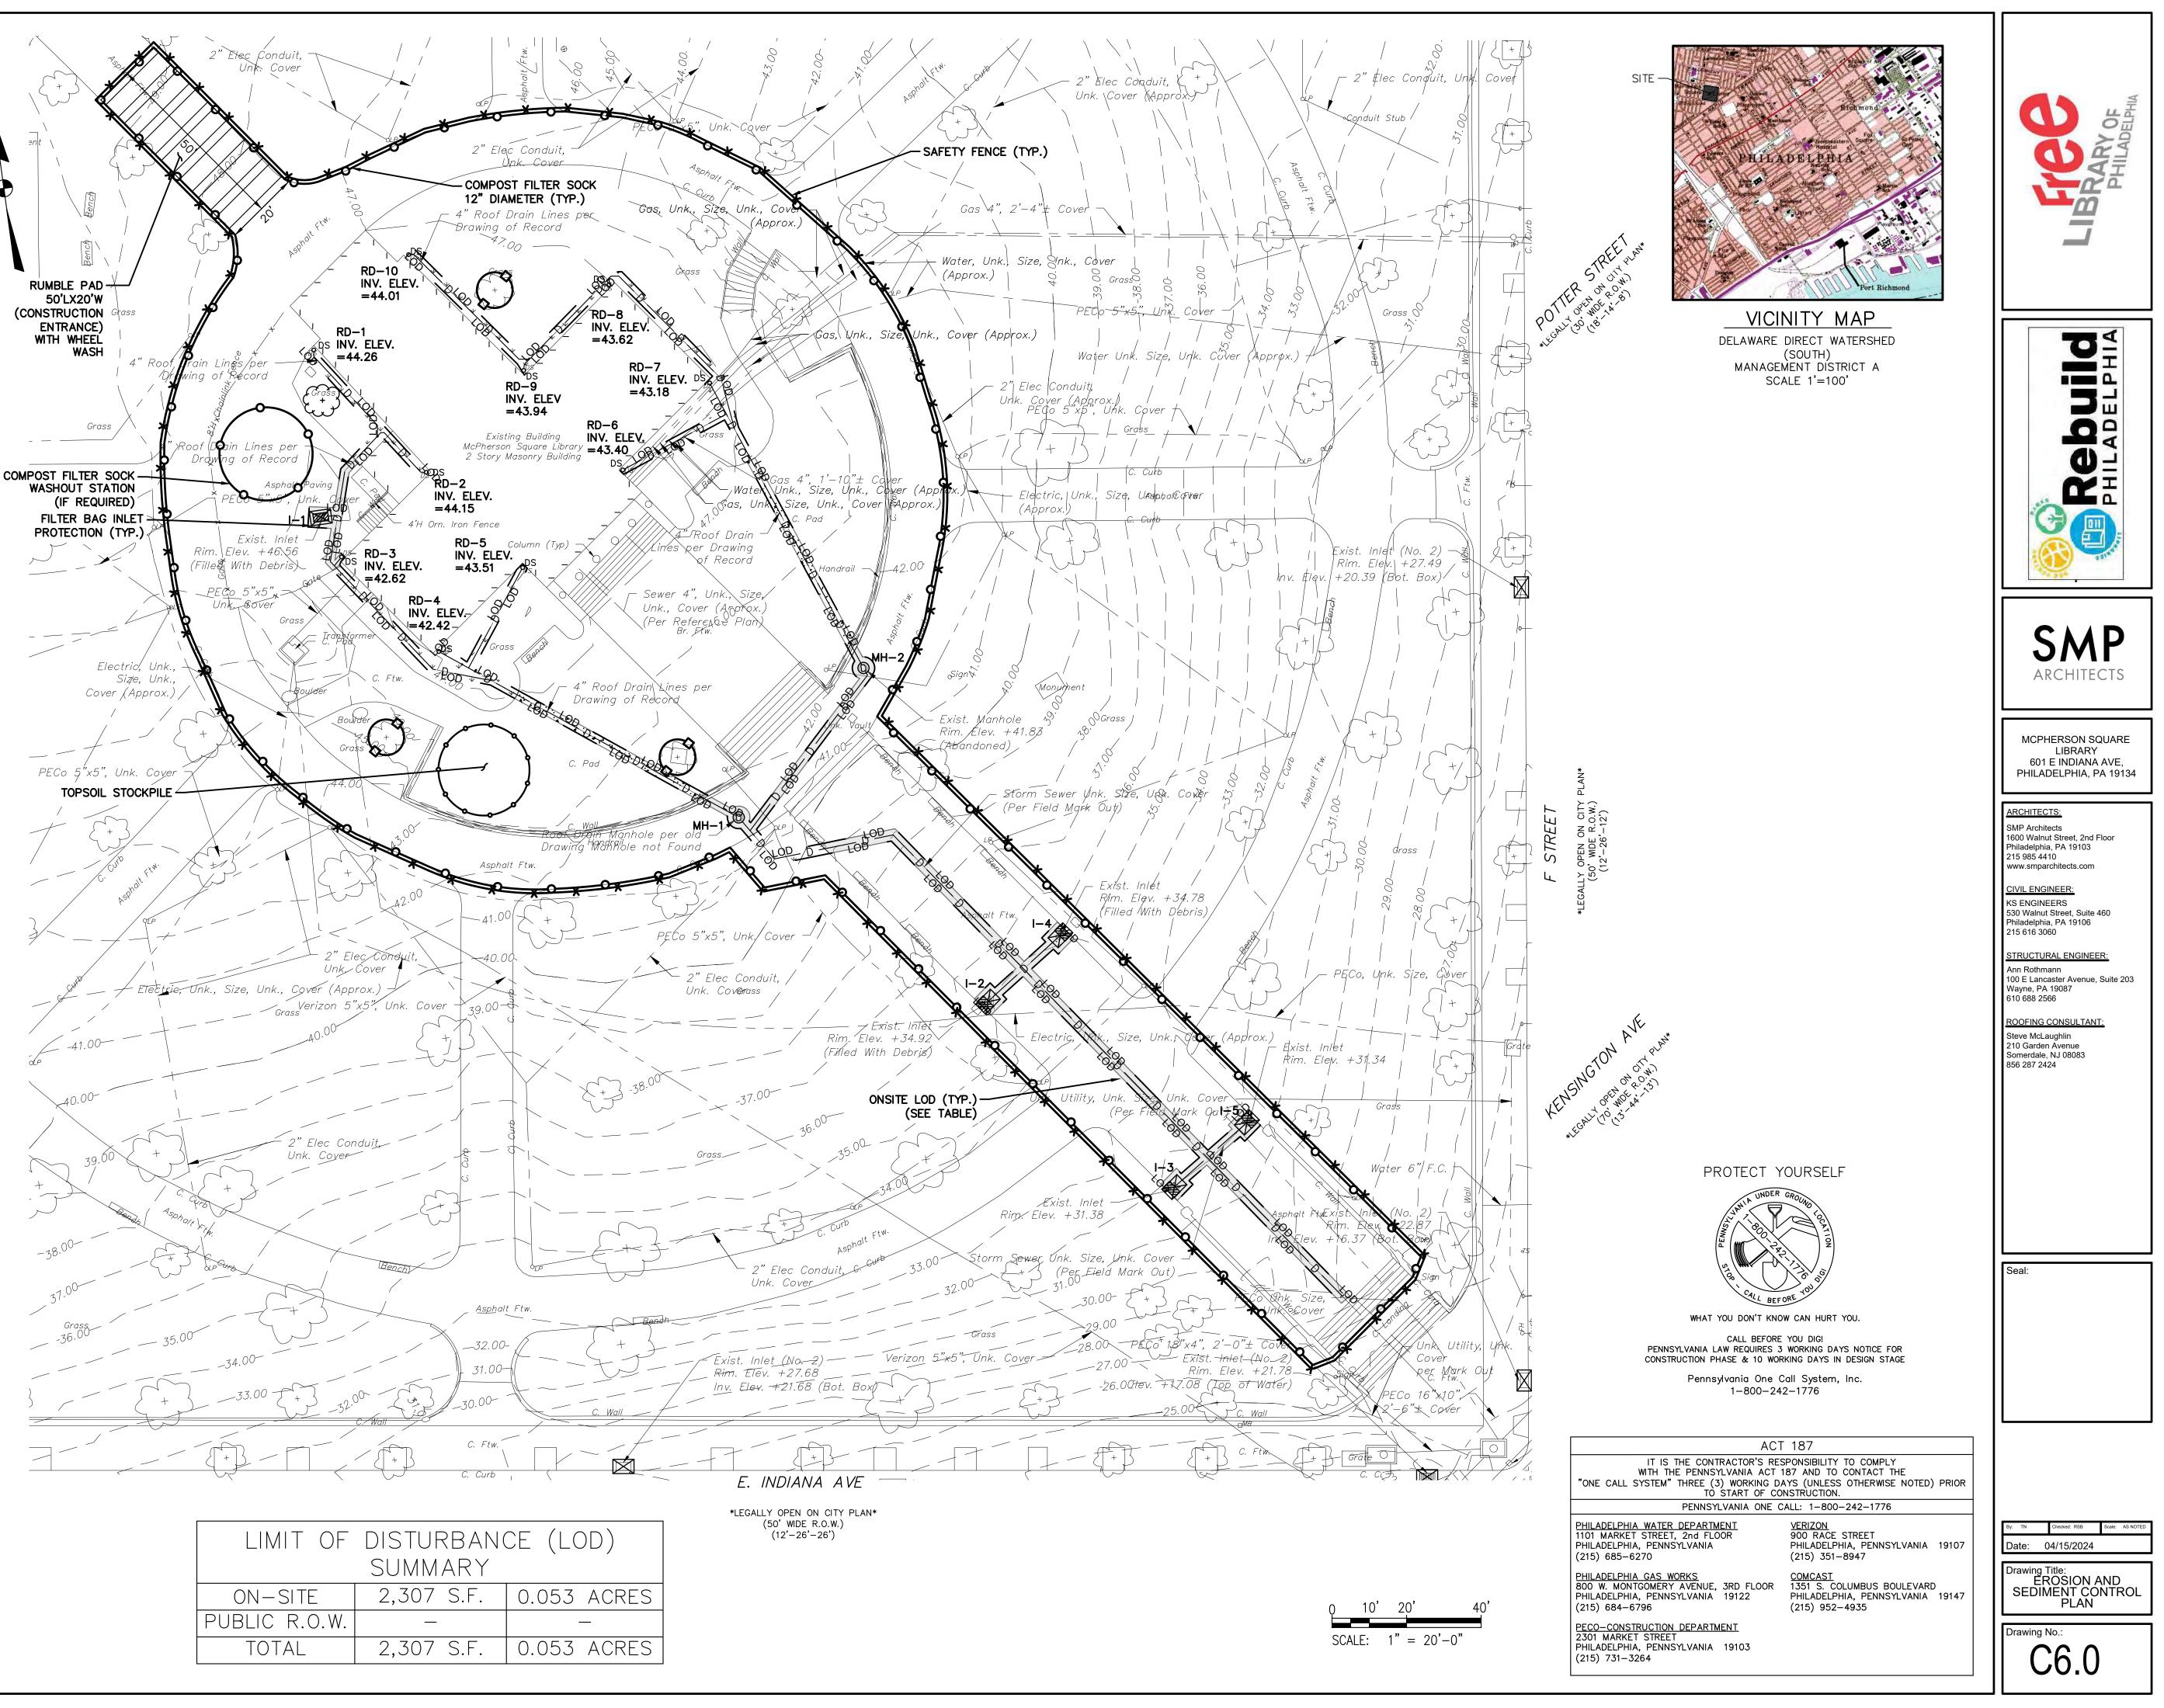


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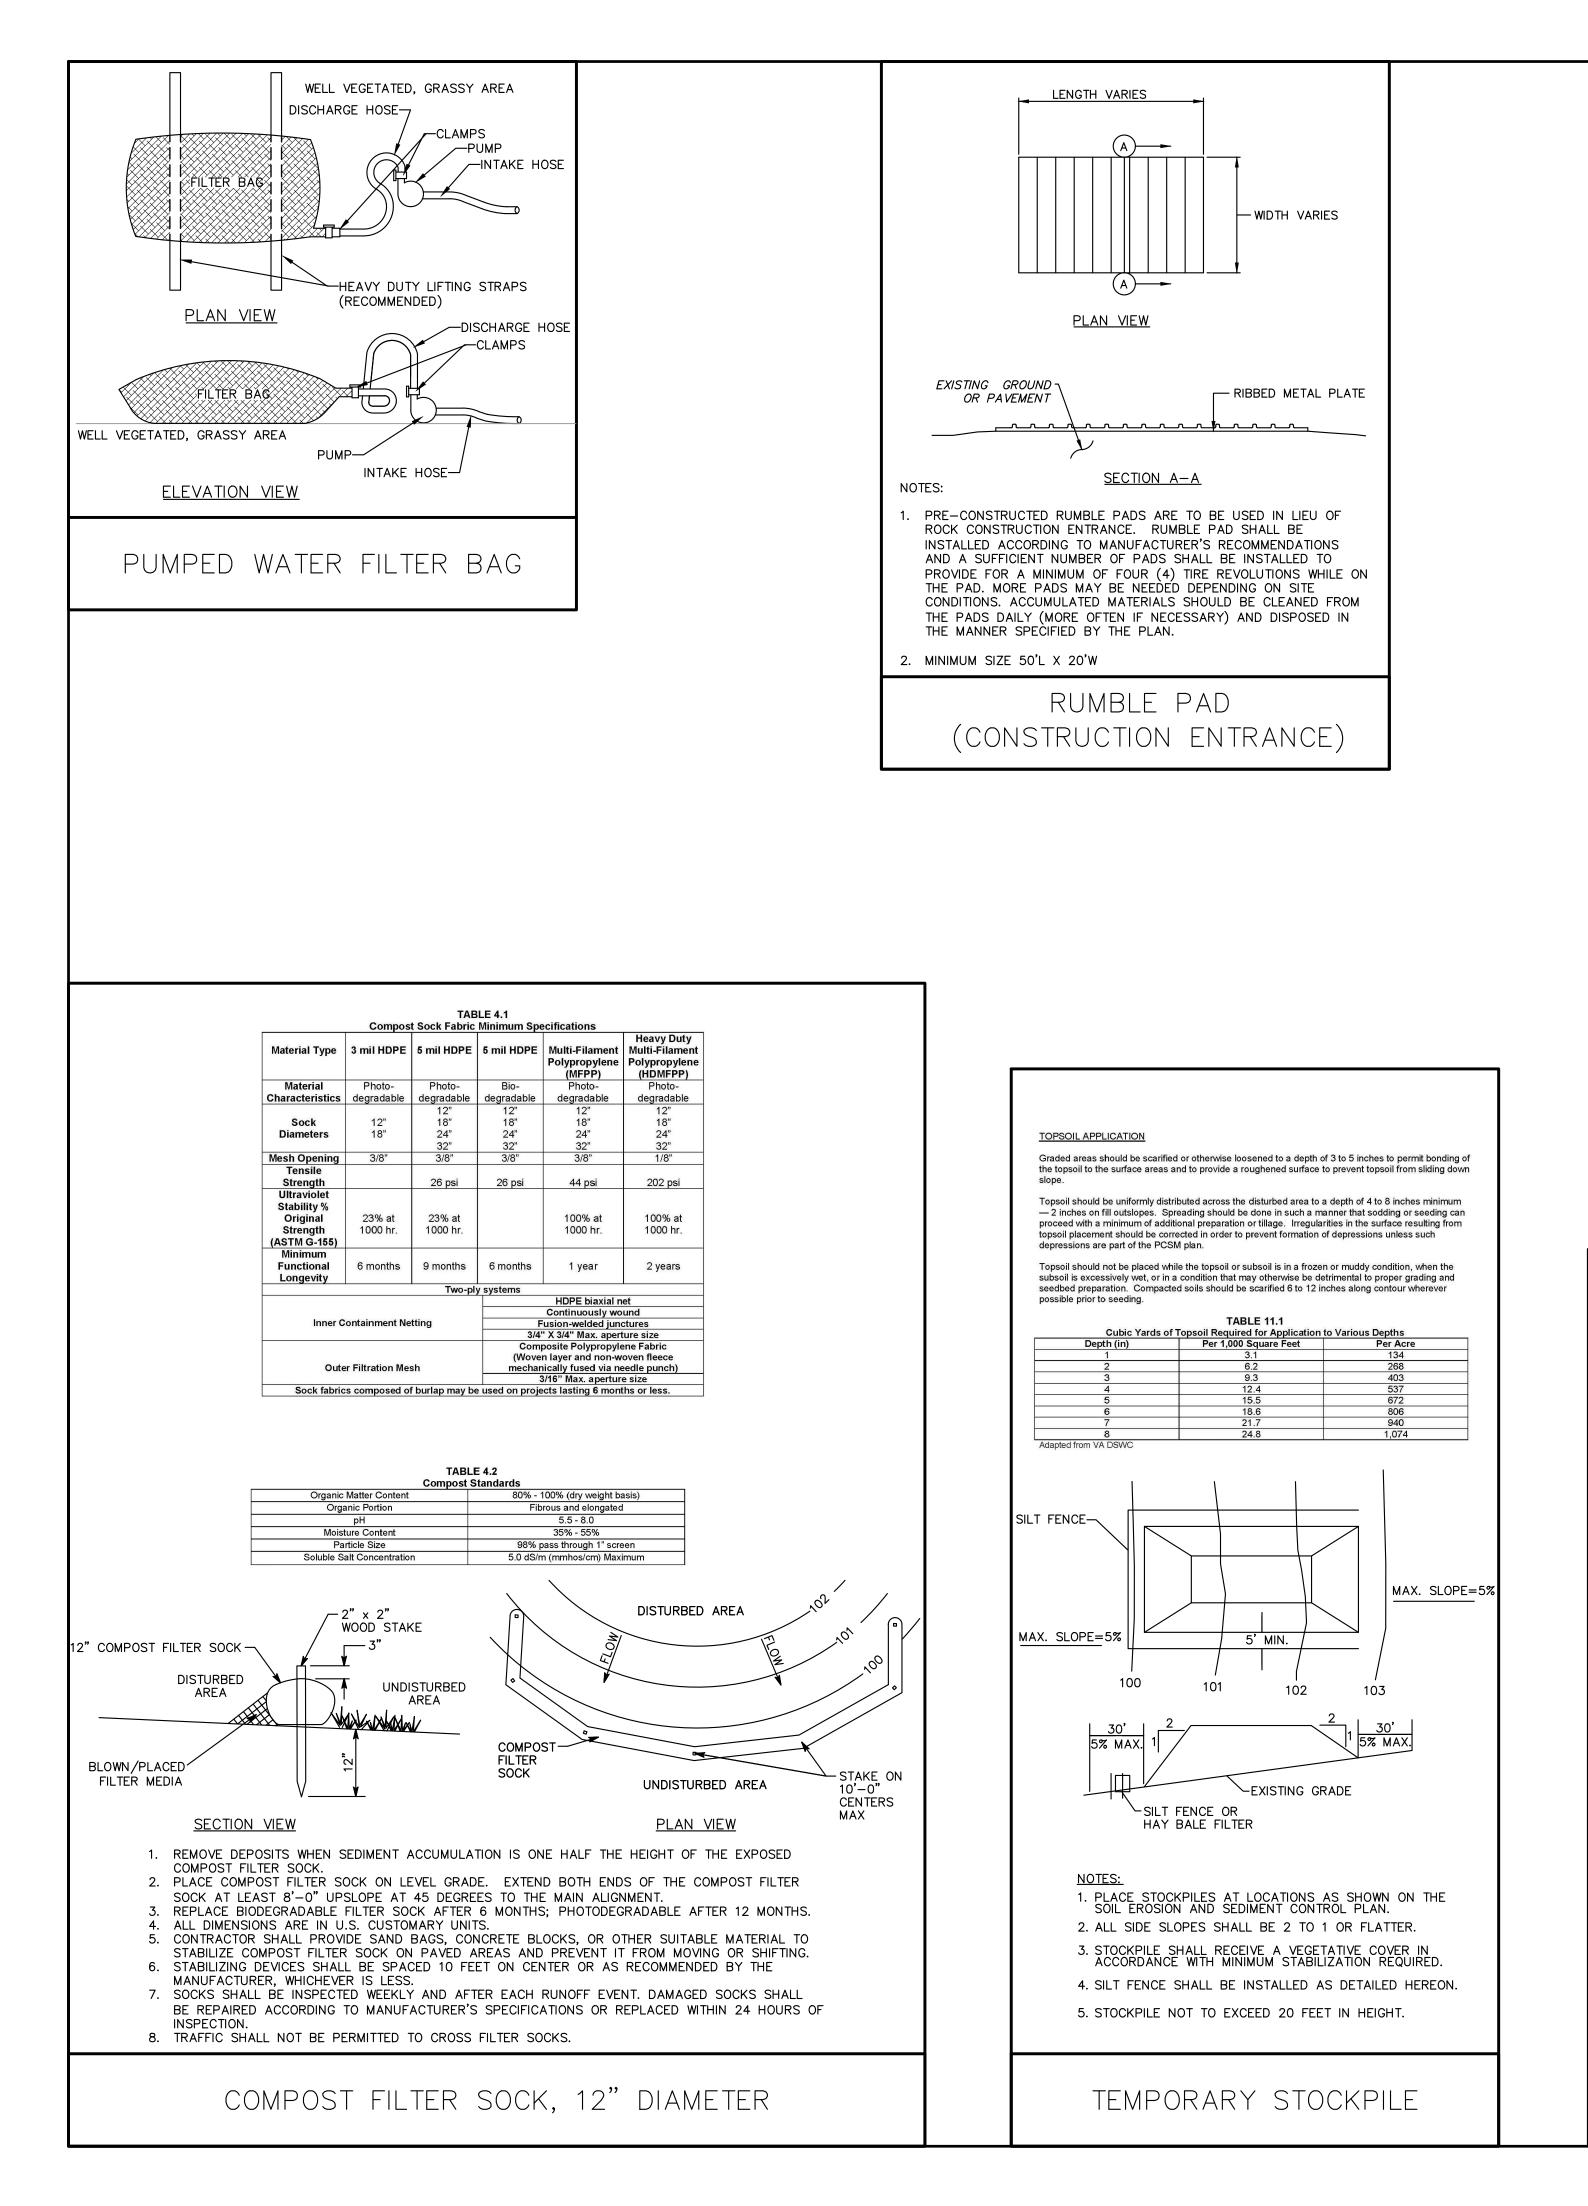



### EROSION AND SEDIMENT CONTROL (E&SC) NOTES:

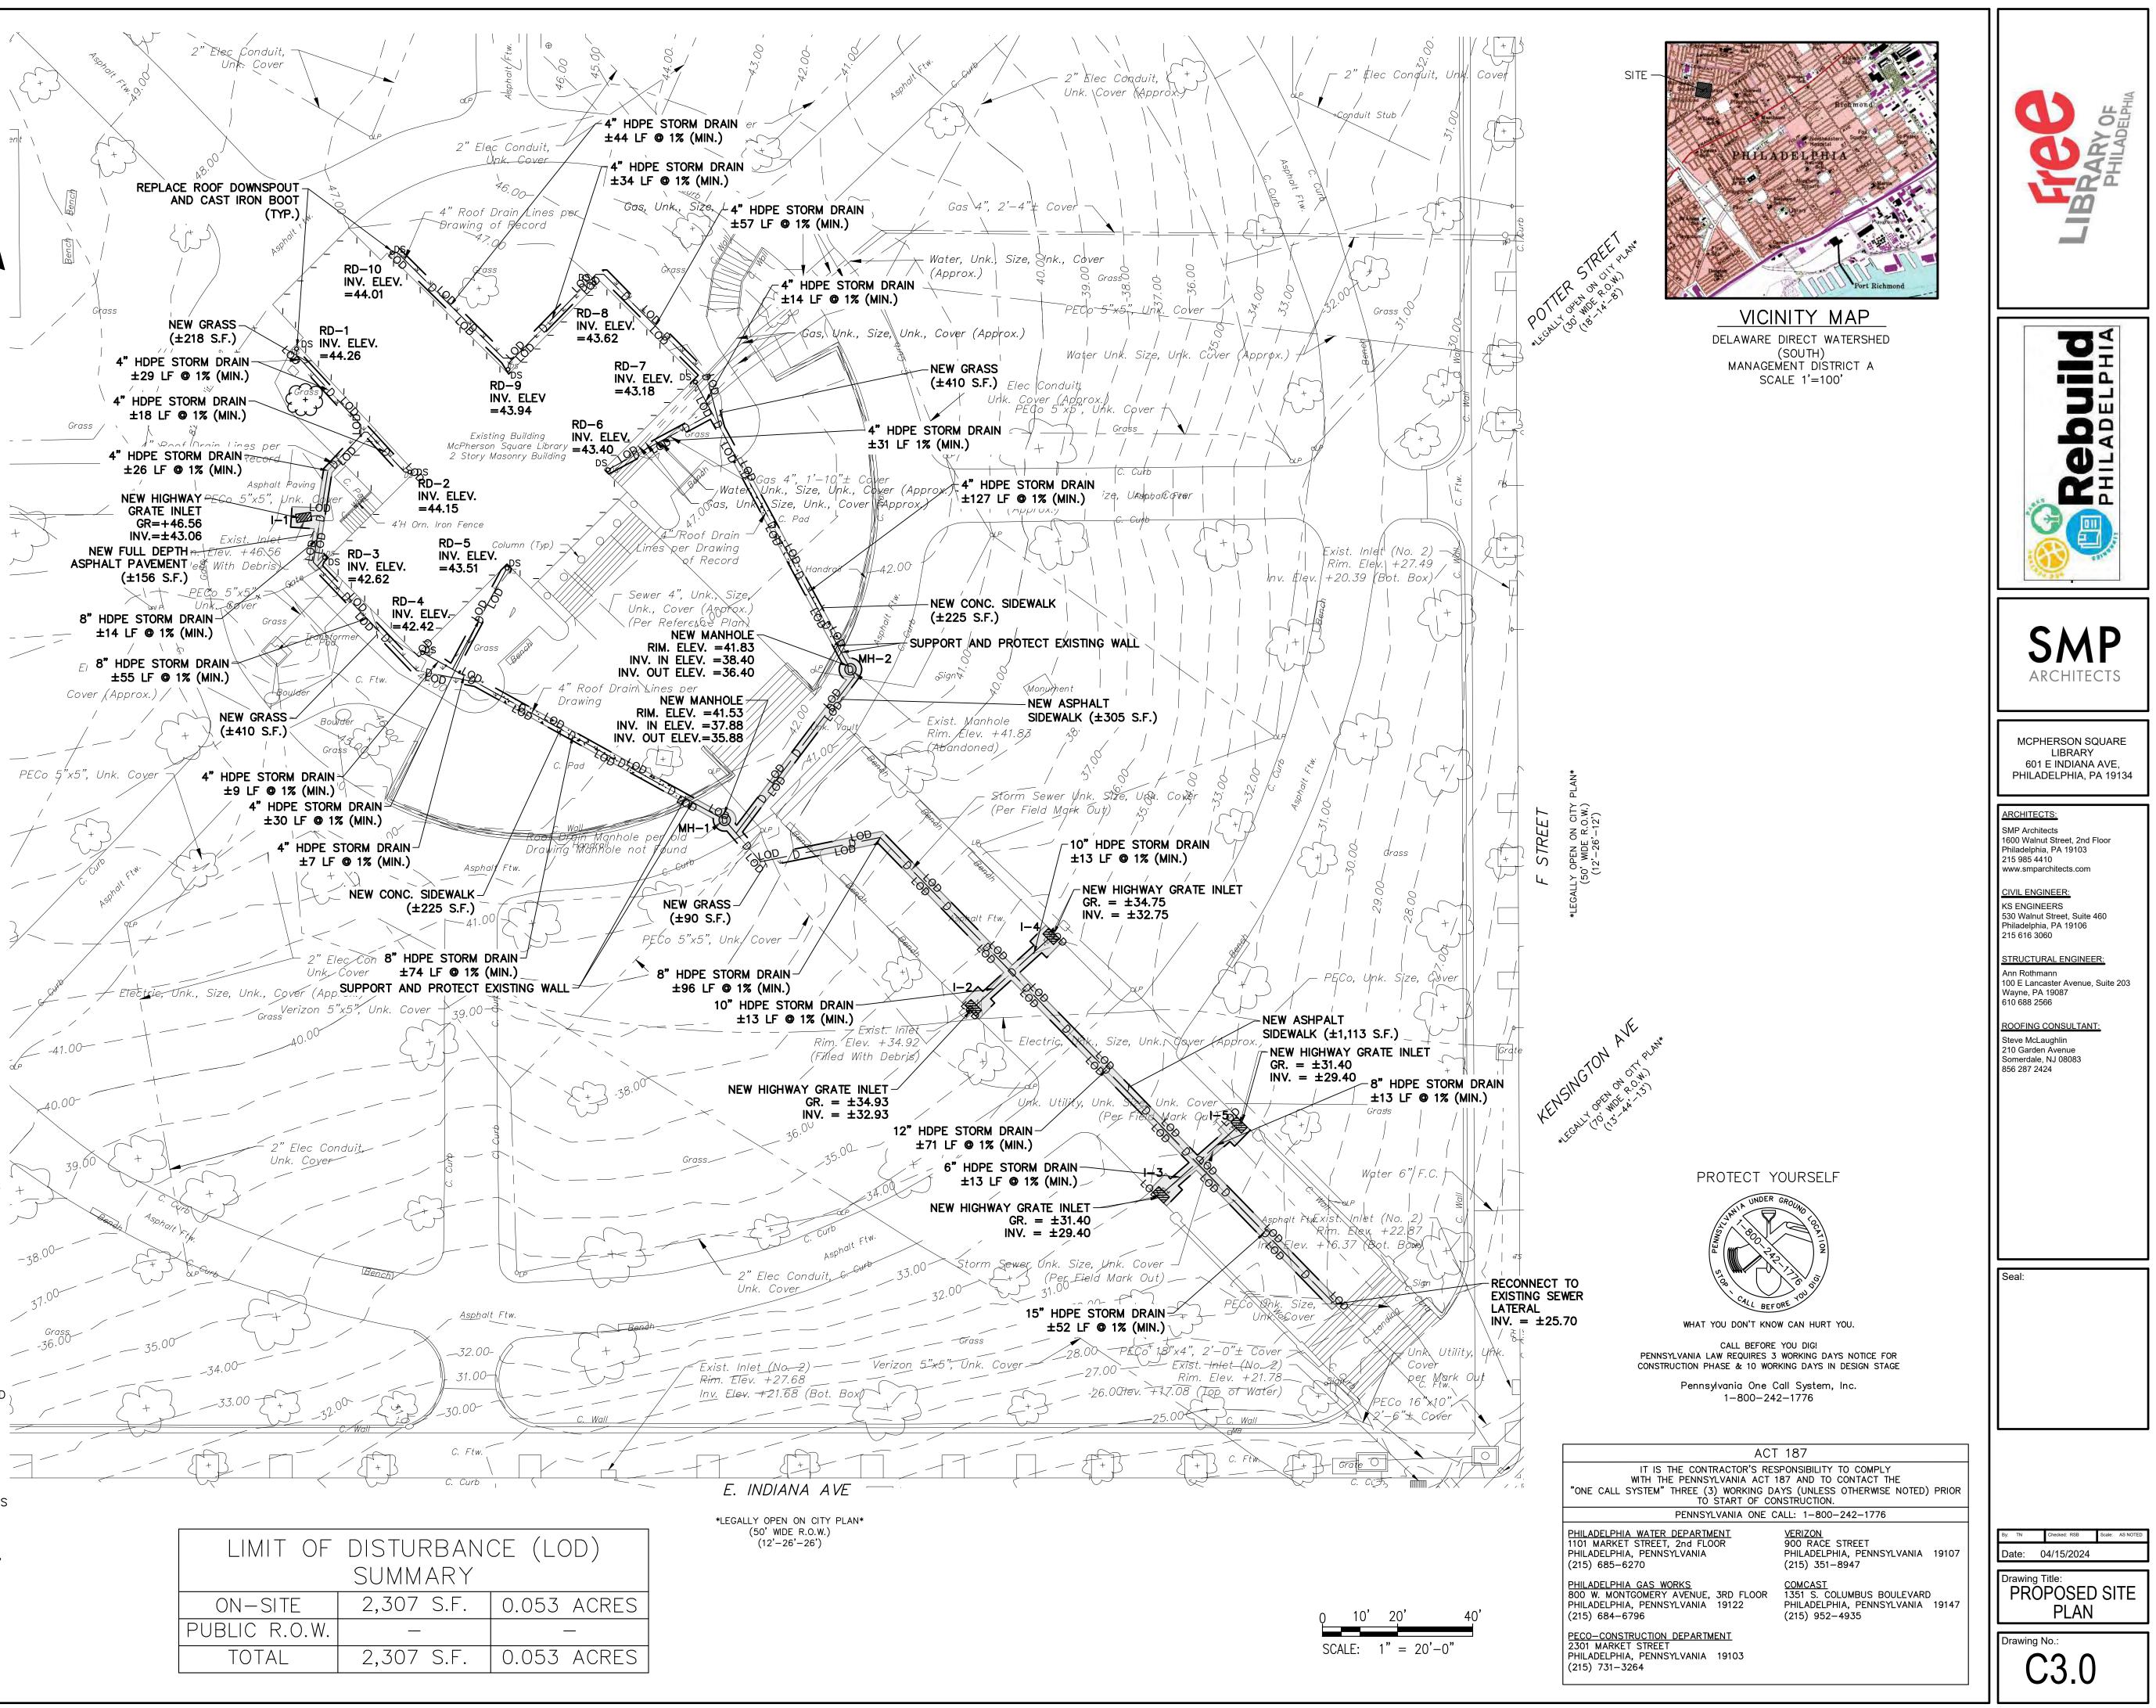
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- . THE CONTRACTOR SHALL REMOVE FROM THE SITE ALL DEBRIS, RUBBISH AND OTHER MATERIALS RESULTING FROM DEMOLITION AND SHALL SAFELY AND LEGALLY DISPOSE OF ALL THESE ITEMS IN ACCORDANCE WITH APPLICABLE LOCAL, FEDERAL, STATE AND REGULATORY AUTHORITY HAVING JURISDICTION. RECYCLING MUST BE DONE IN ACCORDANCE WITH APPLICABLE REGULATIONS. BURNING OF ANY DEMOLISHED MATERIALS ON-SITE SHALL NOT BE PERMITTED. RECYCLING OF DEMOLITION DEBRIS SHALL BE APPROVED BY THE OWNER. ALL EXISTING FILL TO BE REMOVED FROM SITE IN ACCORDANCE WITH THE PA DEP MANAGEMENT OF FILL POLICY AND REGULATIONS.
- COMPOST FILTER SOCK ON PAVING TO BE WEIGHTED DOWN BY OBJECTS OF CONSIDERABLE MASS (SAND BAGS, CONCRETE BLOCK OR OTHER SUITABLE MATERIAL). COMPOST FILTER SOCK TO BE INSTALLED DOWNSTREAM OF ALL EARTH MOVING ACTIVITIES.
- . RUMBLE PAD CONSTRUCTION ENTRANCE TO BE SIZED IN ACCORDANCE WITH PA DEP MINIMUM REQUIREMENTS OF 50'L X 20'W AND BE INSTALLED IN ACCORDANCE WITH MANUFACTURES RECOMMENDATIONS.
- CONSTRUCTION, DEMOLITION AND EARTHWORK DUST CONTROL TO BE COMPLETED IN ACCORDANCE WITH THE CITY OF PHILADELPHIA DUST CONTROL REQUIREMENTS (AIR MANAGEMENT REGULATION (AMR) II. SECTION IX.) AND TO INCLUDE BUT NOT LIMITED TO:
  - a. NOTIFY OCCUPANTS OF NEARBY PROPERTIES, IN WRITING 10 DAYS BEFORE ENGAGING IN EARTHWORK, CONSTRUCTION AND DEMOLITION ACTIVITIES.
  - b. USE OF VACUUM OR SIMILAR SUCTION SYSTEMS TO CAPTURE DUST KICKED UP BY POWER TOOLS WHEN GRINDING OR CUTTING. c. APPLICATION OF WATER OR APPROVED DUST CONTROL
  - SUPPRESSANT DURING EXCAVATION, DEMOLITION AND/OR CONSTRUCTION TO SUPPRESS DUST FORMATION. d. COVERING AND WETTING OF STOCKPILES EARTH, SAND, GRAVEL
  - AND OTHER SIMILAR CONSTRUCTION MATERIALS. e. ALL PERIMETER FENCING MUST HAVE DUST CONTROL FABRIC AND
  - MUST MEASURE A MINIMUM OF 5 FT IN HEIGHT FROM THE BOTTOM OF FENCING.
  - f. 10 MILE PER HOUR SPEED LIMIT FOR ALL EQUIPMENT AND TRUCKS TRAVELING WITHIN THE WORK SITE.
  - g. WETTING AND SWEEPING OF ROADWAYS / ACCESS ROAD IN A WORK SITE TO PREVENT DUST FORMATIÓN.
- . PERMANENT INLET PROTECTION TO BE INSTALLED ON ALL INLETS THAT DRAIN TO THE UNDERGROUND STORMWATER MANAGEMENT SYSTEMS IN ACCORDANCE WITH THE SPECIFICATIONS.

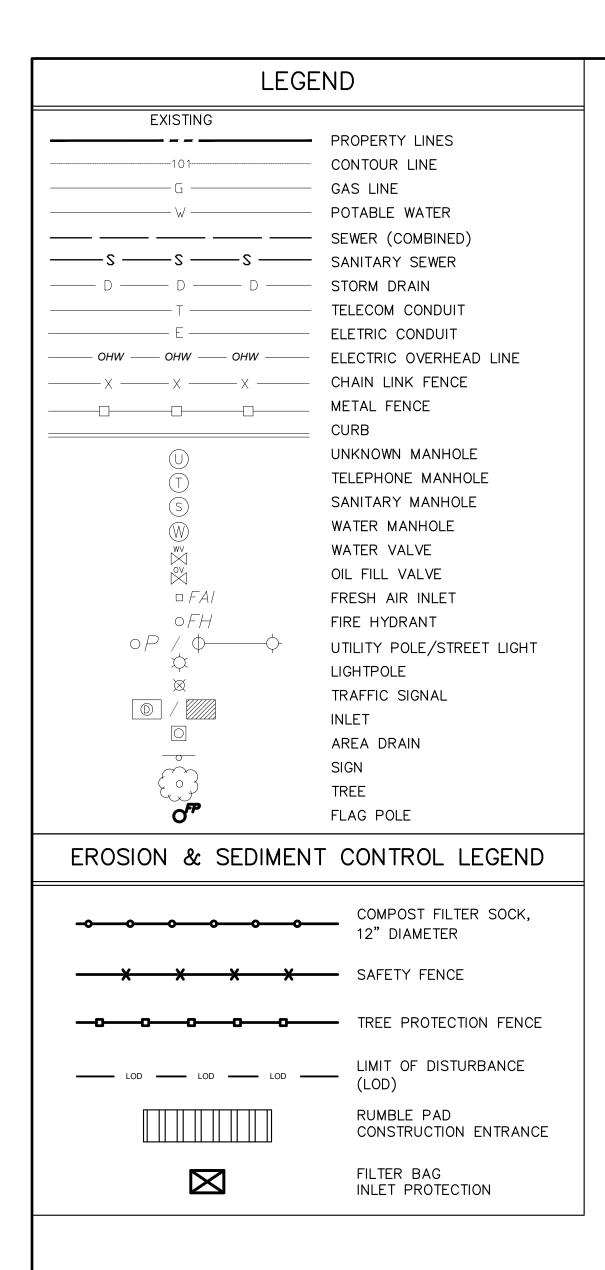

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	SUMM
ON-SITE	2,307
PUBLIC R.O.W.	
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#### STANDARD EROSION AND SEDIMENT CONTROL NOTES:

- AN INDUSTRIAL WASTE PERMIT WILL BE REQUIRED SHOULD PUMPING TO CITY-OWNED INFRASTRUCTURE BECOME NECESSARY DURING CONSTRUCTION. ALL PUMPING OF WATER FROM ANY WORK AREA SHALL BE DONE ACCORDING TO THE PROCEDURE DESCRIBED IN THIS PLAN, OVER UNDISTURBED VEGETATED AREAS.
- INLET PROTECTION SHOULD BE PROVIDED FOR ALL INLETS OWNED BY PWD THAT ARE LOCATED WITHIN ONE BLOCK OF THE PROJECT SITE.
- PWD IS NOT RESPONSIBLE FOR ANY CLEANING OR REPAIRS NEEDED ON CITY-OWNED INFRASTRUCTURE DUE TO FAILURE OF ANY EROSION AND SEDIMENT CONTROL PRACTICES. 24. FROZEN MATERIALS OR SOFT, MUCKY, OR HIGHLY COMPRESSIBLE MATERIALS SHALL NOT IT IS THE RESPONSIBILITY OF THE CONTRACTOR TO ENSURE THAT ALL EROSION AND SEDIMENT CONTROL PRACTICES ARE FUNCTIONING IN ACCORDANCE WITH THE APPROVED PLANS.
- INSPECTION AND MAINTENANCE OF ALL EROSION AND SEDIMENT CONTROL BEST MANAGEMENT PRACTICES SHALL OCCUR ON A WEEKLY BASIS, BEFORE ANY ANTICIPATED PRECIPITATION EVENTS, AND AFTER ALL PRECIPITATION EVENTS.
- THE MAXIMUM HEIGHT FOR STOCKPILES AREAS SHALL BE 20 FEET. THE MAXIMUM SIDE SLOPE FOR STOCKPILE AREAS SHALL NOT EXCEED 2:1.
- THE ROCK CONSTRUCTION ENTRANCE THICKNESS SHALL BE CONSTANTLY MAINTAINED ON-SITE. A STOCKPILE SHALL BE MAINTAINED ON-SITE FOR THIS PURPOSE AT THE END OF EACH CONSTRUCTION DAY, ALL SEDIMENT DEPOSITED ON PAVED ROADWAYS SHALL BE REMOVED AND RETURNED TO THE CONSTRUCTION SITE. IN NO CASE SHALL THE SEDIMENT BE WASHED, SHOVELED, OR SWEPT INTO ANY ROADSIDE DITCH, STORM SEWER, OR SURFACE WATER.
- FILTER FABRIC FENCE SHOULD BE INSTALLED AT LEVEL GRADE. BOTH ENDS OF EACH FENCE SECTION SHOULD BE EXTENDED AT LEAST 8 FEET UPSLOPE AT 45 DEGREES TO THE MAIN BARRIER ALIGNMENT. SUPPORT STAKES SHALL BE SPACED AT A MAXIMUM OF 8 FEET. SEDIMENT MUST BE REMOVED WHEN ACCUMULATIONS REACH 1/2 THE ABOVE GROUND HEIGHT OF THE FILTER FENCE.
- ANY FENCE SECTION WHICH HAS BEEN UNDERMINED OR TOPPED MUST BE IMMEDIATELY REPLACED WITH A ROCK FILTER OUTLET. SEDIMENT MUST BE REMOVED WHEN ACCUMULATIONS REACH 1/3 THE HEIGHT OF THE OUTLET.
- EROSION CONTROL BLANKETING SHALL BE INSTALLED ON ALL SLOPES 3H: 1V OR STEEPER 30. E&S BMP'S SHALL REMAIN FUNCTIONAL AS SUCH UNTIL ALL AREAS TRIBUTARY TO THEM WITHIN 50 FEET OF A SURFACE WATER AND ON ALL OTHER DISTURBED AREAS SPECIFIED ON THE PLAN MAPS AND/OR DETAIL SHEETS.
- 10. IMMEDIATELY UPON DISCOVERING UNFORESEEN CIRCUMSTANCES POSING THE POTENTIAL FOR ACCELERATED EROSION AND/OR SEDIMENT POLLUTION. THE OPERATOR SHALL IMPLEMENT APPROPRIATE BEST MANAGEMENT PRACTICES TO MINIMIZE THE POTENTIAL FOR EROSION AND SEDIMENT POLLUTION AND NOTIFY PWD AND PA DEP.
- I. UNTIL THE SITE IS STABILIZED, ALL E&S BMP'S SHALL BE MAINTAINED PROPERLY. MAINTENANCE SHALL INCLUDE INSPECTIONS OF ALL E&S BMP'S PRIOR TO ANY ANTICIPATED STORM EVENT, AFTER EACH RUNOFF EVENT AND ON A WEEKLY BASIS. ALL PREVENTATIVE AND REMEDIAL MAINTENANCE WORK, INCLUDING CLEAN OUT, REPAIR, REPLACEMENT, REGRADING, RESEEDING, REMULCHING, AND RENETTING, MUST BE PERFORMED IMMEDIATELY. IF THE E&S BMP'S FAIL TO PERFORM AS EXPECTED REPLACEMENT BMP'S, OR MODIFICATIONS OF THOSE INSTALLED, WILL BE REQUIRED.
- 12. ALL EARTH DISTURBANCES, INCLUDING CLEARING AND GRUBBING, AS WELL AS CUTS AND FILLS, SHALL BE DONE IN ACCORDANCE WITH THE APPROVED E&S PLAN. A COPY OF THE APPROVED DRAWINGS MUST BE AVAILABLE AT THE PROJECT SITE AT ALL TIMES. PWD SHALL BE NOTIFIED OF ANY CHANGES TO THE APPROVED PLAN PRIOR TO IMPLEMENTATION OF THOSE CHANGES. PWD MAY REQUIRE A WRITTEN SUBMITTAL OF THOSE CHANGES FOR REVIEW AND APPROVAL AT ITS DISCRETION.
- 13. AT LEAST THREE (3) DAYS PRIOR TO STARTING ANY EARTH DISTURBANCE ACTIVITIES, OR EXPANDING INTO AN AREA PREVIOUSLY UNMARKED, THE PENNSYLVANIA ONE CALL SYSTEM INC. SHALL BE NOTIFIED AT 1-800-242-1776 FOR THE LOCATION OF EXISTING UNDERGROUND UTILITIES.
- 14. ALL EARTH DISTURBANCE ACTIVITIES SHALL PROCEED IN ACCORDANCE WITH THE SEQUENCE PROVIDED ON THE PLAN DRAWINGS. DEVIATION FROM THAT SEQUENCI MUST BE APPROVED IN WRITING BY PWD AND THE PA DEP PRIOR TO IMPLEMENTATION.
- 5. AREAS TO BE FILLED ARE TO BE CLEARED, GRUBBED, AND STRIPPED OF TOPSOIL TO REMOVE TREES, VEGETATION, ROOTS, AND OTHER OBJECTIONABLE MATERIAL.
- 16. CLEARING, GRUBBING, AND TOPSOIL STRIPPING SHALL BE LIMITED TO THOSE AREAS GRUBBING, AND TOPSOIL STRIPPING MAY NOT COMMENCE IN ANY STAGE OF THE PROJECT UNTIL THE E&S BMP'S SPECIFIED BY THE BMP'S SEQUENCE FOR THAT STAGE HAVE BEEN INSTALLED AND ARE FUNCTIONING AS DESCRIBED IN THIS E&S PLAN.
- 17. AT NO TIME SHALL CONSTRUCTION VEHICLES BE ALLOWED TO ENTER AREAS OUTSIDE THE LIMIT OF DISTURBANCE BOUNDARIES SHOWN ON THE PLAN MAPS. THESE AREAS MUST BE CLEARLY MARKED AND FENCED OFF BEFORE CLEARING AND GRUBBING OPERATIONS
- 18. A LOG SHOWING DATES THAT E&S BMP'S WERE INSPECTED AS WELL AS ANY DEFICIENCIES FOUND AND THE DATE THEY WERE CORRECTED SHALL BE MAINTAINED ON THE SITE AND BE MADE AVAILABLE TO PWD AT THE TIME OF INSPECTION.
- 19. ALL SEDIMENT REMOVED FROM BMP'S SHALL BE DISPOSED OF IN THE FOLLOWING MANNER: REMOVAL AND DISPOSAL TO BE AT AN OFF-SITE LOCATION IN ACCORDANCE 3. WITH ALL LOCAL, STATE AND FEDERAL REGULATIONS.
- 20. AREAS WHICH ARE TO BE TOPSOILED SHALL BE SCARIFIED TO A MINIMUM DEPTH OF THREE TO FIVE INCHES -- SIX TO 12 INCHES ON COMPACTED SOILS -- PRIOR TO PLACEMENT OF TOPSOIL. AREAS TO BE VEGETATED SHALL HAVE A MINIMUM FOUR INCHES OF TOPSOIL IN PLACE PRIOR TO SEEDING AND MULCHING. FILL OUTSLOPES SHALL HAVE A MINIMUM OF TWO INCHES OF TOPSOIL.

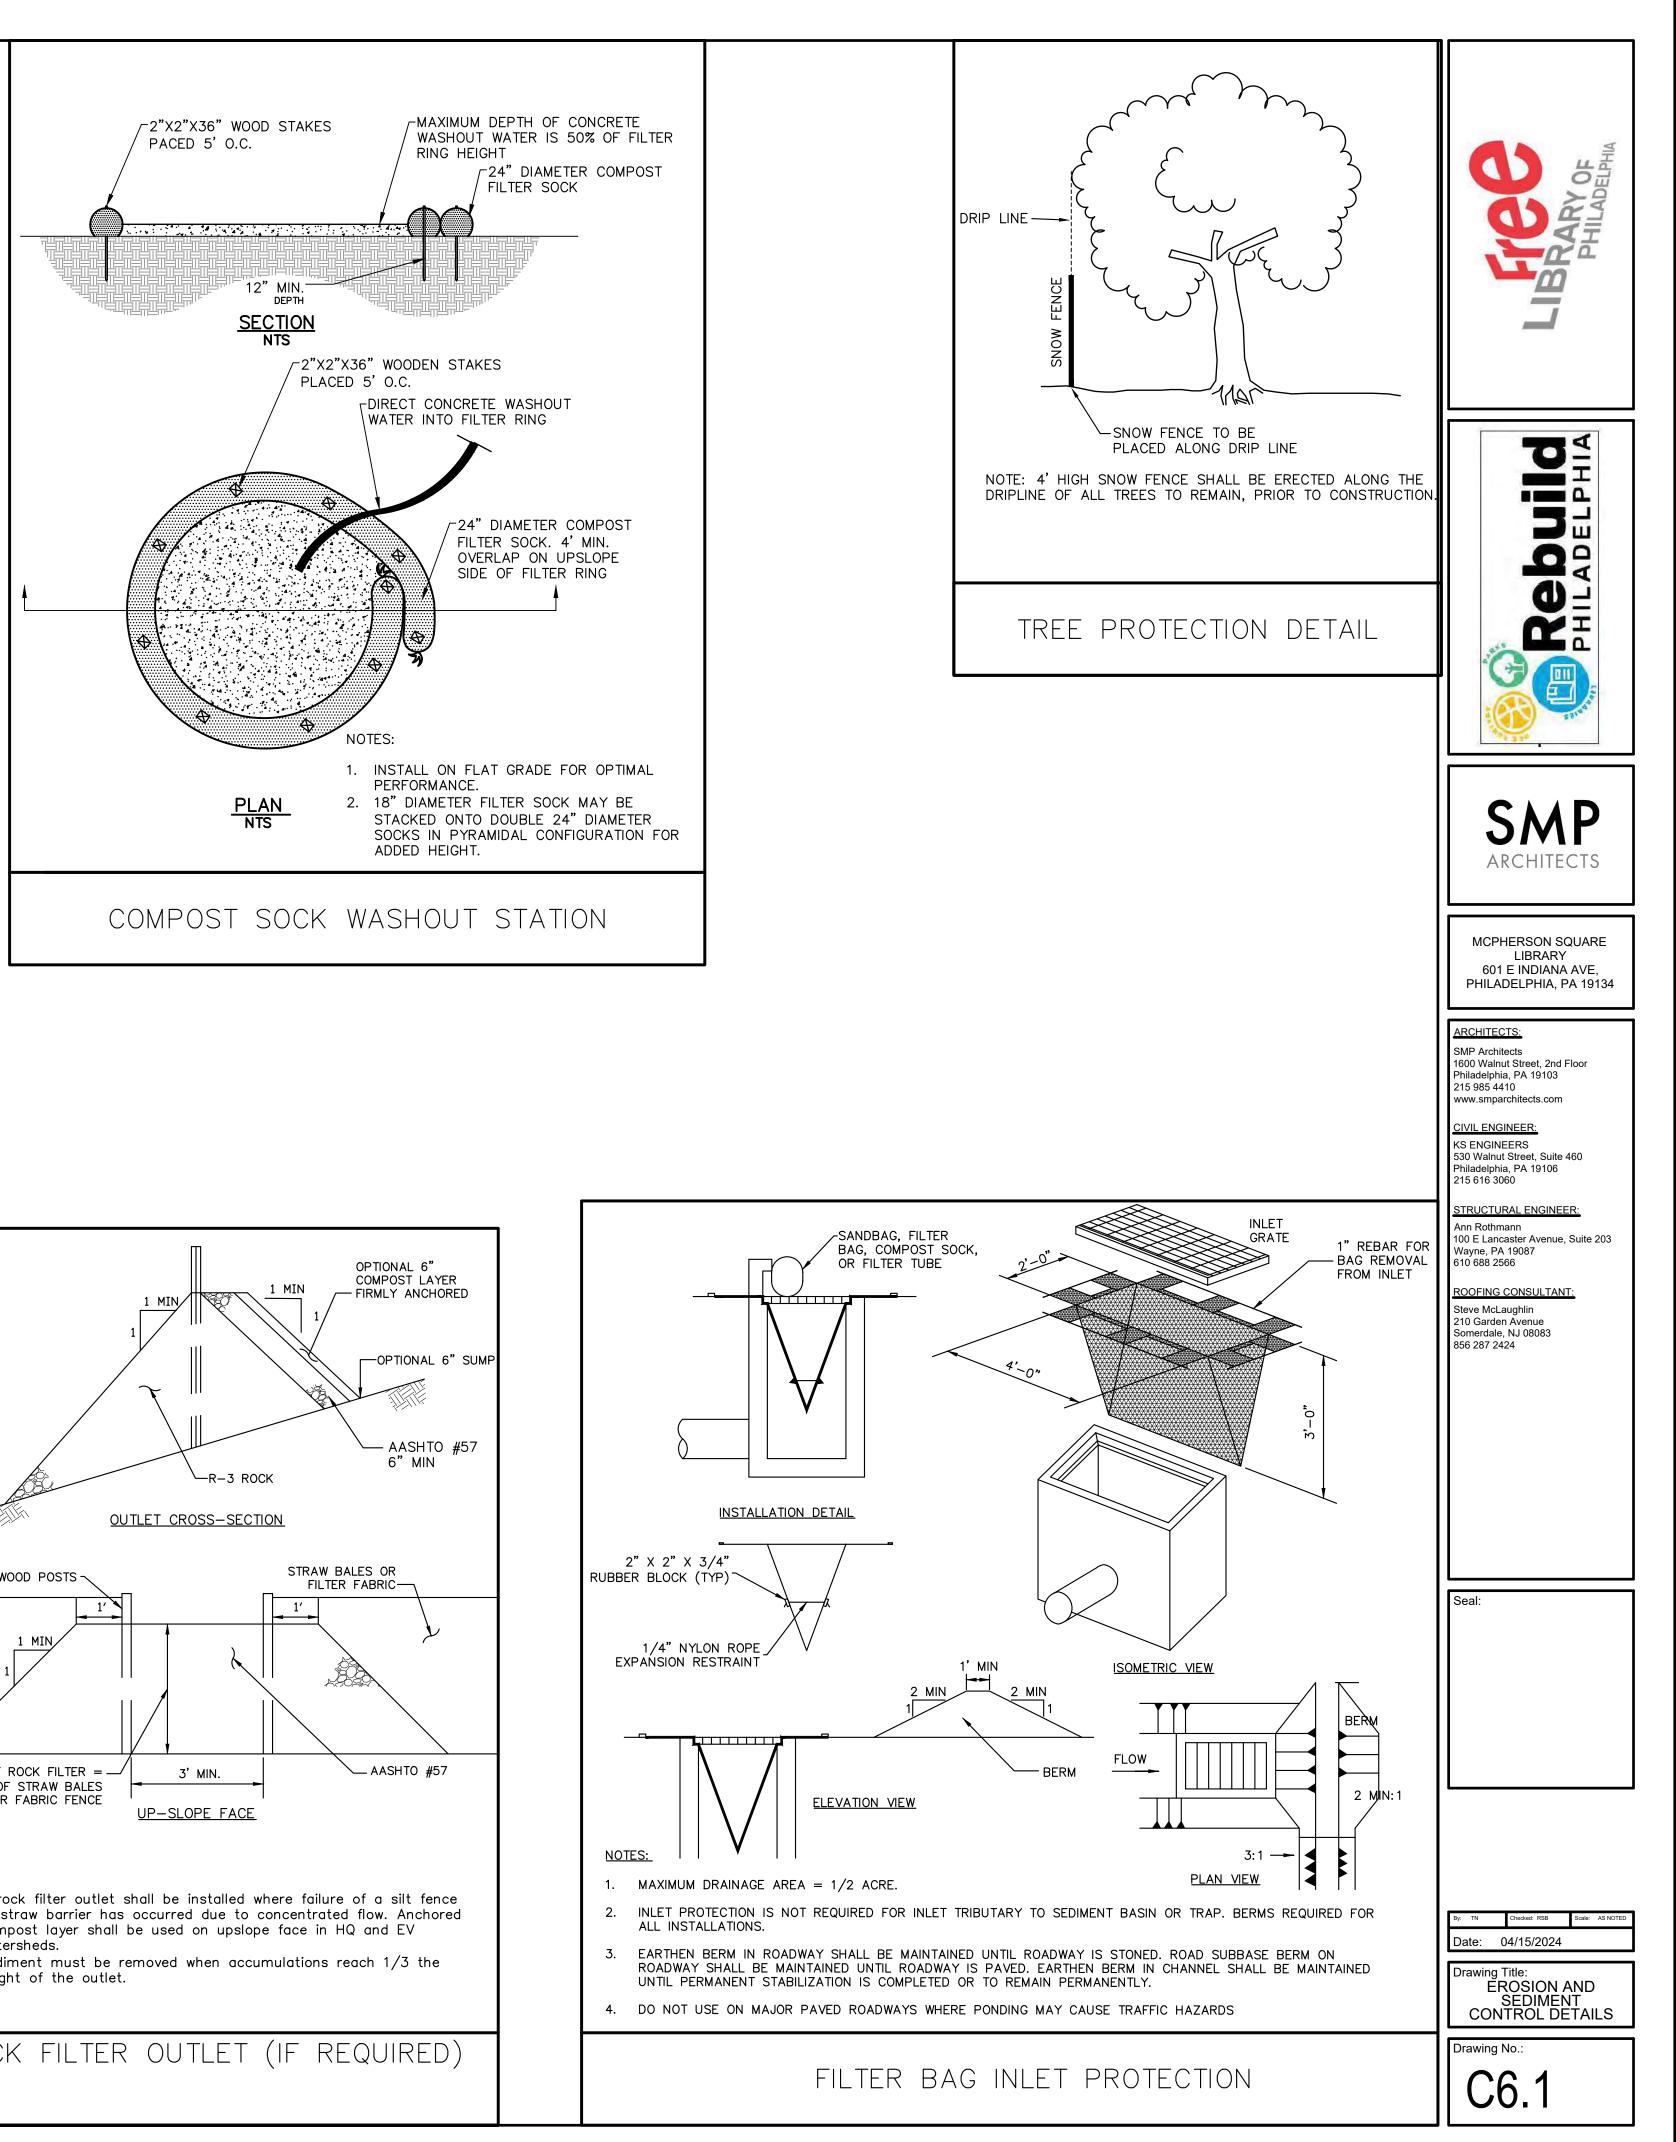- 21. ALL FILLS SHALL BE COMPACTED AS REQUIRED TO REDUCE EROSION, SLIPPAGE SETTLEMENT, SUBSIDENCE, OR OTHER RELATED PROBLEMS. FILL INTENDED TO SUPPORT BUILDINGS, STRUCTURES, AND CONDUITS, ETC. SHALL BE COMPACTED IN ACCORDANCE WITH LOCAL REQUIREMENTS OR CODES.
- 22. ALL EARTHEN FILLS SHALL BE PLACED IN COMPACTED LAYERS NOT TO EXCEED NINE INCHES IN THICKNESS.
- 23. FILL MATERIALS SHALL BE FREE OF FROZEN PARTICLES, BRUSH, ROOTS, SOD, OR OTHER FOREIGN OR OBJECTIONABLE MATERIALS THAT WOULD INTERFERE WITH OR PREVENT CONSTRUCTION OF SATISFACTORY FILLS.
- BE INCORPORATED INTO FILLS.
- 25. FILL SHALL NOT BE PLACED ON SATURATED OR FROZEN SURFACES.
- 26. SEEPS OR SPRINGS ENCOUNTERED DURING CONSTRUCTION SHALL BE HANDLED IN ACCORDANCE WITH THE STANDARD AND SPECIFICATION FOR SUBSURFACE DRAIN OR OTHER APPROVED METHOD.
- 27. ALL GRADED AREAS SHALL BE PERMANENTLY STABILIZED IMMEDIATELY UPON REACHING FINISHED GRADE. CUT SLOPES IN COMPETENT BEDROCK AND ROCK FILLS NEED NOT BE VEGETATED. SEEDED AREAS WITHIN 50 FEET OF A SURFACE WATER, OR AS OTHERWISE SHOWN ON THE PLAN DRAWINGS, SHALL BE BLANKETED ACCORDING TO THE STANDARDS OF THIS PLAN.
- 28. IMMEDIATELY AFTER EARTH DISTURBANCE ACTIVITIES CEASE IN ANY AREA OR SUB-AREA OF THE PROJECT. THE OPERATOR SHALL STABILIZE ALL DISTURBED AREAS. DURING NON-GERMINATING MONTHS. MULCH OR PROTECTIVE BLANKETING SHALL BE APPLIED AS DESCRIBED IN THE PLAN. AREAS NOT AT FINISHED GRADE, WHICH WILL BE REACTIVATED WITHIN ONE YEAR. MAY BE STABILIZED IN ACCORDANCE WITH THE TEMPORARY STABILIZATION SPECIFICATIONS. THOSE AREAS WHICH WILL NOT BE REACTIVATED WITHIN ONE YEAR SHALL BE STABILIZED IN ACCORDANCE WITH THE PERMANENT STABILIZATION SPECIFICATIONS
- 29. PERMANENT STABILIZATION IS DEFINED AS A MINIMUM UNIFORM, PERENNIAL 70% VEGETATIVE COVER OR OTHER PERMANENT NON-VEGETATIVE COVER WITH A DENSITY SUFFICIENT TO RESIST ACCELERATED EROSION. CUT AND FILL SLOPES SHALL BE CAPABLE OF RESISTING FAILURE DUE TO SLUMPING, SLIDING, OR OTHER MOVEMENTS.
- ARE PERMANENTLY STABILIZED OR UNTIL THEY ARE REPLACED BY ANOTHER BMP'S APPROVED BY PWD AND PA DEP.
- . AFTER FINAL SITE STABILIZATION HAS BEEN ACHIEVED, TEMPORARY E&S BMP'S MUST BE REMOVED OR CONVERTED TO PERMANENT POST-CONSTRUCTION STORMWATER MANAGEMENT PRACTICES. AREAS DISTURBED DURING REMOVAL OR CONVERSION OF THE E&S BMP'S SHALL BE STABILIZED IMMEDIATELY. IN ORDER TO ENSURE RAPID REVEGETATION OF DISTURBED AREAS, SUCH REMOVAL/CONVERSIONS ARE TO BE DONE ONLY DURING THE GERMINATING SEASON.
- B. 3% RED TOP 32. SEDIMENT BASINS AND/OR TRAPS SHALL BE KEPT FREE OF ALL CONSTRUCTION WASTE, C. 20% CHAMPION PERENNIAL RYE GRASS QUANTITIES ARE OF PURE LIVE SEED (P.L.S.) WASH WATER, AND OTHER DEBRIS HAVING POTENTIAL TO CLOG THE BASIN/TRAP OUTLET SPREAD AT A RATE OF 63 LBS. PER ACRE. STRUCTURES AND/OR POLLUTE THE SURFACE WATERS. (WHEN APPLICABLE)
- REMOVE ALL DEBRIS, INCLUDING LARGE STONES. TILL SOIL TO A DEPTH OF FOUR 33. DURING CONSTRUCTION, THE SELECTED CONTRACTOR IS EXPECTED TO FOLLOW THE INCHES TO SIX INCHES, APPLY LIME AT A RATE OF 4 TONS PER ACRE, APPLY PCSMP APPROVED BY PWD (WHERE APPLICABLE). NO CHANGE OR DEVIATION FROM THE COMMERCIAL 10-20-20 FERTILIZER AT A RATE OF 930 LBS. PER ACRE. WORK APPROVED PCSMP IS PERMITTED WITHOUT PRIOR APPROVAL FROM PWD. FERTILIZER INTO TOP INCH OF SOIL.
- 34. ALL WORK ASSOCIATED WITH PWD WATER CONVEYANCE AND SEWER INFRASTRUCTURE SHALL BE DONE IN ACCORDANCE WITH THE CITY OF PHILADELPHIA WATER DEPARTMENT "WATER MAIN STANDARD DETAILS AND CORROSION CONTROL SPECIFICATIONS". 1985 EDITION, AND "STANDARD DETAILS AND STANDARD SPECIFICATIONS FOR SEWERS", 1985 EDITION
- 35. CONTACT PWD WATER TRANSPORT RECORDS (1101 MARKET STREET, 2ND FLOOR, PHONE: 215-685-6271) FOR ADDITIONAL APPROVALS AND PERMITS REQUIRED FOR ALL WATER SERVICES, METERS, AND CONNECTIONS TO THE EXISTING AND/OR PROPOSED PWD FACILITIES.
- 36. ALL BUILDING MATERIALS AND WASTES SHALL BE REMOVED FROM THE SITE AND RECYCLED OR DISPOSED OF IN ACCORDANCE WITH THE PADEP'S SOLID WASTE MANAGEMENT REGULATIONS AT 25 PA CODE 260.1 ET SEQ., 271.1 AND 287.1 ET SEQ. NO BUILDING MATERIALS OR WASTES OR UNUSED BUILDING MATERIALS SHALL BE BURNED, BURIED, DUMPED, OR DISCHARGED AT THE SITE.
- DESCRIBED IN EACH STAGE OF THE CONSTRUCTION SEQUENCE. GENERAL SITE CLEARING, 37. A DUST CONTROL PERMIT WILL BE REQUIRED WHEN COMPLETELY DEMOLISHING A BUILDING OR AS DIRECTED. OR STRUCTURE THAT IS MORE THAN THREE (3) STORIES, GREATER THAN FORTY (40) 7. LIQUID MULCH BINDERS MAY BE USED TO ANCHOR SALT HAY, HAY OR STRAW MULCHES. FEET TALL OR ENCOMPASSES MORE THAN TEN THOUSAND (10,000) SQUARE FEET: A. APPLICATIONS SHOULD BE HEAVIER AT EDGES WHERE WIND CATCHES THE MULCH IN COMPLETELY OR PARTIALLY DEMOLISHING ANY BUILDING OR STRUCTURE BY IMPLOSION: VALLEYS AND AT CRESTS OF BANKS. REMAINDER OF AREAS SHOULD BE UNIFORM IN OR ENGAGING IN EARTHWORKS, DEFINED AS "CLEAING, GRUBBING, OR EARTH APPEARANCE B. USE ONE OF THE FOLLOWING: EMULSIFIED ASPHALT. CLASS E-1 OR E-6. APPLY 31 DISTURBANCE OF ANY LAND EXCESS OF 5,000 SQUARE FEET."

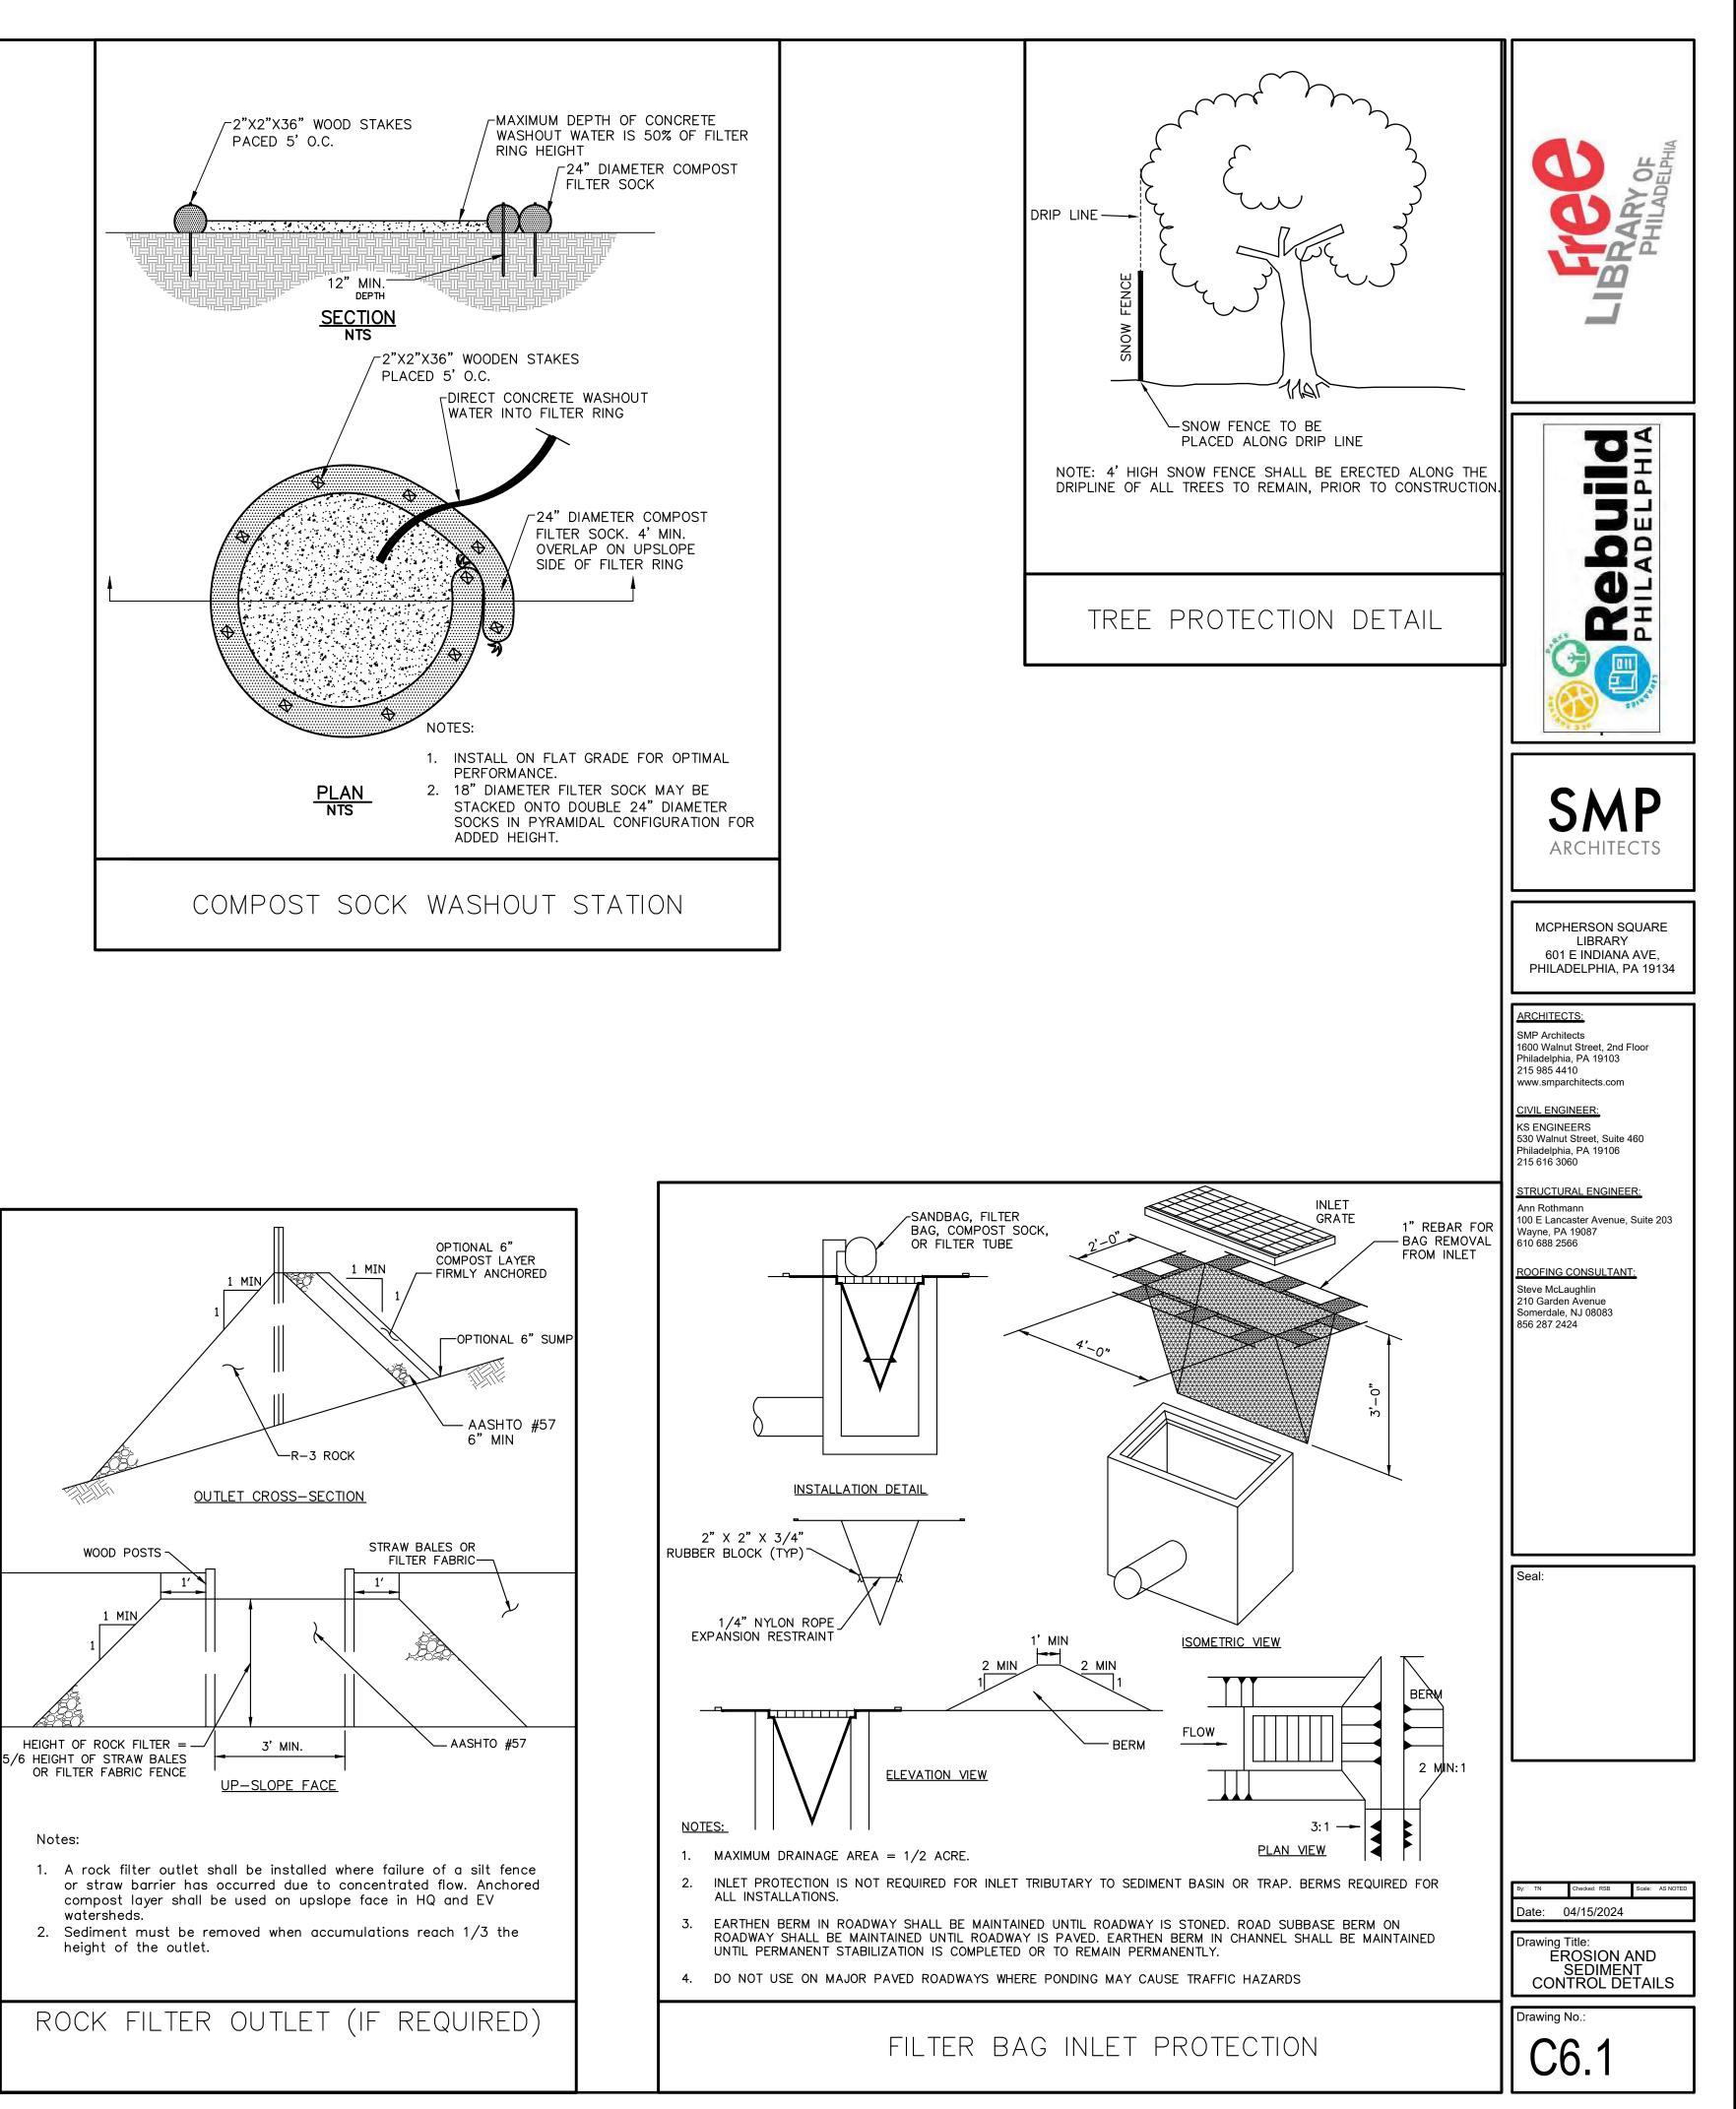SITE STABILIZATION METHODS (TEMPORARY & PERMANENT STABILIZATION)

- 1. STRAW MULCH MUST BE APPLIED AT 3.0 TONS PER ACRE.
- 2. MULCH WITH MULCH CONTROL NETTING OR EROSION CONTROL BLANKETS MUST BE INSTALLED ON ALL SLOPES GREATER THAN 3:1.
- . STRAW MULCH SHALL BE APPLIED IN LONG STRANDS, NOT CHOPPED OR FINELY MAINTENANCE PROGRAM BROKEN.

12. WATER PUMPED FROM WORK AREAS SHOULD BE TREATED FOR SEDIMENT REMOVAL PRIOR 1. THE CONTRACTOR WILL BE RESPONSIBLE FOR THE PROPER CONSTRUCTION STABILIZATION, TO DISCHARGING TO A "SURFACE WATER" TEMPORARY SEEDING AND MAINTENANCE OF ALL TEMPORARY EROSION AND SEDIMENTATION CONTROL MEASURES AND RELATED ITEMS INCLUDED WITHIN THIS PLAN. THE CONTRACTOR WILL 13. AS SOON AS SLOPES, CHANNEL DITCHES AND OTHER DISTURBED AREAS REACH FINAL 1. THE FOLLOWING SURFACES OF THE SITE SHALL BE TEMPORARILY SEEDED AND ALSO BE RESPONSIBLE FOR THE PROPER CONSTRUCTION AND STABILIZATION OF GRADE, THEY MUST BE STABILIZED. CESSATION OF ACTIVITY FOR FOUR (4) DAYS OR MULCHED: PERMANENT CONTROL MEASURES AND RELATED ITEMS INCLUDED WITHIN THIS PLAN. LONGER REQUIRES TEMPORARY STABILIZATION.

- A. THE SURFACE OF TOPSOIL STOCKPILES. B. THE SURFACE OF EXPOSED EARTH AREAS THAT WILL BE EXPOSED WITHOUT CONSTRUCTION ACTIVITY THEREON. SEEDING SHALL OCCUR IMMEDIATELY AFTER ESTABLISHMENT OF THE TOPSOIL STOCKPILES OR ROUGH GRADED AREAS. THE FOLLOWING SHALL BE PLANTED: A. 40 LBS. / ACRE ANNUAL RYE GRASS - COMMON. 100% P.L.S.
- 3. PREPARE AREAS TO BE SEEDED AS FOLLOWS: A. REMOVE ALL DEBRIS, INCLUDING LARGE STONES. APPLY LIME AT A RATE OF 3 TONS PER ACRE AND FERTILIZER AT THE RATE OF 50-50 PER ACRE AND WORK INTO SOIL B. SOW SEED AT THE INDICATED RATE. DIVIDE SEED INTO TWO EQUAL LOTS. SOW ONE LOT IN ONE DIRECTION. SOW SECOND LOT AT RIGHT ANGLE TO

FIRST. RAKE SEEDED AREA SLIGHTLY. ROLL SURFACE LIGHTLY TO FIRM SOIL


- AROUND SEED. 4. PLACE CLEAN DRY STRAW OR HAY MULCH WITHIN 48 HOURS AFTER SEEDING.
- PLACE AT THE RATE OF 3 TONS PER ACRE. SEEDING DATES SHALL BE BETWEEN MARCH 1 AND NOVEMBER 15.
- TEMPORARY MULCHING
- MULCH PROPOSED LANDSCAPE AREAS OR TOPSOIL STOCKPILES IF EARTHWORK IS COMPLETED OUTSIDE OF THE RECOMMENDED PLANTING SEASONS FOR TEMPORARY SEEDING OR DUE TO UNFAVORABLE WEATHER CONDITIONS.
- MULCH SHALL BE APPLIED IMMEDIATELY FOLLOWING THE ESTABLISHMENT OF THE TOPSOIL STOCKPILE OR ROUGH GRADING.
- 3. MULCH WITH SUITABLE FIBROUS GROUND, SHREDDED AGED HARDWOOD, PINE WOOD BARK OR STRAW, UNIFORMLY AND CONTINUOUSLY TO A LOOSE DEPTH OF 3 INCHES MINIMUM. ANCHOR AS REQUIRED.
- 4. PROPERLY MAINTAIN MULCHED AREAS UNTIL PERMANENT STABILIZATION MEASURES ARE COMPLETE. REAPPLY MULCH MATERIALS WHICH BECOME DISLODGED AS INITIAL OR MODIFIED RATES AS NECESSARY. IF A SLOPE FAILURE OCCURS WHICH REQUIRES REDRESSING, EXCAVATION, OR THE ESTABLISHMENT OF A NEW SLOPE, REPLACE MULCH AS NECESSARY.
- PERMANENT SEEDING
- PERMANENT SEEDING SHALL OCCUR IMMEDIATELY AFTER THE FINAL GRADING IS COMPLETED. THE FOLLOWING SEED SHALL BE PLACED UNLESS OTHERWISE SPECIFIED ON THE PLANS OR DIRECTED IN THE FIELD. THE FOLLOWING SEED MIX SHALL BE USED: A. 40% PENNLAWN FINE FESCUE
- SEED ONLY AT THE FOLLOWING TIMES: A. SPRING: MARCH 1 TO APRIL 30

LBS. PER 1,000 SQUARE YARDS.


- B. LATE SUMMER/EARLY FALL: AUGUST 15 TO NOVEMBER 15
- 4. DIVIDE SEED INTO TWO EQUAL LOTS. SOW ONE LOT IN ONE DIRECTION. SOW SECOND LOT AT RIGHT ANGLE TO FIRST LOT. RAKE SEEDED AREA SLIGHTLY. ROLL SURFACE LIGHTLY TO FIRM SOIL AROUND SEED.
- MULCH SEEDED AREAS WITH STRAW OR HAY AT THE RATE OF 3 TONS PER ACRE. ANCHOR MULCH. COMPLY WITH THE REQUIREMENTS OF SECTION 805 - MULCHING, PENNDOT PUBLICATION 408. ANCHOR MULCH AS SPECIFIED.
- MULCHING SHALL BE DONE AT THE MINIMUM RATE OF 3 TONS PER ACRE WITH SALT HAY. HAY OR STRAW MULCHES. PLACE MULCH IMMEDIATELY AFTER SEEDING OR WITHIN 48 HOURS AFTER SEEDING IS COMPLETED. PROPERLY MAINTAIN MULCHED AREAS UNTIL THE ENTIRE PROJECT HAS BEEN COMPLETED. PROMPTLY REAPPLY MULCH MATERIALS WHICH BECOME DISLODGED OR LOST DUE TO WIND, RAIN, OR OTHER CAUSES AT INITIAL RATES
- GALLONS PER 1,000 SQUARE YARDS ON SLOPES LESS THAN 8 FEET HIGH. ON SLOPES 8 FEET HIGH OR MORE, USE 58 GALLONS PER 1,000 SQUARE YARDS. CUTBACK ASPHALT. CLASS RC-250. APPLY 31 GALLONS PER 1.000 SOUARE YARDS ON FLAT AREAS AND ON SLOPES LESS THAN 8 FEFT HIGH. ON SLOPES 8 FEFT HIGH NATURAL VEGETABLE GUM BLENDED WITH GELLING AND HARDENING AGENTS (TERRA TACK. AR) AS MANUFACTURED BY GRASS GROWERS COMPANY OR EQUAL. APPLY 25


- 2. THE OWNER WILL BE RESPONSIBLE FOR THE MAINTENANCE OF ALL PERMANENT CONTROL MEASURES.
- 3. UNTIL THE SITE IS STABILIZED, ALL EROSION AND SEDIMENT BMP'S MUST BE MAINTAINED PROPERLY. MAINTENANCE MUST INCLUDE INSPECTIONS OF ALL EROSION AND SEDIMENT CONTROL BMP'S AFTER EACH RUNOFF EVENT AND ON A WEEKLY BASIS. ALL PREVENTATIVE AND REMEDIAL MAINTENANCE WORK, INCLUDING CLEAN OUT, REPAIR. REPLACEMENT, REGRADING, RESEEDING, REMULCHING, AND RENETTING, MUST BE DONE IMMEDIATELY. IF EROSION AND SEDIMENT CONTROL BMP'S FAIL TO PERFORM AS EXPECTED, REPLACEMENT BMP'S, OR MODIFICATIONS TO THOSE INSTALLED WILL BE REQUIRED.
- SEDIMENT REMOVED FROM BMP'S SHALL BE DISPOSED OF AT AN OFF-SITE LOCATION IN ACCORDANCE WITH ALL LOCAL, STATE AND FEDERAL REGULATIONS.
- SOIL SEDIMENT REMOVED FROM SILT FENCE DURING REGULAR MAINTENANCE WILL BE INCORPORATED BACK INTO THE EARTHWORK AS FILL ON THE SITE. SOIL SEDIMENT MATERIAL SHALL BE DISTRIBUTED ON-SITE WITHOUT CHANGING DRAINAGE PATTERNS DURING A SPECIFIC CONSTRUCTION STAGE. SILT FENCE INSTALLED ON THE PROJECT SITE SHALL BE MAINTAINED AS FOLLOWS:
- A. THE FENCE CONDITION WILL BE INSPECTED ONCE A WEEK OR AFTER EVERY STORM EVENT, WHICHEVER COMES FIRST. ANY NECESSARY REPAIRS WILL BE MADE IMMEDIATELY. B. ACCUMULATED SEDIMENTS WILL BE REMOVED AS REQUIRED TO KEEP THE FENCE
- FUNCTIONAL. DEPOSITS WILL BE REMOVED WHERE ACCUMULATIONS REACH ONE-HALF THE ABOVE-GROUND HEIGHT OF THE FENCE. C. UNDERCUTTING OR EROSION OF THE TOE ANCHOR WILL BE REPLACED IMMEDIATELY
- WITH ROCK FILTER OUTLETS. D. ANY MANUFACTURER'S RECOMMENDATIONS WILL BE ADHERED TO WHEN REPLACING FILTER FABRIC FENCE DUE TO WEATHERING.
- 6. AT THE END OF EACH CONSTRUCTION DAY, ANY SEDIMENT DEPOSITED ON PUBLIC ROADWAYS, WILL BE REMOVED AND RETURNED TO THE CONSTRUCTION SITE. WASHING OF THE ROADWAY WITH WATER WILL NOT BE PERMITTED.
- OTHER BMP'S A. SEDIMENT MUST BE REMOVED FROM STORM WATER INLET PROTECTION AFTER EACH RUNOFF EVENT.
- CONSTRUCTION SEQUENCE:
- 1. AT LEAST 7 DAYS PRIOR TO STARTING ANY EARTH DISTURBANCE ACTIVITIES, THE OPERATOR SHALL INVITE ALL CONTRACTORS INVOLVED IN EARTH MOVING ACTIVITIES. THE LANDOWNER, ALL APPROPRIATE CITY OFFICIALS. THE EROSION AND SEDIMENT CONTROL PREPARER. AND REPRESENTATIVE OF THE CITY OF PHILADELPHIA EROSION AND SEDIMENT CONTROL OFFICE TO AN ON-SITE MEETING. INCLUDE A REPRESENTATIVE FROM PWD'S EROSION AND SEDIMENT CONTROL INSPECTION GROUP BY CONTACTING THE INSPECTIONS COORDINATOR OF PWD (OFFICE 215-685-6387).
- 2. AT LEAST 3 DAYS BEFORE STARTING ANY EARTH DISTURBANCE ACTIVITIES, ALL CONTRACTORS INVOLVED IN THOSE ACTIVITIES SHALL NOTIFY THE PENNSYLVANIA ONE CALL SYSTEM INCORPORATED AT 1-800-242-1776 FOR BURIED UTILITY LOCATIONS.
- CONSTRUCTION FENCE TO BE INSTALLED AROUND THE PERIMETER OF THE WORK AREA. THE CONTRACTOR SHALL COORDINATE THE LOCATION OF THE FENCE WITH THE OWNER AND/OR ENGINEER. CONSTRUCTION FENCE LOCATION SHALL BE INSTALLED TO PROTECT THE PUBLIC FROM LAND DISTURBANCE ACTIVITIES AND TO MAINTAIN PEDESTRIAN ACCESS
- 4. INSTALL COMPOST FILTER SOCK DOWNHILL FROM ALL EARTH MOVING ACTIVITIES AND AS SHOWN ON THE PLAN. ALTHOUGH OFF SITE AREAS ARE PAVED, COMPOST FILTER SOCK OR OTHER EROSION CONTROL PRACTICES SHALL BE INSTALLED AROUND THE PERIMETER OF THE WORK AREA AS SHOWN ON THE PLAN
- INSTALL INLET PROTECTION AS SHOWN ON THE PLAN. EXISTING INLETS SHALL BE PROTECTED THROUGHOUT THE DURATION OF THE CONSTRUCTION.
- 6. INSTALL CONSTRUCTION ENTRANCE AS SHOWN AND IN ACCORDANCE WITH THE CONSTRUCTION ENTRANCE DETAIL.
- 7. CLEAR AND GRUB SITE, DEMOLISH EXISTING PAVING, CURBING, AND FENCING AS REQUIRED SAWCUT PAVED AREAS AS NEEDED TO MINIMIZE FARTH DISTURBANCE EXCAVATE TRENCHES FOR PROPOSED SEWER CONNECTIONS. DEMOLISHED MATERIAL SHALL BE REMOVED FROM THE SITE AND DISCARDED IN ACCORDANCE WITH APPLICABLE CITY, STATE, AND FEDERAL REGULATIONS.
- ROUGH GRADE SUBBASE TO REQUIRED DEPTHS.
- INSTALL ALL INLETS AND PIPING IN ACCORDANCE WITH THE PLAN DRAWINGS. PHOTOGRAPH INLETS SHOWING THE PROPERLY INSTALLED SUMP (WITH TAPE MEASURE AS SIZE REFERENCE) AND TRAP/HOOD (INCLUDING GROUTING) IN ACCORDANCE WITH THE CONSTRUCTION CERTIFICATION PACKAGE. CONFIRM. MEASURE. AND PHOTOGRAPH INLET AND INLET SUMP DEPTHS IN ACCORDANCE WITH THE CONSTRUCTION CERTIFICATION PACKAGE, INSTALL AND PHOTOGRAPH TRAPS/HOODS AS INDICATED ON THE PLANS IN ACCORDANCE WITH THE CONSTRUCTION CERTIFICATION PACKAGE. INSTALL INLET PROTECTION ON INLETS AS THEY BECOME FUNCTIONAL.
- OR MORE, USE 58 GALLONS PER 1,000 SQUARE YARDS. NON-ASPHALTIC EMULSION 10. REMOVE ANY ACCUMULATED DEBRIS OR SEDIMENT THAT HAS TAKEN PLACE AFTER THE APPROVAL OF THE SUBGRADE.
  - 11. INSTALL PROPOSED SITE IMPROVEMENTS.
  - 14. TOPSOIL AND SEED GRASSED AREAS. INSTALL PLANTS AND TREES.
  - 15. SWEEP PAVED AREAS DAILY TO PREVENT TRACKING OF SOIL OFF-SITE.
  - 16. UPON COMPLETION OF ALL EARTH DISTURBANCE ACTIVITIES AND PERMANENT STABILIZATION OF ALL DISTURBED AREAS, THE OWNER AND/OR OPERATOR SHALL CONTACT INSPECTIONS COORDINATOR OF PWD (OFFICE: 215-685-6387) FOR A FINAL INSPECTION PRIOR TO REMOVAL ON THE E&SC BMPS.
  - 17. REMOVE SOIL EROSION MEASURES AFTER SITE HAS BEEN INSPECTED AND STABILIZED.




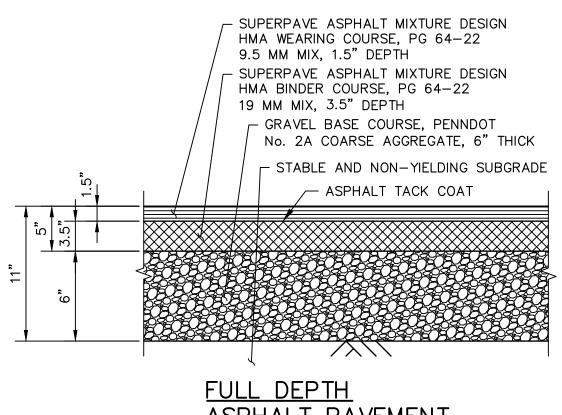

ASPHALT PAVEMENT SCALE: N.T.S.

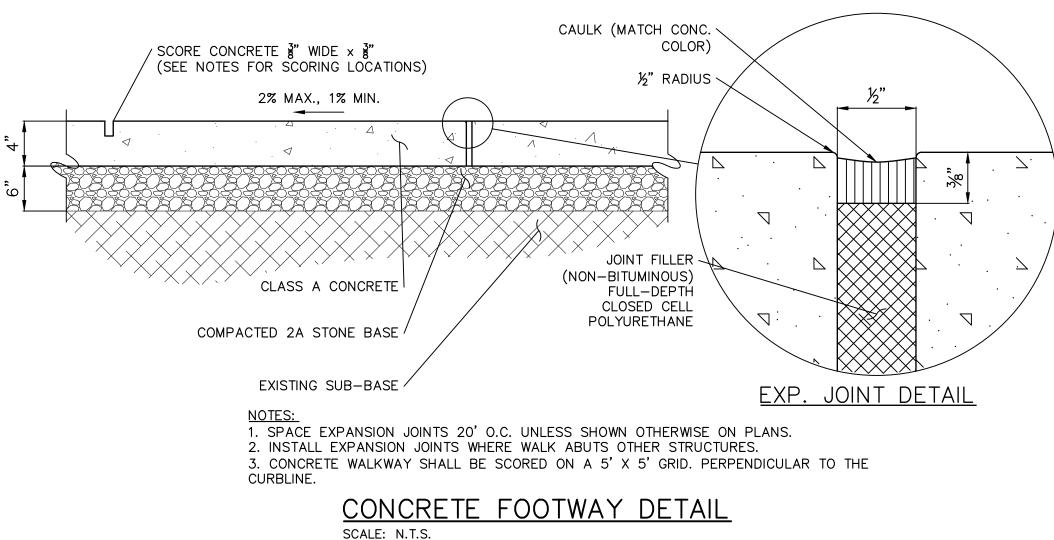


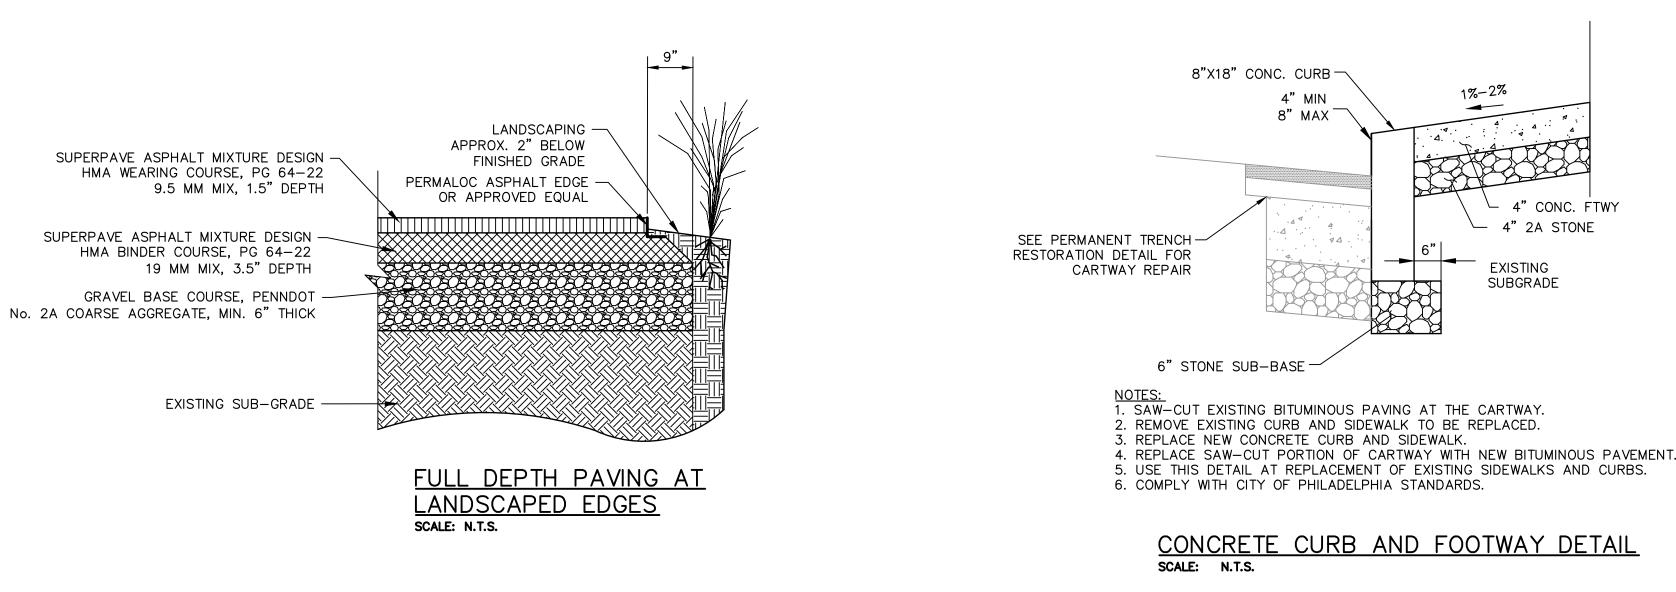

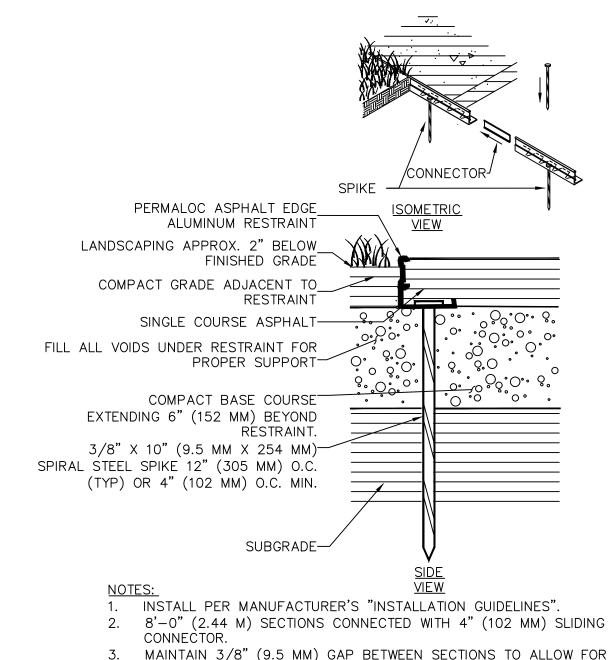

- MAINTAIN 3/8" (9.5 MM) GAP BETWEEN SECTIONS TO ALLOW FOR PRODUCT EXPANSION IN EXTREME TEMPERATURES.
- CORNERS: NOTCH BASE ONLY AND FORM A CONTINUOUS CORNER. 4.

ASPHALT EDGING DETAIL SCALE: N.T.S.

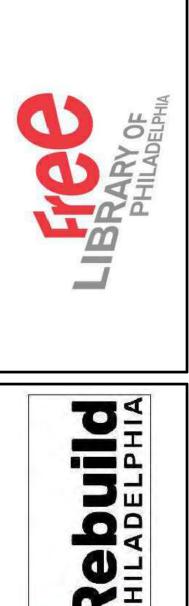



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ARCHITECTS: SMP Architects 1600 Walnut Street, 2nd Floor Philadelphia, PA 19103 215 985 4410 www.smparchitects.com


UVIL ENGI KS ENGINEERS 530 Walnut Street, Suite 460 Philadelphia, PA 19106 215 616 3060

STRUCTURAL ENGINEER: Ann Rothmann 100 E Lancaster Avenue, Suite 203 Wayne, PA 19087 610 688 2566


**ROOFING CONSULTANT:** Steve McLaughlin 210 Garden Avenue Somerdale, NJ 08083 856 287 2424

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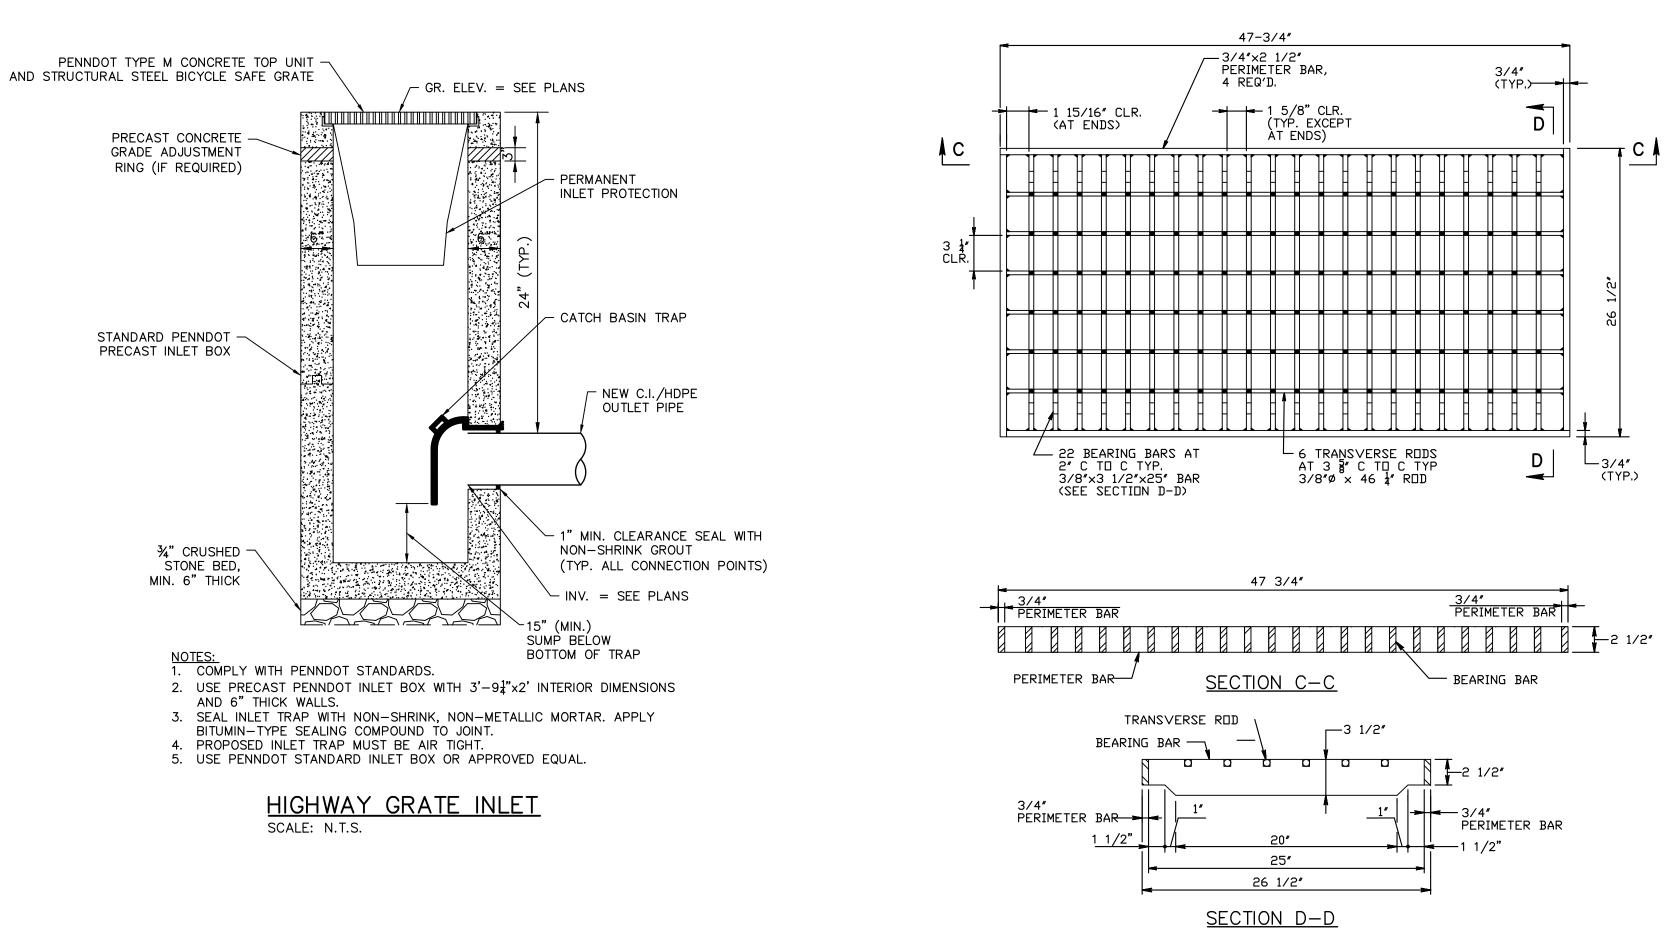


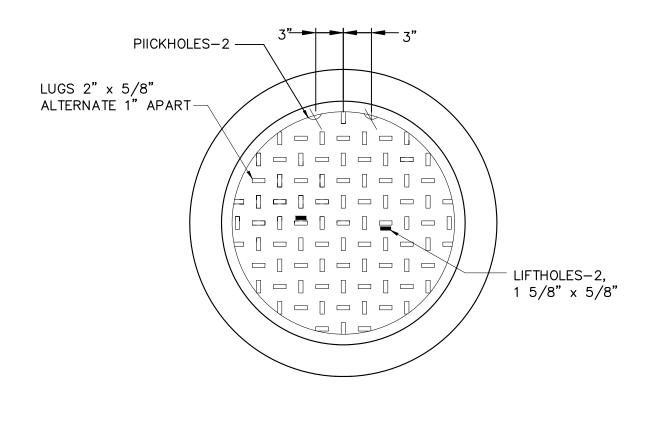


GRAY MANHOLE FRAME AND COVER SCALE: N.T.S.

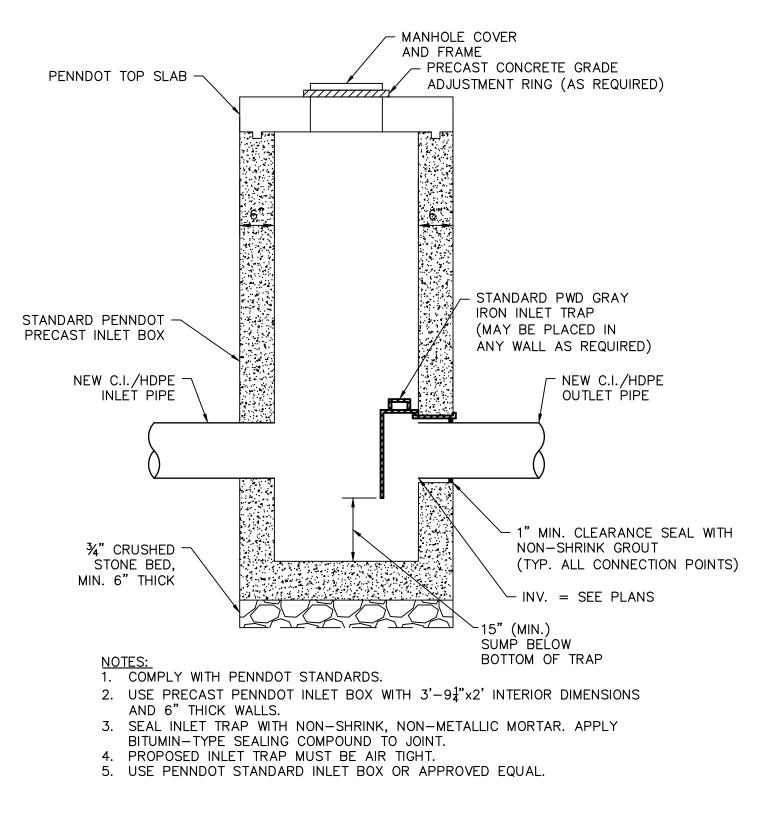


STANDARD MANHOLE SCALE: N.T.S.



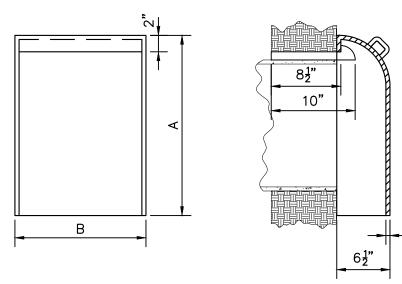

NOTES: 1. CAST IRON HANDLE. 2. LOCATE BOTTOM OF TRAP MINIMUM

6" BELOW FLOW LINE. 3. INSTALL ON FLAT WALL ONLY.

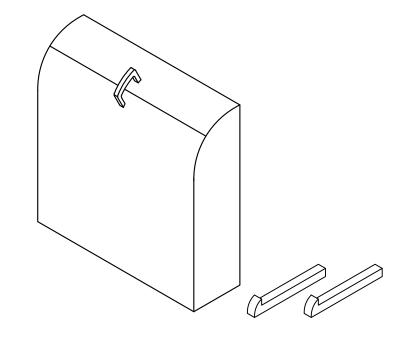


R-3701 CATCH BASIN TRAP - ALL DIMENSIONS IN INCHES				
CATALOG NO.	A (IN)	B(IN)	PIPE SIZE (IN)	SETTING METHOD
R-3701-6	16	12	UP TO 6	ON 2 HOOKS
R-3701-8	18	12	8	ON 2 HOOKS
R-3701-10	20	12	10	ON 2 HOOKS
R-3701-12	22	16	12	ON 2 HOOKS
R-3701-15	25	19	15	ON 2 HOOKS
R-3701-18	28	22	18	ON 2 HOOKS

## STANDARD INLET TRAP SCALE: N.T.S.


STRUCTURAL STEEL BICYCLE SAFE GRATE SCALE: N.T.S.




wing No.:	
<b>C8</b>	0

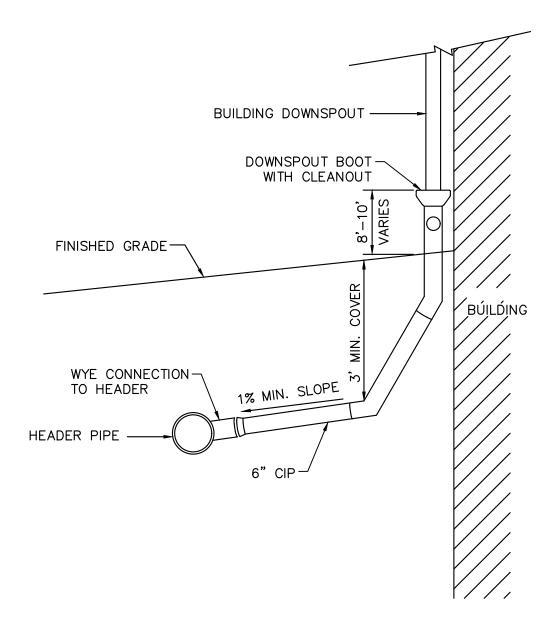

DOWNSPOUT LATERAL CONNECTION SCALE: N.T.S.

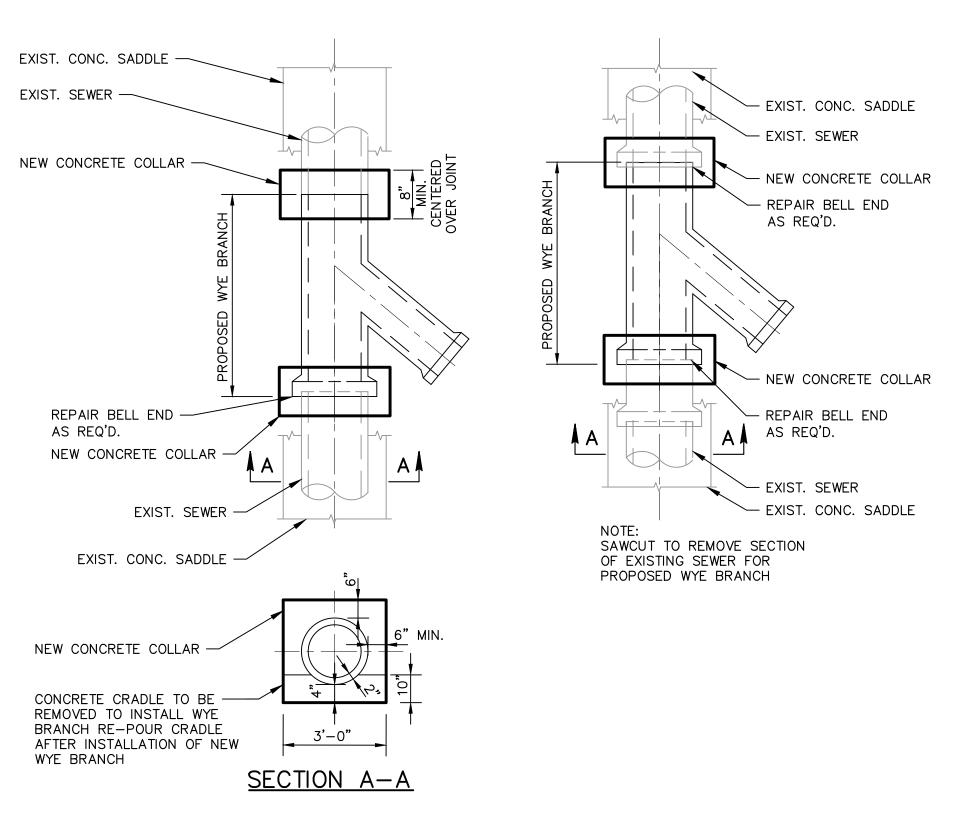

PREFABRICATED WYE BRANCH DETAIL scale: n.t.s.

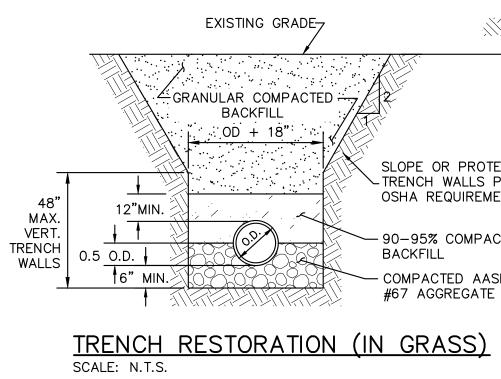

SLOPE OR PROTECT TRENCH WALLS PER OSHA REQUIREMENTS

- 90-95% COMPACTED BACKFILL COMPACTED AASHTO #67 AGGREGATE







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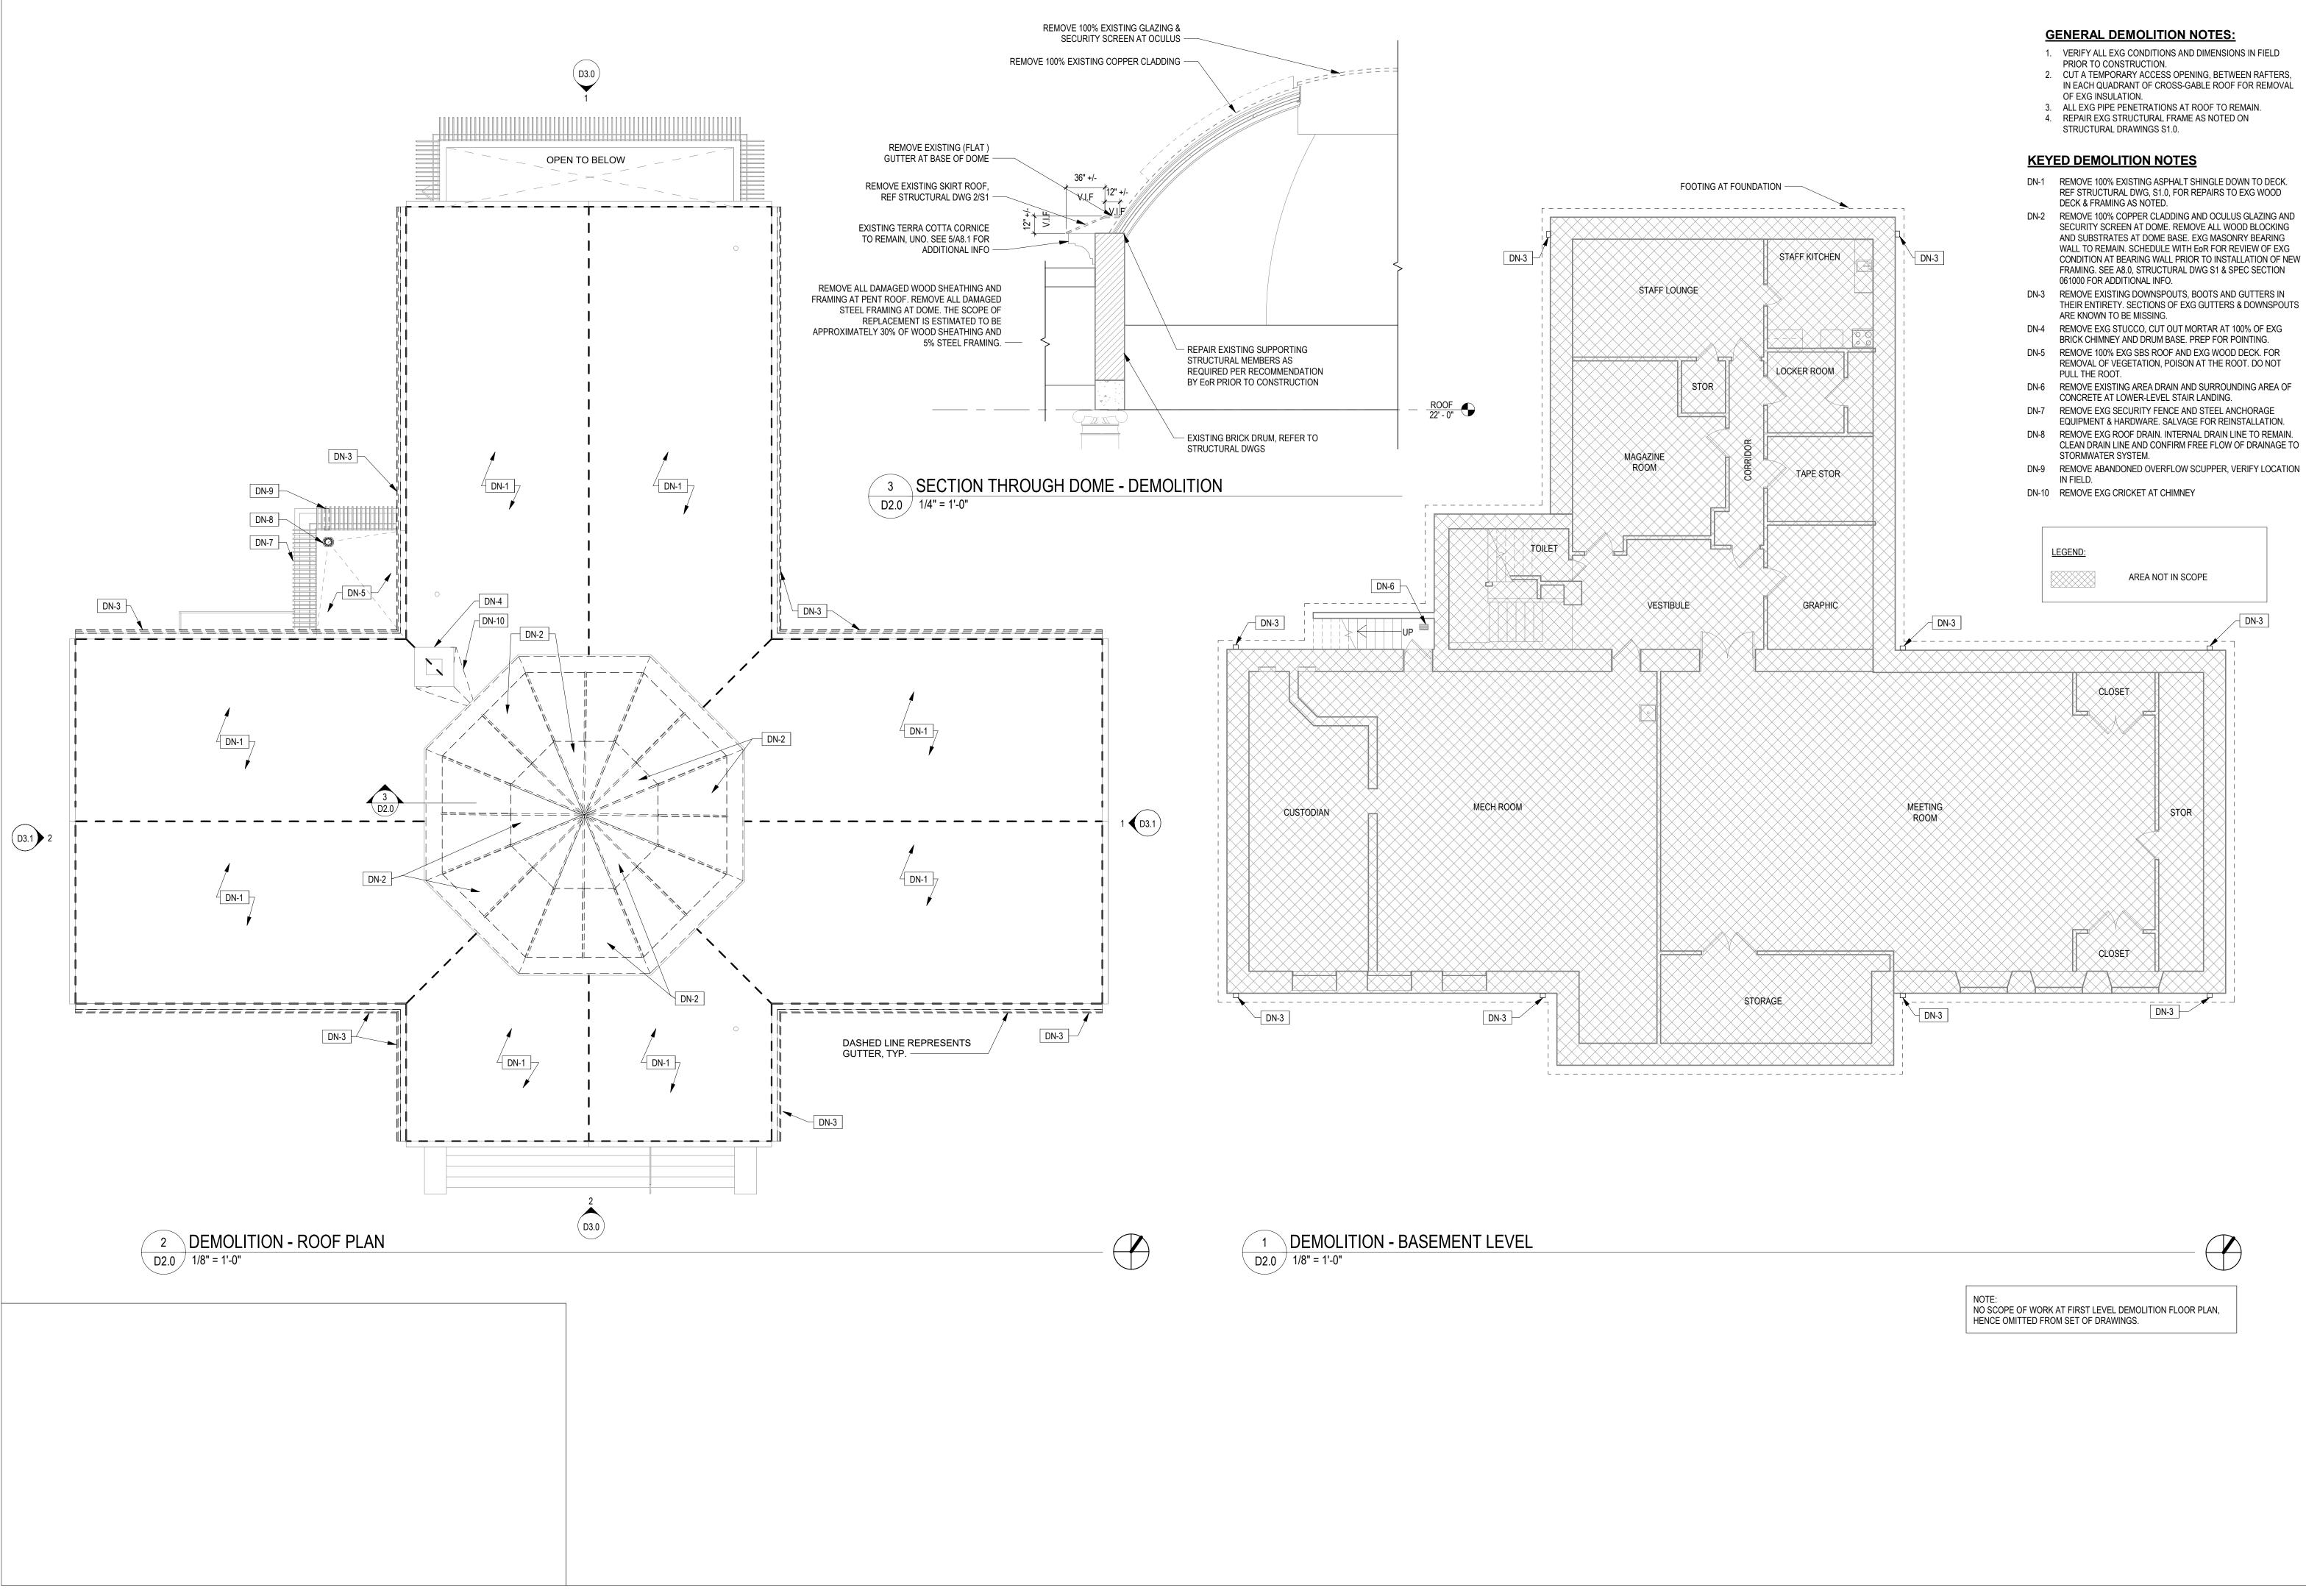
CIVIL ENGIN KS ENGINEERS 530 Walnut Street, Suite 460 Philadelphia, PA 19106 215 616 3060

STRUCTURAL ENGINEER: Ann Rothmann 100 E Lancaster Avenue, Suite 203 Wayne, PA 19087 610 688 2566

ROOFING CONSULTANT: Steve McLaughlin 210 Garden Ävenue Somerdale, NJ 08083 856 287 2424

Seal:

By: TN Checked: RSB Scale: AS NOTE Date: 04/15/2024 Drawing Title: UTILITY DETAILS Drawing No.: C8.1



- 2. CUT A TEMPORARY ACCESS OPENING, BETWEEN RAFTERS, IN EACH QUADRANT OF CROSS-GABLE ROOF FOR REMOVAL
- 3. ALL EXG PIPE PENETRATIONS AT ROOF TO REMAIN.

- DN-1 REMOVE 100% EXISTING ASPHALT SHINGLE DOWN TO DECK. REF STRUCTURAL DWG, S1.0, FOR REPAIRS TO EXG WOOD
- DN-2 REMOVE 100% COPPER CLADDING AND OCULUS GLAZING AND SECURITY SCREEN AT DOME. REMOVE ALL WOOD BLOCKING AND SUBSTRATES AT DOME BASE. EXG MASONRY BEARING WALL TO REMAIN. SCHEDULE WITH EOR FOR REVIEW OF EXG CONDITION AT BEARING WALL PRIOR TO INSTALLATION OF NEW FRAMING. SEE A8.0, STRUCTURAL DWG S1 & SPEC SECTION DN-3 REMOVE EXISTING DOWNSPOUTS, BOOTS AND GUTTERS IN THEIR ENTIRETY. SECTIONS OF EXG GUTTERS & DOWNSPOUTS
- DN-4 REMOVE EXG STUCCO, CUT OUT MORTAR AT 100% OF EXG BRICK CHIMNEY AND DRUM BASE. PREP FOR POINTING.
- REMOVAL OF VEGETATION, POISON AT THE ROOT. DO NOT
- EQUIPMENT & HARDWARE. SALVAGE FOR REINSTALLATION.
- DN-8 REMOVE EXG ROOF DRAIN. INTERNAL DRAIN LINE TO REMAIN.
- DN-9 REMOVE ABANDONED OVERFLOW SCUPPER, VERIFY LOCATION







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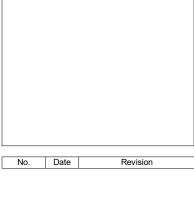
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ROOFING CONSULTANT: Steve McLaughlin 210 Garden Avenue Somerdale, NJ 08083 856 287 2424

Seal:



By: JS Checked: JGH Scale: AS NOTED Date: 04/15/2024

Drawing Title: DEMOLITION BASEMENT & ROOF PLAN

Drawing No.:

D2.0


REMOVE 100% EXISTING ASPHALT SHINGLE DOWN TO DECK. REF STRUCTURAL DWG, S1.0, FOR REPAIRS TO EXG WOOD DECK & FRAMING AS NOTED


REMOVE EXISTING DOWNSPOUTS, BOOTS AND GUTTERS IN THEIR ENTIRETY, TYP. SECTIONS OF EXG GUTTERS & DOWNSPOUTS ARE KNOWN TO BE MISSING -

**REMOVE 100% EXISTING ASPHALT** SHINGLE DOWN TO DECK. REF STRUCTURAL DWG, S1.0, FOR **REPAIRS TO EXG WOOD DECK &** FRAMING AS NOTED -

REMOVE EXISTING DOWNSPOUTS, BOOTS AND GUTTERS IN THEIR ENTIRETY, TYP. SECTIONS OF EXG GUTTERS & DOWNSPOUTS ARE KNOWN TO BE MISSING -

## 1 NORTH (REAR) ELEVATION D3.0 / 1/8" = 1'-0"

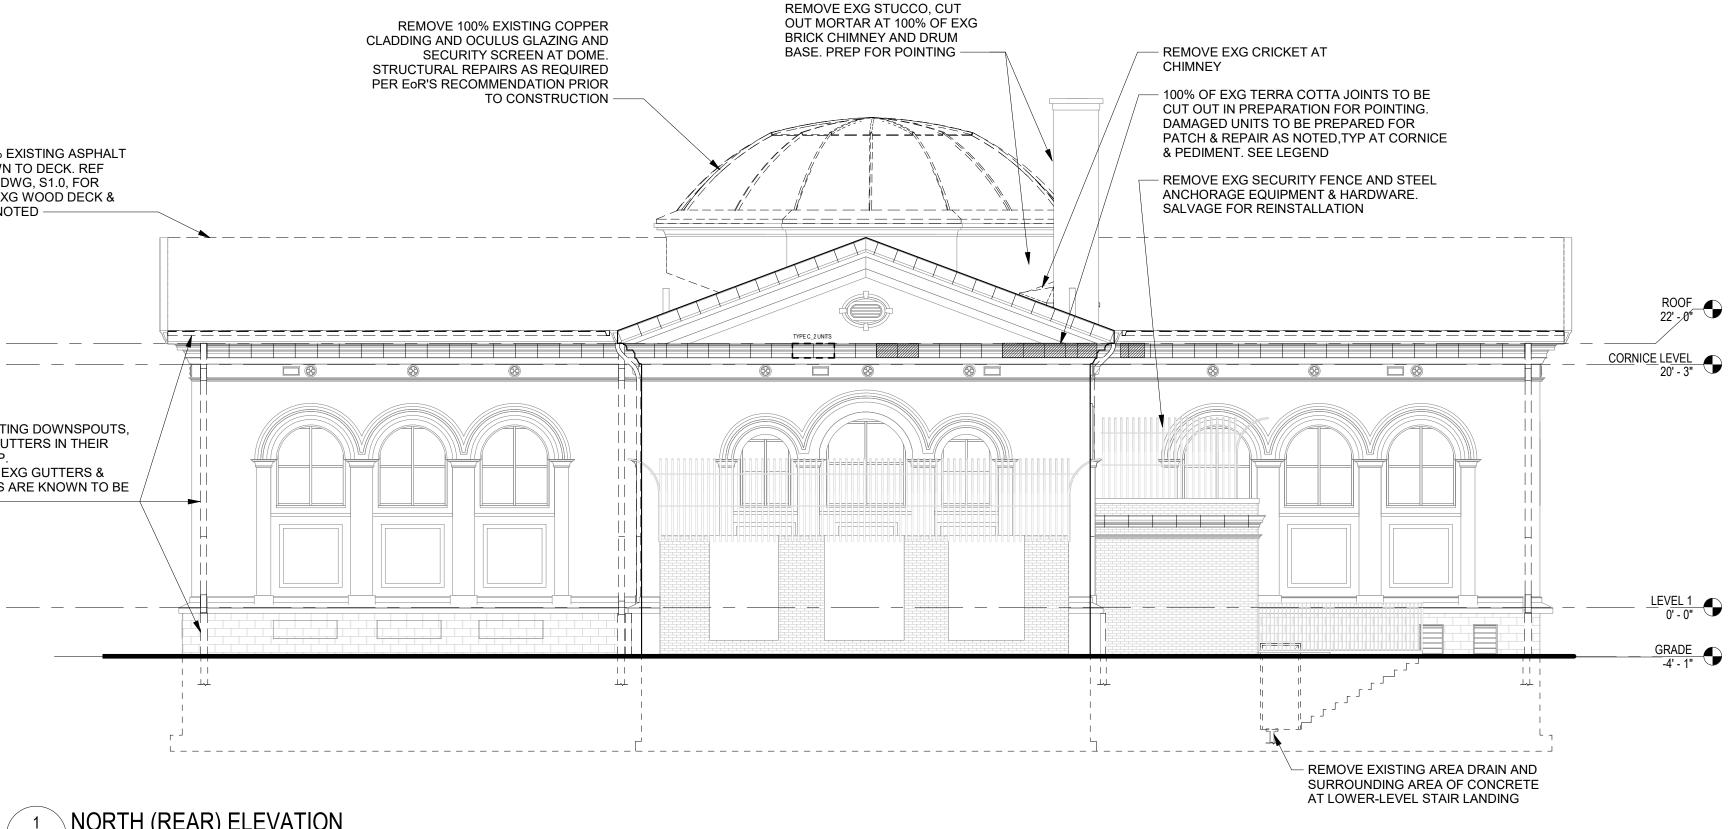

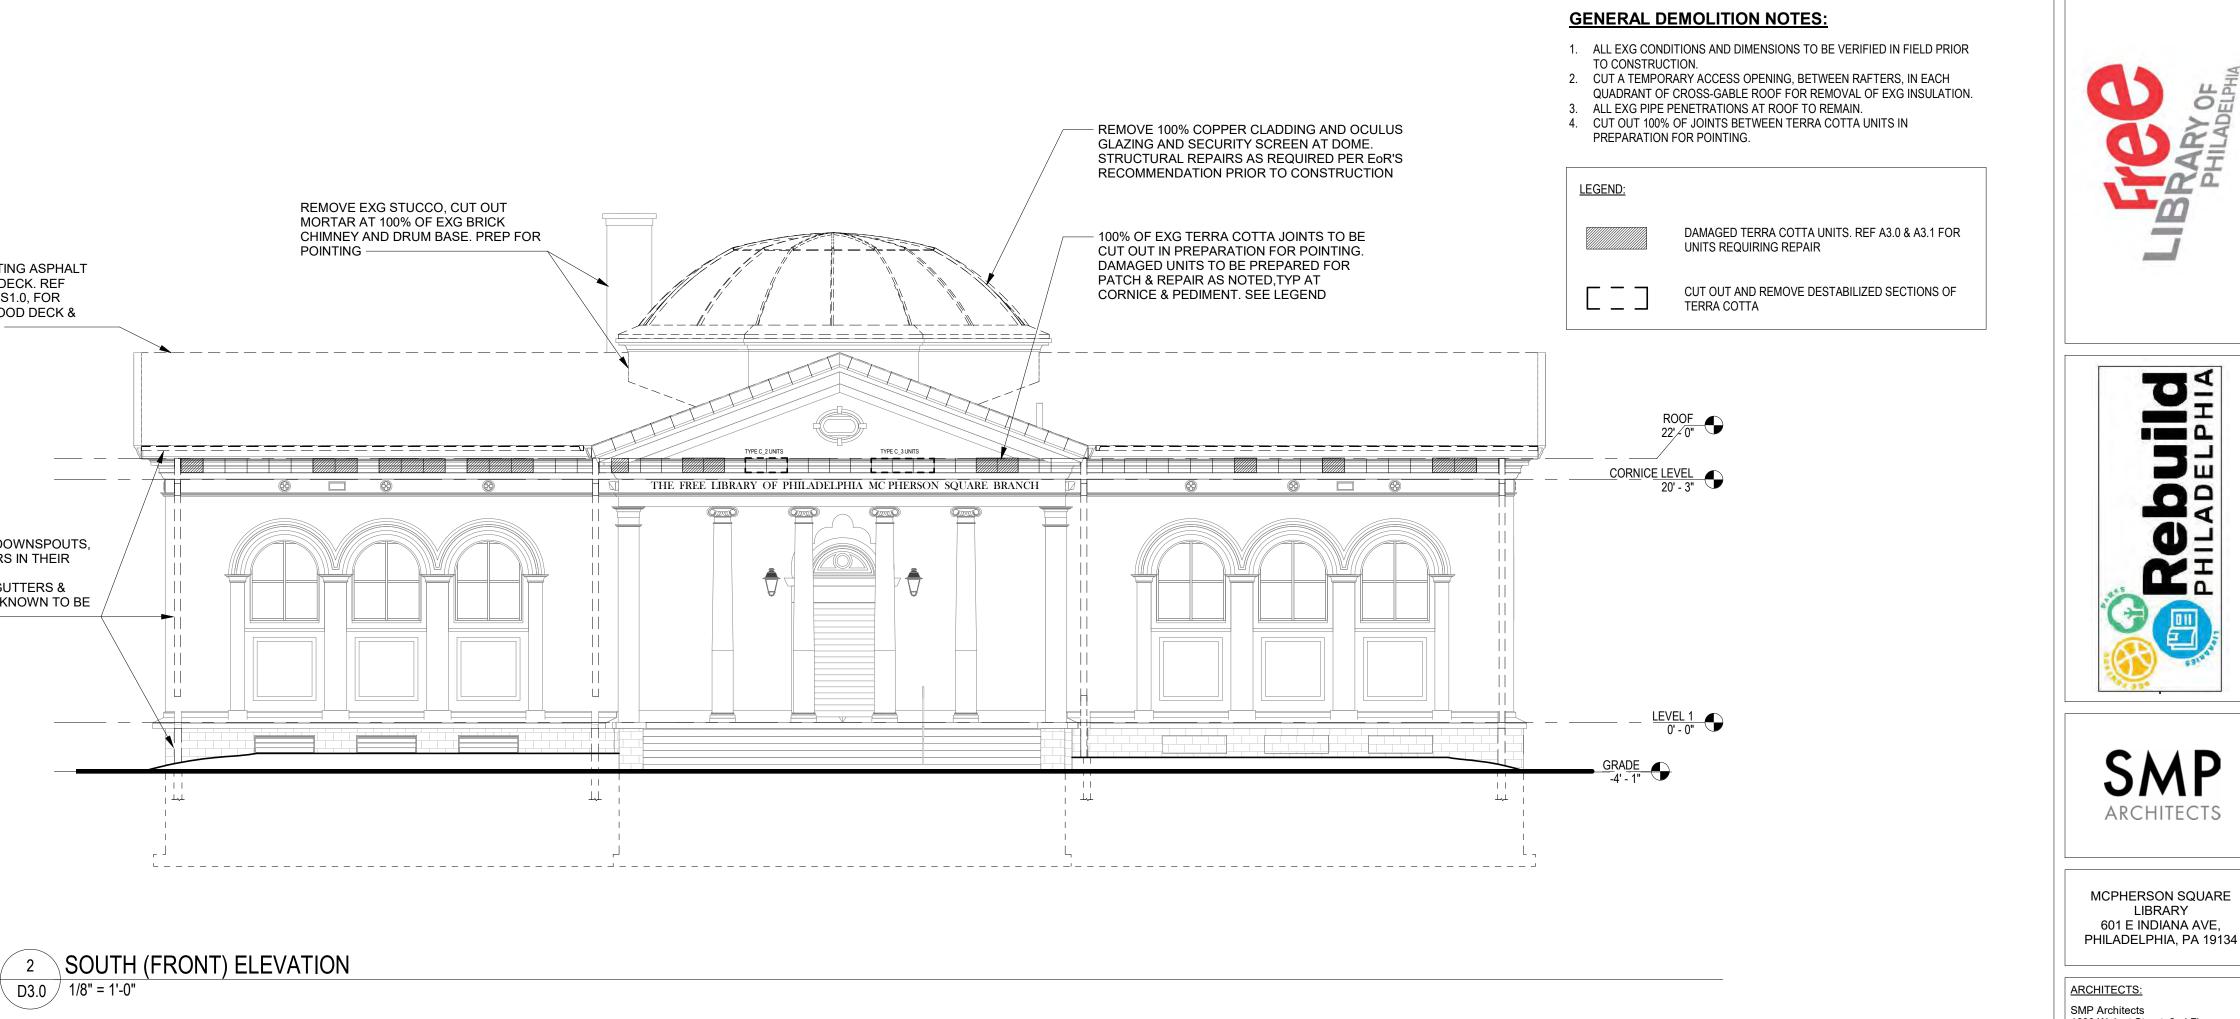

Seal: No. Date Revision By: JS Checked: JGH Scale: AS NOTED Date: 04/15/2024 Drawing Title: DEMOLITION EXTERIOR ELEVATIONS Drawing No.: D3.0

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KS Engineers 530 Walnut Street, Suite 460

STRUCTURAL ENGINEER:

ROOFING CONSULTANT:

100 E Lancaster Avenue, Suite 203 Wayne, PA 19087

Philadelphia, PA 19106

CIVIL ENGINEER:

215 616 3060

Ann Rothmann

610 688 2566


Steve McLaughlin

856 287 2424

210 Garden Avenue

Somerdale, NJ 08083

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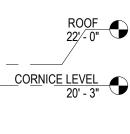
D3.1 / 1/8" = 1'-0"

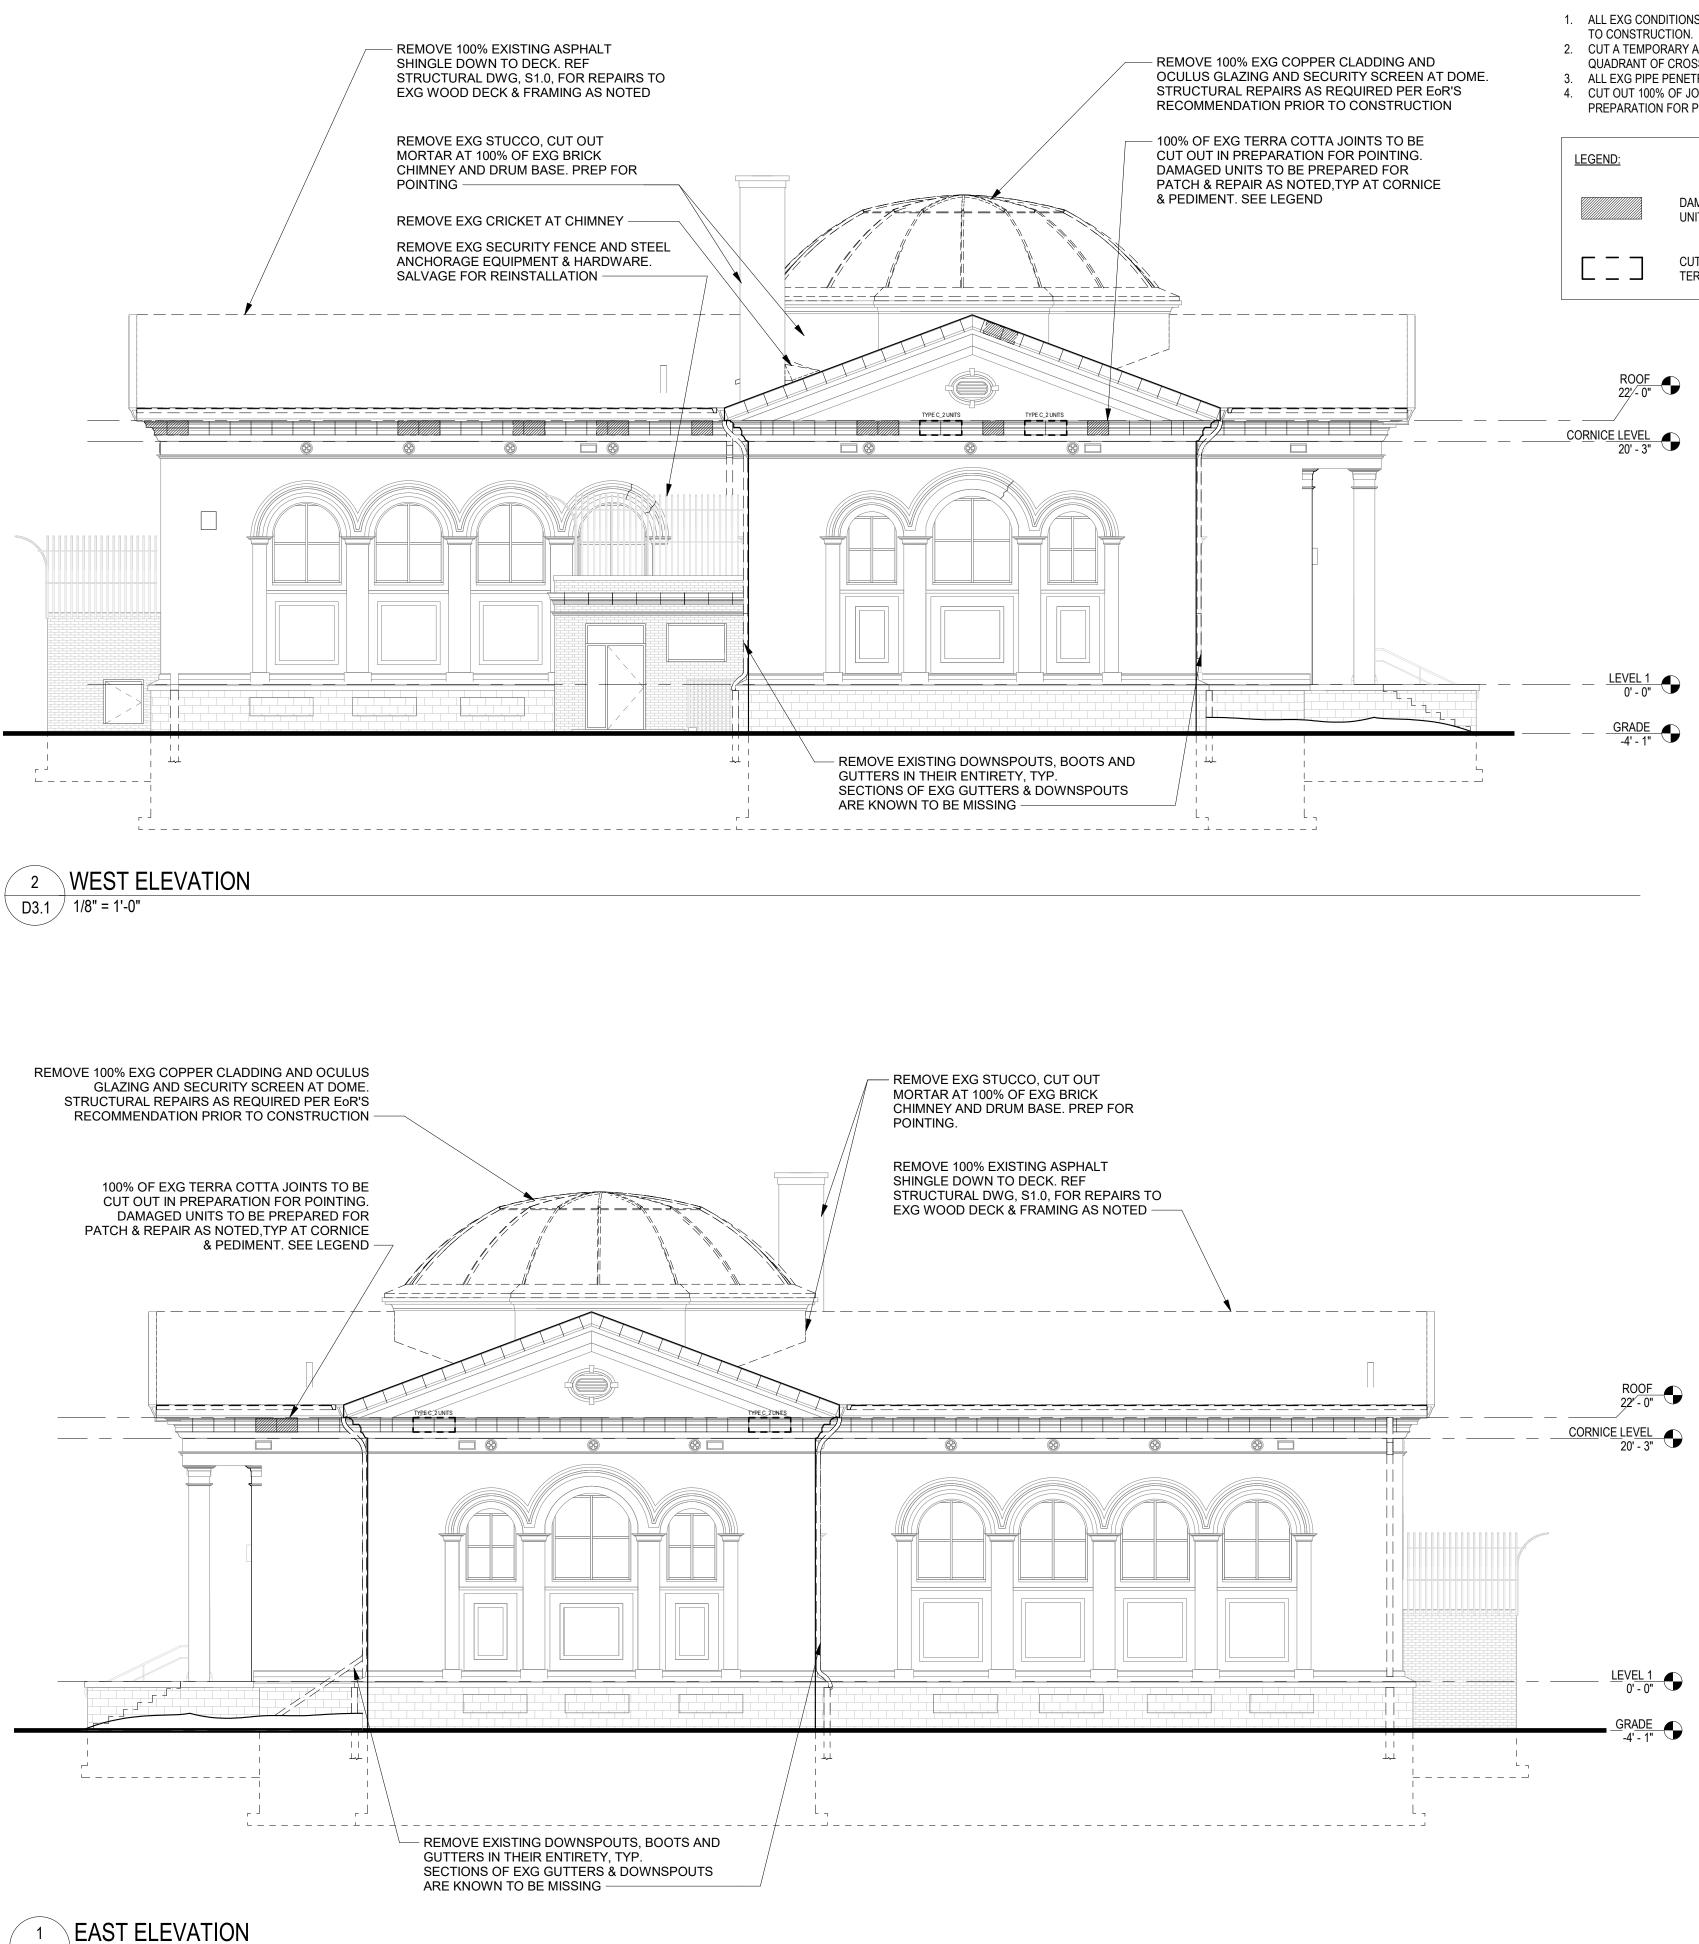
#### **GENERAL DEMOLITION NOTES:**

- 1. ALL EXG CONDITIONS AND DIMENSIONS TO BE VERIFIED IN FIELD PRIOR
- 2. CUT A TEMPORARY ACCESS OPENING, BETWEEN RAFTERS, IN EACH
- QUADRANT OF CROSS-GABLE ROOF FOR REMOVAL OF EXG INSULATION. 3. ALL EXG PIPE PENETRATIONS AT ROOF TO REMAIN. 4. CUT OUT 100% OF JOINTS BETWEEN TERRA COTTA UNITS IN
- PREPARATION FOR POINTING.



- CUT OUT AND REMOVE DESTABILIZED SECTIONS OF TERRA COTTA



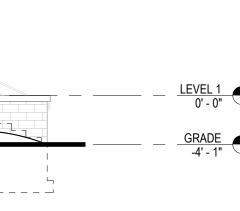







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Seal:


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By: JS Checked: JGH Scale: AS NOTED Date: 04/15/2024

Drawing Title: DEMOLITION EXTERIOR ELEVATIONS

Drawing No.:

D3.1



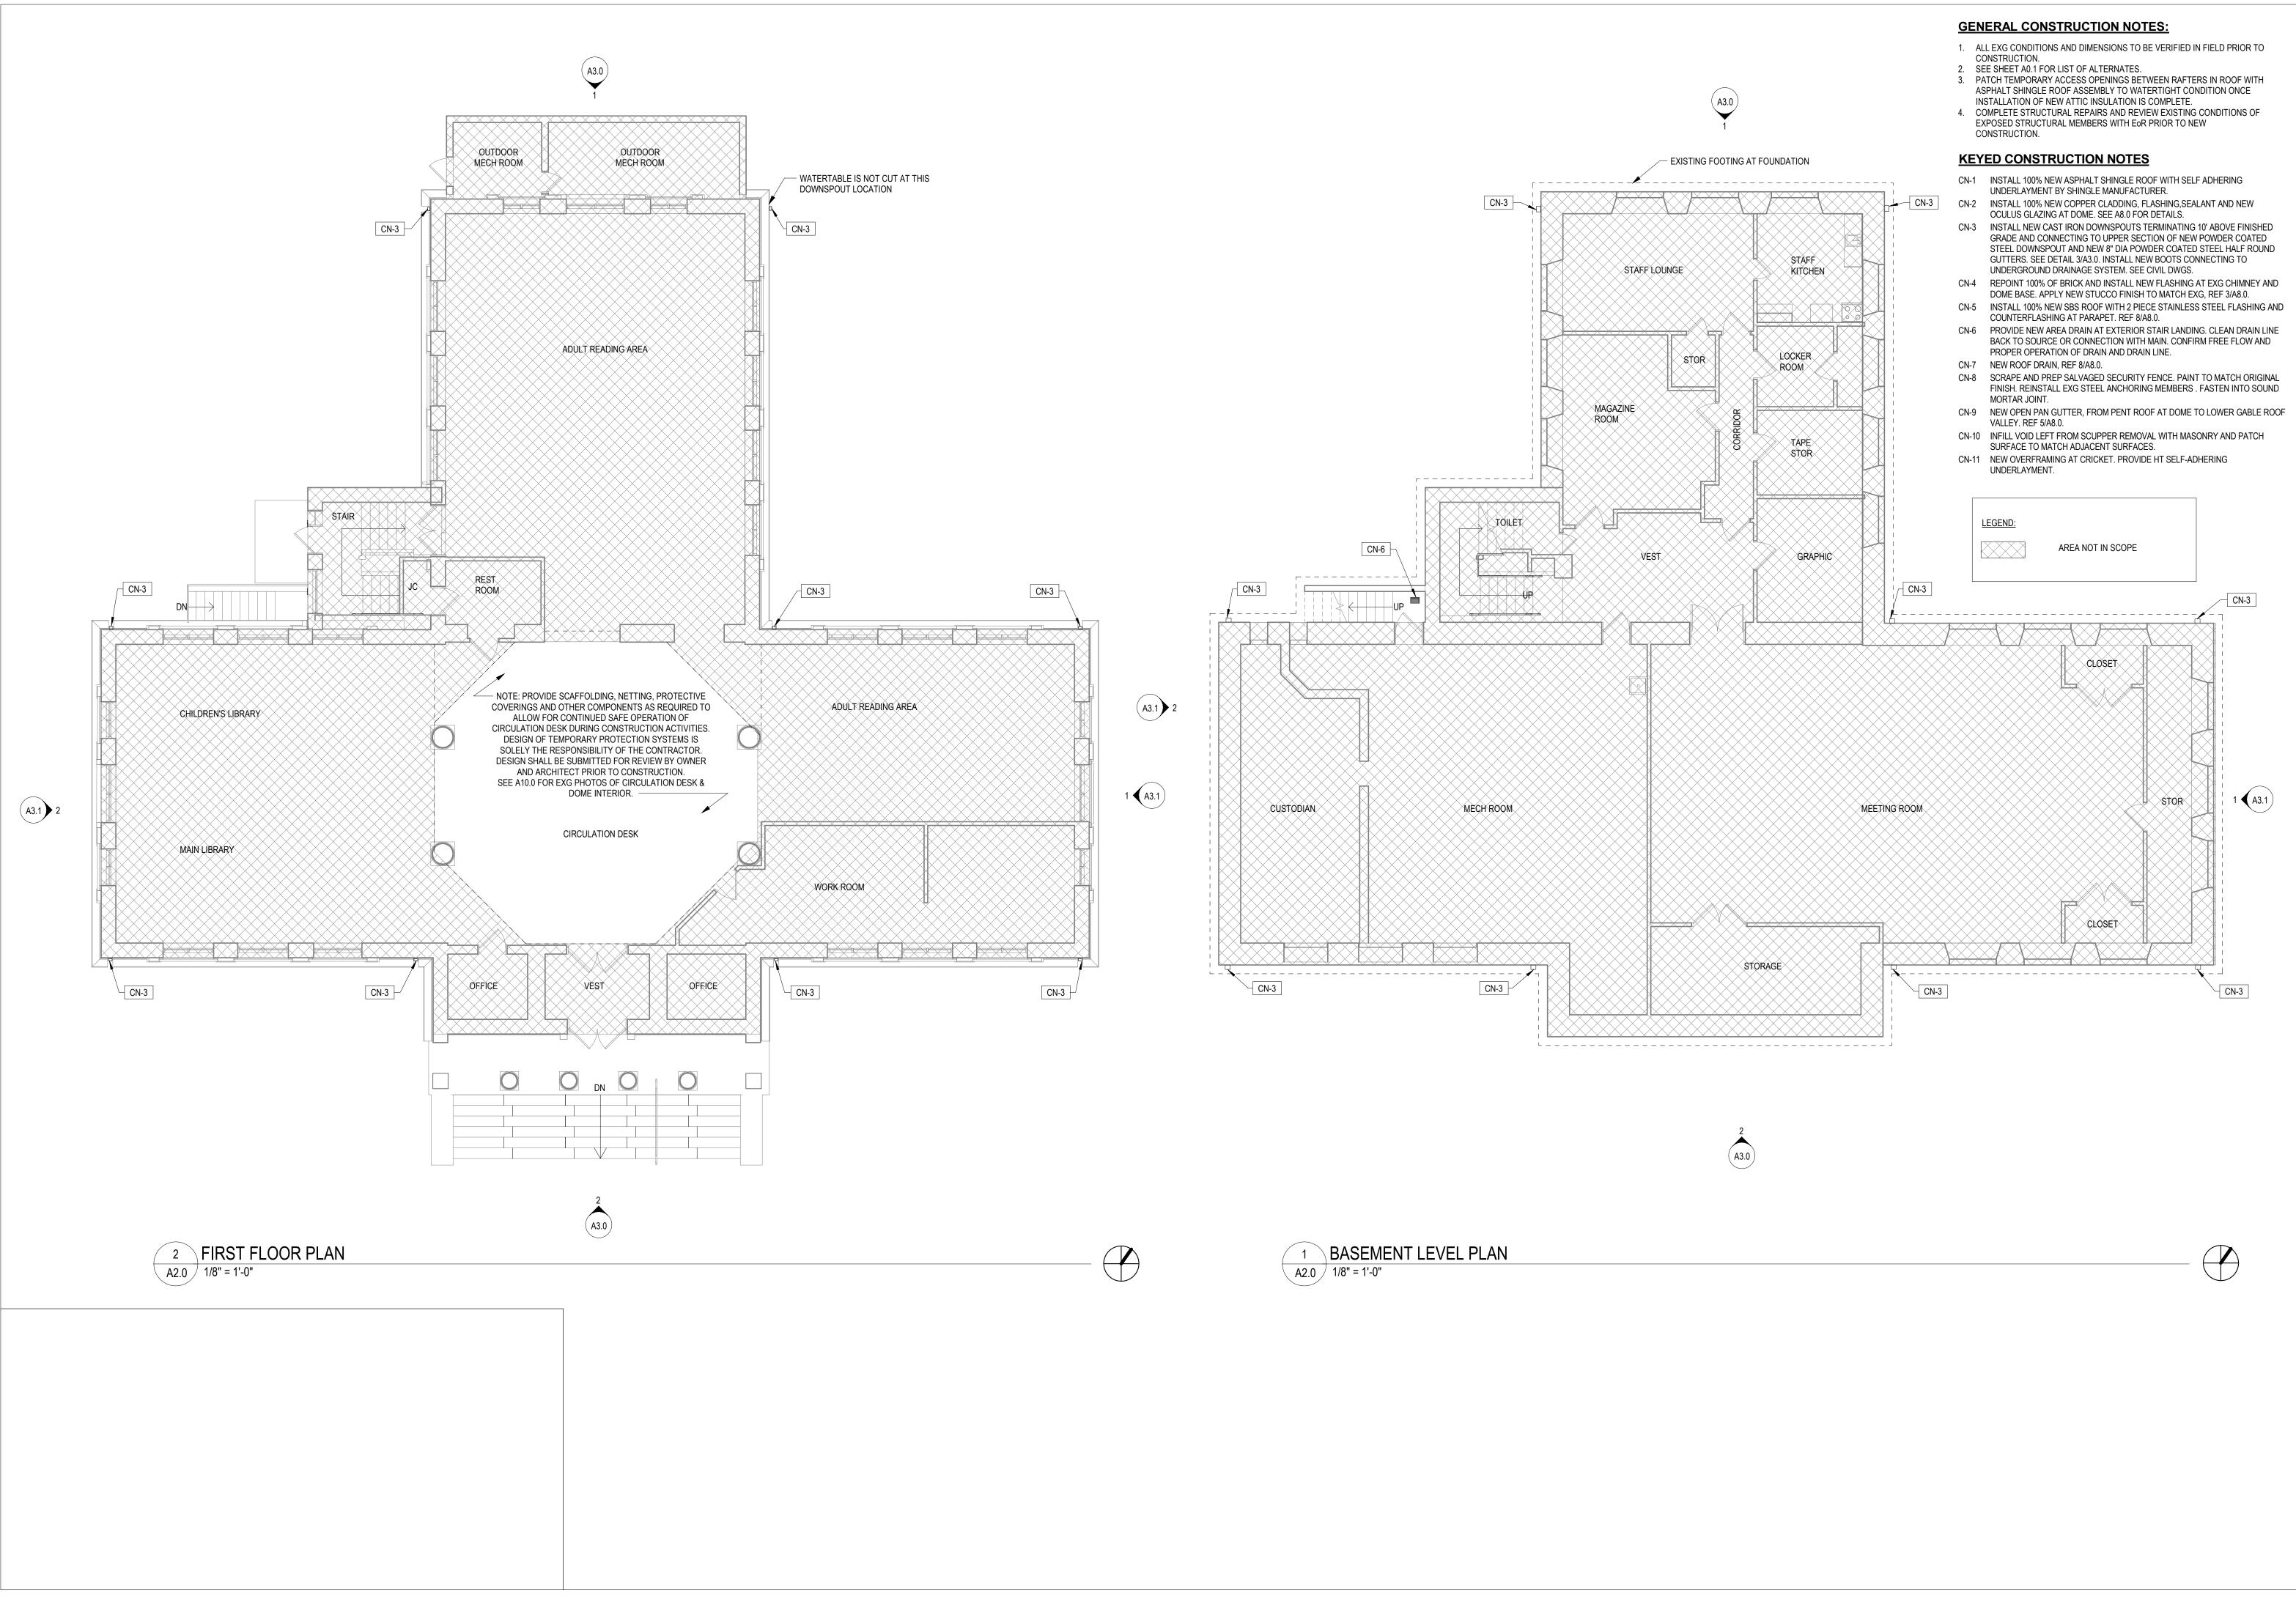



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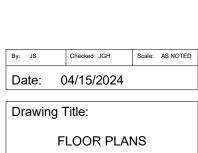
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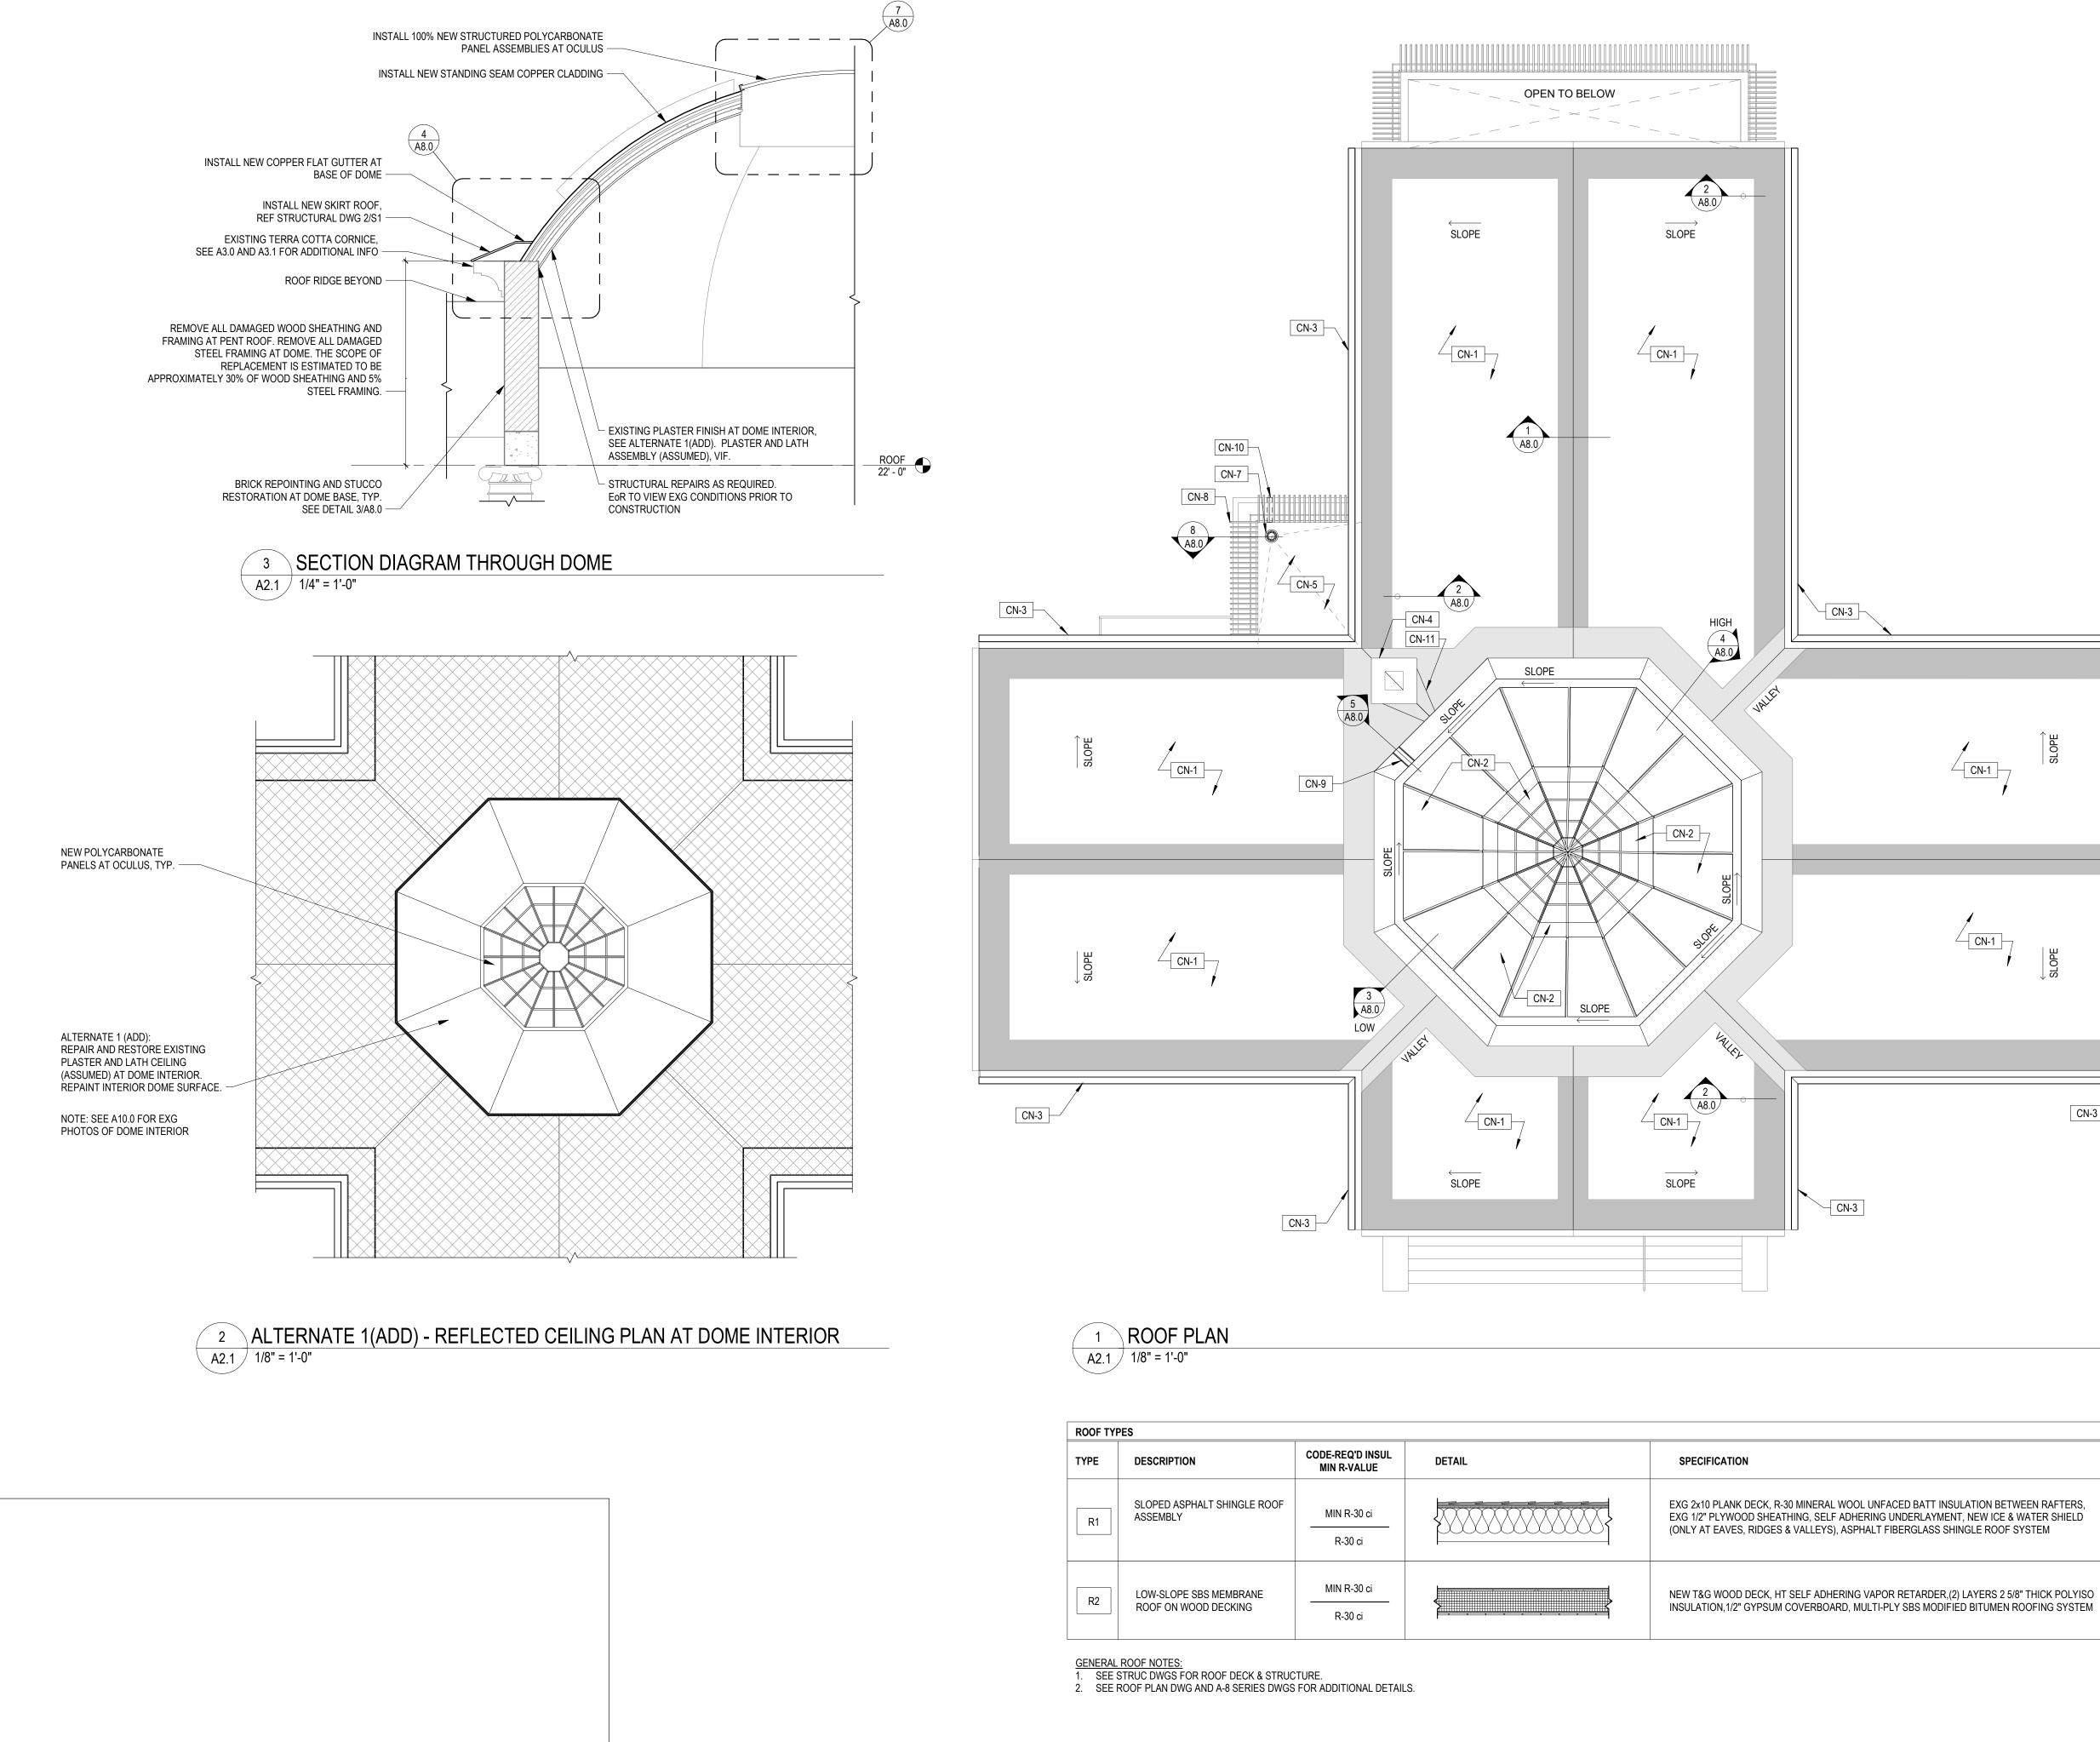
Seal:



No. Date Revision

Drawing No.:

A2.0



#### **GENERAL CONSTRUCTION NOTES:**

- 1. ALL EXG CONDITIONS AND DIMENSIONS TO BE VERIFIED IN FIELD PRIOR TO CONSTRUCTION.
- 2. SEE SHEET A0.1 FOR LIST OF ALTERNATES.
- 3. PATCH TEMPORARY ACCESS OPENINGS BETWEEN RAFTERS IN ROOF WITH
- ASPHALT SHINGLE ROOF ASSEMBLY TO WATERTIGHT CONDITION ONCE INSTALLATION OF NEW ATTIC INSULATION IS COMPLETE. 4. COMPLETE STRUCTURAL REPAIRS AND REVIEW EXISTING CONDITIONS OF EXPOSED STRUCTURAL MEMBERS WITH EOR PRIOR TO NEW CONSTRUCTION.

#### **GENERAL ROOF NOTES:**


- 1. REFER TO STRUCTURAL DRAWINGS FOR INFORMATION ABOUT WOOD FRAMING REPLACEMENTS.
- ALL METAL FLASHINGS TO BE ZT COPPER. INSTALL R-30 MINERAL WOOL UNFACED BATT INSULATION BETWEEN RAFTERS. UTILIZE OPENING CUT IN EACH QUADRANT OF CROSS-GABLE ROOF FOR ACCESS TO ATTIC SPACE. SEE GENERAL CONSTRUCTION NOTE 3.

#### KEYED CONSTRUCTION NOTES

- CN-1 INSTALL 100% NEW ASPHALT SHINGLE ROOF WITH SELF ADHERING
- UNDERLAYMENT BY SHINGLE MANUFACTURER. CN-2 INSTALL 100% NEW COPPER CLADDING, FLASHING, SEALANT AND NEW
- OCULUS GLAZING AT DOME. SEE A8.0 FOR DETAILS. CN-3 INSTALL NEW CAST IRON DOWNSPOUTS TERMINATING 10' ABOVE FINISHED GRADE AND CONNECTING TO UPPER SECTION OF NEW POWDER COATED STEEL DOWNSPOUT AND NEW 8" DIA POWDER COATED STEEL HALF ROUND GUTTERS. SEE DETAIL 3/A3.0. INSTALL NEW BOOTS CONNECTING TO
- UNDERGROUND DRAINAGE SYSTEM. SEE CIVIL DWGS. CN-4 REPOINT 100% OF BRICK AND INSTALL NEW FLASHING AT EXG CHIMNEY AND
- DOME BASE. APPLY NEW STUCCO FINISH TO MATCH EXG, REF 3/A8.0.
- CN-5 INSTALL 100% NEW SBS ROOF WITH 2 PIECE STAINLESS STEEL FLASHING AND COUNTERFLASHING AT PARAPET. REF 8/A8.0.
- CN-6 PROVIDE NEW AREA DRAIN AT EXTERIOR STAIR LANDING. CLEAN DRAIN LINE BACK TO SOURCE OR CONNECTION WITH MAIN. CONFIRM FREE FLOW AND PROPER OPERATION OF DRAIN AND DRAIN LINE.
- CN-7 NEW ROOF DRAIN, REF 8/A8.0. CN-8 SCRAPE AND PREP SALVAGED SECURITY FENCE. PAINT TO MATCH ORIGINAL FINISH. REINSTALL EXG STEEL ANCHORING MEMBERS . FASTEN INTO SOUND MORTAR JOINT.
- CN-9 NEW OPEN PAN GUTTER, FROM PENT ROOF AT DOME TO LOWER GABLE ROOF VALLEY. REF 5/A8.0. CN-10 INFILL VOID LEFT FROM SCUPPER REMOVAL WITH MASONRY AND PATCH
- SURFACE TO MATCH ADJACENT SURFACES. CN-11 NEW OVERFRAMING AT CRICKET. PROVIDE HT SELF-ADHERING

UNDERLAYMENT.

LEGEND: AREA NOT IN SCOPE BRICK ICE & WATER SHIELD (INSTALL PER MFR INSTRUCTIONS) UNDERLAYMENT HT (BY SHINGLE MFR)

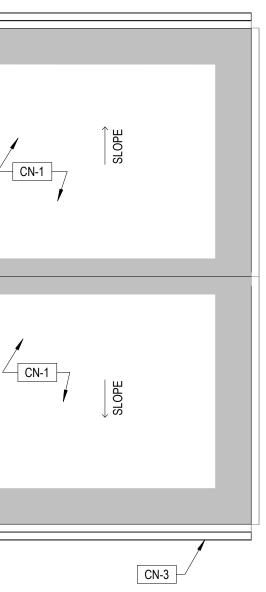









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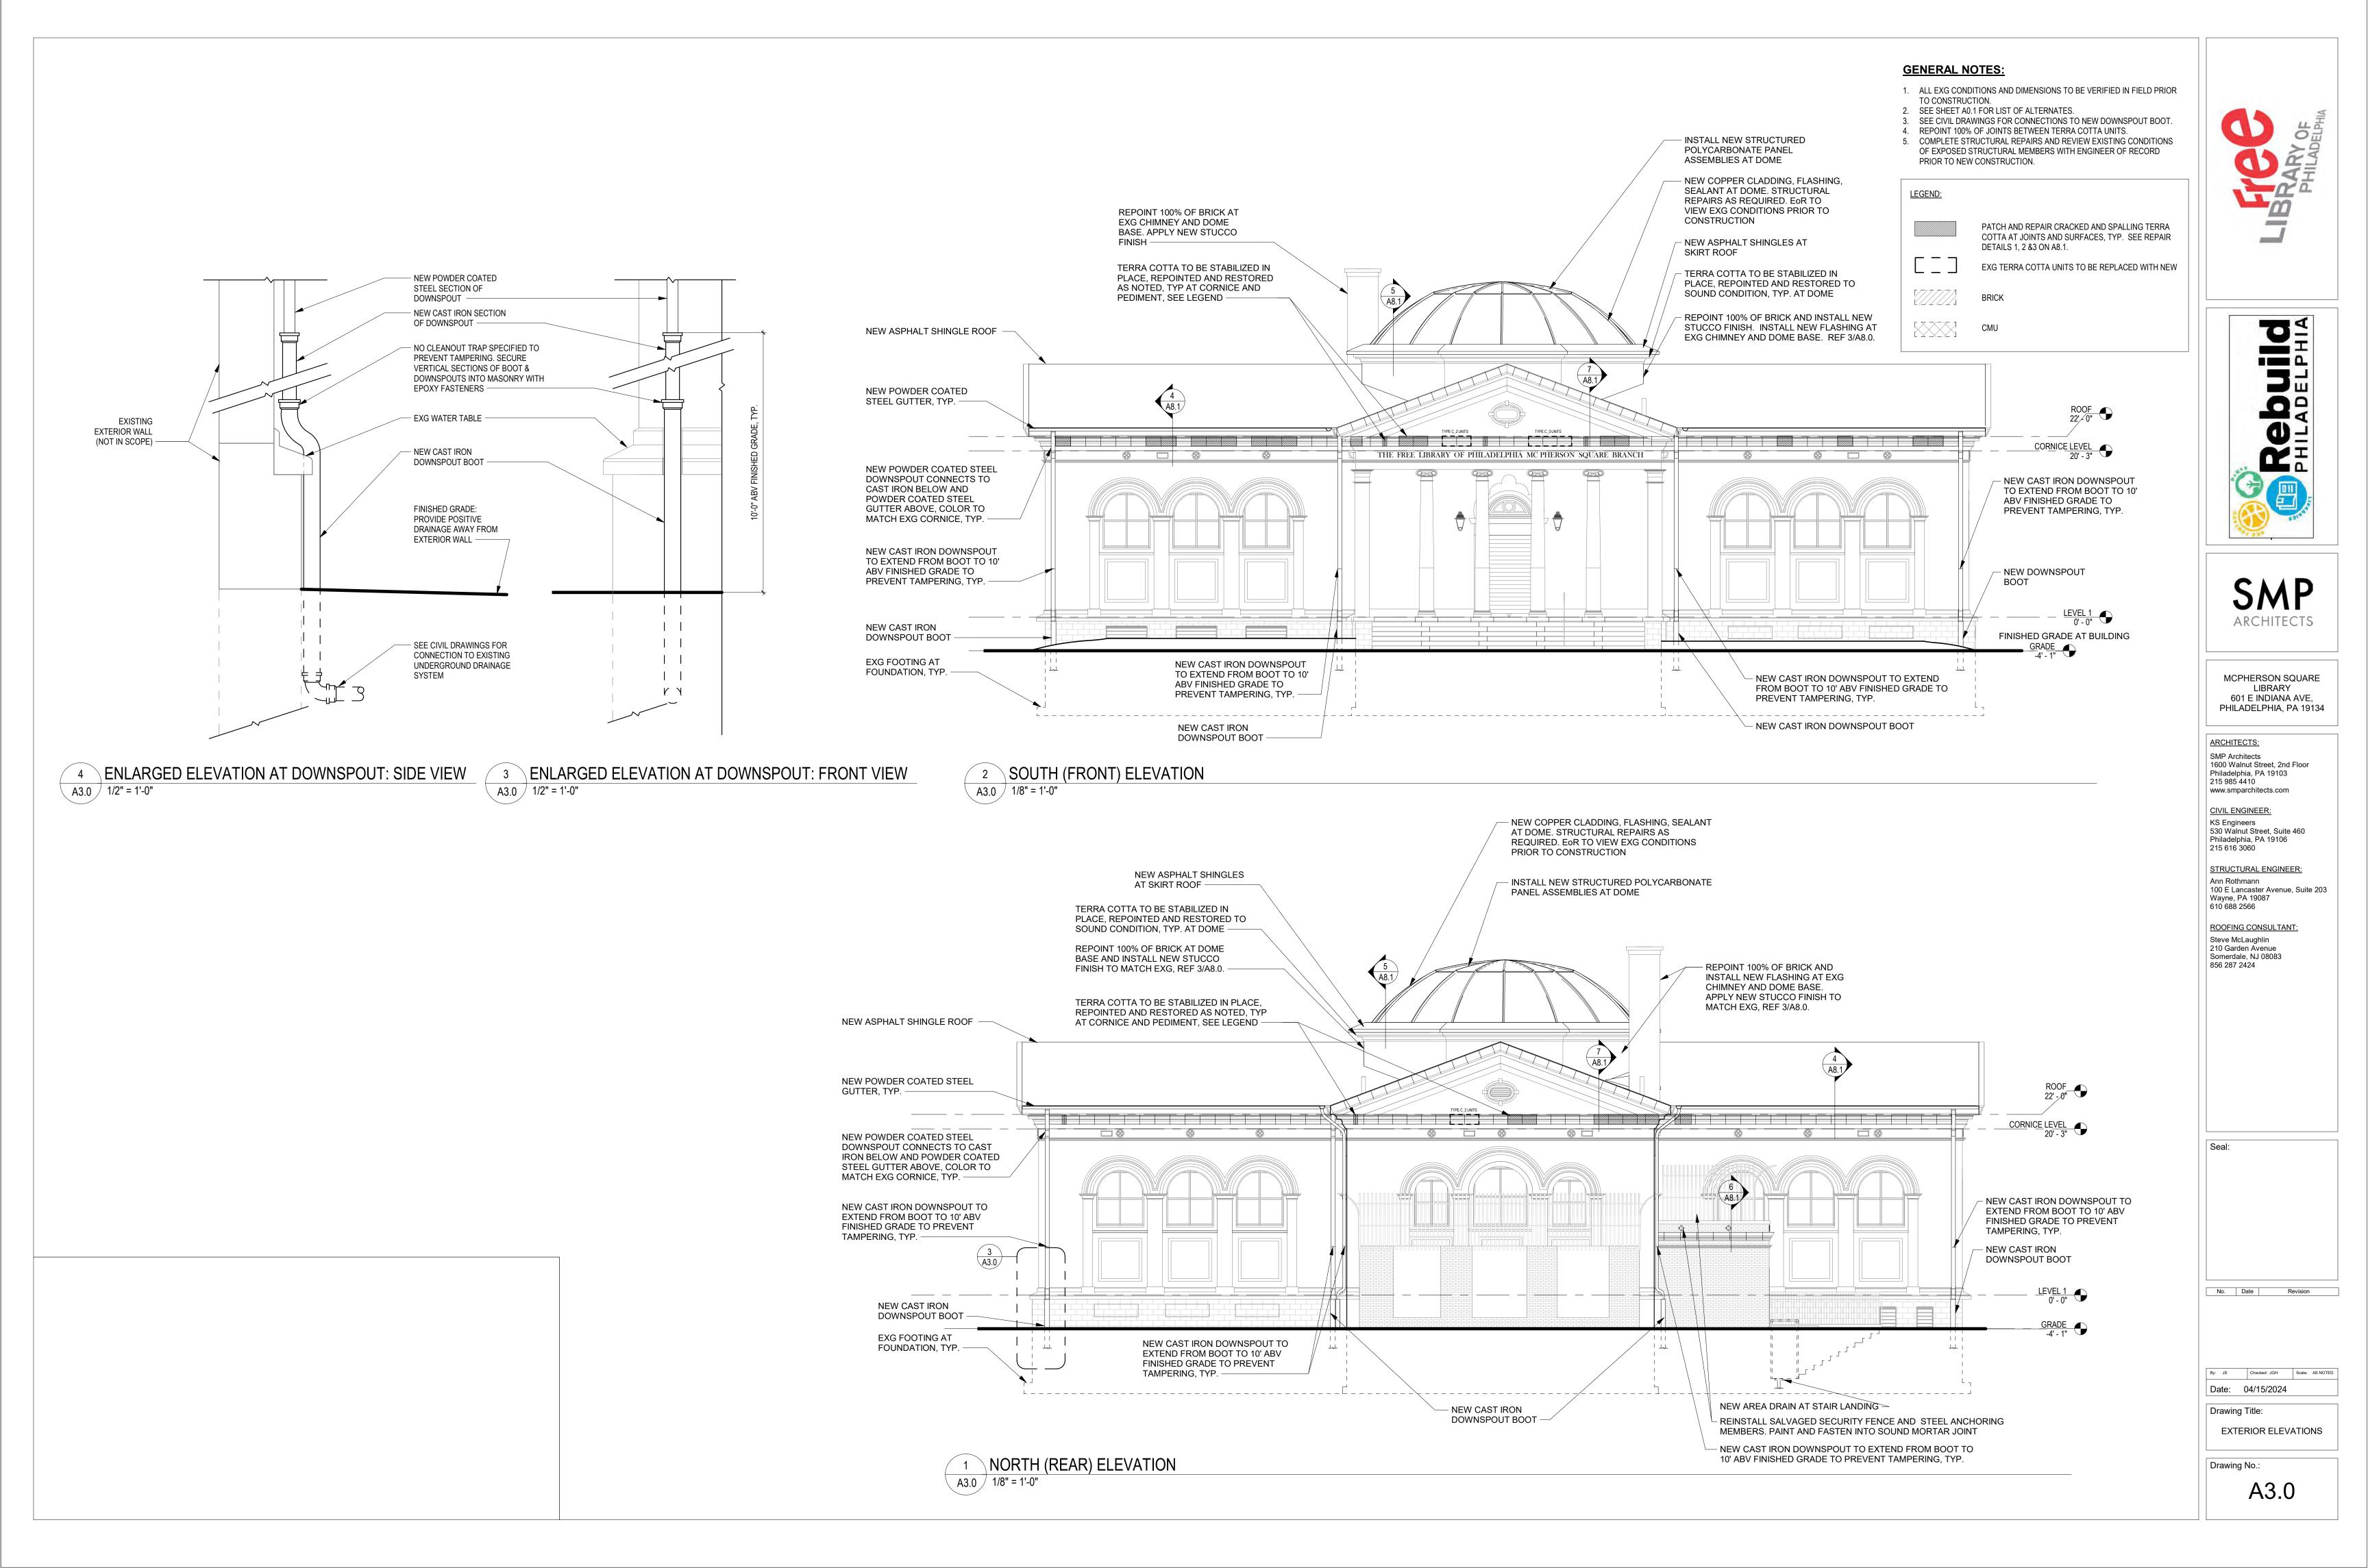
By: JS Checked: JGH Scale: AS NOTED Date: 04/15/2024

ROOF PLAN

Drawing Title:

Drawing No.:

A2.1



NEW ASPHALT SHINGLE ROOF -

NEW POWDER COATED STEEL GUTTER, TYP.

NEW POWDER COATED STEEL DOWNSPOUT CONNECTS TO CAST IRON BELOW AND POWDER COATED STEEL GUTTER ABOVE, COLOR TO MATCH EXG CORNICE, TYP. -

NEW CAST IRON DOWNSPOUT TO EXTEND FROM BOOT TO 10' ABV FINISHED GRADE TO PREVENT TAMPERING, TYP.


NEW CAST IRON DOWNSPOUT BOOT, TYP


EXG FOOTING AT FOUNDATION, TYP.

> 2 A3.1 1/8" = 1'-0"

NEW ASPHALT SHINGLE ROOF

EXG FOOTING AT FOUNDATION, TYP. -

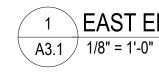

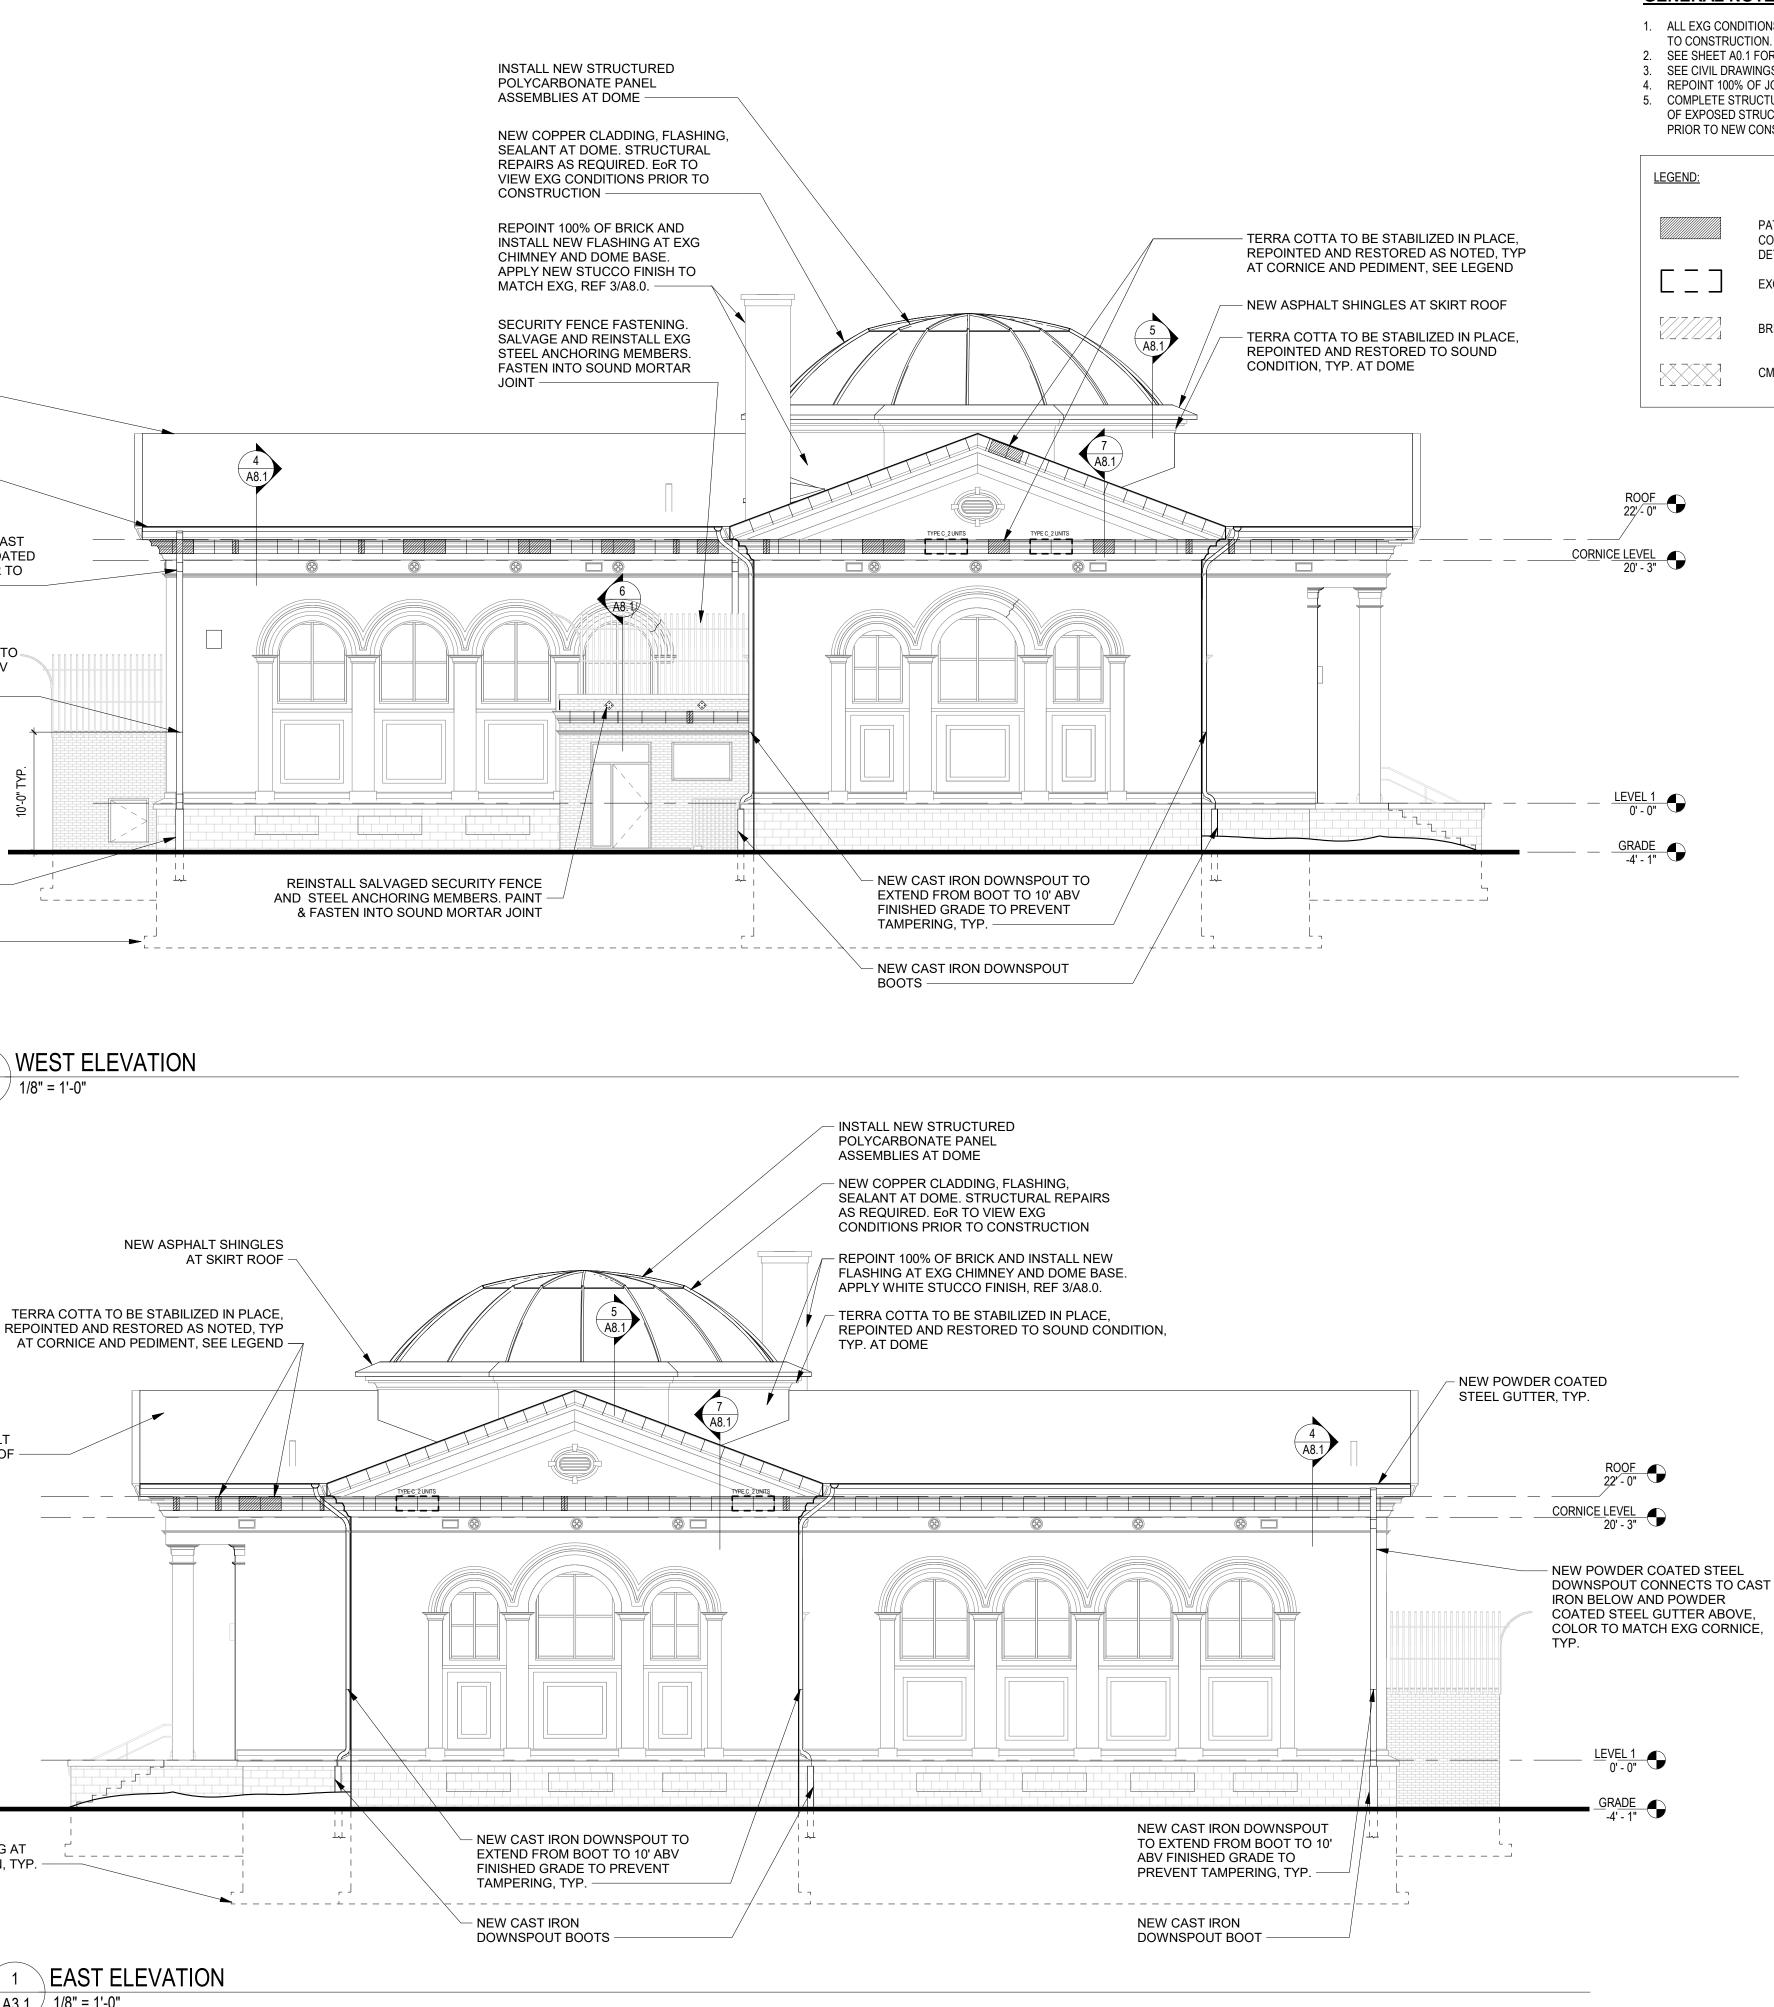


### **GENERAL NOTES:**

- 1. ALL EXG CONDITIONS AND DIMENSIONS TO BE VERIFIED IN FIELD PRIOR TO CONSTRUCTION.
- 2. SEE SHEET A0.1 FOR LIST OF ALTERNATES. 3. SEE CIVIL DRAWINGS FOR CONNECTIONS TO NEW DOWNSPOUT BOOT.

BRICK

CMU

- 4. REPOINT 100% OF JOINTS BETWEEN TERRA COTTA UNITS. 5. COMPLETE STRUCTURAL REPAIRS AND REVIEW EXISTING CONDITIONS
- OF EXPOSED STRUCTURAL MEMBERS WITH ENGINEER OF RECORD PRIOR TO NEW CONSTRUCTION.

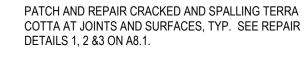

EXG TERRA COTTA UNITS TO BE REPLACED WITH NEW





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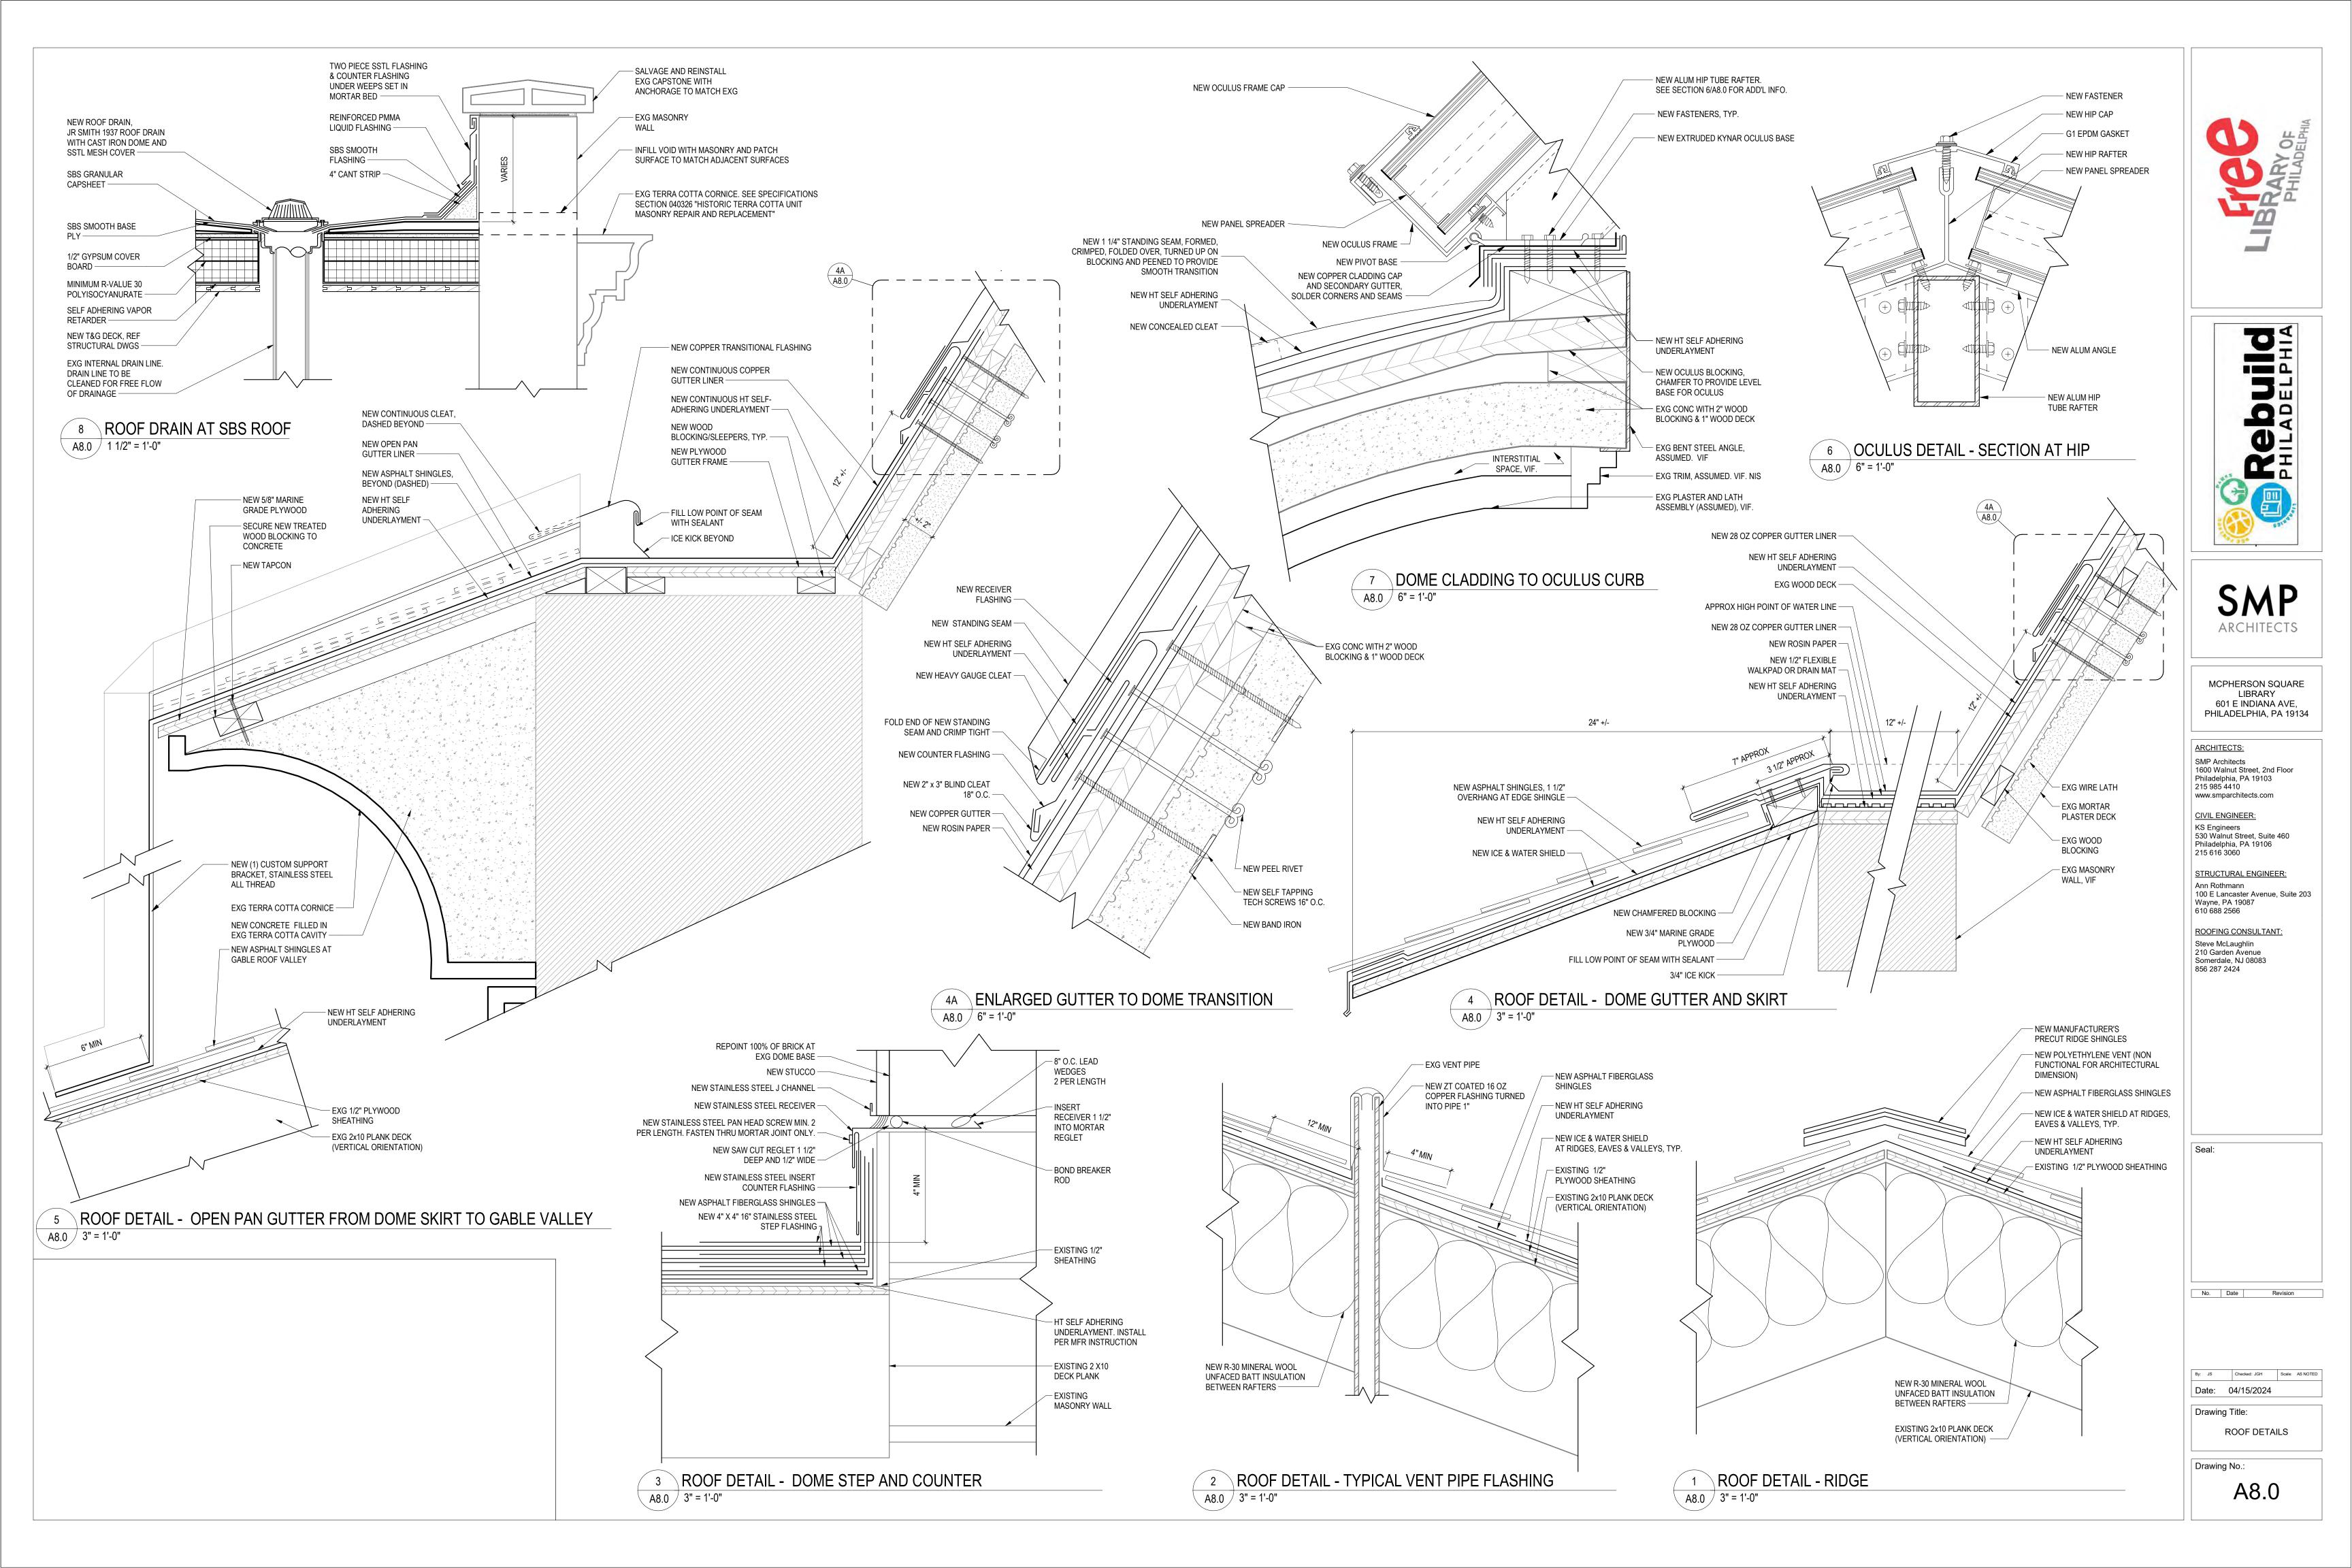
By: JS Checked: JGH Scale: AS NOTED Date: 04/15/2024


Drawing Title:

EXTERIOR ELEVATIONS


Drawing No.:

A3.1




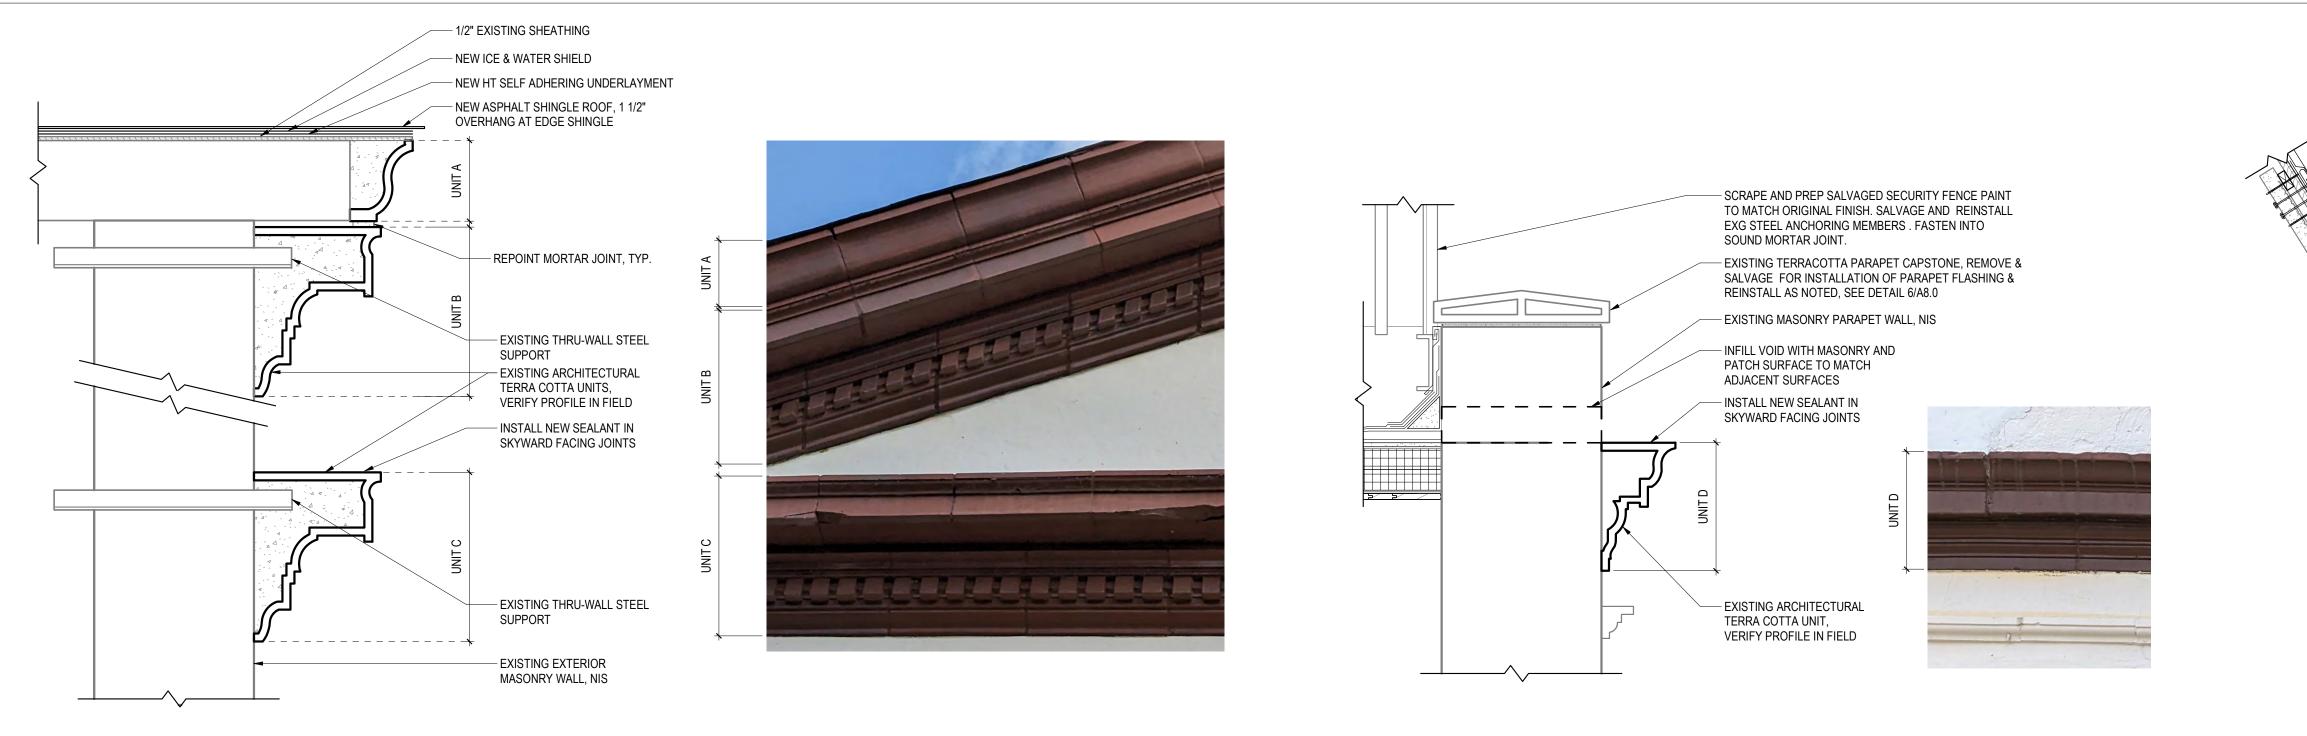


TERRA COTTA DETAIL - CORNICE AT RAKE AND PEDIMENT 7 A8.1 1" = 1'-0"

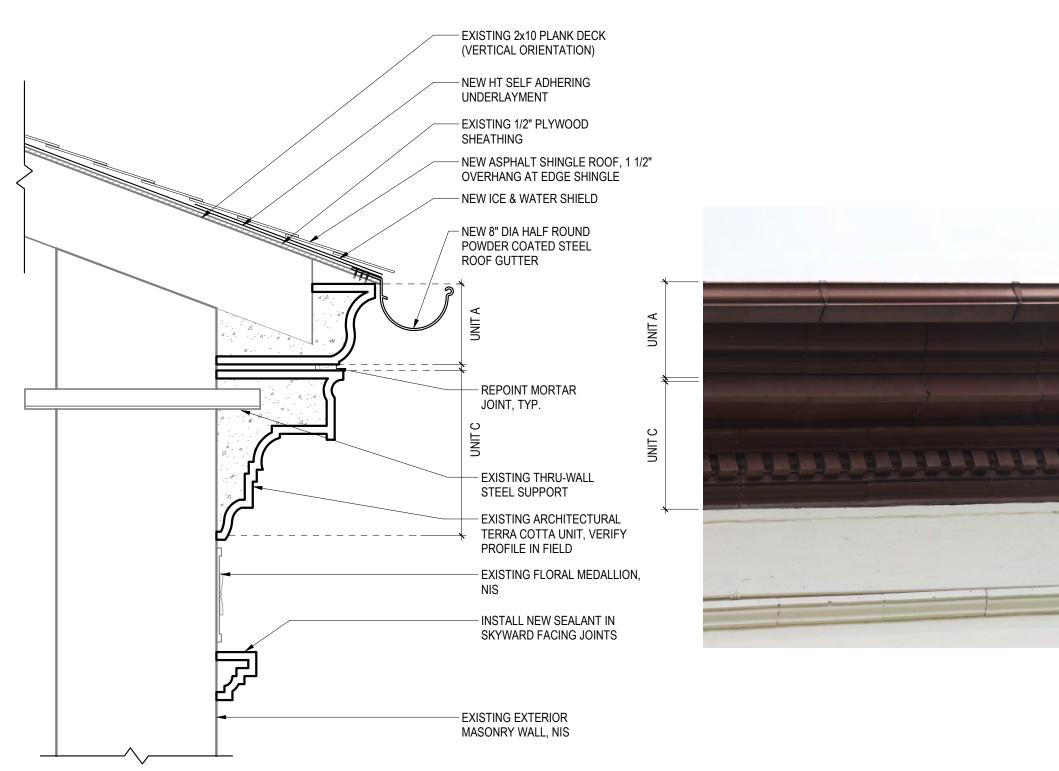

TERRA COTTA DETAIL - CORNICE AT EAVE 4 A8.1 1" = 1'-0"

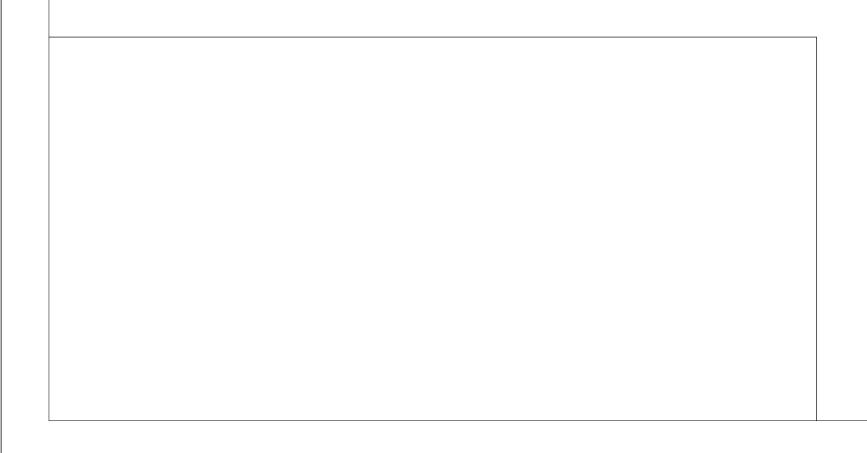




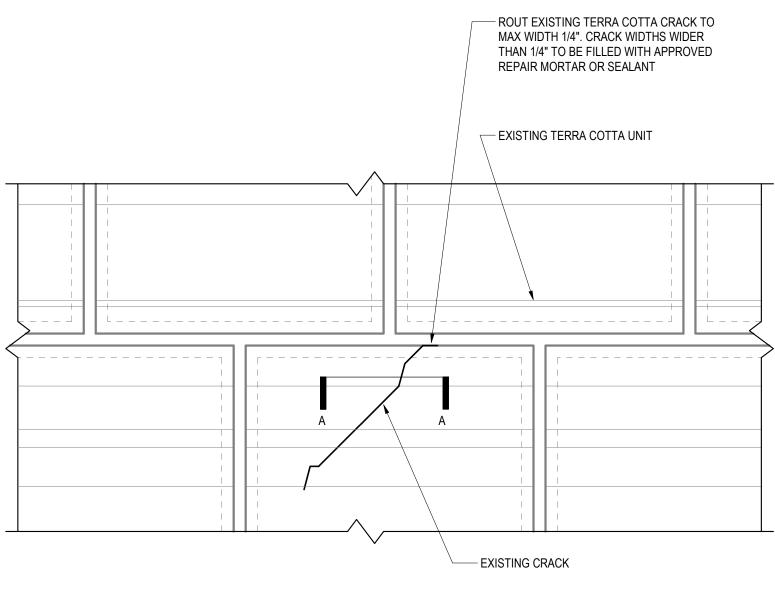

ELEVATION

CORNICE DETAIL TYPICAL - ROUT AND SEAL CRACKED UNITS 3 A8.1 / 1 1/2" = 1'-0"

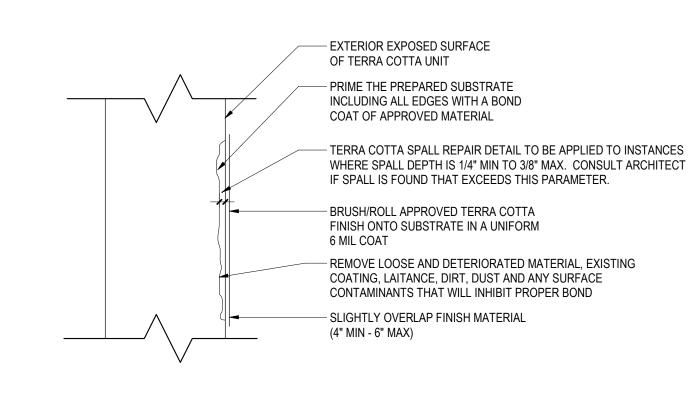





6 TERRA COTTA DETAIL - CORNICE AT SBS ROOF


A8.1 / 1" = 1'-0"

<sup>2</sup> CORNICE DETAIL TYPICAL - GLAZE SPALLS A8.1 6" = 1'-0"

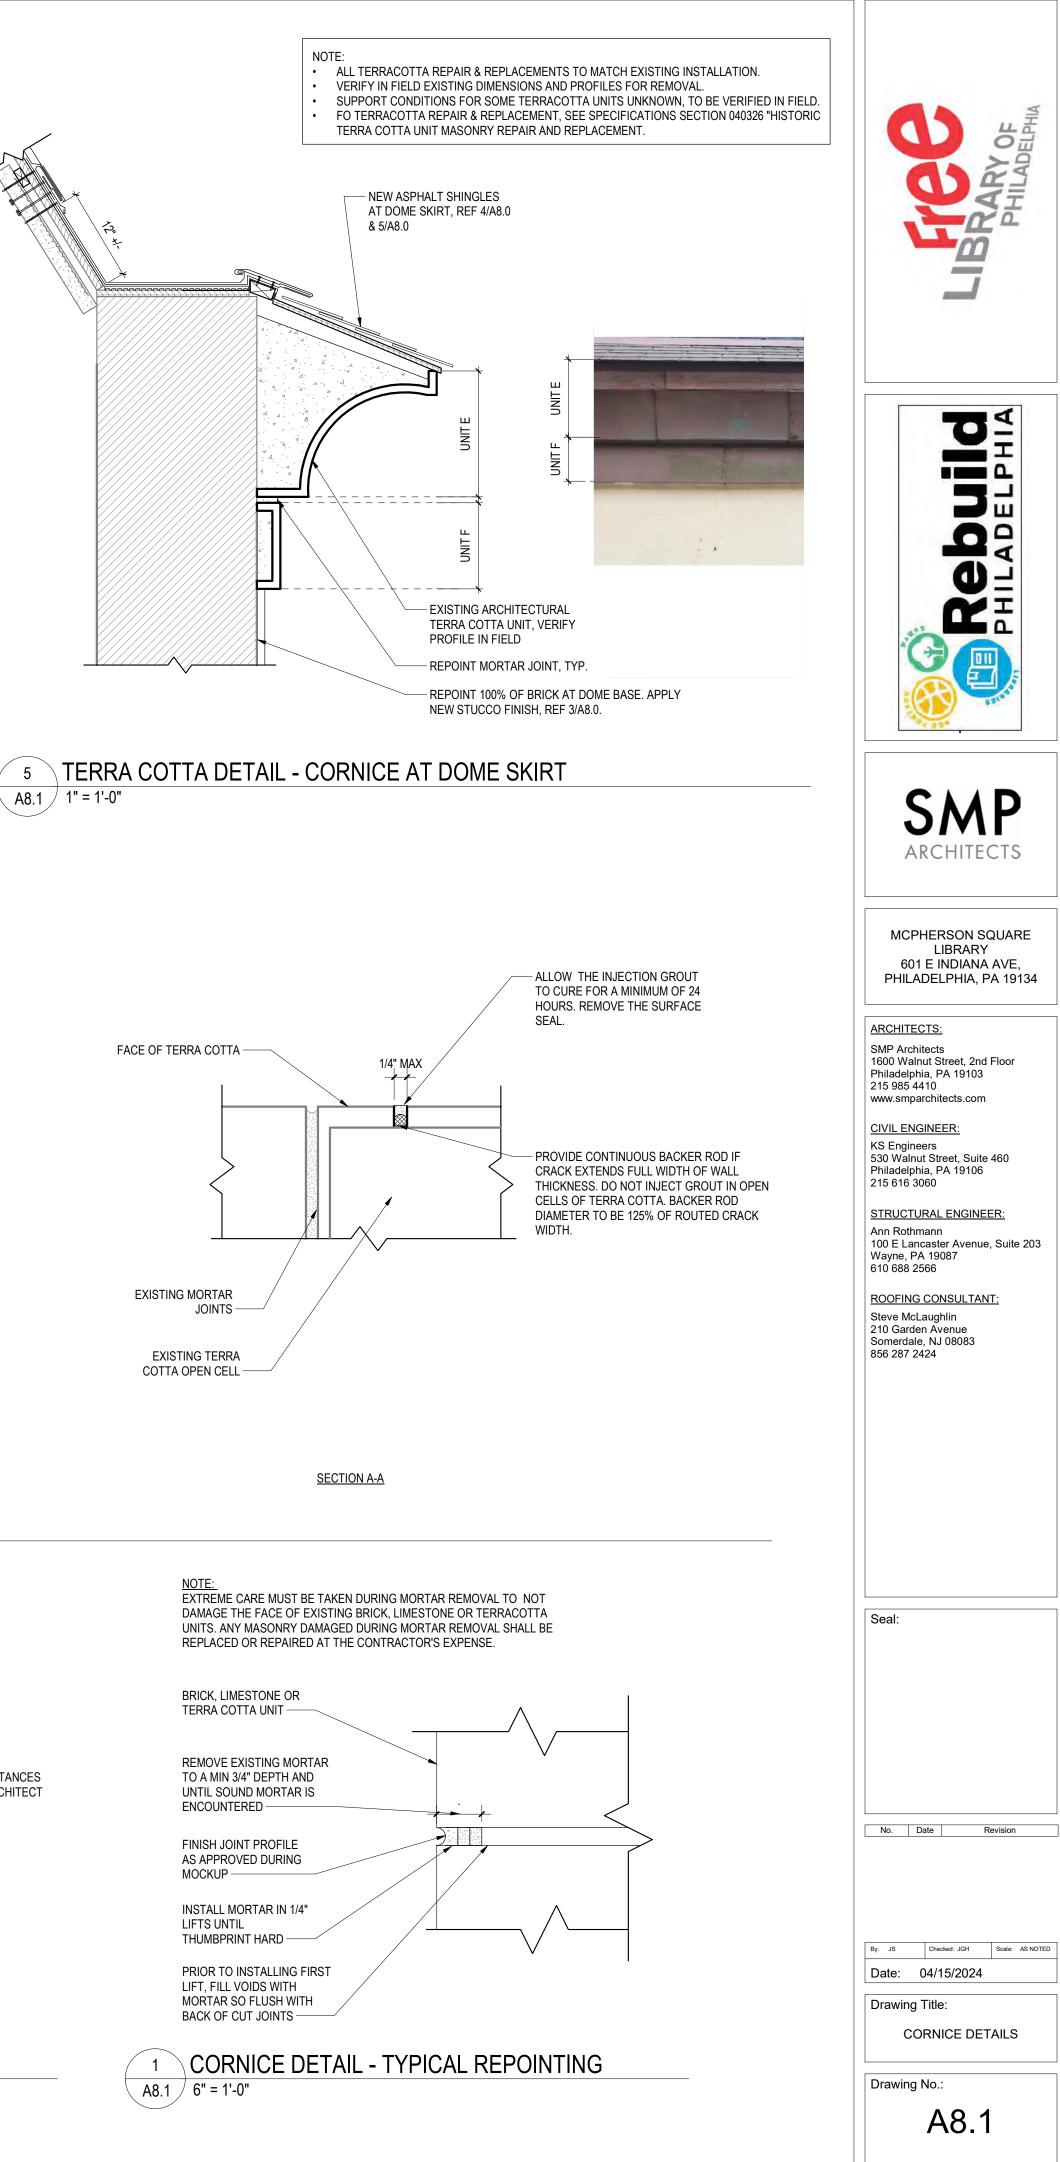

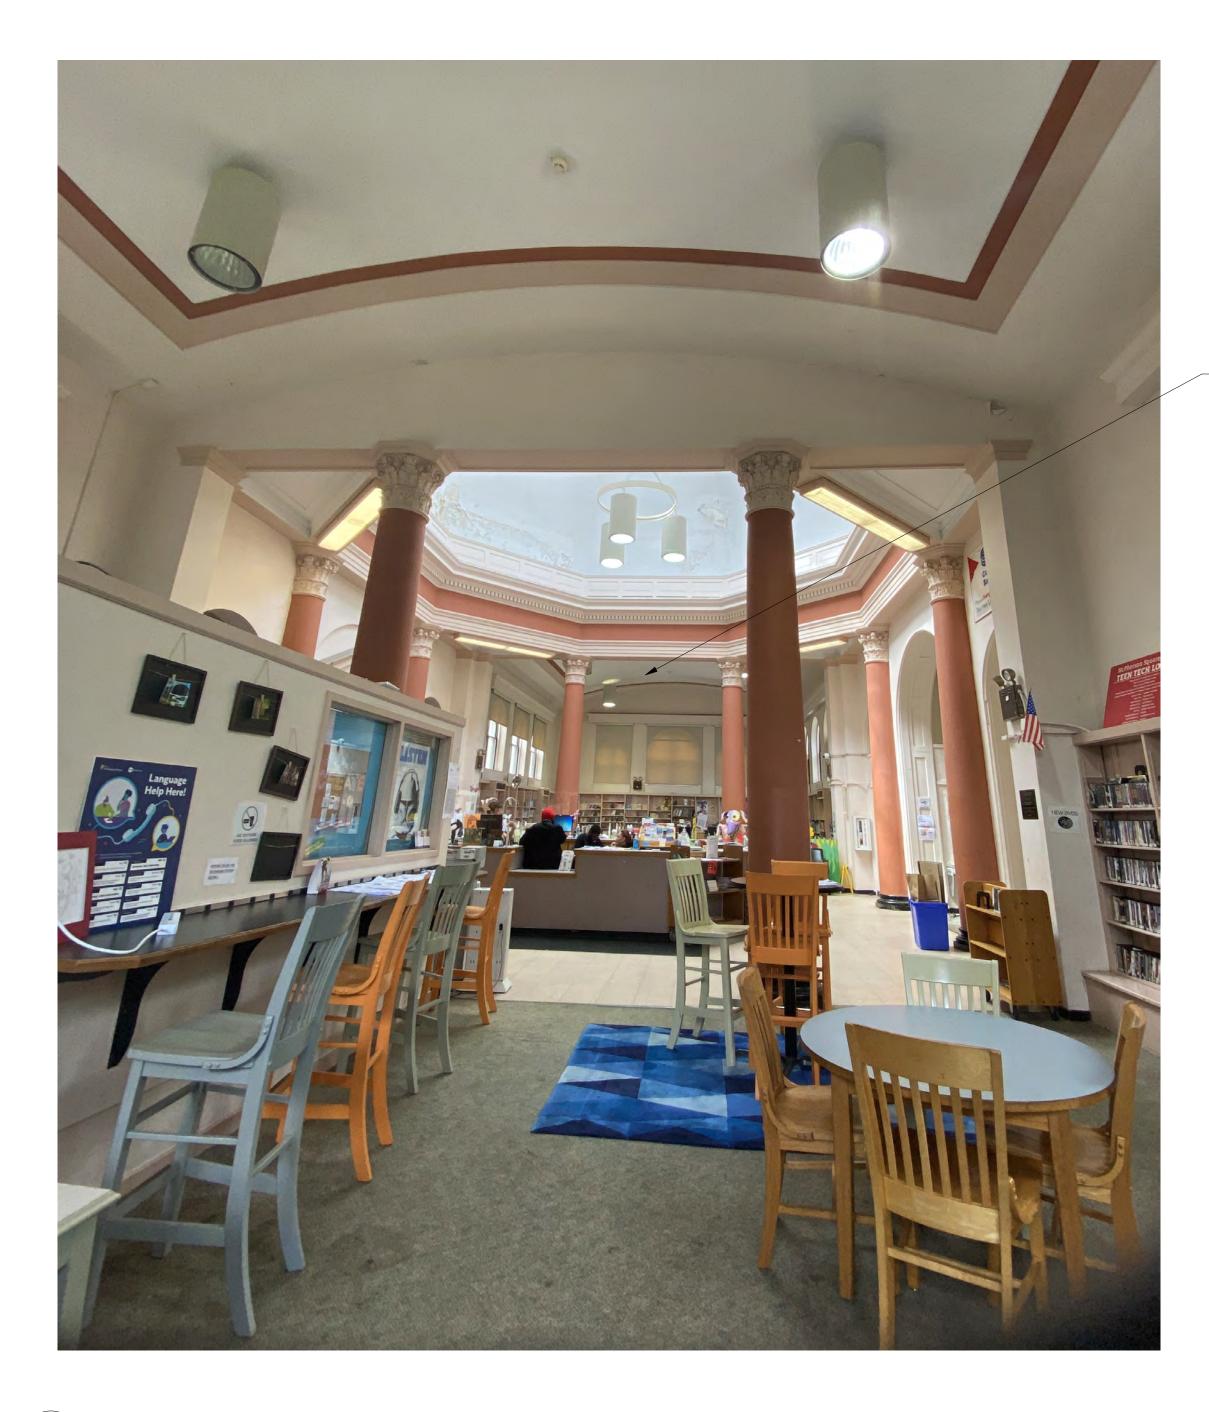


1 DOME INTERIOR PHOTOS A10.0 NTS

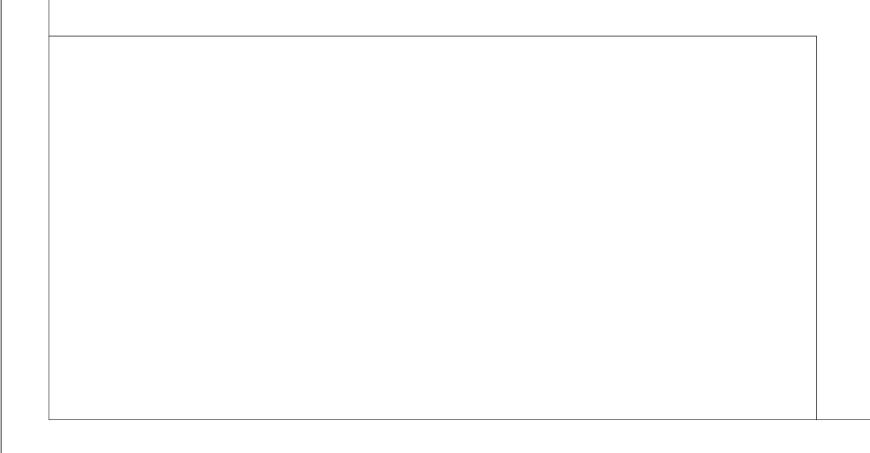

 PROVIDE PROTECTION TO ALLOW FOR CONTINUED OPERATION OF CIRCULATION DESK AREA DURING CONSTRUCTION ACTIVITIES

ALTERNATE 1 (ADD): REPAIR AND RESTORE EXISTING PLASTER AND LATH CEILING (ASSUMED) AT DOME INTERIOR. REPAINT INTERIOR DOME SURFACE. PAINTING SHALL INCLUDE ALL SURFACES AND ELEMENTS ABOVE THE CORNICE LINE

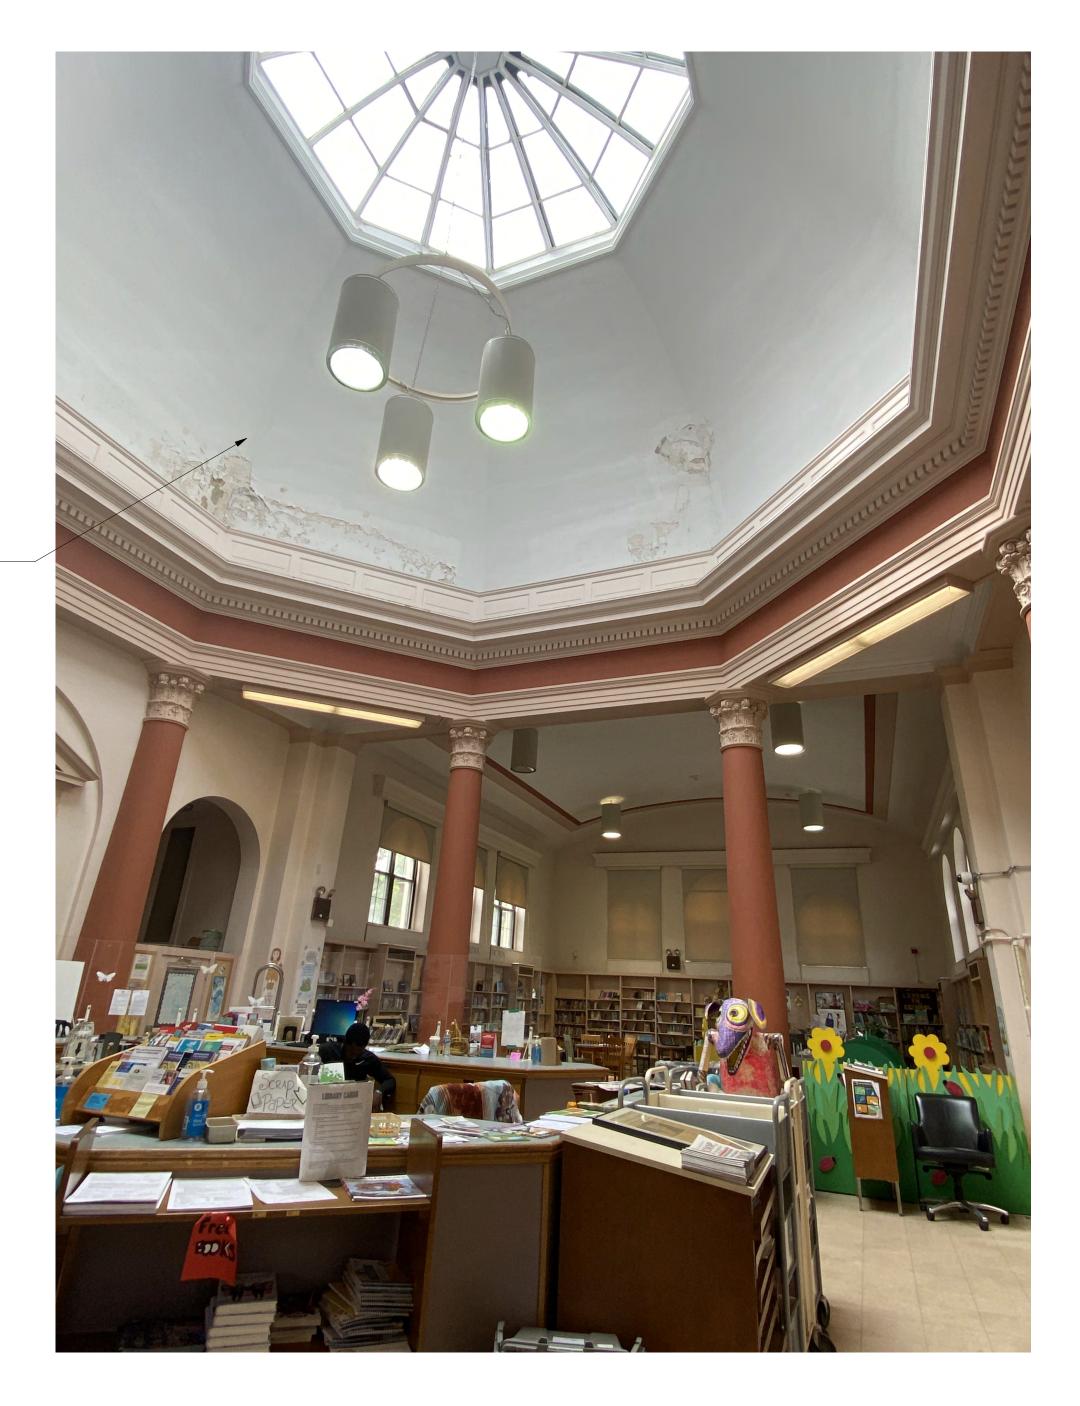







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ROOFING CONSULTANT: Steve McLaughlin 210 Garden Avenue Somerdale, NJ 08083 856 287 2424

Seal:

 By:
 JS
 Checked: JGH
 Scale:
 AS NOTED

 Date:
 04/15/2024

 Drawing Title:

 DOME INTERIOR PHOTOS

 Drawing No.:

No. Date Revision

A10.0

#### GENERAL STRUCTURAL NOTES

- 1. THIS PROJECT HAS BEEN DESIGNED USING THE 2018 INTERNATIONAL BUILDING CODE (IBC), AND APPLICABLE LOCAL REGULATIONS.
- 2. NOTIFY THE ENGINEER IMMEDIATELY IF ANY EXISTING CONDITIONS CONFLICT WITH STRUCTURAL INFORMATION SHOWN IN THE CONSTRUCTION DOCUMENTS.
- 3. THE STRUCTURAL ENGINEER IS NOT RESPONSIBLE FOR WORK THAT SHE DOES NOT REVIEW AND/OR WORK
- NOT COMPLETED IN ACCORDANCE WITH STRUCTURAL ENGINEER'S PLANS AND /OR SPECIFICATIONS. 4. IN CASE OF CONFLICT BETWEEN THE GENERAL NOTES, DETAILS AND SPECIFICATIONS, THE CONTRACTOR
- SHALL SUBMIT A REQUEST FOR CLARIFICATION.
- 5. STRUCTURAL SPECIAL INSPECTIONS ARE A REQUIREMENT FOR THIS PROJECT. A QUALIFIED INDEPENDENT INSPECTION AGENCY REGISTERED WITH THE CITY OF PHILADELPHIA SHALL BE SELECTED BY THE OWNER TO PERFORM THESE SERVICES. SPECIAL INSPECTIONS SHALL BE PERFORMED FOR THIS PROJECT AS FOLLOWS, AND IN ACCORDANCE WITH PROJECT SPECIFICATIONS:
- STRUCTURAL STEEL (AISC 360) VISUAL INSPECTION OF FIELD CONNECTIONS PERIODIC
- POST-INSTALLED ANCHOR INSTALLATION HORIZONTAL & OVERHEAD INSTALLATIONCONTINUOUS 6. THE SPECIAL INSPECTIONS AGENCY SHALL PERFORM INSPECTIONS AND SUBMIT REPORTS THE ENGINEER OF RECORD (EOR) WITHIN 72 HOURS OF INSPECTION. ANY INADEQUACIES FOUND BY THE INSPECTOR SHALL BE REPORTED TO THE EOR WITHIN 24 HOURS. THE CONTRACTOR SHALL FACILITATE THESE INSPECTIONS BY SCHEDULING THE INSPECTIONS TO COORDINATE WITH THE WORK BEING PERFORMED BY THEIR SUB-CONTRACTORS.
- POST-INSTALLED ANCHORS IN MASONRY
- 1. WHEN INSTALLING POST INSTALLED ADHESIVE ANCHORS, THE CONTRACTOR SHALL TAKE MEASURES TO AVOID DAMAGING EXISTING MASONRY. INSTALLER SHALL BE TRAINED BY MANUFACTURER ON INSTALLATION PROCEDURES. CLEAN HOLE FREE OF DUST, DEBRIS, AND MOISTURE. USE COMPRESSED AIR AND WIRE BRUSH, IN ACCORDANCE WITH MANUFACTURERS PROCEDURES. VERIFY THAT ADHESIVES TO BE USED, ARE WITHIN EXPIRATION DATE. PROVIDE HILTI OR APPROVED ALTERNATIVE.


#### STEEL


- 1. ALL STRUCTURAL STEEL WORK SHALL CONFORM TO THE FOLLOWING GOVERNING STANDARDS:
- A. AISC "SPECIFICATION FOR STRUCTURAL STEEL BUILDINGS," CURRENT EDITION.
- B. THE AMERICAN WELDING SOCIETY (AWS D1.1) "CODE FOR WELDING IN BUILDING CONSTRUCTION," CURRENT EDITION.
- 2. INSTALLER QUALIFICATIONS: ENGAGE AN EXPERIENCED INSTALLER WHO HAS COMPLETED STRUCTURAL STEEL WORK SIMILAR IN MATERIAL, DESIGN, AND EXTENT TO THAT INDICATED FOR THIS PROJECT AND WITH A RECORD OF SUCCESSFUL IN-SERVICE PERFORMANCE.
- 3. FABRICATOR QUALIFICATIONS: ENGAGE A FIRM EXPERIENCED IN FABRICATING STRUCTURAL STEEL SIMILAR TO THAT INDICATED FOR THIS PROJECT AND WITH A RECORD OF SUCCESSFUL IN-SERVICE PERFORMANCE, AS WELL AS SUFFICIENT PRODUCTION CAPACITY TO FABRICATE STRUCTURAL STEEL WITHOUT DELAYING THE WORK.
- 4. ALL STRUCTURAL STEEL SHALL CONFORM TO THE FOLLOWING ASTM SPECIFICATIONS:
- A. PLATES AND ANGLES: ASTM A36, FY=36 KSI.
- B. W, WT & C SHAPES: ASTM A992, FY=50 KSI.
- B. STEEL PIPE SHALL CONFORM TO ASTM A53 TYPE E GRADE B. [STD. = SCHEDULE 40] C. BOLTED CONNECTIONS (STEEL TO STEEL): ASTM A325-N, (3/4" DIAM.), U.N.O.
- D. ANCHOR BOLTS AND CONNECTORS IN WOOD FRAMING: ASTM A307, (3/4" DIAM.), U.N.O.
- 5. ANCHORAGE BOLTS AND FITTINGS IN MASONRY SHALL BE GALVANIZED.
- 6. WELDING SHALL BE PERFORMED BY WELDERS CERTIFIED BY THE A.W.S. SUBMIT WELDER CERTIFICATES TO ENGINEER FOR RECORD.
- 7. WELDING ELECTRODES SHALL BE ASTM A233, CLASS E70XX. ALL WELDING SHALL CONFORM TO THE A.W.S. STANDARD CODE.
- 8. ALL SHOP AND FIELD WELDS SHALL BE 3/16" FILLET WELDS MINIMUM, U.N.O.
- 9. SHOP PRIME ALL STEEL. TOUCH UP FIELD WELDS AND ANY DAMAGED AREAS OF PAINT WITH A ZINC RICH PAINT, IN FIELD AFTER WELDING.
- 10. MINIMUM CENTER-CENTER SPACING BETWEEN BOLTS SHALL BE 3", U.N.O. MINIMUM EDGE DISTANCE SHALL BE 1-1/4" FROM CENTER OF BOLTS TO EDGE OF STEEL.
- **REPAIR EXISTING STEEL** 1. STEEL FRAMING FOR THE DOME ARMATURE IS TO BE INSPECTED BY THE EOR DURING CONSTRUCTION. CONTRACTOR SHALL DEMOLISH FINISHES AS NEEDED TO EXPOSE DAMAGED FRAMING
- 2. EOR AND SPECIAL INSPECTIONS AGENCY REPRESENTATIVE SHALL ATTEND SITE MEETING TO ESTABLISH CRITERIA FOR IDENTIFYING A) EXISTING FRAMING MEMBERS TO BE REMOVED AND REPLACED; B) EXISTING FRAMING MEMBERS TO BE REINFORCED AND RE-USED; AND C) EXISTING FRAMING MEMBERS IN GOOD CONDITION TO REMAIN IN PLACE.
- 3. POWER-TOOL CLEAN EXISTING STEEL FRAMING TO SSPC-SP3 STANDARDS, IN PREPARATION FOR REPAIRS 4. SPECIAL INSPECTIONS AGENCY SHALL SURVEY ALL STEEL FRAMING MEMBERS FOR MATERIAL PROFILE, AND REPORT FINDINGS.
- 5. ELECTRODES TO BE USED WELDING EXISTING STEEL, SHALL BE ASTM A233, CLASS E60XX. WELD PROCEDURES SHALL CONFORM TO THE A.W.S. D1.1 STANDARD PRE-CERTIFIED..
- FRAMING LUMBER & SHEATHING
- 1. FRAMING LUMBER SHALL BE OF THE FOLLOWING MINIMUM STRENGTH FOR THE SPECIFIED USE, UNLESS OTHERWISE NOTED ON PLAN. ALL LUMBER SHALL BE GRADE-STAMPED BY A RECOGNIZED GRADING AGENCY AND SHALL BE SURFACED DRY. MOISTURE CONTENT NOT TO EXCEED 19%.
- DIMENSION LUMBER GRADE NO.2, PRESSURE TREATED, MIXED SOUTHERN PINE OR EQUAL. PROVIDE LUMBER STAMPED KDAT (KILN-DRIED AFTER TREATMENT). ALTERNATIVELY, SEASON THE LUMBER FOR SEVERAL MONTHS AFTER TREATMENT, SO MOISTURE CONTENT MEETS EQUILIBRIUM CONDITIONS.
- 2. STRUCTURAL COMPOSITE LUMBER SHALL BE PRESERVATIVE TREATED, (WOLMANIZED) PARALLEL STRAND LUMBER, (PSL-PT)
- PSL 2900FB-2.0E
- 3. STORE FRAMING AND SHEATHING MATERIALS IN DRY LOCATION. REMOVE STANDING WATER FROM INSTALLED SHEATHING. ENSURE INSTALLED LUMBER MOISTURE CONTENT IS 19% OR LESS, BEFORE INSTALLING HOLD DOWN ANCHORS, STRAPS, OR FINISHES THAT WOULD BE AFFECTED BY LUMBER SHRINKING OR EXPANDING.
- 4. FASTENING SHALL CONFORM TO A MINIMUM AS SPECIFIED IN TABLE 2304.10.1 OF THE INTERNATIONAL BUILDING CODE. 5. BUILT-UP MULTI-MEMBER WOOD GIRDERS SHALL HAVE MEMBER JOINTS STAGGERED SUCH THAT NOT MORE THAN (1) MEMBER SPLICE OCCURS BETWEEN SUPPORT POINTS. ORIENT ADJACENT MEMBERS WITH ALTERNATE GRAINS, AND CONNECT MEMBERS WITH GALVANIZED NAILS: 10D (.148") X 3" COMMON FOR (2) MEMBERS, 16D (.162") X 3-1/2" COMMON FOR (3) MEMBERS, AND 20D(.192") X 4" COMMON FOR (4) MEMBERS. NAIL AT TOP AND BOTTOM @ 24" OC, STAGGER OPPOSITE FACES, AND WITHIN 1-1/2" OF MEMBER ENDS.
- 6. PROVIDE CROSS BRIDGING AT MAXIMUM 8'-0" O.C. FOR ALL JOISTS. NO JOISTS SHALL BE CUT OR NOTCHED WITHOUT APPROVAL.
- 7. ALL MEMBERS SHALL HAVE LATERAL SUPPORT SUPPLIED AT ALL BEARING POINTS AS WELL AS CONTINUOUSLY ALONG THE COMPRESSION FACE.
- 8. PLYWOOD OR OSB SHEATHING SHALL BE APA GRADE STAMPED FOR SPECIFIC SPAN, SHALL BE MADE WITH EXTERIOR GLUE AND SHALL BE OF THE FOLLOWING THICKNESS:
- ROOF: 19/32" THICK, EXPOSURE 1, STRUCTURAL 1, SPAN RATING 40/20.
- INDEX STAMP SHALL BE VISIBLE ON ALL SHEETS.
- PROTECT SHEATHING FROM EXTENSIVE EXPOSURE TO WEATHER.
- 9. INSTALL PLYWOOD SHEATHING WITH FACE GRAIN PERPENDICULAR TO THE SUPPORTING MEMBERS, U.N.O. 10.USE PLYCLIPS OR OTHER EDGE SUPPORT AS REQUIRED FOR ROOF SHEATHING.
- 11.PROVIDE STRUCTURAL WOOD TONGUE AND GROOVE DECKING TO MATCH EXISTING DECKING DEPTH. PROVIDE SYP GRADE #1 OR EQUAL. FASTEN TO SUPPORTING JOISTS WITH #10 SCREWS X 2" EMBED @ 8" OC.
- 12.PRESERVATIVE TREATMENT: TREAT WOOD MEMBERS AND SHEATHING IN CONTACT WITH MASONRY OR CONCRETE, OR WITHIN 6" OF GROUND, [IRC-R317.1.5]. TREAT IN ACCORDANCE WITH CURRENT STANDARDS OF AMERICAN WOOD PRESERVERS ASSOCIATION (AWPA) STANDARD.
- USE CATEGORY 3B FOR EXPOSED EXTERIOR WOOD, NOT IN CONTACT WITH GROUND.
- USE CATEGORY 4A FOR WOOD IN CONTACT WITH GROUND. LUMBER AND SHEATHING SHALL BE VISIBLY STAMPED WITH AWPA USE CATEGORY STAMP.
- 13.CONTRACTOR SHALL VERIFY CORROSIVE COMPATIBILITY OF FASTENERS WITH ACQ PRESERVATIVE


14.PROTECT ENDS AND TOPS OF FRAMING IN CONTACT WITH MOISTURE WITH SELF ADHERED FLASHING OR EQUAL.

STRUCTURAL DESIGN CRITERIA GROUND SNOW LOAD 25 LBS/SQ FT ROOF LIVE LOAD WIND LOADS WIND SPEED: WIND PRESSURE FOR COMPONENTS AND CLADDING DESIGN 20 LBS/SQ FT


20 LBS/ SQ FT 115 MPH, EXPOSURE B

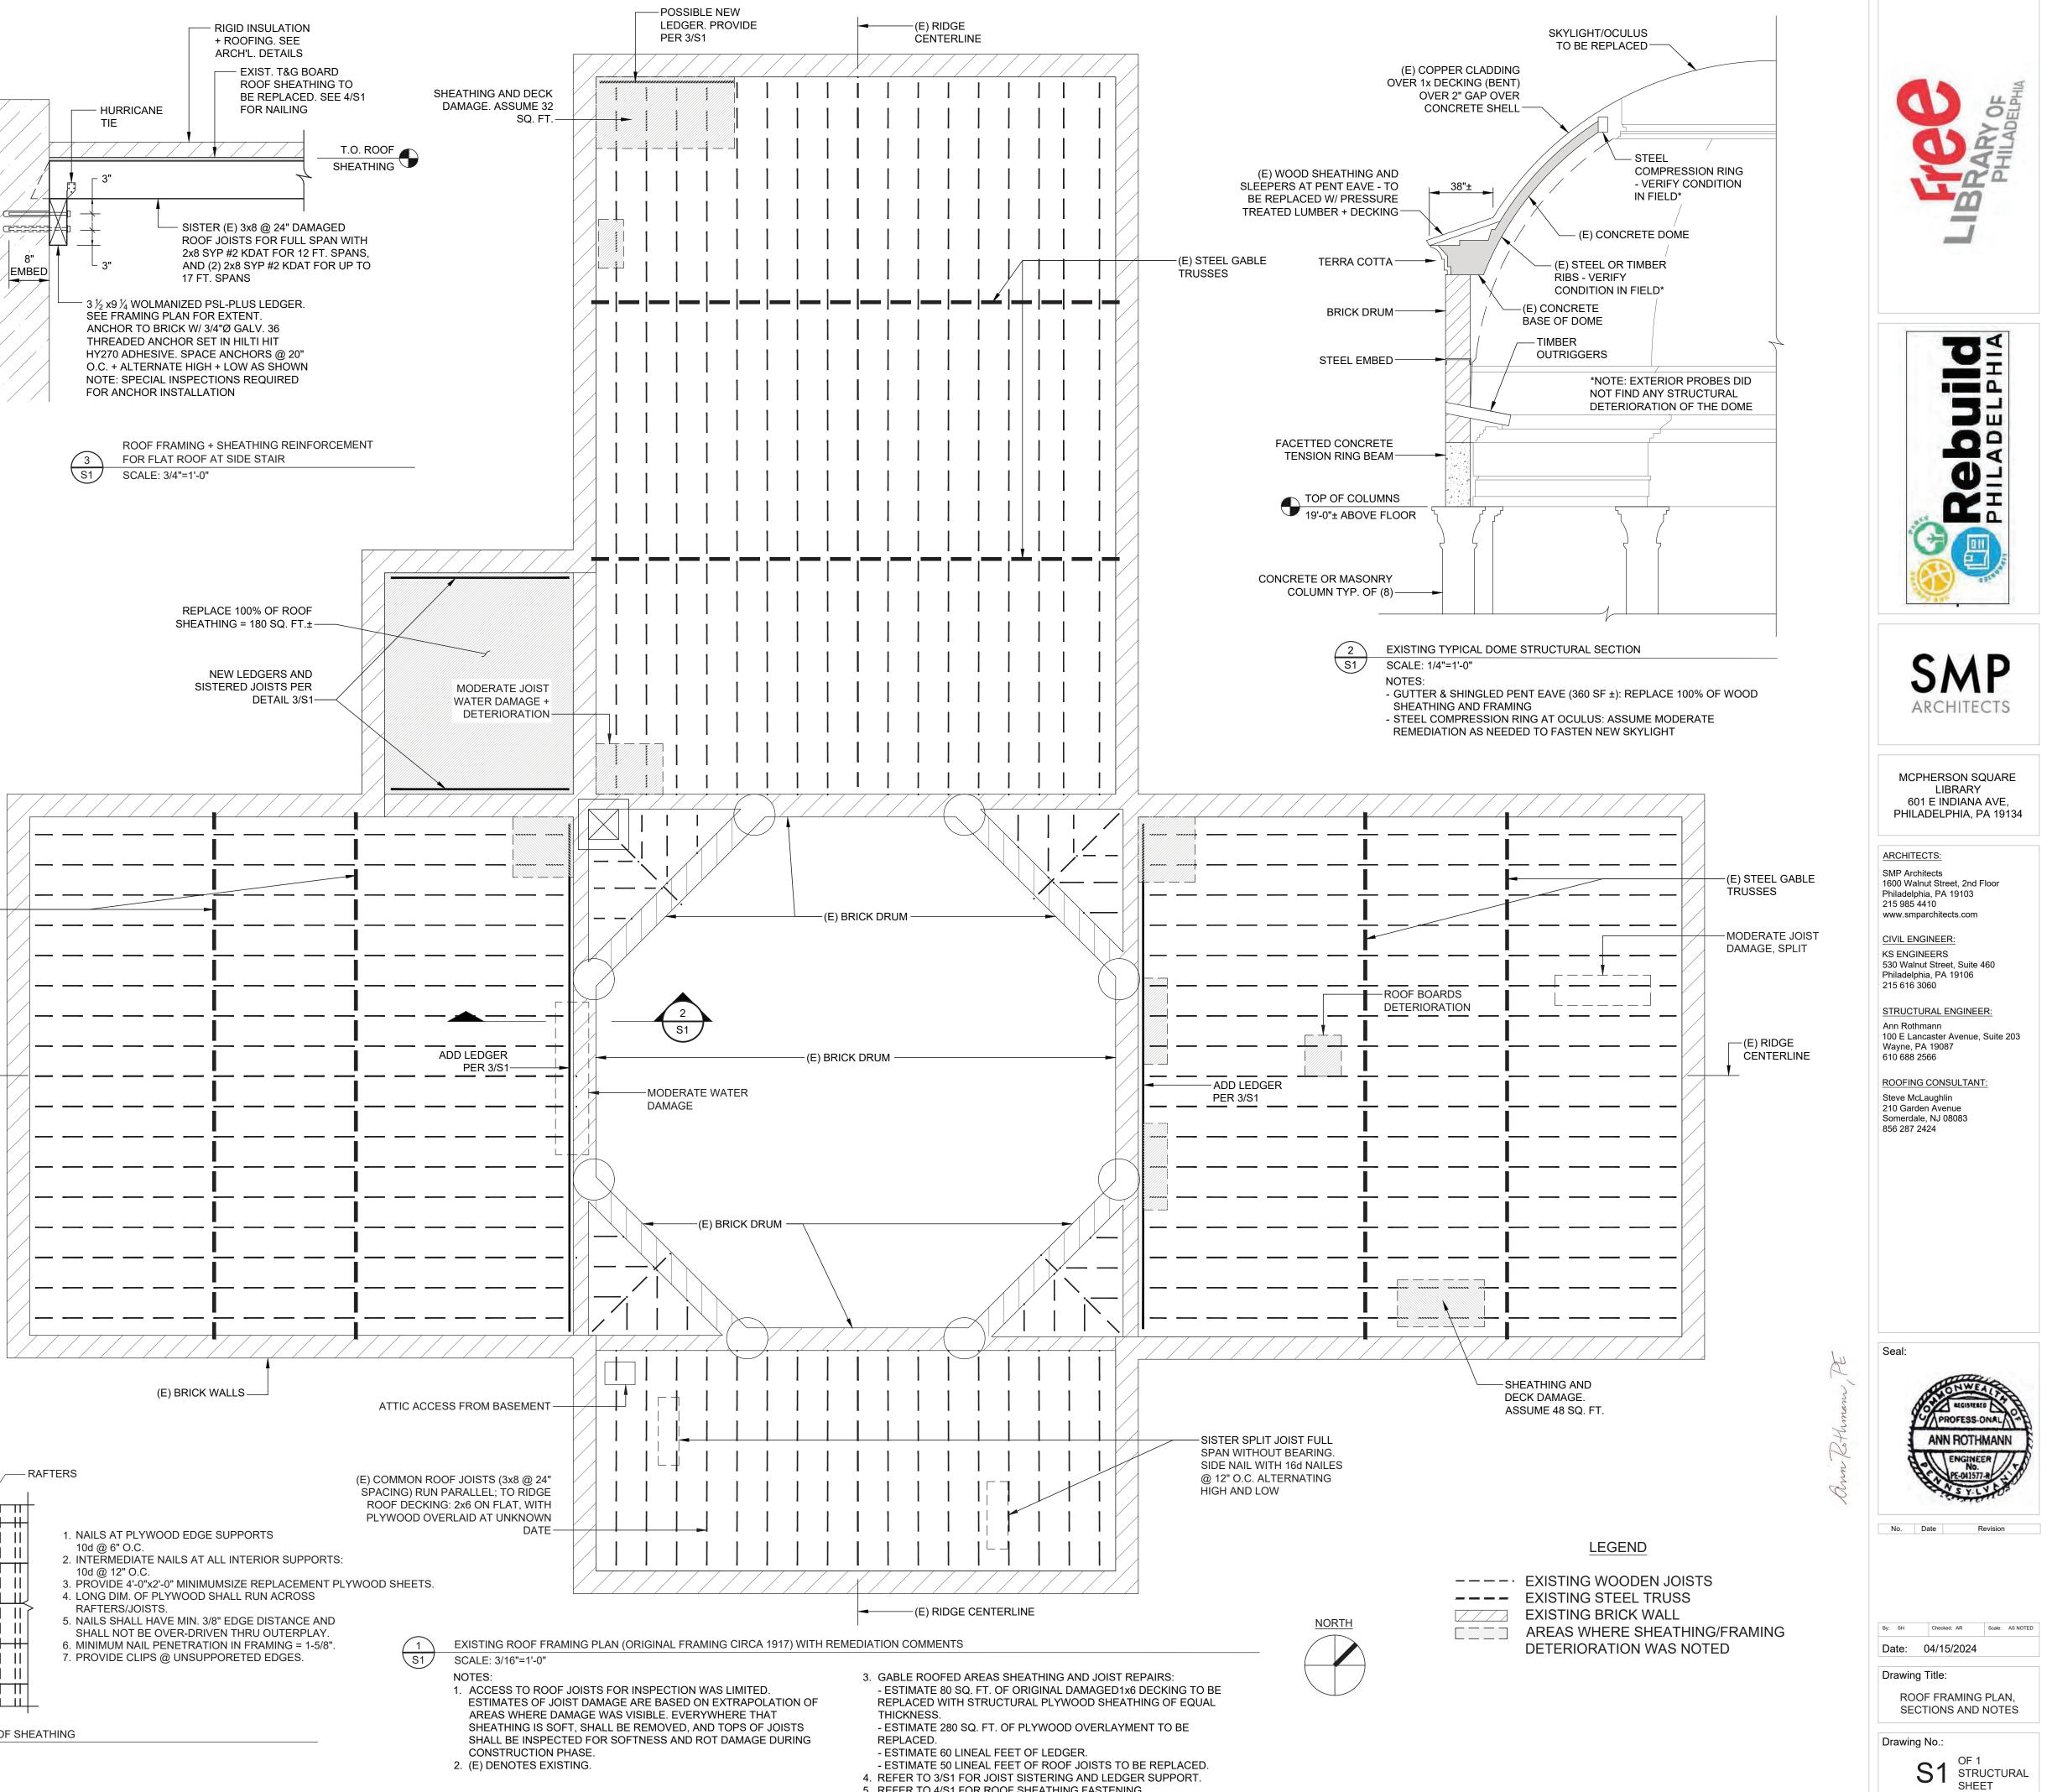

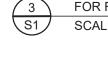

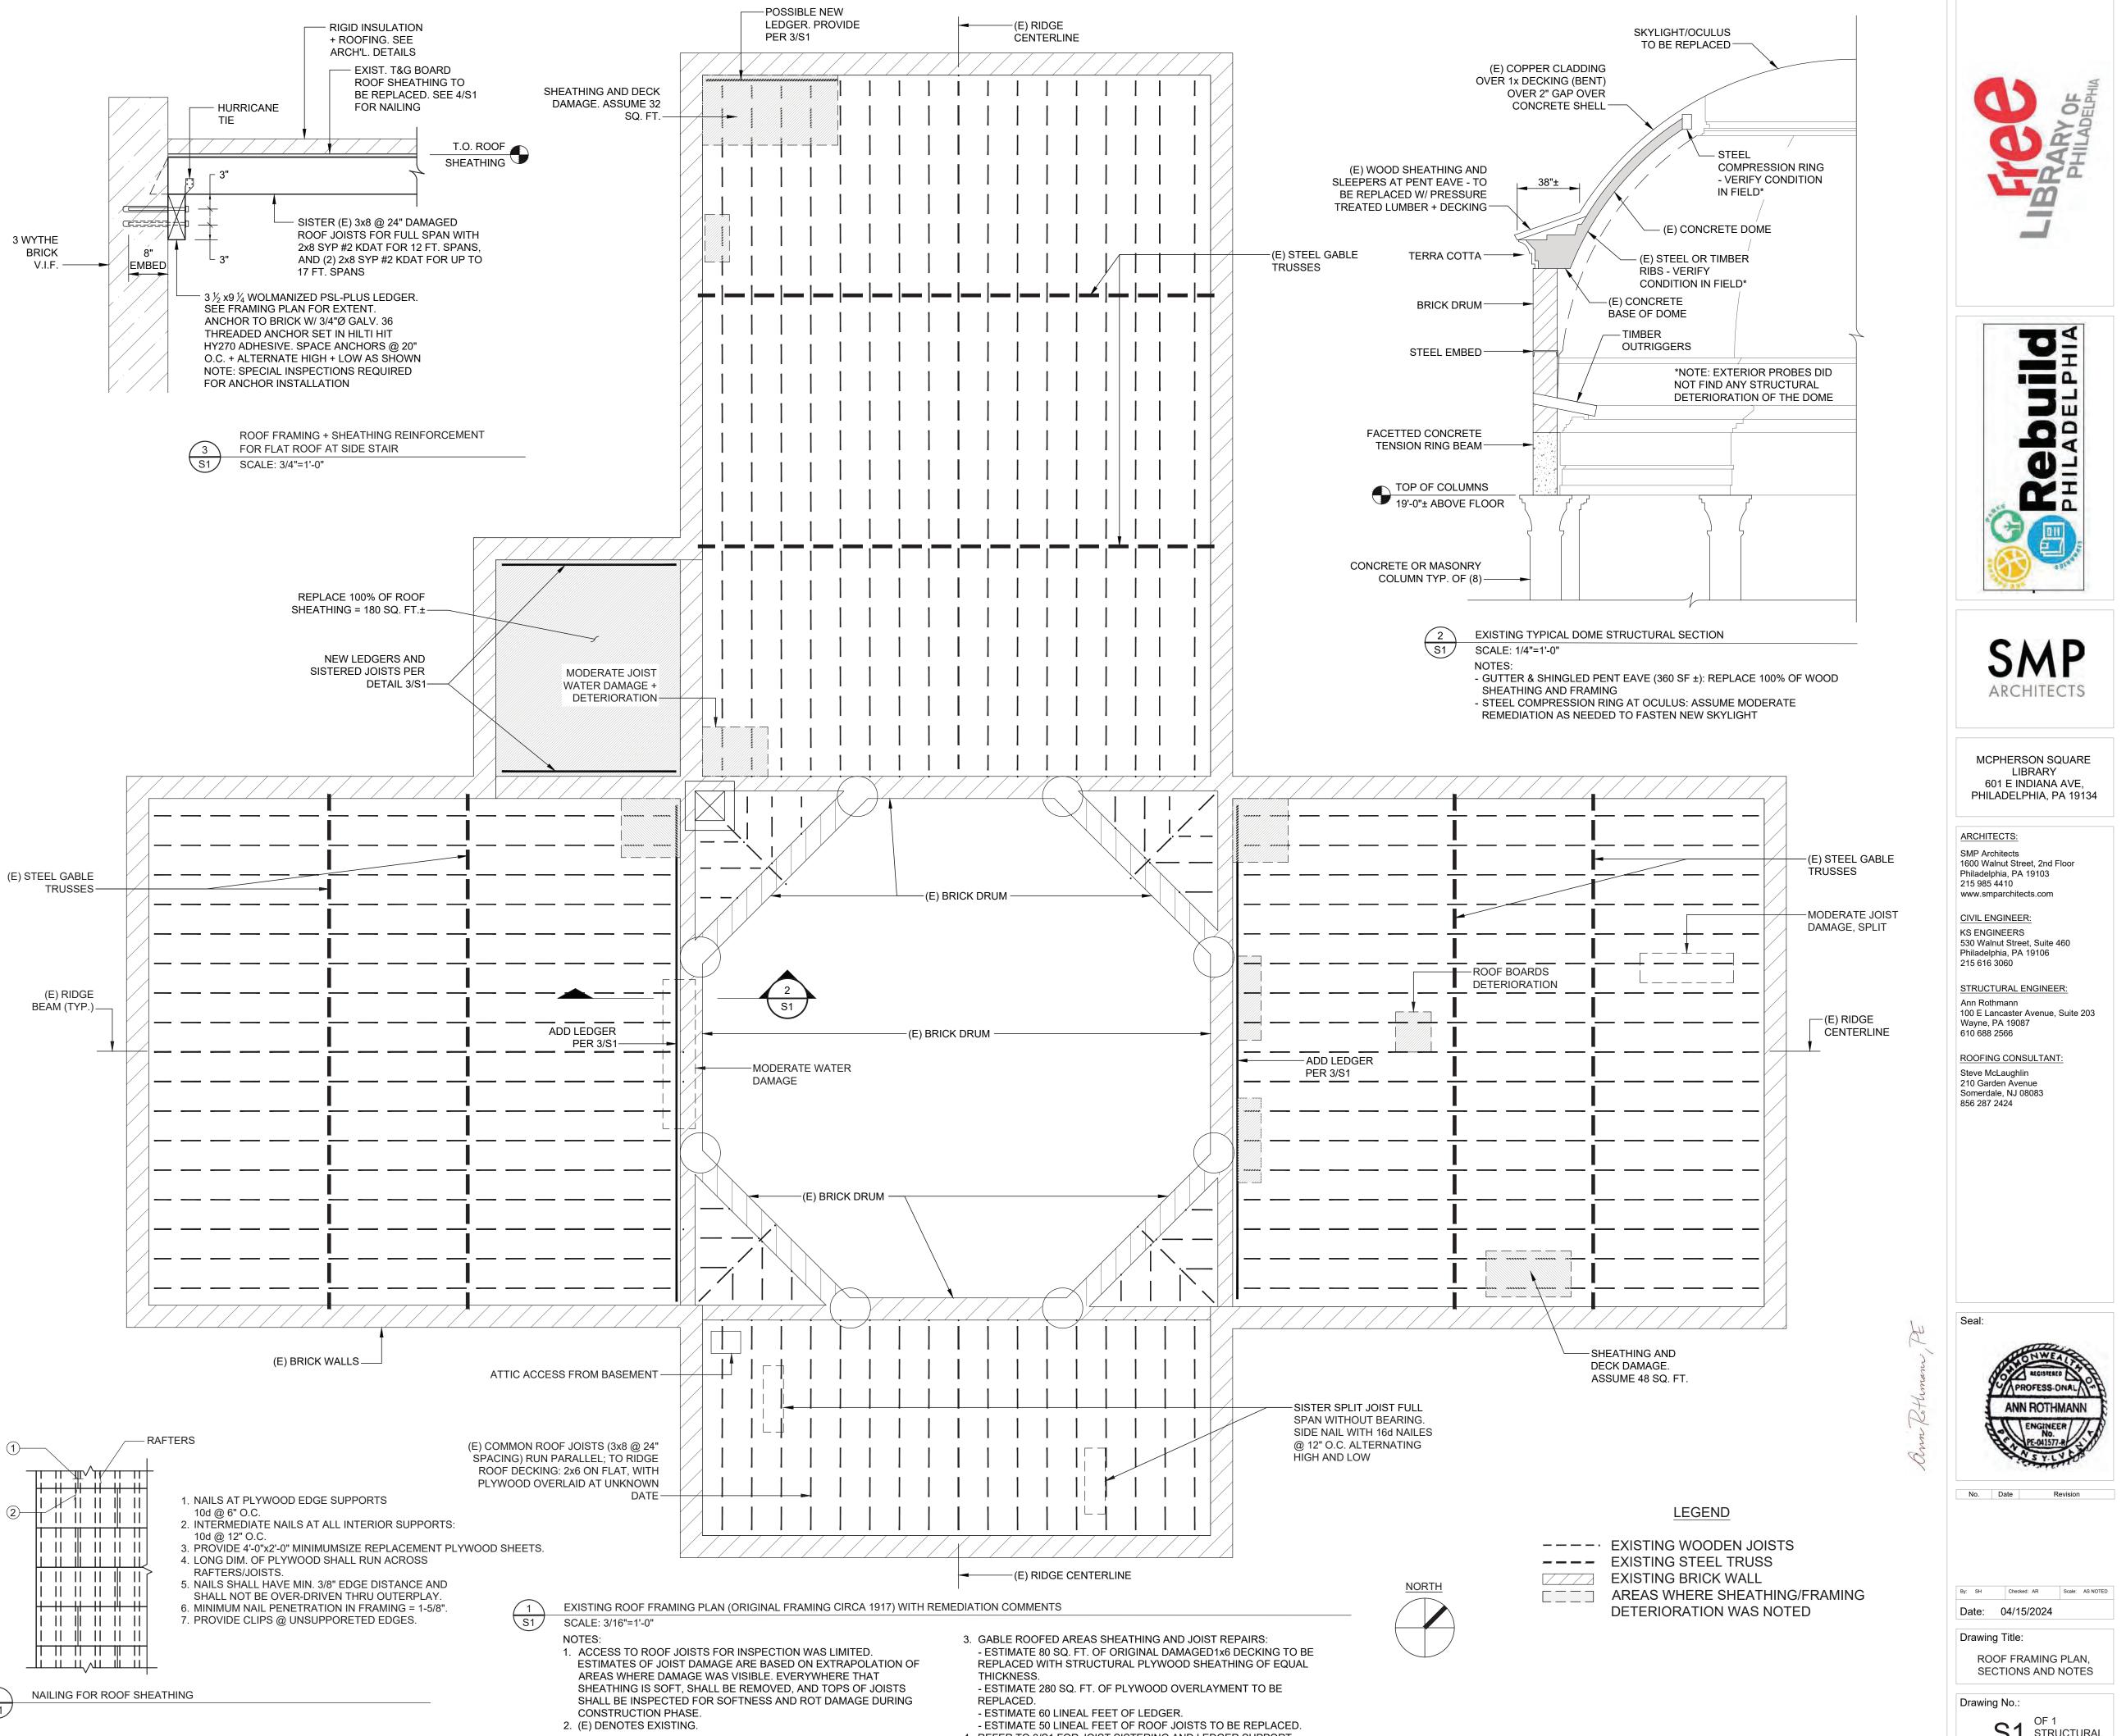



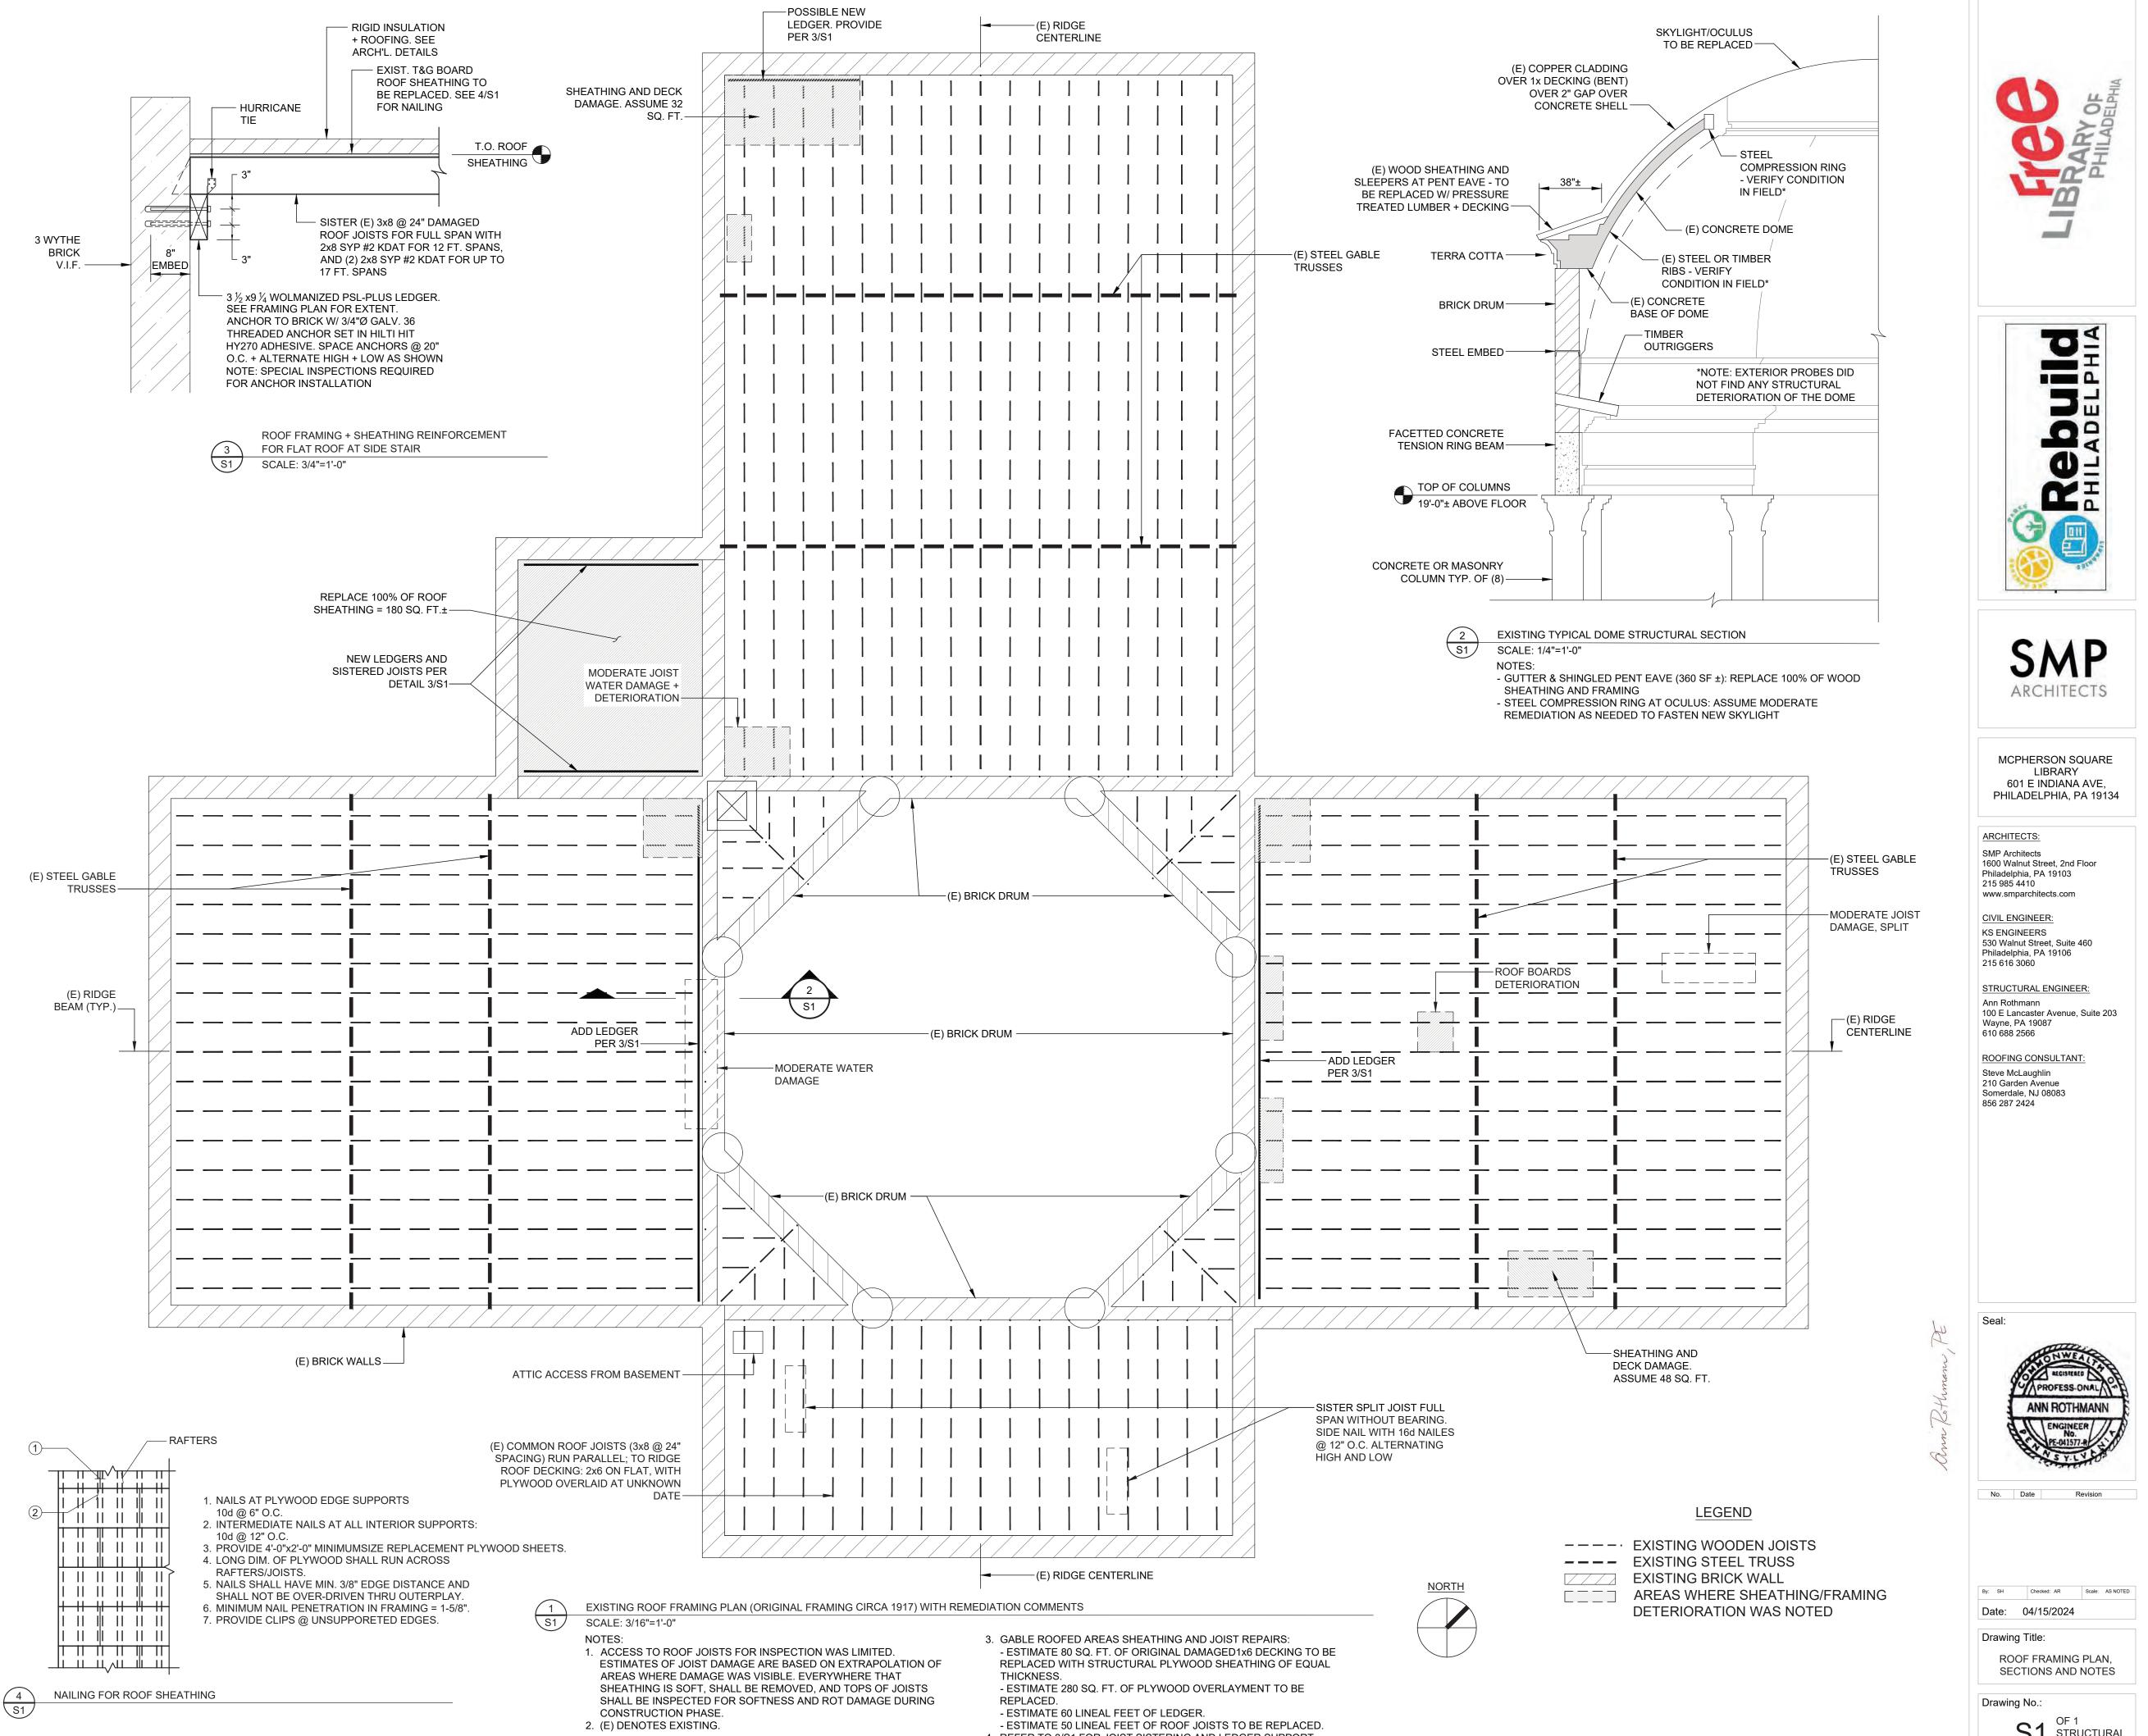



4. REFER TO 3/S1 FOR JOIST SISTERING AND LEDGER SUPPORT.

5. REFER TO 4/S1 FOR ROOF SHEATHING FASTENING.