



CITY OF PHILADELPHIA FREE LIBRARY OF PHILADELPHIA

MAYOR - CHERELLE L. PARKER
PRESIDENT AND DIRECTOR - FREE LIBRARY - KELLY RICHARDS

MCPHERSON SQUARE LIBRARY

PROJECT NO.: 52025E-05-01

601 E Indiana Ave,
Philadelphia, PA 19134



CONSTRUCTION DOCUMENTATION

SMP ARCHITECTS
1600 Walnut Street, 2nd Floor
Philadelphia, Pennsylvania 19103
215 985 4410

CIVIL ENGINEER:
KS ENGINEERS, P.C.
530 Walnut Street, Suite 460
Philadelphia, Pennsylvania 19106
215 925 0425

STRUCTURAL ENGINEER:
ANN ROTHMANN STRUCTURAL ENGINEERING
100 East Lancaster Avenue, Suite 203
Wayne, Pennsylvania 19087
610 213 3657


ROOFING CONSULTANT:
STEVE McLAUGHLIN
Steve McLaughlin
210 Garden Avenue
Somerville, NJ 08083
856 287 242

PROJECT USER:
FREE LIBRARY OF PHILADELPHIA
1901 Vine Street,
Philadelphia, Pennsylvania 19103

PROJECT ADMINISTRATOR:
REBUILD PHILADELPHIA
Cassie O'Connell, Project Manager
1515 Arch Street, Mezzanine Level
Philadelphia, Pennsylvania 19107

Free
LIBRARY OF
PHILADELPHIA

LOCATION PLAN

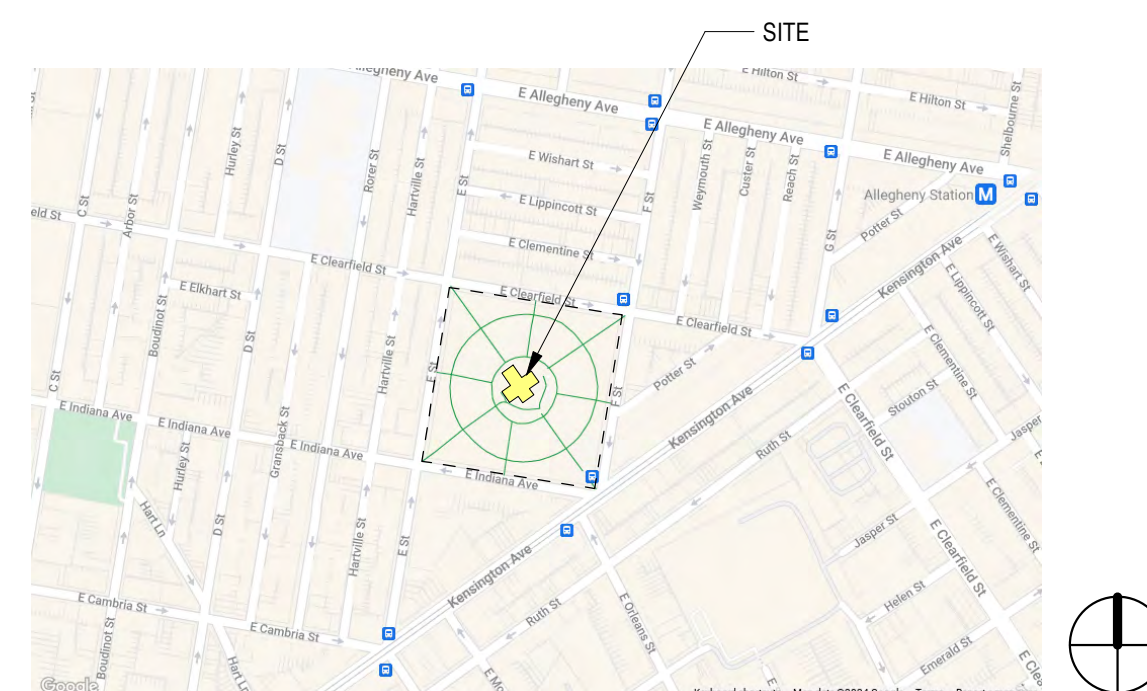

DRAWING LIST

GENERAL

CS 1	COVER SHEET
A0.1	GENERAL NOTES, ABBREVIATIONS, MATERIALS, REFERENCE SYMBOLS

CIVIL

C1.0	EXISTING SITE PLAN
C2.0	DEMOLITION PLAN
C3.0	PROPOSED SITE PLAN
C6.0	EROSION AND SEDIMENT CONTROL PLAN
C6.1	EROSION AND SEDIMENT CONTROL DETAILS
C6.2	EROSION AND SEDIMENT CONTROL NOTES
C7.0	CONSTRUCTION DETAILS
C8.0	UTILITY DETAILS
C8.1	UTILITY DETAILS

ARCHITECTURAL

D2.0	DEMOLITION BASEMENT & ROOF PLAN
D3.0	DEMOLITION EXTERIOR ELEVATIONS
D3.1	DEMOLITION EXTERIOR ELEVATIONS
A2.0	FLOOR PLANS
A2.1	ROOF PLAN
A3.0	EXTERIOR ELEVATIONS
A3.1	EXTERIOR ELEVATIONS
A8.0	ROOF DETAILS
A8.1	CORNICE DETAILS
A10.0	DOME INTERIOR PHOTOS

STRUCTURAL

S1	ROOF FRAMING PLAN, SECTIONS AND NOTES
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PROJECT APPROVED

PROJECT MANAGER/PUBLIC PROPERTY

PROJECT MANAGER/REBUILD

ART COMMISSION

SEALS

CITY OF PHILADELPHIA
DEPARTMENT OF PUBLIC PROPERTY

ROOM 709

PHILADELPHIA PENNSYLVANIA

PROJECT NO. DRAWING NO.

52025E-05-01 CS-1

DATE 04/15/2024

SCALE AS NOTED

DRAWN BY JS

CHECKED BY JGH FILET/CP/FORMS/PRESERVE/24/03/2024

NOTE: ALL DIMENSIONS AND CONDITIONS SHALL BE VERIFIED BY THE CONTRACTOR AT THE SITE BEFORE PROCEEDING WITH THE WORK.


GENERAL NOTES:

- DO NOT SCALE DRAWINGS.
- THE CONTRACTOR SHALL OBTAIN ALL REQUIRED PERMITS PRIOR TO THE START OF CONSTRUCTION.
- THE CONTRACTOR SHALL COMPLY WITH ALL FEDERAL, STATE AND LOCAL REGULATIONS, CODES AND ORDINANCES.
- THE CONTRACTOR SHALL CONFIRM, LOCATE AND COORDINATE WORK WITH HIDDEN MECHANICAL, PLUMBING AND ELECTRICAL CONDITIONS.
- THE CONTRACTOR SHALL BE RESPONSIBLE FOR ANY DAMAGE TO THE EXISTING BUILDING, SITE AND EQUIPMENT DURING CONSTRUCTION, INCLUDING DAMAGE FROM THE ELEMENTS. THE CONTRACTOR SHALL EXERCISE CARE SO AS NOT TO DAMAGE EXISTING BUILDING DURING CONSTRUCTION. THE CONTRACTOR SHALL REPAIR ANY DAMAGE IMMEDIATELY AND TO THE SATISFACTION OF THE OWNER.
- THE CONTRACTOR SHALL VERIFY EXISTING CONDITIONS AND DIMENSIONS ON THE JOB SITE. IF EXISTING CONDITIONS DO NOT PERMIT INSTALLATION OF WORK IN ACCORDANCE WITH THE DRAWINGS AND SPECIFICATIONS, NOTIFY THE ARCHITECT AND PROVIDE A SKETCH OF THE CONDITION.
- DIMENSIONS ARE TO FINISH FACE OF WALL UNLESS NOTED OTHERWISE.
- THE CONTRACTOR SHALL COORDINATE LOCATION AND SIZE OF ALL OPENINGS WITH ALL TRADES PRIOR TO INSTALLATION.
- DETAILS SHOWN ARE INTENDED FOR SPECIFIC LOCATIONS AND CONDITIONS. MINOR MODIFICATIONS MAY BE REQUIRED TO SUIT SIMILAR CONDITIONS AND SHALL BE CONSIDERED PART OF THE WORK.
- UNLESS OTHERWISE INDICATED ON THE DRAWINGS OR IN THE SPECIFICATIONS AS BEING NIC, ALL ITEMS, MATERIALS, ETC. AND INSTALLATION OF SAME ARE A PART OF THE CONTRACT WORK.
- THE GENERAL CONTRACTOR SHALL COORDINATE ALL SLEEVING WORK, UNO, COORDINATE LOCATION AND SIZE OF ALL OPENINGS, INTERIOR AND/OR EXTERIOR WITH ALL TRADES PRIOR TO INSTALLATION.


ABBREVIATIONS:

A	ARCHITECT/ENGINEER	F	FIRE ALARM	P	PRECAST ARCHITECTURAL CONCRETE
A/E	ANCHOR BOLT	FCB	FIBER CEMENT BOARD	PERF	PERFORATED
ABV	ABOVE	FCU	FAN COIL UNIT	PLAM	PLASTIC LAMINATE
ACT	ACOUSTIC CEILING TILE	FD	FLOOR DRAIN	PLAS	PLASTER
ADJ	ADJACENT/ADJUSTABLE	FEC	FIRE EXTINGUISHER CABINET	PNL	PANEL
AFF	ABOVE FINISH FLOOR	FF	FACTORY FINISH	PNLG	PANELING
AGG	AGGREGATE	FEE	FINISHED FLOOR ELEVATION	PNT	PAINT(ED)
ALOW	ALUMINUM CURTAINWALL	FIN	FINISH(ED)	POL	POLISHED
AL(ALUM)	ALUMINUM	FLG	FLASHING	PROJ	PROJECTION
ALSF	ALUMINUM STOREFRONT	FLR	FLOOR(ING)	P.T.	PRESSURE TREATED
ALW	ALUMINUM WINDOW	FND	FOUNDATION	PT	PORCELAIN TILE
ANOD	ANODIZED	F.O.	FACE OF	PTN	PARTITION
AP	ACCESS PANEL	FP	FILLER PANEL	PWD	PLYWOOD
APPROX	APPROXIMATE	FT	FOOT (FEET)	PV	PIPE VENT
ARCH	ARCHITECTURAL	FTG	FOOTING		
		FTR	FIN TUBE RADIATOR		
B		G		R	
B&B	BOARD AND BATTEN	GA	GAUGE	RA	RETURN AIR
BCAB	BASE CABINET	GALV	GALVANIZED	RAD	RADIUS
BD	BOARD	GF	GROUND FACE	RB	RUBBER BASE
BLDG	BUILDING	GLAZ	GLAZED, GLAZING, GLASS	RBT	RUBBER STAIR TREAD
BLKG	BLOCKING	GRG	GLASS REINFORCED GYPSUM	RCP	REFLECTED CEILING PLAN
BLW	BELOW	GWB	GYPSUM WALLBOARD	RD	ROOF DRAIN
B.O.	BOTTOM OF			REF	REFER, REFERENCE
BC	BROADLOOM CARPET			REQD	REQUIRED
BM	BEAM	H		REV	REVISION, REVISE(D)
BRK	BRICK	HDPE	HIGH DENSITY POLYETHYLENE	RSF	RESILIENT FLOORING
BTW	BETWEEN	HM	HOLLOW METAL	RT	RESILIENT TILE FLOORING
		HOR	HORIZONTAL	RM	ROOM
C		HR	HARDWOOD	R.O.	ROUGH OPENING
CAB	CABINET	HRWD	HARDWOOD	RTF	RESILIENT RUBBER TILE FLOORING
CB	CEMENTBOARD	HSS	HOLLOW STEEL SECTION	RWC	RAINWATER CONDUCTOR
CERT	CERTIFIED	HT	HIGH TEMPERATURE		
CFMF	COLD FORMED METAL FRAMING	HVAC	HEAVY/VENTILATION/AIR CONDITIONING	S	
CJ	CONSTRUCTION/CONTROL JOINT	HWH	HOT WATER HEATER	S	SOUTH
CL	CENTERLINE			SA	SUPPLY AIR
CLG	CEILING	I		SBC	SINK BASE CABINET
CLR	CLEAR/CLEARANCE	IGU	INSULATED GLAZING UNIT	SBO	SUPPLIED BY OTHERS
CMU	CONCRETE MASONRY UNIT	INCL	INCLUDING/INCLUDED	SFI	SPRAY FOAM INSULATION
COL	COLUMN	INFO	INFORMATION	SIT	STRUCTURAL GLAZED TILE
COMP	COMPOSITE	INSUL	INSULATED, INSULATION	SIM	SIMILAR
CONC	CONCRETE	INT	INTERIOR	SIP	STRUCTURAL INSULATED PANEL
CONC	CONCRETE			SL	SLOPED/SLOPE
CONT	CONTINUOUS	J		SOG	SLAB ON GRADE
COORD	COORDINATE	JT	JOINT	SSTL	STAINLESS STEEL
COR	CORRUGATED			STD	STANDARD
CPT	CARPET TILE	L		STL	STEEL
CT	CERAMIC TILE	LAM	LAMINATED	STN	STAIN(ED)
CUH	CABINET UNIT HEATER	LF	LINEAR FEET	STRUC	STRUCTURAL
CW	CURTAINWALL	LG	LONG	SUSP	SUSPENDED
		LIN	LINOLEUM		
D		LLV	LONG LEG VERTICAL	T	
DEMO	DEMOLISH/DEMOLITION	LTL	LINTEL	TER	TERRAZZO
DIA	DIAMETER	LT	LIGHT	TF	TRANSPARENT FINISH
DIM	DIMENSION	LOUV	LOUVER	THK	THICKNESS
DN	DOWN			TLT	TOILET
DR	DOOR	M		TPTN	TOILET PARTITION
DS	DOWNSPOUT	MAS	MASONRY	T.O.	TOP OF
DTL	DETAIL	MATL	MASONRY DIMENSION	TYP	TYPICAL
DWG(S)	DRAWING(S)	MAX	MAXIMUM	T&G	TONGUE AND GROOVE
		MDF	MEDIUM DENSITY FIBERBOARD	U	
E		MECH	MECHANICAL	UNO	UNLESS NOTED OTHERWISE
E	EAST	MFR	MANUFACTURER	V	
EA	EACH	MIN	MINIMUM	VAR	VARIES/VARIOUS
EJ	EXPANSION JOINT	M.O.	MASONRY OPENING	VERT	VERTICAL
EL	ELEVATION	MR	MOISTURE RESISTANT	VEST	VESTIBULE
ELEC	ELECTRICAL	MTD	MOUNTED	VIF	VERIFY IN FIELD
ELEV	ELEVATOR	MTL	METAL	VTR	VENT THROUGH ROOF
EMER	EMERGENCY	MULL	MULLION		
ENR	ENGINEER OF RECORD	N		W	
EP	ELECTRICAL PANEL	NA	NORTH	W	WEST
EPX	EPOXY	NAT	NATURAL	W/	WITH
EQ	EQUAL	NIC	NOT IN CONTRACT	W/O	WITHOUT
EQPM	EQUIPMENT	NIS	NOT IN SCOPE	WB	WALL BASE
ES	EXPOSED STRUCTURE	NOM	NOMINAL	WC	WATER CLOSET
ETR	EXISTING TO REMAIN	NTS	NOT TO SCALE	WCAB	WALL CABINET
EWC	ELECTRIC WATER COOLER			WD	WOOD
EXP	EXPOSED	O		WDP	WOOD PANEL
EXG	EXISTING	OC	ON CENTER	WF	WIDE FLANGE
EXT	EXTERIOR	OFE	OWNER FURNISHED EQUIPMENT	WIN	WINDOW
		OH	OPPOSITE HAND	WOM	WALK OFF MAT
		OPP	OPPOSITE	WSCT	WAINSCOT
		OPG	OPENING	X	
		OSB	ORIENTED STRAND BOARD	XPS	EXTRUDED POLYSTYRENE
		OTLN	OUTLINE		

MATERIAL SYMBOLS:

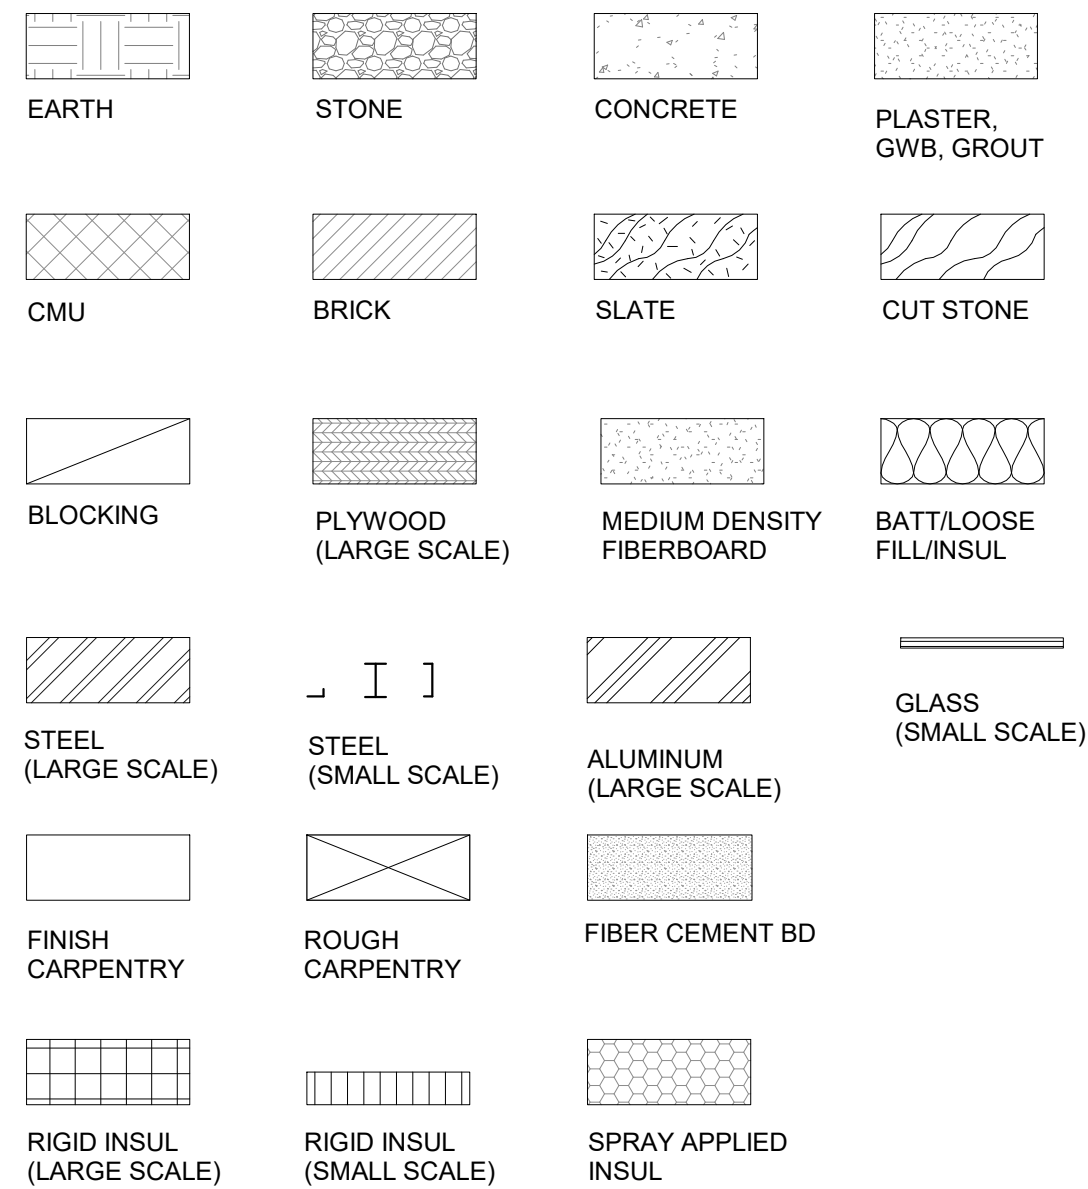

REFERENCE SYMBOLS:

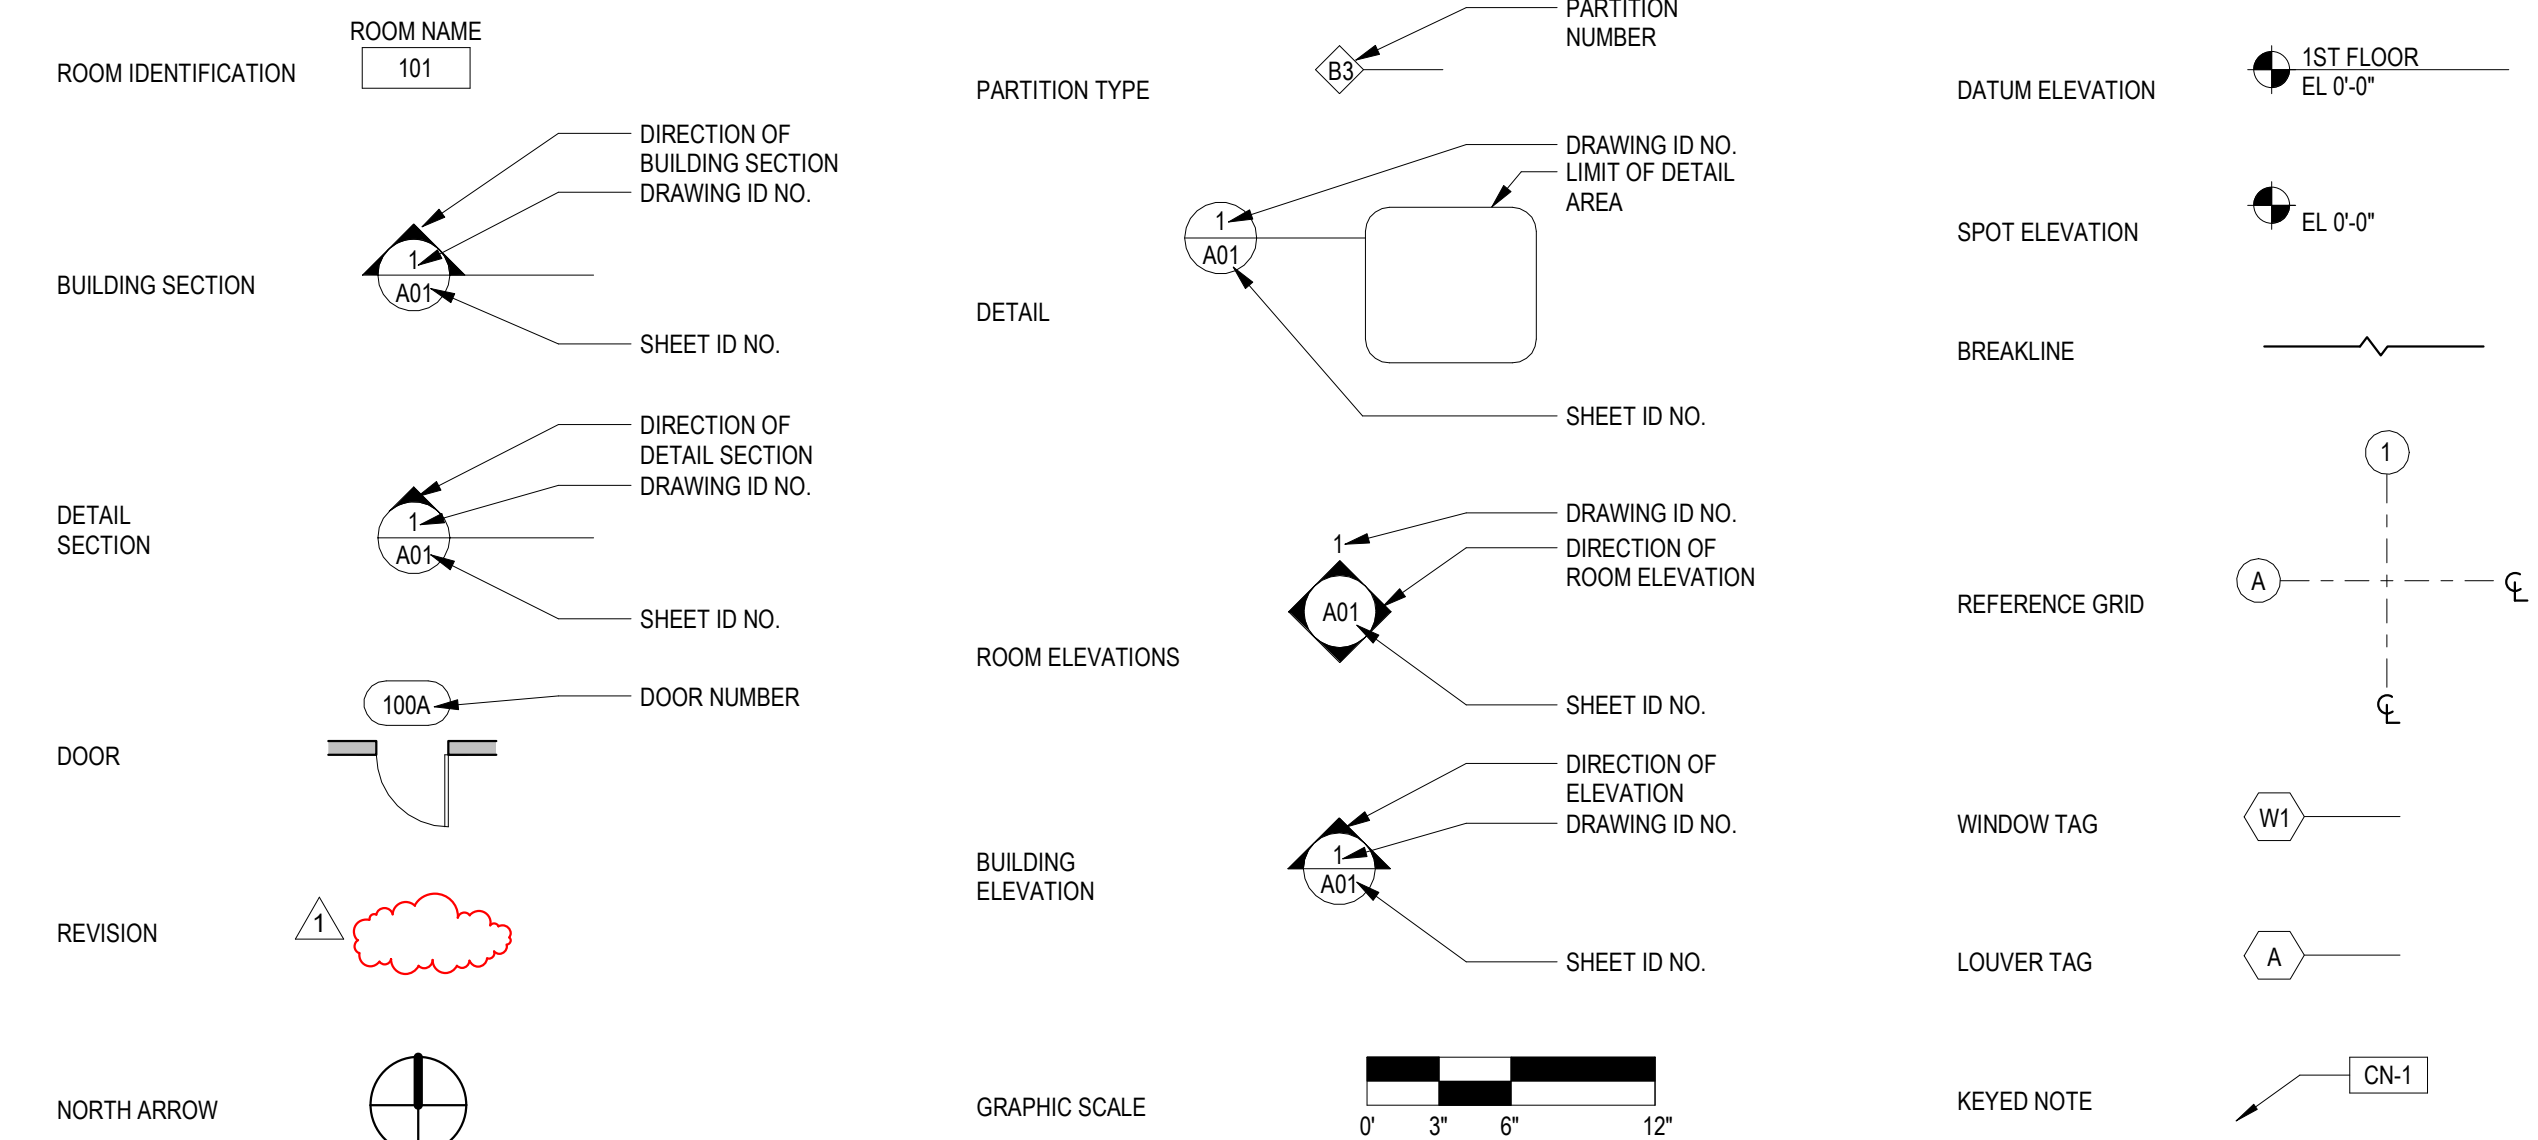

CODE:

THIS RENOVATION DOES NOT IMPACT ISSUES OF OCCUPANCY, HEIGHT AND AREA OR EGRESS.

ALTERNATES:

- ALTERNATE 1(ADD):** REPAIR AND RESTORE EXISTING PLASTER AND LATH CEILING (ASSUMED) AT DOME INTERIOR. REPAINT INTERIOR DOME SURFACE.
- ALTERNATE 2:** FOR REPLACEMENT TERRA COTTA UNITS, CONTRACTOR MAY CONSIDER ALTERNATIVE MATERIALS, SUCH AS GLASS FIBER REINFORCED CONCRETE (GFRC) AS AN ALTERNATE FOR CONSIDERATION BY OWNER. PROVIDE PRODUCT DATA FOR ALTERNATIVE PRODUCT FOR REVIEW. IN ADDITION TO PROPOSED DEDUCT ALTERNATE COST. IDENTIFY AND QUANTIFY SCHEDULE IMPROVEMENTS AVAILABLE TO THE PROJECT IF THIS ALTERNATE IS SELECTED BY THE OWNER.

Seal:

No.	Date	Revision
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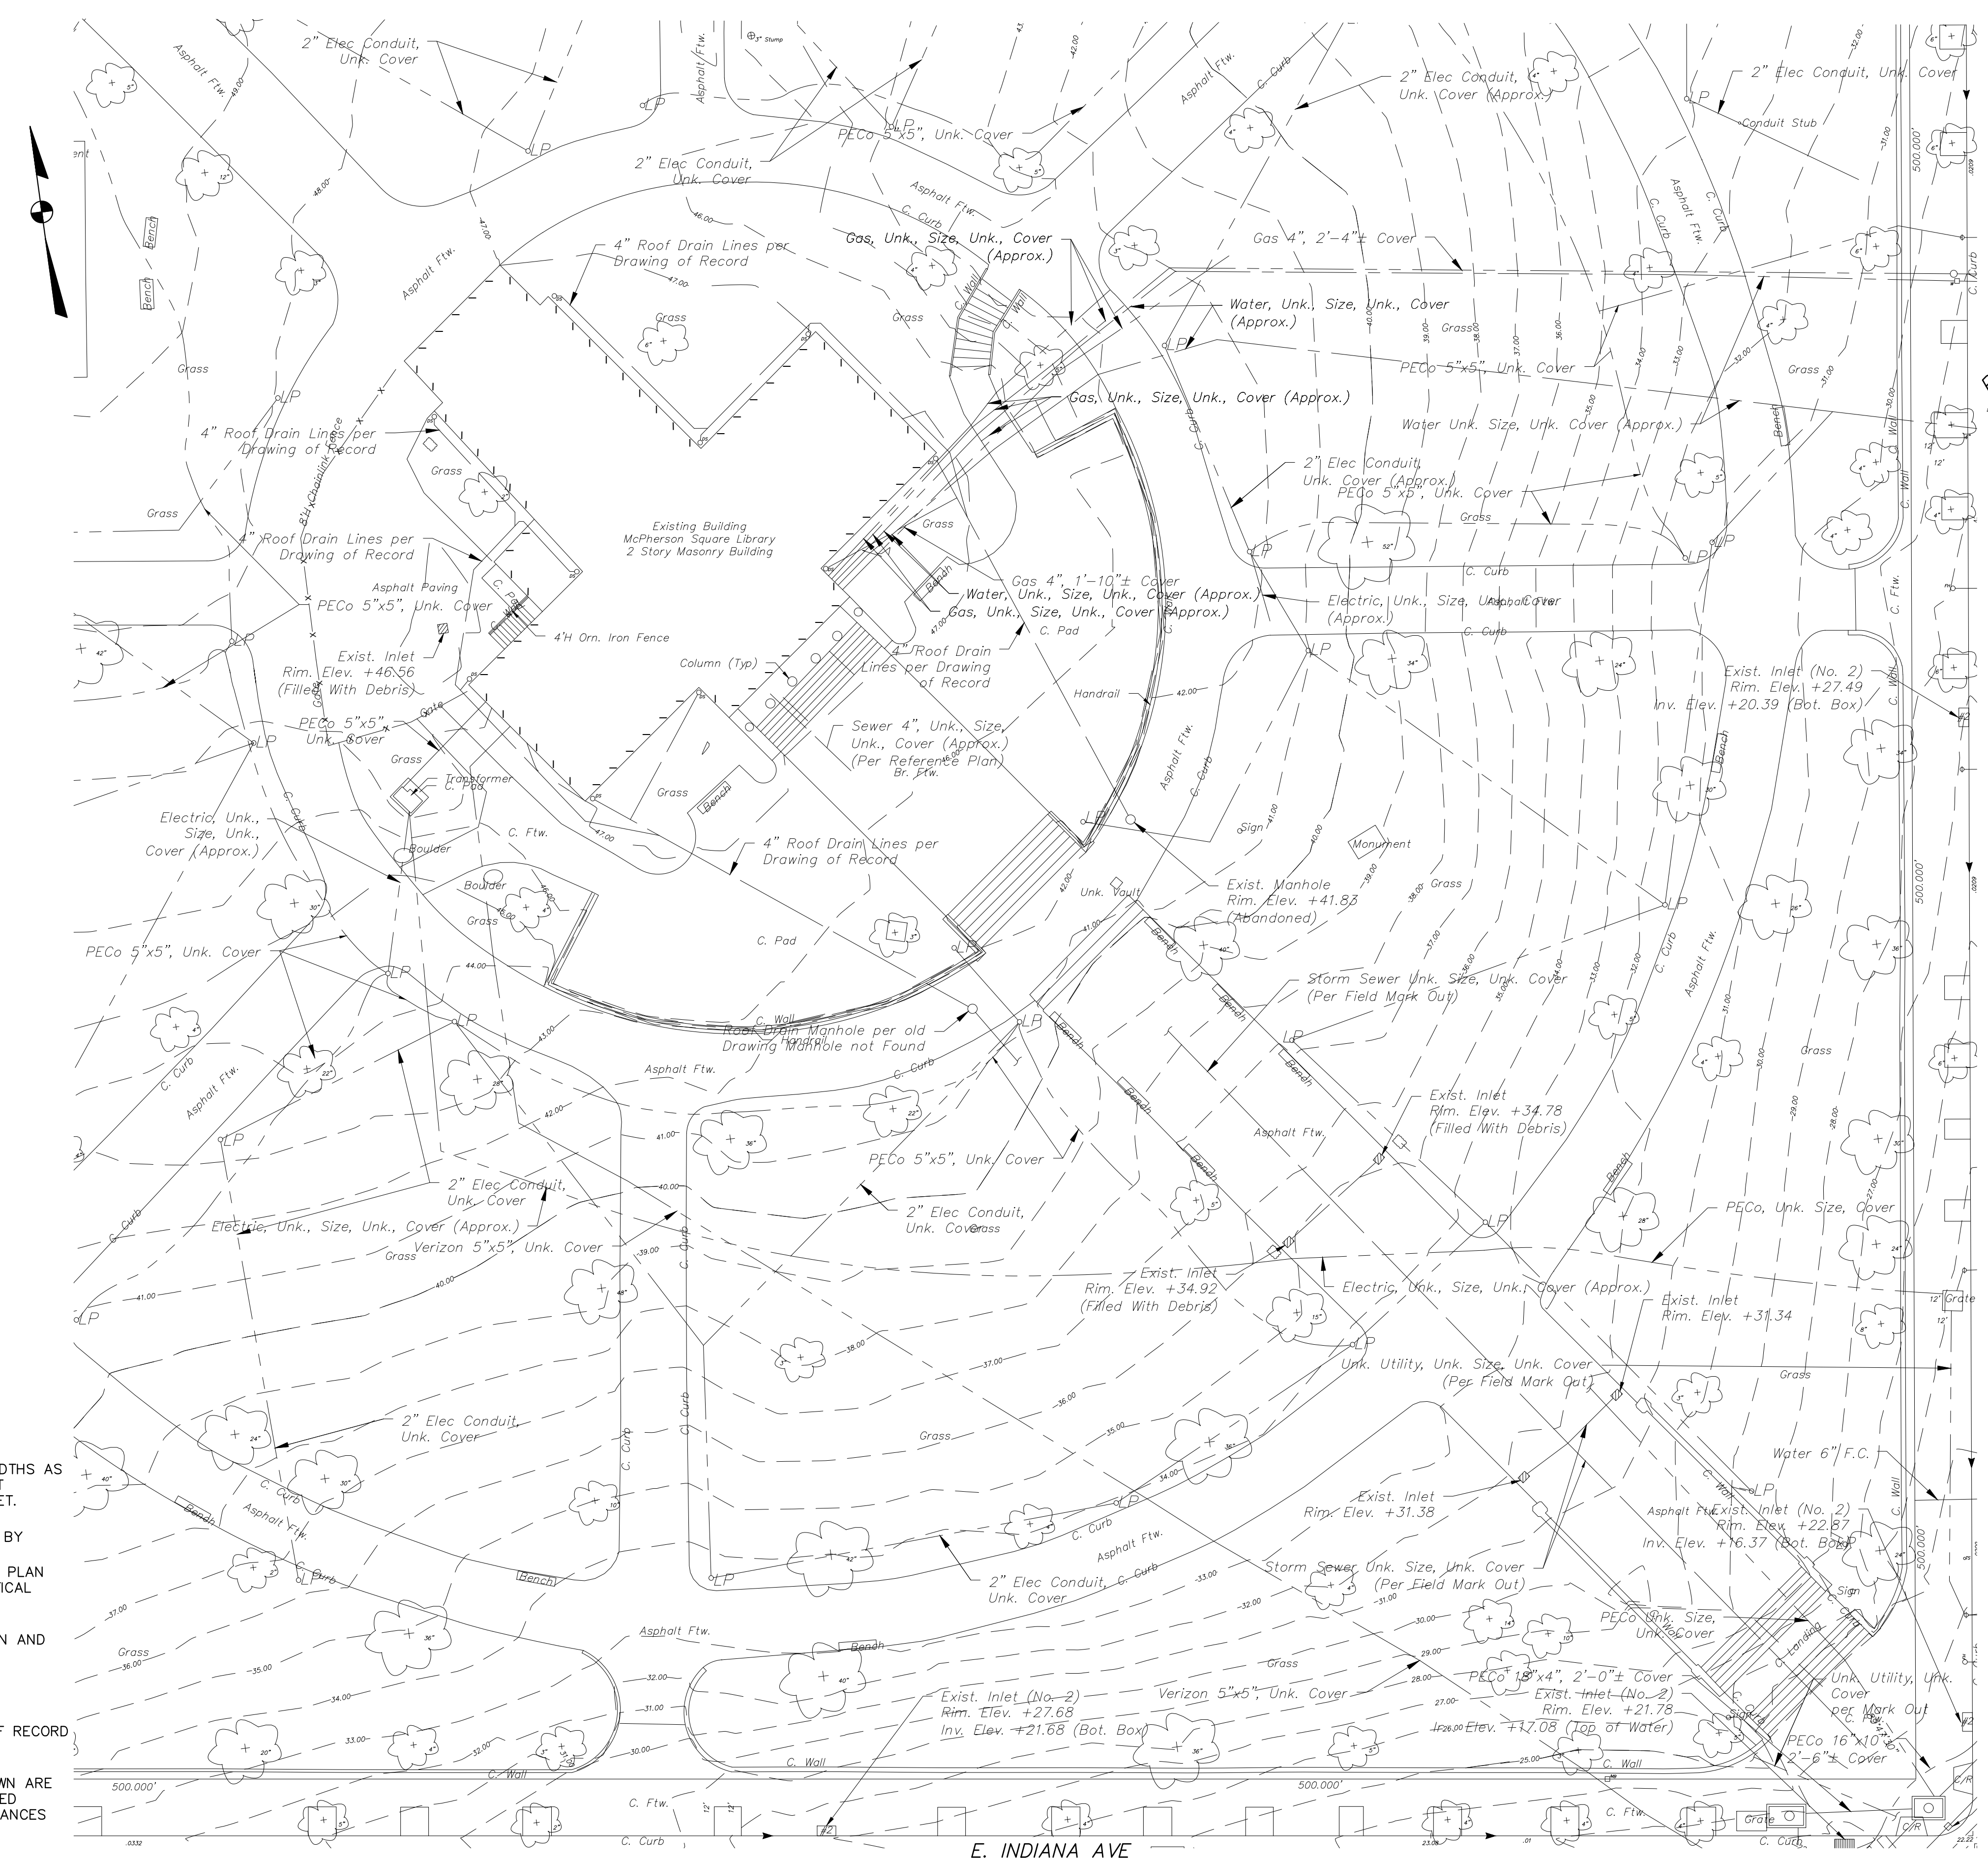
By: JH Checked: JPH Date: 04/15/2024

Drawing Title: GENERAL NOTES, ABBREVIATIONS, MATERIALS, REFERENCE SYMBOLS


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LEGEND

EXISTING	
---	PROPERTY LINES
---	CONTOUR LINE
G	GAS LINE
W	POTABLE WATER
---	SEWER (COMBINED)
S	SANITARY SEWER
D	STORM DRAIN
T	TELECOM CONDUIT
E	ELECTRIC CONDUIT
OHW	ELECTRIC OVERHEAD LINE
X	CHAIN LINK FENCE
□	METAL FENCE
□	CURB
⊙	UNKNOWN MANHOLE
⊙	TELEPHONE MANHOLE
⊙	SANITARY MANHOLE
⊙	WATER MANHOLE
⊙	WATER VALVE
⊙	OIL FILL VALVE
⊙	FRESH AIR INLET
⊙	FIRE HYDRANT
⊙	UTILITY POLE/STREET LIGHT
⊙	LIGHTPOLE
⊙	TRAFFIC SIGNAL
⊙	INLET
⊙	AREA DRAIN
⊙	SIGN
⊙	TREE
⊙	FLAG POLE



- GENERAL NOTES:**
- PROPERTY DIMENSIONS ARE PER DEEDS OF RECORD AND STREET WIDTHS AS PER CITY PLAN NO. 18 AND ARE SHOWN IN PHILADELPHIA DISTRICT STANDARD. ALL OTHER DIMENSIONS ARE SHOWN IN U.S. SURVEY FEET.
 - SURVEY INFORMATION OBTAINED FROM A FIELD SURVEY PERFORMED BY RODRIGUEZ CONSULTING, LLC ON 02/19/2020. SURVEY BASED ON P.A.S.P.C.S. (SOUTH ZONE) NAD83. BEARINGS SHOWN ARE PER CITY PLAN AND DEED OF RECORD. ELEVATIONS ARE REFERENCED TO CITY VERTICAL DATUM.
 - EXISTING SITE CONDITIONS AND PROPERTY LINE ARE BASED ON PLAN AND SURVEY BY OTHERS:
PLAN REFERENCE:
#1 - PWD GSI PROJECT #50120, RECEIVED 11/26/2019
 - SUBJECT TO ALL RESTRICTIONS, EASEMENTS AND/OR COVENANTS OF RECORD EITHER WRITTEN OR IMPLIED THAT MAY NOT APPEAR OF THIS PLAN.
 - IF BUILDINGS ARE ON THIS PLAN, BUILDING OFFSET DISTANCES SHOWN ARE FOR THE PURPOSE OF CHECKING COMPLIANCE WITH ZONING AND DEED RESTRICTIONS ONLY. NO LIABILITY WILL BE ACCEPTED IF THESE DISTANCES ARE USED FOR ANY OTHER PURPOSES.
 - UNDERGROUND UTILITIES AS SHOWN TAKEN FROM FIELD EVIDENCE AND PLANS AS PROVIDED BY THE VARIOUS UTILITY AUTHORITIES (PA ONE CALL SERIAL NO. 20200520979). THE ACCURACY REGARDING UTILITY LOCATION AND/OR DEPTH CANNOT BE GUARANTEED AND ADDITIONAL UNDERGROUND UTILITIES NOT DEPICTED ON THIS PLAN MAY EXIST. BEFORE EXCAVATIONS ARE BEGUN, THE PENNSYLVANIA ONE CALL SYSTEM AT 1-800-242-1776 SHALL BE CONTACTED AT LEAST 3-10 DAYS PRIOR TO COMMENCEMENT OF ANY DEMOLITION OR EXCAVATION ACTIVITIES IN ACCORDANCE WITH ALL APPLICABLE LAWS, RULES AND REGULATIONS.
 - INFORMATION PERTAINING TO LOTS OTHER THAN THE SUBJECT PARCEL IS SHOWN FOR INFORMATIONAL PURPOSES ONLY.
 - PROJECT SITE IS LOCATED WITHIN THE SP-PO-A DISTRICT.

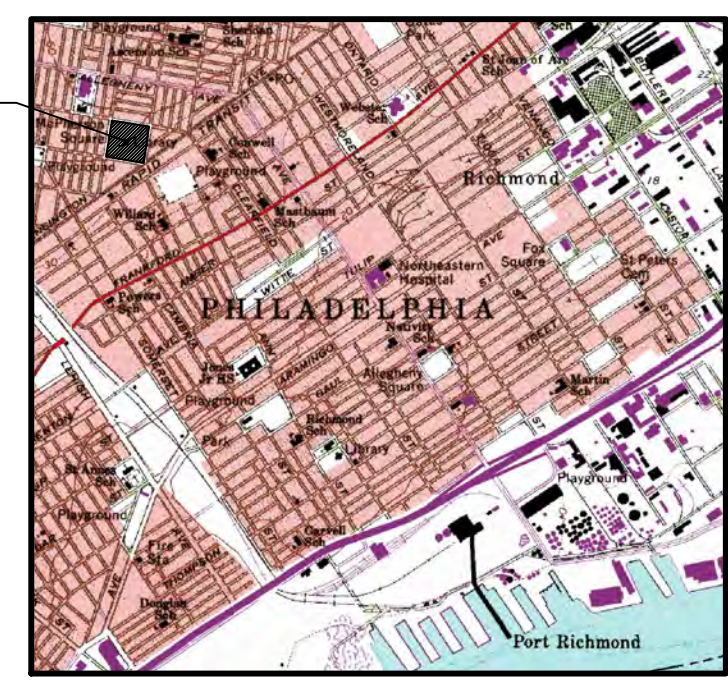

VICINITY MAP
DELAWARE DIRECT WATERSHED (SOUTH)
MANAGEMENT DISTRICT A
SCALE 1"=100'



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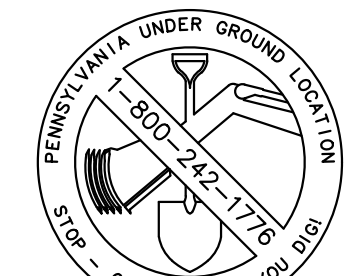
POTTER STREET
LEGALLY OPEN ON CITY PLAN
(50' WIDE R.O.W.)
(18'-14'-8")

F STREET
LEGALLY OPEN ON CITY PLAN
(50' WIDE R.O.W.)
(12'-26'-12")

KENSINGTON AVE
LEGALLY OPEN ON CITY PLAN
(70' WIDE R.O.W.)
(13'-04'-35")


E. INDIANA AVE
LEGALLY OPEN ON CITY PLAN
(50' WIDE R.O.W.)
(12'-26'-26")

PROTECT YOURSELF



WHAT YOU DON'T KNOW CAN HURT YOU.
CALL BEFORE YOU DIG!
PENNSYLVANIA LAW REQUIRES 3 WORKING DAYS NOTICE FOR CONSTRUCTION PHASE & 10 WORKING DAYS IN DESIGN STAGE
Pennsylvania One Call System, Inc.
1-800-242-1776

ACT 187	
IT IS THE CONTRACTOR'S RESPONSIBILITY TO COMPLY WITH THE PENNSYLVANIA ACT 187 AND TO CONTACT THE "ONE CALL SYSTEM" THREE (3) WORKING DAYS (UNLESS OTHERWISE NOTED) PRIOR TO START OF CONSTRUCTION.	
PENNSYLVANIA ONE CALL: 1-800-242-1776	
PHILADELPHIA WATER DEPARTMENT 1101 MARKET STREET, 2ND FLOOR PHILADELPHIA, PENNSYLVANIA (215) 685-6270	VERIZON 900 RACE STREET PHILADELPHIA, PENNSYLVANIA 19107 (215) 351-8947
PHILADELPHIA GAS WORKS 800 W. MONTGOMERY AVENUE, 3RD FLOOR PHILADELPHIA, PENNSYLVANIA 19122 (215) 684-6796	COMCAST 1351 S. COLUMBUS BOULEVARD PHILADELPHIA, PENNSYLVANIA 19147 (215) 952-4935
PECO-CONSTRUCTION DEPARTMENT 2301 MARKET STREET PHILADELPHIA, PENNSYLVANIA 19103 (215) 731-3264	

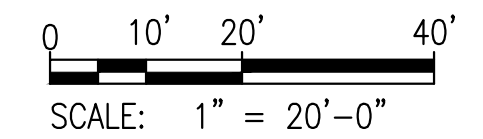

EXISTING SITE PLAN

Date: 04/15/2024

Drawing Title:
C1.0

Drawing No.:

LEGEND


EXISTING	
---	PROPERTY LINES
- - -	CONTOUR LINE
G	GAS LINE
W	POTABLE WATER
- - - S - - -	SEWER (COMBINED)
- - - S - - -	SANITARY SEWER
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- - - E - - -	ELECTRIC CONDUIT
OHW OHW OHW	ELECTRIC OVERHEAD LINE
X X X	CHAIN LINK FENCE
□ □ □	METAL FENCE
□	CURB
⊙	UNKNOWN MANHOLE
⊙	TELEPHONE MANHOLE
⊙	SANITARY MANHOLE
⊙	WATER MANHOLE
⊙	WATER VALVE
⊙	OIL FILL VALVE
⊙	FRESH AIR INLET
⊙	FIRE HYDRANT
⊙	UTILITY POLE/STREET LIGHT
⊙	LIGHTPOLE
⊙	TRAFFIC SIGNAL
⊙	INLET
⊙	AREA DRAIN
⊙	SIGN
⊙	TREE
⊙	FLAG POLE

DEMOLITION LEGEND


---	SAWCUT PAVEMENT LINE
---	EX. CONC. CURB TO BE REMOVED
⊘	EX. PAVING TO BE REMOVED
⊘	EX. GRASS TO BE REMOVED
⊘	EX. CONCRETE TO BE REMOVED
⊘	EX. INLET/ AREA DRAIN TO BE REMOVED
⊘	EX. TREE TO BE REMOVED

DEMOLITION NOTES:

- PRIOR TO STARTING ANY DEMOLITION WORK, CONTRACTOR TO DOCUMENT EXISTING SITE CONDITIONS WITH PHOTOS.
- PRIOR TO STARTING ANY EXCAVATION, CONTRACTOR TO HAVE UNDERGROUND UTILITY LOCATION SERVICES COMPLETED WITHIN THE LIMIT OF DISTURBANCE.
- EXISTING CONCRETE AND BITUMINOUS PAVING TO BE SAW-CUT WITH A CLEAN CUT LINE TO A SUFFICIENT DEPTH TO ALLOW THE REMOVAL OF PAVING WITHOUT DISTURBING THE EXISTING PAVING THAT IS TO REMAIN
- ALL EXISTING FILL TO BE REMOVED FROM SITE IN ACCORDANCE WITH THE PA DEP MANAGEMENT OF FILL POLICY AND REGULATIONS.
- TEMPORARY 8' HIGH LOCKABLE CHAINLINK CONSTRUCTION FENCE TO BE UTILIZED IN SECURING THE WORK AREA AND BLOCK OFF ENTRANCES TO WORK AREA. CONSTRUCTION FENCE TO BE SECURED WITH THE USE OF CONCRETE BLOCKS AND TO BE LOCKED WHEN NOT IN USE. ALL CONSTRUCTION VEHICLES, EQUIPMENT, AND MATERIALS ARE TO BE KEPT INSIDE LOCKED AREA WHEN NOT IN USE.
- CONTRACTOR TO MONITOR EXISTING PARKING LOT AND PLAYGROUND AREA AT ALL TIMES TO PREVENT CONFLICT BETWEEN CONSTRUCTION VEHICLES, STAFF VEHICLES, DELIVERY TRUCKS AND PEDESTRIANS. CONTRACTOR TO REPAIR/REPLACE ANY CONCRETE, ASPHALT, LAWN OR PLANTED AREAS WITHIN THIS AREA AND WITHIN THE PUBLIC ROW THAT IS DAMAGED BY CONSTRUCTION VEHICLES DURING CONSTRUCTION.
- REMOVAL OF EXISTING TREES TO INCLUDE ALL MAJOR ROOT STRUCTURES, LOCATIONS TO BE TEMPORARILY BACKFILLED IN ACCORDANCE WITH SPECIFICATIONS.

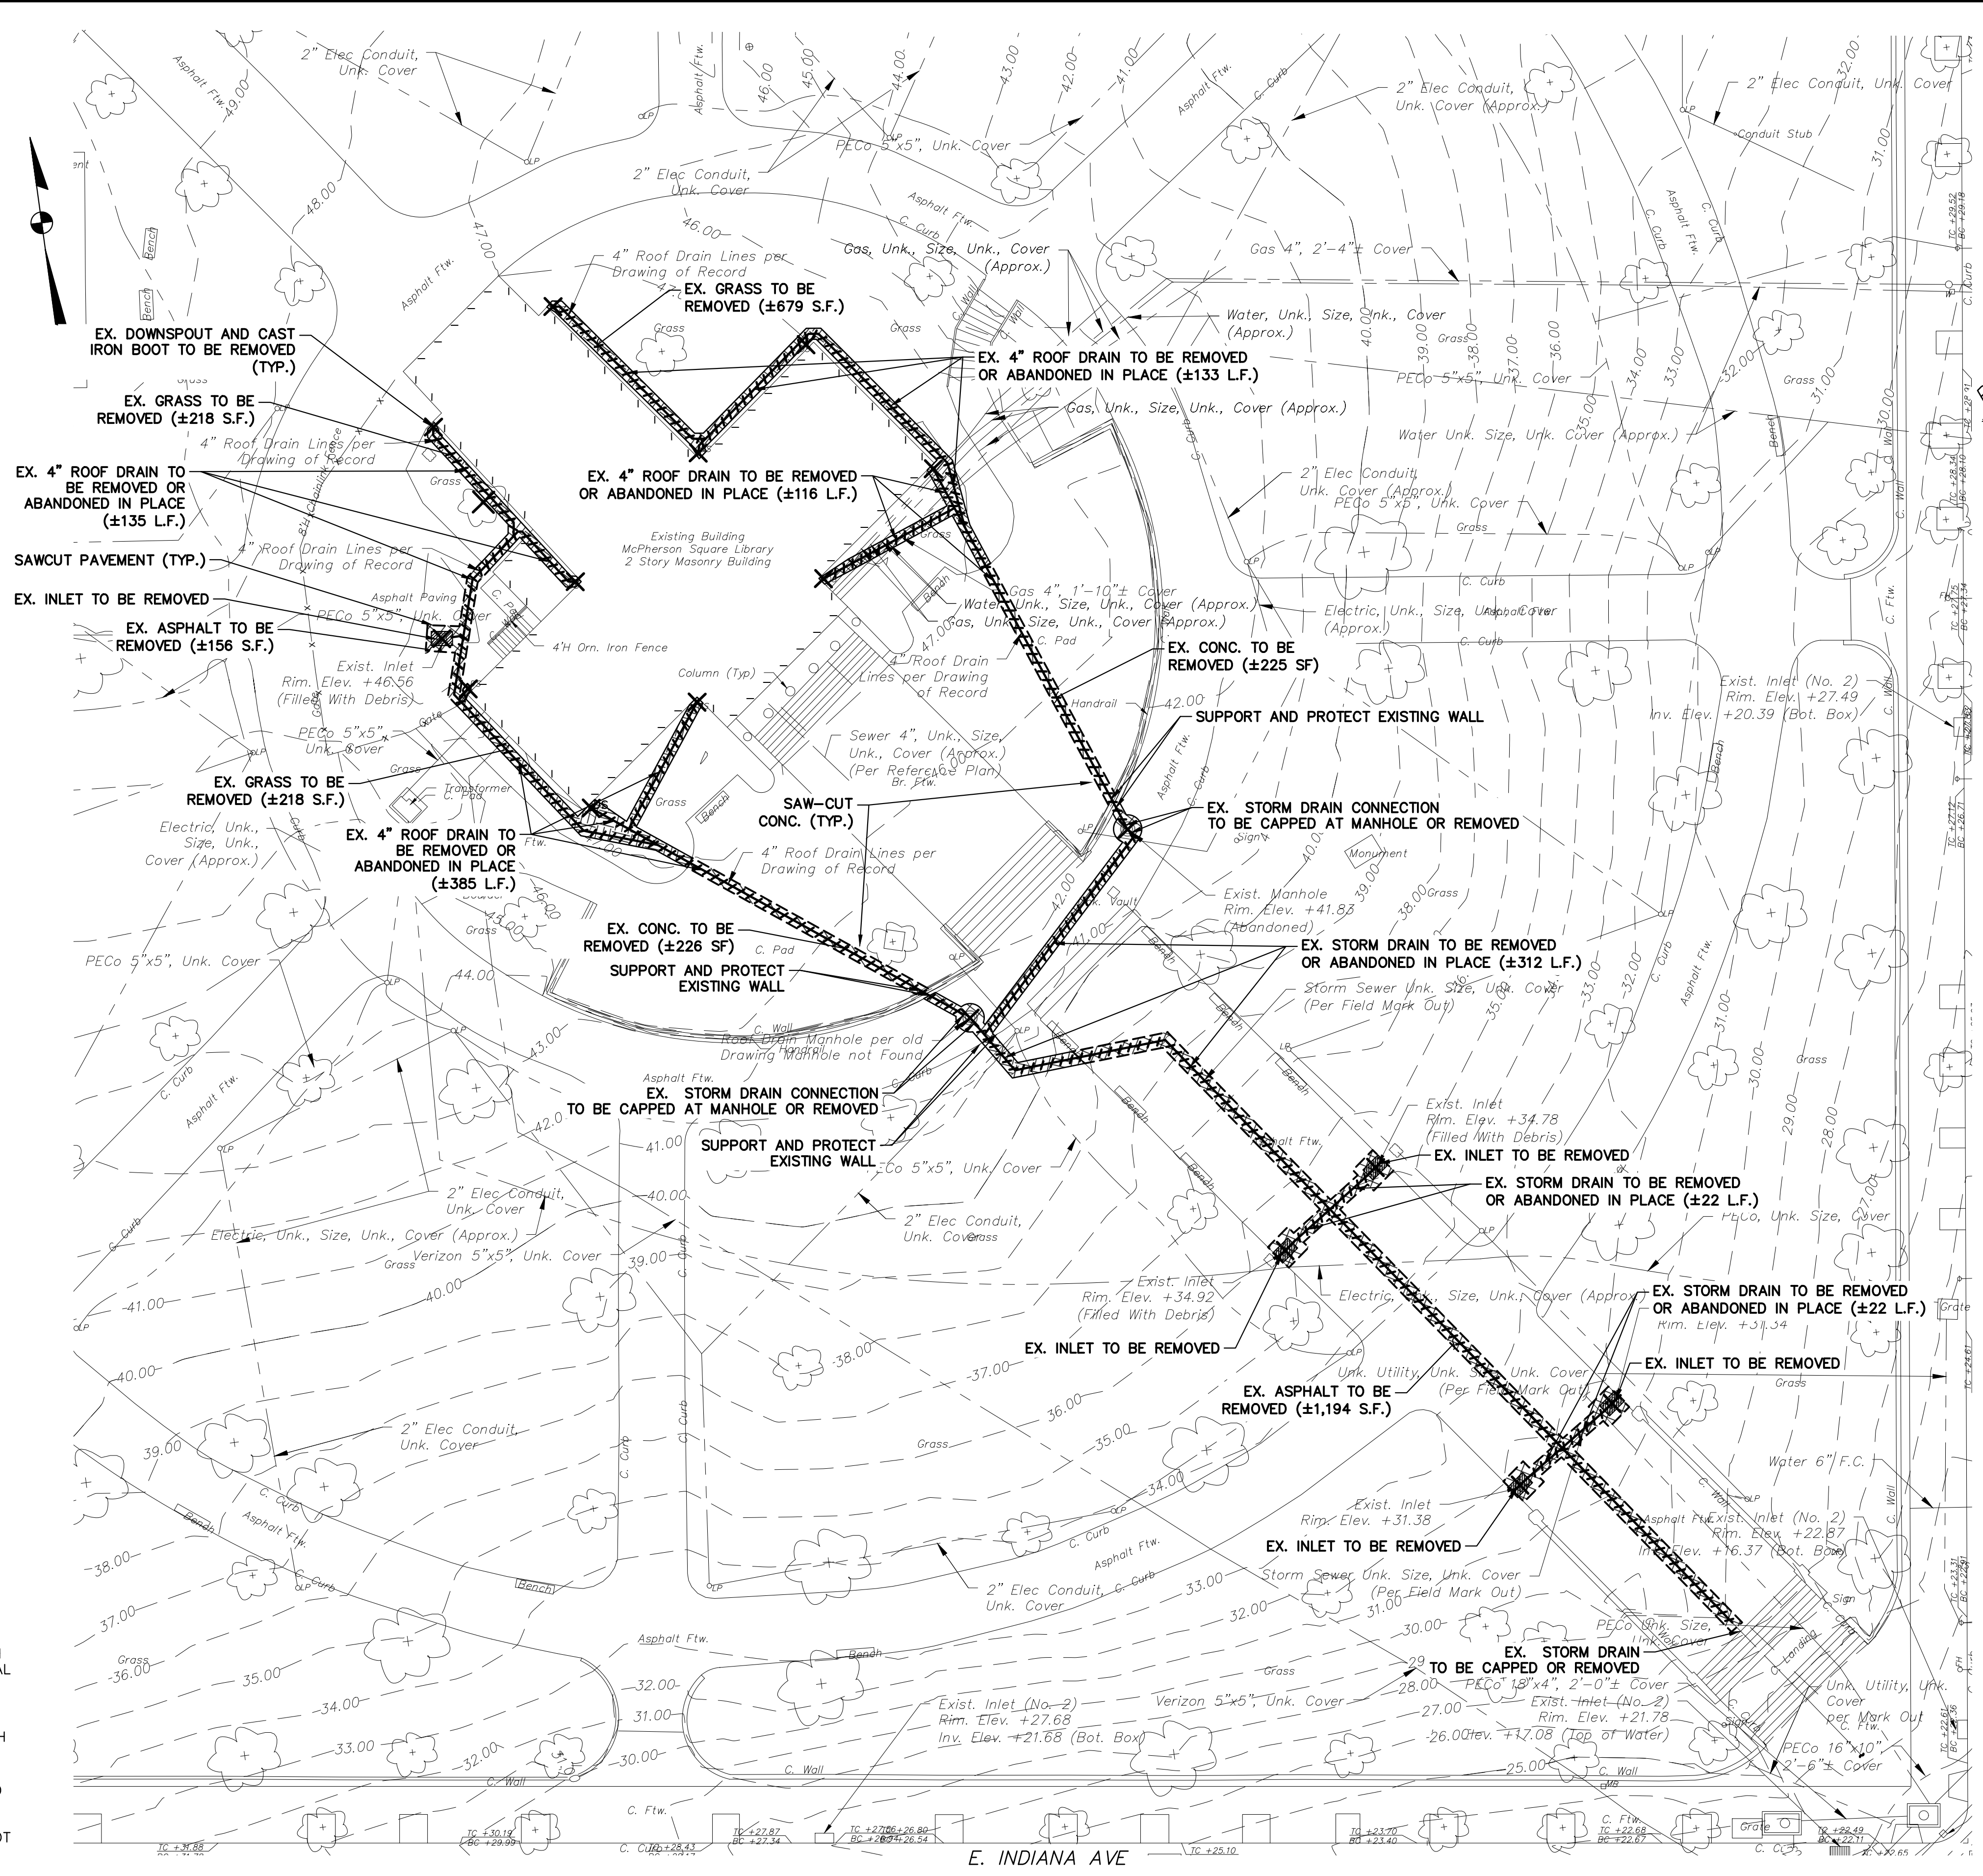

LIMIT OF DISTURBANCE (LOD) SUMMARY		
ON-SITE	2,307 S.F.	0.053 ACRES
PUBLIC R.O.W.	-	-
TOTAL	2,307 S.F.	0.053 ACRES

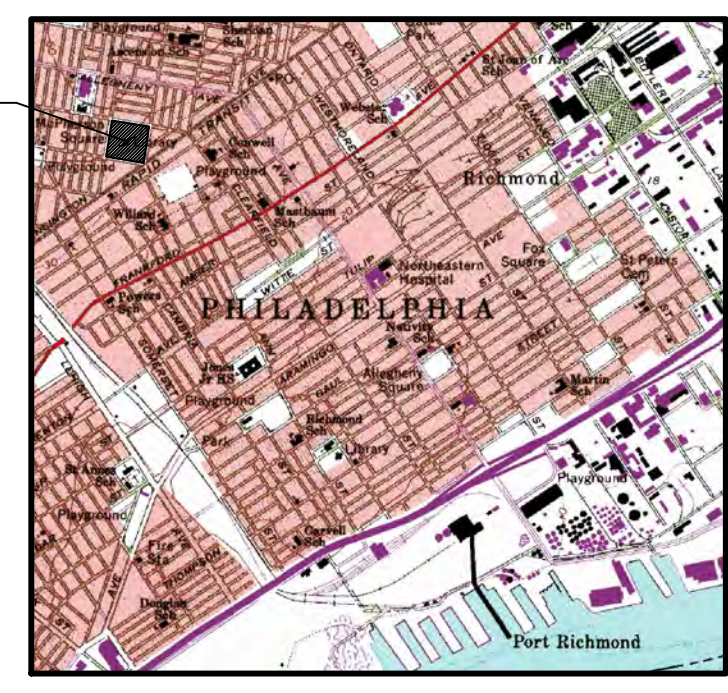

VICINITY MAP
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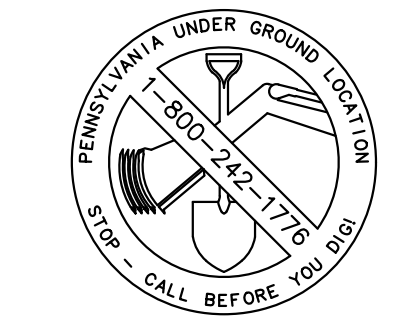
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POTTER STREET
LEGALLY OPEN ON CITY PLAN
(18'-14" R.O.W.)

F STREET
LEGALLY OPEN ON CITY PLAN
(12'-26" R.O.W.)


KENSINGTON AVE
LEGALLY OPEN ON CITY PLAN
(10'-24" R.O.W.)

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PECO-CONSTRUCTION DEPARTMENT 2301 MARKET STREET PHILADELPHIA, PENNSYLVANIA 19103 (215) 731-3264	



Seal:

Drawing Title:
DEMOLITION PLAN


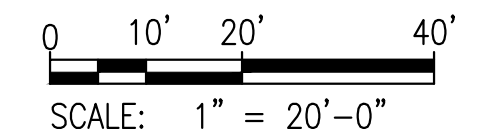
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C2.0

LEGEND

EXISTING	
---	PROPERTY LINES
---	CONTOUR LINE
G	GAS LINE
W	POTABLE WATER
---	SEWER (COMBINED)
S	SANITARY SEWER
D	STORM DRAIN
T	TELECOM CONDUIT
E	ELECTRIC CONDUIT
OHW	ELECTRIC OVERHEAD LINE
X	CHAIN LINK FENCE
□	METAL FENCE
□	CURB
○	UNKNOWN MANHOLE
○	TELEPHONE MANHOLE
○	SANITARY MANHOLE
○	WATER MANHOLE
○	WATER VALVE
○	OIL FILL VALVE
○	FRESH AIR INLET
○	FIRE HYDRANT
○	UTILITY POLE/STREET LIGHT
○	LIGHTPOLE
○	TRAFFIC SIGNAL
○	INLET
○	AREA DRAIN
○	SIGN
○	TREE
○	FLAG POLE

PROPOSED LEGEND	
---	PROPERTY LINE
---	EXISTING CONTOUR
---	PROPOSED CONTOUR
D	STORM SEWER
X	FENCE
S	SANITARY SEWER
W	WATER SERVICE
---	LIMIT OF DISTURBANCE (LOD) & DEP SITE BOUNDARY
---	ASPHALT CURB
○	INLET
○	OBSERVATION WELL
○	ROOF DRAIN
○	STORM DRAIN CLEANOUT
○	FULL DEPTH ASPHALT PAVING
○	GRASS AREA
○	CONCRETE SIDEWALK
○	LANDSCAPED AREA

- GENERAL NOTES:**
- PROPERTY DIMENSIONS ARE PER DEEDS OF RECORD AND STREET WIDTHS AS PER CITY PLAN NO. 18 AND ARE SHOWN IN PHILADELPHIA DISTRICT STANDARD. ALL OTHER DIMENSIONS ARE SHOWN IN U.S. SURVEY FEET.
 - SURVEY INFORMATION OBTAINED FROM A FIELD SURVEY PERFORMED BY RODRIGUEZ CONSULTING, LLC ON 02/19/2020. SURVEY BASED ON P.A.S.P.C.S. (SOUTH ZONE) NAD83. BEARINGS SHOWN ARE PER CITY PLAN AND DEED OF RECORD. ELEVATIONS ARE REFERENCED TO CITY VERTICAL DATUM.
 - EXISTING SITE CONDITIONS AND PROPERTY LINE ARE BASED ON PLAN AND SURVEY BY OTHERS:
PLAN REFERENCE:
#1 - PWD GSI PROJECT #50120, RECEIVED 11/26/2019
 - SUBJECT TO ALL RESTRICTIONS, EASEMENTS AND/OR COVENANTS OF RECORD EITHER WRITTEN OR IMPLIED THAT MAY NOT APPEAR OF THIS PLAN.
 - IF BUILDINGS ARE ON THIS PLAN, BUILDING OFFSET DISTANCES SHOWN ARE FOR THE PURPOSE OF CHECKING COMPLIANCE WITH ZONING AND DEED RESTRICTIONS ONLY. NO LIABILITY WILL BE ACCEPTED IF THESE DISTANCES ARE USED FOR ANY OTHER PURPOSES.
 - UNDERGROUND UTILITIES AS SHOWN TAKEN FROM FIELD EVIDENCE AND PLANS AS PROVIDED BY THE VARIOUS UTILITY AUTHORITIES (PA ONE CALL SERIAL NO. 20200520979). THE ACCURACY REGARDING UTILITY LOCATION AND/OR DEPTH CANNOT BE GUARANTEED AND ADDITIONAL UNDERGROUND UTILITIES NOT DEPICTED ON THIS PLAN MAY EXIST. BEFORE EXCAVATIONS ARE BEGUN, THE PENNSYLVANIA ONE CALL SYSTEM AT 1-800-242-1776 SHALL BE CONTACTED AT LEAST 3-10 DAYS PRIOR TO COMMENCEMENT OF ANY DEMOLITION OR EXCAVATION ACTIVITIES IN ACCORDANCE WITH ALL APPLICABLE LAWS, RULES AND REGULATIONS.
 - INFORMATION PERTAINING TO LOTS OTHER THAN THE SUBJECT PARCEL IS SHOWN FOR INFORMATIONAL PURPOSES ONLY.
 - PROJECT SITE IS LOCATED WITHIN THE SP-PO-A DISTRICT.

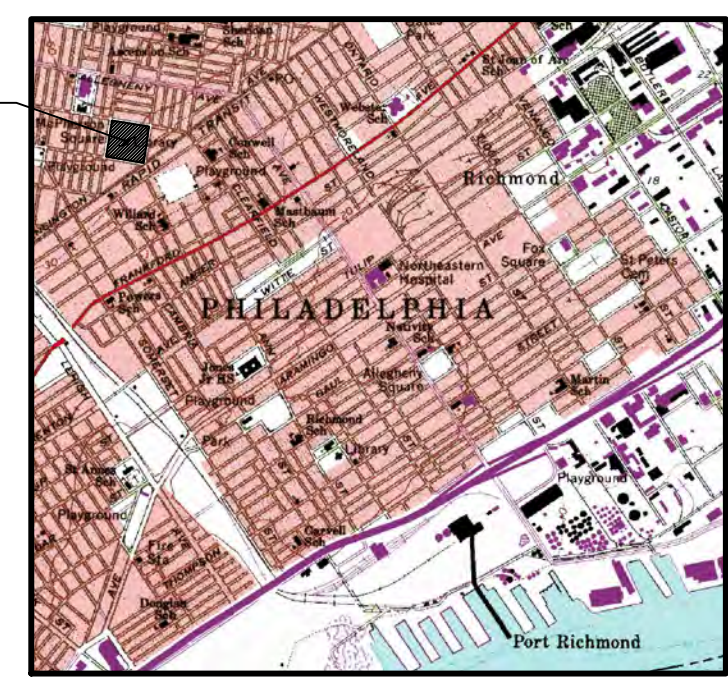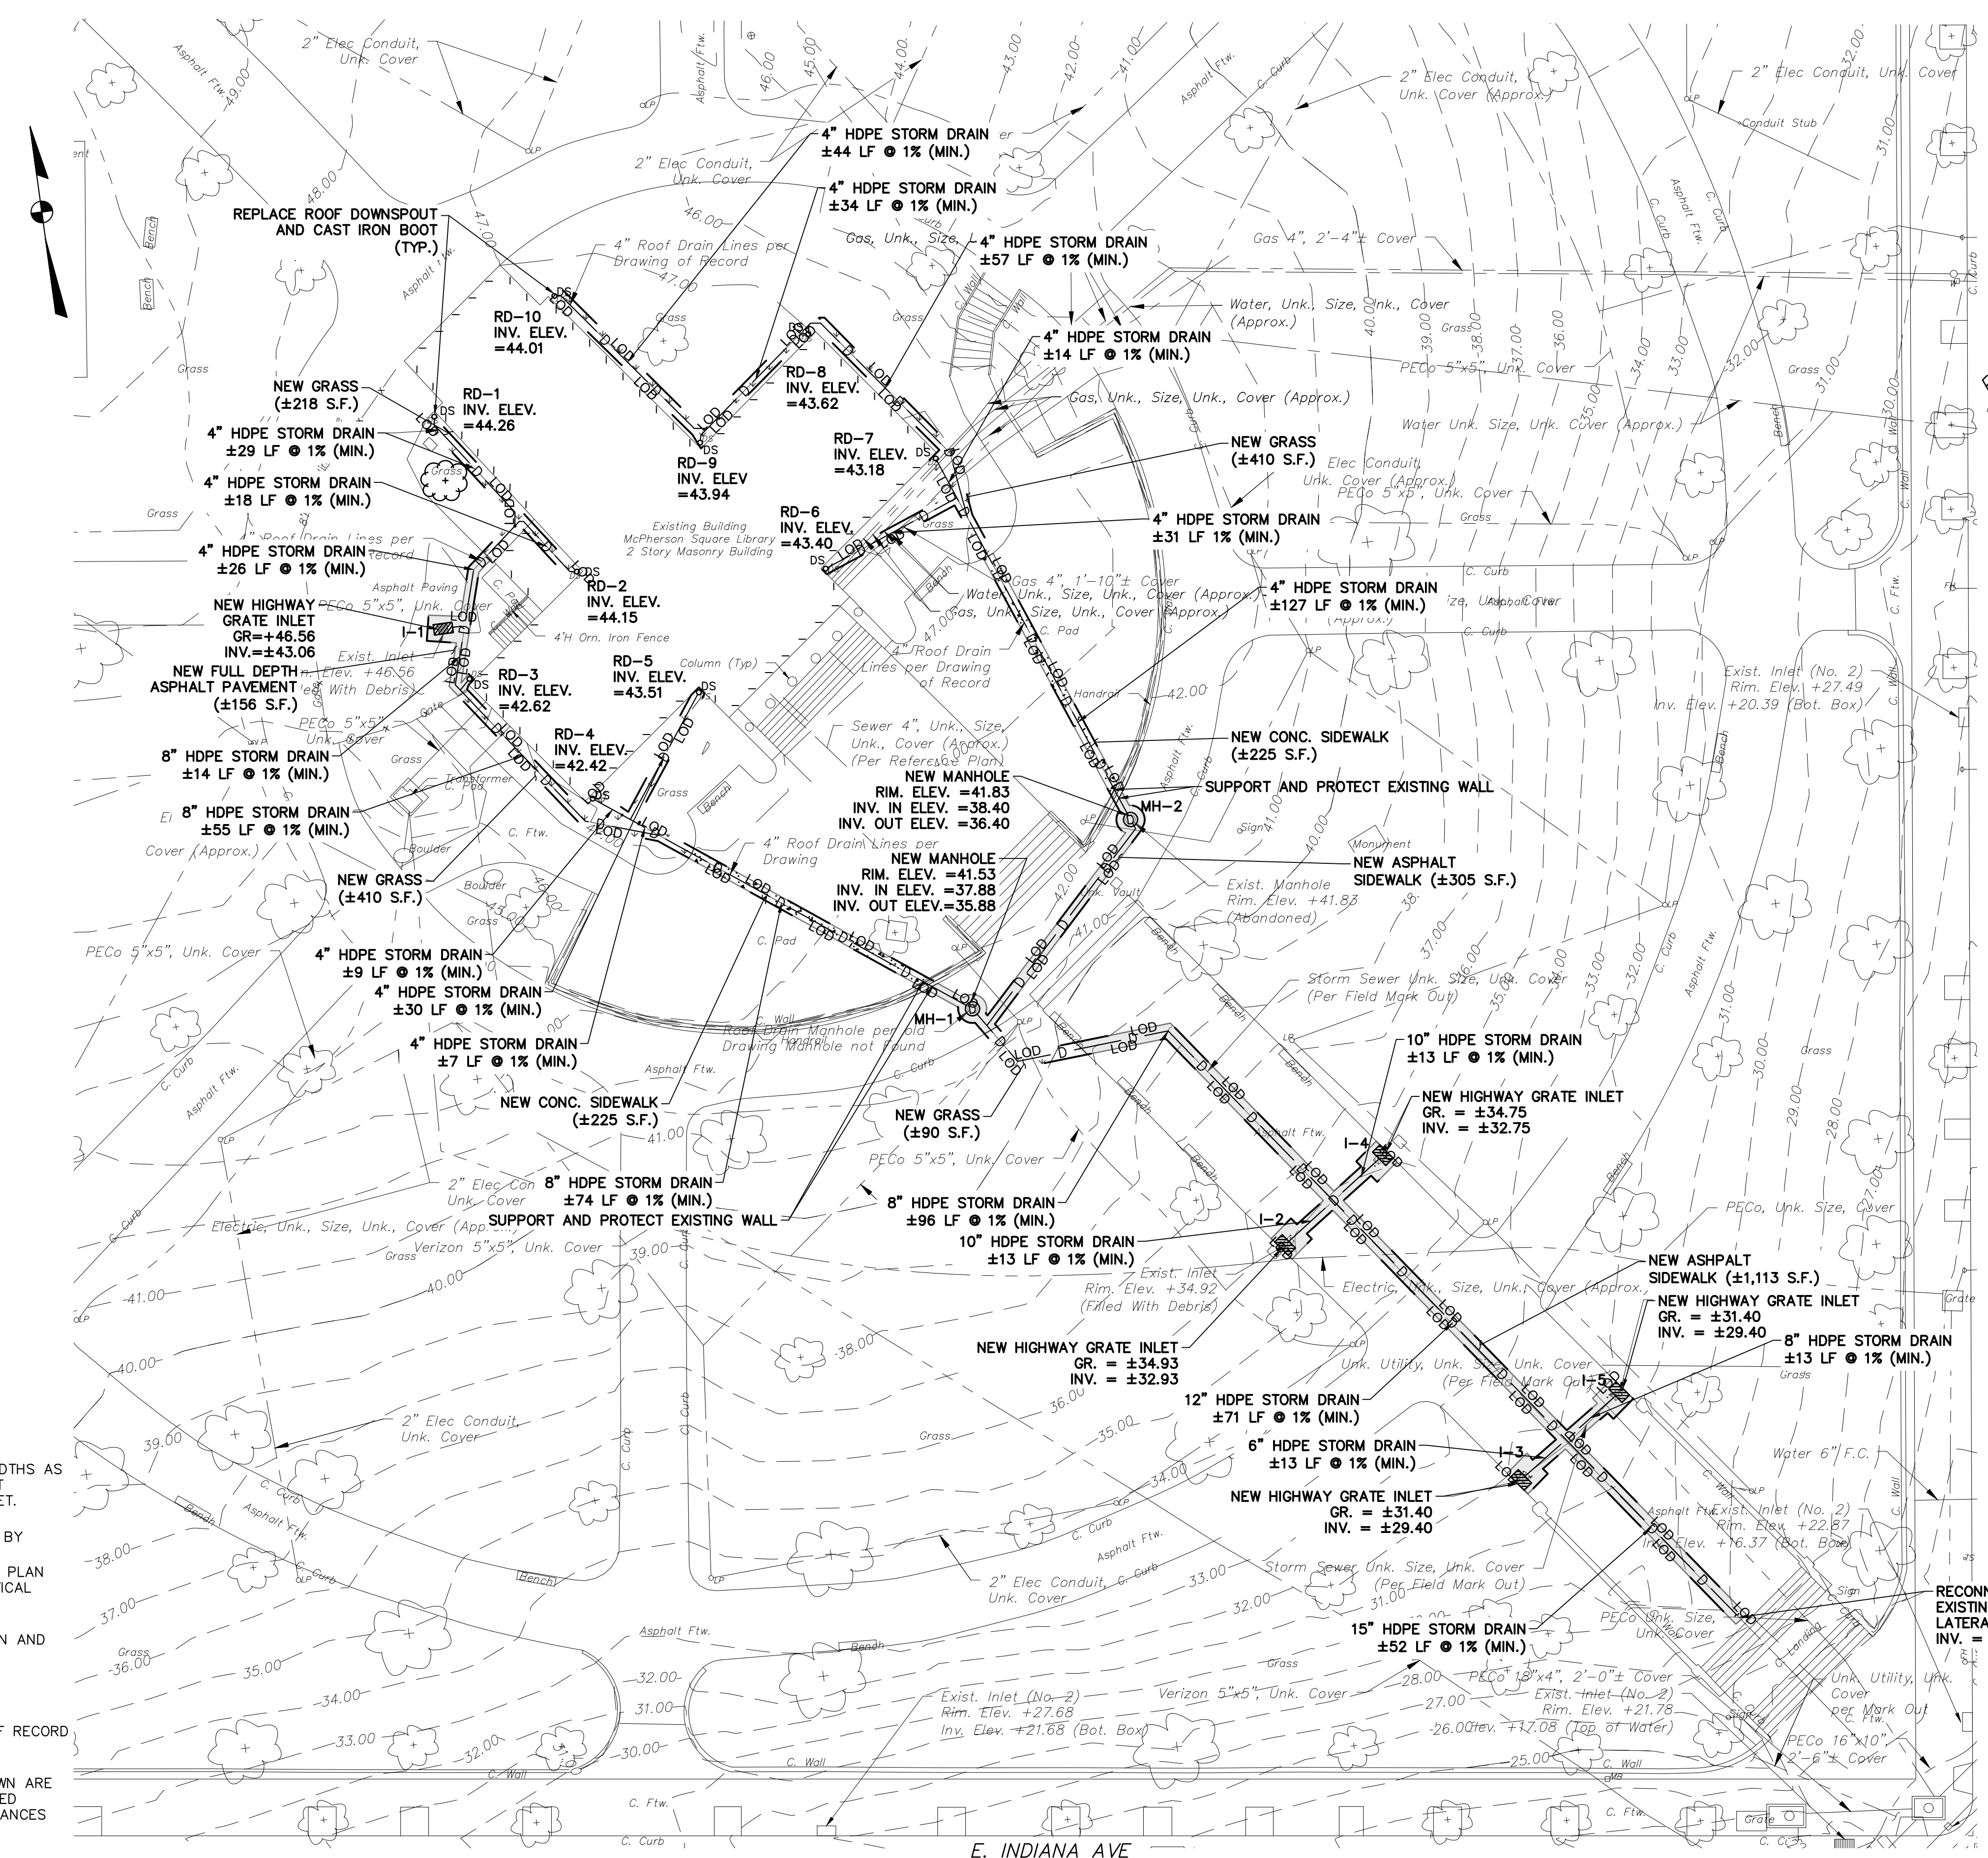

VICINITY MAP
DELAWARE DIRECT WATERSHED (SOUTH)
MANAGEMENT DISTRICT A
SCALE 1"=100'


POTTER STREET
LEGALLY OPEN ON CITY PLAN
(18-14-87)

F STREET
LEGALLY OPEN ON CITY PLAN
(12-28-12)


KENSINGTON AVE
LEGALLY OPEN ON CITY PLAN
(13-04-25)

LEGALLY OPEN ON CITY PLAN
(50' WIDE R.O.W.)
(12'-26'-26')

LIMIT OF DISTURBANCE (LOD) SUMMARY		
ON-SITE	2,307 S.F.	0.053 ACRES
PUBLIC R.O.W.	-	-
TOTAL	2,307 S.F.	0.053 ACRES

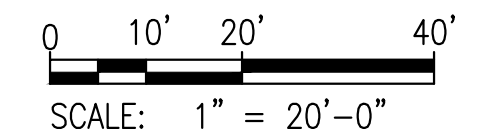

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Pennsylvania One Call System, Inc.
1-800-242-1776

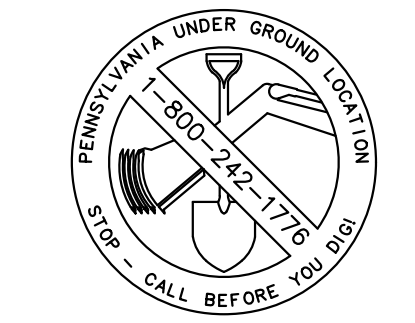ACT 187
IT IS THE CONTRACTOR'S RESPONSIBILITY TO COMPLY WITH THE PENNSYLVANIA ACT 187 AND TO CONTACT THE "ONE CALL SYSTEM" THREE (3) WORKING DAYS (UNLESS OTHERWISE NOTED) PRIOR TO START OF CONSTRUCTION.
PENNSYLVANIA ONE CALL: 1-800-242-1776

PHILADELPHIA WATER DEPARTMENT 1101 MARKET STREET, 2ND FLOOR PHILADELPHIA, PENNSYLVANIA (215) 685-6270	VERIZON 900 RACE STREET PHILADELPHIA, PENNSYLVANIA 19107 (215) 351-8947
PHILADELPHIA GAS WORKS 800 W. MONTGOMERY AVENUE, 3RD FLOOR PHILADELPHIA, PENNSYLVANIA 19122 (215) 684-6796	COMCAST 1351 S. COLUMBUS BOULEVARD PHILADELPHIA, PENNSYLVANIA 19147 (215) 952-4935
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Wayne, PA 19087
610.688.2566

ROOFING CONSULTANT:
Steve McLaughlin
210 Garden Avenue
Somerset, NJ 08083
856.287.2424

Seal:

Drawing Title:
PROPOSED SITE PLAN

Drawing No.:
C3.0

LEGEND


EXISTING	
---	PROPERTY LINES
- - -	CONTOUR LINE
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W	POTABLE WATER
- - -	SEWER (COMBINED)
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○	LIGHTPOLE
○	TRAFFIC SIGNAL
○	INLET
○	AREA DRAIN
○	SIGN
○	TREE
○	FLAG POLE

EROSION & SEDIMENT CONTROL LEGEND


○-○-○-○-○	COMPOST FILTER SOCK, 12" DIAMETER
X-X-X-X-X	SAFETY FENCE
□-□-□-□-□	TREE PROTECTION FENCE
- - - - -	LIMIT OF DISTURBANCE (LOD)
▨	RUMBLE PAD CONSTRUCTION ENTRANCE
⊗	FILTER BAG INLET PROTECTION

EROSION AND SEDIMENT CONTROL (E&S) NOTES:

- EXISTING CONCRETE AND BITUMINOUS PAVING TO BE SAW-CUT ALONG LIMIT OF DISTURBANCE LINE WITH A CLEAN CUT LINE TO A SUFFICIENT DEPTH TO ALLOW THE REMOVAL OF PAVING WITHOUT DISTURBING THE EXISTING PAVING THAT IS TO REMAIN
- THE CONTRACTOR SHALL REMOVE FROM THE SITE ALL DEBRIS, RUBBISH AND OTHER MATERIALS RESULTING FROM DEMOLITION AND SHALL SAFELY AND LEGALLY DISPOSE OF ALL THESE ITEMS IN ACCORDANCE WITH APPLICABLE LOCAL, FEDERAL, STATE AND REGULATORY AUTHORITY HAVING JURISDICTION. RECYCLING MUST BE DONE IN ACCORDANCE WITH APPLICABLE REGULATIONS. BURNING OF ANY DEMOLISHED MATERIALS ON-SITE SHALL NOT BE PERMITTED. RECYCLING OF DEMOLITION DEBRIS SHALL BE APPROVED BY THE OWNER. ALL EXISTING FILL TO BE REMOVED FROM SITE IN ACCORDANCE WITH THE PA DEP MANAGEMENT OF FILL POLICY AND REGULATIONS.
- COMPOST FILTER SOCK ON PAVING TO BE WEIGHTED DOWN BY OBJECTS OF CONSIDERABLE MASS (SAND BAGS, CONCRETE BLOCK OR OTHER SUITABLE MATERIAL). COMPOST FILTER SOCK TO BE INSTALLED DOWNSTREAM OF ALL EARTH MOVING ACTIVITIES.
- RUMBLE PAD CONSTRUCTION ENTRANCE TO BE SIZED IN ACCORDANCE WITH PA DEP MINIMUM REQUIREMENTS OF 50' X 20'W AND BE INSTALLED IN ACCORDANCE WITH MANUFACTURERS RECOMMENDATIONS.
- CONSTRUCTION, DEMOLITION AND EARTHWORK DUST CONTROL TO BE COMPLETED IN ACCORDANCE WITH THE CITY OF PHILADELPHIA DUST CONTROL REQUIREMENTS (AIR MANAGEMENT REGULATION (AMR) II, SECTION IX.) AND TO INCLUDE BUT NOT LIMITED TO:
 - NOTIFY OCCUPANTS OF NEARBY PROPERTIES, IN WRITING 10 DAYS BEFORE ENGAGING IN EARTHWORK, CONSTRUCTION AND DEMOLITION ACTIVITIES.
 - USE OF VACUUM OR SIMILAR SUCTION SYSTEMS TO CAPTURE DUST KICKED UP BY POWER TOOLS WHEN GRINDING OR CUTTING.
 - APPLICATION OF WATER OR APPROVED DUST CONTROL SUPPRESSANT DURING EXCAVATION, DEMOLITION AND/OR CONSTRUCTION TO SUPPRESS DUST FORMATION.
 - COVERING AND WETTING OF STOCKPILES EARTH, SAND, GRAVEL AND OTHER SIMILAR CONSTRUCTION MATERIALS.
 - ALL PERIMETER FENCING MUST HAVE DUST CONTROL FABRIC AND MUST MEASURE A MINIMUM OF 5 FT IN HEIGHT FROM THE BOTTOM OF FENCING.
 - 10 MILE PER HOUR SPEED LIMIT FOR ALL EQUIPMENT AND TRUCKS TRAVELING WITHIN THE WORK SITE.
 - WETTING AND SWEEPING OF ROADWAYS / ACCESS ROAD IN A WORK SITE TO PREVENT DUST FORMATION.
- PERMANENT INLET PROTECTION TO BE INSTALLED ON ALL INLETS THAT DRAIN TO THE UNDERGROUND STORMWATER MANAGEMENT SYSTEMS IN ACCORDANCE WITH THE SPECIFICATIONS.

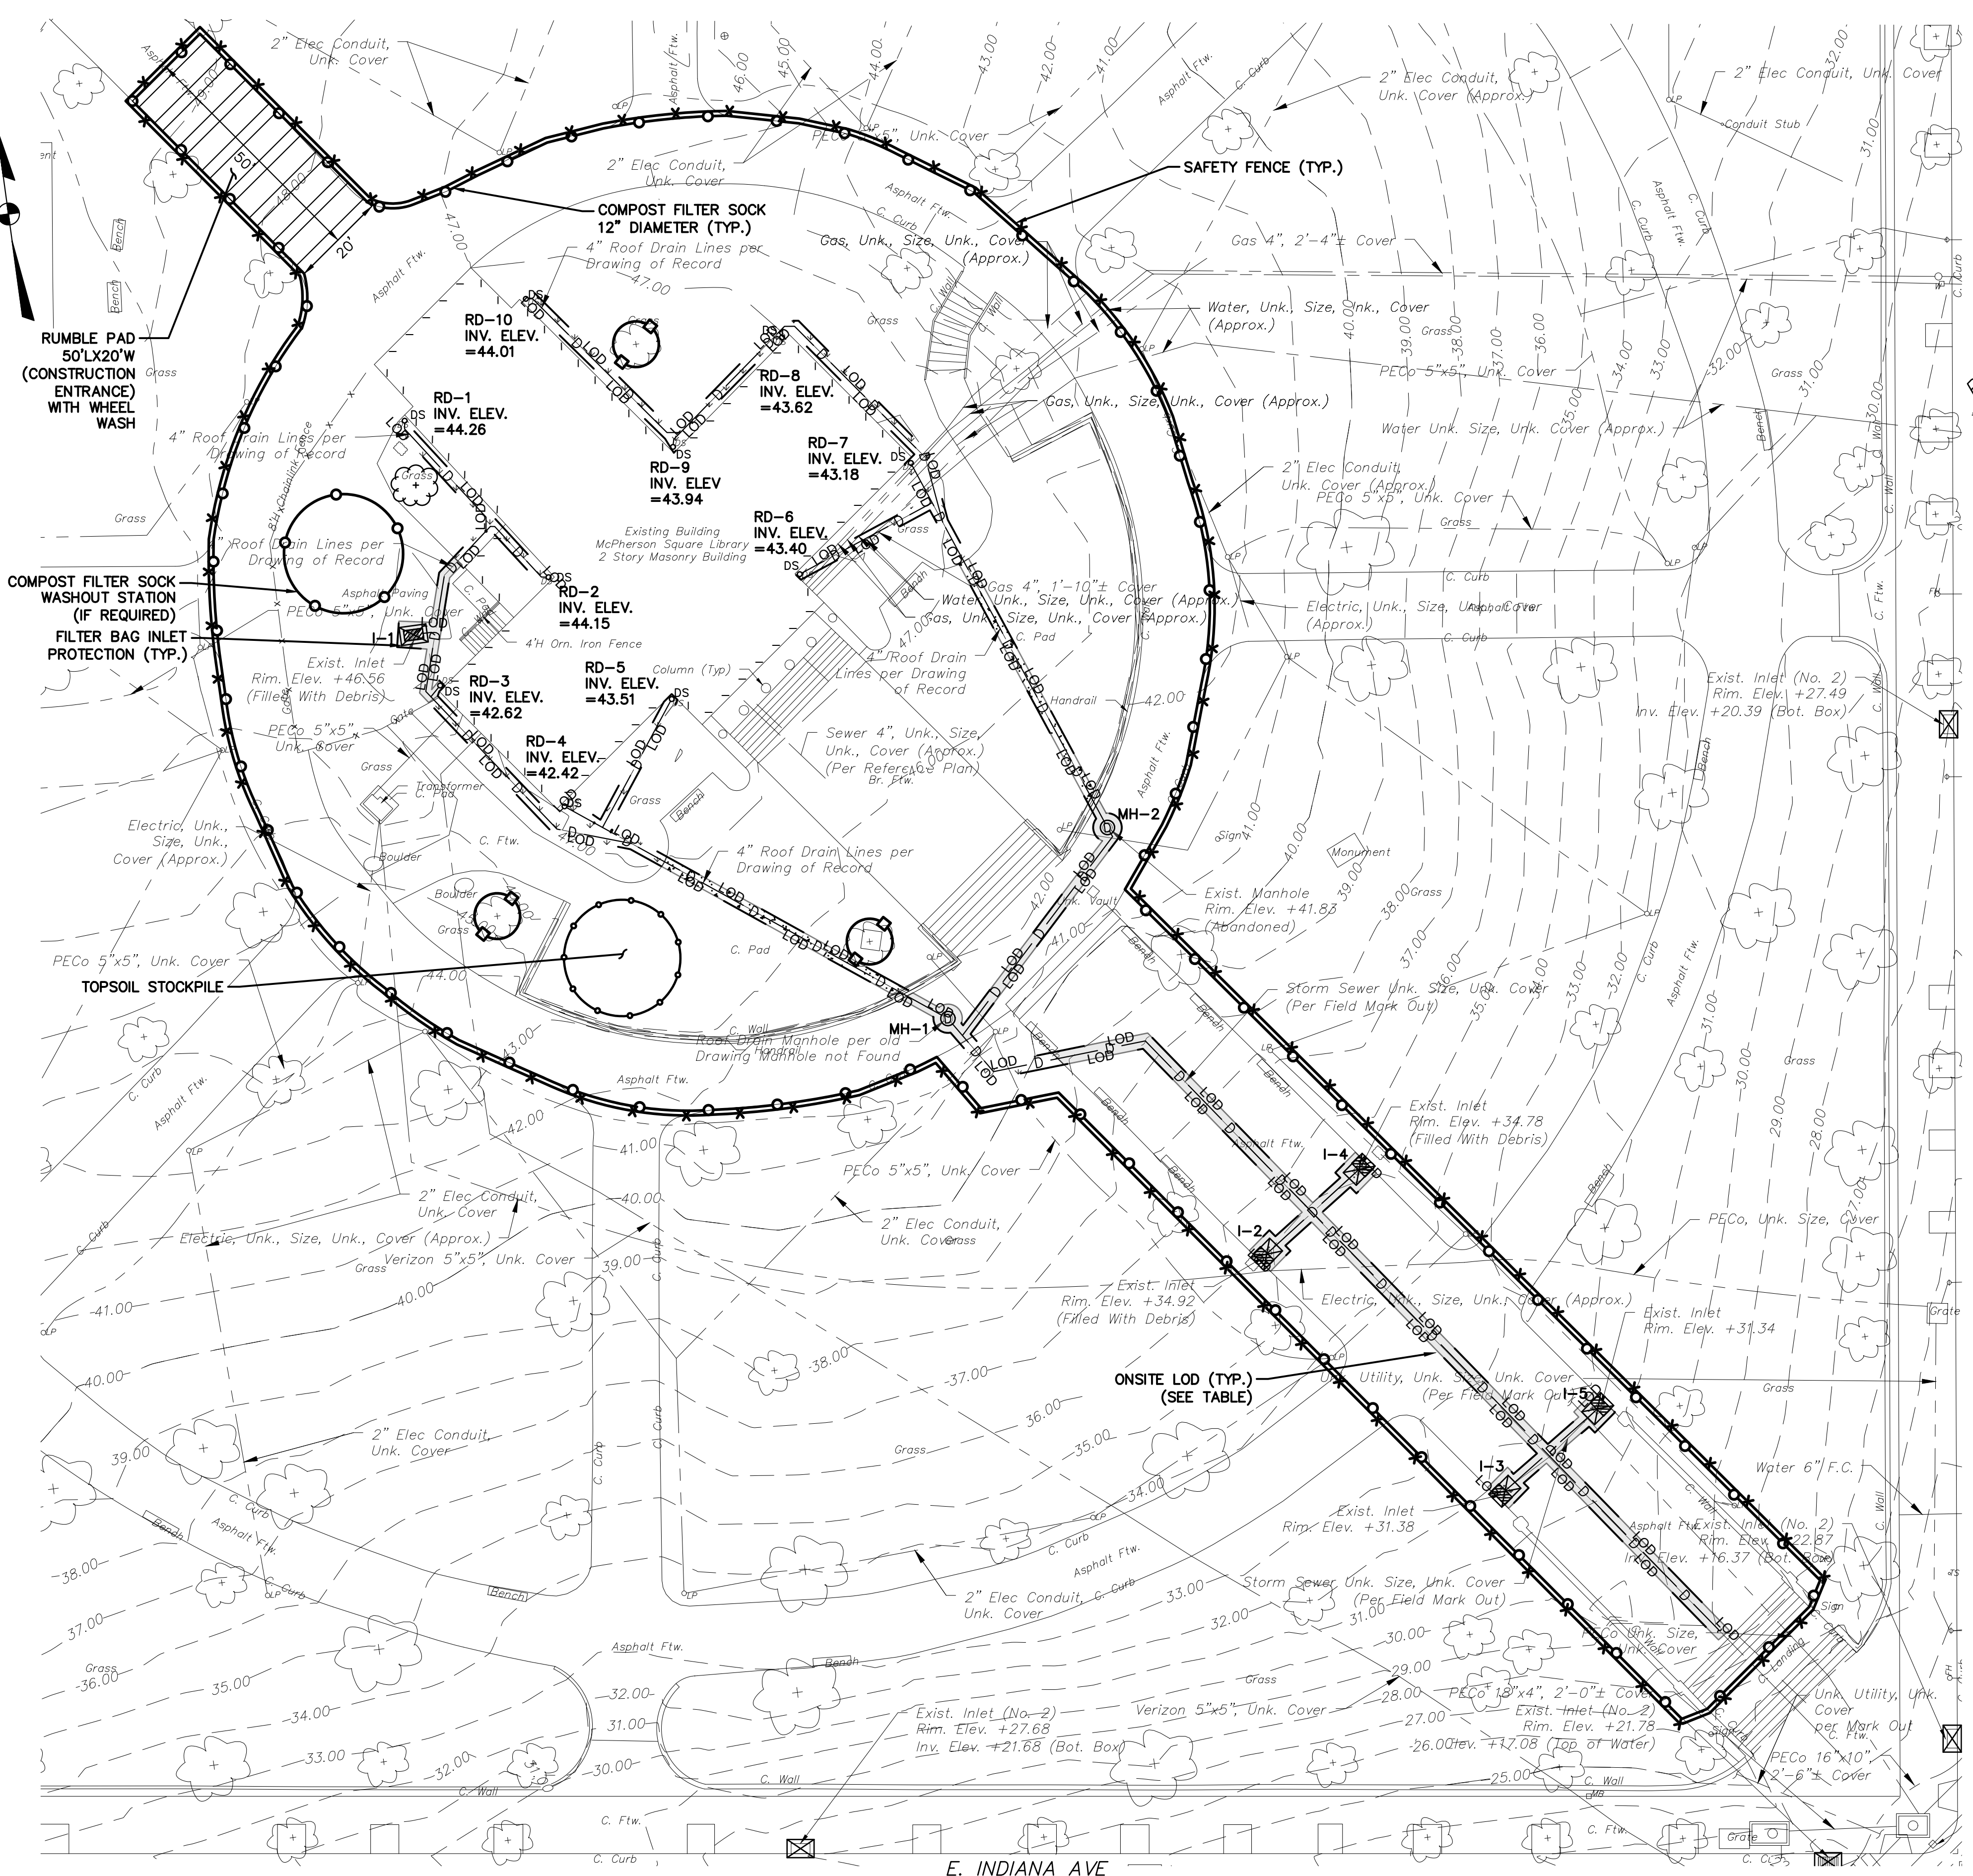

LIMIT OF DISTURBANCE (LOD) SUMMARY		
ON-SITE	2,307 S.F.	0.053 ACRES
PUBLIC R.O.W.	-	-
TOTAL	2,307 S.F.	0.053 ACRES

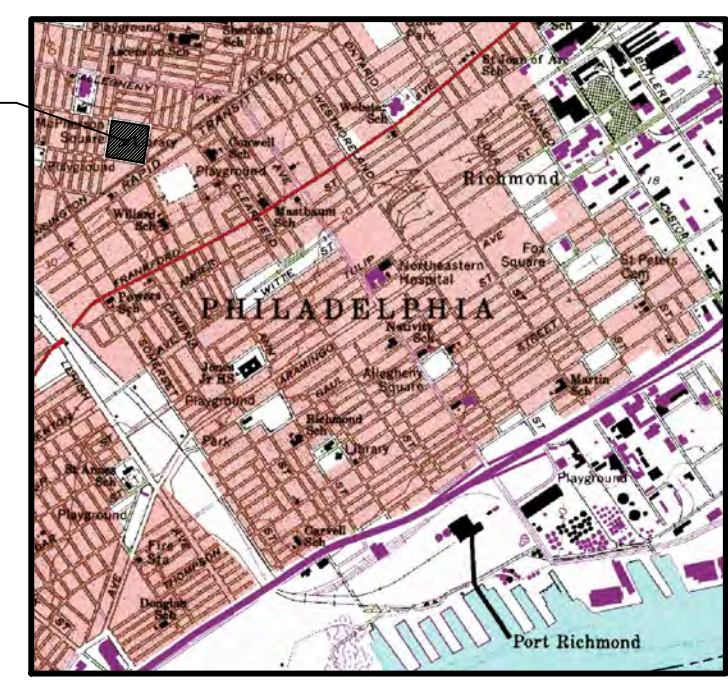

VICINITY MAP
DELAWARE DIRECT WATERSHED (SOUTH)
MANAGEMENT DISTRICT A
SCALE 1"=100'



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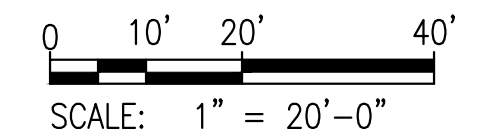
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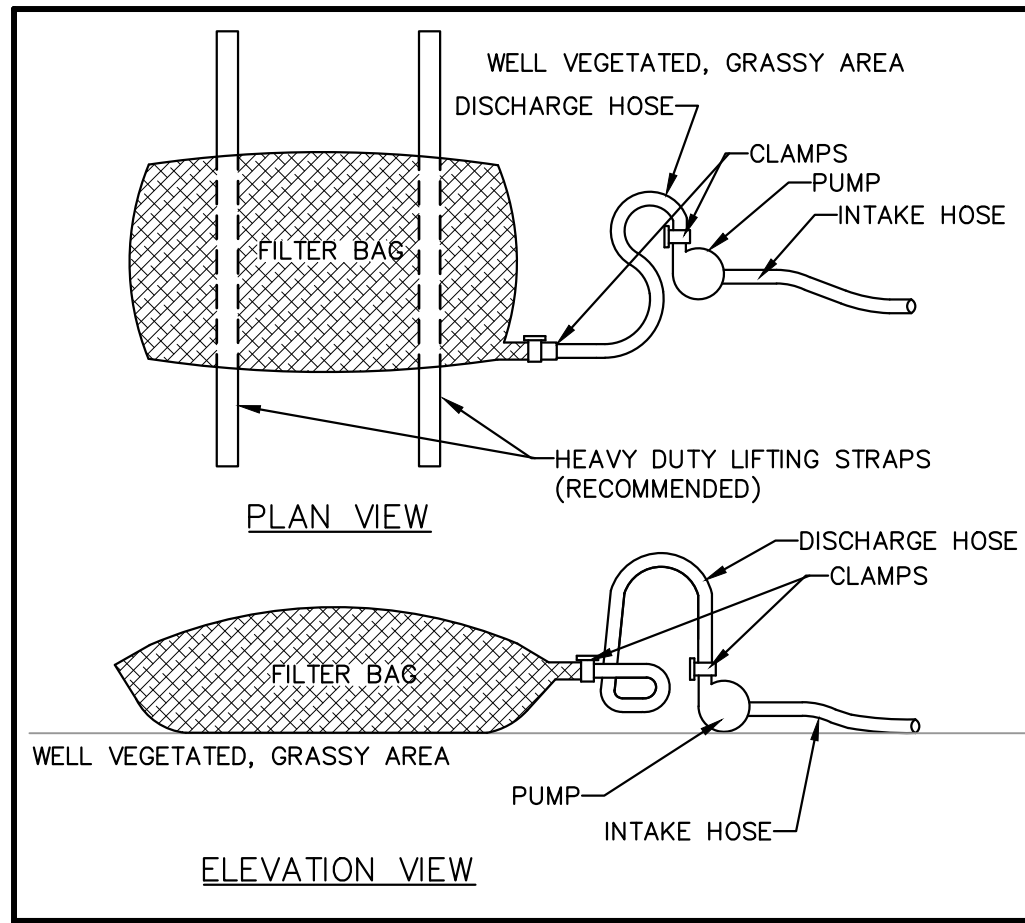


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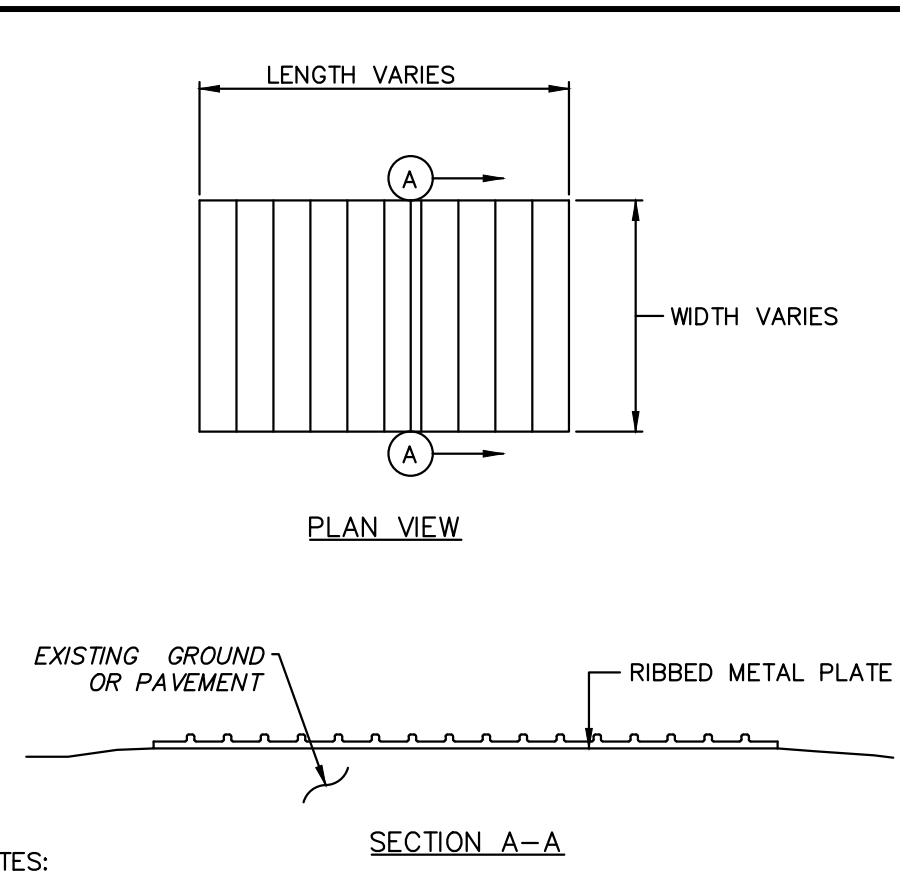
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Drawing Title: EROSION AND SEDIMENT CONTROL PLAN

Drawing No.: C6.0




PUMPED WATER FILTER BAG




NOTES:
 1. PRE-CONSTRUCTED RUMBLE PADS ARE TO BE USED IN LIEU OF ROCK CONSTRUCTION ENTRANCE. RUMBLE PAD SHALL BE INSTALLED ACCORDING TO MANUFACTURER'S RECOMMENDATIONS AND A SUFFICIENT NUMBER OF PADS SHALL BE INSTALLED TO PROVIDE FOR A MINIMUM OF FOUR (4) TIRE REVOLUTIONS WHILE ON THE PAD. MORE PADS MAY BE NEEDED DEPENDING ON SITE CONDITIONS. ACCUMULATED MATERIALS SHOULD BE CLEANED FROM THE PADS DAILY (MORE OFTEN IF NECESSARY) AND DISPOSED IN THE MANNER SPECIFIED BY THE PLAN.
 2. MINIMUM SIZE 50'L X 20'W

RUMBLE PAD (CONSTRUCTION ENTRANCE)

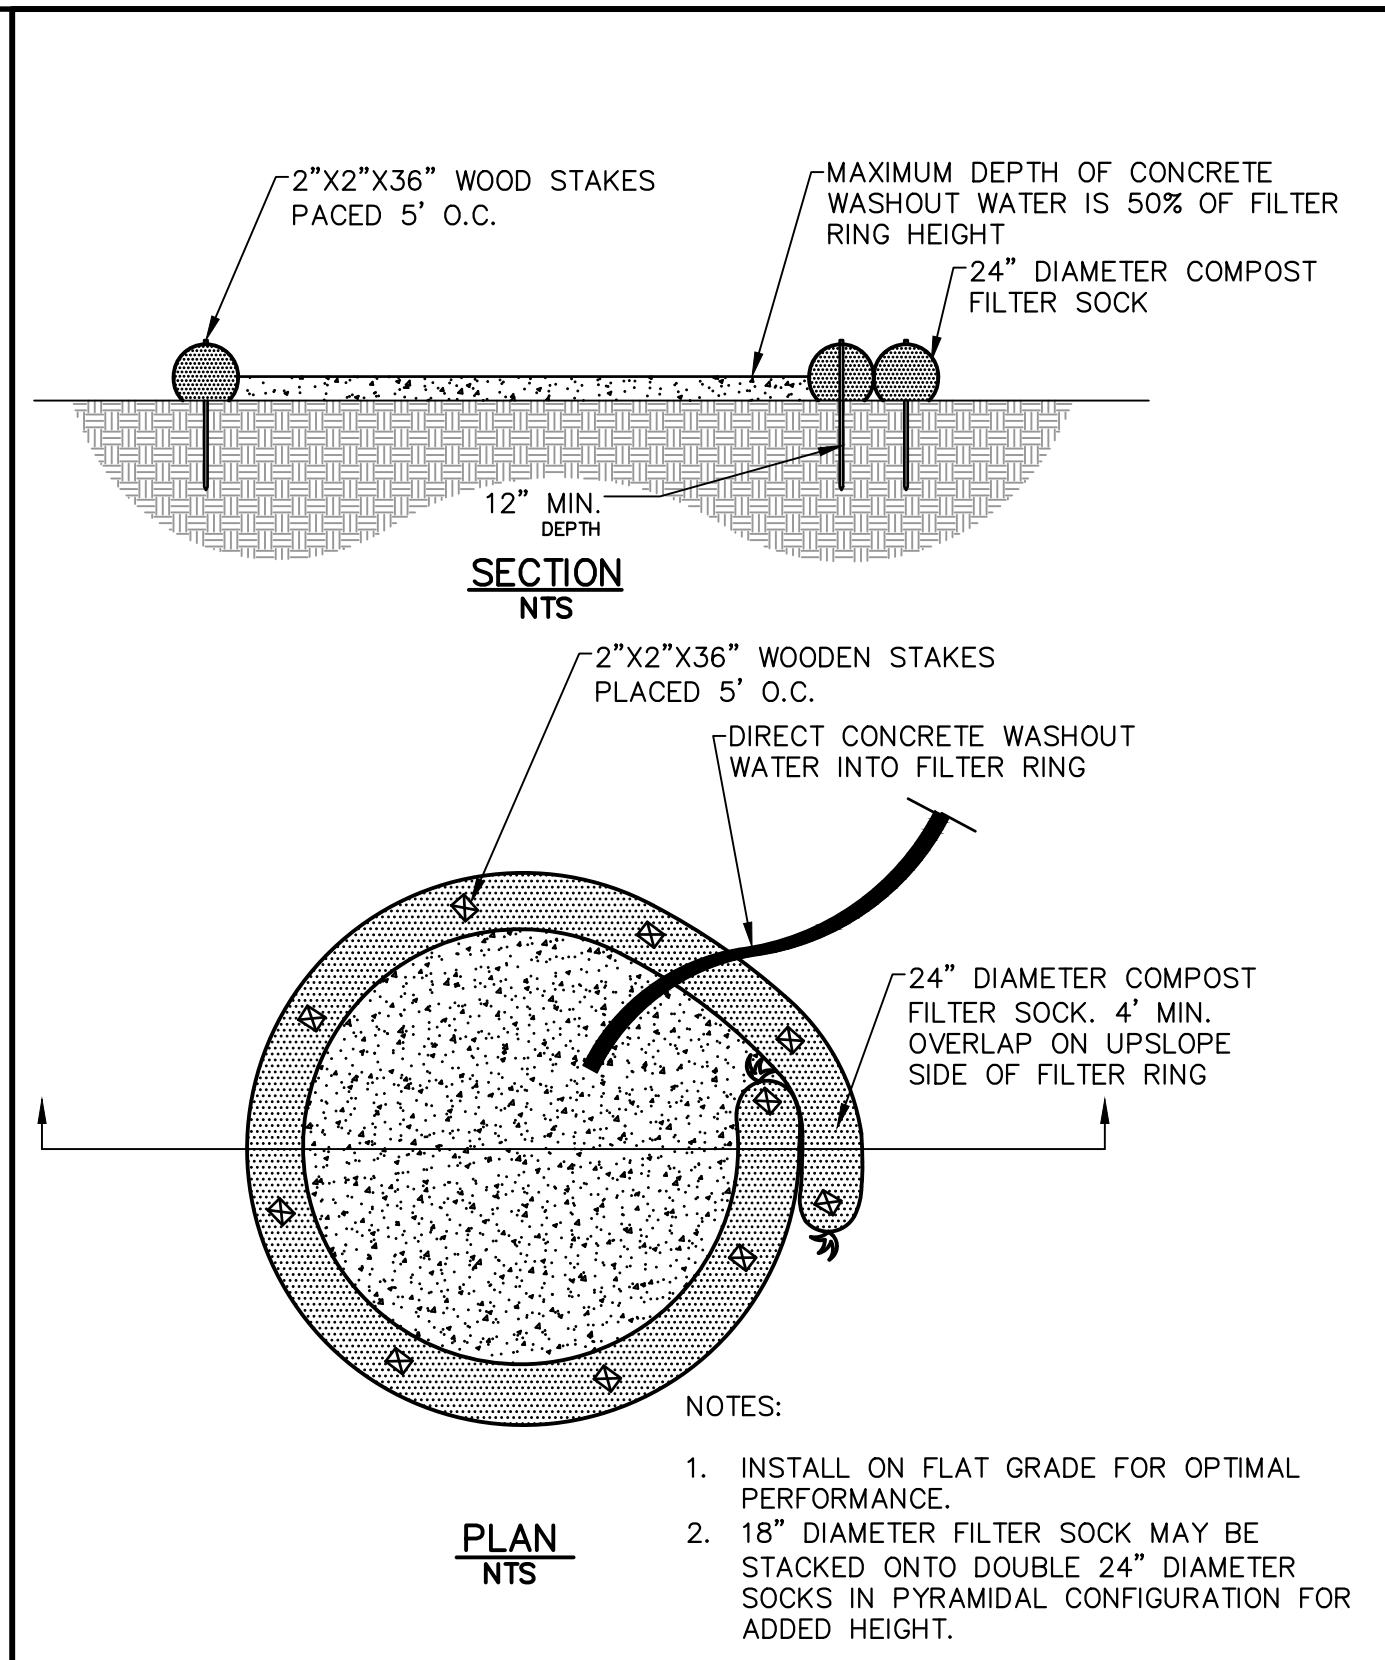

NOTES:
 1. INSTALL ON FLAT GRADE FOR OPTIMAL PERFORMANCE.
 2. 18" DIAMETER FILTER SOCK MAY BE STACKED ONTO DOUBLE 24" DIAMETER SOCKS IN PYRAMIDAL CONFIGURATION FOR ADDED HEIGHT.

COMPOST SOCK WASHOUT STATION

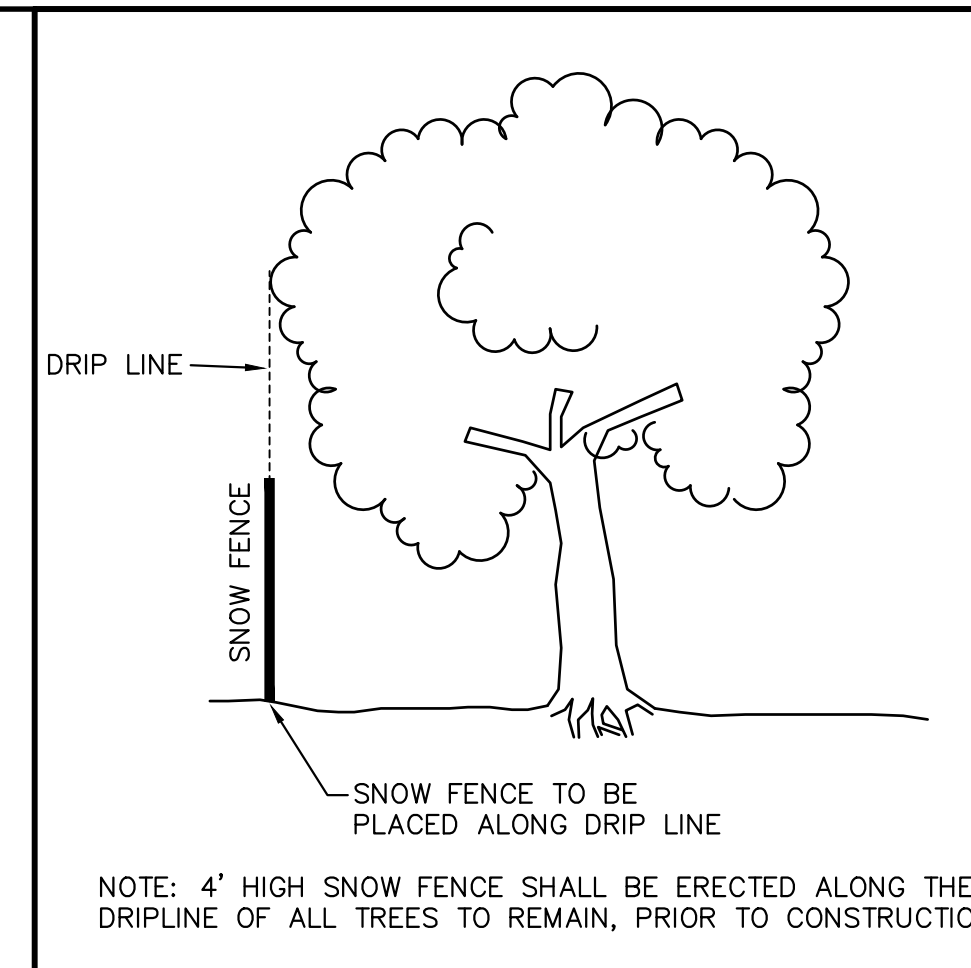

NOTE: 4' HIGH SNOW FENCE SHALL BE ERECTED ALONG THE DRIPLINE OF ALL TREES TO REMAIN, PRIOR TO CONSTRUCTION.

TREE PROTECTION DETAIL


TABLE 4.1
Compost Sock Fabric Minimum Specifications

Material Type	3 mil HDPE	5 mil HDPE	5 mil HDPE	Multi-Filament Polypropylene (MFPP)	Heavy Duty Multi-Filament Polypropylene (HDMFPP)
Material Characteristics	Photo-degradable	Photo-degradable	Bio-degradable	Photo-degradable	Photo-degradable
Sock Diameters	12", 18"	18", 24", 32"	18", 24", 32"	12", 18", 24", 32"	18"
Mesh Opening	3/8"	3/8"	3/8"	3/8"	1/8"
Tensile Strength		26 psi	26 psi	44 psi	202 psi
Ultraviolet Stability % Original Strength (ASTM G-155)	23% at 1000 hr.	23% at 1000 hr.		100% at 1000 hr.	100% at 1000 hr.
Minimum Functional Longevity	6 months	9 months	6 months	1 year	2 years

Two-ply systems:
 HDPE biaxial net
 Continuously wound
 Fusion-welded junctures
 3/4" X 3/4" Max. aperture size
 Composite Polypropylene Fabric
 (Woven layer and non-woven fleece mechanically fused via needle punch)
 3/16" Max. aperture size
 Sock fabrics composed of burlap may be used on projects lasting 6 months or less.

TABLE 4.2
Compost Standards

Organic Matter Content	80% - 100% (dry weight basis)
Organic Portion	Fibrous and elongated
pH	5.5 - 8.0
Moisture Content	35% - 55%
Particle Size	98% pass through 1" screen
Soluble Salt Concentration	5.0 dS/m (mmhos/cm) Maximum

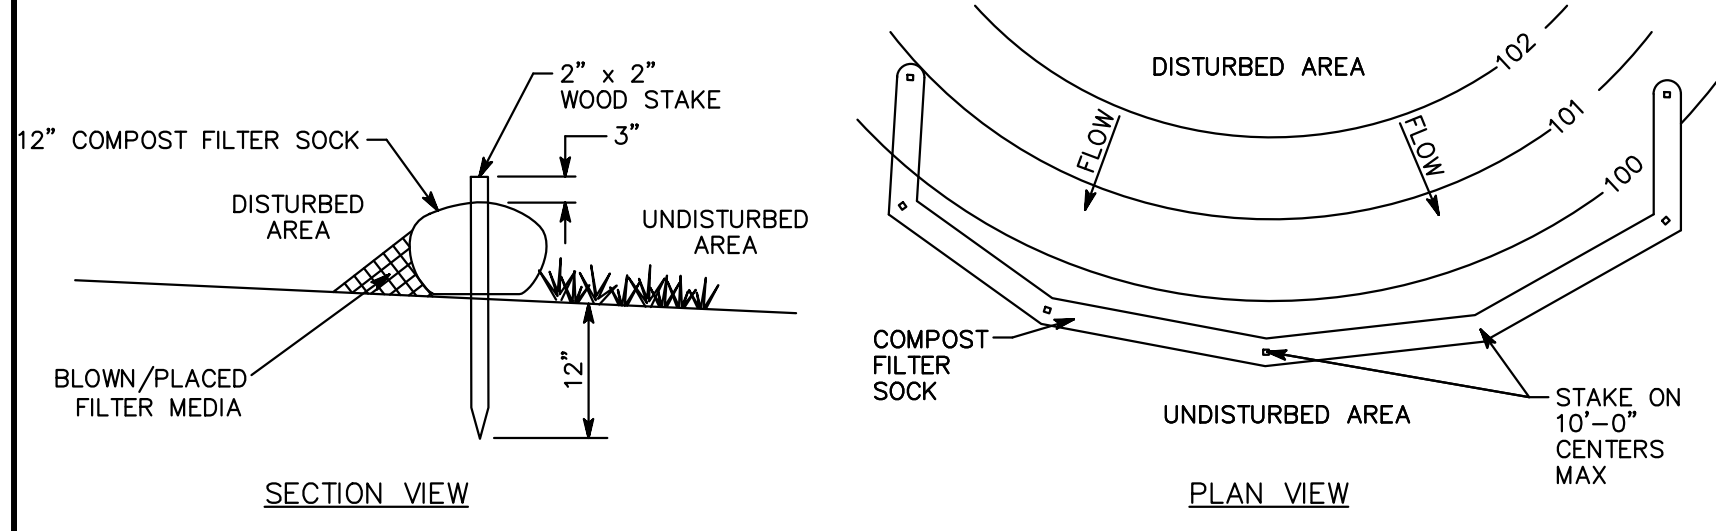


NOTES:
 1. REMOVE DEPOSITS WHEN SEDIMENT ACCUMULATION IS ONE HALF THE HEIGHT OF THE EXPOSED COMPOST FILTER SOCK.
 2. PLACE COMPOST FILTER SOCK ON LEVEL GRADE. EXTEND BOTH ENDS OF THE COMPOST FILTER SOCK AT LEAST 8'-0" UPSLOPE AT 45 DEGREES TO THE MAIN ALIGNMENT.
 3. REPLACE BIODEGRADABLE FILTER SOCK AFTER 6 MONTHS; PHOTODEGRADABLE AFTER 12 MONTHS.
 4. ALL DIMENSIONS ARE IN U.S. CUSTOMARY UNITS.
 5. CONTRACTOR SHALL PROVIDE SAND BAGS, CONCRETE BLOCKS, OR OTHER SUITABLE MATERIAL TO STABILIZE COMPOST FILTER SOCK ON PAVED AREAS AND PREVENT IT FROM MOVING OR SHIFTING.
 6. STABILIZING DEVICES SHALL BE SPACED 10 FEET ON CENTER OR AS RECOMMENDED BY THE MANUFACTURER, WHICHEVER IS LESS.
 7. SOCKS SHALL BE INSPECTED WEEKLY AND AFTER EACH RUNOFF EVENT. DAMAGED SOCKS SHALL BE REPAIRED ACCORDING TO MANUFACTURER'S SPECIFICATIONS OR REPLACED WITHIN 24 HOURS OF INSPECTION.
 8. TRAFFIC SHALL NOT BE PERMITTED TO CROSS FILTER SOCKS.

COMPOST FILTER SOCK, 12" DIAMETER

TABLE 11.1
Cubic Yards of Topsoil Required for Application to Various Depths


Depth (in)	Per 1,000 Square Feet	Per Acre
1	3.1	134
2	6.2	268
3	9.3	403
4	12.4	537
5	15.5	672
6	18.6	806
7	21.7	940
8	24.8	1,074

Adapted from VA DSWC

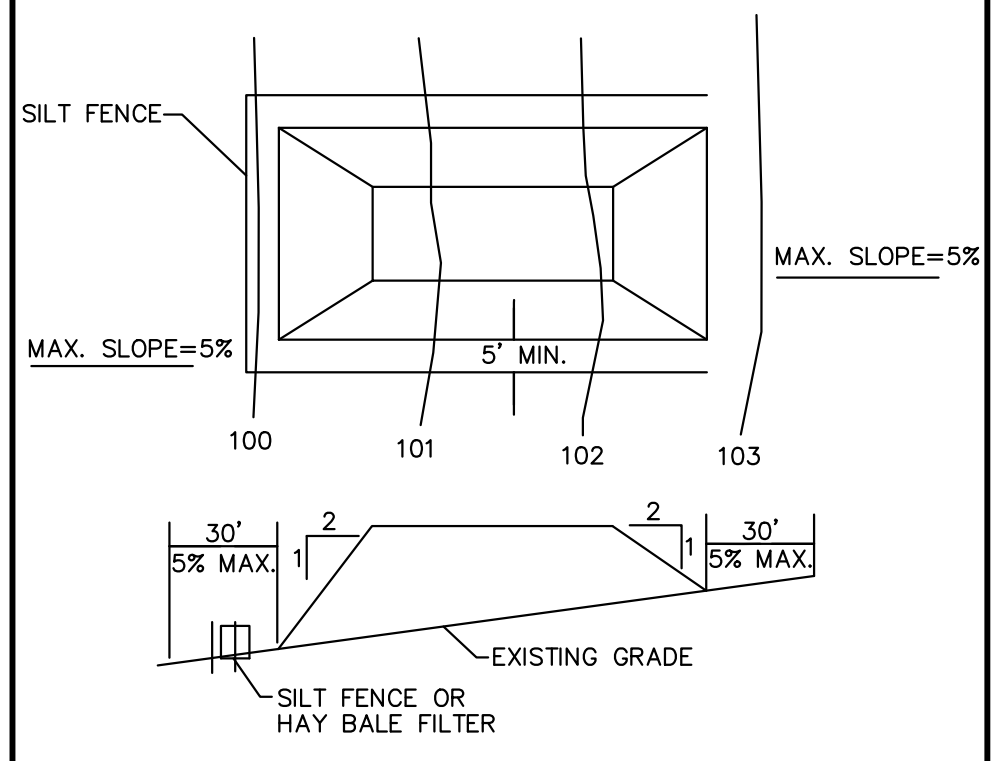


NOTES:
 1. PLACE STOCKPILES AT LOCATIONS AS SHOWN ON THE SOIL EROSION AND SEDIMENT CONTROL PLAN.
 2. ALL SIDE SLOPES SHALL BE 2 TO 1 OR FLATTER.
 3. STOCKPILE SHALL RECEIVE A VEGETATIVE COVER IN ACCORDANCE WITH MINIMUM STABILIZATION REQUIRED.
 4. SILT FENCE SHALL BE INSTALLED AS DETAILED HEREON.
 5. STOCKPILE NOT TO EXCEED 20 FEET IN HEIGHT.

TEMPORARY STOCKPILE

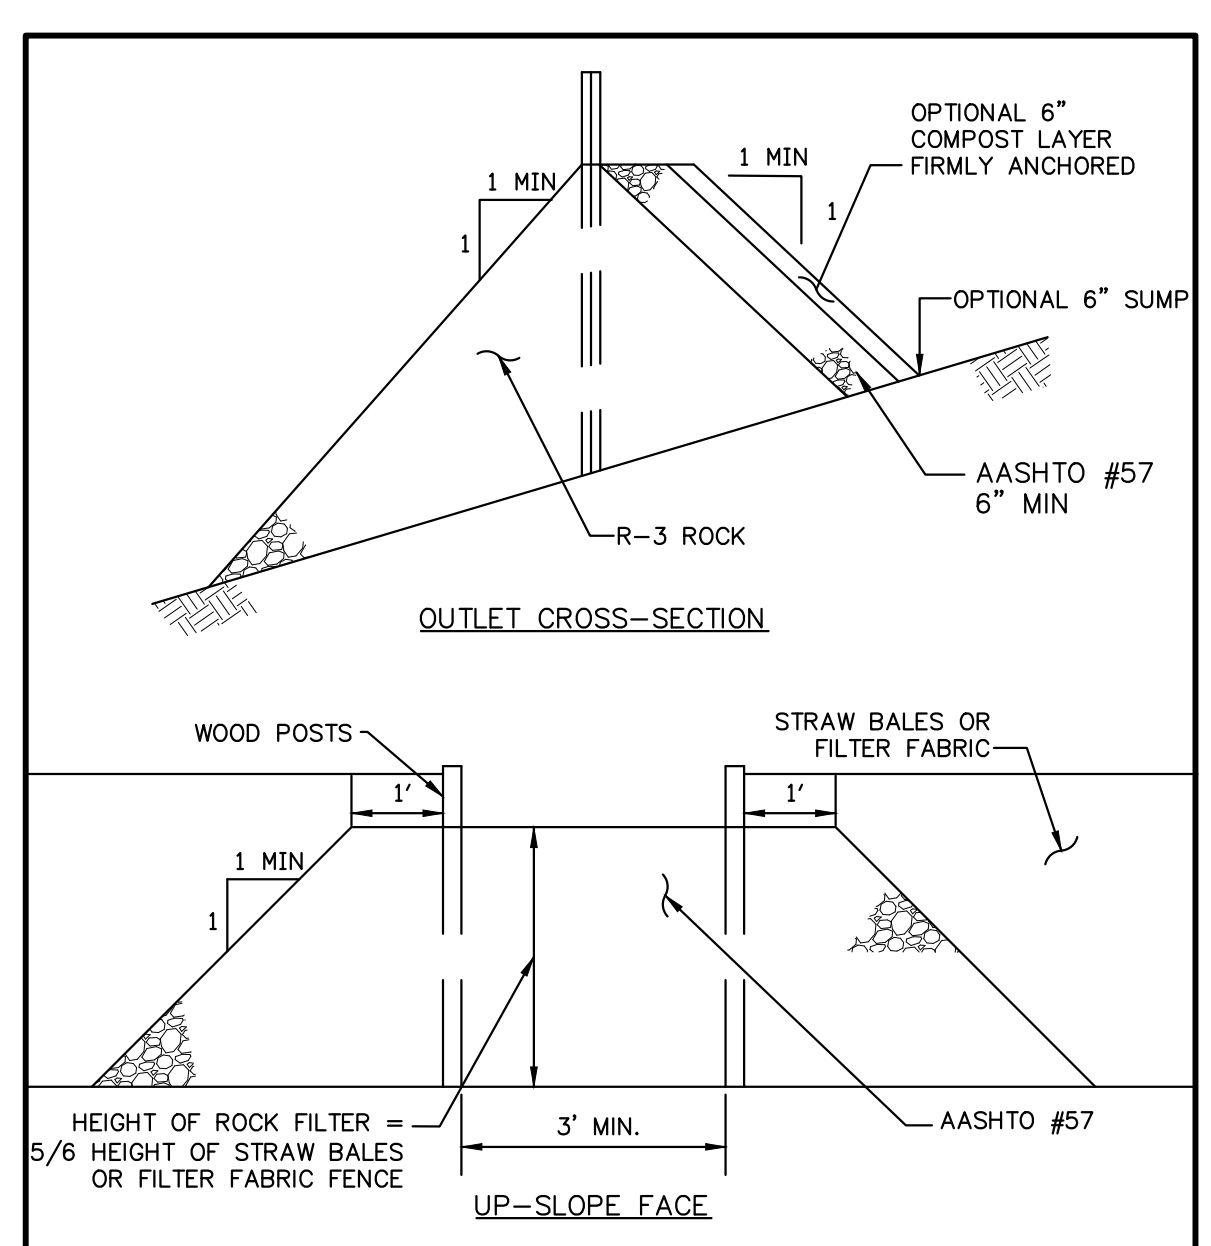

NOTES:
 1. A rock filter outlet shall be installed where failure of a silt fence or straw barrier has occurred due to concentrated flow. Anchored compost layer shall be used on upslope face in HQ and EV watersheds.
 2. Sediment must be removed when accumulations reach 1/3 the height of the outlet.

ROCK FILTER OUTLET (IF REQUIRED)

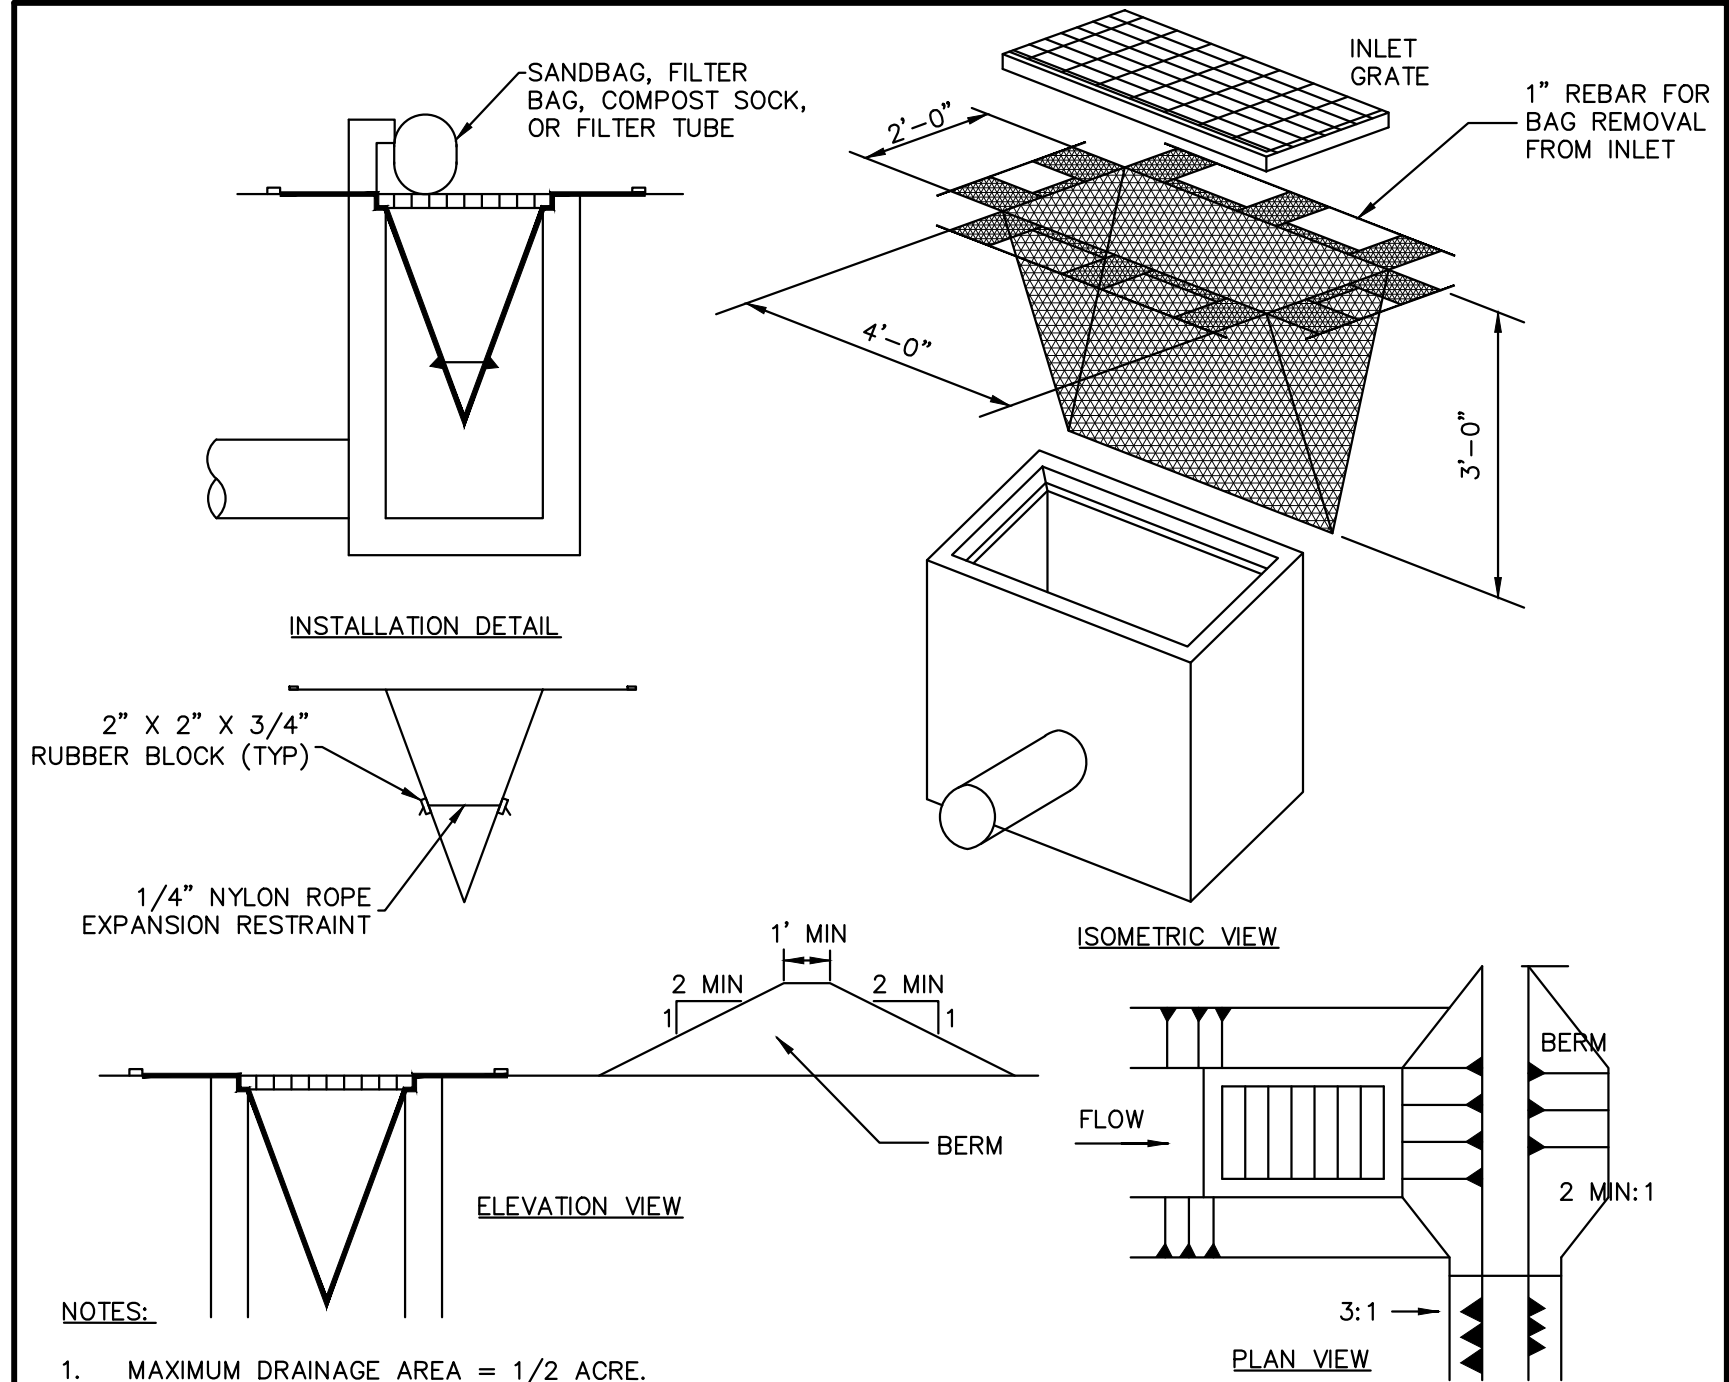

NOTES:
 1. MAXIMUM DRAINAGE AREA = 1/2 ACRE.
 2. INLET PROTECTION IS NOT REQUIRED FOR INLET TRIBUTARY TO SEDIMENT BASIN OR TRAP. BERMS REQUIRED FOR ALL INSTALLATIONS.
 3. EARTHEN BERM IN ROADWAY SHALL BE MAINTAINED UNTIL ROADWAY IS STONED. ROAD SUBBASE BERM ON ROADWAY SHALL BE MAINTAINED UNTIL ROADWAY IS PAVED. EARTHEN BERM IN CHANNEL SHALL BE MAINTAINED UNTIL PERMANENT STABILIZATION IS COMPLETED OR TO REMAIN PERMANENTLY.
 4. DO NOT USE ON MAJOR PAVED ROADWAYS WHERE PONDING MAY CAUSE TRAFFIC HAZARDS

FILTER BAG INLET PROTECTION



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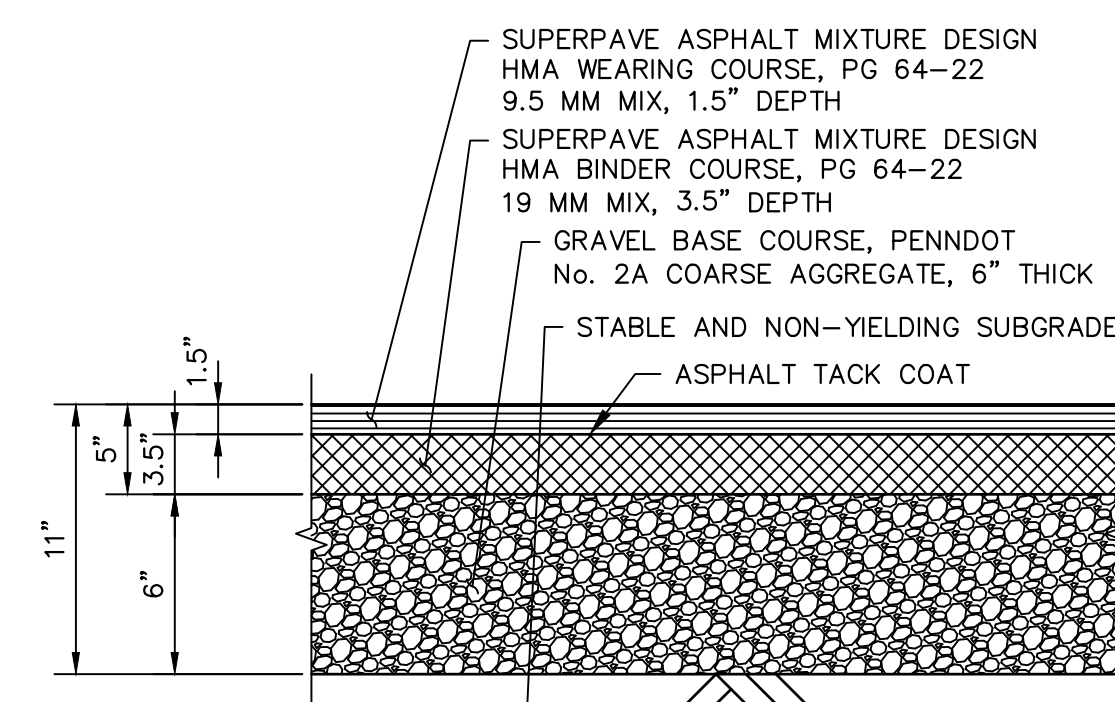
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 856 287 2424

Scale:


Date: 04/15/2024

Drawing Title:
 EROSION AND SEDIMENT CONTROL DETAILS


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FULL DEPTH ASPHALT PAVEMENT
SCALE: N.T.S.




FULL DEPTH PAVING AT LANDSCAPED EDGES
SCALE: N.T.S.

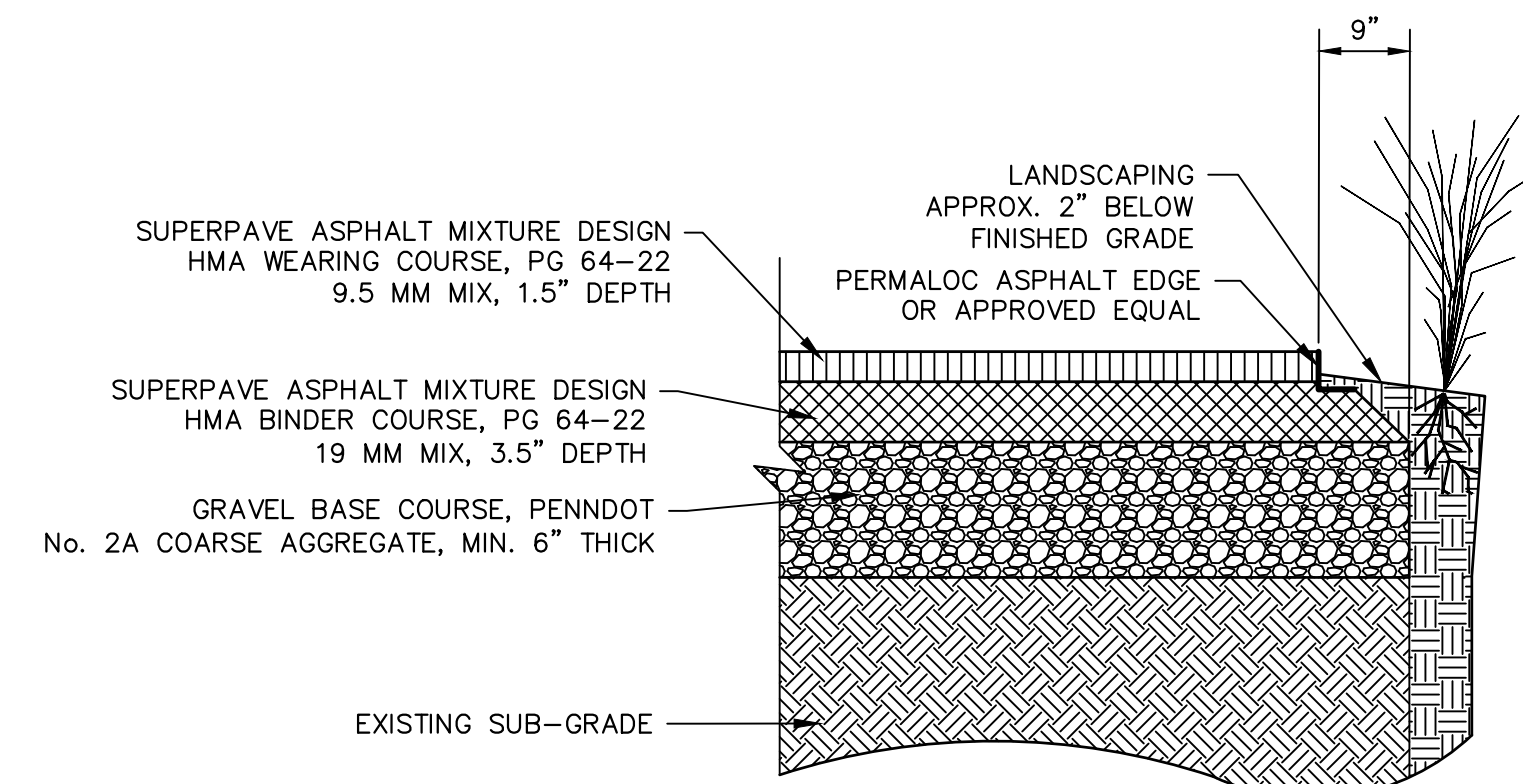


- NOTES:
1. SAW-CUT EXISTING BITUMINOUS PAVING AT THE CARTWAY.
 2. REMOVE EXISTING CURB AND SIDEWALK TO BE REPLACED.
 3. REPLACE NEW CONCRETE CURB AND SIDEWALK.
 4. REPLACE SAW-CUT PORTION OF CARTWAY WITH NEW BITUMINOUS PAVEMENT.
 5. USE THIS DETAIL AT REPLACEMENT OF EXISTING SIDEWALKS AND CURBS.
 6. COMPLY WITH CITY OF PHILADELPHIA STANDARDS.

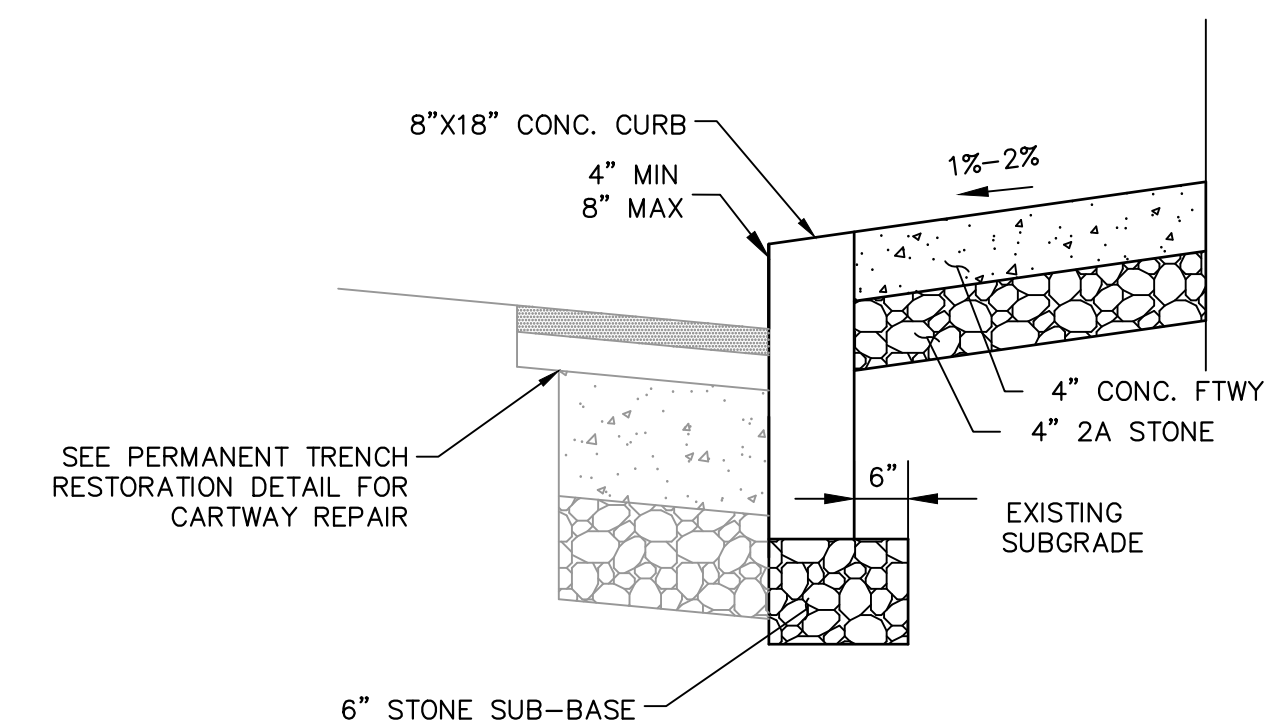CONCRETE CURB AND FOOTWAY DETAIL
SCALE: N.T.S.

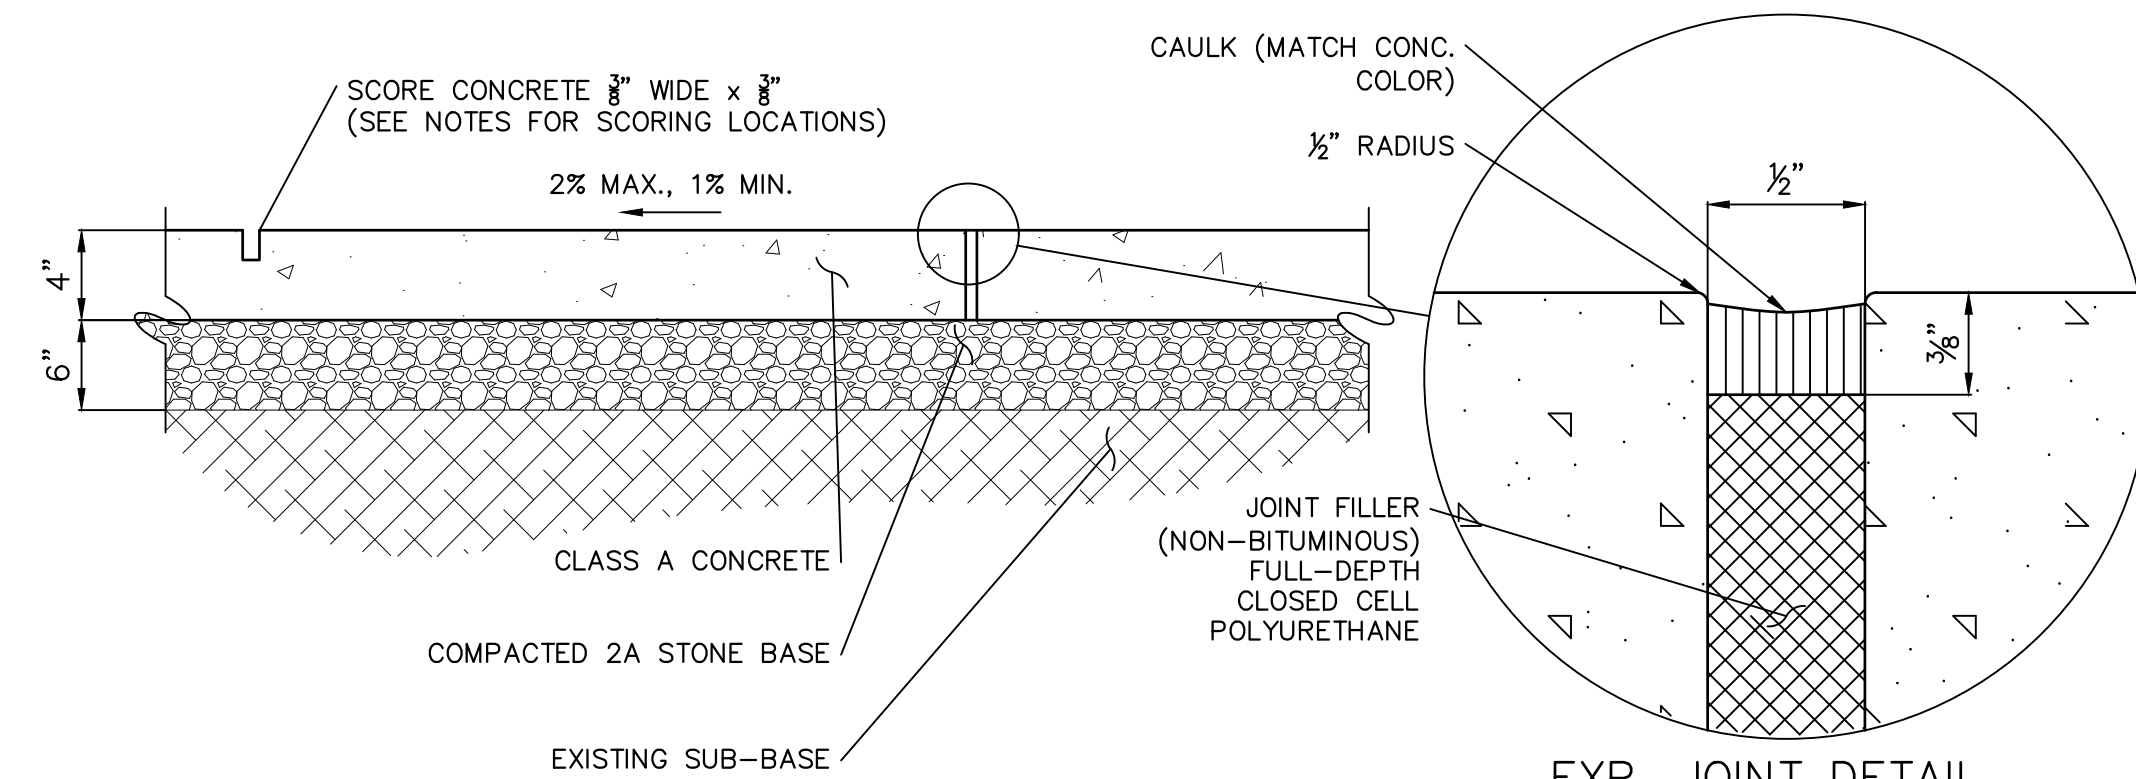


- NOTES:
1. SPACE EXPANSION JOINTS 20' O.C. UNLESS SHOWN OTHERWISE ON PLANS.
 2. INSTALL EXPANSION JOINTS WHERE WALK ABUTS OTHER STRUCTURES.
 3. CONCRETE WALKWAY SHALL BE SCORED ON A 5' X 5' GRID. PERPENDICULAR TO THE CURBLINE.

CONCRETE FOOTWAY DETAIL
SCALE: N.T.S.

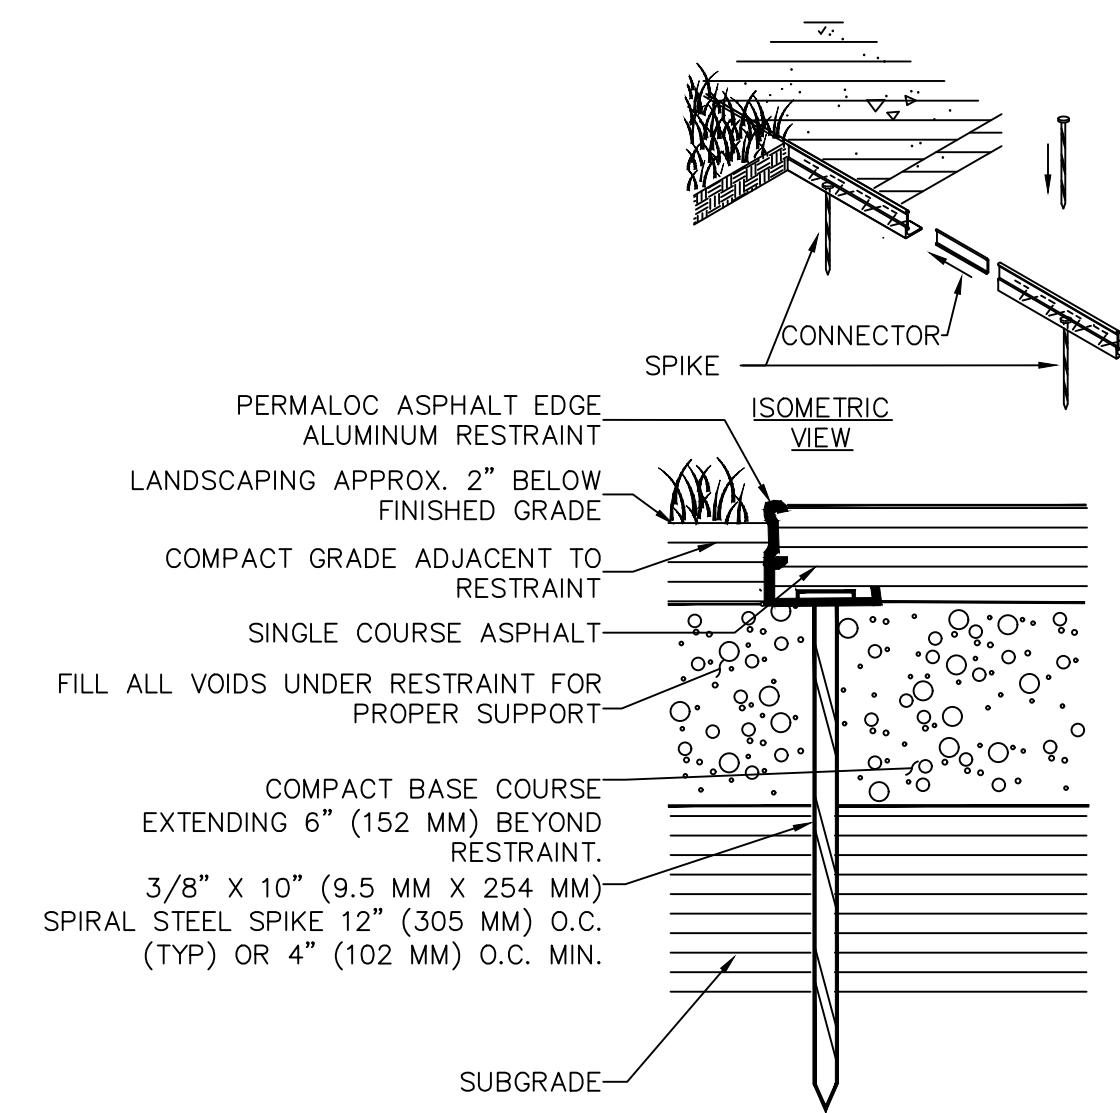


- NOTES:
1. INSTALL PER MANUFACTURER'S "INSTALLATION GUIDELINES".
 2. 8'-0" (2.44 M) SECTIONS CONNECTED WITH 4" (102 MM) SLIDING CONNECTOR.
 3. MAINTAIN 3/8" (9.5 MM) GAP BETWEEN SECTIONS TO ALLOW FOR PRODUCT EXPANSION IN EXTREME TEMPERATURES.
 4. CORNERS: NOTCH BASE ONLY AND FORM A CONTINUOUS CORNER.

ASPHALT EDGING DETAIL
SCALE: N.T.S.



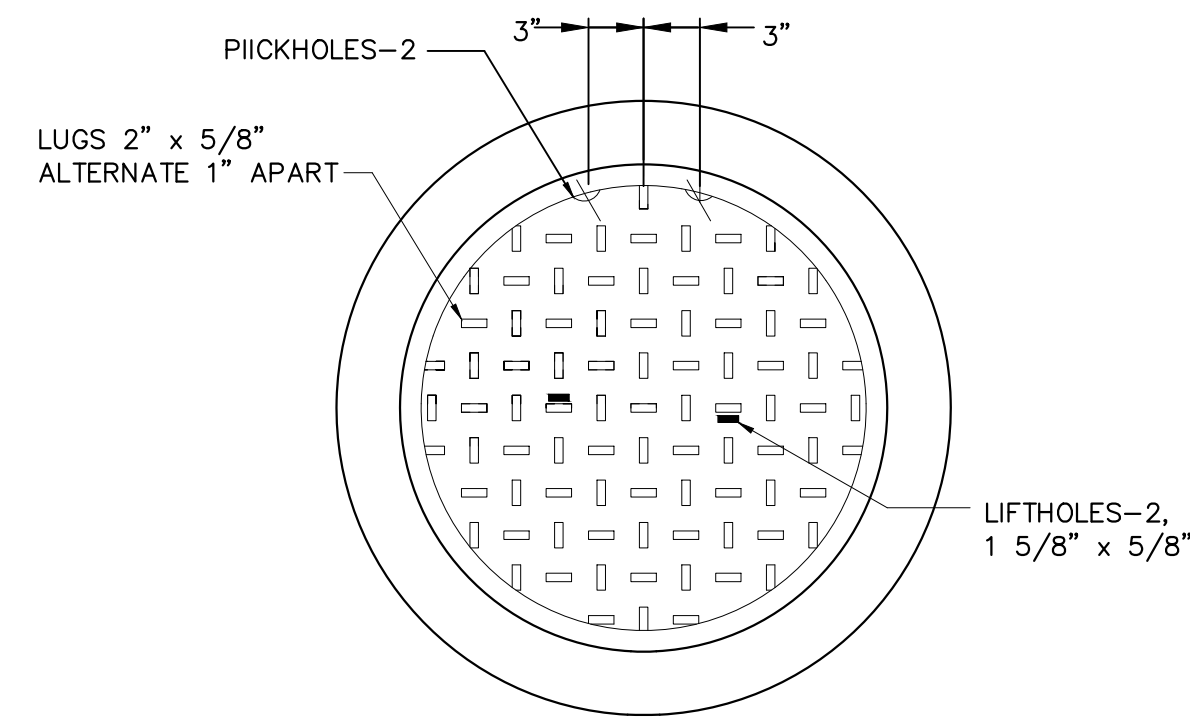


GRAY MANHOLE FRAME AND COVER
SCALE: N.T.S.

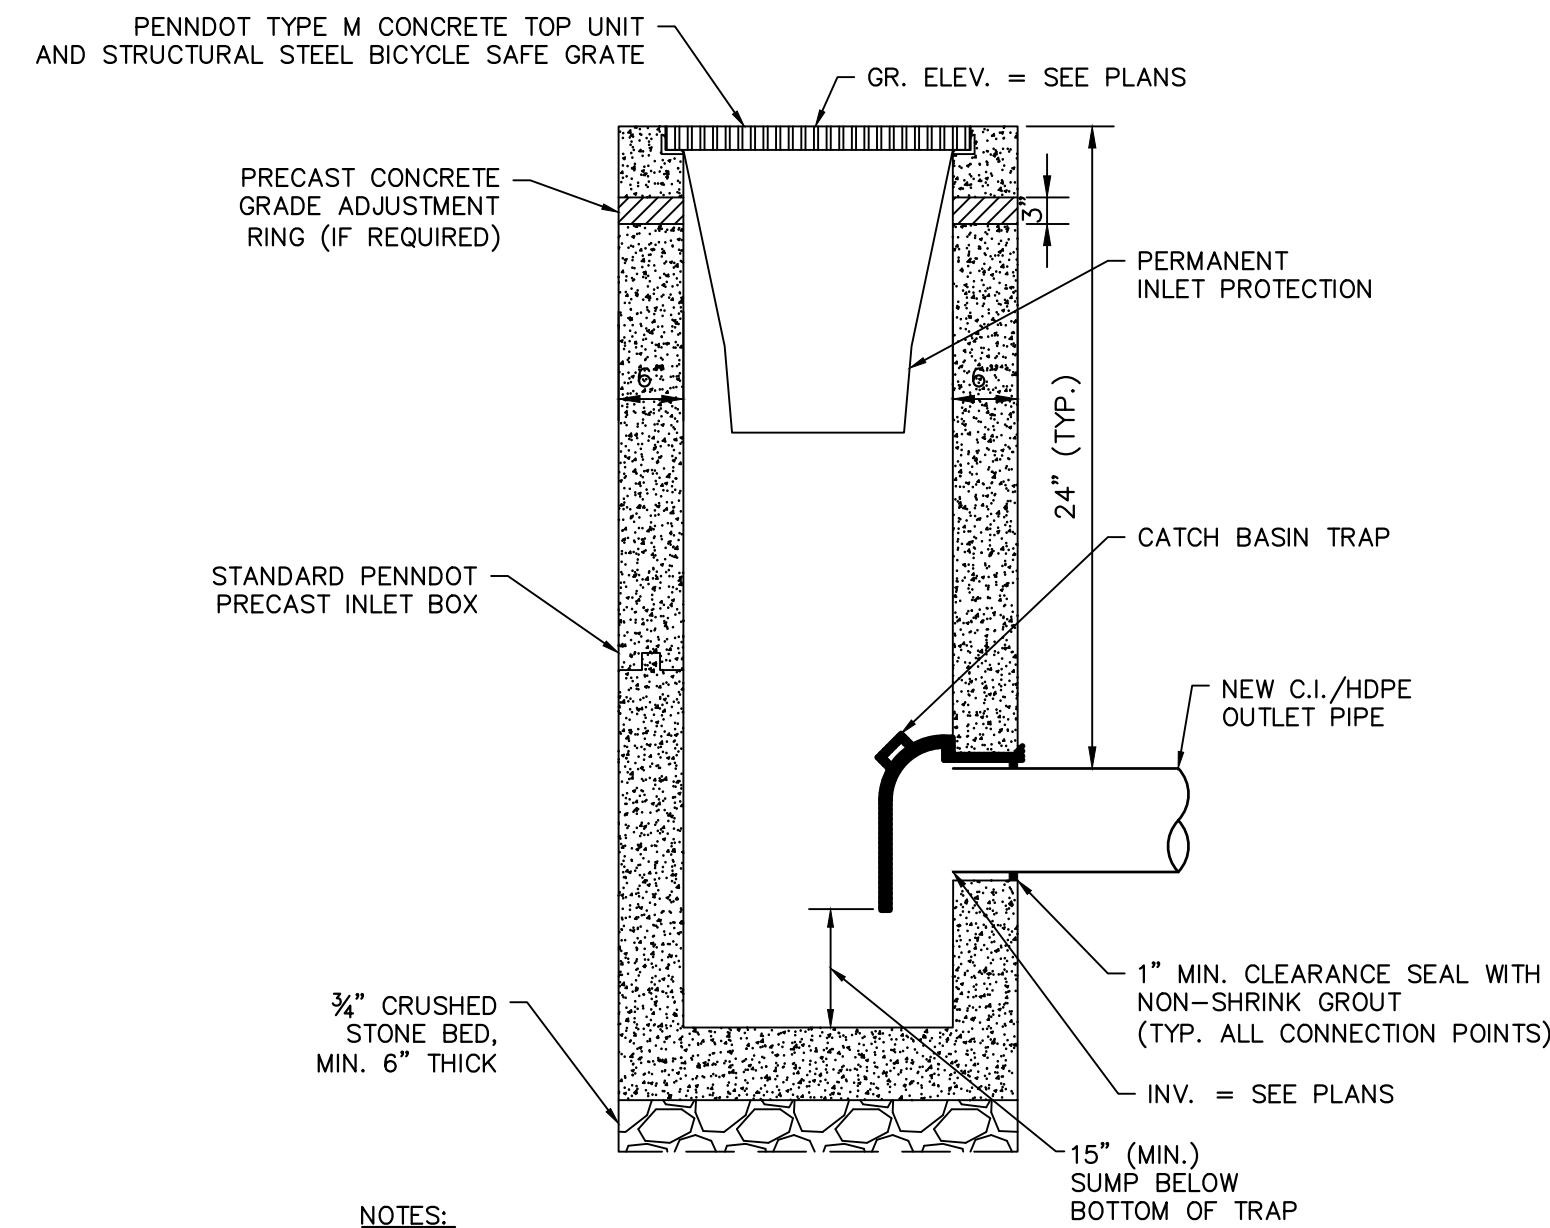


- NOTES:
1. COMPLY WITH PENNDOT STANDARDS.
2. USE PRECAST PENNDOT INLET BOX WITH 3'-9 1/2" x 2' INTERIOR DIMENSIONS AND 6" THICK WALLS.
3. SEAL INLET TRAP WITH NON-SHRINK, NON-METALLIC MORTAR. APPLY BITUMIN-TYPE SEALING COMPOUND TO JOINT.
4. PROPOSED INLET TRAP MUST BE AIR TIGHT.
5. USE PENNDOT STANDARD INLET BOX OR APPROVED EQUAL.

HIGHWAY GRATE INLET
SCALE: N.T.S.

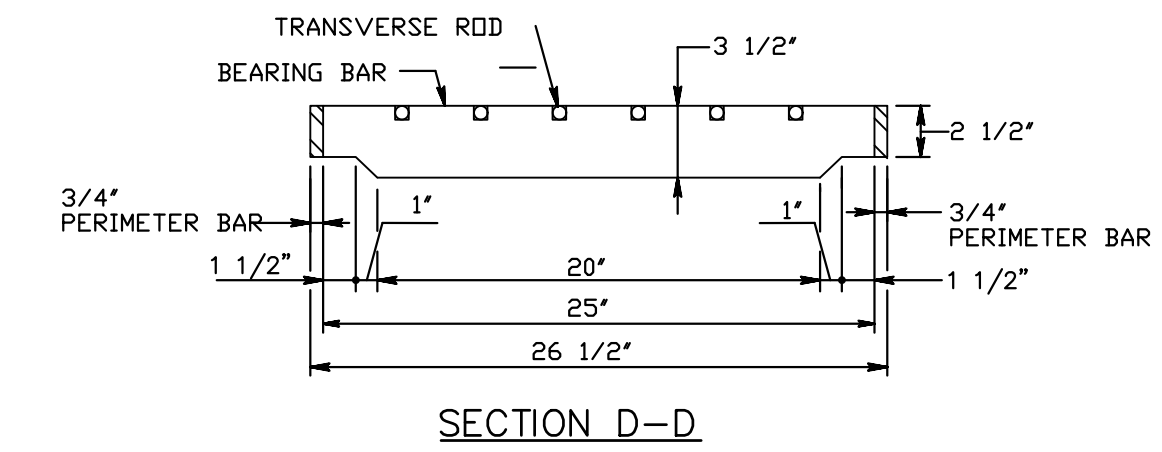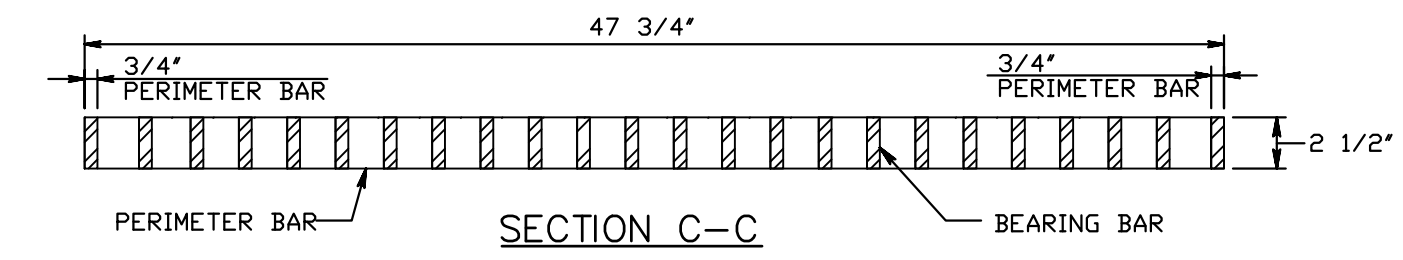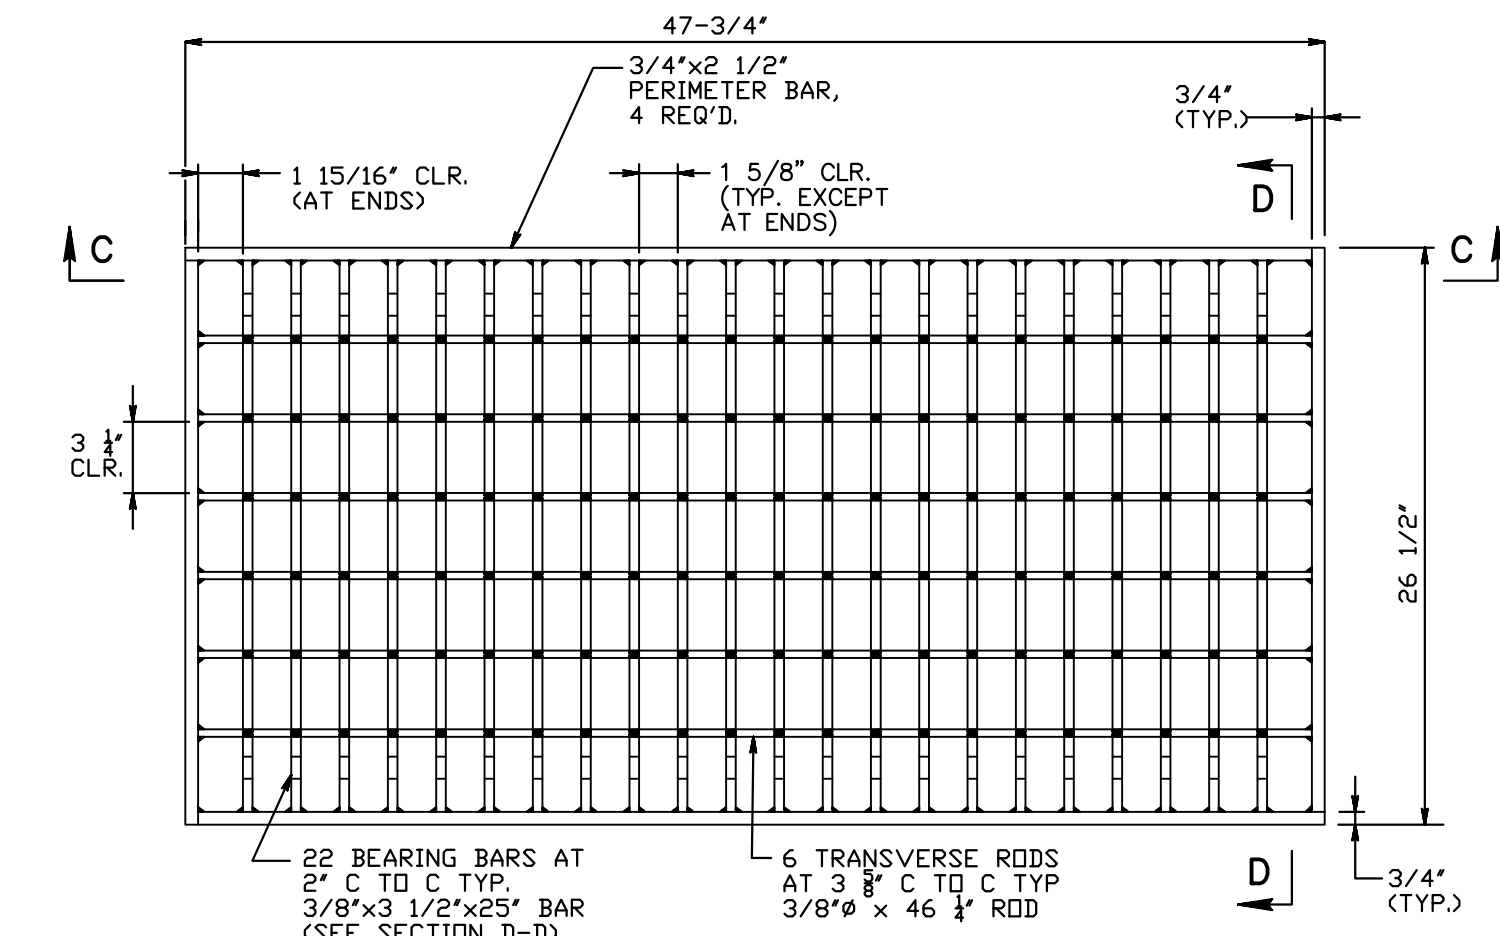


**STRUCTURAL STEEL
BICYCLE SAFE GRATE**
SCALE: N.T.S.

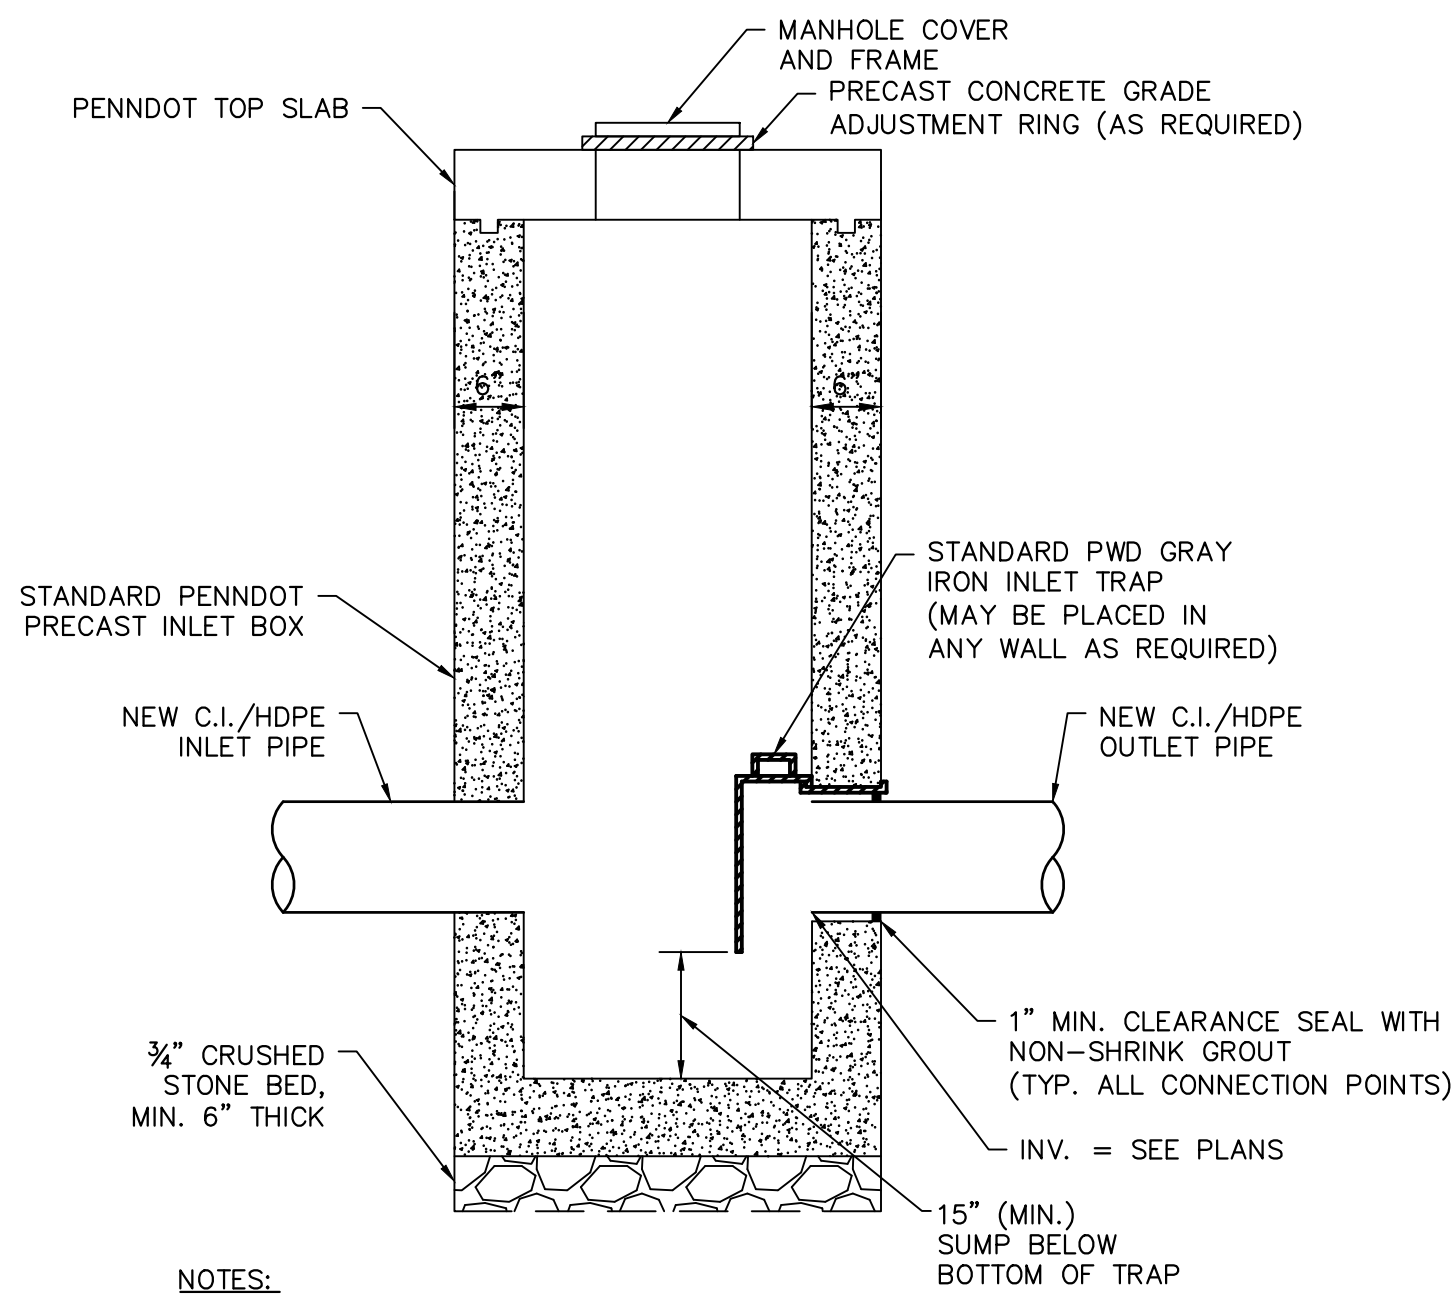

- NOTES:
1. COMPLY WITH PENNDOT STANDARDS.
2. USE PRECAST PENNDOT INLET BOX WITH 3'-9 1/2" x 2' INTERIOR DIMENSIONS AND 6" THICK WALLS.
3. SEAL INLET TRAP WITH NON-SHRINK, NON-METALLIC MORTAR. APPLY BITUMIN-TYPE SEALING COMPOUND TO JOINT.
4. PROPOSED INLET TRAP MUST BE AIR TIGHT.
5. USE PENNDOT STANDARD INLET BOX OR APPROVED EQUAL.


STANDARD MANHOLE
SCALE: N.T.S.

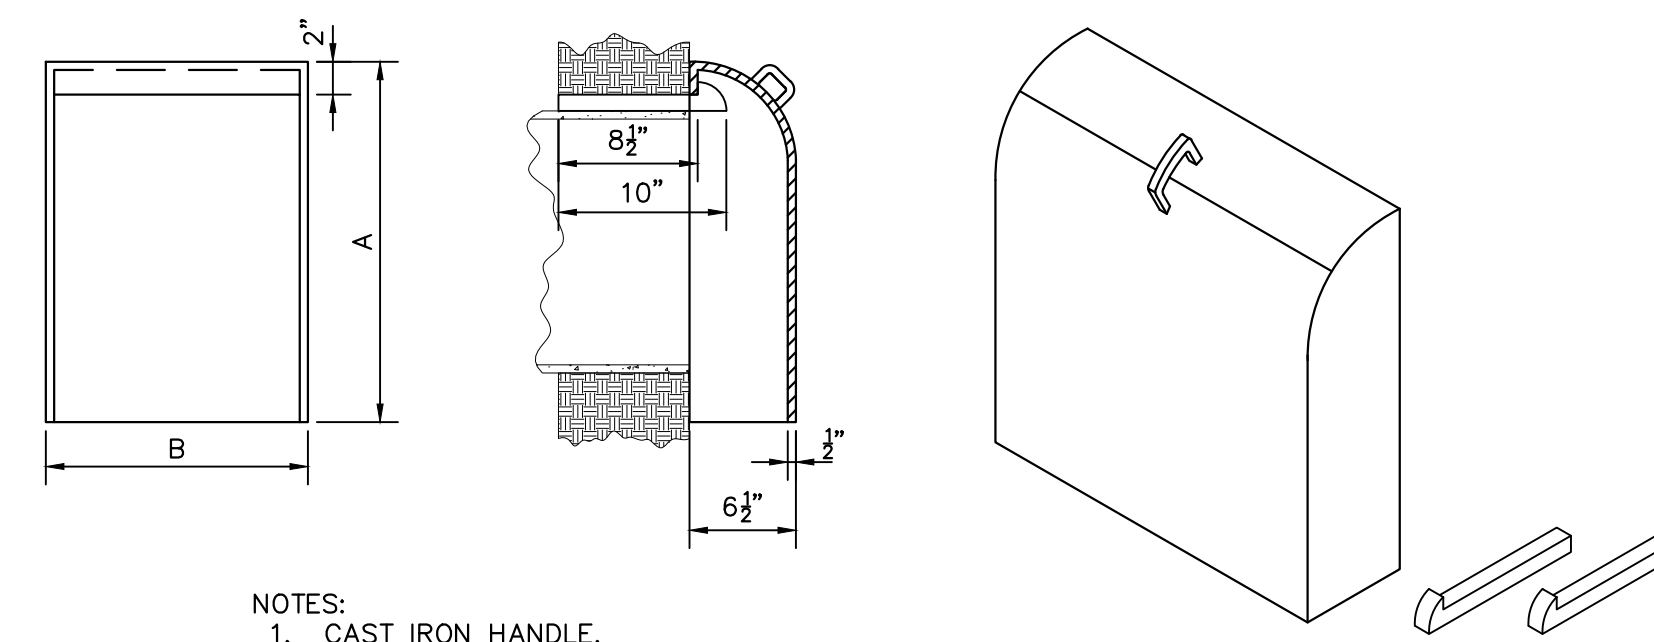


R-3701 CATCH BASIN TRAP - ALL DIMENSIONS IN INCHES

CATALOG NO.	A (IN)	B (IN)	PIPE SIZE (IN)	SETTING METHOD
R-3701-6	16	12	UP TO 6	ON 2 HOOKS
R-3701-8	18	12	8	ON 2 HOOKS
R-3701-10	20	12	10	ON 2 HOOKS
R-3701-12	22	16	12	ON 2 HOOKS
R-3701-15	25	19	15	ON 2 HOOKS
R-3701-18	28	22	18	ON 2 HOOKS


STANDARD INLET TRAP
SCALE: N.T.S.

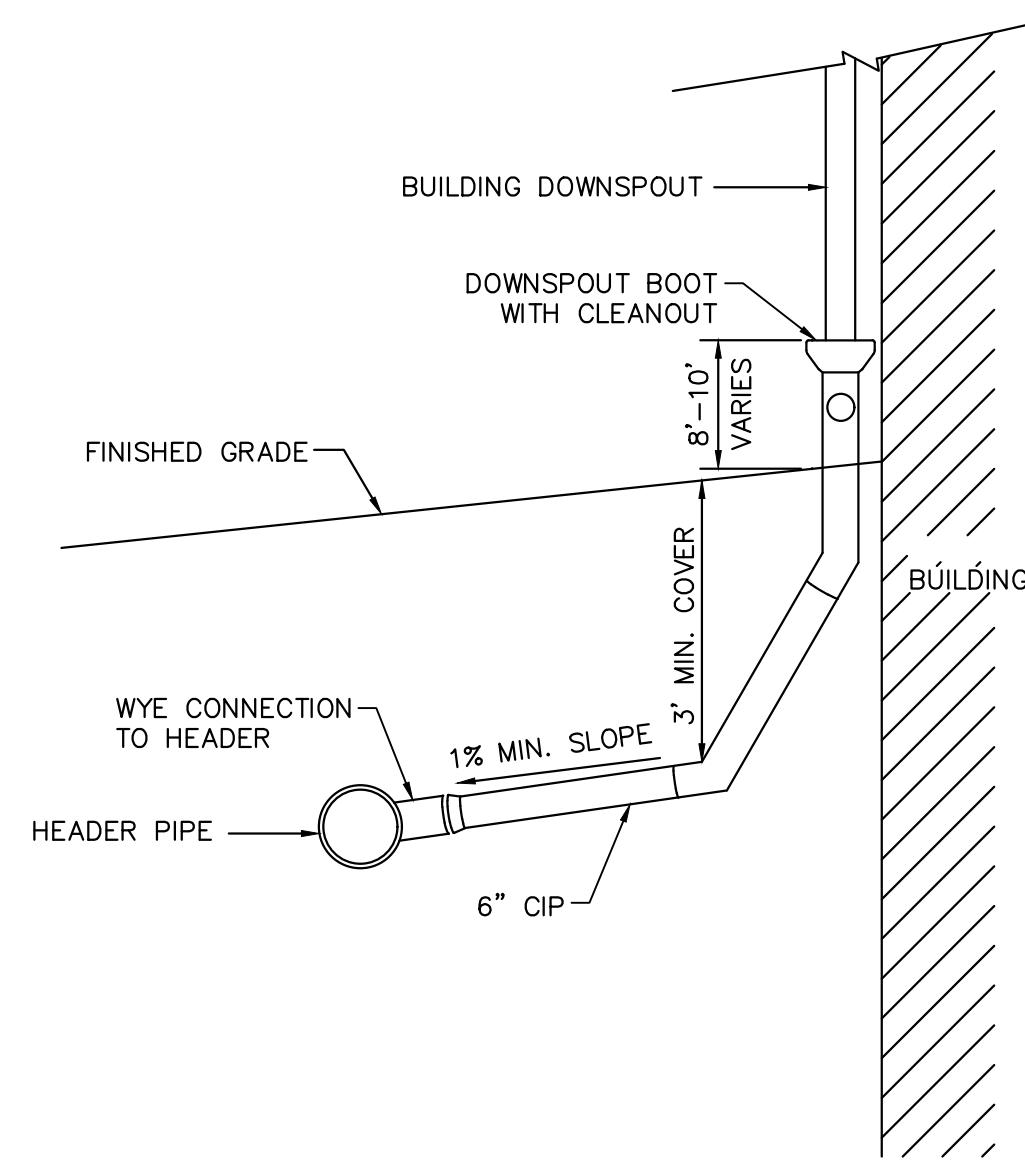

DOWNSPOUT LATERAL CONNECTION
SCALE: N.T.S.

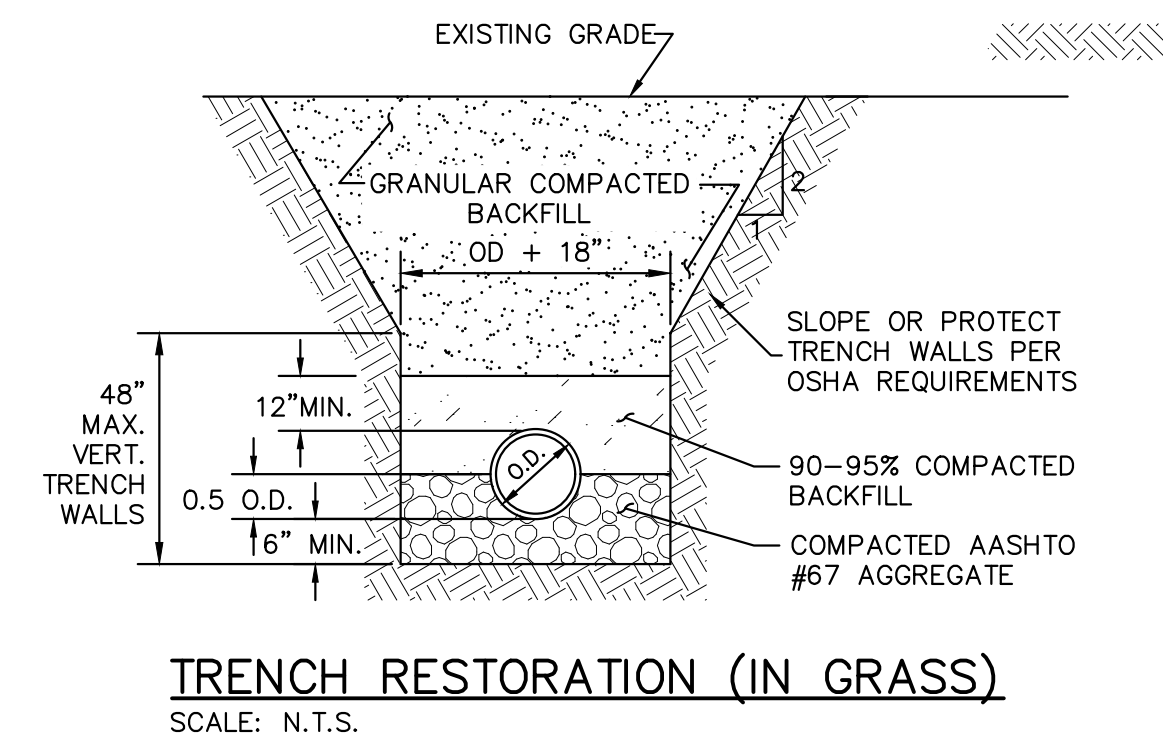

TRENCH RESTORATION (IN GRASS)
SCALE: N.T.S.

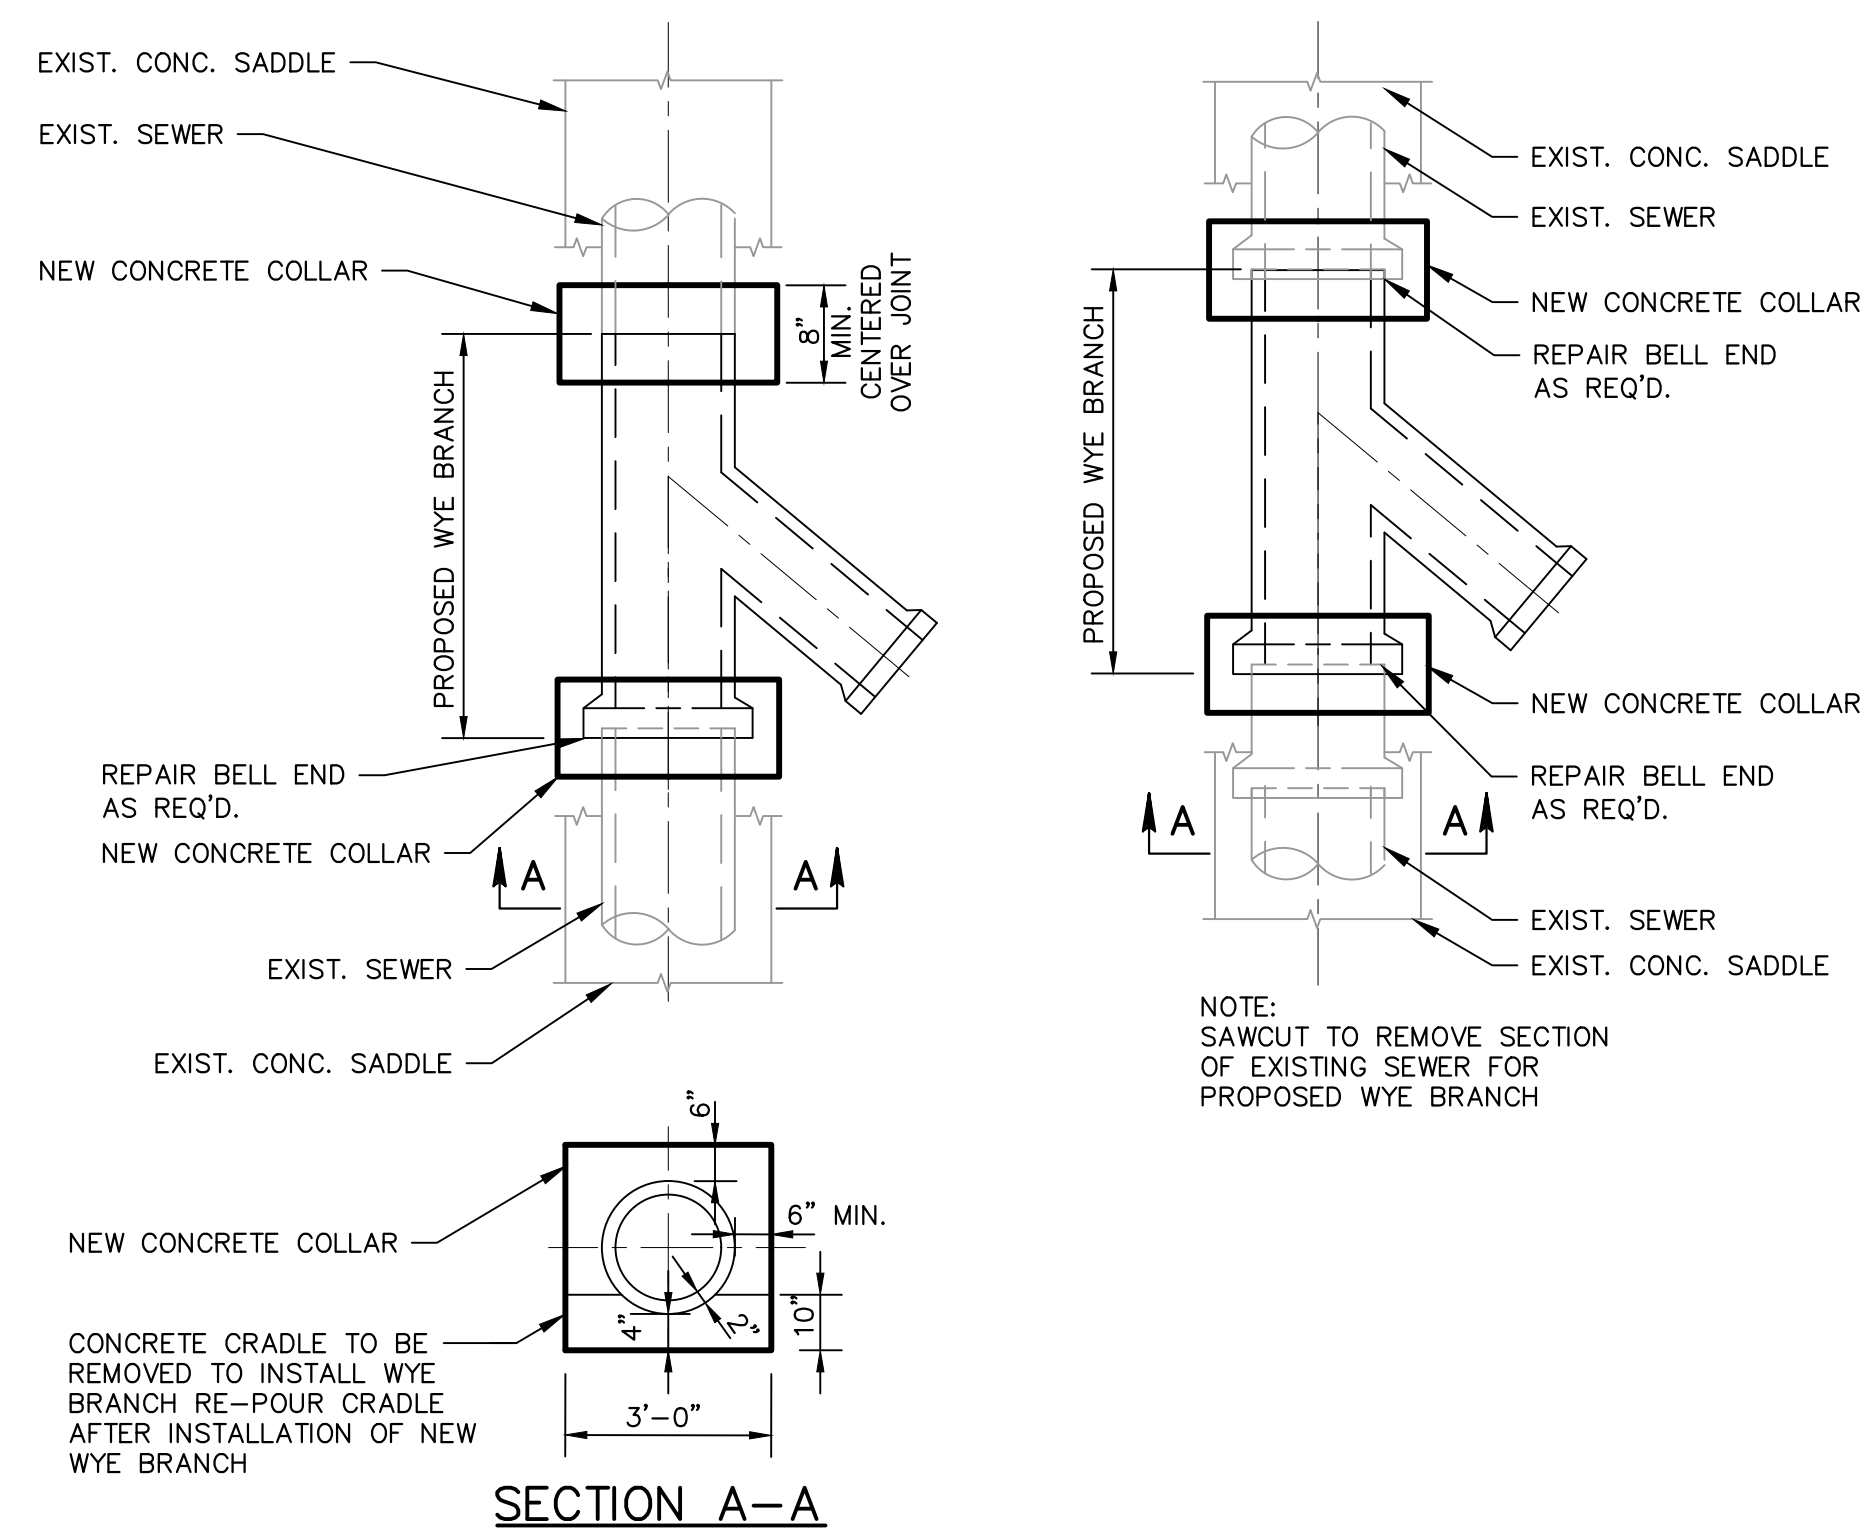


PREFABRICATED WYE BRANCH DETAIL
SCALE: N.T.S.

Seal:


By: [] Th: [] Checked: [] Date: 04/15/2024

Drawing Title:
UTILITY DETAILS


Drawing No.:
C8.1

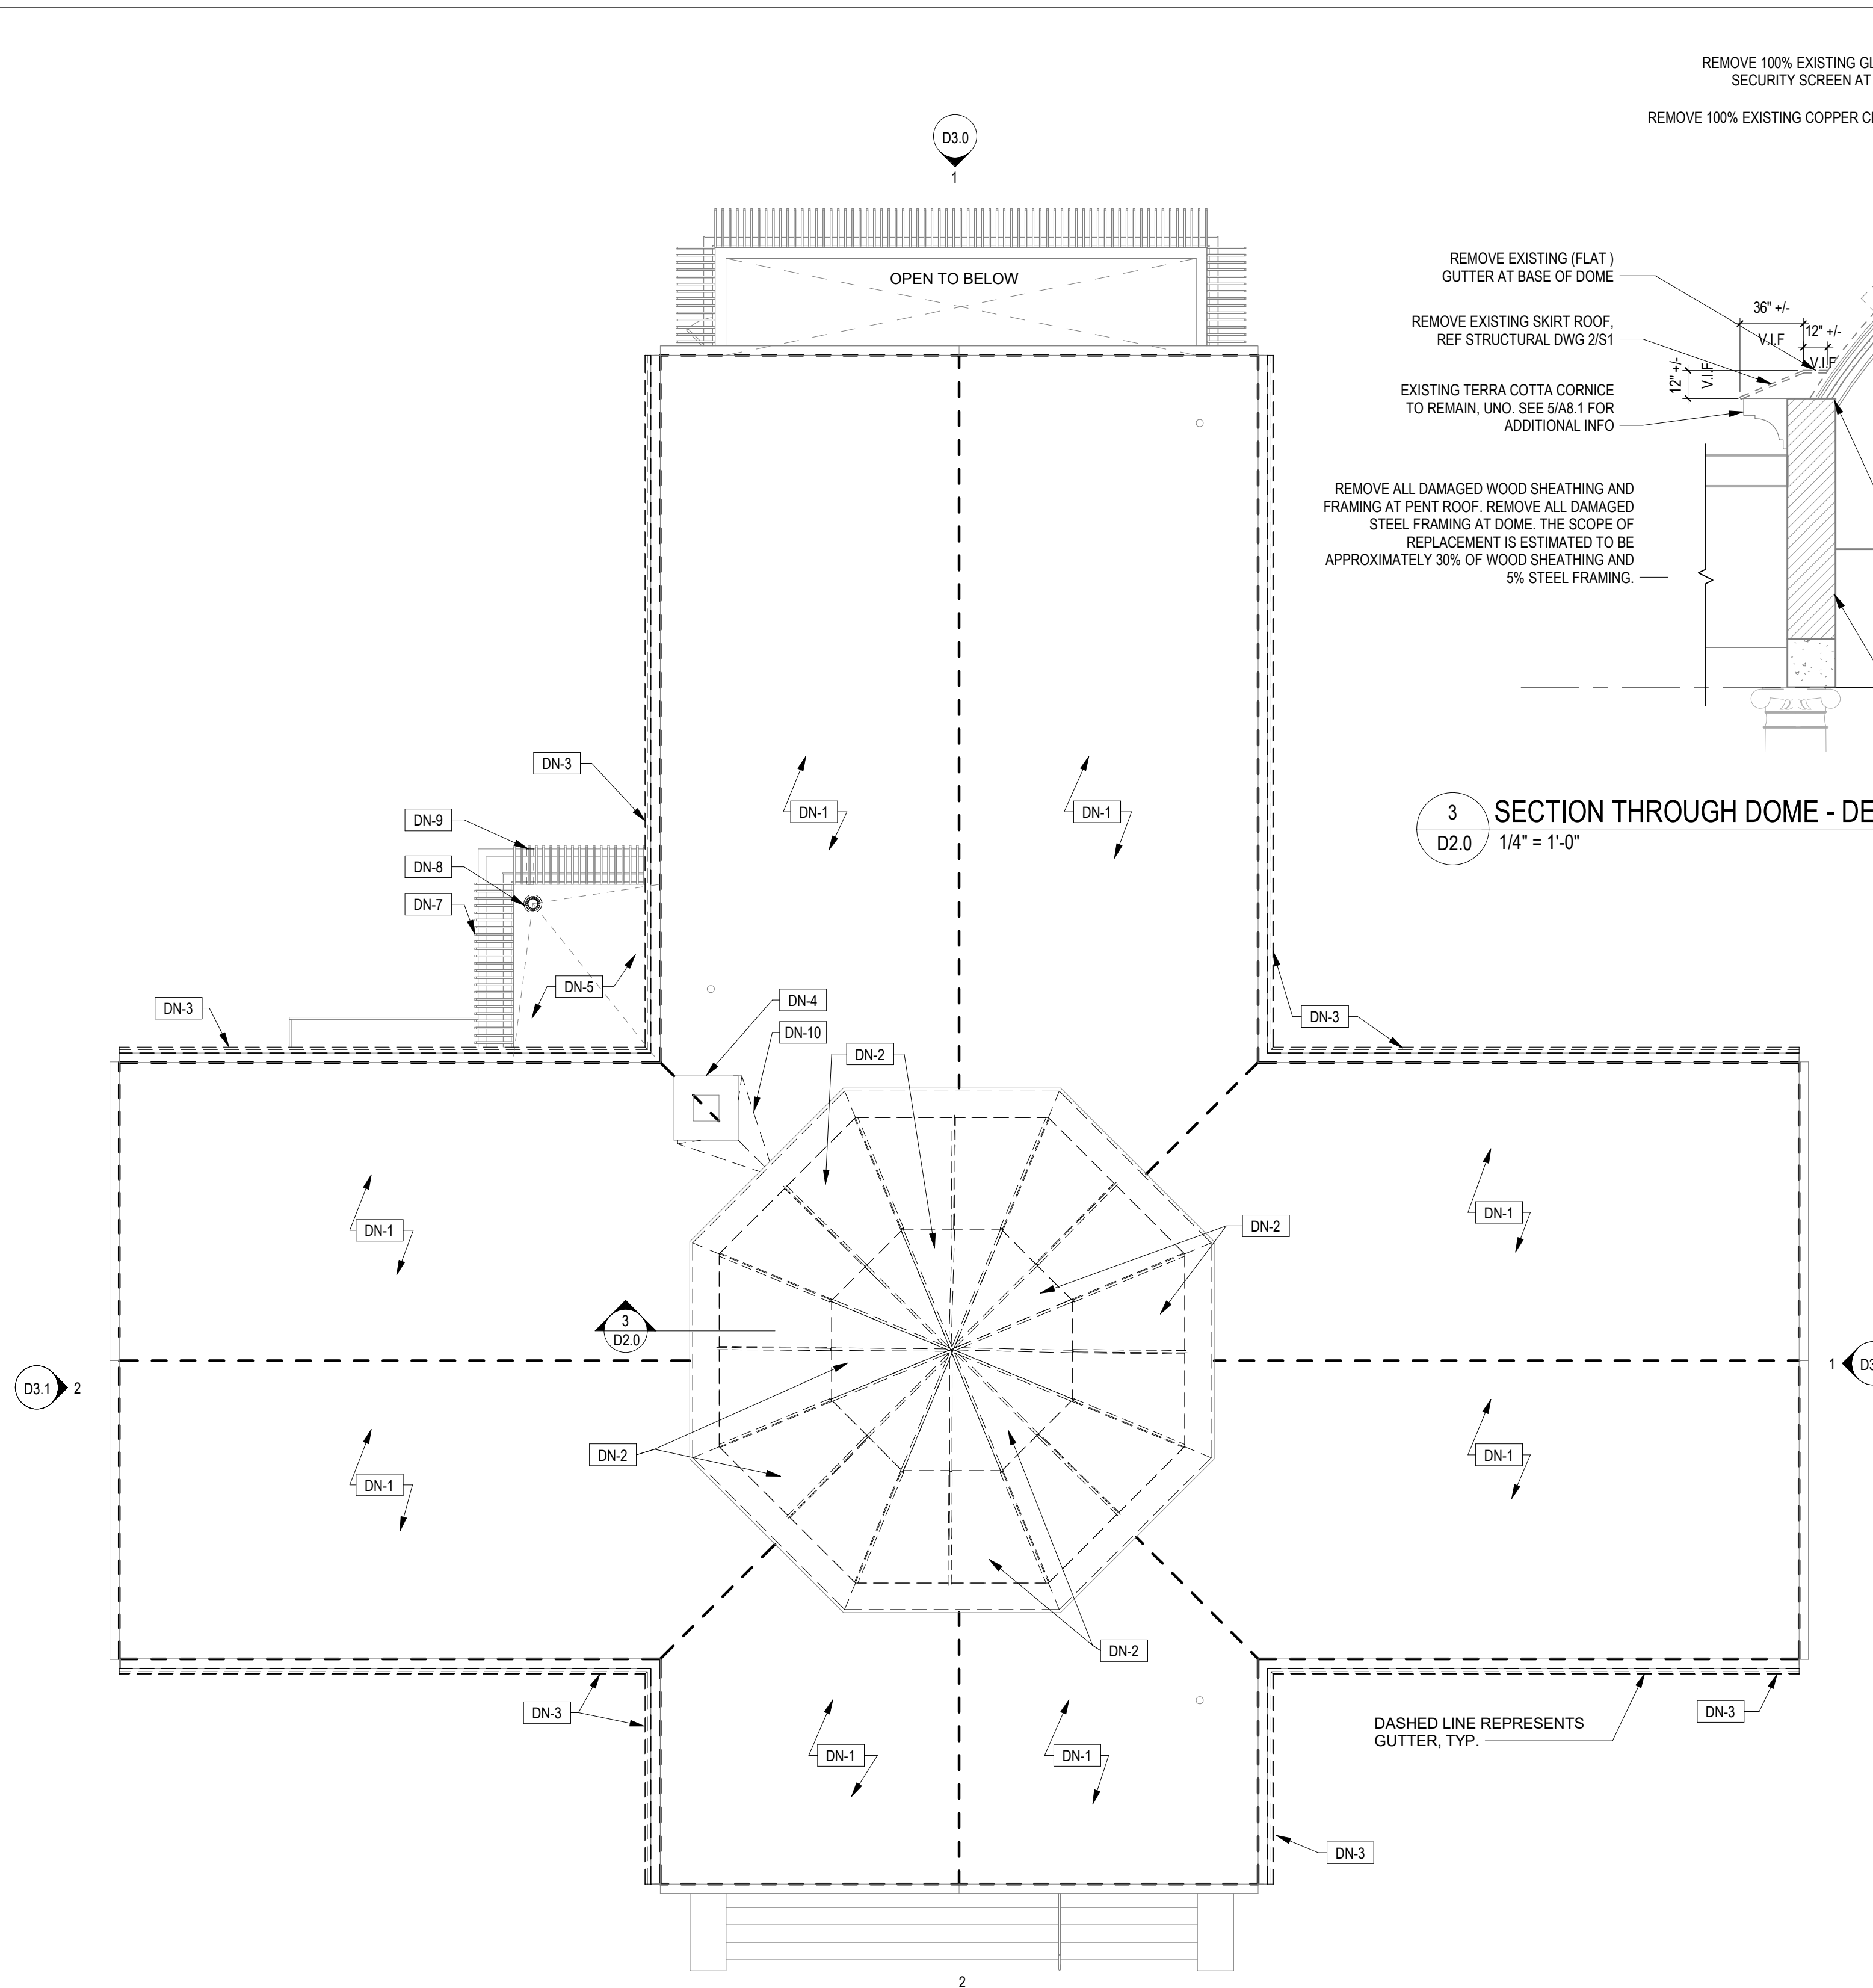

2 DEMOLITION - ROOF PLAN
D2.0 1/8" = 1'-0"

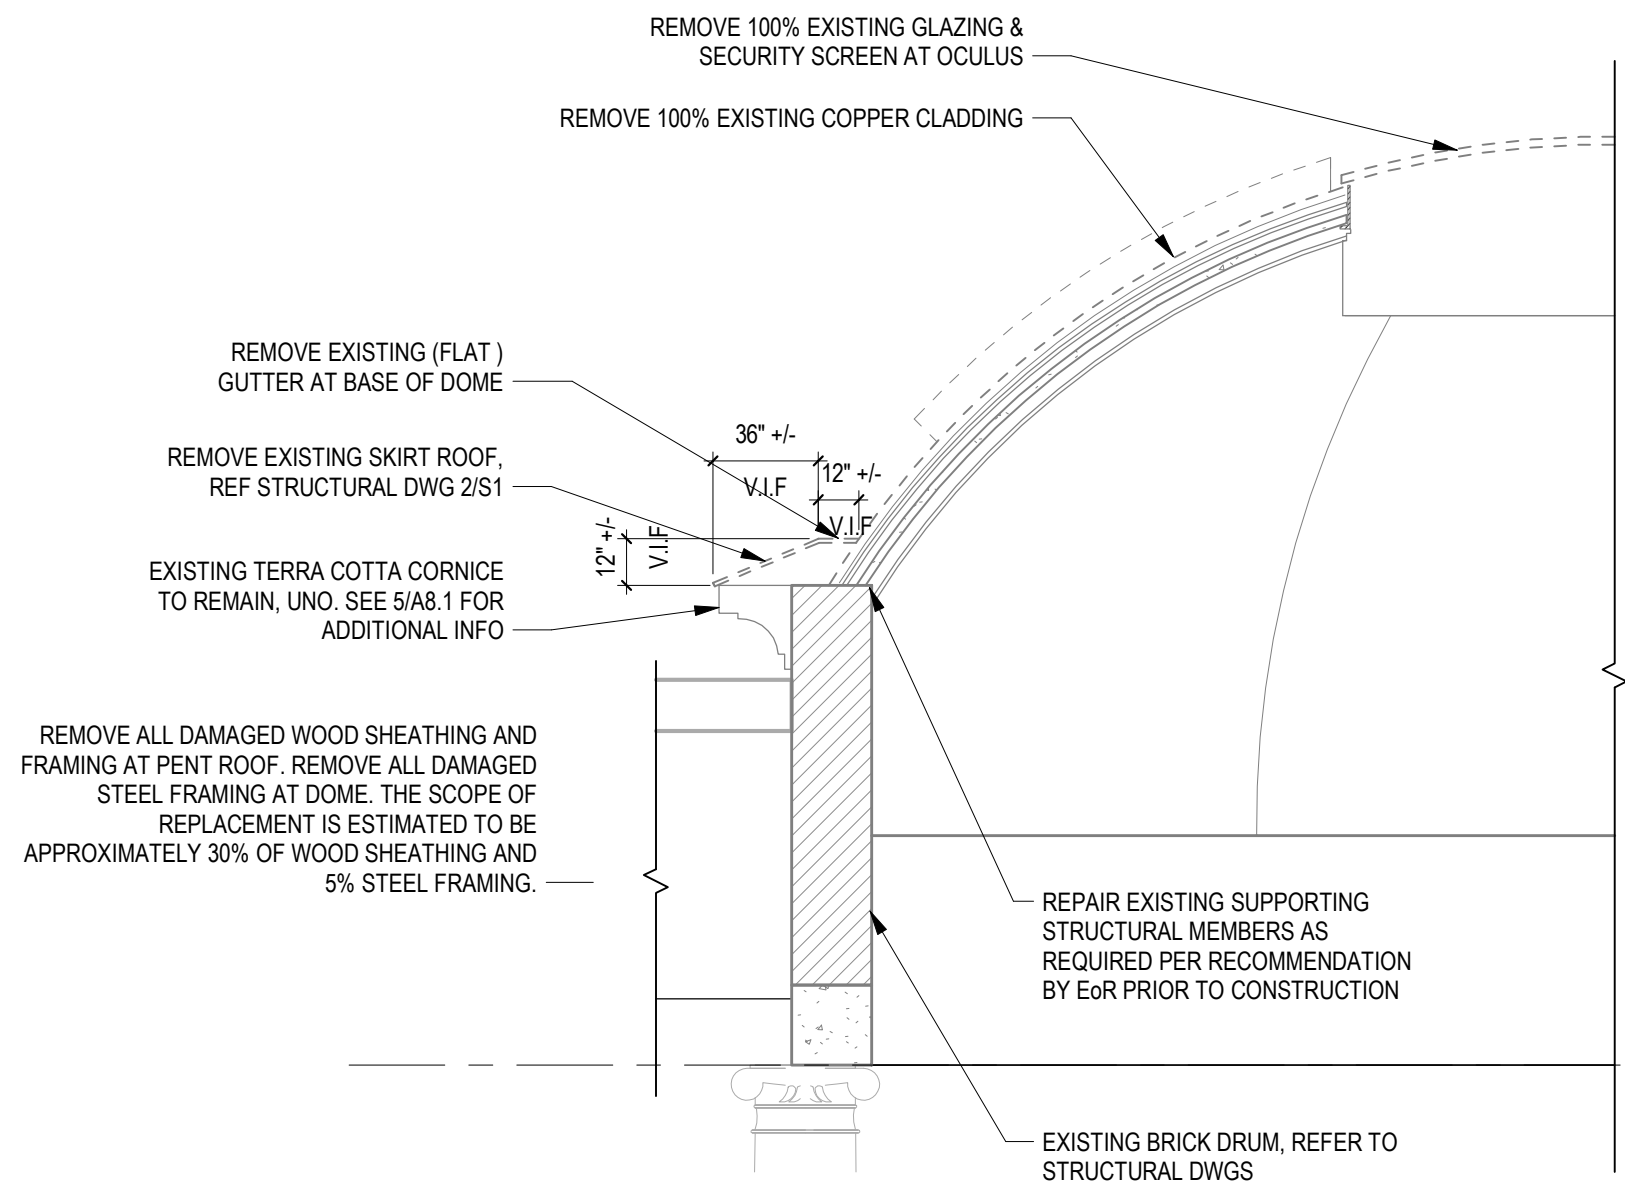


3 SECTION THROUGH DOME - DEMOLITION
D2.0 1/4" = 1'-0"

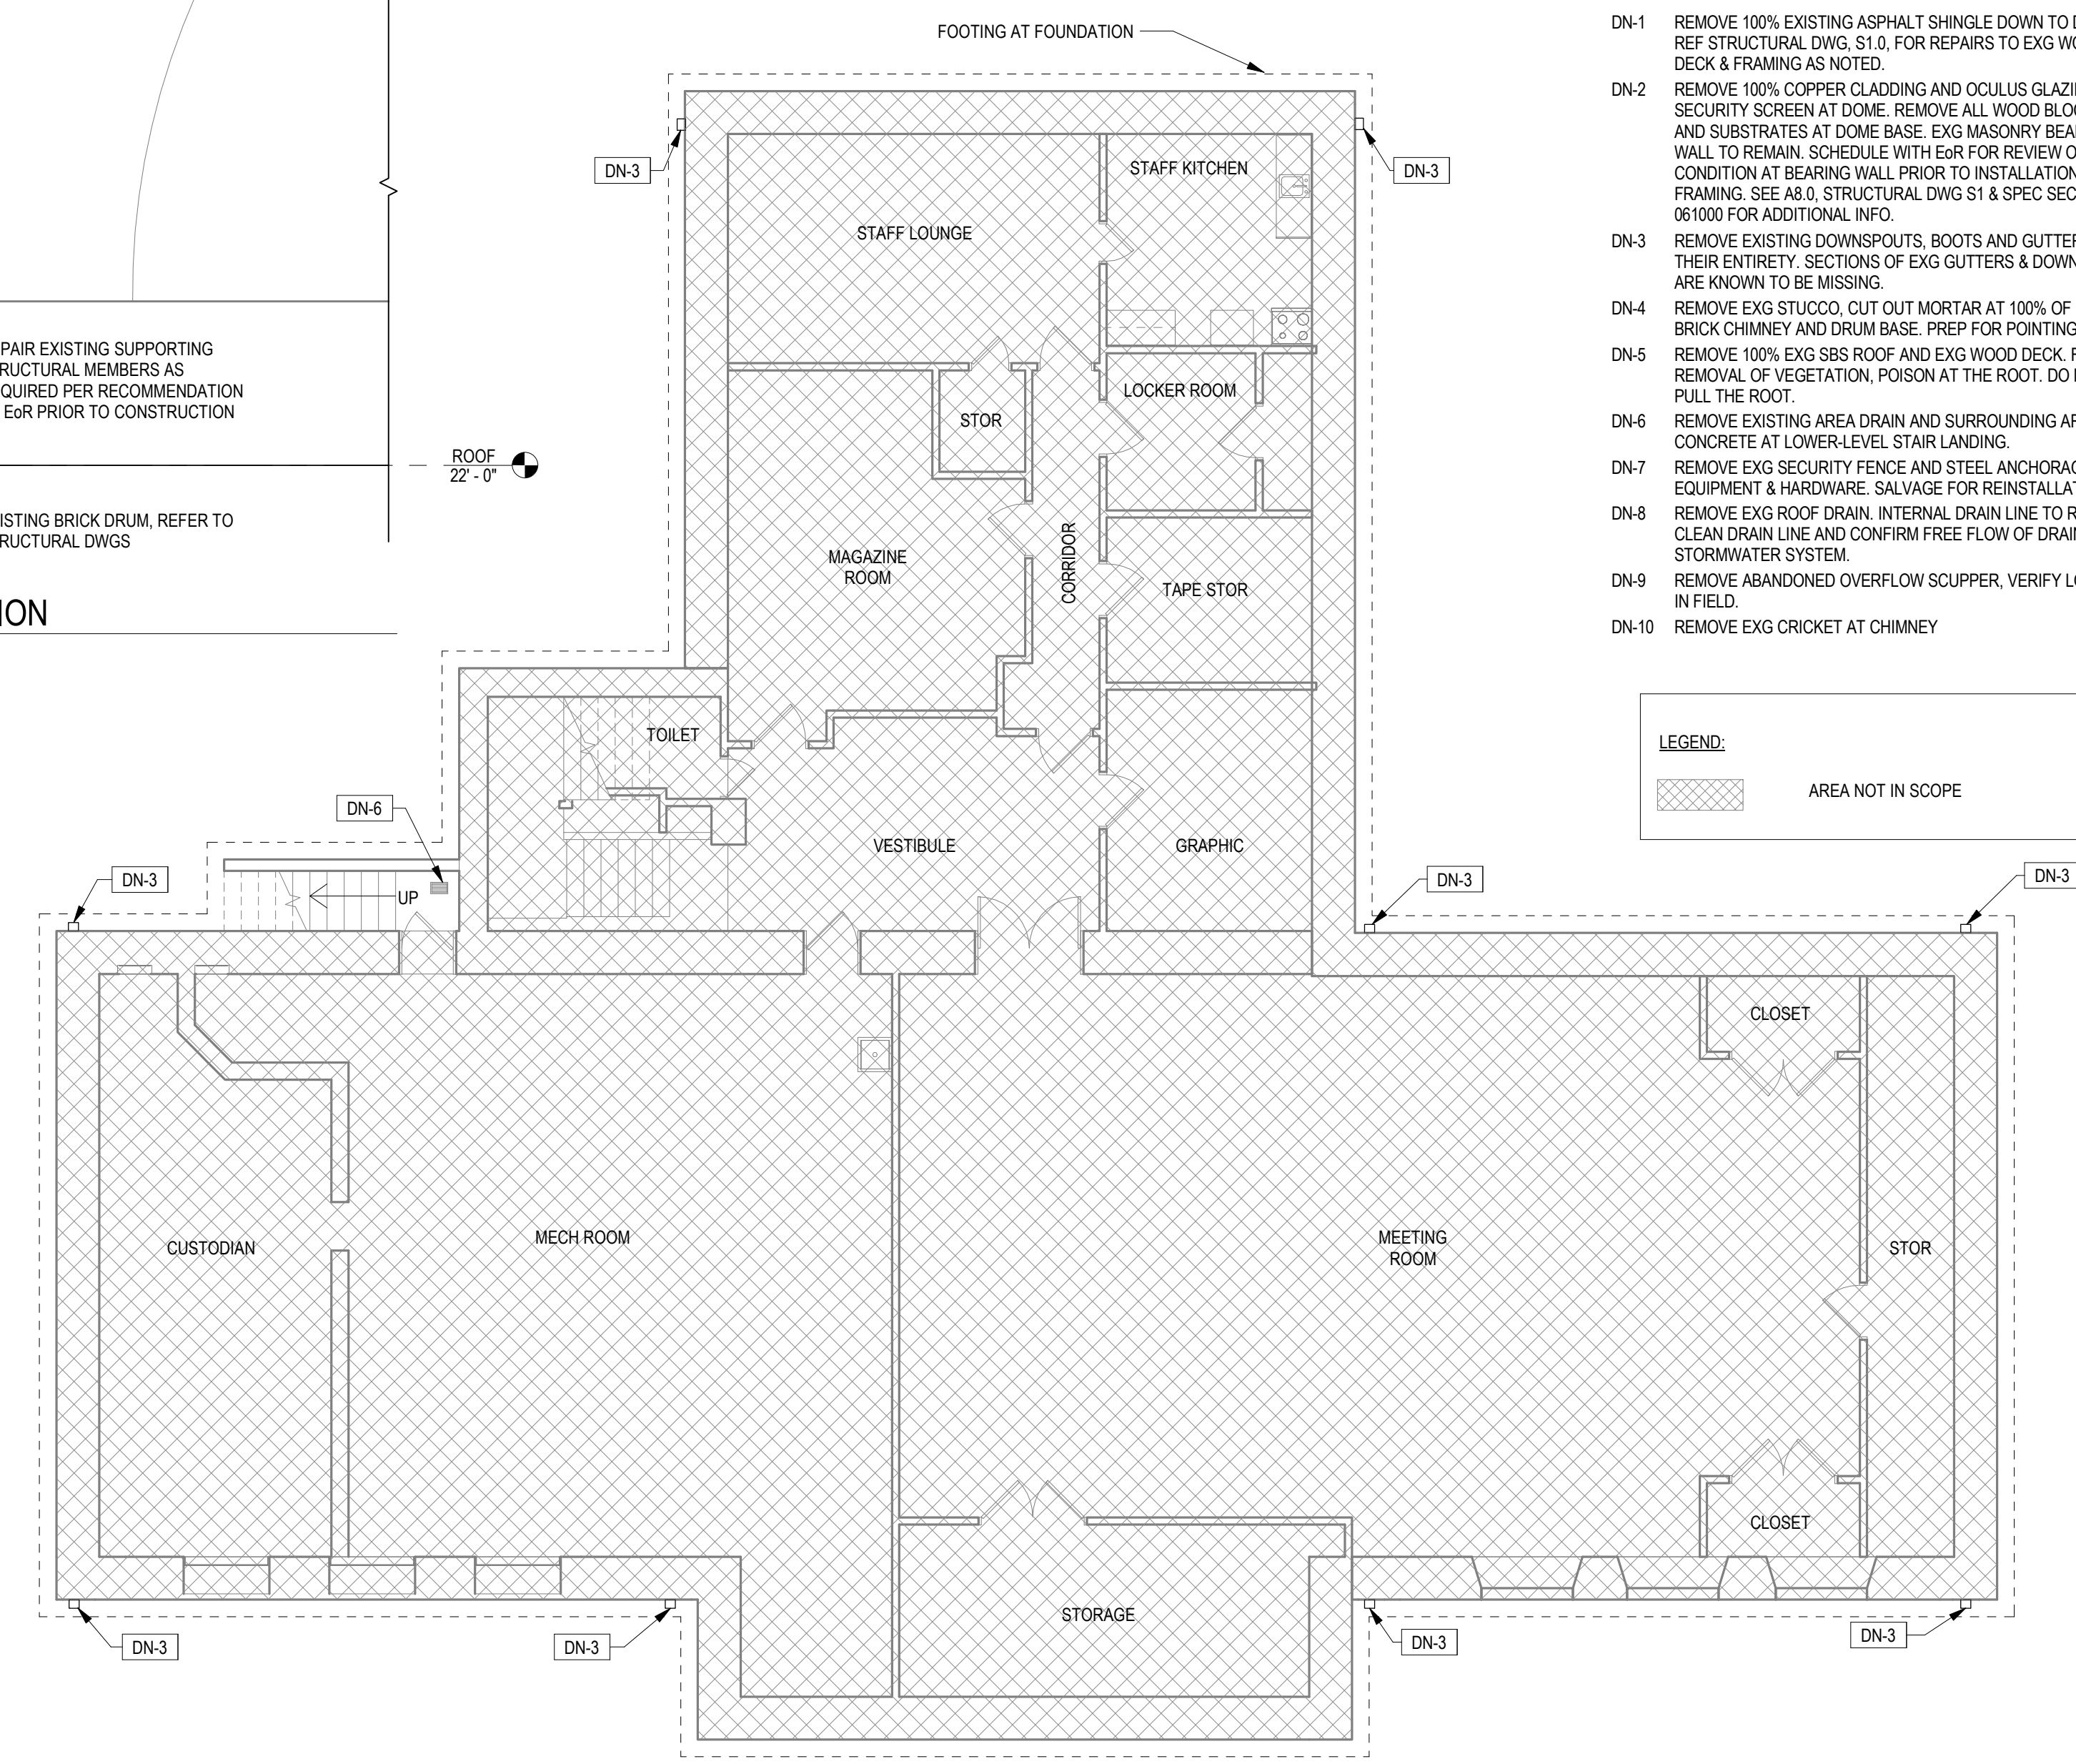

1 DEMOLITION - BASEMENT LEVEL
D2.0 1/8" = 1'-0"

- GENERAL DEMOLITION NOTES:**
1. VERIFY ALL EXG CONDITIONS AND DIMENSIONS IN FIELD PRIOR TO CONSTRUCTION.
 2. CUT A TEMPORARY ACCESS OPENING, BETWEEN RAFTERS, IN EACH QUADRANT OF CROSS-GABLE ROOF FOR REMOVAL OF EXG INSULATION.
 3. ALL EXG PIPE PENETRATIONS AT ROOF TO REMAIN.
 4. REPAIR EXG STRUCTURAL FRAME AS NOTED ON STRUCTURAL DRAWINGS S1.0.

- KEYED DEMOLITION NOTES**
- DN-1 REMOVE 100% EXISTING ASPHALT SHINGLE DOWN TO DECK. REF STRUCTURAL DWG. S1.0, FOR REPAIRS TO EXG WOOD DECK & FRAMING AS NOTED.
 - DN-2 REMOVE 100% COPPER CLADDING AND OCELLUS GLAZING AND SECURITY SCREEN AT DOME BASE. REMOVE ALL WOOD BLOCKING AND SUBSTRATES AT DOME BASE. EXG MASONRY BEARING WALL TO REMAIN. SCHEDULE WITH EOR FOR REVIEW OF EXG CONDITION AT BEARING WALL PRIOR TO INSTALLATION OF NEW FRAMING. SEE A8.0, STRUCTURAL DWG S1 & SPEC SECTION 061000 FOR ADDITIONAL INFO.
 - DN-3 REMOVE EXISTING DOWNSPOUTS, BOOTS AND GUTTERS IN THEIR ENTIRETY. SECTIONS OF EXG GUTTERS & DOWNSPOUTS ARE KNOWN TO BE MISSING.
 - DN-4 REMOVE EXG STUCCO, CUT OUT MORTAR AT 100% OF EXG BRICK CHIMNEY AND DRUM BASE. PREP FOR POINTING.
 - DN-5 REMOVE 100% EXG SBS ROOF AND EXG WOOD DECK. FOR REMOVAL OF VEGETATION, POISON AT THE ROOT. DO NOT PULL THE ROOT.
 - DN-6 REMOVE EXISTING AREA DRAIN AND SURROUNDING AREA OF CONCRETE AT LOWER-LEVEL STAIR LANDING.
 - DN-7 REMOVE EXG SECURITY FENCE AND STEEL ANCHORAGE EQUIPMENT & HARDWARE. SALVAGE FOR REINSTALLATION.
 - DN-8 REMOVE EXG ROOF DRAIN. INTERNAL DRAIN LINE TO REMAIN. CLEAN DRAIN LINE AND CONFIRM FREE FLOW OF DRAINAGE TO STORMWATER SYSTEM.
 - DN-9 REMOVE ABANDONED OVERFLOW SCUPPER, VERIFY LOCATION IN FIELD.
 - DN-10 REMOVE EXG CRICKET AT CHIMNEY

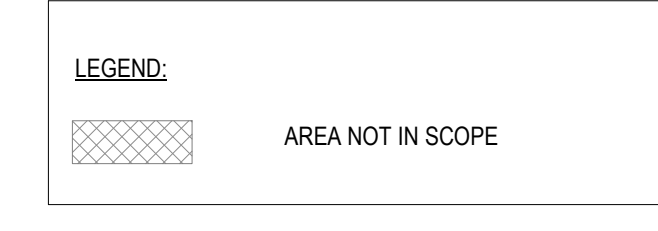

NOTE:
NO SCOPE OF WORK AT FIRST LEVEL DEMOLITION FLOOR PLAN,
HENCE OMITTED FROM SET OF DRAWINGS.



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210 Garden Avenue
Somersdale, NJ 08083
856 287 2424

Seal:

No.	Date	Revision

By: JH Checked: JPH Date: 04/15/2024


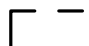
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DEMOLITION BASEMENT & ROOF PLAN


Drawing No.:
D2.0

GENERAL DEMOLITION NOTES:


1. ALL EXG CONDITIONS AND DIMENSIONS TO BE VERIFIED IN FIELD PRIOR TO CONSTRUCTION.
2. CUT A TEMPORARY ACCESS OPENING, BETWEEN RAFTERS, IN EACH QUADRANT OF CROSS-GABLE ROOF FOR REMOVAL OF EXG INSULATION.
3. ALL EXG PIPE PENETRATIONS AT ROOF TO REMAIN.
4. CUT OUT 100% OF JOINTS BETWEEN TERRA COTTA UNITS IN PREPARATION FOR POINTING.

LEGEND:

-  DAMAGED TERRA COTTA UNITS. REF A3.0 & A3.1 FOR UNITS REQUIRING REPAIR
-  CUT OUT AND REMOVE DESTABILIZED SECTIONS OF TERRA COTTA

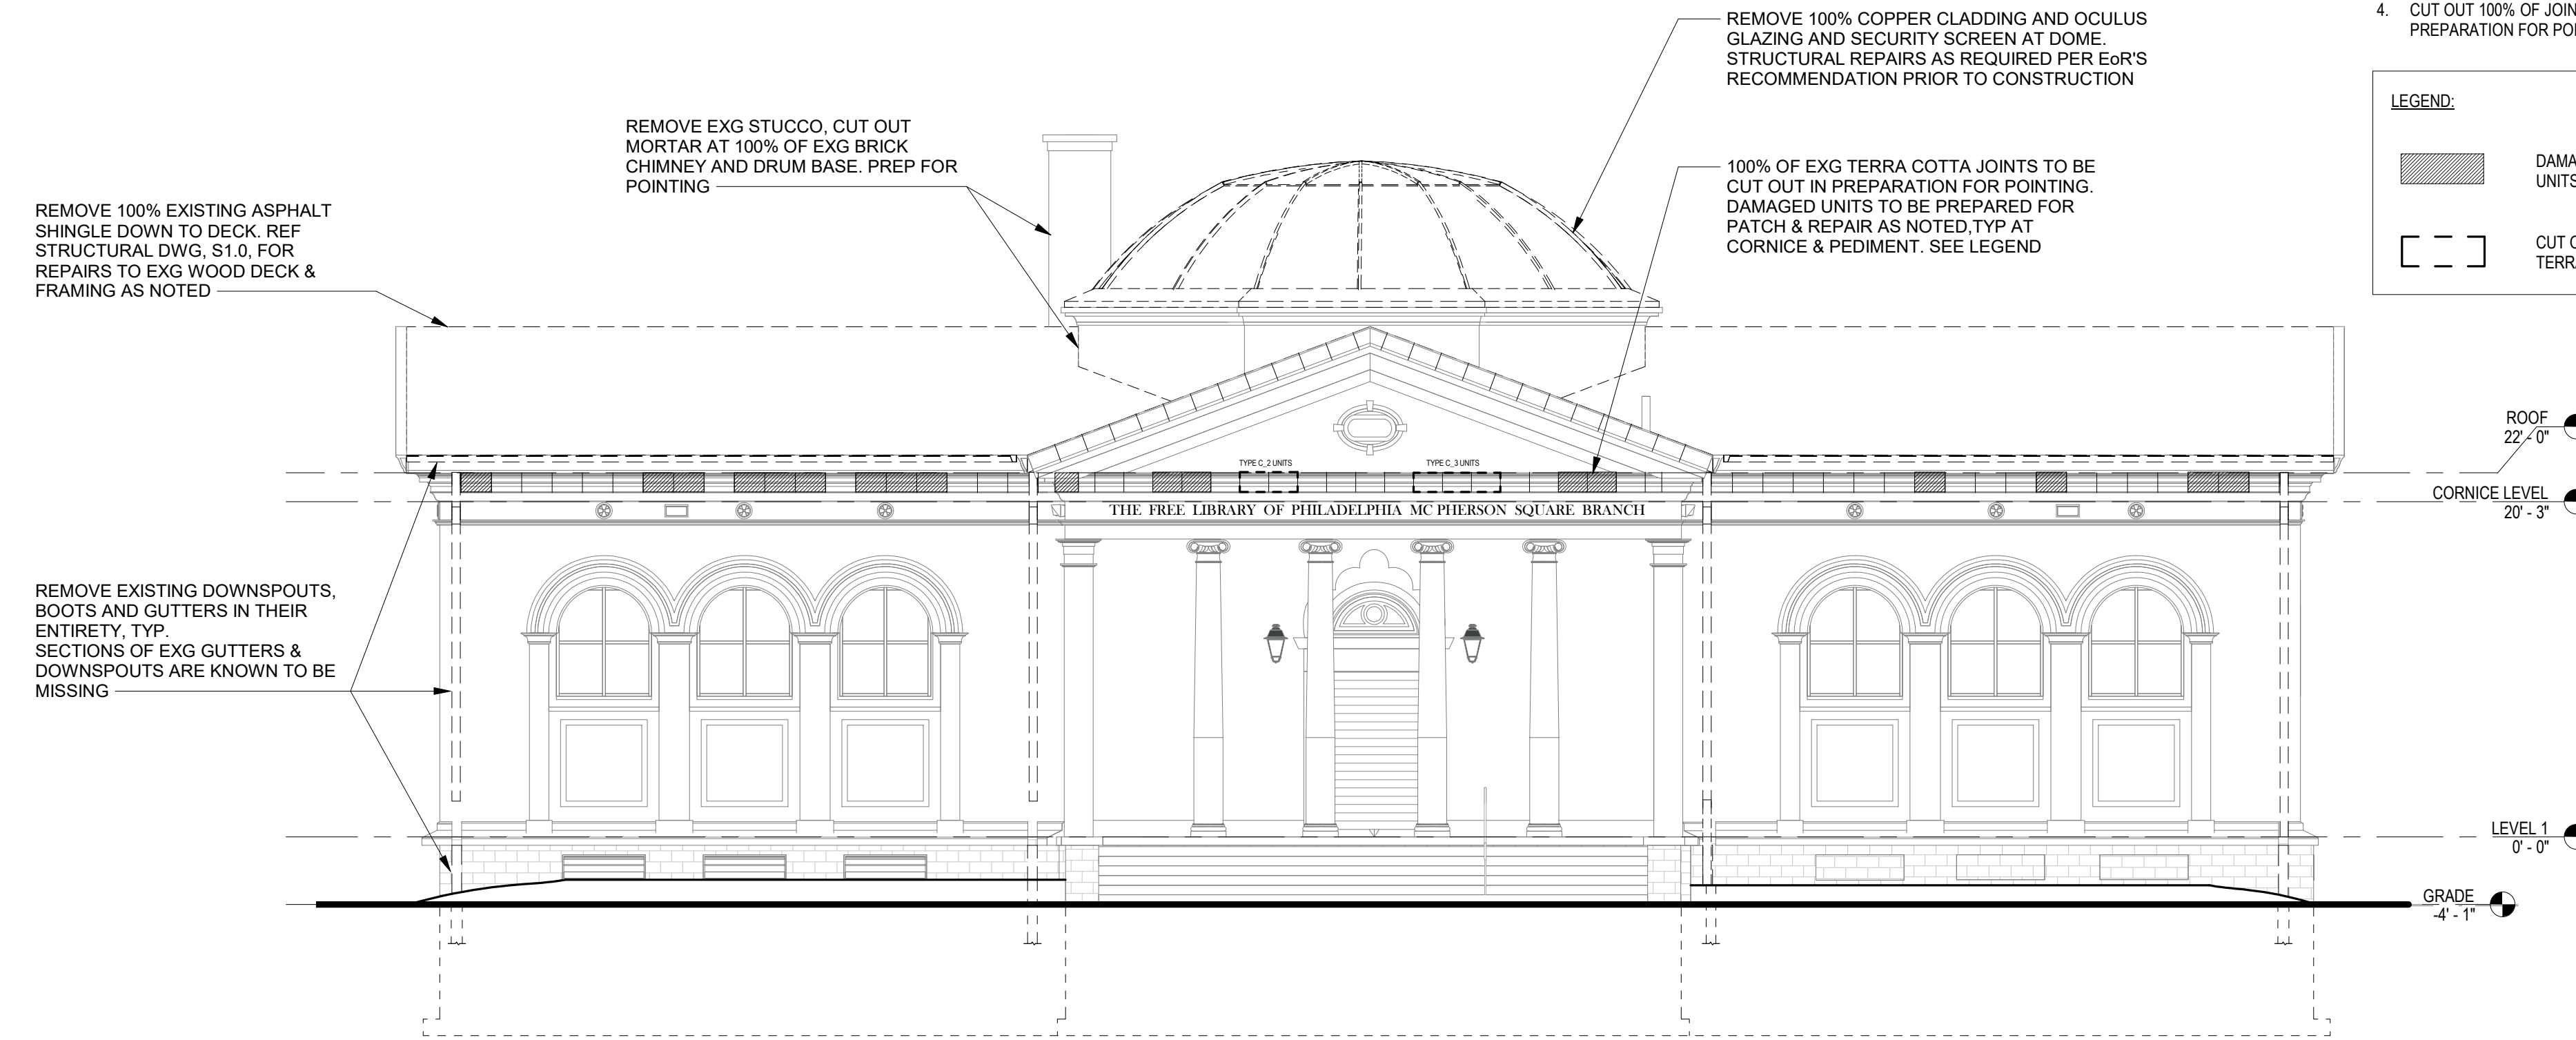

2 SOUTH (FRONT) ELEVATION
D3.0 1/8" = 1'-0"

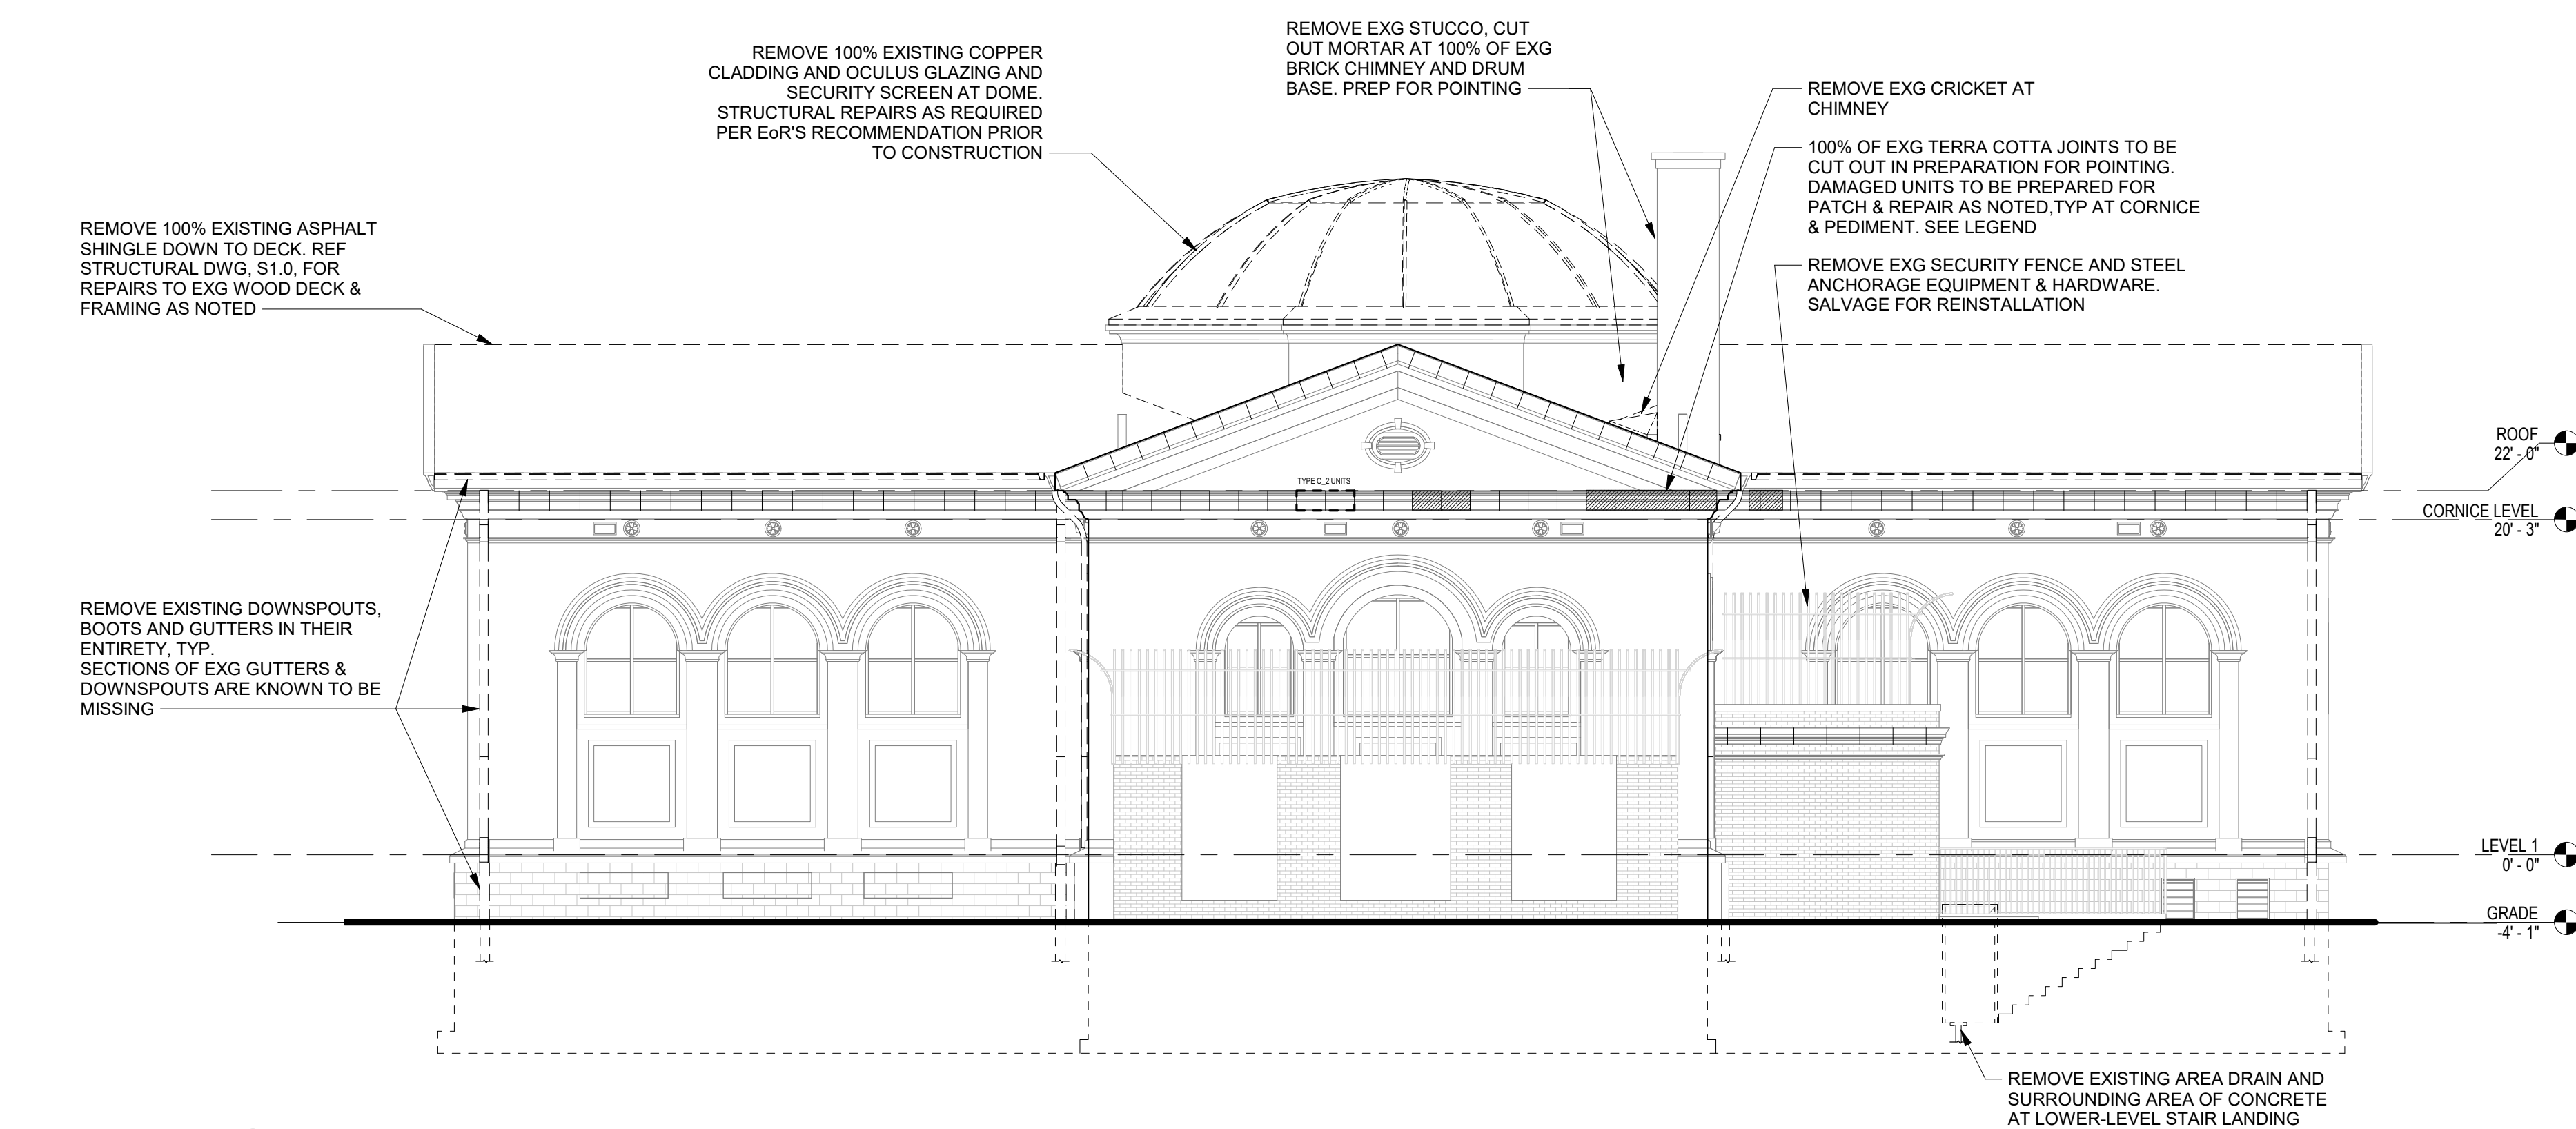

1 NORTH (REAR) ELEVATION
D3.0 1/8" = 1'-0"

Seal:

No.	Date	Revision

By: JH Checked: JGH Scale: AS NOTED
Date: 04/15/2024

Drawing Title:
DEMOLITION EXTERIOR
ELEVATIONS

Drawing No.:
D3.0

Seal:

No.	Date	Revision

By: JH Checked: JPH Scale: AS NOTED
Date: 04/15/2024


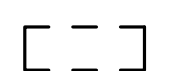
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DEMOLITION EXTERIOR
ELEVATIONS


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D3.1

GENERAL DEMOLITION NOTES:


1. ALL EXG CONDITIONS AND DIMENSIONS TO BE VERIFIED IN FIELD PRIOR TO CONSTRUCTION.
2. CUT A TEMPORARY ACCESS OPENING, BETWEEN RAFTERS, IN EACH QUADRANT OF CROSS-GABLE ROOF FOR REMOVAL OF EXG INSULATION.
3. ALL EXG PIPE PENETRATIONS AT ROOF TO REMAIN.
4. CUT OUT 100% OF JOINTS BETWEEN TERRA COTTA UNITS IN PREPARATION FOR POINTING.

LEGEND:


-  DAMAGED TERRA COTTA UNITS. REF A3.0 & A3.1 FOR UNITS REQUIRING REPAIR
-  CUT OUT AND REMOVE DESTABILIZED SECTIONS OF TERRA COTTA

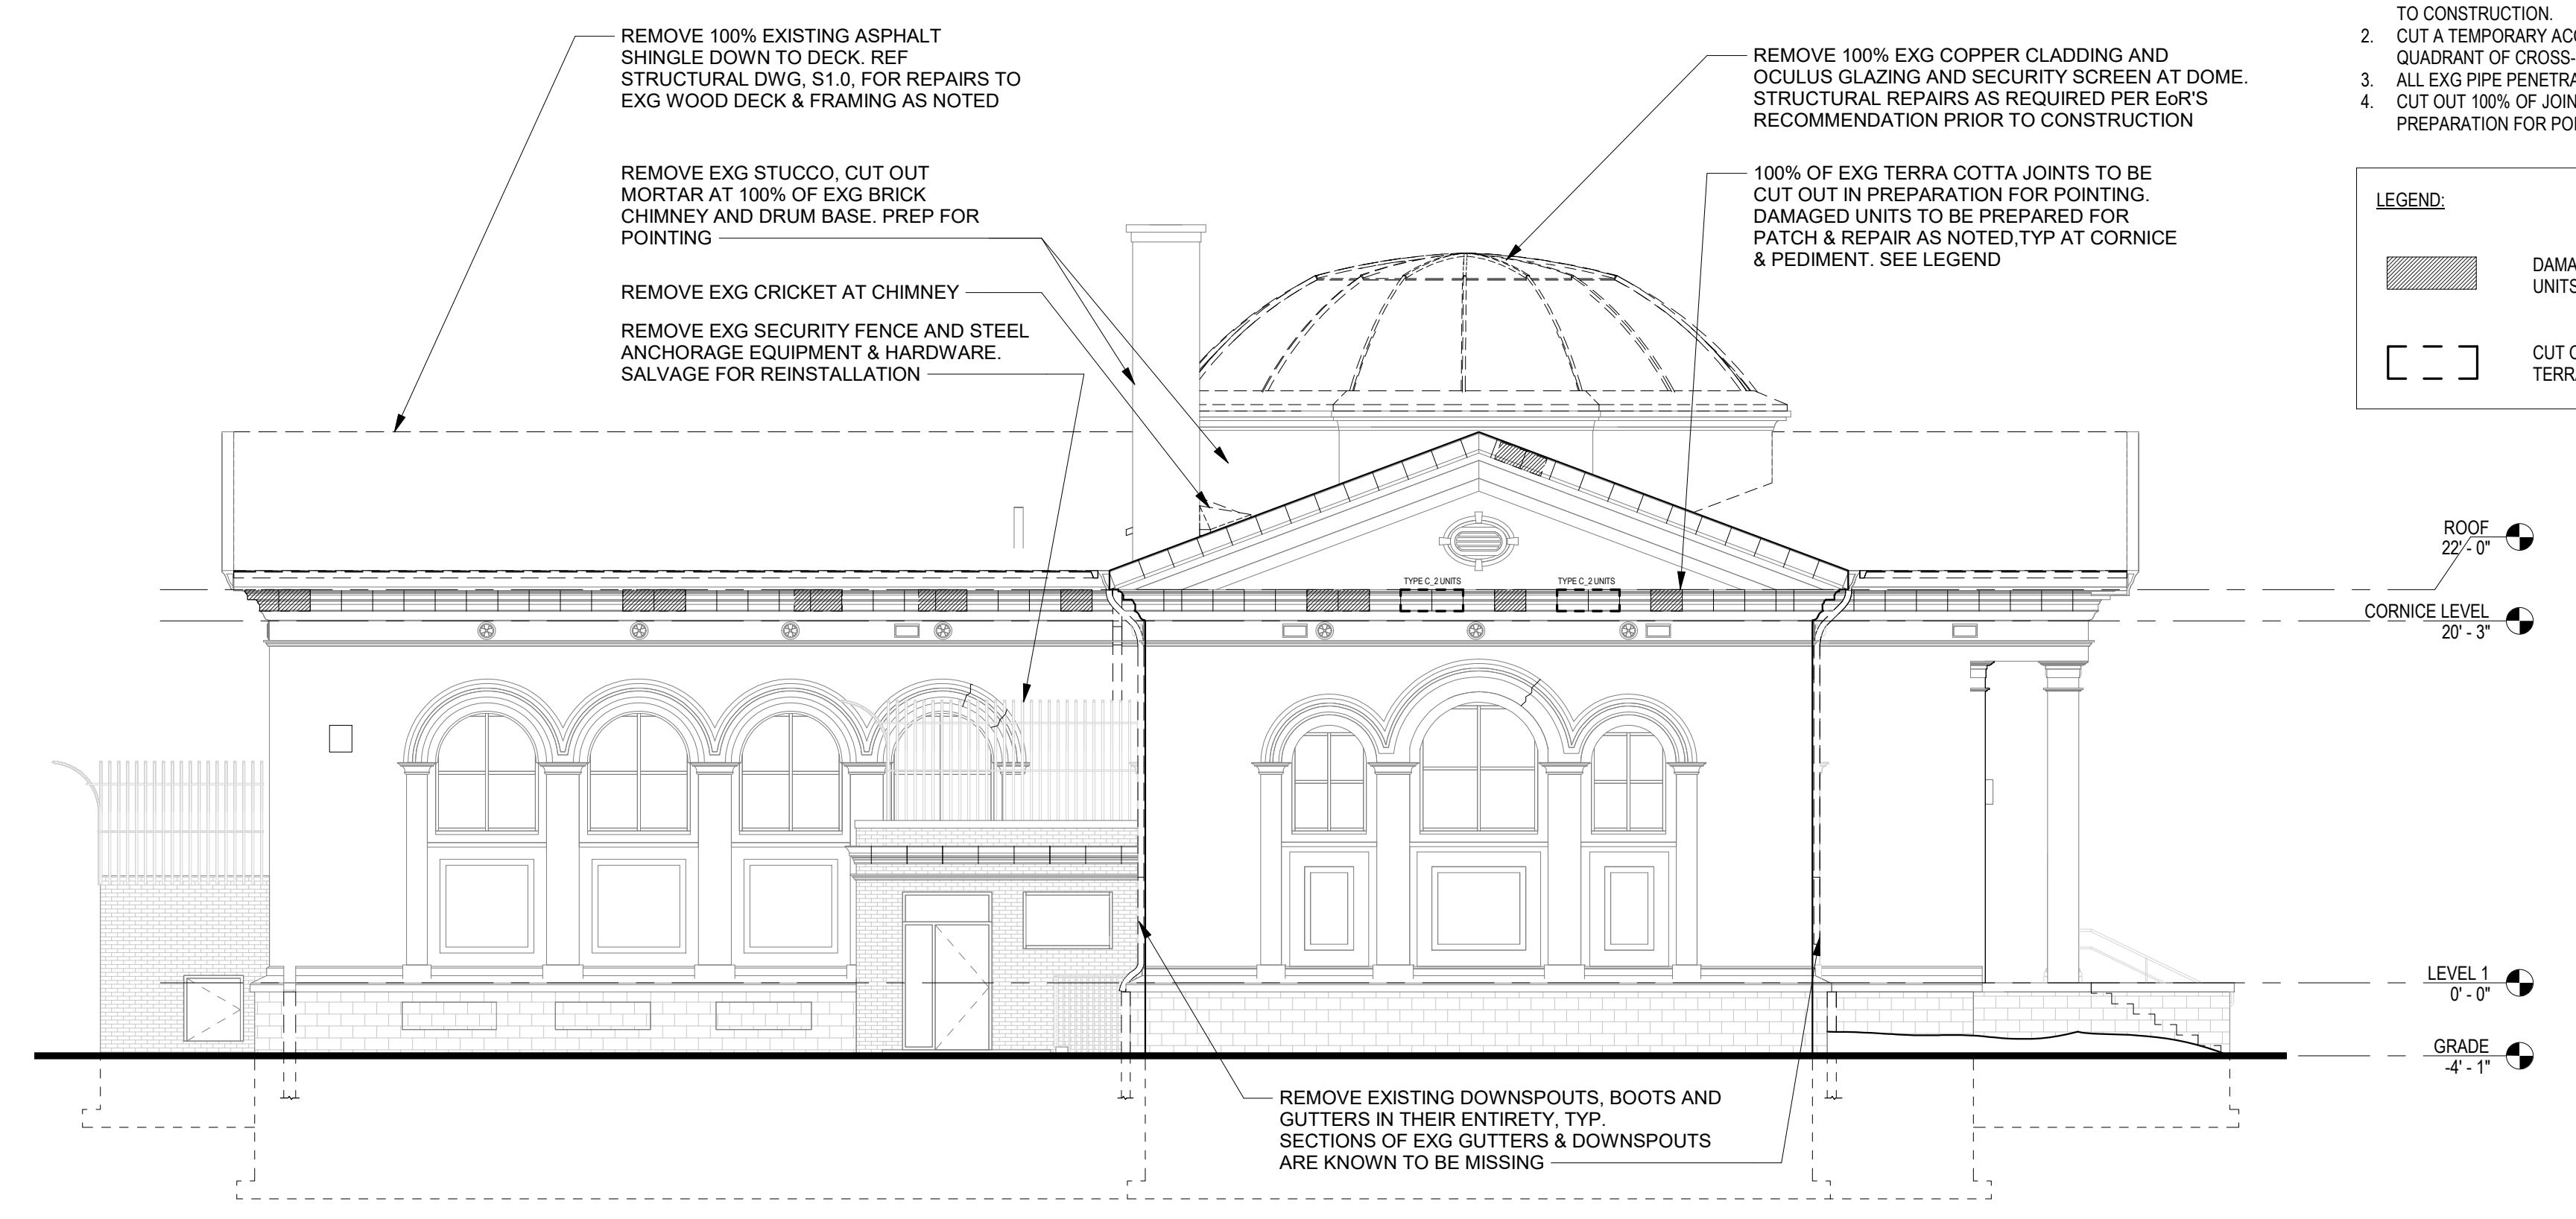


2 WEST ELEVATION
D3.1 1/8" = 1'-0"

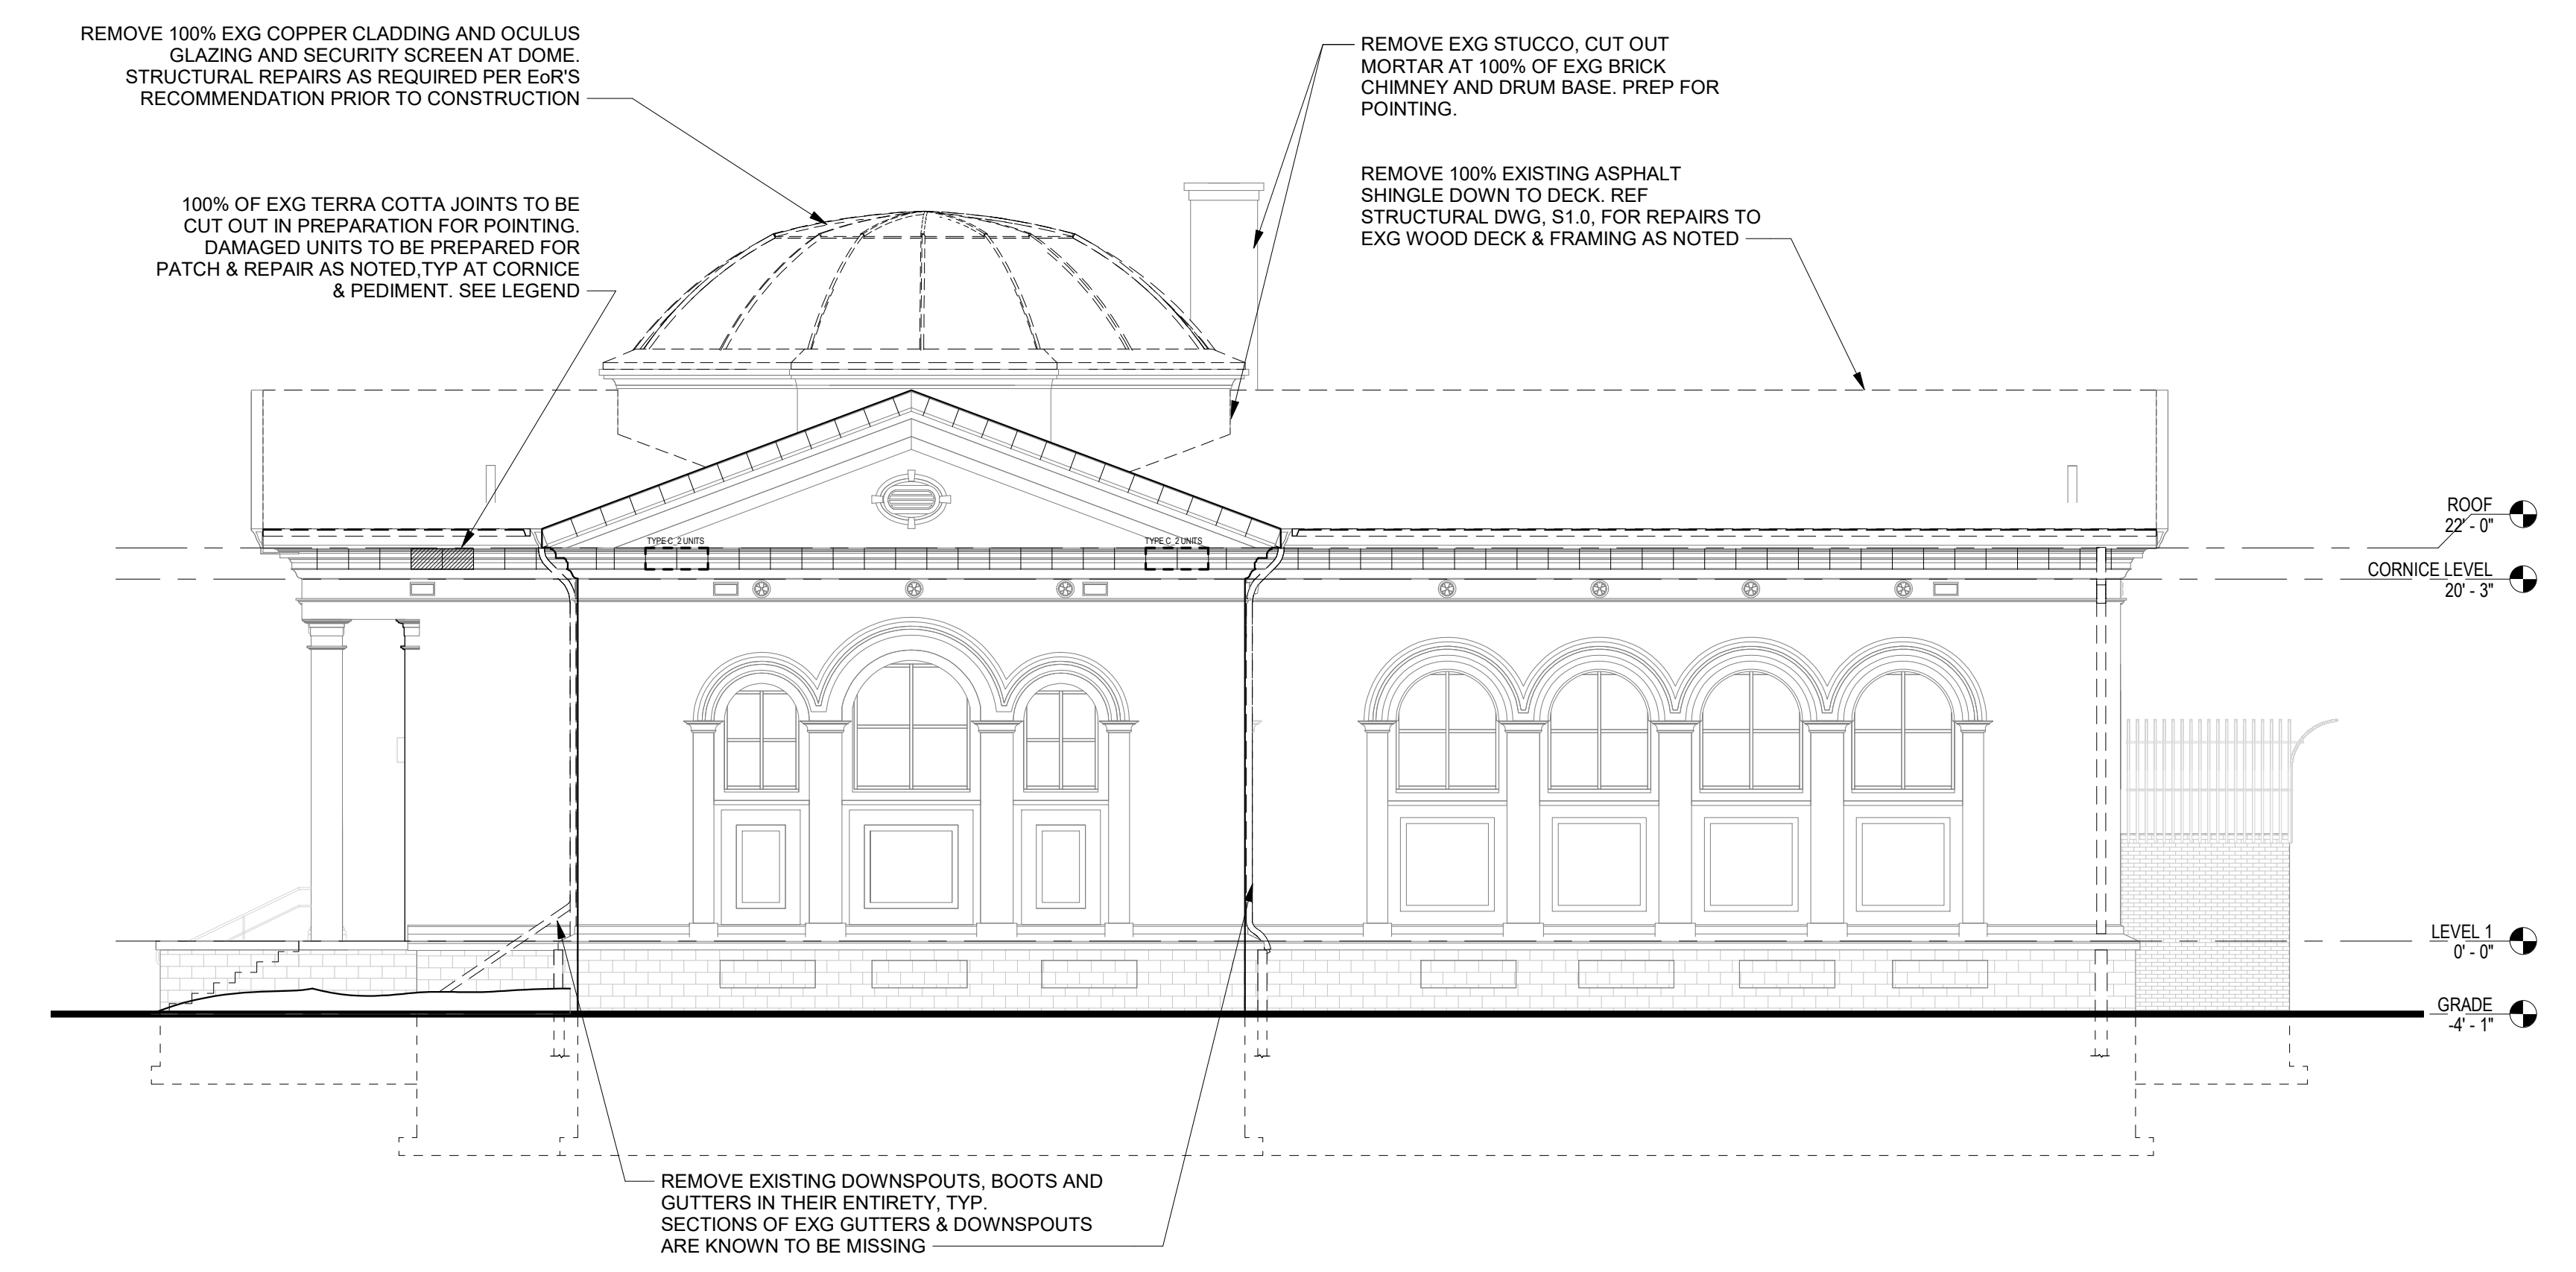

1 EAST ELEVATION
D3.1 1/8" = 1'-0"

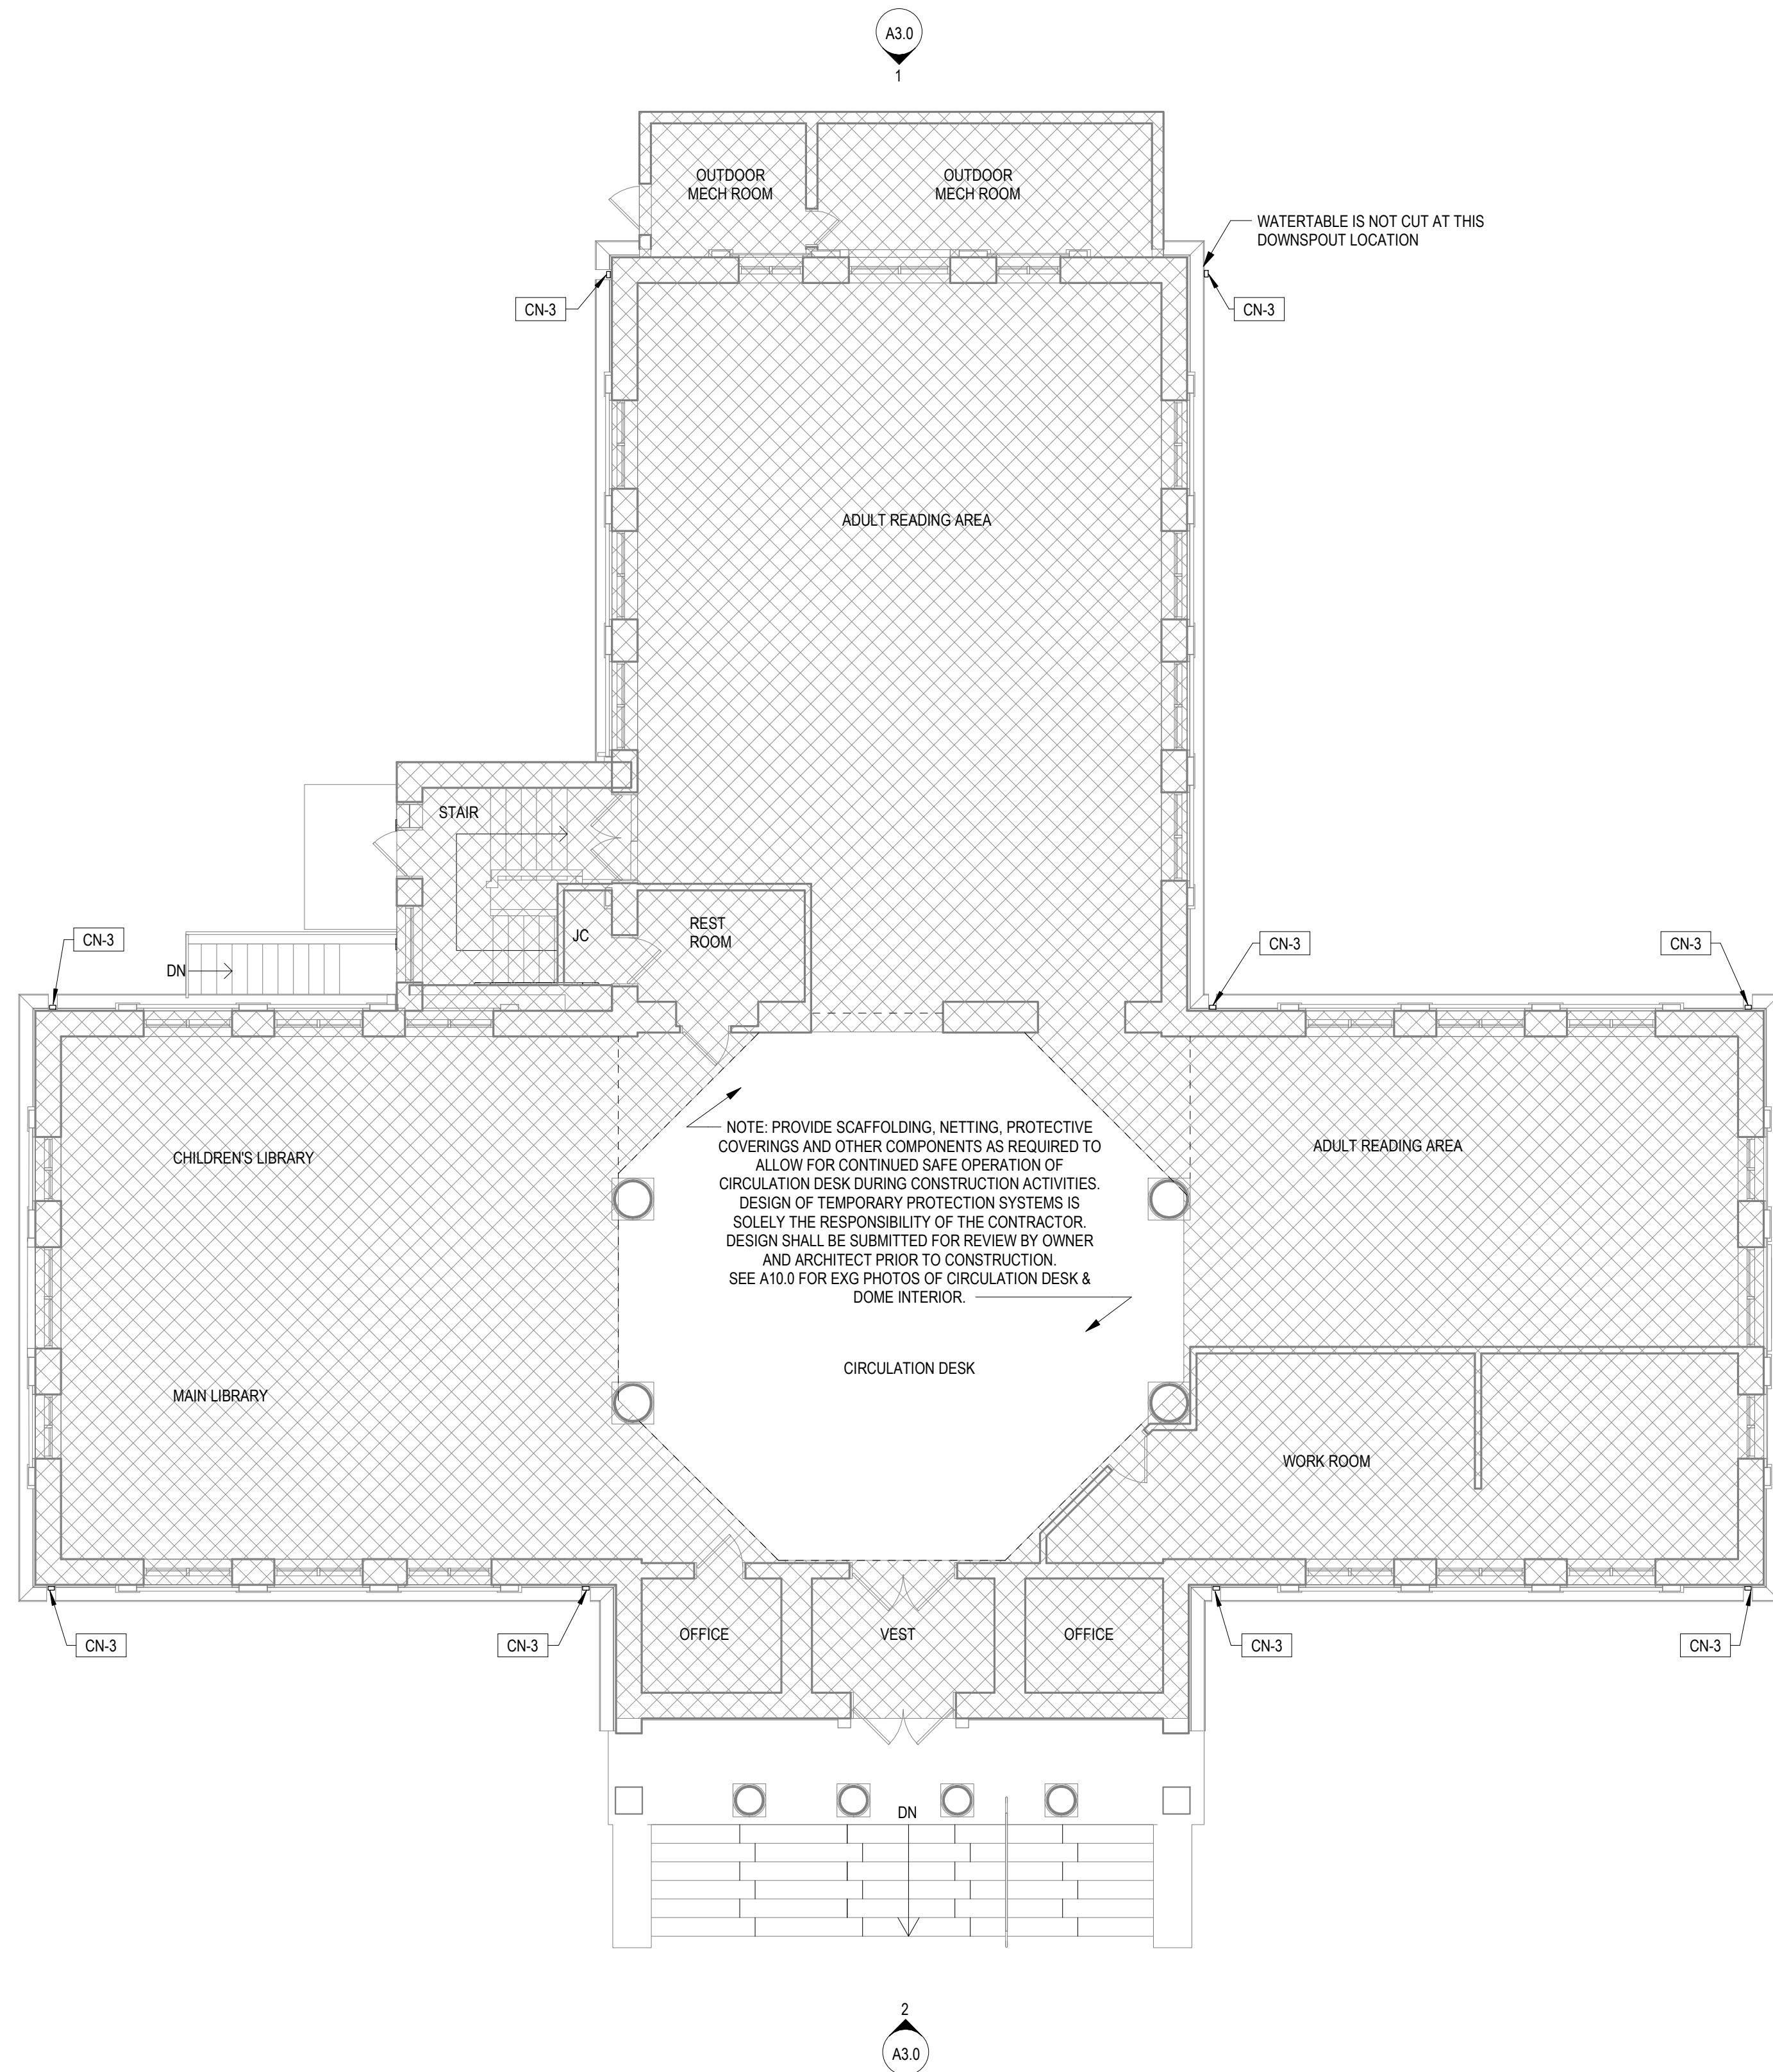

2 FIRST FLOOR PLAN
A2.0 1/8" = 1'-0"

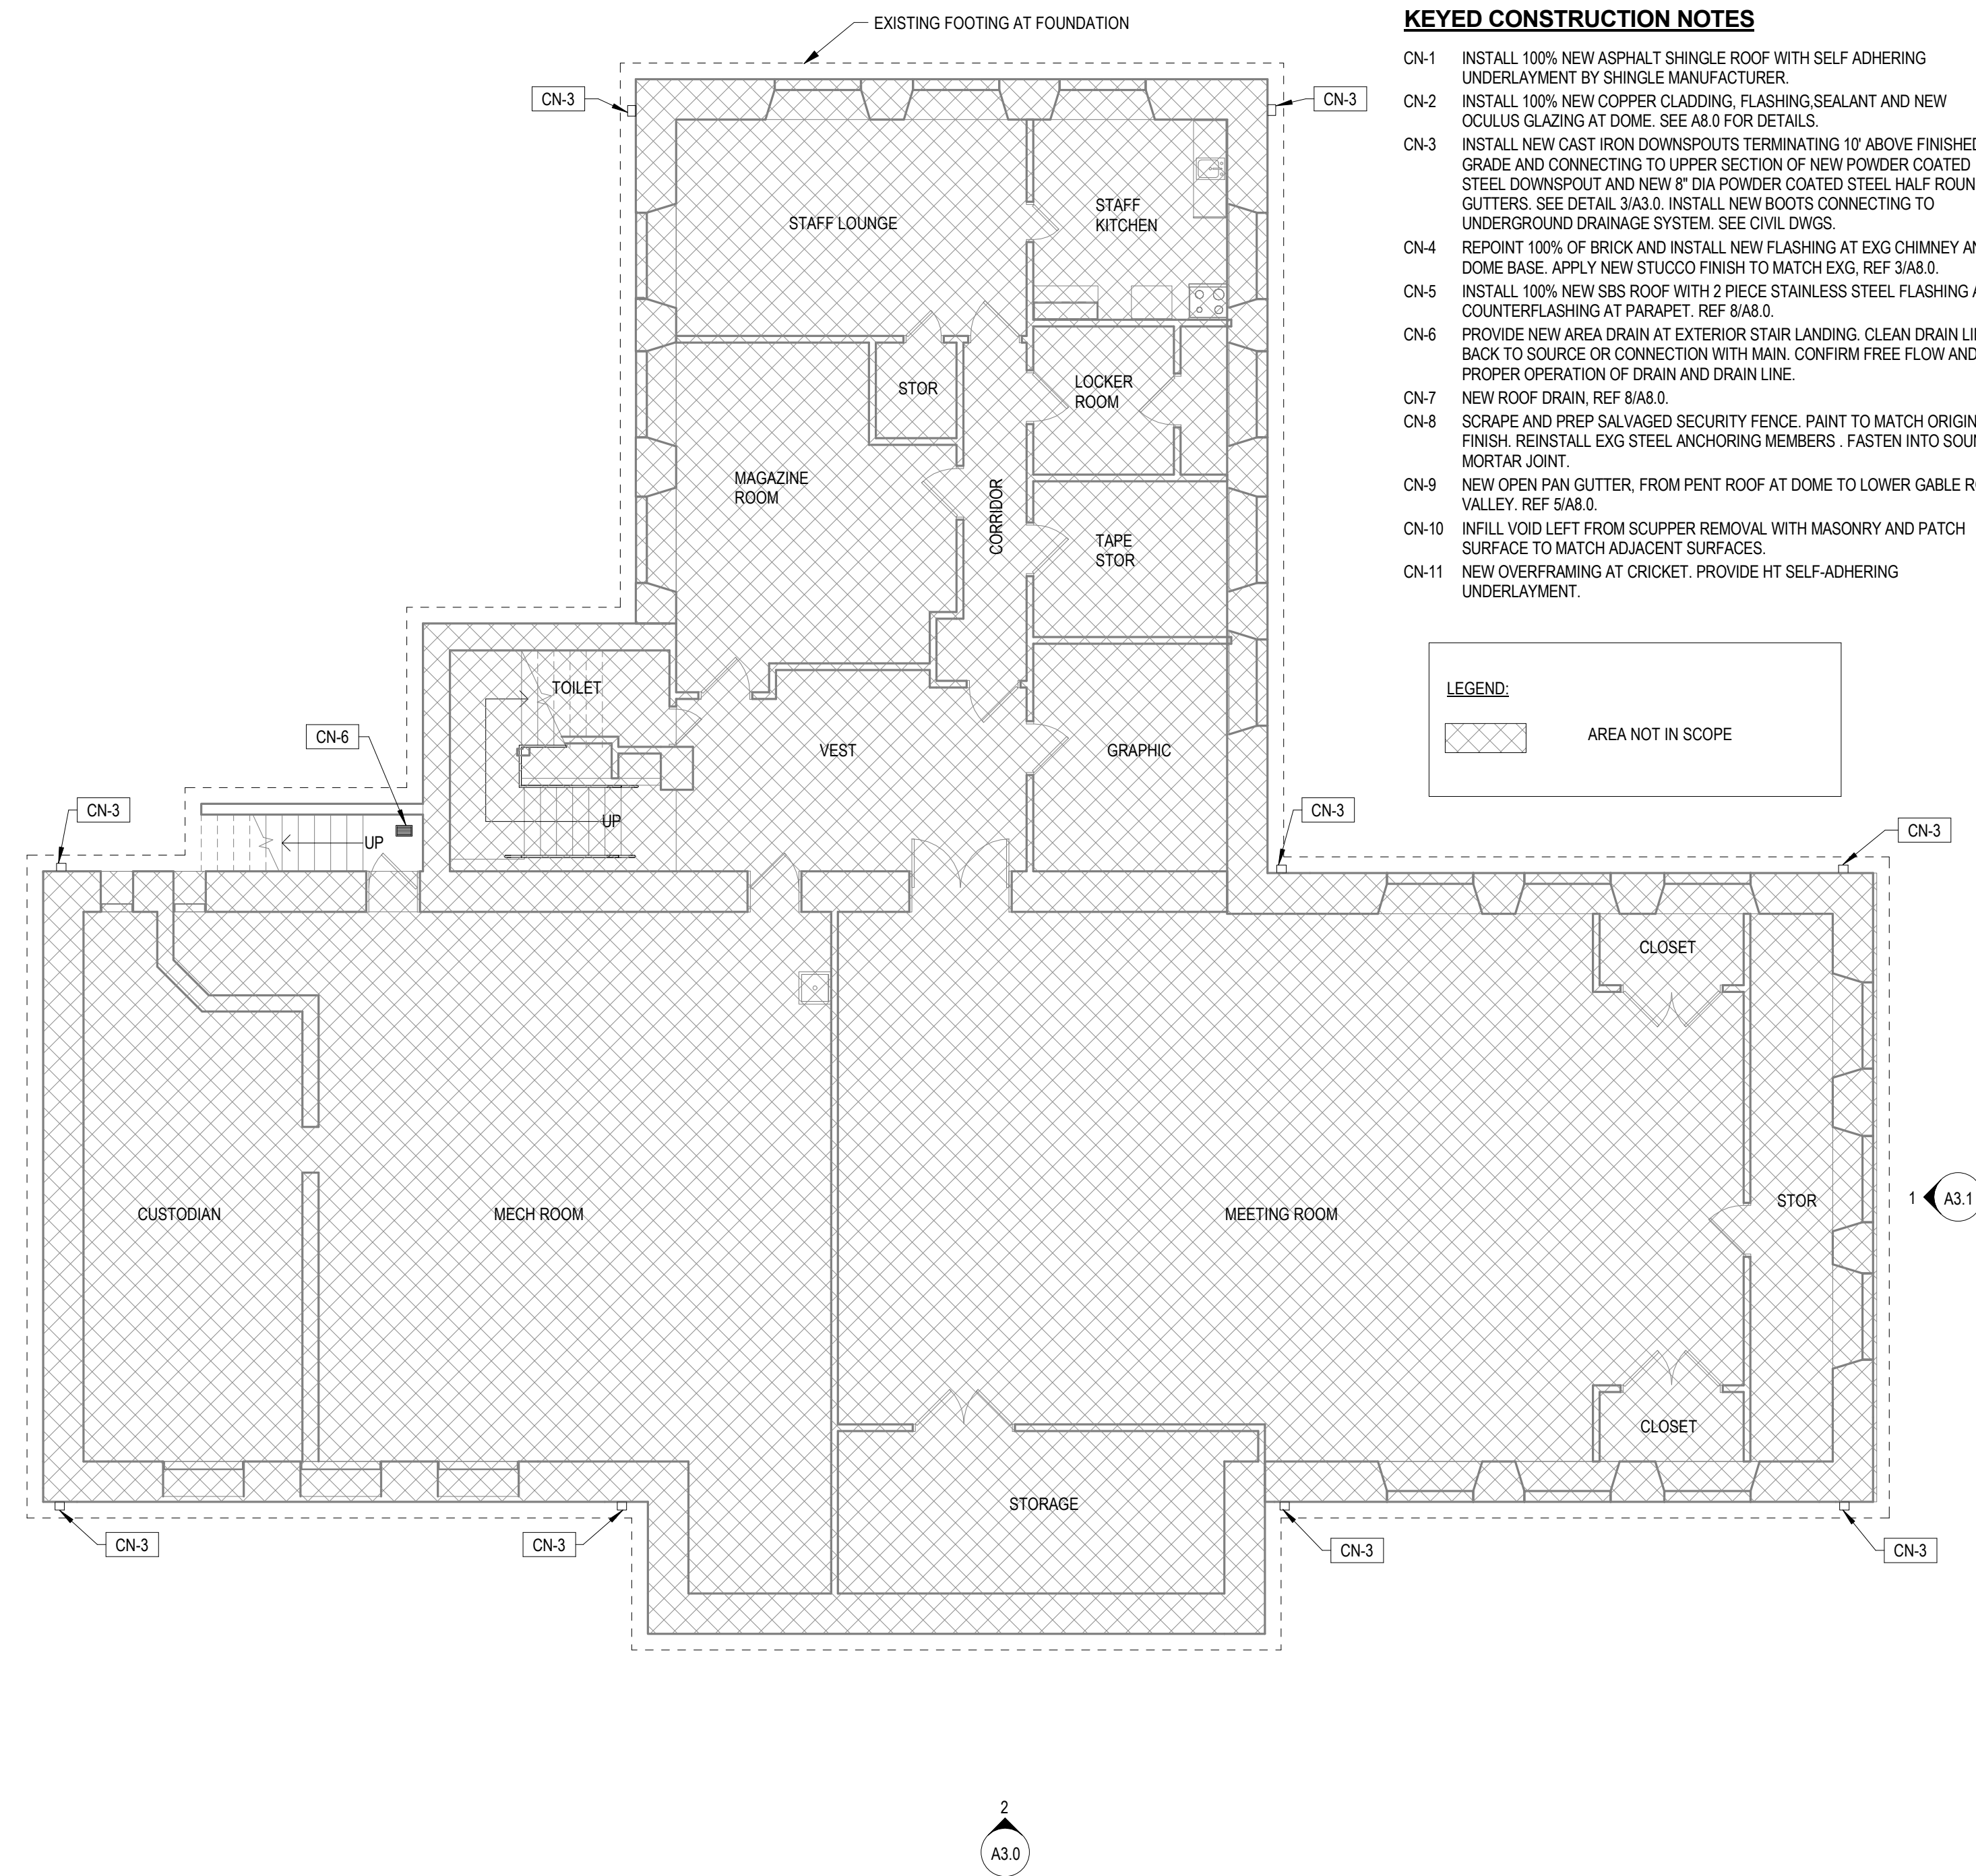

1 BASEMENT LEVEL PLAN
A2.0 1/8" = 1'-0"

GENERAL CONSTRUCTION NOTES:

1. ALL EXG CONDITIONS AND DIMENSIONS TO BE VERIFIED IN FIELD PRIOR TO CONSTRUCTION.
2. SEE SHEET A0.1 FOR LIST OF ALTERNATES.
3. PATCH TEMPORARY ACCESS OPENINGS BETWEEN RAFTERS IN ROOF WITH ASPHALT SHINGLE ROOF ASSEMBLY TO WATERTIGHT CONDITION ONCE INSTALLATION OF NEW ATTIC INSULATION IS COMPLETE.
4. COMPLETE STRUCTURAL REPAIRS AND REVIEW EXISTING CONDITIONS OF EXPOSED STRUCTURAL MEMBERS WITH EGR PRIOR TO NEW CONSTRUCTION.

KEYED CONSTRUCTION NOTES

- CN-1 INSTALL 100% NEW ASPHALT SHINGLE ROOF WITH SELF-ADHERING UNDERLAYMENT BY SHINGLE MANUFACTURER.
- CN-2 INSTALL 100% NEW COPPER CLADDING, FLASHING, SEALANT AND NEW OCLLUS GLAZING AT DOME. SEE A8.0 FOR DETAILS.
- CN-3 INSTALL NEW CAST IRON DOWNSPOUTS TERMINATING 10' ABOVE FINISHED GRADE AND CONNECTING TO UPPER SECTION OF NEW POWDER COATED STEEL DOWNSPOUT AND NEW 8" DIA POWDER COATED STEEL HALF ROUND GUTTERS. SEE DETAIL 3/A3.0. INSTALL NEW BOOTS CONNECTING TO UNDERGROUND DRAINAGE SYSTEM. SEE CIVIL DWGS.
- CN-4 REPOINT 100% OF BRICK AND INSTALL NEW FLASHING AT EXG CHIMNEY AND DOME BASE. APPLY NEW STUCCO FINISH TO MATCH EXG. REF 3/A8.0.
- CN-5 INSTALL 100% NEW SBS ROOF WITH 2 PIECE STAINLESS STEEL FLASHING AND COUNTERFLASHING AT PARAPET. REF 8/A8.0.
- CN-6 PROVIDE NEW AREA DRAIN AT EXTERIOR STAIR LANDING. CLEAN DRAIN LINE BACK TO SOURCE OR CONNECTION WITH MAIN. CONFIRM FREE FLOW AND PROPER OPERATION OF DRAIN AND DRAIN LINE.
- CN-7 NEW ROOF DRAIN, REF 8/A8.0.
- CN-8 SCRAPE AND PREP SALVAGED SECURITY FENCE. PAINT TO MATCH ORIGINAL FINISH. REINSTALL EXG STEEL ANCHORING MEMBERS. FASTEN INTO SOUND MORTAR JOINT.
- CN-9 NEW OPEN PAN GUTTER, FROM PENT ROOF AT DOME TO LOWER GABLE ROOF VALLEY. REF 5/A8.0.
- CN-10 INFILL VOID LEFT FROM SCUPPER REMOVAL WITH MASONRY AND PATCH SURFACE TO MATCH ADJACENT SURFACES.
- CN-11 NEW OVERFRAMING AT CRICKET. PROVIDE HT SELF-ADHERING UNDERLAYMENT.

LEGEND:

AREA NOT IN SCOPE



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610 688 2566

ROOFING CONSULTANT:
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210 Garden Avenue
Somersdale, NJ 08083
856 287 2424

Seal:

No.	Date	Revision

By: JH Checked: JPH Scale: AS NOTED
Date: 04/15/2024

Drawing Title:
FLOOR PLANS

Drawing No.:
A2.0

Seal:

No.	Date	Revision

By: JH Checked: JPH Scale: AS NOTED
Date: 04/15/2024

Drawing Title:
ROOF PLAN

Drawing No.:
A2.1

GENERAL CONSTRUCTION NOTES:

1. ALL EXG CONDITIONS AND DIMENSIONS TO BE VERIFIED IN FIELD PRIOR TO CONSTRUCTION
2. SEE SHEET A0.1 FOR LIST OF ALTERNATES.
3. PATCH TEMPORARY ACCESS OPENINGS BETWEEN RAFTERS IN ROOF WITH ASPHALT SHINGLE ROOF ASSEMBLY TO WATERTIGHT CONDITION ONCE INSTALLATION OF NEW ATTIC INSULATION IS COMPLETE.
4. COMPLETE STRUCTURAL REPAIRS AND REVIEW EXISTING CONDITIONS OF EXPOSED STRUCTURAL MEMBERS WITH E&R PRIOR TO NEW CONSTRUCTION.

GENERAL ROOF NOTES:


1. REFER TO STRUCTURAL DRAWINGS FOR INFORMATION ABOUT WOOD FRAMING REPLACEMENTS.
2. ALL METAL FLASHINGS TO BE ZT COPPER.
3. INSTALL R-30 MINERAL WOOL UNFACED BATT INSULATION BETWEEN RAFTERS. UTILIZE OPENING CUT IN EACH QUADRANT OF CROSS-GABLE ROOF FOR ACCESS TO ATTIC SPACE. SEE GENERAL CONSTRUCTION NOTE 3.

KEYED CONSTRUCTION NOTES

- CN-1 INSTALL 100% NEW ASPHALT SHINGLE ROOF WITH SELF ADHERING UNDERLAYMENT BY SHINGLE MANUFACTURER.
- CN-2 INSTALL 100% NEW COPPER CLADDING, FLASHING SEALANT AND NEW OCULUS GLAZING AT DOME. SEE A8.0 FOR DETAILS.
- CN-3 INSTALL NEW CAST IRON DOWNSPOUTS TERMINATING 10' ABOVE FINISHED GRADE AND CONNECTING TO UPPER SECTION OF NEW POWDER COATED STEEL DOWNSPOUT AND NEW 8" DIA POWDER COATED STEEL HALF ROUND GUTTERS. SEE DETAIL 3/A3.0. INSTALL NEW BOOTS CONNECTING TO UNDERGROUND DRAINAGE SYSTEM. SEE CIVIL DWGS.
- CN-4 REPOINT 100% OF BRICK AND INSTALL NEW FLASHING AT EXG CHIMNEY AND DOME BASE. APPLY NEW STUCCO FINISH TO MATCH EXG. REF 3/A8.0.
- CN-5 INSTALL 100% NEW SBS ROOF WITH 2 PIECE STAINLESS STEEL FLASHING AND COUNTERFLASHING AT PARAPET. REF 8/A8.0.
- CN-6 PROVIDE NEW AREA DRAIN AT EXTERIOR STAIR LANDING. CLEAN DRAIN LINE BACK TO SOURCE OR CONNECTION WITH MAIN. CONFIRM FREE FLOW AND PROPER OPERATION OF DRAIN AND DRAIN LINE.
- CN-7 NEW ROOF DRAIN, REF 8/A8.0.
- CN-8 SCRAPE AND PREP SALVAGED SECURITY FENCE. PAINT TO MATCH ORIGINAL FINISH. REINSTALL EXG STEEL ANCHORING MEMBERS. FASTEN INTO SOUND MORTAR JOINT.
- CN-9 NEW OPEN PAN GUTTER, FROM PENT ROOF AT DOME TO LOWER GABLE ROOF VALLEY. REF 5/A8.0.
- CN-10 INFILL VOID LEFT FROM SCUPPER REMOVAL WITH MASONRY AND PATCH SURFACE TO MATCH ADJACENT SURFACES.
- CN-11 NEW OVERFRAMING AT CRICKET. PROVIDE HT SELF-ADHERING UNDERLAYMENT.

LEGEND:


	AREA NOT IN SCOPE
	BRICK
	ICE & WATER SHIELD (INSTALL PER MFR INSTRUCTIONS)
	UNDERLAYMENT HT (BY SHINGLE MFR)

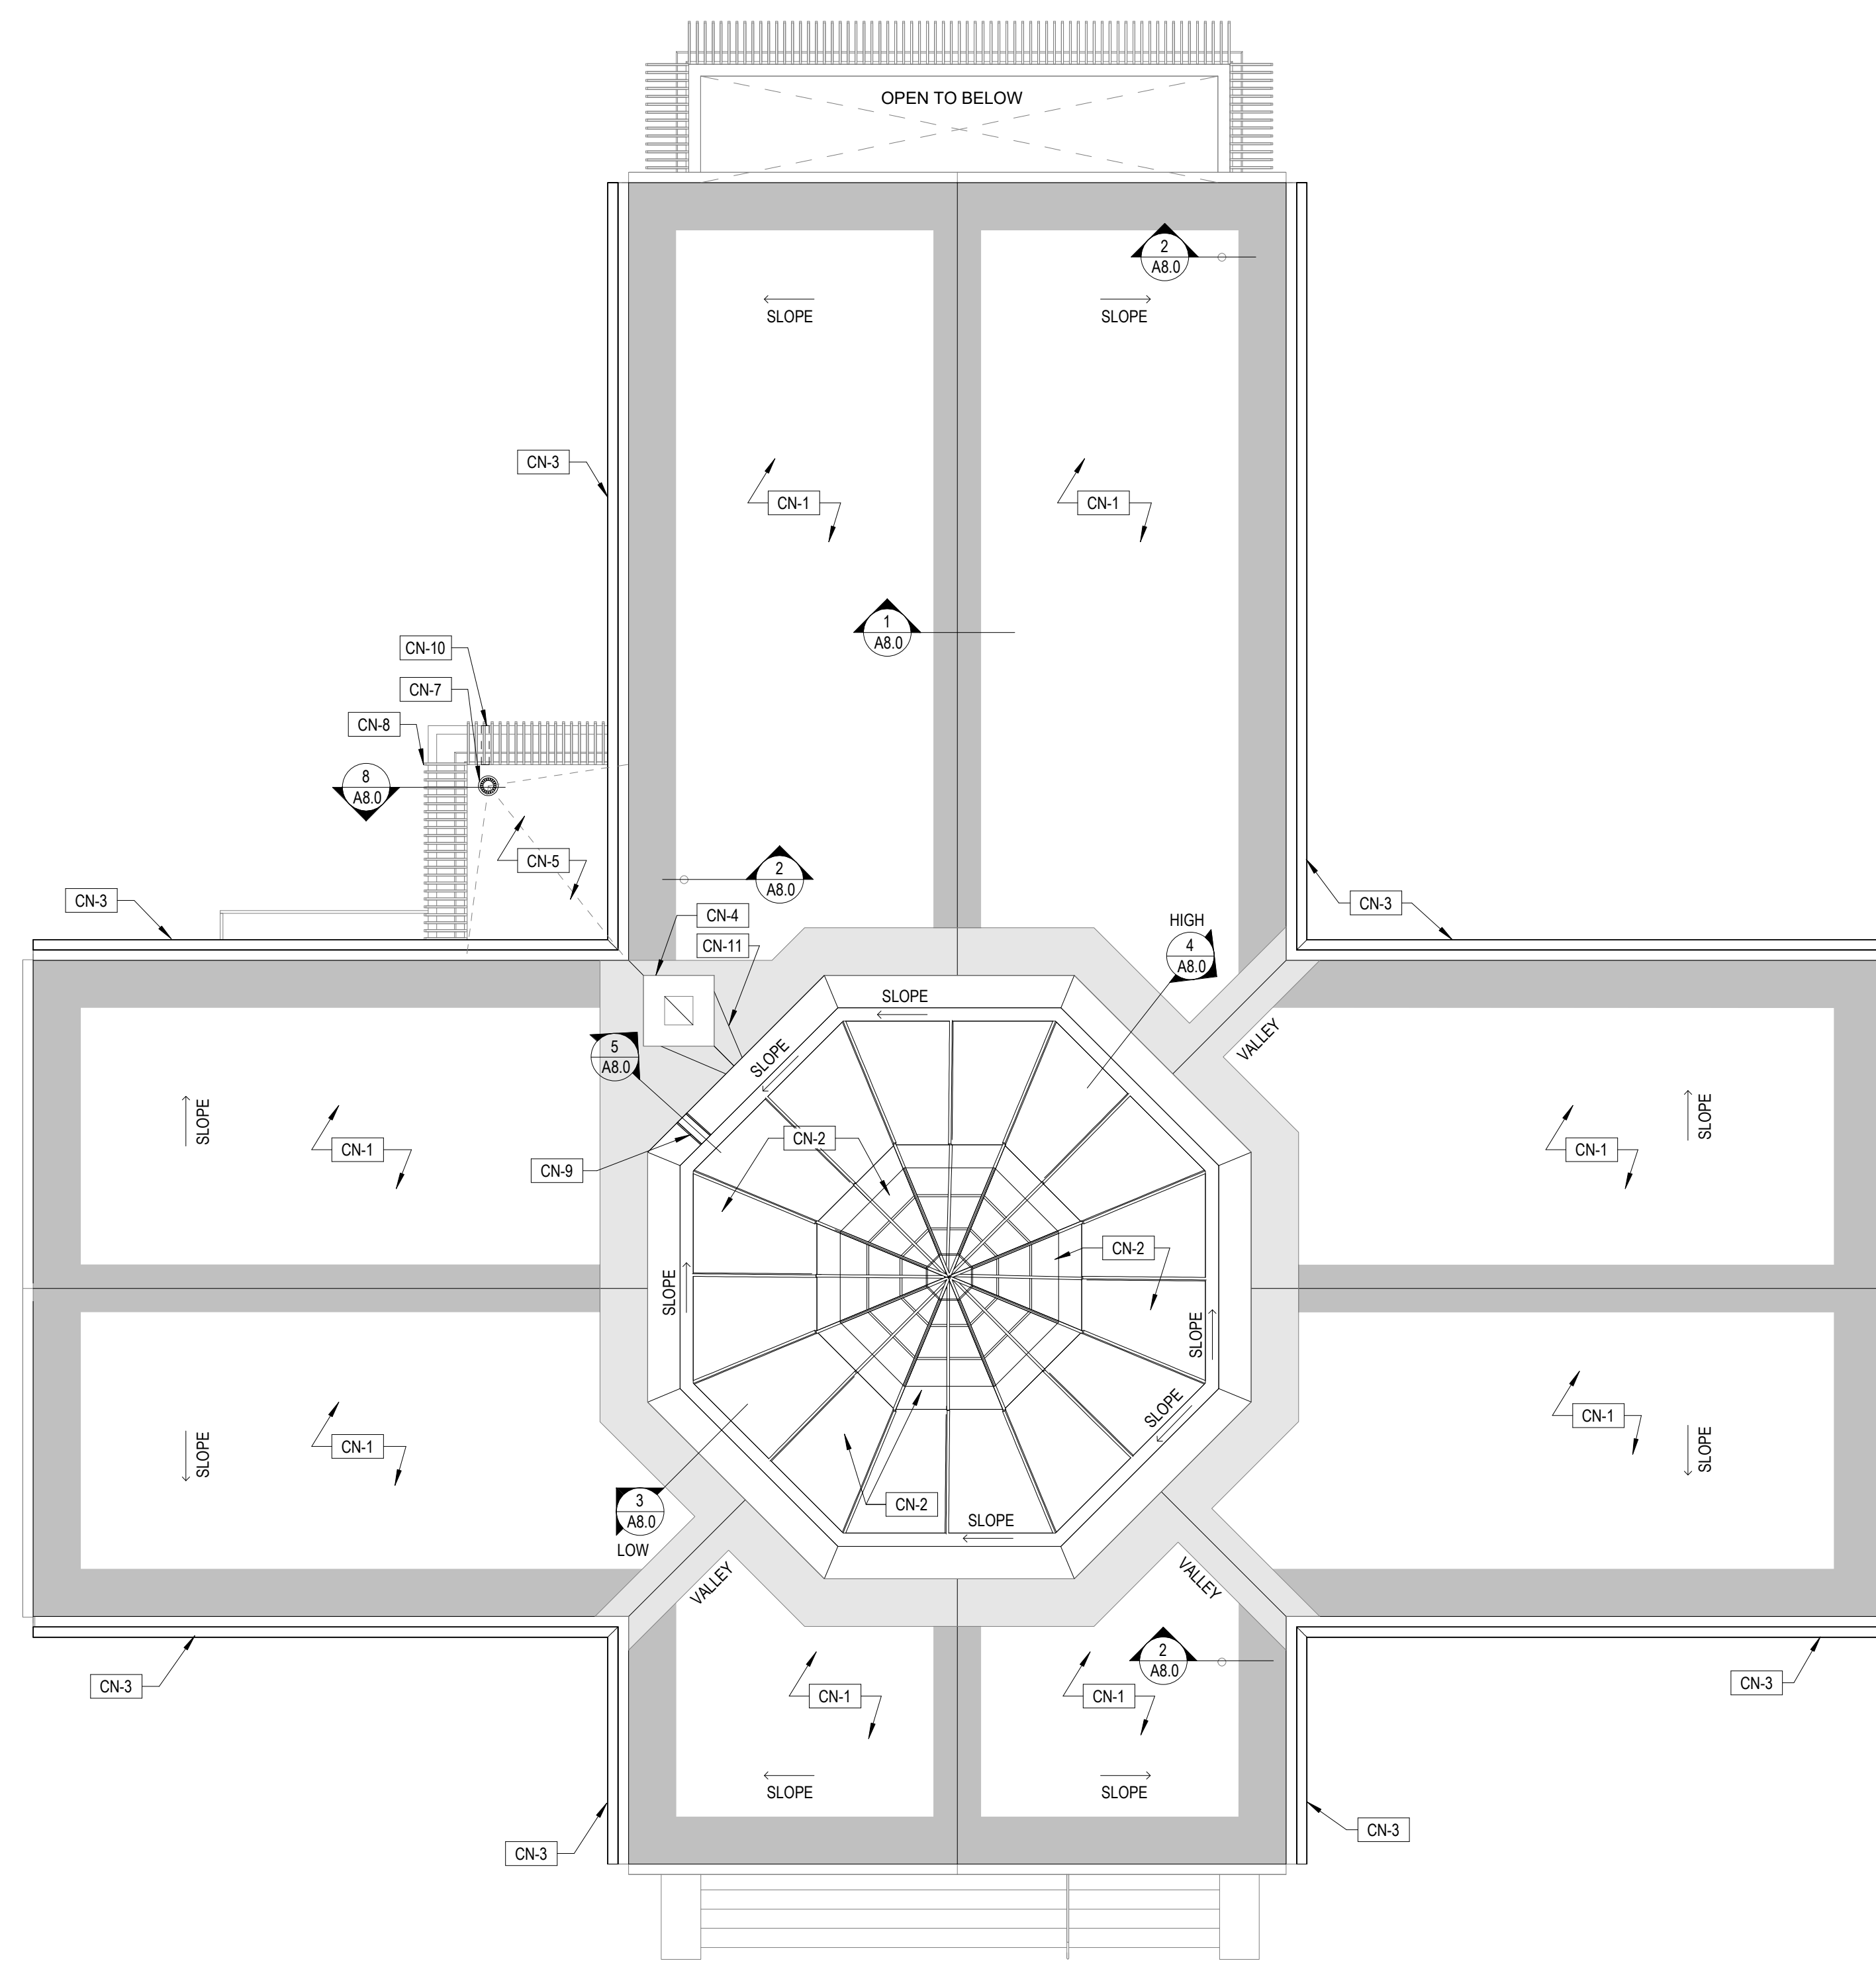


1
A2.1
ROOF PLAN
1/8" = 1'-0"

ROOF TYPES				
TYPE	DESCRIPTION	CODE-REQ'D INSUL MIN R-VALUE	DETAIL	SPECIFICATION
R1	SLOPED ASPHALT SHINGLE ROOF ASSEMBLY	MIN R-30 ci R-30 ci		EXG 2x10 PLANK DECK, R-30 MINERAL WOOL UNFACED BATT INSULATION BETWEEN RAFTERS, EXG 1/2" PLYWOOD SHEATHING, SELF ADHERING UNDERLAYMENT, NEW ICE & WATER SHIELD (ONLY AT EAVES, RIDGES & VALLEYS), ASPHALT FIBERGLASS SHINGLE ROOF SYSTEM
R2	LOW-SLOPE SBS MEMBRANE ROOF ON WOOD DECKING	MIN R-30 ci R-30 ci		NEW T&G WOOD DECK, HT SELF ADHERING VAPOR RETARDER, (2) LAYERS 2.5/8" THICK POLYISO INSULATION, 1/2" GYPSUM COVERBOARD, MULTI-PLY SBS MODIFIED BITUMEN ROOFING SYSTEM

- GENERAL ROOF NOTES:**
1. SEE STRUC DWGS FOR ROOF DECK & STRUCTURE.
 2. SEE ROOF PLAN DWG AND A-8 SERIES DWGS FOR ADDITIONAL DETAILS.

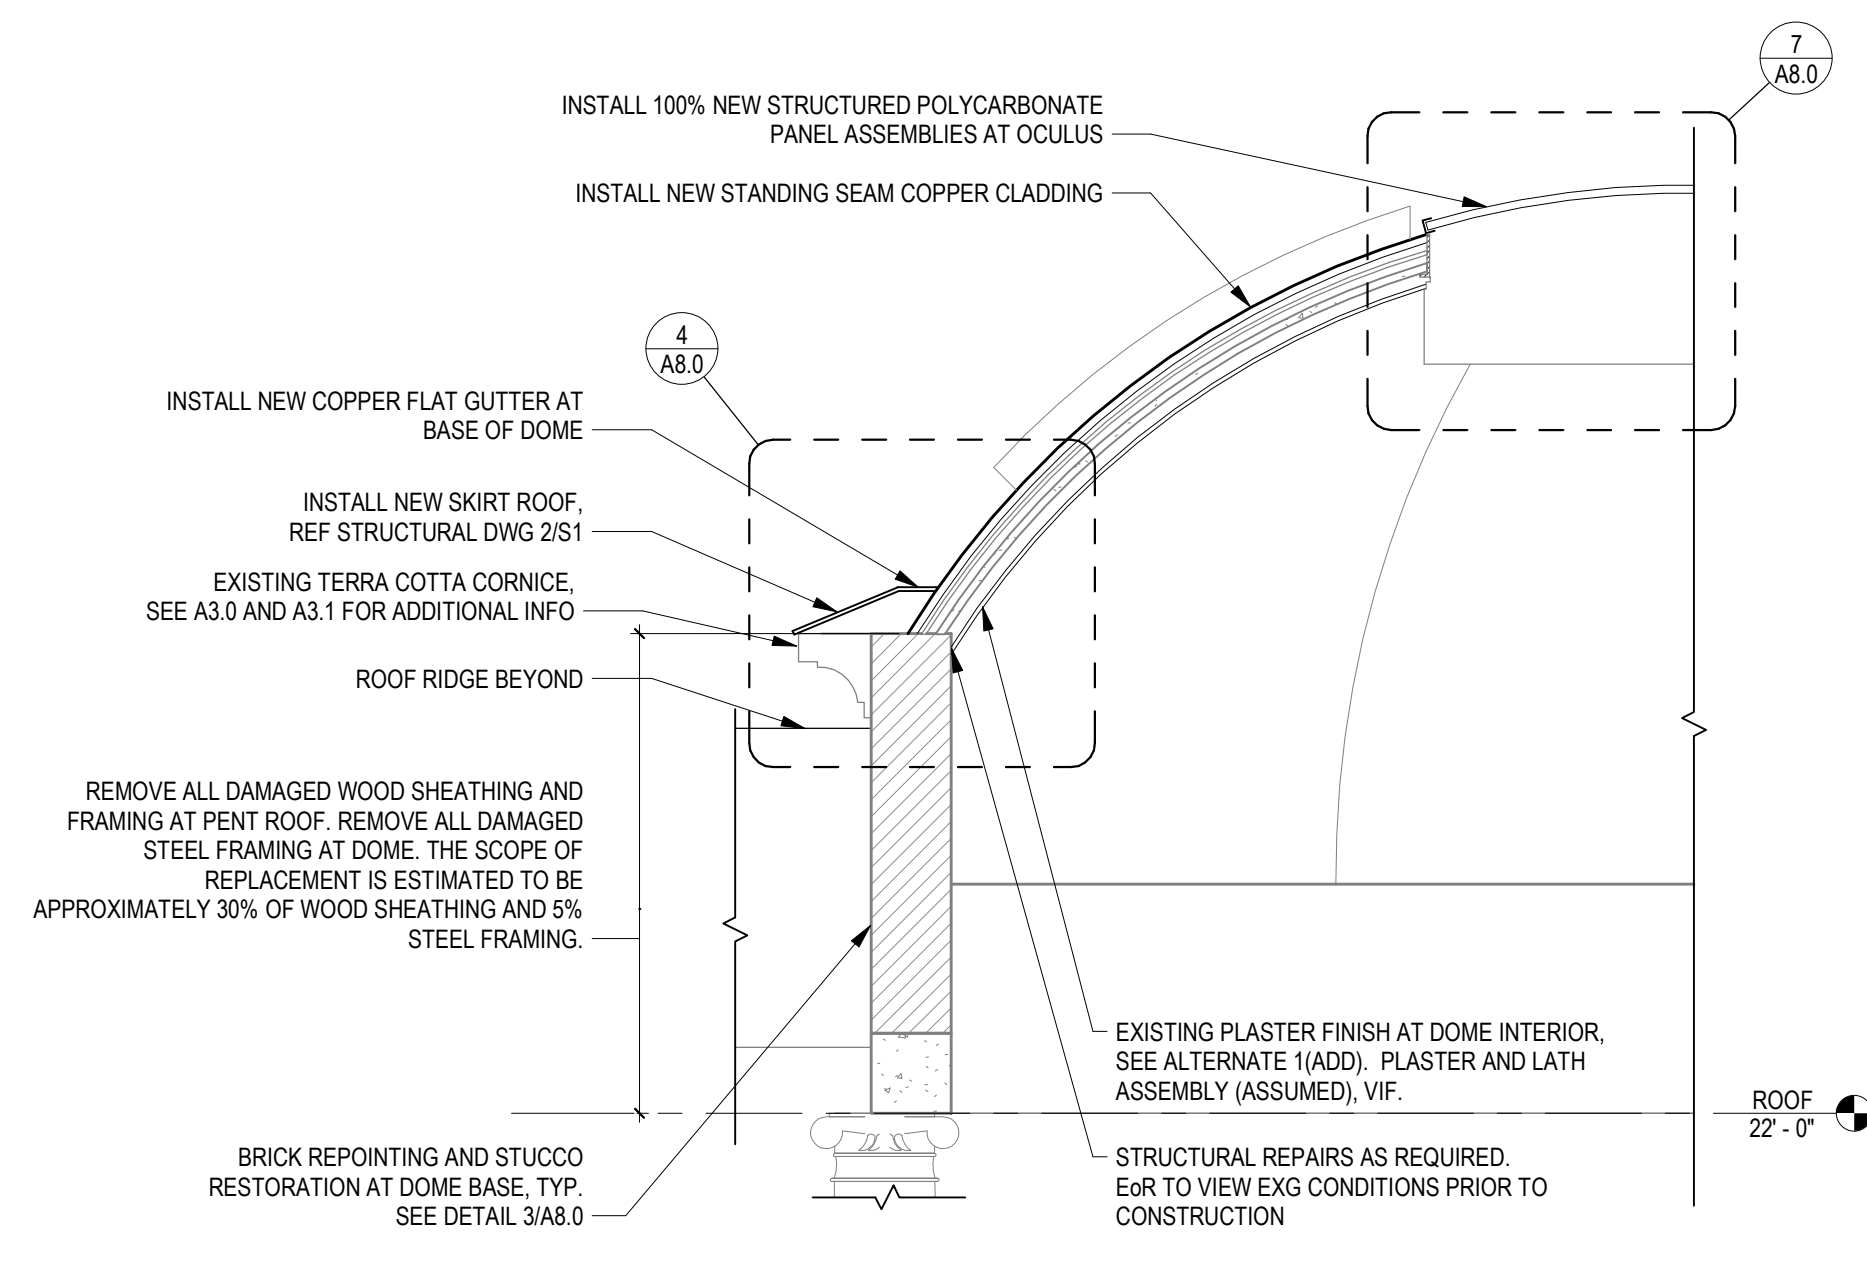

3
A2.1
SECTION DIAGRAM THROUGH DOME
1/4" = 1'-0"

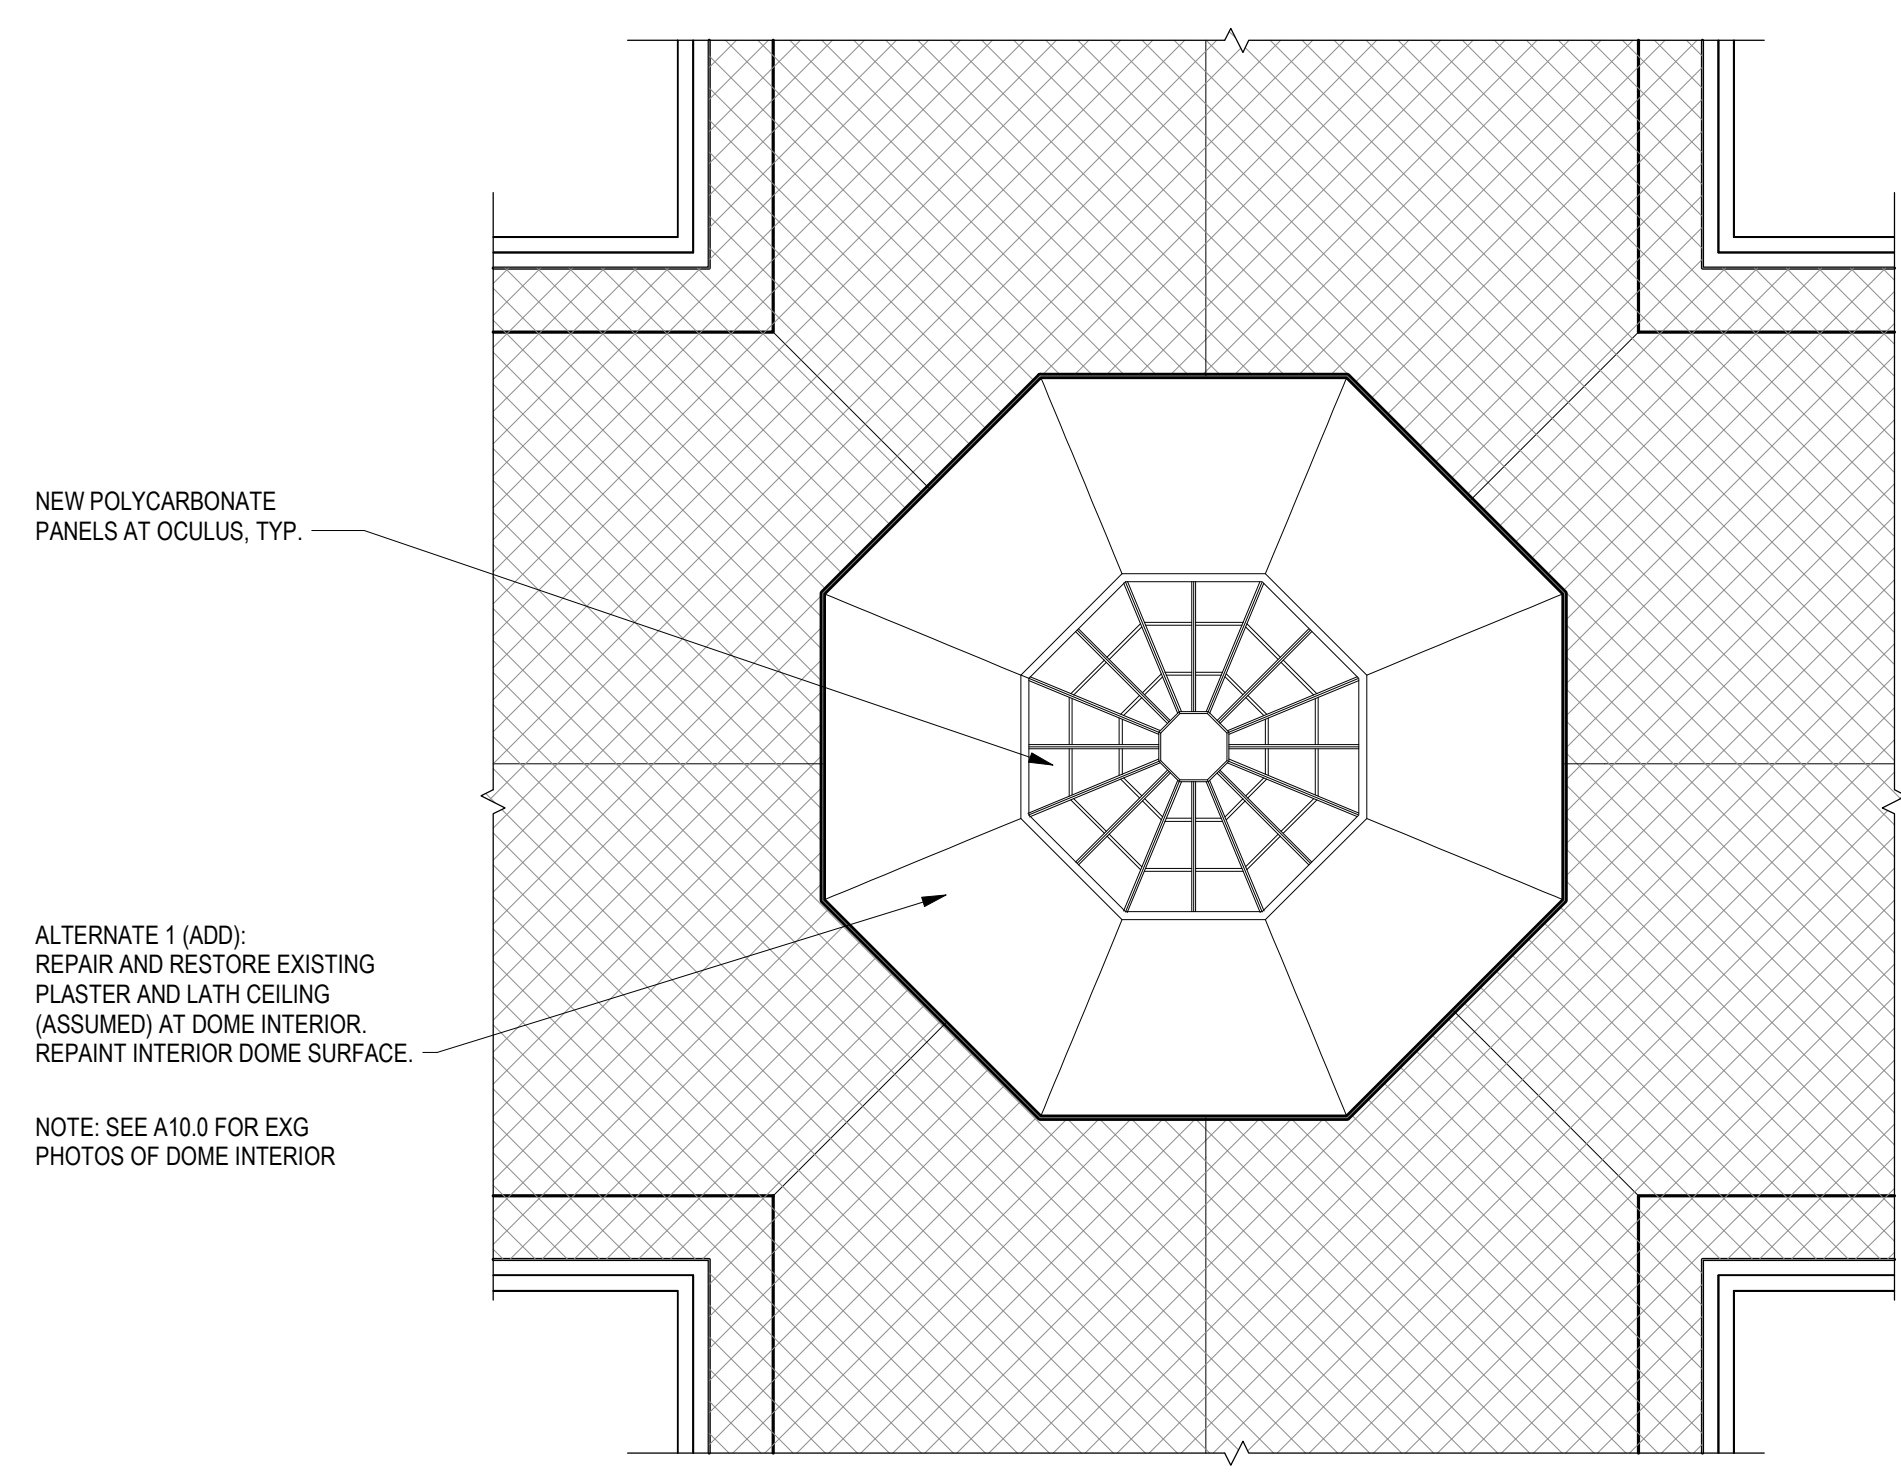


2
A2.1
ALTERNATE 1(ADD) - REFLECTED CEILING PLAN AT DOME INTERIOR
1/8" = 1'-0"

GENERAL NOTES:

1. ALL EXG CONDITIONS AND DIMENSIONS TO BE VERIFIED IN FIELD PRIOR TO CONSTRUCTION.
2. SEE SHEET A0.1 FOR LIST OF ALTERNATES.
3. SEE CIVIL DRAWINGS FOR CONNECTIONS TO NEW DOWNSPOUT BOOT.
4. REPOINT 100% OF JOINTS BETWEEN TERRA COTTA UNITS.
5. COMPLETE STRUCTURAL REPAIRS AND REVIEW EXISTING CONDITIONS OF EXPOSED STRUCTURAL MEMBERS WITH ENGINEER OF RECORD PRIOR TO NEW CONSTRUCTION.


LEGEND:

- [Hatched Pattern] PATCH AND REPAIR CRACKED AND SPALLING TERRA COTTA AT JOINTS AND SURFACES, TYP. SEE REPAIR DETAILS 1, 2 & 3 ON A8.1.
- [Dashed Line] EXG TERRA COTTA UNITS TO BE REPLACED WITH NEW
- [Brick Pattern] BRICK
- [CMU Pattern] CMU

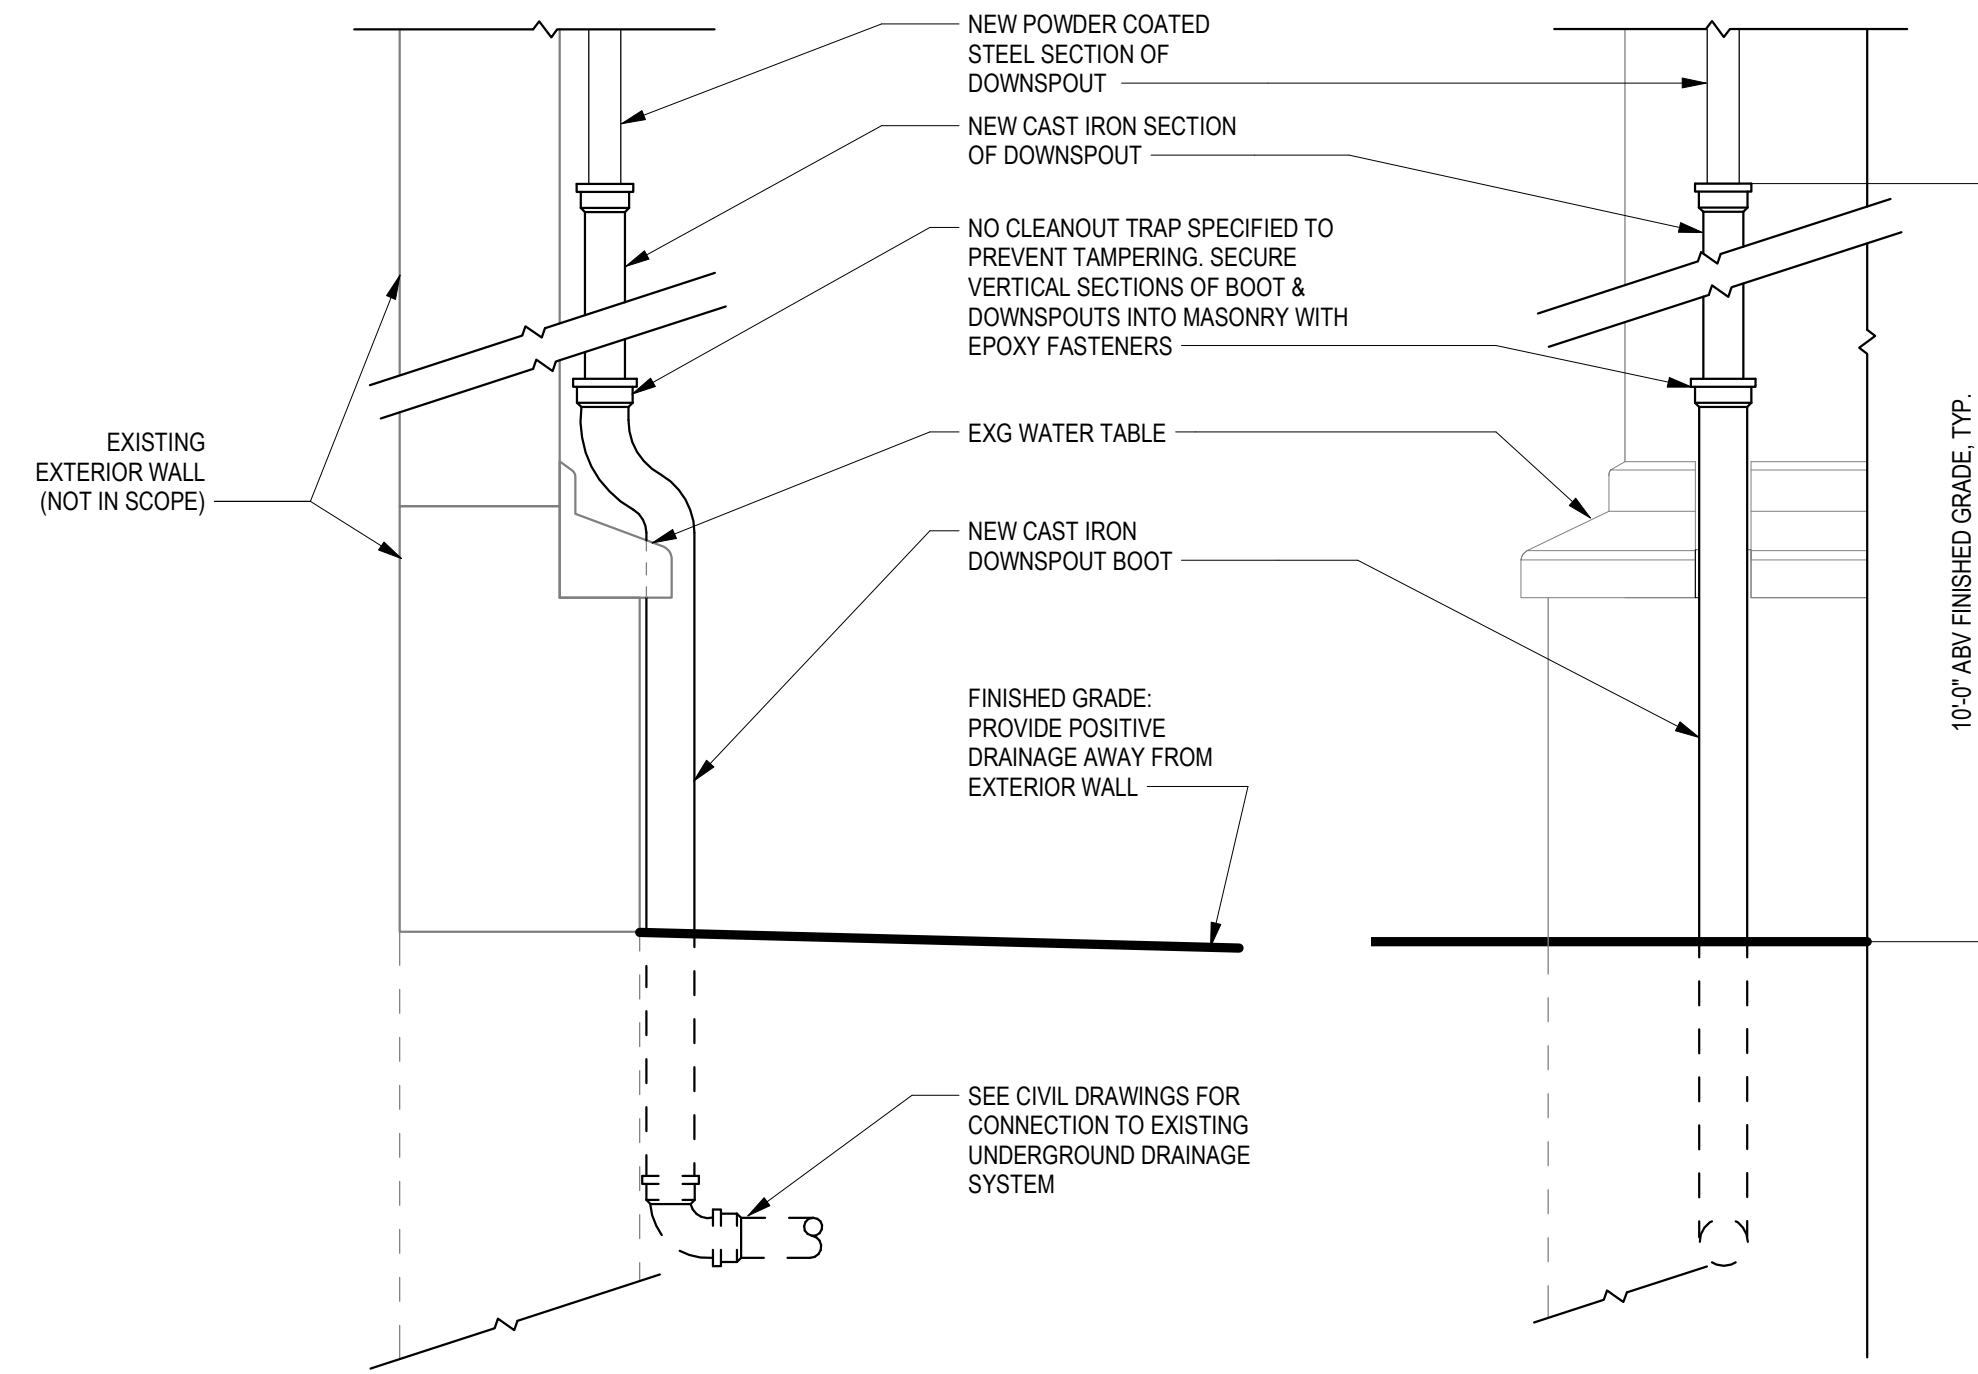


4 ENLARGED ELEVATION AT DOWNSPOUT: SIDE VIEW
A3.0 1/2" = 1'-0"

3 ENLARGED ELEVATION AT DOWNSPOUT: FRONT VIEW
A3.0 1/2" = 1'-0"

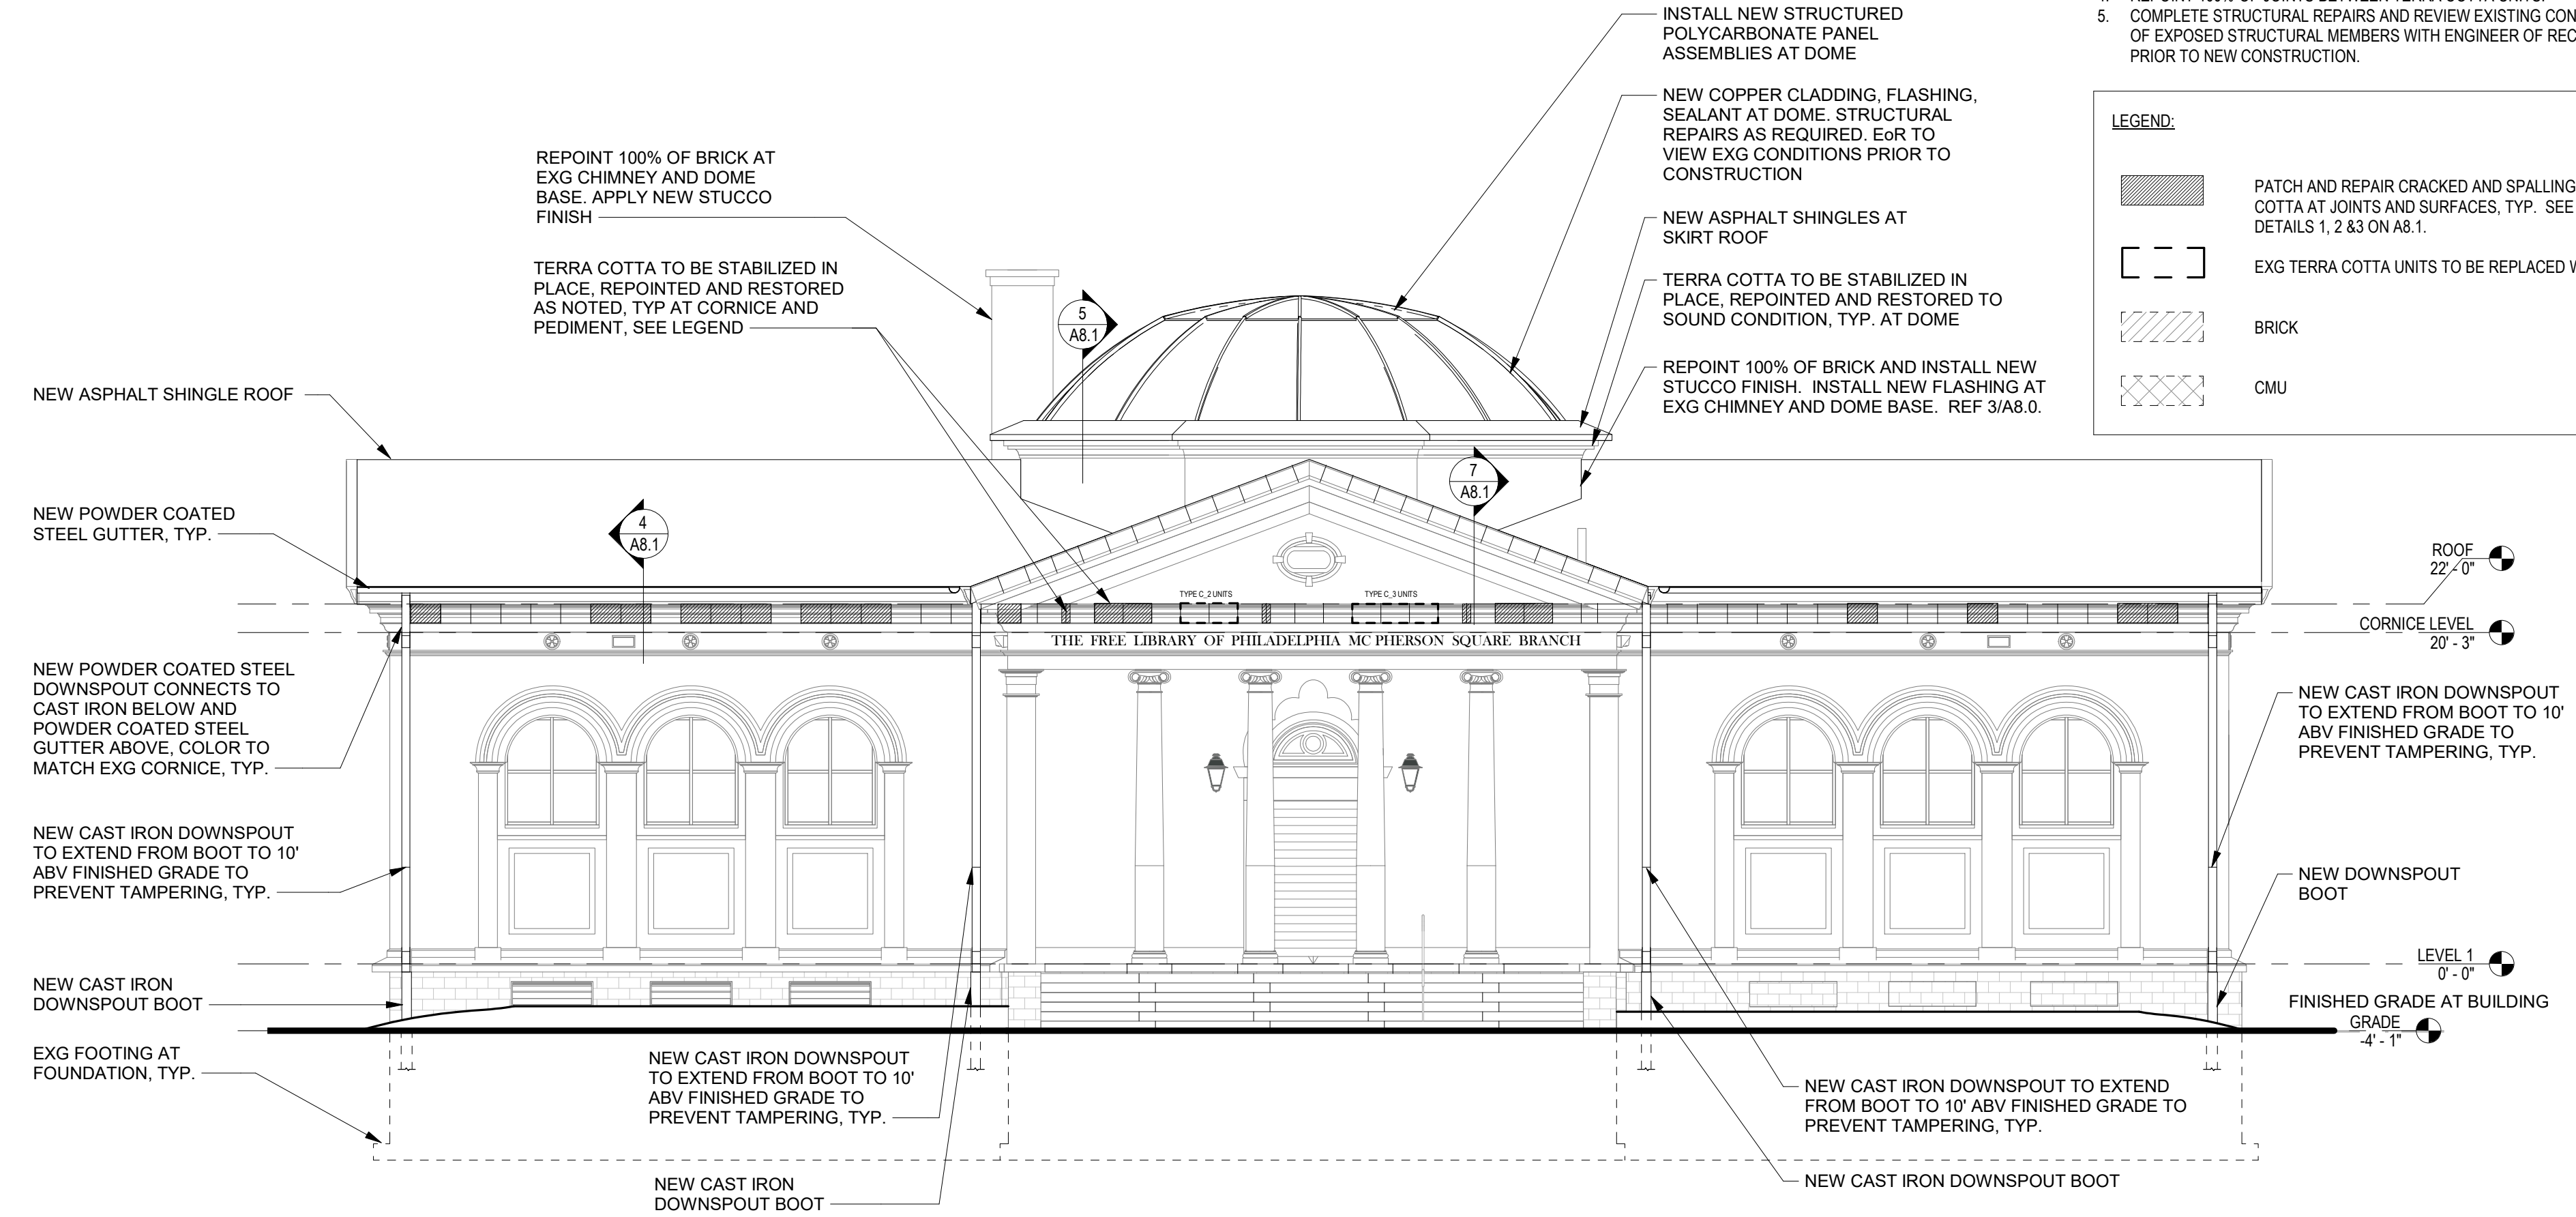

2 SOUTH (FRONT) ELEVATION
A3.0 1/8" = 1'-0"




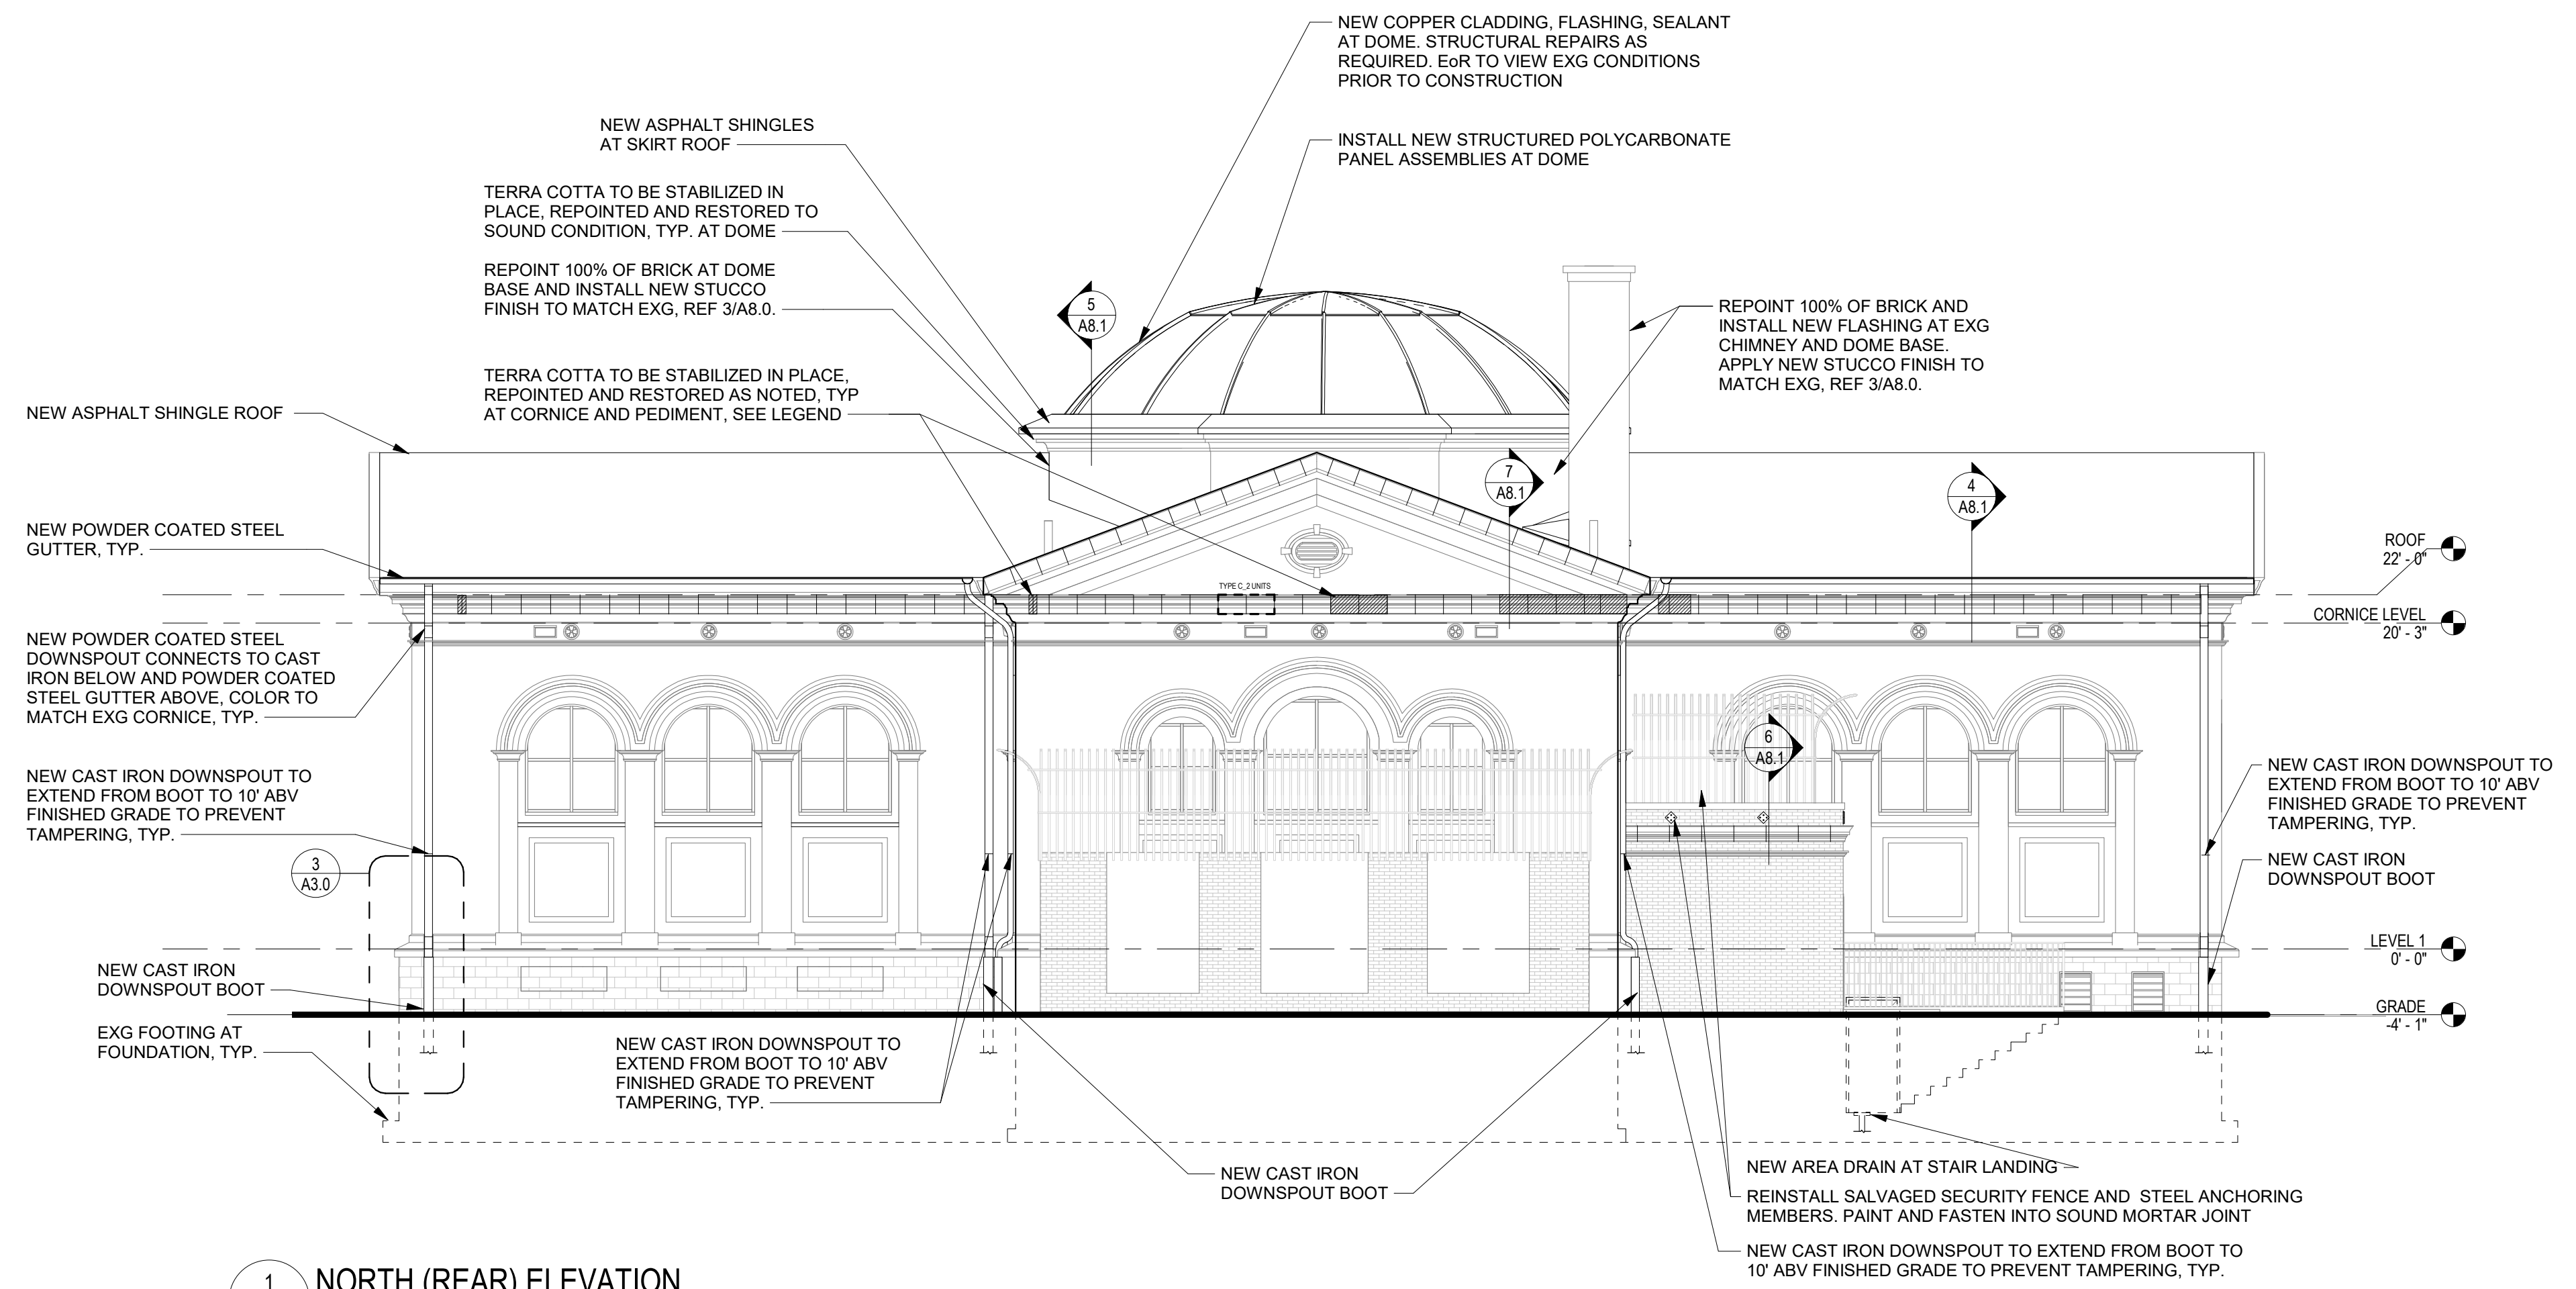



1 NORTH (REAR) ELEVATION
A3.0 1/8" = 1'-0"

GENERAL NOTES:


1. ALL EXG CONDITIONS AND DIMENSIONS TO BE VERIFIED IN FIELD PRIOR TO CONSTRUCTION.
2. SEE SHEET A0.1 FOR LIST OF ALTERNATES.
3. SEE CIVIL DRAWINGS FOR CONNECTIONS TO NEW DOWNSPOUT BOOT.
4. REPOINT 100% OF JOINTS BETWEEN TERRA COTTA UNITS.
5. COMPLETE STRUCTURAL REPAIRS AND REVIEW EXISTING CONDITIONS OF EXPOSED STRUCTURAL MEMBERS WITH ENGINEER OF RECORD PRIOR TO NEW CONSTRUCTION.

LEGEND:

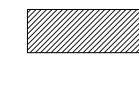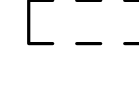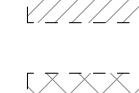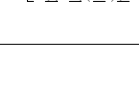
-  PATCH AND REPAIR CRACKED AND SPALLING TERRA COTTA AT JOINTS AND SURFACES. TYP. SEE REPAIR DETAILS 1, 2 & 3 ON A8.1.
-  EXG TERRA COTTA UNITS TO BE REPLACED WITH NEW
-  BRICK
-  CMU

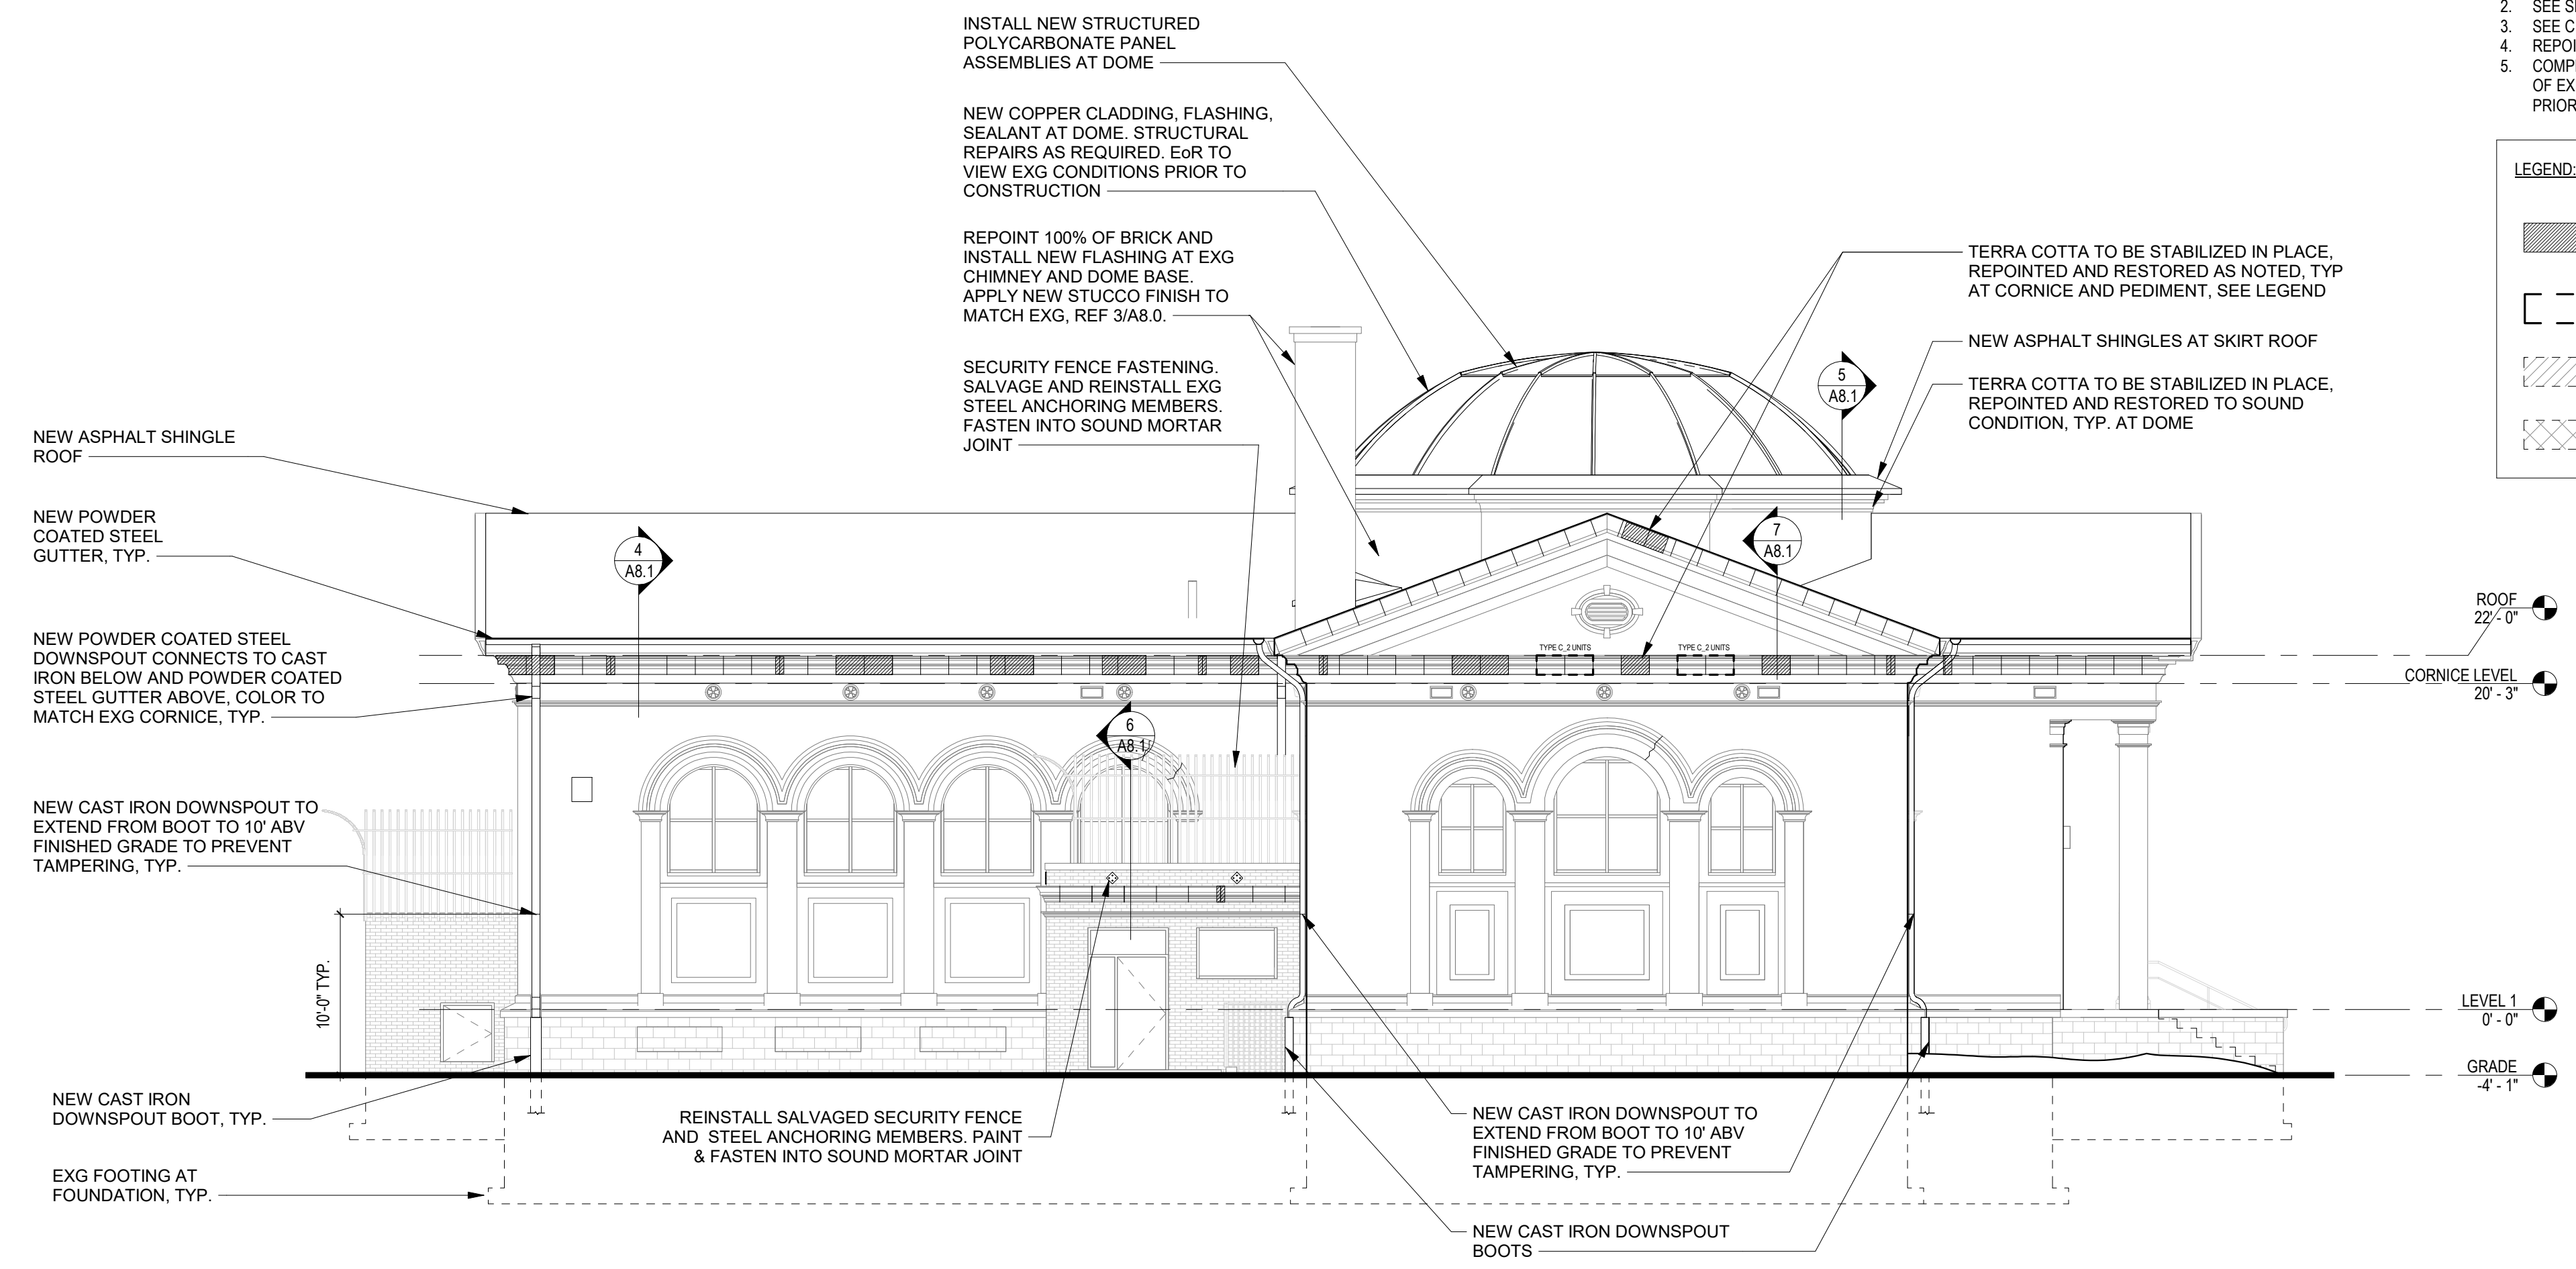


2 WEST ELEVATION
A3.1 1/8" = 1'-0"

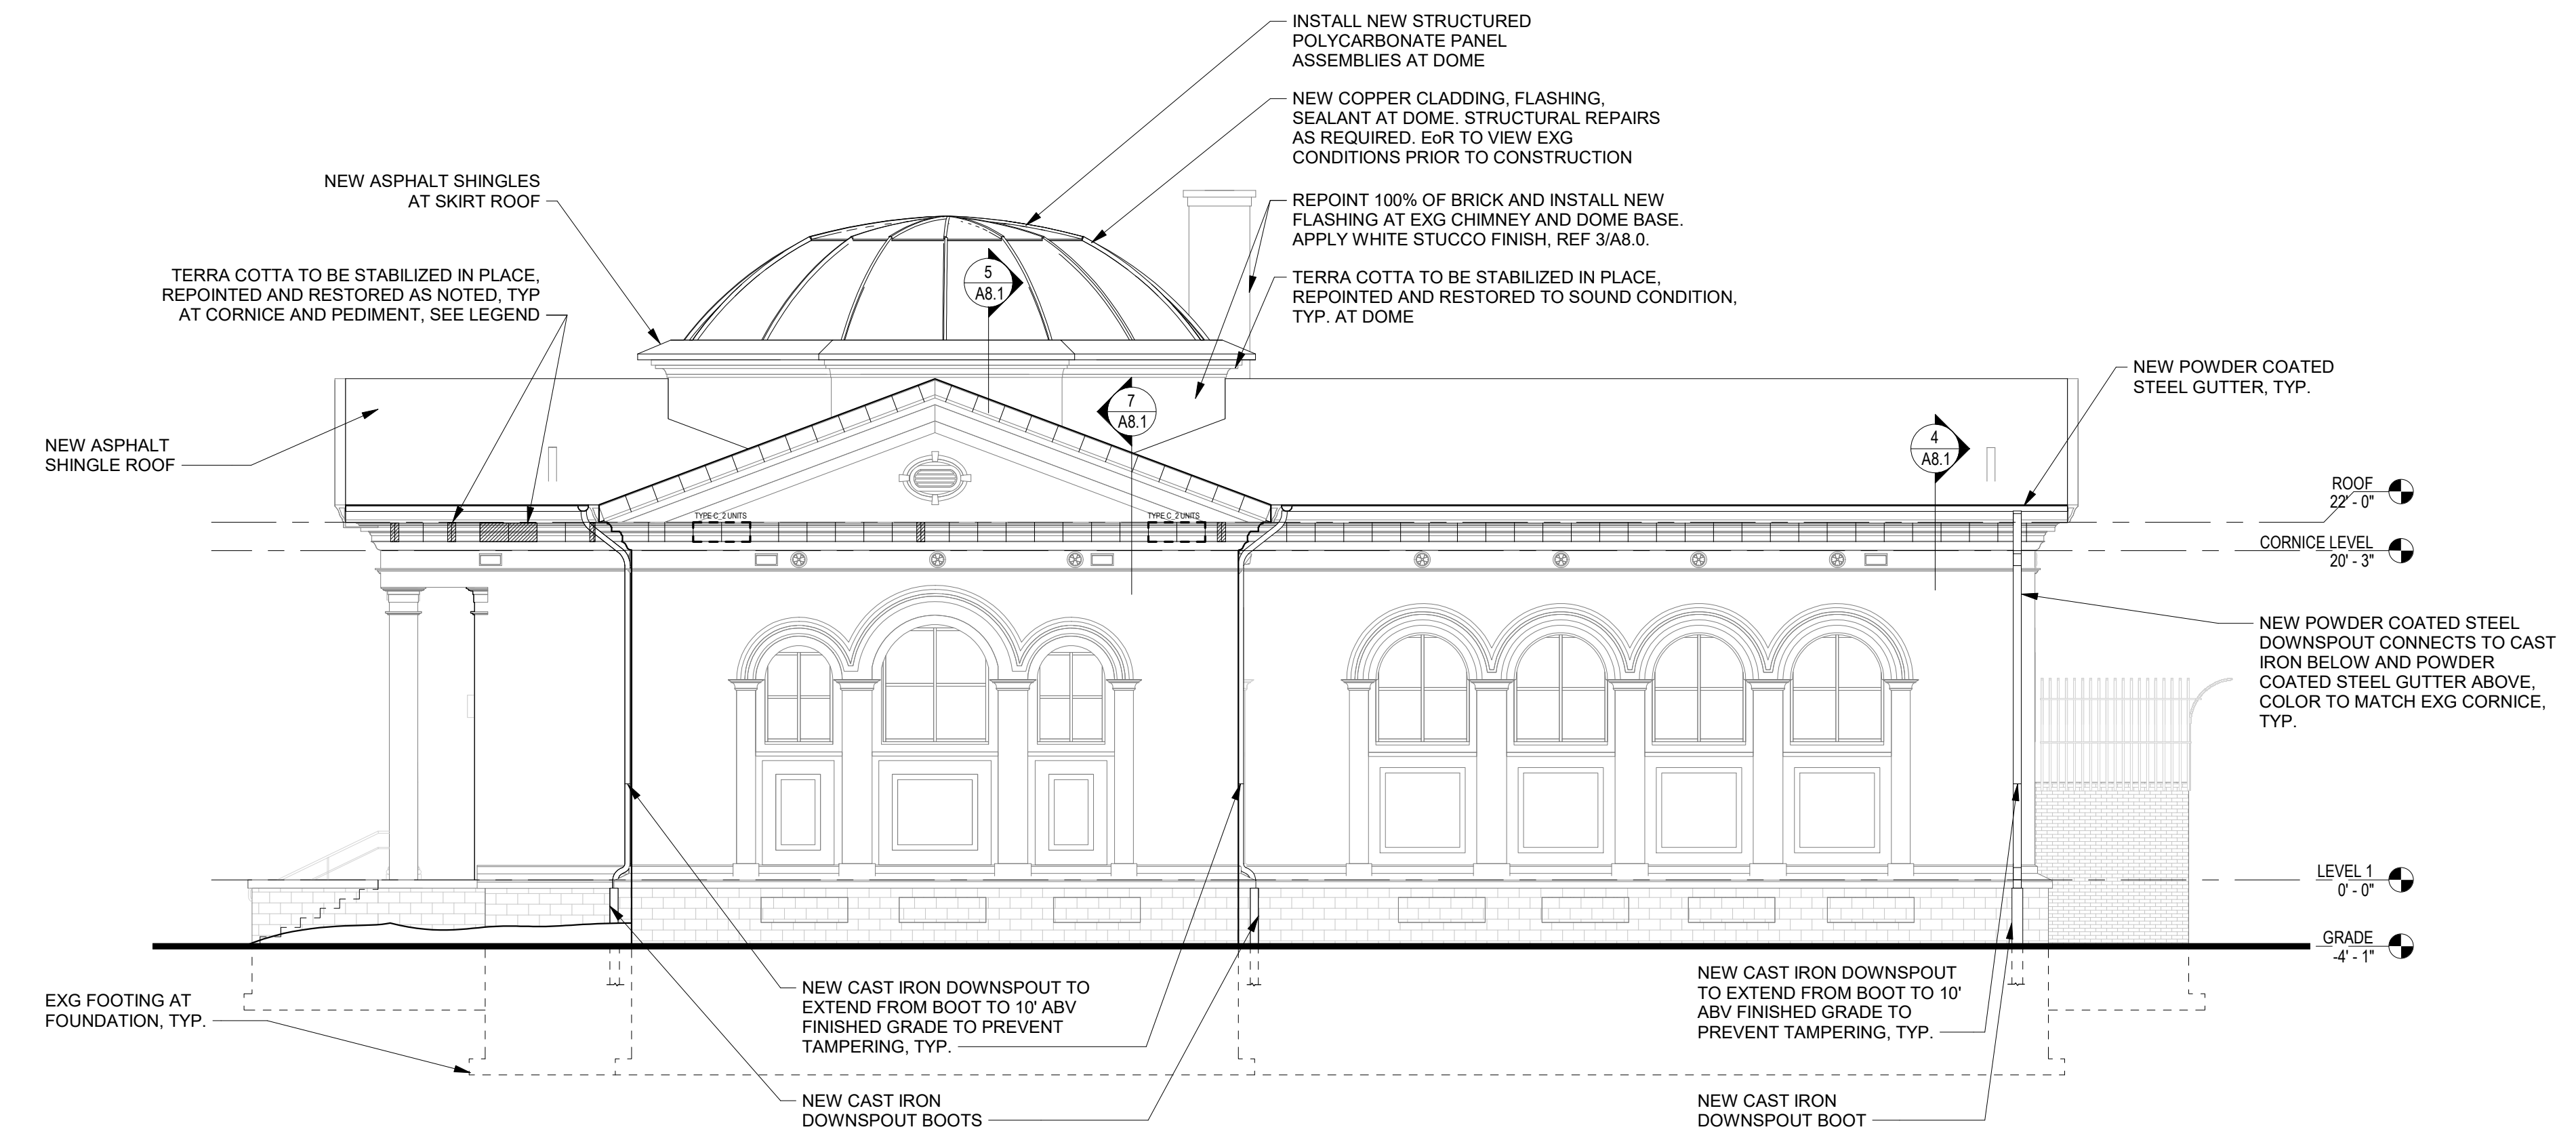


1 EAST ELEVATION
A3.1 1/8" = 1'-0"

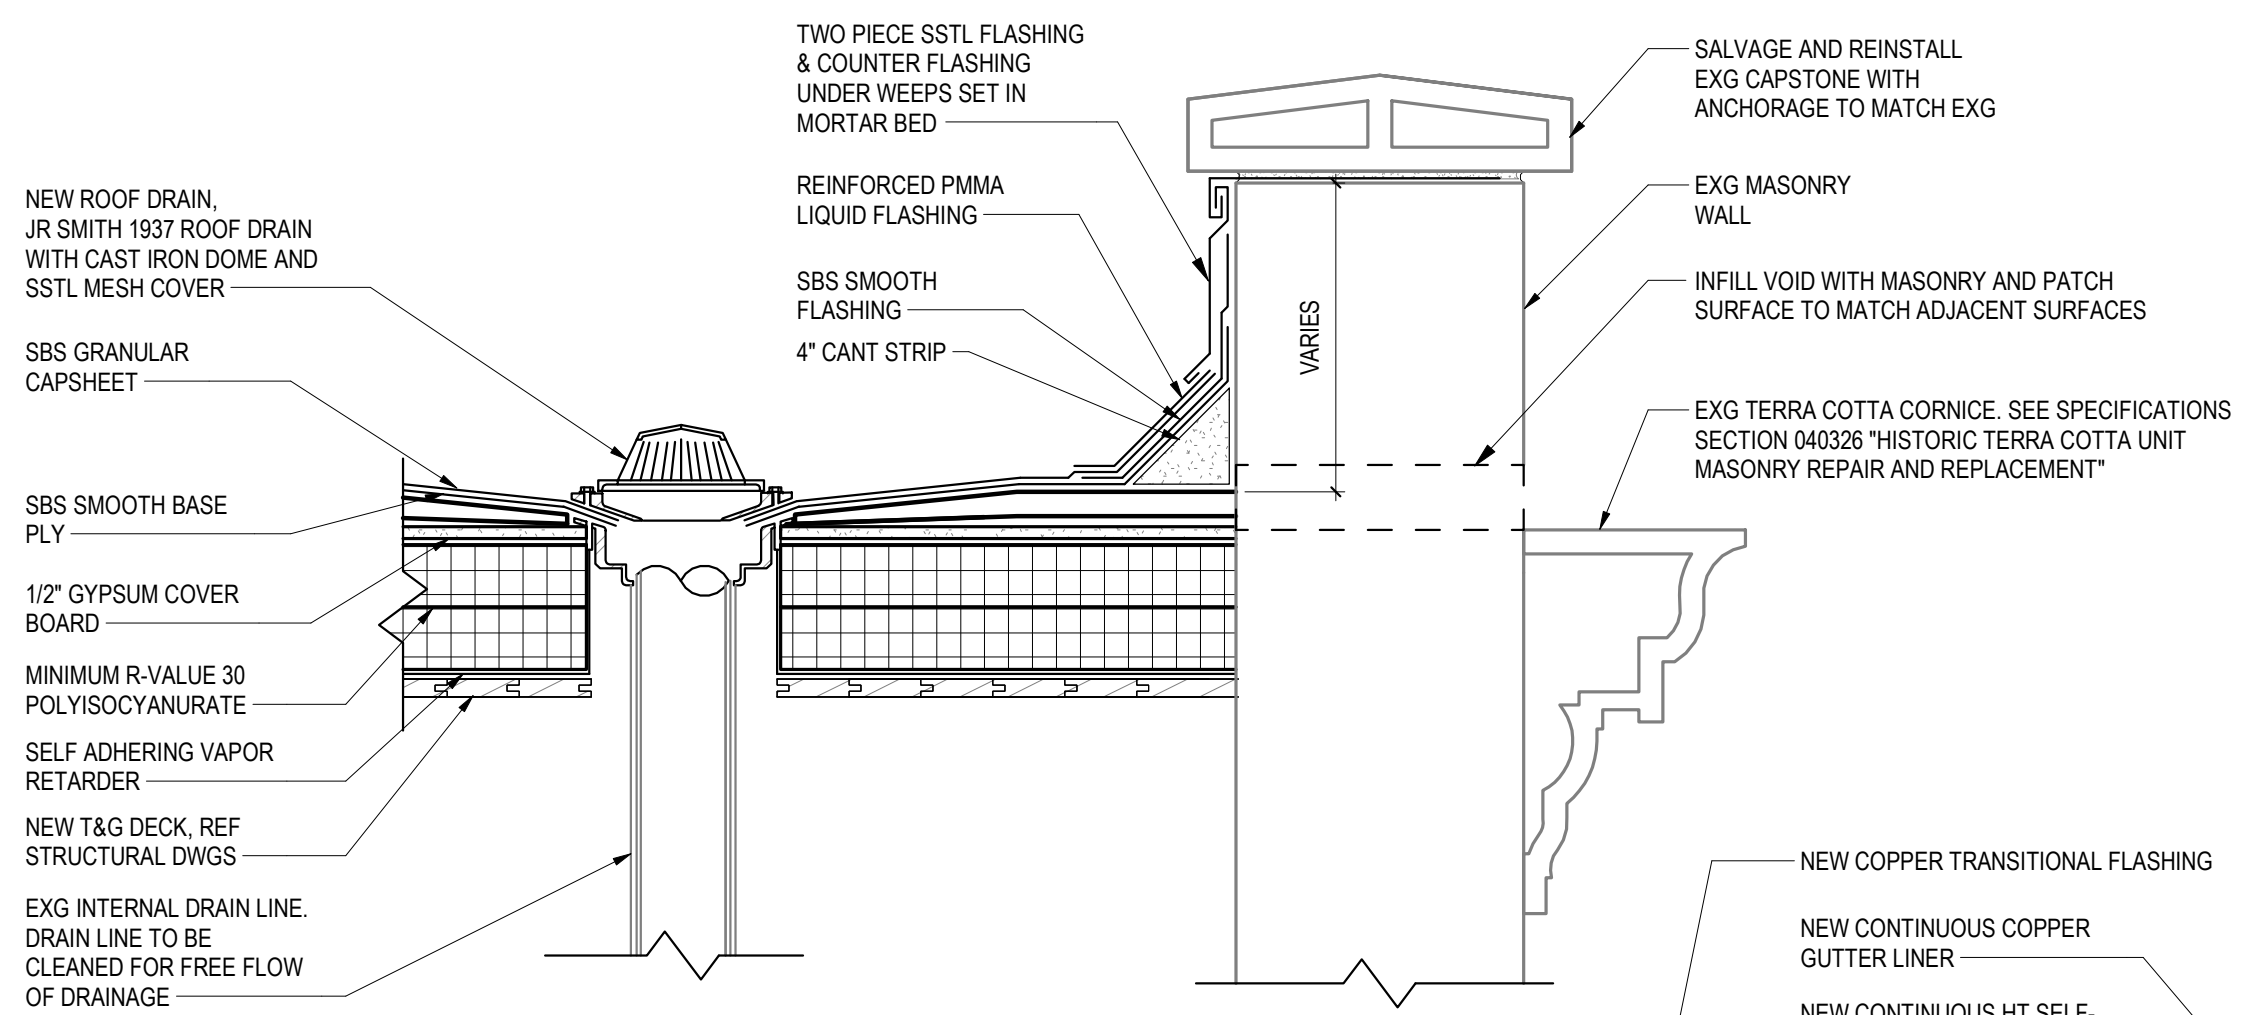


8 ROOF DRAIN AT SBS ROOF
A8.0 1 1/2" = 1'-0"

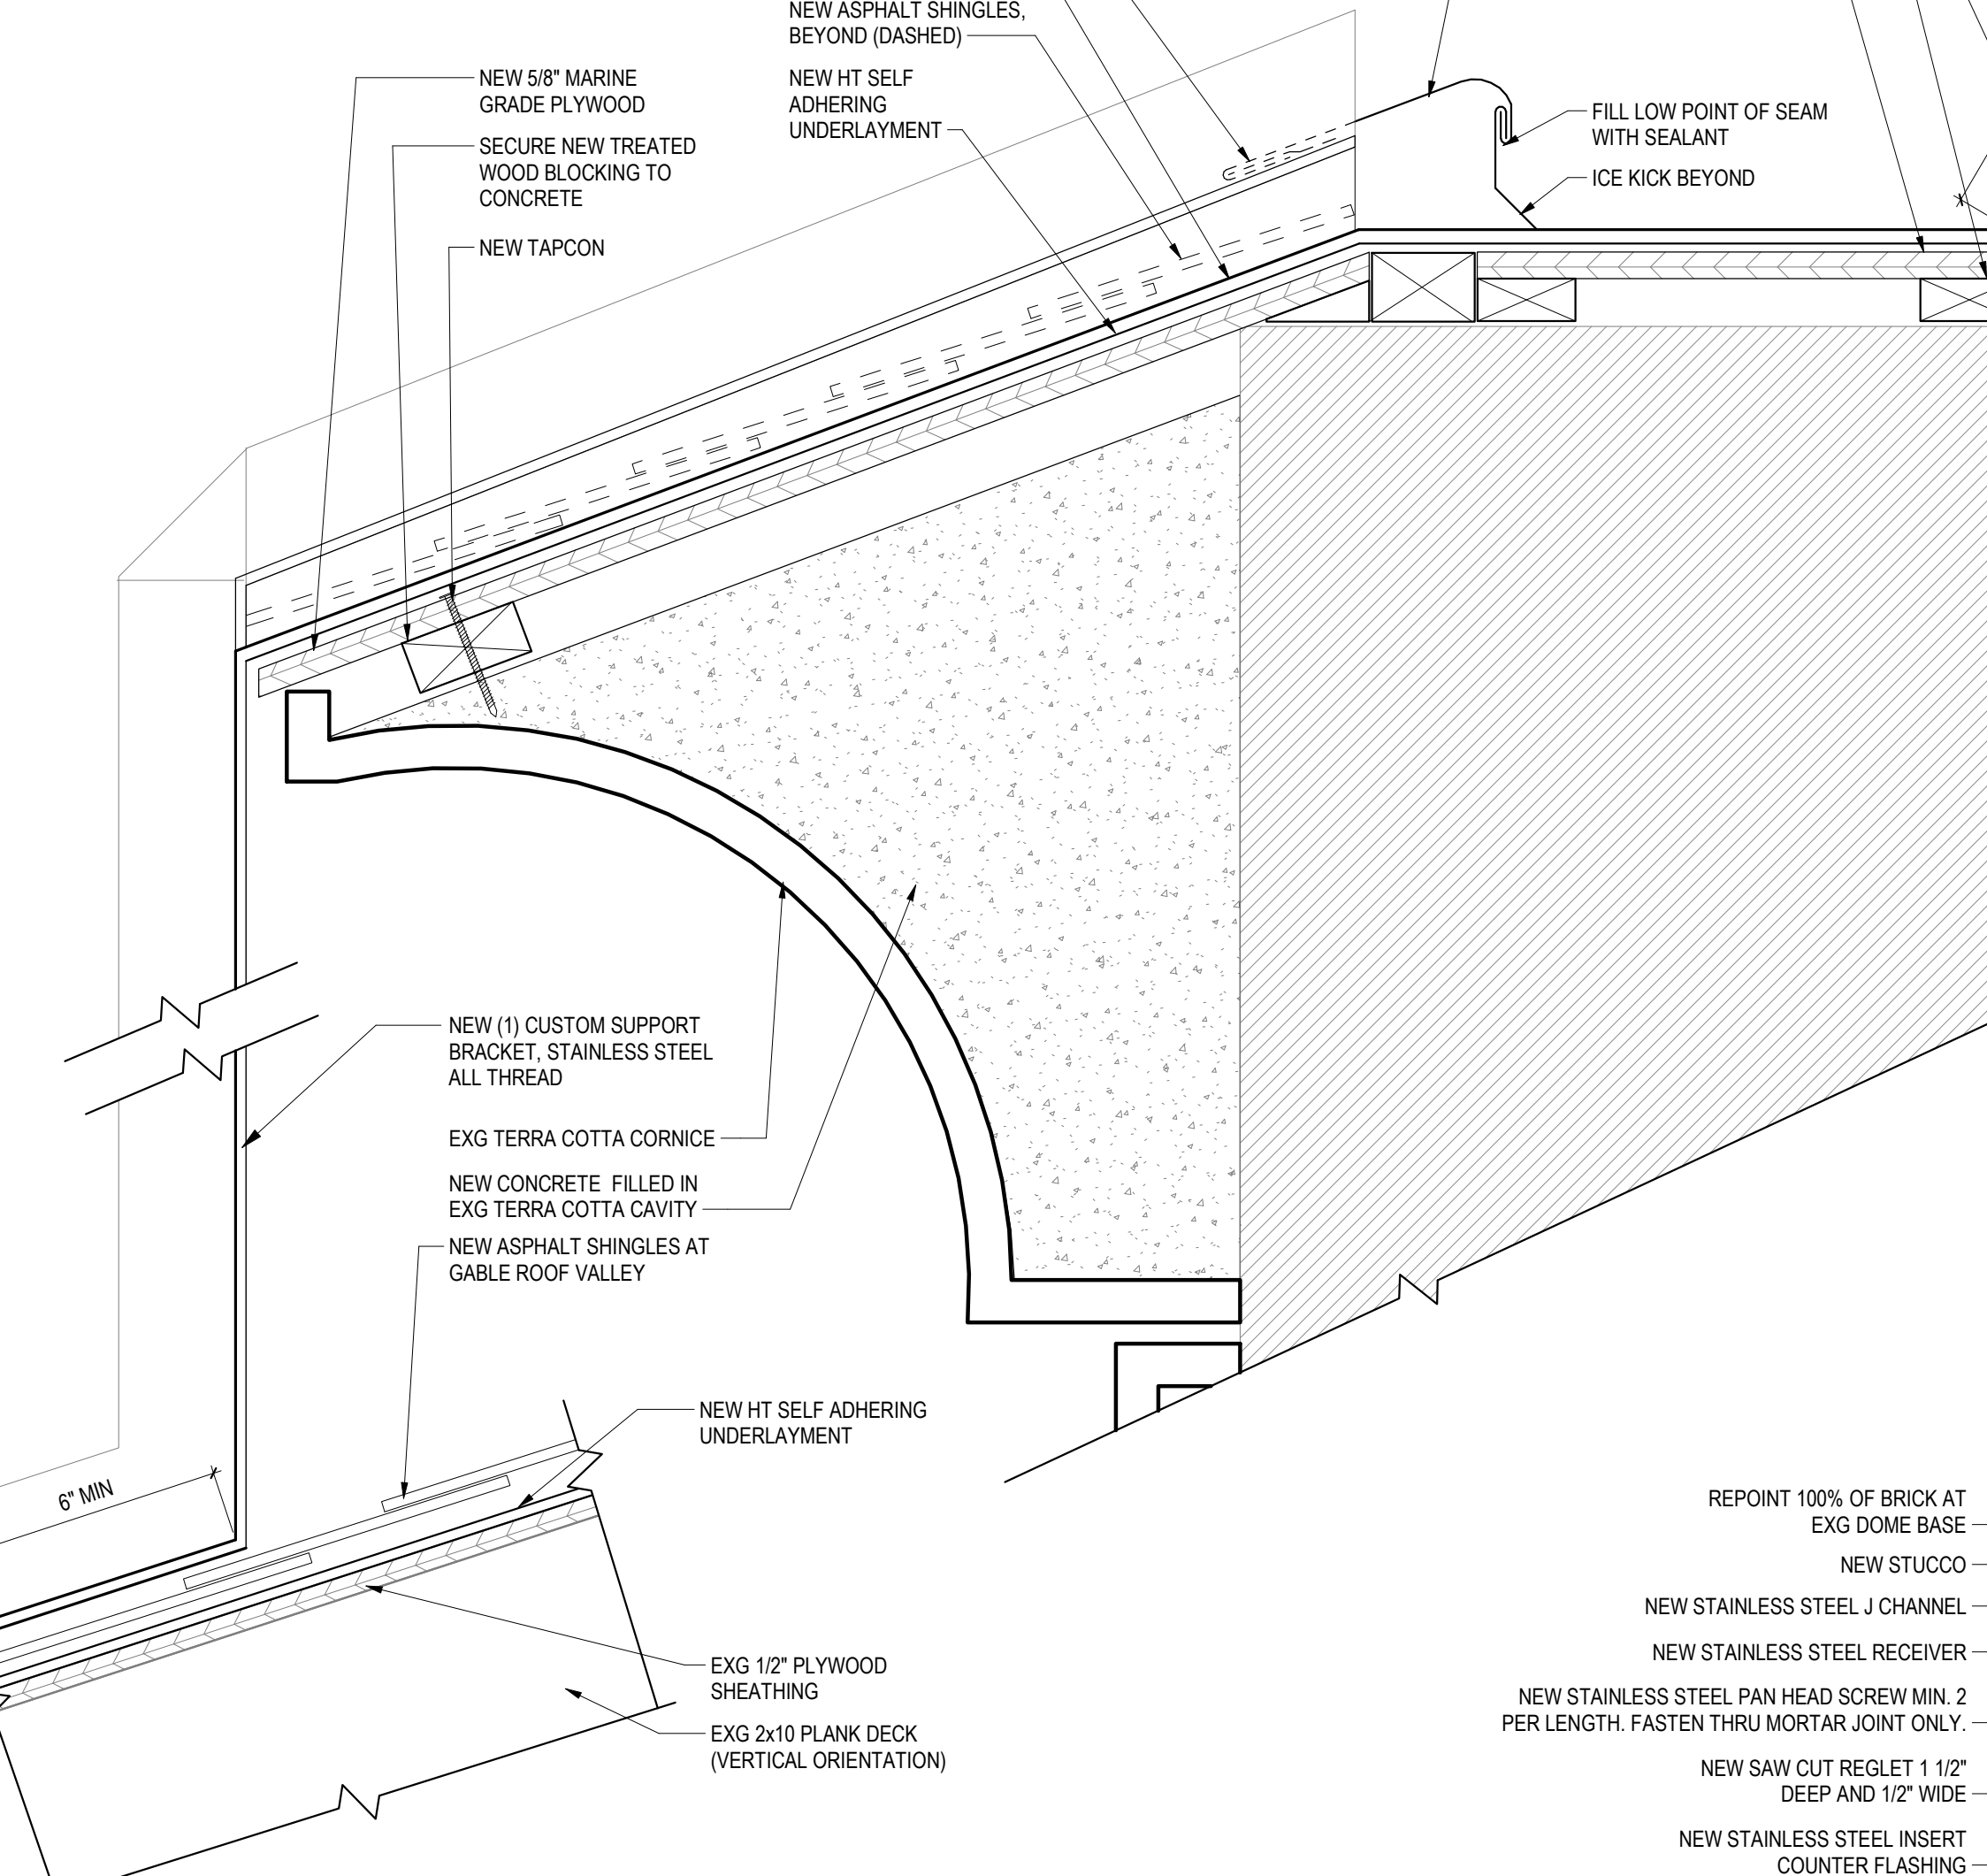


5 ROOF DETAIL - OPEN PAN GUTTER FROM DOME SKIRT TO GABLE VALLEY
A8.0 3" = 1'-0"

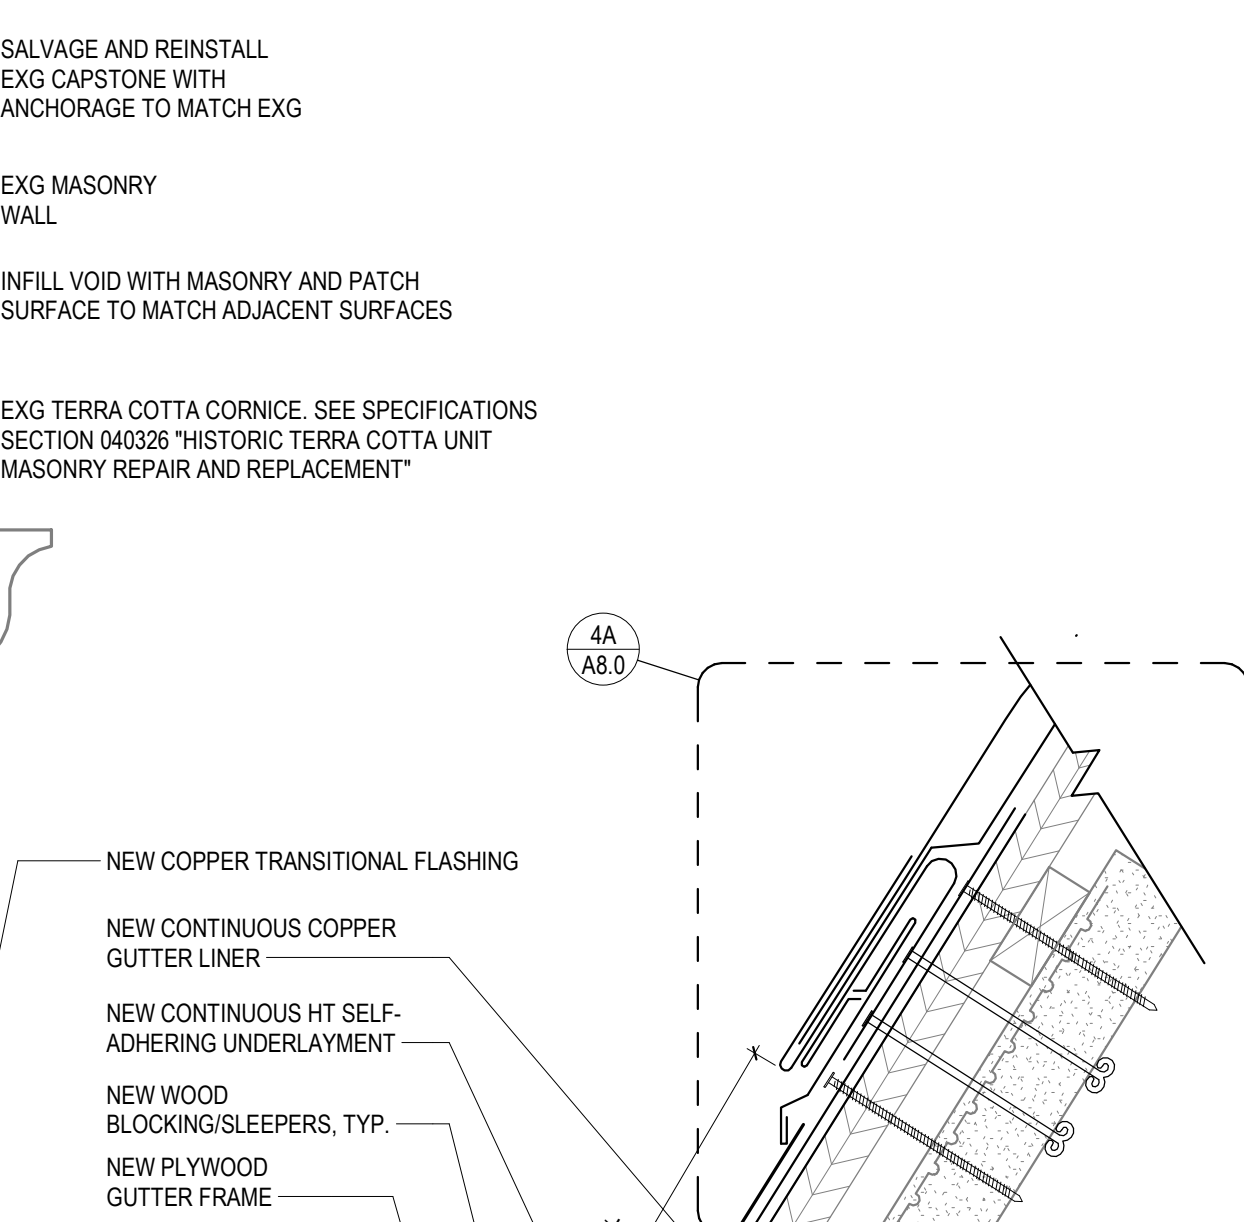


3 ROOF DETAIL - DOME STEP AND COUNTER
A8.0 3" = 1'-0"

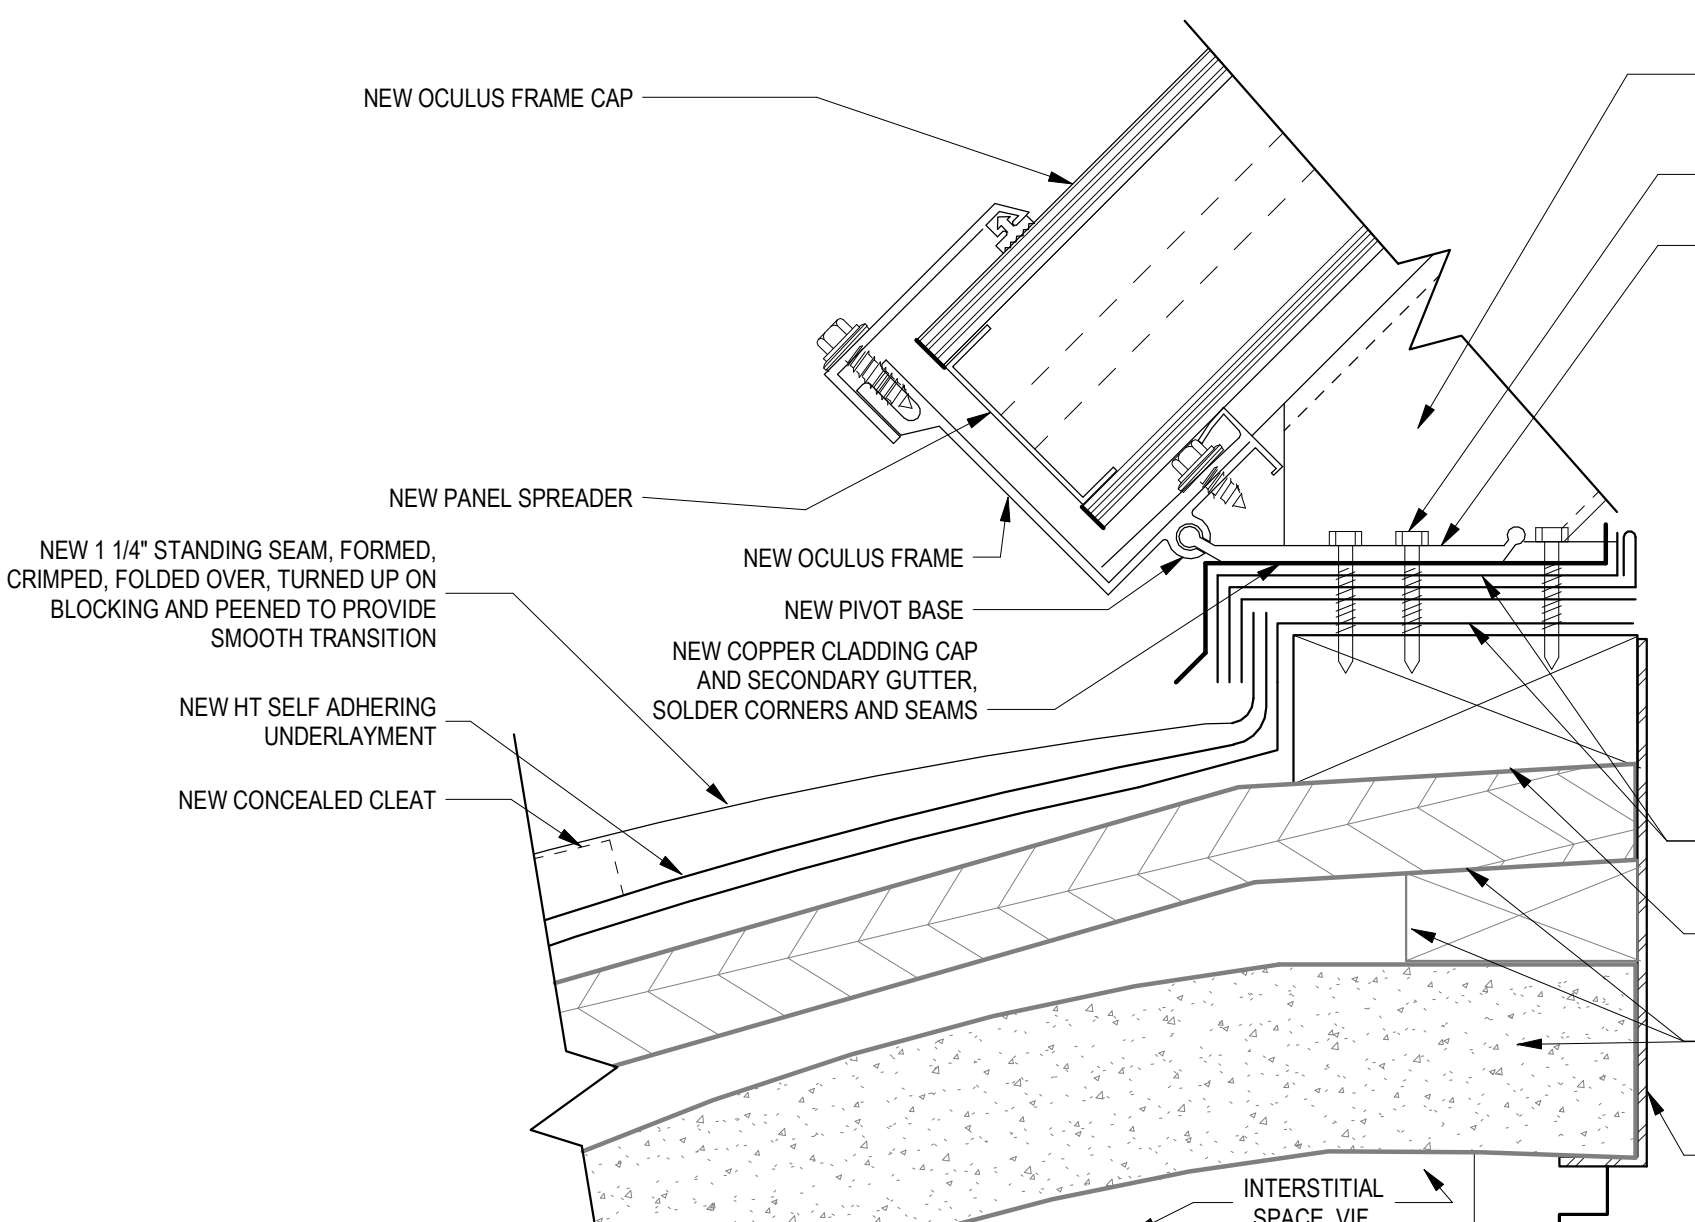


2 ROOF DETAIL - TYPICAL VENT PIPE FLASHING
A8.0 3" = 1'-0"

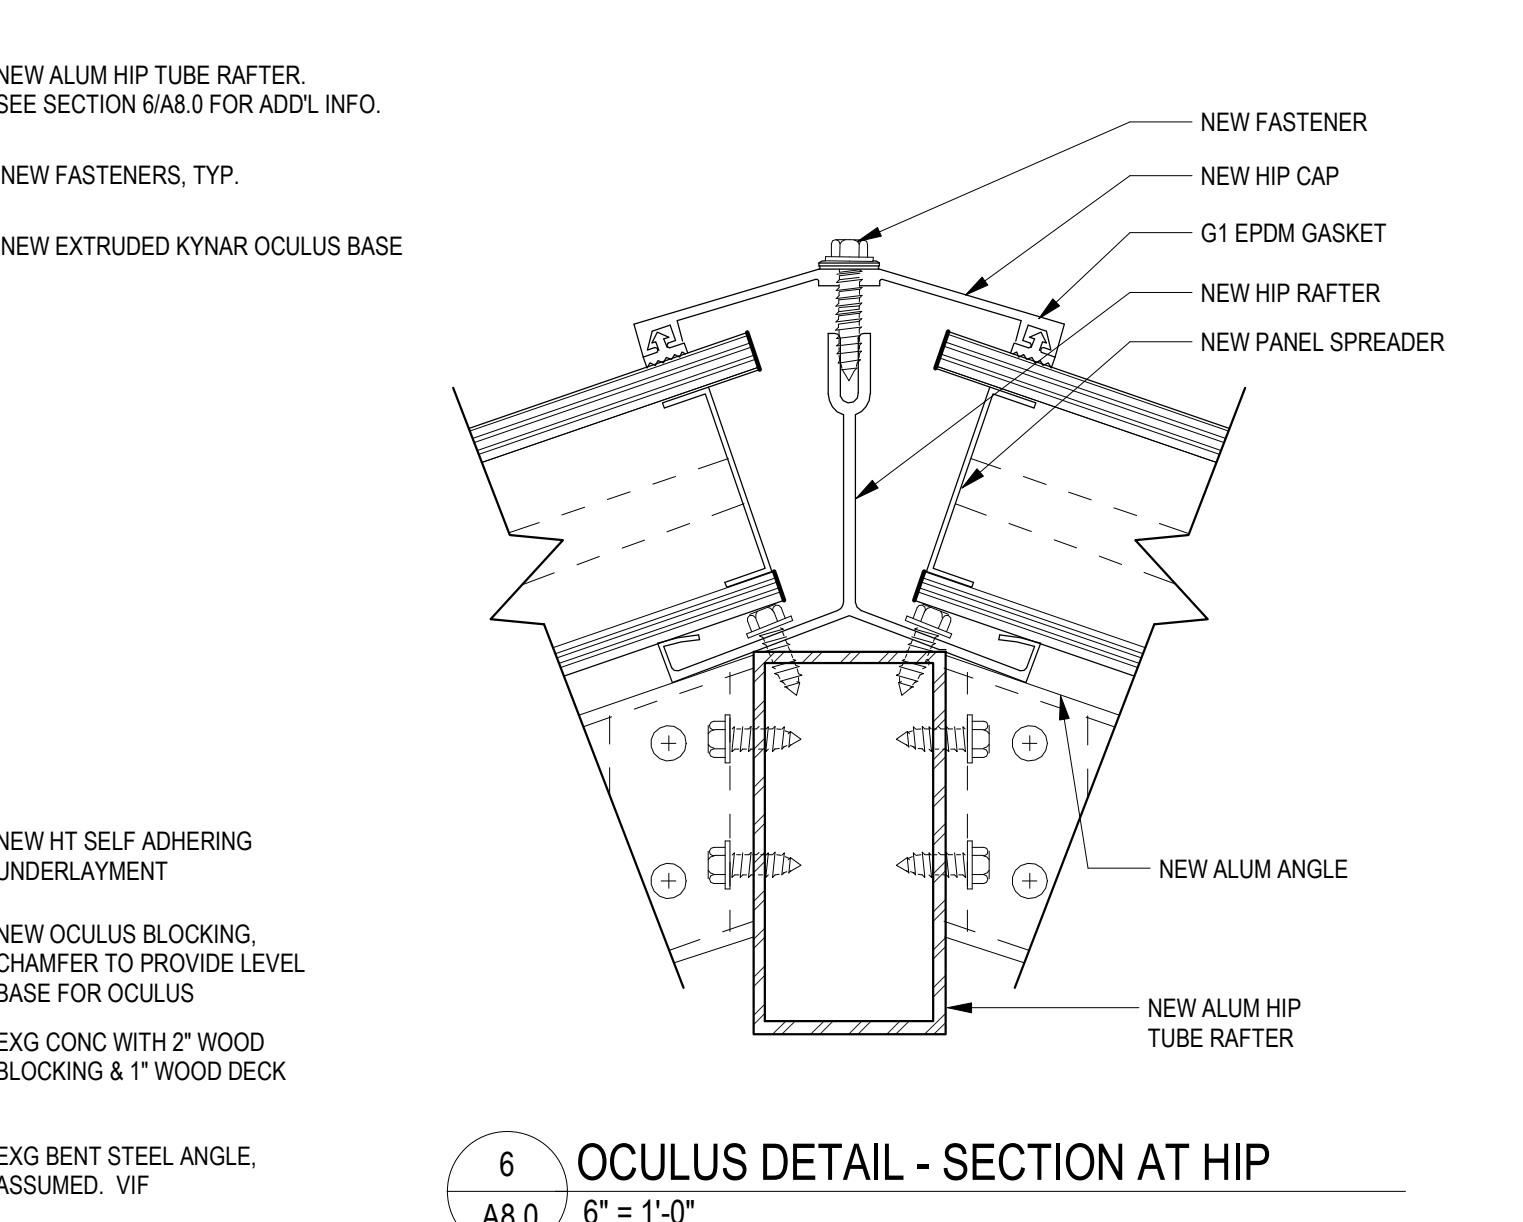


1 ROOF DETAIL - RIDGE
A8.0 3" = 1'-0"

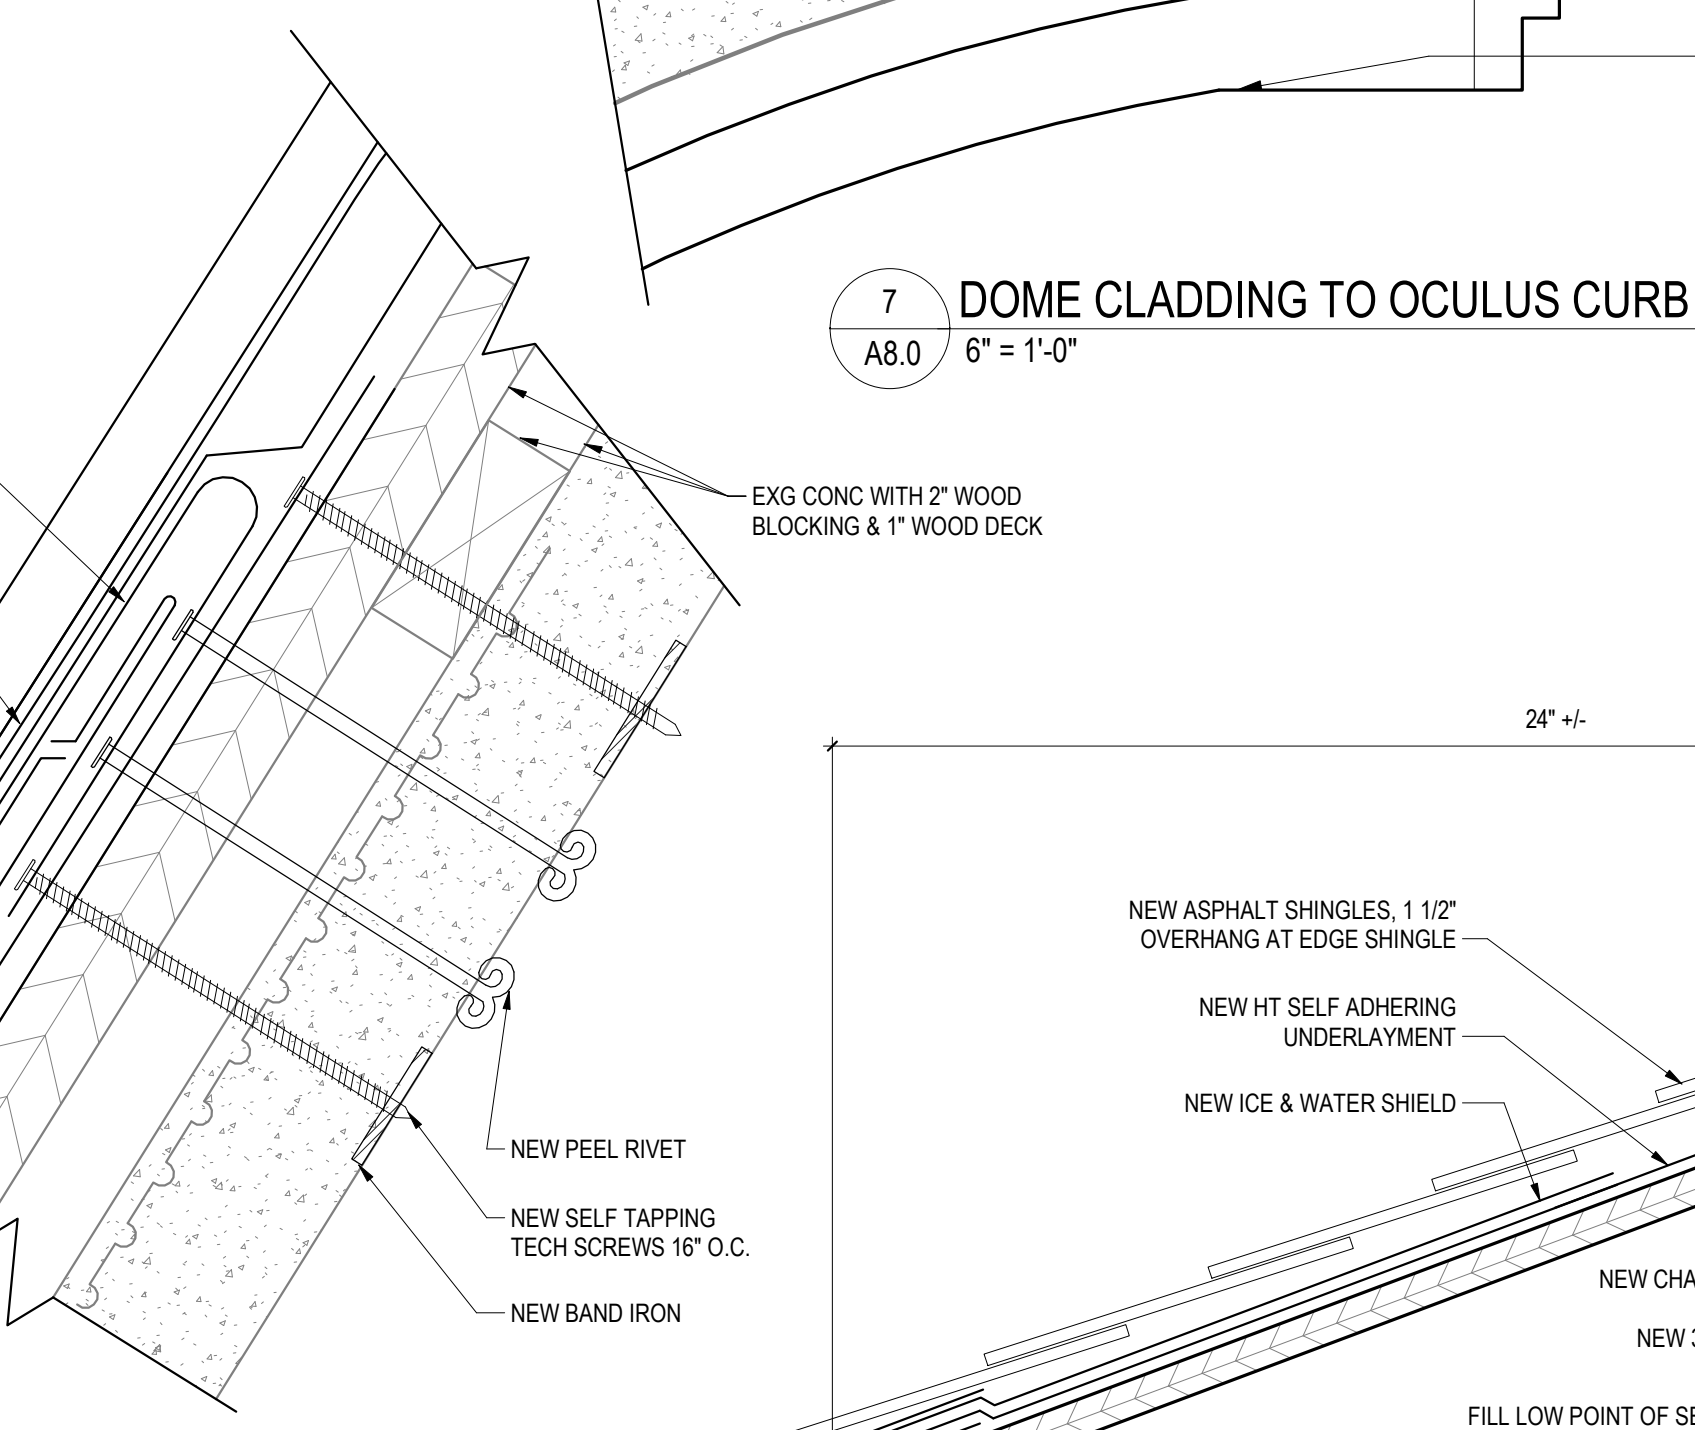


7 DOME CLADDING TO OCULUS CURB
A8.0 6" = 1'-0"

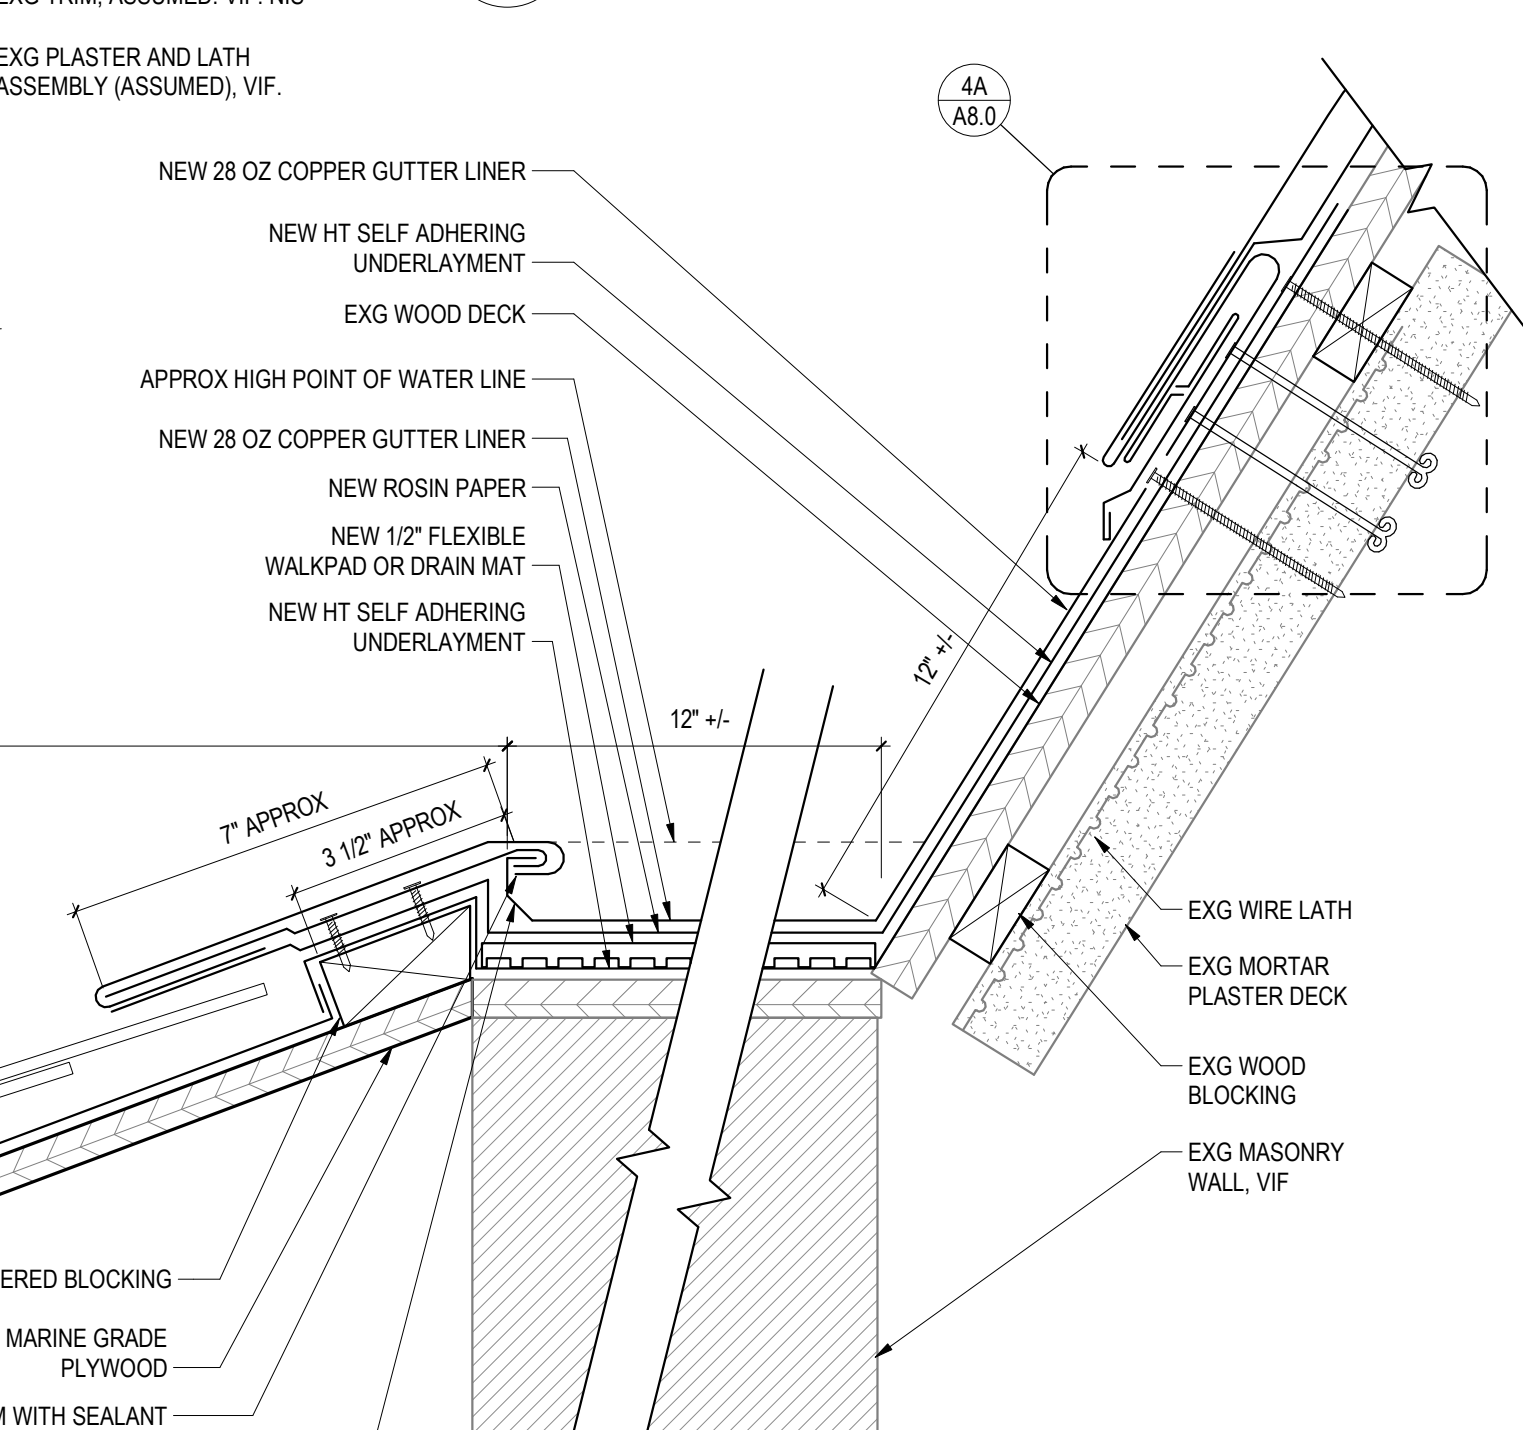


4 ROOF DETAIL - DOME GUTTER AND SKIRT
A8.0 3" = 1'-0"

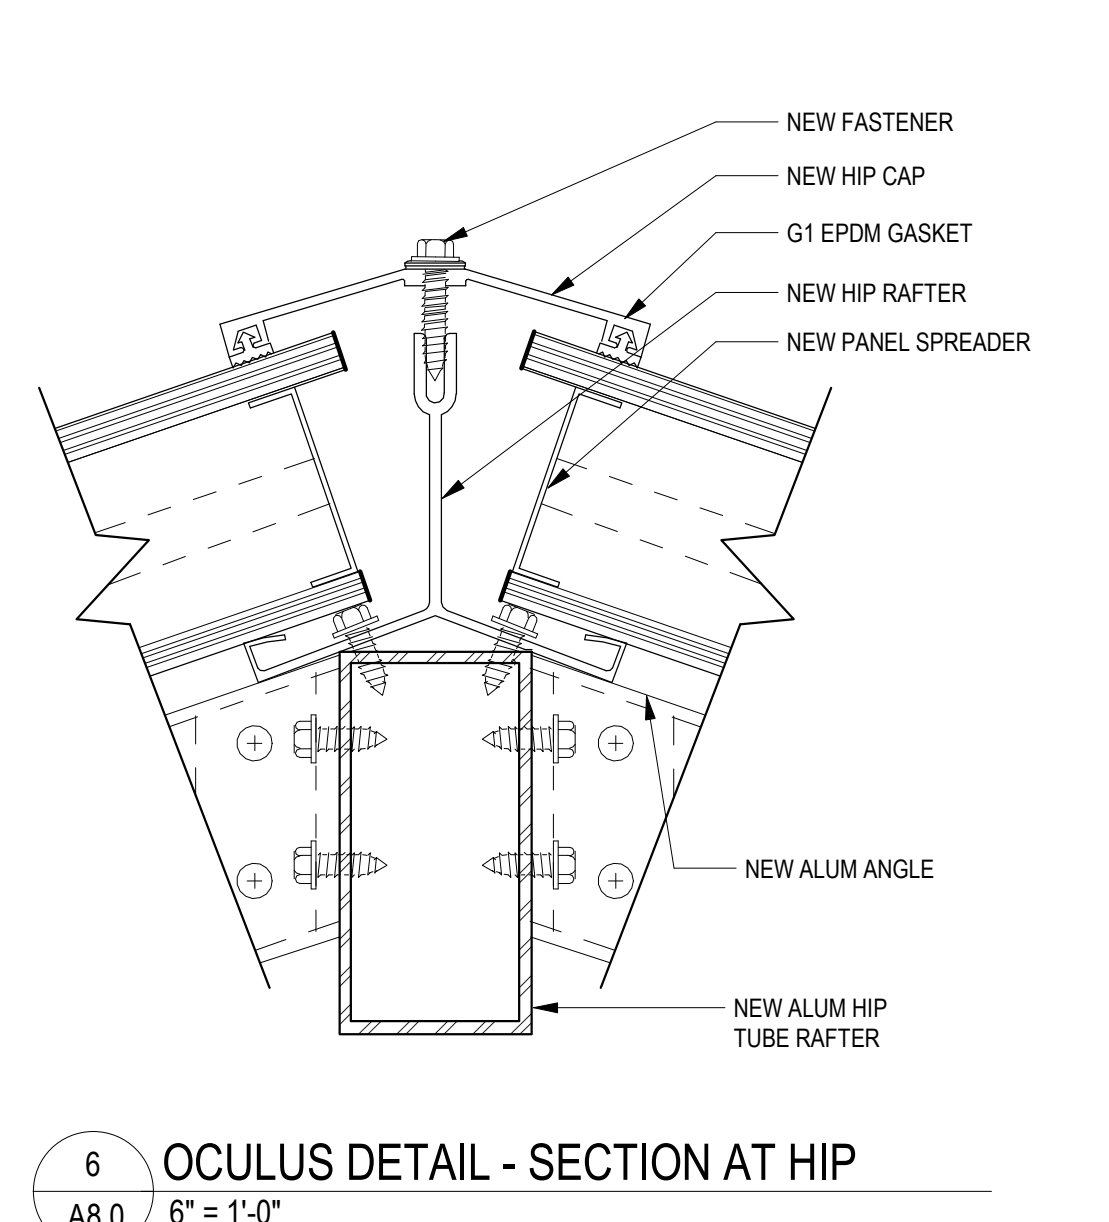


6 OCULUS DETAIL - SECTION AT HIP
A8.0 6" = 1'-0"

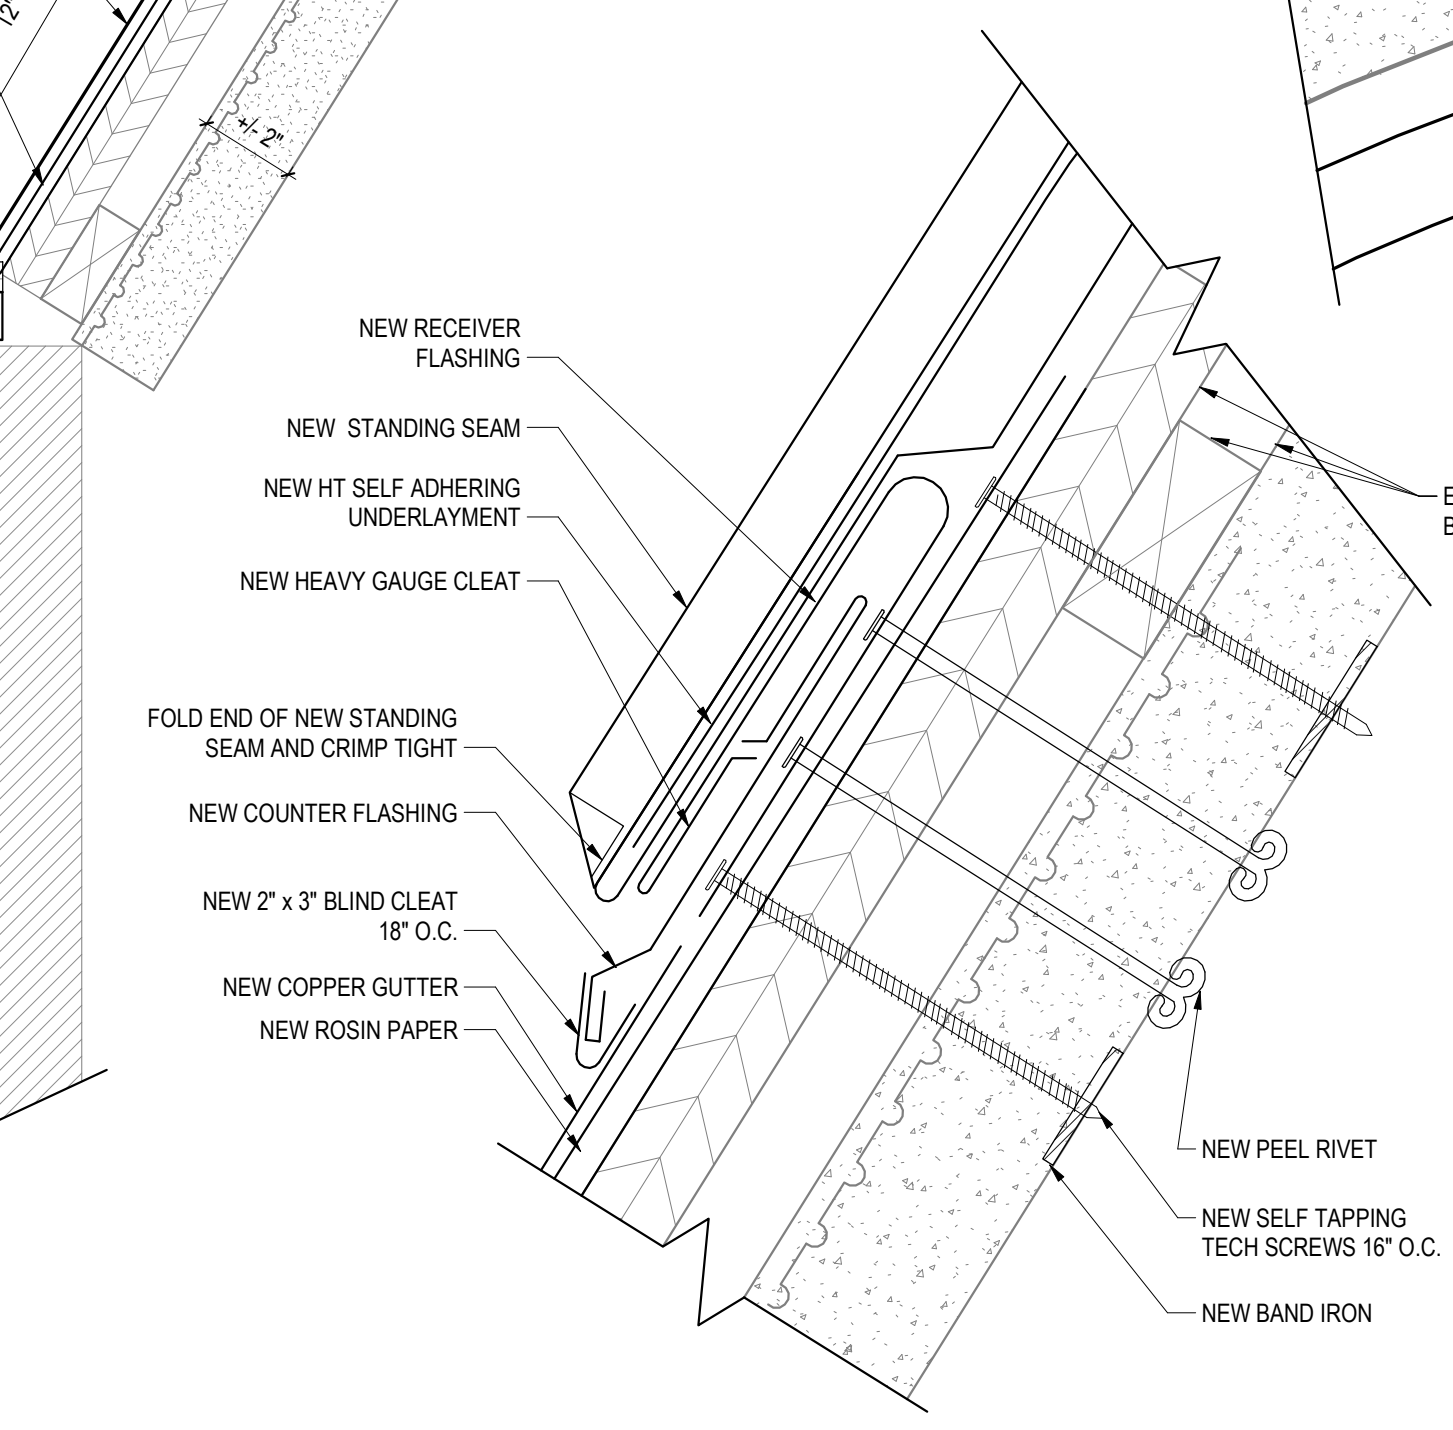


4A ENLARGED GUTTER TO DOME TRANSITION
A8.0 6" = 1'-0"

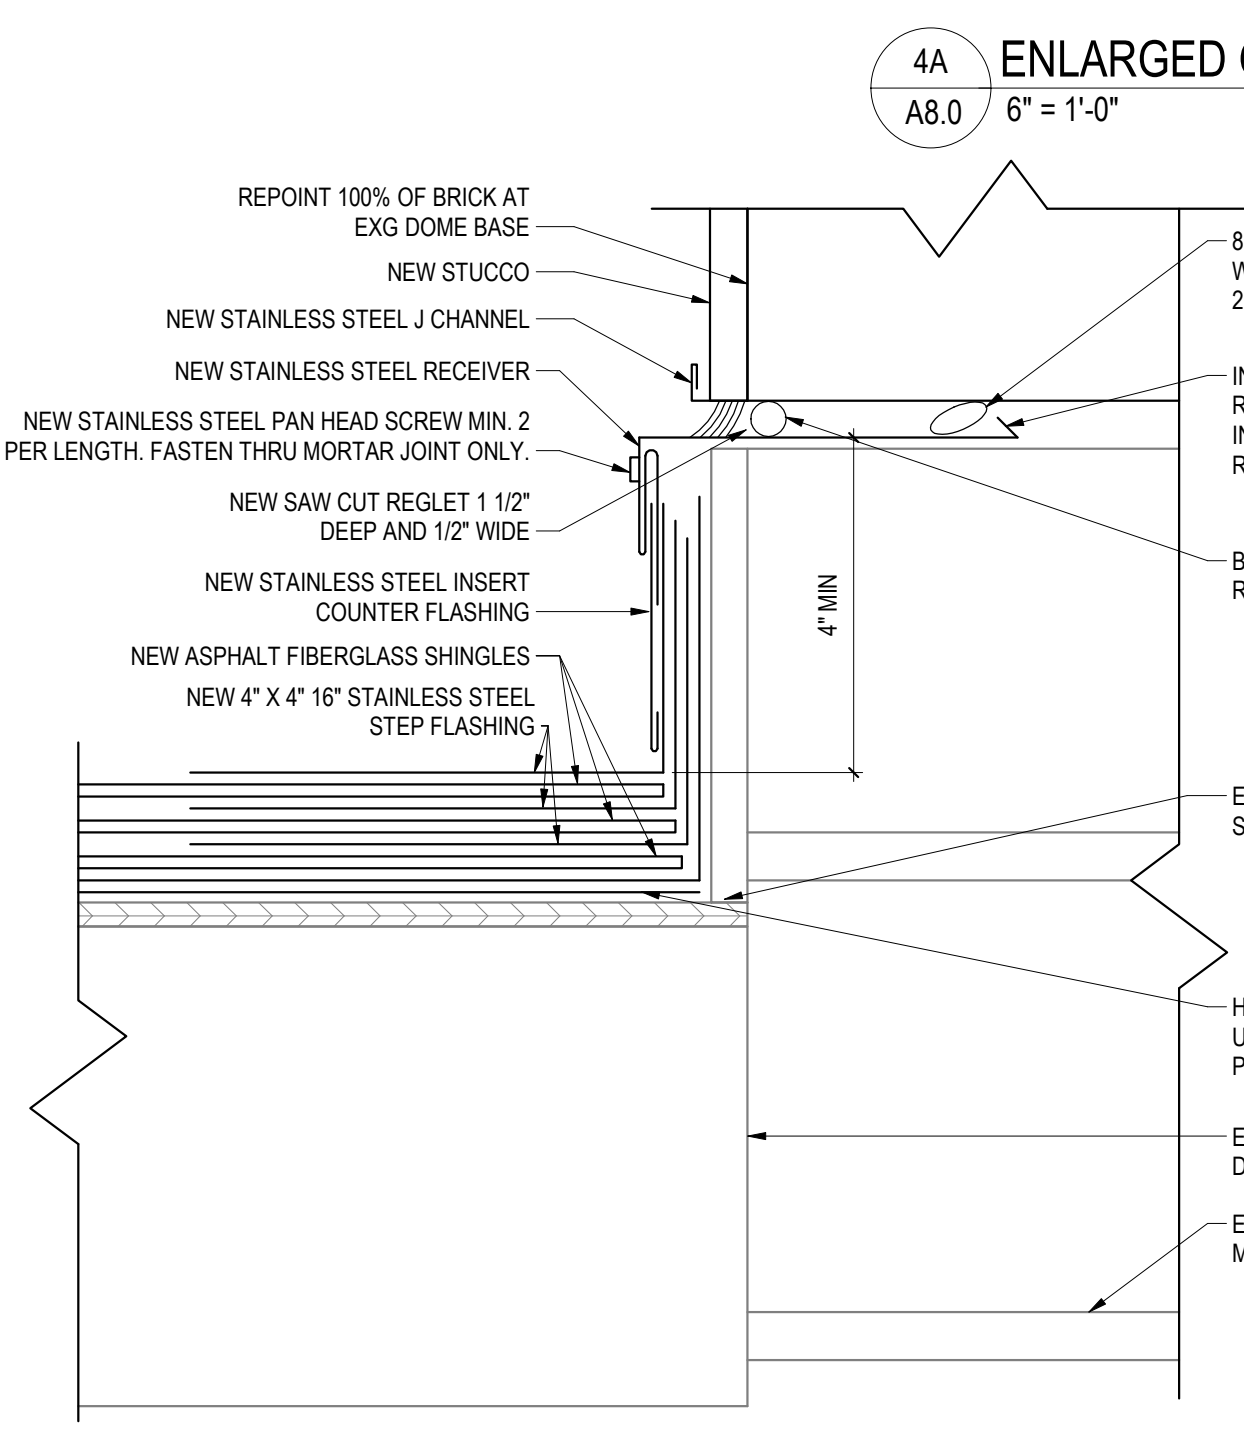


3 ROOF DETAIL - DOME STEP AND COUNTER
A8.0 3" = 1'-0"

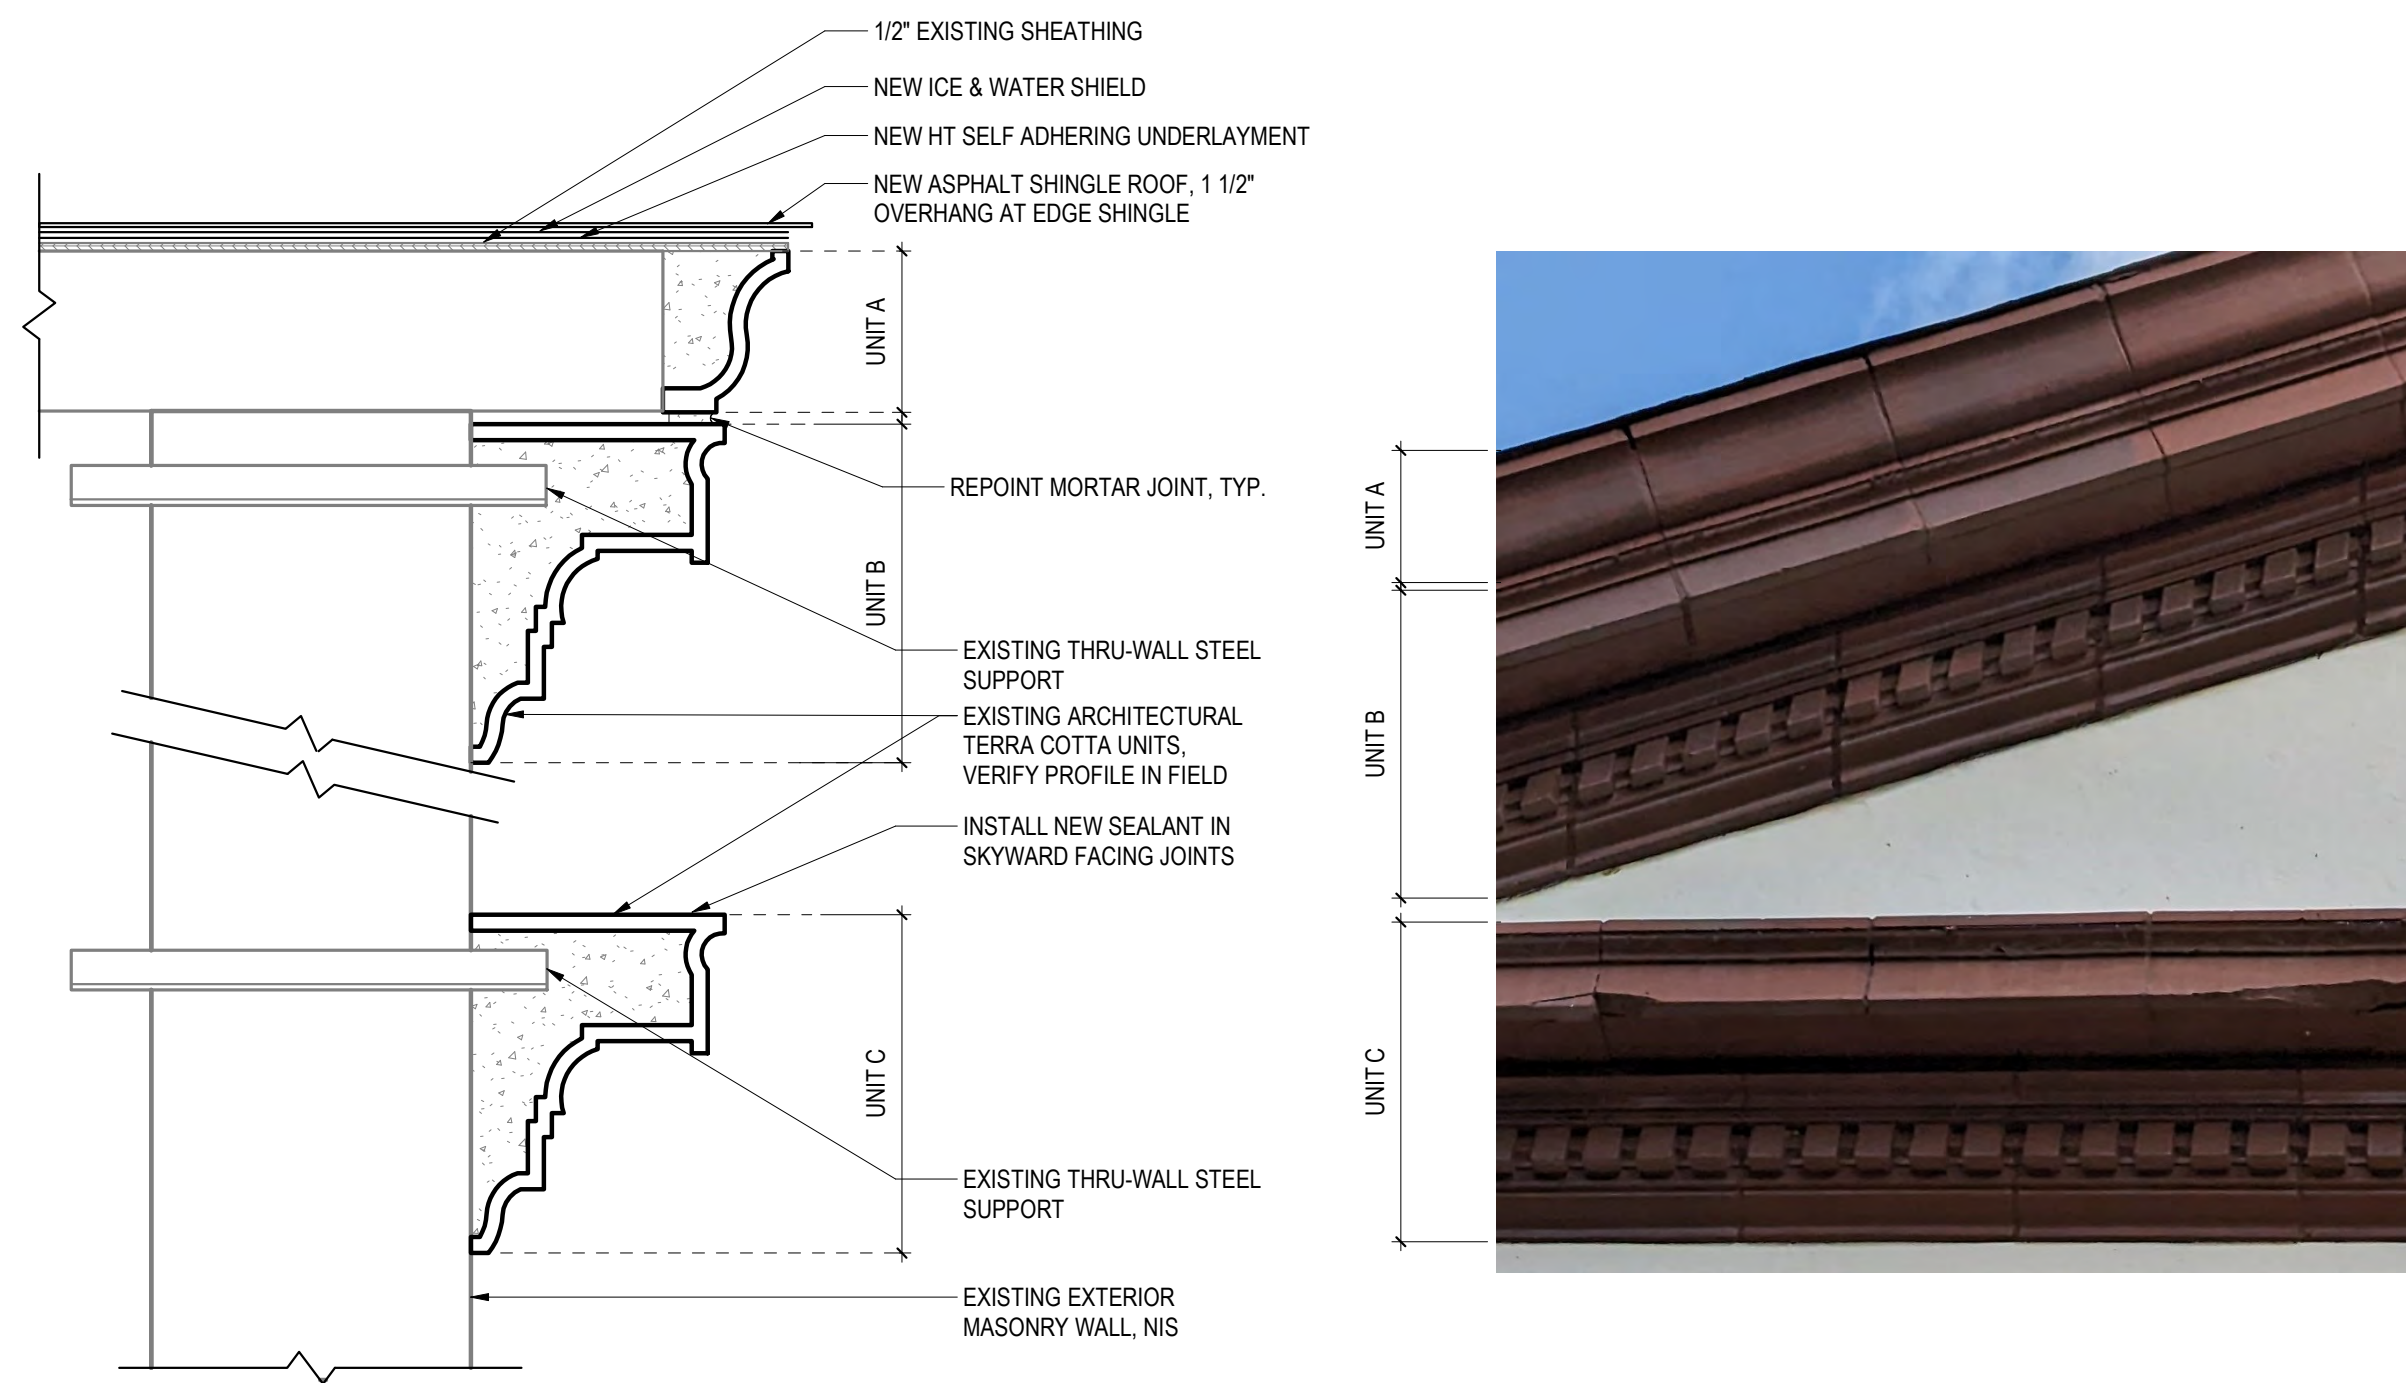


7 TERRA COTTA DETAIL - CORNICE AT RAKE AND PEDIMENT
A8.1 1" = 1'-0"

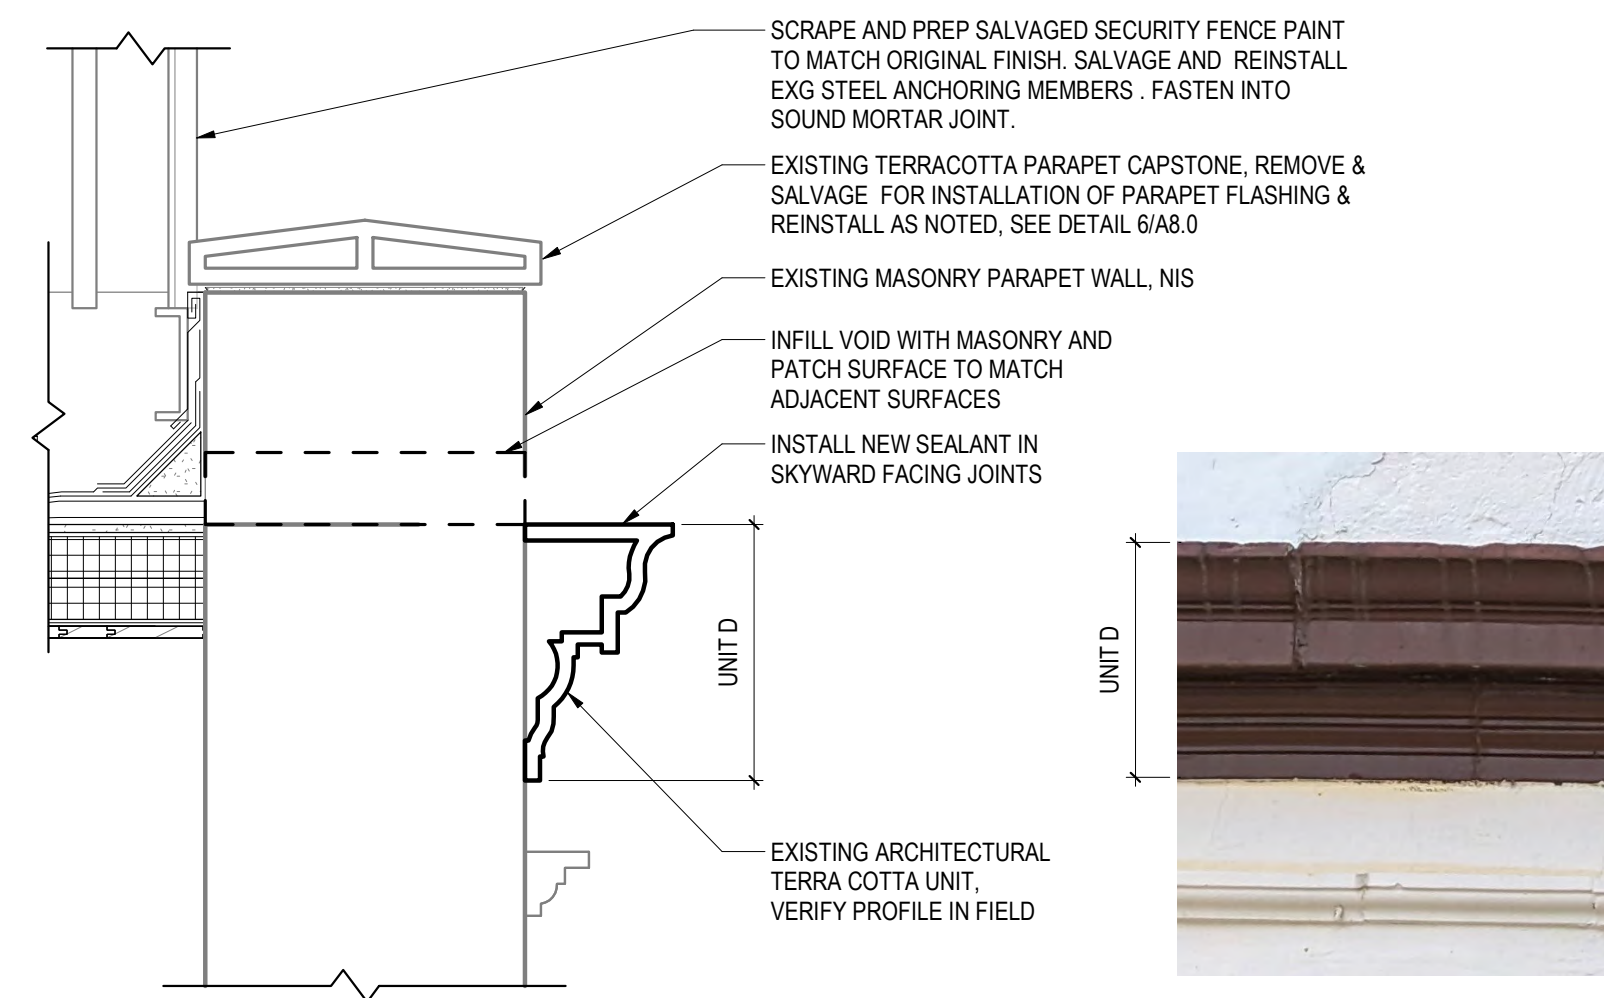


6 TERRA COTTA DETAIL - CORNICE AT SBS ROOF
A8.1 1" = 1'-0"

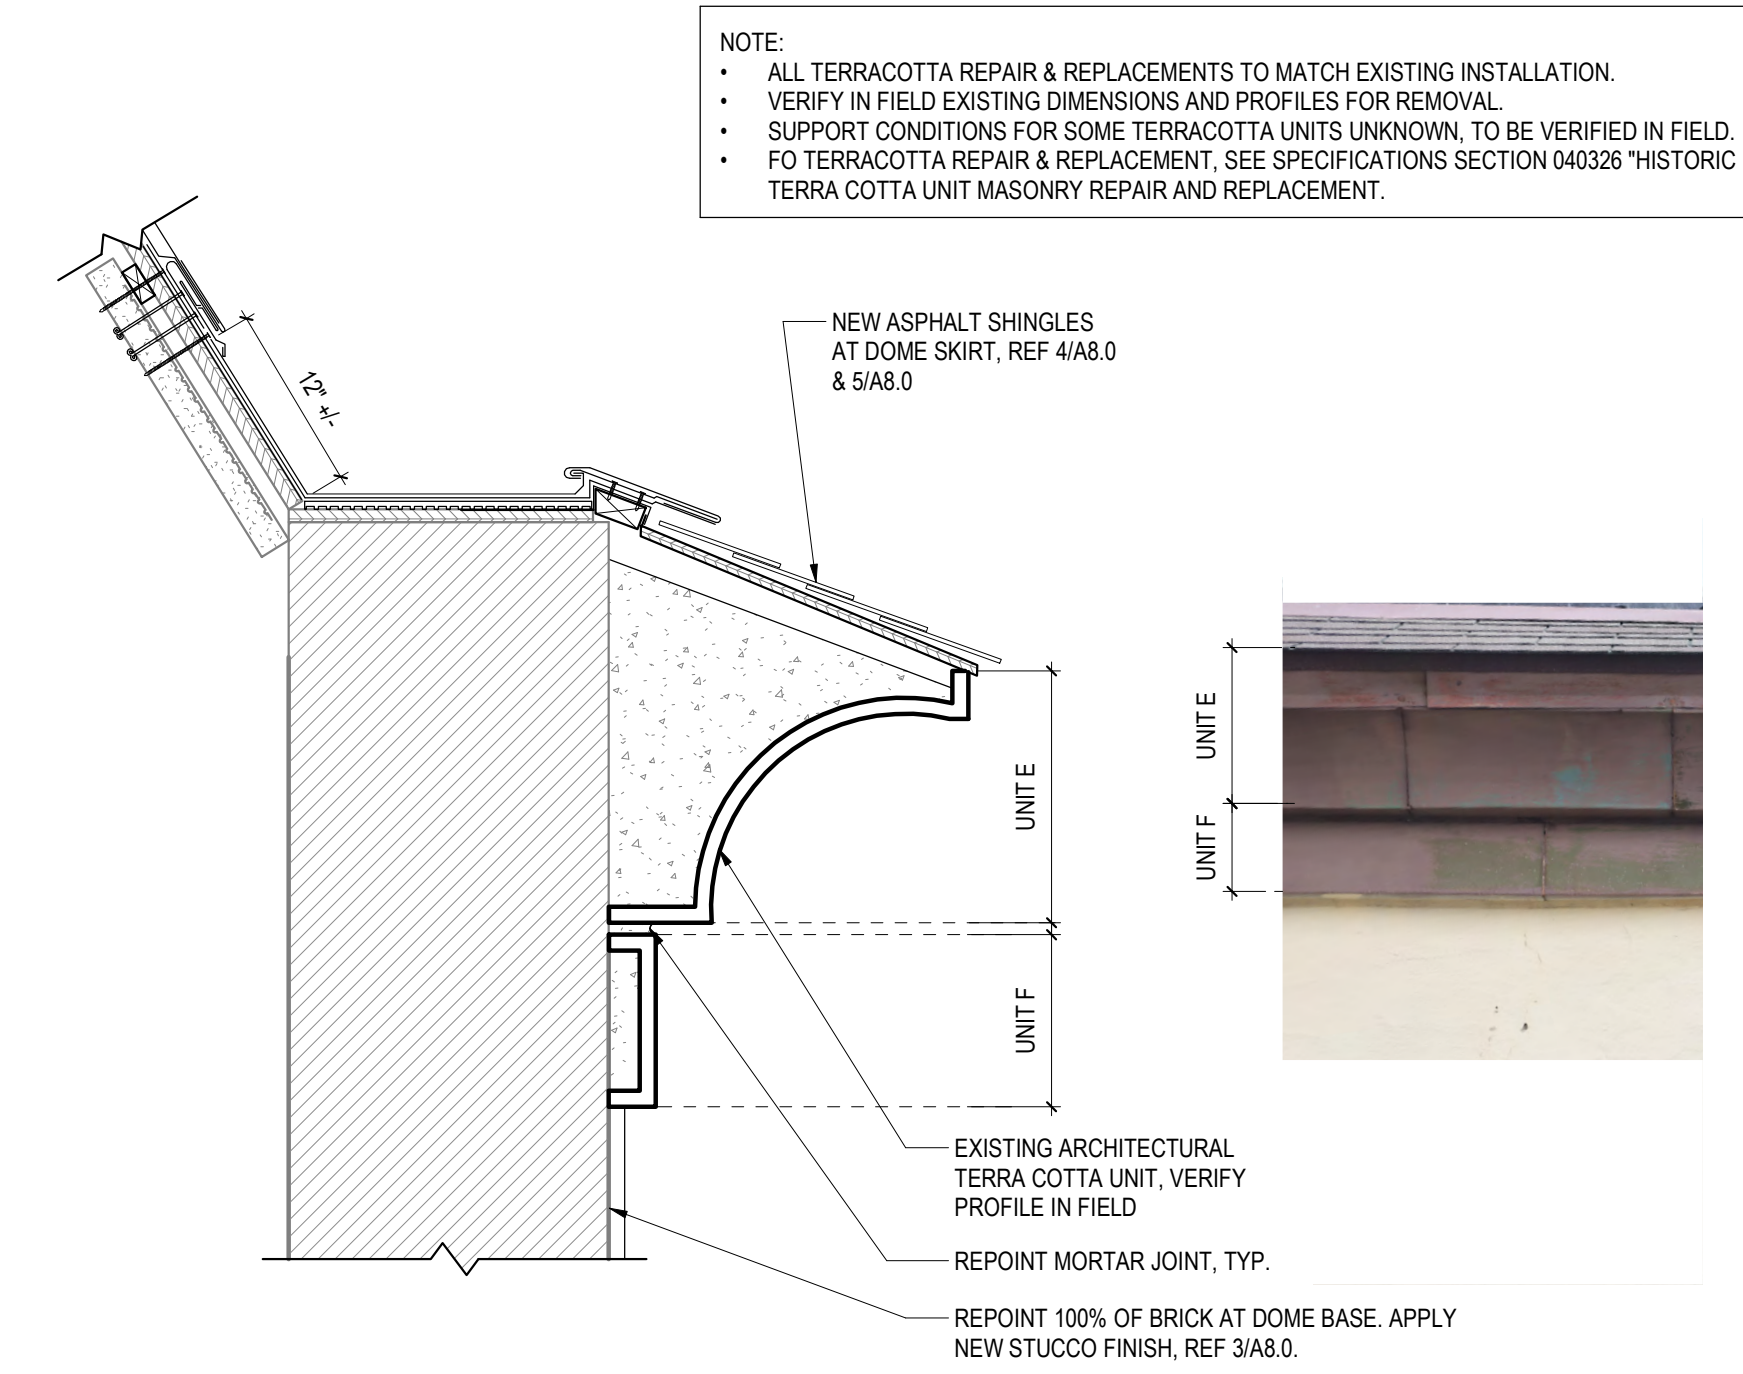



5 TERRA COTTA DETAIL - CORNICE AT DOME SKIRT
A8.1 1" = 1'-0"

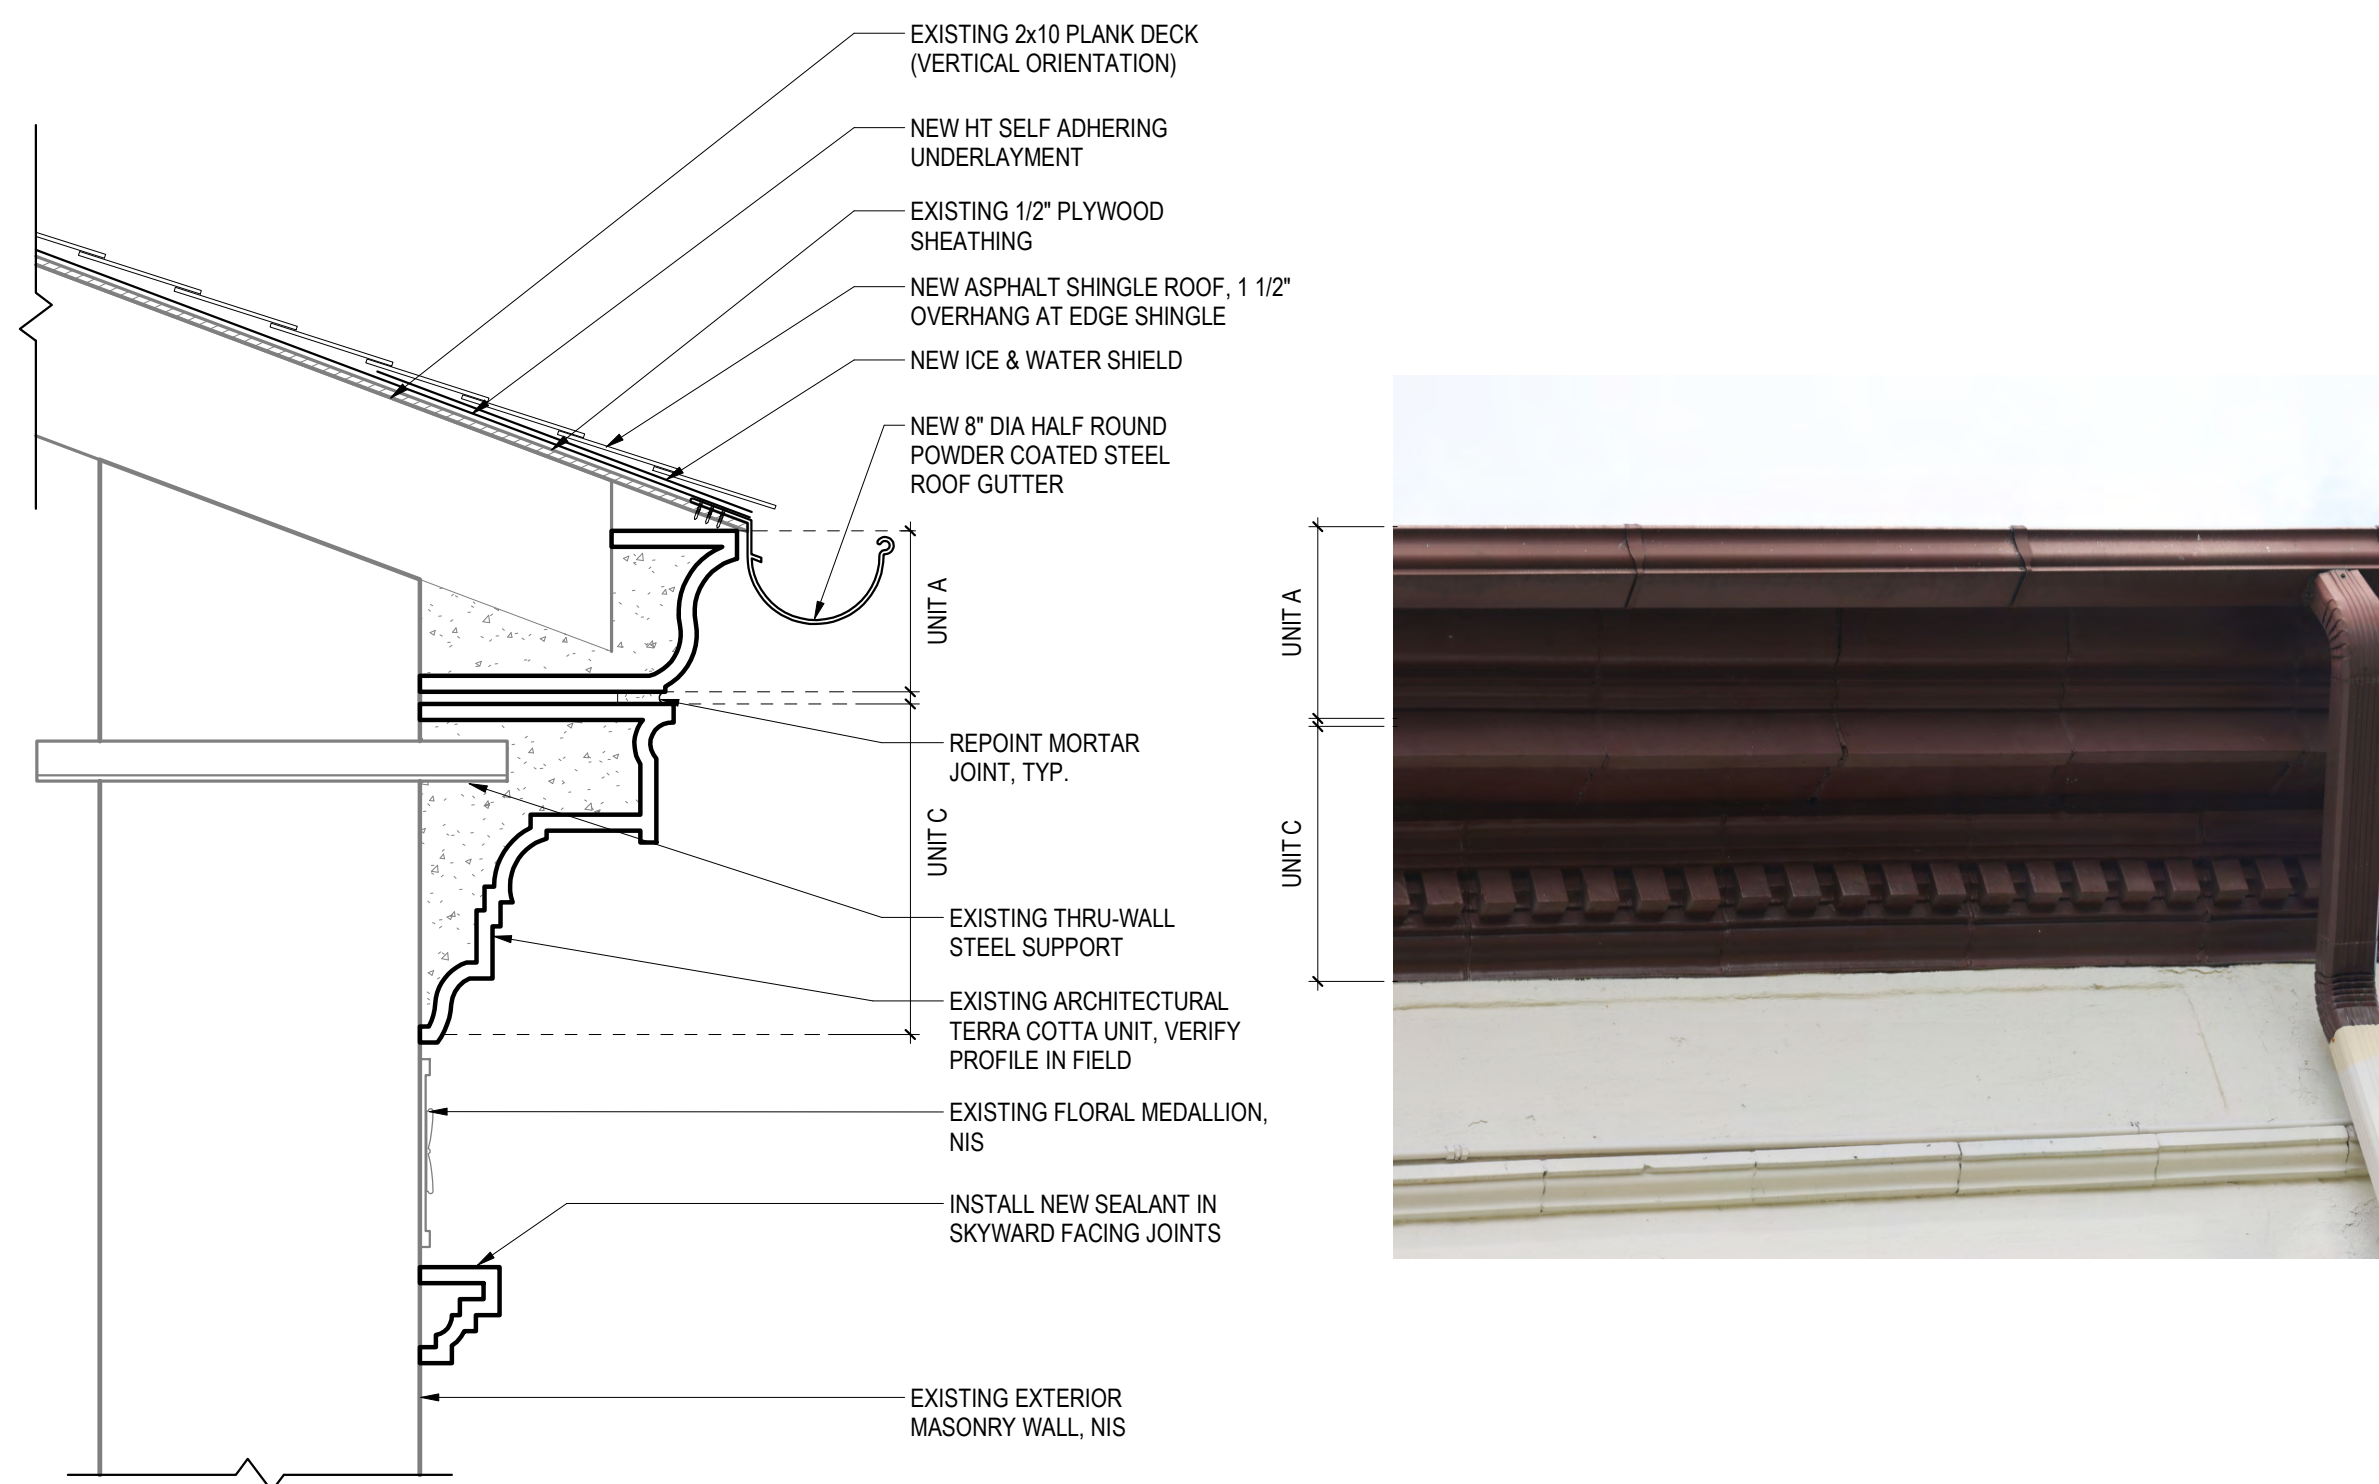


4 TERRA COTTA DETAIL - CORNICE AT EAVE
A8.1 1" = 1'-0"

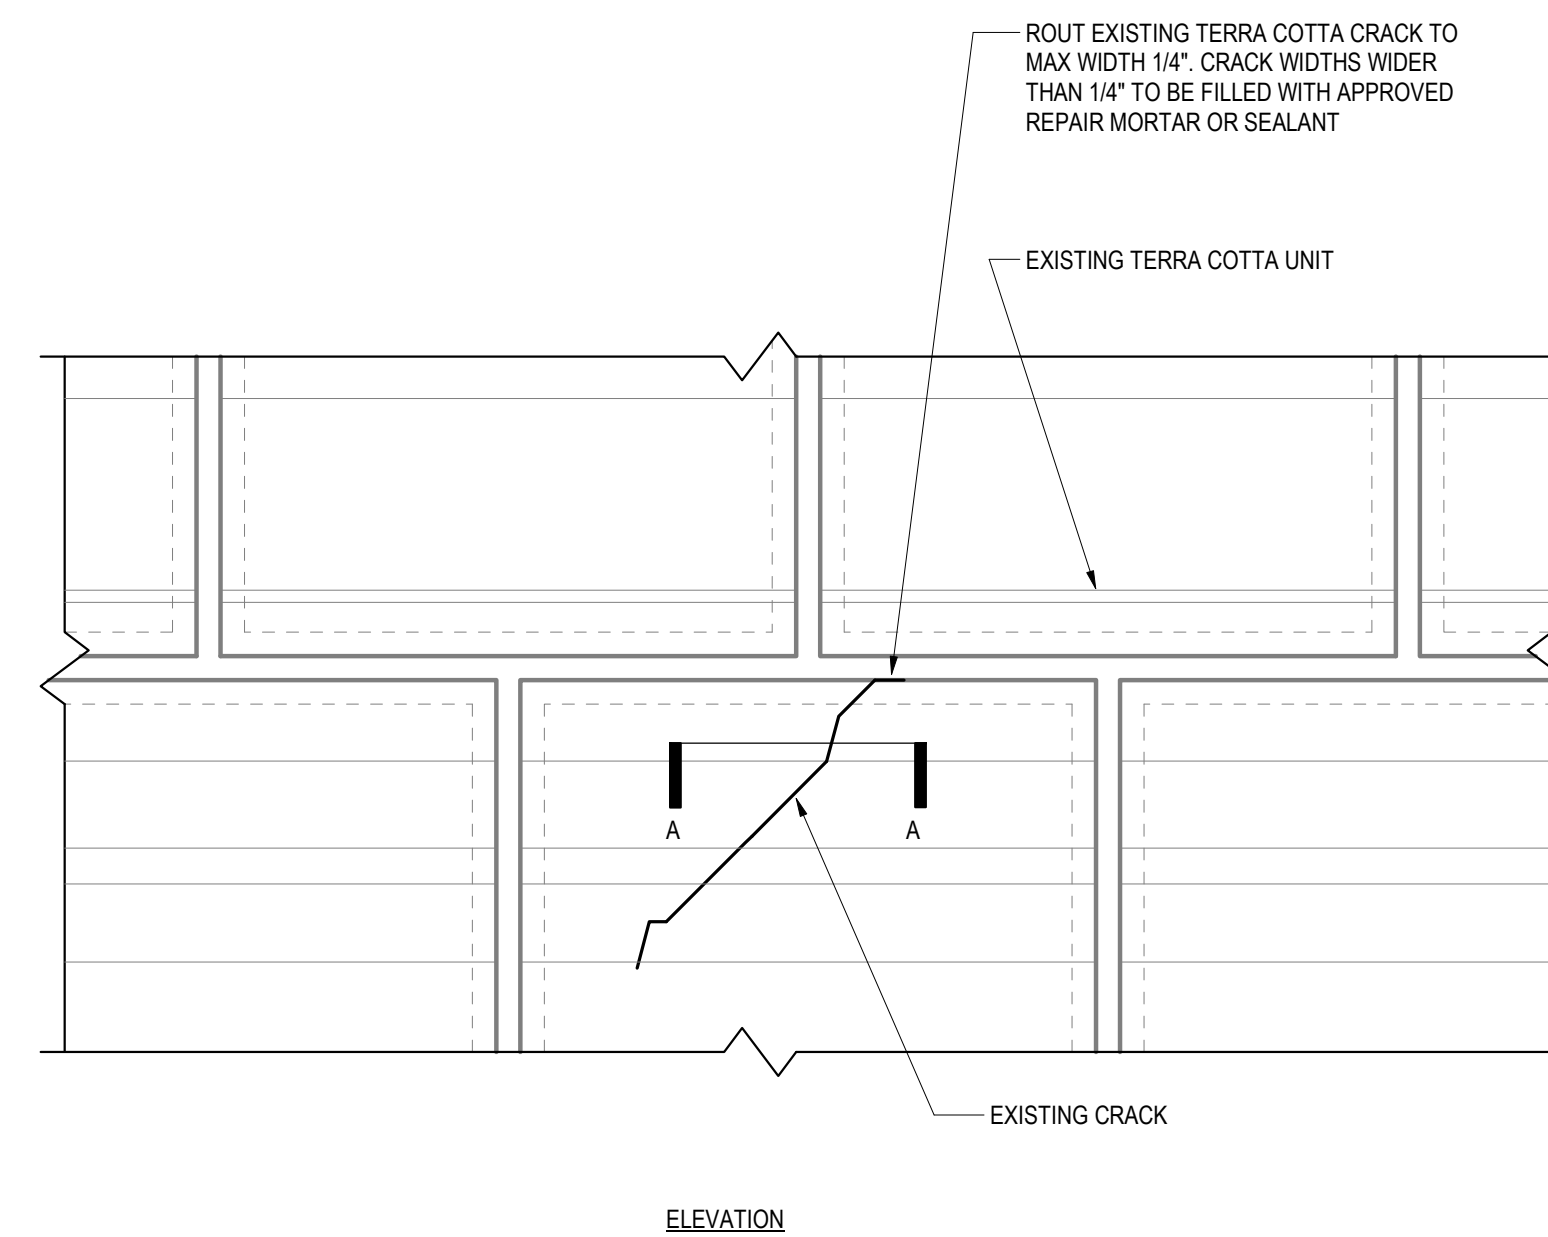

3 CORNICE DETAIL TYPICAL - ROUT AND SEAL CRACKED UNITS
A8.1 1 1/2" = 1'-0"

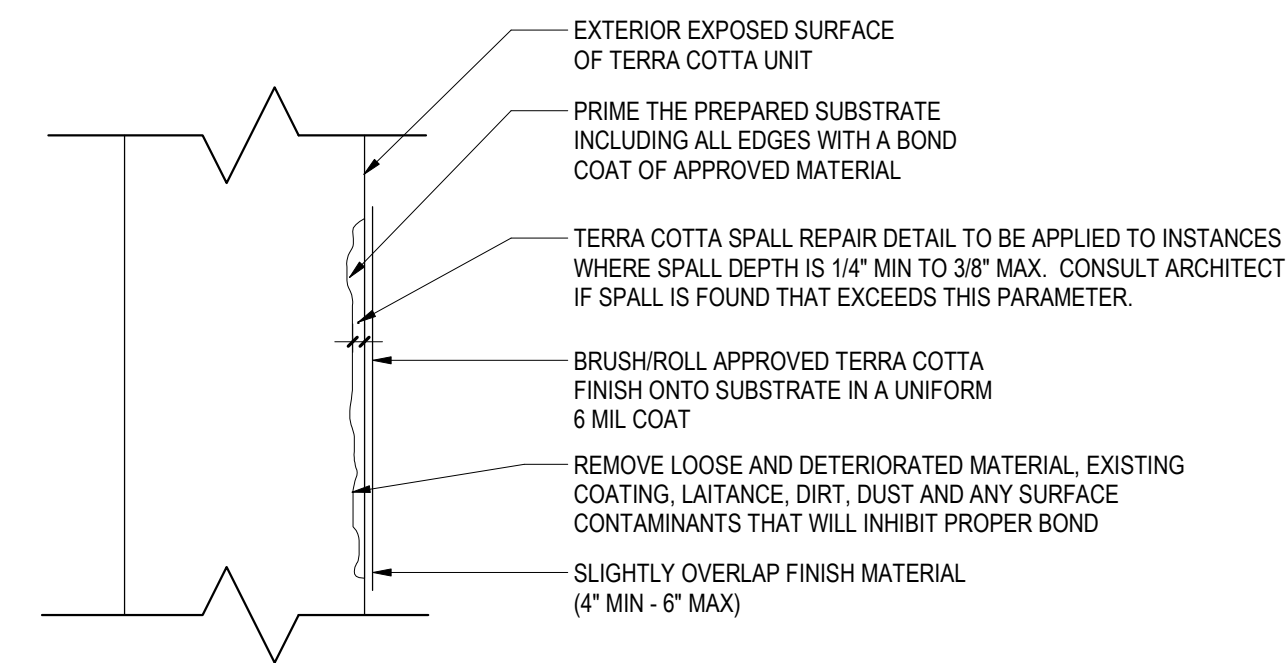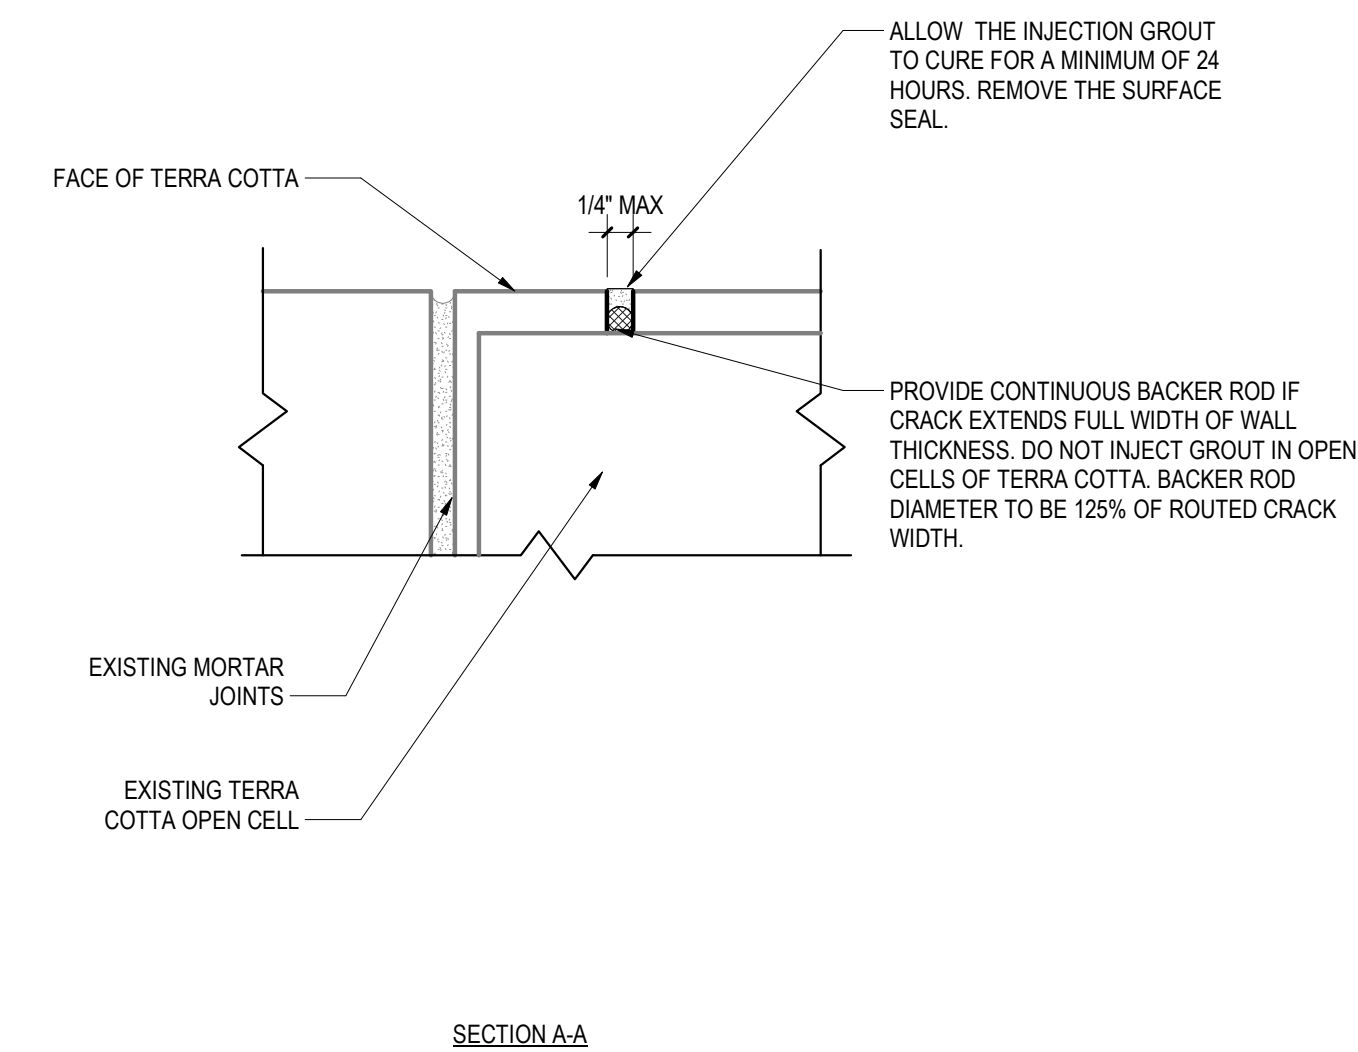

2 CORNICE DETAIL TYPICAL - GLAZE SPALLS
A8.1 6" = 1'-0"

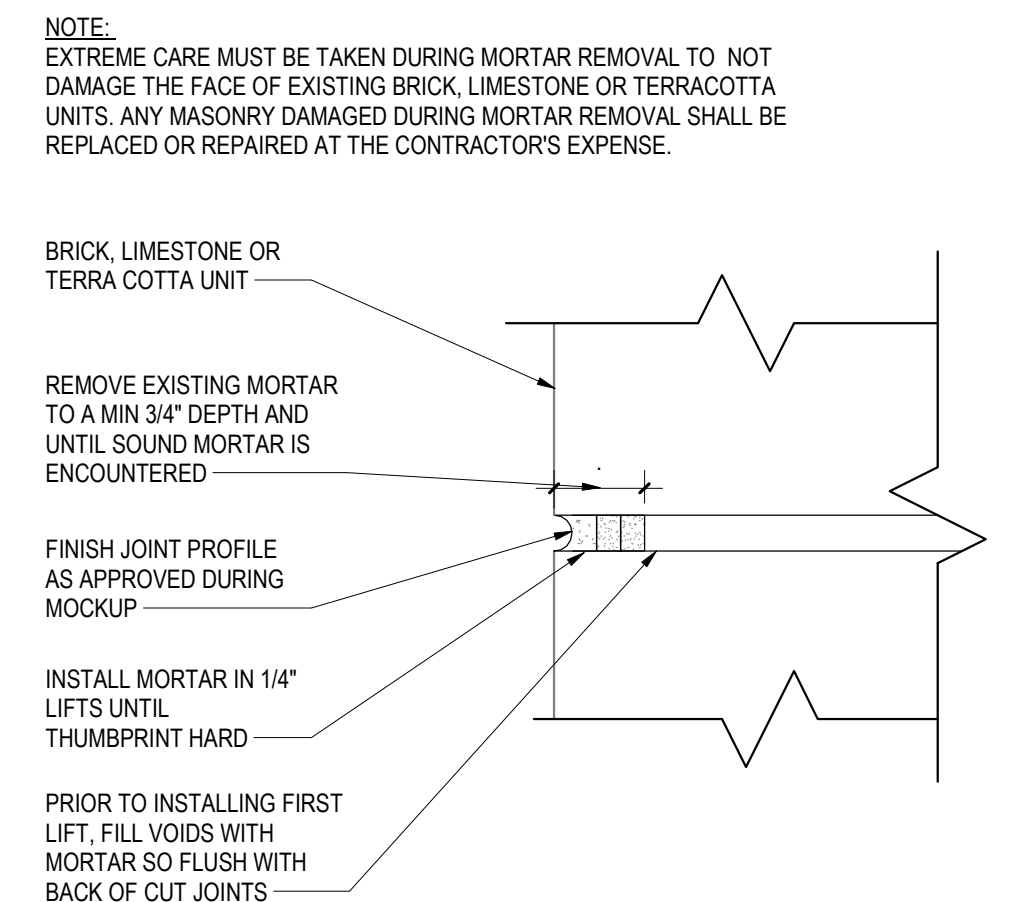

1 CORNICE DETAIL - TYPICAL REPOINTING
A8.1 6" = 1'-0"

Seal:

No.	Date	Revision

By: JH Checked: JPH Scale: AS NOTED
Date: 04/15/2024

Drawing Title:
CORNICE DETAILS

Drawing No.:
A8.1



PROVIDE PROTECTION TO ALLOW FOR CONTINUED OPERATION OF CIRCULATION DESK AREA DURING CONSTRUCTION ACTIVITIES

ALTERNATE 1 (ADD):
 REPAIR AND RESTORE EXISTING PLASTER AND LATH CEILING (ASSUMED) AT DOME INTERIOR.
 REPAINT INTERIOR DOME SURFACE. PAINTING SHALL INCLUDE ALL SURFACES AND ELEMENTS ABOVE THE CORNICE LINE



1 DOME INTERIOR PHOTOS
 A10.0 NTS

Seal:

No.	Date	Revision

By: JH Checked: JSH Scale: AS NOTED
 Date: 04/15/2024

Drawing Title:
 DOME INTERIOR PHOTOS

Drawing No.:
 A10.0

GENERAL STRUCTURAL NOTES

1. THIS PROJECT HAS BEEN DESIGNED USING THE 2018 INTERNATIONAL BUILDING CODE (IBC), AND APPLICABLE LOCAL REGULATIONS.
2. NOTIFY THE ENGINEER IMMEDIATELY IF ANY EXISTING CONDITIONS CONFLICT WITH STRUCTURAL INFORMATION SHOWN IN THE CONSTRUCTION DOCUMENTS.
3. THE STRUCTURAL ENGINEER IS NOT RESPONSIBLE FOR WORK THAT SHE DOES NOT REVIEW AND/OR WORK NOT COMPLETED IN ACCORDANCE WITH STRUCTURAL ENGINEER'S PLANS AND/OR SPECIFICATIONS.
4. IN CASE OF CONFLICT BETWEEN THE GENERAL NOTES, DETAILS AND SPECIFICATIONS, THE CONTRACTOR SHALL SUBMIT A REQUEST FOR CLARIFICATION.
5. STRUCTURAL SPECIAL INSPECTIONS ARE A REQUIREMENT FOR THIS PROJECT. A QUALIFIED INDEPENDENT INSPECTION AGENCY REGISTERED WITH THE CITY OF PHILADELPHIA SHALL BE SELECTED BY THE OWNER TO PERFORM THESE SERVICES. SPECIAL INSPECTIONS SHALL BE PERFORMED FOR THIS PROJECT AS FOLLOWS, AND IN ACCORDANCE WITH PROJECT SPECIFICATIONS:
STRUCTURAL STEEL (AISC 360) VISUAL INSPECTION OF FIELD CONNECTIONS PERIODIC POST-INSTALLED ANCHOR INSTALLATION HORIZONTAL & OVERHEAD INSTALLATION/CONTINUOUS
6. THE SPECIAL INSPECTIONS AGENCY SHALL PERFORM INSPECTIONS AND SUBMIT REPORTS THE ENGINEER OF RECORD (EOR) WITHIN 72 HOURS OF INSPECTION. ANY INADEQUACIES FOUND BY THE INSPECTOR SHALL BE REPORTED TO THE EOR WITHIN 24 HOURS. THE CONTRACTOR SHALL FACILITATE THESE INSPECTIONS BY SCHEDULING THE INSPECTIONS TO COORDINATE WITH THE WORK BEING PERFORMED BY THEIR SUB-CONTRACTORS.

POST-INSTALLED ANCHORS IN MASONRY

1. WHEN INSTALLING POST INSTALLED ADHESIVE ANCHORS, THE CONTRACTOR SHALL TAKE MEASURES TO AVOID DAMAGING EXISTING MASONRY. INSTALLER SHALL BE TRAINED BY MANUFACTURER ON INSTALLATION PROCEDURES, CLEAN HOLE FREE OF DUST, DEBRIS, AND MOISTURE. USE COMPRESSED AIR AND WIRE BRUSH, IN ACCORDANCE WITH MANUFACTURERS PROCEDURES. VERIFY THAT ADHESIVES TO BE USED, ARE WITHIN EXPIRATION DATE. PROVIDE HILTI OR APPROVED ALTERNATIVE.

STEEL

1. ALL STRUCTURAL STEEL WORK SHALL CONFORM TO THE FOLLOWING GOVERNING STANDARDS:
A. AISC "SPECIFICATION FOR STRUCTURAL STEEL BUILDINGS," CURRENT EDITION.
B. THE AMERICAN WELDING SOCIETY (AWS D1.1) "CODE FOR WELDING IN BUILDING CONSTRUCTION," CURRENT EDITION.
2. INSTALLER QUALIFICATIONS: ENGAGE AN EXPERIENCED INSTALLER WHO HAS COMPLETED STRUCTURAL STEEL WORK SIMILAR IN MATERIAL, DESIGN, AND EXTENT TO THAT INDICATED FOR THIS PROJECT AND WITH A RECORD OF SUCCESSFUL IN-SERVICE PERFORMANCE.
3. FABRICATOR QUALIFICATIONS: ENGAGE A FIRM EXPERIENCED IN FABRICATING STRUCTURAL STEEL SIMILAR TO THAT INDICATED FOR THIS PROJECT AND WITH A RECORD OF SUCCESSFUL IN-SERVICE PERFORMANCE, AS WELL AS SUFFICIENT PRODUCTION CAPACITY TO FABRICATE STRUCTURAL STEEL WITHOUT DELAYING THE WORK.
4. ALL STRUCTURAL STEEL SHALL CONFORM TO THE FOLLOWING ASTM SPECIFICATIONS:
A. PLATES AND ANGLES: ASTM A36, Fy=36 KSI.
B. W, WT & C SHAPES: ASTM A992, Fy=50 KSI.
C. STEEL PIPE SHALL CONFORM TO ASTM A53 TYPE E GRADE B, [STD. = SCHEDULE 40]
D. BOLTED CONNECTIONS (STEEL TO STEEL): ASTM A325-N, (3/4" DIAM.), U.N.O.
E. ANCHOR BOLTS AND CONNECTORS IN WOOD FRAMING: ASTM A307, (3/4" DIAM.), U.N.O.
5. ANCHORAGE BOLTS AND FITTINGS IN MASONRY SHALL BE GALVANIZED.
6. WELDING SHALL BE PERFORMED BY WELDERS CERTIFIED BY THE A.W.S. SUBMIT WELDER CERTIFICATES TO ENGINEER FOR RECORD.
7. WELDING ELECTRODES SHALL BE ASTM A233, CLASS E70XX. ALL WELDING SHALL CONFORM TO THE A.W.S. STANDARD CODE.
8. ALL SHOP AND FIELD WELDS SHALL BE 3/16" FILLET WELDS MINIMUM, U.N.O.
9. SHOP PRIME ALL STEEL. TOUCH UP FIELD WELDS AND ANY DAMAGED AREAS OF PAINT WITH A ZINC RICH PAINT, IN FIELD AFTER WELDING.
10. MINIMUM CENTER-CENTER SPACING BETWEEN BOLTS SHALL BE 3", U.N.O. MINIMUM EDGE DISTANCE SHALL BE 1-1/4" FROM CENTER OF BOLTS TO EDGE OF STEEL.

REPAIR EXISTING STEEL

1. STEEL FRAMING FOR THE DOME ARMATURE IS TO BE INSPECTED BY THE EOR DURING CONSTRUCTION. CONTRACTOR SHALL DEMOLISH FINISHES AS NEEDED TO EXPOSE DAMAGED FRAMING.
2. EOR AND SPECIAL INSPECTIONS AGENCY REPRESENTATIVE SHALL ATTEND SITE MEETING TO ESTABLISH CRITERIA FOR IDENTIFYING A) EXISTING FRAMING MEMBERS TO BE REMOVED AND REPLACED; B) EXISTING FRAMING MEMBERS TO BE REINFORCED AND RE-USED; AND C) EXISTING FRAMING MEMBERS IN GOOD CONDITION TO REMAIN IN PLACE.
3. POWER-TOOL CLEAN EXISTING STEEL FRAMING TO SSPC-SP3 STANDARDS, IN PREPARATION FOR REPAIRS.
4. SPECIAL INSPECTIONS AGENCY SHALL SURVEY ALL STEEL FRAMING MEMBERS FOR MATERIAL PROFILE, AND REPORT FINDINGS.
5. ELECTRODES TO BE USED WELDING EXISTING STEEL, SHALL BE ASTM A233, CLASS E60XX. WELD PROCEDURES SHALL CONFORM TO THE A.W.S. D1.1 STANDARD PRE-CERTIFIED.

FRAMING LUMBER & SHEATHING

1. FRAMING LUMBER SHALL BE OF THE FOLLOWING MINIMUM STRENGTH FOR THE SPECIFIED USE, UNLESS OTHERWISE NOTED ON PLAN. ALL LUMBER SHALL BE GRADE-STAMPED BY A RECOGNIZED GRADING AGENCY AND SHALL BE SURFACED DRY. MOISTURE CONTENT NOT TO EXCEED 19%.


- DIMENSION LUMBER:**
GRADE NO.2 PRESSURE TREATED, MIXED SOUTHERN PINE OR EQUAL. PROVIDE LUMBER STAMPED KDAT (KILN-DRIED AFTER TREATMENT). ALTERNATIVELY, SEASON THE LUMBER FOR SEVERAL MONTHS AFTER TREATMENT, SO MOISTURE CONTENT MEETS EQUILIBRIUM CONDITIONS.
2. STRUCTURAL COMPOSITE LUMBER SHALL BE PRESERVATIVE TREATED, (WOLMANIZED) PARALLEL STRAND LUMBER, (PSL-PT) PSL 2900FB-2.0E
 3. STORE FRAMING AND SHEATHING MATERIALS IN DRY LOCATION. REMOVE STANDING WATER FROM INSTALLED SHEATHING. ENSURE INSTALLED LUMBER MOISTURE CONTENT IS 19% OR LESS, BEFORE INSTALLING HOLD DOWN ANCHORS, STRAPS, OR FINISHES THAT WOULD BE AFFECTED BY LUMBER SHRINKING OR EXPANDING.
 4. FASTENING SHALL CONFORM TO A MINIMUM AS SPECIFIED IN TABLE 2304.10.1 OF THE INTERNATIONAL BUILDING CODE.
 5. BUILT-UP MULTI-MEMBER WOOD GIRDERS SHALL HAVE MEMBER JOINTS STAGGERED SUCH THAT NOT MORE THAN (1) MEMBER SPICE OCCURS BETWEEN SUPPORT POINTS. ORIENT ADJACENT MEMBERS WITH ALTERNATE GRAINS, AND CONNECT MEMBERS WITH GALVANIZED NAILS: 10D (148") X 3" COMMON FOR (2) MEMBERS, 16D (162") X 3-1/2" COMMON FOR (3) MEMBERS, AND 20D (192") X 4" COMMON FOR (4) MEMBERS. NAIL AT TOP AND BOTTOM @ 24" O.C. STAGGER OPPOSITE FACES, AND WITHIN 1-1/2" OF MEMBER ENDS.
 6. PROVIDE CROSS BRIDGING AT MAXIMUM 8'-0" O.C. FOR ALL JOISTS. NO JOISTS SHALL BE CUT OR NOTCHED WITHOUT APPROVAL.
 7. ALL MEMBERS SHALL HAVE LATERAL SUPPORT SUPPLIED AT ALL BEARING POINTS AS WELL AS CONTINUOUSLY ALONG THE COMPRESSION FACE.
 8. PLYWOOD OR OSB SHEATHING SHALL BE APA GRADE STAMPED FOR SPECIFIC SPAN, SHALL BE MADE WITH EXTERIOR GLUE AND SHALL BE OF THE FOLLOWING THICKNESS:

- ROOF: 19/32" THICK, EXPOSURE 1, STRUCTURAL 1, SPAN RATING 40/20.
INDEX STAMP SHALL BE VISIBLE ON ALL SHEETS.
PROTECT SHEATHING FROM EXTENSIVE EXPOSURE TO WEATHER.
9. INSTALL PLYWOOD SHEATHING WITH FACE GRAIN PERPENDICULAR TO THE SUPPORTING MEMBERS, U.N.O.
 10. USE PLYCLIPS OR OTHER EDGE SUPPORT AS REQUIRED FOR ROOF SHEATHING.

11. PROVIDE STRUCTURAL WOOD TONGUE AND GROOVE DECKING TO MATCH EXISTING DECKING DEPTH. PROVIDE SYP GRADE #1 OR EQUAL. FASTEN TO SUPPORTING JOISTS WITH #10 SCREWS X 2" EMBED @ 8" O.C.
12. PRESERVATIVE TREATMENT: TREAT WOOD MEMBERS AND SHEATHING IN CONTACT WITH MASONRY OR CONCRETE, OR WITHIN 6" OF GROUND, (IRC-R317.1.5). TREAT IN ACCORDANCE WITH CURRENT STANDARDS OF AMERICAN WOOD PRESERVERS ASSOCIATION (AWPA) STANDARD.
USE CATEGORY 3B FOR EXPOSED EXTERIOR WOOD, NOT IN CONTACT WITH GROUND.
USE CATEGORY 4A FOR WOOD IN CONTACT WITH GROUND.
LUMBER AND SHEATHING SHALL BE VISIBLY STAMPED WITH AWPA USE CATEGORY STAMP.
13. CONTRACTOR SHALL VERIFY CORROSIVE COMPATIBILITY OF FASTENERS WITH ACO PRESERVATIVE
14. PROTECT ENDS AND TOPS OF FRAMING IN CONTACT WITH MOISTURE WITH SELF ADHERED FLASHING OR EQUAL.

STRUCTURAL DESIGN CRITERIA

GROUND SNOW LOAD	25 LBS/SQ FT
ROOF LIVE LOAD	20 LBS/ SQ FT
WIND LOADS	
WIND SPEED:	115 MPH, EXPOSURE B
WIND PRESSURE FOR COMPONENTS AND CLADDING DESIGN	20 LBS/SQ FT

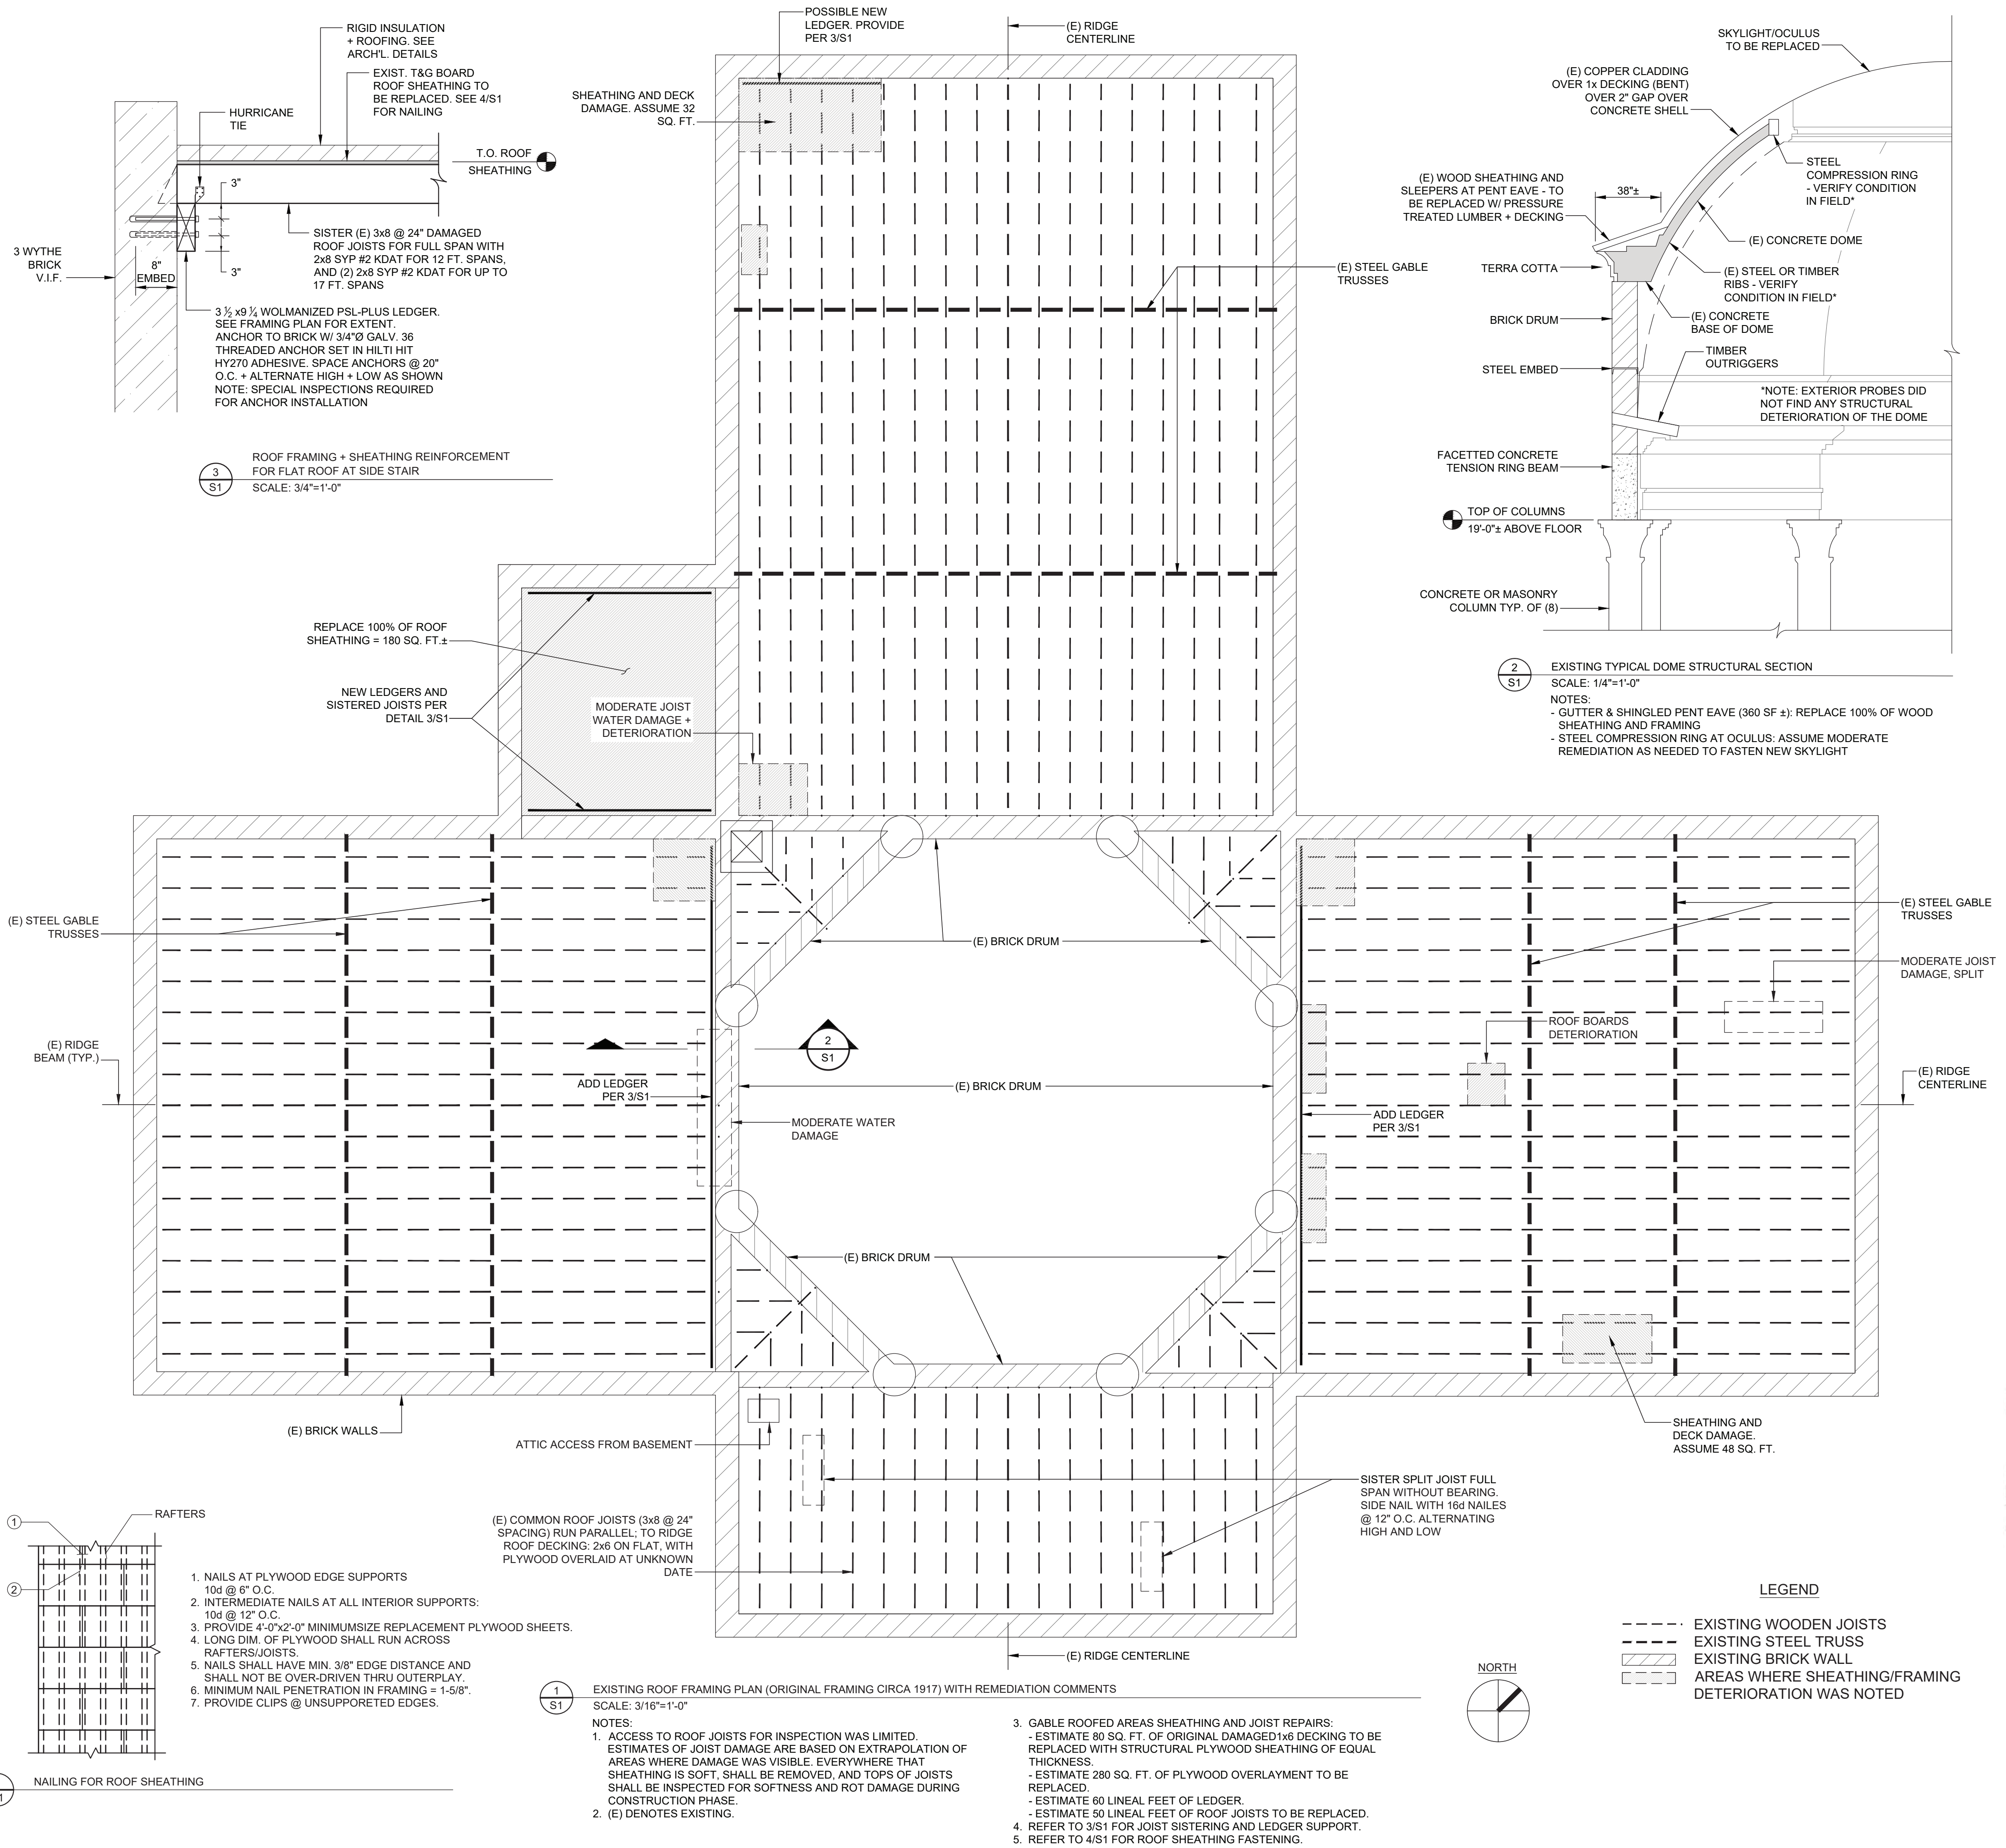

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No.	Date	Revision

By: SH Checked: AR Date: 04/15/2024
Scale: AS NOTED

Drawing Title:
ROOF FRAMING PLAN, SECTIONS AND NOTES

Drawing No.:
S1 OF 1
STRUCTURAL SHEET