## **GENERAL NOTES**

DESCRIBED HEREIN AND IN THE SPECIFICATIONS.

- THESE DRAWINGS DESCRIBE THE GENERAL REQUIREMENTS FOR THE INSTALLATION OF TELECOMMUNICATIONS STRUCTURED CABLING SYSTEM, PUBLIC ADDRESS SYSTEM, AND SECURITY SYSTEM WITHIN THE FACILITIES OF KINGSESSING LIBRARY & REC CENTER (KNG). THE PROJECT INCLUDES FURNISHING, INSTALLATION AND TESTING OF THE COMPONENTS FOR THE OUTSIDE PLANT STRUCTURED CABLING AS
- PRIOR TO ACCEPTANCE OF THE INSTALLATION, ALL SYSTEMS SHALL BE TESTED, AND OPERATED TO DEMONSTRATE TO THE OWNER. OR DESIGNATED REPRESENTATIVE. THAT THE INSTALLATION AND PERFORMANCE OF THESE SYSTEMS AND/OR PARTS THEREOF CONFORM TO THE DESIGN INTENT.
- CONTRACT DRAWINGS ARE DIAGRAMMATIC AND ARE INTENDED TO CONVEY SCOPE. DESIGN INTENT, AND GENERAL ARRANGEMENT ONLY. CONTRACTOR IS RESPONSIBLE FOR COORDINATING THE WORK OF ALL TRADES INCLUDING RESOLUTION OF FIELD CONFLICTS THAT MAY ARISE.
- CONTRACTOR SHALL BE RESPONSIBLE TO FIELD LOCATE AND IDENTIFY ALL EXISTING UTILITIES AND CONDITIONS IN THE CONSTRUCTION AREA, WHETHER INDICATED ON DRAWINGS OR NOT. THE CONTRACTOR SHALL BE RESPONSIBLE FOR REPAIRS TO EXISTING UTILITIES, CABLES AND/OR FACILITIES DAMAGED DURING CONSTRUCTION. NO REIMBURSEMENT WILL BE ALLOWED FOR REPAIR AND/OR REPLACEMENT OF DAMAGED FACILITIES/UTILITIES.
- THE CONTRACTOR IS RESPONSIBLE FOR THE MAINTENANCE AND PROTECTION OF UNDERGROUND UTILITIES WHICH PASS THROUGH THE CONSTRUCTION AREA BUT ARE NOT PART OF THE CONSTRUCTION SCOPE OF WORK. THE CONTRACTOR SHALL ENSURE THESE CABLES ARE PROTECTED AND THE SYSTEMS STAY FUNCTIONAL TO WHICH THEY ARE CONNECTED.
- THE INTEGRATION OF EXISTING SYSTEMS IS WORK OF A COMPLEX NATURE WHICH WILL REQUIRE ACCURATE PLANNING, CAREFUL PREPARATION AND EXECUTION, ATTENTION TO DETAIL AND CLOSE SUPERVISION BY THE CONTRACTOR. THE CONTRACTOR SHALL BE REQUIRED TO DO THIS WORK IN FULL COOPERATION WITH ALL SYSTEM INTEGRATORS AND SUBJECT TO SCHEDULING ARRANGED TO MINIMIZE DISRUPTION OF NORMAL ACTIVITIES OF THE REST OF THE AIRPORT. PHASING OF ALL WORK SHALL BE DONE IN COORDINATION WITH THE CONSTRUCTION PHASING PLAN OR AS INSTRUCTED BY THE CM.
- ALL CABLING, VAULTS, DEVICES AND BOXES INSTALLED SHALL BE TAGGED AND/OR MARKED AS IN ACCORDANCE WITH THE DRAWINGS AND SPECIFICATIONS.
- WHERE UTILITIES, SYSTEMS, SWITCHES, PANELS, POWER SUPPLIES, ROUTERS AND/OR SERVICES REQUIRE SHUTDOWN, IN THE MAIN TERMINAL, FOR THE WORK TO BE PERFORMED, NOTIFY THE CM AND OWNER. REQUESTS FOR SYSTEMS SHUTDOWNS SHALL BE SUBMITTED TO THE OWNER, IN WRITING, A MIN. OF 1 WEEK PRIOR TO THE SCHEDULED SHUTDOWN. THE REQUEST MUST INCLUDE ALL SYSTEMS TO BE AFFECTED AND THE EXPECTED DISRUPTION DURATIONS.
- ALL MATERIALS SHALL COMPLY WITH APPLICABLE CODES, ORDINANCES AND REGULATIONS AND APPLICABLE CONTRACT SPECIFICATIONS.
- PROVIDE ALL LABOR, MATERIAL, EQUIPMENT, INCIDENTALS, METHODS AND SERVICES
- REQUIRED TO INSTALL ALL WORK INDICATED COMPLETELY AND IN FULL OPERATION. 11. ALL WORK SHALL BE IN CONFORMANCE WITH THE LATEST AND ALL APPLICABLE LAWS, TIA CODES, AND REGULATIONS ADOPTED BY MUNICIPAL, COUNTY, STATE, FEDERAL AUTHORITIES, UTILITY COMPANIES, INSURANCE AGENCIES AND OTHER AUTHORITIES HAVING JURISDICTION OVER THE WORK, INCLUDING CURRENT ENVIRONMENTAL REGULATIONS, AND SHALL COMPLY WITH THE APPLICABLE LOCAL ELECTRICAL CODES, LATEST ADOPTED EDITION OF THE NEC AND ANY APPLICABLE INDUSTRIAL CODES: NECA, NEC, NESC, NFPA, IEEE, ANSI/TIA, NORTH CAROLINA AND LOCAL CODES.
- 12. THE CONTRACTOR SHALL GUARANTEE THE ENTIRE INSTALLATION FOR A PERIOD OF ONE YEAR (OR AS CONTRACTUALLY OBLIGATED) FROM THE DATE OF ACCEPTANCE OF THE SYSTEM(S) AS A WHOLE. ANY DEFECTS IN WORKMANSHIP, MATERIALS. MALFUNCTION OF EQUIPMENT OR UNSATISFACTORY PERFORMANCE, AND ALL OTHER WORK OR PARTS OF THE BUILDING DAMAGED THEREBY, AS A RESULT OF WORK OF THE PROJECT BY THE CONTRACTOR, SHALL BE THE RESPONSIBILITY OF THE CONTRACTOR. CONTRACTOR SHALL PAY ALL REPAIR COSTS ACCORDINGLY WITHOUT ADDITIONAL COSTS TO THE OWNER.
- UNLESS OTHERWISE NOTED, ALL PARTS, EQUIPMENT, AND MATERIALS SHALL BE NEW AND SHALL BE SAME AND/OR UL APPROVED.
- CONTRACTOR SHALL BE RESPONSIBLE FOR FURNISHING AND INSTALLING CABLING. CONTRACTOR SHALL ALSO BE RESPONSIBLE FOR FURNISHING AND INSTALLING CONDUIT FROM ALL EQUIPMENT DEVICE LOCATIONS TO DESIGNATED TERMINATION ROOMS. ALL NEW CABLING SHALL BE INSTALLED IN CONDUIT UNLESS OTHERWISE
- ALL OSP CABLING SHALL BE INSTALLED IN CONCRETE ENCASED SCHEDULE 40 PVC OR RGS CONDUIT AS INDICATED IN DRAWINGS AND SPECS AND IN FABRIC INNERDUCT. ALL VERTICAL ELBOWS AND TRANSITIONS FROM UNDERGROUND TO ABOVE GROUND SHALL BE RGS. ALL SPARE CONDUITS SHALL CONTAIN FABRIC INTERDUCT AND/OR A PULL STRING AS INDICATED. PRIMARY AND SECONDARY BACKBONE CABLING SHALL NOT SHARE A PHYSICAL PATHWAY.
- CONTRACTOR SHALL PROVIDE FINAL CONNECTIONS TO OWNER PROVIDED EQUIPMENT AS INDICATED ON THE PLANS.
- INSTALLATION OF CATEGORY 6A CABLE SHALL BE IN ACCORDANCE WITH TIA GUIDELINES. CABLE INSTALLATION AND TERMINATIONS THAT DO NOT COMPLY SHALL BE REPLACED BY THE CONTRACTOR AT NO ADDITIONAL COST TO THE OWNER. THE MAXIMUM PULLING TENSION FOR A SINGLE CABLE SHALL NOT EXCEED 25
- THE MINIMUM BENDING RADIUS OF THE CABLE SHALL NOT BE LESS THAN 4X THE OUTSIDE DIAMETER OF THE CABLE. THE CABLE SHALL BE INSTALLED WITHOUT KINKS OR TWISTS AND THE APPLICATION OF CABLE TIES SHALL NOT DEFORM THE CABLE BUNDLE. CONDUITS SHALL TRANSITION INTO CABLE TRAYS USING CONDUIT END BELLS,
- NO CABLE SHALL BE INSTALLED OVER ROUGH CONDUIT EDGES IN ANY STRIP BACK ONLY AS MUCH CABLE JACKET AS IS REQUIRED TO TERMINATE THE CABLE. CABLE PAIRS SHALL NOT BE UNTWISTED MORE THAN 1/2 INCH. CABLES SHALL BE TESTED PER THE SPECIFICATIONS, CABLES WHICH DO NOT

PASS TESTS SHALL BE REPLACED, OR RECTIFIED BY THE CONTRACTOR AT NO

THAN 1 INCH UNDER NO-LOAD CONDITIONS. WHEN UNDER A MAXIMUM TENSILE

- THE CONTRACTOR SHALL NOT INSTALL ANY NEW CATEGORY 6A OR HIGHER DATA CABLE AT LENGTHS GREATER THAN 90 METERS FROM PATCH PANEL TO OUTLET BOX. THE CONTRACTOR SHALL BRING ANY CONDITIONS EXCEEDING THE CABLE LIMIT
- DISTANCE TO THE ENGINEERS ATTENTION. INSTALLATION OF FIBER OPTIC CABLES SHALL BE IN ACCORDANCE WITH TIA GUIDELINES. CABLE INSTALLATION AND TERMINATIONS THAT DO NOT COMPLY SHALL BE REPLACED BY THE CONTRACTOR AT NO ADDITIONAL COST TO THE OWNER. THE BEND RADIUS FOR HORIZONTAL OPTICAL FIBER CABLE SHALL NOT BE LESS
  - LOAD OF 50 LBF, THE BEND RADIUS SHALL NOT BE LESS THAN 2 INCHES. THE BEND RADIUS FOR FIBER BACKBONE SHALL NOT BE LESS THAN THAT RECOMMENDED BY THE MANUFACTURER IF NO RECOMMENDATION IS KNOWN, THEN THE APPLIED BEND RADIUS SHALL NOT BE LESS THAN 12 TIMES THE CABLE OUTSIDE DIAMETER UNDER NO-LOAD CONDITIONS AND NOT LESS THAN 15 TIMES THE CABLE OUTSIDE DIAMETER WHEN THE CABLE IS UNDER TENSILE
  - THE BEND RADIUS FOR OUTSIDE PLANT OPTICAL FIBER BACKBONE CABLE SHALL NOT BE LESS THAN THAT RECOMMENDED BY THE MANUFACTURER IF NO RECOMMENDATION IS KNOWN, THEN THE APPLIED BEND RADIUS SHALL NOT BE LESS THAN 10 TIMES THE CABLE OUTSIDE DIAMETER NO-LOAD CONDITIONS AND NOT LESS THAN 20 TIMES THE CABLE OUTSIDE DIAMETER WHEN THE
- 20. ALL OUTSIDE PLANT COPPER CABLES SHALL INCLUDE A MINIMUM OF TWO SERVICE LOOPS IN ALL VAULTS, MANHOLES, HANDHOLES OR JUNCTION BOXES EQUIVALENT TO TWO PERIMETERS OF THE STRUCTURE THE CABLE IS PASSING THROUGH. UNLESS OTHERWISE SPECIFIED.
- CONTRACTOR TO COORDINATE ALL UNDERGROUND UTILITY ROUTINGS. KEEP A MINIMUM OF 6-IN CLEAR FROM ALL FOUNDATIONS IN PLAN

CABLE IS UNDER A TENSILE LOAD.

CONTRACTOR TO COORDINATE UNDERGROUND UTILITY TO BE A MINIMUM OF 3" CLEAR BELOW THE BASE OF THE GRADE BEAMS WHEN PASSING BENEATH

# **ABBREVIATIONS:**

ACS

OFCI

SOC

ALTERNATE CURRENT ACCESS CONTROL PANEL ACCESS CONTROL SYSTEM ABOVE FINISHED GRADE AMPLIFIER AMERICAN WIRE GAUGE BELOW FINISH CEILING BAGGAGE HANDLING SYSTEM CONDUIT CONTRACTOR FURNISHED CONTRACTOR INSTALLED CENTER LINE CLEAR CONSTRUCTION MANAGER PLENUM CABLE RISER CABLE CABLE TRAY COMMUNICATIONS VAULT

DISTRIBUTED ANTENNA SYSTEM DIRECT CURRENT ELECTRICAL METALLIC TUBING FREE LIBRARY OF PHILADELPHIA FIBER OPTIC CABLE FIBER OPTIC PATCH PANEL GENERAL CONTRACTOR GROUND TRANSPORTATION HORIZONTAL(LY) IDENTIFICATION INSULATION DISPLACEMENT CONTACT INTERMEDIATE DISTRIBUTION FRAME INSIDE PLANT CABLE INFORMATION TECHNOLOGY JUNCTION BOX LOCAL AREA NETWORK

MAXIMUM MAIN DISTRIBUTION FRAME MINIMUM NOT TO SCALE NATIONAL ELECTRIC CODE OWNER FURNISHED OWNER INSTALLED OUTSIDE PLANT CABLE PASSENGER BOARDING BRIDGE PASSENGER GATE RIGID GALVANIZED STEEL SYSTEM ON CHIP STRUCTURED CABLING SYSTEM SINGLE MODE FIBER OPTIC CABLE SHIELDED TWISTED PAIR SUSPENDED

TERMINAL TO BE DETERMINED TELECOM TELECOMMUNICATIONS TELECOMMUNICATIONS GROUNDING TELECOMMUNICATIONS INDUSTRY ASSOCIATION TELECOMMUNCIATION OUTLET TELECOMMUNICATIONS ROOM TYPICAL UNDERGROUND UNLESS OTHERWISE NOTED

VEHICLE GATE

WALL FIELD

OUTLET: TYPES & CABLING				
SYMBOL	DESCRIPTION			
TAG#	DATA OUTLET # DENOTES THE NUMBER OF CABLES. IF BLANK, OUTLET IS FOR FUTURE FLEXIBILITY AND NUMBER OF CABLES IS ZERO.			
	POWER/DATA FLOOR BOX  REFER TO ELECTRICAL DRAWINGS FOR FLOOR BOX DETAILS.			

#### OUTLET: MOUNTING LEGEND

OUTLET. MOUNTING LEGEND					
SYMBOL	DESCRIPTION				
▼ ▽ ▼	WALL MOUNTED OUTLET  PROVIDE A 4-11/16"W x 4-11/16"H x 2½"DEEP DOUBLE GANG BACK BOX, DOUBLE GANG PLASTER RING. ALL CABLING TO OUTLET MUST BE IN CONDUIT OR CABLE TRAY.				
	CEILING MOUNTED OUTLET  PROVIDE A 4-11/16"W x 4-11/16"H x 2½"DEEP DOUBLE GANG BACK BOX, DOUBLE GANG PLASTER RING ALL CABLING TO OUTLET MUST BE IN CONDUIT OR CABLE TRAY. OUTLET SHALL BE MOUNTED ON UNDERSIDE OF				

# OUTLET: SYSTEM ID LEGEND

ID (X)	DESCRIPTION		
(NONE)	STANDARD DATA OUTLET PROVIDE 4-PAIR UTP CATEGORY 6A CABLES X = DENOTES CABLE QTY.		
WIRELESS ACCESS POINT (OWNER PROVIDED) PROVIDE (1) 4-PAIR UTP CATEGORY 6A CABLES, UON. MOUNTING REQUIREMENTS: - CEILING: ON NEAREST STRUCTURAL ELEMENT ABOVE ACCESSIBLE CEILINGS - WALL: AT 1' 0" BFC TYPICAL BUT NOT MORE THAN 10' 0" AFF.			
CCTV	CLOSED-CIRCUIT TELEVISION REFER TO SECURITY DRAWINGS FOR LOCATIONS, QUANTITIES AND MOUNTING DETAILS. PROVIDE (1) 4-PAIR UTP CATEGORY 6 CABLE, UON. MOUNTING REQUIREMENTS: - CEILING: ON NEAREST STRUCTURAL ELEMENT ABOVE ACCESSIBLE CEILINGS - WALL: AT 1' 0" BFC TYPICAL BUT NOT MORE THAN 10' 0" AFF.		

## PATHWAYS & MISCELLANEOUS

SYMBOL	DESCRIPTION					
DETAIL REFERENCE: # = DETAIL NUMBER; TXXX = DRAWING NUMBER						
	LADDER STYLE CABLE TRAY					
9	CONDUIT OR SLEEVE GOING UP					
CONDUIT OR SLEEVE GOING DOWN						
CONDUIT GOING THROUGH						
	TELECOM SPACES/ROOM OUTLINE					
	PULL BOX LL = LOWER LEVEL FF = FIRST FLOOR					
СВ	ELEVATOR CALL BOX					
_	INTERCOM MASTER MONITOR STATION					
XX WP	PROVIDE 4X4 EXTERIOR WEATHERPROOF JUNCTION BOX. XX DEFINES SYSTEM. PROVIDE RJ-45 CONNECTOR ON END OF CABLE AND PROVIDE MIN 36" OF SLACK.					

# **AV SYMBOLS**

SYMBOL

SYMBOL	DESCRIPTION
0	WALL MOUNTEDAV SPEAKER, SPEAKERS WILL BE CONNTECTED IN SERIES WITH MIN 18/2 SHIELDED CABLE IN FMC WITH ONE 18/2 CABLE HOMERUN TO AMPLIFIER IN MIN 3/4" CONDUIT

# **SECURITY SYMBOLS**

DESCRIPTION

**REVISIONS** 

**DESCRIPTION** 

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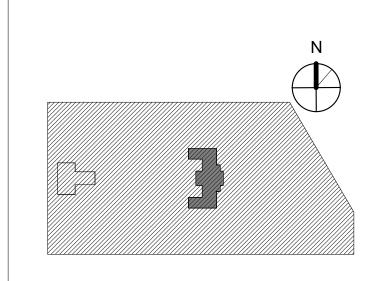




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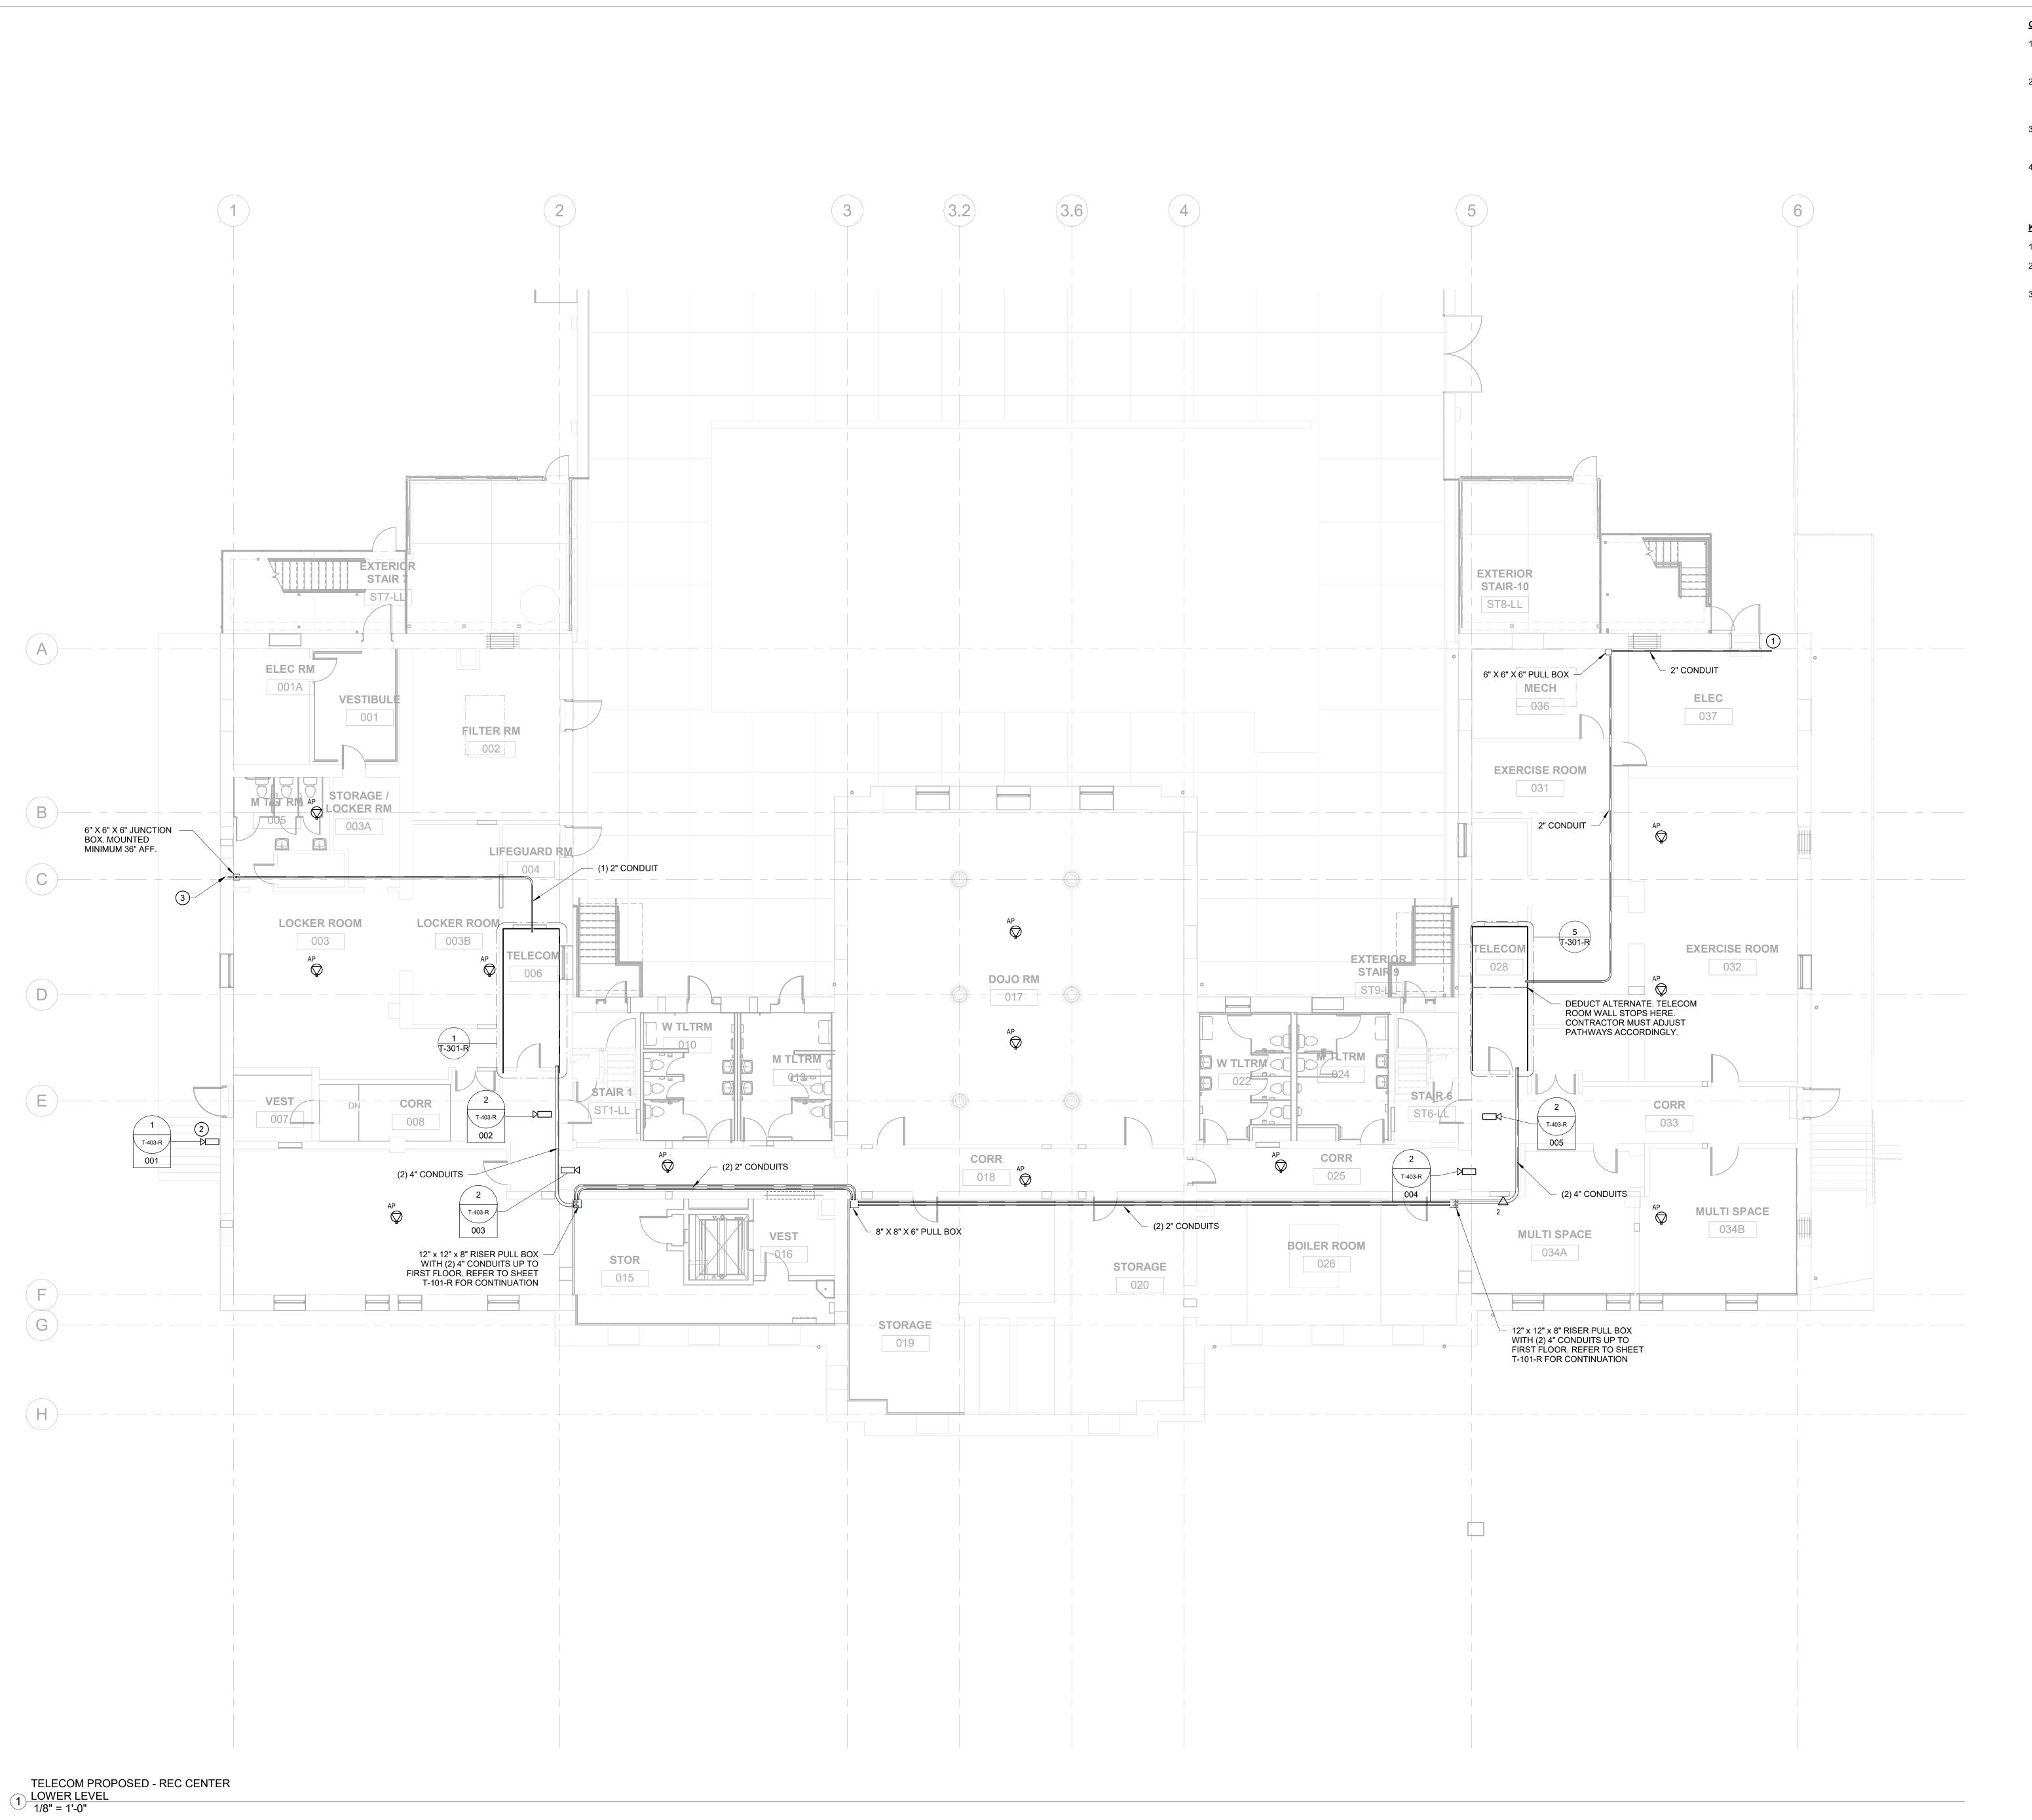
KEY PLAN



TELECOM GENERAL NOTES. ABBREVIATIONS & SYMBOLS

T-001-R 08/28/23

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#### **GENERAL NOTES:**

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- 2. CONTRACTOR MUST PROTECT AND PRESERVE THE HISTORIC ELEMENTS AND STRUCTURES WHEN
- ARCHITECT PLANS FOR ADDITIONAL DETAILS.

  3. PROVIDE SURFACE MOUNTED RACEWAYS FOR BRANCH CONNECTIONS. ACCECPTABLE RACEWAYS ARE SERIES 4000 WIREMOLD OR CONDUIT.

INSTALLING NEW PATHWAYS AND DEVICES. REFER TO

4. AV SYSTEM EQUIPMENT FURNISHED AND INSTALLED BY OWNER

#### KEYED NOTES: #

- 1. EXISTING COMMUNICATIONS DEMARC.
- 2. EXTERIOR CAMERA. PROVIDE EXTERIOR HOUSING FOR
- 3. SEE 1/T-104-R FOR CONTINUATION.



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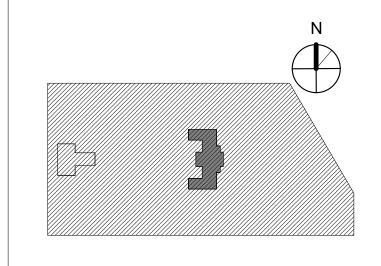
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DRAWING TITLE

TELECOM PROPOSED -LOWER LEVEL

PROJECT NO. 21070


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  - ARCHITECT PLANS FOR ADDITIONAL DETAILS. PROVIDE SURFACE MOUNTED RACEWAYS FOR BRANCH CONNECTIONS. ACCECPTABLE RACEWAYS ARE SERIES 4000 WIREMOLD OR CONDUIT.
- 4. AV SYSTEM EQUIPMENT FURNISHED AND INSTALLED BY
- CONTRACTOR TO INSTALL WALL MOUNTED DEVICES ABOVE CROWN MOLDING.

CAMERA.

- 1. EXTERIOR CAMERA. PROVIDE EXTERIOR HOUSING FOR
- NEW CONTRACTOR FURNISHED CONTRACTOR INSTALLED VIDEO MONITORING WORKSTATION.
- 3. EXISTING SECURITY WORKSTATION TO BE DEMOLISHED.
- EXISTING SECURITY CABINET TO BE DEMOLISHED. CONTRACTOR REMOVE EXISTING SECURITY EQUIPMENT AND RETURN TO OWNER.



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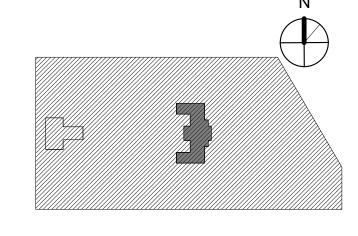
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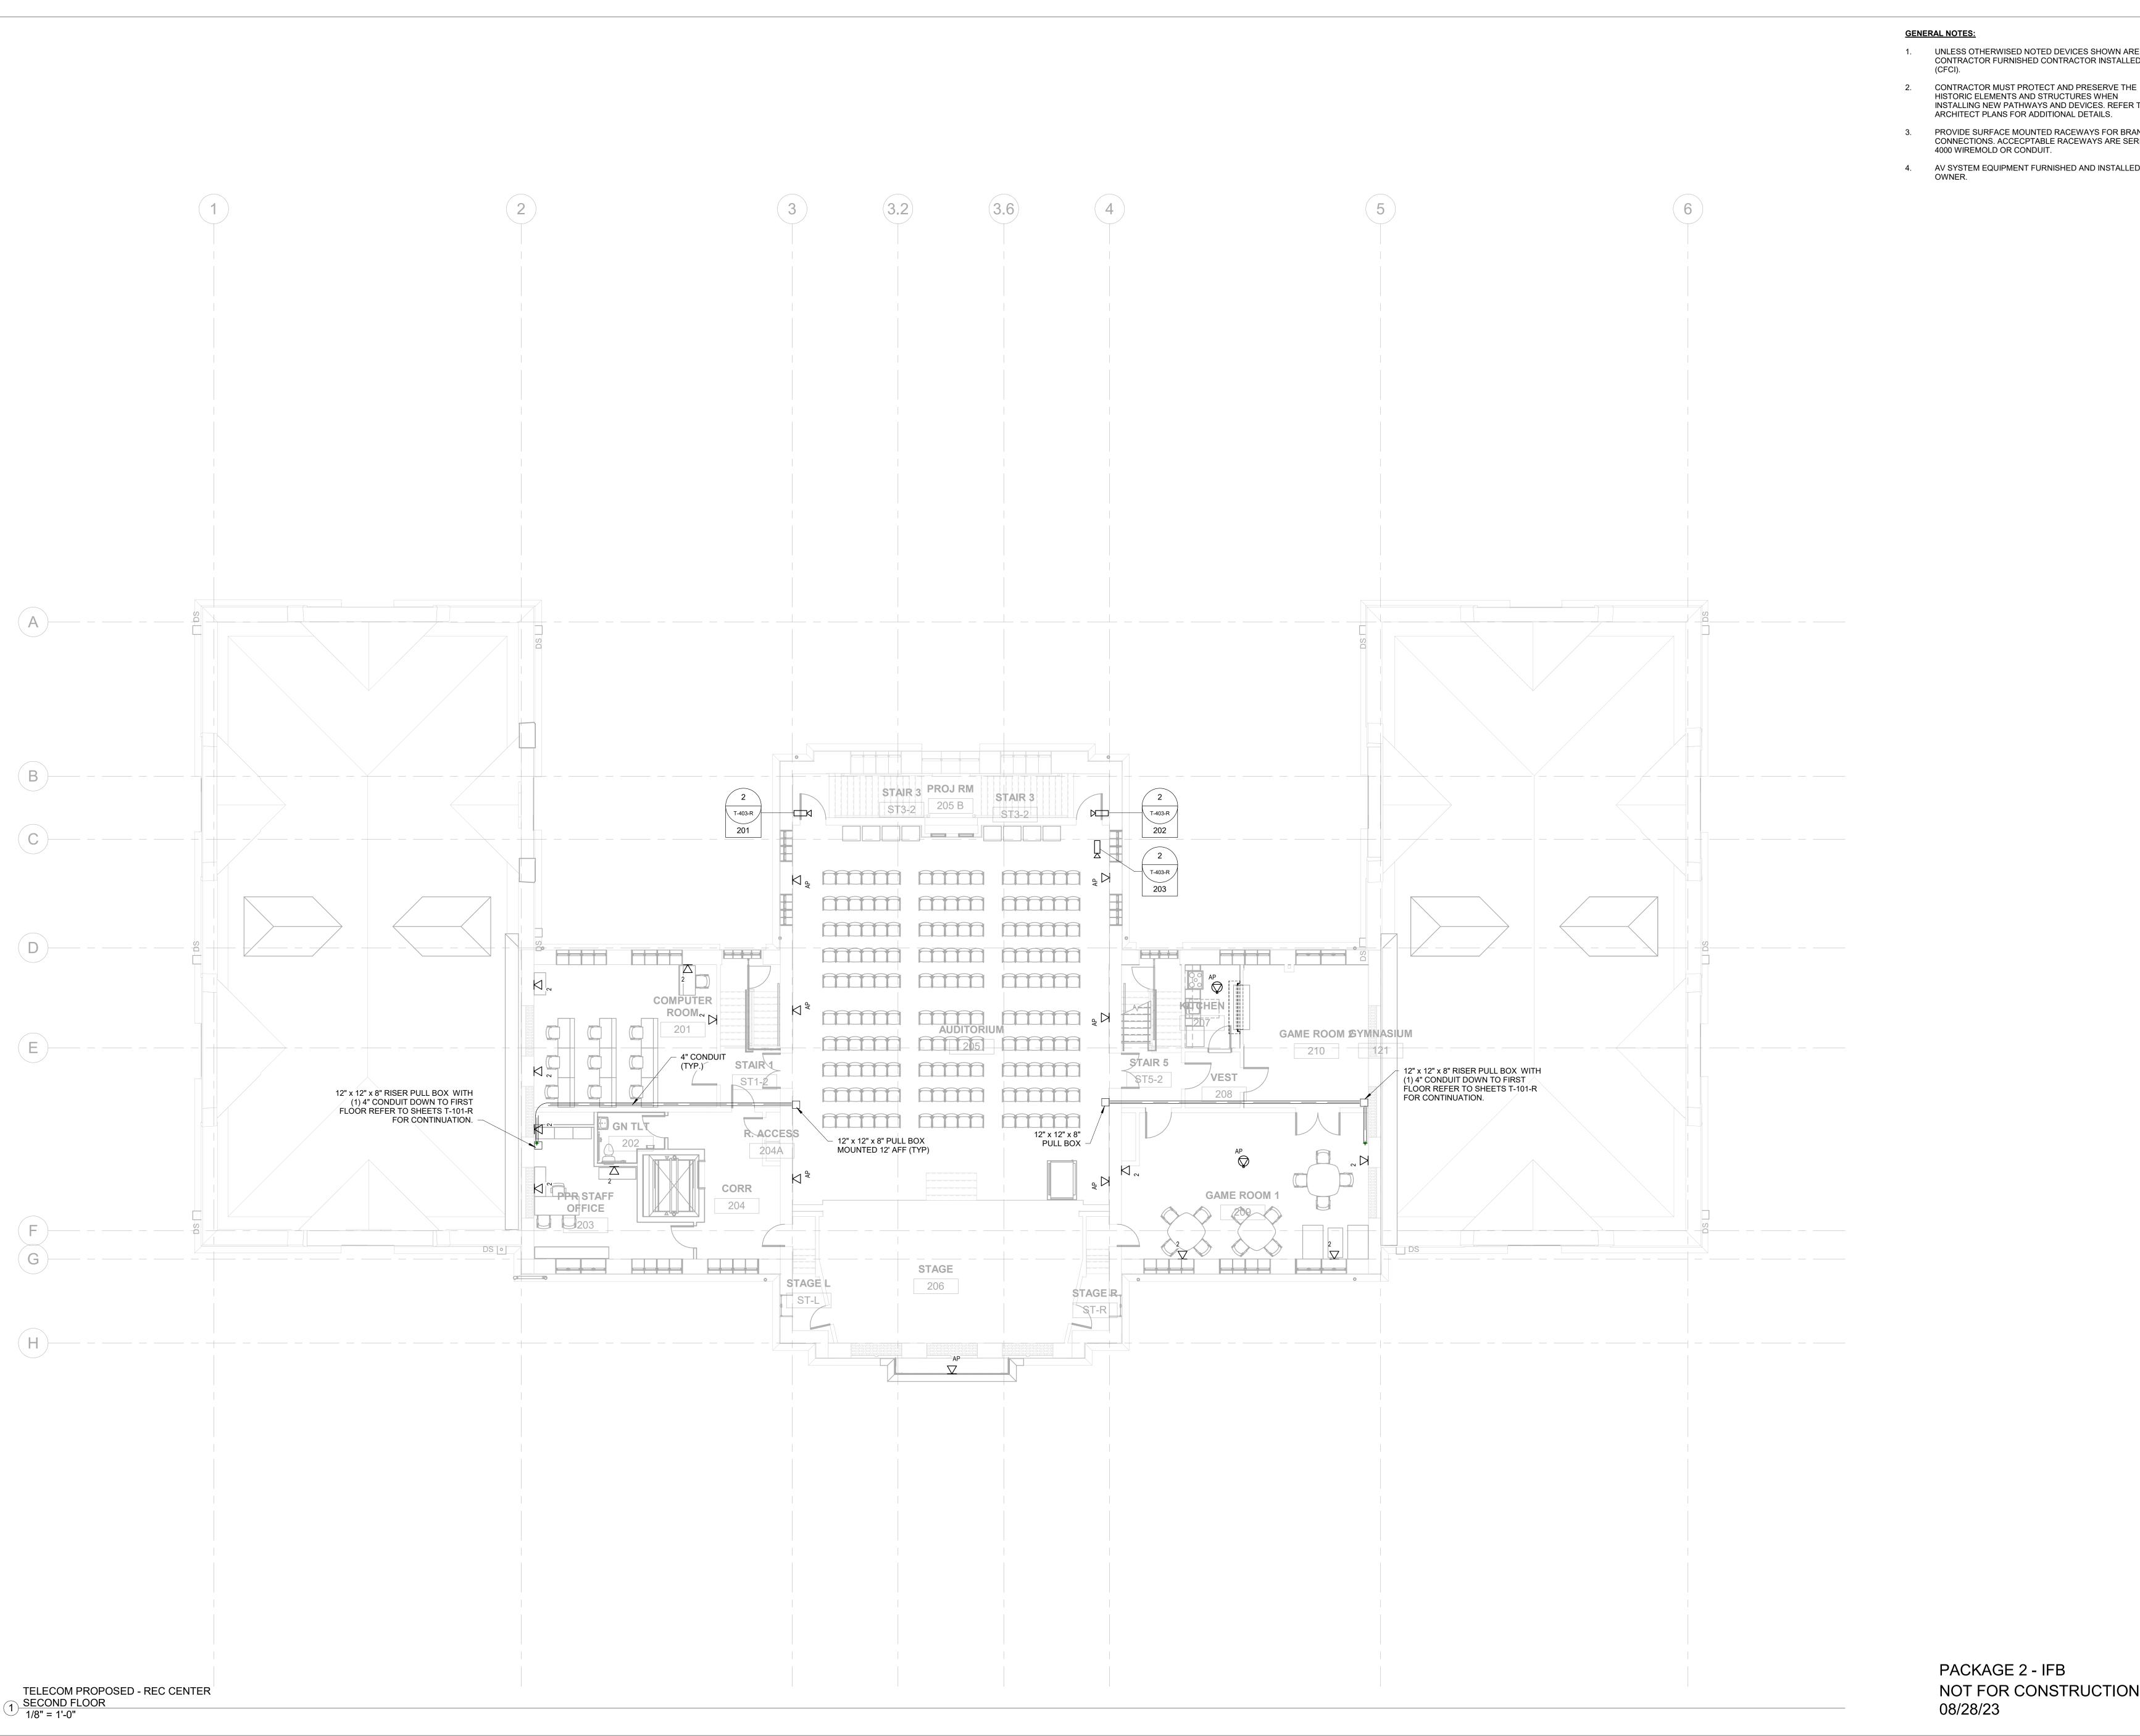


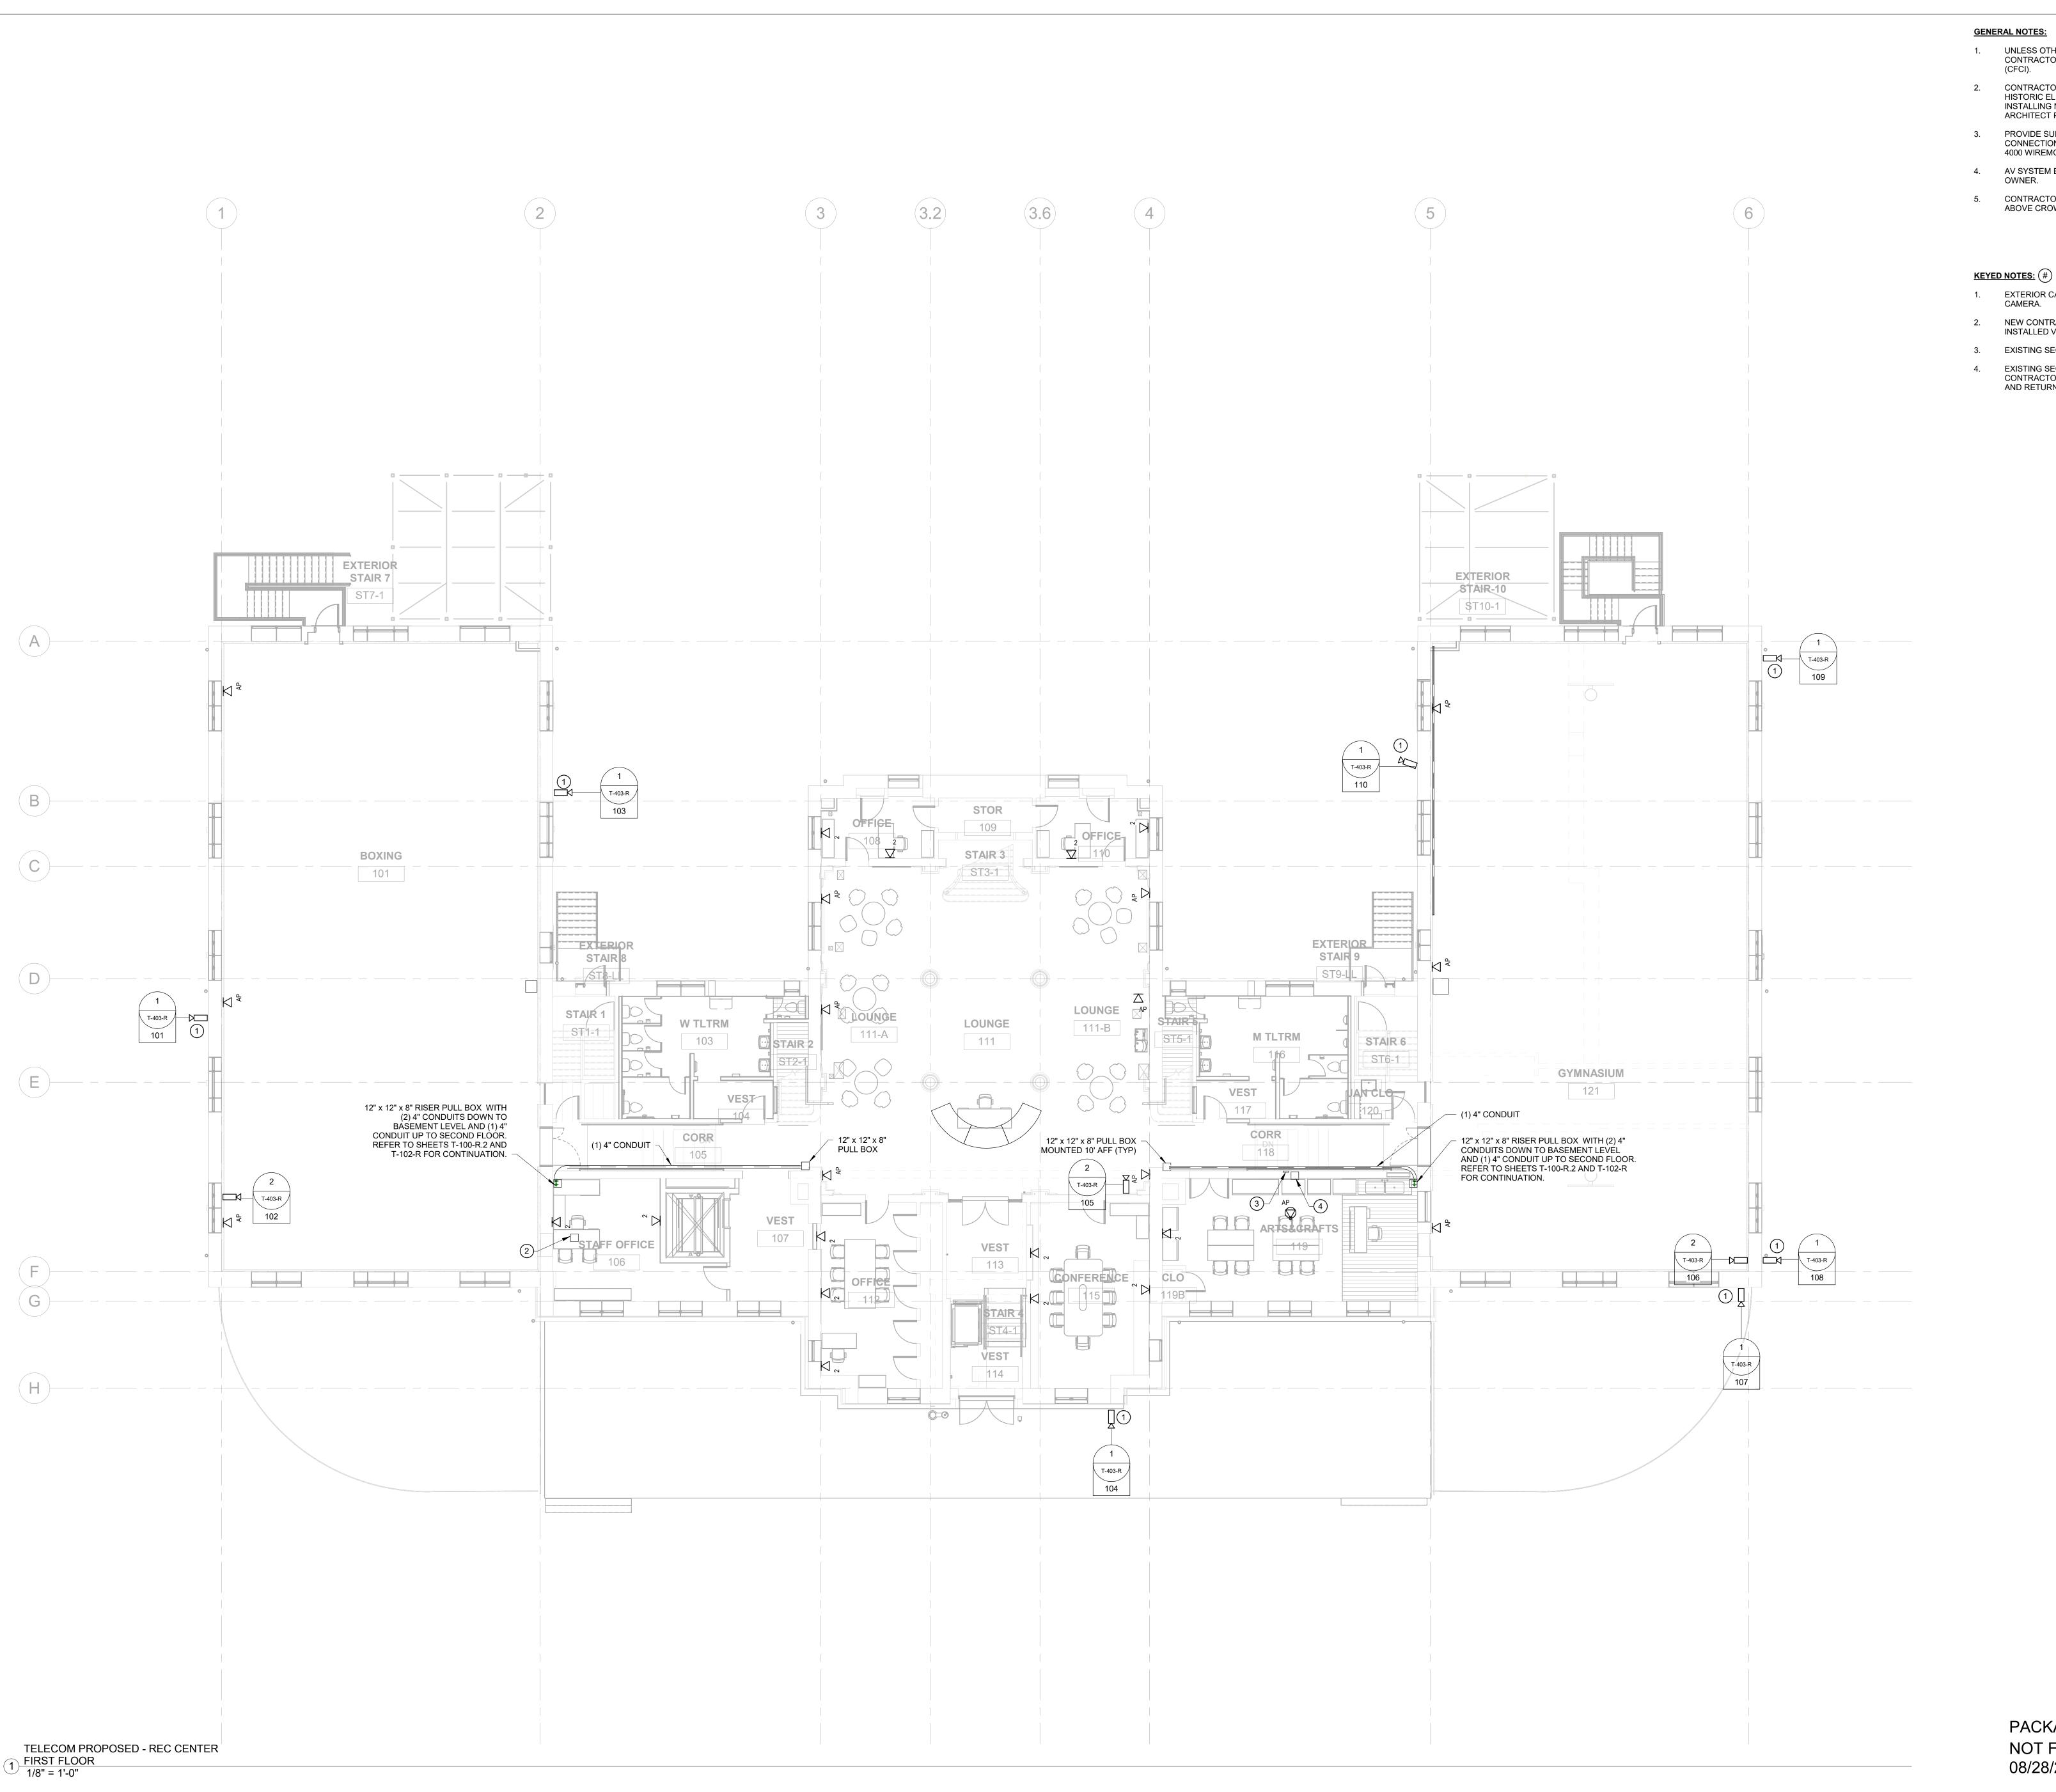TELECOM PROPOSED -FIRST FLOOR

PACKAGE 2 - IFB NOT FOR CONSTRUCTION 08/28/23

T-101-R 08/28/23 1/8" = 1'-0" DRAWN BY EEH

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- 4. AV SYSTEM EQUIPMENT FURNISHED AND INSTALLED BY

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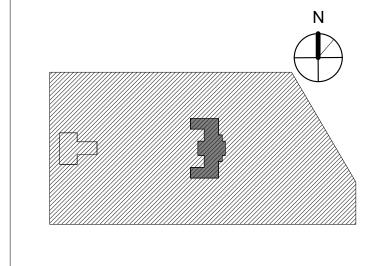


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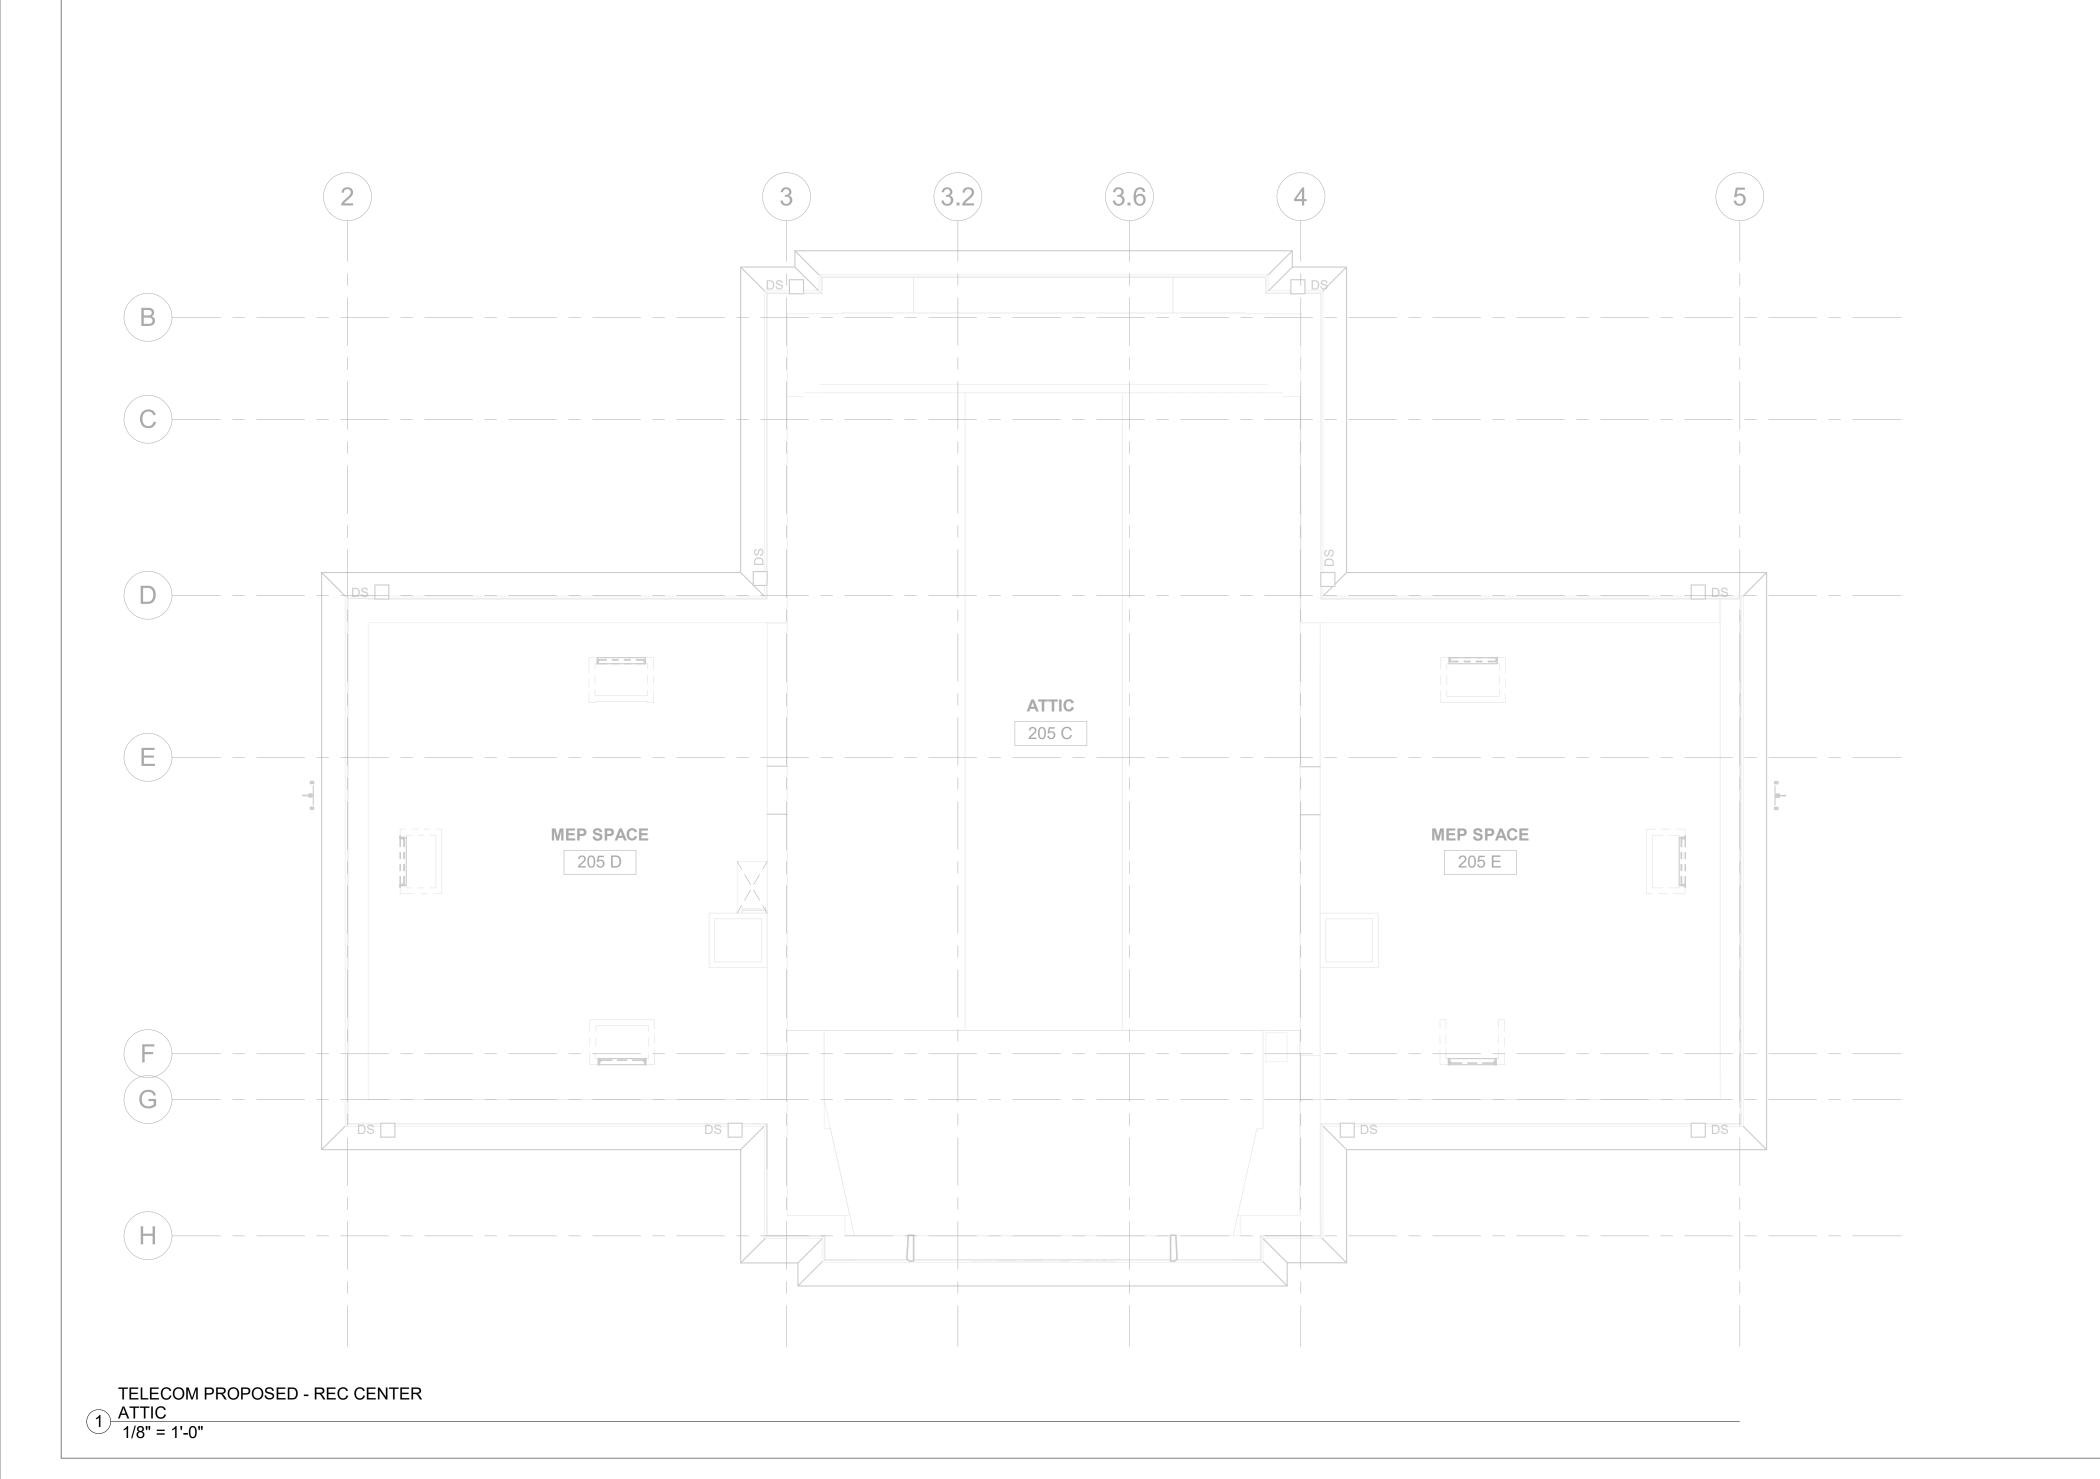


TELECOM PROPOSED -SECOND FLOOR

T-102-R 08/28/23 As indicated

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- ARCHITECT PLANS FOR ADDITIONAL DETAILS.

  3. PROVIDE SURFACE MOUNTED RACEWAYS FOR BRANCH CONNECTIONS. ACCECPTABLE RACEWAYS ARE SERIES 4000 WIREMOLD OR CONDUIT.
- 4. AV SYSTEM EQUIPMENT FURNISHED AND INSTALLED BY OWNER.

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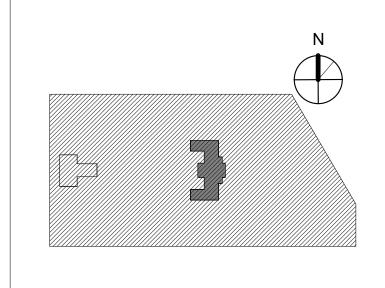
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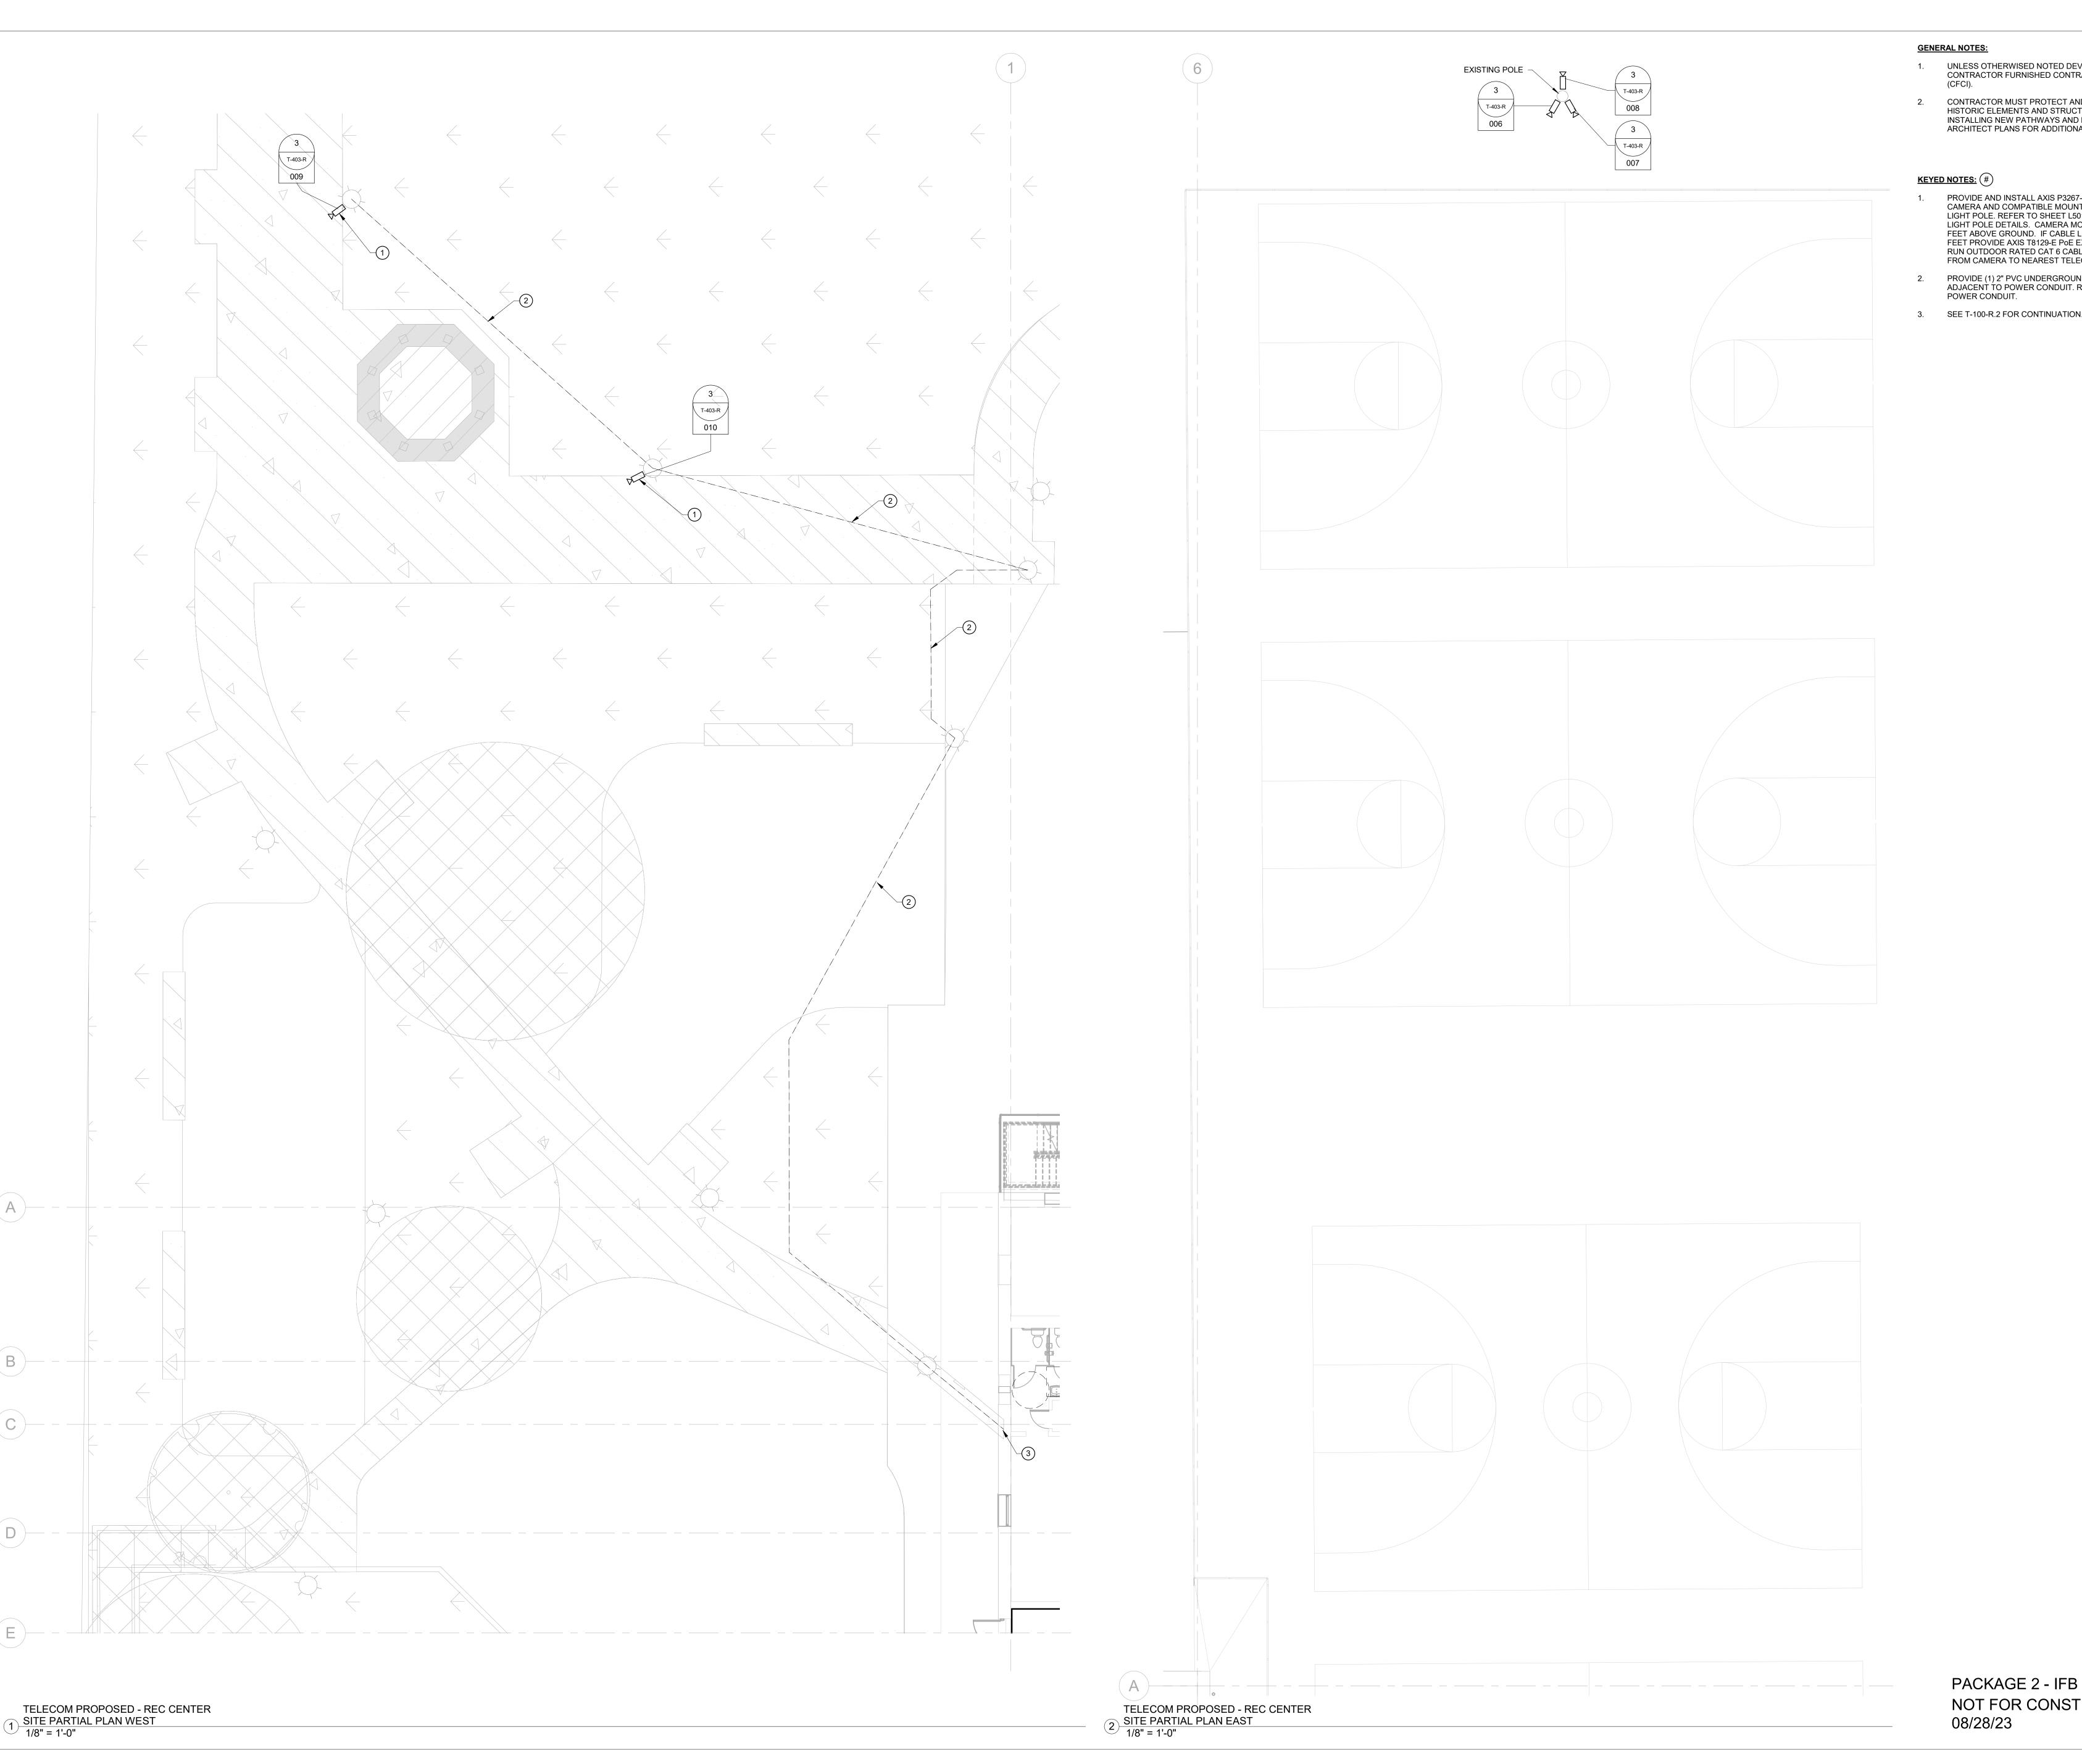
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- UNLESS OTHERWISED NOTED DEVICES SHOWN ARE CONTRACTOR FURNISHED CONTRACTOR INSTALLED
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- 1. PROVIDE AND INSTALL AXIS P3267-LVE OUTDOOR CAMERA AND COMPATIBLE MOUNTING ACCESSORIES TO LIGHT POLE. REFER TO SHEET L501-R-2 DETAIL 6 FOR LIGHT POLE DETAILS. CAMERA MOUNTING HEIGHT IS 13 FEET ABOVE GROUND. IF CABLE LENGTH EXCEEDS 295
  FEET PROVIDE AXIS T8129-E POE EXTENDER. PROVIDE
  RUN OUTDOOR RATED CAT 6 CABLE AND RJ-45 JACKS
  FROM CAMERA TO NEAREST TELECOM ROOM.
  - PROVIDE (1) 2" PVC UNDERGROUND CONDUIT, RUN ADJACENT TO POWER CONDUIT. RUN 6" AWAY FROM POWER CONDUIT.
- 3. SEE T-100-R.2 FOR CONTINUATION.



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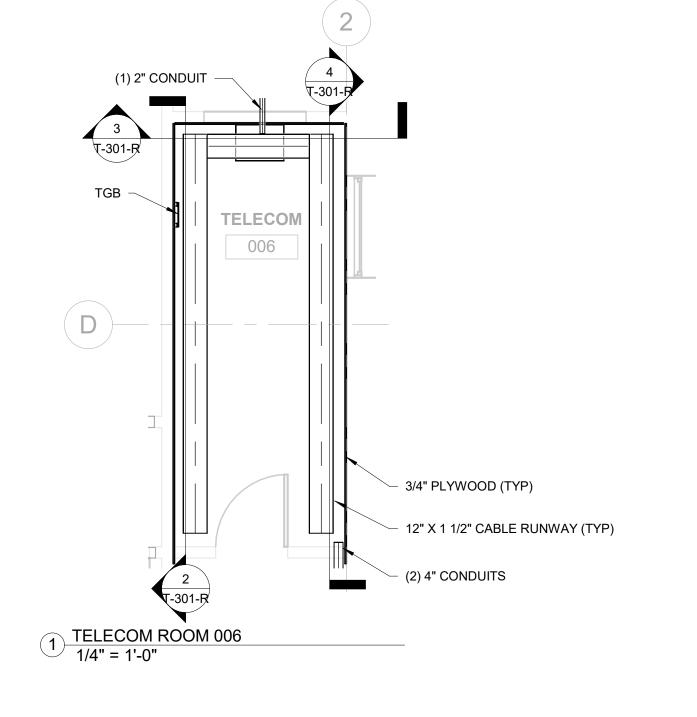
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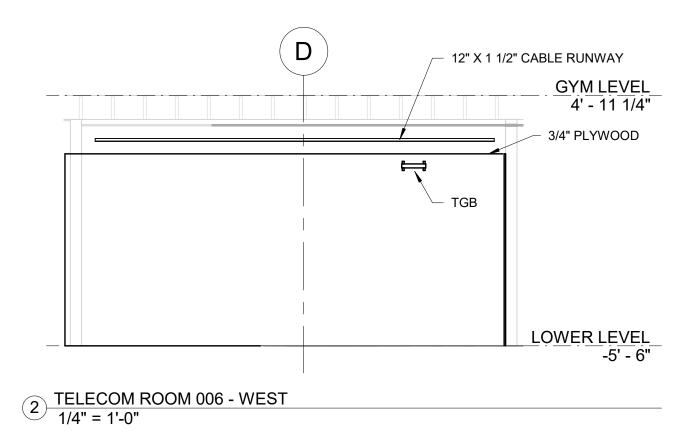
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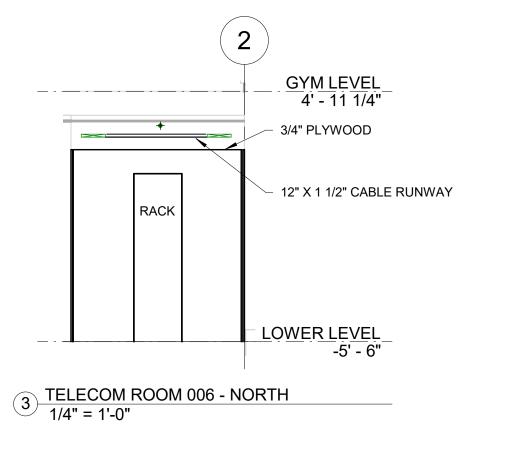
T-104-R 1/8" = 1'-0"


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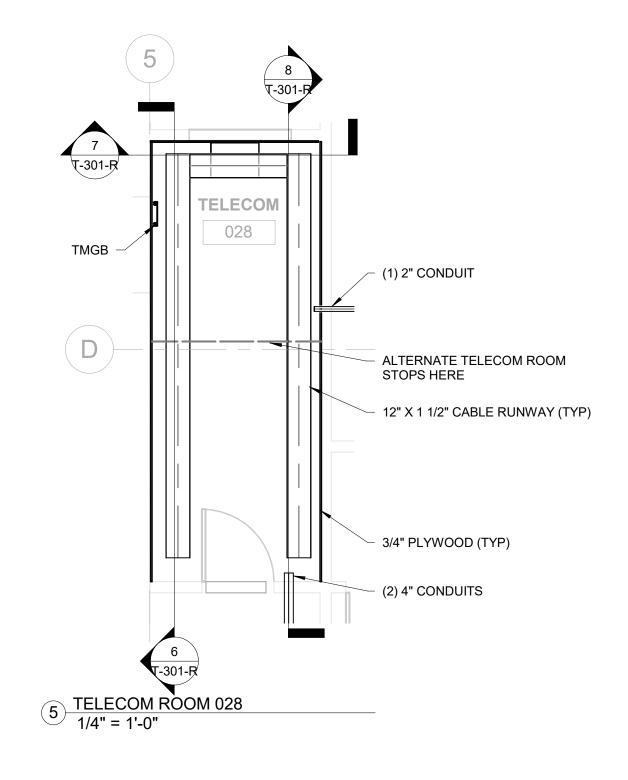
NOT FOR CONSTRUCTION












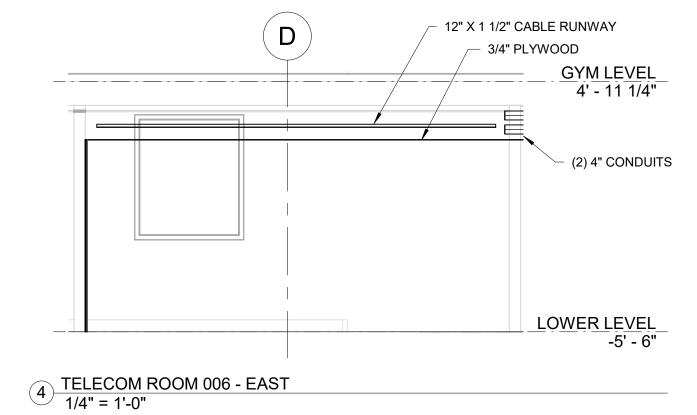

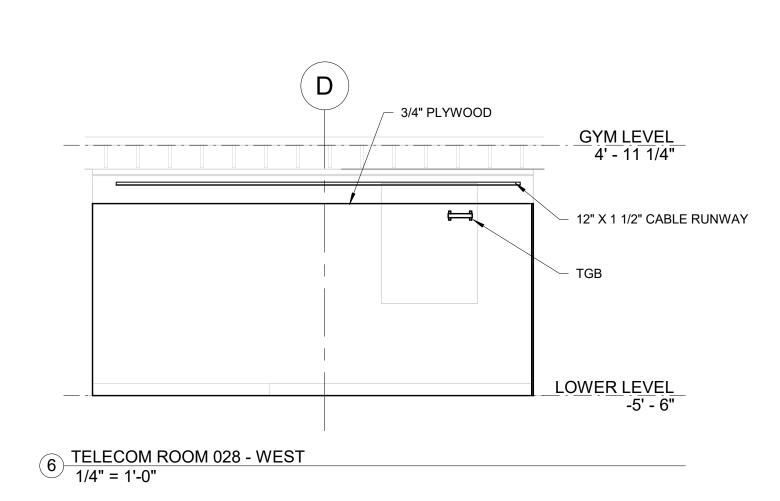

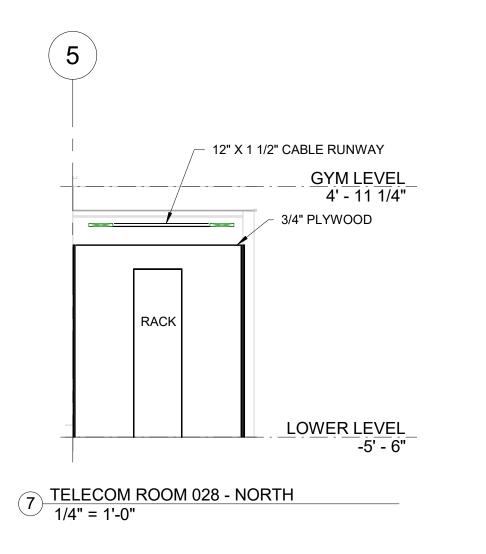


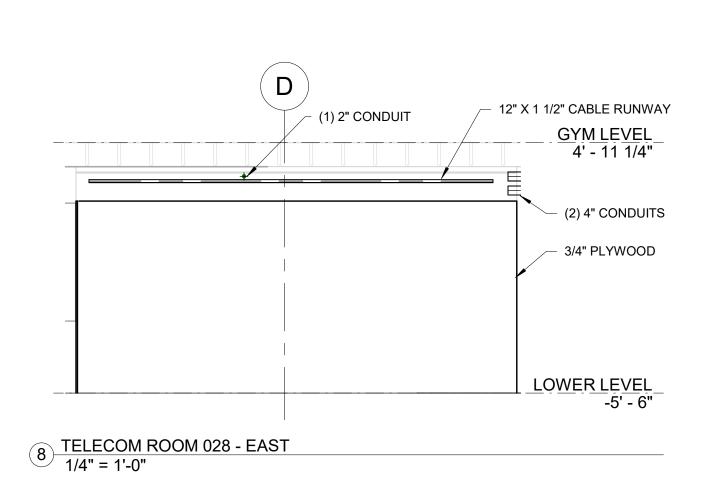

RU	EQUIPMENT ID	(W)	DESCRIPTION
1	SPACE	,	
2	-		6 STRAND SINGLE MODE FIBER TO DEMARC
4	FIBER PATCH PANEL 1		6 STRAND SINGLE MODE FIBER TO TELECOM ROOM 028
5	4 DU MUDE MANIA OFMENT		
6	1 RU WIRE MANAGEMENT  COPPER PATCH PANEL		CAT 6 CABLES TO TELECOM
7			OUTLETS AND WAPS
8	1 RU WIRE MANAGEMENT		
9	COPPER PATCH PANEL		CAT 6 CABLES TO TELECOM OUTLETS AND WAPS
10	SPACE		(2.1.2.1.1.2.1.1.2.1.1.2.1.1.1.2.1.1.1.1
11	48 PORT NETWORK SWITCH		(BY OWNER)
12	SPACE		
13	48 PORT NETWORK SWITCH		(BY OWNER)
14 15	GENETEC VIDEO MANAGEMENT SYSTEM		
16	GENETEC NETWORK VIDEO RECORDER		
17			
18	SPACE		CAT & CARLES TO CAMERAS
19	48 PORT COPPER PATCH PANEL		CAT 6 CABLES TO CAMERAS
20	SPACE		OAT COARLEG TO CAMERAG
21	48 PORT COPPER PATCH PANEL		CAT 6 CABLES TO CAMERAS
22	48 PORT NETWORK SWITCH		(BY OWNER)
23			
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25			
26			
27			
28			
29			
30			
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711		1	
42			

9 NOT TO SCALE


RU	EQUIPMENT ID	PPER I		1
1	SPACE	(,	220111111111	
2				1
3			6 STRAND SINGLE MODE FIBER TO	
4	FIBER PATCH PANEL 1		DEMARC	
5			6 STRAND SINGLE MODE FIBER TO	
6			TELECOM ROOM 006	
7	1 RU WIRE MANAGEMENT			1
8	COPPER PATCH PANEL		CAT 6 CABLES TO TELECOM	
9	1 RU WIRE MANAGEMENT		OUTLETS AND WAPS	
10	COPPER PATCH PANEL		CAT 6 CABLES TO TELECOM OUTLETS AND WAPS	]
11	SPACE		OUTLETS AND WAPS	
12	48 PORT NETWORK SWITCH		(BY OWNER)	]
13	SPACE			
14	48 PORT NETWORK SWITCH		(BY OWNER)	
15				
16				_
17				
18				CABI E MANAGEMENT
19				
20				≥
21				ABI
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23				VERTICAL
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44 45	2000VA UPS			

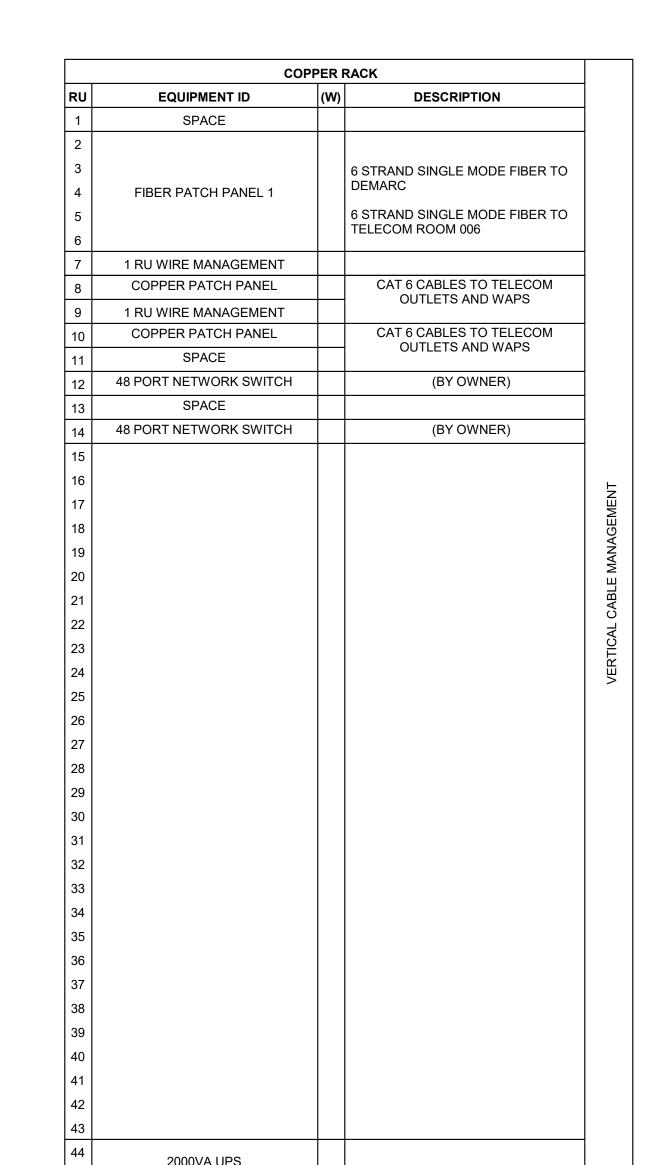


PACKAGE 2 - IFB NOT FOR CONSTRUCTION 08/28/23

RE	VISIONS
SUE DATE	DESCRIPTION
06/02/23 IS	SUE FOR BID
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S. C. C.	THE PROPERTY OF
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VIEWED BY:	
OJECT COORDINATOR	
ALS	
KELLY MAIELLO	APCHITECTS
420 Walnut Street, Philadelphia, PA 19	15th Floor
vww.kmarchitects.	
ANDSCAPE ARC	HITECT:
161 Leverington Av Philadelphia PA 19	
www.saltdesignstud	dio.com
Pennoni Associates	
1900 Market Street Philadelphia PA 19	
www.pennoni.com	
LEED CONSULTAI	Consulting
1635 Market Street Philadelphia PA 19	
SPECIAL SYSTEM	IS ENGINEERS:
Arora Engineers 1600 Market Street	
Philadelphia PA 19 www.aroraengineer	
	600
	LIBICO
	Free LIBRARY OF PHILADELPHIA
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PH	<b>ebuild</b>
	PHILADELPHIA
	Y OF PHILADELPHIA 11 VINE ST
	LPHIA, PA 19103
PHILADELPHIA	PENNSYLVANIA
OJECT TITLE  KINGSESS	SING RECREATION
	BUILDING AND SITE ROVEMENTS
Y PLAN	
AWING TITLE	NA
	M - ENLARGED PLANS
OJECT NO.	DRAWING NO.
21070	
TE 08/28/23	T-301-R
ALE As indicated	
AWN BY EEH	
IECKED BY DS	

ALL DIMENSIONS AND CONDITIONS SHALL BE VERIFIED BY THE CONTRACTOR AT THE SITE BEFORE PROCEEDING WITH THE WORK.

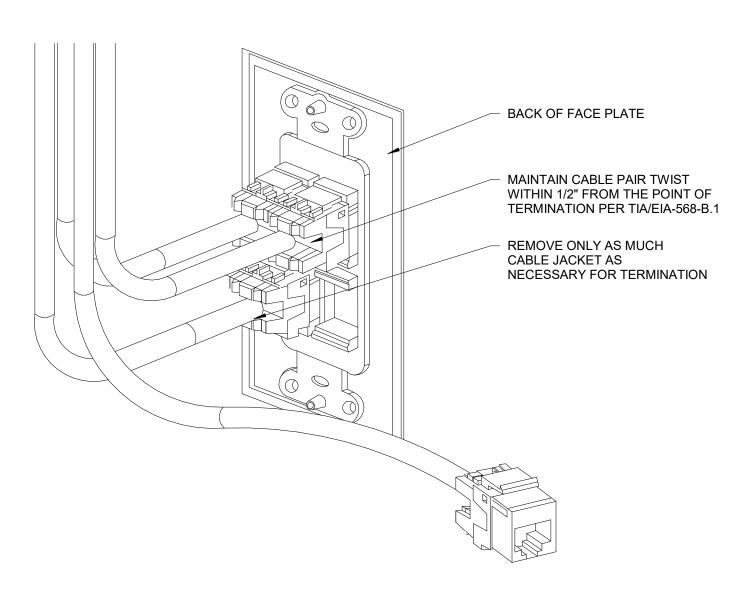


TYPICAL CAT6A - FACEPLATE TERMINATION DETAIL NOT TO SCALE

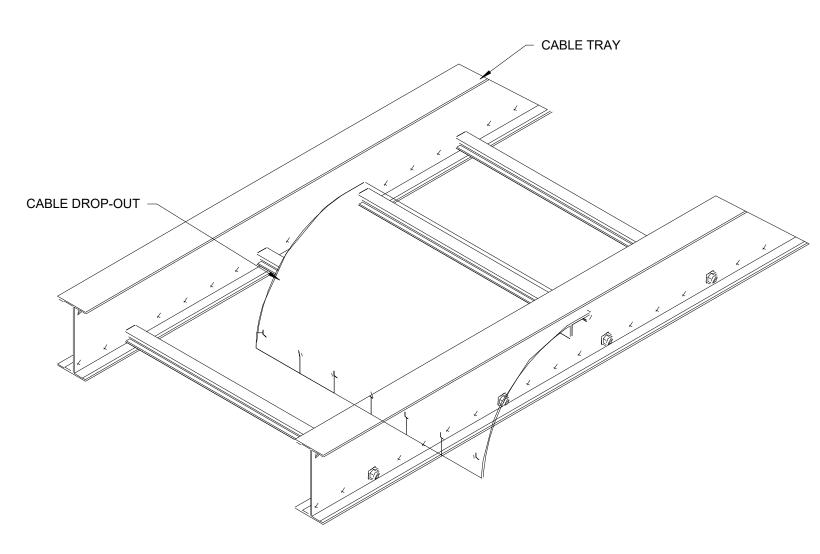


4 TYPICAL CABLE TRAY DETAIL (DROP OUT)


NOT TO SCALE

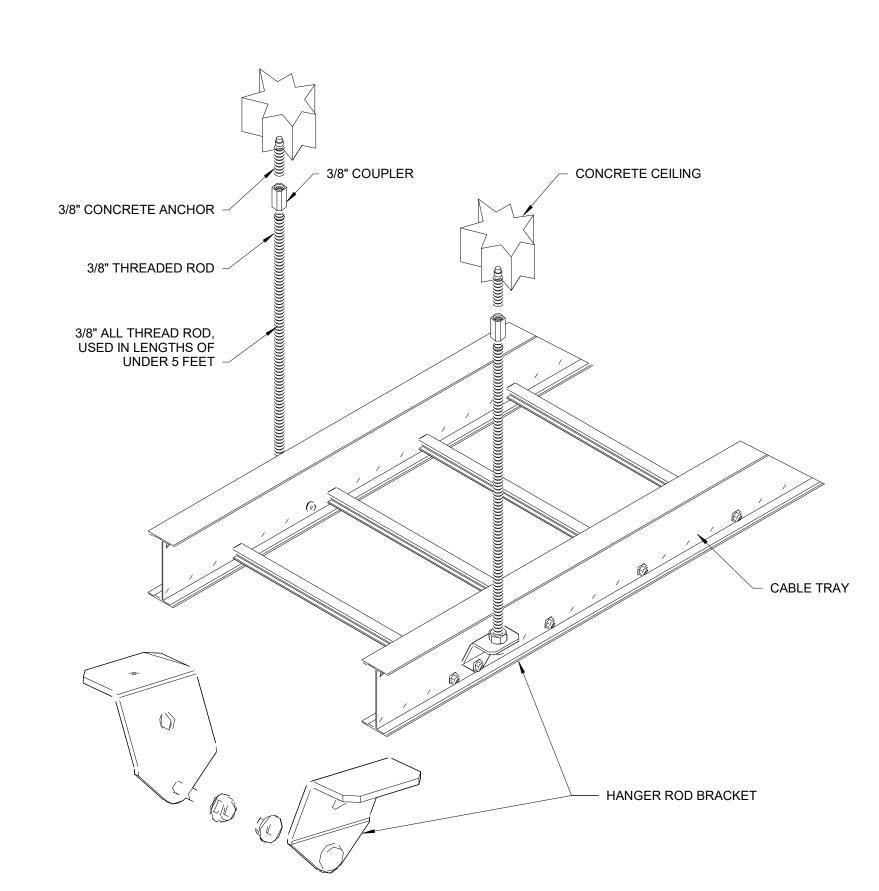


7 TYPICAL CABLE TRAY DETAIL (SUPPORT SYSTEM)
NOT TO SCALE

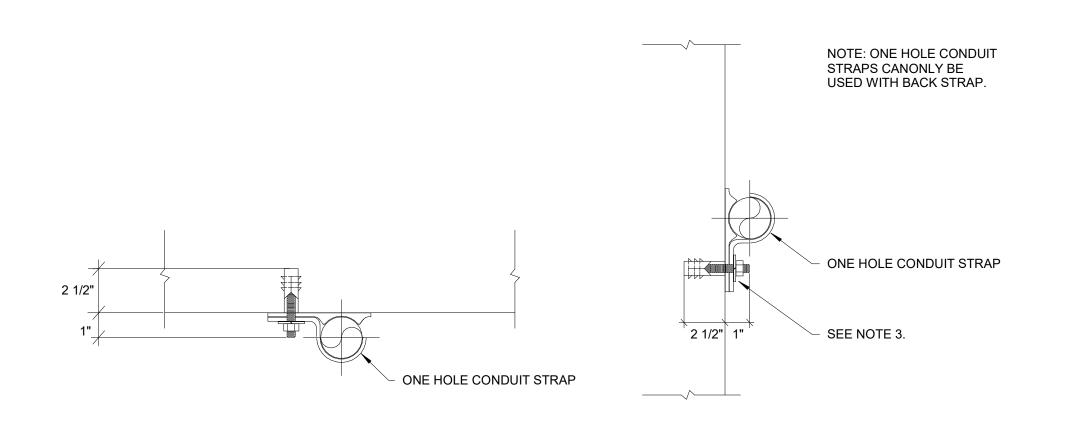


TYPICAL TELECOM CONDUIT DETAILS (SURFACE MOUNT)

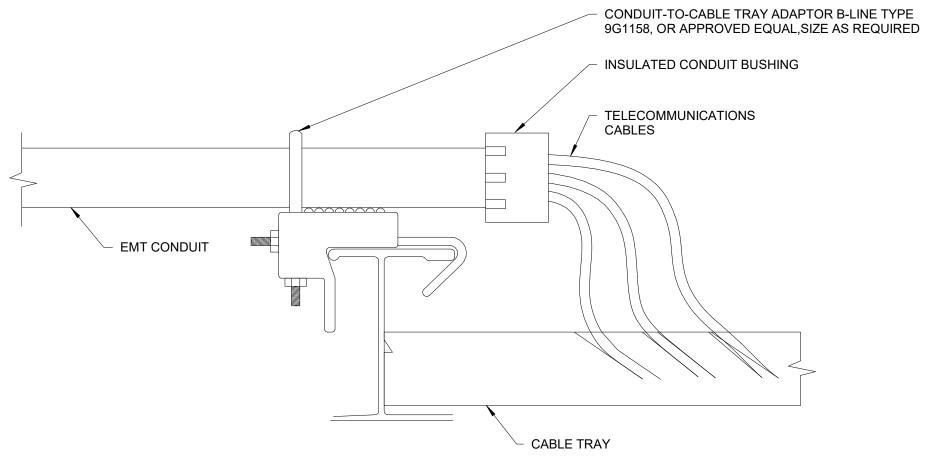


3 TYPICAL CABLE TRAY DETAIL (CONDUIT TRANSITION)
NOT TO SCALE

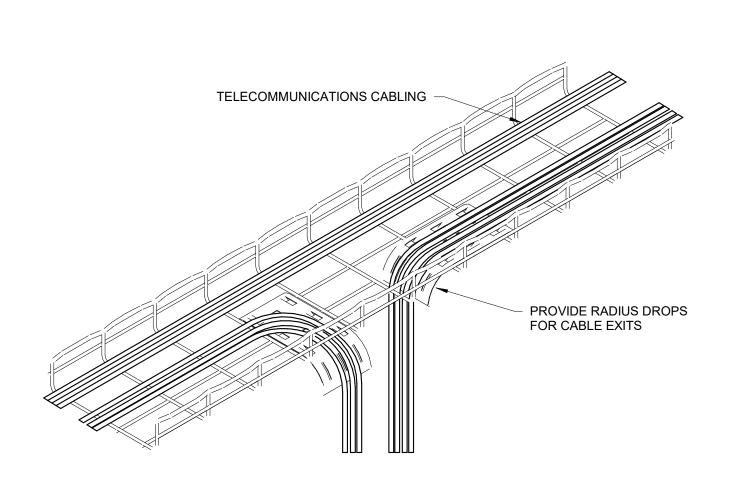

TYPICAL CABLE TRAY DETAIL (RADIUS DROP)

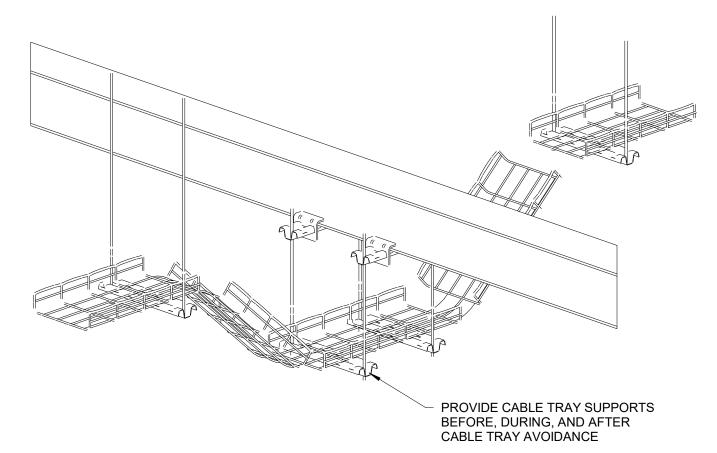

TYPICAL CABLE TRAY DETAIL (OBSTACLE AVOIDANCE)

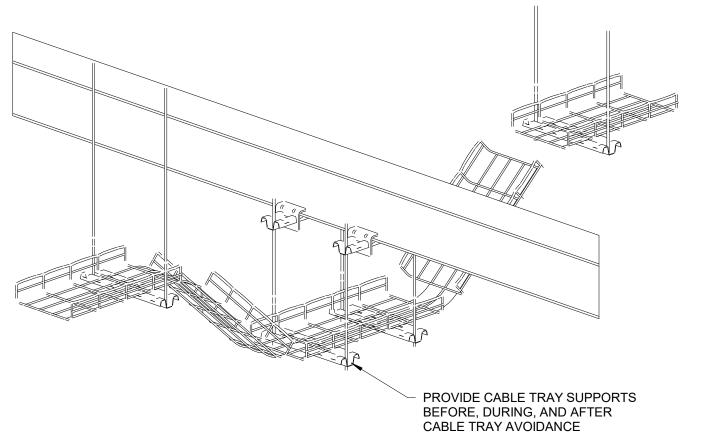

SUPPORT TO STRUCTURE ABOVE WITH ANCHOR OR HEX NUT BEAM CLAMP WASHER CABLE TRAY THREADED ROD SEE FLOOR PLAN DRAWINGS FOR MOUNTING HEIGHTS NOTE: PROTRUSION OF THREADED ROD BEYOND BASKET TRAY HANGER BRACKET MUST BE CAPPED, ALTERNATIVELY THREADED ROD MAY NOT PROTRUDE BEYOND HEX NUT.

8 TYPICAL CABLE TRAY DETAIL (SUPPORT)



08/28/23

As indicated

DRAWN BY EEH

CHECKED BY DS

SCALE

DRAWING NO.

ALL DIMENSIONS AND CONDITIONS SHALL BE VERIFIED BY THE CONTRACTOR AT THE SITE BEFORE PROCEEDING WITH THE WORK.

T-401-R

**REVISIONS** 


06/02/23 ISSUE FOR BID

ISSUE DATE

REVIEWED BY:

PROJECT COORDINATOR


DESCRIPTION

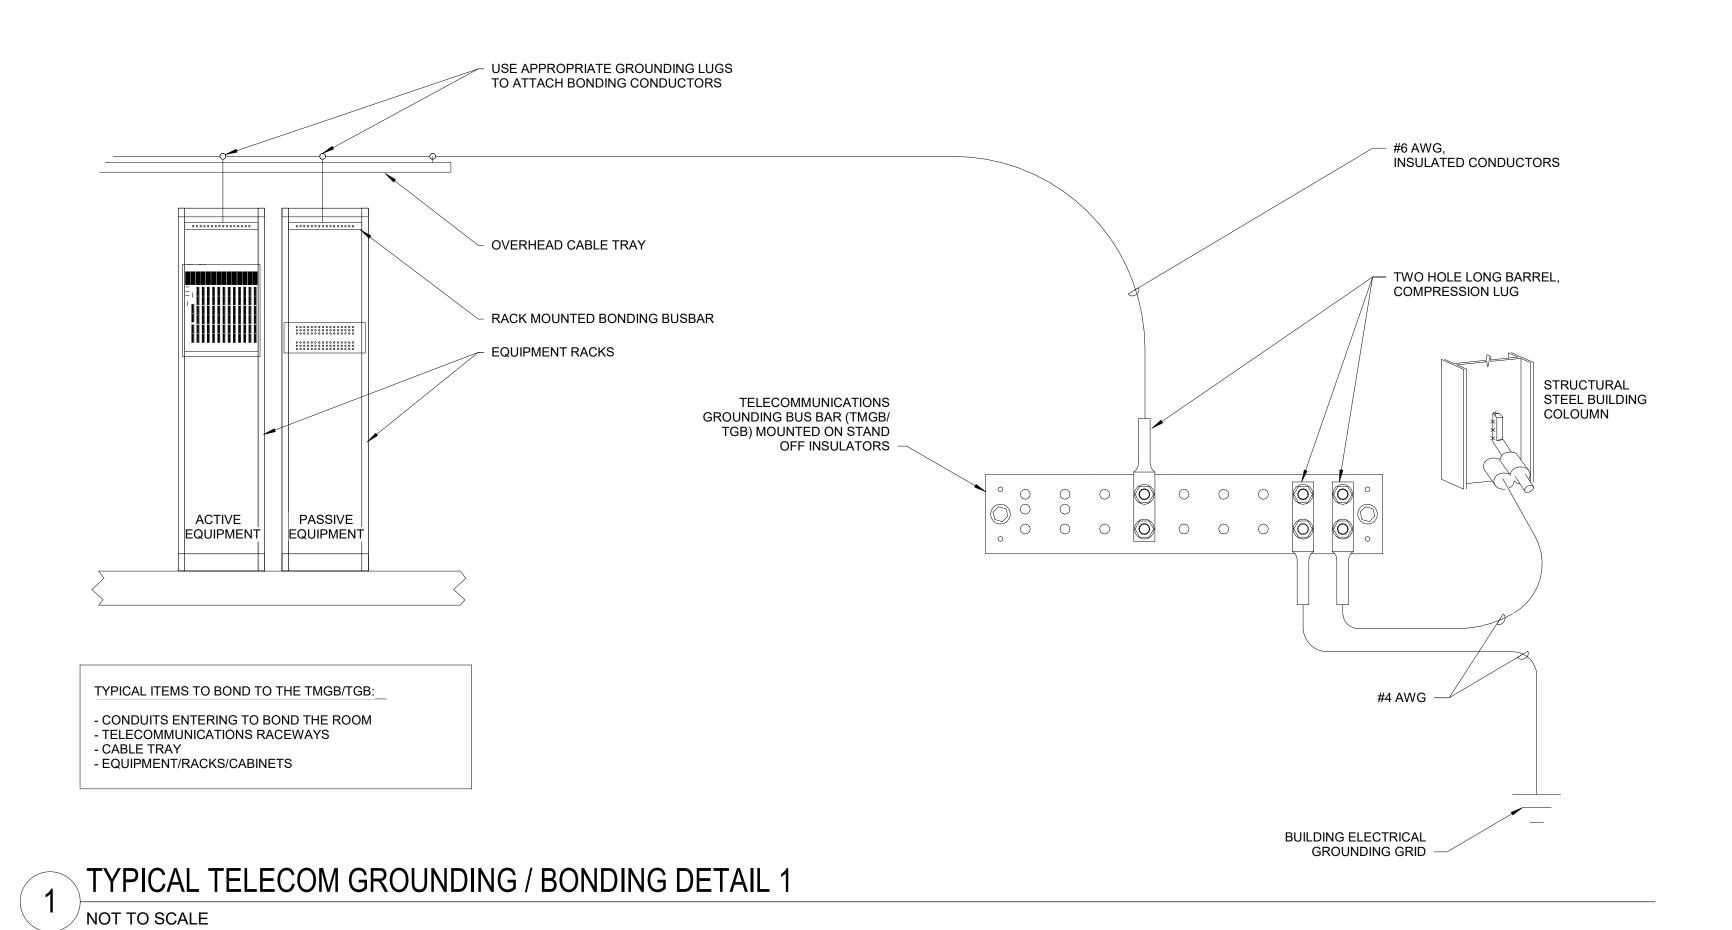

- IRREVERSIBLE COMPRESSION **IRREVERSIBLE** COMPRESSION CONNECTOR CONNECTOR TO THE TMGB/TGB -- TEBC CABLE TRAY BOUNDING CONDUCTOR (TYP)

TYPICAL CABLE TRAY GROUNDING DETAIL 3

NOT TO SCALE

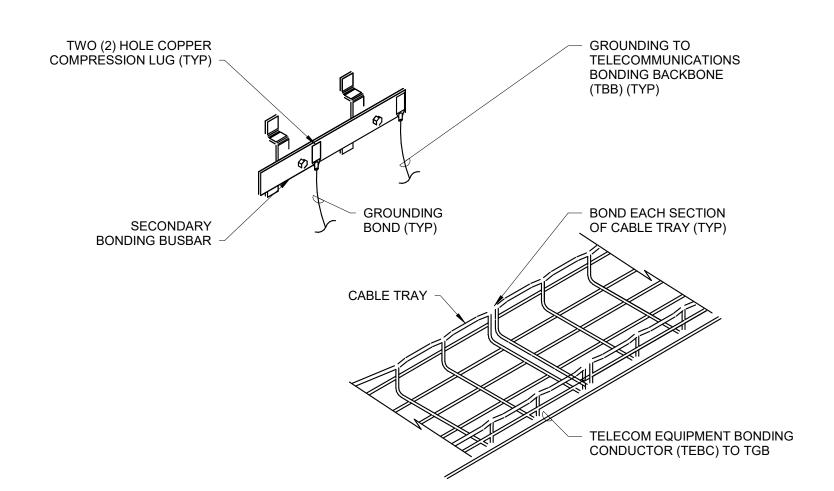

- 1. SECONDARY BONDING BUSBAR TO BE INSTALLED AND GROUNDED TO
- 2. FURNISH AND INSTALL A MINIMUM OF A #6 AWG STRANDED GROUNDING CONDUCTOR AND A TWO
- (2) HOLE COPPER COMPRESSION LUG FOR EACH INDIVIDUAL EQUIPMENT RACK AND CABLE TRAY 3. SEE ELECTRICAL DETAILS FOR ADDITIONAL GROUNDING INFORMATION
- 4. PROVIDE GROUNDING AT EVERY 6 FEET AND AT EVERY PIECE OF TRAY

TYPICAL CABLE TRAY GROUNDING DETAIL 2

TELECOMMUNICATIONS BONDING BACKBONE (TBB)

**REVISIONS** ISSUE DATE 06/02/23 ISSUE FOR BID REVIEWED BY: PROJECT COORDINATOR KELLY MAIELLO ARCHITECTS 1420 Walnut Street, 15th Floor Philadelphia, PA 19102 www.kmarchitects.com LANDSCAPE ARCHITECT: Salt Design Studio 161 Leverington Ave, Suite 1005 Philadelphia PA 19127 www.saltdesignstudio.com M.E.P./F.P./SITE CIVIL ENGINEERS: Pennoni Associates 1900 Market Street Suite 300 Philadelphia PA 19103 www.pennoni.com LEED CONSULTANT: Verde Architecture Consulting 1635 Market Street Suite 1600 Philadelphia PA 19103 SPECIAL SYSTEMS ENGINEERS: Arora Engineers 1600 Market Street Suite 1630 Philadelphia PA 19103 www.aroraengineers.com PHILADELPHIA KEY PLAN

DESCRIPTION

Rebuild CITY OF PHILADELPHIA FREE LIBRARY OF PHILADELPHIA 1901 VINE ST PHILADELPHIA, PA 19103 KINGSESSING RECREATION CENTER BUILDING AND SITE IMPROVEMENTS TELECOM - DETAILS DRAWING NO.

08/28/23

NOTE: ALL DIMENSIONS AND CONDITIONS SHALL BE VERIFIED BY THE CONTRACTOR AT THE SITE BEFORE PROCEEDING WITH THE WORK.

NTS


DRAWN BY EEH

CHECKED BY DS


SCALE

PENNSYLVANIA

T-402-R

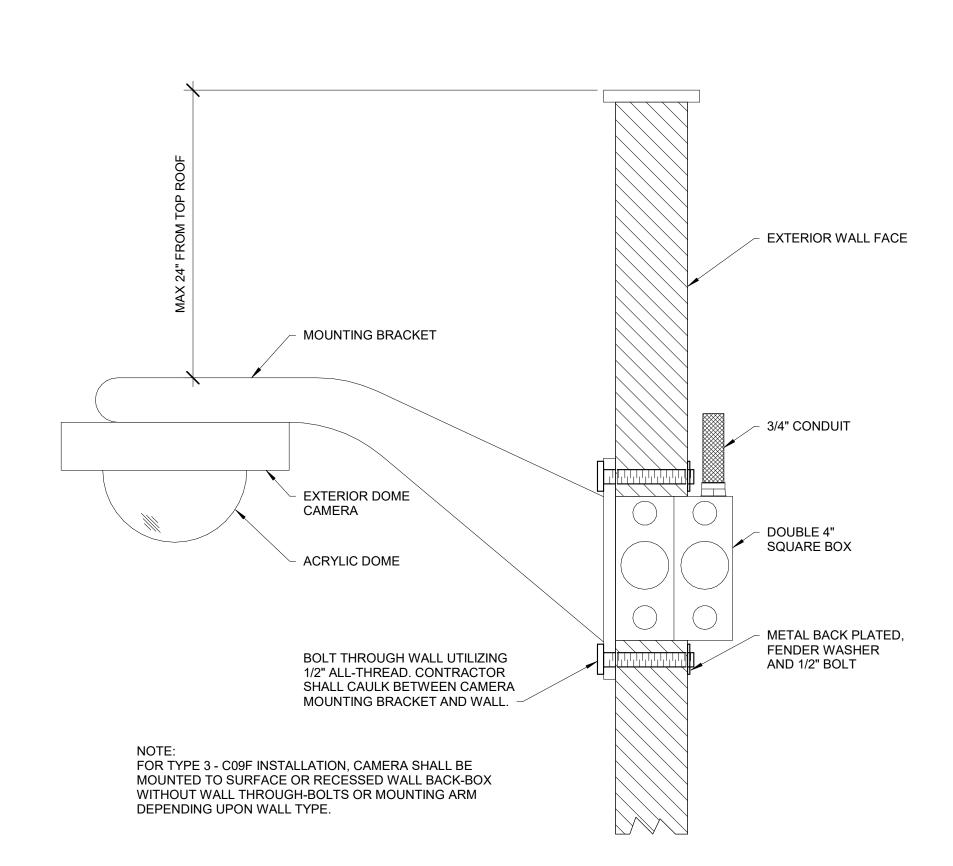


TYPICAL EXTERIOR WALL MOUNT DETAIL (DOME CAMERA) NOT TO SCALE

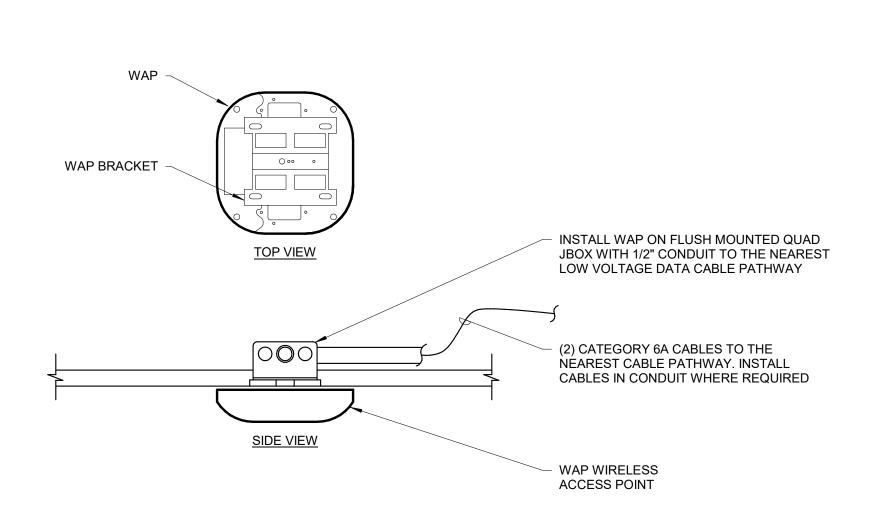


4 TYPICAL WAP CEILING MOUNTED DETAIL


NOT TO SCALE

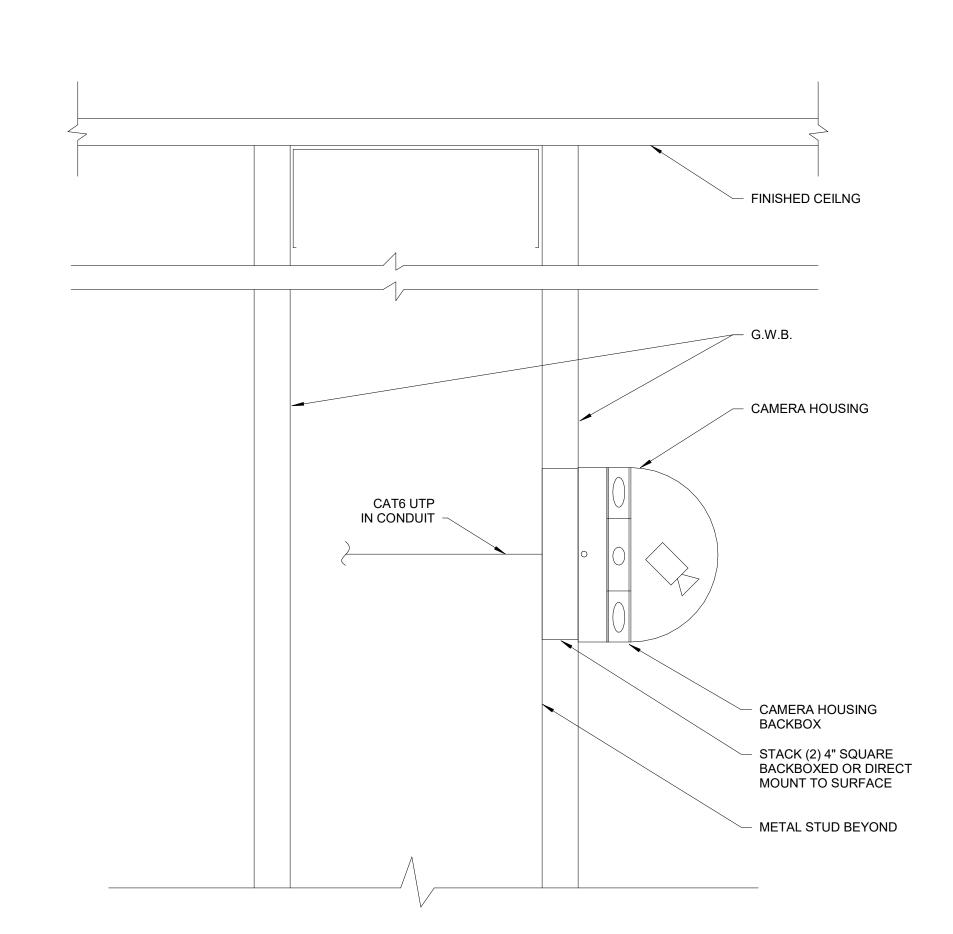

TYPICAL WALL DIFFUSER MOUNT DETAIL (FIXED CAMERA) / NOT TO SCALE

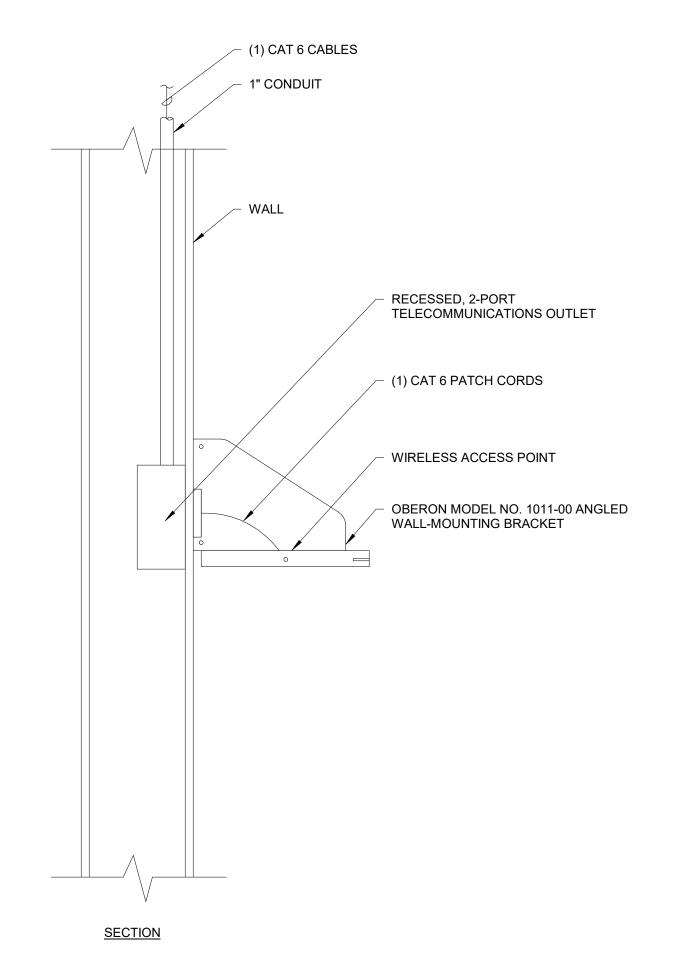

TYPICAL WAP WALL MOUNTED DETAIL

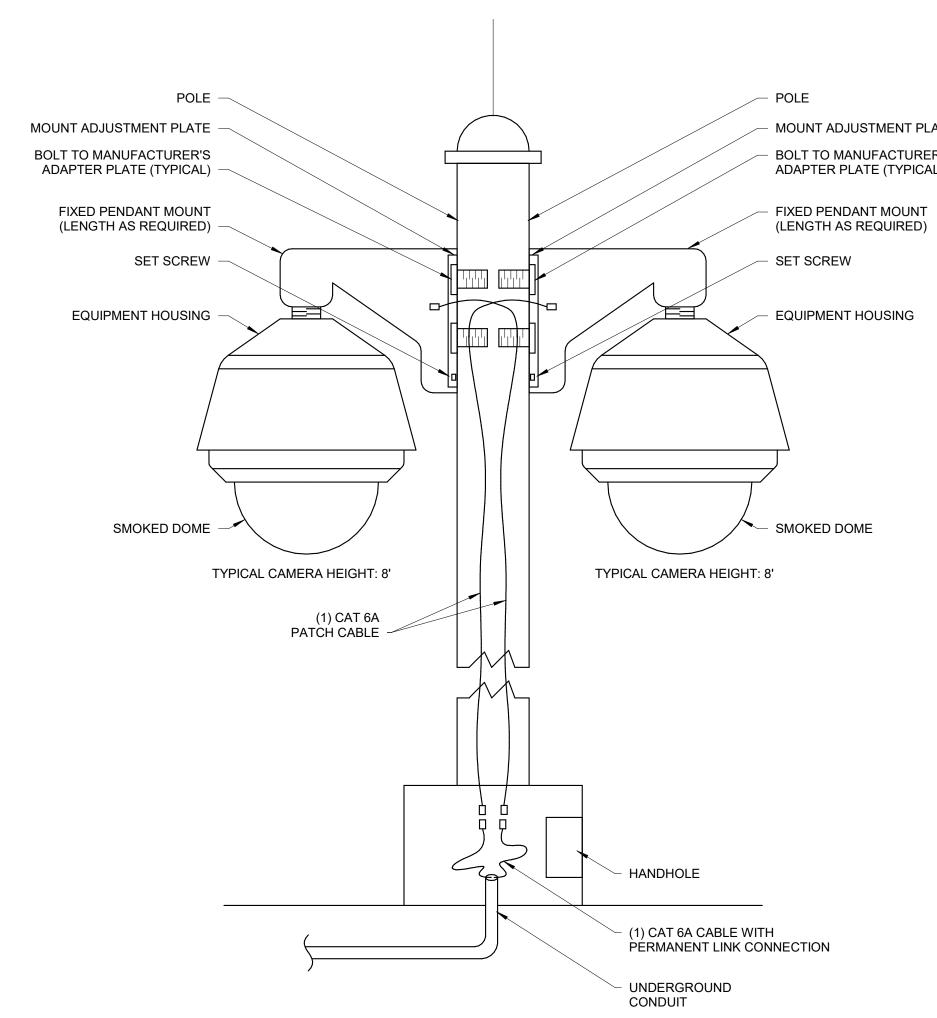

TYPICAL POLE MOUNT DETAIL (MULTIPLE DOME CAMERA) NOT TO SCALE





REVIEWED BY:

PROJECT COORDINATOR

**REVISIONS** 

06/02/23 ISSUE FOR BID

DESCRIPTION

1900 Market Street Suite 300 Philadelphia PA 19103 www.pennoni.com LEED CONSULTANT:

Verde Architecture Consulting 1635 Market Street Suite 1600 Philadelphia PA 19103 SPECIAL SYSTEMS ENGINEERS: Arora Engineers

1600 Market Street Suite 1630 Philadelphia PA 19103 www.aroraengineers.com



CITY OF PHILADELPHIA FREE LIBRARY OF PHILADELPHIA 1901 VINE ST PHILADELPHIA, PA 19103

PHILADELPHIA KINGSESSING RECREATION CENTER BUILDING AND SITE


**IMPROVEMENTS** KEY PLAN

TELECOM - DETAILS

DRAWING NO. T-403-R 08/28/23 SCALE As indicated DRAWN BY EEH


NOTE: ALL DIMENSIONS AND CONDITIONS SHALL BE VERIFIED BY THE CONTRACTOR AT THE SITE BEFORE PROCEEDING WITH THE WORK.

CHECKED BY DS

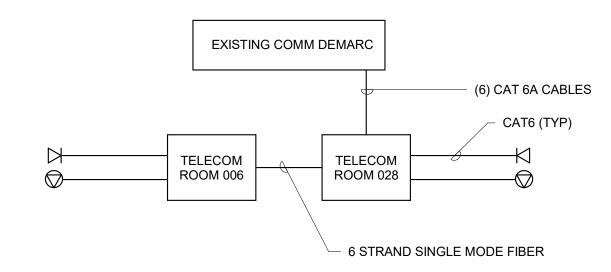

# 1 TELECOM ONE LINE DIAGRAM NOT TO SCALE

	CHEET		CCTV SCHEDULE	MOLITALINIO	FIDED
CAMERA ID	SHEET NUMBER	FIELD OF VIEW	TYPE (DETAIL - CAMERA TYPE - MOUNT TYPE)	MOUTNING HEIGHT	FIBER EXTENSION
			THE (BETTAL OF WALLOW THE WOOTH THE)		
OWER LE	√EL				
001	T-100-R.2		1/T-403-R - FIXED - WALL MOUNT EXTERIOR	9' - 0"	No
002	T-100-R.2		2/T-403-R - FIXED - WALL MOUNT	9' - 0"	No
003	T-100-R.2		2/T-403-R - FIXED - WALL MOUNT	9' - 0"	No
004	T-100-R.2		2/T-403-R - FIXED - WALL MOUNT	9' - 0"	No
005	T-100-R.2		2/T-403-R - FIXED - WALL MOUNT	9' - 0"	No
006	T-104-R		3/T-403-R - FIXED - POLE MOUNT	13' - 0"	No
007	T-104-R		3/T-403-R - FIXED - POLE MOUNT	13' - 0"	No
800	T-104-R		3/T-403-R - FIXED - POLE MOUNT	13' - 0"	No
009	T-104-R		3/T-403-R - FIXED - POLE MOUNT	13' - 0"	Yes
010	T-104-R		3/T-403-R - FIXED - POLE MOUNT	13' - 0"	Yes
RST FLO	OR	l.			
101	T-101-R		1/T-403-R - FIXED - WALL MOUNT EXTERIOR	9' - 0"	No
102	T-101-R		2/T-403-R - FIXED - WALL MOUNT	9' - 0"	No
103	T-101-R		1/T-403-R - FIXED - WALL MOUNT EXTERIOR	9' - 0"	No
104	T-101-R		1/T-403-R - FIXED - WALL MOUNT EXTERIOR	9' - 0"	No
105	T-101-R		2/T-403-R - FIXED - WALL MOUNT	9' - 0"	No
106	T-101-R		2/T-403-R - FIXED - WALL MOUNT	9' - 0"	No
107	T-101-R		1/T-403-R - FIXED - WALL MOUNT EXTERIOR	9' - 0"	No
108	T-101-R		1/T-403-R - FIXED - WALL MOUNT EXTERIOR	9' - 0"	No
109	T-101-R		1/T-403-R - FIXED - WALL MOUNT EXTERIOR	9' - 0"	No
110	T-101-R		1/T-403-R - FIXED - WALL MOUNT EXTERIOR	9' - 0"	No
ECOND FI	OOR				
201	T-102-R		2/T-403-R - FIXED - WALL MOUNT	9' - 0"	No
202	T-102-R		2/T-403-R - FIXED - WALL MOUNT	9' - 0"	No
203	T-102-R		2/T-403-R - FIXED - WALL MOUNT	9' - 0"	No

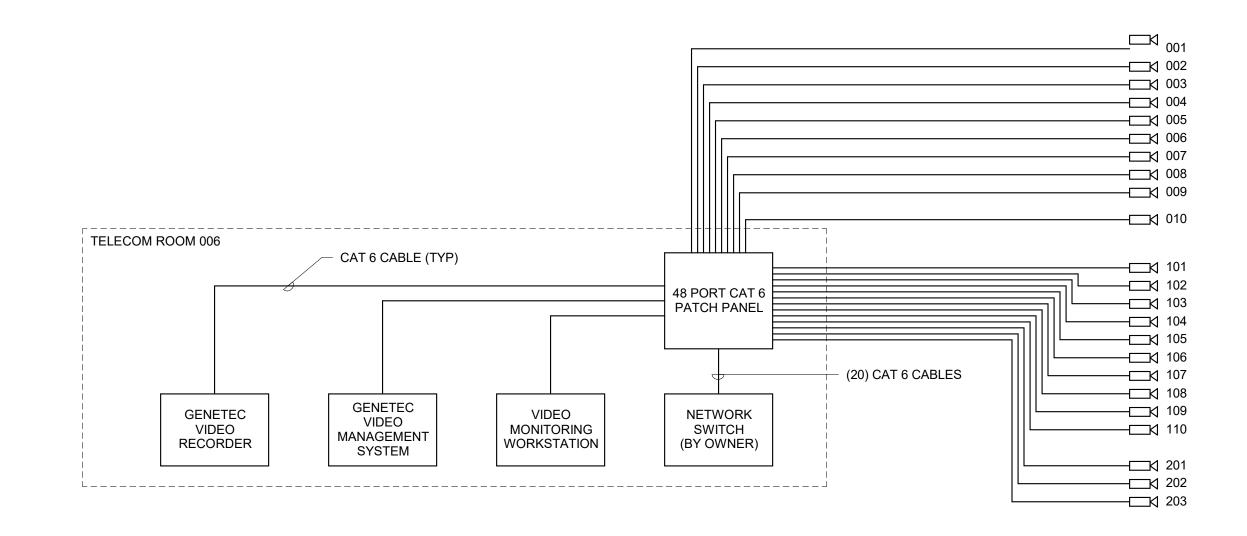


2 SECURITY CAMERA SINGLE LINE DIAGRAM

NOT TO SCALE




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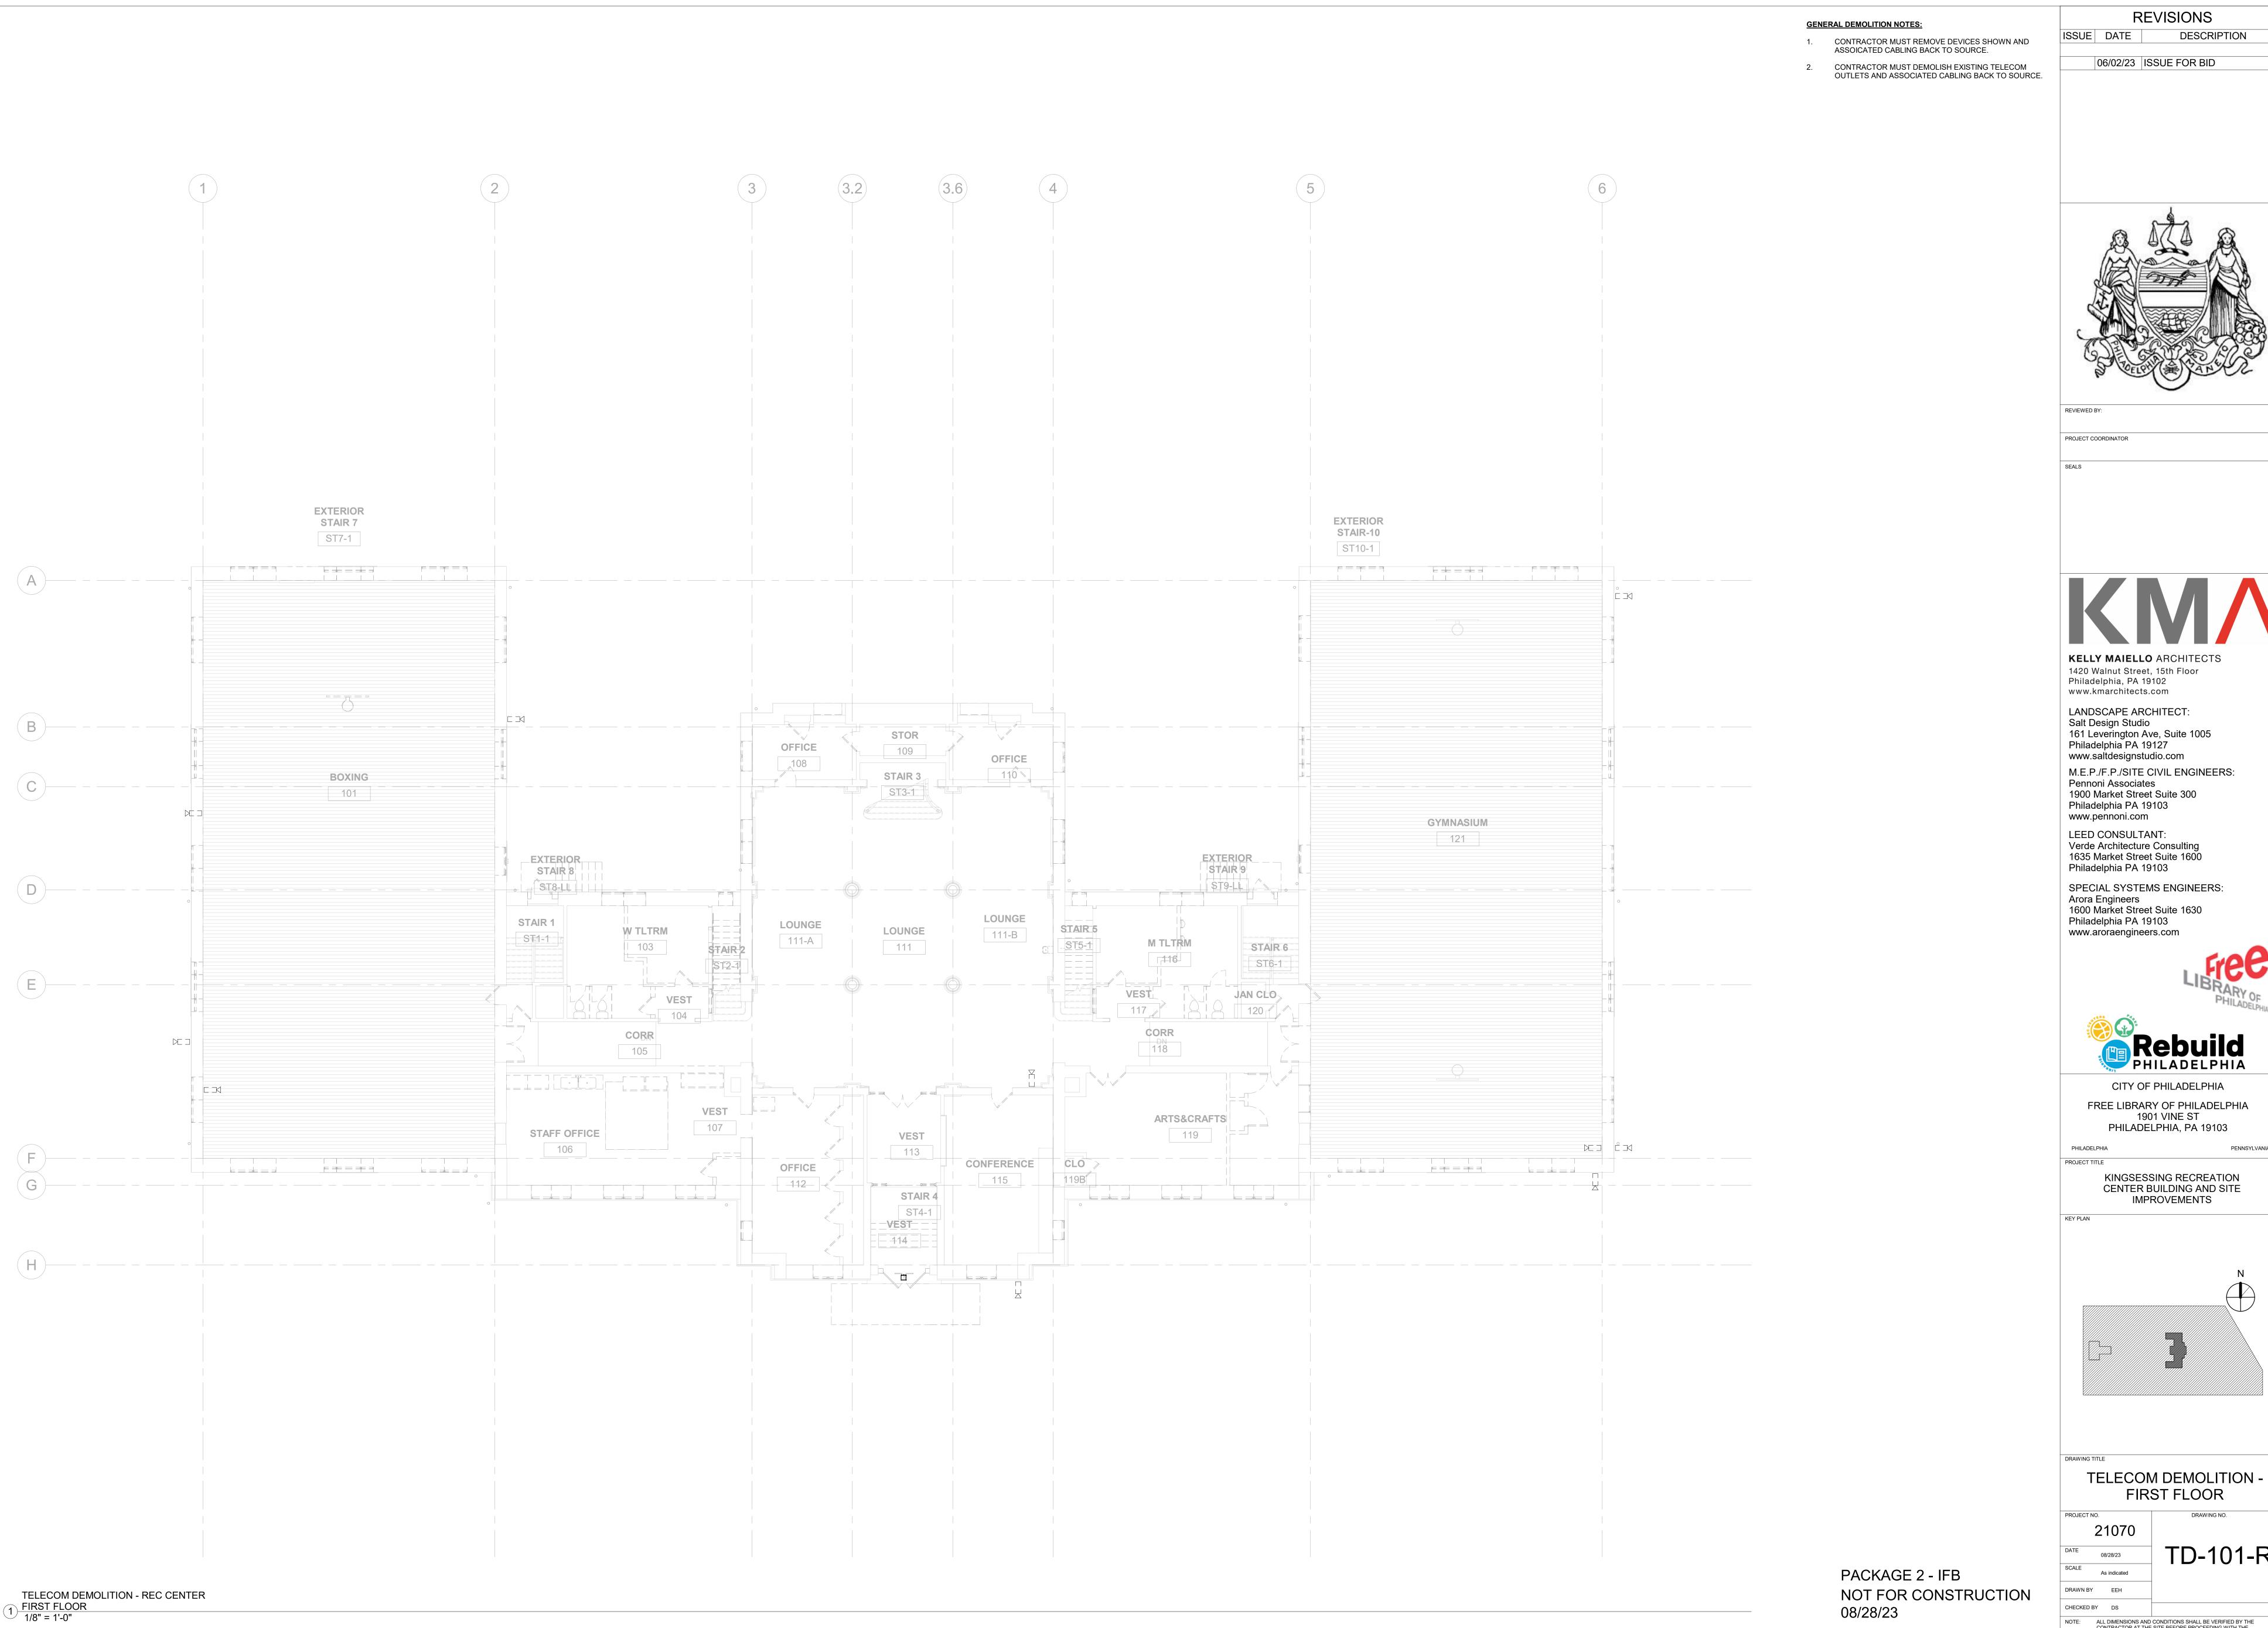


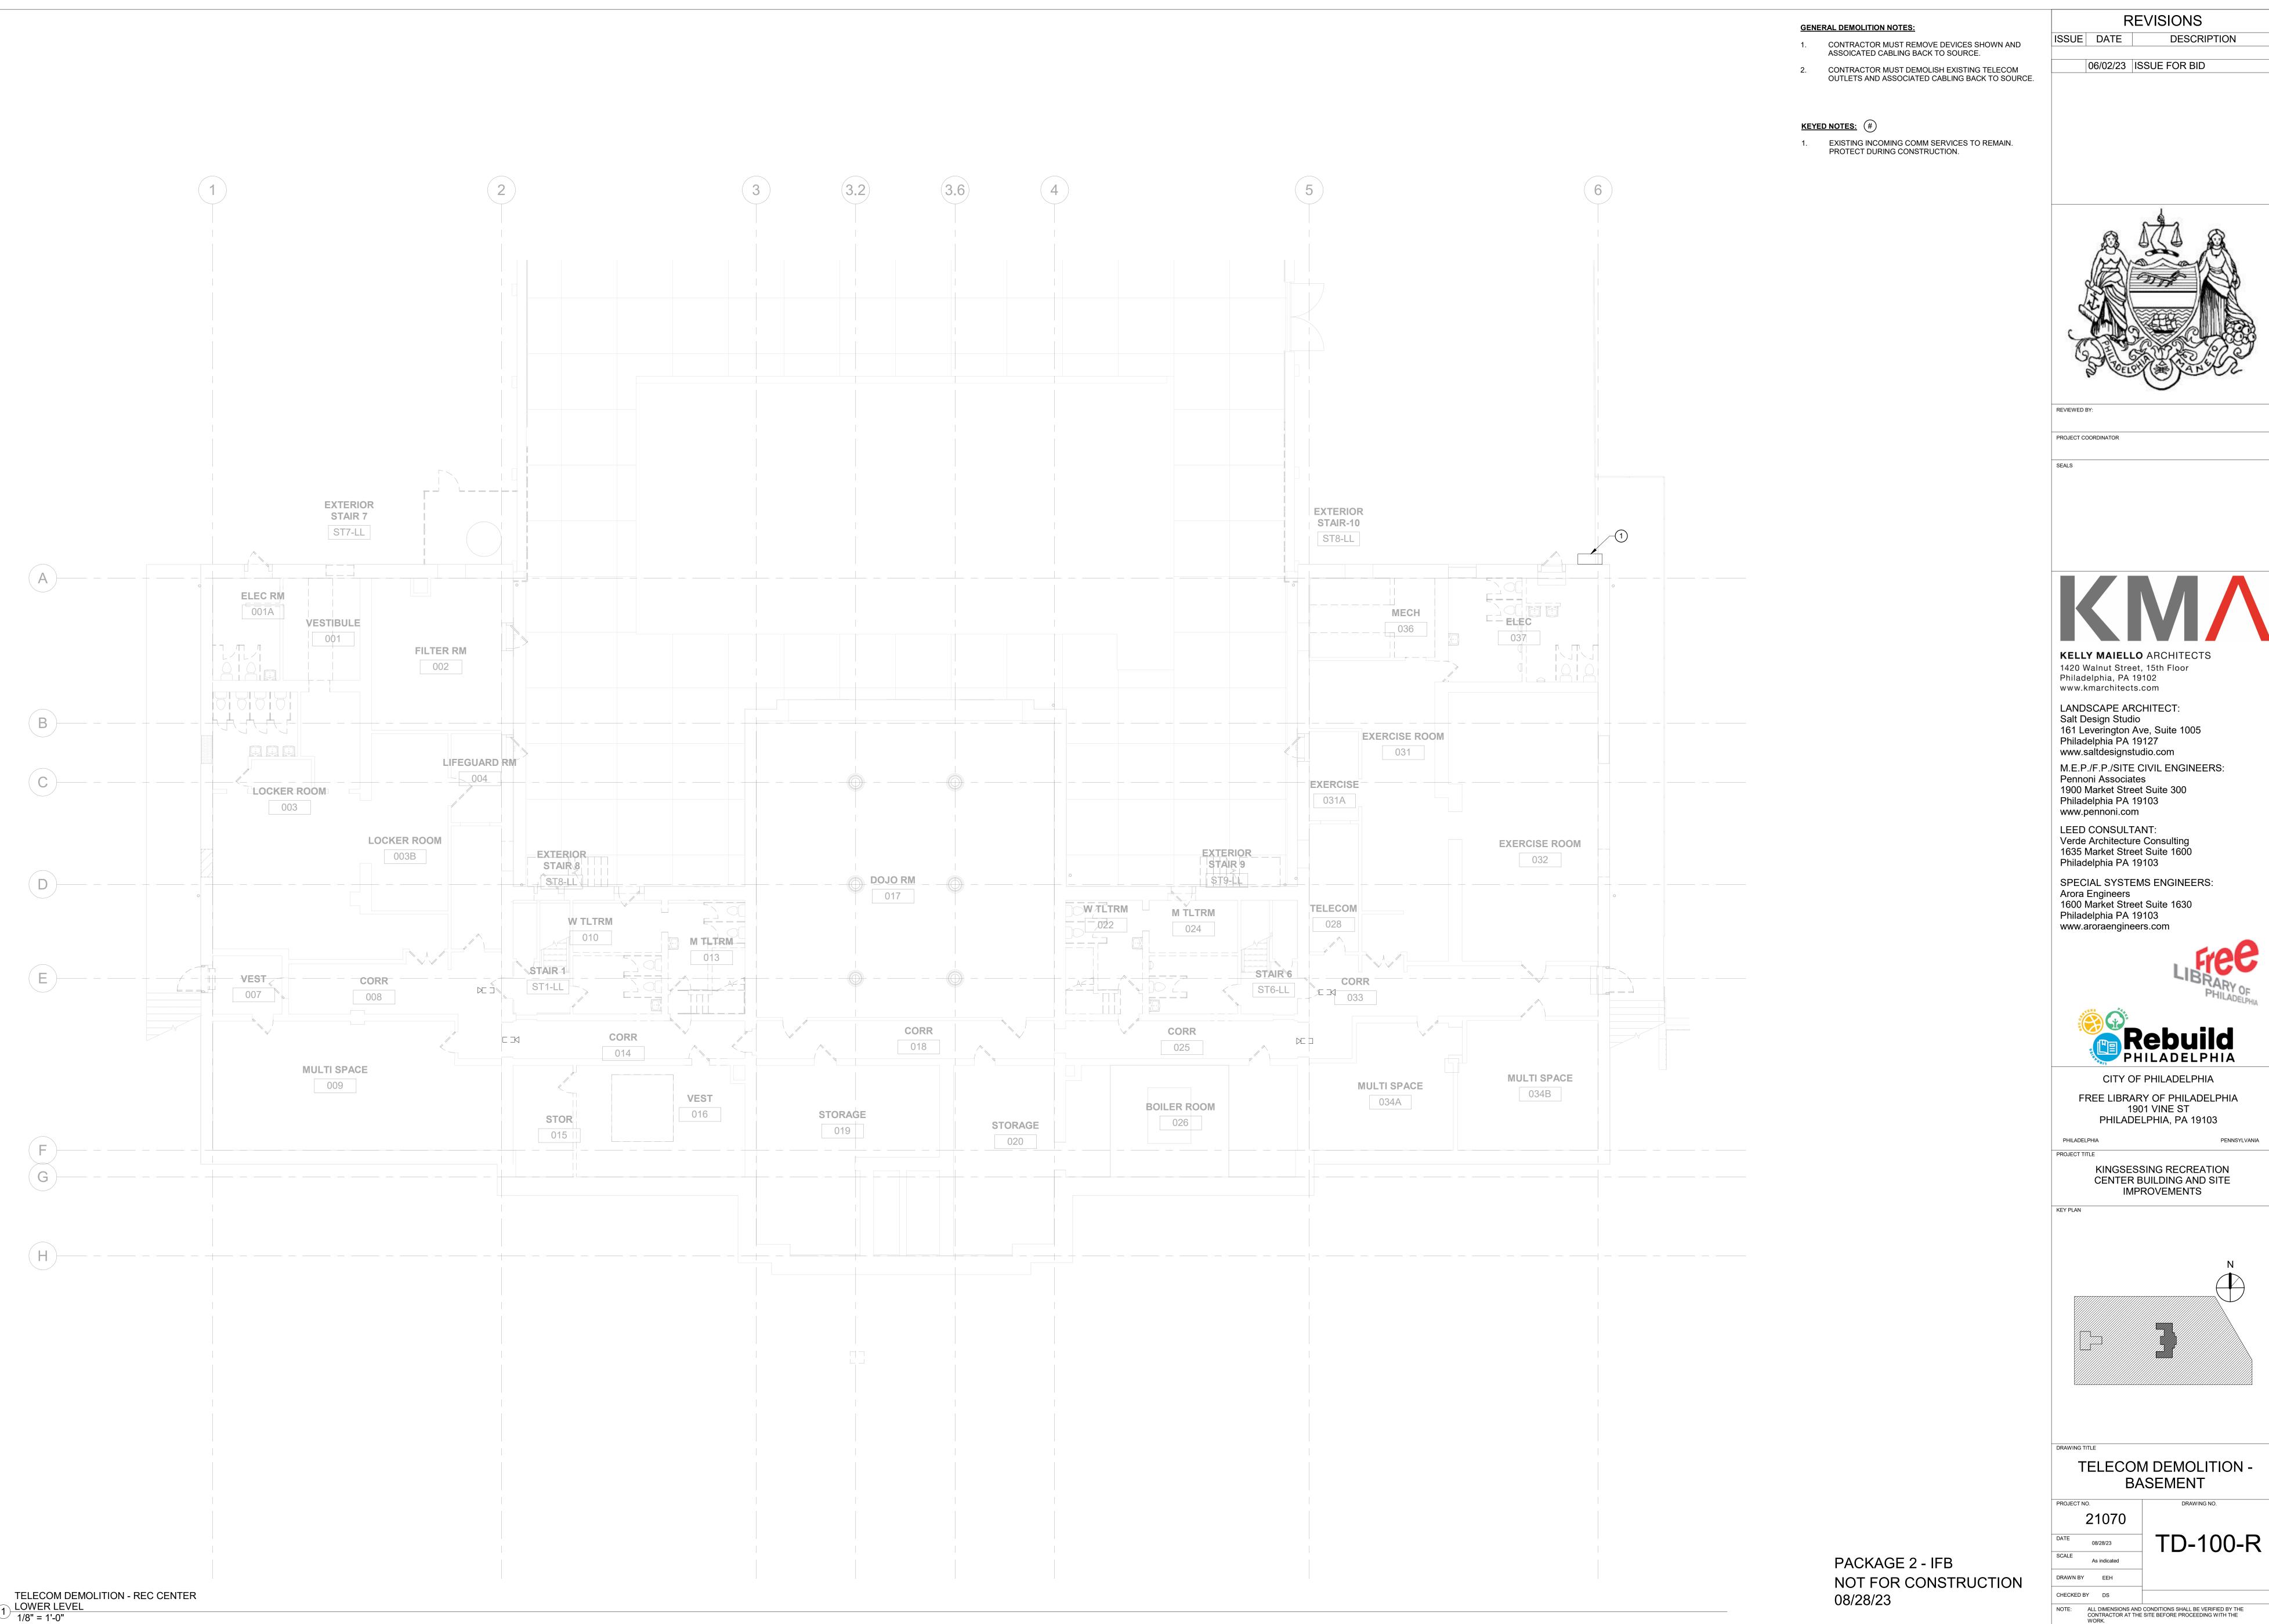




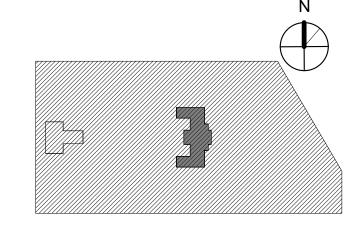

ALL DIMENSIONS AND CONDITIONS SHALL BE VERIFIED BY THE CONTRACTOR AT THE SITE BEFORE PROCEEDING WITH THE WORK.



TD-101-R ALL DIMENSIONS AND CONDITIONS SHALL BE VERIFIED BY THE CONTRACTOR AT THE SITE BEFORE PROCEEDING WITH THE WORK.

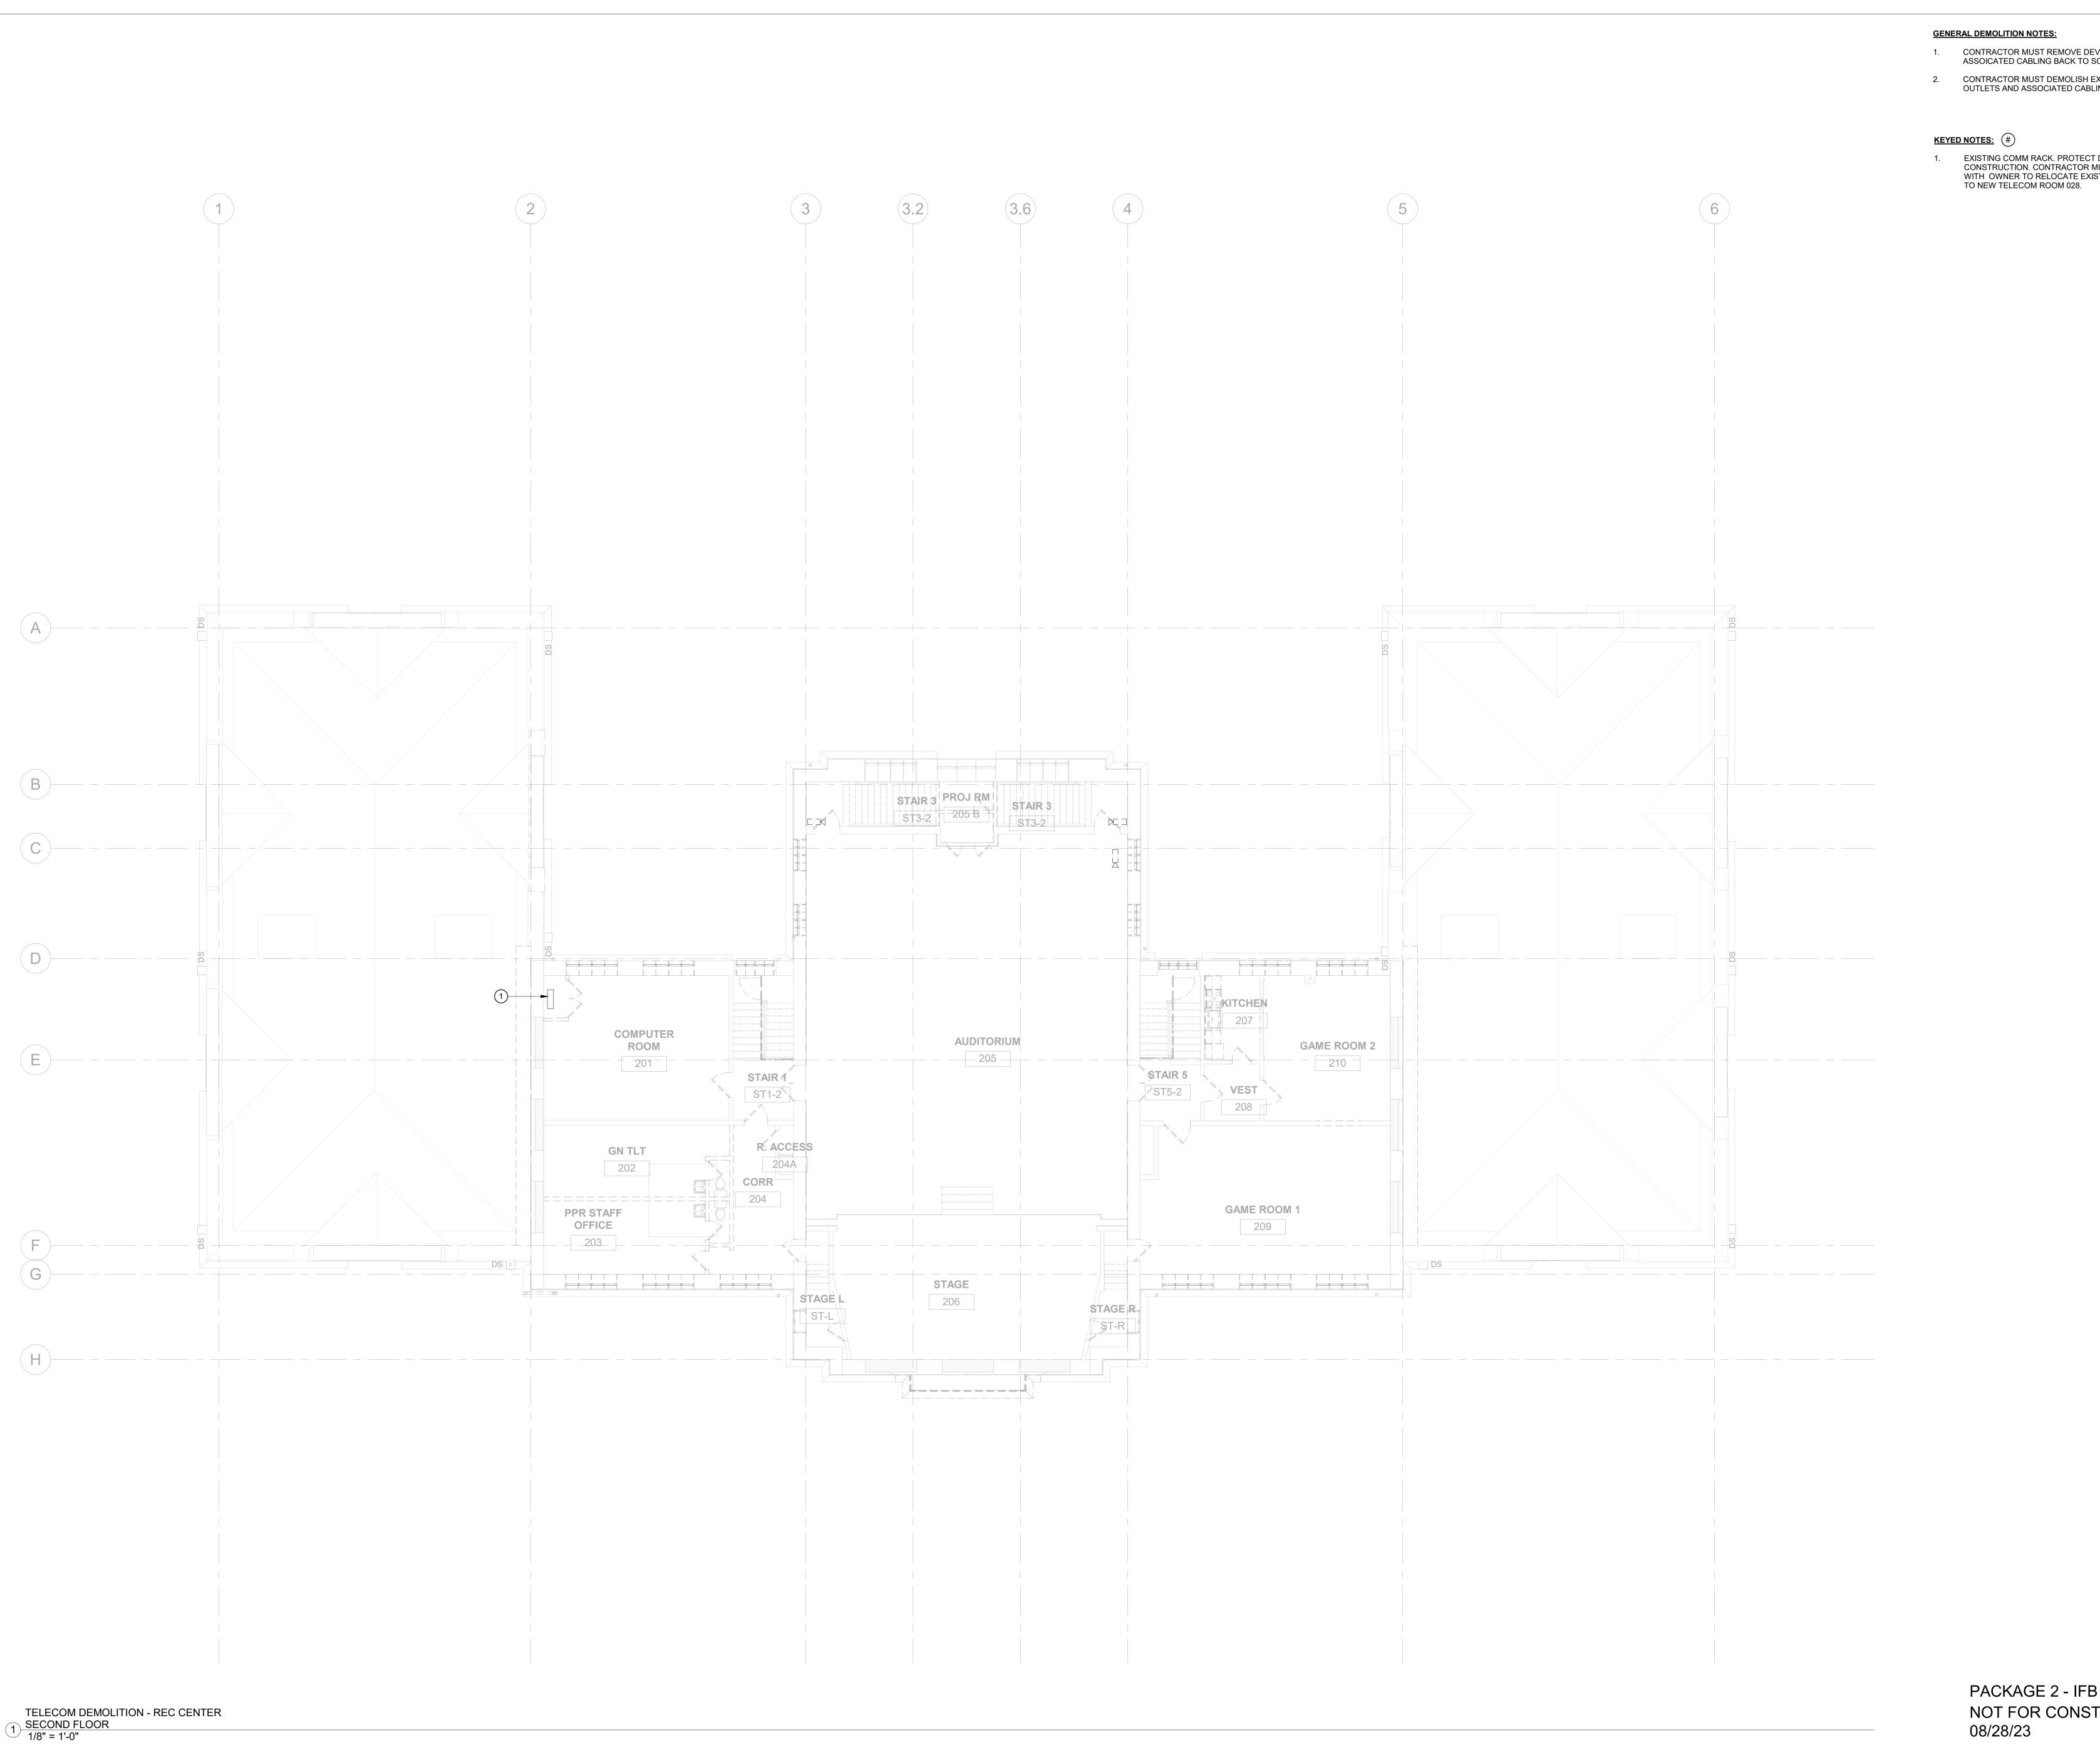

CONTRACTOR MUST REMOVE DEVICES SHOWN AND ASSOICATED CABLING BACK TO SOURCE.

CONTRACTOR MUST DEMOLISH EXISTING TELECOM OUTLETS AND ASSOCIATED CABLING BACK TO SOURCE.

ISSUE DATE

06/02/23 ISSUE FOR BID

**REVISIONS** 

DESCRIPTION

EXISTING COMM RACK. PROTECT DURING CONSTRUCTION. CONTRACTOR MUST COORDINATE WITH OWNER TO RELOCATE EXISTING EQUIPMENT TO NEW TELECOM ROOM 028.



REVIEWED BY:

PROJECT COORDINATOR



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LANDSCAPE ARCHITECT:

www.pennoni.com

LEED CONSULTANT: Verde Architecture Consulting 1635 Market Street Suite 1600 Philadelphia PA 19103

SPECIAL SYSTEMS ENGINEERS: Arora Engineers 1600 Market Street Suite 1630 Philadelphia PA 19103 www.aroraengineers.com




PHILADELPHIA CITY OF PHILADELPHIA

FREE LIBRARY OF PHILADELPHIA 1901 VINE ST PHILADELPHIA, PA 19103

KINGSESSING RECREATION CENTER BUILDING AND SITE IMPROVEMENTS

KEY PLAN

PHILADELPHIA

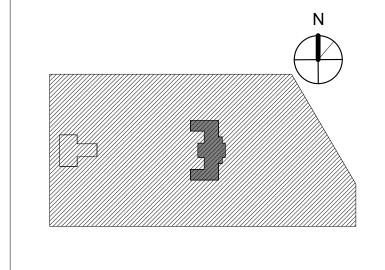

TELECOM DEMOLITION -SECOND FLOOR

TD-102-R 08/28/23 As indicated

DRAWN BY EEH

CHECKED BY DS ALL DIMENSIONS AND CONDITIONS SHALL BE VERIFIED BY THE CONTRACTOR AT THE SITE BEFORE PROCEEDING WITH THE WORK.

NOT FOR CONSTRUCTION

TELECOM DEMOLITION - REC CENTER

SITE PARTIAL PLAN

1/8" = 1'-0"

GENERAL DEMOLITION NOTES:

 CONTRACTOR MUST DEMOLISH EXISTING DEVICES SHOWN AND ASSOCIATED CABLING BACK TO SOURCE. REVISIONS

ISSUE DATE DESCRIPTION

06/02/23 ISSUE FOR BID

REVIEWED BY:

PROJECT COORDINATOR

**KELLY MAIELLO** ARCHITECTS 1420 Walnut Street, 15th Floor Philadelphia, PA 19102 www.kmarchitects.com

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1635 Market Street Suite 1600
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Arora Engineers
1600 Market Street Suite 1630
Philadelphia PA 19103
www.aroraengineers.com



CITY OF PHILADELPHIA


EE LIBRARY OF PHILADELPHIA

FREE LIBRARY OF PHILADELPHIA
1901 VINE ST
PHILADELPHIA, PA 19103

PHILADELPHIA
PROJECT TITLE

KINGSESSING RECREATION CENTER BUILDING AND SITE IMPROVEMENTS

KEY PLAN

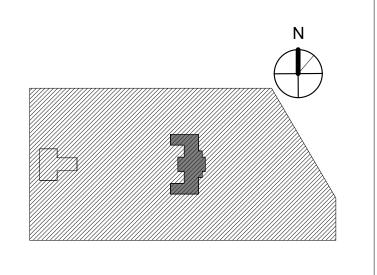

TELECOM DEMOLITION -SITE

PROJECT NO. 21070

SCALE

21070

08/28/23

TD-103-R

PACKAGE 2 - IFB NOT FOR CONSTRUCTION 08/28/23

DRAWN BY EEH

CHECKED BY DS

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