



CITY OF PHILADELPHIA DEPARTMENT OF PARKS & RECREATION

MAYOR - CHERELLE L. PARKER

COMMISSIONER - DEPARTMENT OF PARKS & RECREATION - SUSAN SLAWSON

RENOVATIONS TO THE HAPPY HOLLOW RECREATION CENTER

PROJECT NO. 16315E-03-02

4800 WAYNE AVENUE, PHILADELPHIA, PA 19144

CONSTRUCTION DOCUMENTS

Philadelphia, Pennsylvania 19103 215 985 4410

GROUND RECONSIDERED Philadelphia, PA 19123 215 790 0727

Philadelphia, PA 19106 215 925 0425

100 E Lancaster Avenue, Suite 203 Wayne, PA 19087 610 688 2566

DRAWING LIST

Chadds Ford, PA 19317 610 459 7900

BUILDING SECTIONS & ROOF TYPES

ROOFING CONSULTANT: STEVE MCLAUGHLIN ROOFING CONSULTANT Somerdale, NJ 08083 856 287 2424

PLUMBING

FIRE PROTECTION

FA-102

FA-500

ELECTRICAL DETAILS



ALTERNATES:

- 1. WAYNE AVENUE SIDEWALK **BASE SCOPE:** EXISTING TO REMAIN ADD ALTERNATE: DEMOLISH EXISTING CONCRETE PAVING. ADD NEW CONCRETE PAVING. REFER TO LANDSCAPE DRAWINGS. CLEAN AND JET EXISTING INLET AT BASKETBALL COURTS.
- 2. BASKETBALL COURTS **BASE SCOPE:** EXISTING TO REMAIN ADD ALTERNATE: MILL EXG ASPHALT PAVING AND OVERLAY WITH NEW ASPHALT TOPPING, PROVIDE NEW COURT MARKING. REFER TO LANDSCAPE DRAWINGS.
- 3. COMPUTER ROOM 102 AND GAMING ROOM 103 MILLWORK BASE SCOPE: DEMOLISH EXISTING MILLWORK AND EQUIPMENT PER DRAWINGS. PROVIDE NEW COUINTERTOP, CASEWORK, AND SHELVING AS DOCUMENTED. **DEDUCT ALTERNATE**: DEMOLISH EXISTING MILLWORK AND EQUIPMENT PER DRAWINGS, FINISH ALL WALL, CEILING, AND FLOOR PER SPECIFICATIONS.

		710.2	BOILDING OLOTIONO WINCOL THE LO
GENERAL	OOVED OUEST	A4.0	ENLARGED RESTROOM PLANS & INTERIOR ELEVATIONS
CS	COVER SHEET	A5.0	INTERIOR ELEVATIONS
ADOLUTEOTU	DAL	A5.1	CASEWORK DETAILS
ARCHITECTU		A6.0	REFLECTED CEILING PLANS
A0.1	GENERAL NOTES, ABBREVIATIONS, MATERIALS, REFERENCE SYMBOLS	A8.0	ROOF DETAILS
A0.2	BUILDING CODE INFORMATION	A8.1	BREEZEWAY ENLARGED PLAN & DETAILS
AU.2	BOILDING CODE INFORMATION	A9.0	DOOR SCHEDULE, TYPES & DETAILS
CIVIL		A9.1	WINDOW TYPES & DETAILS
C1.00	EXISTING SITE PLAN & INLET CLEANING	A9.2	FINISH PLANS & SCHEDULE, SIGNAGE
C1.00	PLAN	A10.0	INTERIOR DETAILS
C1.01	SIDEWALK SITE PLAN	A10.0	INTERIOR DETAILS
C1.02	SIDEWALK GRADING PLAN	STRUCTURA	
C1.03	UTILITY PLAN	S1.0	STRUCTURAL DETAILS
C5.00	SIDEWALK CONSTRUCTION DETAILS	S1.0 S1.1	
CE1.01	EROSION AND SEDIMENT CONTROL PLAN	31.1	GENERAL NOTES
CE5.01	EROSION AND SEDIMENT CONTROL	MECHANICAL	
CL3.01	DETAILS	MECHANICAL	
CE7.01	EROSION AND SEDIMENT CONTROL	M-001	MECHANICAL GENERAL NOTES, SYMBOLS AND ABBREVIATIONS
027.01	NOTES	MD-101	MECHANICAL DEMOLITION BASEMENT
		IVID-101	PLAN
LANDSCAPE		MD-102	MECHANICAL DEMOLITION FIRST FLOOR
L1.0	DEMOLITION AND PROTECTION PLAN	102	PLAN
L2.0	MATERIALS PLAN	MD-103	MECHANICAL DEMOLITION ROOF PLAN
L2.1	MATERIALS PLAN	M-101	MECHANICAL BASEMENT PLAN
L3.0	LAYOUT PLAN	M-102	MECHANICAL FIRST FLOOR PLAN
L3.1	LAYOUT PLAN	M-103	MECHANICAL ROOF PLAN
L3.2	LAYOUT PLAN PLAY & SPRAY EQUIPMENT	M-500	MECHANICAL DETAILS
L3.3	LAYOUT PLAN - JOINTING & SAFETY	M-600	MECHANICAL SCHEDULES
L0.0	SURFACE	M-601	MECHANICAL SCHEDULES
L4.0	GRADING PLAN	W 001	MEGINATO LE GOTTE GELEG
L5.0	PLANTING PLAN	ELECTRICAL	
L6.0	SITE DETAILS	E-001	ELECTRICAL GENERAL NOTES, SYMBOLS
L6.1	SITE DETAILS	L-001	AND ABBREVIATIONS
L6.2	SITE DETAILS	ED-101	ELECTRICAL DEMOLITION BASEMENT
L6.3	SITE DETAILS	25 .0.	POWER PLAN
L6.4	SITE DETAILS	ED-102	ELECTRICAL DEMOLITION FIRST FLOOR
L6.5	SITE DETAILS		POWER AND SECURITY PLAN
L6.6	PLANTING DETAILS	ED-201	ELECTRICAL DEMOLITION BASEMENT LIGHTING PLAN
ARCHITECTU	RAL	ED-202	ELECTRICAL DEMOLITION FIRST FLOOR LIGHTING PLAN
D2.0	BASEMENT DEMOLITION PLAN	E-101	ELECTRICAL POWER BASEMENT PLAN
D2.1	FIRST FLOOR DEMOLITION PLAN	E-102	ELECTRICAL POWER AND SECURITY FIRS
D2.2	ROOF DEMOLITION PLAN		FLOOR PLAN
D3.0	DEMOLITION ELEVATIONS	E-201	ELECTRICAL LIGHTING BASEMENT PLAN
D3.1	DEMOLITION ELEVATIONS	E-202	ELECTRICAL LIGHTING FIRST FLOOR PLAI
A2.0	BASEMENT PLAN	E-501	ELECTRICAL SINGLE LINE DIAGRAM
A2.1	FLOOR PLAN, EXTERIOR & INTERIOR WALL TYPES	E-502	DEMOLITION ELECTRICAL SINGLE LINE DIAGRAM NEW
A2.2	ROOF PLAN	L-302	WORK
	EXTERIOR ELEVATIONS & DETAIL	E-601	ELECTRICAL LUMINAIRE SCHEDULE
A3.0	EVIEDIOUS ELEVATIONS & DETAIL		

PLUMBING, GENERAL NOTES, SYMBOLS AND ABBREVIATIONS	COMMISSIONER/PARKS AND RECF	REATION
PLUMBING DEMOLITION BASEMENT PLAN		
PLUMBING DEMOLITION FIRST FLOOR PLAN	DEPUTY COMMISSIONER/CAPITAL	PROJECTS
PLUMBING DEMOLITION ROOF PLAN		
PLUMBING SITE PLAN	PROJECT DIRECTOR	
PLUMBING BASEMENT PLAN		
PLUMBING FIRST FLOOR PLAN		
PLUMBING ROOF PLAN		
PLUMBING ENLARGED PLANS		
PLUMBING RISER DIAGRAMS		
PLUMBING DETAILS		
PLUMBING DETAILS		
PLUMBING SCHEDULES		
ON		
FIRE ALARM GENERAL NOTES, SYMBOLS AND ABBREVIATIONS		
FIRE ALARM DEMOLITION BASEMENT PLAN	SEALS	William trees
FIRE ALARM DEMOLITION BASEMENT FLAN	SHIPTERE	D ARCHINE
PLAN	State Charles	SYLVASO
FIRE ALARM BASEMENT PLAN	S. O. O. C.	
FIRE ALARM FIRST FLOOR PLAN		
FIRE ALARM DETAILS	1 500000	
FIRE ALARM DETAILS	10:80 O	四川 / 原: 大員
FIRE ALARM DETAILS, SCHEDULES AND	10000	
RISER DIAGRAM	The Constitution of the Co	SON CONTRACTOR
	mount	O NO. Programme
		internation
	CITY OF PH	IILADELPHIA
	DEPARTMENT OF PA	ARKS AND RECREATION
	1515 ADO	CH STREET
		PARKWAY BUILDING
	PHILADELPHIA	PENNSYLVANIA
	PROJECT NO.	DRAWING NO.
	16315E-03-02	
	DATE 05/13/2025	CS-1
	SCALE AS NOTED	00-1
	DRAWN BY JS/SCR	
	CHECKED BY SCR	FILE:F:\CPOFORMS\PREDESIGN\24x36DWGS
	NOTE: ALL DIMENSIONS AND COND	ITIONS SHALL BE VERIFIED BY THE
		BEFORE PROCEEDING WITH THE WORK

PROJECT APPROVED

- DO NOT SCALE DRAWINGS.
- 2. THE CONTRACTOR SHALL OBTAIN ALL REQUIRED PERMITS PRIOR TO THE START OF CONSTRUCTION.
- 3. THE CONTRACTOR SHALL COMPLY WITH ALL FEDERAL, STATE AND LOCAL REGULATIONS. CODES AND ORDINANCES.
- 4. THE CONTRACTOR SHALL CONFIRM, LOCATE AND COORDINATE WORK WITH HIDDEN MECHANICAL, PLUMBING AND ELECTRICAL CONDITIONS.
- 5. THE CONTRACTOR SHALL BE RESPONSIBLE FOR ANY DAMAGE TO THE EXISTING BUILDING. SITE AND EQUIPMENT DURING CONSTRUCTION, INCLUDING DAMAGE FROM THE ELEMENTS. THE CONTRACTOR SHALL EXERCISE CARE SO AS NOT TO DAMAGE EXISTING BUILDING DURING CONSTRUCTION. THE CONTRACTOR SHALL REPAIR ANY DAMAGE IMMEDIATELY AND TO THE SATISFACTION OF THE OWNER.
- 6. THE CONTRACTOR SHALL VERIFY EXISTING CONDITIONS AND DIMENSIONS ON THE JOB SITE. IF EXISTING CONDITIONS DO NOT PERMIT INSTALLATION OF WORK IN ACCORDANCE WITH THE DRAWINGS AND SPECIFICATIONS, NOTIFY THE ARCHITECT AND PROVIDE A SKETCH OF THE CONDITION.
- 7. (RESERVED)
- 8. THE CONTRACTOR SHALL COORDINATE LOCATION AND SIZE OF ALL OPENINGS WITH ALL TRADES PRIOR TO INSTALLATION.
- 9. DETAILS SHOWN ARE INTENDED FOR SPECIFIC LOCATIONS AND CONDITIONS. MINOR MODIFICATIONS MAY BE REQUIRED TO SUIT SIMILAR CONDITIONS AND SHALL BE CONSIDERED PART OF THE WORK.
- 10. UNLESS OTHERWISE INDICATED ON THE DRAWINGS OR IN THE SPECIFICATIONS AS BEING NIC, ALL ITEMS, MATERIALS, ETC. AND INSTALLATION OF SAME ARE A PART OF THE CONTRACT WORK.
- 11. THE GENERAL CONTRACTOR SHALL COORDINATE ALL SLEEVING WORK, UNO. COORDINATE LOCATION AND SIZE OF ALL OPENINGS, INTERIOR AND/OR EXTERIOR WITH ALL TRADES PRIOR TO INSTALLATION.

GENERAL RENOVATION NOTES:

- 1. PERFORM DISASSEMBLY AND REMOVALS IN A CONTROLLED MANNER; WITHOUT UNNECESSARY CUTS; WITHOUT DAMAGE TO THE SITE, STRUCTURE OR FEATURES; WITHOUT DAMAGE TO THE MATERIALS OR CONSTRUCTION TO
- 2. PROMPTLY RESTORE, REPLACE, OR REINSTALL ANY ITEMS DEMOLISHED WHERE NOT SCHEDULED TO BE DEMOLISHED, OR DAMAGED BY ANY DEMOLITION/CONSTRUCTION ACTIVITIES AT NO ADDITIONAL COST TO THE OWNER. SECURE A/E APPROVAL PRIOR TO CONDUCTING REMEDIAL WORK.
- 3. REPRESENTATIVE DETAILS, PROFILES, AND DIMENSIONS NOTED ARE APPROXIMATE. FIELD VERIFY EXISTING CONDITIONS, DIMENSIONS, AND ASSEMBLIES PRIOR TO PREPARING SHOP DRAWINGS.
- 4. ALL EXISTING OPENINGS AND PENETRATIONS THAT ARE ABANDONED SHALL BE PATCHED AND REPAIRED. ALL PATCH AND REPAIR WORK SHALL BE PERFORMED USING MATERIALS THAT MATCH THE EXISTING ADJACENT CONSTRUCTION IN LIKE AND KIND. WHERE PATCHING IS REQUIRED IN MASONRY PARTITIONS. MASONRY SHALL BE TOOTHED IN TO MATCH.

DIMENSIONING:

- 1. FIELD VERIFY ALL DIMENSIONS AND REPORT ANY DISCREPANCIES TO THE ARCHITECT PRIOR TO THE COMMENCEMENT OF WORK.
- 2. INTERIOR DIMENSIONS ARE TO FINISH FACE OF WALL OR NOMINAL THICKNESS MASONRY THICKNESS UNLESS NOTED OTHERWISE. REFER TO PARTITION TYPES AND PLAN DETAILS FOR MORE INFORMATION.
- 3. EXTERIOR DIMENSIONS ARE NOMINAL UNLESS NOTED OTHERWISE.
- 4. OPENING DIMENSIONS IN BRICK/CMU/PLASTER PARTITIONS ARE TO NOMINAL MASONRY OPENING.
- 5. ALL FINISH FLOOR HEIGHTS ARE TO BE VERIFIED IN FIELD. CONTRACTOR TO COORDINATE THE ALIGNMENT OF EXISTING AND NEW FINISH FLOOR HEIGHTS.

GENERAL PRESERVATION NOTES:

- 1. THE PROJECT INVOLVES THE RENOVATION OF HISTORIC STRUCTURES AND SHALL BE TREATED RESPECTFULLY. EXISTING BUILDING ELEMENTS SHALL BE CAREFULLY HANDLED AND PROTECTED. NO EXISTING MATERIAL OR ELEMENT SHALL BE REMOVED OR ALTERED UNLESS SPECIFICALLY INDICATED ON THE DRAWINGS OR DIRECTED BY THE ARCHITECT.
- 2. PRESERVATION OF THE HISTORIC STRUCTURE: THE WORK CONSISTS OF RESTORATION OF AN HISTORIC STRUCTURE LISTED ON THE LOCAL REGISTER OF HISTORIC PLACES. EXERCISE EXTREME CARE IN ALL ASPECTS OF THE WORK TO CONSERVE, PRESERVE, AND PROTECT THE EXISTING STRUCTURE. DO NOT USE METHODS WHICH WILL RESULT IN UNNECESSARY LOSS OF DETAIL OR MATERIAL FROM THE EXISTING STRUCTURE. IF IN DOUBT, CONTACT THE A/E FOR
- 3. THE WORK SHALL BE COMPLETED IN COMPLIANCE WITH THE UNITED STATES SECRETARY OF THE INTERIOR'S STANDARDS FOR THE TREATMENT OF HISTORIC PROPERTIES (REVISED 1995). STRICT COMPLIANCE WITH THE DRAWINGS AND SPECIFICATIONS IS REQUIRED TO ASSURE COMPLIANCE OF THE WORK WITH THESE STANDARDS.
- 4. STRUCTURAL STABILITY AND SAFETY: DO NOT SECURE SCAFFOLDING, PLATFORMS, LADDERS, MATERIALS OR EQUIPMENT TO THE EXISTING STRUCTURE PRIOR TO REVIEW BY THE A/E.
- 5. CONCEALED CONDITIONS: BECAUSE EVIDENCE IS CONCEALED BY EXTANT EXTERIOR SURFACES, QUESTIONS MAY REMAIN WITH REGARD TO THE ORIGINAL CONSTRUCTION OF THE BUILDING. THE A/E AND OWNER WILL OBSERVE CURRENTLY CONCEALED SURFACES AFTER THEY HAVE BEEN REVEALED BY SELECTIVE DEMOLITION. THE CONTRACTOR SHALL PLAN AND PROVIDE FOR TIMELY NOTIFICATION TO THE A/E AND OWNER WHEN MANDATORY OBSERVATION AREAS ARE UNCOVERED SO THAT WORK IS NOT DELAYED. DO NOT PROCEED WITH WORK UNTIL A/E AND OWNER OBSERVATION HAS BEEN PERFORMED AND FURTHER WORK HAS BEEN RELEASED BY THE A/E AND
- 6. FIRE HAZARDS AND FIRE PREVENTIONS: SMOKE WITHIN, ON OR NEAR THE STRUCTURE IS NOT PERMITTED. BURNING, CUTTING, WELDING, BRAZING, OR OPEN FLAMES WITHIN, OR ON, THE STRUCTURE IS NOT PERMITTED UNLESS NOTED OTHERWISE. POST AND MAINTAIN A FIRE-WATCH DURING SOLDERING WORK. MAINTAIN THE FIRE WATCH FOR A MINIMUM OF THREE HOURS AFTER CESSATION OF SOLDERING. DO NOT PERMIT STORAGE OF MATERIALS OR WASTE IN THE BUILDING. IMMEDIATELY REMOVE ALL WASTE FROM THE BUILDING AT THE END OF EACH WORK DAY. DO NOT STORE FLAMMABLE MATERIALS IN OR NEAR THE STRUCTURE.
- 7. MAINTAIN A PROGRAM OF FIRE PREVENTION FOR DEMOLITION AND CONSTRUCTION OPERATIONS FOR THE DURATION OF WORK, INCLUDING APPROPRIATE FIRE EXTINGUISHERS IN COMPLIANCE WITH NFPA 241. PROVIDE FOR NOTIFICATION TO THE FIRE DEPARTMENT IN THE EVENT OF FIRE. MAINTAIN CLEAR ACCESS ON ROADS AND AROUND THE STRUCTURE AT ALL TIMES.
- 8. EXISTING CONDITIONS AND LAYOUT: DATA ON EXISTING CONDITIONS INDICATED IN THE DRAWINGS, SPECIFICATIONS ARE AS EXACT AS COULD BE SECURED BUT THEIR ABSOLUTE ACCURACY IS NOT GUARANTEED. THE EXACT LOCATIONS, DISTANCES, LEVELS AND OTHER CONDITIONS WILL BE GOVERNED BY ACTUAL CONSTRUCTION (VISIBLE OR CONCEALED) AND THE EXACT LOCATION OF EXISTING FEATURES. THE DRAWINGS AND DETAILS ARE TO BE USED FOR GUIDANCE IN SUCH REGARD.
- 9. DETRIMENTAL (UNFORESEEN) CONDITIONS: EXAMINE THE AREAS AND CONDITIONS UNDER WHICH THIS WORK WILL BE PERFORMED. NOTIFY HE A/E IF UNSOUND OR UNSAFE CONDITIONS ARE ENCOUNTERED/EXPOSED AND OBTAIN A/E DIRECTION. CORRECT CONDITIONS IN A TIMELY MANNER. DO NOT PROCEED UNTIL UNSOUND OR UNSAFE CONDITIONS ARE CORRECTED.
- 10. MOCKUPS OF THE WORK: CONSTRUCT MOCKUPS AND SECURE ACCEPTANCE OF MOCKUPS FROM THE A/E AND OWNER PRIOR TO PROCEEDING WITH PORTIONS OF THE WORK, AS DESCRIBED IN THE SPECIFICATIONS. DO NOT PROCEED ITH THE WORK IN OTHER AREAS UNTIL THE MOCKUPS HAVE BEEN ACCEPTED. SELECTED MOCKUPS MAY BE INCORPORATED INTO THE FINAL WORK ONLY AFTER APPROVAL BY A/E AND OWNER.
- 11. OBSERVATIONS OF THE WORK: THE CONSTRUCTION DOCUMENTS DESCRIBE POINTS DURING THE WORK AT WHICH THE OBSERVATION OF THE A/E AND OWNER IS REQUIRED BEFORE WORK MAY PROCEED. PLAN AND PROVIDE FOR THE TIMELY NOTIFICATION TO THE A/E AND OWNER WHEN MANDATORY OBSERVATION POINTS WILL BE REACHED SO THAT WORK IS NOT DELAYED. DO NOT PROCEED WITH WORK UNTIL OBSERVATION IS COMPLETE AND FURTHER WORK HAS BEEN RELEASED BY THE A/E AND OWNER.

CONCRETE

SLATE

MEDIUM DENSITY

FIBERBOARD

ALUMINUM

(LARGE SCALE)

FIBER CEMENT BD

SPRAY APPLIED

INSUL

PLASTER.

GWB, GROUT

CUT STONE

BATT/LOOSE

MINERAL WOOL

(SMALL SCALE)

INSULATION

GLASS

FILL/INSUL

MATERIAL SYMBOLS:

STONE

BRICK

PLYWOOD

STEEL

ROUGH

CARPENTRY

RIGID INSUL

(SMALL SCALE)

(LARGE SCALE)

(SMALL SCALE)

EARTH

CMU

BLOCKING

STEEL

FINISH

CARPENTRY

RIGID INSUL

(LARGE SCALE)

(LARGE SCALE)

ABBREVIATIONS:

ADJ

AFF

AGG

ALCW

ALSF

ANOD

APPROX

ARCH

B&B

BD

BCAB

BLDG

BLKG

BLW

B.O.

BRK

BTW

CAB

CB

CERT

CFMF

CJ

CL

CLG

CMU

COL

COMP

CONC

CONT

COR

CPT

CUH

CW

DEMO

DIA

DN

DR

DS

DTL

ELEC

ELEV

EMER

EP

EPX

ETR

EXG

EXT

DWG(S)

CT

COORD

ALW

AL(ALUM)

ARCHITECT/ENGINEER

ACOUSTIC CEILING TILE

ADJACENT/ADJUSTABLE

ALUMINUM CURTAINWALL

ALUMINUM STOREFRONT

ALUMINUM WINDOW

ABOVE FINISH FLOOR

ANCHOR BOLT

AGGREGATE

ALUMINUM

ANODIZED

ACCESS PANEL

ARCHITECTURAL

BOARD AND BATTEN

BROADLOOM CARPET

APPROXIMATE

BASE CABINET

BOARD

BELOW

BRICK

BETWEEN

CABINET

CERTIFIED

CENTERLINE

CLEAR/ CLEARANCE

CONCRETE MASONRY UNIT

CEILING

COLUMN

COMPOSITE

CONCRETE

CONTINUOUS

COORDINATE

CARPET TILE

CORRUGATED

CERAMIC TILE

CURTAINWALL

DIAMETER

DOWN

DOOR

DETAIL

EAST

EACH

DIMENSION

DOWNSPOU⁻

DRAWING(S)

ELEVATION

ELECTRICAL

EMERGENCY

EQUIPMENT

EXPOSED

EXISTING

EXTERIOR

ELEVATOR

FPOXY

EQUAL

EXPANSION JOINT

ELECTRICAL PANEL

EXPOSED STRUCTURE

ELECTRIC WATER COOLER

EXISTING TO REMAIN

CABINET UNIT HEATER

DEMOLISH/DEMOLITION

CEMENTBOARD

COLD FORMED METAL FRAMING


CONSTRUCTION/CONTROL JOINT

BUILDING

BLOCKING

BOTTOM OF

ABOVE

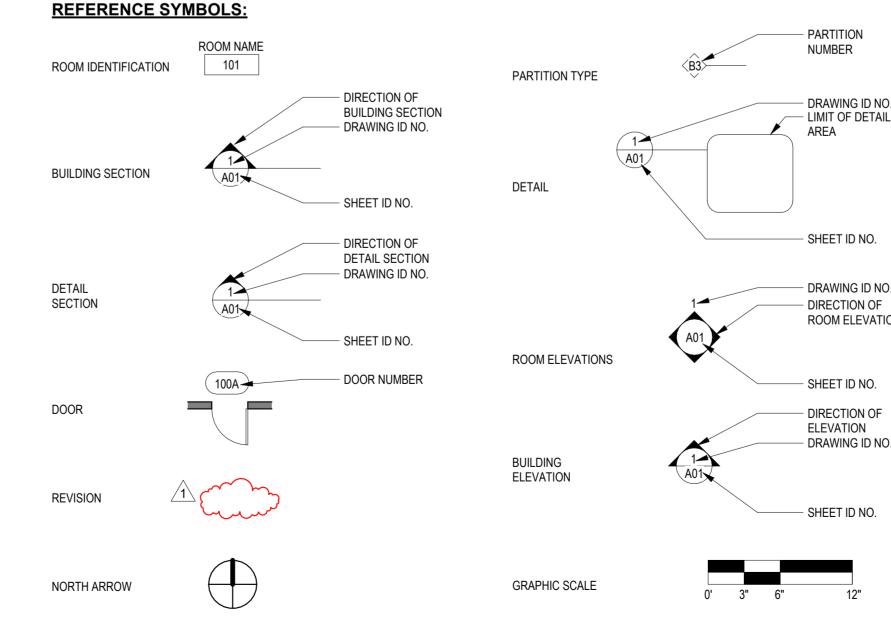

GF **GROUND FACE** GLAZ GLAZED, GLAZING, GLASS GRG GLASS REINFORCED GYPSUM **GWB** GYPSUM WALLBOARD **HDPE** HIGH DENSITY POLYETHYLENE HOLLOW METAL HOR HORIZONTAL HOUR **HRWD** HARDWOOD HSS HOLLOW STEEL SECTION HEIGHT **HVAC** HEAVING/VENTILATION/AIR CONDITIONING HWH HOT WATER HEATER INSULATED GLAZING UNIT IGU INCL INCLUDING/INCLUDED INFO INFORMATION INSUL INSULATED, INSULATION INTERIOR **JOINT** LAMINATED LAM LINEAR FEET LINOLEUM LLV LONG LEG VERTICAL LTL LINTEL LIGHT LOUV LOUVER MAS MASONRY MAS DIM MASONRY DIMENSION MATL MATERIAL **MAXIMUIM** MDF MEDIUM DENSITY FIBERBOARD **MECH MECHANICAL** MFR MANUFACTURE MGP MARINE GRADE PLYWOOD MIN MINIMUM M.O. MASONRY OPENING MR MOISTURE RESISTANT MTD MOUNTED MTL METAL MULL MULLION NORTH **NOT APPLICABLE** NATURAL NOT IN CONTRACT NIC NOM NOMINAL NTS NOT TO SCALE 0 ON CENTER OC OWNER FURNISHED EQUIPMENT OFE ОН OPPOSITE HAND

FIRE ALARM

FAN COIL UNIT

FLOOR DRAIN

FINISH(ED)

FLASHING

FACE OF

FOOTING

GAUGE

FLOOR(ING)

FOUNDATION

FILLER PANEL

FOOT (FEET)

GALVANIZED

FIN TUBE RADIATOR

FACTORY FINISH

FIBER CEMENT BOARD

FIRE EXTINGUISHER CABINET

FINISHED FLOOR ELEVATION

FCB

FCU

FEC

FF

FFE

FIN

FLG

FLR

FND

F.O.

FP

FT

FTG

FTR

GΑ

GALV

OPP

OPG

OSB

OTLN

OPPOSITE

OPENING

OUTLINE

ORIENTED STRAND BOARD

RB **RUBBER BASE** RBT RCP **RUBBER STAIR TREAD** REFLECTED CEILING PLAN RD **ROOF DRAIN** REF REFER; REFERENCE REQ'D REQIURED **REV** REVISION, REVISE(D) RSF RESILIENT FLOORING RESILIENT TILE FLOORING R.O. **ROUGH OPENING** RTF RESILIENT RUBBER TILE FLOORING **RWC** RAINWATER CONDUCTOR SUPPLY AIR SELF ADHERING UNDERLAYMENT SBC SINK BASE CABINET SBO SUPPLIED BY OTHERS SFI SPRAY FOAM INSULATION SGT STRUCTURAL GLAZED TILE SIM SIMII AR SIP STRUCTURAL INSULATED PANEL SLOPED/SLOPE SOG SLAB ON GRADE SSTL STAINLESS STEEL STD STANDARD STL STEEL STN STAIN(ED) STRUC STRUCTURAL SUSP SUSPENDED TER TERRAZZO TRANSPARENT FINISH THK **THICKNESS** TLT TOILET **TPTN TOILET PARTITION** T.O. TOP OF TYP **TYPICAL** T&G **TONGUE AND GROOVE UNLESS NOTED OTHERWISE** UNO VAR VARIES/VARIOUS **VERT** VERTICAL **VEST VESTIBULE** VIF **VERIFY IN FIELD** VTR **VENT THROUGH ROOF WEST** WITH W/O WITHOUT WALL BASE WC WATER CLOSET **WCAB** WALL CABINET WD WOOD WDP

PRECAST ARCHITECTURAL CONCRETE

PERFORATED

PLASTER

PANELING

PAINT(ED)

POLISHED

PARTITION

PLYWOOD

PIPE VENT

RETURN AIR

RADIUS

PROJECTION

PRESSURE TREATED

PORCELAIN TILE

PANFI

PLASTIC LAMINATE

PERF

PLAM

PLAS

PNLG

PNT

POL

P.T.

PTN

PWD

PV

RAD

RT

WF

WIN

WOM

WSCT

XPS

PARTITION

DRAWING ID NO.

SHEET ID NO.

DRAWING ID NO.

DIRECTION OF

SHEET ID NO.

DIRECTION OF

ELEVATION DRAWING ID NO.

SHEET ID NO.

ROOM ELEVATION

NUMBER

AREA

PT

PROJ

PNL

WOOD PANEL WIDE FLANGE **WINDOW** WALK OFF MAT WAINSCOT EXTRUDED POLYSTYRENE

1ST FLOOR EL 0'-0"

(1)

DATUM ELEVATION

SPOT ELEVATION

REFERENCE GRID

WINDOW TAG

LOUVER TAG

KEYED NOTE

BREAKLINE

CONSTRUCTION DOCUMENTS

REVISIONS

REVISIONS

ISSUE

PROJECT COORDINATOR

LEEANN SUEN



SMPARCHITECTS 1600 Walnut Street, 2nd Floor Philadelphia, Pennsylvania 19103 215 985 4410

LANDSCAPE ARCHITECT: **GROUND RECONSIDERED** www.groundreconsidered.com

215 790 0727 **CIVIL ENGINEER KS ENGINEERS** www.kseng.com

610 688 2566

215 925 0425 STRUCTURAL ENGINEER: ANN ROTHMANN STRUCTURAL ENGINEERING arstructural.com

MEP ENGINEER: **ARORA ENGINEERS** www.aroraengineers.com 610 459 7900

ROOFING CONSULTANT: STEPHEN McLAUGHLIN ROOFING CONSULTANT stevemclaughlin.biz 856 287 2424

CITY OF PHILADELPHIA **DEPARTMENT OF PARKS & RECREATION**

1515 ARCH STREET 11TH FLOOR, ONE PARKWAY BUILDING

PROJECT TITLE RENOVATIONS TO THE HAPPY HOLLOW RECREATION CENTER

DRAWING TITLE

GENERAL NOTES, ABBREVIATIONS, MATERIALS. REFERENCE SYMBOLS

PROJECT NO. 16315E-03-02 05/13/2025 AS NOTED DRAWN BY JS/SCR CHECKED BY

PROJECT INFORMATION: RENOVATIONS TO THE HAPPY HOLLOW RECREATION CENTER THE CITY OF PHILADELPHIA, DEPARTMENT OF PARKS AND RECREATION 1515 ARCH STREET, 11TH FLOOR, ONE PARKWAY BUILDING PHILADELPHIA, PA 19104 CODES REFERENCED: PHILADELPHIA EXISTING BUILDING CODE (IEBC 2018) PHILADELPHIA BUILDING CODE (IBC 2018) PHILADELPHIA PLUMBING CODE (IPC 2018) ACCESSIBLE AND USEABLE BUILDINGS AND FACILITIES 2017 OF PHILADELPHIA (A117.1, 2017)

IEBC CHAPTER 6: CLASSIFICATION OF WORK PROPOSED WORK IS ALTERATION LEVEL 2 TOTAL WORK AREA: 424 SQFT

CODE SUMMARY (ALL REFERENCES TO IBC 2018 UNO):

IEBC CHAPTER 8: ALTERATIONS - LEVEL 2 810.1 ENERGY CONSERVATION

LEVEL 2 ALTERATIONS TO EXISTING BUILDINGS OR STRUCTURES ARE PERMITTED WITHOUT REQUIRING THE ENTIRE BUILDING OR STRUCTURE TO COMPLY WITH THE ENERGY REQUIREMENTS OF IEBC.

CHAPTER 3: OCCUPANCY CLASSIFICATION & USE NO PROPOSED CHANGES TO OCCUPANCY CLASSIFICATION & USE ASSEMBLY GROUP A-3

CHAPTER 4: SPECIAL DETAILED REQUIREMENTS

CHAPTER 5: GENERAL BUILDING HEIGHTS & AREAS NO PROPOSED CHANGES TO HEIGHT OR AREA EXISTING BUILDING AREA: 1,455 SF (BASEMENT) + 3,544 SF (1ST FLOOR) = 4,999 SF EXISTING BUILDING HEIGHT: 1 STORY W/ PARTIAL BASEMENT

CHAPTER 6: TYPES OF CONSTRUCTION CONSTRUCTION CLASSIFICATION: III-B, UNSPRINKLERED FIRE RESISTANCE RATINGS (TABLE 601)

PRIMARY STRUCTURAL FRAME 0 HOURS BEARING WALLS 2 HOURS NON BEARING WALLS 0 HOURS FLOOR CONSTRUCTION 0 HOURS ROOF CONSTRUCTION 0 HOUR

FIRE RESISTANCE RATING REQS FOR EXT WALLS BASED ON FIRE SEPARATION DISTANCE (TABLE 602) 10<X<30 - OCCUPANCY GROUP A - 1HR

CHAPTER 7: FIRE AND SMOKE PROTECTION FEATURES 705.3 BUILDINGS ON THE SAME LOT

AGGREGATE AREA OF BUILDINGS = 8,075 SQFT (TABLE 506.2 ALLOWABLE AREA DETERMINATION) A-3 - TYPE IIB/IIIB - NS - 9,500 SQFT (> 8,075 SQFT) BUILDINGS SHALL BE TREATED AS ONE BUILDING

CHAPTER 8: INTERIOR FINISHES

INTERIOR WALL & CEILING FINISHES BASED ON OCCUPANCY (TABLE 803.13, OCCUPANCY GROUP A-3 GOVERNS) INTERIOR EXIT STAIRWAYS / EXIT PASSAGEWAYS CORRIDORS/ENCLOSURE FOR EXIT ACCESS STAIRWAYS ROOMS AND ENCLOSED SPACES

CHAPTER 9: FIRE PROTECTION & LIFE SAFETY SYSTEMS 906.1 PORTABLE FIRE EXTINGUISHERS ARE REQUIRED IN EXSITING GROUP A OCCUPANCY TABLE 906.3: FIRE EXTINGUISHERS FOR CLASS A FIRE HAZARDS, LOW HAZARD OCCUPANCY MINIMUM RATED SINGLE EXTINGUISHER = 2-A

MAXIMUM FLOOR AREA PER UNIT OF A = 3000 SF MAXIMUM FLOOR AREA FOR EXTINGUISHER = 11,250 SF MAXIMUM DISTANCE OF TRAVEL TO EXTINGUISHER = 75 FEET


CHAPTER 10: MEANS OF EGRESS OCCUPANT LOAD: SEE TABLES BELOW

EXIT AND EXIT ACCESS DOORWAY CONFIGURATION (1007) WHERE TWO EXITS, EXIT ACCESS DOORWAYS, EXIT ACCESS STAIRWAYS OR RAMPS, OR ANY COMBINATION THERE OF, ARE REQUIRED FROM ANY PORTION OF THE EXIT ACCESS THEY SHALL BE PLACED A DISTANCE EQUAL TO NOT LESS THAN ONE-HALF OF THE LENGTH OF THE MAXIMUM OVERALL DIAGONAL DIMENSION OF THE BUILDING OR AREA TO BE SERVED MEASURED IN A STRAIGHT LINE BETWEEN THEM.

EXIT ACCESS DISTANCE (TABLE 1017.2) MAX TRAVEL DISTANCE **250'** (OCCÚPANCY A, UNSPRINKLERED)

IPC CHAPTER 4: FIXTURES, FAUCETS, AND FIXTURE FITTINGS MIN NUMBER OF REQ'D PLUMBING FIXTURES


> GYMNASIUMS: 1 PER 125 OCCUPANTS P424.2 URINALS SHALL NOT BE SUBSTITUTED FOR MORE THAN 67 PERCENT OF THE REQUIRED WATER CLOSETS IN ASSEMBLY AND EDUCATIONAL OCCUPANCIES.

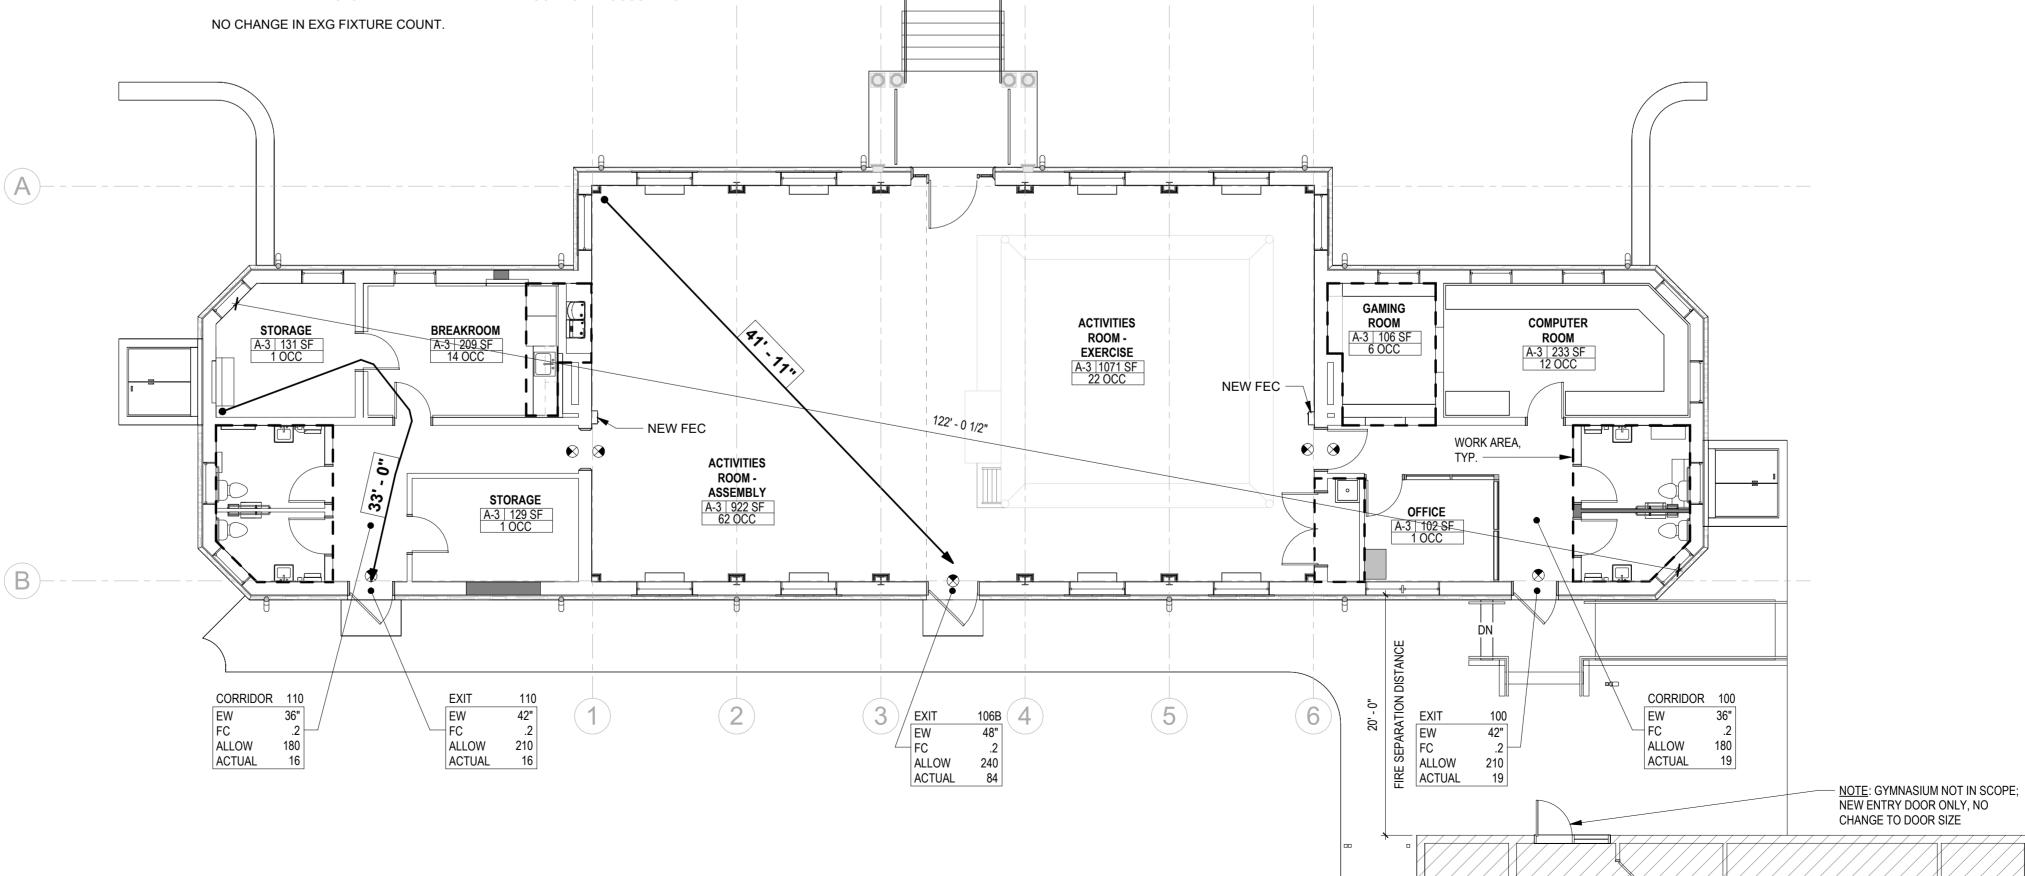

			oco	SUPANT LOAD		
OCCUPANCY		ROOM			SF/	
CLASSIFICATION	NUMBER	NAME	AREA	FUNCTION (TABLE 1004.5)	OCCUPANT	OCCUPANT LOAD
FIRST FLOOR FFE						
ASSEMBLY GROUP A-3	102	COMPUTER ROOM	233 SF	Educational - Classroom area	20 NET	12
ASSEMBLY GROUP A-3	103	GAMING ROOM	106 SF	Educational - Classroom area	20 NET	6
ASSEMBLY GROUP A-3	105	OFFICE	102 SF	Business Areas	150 GROSS	1
ASSEMBLY GROUP A-3	106	ACTIVITIES ROOM - EXERCISE	1071 SF	Exercise rooms	50 GROSS	22
ASSEMBLY GROUP A-3	106	ACTIVITIES ROOM - ASSEMBLY	922 SF	Assembly without fixed seats - Unconcentrated (tables and chairs)	15 NET	62
ASSEMBLY GROUP A-3	107	BREAKROOM	209 SF	Assembly without fixed seats - Unconcentrated (tables and chairs)	15 NET	14
ASSEMBLY GROUP A-3	108	STORAGE	131 SF	Accessory storage areas, mechanical equipment room	300 GROSS	1
ASSEMBLY GROUP A-3	111	STORAGE	129 SF	Accessory storage areas, mechanical equipment room	300 GROSS	1
TOTAL BUILDING OCCUPAN	T LOAD	•	'		<u>'</u>	119

COD	F P	ΔN	KEY	

DOOR / CORRIDOR / STAIR CAPACITY	OCCUPANCY	SYMBOLS
EXIT / STAIR / CORRIDOR WIDTH CODE WIDTH FACTOR ALLOWABLE CAPACITY ACTUAL CAPACITY ACTUAL TYPE MARK EW - FC 0.2/0.3 ALLOW - ACTUAL -	OCCUPANCY CLASSIFICATION ADMIN SUITE (IF APPLICABLE) AREA OCCUPANT COUNT	EXIT SIGN. SEE A6 SERIES FOR EXACT LOCATION AND DIRECTION.
RATED WALLS	TRAVEL DISTANCE TO NEAREST EXIT	FEC FIRE EXTINGUISHER CABINET
1 HOUR FIRE PARTITION (FIRE BARRIER WHERE NOTED)	•	(SURFACE MOUNTED, UNO
2 HOUR FIRE BARRIER	PATH OF TRAVEL TRAVEL DISTANCE	

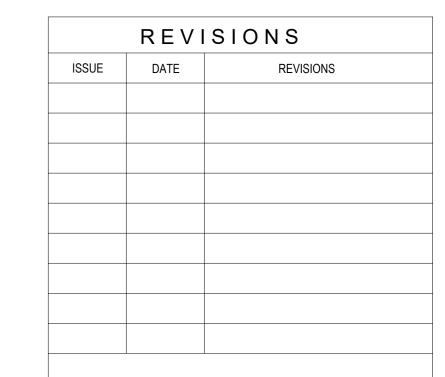



CONSTRUCTION DOCUMENTS

PROJECT COORDINATOR LEEANN SUEN



SMPARCHITECTS 1600 Walnut Street, 2nd Floor Philadelphia, Pennsylvania 19103

LANDSCAPE ARCHITECT: **GROUND RECONSIDERED** www.groundreconsidered.com 215 790 0727

215 985 4410

CIVIL ENGINEER: KS ENGINEERS www.kseng.com 215 925 0425

STRUCTURAL ENGINEER:
ANN ROTHMANN STRUCTURAL ENGINEERING arstructural.com

610 688 2566 **MEP ENGINEER:** ARORA ENGINEERS www.aroraengineers.com

856 287 2424

610 459 7900 **ROOFING CONSULTANT:** STEPHEN McLAUGHLIN ROOFING CONSULTANT stevemclaughlin.biz

CITY OF PHILADELPHIA DEPARTMENT OF PARKS & RECREATION

1515 ARCH STREET 11TH FLOOR, ONE PARKWAY BUILDING

PROJECT TITLE RENOVATIONS TO THE HAPPY **HOLLOW RECREATION CENTER**

DRAWING TITLE


PROJECT NO.

BUILDING CODE INFORMATION


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DATE	05/13/2025	А
SCALE	AS NOTED	
DRAWN BY	SCR	

CHECKED BY Checker ALL DIMENSIONS AND CONDITIONS SHALL BE VERIFIED BY THE CONTACTOR AT THE SITE BEFORE PROCEEDING WITH THE WORK

LIFE SAFETY PLAN A0.2 / 1/8" = 1'-0"

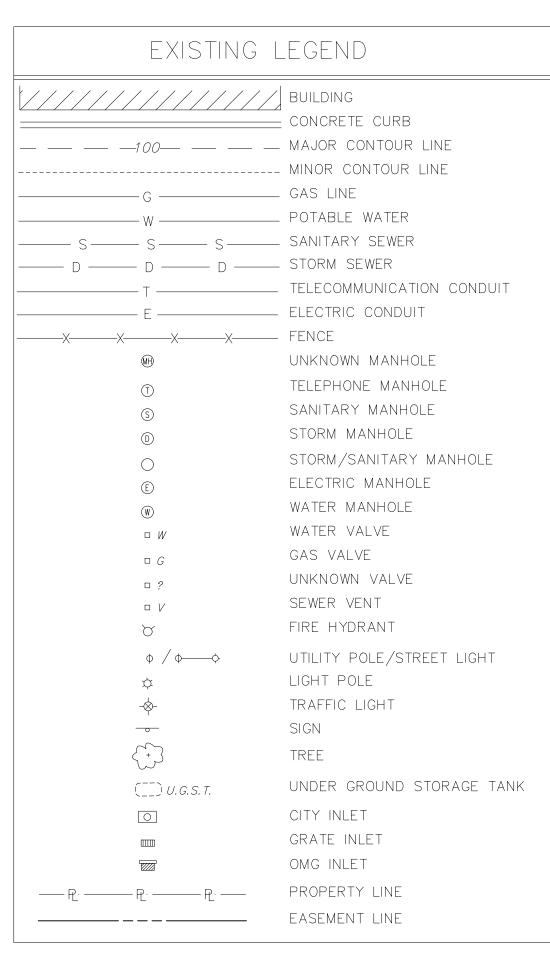

- 1. SURVEY INFORMATION OBTAINED FROM A FIELD SURVEY PERFORMED BY KS ENGINEERS, P.C. IN JUNE 2023. SURVEY BASED ON P.A.S.P.C.S. (SOUTH ZONE) NAD83. BEARINGS SHOWN ARE PER CITY PLAN AND DEED OF RECORD. ELEVATIONS ARE REFERENCED TO THE PHILADELPHIA CITY DATUM.
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PECO 1', 1'-3" Cov.

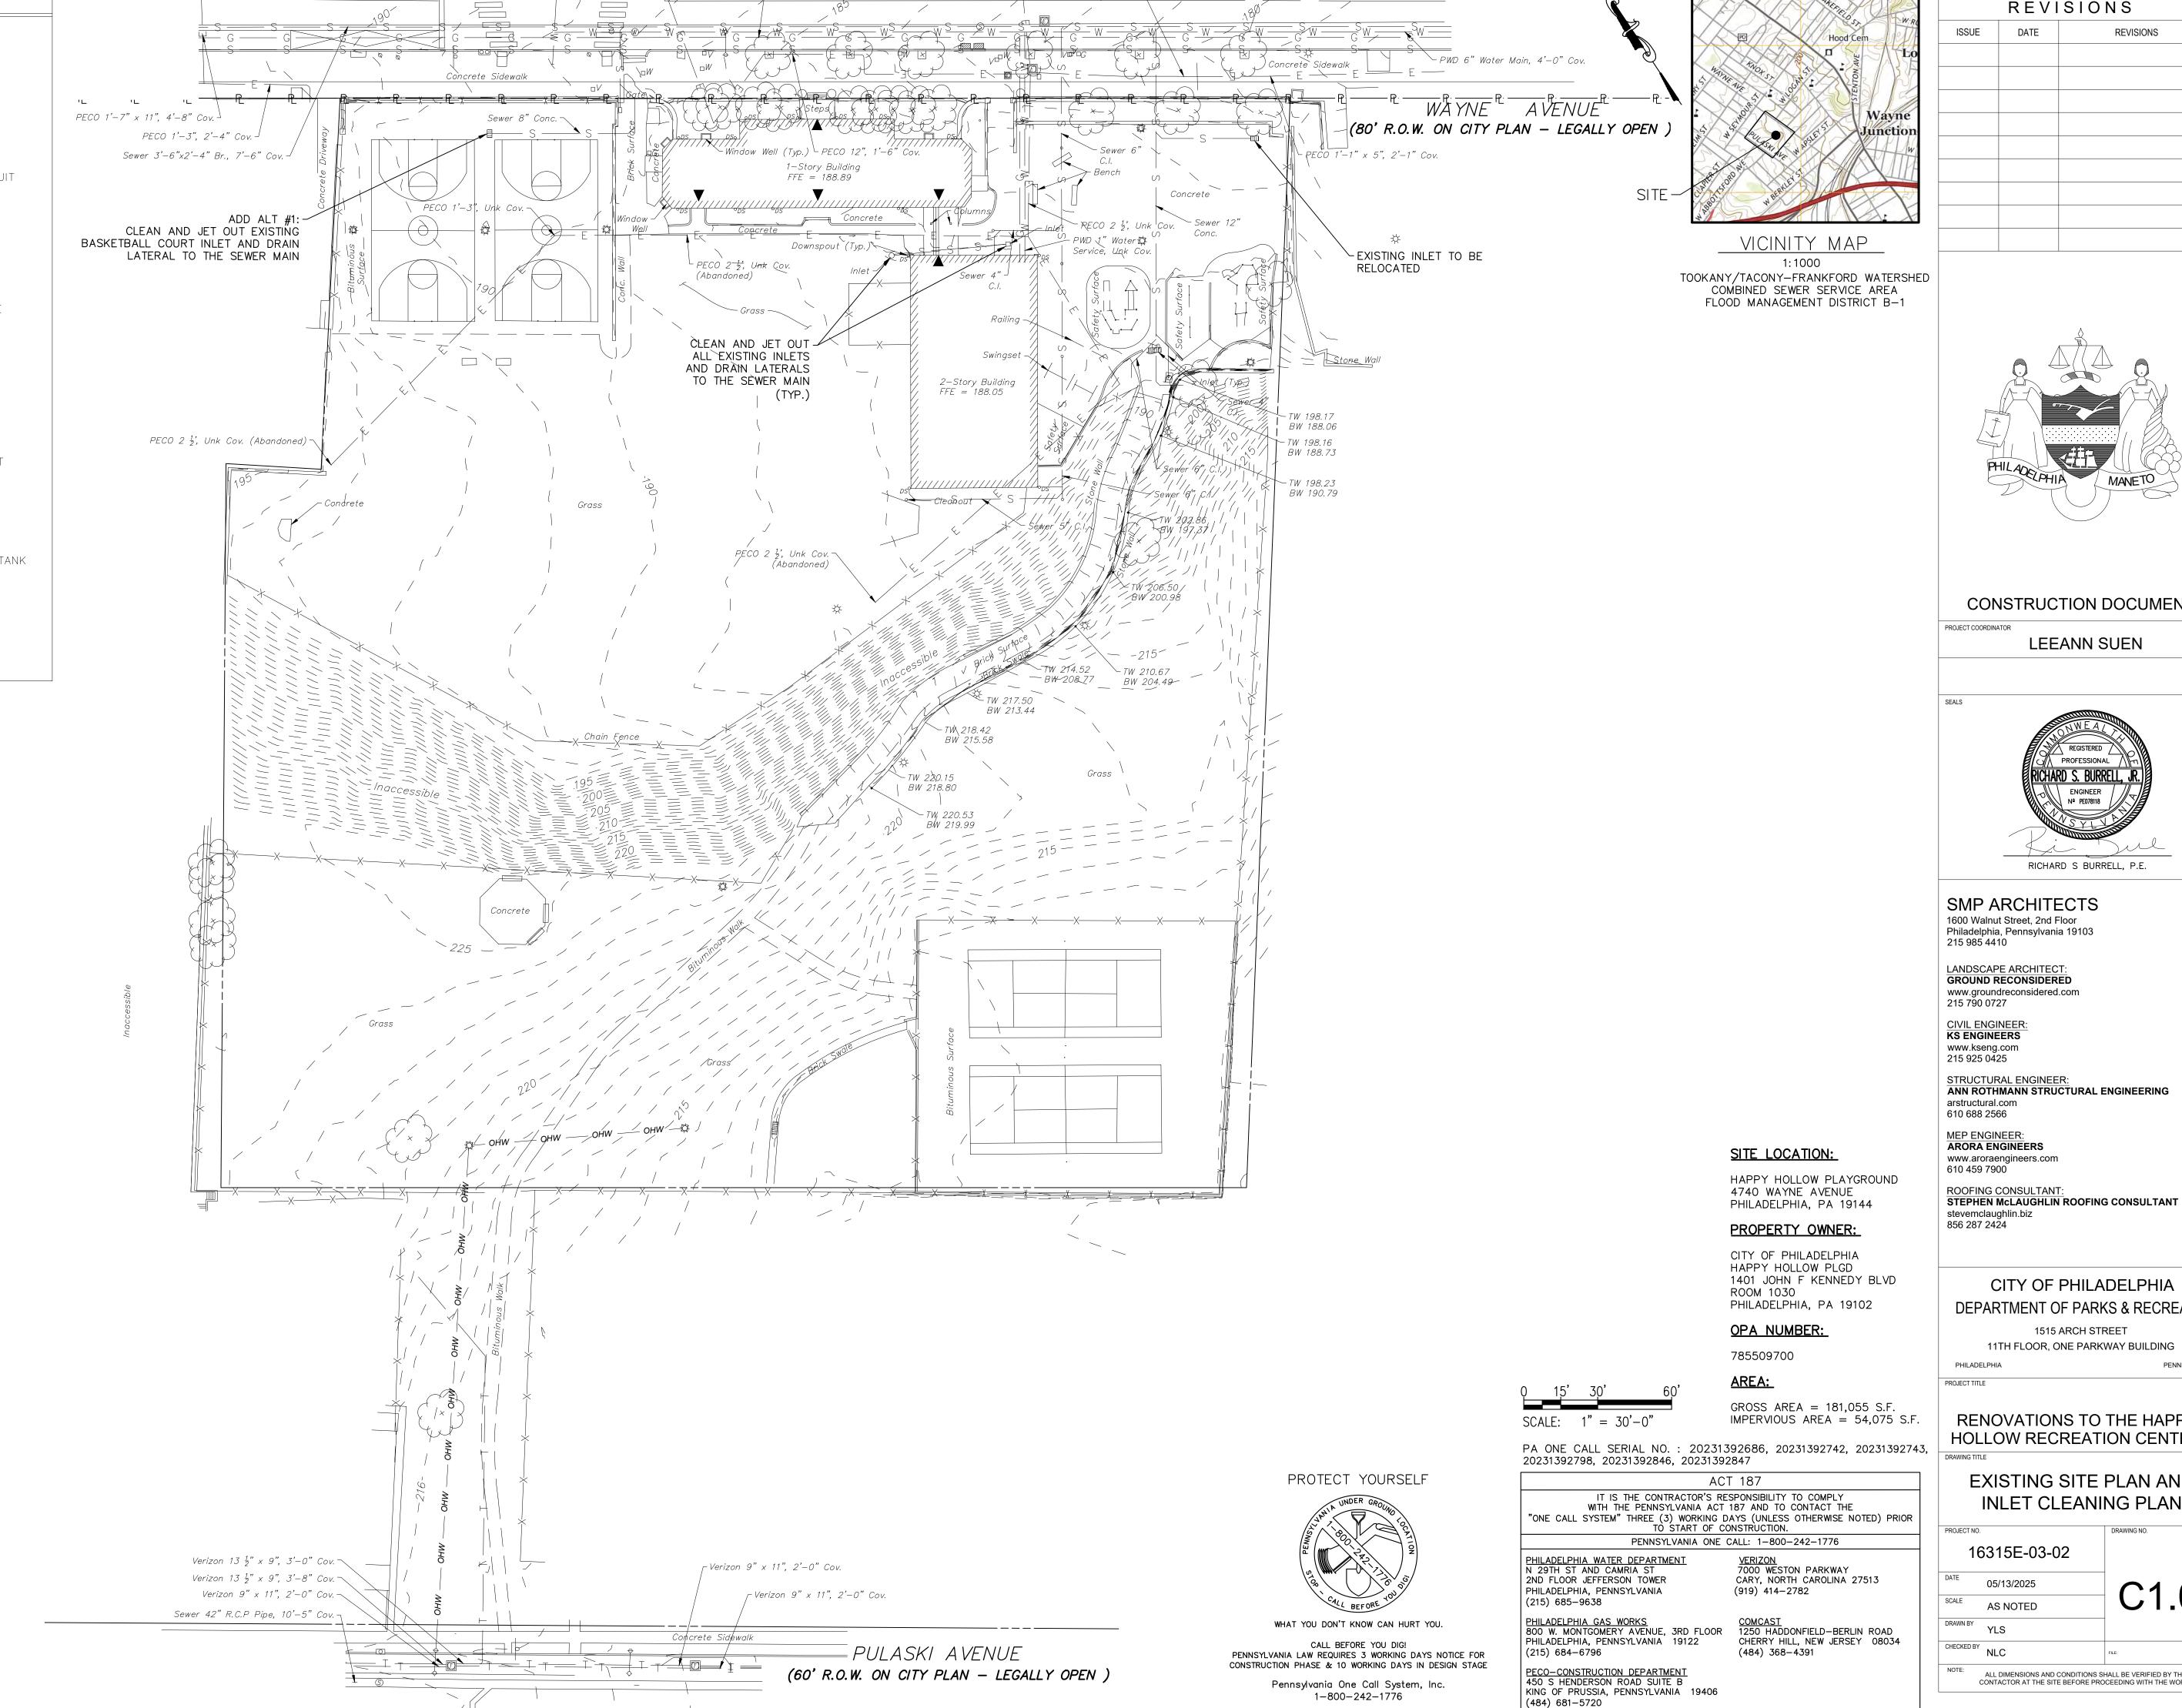REVISIONS

CONSTRUCTION DOCUMENTS

LEEANN SUEN

RICHARD S BURRELL, P.E.

CITY OF PHILADELPHIA

DEPARTMENT OF PARKS & RECREATION

1515 ARCH STREET

11TH FLOOR, ONE PARKWAY BUILDING

RENOVATIONS TO THE HAPPY

HOLLOW RECREATION CENTER

EXISTING SITE PLAN AND

INLET CLEANING PLAN

ALL DIMENSIONS AND CONDITIONS SHALL BE VERIFIED BY THE

CONTACTOR AT THE SITE BEFORE PROCEEDING WITH THE WORK

16315E-03-02

05/13/2025

AS NOTED

YLS

PENNSYLVANIA

C1.00

LANDSCAPE ARCHITECT:

STRUCTURAL ENGINEER:

www.aroraengineers.com

ROOFING CONSULTANT:


stevemclaughlin.biz

PHILADELPHIA

REVISIONS

DATE


ISSUE

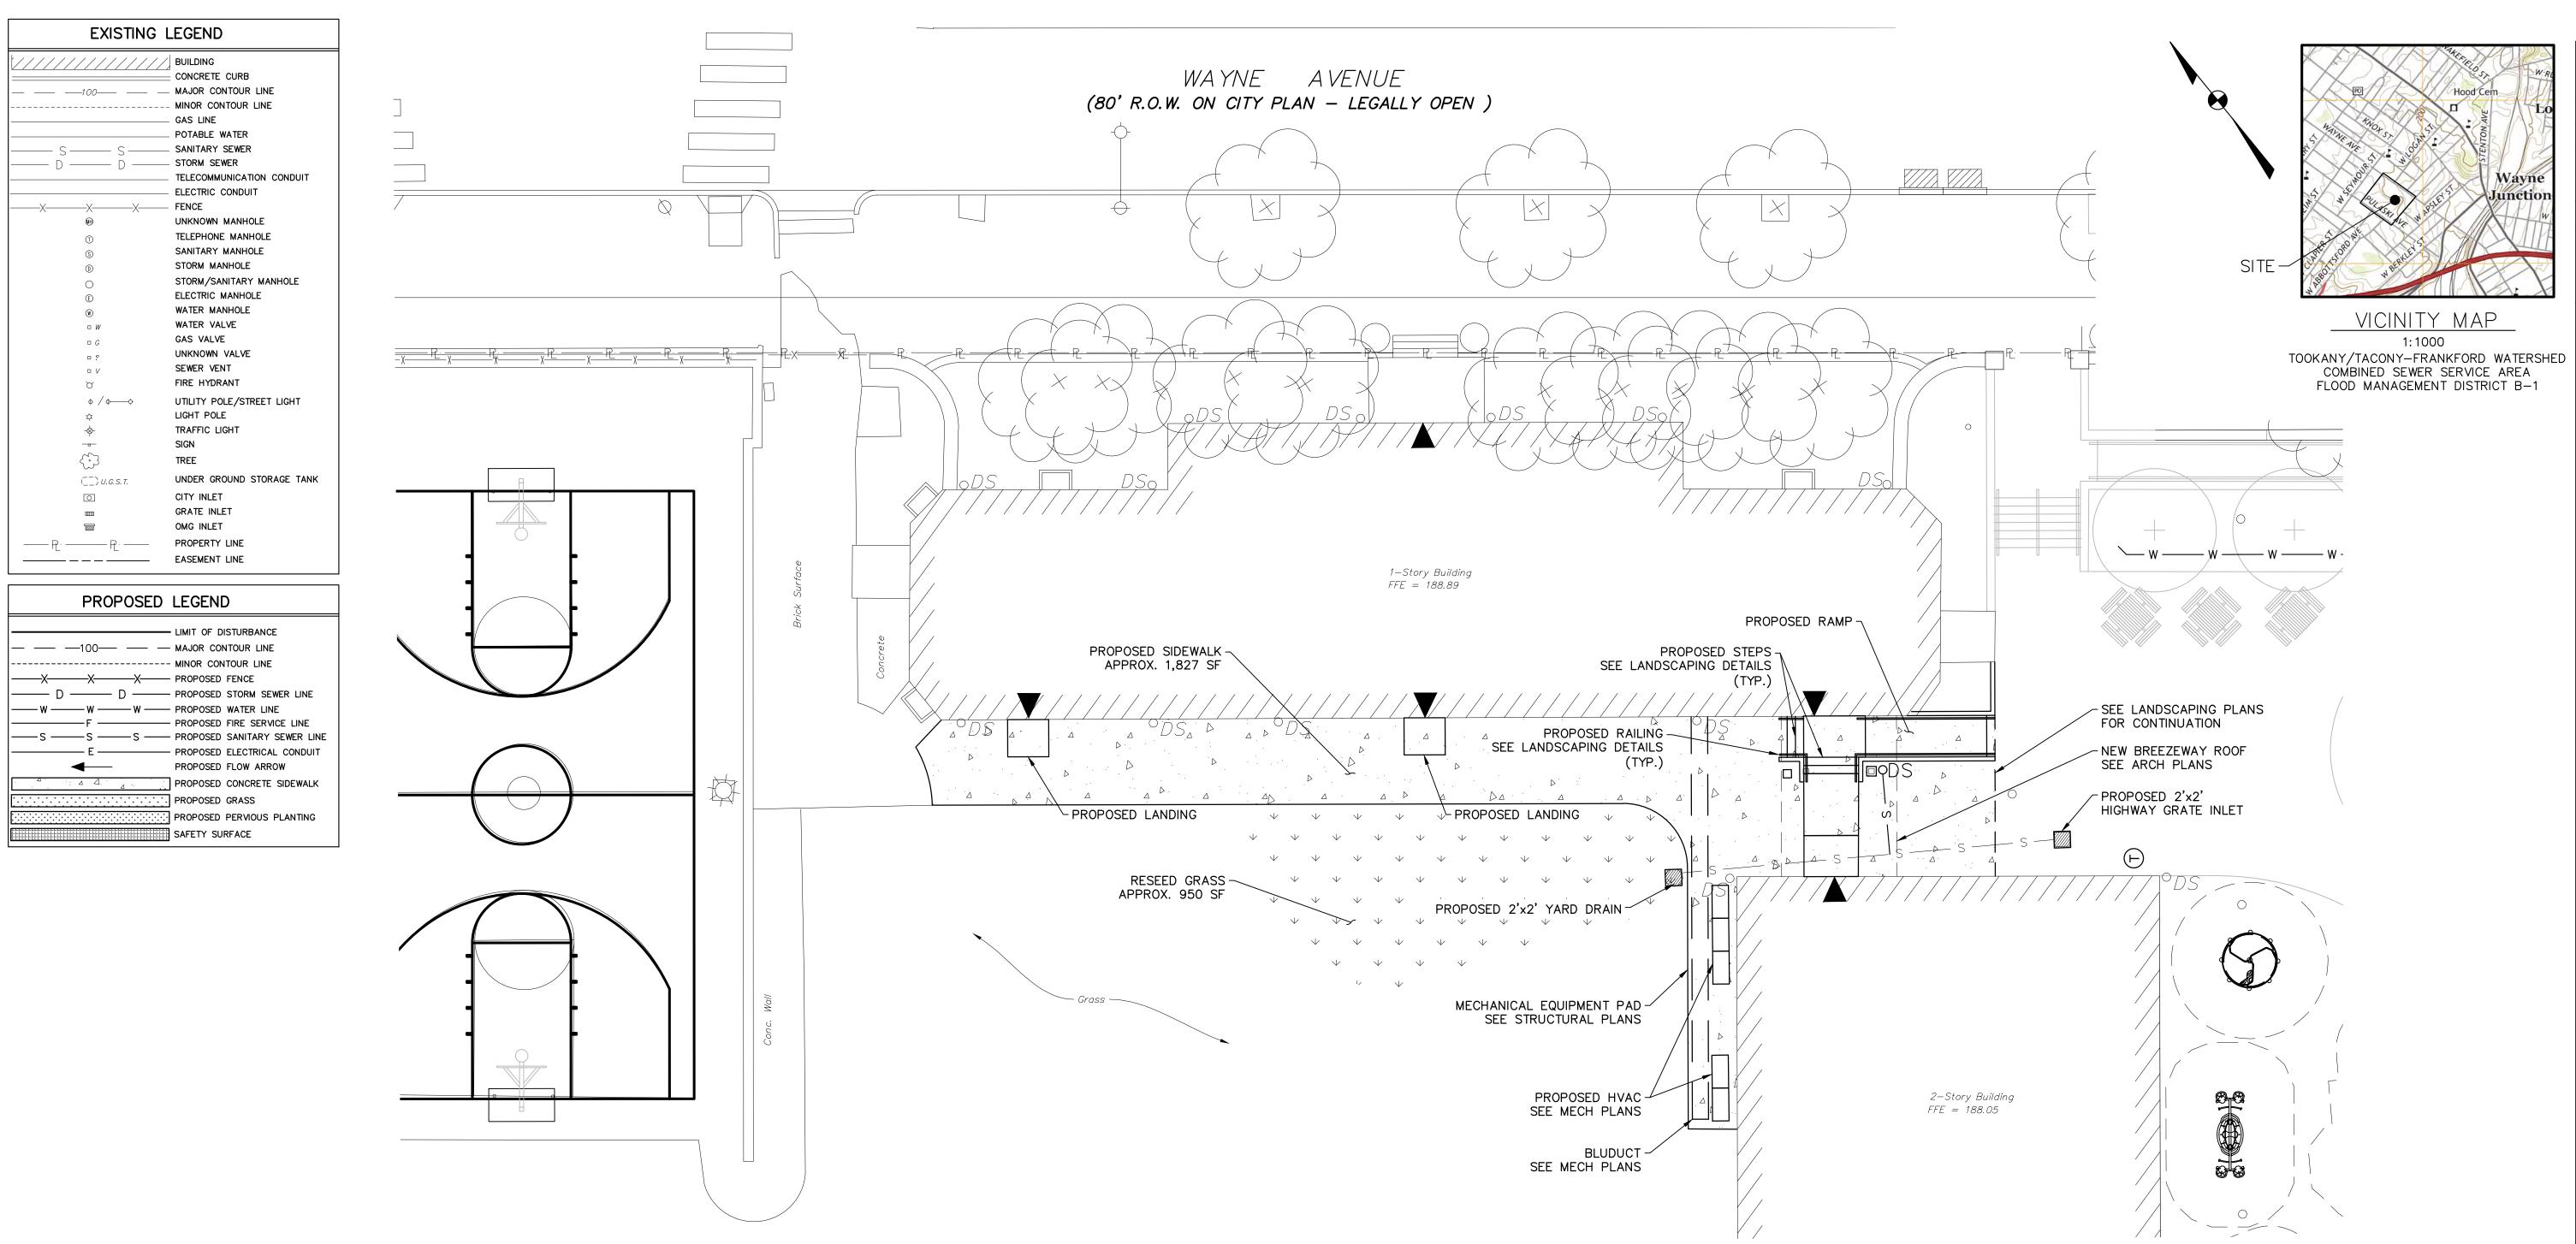

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NOTES:

1. INLETS (2) AND ASSOCIATED LATERALS ARE TO BE CLEANED OUT AT THE BEGINNING OF PROJECT AND VERIFIED WITH VIDEO. REVERIFY AT PROJECT COMPLETION.

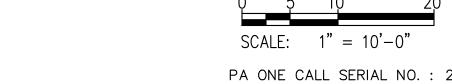

785509700 AREA:

OPA NUMBER:

ROOM 1030

SITE LOCATION:

4740 WAYNE AVENUE PHILADELPHIA, PA 19144

PROPERTY OWNER:

CITY OF PHILADELPHIA HAPPY HOLLOW PLGD

HAPPY HOLLOW PLAYGROUND

1401 JOHN F KENNEDY BLVD

PHILADELPHIA, PA 19102

GROSS AREA = 181,055 S.F. IMPERVIOUS AREA = 54,075 S.F.

PA ONE CALL SERIAL NO.: 20231392686, 20231392742, 20231392743 20231392798, 20231392846, 20231392847

ACT 187

IT IS THE CONTRACTOR'S RESPONSIBILITY TO COMPLY WITH THE PENNSYLVANIA ACT 187 AND TO CONTACT THE "ONE CALL SYSTEM" THREE (3) WORKING DAYS (UNLESS OTHERWISE NOTED) PRIOR TÒ START OF CONSTRUCTION.

PENNSYLVANIA ONE CALL: 1-800-242-1776 PHILADELPHIA WATER DEPARTMENT 1101 MARKET STREET, 2nd FLOOR PHILADELPHIA, PENNSYLVANIA

(215) 685-6270 PHILADELPHIA GAS WORKS 800 W. MONTGOMERY AVENUE, 3RD FLOOR

PHILADELPHIA, PENNSYLVANIA 19122 (215) 684-6796 PECO-CONSTRUCTION DEPARTMENT 2301 MARKET STREET PHILADELPHIA, PENNSYLVANIA 19103

(215) 731-3264

<u>VERIZON</u> 900 RACE STREET PHILADELPHIA, PENNSYLVANIA 19107 (215) 351-8947

COMCAST 1351 S. COLUMBUS BOULEVARD PHILADELPHIA, PENNSYLVANIA 19147 (215) 952-4935




REVISIONS

DATE

ISSUE

CONSTRUCTION DOCUMENTS

LEEANN SUEN

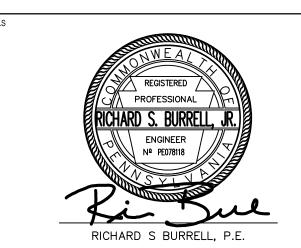

SMP ARCHITECTS 1600 Walnut Street, 2nd Floor Philadelphia, Pennsylvania 19103

LANDSCAPE ARCHITECT: GROUND RECONSIDERED www.groundreconsidered.com

215 985 4410

PROJECT COORDINATOR

215 790 0727 CIVIL ENGINEER: KS ENGINEERS www.kseng.com

215 925 0425

STRUCTURAL ENGINEER:
ANN ROTHMANN STRUCTURAL ENGINEERING arstructural.com 610 688 2566

MEP ENGINEER:
ARORA ENGINEERS www.aroraengineers.com 610 459 7900

ROOFING CONSULTANT:
STEPHEN McLAUGHLIN ROOFING CONSULTANT stevemclaughlin.biz 856 287 2424

CITY OF PHILADELPHIA DEPARTMENT OF PARKS & RECREATION

1515 ARCH STREET

11TH FLOOR, ONE PARKWAY BUILDING

PHILADELPHIA PENNSYLVANIA

RENOVATIONS TO THE HAPPY **HOLLOW RECREATION CENTER**


SIDEWALK SITE PLAN


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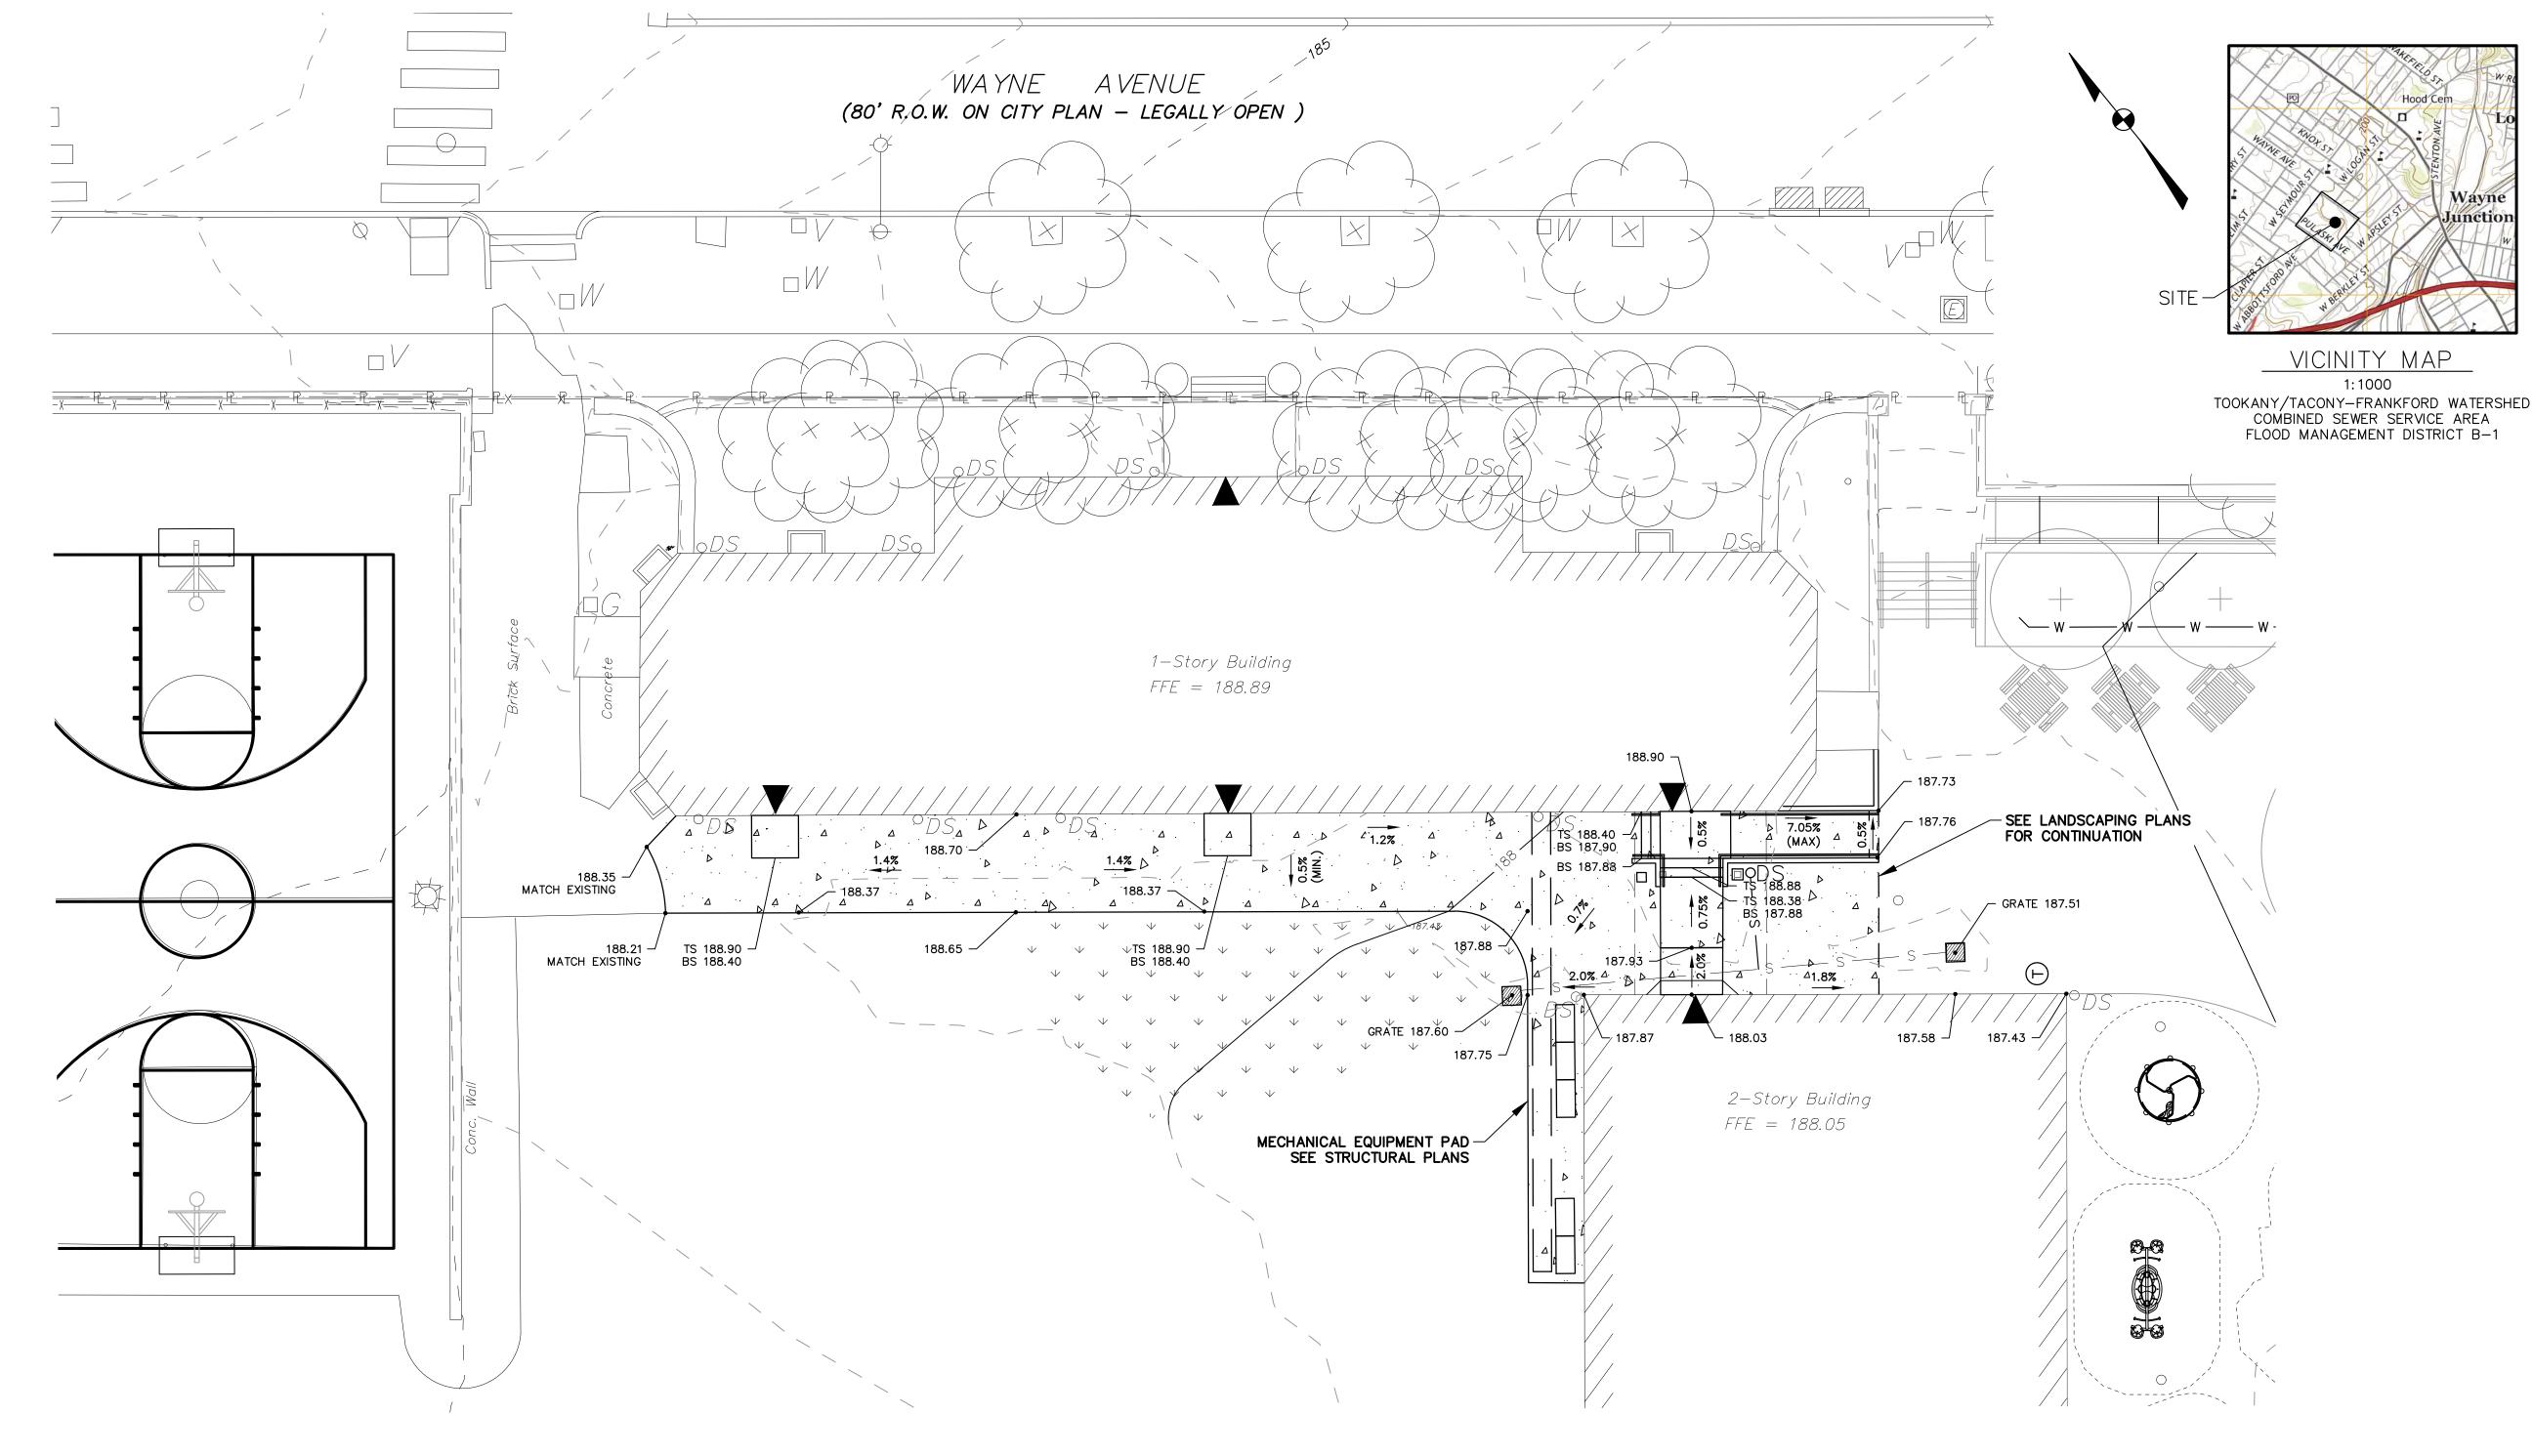
CONTACTOR AT THE SITE BEFORE PROCEEDING WITH THE WORK

WHAT YOU DON'T KNOW CAN HURT YOU. CALL BEFORE YOU DIG! PENNSYLVANIA LAW REQUIRES 3 WORKING DAYS NOTICE FOR CONSTRUCTION PHASE & 10 WORKING DAYS IN DESIGN STAGE Pennsylvania One Call System, Inc. 1-800-242-1776

PROTECT YOURSELF



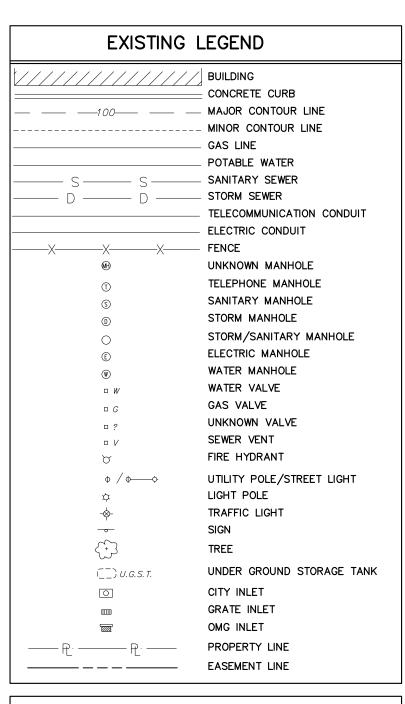

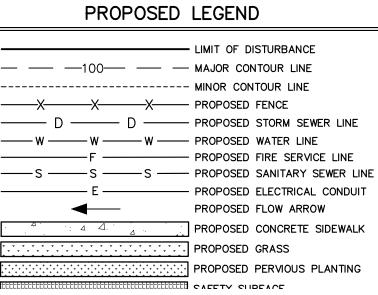

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SITE LOCATION:

HAPPY HOLLOW PLAYGROUND 4740 WAYNE AVENUE PHILADELPHIA, PA 19144

PROPERTY OWNER:

CITY OF PHILADELPHIA HAPPY HOLLOW PLGD 1401 JOHN F KENNEDY BLVD ROOM 1030 PHILADELPHIA, PA 19102

OPA NUMBER:

785509700

GROSS AREA = 181,055 S.F.

IMPERVIOUS AREA = 54,075 S.F. PA ONE CALL SERIAL NO.: 20231392686, 20231392742, 20231392743 20231392798, 20231392846, 20231392847

IT IS THE CONTRACTOR'S RESPONSIBILITY TO COMPLY WITH THE PENNSYLVANIA ACT 187 AND TO CONTACT THE "ONE CALL SYSTEM" THREE (3) WORKING DAYS (UNLESS OTHERWISE NOTED) PRIOR TÒ START OF CONSTRUCTION.

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PHILADELPHIA, PENNSYLVANIA (215) 685-6270 PHILADELPHIA GAS WORKS 800 W. MONTGOMERY AVENUE, 3RD FLOOR

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PROTECT YOURSELF

WHAT YOU DON'T KNOW CAN HURT YOU.

CALL BEFORE YOU DIG!

PENNSYLVANIA LAW REQUIRES 3 WORKING DAYS NOTICE FOR CONSTRUCTION PHASE & 10 WORKING DAYS IN DESIGN STAGE

Pennsylvania One Call System, Inc.

1-800-242-1776

PHILADELPHIA, PENNSYLVANIA 19122 (215) 684-6796 (215) 952-4935 PECO-CONSTRUCTION DEPARTMENT 2301 MARKET STREET PHILADELPHIA, PENNSYLVANIA 19103

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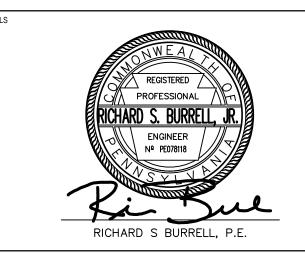
REVISIONS

DATE

ISSUE

CONSTRUCTION DOCUMENTS

LEEANN SUEN



SMP ARCHITECTS 1600 Walnut Street, 2nd Floor Philadelphia, Pennsylvania 19103 215 985 4410

LANDSCAPE ARCHITECT: GROUND RECONSIDERED www.groundreconsidered.com 215 790 0727

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PROJECT COORDINATOR

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ROOFING CONSULTANT:
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CITY OF PHILADELPHIA DEPARTMENT OF PARKS & RECREATION

1515 ARCH STREET

11TH FLOOR, ONE PARKWAY BUILDING PHILADELPHIA


RENOVATIONS TO THE HAPPY


HOLLOW RECREATION CENTER

SIDEWALK GRADING PLAN


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	NOTE:	ALL DIMENSIONS AND CONDITIONS SI	HALL BE VERIFIED BY THE

CONTACTOR AT THE SITE BEFORE PROCEEDING WITH THE WORK

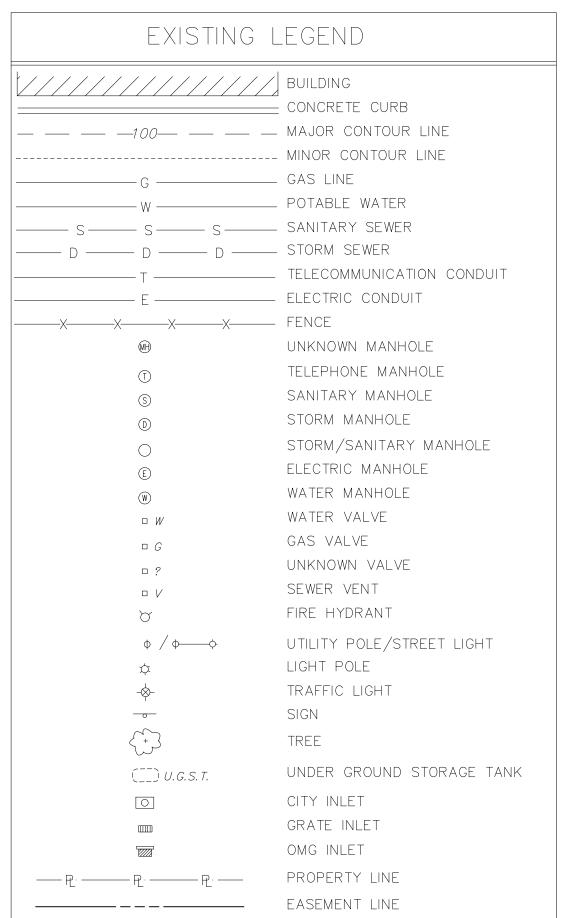

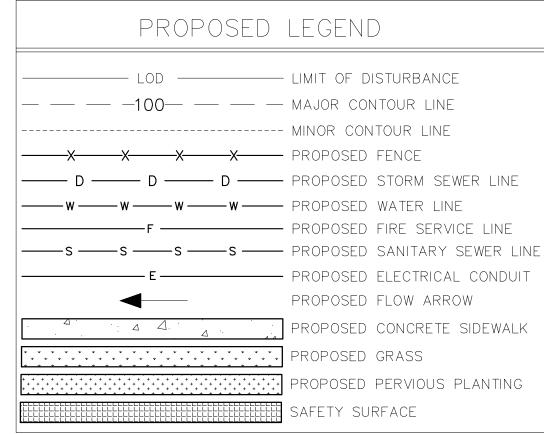

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- 2. THERE WILL BE NO PROPOSED UTILITY EASEMENTS FOR WATER OR SEWER.
- 3. THERE WILL BE NO PROPOSED CRANE FOOTING LOCATION.
- 4. CONSTRUCTION ENTRANCE WILL BE AT PROPOSED DRIVEWAY AND THROUGH THE ROCK CONSTRUCTION ENTRANCE SHOWN ON THE PLAN.
- 5. LOCATION OF SOIL STOCKPILE IS SHOWN ON THE PLAN.
- 6. DEVELOPER/ OWNER WILL COMPLY WITH ALL PHILADELPHIA REGULATIONS PERTAINING TO PROPER ABANDONMENT AND OR REUSE OF WATER SERVICE LINES AND SEWER LATERALS. PROOF OF ABANDONMENT AND OR WATER DISCONTINUANCE MUST BE PROVIDED UPON REQUEST.
- 7. METER SIZE MUST MATCH THE SIZE OF THE CONNECTION PIPE.
- 8. PWD HAS THE RIGHT TO APPROVE OR DENY LOCATIONS OF METERS. CRAWL SPACES ARE NOT CONSIDERED AN ACCESSIBLE SPACE.
- 9. AS PER PWD REGULATIONS (07/01/22) 401.3B ALL METERS LOCATED INSIDE A PROPERTY SHALL BE SET AS CLOSE AS POSSIBLE TO THE POINT WHERE THE WATER SERVICE PIPE ENTERS THE PROPERTY.

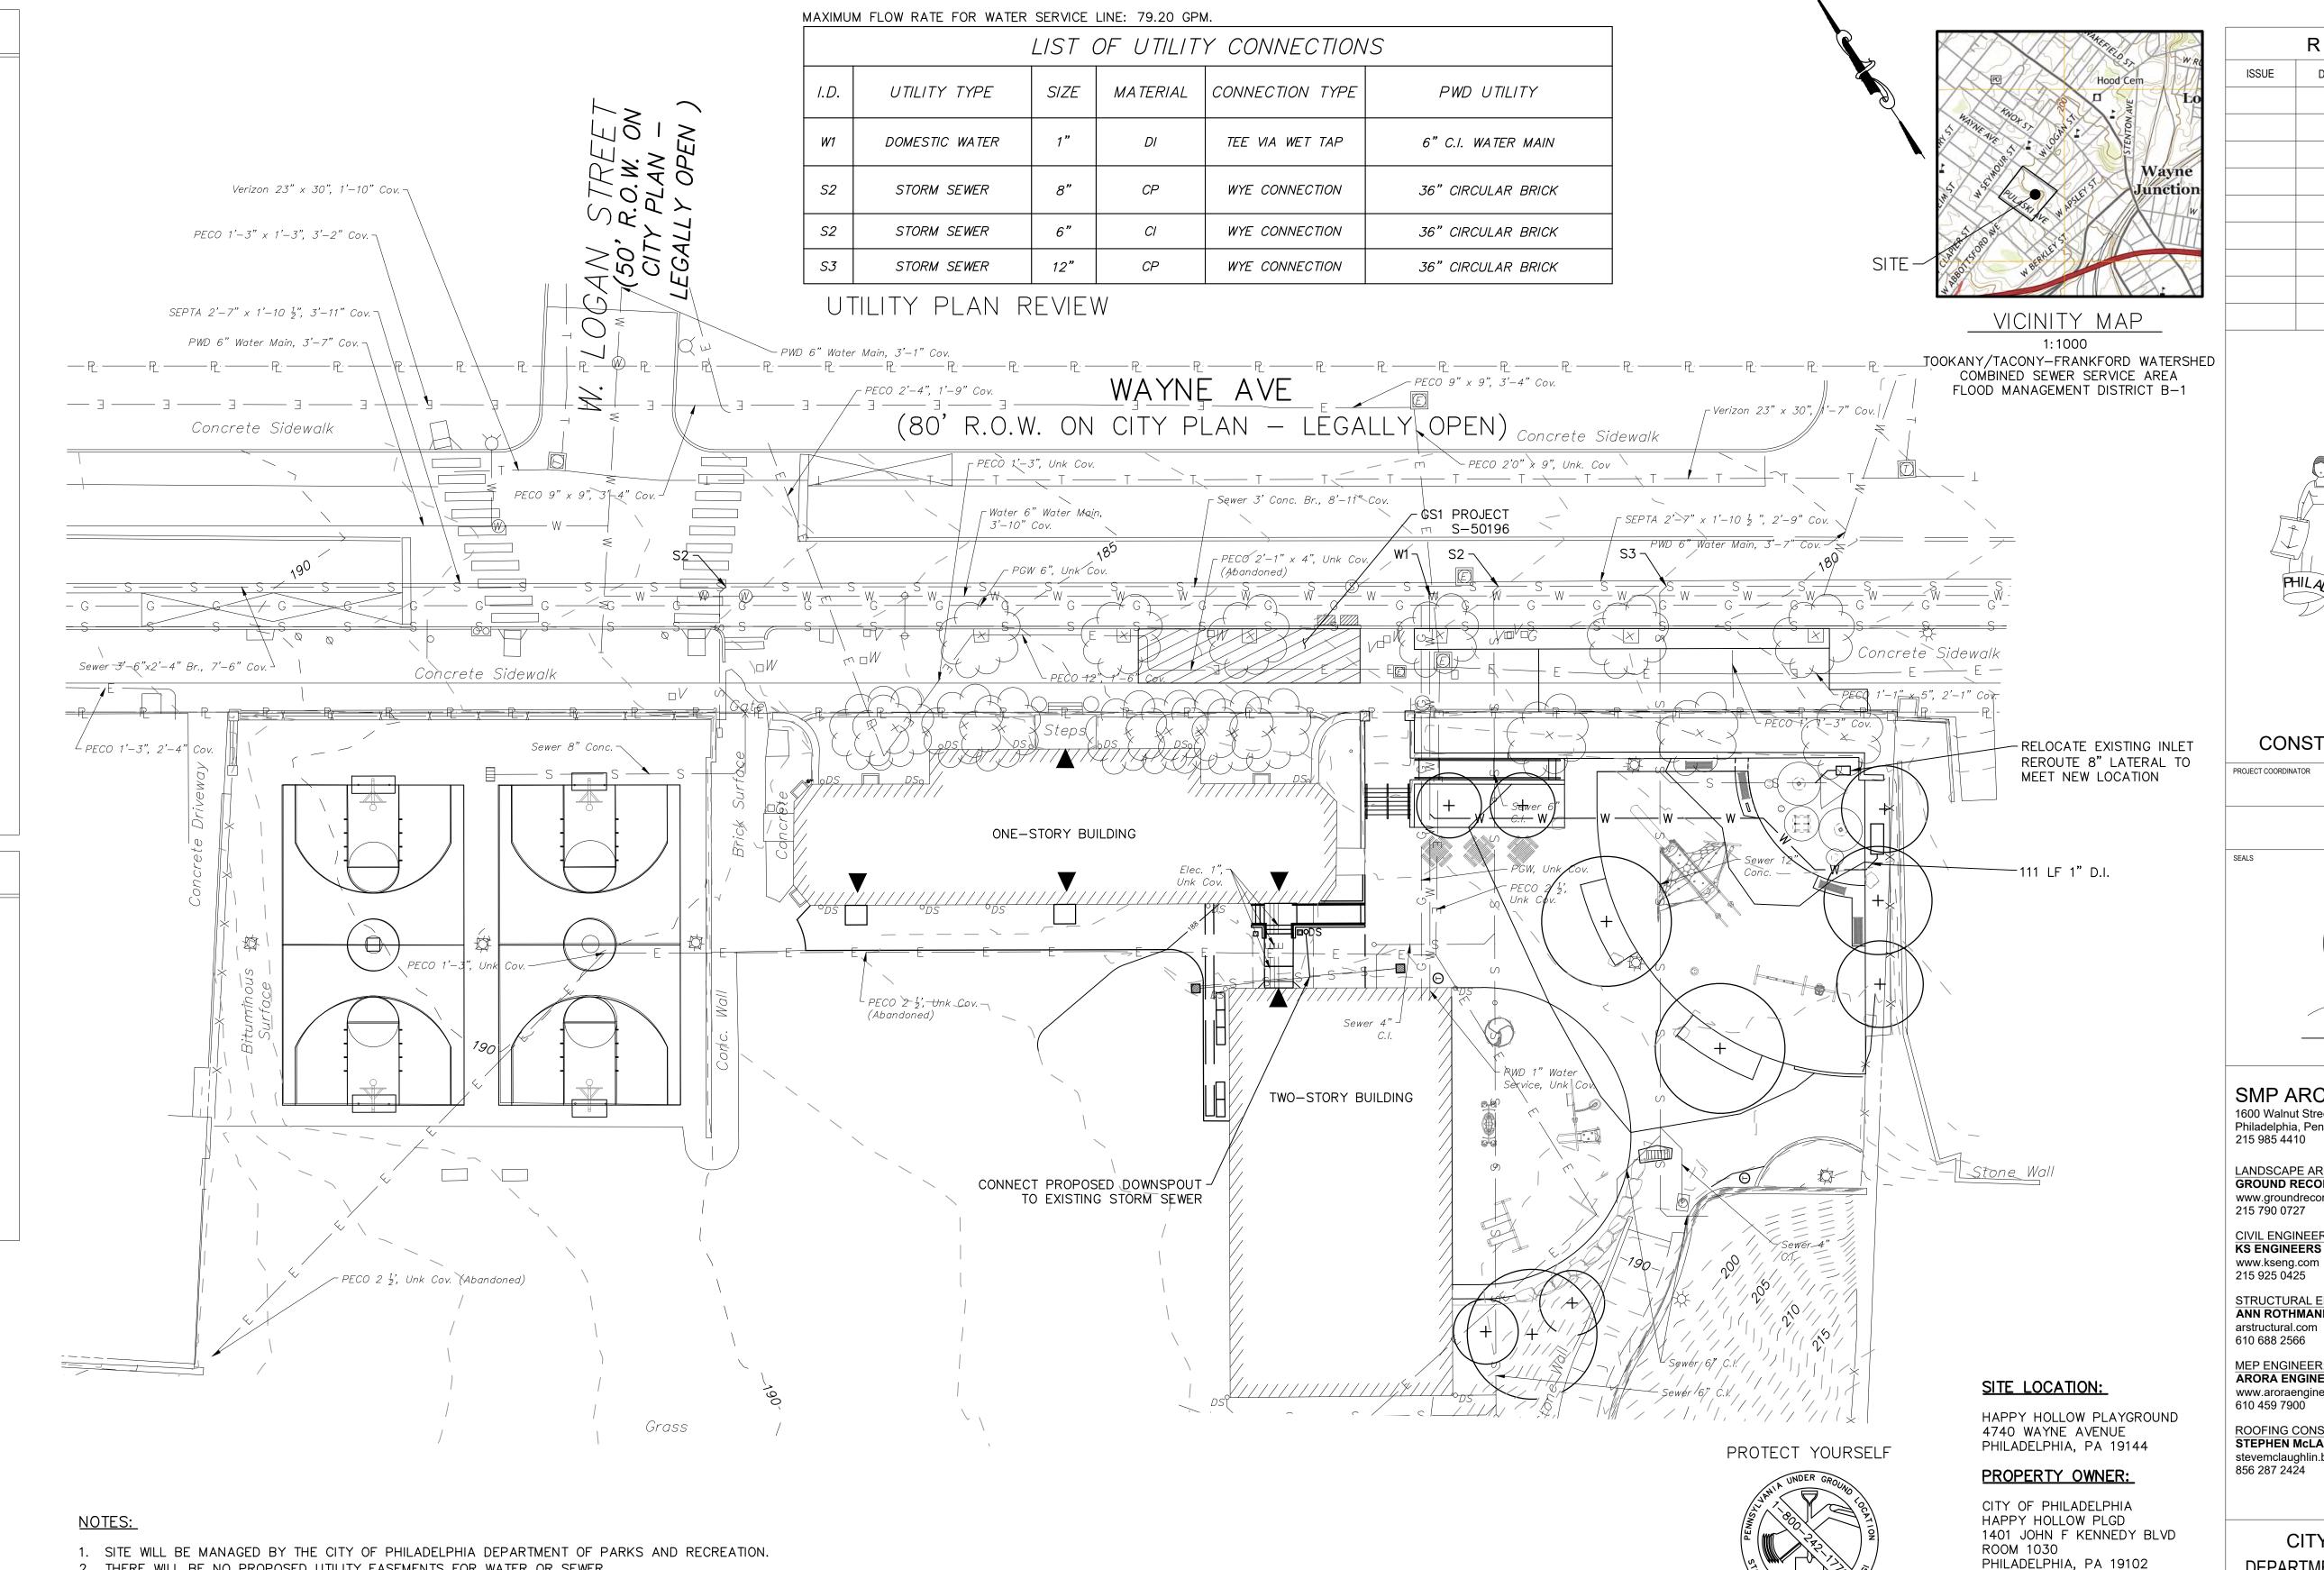PROJECT DESCRIPTION:

- 1. EXISTING PLAYGROUND WITH ONE, ONE—STORY BUILDING AND ONE, TWO—STORY BUILDING. ACTIVE RECREATION USE.
- 2. VACANT PORTION OF LOT, NO PROPOSED DEMOLITION.

SITE DATA INFORMATION:

1. TOTAL SITE SQUARE FOOTAGE: 181,055 SF.

2. TOTAL ON-SITE EARTH DISTURBANCE: 14,552 SF.

3. PWD STORMWATER TRACKING NO.: FY24-HAPP-7780-01



WHAT YOU DON'T KNOW CAN HURT YOU.

CALL BEFORE YOU DIG! PENNSYLVANIA LAW REQUIRES 3 WORKING DAYS NOTICE FOR

CONSTRUCTION PHASE & 10 WORKING DAYS IN DESIGN STAGE GROSS AREA = 181,055 S.F. Pennsylvania One Call System, Inc. IMPERVIOUS AREA = 54,075 S.F. 1-800-242-1776

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> > ACT 187

IT IS THE CONTRACTOR'S RESPONSIBILITY TO COMPLY

OPA NUMBER:

785509700

WITH THE PENNSYLVANIA ACT 187 AND TO CONTACT THE "ONE CALL SYSTEM" THREE (3) WORKING DAYS (UNLESS OTHERWISE NOTED) PRIOR TO START OF CONSTRUCTION. PENNSYLVANIA ONE CALL: 1-800-242-1776 PHILADELPHIA WATER DEPARTMENT N 29TH ST AND CAMRIA ST <u>VERIZON</u> 7000 WESTON PARKWAY CARY, NORTH CAROLINA 27513 2ND FLOOR JEFFERSON TOWER PHILADELPHIA, PENNSYLVANIA (919) 414-2782 (215) 685-9638 PHILADELPHIA GAS WORKS 800 W. MONTGOMERY AVENUE, 3RD FLOOR COMCAST 1250 HADDONFIELD—BERLIN ROAD PHILADELPHIA, PENNSYLVANIA 19122 CHERRY HILL, NEW JERSEY 08034 (215) 684-6796 (484) 368-4391 PECO-CONSTRUCTION DEPARTMENT 450 S HENDERSON ROAD SUITE B KING OF PRUSSIA, PENNSYLVANIA 19406 (484) 681-5720




REVISIONS

REVISIONS

CONSTRUCTION DOCUMENTS

LEEANN SUEN

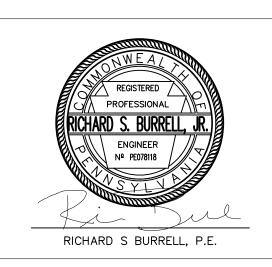

SMP ARCHITECTS 1600 Walnut Street, 2nd Floor Philadelphia, Pennsylvania 19103

LANDSCAPE ARCHITECT: GROUND RECONSIDERED www.groundreconsidered.com

215 790 0727 CIVIL ENGINEER: **KS ENGINEERS**

STRUCTURAL ENGINEER: ANN ROTHMANN STRUCTURAL ENGINEERING arstructural.com

MEP ENGINEER: **ARORA ENGINEERS** www.aroraengineers.com 610 459 7900

ROOFING CONSULTANT: STEPHEN McLAUGHLIN ROOFING CONSULTANT stevemclaughlin.biz 856 287 2424

CITY OF PHILADELPHIA DEPARTMENT OF PARKS & RECREATION

1515 ARCH STREET 11TH FLOOR, ONE PARKWAY BUILDING

PHILADELPHIA PENNSYLVANIA PROJECT TITLE

RENOVATIONS TO THE HAPPY HOLLOW RECREATION CENTER


UTILITY PLAN

16315E-03-02 05/13/2025 AS NOTED YLS CHECKED BY ALL DIMENSIONS AND CONDITIONS SHALL BE VERIFIED BY THE

PWD TRACKING NO.: UPR-FY25-HAPP-7863

SCALE: 1" = 20'-0"

CONTACTOR AT THE SITE BEFORE PROCEEDING WITH THE WORK

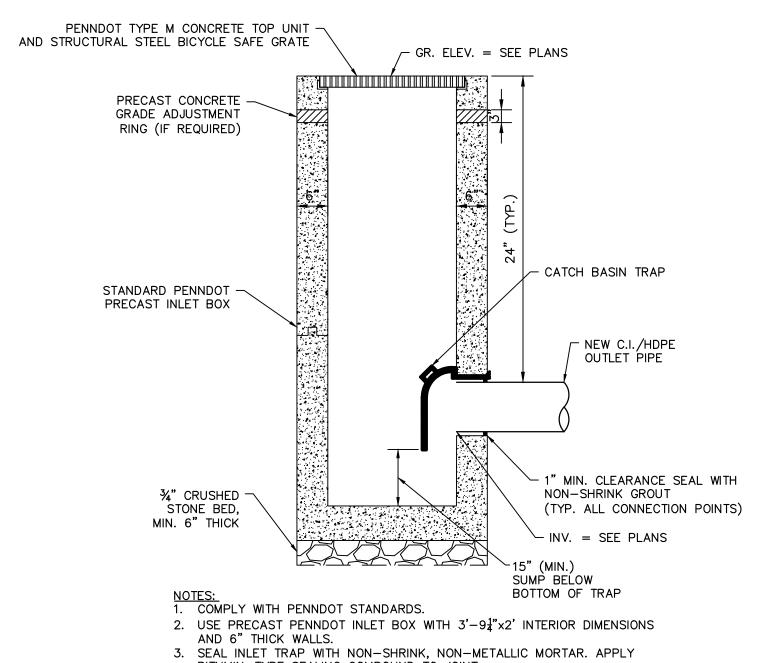


HIGHWAY GRATE INLET SCALE: N.T.S.

BITUMIN-TYPE SEALING COMPOUND TO JOINT.

4. PROPOSED INLET TRAP MUST BE AIR TIGHT.


5. USE PENNDOT STANDARD INLET BOX OR APPROVED EQUAL.

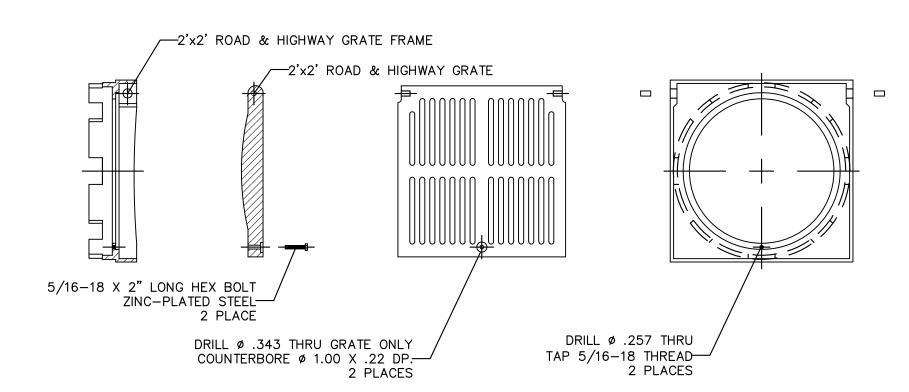


- NOTES:

 1. DIMENSIONS ARE FOR REFERENCE ONLY. ACTUAL
- DIMENSIONS MAY VARY.
- 2. QUALITY: MATERIALS SHALL CONFORM TO ASTM
 A536 GRADE 70-50-05
 3. PAINT: CASTINGS ARE FURNISHED WITH A
 BLACK PAINT

2'x2' GRATE

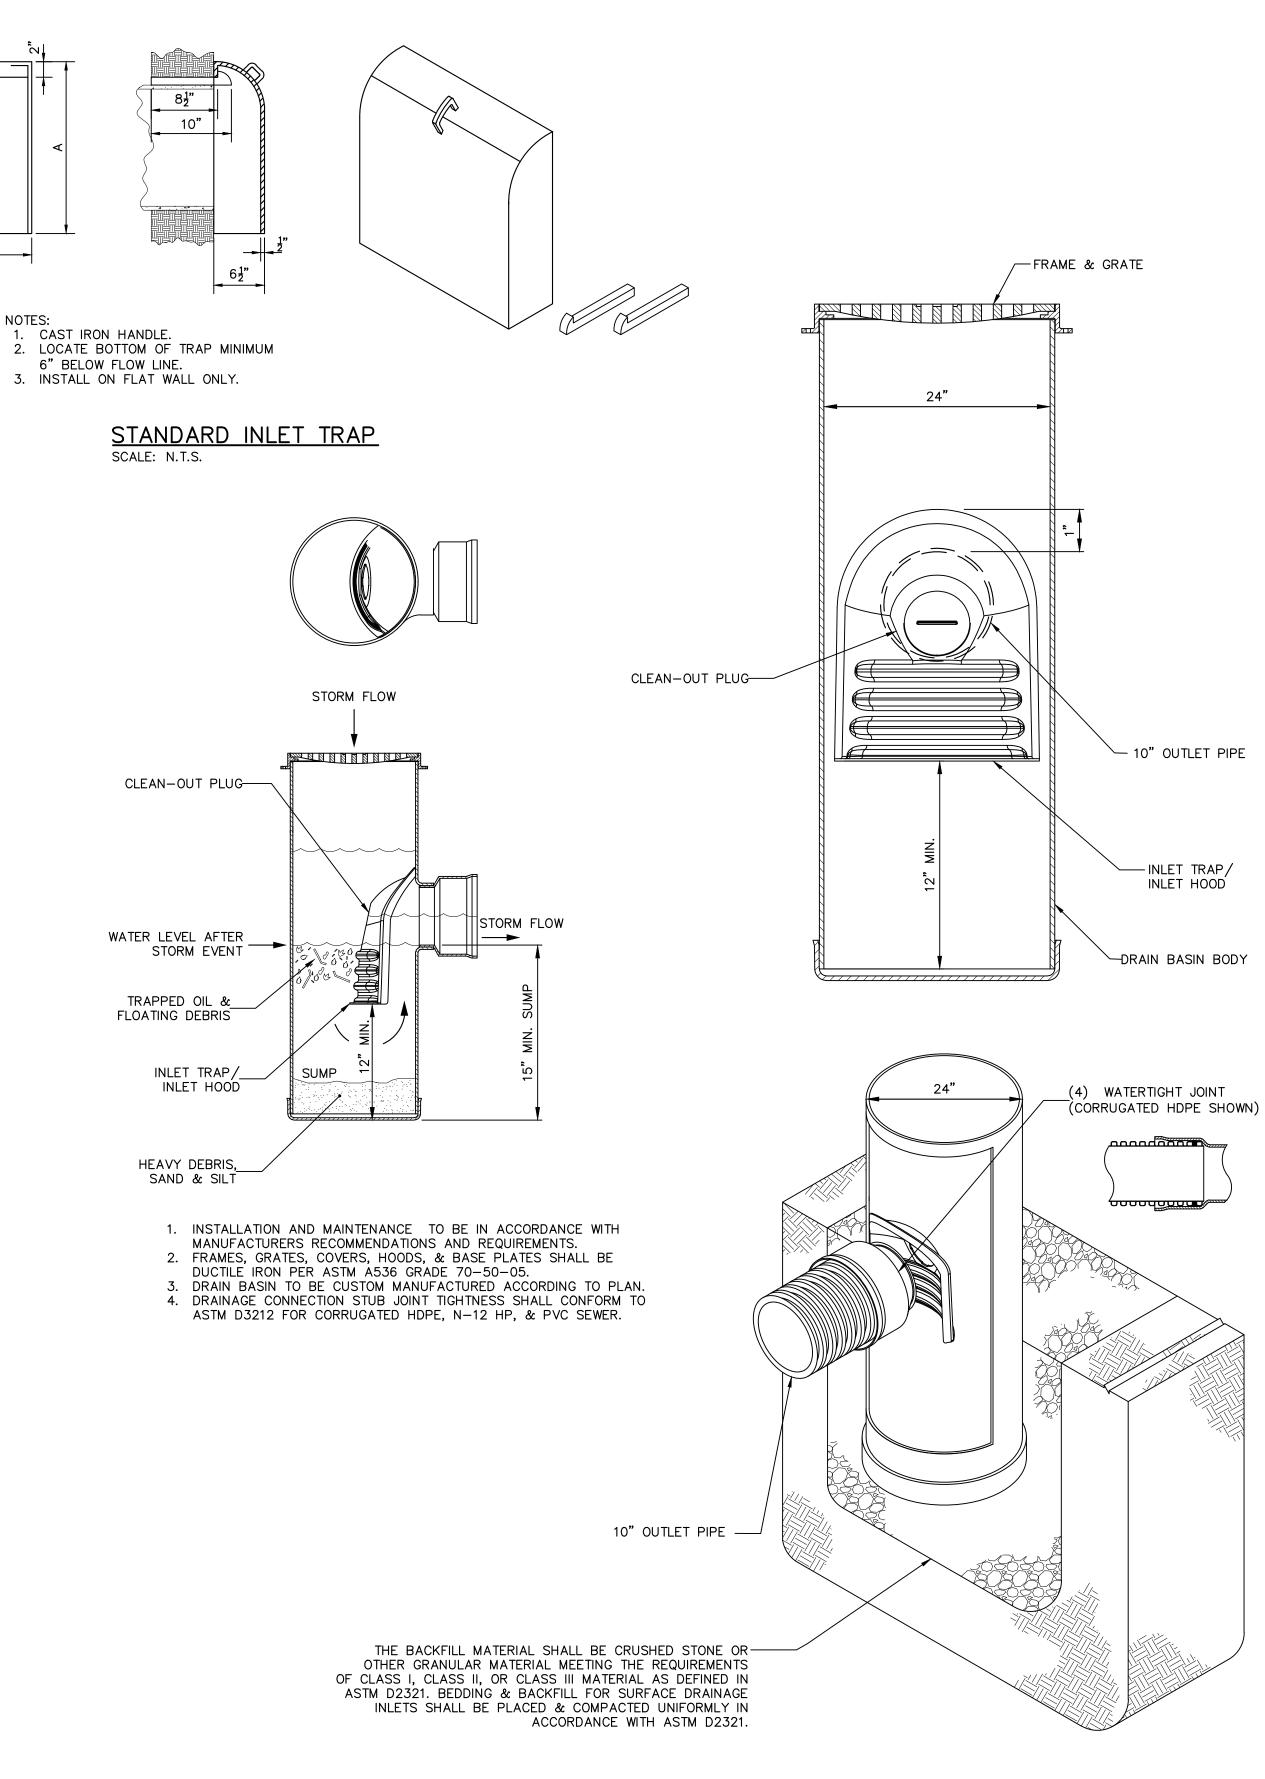

YARD DRAIN

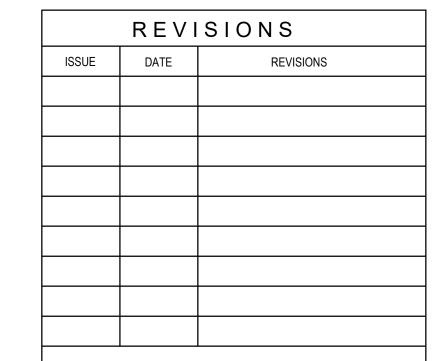



CONSTRUCTION DOCUMENTS

PROJECT COORDINATOR LEEANN SUEN

SMP ARCHITECTS 1600 Walnut Street, 2nd Floor Philadelphia, Pennsylvania 19103 215 985 4410

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GROUND RECONSIDERED

www.groundreconsidered.com 215 790 0727

CIVIL ENGINEER: KS ENGINEERS

www.kseng.com 215 925 0425

STRUCTURAL ENGINEER:
ANN ROTHMANN STRUCTURAL ENGINEERING arstructural.com

610 688 2566 MEP ENGINEER: ARORA ENGINEERS

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CITY OF PHILADELPHIA DEPARTMENT OF PARKS & RECREATION


1515 ARCH STREET


11TH FLOOR, ONE PARKWAY BUILDING PENNSYLVANIA PHILADELPHIA


RENOVATIONS TO THE HAPPY HOLLOW RECREATION CENTER

SIDEWALK CONSTRUCTION **DETAILS**


16	6315E-03-02	DRAWING NO.
DATE	05/13/2025	CE 00
SCALE	AS NOTED	C5.00
DRAWN BY	YLS	
CHECKED BY	NLC	FILE:

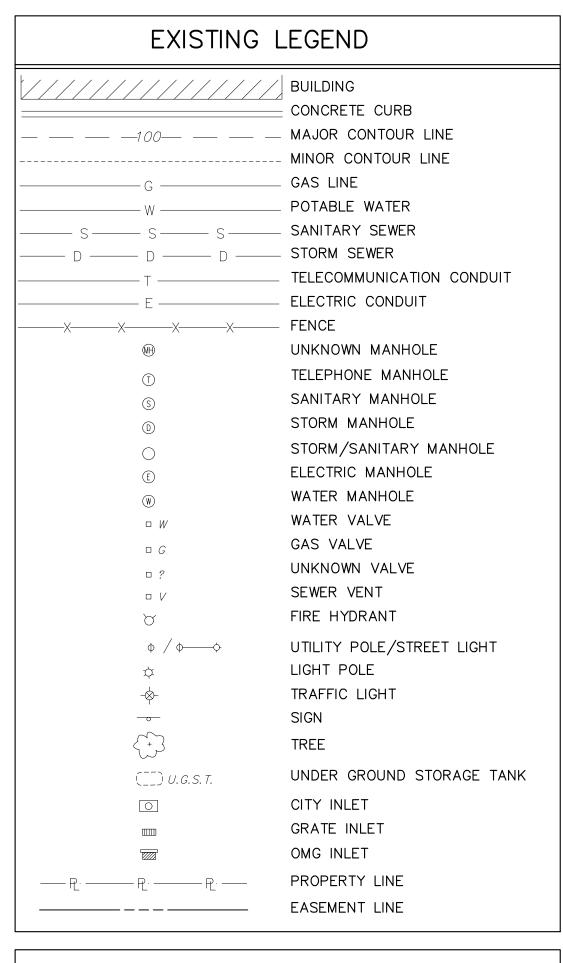

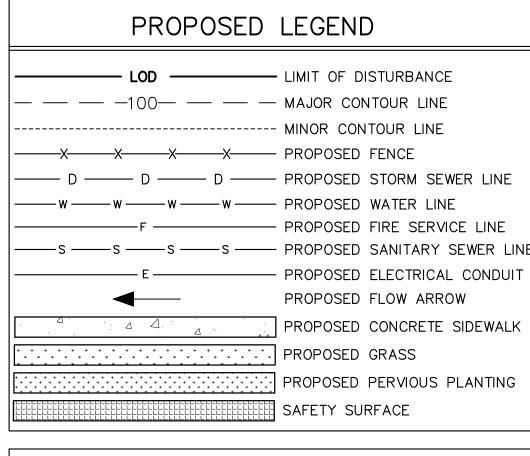

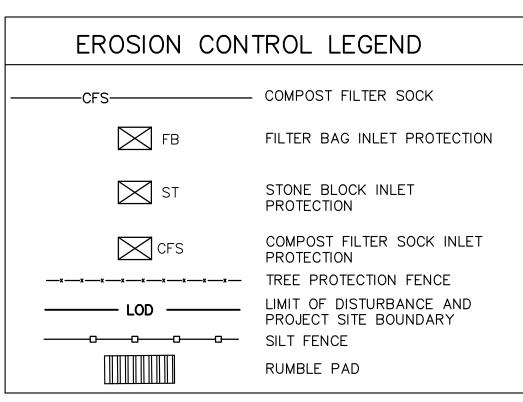

- 1. SURVEY INFORMATION OBTAINED FROM A FIELD SURVEY PERFORMED BY KS ENGINEERS, P.C. IN MAY 2023. SURVEY BASED ON P.A.S.P.C.S. (SOUTH ZONE) NAD83. BEARINGS SHOWN ARE PER CITY PLAN AND DEED OF RECORD. ELEVATIONS ARE REFERENCED TO THE PHILADELPHIA CITY DATUM.
- 2. SUBJECT TO ALL RESTRICTIONS, EASEMENTS AND/OR COVENANTS OF RECORD EITHER WRITTEN OR IMPLIED THAT MAY NOT APPEAR OF THIS PLAN.
- 3. IF BUILDINGS ARE ON THIS PLAN, BUILDING OFFSET DISTANCES SHOWN ARE FOR THE PURPOSE OF CHECKING COMPLIANCE WITH ZONING AND DEED RESTRICTIONS ONLY. NO LIABILITY WILL BE ACCEPTED IF THESE DISTANCES ARE USED FOR ANY OTHER PURPOSES.
- 4. UNDERGROUND UTILITIES AS SHOWN TAKEN FROM FIELD EVIDENCE AND PLANS AS PROVIDED BY THE VARIOUS UTILITY AUTHORITIES (PA ONE CALL SERIAL NOS. 20231392686, 20231392742, 20231392743, 20231392798, 20231392846, AND 20231392847). THE ACCURACY REGARDING UTILITY LOCATION AND/OR DEPTH CANNOT BE GUARANTEED AND ADDITIONAL UNDERGROUND UTILITIES NOT DEPICTED ON THIS PLAN MAY EXIST. BEFORE EXCAVATIONS ARE BEGUN, THE PENNSYLVANIA ONE CALL SYSTEM AT 1-800-242-1776 SHALL BE CONTACTED AT LEAST 3-10 DAYS PRIOR TO COMMENCEMENT OF ANY DEMOLITION OR EXCAVATION ACTIVITIES IN ACCORDANCE WITH ALL APPLICABLE LAWS, RULES AND REGULATIONS.
- 5. INFORMATION PERTAINING TO LOTS OTHER THAN THE SUBJECT PARCEL IS SHOWN FOR INFORMATIONAL PURPOSES ONLY.
- 6. SITE LIES WITHIN THE MAPPED LIMITS OF FLOOD ZONE X, AS SHOWN ON THE FEMA FLOOD INSURANCE RATE MAP COMMUNITY-PANEL NO. 4207570095G, DATED 01/17/2007 FOR THE CITY OF PHILADELPHIA.
- 7. PROJECT SITE IS NOT LOCATED IN A SPECIAL FLOOD HAZARD ZONE AND THERE ARE NO WETLANDS ON SITE. THERE ARE NO WATER COURSES OR BODIES OF WATER LOCATED WITHIN 100 FEET OF THE PROPERTY.
- 8. PAVEMENT SUBBASE SHALL NOT BE EXPOSED DURING THE MILLING PROCESS.
- 9. ALL TEMPORARY PERIMETER FENCING SHALL HAVE DUST CONTROL FABRIC.

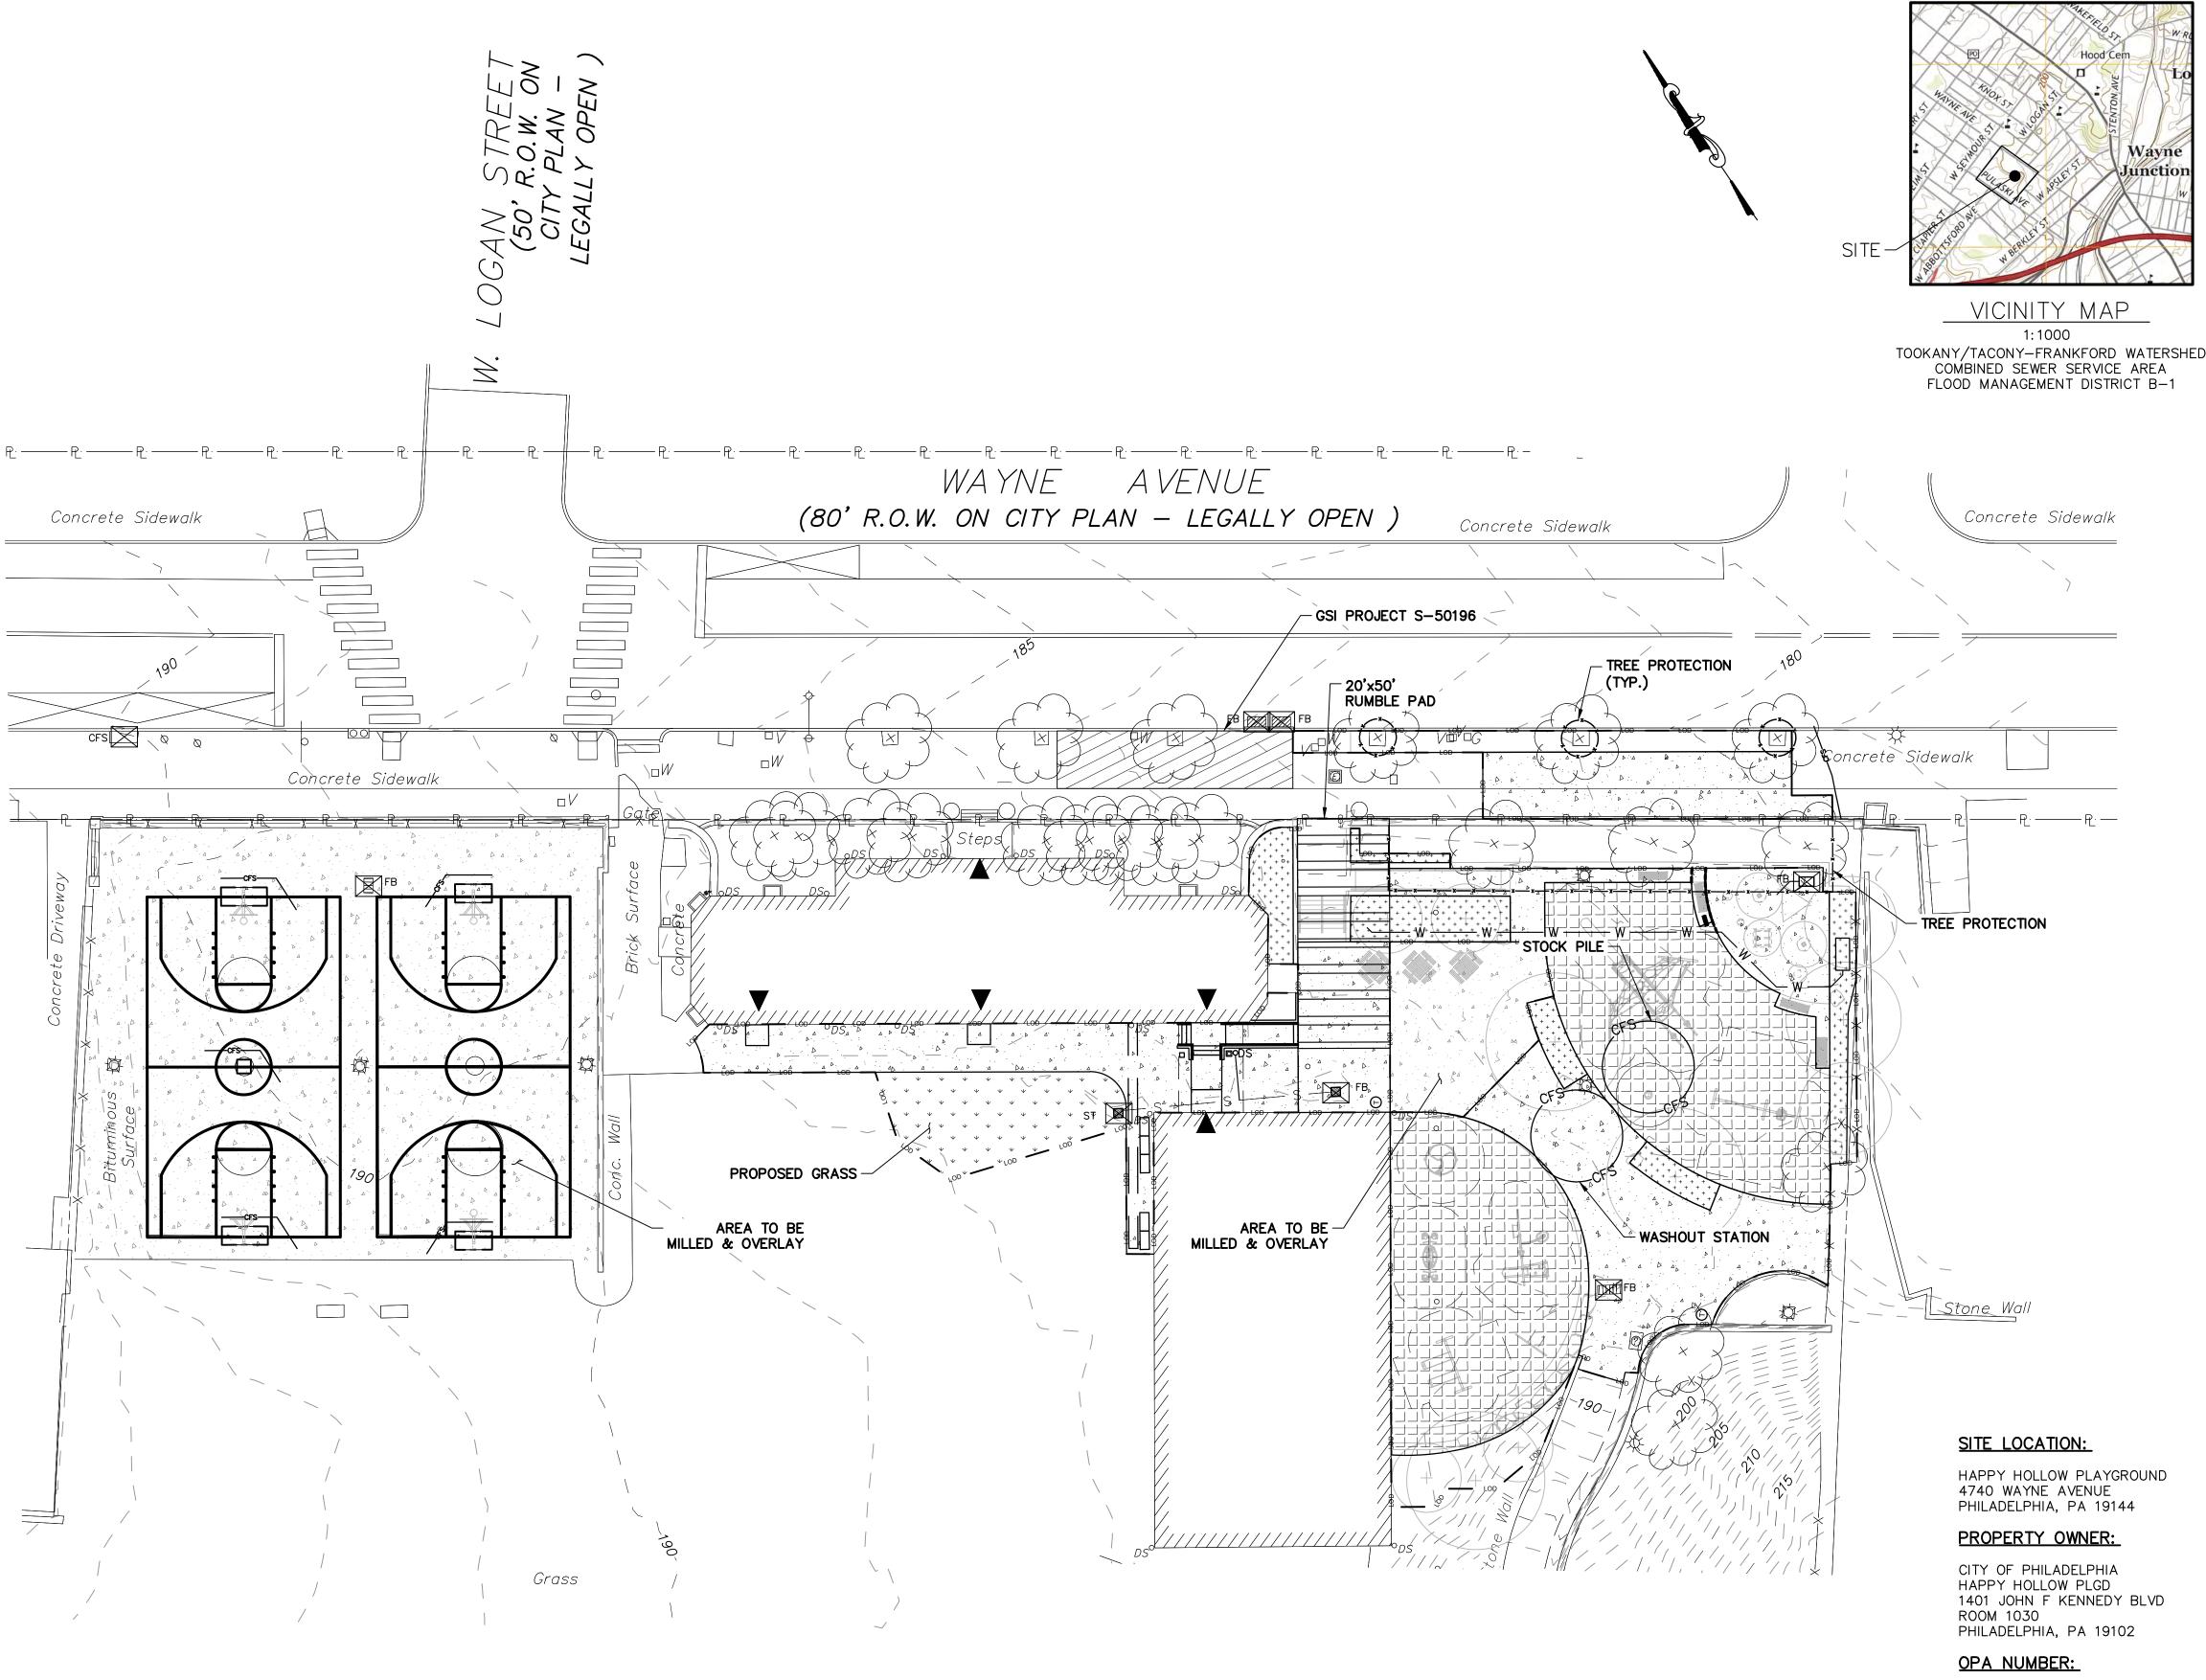


LIMIT OF DISTURBANCE (LOD) SUMMARY 14,552 SF ON-SITE 0.33 ACRES PUBLIC R.O.W 1,530 SF 0.04 ACRES

TOTAL 16,082 SF 0.37 ACRES

> PWD TRACKING No. FY24-HAPP-7780-01



PENNSYLVANIA LAW REQUIRES 3 WORKING DAYS NOTICE FOR CONSTRUCTION PHASE & 10 WORKING DAYS IN DESIGN STAGE Pennsylvania One Call System, Inc. 1-800-242-1776

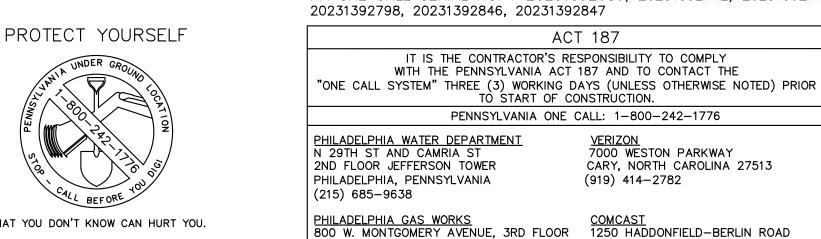

PHILADELPHIA, PENNSYLVANIA 19122

KING OF PRUSSIA, PENNSYLVANIA 19406

PECO-CONSTRUCTION DEPARTMENT 450 S HENDERSON ROAD SUITE B

(215) 684-6796

(484) 681-5720

785509700


GROSS AREA = 181,055 S.F.

IMPERVIOUS AREA = 54,075 S.F.

CHERRY HILL, NEW JERSEY 08034

AREA:


PA ONE CALL SERIAL NO.: 20231392686, 20231392742, 20231392743,

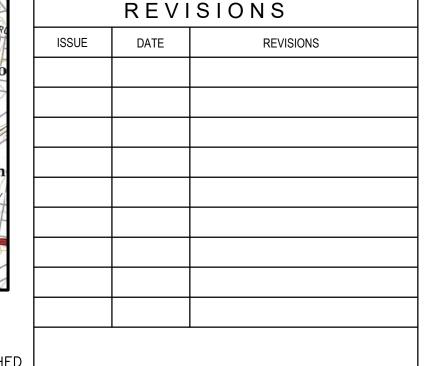



CONSTRUCTION DOCUMENTS

LEEANN SUEN

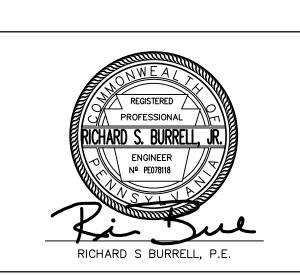

SMP ARCHITECTS 1600 Walnut Street, 2nd Floor Philadelphia, Pennsylvania 19103 215 985 4410

LANDSCAPE ARCHITECT: GROUND RECONSIDERED www.groundreconsidered.com

215 790 0727 CIVIL ENGINEER: KS ENGINEERS www.kseng.com

215 925 0425

PROJECT COORDINATOR

STRUCTURAL ENGINEER:
ANN ROTHMANN STRUCTURAL ENGINEERING arstructural.com 610 688 2566

MEP ENGINEER: ARORA ENGINEERS www.aroraengineers.com 610 459 7900

ROOFING CONSULTANT:
STEPHEN McLAUGHLIN ROOFING CONSULTANT stevemclaughlin.biz 856 287 2424

CITY OF PHILADELPHIA DEPARTMENT OF PARKS & RECREATION


1515 ARCH STREET


11TH FLOOR, ONE PARKWAY BUILDING PHILADELPHIA PENNSYLVANIA PROJECT TITLE

RENOVATIONS TO THE HAPPY HOLLOW RECREATION CENTER

EROSION AND SEDIMENT CONTROL PLAN


PROJECT NO.		DRAWING NO.
16	315E-03-02	
DATE	05/13/2025	CE1 01
SCALE	AS NOTED	
DRAWN BY	YLS	
CHECKED BY	NLC	FILE:
NOTE:	ALL DIMENSIONS AND CONDITIONS S	

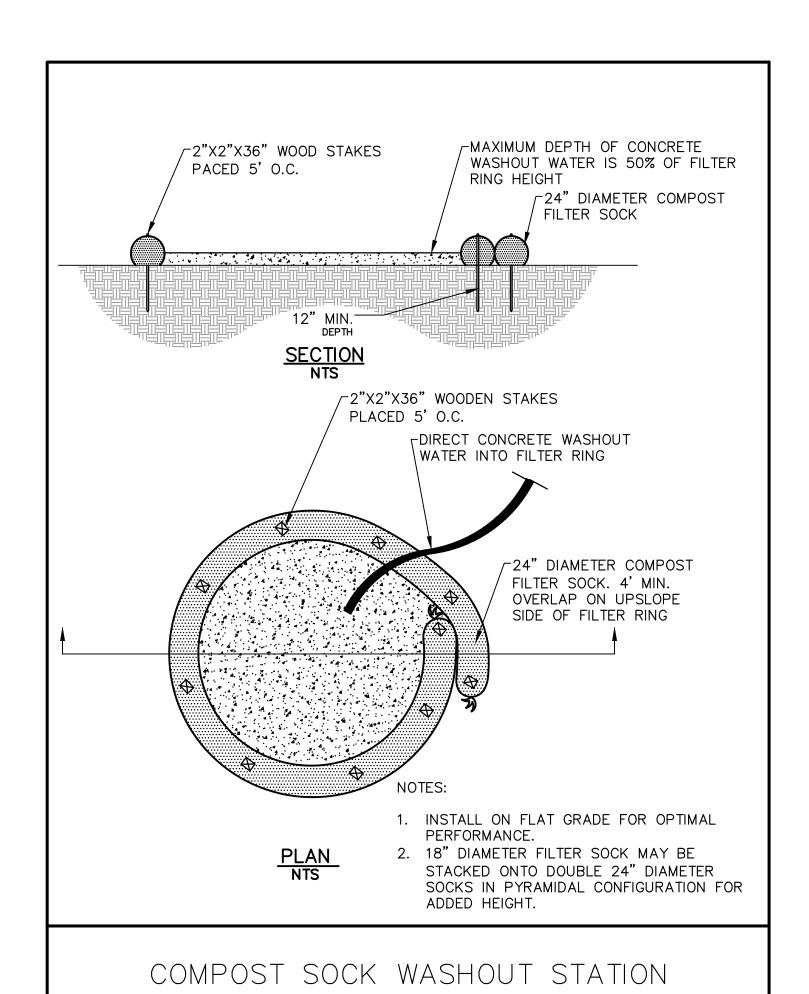


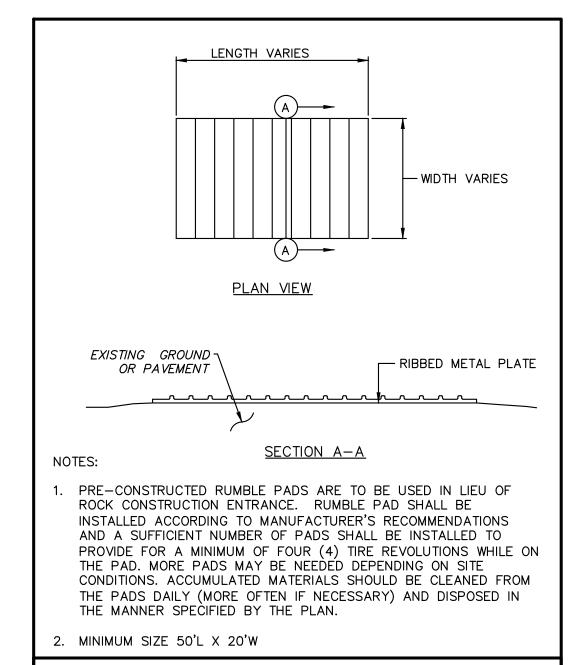


RUMBLE PAD


(CONSTRUCTION ENTRANCE)

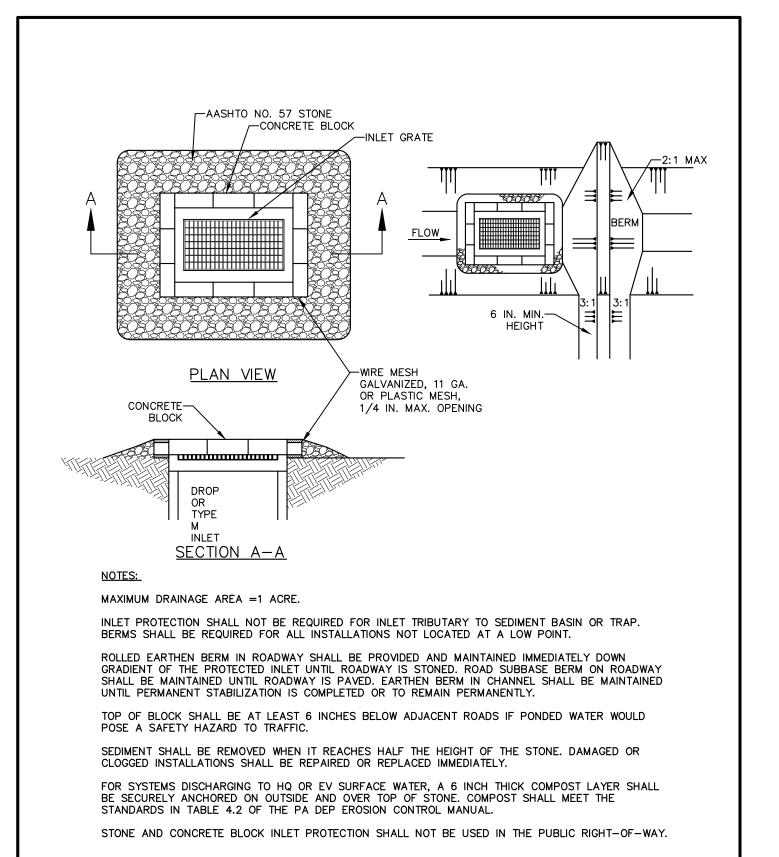


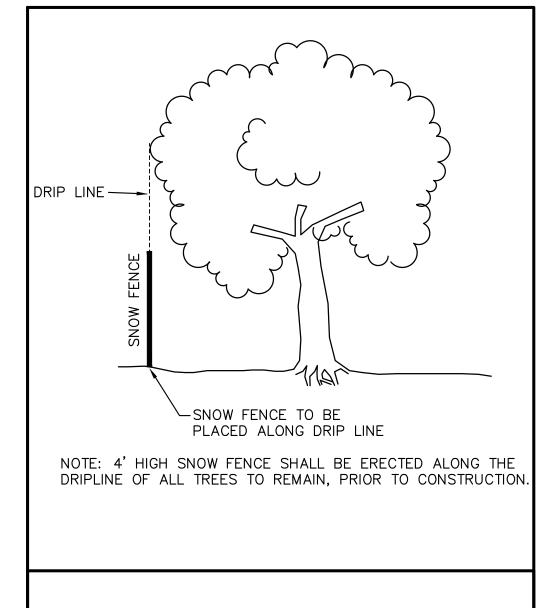

STONE AND CONCRETE BLOCK INLET PROTECTION

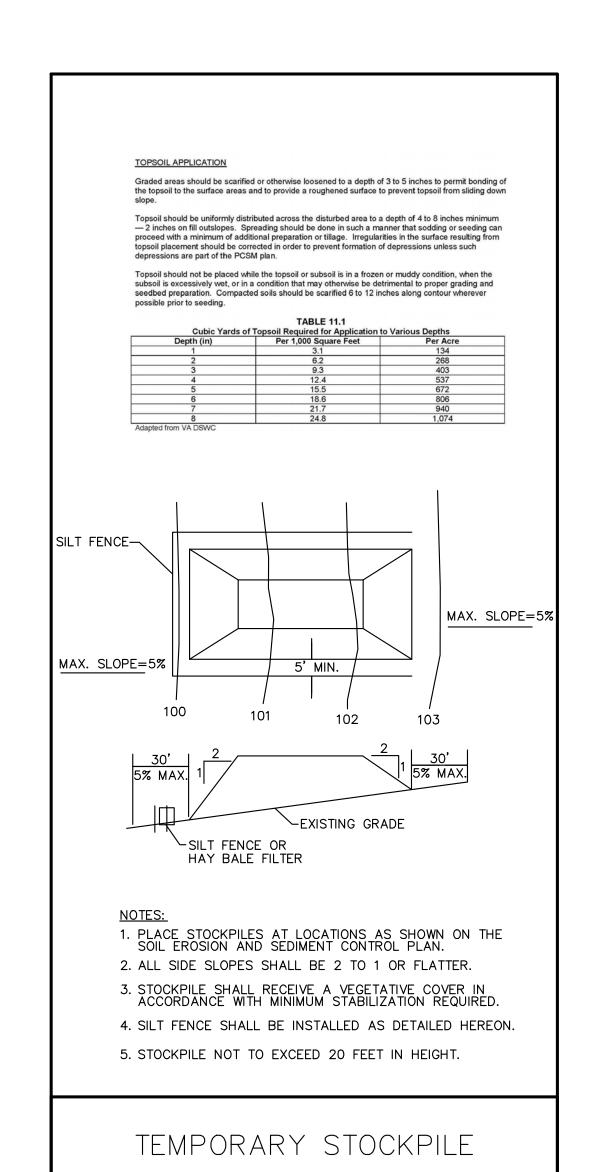

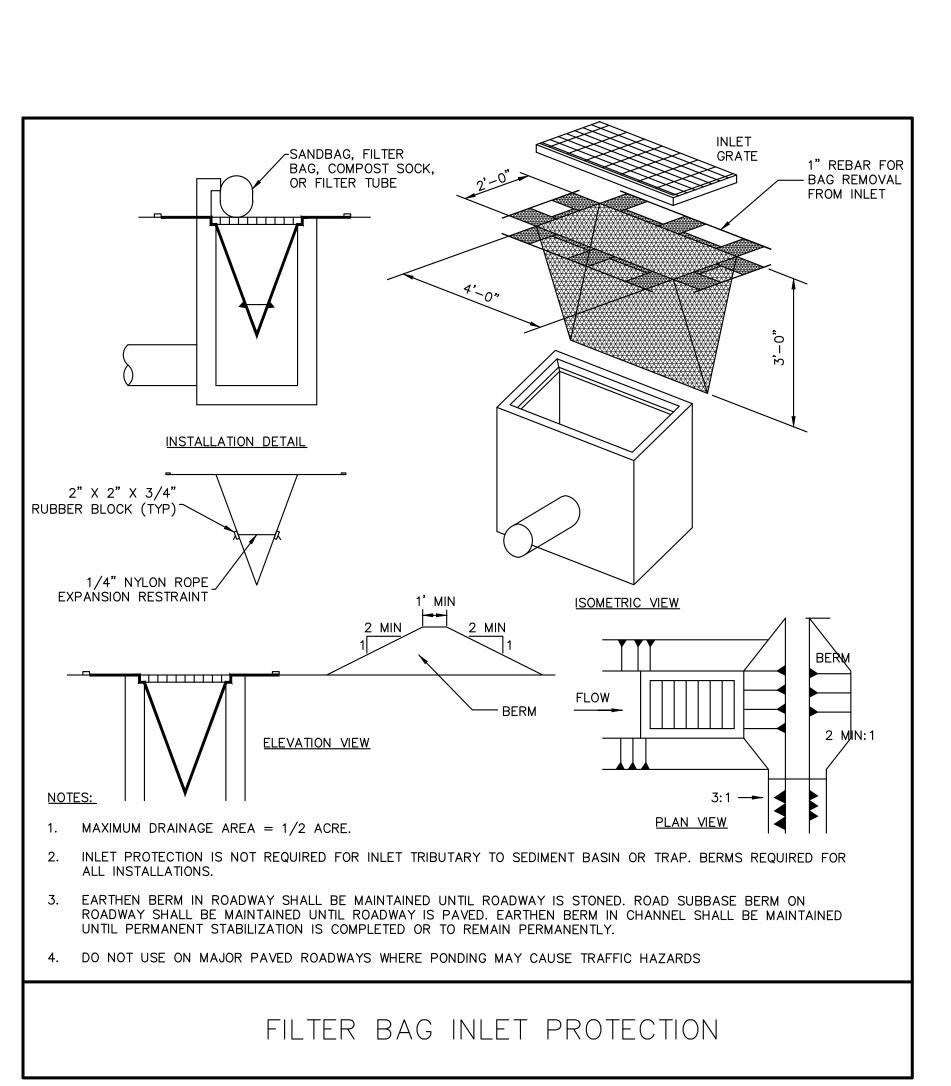

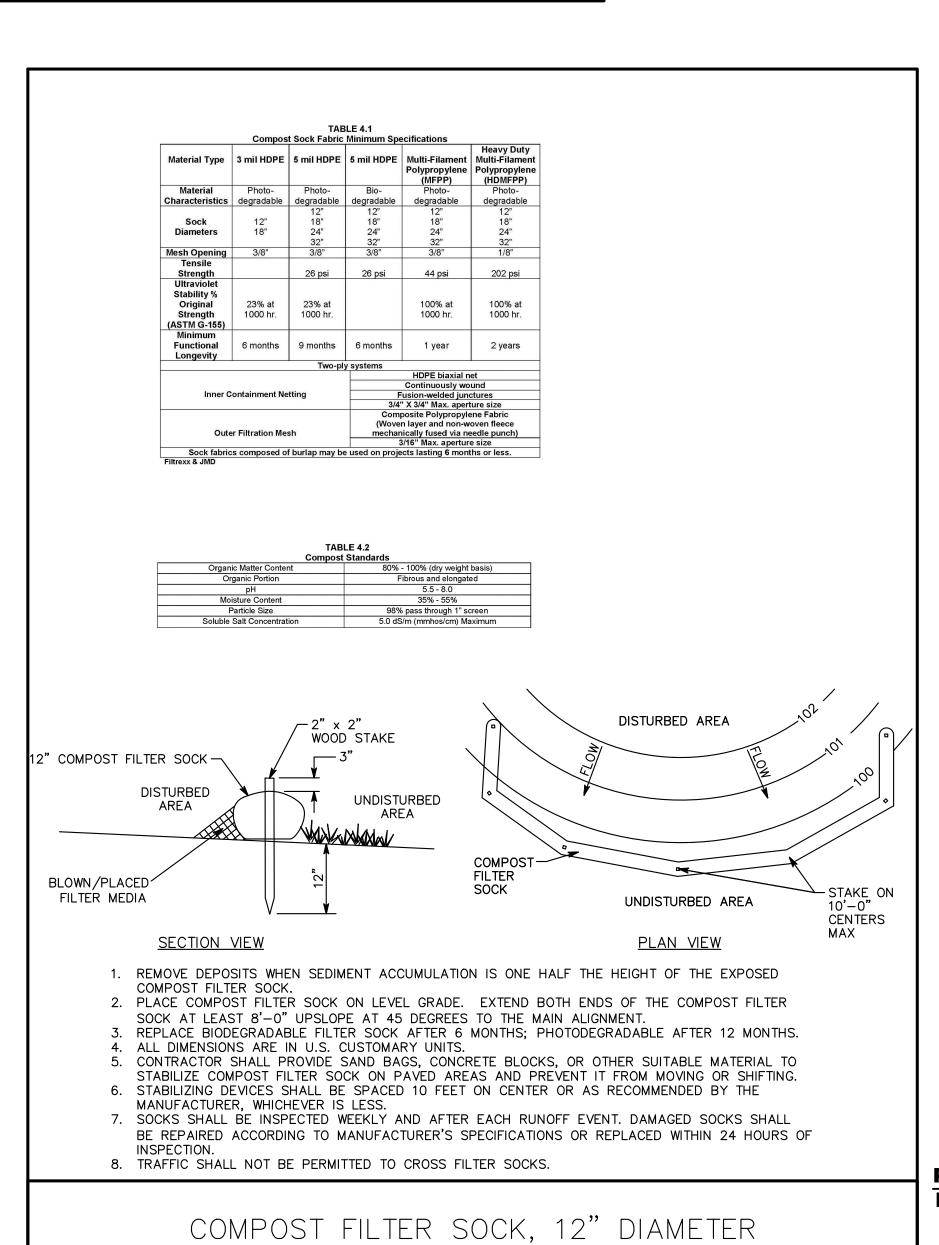

PWD TRACKING No. FY24-HAPP-7780-01

TREE PROTECTION DETAIL

REVISIONS

CONSTRUCTION DOCUMENTS

LEEANN SUEN

PROJECT COORDINATOR

SMP ARCHITECTS

Philadelphia, Pennsylvania 19103

LANDSCAPE ARCHITECT: GROUND RECONSIDERED

www.groundreconsidered.com

STRUCTURAL ENGINEER:
ANN ROTHMANN STRUCTURAL ENGINEERING

ROOFING CONSULTANT:
STEPHEN McLAUGHLIN ROOFING CONSULTANT

CITY OF PHILADELPHIA

DEPARTMENT OF PARKS & RECREATION

1515 ARCH STREET 11TH FLOOR, ONE PARKWAY BUILDING

RENOVATIONS TO THE HAPPY

HOLLOW RECREATION CENTER

EROSION & SEDIMENT

CONTROL DETAILS

ALL DIMENSIONS AND CONDITIONS SHALL BE VERIFIED BY THE CONTACTOR AT THE SITE BEFORE PROCEEDING WITH THE WORK

16315E-03-02

05/13/2025

AS NOTED

YLS

PENNSYLVANIA

CE5.01

215 985 4410

215 790 0727

CIVIL ENGINEER: KS ENGINEERS

www.kseng.com 215 925 0425

arstructural.com 610 688 2566

610 459 7900

PHILADELPHIA

MEP ENGINEER:
ARORA ENGINEERS www.aroraengineers.com

stevemclaughlin.biz 856 287 2424

REVISIONS

DATE

ISSUE

STANDARD EROSION AND SEDIMENT CONTROL NOTES:

- 1. AN INDUSTRIAL WASTE PERMIT WILL BE REQUIRED SHOULD PUMPING TO CITY-OWNED INFRASTRUCTURE BECOME NECESSARY DURING CONSTRUCTION. ALL PUMPING OF WATER FROM ANY WORK AREA SHALL BE DONE ACCORDING TO THE PROCEDURE DESCRIBED IN THIS PLAN, OVER UNDISTURBED VEGETATED AREAS.
- 2. INLET PROTECTION SHOULD BE PROVIDED FOR ALL INLETS OWNED BY PWD THAT ARE LOCATED WITHIN ONE BLOCK OF THE PROJECT SITE.
- PWD IS NOT RESPONSIBLE FOR ANY CLEANING OR REPAIRS NEEDED ON CITY—OWNED INFRASTRUCTURE DUE TO FAILURE OF ANY EROSION AND SEDIMENT CONTROL PRACTICES. IT IS THE RESPONSIBILITY OF THE CONTRACTOR TO ENSURE THAT ALL EROSION AND SEDIMENT CONTROL PRACTICES ARE FUNCTIONING IN ACCORDANCE WITH THE APPROVED
- 4. INSPECTION AND MAINTENANCE OF ALL EROSION AND SEDIMENT CONTROL BEST MANAGEMENT PRACTICES SHALL OCCUR ON A WEEKLY BASIS, BEFORE ANY ANTICIPATED PRECIPITATION EVENTS, AND AFTER ALL PRECIPITATION EVENTS.
- 5. THE MAXIMUM HEIGHT FOR STOCKPILES AREAS SHALL BE 20 FEET. THE MAXIMUM SIDE SLOPE FOR STOCKPILE AREAS SHALL NOT EXCEED 2:1.
- 6. THE ROCK CONSTRUCTION ENTRANCE THICKNESS SHALL BE CONSTANTLY MAINTAINED ON-SITE. A STOCKPILE SHALL BE MAINTAINED ON-SITE FOR THIS PURPOSE. AT THE END OF EACH CONSTRUCTION DAY, ALL SEDIMENT DEPOSITED ON PAVED ROADWAYS SHALL BE REMOVED AND RETURNED TO THE CONSTRUCTION SITE. IN NO CASE SHALL THE SEDIMENT BE WASHED, SHOVELED, OR SWEPT INTO ANY ROADSIDE DITCH, STORM SEWER, OR SURFACE WATER.
- 7. FILTER FABRIC FENCE SHOULD BE INSTALLED AT LEVEL GRADE. BOTH ENDS OF EACH FENCE SECTION SHOULD BE EXTENDED AT LEAST 8 FEET UPSLOPE AT 45 DEGREES TO THE MAIN BARRIER ALIGNMENT. SUPPORT STAKES SHALL BE SPACED AT A MAXIMUM OF 8 FEET. SEDIMENT MUST BE REMOVED WHEN ACCUMULATIONS REACH 1/2 THE ABOVE GROUND HEIGHT OF THE FILTER FENCE.
- 8. ANY FENCE SECTION WHICH HAS BEEN UNDERMINED OR TOPPED MUST BE IMMEDIATELY REPLACED WITH A ROCK FILTER OUTLET. SEDIMENT MUST BE REMOVED WHEN ACCUMULATIONS REACH 1/3 THE HEIGHT OF THE OUTLET.
- 9. EROSION CONTROL BLANKETING SHALL BE INSTALLED ON ALL SLOPES 3H:1V OR STEEPER WITHIN 50 FEET OF A SURFACE WATER AND ON ALL OTHER DISTURBED AREAS SPECIFIED 30. E&S BMP'S SHALL REMAIN FUNCTIONAL AS SUCH UNTIL ALL AREAS TRIBUTARY TO THEM ON THE PLAN MAPS AND/OR DETAIL SHEETS.
- 10. IMMEDIATELY UPON DISCOVERING UNFORESEEN CIRCUMSTANCES POSING THE POTENTIAL IMPLEMENT APPROPRIATE BEST MANAGEMENT PRACTICES TO MINIMIZE THE POTENTIAL FOR EROSION AND SEDIMENT POLLUTION AND NOTIFY PWD AND PA DEP.
- 11. UNTIL THE SITE IS STABILIZED, ALL E&S BMP'S SHALL BE MAINTAINED PROPERLY. MAINTENANCE SHALL INCLUDE INSPECTIONS OF ALL E&S BMP'S PRIOR TO ANY ANTICIPATED STORM EVENT, AFTER EACH RUNOFF EVENT AND ON A WEEKLY BASIS. ALL PREVENTATIVE AND REMEDIAL MAINTENANCE WORK, INCLUDING CLEAN OUT, REPAIR, REPLACEMENT, REGRADING, RESEEDING, REMULCHING, AND RENETTING, MUST BE PERFORMED IMMEDIATELY. IF THE E&S BMP'S FAIL TO PERFORM AS EXPECTED, REPLACEMENT BMP'S, OR MODIFICATIONS OF THOSE INSTALLED, WILL BE REQUIRED.
- 12. ALL EARTH DISTURBANCES, INCLUDING CLEARING AND GRUBBING, AS WELL AS CUTS AND FILLS, SHALL BE DONE IN ACCORDANCE WITH THE APPROVED E&S PLAN. A COPY OF THE APPROVED DRAWINGS MUST BE AVAILABLE AT THE PROJECT SITE AT ALL TIMES. PWD SHALL BE NOTIFIED OF ANY CHANGES TO THE APPROVED PLAN PRIOR TO IMPLEMENTATION OF THOSE CHANGES. PWD MAY REQUIRE A WRITTEN SUBMITTAL OF THOSE CHANGES FOR REVIEW AND APPROVAL AT ITS DISCRETION.
- 13. AT LEAST THREE (3) DAYS PRIOR TO STARTING ANY EARTH DISTURBANCE ACTIVITIES, OR EXPANDING INTO AN AREA PREVIOUSLY UNMARKED. THE PENNSYLVANIA ONE CALL SYSTEM INC. SHALL BE NOTIFIED AT 1-800-242-1776 FOR THE LOCATION OF EXISTING UNDERGROUND UTILITIES.
- 14. ALL EARTH DISTURBANCE ACTIVITIES SHALL PROCEED IN ACCORDANCE WITH THE SEQUENCE PROVIDED ON THE PLAN DRAWINGS. DEVIATION FROM THAT SEQUENCE MUST BE APPROVED IN WRITING BY PWD AND THE PA DEP PRIOR TO IMPLEMENTATION.
- 15. AREAS TO BE FILLED ARE TO BE CLEARED, GRUBBED, AND STRIPPED OF TOPSOIL TO REMOVE TREES, VEGETATION, ROOTS, AND OTHER OBJECTIONABLE MATERIAL.
- 16. CLEARING, GRUBBING, AND TOPSOIL STRIPPING SHALL BE LIMITED TO THOSE AREAS DESCRIBED IN EACH STAGE OF THE CONSTRUCTION SEQUENCE. GENERAL SITE CLEARING UNTIL THE E&S BMP'S SPECIFIED BY THE BMP'S SEQUENCE FOR THAT STAGE HAVE BEEN INSTALLED AND ARE FUNCTIONING AS DESCRIBED IN THIS E&S PLAN.
- 17. AT NO TIME SHALL CONSTRUCTION VEHICLES BE ALLOWED TO ENTER AREAS OUTSIDE THE LIMIT OF DISTURBANCE BOUNDARIES SHOWN ON THE PLAN MAPS. THESE AREAS MUST BE CLEARLY MARKED AND FENCED OFF BEFORE CLEARING AND GRUBBING OPERATIONS
- 18. A LOG SHOWING DATES THAT E&S BMP'S WERE INSPECTED AS WELL AS ANY DEFICIENCIES FOUND AND THE DATE THEY WERE CORRECTED SHALL BE MAINTAINED ON THE SITE AND BE MADE AVAILABLE TO PWD AT THE TIME OF INSPECTION.
- 19. ALL SEDIMENT REMOVED FROM BMP'S SHALL BE DISPOSED OF IN THE FOLLOWING MANNER: REMOVAL AND DISPOSAL TO BE AT AN OFF-SITE LOCATION IN ACCORDANCE WITH ALL LOCAL, STATE AND FEDERAL REGULATIONS.
- 20. AREAS WHICH ARE TO BE TOPSOILED SHALL BE SCARIFIED TO A MINIMUM DEPTH OF THREE TO FIVE INCHES -- SIX TO 12 INCHES ON COMPACTED SOILS -- PRIOR TO PLACEMENT OF TOPSOIL. AREAS TO BE VEGETATED SHALL HAVE A MINIMUM FOUR INCHES OF TOPSOIL IN PLACE PRIOR TO SEEDING AND MULCHING. FILL OUTSLOPES SHALL HAVE A MINIMUM OF TWO INCHES OF TOPSOIL.

- 21. ALL FILLS SHALL BE COMPACTED AS REQUIRED TO REDUCE EROSION, SLIPPAGE, SETTLEMENT, SUBSIDENCE, OR OTHER RELATED PROBLEMS. FILL INTENDED TO SUPPORT BUILDINGS, STRUCTURES, AND CONDUITS, ETC. SHALL BE COMPACTED IN ACCORDANCE WITH LOCAL REQUIREMENTS OR CODES.
- 22. ALL EARTHEN FILLS SHALL BE PLACED IN COMPACTED LAYERS NOT TO EXCEED NINE INCHES IN THICKNESS.
- 23. FILL MATERIALS SHALL BE FREE OF FROZEN PARTICLES, BRUSH, ROOTS, SOD, OR OTHER FOREIGN OR OBJECTIONABLE MATERIALS THAT WOULD INTERFERE WITH OR PREVENT CONSTRUCTION OF SATISFACTORY FILLS.
- 24. FROZEN MATERIALS OR SOFT, MUCKY, OR HIGHLY COMPRESSIBLE MATERIALS SHALL NOT BE INCORPORATED INTO FILLS.
- 25. FILL SHALL NOT BE PLACED ON SATURATED OR FROZEN SURFACES.
- 26. SEEPS OR SPRINGS ENCOUNTERED DURING CONSTRUCTION SHALL BE HANDLED IN ACCORDANCE WITH THE STANDARD AND SPECIFICATION FOR SUBSURFACE DRAIN OR OTHER APPROVED METHOD.
- 27. ALL GRADED AREAS SHALL BE PERMANENTLY STABILIZED IMMEDIATELY UPON REACHING FINISHED GRADE. CUT SLOPES IN COMPETENT BEDROCK AND ROCK FILLS NEED NOT BE 5. SEEDING DATES SHALL BE BETWEEN MARCH 1 AND NOVEMBER 15. VEGETATED. SEEDED AREAS WITHIN 50 FEET OF A SURFACE WATER, OR AS OTHERWISE SHOWN ON THE PLAN DRAWINGS, SHALL BE BLANKETED ACCORDING TO THE STANDARDS TEMPORARY MULCHING OF THIS PLAN.
- 28. IMMEDIATELY AFTER EARTH DISTURBANCE ACTIVITIES CEASE IN ANY AREA OR SUB-AREA OF THE PROJECT, THE OPERATOR SHALL STABILIZE ALL DISTURBED AREAS. DURING NON-GERMINATING MONTHS, MULCH OR PROTECTIVE BLANKETING SHALL BE APPLIED AS DESCRIBED IN THE PLAN. AREAS NOT AT FINISHED GRADE, WHICH WILL BE REACTIVATED WITHIN ONE YEAR, MAY BE STABILIZED IN ACCORDANCE WITH THE TEMPORARY STABILIZATION SPECIFICATIONS. THOSE AREAS WHICH WILL NOT BE REACTIVATED WITHIN ONE YEAR SHALL BE STABILIZED IN ACCORDANCE WITH THE PERMANENT STABILIZATION SPECIFICATIONS.
- 29. PERMANENT STABILIZATION IS DEFINED AS A MINIMUM UNIFORM, PERENNIAL 70% VEGETATIVE COVER OR OTHER PERMANENT NON-VEGETATIVE COVER WITH A DENSITY SUFFICIENT TO RESIST ACCELERATED EROSION. CUT AND FILL SLOPES SHALL BE CAPABLE OF RESISTING FAILURE DUE TO SLUMPING, SLIDING, OR OTHER MOVEMENTS.
- ARE PERMANENTLY STABILIZED OR UNTIL THEY ARE REPLACED BY ANOTHER BMP'S APPROVED BY PWD AND PA DEP.
- MANAGEMENT PRACTICES. AREAS DISTURBED DURING REMOVAL OR CONVERSION OF THE E&S BMP'S SHALL BE STABILIZED IMMEDIATELY. IN ORDER TO ENSURE RAPID REVEGETATION OF DISTURBED AREAS, SUCH REMOVAL/CONVERSIONS ARE TO BE DONE ONLY DURING THE GERMINATING SEASON.
- 32. SEDIMENT BASINS AND/OR TRAPS SHALL BE KEPT FREE OF ALL CONSTRUCTION WASTE, WASH WATER, AND OTHER DEBRIS HAVING POTENTIAL TO CLOG THE BASIN/TRAP OUTLET STRUCTURES AND/OR POLLUTE THE SURFACE WATERS. (WHEN APPLICABLE)
- PCSMP APPROVED BY PWD (WHERE APPLICABLE). NO CHANGE OR DEVIATION FROM THE APPROVED PCSMP IS PERMITTED WITHOUT PRIOR APPROVAL FROM PWD. 34. ALL WORK ASSOCIATED WITH PWD WATER CONVEYANCE AND SEWER INFRASTRUCTURE SHALL BE DONE IN ACCORDANCE WITH THE CITY OF PHILADELPHIA WATER DEPARTMENT

"WATER MAIN STANDARD DETAILS AND CORROSION CONTROL SPECIFICATIONS", 1985

33. DURING CONSTRUCTION, THE SELECTED CONTRACTOR IS EXPECTED TO FOLLOW THE

- EDITION, AND "STANDARD DETAILS AND STANDARD SPECIFICATIONS FOR SEWERS", 1985 35. CONTACT PWD WATER TRANSPORT RECORDS (1101 MARKET STREET, 2ND FLOOR, PHONE: 215-685-6271) FOR ADDITIONAL APPROVALS AND PERMITS REQUIRED FOR ALL WATER SERVICES, METERS, AND CONNECTIONS TO THE EXISTING AND/OR PROPOSED PWD
- 36. ALL BUILDING MATERIALS AND WASTES SHALL BE REMOVED FROM THE SITE AND RECYCLED OR DISPOSED OF IN ACCORDANCE WITH THE PADEP'S SOLID WASTE MANAGEMENT REGULATIONS AT 25 PA CODE 260.1 ET SEQ., 271.1 AND 287.1 ET SEQ. NO BUILDING MATERIALS OR WASTES OR UNUSED BUILDING MATERIALS SHALL BE BURNED,
- GRUBBING, AND TOPSOIL STRIPPING MAY NOT COMMENCE IN ANY STAGE OF THE PROJECT 37. A DUST CONTROL PERMIT WILL BE REQUIRED WHEN COMPLETELY DEMOLISHING A BUILDING 7. LIQUID MULCH BINDERS MAY BE USED TO ANCHOR SALT HAY, HAY OR STRAW MULCHES. OR STRUCTURE THAT IS MORE THAN THREE (3) STORIES, GREATER THAN FORTY (40) FEET TALL, OR ENCOMPASSES MORE THAN TEN THOUSAND (10,000) SQUARE FEET; COMPLETELY OR PARTIALLY DEMOLISHING ANY BUILDING OR STRUCTURE BY IMPLOSION; OR ENGAGING IN EARTHWORKS, DEFINED AS "CLEAING, GRUBBING, OR EARTH DISTURBANCE OF ANY LAND EXCESS OF 5,000 SQUARE FEET."
 - SITE STABILIZATION METHODS (TEMPORARY & PERMANENT STABILIZATION)

BURIED, DUMPED, OR DISCHARGED AT THE SITE.

- 1. STRAW MULCH MUST BE APPLIED AT 3.0 TONS PER ACRE 2. MULCH WITH MULCH CONTROL NETTING OR EROSION CONTROL BLANKETS MUST
- BE INSTALLED ON ALL SLOPES GREATER THAN 3:1.
- 3. STRAW MULCH SHALL BE APPLIED IN LONG STRANDS, NOT CHOPPED OR FINELY

TEMPORARY SEEDING

MULCHED:

1. THE FOLLOWING SURFACES OF THE SITE SHALL BE TEMPORARILY SEEDED AND

- A. THE SURFACE OF TOPSOIL STOCKPILES. B. THE SURFACE OF EXPOSED EARTH AREAS THAT WILL BE EXPOSED WITHOUT CONSTRUCTION ACTIVITY THEREON.
- 2. SEEDING SHALL OCCUR IMMEDIATELY AFTER ESTABLISHMENT OF THE TOPSOIL STOCKPILES OR ROUGH GRADED AREAS. THE FOLLOWING SHALL BE PLANTED: A. 40 LBS./ACRE ANNUAL RYE GRASS - COMMON, 100% P.L.S.
- 3. PREPARE AREAS TO BE SEEDED AS FOLLOWS: A. REMOVE ALL DEBRIS, INCLUDING LARGE STONES. APPLY LIME AT A RATE OF 3 TONS PER ACRE AND FERTILIZER AT THE RATE OF 50-50-50 PER ACRE AND
- WORK INTO SOIL. B. SOW SEED AT THE INDICATED RATE. DIVIDE SEED INTO TWO EQUAL LOTS. SOW ONE LOT IN ONE DIRECTION. SOW SECOND LOT AT RIGHT ANGLE TO

FIRST. RAKE SEEDED AREA SLIGHTLY. ROLL SURFACE LIGHTLY TO FIRM SOIL

- 4. PLACE CLEAN DRY STRAW OR HAY MULCH WITHIN 48 HOURS AFTER SEEDING. PLACE AT THE RATE OF 3 TONS PER ACRE.

AROUND SEED.

- MULCH PROPOSED LANDSCAPE AREAS OR TOPSOIL STOCKPILES IF EARTHWORK IS COMPLETED OUTSIDE OF THE RECOMMENDED PLANTING SEASONS FOR TEMPORARY SEEDING OR DUE TO UNFAVORABLE WEATHER CONDITIONS.
- MULCH SHALL BE APPLIED IMMEDIATELY FOLLOWING THE ESTABLISHMENT OF THE TOPSOIL STOCKPILE OR ROUGH GRADING.
- 3. MULCH WITH SUITABLE FIBROUS GROUND, SHREDDED AGED HARDWOOD, PINE WOOD BARK OR STRAW, UNIFORMLY AND CONTINUOUSLY TO A LOOSE DEPTH OF 3 INCHES MINIMUM. ANCHOR AS REQUIRED.
- 4. PROPERLY MAINTAIN MULCHED AREAS UNTIL PERMANENT STABILIZATION MEASURES ARE COMPLETE. REAPPLY MULCH MATERIALS WHICH BECOME DISLODGED AS INITIAL OR MODIFIED RATES AS NECESSARY. IF A SLOPE FAILURE OCCURS WHICH REQUIRES REDRESSING, EXCAVATION, OR THE ESTABLISHMENT OF A NEW SLOPE, REPLACE MULCH AS NECESSARY.

PERMANENT SEEDING

- PERMANENT SEEDING SHALL OCCUR IMMEDIATELY AFTER THE FINAL GRADING IS COMPLETED. THE FOLLOWING SEED SHALL BE PLACED UNLESS OTHERWISE SPECIFIED ON THE PLANS OR DIRECTED IN THE FIELD. THE FOLLOWING SEED MIX SHALL BE USED:
- C. 20% CHAMPION PERENNIAL RYE GRASS QUANTITIES ARE OF PURE LIVE SEED (P.L.S.) SPREAD AT A RATE OF 63 LBS. PER ACRE.
- REMOVE ALL DEBRIS, INCLUDING LARGE STONES. TILL SOIL TO A DEPTH OF FOUR INCHES TO SIX INCHES. APPLY LIME AT A RATE OF 4 TONS PER ACRE. APPLY COMMERCIAL 10-20-20 FERTILIZER AT A RATE OF 930 LBS. PER ACRE. WORK FERTILIZER INTO TOP INCH OF SOIL.
- 3. SEED ONLY AT THE FOLLOWING TIMES: A. SPRING: MARCH 1 TO APRIL 30

A. 40% PENNLAWN FINE FESCUE

- B. LATE SUMMER/EARLY FALL: AUGUST 15 TO NOVEMBER 15
- 4. DIVIDE SEED INTO TWO EQUAL LOTS. SOW ONE LOT IN ONE DIRECTION. SOW SECOND LOT AT RIGHT ANGLE TO FIRST LOT. RAKE SEEDED AREA SLIGHTLY. ROLL SURFACE LIGHTLY TO FIRM SOIL AROUND SEED.
- 5. MULCH SEEDED AREAS WITH STRAW OR HAY AT THE RATE OF 3 TONS PER ACRE. ANCHOR MULCH. COMPLY WITH THE REQUIREMENTS OF SECTION 805 - MULCHING, PENNDOT PUBLICATION 408. ANCHOR MULCH AS SPECIFIED.
- 6. MULCHING SHALL BE DONE AT THE MINIMUM RATE OF 3 TONS PER ACRE WITH SALT HAY, HAY OR STRAW MULCHES. PLACE MULCH IMMEDIATELY AFTER SEEDING OR WITHIN 48 HOURS AFTER SEEDING IS COMPLETED. PROPERLY MAINTAIN MULCHED AREAS UNTIL THE ENTIRE PROJECT HAS BEEN COMPLETED. PROMPTLY REAPPLY MULCH MATERIALS WHICH BECOME DISLODGED OR LOST DUE TO WIND, RAIN, OR OTHER CAUSES AT INITIAL RATES
- A. APPLICATIONS SHOULD BE HEAVIER AT EDGES WHERE WIND CATCHES THE MULCH IN VALLEYS AND AT CRESTS OF BANKS. REMAINDER OF AREAS SHOULD BE UNIFORM IN APPEARANCE
- B. USE ONE OF THE FOLLOWING: EMULSIFIED ASPHALT. CLASS E-1 OR E-6. APPLY 31 GALLONS PER 1,000 SQUARE YARDS ON SLOPES LESS THAN 8 FEET HIGH. ON SLOPES 8 FEET HIGH OR MORE, USE 58 GALLONS PER 1,000 SQUARE YARDS. CUTBACK ASPHALT. CLASS RC-250. APPLY 31 GALLONS PER 1.000 SQUARE YARDS ON FLAT AREAS AND ON SLOPES LESS THAN 8 FEET HIGH. ON SLOPES 8 FEET HIGH. OR MORE, USE 58 GALLONS PER 1,000 SQUARE YARDS. NON-ASPHALTIC EMULSION -NATURAL VEGETABLE GUM BLENDED WITH GELLING AND HARDENING AGENTS (TERRA TACK, AR) AS MANUFACTURED BY GRASS GROWERS COMPANY OR EQUAL. APPLY 25

 13. AS SOON AS SLOPES, CHANNELS, DITCHES, AND OTHER DISTURBED AREAS REACH FINAL LBS. PER 1,000 SQUARE YARDS.

MAINTENANCE PROGRAM

1. THE CONTRACTOR WILL BE RESPONSIBLE FOR THE PROPER CONSTRUCTION STABILIZATION. AND MAINTENANCE OF ALL TEMPORARY EROSION AND SEDIMENTATION CONTROL MEASURES AND RELATED ITEMS INCLUDED WITHIN THIS PLAN. THE CONTRACTOR WIL ALSO BE RESPONSIBLE FOR THE PROPER CONSTRUCTION AND STABILIZATION OF PERMANENT CONTROL MEASURES AND RELATED ITEMS INCLUDED WITHIN THIS PLAN

- 2. THE OWNER WILL BE RESPONSIBLE FOR THE MAINTENANCE OF ALL PERMANENT CONTROL
- 3. UNTIL THE SITE IS STABILIZED, ALL EROSION AND SEDIMENT BMP'S MUST BE MAINTAINED PROPERLY. MAINTENANCE MUST INCLUDE INSPECTIONS OF ALL EROSION AND SEDIMENT CONTROL BMP'S AFTER EACH RUNOFF EVENT AND ON A WEEKLY BASIS. ALL PREVENTATIVE AND REMEDIAL MAINTENANCE WORK. INCLUDING CLEAN OUT. REPAIR. REPLACEMENT, REGRADING, RESEEDING, REMULCHING, AND RENETTING, MUST BE DONE IMMEDIATELY. IF EROSION AND SEDIMENT CONTROL BMP'S FAIL TO PERFORM AS EXPECTED, REPLACEMENT BMP'S, OR MODIFICATIONS TO THOSE INSTALLED WILL BE
- 4. SEDIMENT REMOVED FROM BMP'S SHALL BE DISPOSED OF AT AN OFF-SITE LOCATION IN ACCORDANCE WITH ALL LOCAL, STATE AND FEDERAL REGULATIONS.
- 5. SOIL SEDIMENT REMOVED FROM SILT FENCE DURING REGULAR MAINTENANCE WILL BE INCORPORATED BACK INTO THE EARTHWORK AS FILL ON THE SITE. SOIL SEDIMENT MATERIAL SHALL BE DISTRIBUTED ON—SITE WITHOUT CHANGING DRAINAGE PATTERNS DURING A SPECIFIC CONSTRUCTION STAGE. SILT FENCE INSTALLED ON THE PROJECT SITE SHALL BE MAINTAINED AS FOLLOWS: A. THE FENCE CONDITION WILL BE INSPECTED ONCE A WEEK OR AFTER EVERY STORM
- EVENT, WHICHEVER COMES FIRST. ANY NECESSARY REPAIRS WILL BE MADE IMMEDIATELY. B. ACCUMULATED SEDIMENTS WILL BE REMOVED AS REQUIRED TO KEEP THE FENCE FUNCTIONAL DEPOSITS WILL BE REMOVED WHERE ACCUMULATIONS REACH ONE-HALF
- C. UNDERCUTTING OR EROSION OF THE TOE ANCHOR WILL BE REPLACED IMMEDIATELY WITH ROCK FILTER OUTLETS. D. ANY MANUFACTURER'S RECOMMENDATIONS WILL BE ADHERED TO WHEN REPLACING
- FILTER FABRIC FENCE DUE TO WEATHERING. 6. AT THE END OF EACH CONSTRUCTION DAY, ANY SEDIMENT DEPOSITED ON PUBLIC
- ROADWAYS, WILL BE REMOVED AND RETURNED TO THE CONSTRUCTION SITE. WASHING OF THE ROADWAY WITH WATER WILL NOT BE PERMITTED.
- A. SEDIMENT MUST BE REMOVED FROM STORM WATER INLET PROTECTION AFTER EACH RUNOFF FVFNT.


CONSTRUCTION SEQUENCE:

THE ABOVE-GROUND HEIGHT OF THE FENCE.

- 1. AT LEAST 7 DAYS PRIOR TO STARTING ANY EARTH DISTURBANCE THE INSPECTIONS COORDINATOR OF PWD (OFFICE 215-685-6387), MUST BE CALLED TO SCHEDULE A PRECONSTRUCTION MEETING.
- 2. AT LEAST 3 DAYS BEFORE STARTING ANY EARTH DISTURBANCE ACTIVITIES, ALL CONTRACTORS INVOLVED IN THOSE ACTIVITIES SHALL NOTIFY THE PENNSYLVANIA ONE CALL SYSTEM INCORPORATED AT 1-800-242-1776 FOR BURIED UTILITY LOCATIONS.
- 3. CONSTRUCTION FENCE TO BE INSTALLED AROUND THE PERIMETER OF THE WORK AREA. THE CONTRACTOR SHALL COORDINATE THE LOCATION OF THE FENCE WITH THE OWNER AND/OR ENGINEER. CONSTRUCTION FENCE LOCATION SHALL BE INSTALLED TO PROTECT THE PUBLIC FROM LAND DISTURBANCE ACTIVITIES AND TO MAINTAIN PEDESTRIAN ACCESS
- 4. INSTALL COMPOST FILTER SOCK DOWNHILL FROM ALL EARTH MOVING ACTIVITIES AND AS SHOWN ON THE PLAN. ALTHOUGH OFF SITE AREAS ARE PAVED, COMPOST FILTER SOCK OR OTHER EROSION CONTROL PRACTICES SHALL BE INSTALLED AROUND THE PERIMETER OF THE WORK AREA AS SHOWN ON THE PLAN.
- 5. INSTALL INLET PROTECTION AS SHOWN ON THE PLAN AND ANY INLETS WITHIN ONE BLOCK OF PROJECT SITE. EXISTING INLETS SHALL BE PROTECTED THROUGHOUT THE DURATION OF THE CONSTRUCTION.
- 5. INSTALL CONSTRUCTION ENTRANCE AS SHOWN AND IN ACCORDANCE WITH THE CONSTRUCTION ENTRANCE DETAIL.
- 7. CLEAR AND GRUB SITE, DEMOLISH EXISTING PAVING, CURBING, AND FENCING AS REQUIRED. SAWCUT PAVED AREAS AS NEEDED TO MINIMIZE EARTH DISTURBANCE. EXCAVATE TRENCHES FOR PROPOSED SEWER CONNECTIONS. DEMOLISHED MATERIAL SHALL BE REMOVED FROM THE SITE AND DISCARDED IN ACCORDANCE WITH APPLICABLE CITY, STATE, AND FEDERAL REGULATIONS.
- 8. ROUGH GRADE SUBBASE TO REQUIRED DEPTHS.
- 9. INSTALL PROPOSED SITE IMPROVEMENTS, INCLUDING PLAY SURFACE, PLAY EQUIPMENT, MINI PITCH, RAMPS, AND BENCHES.
- 10. TOPSOIL AND SEED GRASSED AREAS, INSTALL PLANTS AND TREES.
- 11. SWEEP PAVED AREAS DAILY TO PREVENT TRACKING OF SOIL OFF-SITE.
- 12. UPON COMPLETION OF ALL EARTH DISTURBANCE ACTIVITIES AND PERMANENT STABILIZATION OF ALL DISTURBED AREAS, THE OWNER AND/OR OPERATOR SHALL CONTACT INSPECTIONS COORDINATOR OF PWD (OFFICE: 215-685-6387) FOR A FINAL INSPECTION PRIOR TO REMOVAL OF THE E&SC BMPS. AS SOON AS SLOPES, CHANNEL DITCHES AND OTHER DISTURBED AREAS REACH FINAL GRADE, THEY MUST BE STABILIZED. CESSATION OF ACTIVITY FOR FOUR (4) DAYS OR LONGER REQUIRES TEMPORARY TABILIZATION.
- GRADE, THEY MUST BE STABILIZED. CESSATION OF ACTIVITY FOR FOUR (4) DAYS OR LONGER REQUIRES TEMPORARY STABILIZATION.
- 14. REMOVE SOIL EROSION MEASURES AFTER SITE HAS BEEN INSPECTED AND STABILIZED.

GSI STANDARD NOTES:

- 1. THE APPROVED WORK SHALL BE DONE IN THE PRESENCE OF A PWD INSPECTOR.
- THE CONTRACTOR PERFORMING THIS WORK IS TO NOTIFY PWD'S GREEN STORMWATER OPERATIONS AT LEAST 7 DAYS PRIOR TO STARTING WORK TO SCHEDULE AN INSPECTOR (ATTN: GERALD BRIGHT, 215-300-9079).
- 3. APPROVAL OF THESE PLANS BY THE WATER DEPARTMENT IS STRICTLY LIMITED TO THE PROTECTION OF GREEN STORMWATER INFRASTRUCTURE SHOWN WITHIN THE LIMITS OF THE CITY OF PHILADELPHIA PUBLIC RIGHT OF WAY.
- 4. ANY CHANGE TO, OR DEVIATION FROM THE FINAL APPROVED DESIGN PLANS DURING CONSTRUCTION MUST BE APPROVED BY PWD.
- 5. CONTRACTOR MUST UTILIZE ADEQUATE SHORING METHOD TO PROTECT THE STABILITY OF THE PWD GREEN STORMWATER INFRASTRUCTURE.
- 6. CONTRACTOR MUST COMPLY WITH EROSION AND SEDIMENT CONTROL REQUIREMENTS DURING CONSTRUCTION. SEE PWD REGULATION 5501.3 AND 60.4, PHILA CODE S 13-603 AND 25 PA CODE CHAPTER 102.
- 7. SUFFICIENT EROSION AND SEDIMENTATION CONTROL MEASURE WILL BE INSTALLED AND MAINTAINED BY THE CONTRACTOR AS TO PREVENT SEDIMENTATION OF STORMWATER SYSTEMS. GREEN STORMWATER INFRASTRUCTURE SYSTEMS DETERMINED BY PWD TO BE INADEQUATELY PROTECTED AND THEREBY COMPROMISED WILL BE REPLACED TO THE EXTENT REQUIRED BY PWD (UP TO AND INCLUDING FULL REPLACEMENT) AT NO ADDITIONAL COST
- CONTRACTOR IS REQUIRED TO UNDERTAKE NECESSARY MEASURES TO PREVENT SEDIMENT FROM LEAVING THE WORK SITE, TO PREVENT EROSIVE CONDITIONS AND TO SUPPRESS DUST ON THE SITE AND SURROUNDING AREAS. CONTRACTOR MUST COVER AND SURROUND STOCKPILED WITH EROSION CONTROL MEASURE TO ENSURE SEDIMENT DOES NOT MIGRATE INTO THE PUBLIC ROW OR ENTER THE PUBLIC SEWER IF CONTRACTOR IS HAND DIGGING OR EXCAVATING, CONTRACTOR MUST SWEEP WORK SITE AT THE END OF EACH WORKDAY. THE CITY MAY REQUIRE THE CONTRACTOR/OWNER TO CLEAN CITY-OWNED INLETS AND SYSTEMS AFFECTED BY NONCOMPLIANT OR FAILED E&S CONTROLS.
- 9. CONTRACTOR MUST INSTALL INLET PROTECTION MEASURE AT ALL INLETS ADJACENT TO OR WITHIN THE WORK AREA INLET PROTECTION MEASURES MUST BE INSPECTED DAILY TO ENSURE PROPER PLACEMENT AND MAINTAINED, POSITIONED OR REPLACED AS NEEDED TO ENSURE PROPER FUNCTION AND TO PREVENT FLOODING REFER TO PWD GUIDANCE FOR APPROPRIATE MATERIALS AND PROTECTION METHODS FOR OPEN-MOUTH INLETS, HIGHWAY GRATE INLETS, TRENCH DRAINS AND CURB-CUT INLETS.
- 10. THERE WILL NOT BE A CONFLICT BETWEEN THE EXISTING GSI AND THE PROPOSED DESIGN SHOWN ON THE PLAN.

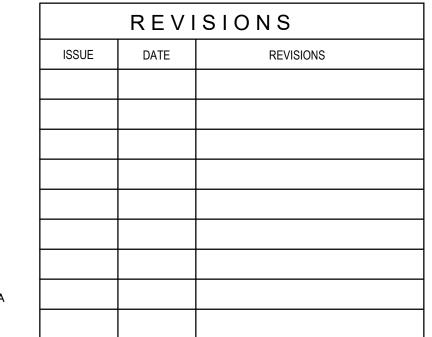



CONSTRUCTION DOCUMENTS

PROJECT COORDINATOR

LEEANN SUEN

ENGINEER Nº PF078118

SMP ARCHITECTS

1600 Walnut Street, 2nd Floor Philadelphia, Pennsylvania 19103 215 985 4410

LANDSCAPE ARCHITECT: GROUND RECONSIDERED www.groundreconsidered.com

215 790 0727 CIVIL ENGINEER
KS ENGINEERS

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610 459 7900

215 925 0425 STRUCTURAL ENGINEER:
ANN ROTHMANN STRUCTURAL ENGINEERING arstructural.com

610 688 2566 **ARORA ENGINEERS** www.aroraengineers.com

ROOFING CONSULTANT:
STEPHEN McLAUGHLIN ROOFING CONSULTANT stevemclaughlin.biz 856 287 2424

CITY OF PHILADELPHIA DEPARTMENT OF PARKS & RECREATION

11TH FLOOR, ONE PARKWAY BUILDING

PENNSYLVANIA

1515 ARCH STREET

PHILADELPHIA

RENOVATIONS TO THE HAPPY HOLLOW RECREATION CENTER

EROSION & SEDIMENT CONTROL NOTES

16315E-03-02 05/13/2025 AS NOTED YLS CHECKED B NLC

TREE REPLACEMENT REQUIREMENTS

§14-705(1)	(g)	TREE REPLACEMENT REQUIREMENTS	QTY.	CALIPER (IN.)
	1	EXISTING NON-HERITAGE TREES TO BE REMOVED	-	-
	2	EXISTING TREES TO BE REMOVED - NOT INCLUDED, SEE NOTES	7	99
	3	EXISTING HERITAGE TREES TO BE REMOVED	-	-
	4	TOTAL TREE REPLACEMENT REQUIREMENT (#1 + #3)	-	-
	5	TOTAL PROPOSED REPLACEMENT TREES (SEE L5.0)	10	25
	6	CAL. INCHES REMAINING (PAY FEE IN-LIEU) (#4 - #5)	-	-

TREE REPLACEMENT NOTES

REPLACEMENT REQUIREMENTS.

24" x 36" SIGN LAMINATED IN-

、L1.0 / Scale: 1/4" = 1'-0"

PLASTIC SPACED EVERY

50'-0" ALONG THE FENCE

TREE PROTECTION FENCE, TYP.

- INVASIVE SPECIES, OR A THREAT TO LIFE OR PROPERTY IN ACCORDANCE WITH 14-705 (1)(g)(.2) AND THEREFORE EXCLUDED FROM TREE REPLACEMENT REQUIREMENTS.
- 2. IN ACCORDANCE WITH PHILADELPHIA ZONING ORDINANCE SECTION 14-705 (1)(g): EACH REPLACEMENT TREE SHALL BE MINIMUM 2.5" DBH AT PLANTING. SEE TREE SCHEDULE ON L002 FOR REQUIRED

1. 7 EXISTING TREES TO BE REMOVED ARE DEEMED BY ARBORIST TO BE DEAD, DAMAGED, DISEASED, AN

- 3. IN ACCORDANCE WITH PHILADELPHIA ZONING ORDINANCE SECTION 14-705(1)(g)(.3) ANY TREES REQUIRED BY § 14-705(1)(d), § 14-705(1)(e), or § 14-803(5) SHALL BE COUNTED TOWARDS THE TOTAL
- 4. PER PHILADELPHIA ZONING ORDINANCE SECTION 14-705 (c) (.9), FOR EACH DBH INCH OF TREE WAIVED FROM THE TREE REPLACEMENT REQUIREMENTS, AN IN-LIEU FEE IS REQUIRED AS FOLLOWS: UP TO 75 DBH INCHES PER ACRE = \$400 PER INCH
- GREATER THAN 75 AND LESS THAN 250 DBH INCHES PER ACRE = \$200 PER INCH GREATER THAN 250 DBH INCHES PER ACRE = \$50 PER INCH
- 5. MULTI-STEM TREES NOTED AT 6'-8' HT. IN PROPOSED PLANTING SCHEDULE (REFER TO L5.0) ARE ASSUMED TO BE THE EQUIVALENT OF 2.5" CAL. FOR REPLACEMENT VALUE.

ON-SITE LANDSCAPE AND TREE REQUIREMENTS

§14-705(1)(d)		LANDSCAPE BUFFERING REQUIREMENTS (8-FT WIDE, 1 TREE, 3 SHRUBS/ 20 LF)	QTY.	UNIT
	1 BUFFER ZONE		112	LF
	2	TOTAL BUFFERING SHRUBS (#1 / 20 x 3)	17	-
	3	TOTAL BUFFERING TREES (#1 / 20)	6	-
§14-705(1)	(e)	YARD TREE REQUIREMENTS (1 TREE/1,600SF. OPEN SPACE)	QTY.	SF
	4	PROJECT AREA	23,712	SF
	5	EXISTING STRUCTURE FOOTPRINT TO REMAIN	4,069	SF
	6	OPEN SPACE AREA (#4 - #5)	19,463	SF
	7	TOTAL YARD TREES (#6 / 1600)	12	-
	8	TOTAL TREES (#3 + #7)	18	-
	9	TOTAL PRESERVATION CREDITS	28	-
	10	TOTAL TREES REQUIRED (#9 - #10)	0	-

DEMOLITION NOTES REMOVE ALL PAVEMENT AND CONSTRUCTION DEBRIS AS INDICATED ON PLAN. PAVING BASE MATERIALS MAY REMAIN

IF CONSISTENT WITH SPECIFIED AGGREGATE BASE 2. DEMOLISH FOOTINGS AND FOUNDATIONS OF ALL SITE

ELEMENTS TO BE REMOVED.

3. USE CARE WHEN REMOVING TREES WITHIN CANOPIES AND ROOTZONES OF EXISTING TREES TO REMAIN. CUT STUMPS FLUSH WITH GRADE

4. REFER TO GRADING PLAN TO CONFIRM EXTENT OF MILL AND

PROTECTION NOTES

OVERLAY

1. USE CARE WHEN REMOVING STRUCTURES THAT ABUT EXISTING STRUCTURES TO AVOID DAMAGE TO EXISTING STRUCTURES TO REMAIN.

OVERALL TREE PRESERVATION CREDIT

6	TOTAL PRESERVATION CREDITS @ 2.5"(#5 / 2.5)		28
5	TOTAL PRESERVATION CREDITS	-	71
4	TREES TO BE PRESERVED <5" DBH	-	-
3	TREES TO BE PRESERVED 5" - 8" DBH	3	15
2 TREES TO BE PRESERVED >8" - 12" DBH			32
1	TREES TO BE PRESERVED >12" DBH	2	24
§14-705(1)(h)	PRESERVATION CREDITS	QTY.	CREDIT

TREE PRESERVATION NOTES

1. PER PHILADELPHIA ZONING ORDINANCE SECTION 14-705 (1): TREES TO BE PRESERVED OVER 12" DBH RECEIVE 12 CREDITS TREES TO BE PRESERVED OVER 8" TO 12" DBH RECEIVE 8 CREDITS.


TREES TO BE PRESERVED 5" TO 8" DBH RECEIVE 5 CREDITS. TREES TO BE PRESERVED UNDER 5" DBH RECEIVE 0 CREDITS. CREDIT FOR PRESERVED TREES DOES NOT INCLUDE INVASIVE TREE SPECIES AND TREES IN POOR HEALTH.


2. IN ACCORDANCE WITH PHILADELPHIA ZONING ORDINANCE SECTION 14-705 (1)(g): EACH REPLACEMENT TREE SHALL BE MINIMUM 2.5" DBH AT PLANTING.

3. CALIPER OF TOTAL PRESEVATION CREDITS HAVE BEEN DIVIDED BY 2.5" DBH TO ASSUME QUANTITY OF PRESERVATION CREDITS TO BE APPLIED TO TREES REQUIRED OTHER THAN THOSE UNDER SECTION 14-705(1)(g).

DEMOLISHED

4. CALCULATIONS ARE BASED ON ARBORIST REPORT: "HAPPY HOLLOW RECREATION CENTER: TREE INVENTORY AND ASSESSMENT REPORT," BY MORRIS ARBORETUM, JASON LUBAR, BCMA, DATED 07/26/2023.

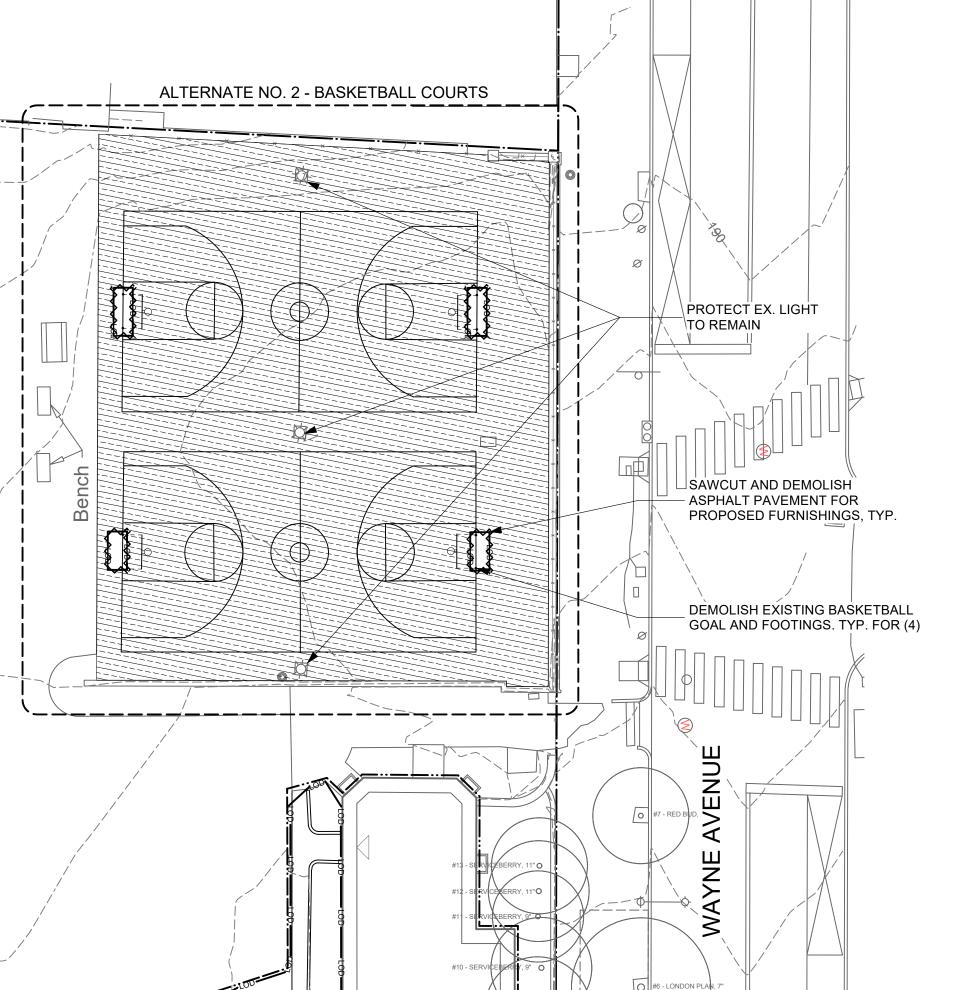

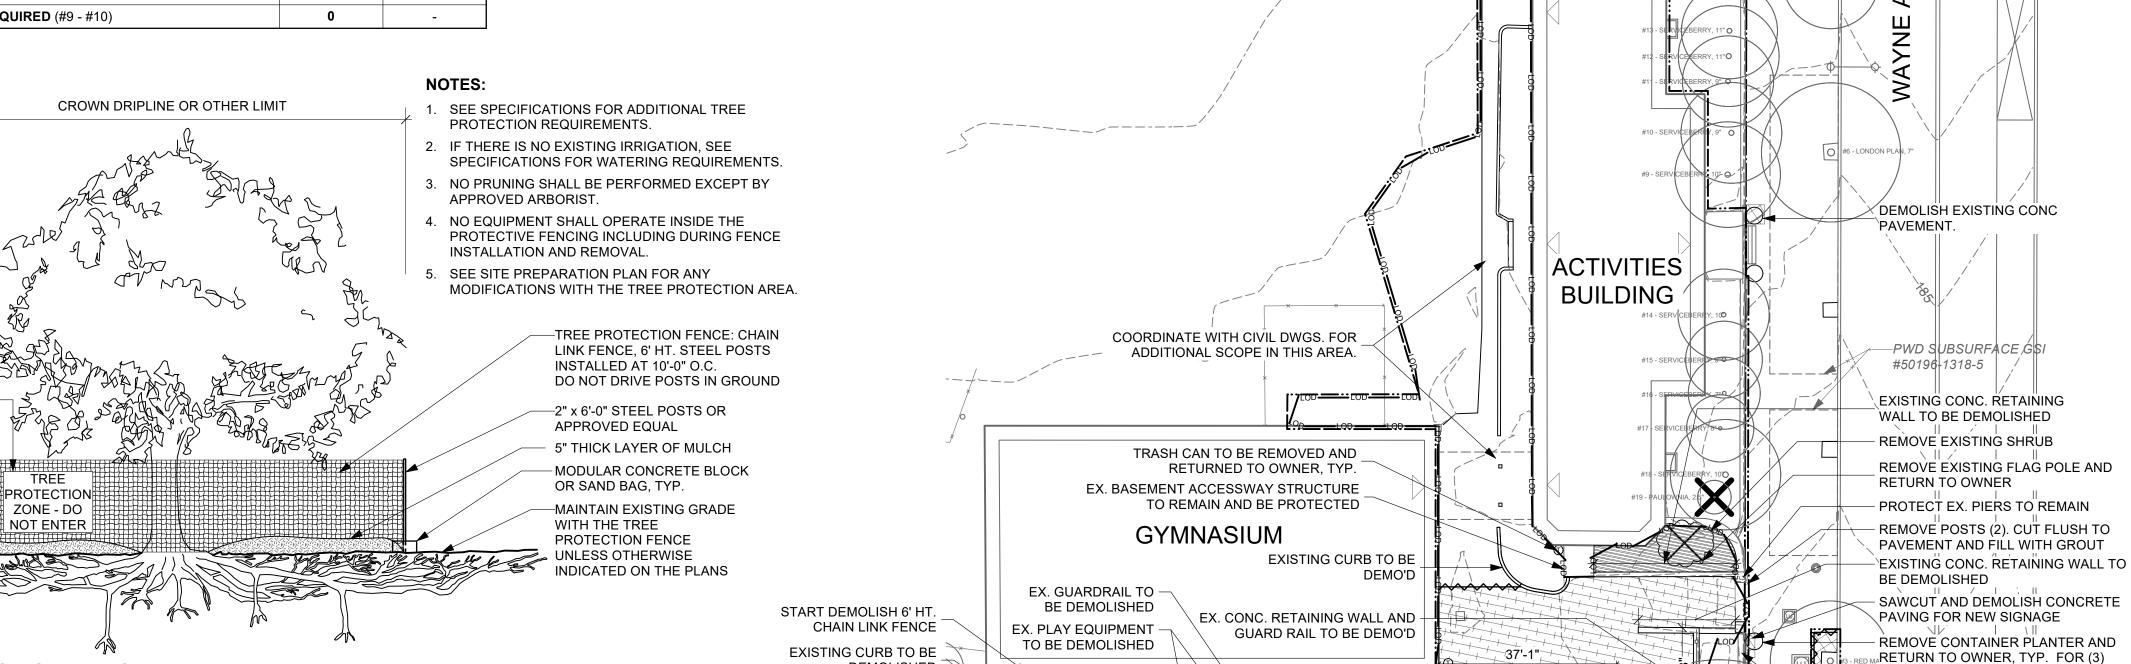

EX. BENCH TO **CUT AND TREAT** BE DEMO'D **VEGETATION** CLEAR AND GRUB ~ **VEGETATION** PROTECT EX. BRICK DRIVEWAY TO REMAIN END DEMOLISH 6' HT. CHAIN LINK FENCE. END POST TO REMAIN FREESTANDING POST TO BE DEMOLISHED PROTECT EX. LIGHT TO REMAIN PRUNE TREE BRANCHES AWAY EX. CURB AND GUARDRAIL FROM EXISTING LIGHT FIXTURE TO BE DEMOLISHED EXISTING CURB TO BE DEMOLISHED EXISTING PLAY EQUIPMENT

TO BE DEMOLISHED

CHAINLINK FENCE

PRESERVE AND PROTECT

EXISTING CURB

SAW CUT AND END DEMOLISH

CONCRETE CURB

STÄRT DEMOLISH 6' HT.

DEMOLITION LEGEND

----- PROPERTY LINE ----- PROJECT LIMIT LINE —LOD —LOD —LOD LIMIT OF DISTURBANCE TREE PROTECTION FENCE, REFER TO 4/L6.5

CONCRETE PAVEMENT TO BE REMOVED

SAFETY SURFACE TO BE REMOVED ASPHALT PAVING TO BE REMOVED

CLEAR AND GRUB VEGETATION

SAWCUT EXISTING PAVEMENT

MILL ASPHALT PAVING

CUT AND TREAT VEGETATON

TREE TO BE REMOVED

TREE PROTECTION NOTES

- 1. CONTRACTOR SHALL DOCUMENT EXISTING CONDITIONS OF EXISTING TREES AND PLANTINGS INDICATED TO REMAIN WITH DIGITAL PHOTOS AND/OR VIDEO. WHICH ESTABLISHES PRECONSTRUCTION CONDITIONS THAT MIGHT BE MISCONTRUED AS DAMAGE CAUSED BY CONSTRUCTION ACTIVITY. INCLUDE PLANS AND NOTATIONS TO INDICATE SPECIFIC WOUNDS AND DAMAGE CONDITIONS OF EACH TREE OR OTHER PLANTS DESIGNATED TO
- 2. LOCATE AND CLEARLY IDENTIFY TREES, SHRUBS AND OTHER VEGETATION TO REMAIN. FLAG EACH TREE TO REMAIN AT A HEIGHT OF 6-FEET +/- WITH DISTINCTIVE, HIGHLY VISIBLE COLOR FLAGGING TAPE. SUPERVISING CONTRACTOR AND/OR SITE FOREMAN IS RESPONSIBLE TO INSTRUCT AND MONITOR ALL LABORERS AND WORKERS ABOUT THE TREE PROTECTION REQUIREMENTS.
- DEPARTMENT OF PARKS & RECREATION ARBORIST SHALL BE CONSULTED PRIOR TO THE START OF ANY CONSTRUCTION ACTIVITY. CONTRACTORS MUST COORDINATE ALL CONSTRUCTION ACTIVITY AFFECTING EXISTING TREES AND PLANTINGS INDICATED TO REMAIN WITH THE ARBORIST. ALL CONTRACTORS SHALL COMPLY WITH THE PROTECTION REQUIREMENTS SET FORTH BY THE CERTIFIED ARBORIST.
- . BRING ANY UNFORESEEN SITE CONDITIONS, SUCH AS STRUCTURAL ROOTS, THAT WILL IMPACT NEW CONSTRUCTION TO THE ATTENTION OF THE OWNER'S REPRESENTATIVE. DO NOT PROCEED WITH WORK WITHOUT WRITTEN AUTHORIZATION.
- 5. PROTECTION FENCING MUST BE APPROVED BY OWNER'S REPRESENTATIVE PRIOR TO COMMENCING WITH ANY DEMOLITION OR CONSTRUCTION WORK.
- 6. WORK WITHIN PROTECTION FENCING, UNLESS NOTED HEREIN, MUST BE APPROVED BY AND SUPERVISED BY OWNER'S REPRESENTATIVE.
- 7. WHEN WORKING WITHIN TREE PROTECTION ZONES, USE CARE TO AVOID DAMAGE TO TREE TRUNKS AND ROOTS SUCH AS, BUT NOT LIMITED TO, IMPACT WOUNDS CAUSED BY EQUIPMENT. CONSULT A CERTIFIED ARBORIST IF DAMAGE TO A PROTECTED TREE OCCURS.
- 8. LIMIT EXTENT OF EXCAVATION WITHIN PROTECTION ZONES TO THE GREATEST EXTENT FEASIBLE. 9. WHERE EXCAVATION IS REQUIRED IN PROTECTION ZONES TO INSTALL UTILITIES, HAND EXCAVATE AND/OR AIR-SPADE AROUND
- TREE ROOTS OR TUNNEL UNDER ROOTS BY DRILLING, AUGER BORING, OR PIPE JACKING. DO NOT CUT MAIN LATERIAL TREE ROOTS OR TAPROOTS. CUTTING OF SMALLER ROOTS BY A CERTIFIED ARBORIST THAT INTERFERE WITH INSTALLATION OF UTILITIES IS PERMITTED. 10. TRENCHING OR EXCAVATION WITHIN THE DRIPLINE OF EXISTING TREES SHALL BE COMPLETED WITH EXTREME CARE AND UNDER THE SUPERVISION OF A CERTIFIED ARBORIST. USE HAND TOOLS
- ONLY. ARBORIST SHALL BE PRESENT DURING ALL WORK DONE WITHIN DRIPLINE OF EXISTING TREES. NOTIFY OWNER PRIOR TO COMMENCEMENT OF WORK WITHIN DRIPLINE OF TREES. 11. WHERE EXSITING ROOTS OF TREES TO REMAIN ARE ENCOUNTERED WITHIN EXCAVATION AREAS, DO NOT ALLOW EXPOSED ROOTS TO
- DRY OUT PRIOR TO PLACING PERMANENT BACKFILL. 12. EXERCISE EXTREME CAUTION IN REMOVING PAVEMENT WITHIN
- DRIPLINE OF EXISTING TREES TO REMAIN. MAINTAIN EXISTING GRADES WITHIN THE PROTECTION ZONE TO THE GREATEST EXTENT FEASIBLE. DO NOT LOWER OR RAISE GRADES MORE THAN 2-INCHES WITHIN PROTECTION ZONE. HAND-GRADE TO REQUIRED FINISHED ELEVATIONS WITH PROTECTION ZONES.
- 14. WHEN DIRECTED BY CERTIFIED ARBORIST, AERATE SURFACE SOIL COMPACTED DURING CONSTRUCTION. AERATE TO EXTENT AS DIRECTED BY ARBORIST AND NO CLOSER THAN 36-INCHES TO TREE TRUNK. DRILL 2-INCH DIAMETER HOLES A MINIMUM OF 12-INCHES DEEP AT 24-INCHES ON CENTER. BACKFILL HOLES WITH APPROVED COMPOST.

- REMOVE FENCE MOUNTED SIGNS

REMOVE GUARDRAIL. CUT POSTS

FLUSH AND FILL WITH NON-SHRINK

ALTERNATE NO. 1 - DEMOLISH EXISTING

TO NEAREST EXISTING JOINT UNLESS

- PROTECT EX. WALL TO REMAIN

MAFPROTECT EXISTING STREET TREES

TO REMAIN. PAVEMENT WITHIN 10'

OF TREE SHALL BE DEMOLISHED

SPECIAL CARE MUST BE TAKEN WHEN

TREE PROTECTION FENCE TO PREVENT

AND RETURN TO OWNER.

DAMAGE TO TREE ROOTS.

- SAWCUT EXISTING WALL

OTHERWISE NOTED

BY HAND ONLY, TYP.

PRESERVE AND PROTECT 4'

- HT. CHAINLINK FENCE

- START DEMOLISH CONC. CURB

END DEMOLISH 6' HT

- CHAINLINK FENCE

- 15. REPLACE TREES, SHRUBS AND OTHER VEGETATION INDICATED TO REMAIN THAT ARE DAMAGED BY CONSTRUCTION OPERATIONS, IN A MANNER APPROVED BY THE OWNER'S REPRESENTATIVE WHEN DEMOLISHING THE EXISTING WALL WITHIN THE GREATER THAN OR EQUAL TO 25% OF THE PLANT IS DEAD OR IN AN UNHEALTHY CONDITION AND OWNER'S REPRESENTATIVE DETERMINES ARE INCAPABLE OF RESTORING TO NORMAL GROWTH. PROVIDE NEW TREES OF THE SAME SIZE AND APPROVED SPECIES FOR EACH TREE THAT MEASURES 6-INCHES IN CALIPER SIZE OR SMALLER. WHERE THE TREE TO BE REPLACED EXCEEDS 6-INCHES IN CALIPER, PROVIDE TWO (2) 8-INCH CALIPER TREES OF AN APPROVED SPECIES AT A LOCATION DIRECTED BY THE OWNER OR OWNER'S REPRESENTATIVE.
 - 16. PROTECT ROOT SYSTEMS FROM PONDING, ERODING, OR EXCESSIVE WETTING CAUSED BY DEWATERING OPERATIONS. 17. DO NOT PARK VEHICLES OR EQUIPMENT WITH PROTECTION ZONES
- 18. CERTIFIED ARBORIST MAY REQUIRE CROWN PRUNING TO CONCRETE PAVING. DEMOLISH CONCRETE COMPENSATE FOR ROOT LOSS CAUSED BY DAMAGING OR CUTTING OF THE ROOT SYSTEM. PROVIDE SUBSEQUENT MAINTENANCE DURING CONTRACT PERIOD AS RECOMMENDED BY ARBORIST. 19. OWNER'S REPRESENTATIVE MAY REQUIRE ADDITIONAL
 - 20. AVOID DAMAGING EXISTING TREES. DAMAGE INCLUDES BUT IS NOT LIMITED TO: CUTTING, BREAKING, SKINNING OR COMPACTING OF ROOTS, SKINNING AND BRUISING OF BARK AND BREAKING OF

PROTECTION FENCING OR RELOCATION OF FENCING AS WORK

- BRANCHES AND LIMBS. 21. DO NOT ATTACH SIGNS TO OR AROUND TREES OR PLANTS TO REMAIN UNLESS OTHERWISE INDICATED
- 22. DO NOT ALLOW ROOTS TO DRY OUT BEFORE PLACING PERMANENT BACKFILL. PROVIDE TEMPORARY EARTH COVER AND/OR WRAP WITH MOIST BURLAP. WATER AND MAINTAIN IN MOIST CONDITION. TEMPORARILY SUPPORT AND PROTECT ROOTS FROM DAMAGE UNTIL THEY ARE PERMANENTLY RELOCATED AND/OR COVERED
- 23. PROTECTION-ZONE SIGNAGE: "TREE PROTECTION AREA DO NOT ENTER" 3-INCH HIGH MINIMUM LETTER SIZE, RED CHARACTERS ON WHITE BACKGROUND. INSTALL ALONG TOP OF PROTECTION FENCING SPACED EVERY 50-FEET AND/OR EACH SIDE OF PROTECTION ZONE.

ISSUE

REVISIONS



CONSTRUCTION DOCUMENTS

LEEANN SUEN

PROJECT COORDINATOR



1600 Walnut Street, 2nd Floor Philadelphia, Pennsylvania 19103 215 985 4410

<u> ANDSCAPE ARCHITECT:</u> **GROUND RECONSIDERED** www.groundreconsidered.com 215 790 0727

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CITY OF PHILADELPHIA DEPARTMENT OF PARKS & RECREATION

1515 ARCH STREET 11TH FLOOR, ONE PARKWAY BUILDING

PHILADELPHIA

RENOVATIONS TO THE HAPPY HOLLOW RECREATION CENTER

DRAWING TITLE

DEMOLITION AND PROTECTION PLAN


DRAWING NO 16315E-03-02 05/13/2025 AS NOTED XD/TM CHECKED BY

DEMOLITION AND PROTECTION PLAN

WITH SOIL.

CONTACTOR AT THE SITE BEFORE PROCEEDING WITH THE WORK

ALL DIMENSIONS AND CONDITIONS SHALL BE VERIFIED BY THE

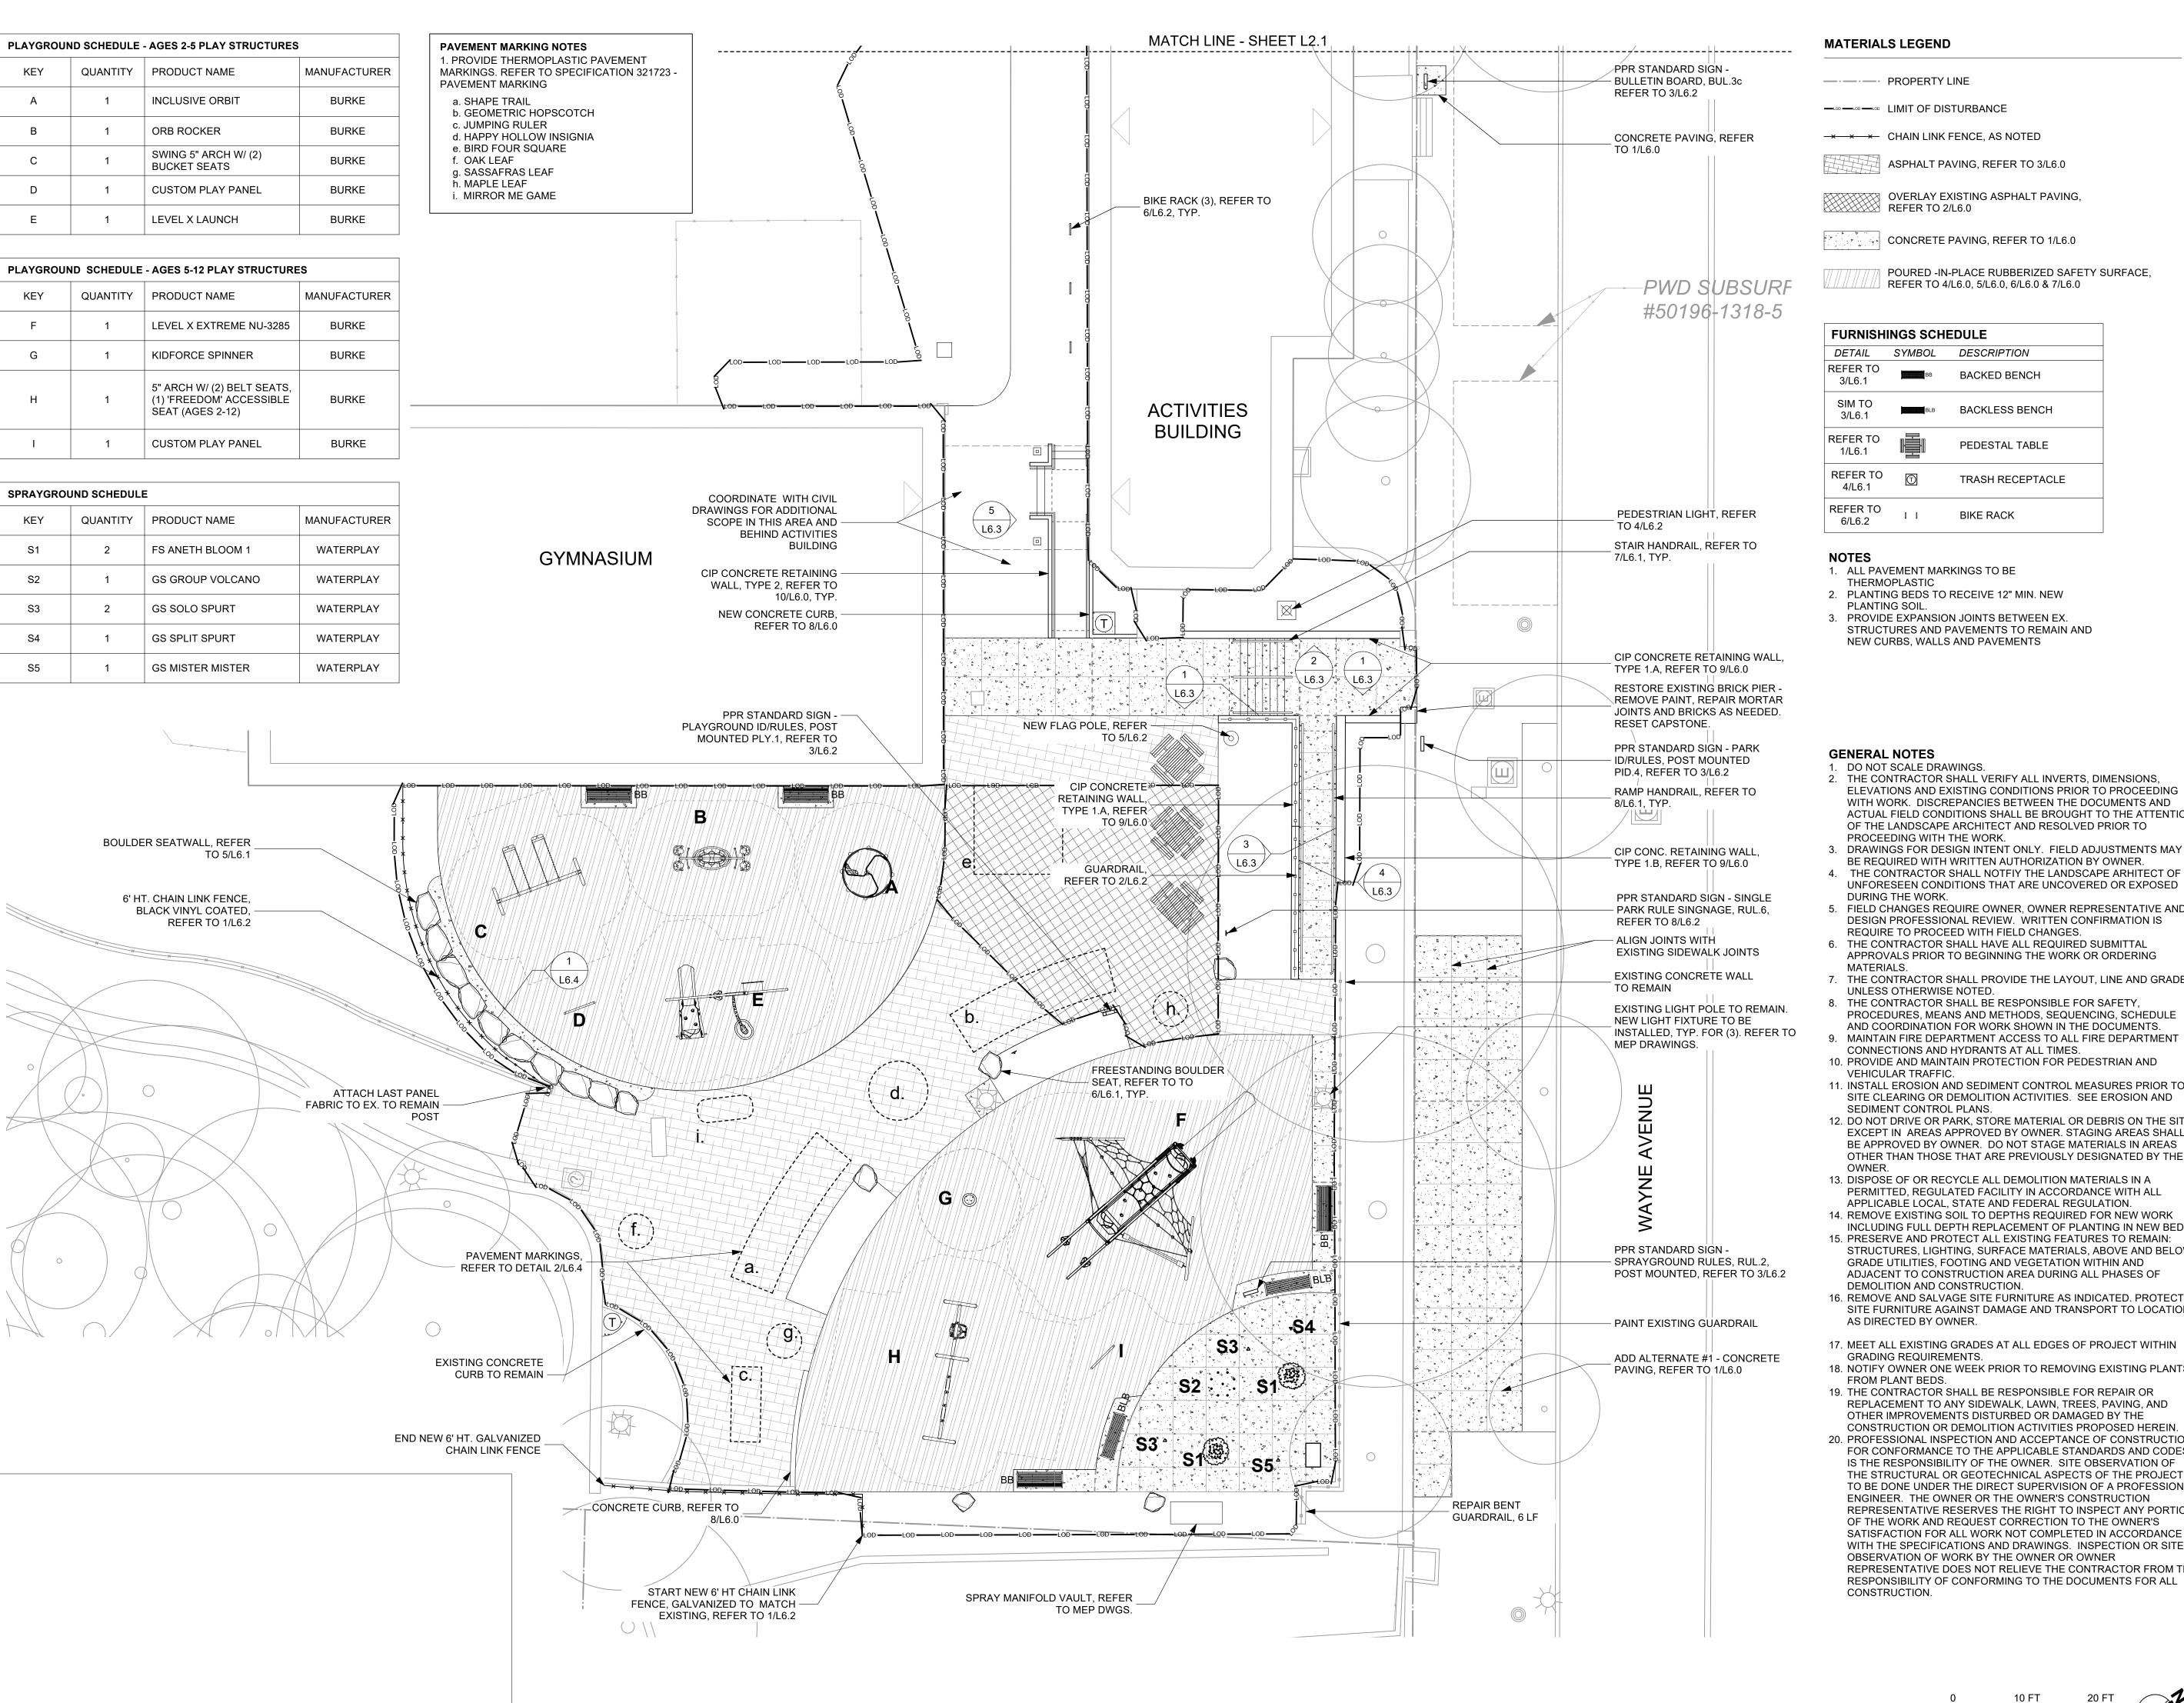



----- PROPERTY LINE

—LOD —LOD —LOD LIMIT OF DISTURBANCE

-× × × CHAIN LINK FENCE, AS NOTED

ASPHALT PAVING, REFER TO 3/L6.0

OVERLAY EXISTING ASPHALT PAVING, REFER TO 2/L6.0

CONCRETE PAVING, REFER TO 1/L6.0

POURED -IN-PLACE RUBBERIZED SAFETY SURFACE,

REFER TO 4/L6.0, 5/L6.0, 6/L6.0 & 7/L6.0

FURNISHINGS SCHEDULE						
DETAIL	SYMBOL	DESCRIPTION				
REFER TO 3/L6.1	ВВ	BACKED BENCH				
SIM TO 3/L6.1	BLB	BACKLESS BENCH				
REFER TO 1/L6.1		PEDESTAL TABLE				
REFER TO 4/L6.1	Ō	TRASH RECEPTACLE				
REFER TO 6/L6.2	1 1	BIKE RACK				


1. ALL PAVEMENT MARKINGS TO BE

- THERMOPLASTIC
- 2. PLANTING BEDS TO RECEIVE 12" MIN. NEW
- 3. PROVIDE EXPANSION JOINTS BETWEEN EX. STRUCTURES AND PAVEMENTS TO REMAIN AND NEW CURBS, WALLS AND PAVEMENTS

GENERAL NOTES

DO NOT SCALE DRAWINGS.

- THE CONTRACTOR SHALL VERIFY ALL INVERTS, DIMENSIONS, ELEVATIONS AND EXISTING CONDITIONS PRIOR TO PROCEEDING WITH WORK. DISCREPANCIES BETWEEN THE DOCUMENTS AND ACTUAL FIELD CONDITIONS SHALL BE BROUGHT TO THE ATTENTION OF THE LANDSCAPE ARCHITECT AND RESOLVED PRIOR TO PROCEEDING WITH THE WORK.
- 3. DRAWINGS FOR DESIGN INTENT ONLY. FIELD ADJUSTMENTS MAY BE REQUIRED WITH WRITTEN AUTHORIZATION BY OWNER.
- THE CONTRACTOR SHALL NOTFIY THE LANDSCAPE ARHITECT OF UNFORESEEN CONDITIONS THAT ARE UNCOVERED OR EXPOSED DURING THE WORK.
- 5. FIELD CHANGES REQUIRE OWNER, OWNER REPRESENTATIVE AND DESIGN PROFESSIONAL REVIEW. WRITTEN CONFIRMATION IS REQUIRE TO PROCEED WITH FIELD CHANGES.
- 6. THE CONTRACTOR SHALL HAVE ALL REQUIRED SUBMITTAL APPROVALS PRIOR TO BEGINNING THE WORK OR ORDERING MATERIALS. 7. THE CONTRACTOR SHALL PROVIDE THE LAYOUT, LINE AND GRADE
- UNLESS OTHERWISE NOTED. 8. THE CONTRACTOR SHALL BE RESPONSIBLE FOR SAFETY,
- PROCEDURES, MEANS AND METHODS, SEQUENCING, SCHEDULE AND COORDINATION FOR WORK SHOWN IN THE DOCUMENTS.
- 9. MAINTAIN FIRE DEPARTMENT ACCESS TO ALL FIRE DEPARTMENT CONNECTIONS AND HYDRANTS AT ALL TIMES.
- 10. PROVIDE AND MAINTAIN PROTECTION FOR PEDESTRIAN AND
- VEHICULAR TRAFFIC. 11. INSTALL EROSION AND SEDIMENT CONTROL MEASURES PRIOR TO
- SITE CLEARING OR DEMOLITION ACTIVITIES. SEE EROSION AND SEDIMENT CONTROL PLANS. 12. DO NOT DRIVE OR PARK, STORE MATERIAL OR DEBRIS ON THE SITE EXCEPT IN AREAS APPROVED BY OWNER. STAGING AREAS SHALL
- OTHER THAN THOSE THAT ARE PREVIOUSLY DESIGNATED BY THE 13. DISPOSE OF OR RECYCLE ALL DEMOLITION MATERIALS IN A PERMITTED, REGULATED FACILITY IN ACCORDANCE WITH ALL
- APPLICABLE LOCAL, STATE AND FEDERAL REGULATION. 14. REMOVE EXISTING SOIL TO DEPTHS REQUIRED FOR NEW WORK INCLUDING FULL DEPTH REPLACEMENT OF PLANTING IN NEW BEDS.
- 15. PRESERVE AND PROTECT ALL EXISTING FEATURES TO REMAIN: STRUCTURES, LIGHTING, SURFACE MATERIALS, ABOVE AND BELOW GRADE UTILITIES, FOOTING AND VEGETATION WITHIN AND ADJACENT TO CONSTRUCTION AREA DURING ALL PHASES OF
- DEMOLITION AND CONSTRUCTION. 16. REMOVE AND SALVAGE SITE FURNITURE AS INDICATED. PROTECT SITE FURNITURE AGAINST DAMAGE AND TRANSPORT TO LOCATION AS DIRECTED BY OWNER.
- 17. MEET ALL EXISTING GRADES AT ALL EDGES OF PROJECT WITHIN
- GRADING REQUIREMENTS. 18. NOTIFY OWNER ONE WEEK PRIOR TO REMOVING EXISTING PLANTS FROM PLANT BEDS.
- 19. THE CONTRACTOR SHALL BE RESPONSIBLE FOR REPAIR OR
- REPLACEMENT TO ANY SIDEWALK, LAWN, TREES, PAVING, AND OTHER IMPROVEMENTS DISTURBED OR DAMAGED BY THE CONSTRUCTION OR DEMOLITION ACTIVITIES PROPOSED HEREIN.
- 20. PROFESSIONAL INSPECTION AND ACCEPTANCE OF CONSTRUCTION FOR CONFORMANCE TO THE APPLICABLE STANDARDS AND CODES IS THE RESPONSIBILITY OF THE OWNER. SITE OBSERVATION OF THE STRUCTURAL OR GEOTECHNICAL ASPECTS OF THE PROJECT IS TO BE DONE UNDER THE DIRECT SUPERVISION OF A PROFESSIONAL ENGINEER. THE OWNER OR THE OWNER'S CONSTRUCTION REPRESENTATIVE RESERVES THE RIGHT TO INSPECT ANY PORTION OF THE WORK AND REQUEST CORRECTION TO THE OWNER'S SATISFACTION FOR ALL WORK NOT COMPLETED IN ACCORDANCE WITH THE SPECIFICATIONS AND DRAWINGS. INSPECTION OR SITE OBSERVATION OF WORK BY THE OWNER OR OWNER REPRESENTATIVE DOES NOT RELIEVE THE CONTRACTOR FROM THE RESPONSIBILITY OF CONFORMING TO THE DOCUMENTS FOR ALL CONSTRUCTION.

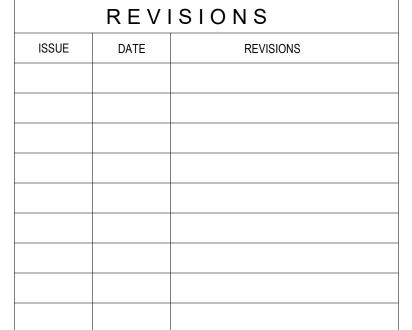



CONSTRUCTION DOCUMENTS

PROJECT COORDINATOR

LEEANN SUEN



1600 Walnut Street, 2nd Floor Philadelphia, Pennsylvania 19103 215 985 4410

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CIVIL ENGINEER: KS ENGINEERS www.kseng.com

215 790 0727

215 925 0425

PHILADELPHIA

DRAWING TITLE

PROJECT NO.

STRUCTURAL ENGINEER: ANN ROTHMANN STRUCTURAL ENGINEERING arstructural.com 610 688 2566

MEP ENGINEER: ARORA ENGINEERS www.aroraengineers.com 610 459 7900

ROOFING CONSULTANT: STEPHEN McLAUGHLIN ROOFING CONSULTANT stevemclaughlin.biz 856 287 2424

CITY OF PHILADELPHIA **DEPARTMENT OF PARKS & RECREATION**

PENNSYLVANIA

1515 ARCH STREET


11TH FLOOR, ONE PARKWAY BUILDING

PROJECT TITLE RENOVATIONS TO THE HAPPY

HOLLOW RECREATION CENTER

MATERIALS PLAN DRAWING NO.

16315E-03-02 05/13/2025 AS NOTED XD/TM CHECKED BY

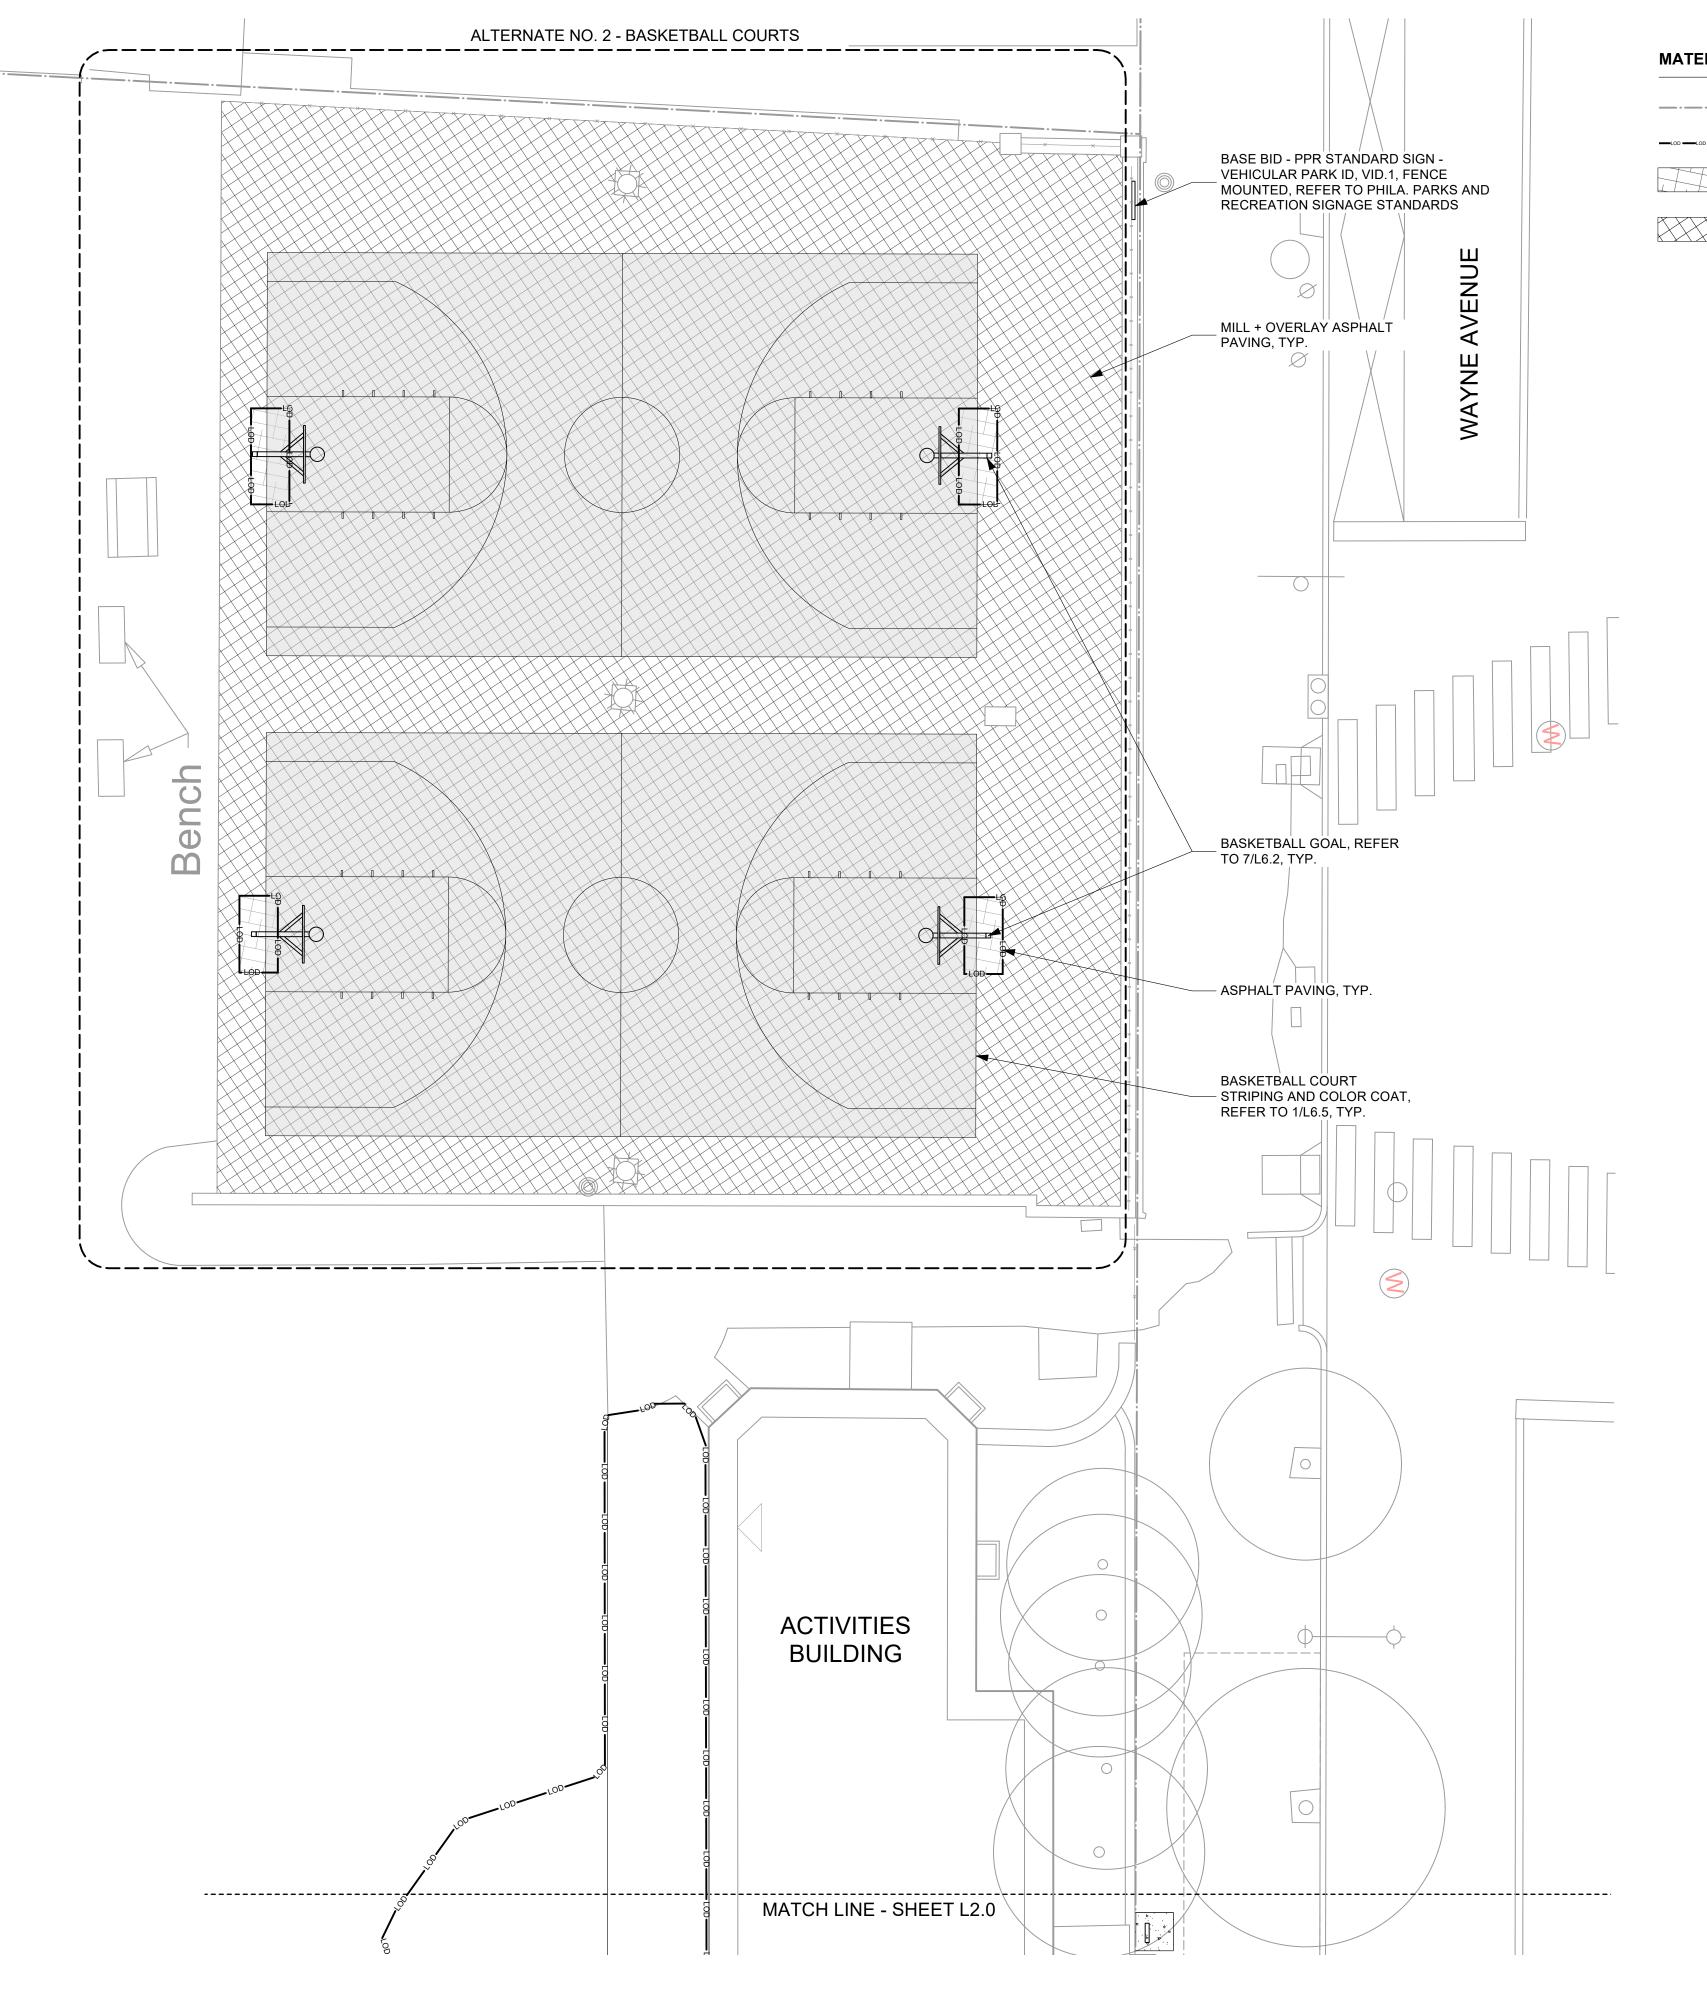


MATERIALS LEGEND


—·—· PROPERTY LINE

-LOD -LOD -LOD LIMIT OF DISTURBANCE

ASPHALT PAVING, REFER TO 3/L6.0

OVERLAY MILLED ASPHALT PAVING, REFER TO 2/L6.0

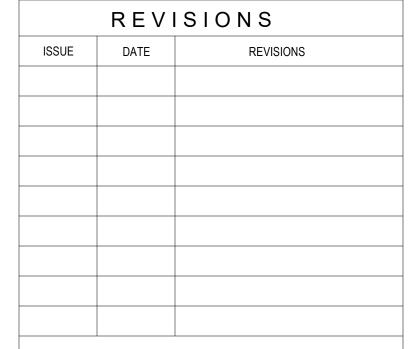

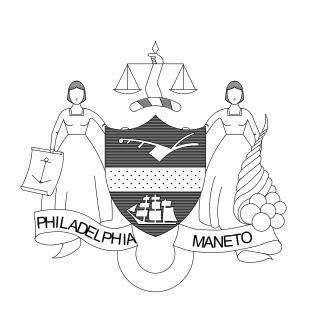

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CITY OF PHILADELPHIA DEPARTMENT OF PARKS & RECREATION

1515 ARCH STREET 11TH FLOOR, ONE PARKWAY BUILDING

PENNSYLVANIA PHILADELPHIA

RENOVATIONS TO THE HAPPY HOLLOW RECREATION CENTER


DRAWING TITLE

MATERIALS PLAN

16315E-03-02

05/13/2025 AS NOTED XD/TM

CHECKED BY

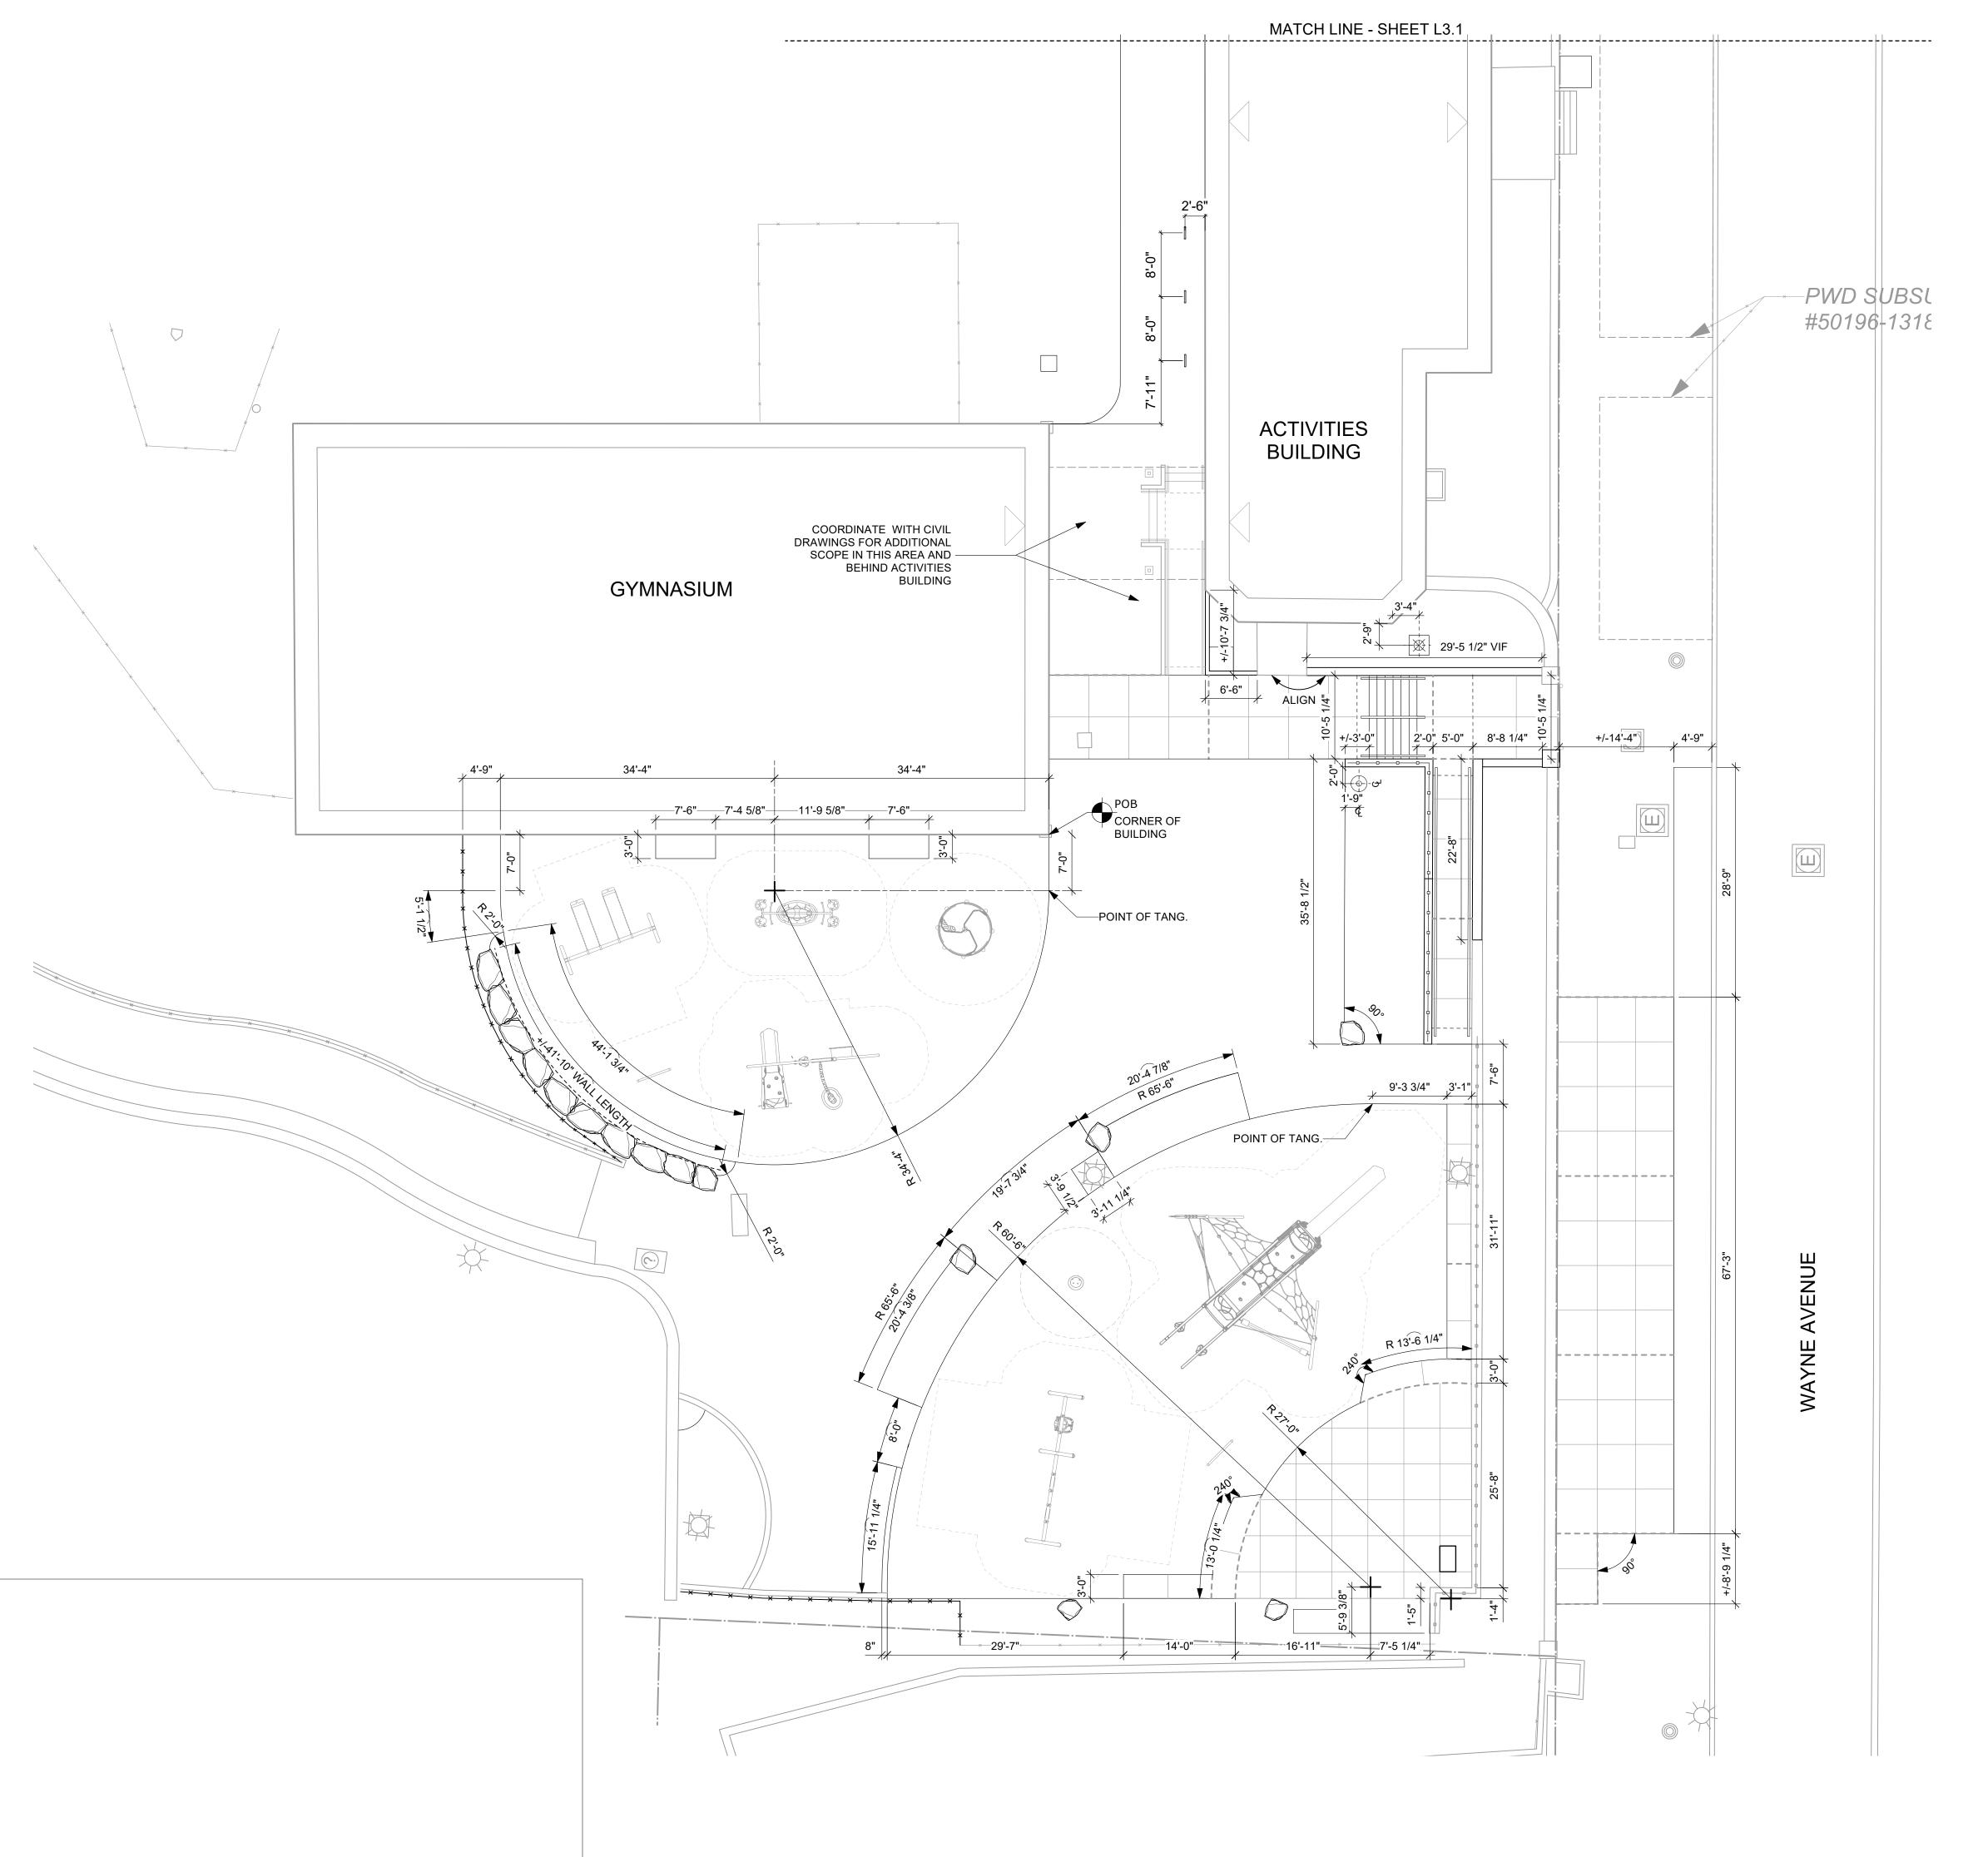

LAYOUT LEGEND


PROPERTY LINE

CENTER LINE

---- REFERENCE LINE

X°

ANGULAR DIMENSION

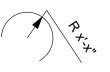

RADIAL DIMENSION



POINT OF BEGINNING

POINT OF CURVATURE



..........

LAYOUT NOTES

1. ALL LINES ARE PARALLEL OR PERPENDICULAR UNLESS OTHERWISE

- NOTED.
 2. ALL DIMENSIONS ARE SHOWN TO FACE OF MATERIALS, UNLESS
- . ALL DIMENSIONS ARE SHOWN TO FACE OF MATERIALS, UNLESS SHOWN OTHERWISE.
- V.I.F. = VERIFY IN FIELD: VERIFY ALL DIMENSIONS FROM FIELD MEASUREMENTS. VERIFY LAYOUT OF ALL PROPOSED WORK WITH EXISTING CONDITIONS. NOTIFY LANDSCAPE ARCHITECT OF ANY DISCREPANCIES BEFORE PROCEEDING WITH ANY WORK.
 PROVIDE STAKED LAYOUT FOR REVIEW AND APPROVAL BY
- LANDSCAPE ARCHITECT PRIOR TO COMMENCING WORK.
 5. DIMENSIONS ARE APPROXIMATE, MUST BE VERIFIED WITH FALL
- 6. ALL SPRAY EQUIPMENT DIMENSIONS ARE SHOWN TO THE CENTER OF SPRAY HEAD AND/OR POST, TYP.

REVISIONS

ISSUE DATE REVISIONS



CONSTRUCTION DOCUMENTS

PROJECT COORDINATOR

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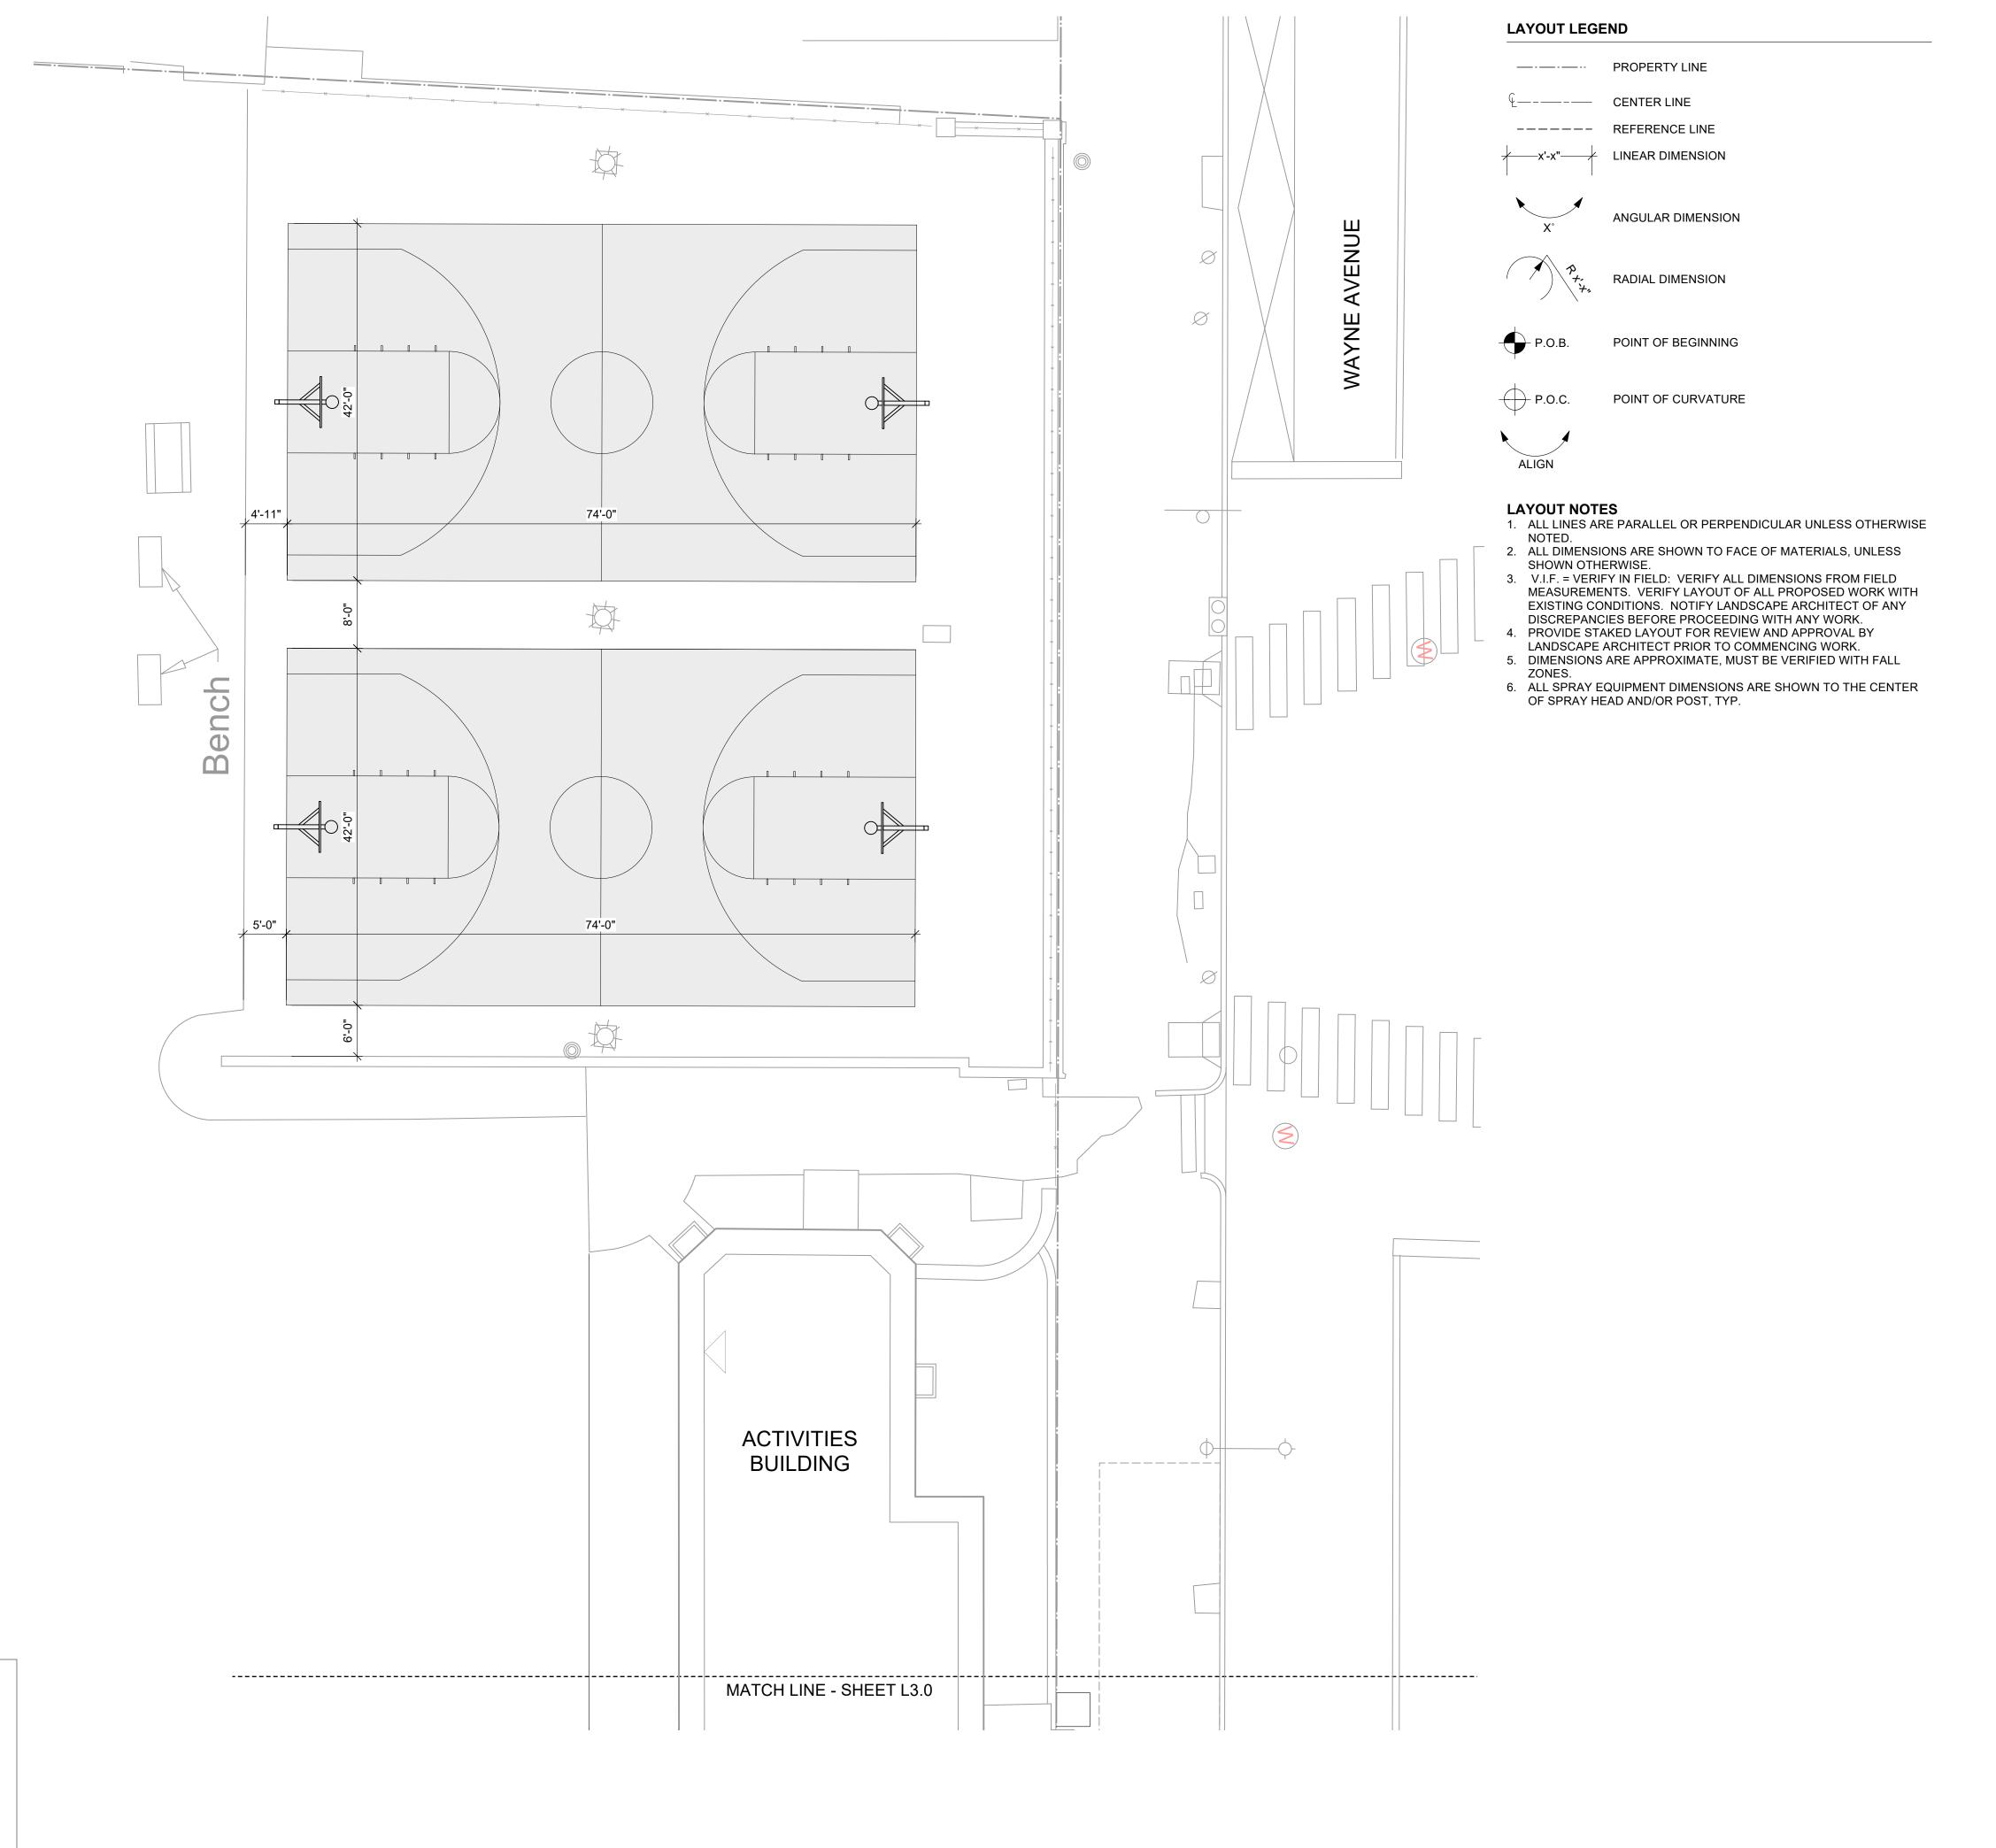
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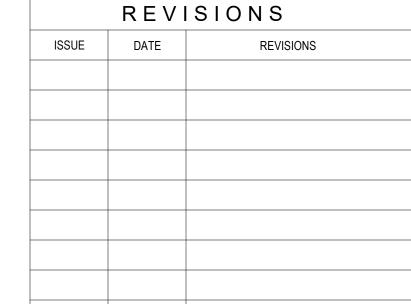
RENOVATIONS TO THE HAPPY HOLLOW RECREATION CENTER

DRAWING TITLE

LAYOUT PLAN

PROJECT NO.		DRAWING NO.
16	6315E-03-02	
DATE	05/13/2025	13()
SCALE	AS NOTED	
DRAWN BY	XD/TM	
CHECKED BY	IB	







CONSTRUCTION DOCUMENTS

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CITY OF PHILADELPHIA DEPARTMENT OF PARKS & RECREATION

1515 ARCH STREET 11TH FLOOR, ONE PARKWAY BUILDING

PHILADELPHIA

RENOVATIONS TO THE HAPPY HOLLOW RECREATION CENTER

DRAWING TITLE


LAYOUT PLAN

16315E-03-02

XD/TM

05/13/2025 AS NOTED

CHECKED BY

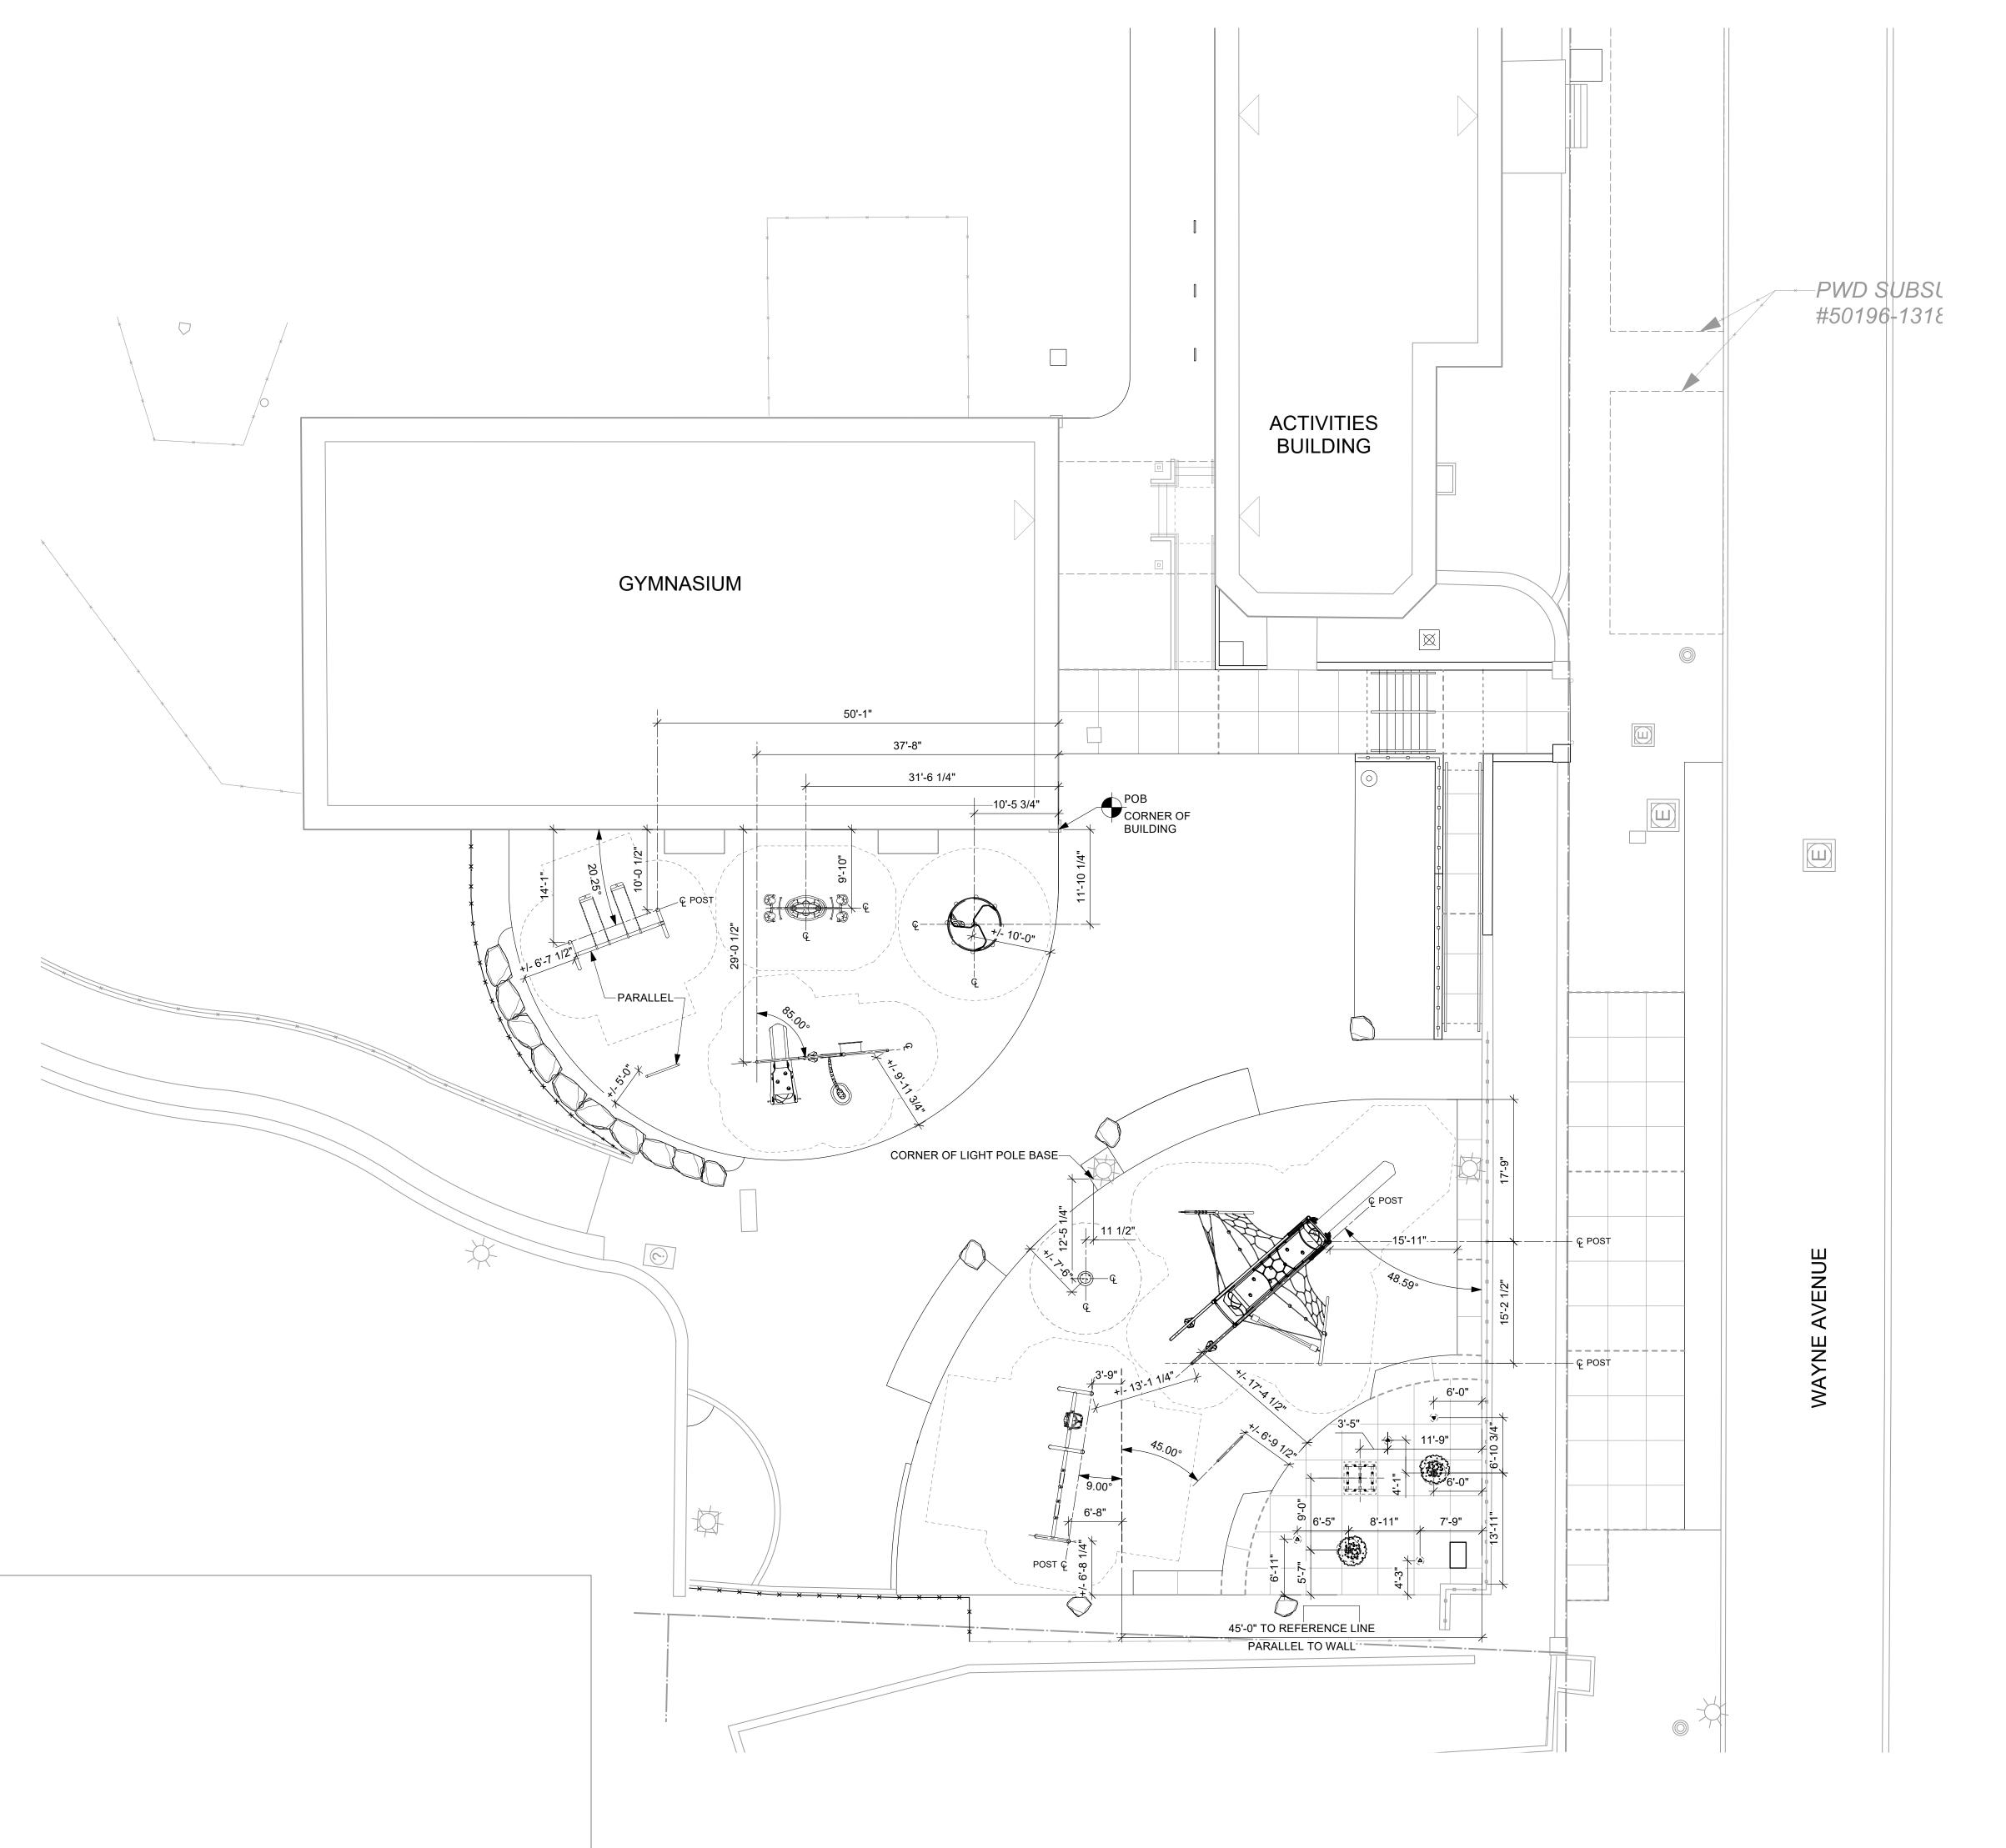

LAYOUT LEGEND

PROPERTY LINE


CENTER LINE

REFERENCE LINE

x'-x" LINEAR DIMENSION





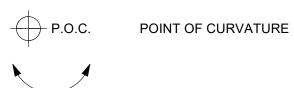

LAYOUT NOTES

- ALL LINES ARE PARALLEL OR PERPENDICULAR UNLESS OTHERWISE NOTED.
- 2. ALL DIMENSIONS ARE SHOWN TO FACE OF MATERIALS, UNLESS
- SHOWN OTHERWISE.

 3. V.I.F. = VERIFY IN FIELD: VERIFY ALL DIMENSIONS FROM FIELD MEASUREMENTS. VERIFY LAYOUT OF ALL PROPOSED WORK WITH EXISTING CONDITIONS. NOTIFY LANDSCAPE ARCHITECT OF ANY
- DISCREPANCIES BEFORE PROCEEDING WITH ANY WORK.

 4. PROVIDE STAKED LAYOUT FOR REVIEW AND APPROVAL BY LANDSCAPE ARCHITECT PRIOR TO COMMENCING WORK.

 5. DIMENSIONS ARE APPROXIMATE, MUST BE VERIFIED WITH FALL
- ZONES.

 3. ALL SPRAY EQUIPMENT DIMENSIONS ARE SHOWN TO THE CENTE
- 6. ALL SPRAY EQUIPMENT DIMENSIONS ARE SHOWN TO THE CENTER
 OF SPRAY HEAD AND/OR POST, TYP.

 CONSTRUCTION

PHILADELPHIA MANETO

REVISIONS

REVISIONS

ISSUE

CONSTRUCTION DOCUMENTS

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CITY OF PHILADELPHIA DEPARTMENT OF PARKS & RECREATION

1515 ARCH STREET 11TH FLOOR, ONE PARKWAY BUILDING

PHILADELPHIA

RENOVATIONS TO THE HAPPY HOLLOW RECREATION CENTER

DRAWING TITLE

XD/TM

LAYOUT PLAN PLAY & SPRAY EQUIPMENT

16315E-03-02


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GCALE AS NOTED

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NOTE: ALL DIMENSIONS AND CONDITIONS SHALL BE VERIFIED BY THE




SAFETY SURFACE: COLOR A

SAFETY SURFACE: COLOR B

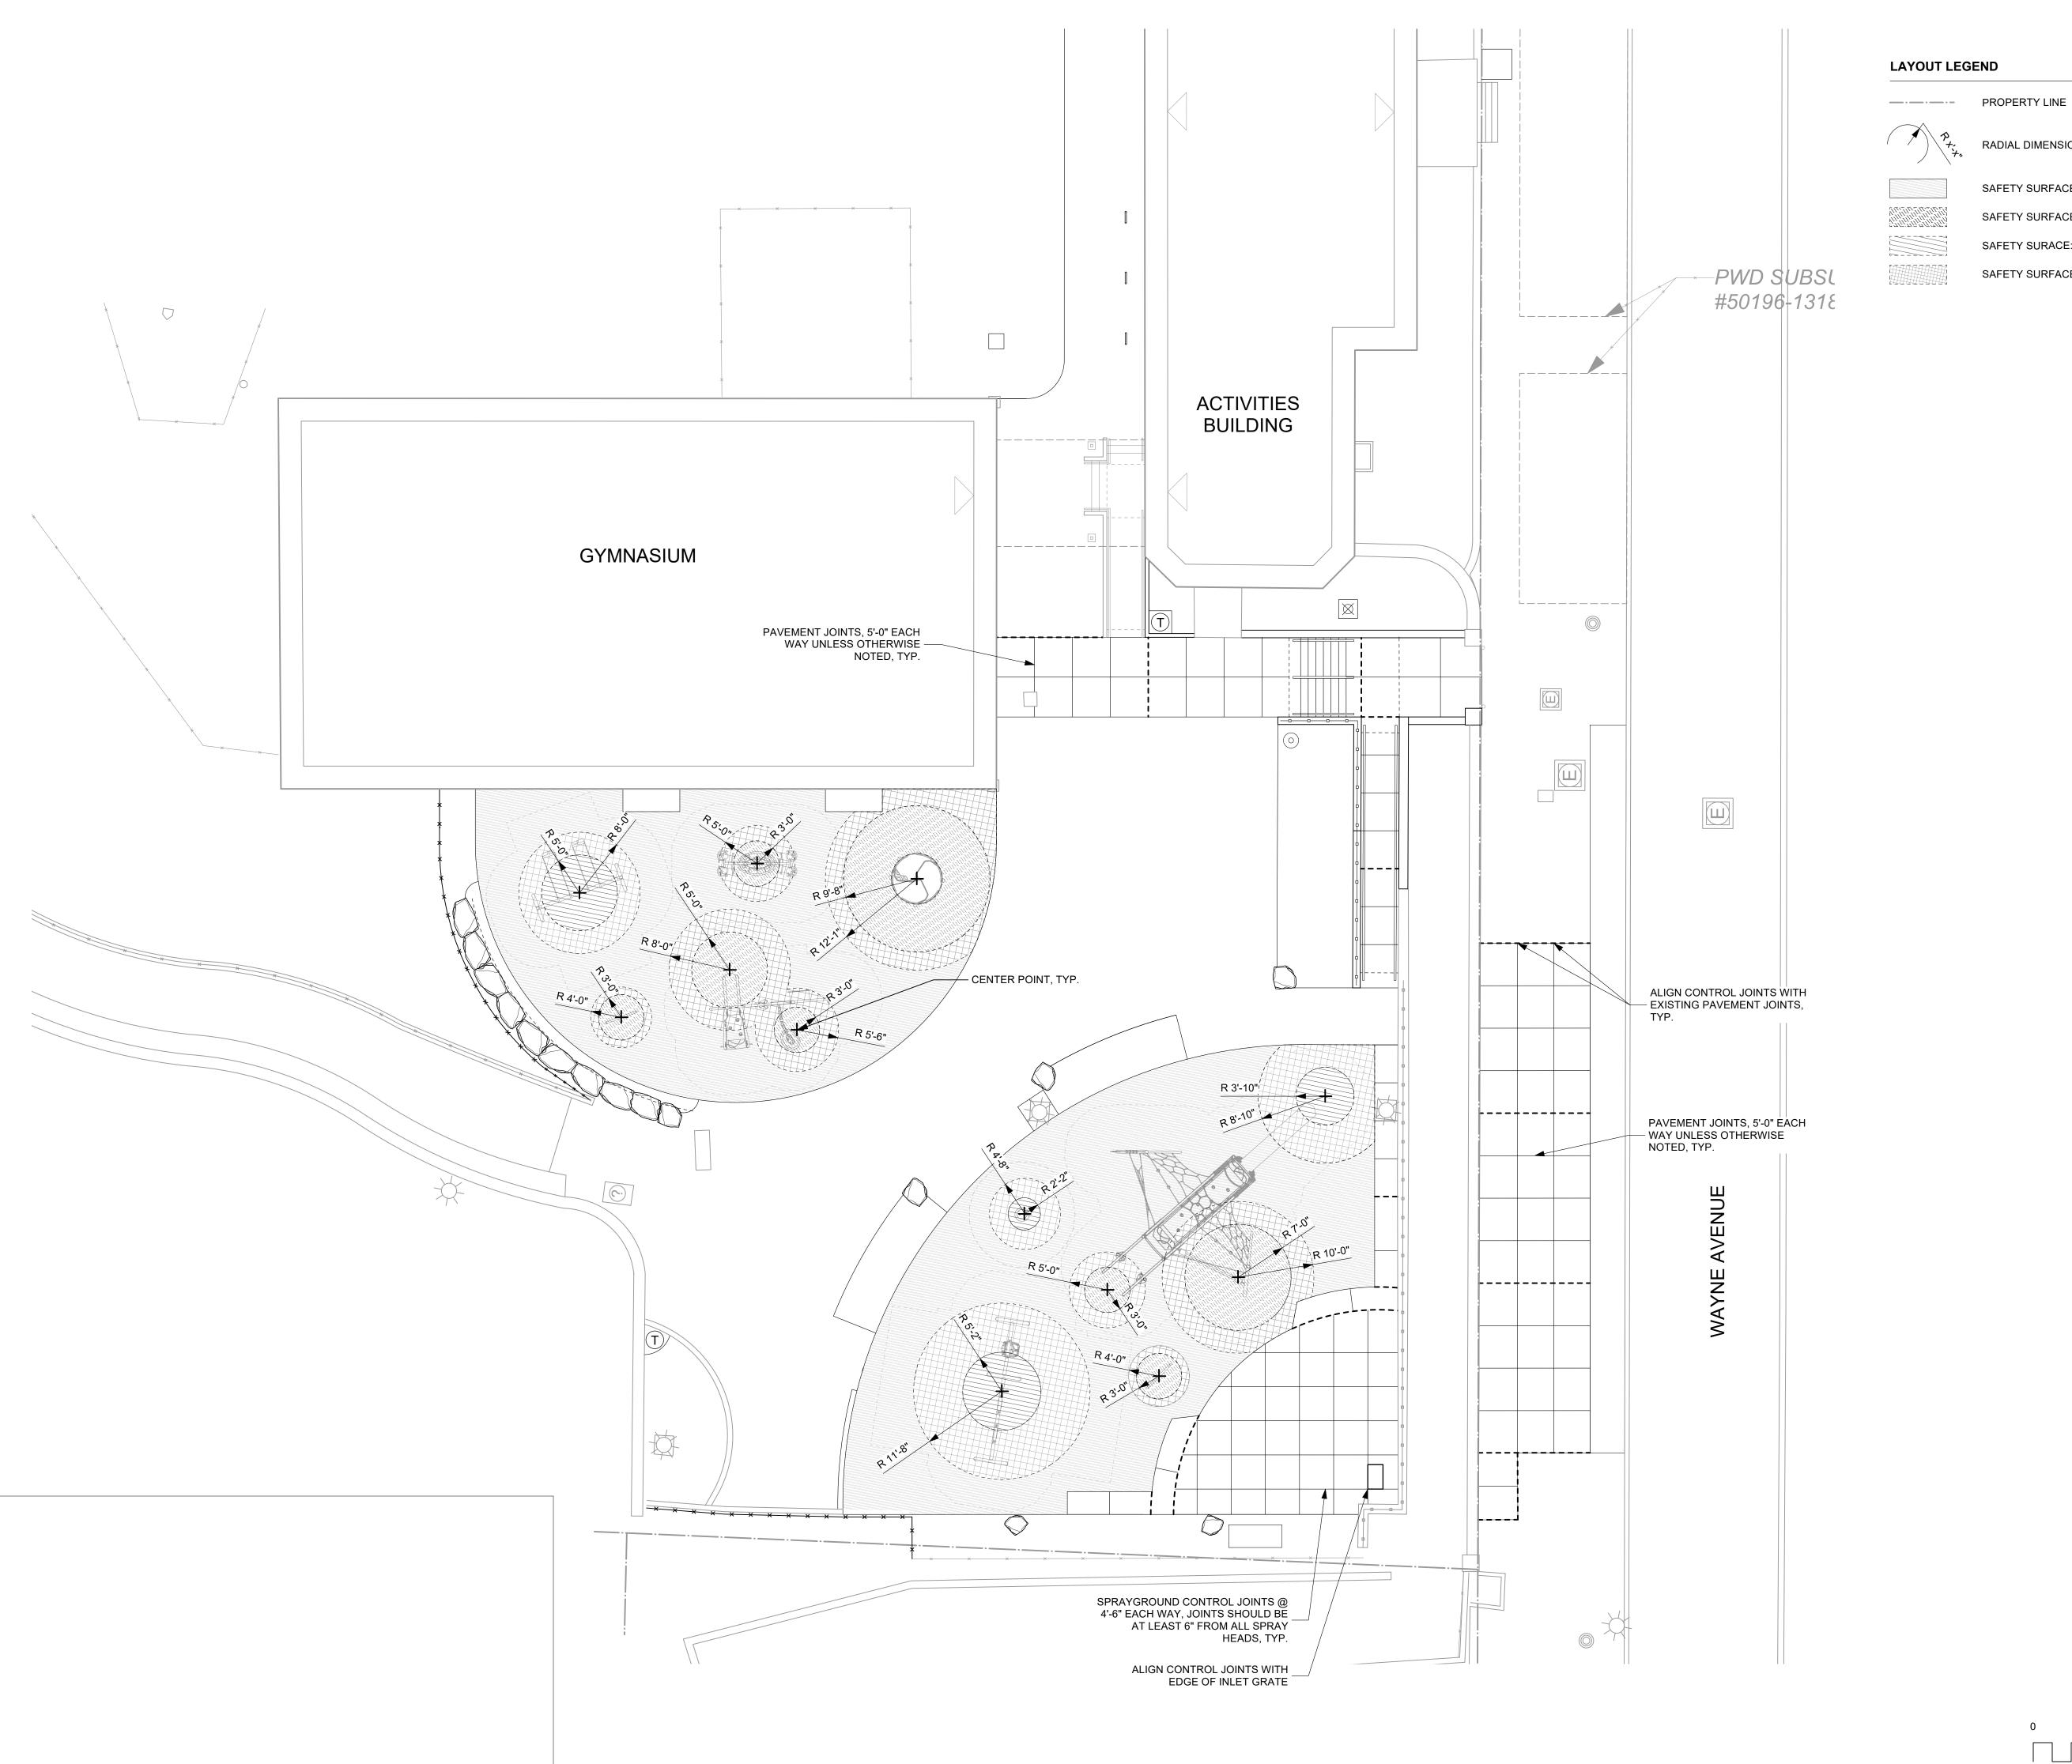SAFETY SURACE: COLOR C

SAFETY SURFACE TRANSITION ZONE

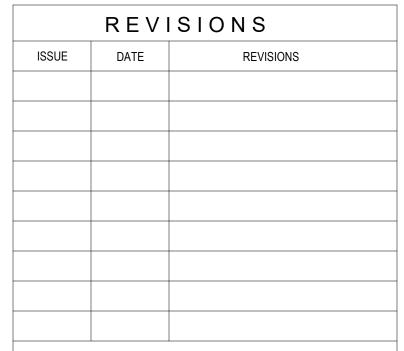



CONSTRUCTION DOCUMENTS

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CITY OF PHILADELPHIA DEPARTMENT OF PARKS & RECREATION

1515 ARCH STREET 11TH FLOOR, ONE PARKWAY BUILDING

PHILADELPHIA

PENNSYLVANIA RENOVATIONS TO THE HAPPY

HOLLOW RECREATION CENTER

DRAWING TITLE

LAYOUT PLAN - JOINTING & SAFETY SURFACE

16315E-03-02 05/13/2025 AS NOTED

XD/TM CHECKED BY



GRADING LEGEND

----- PROPERTY LINE

-LOD -LOD -LOD LIMIT OF DISTURBANCE

× 0.00 EXISTING SPOT ELEVATION

0.00 PROPOSED SPOT ELEVATION

EX0.00 EXISTING ELEVATION (INTERPOLATED)

+TW0.00 TOP OF WALL

W0.00 BOTTOM OF WALL

0.00 TOP OF STEP

BOTTOM OF STEP

P0.00 HIGH POINT

■0.0% PERCENT SLOPE

V.I.F. VERIFY IN FIELD

BY SPOT ELEVATIONS.

CONTOUR

GRADING NOTES


1. ANY DISCREPANCY BETWEEN FIELD CONDITIONS AND DOCUMENTED EXISTING OR PROPOSED CONDITIONS SHALL BE REPORTED TO OWNER IN WRITING.

- 2. ADJUST EXISTING AND PROPOSED UTILITIES TO MEET FINAL DESIGN CONDITIONS AS NECESSARY.
- 3. ADJUST TOPS OF ALL MANHOLE LIDS, EXISTING UTILITY STRUCTURES, ETC. TO MEET
- PROPOSED GRADES.

 4. FINISH GRADES OF PAVEMENTS AND SOIL ALONG BOTTOM OF CURBS AND WALLS SHALL HAVE A CONSTANT SLOPE UNLESS INDICATED

ISSUE DATE REVISIONS

ISSUE DATE REVISIONS

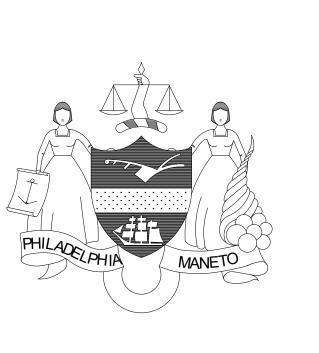

CONSTRUCTION DOCUMENTS

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CITY OF PHILADELPHIA
DEPARTMENT OF PARKS & RECREATION

1515 ARCH STREET 11TH FLOOR, ONE PARKWAY BUILDING

PHILADELPHIA

RENOVATIONS TO THE HAPPY


HOLLOW RECREATION CENTER

PENNSYLVANIA

DRAWING TITLE

GRADING PLAN

PROJECT NO		DRAWING NO.	
1	6315E-03-02		
DATE	05/13/2025	140	
SCALE	AS NOTED		
DRAWN BY	XD/TM		
CHECKED BY	JB	FILE:	
NOTE:	ALL DIMENSIONS AND CONDITIONS S CONTACTOR AT THE SITE BEFORE PRO		

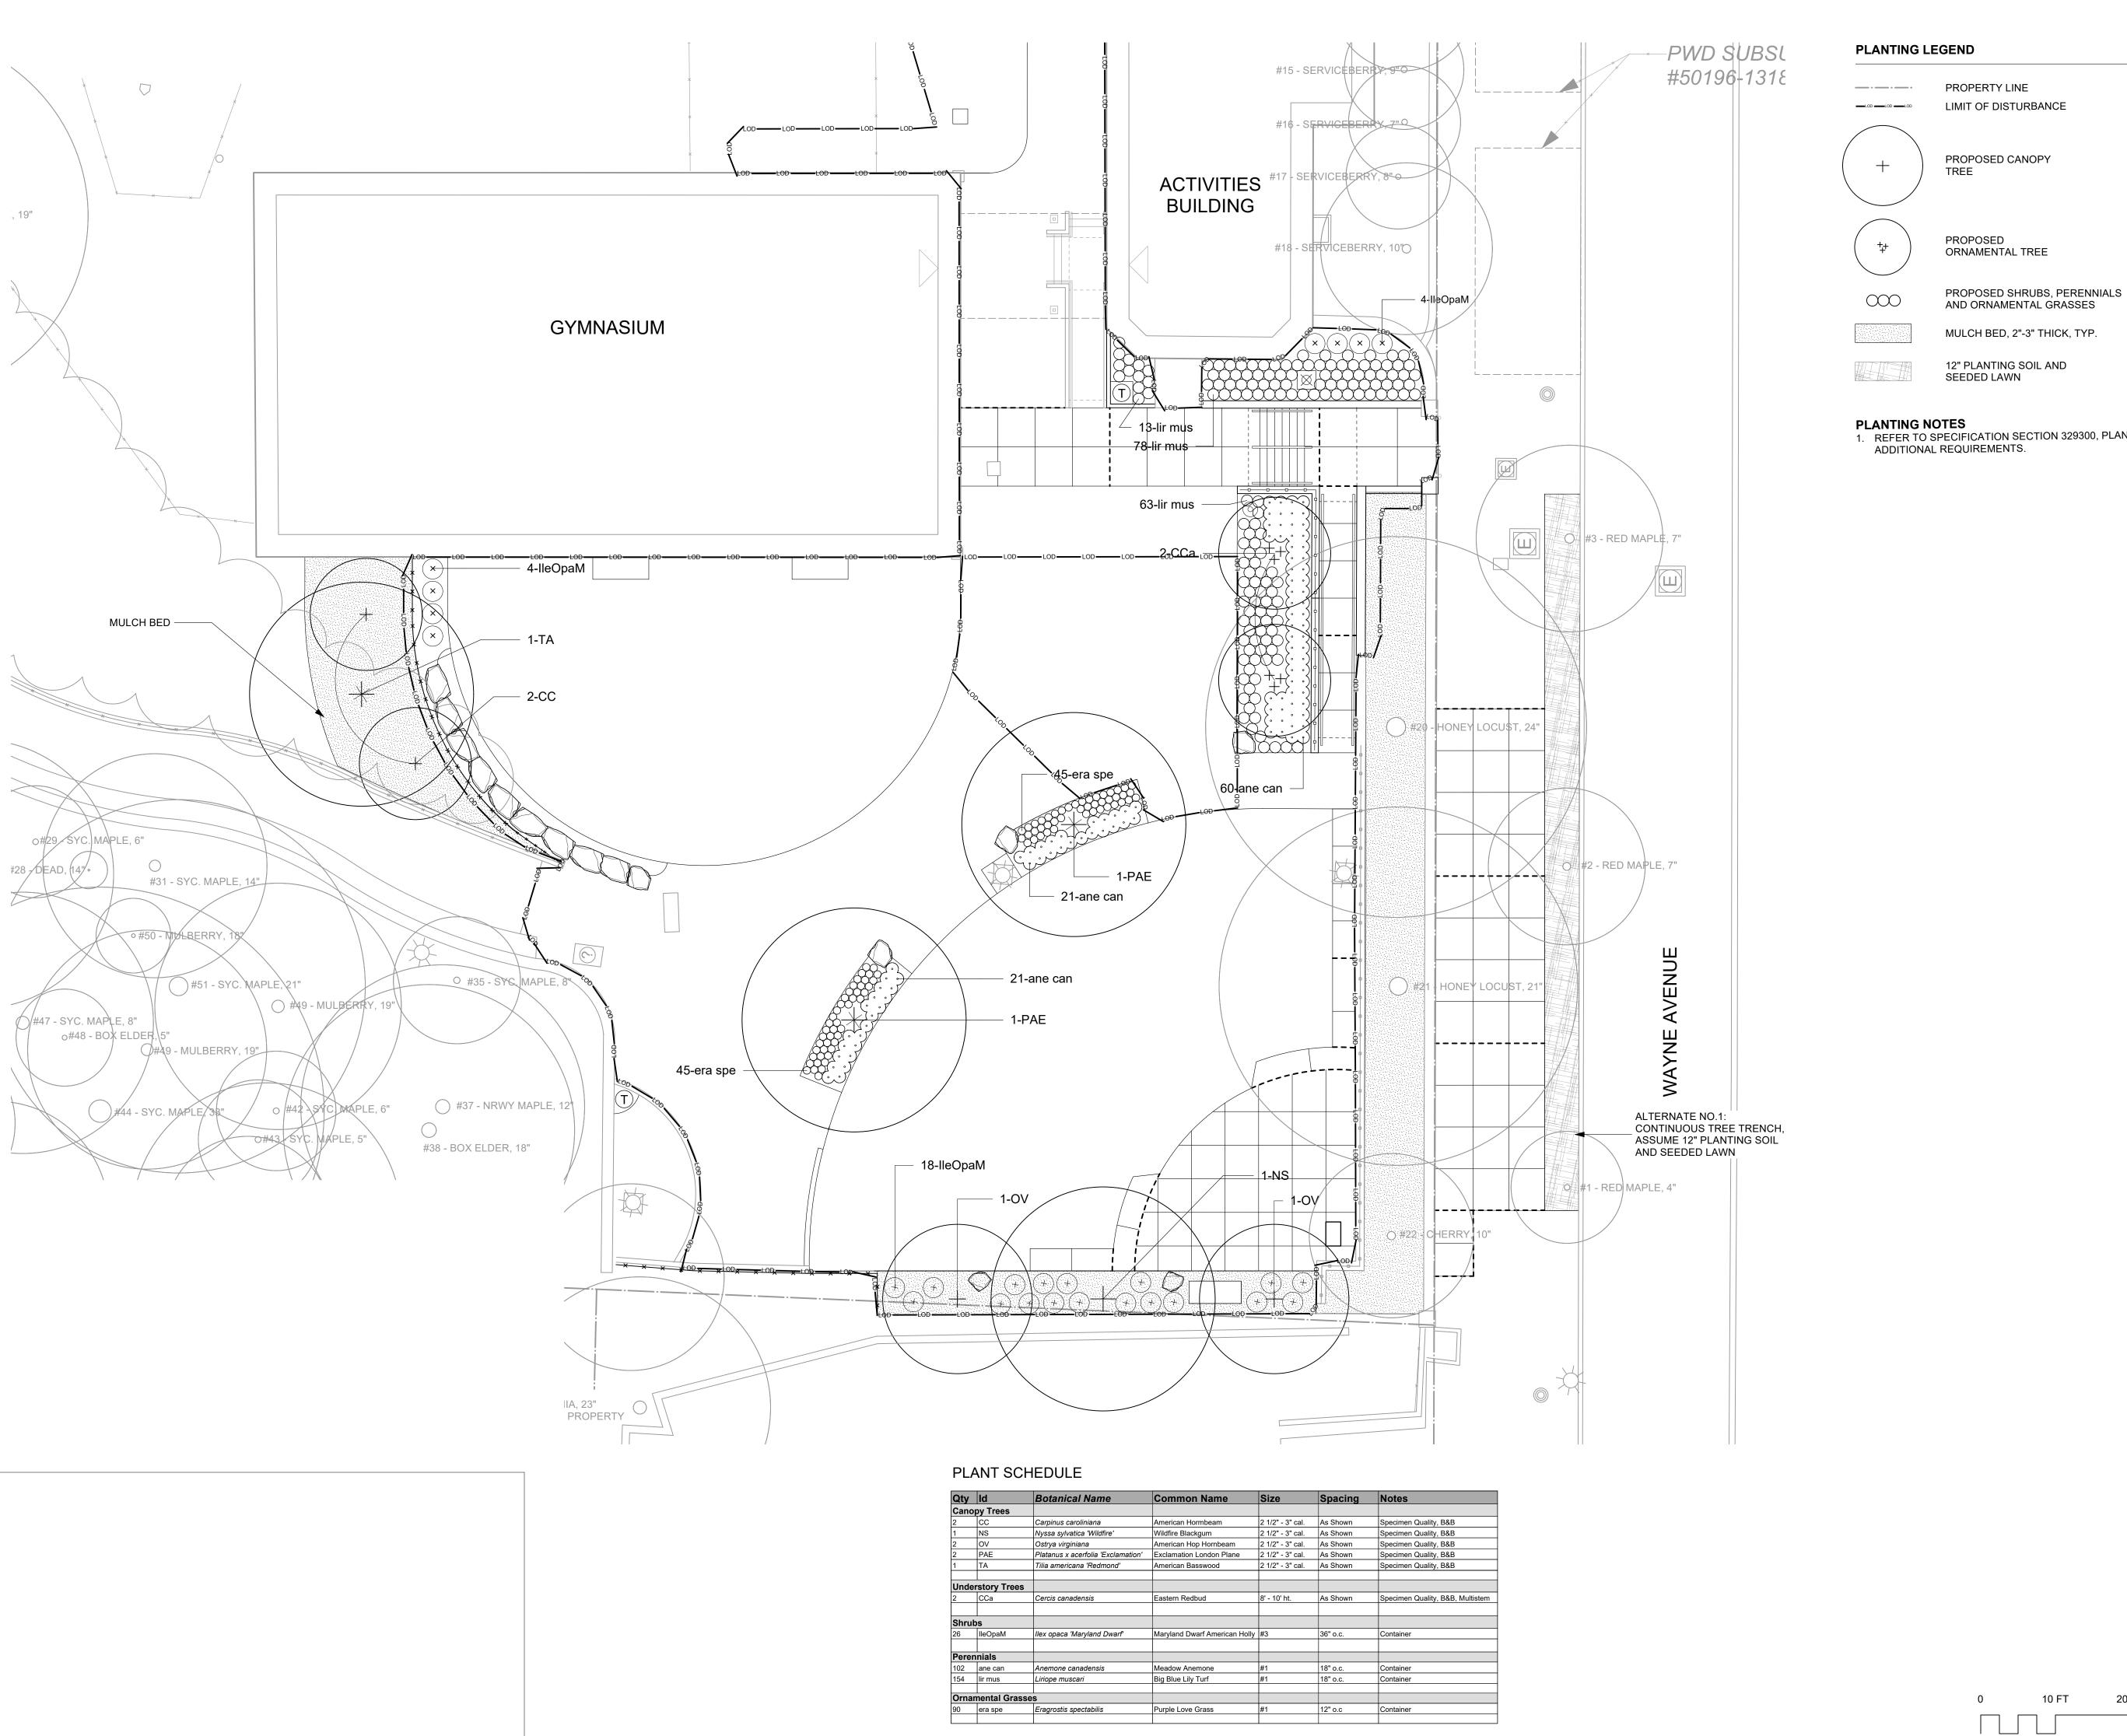



PROPERTY LINE LIMIT OF DISTURBANCE

PROPOSED CANOPY

PROPOSED ORNAMENTAL TREE


AND ORNAMENTAL GRASSES MULCH BED, 2"-3" THICK, TYP.

12" PLANTING SOIL AND SEEDED LAWN



PLANTING NOTES

1. REFER TO SPECIFICATION SECTION 329300, PLANTS FOR ADDITIONAL REQUIREMENTS.

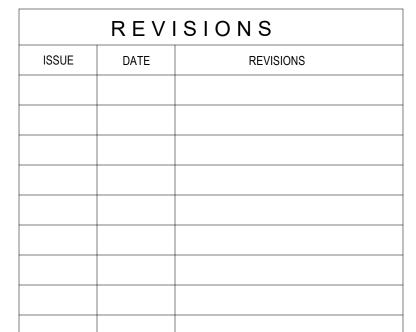



CONSTRUCTION DOCUMENTS

PROJECT COORDINATOR **LEEANN SUEN**





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CITY OF PHILADELPHIA DEPARTMENT OF PARKS & RECREATION

1515 ARCH STREET 11TH FLOOR, ONE PARKWAY BUILDING

PHILADELPHIA

PROJECT TITLE RENOVATIONS TO THE HAPPY


PENNSYLVANIA

DRAWING TITLE

PLANTING PLAN


HOLLOW RECREATION CENTER

PROJECT NO.	DRAWING NO.
16315E-03-02	
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1/8" WIDE HAND
TOOLED CONTROL
JOINT WITH 1/4"
RADIUS

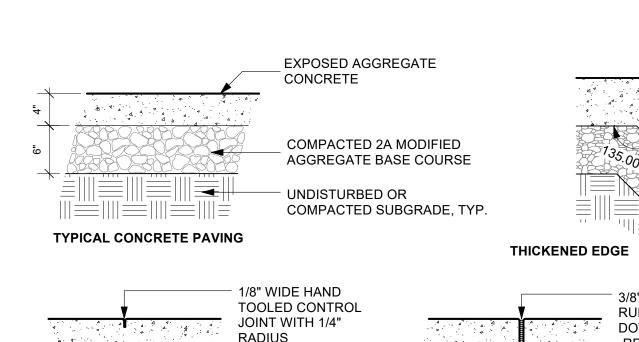NOTE:
DEPTH OF CONTROL
JOINT TO BE 1/4
THICKNESS OF
CONCRETE MIN.



3/8" EXPANSION JOINT - FILL WITH SPONGE
RUBBER EXPANSION JOINT FILLER AND HOLD
DOWN 1/4" FROM FINISHED SURFACE
-REFER TO PLANS AND SPECIFICATIONS FOR
EXPANSION JT. LOCATIONS AND ADDITIONAL
INFORMATION

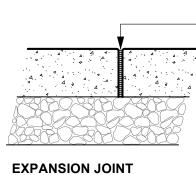VARIES

NOTES:

1.PROVIDE EXPANSION JOINT BETWEEN
CONCRETE PAVING AND ADJACENT FIXED


CURBS, WALLS, FOUNDATIONS, UTILITY STRUCTURES, ETC.

2.PEDESTRAIN CONCRETE PAVING IS 4" THICK UNLESS OTHERWISE NOTED FOR EX. CONCRETE PADS UNDER SITE FURNISHING.


OBJECTS INCLUDING BUT NOT LIMITED TO

1 CONCRETE PAVING L6.0 Scale: 1" = 1'-0"


CONTROL JOINT

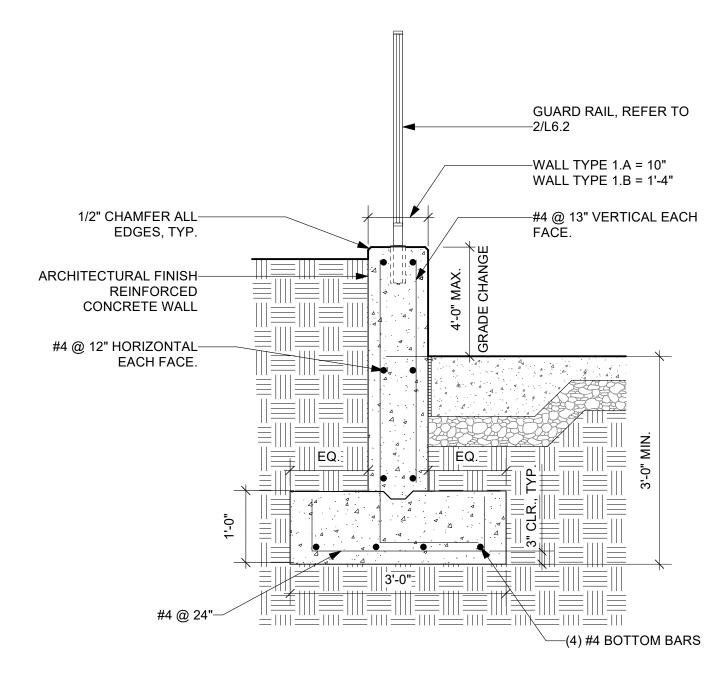

9 CIP CONCRETE RETAINING WALL, TYPE 1
L6.0 Scale: 3/4" = 1'-0"

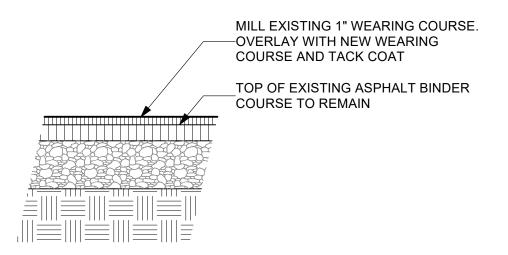


2 ASPHALT PAVING OVERLAY
L6.0 Scale: 1" = 1'-0"

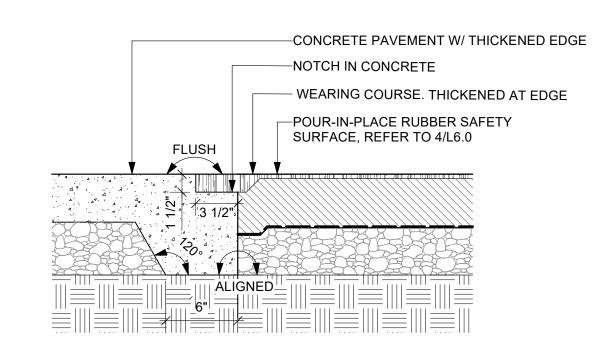


POURED-IN-PLACE RUBBER SAFETY

5 SURFACE / CONCRETE PAVING TRANSITION, TYP.


16.0 Scale: 1 1/2" = 1'-0"

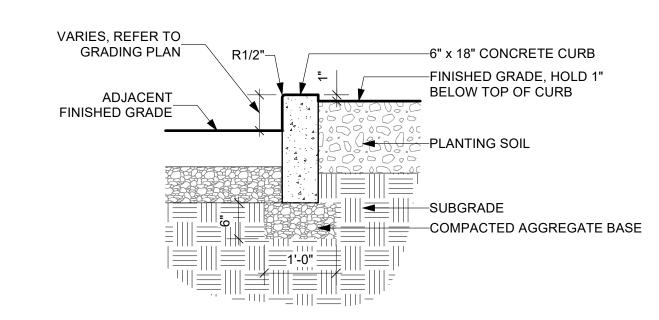


8 CONCRETE CURB, TYP L6.0 Scale: 3/4" = 1'-0"

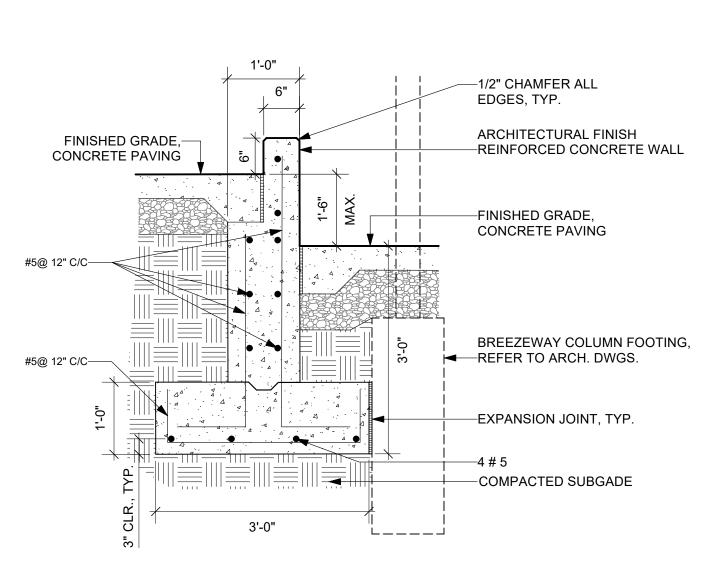

10 CIP CONCRETE RETAINING WALL, TYPE 2
L6.0 Scale: 3/4" = 1'-0"

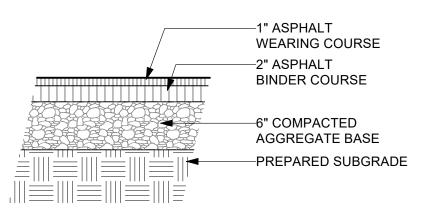


3 FULL DEPTH ASPHALT PAVING L6.0 Scale: 1" = 1'-0"

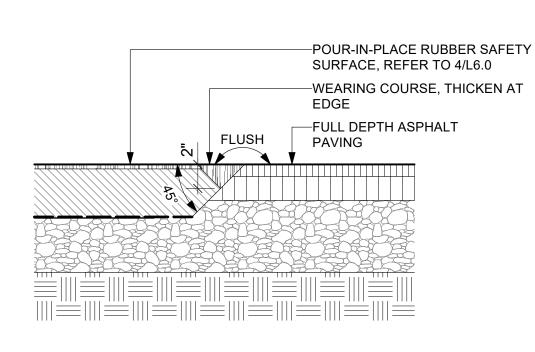

POURED-IN-PLACE RUBBER SAFETY

6 SURFACE / ASPHALT PAVING TRANSITION


16.0 Scale: 1 1/2" = 1'-0"

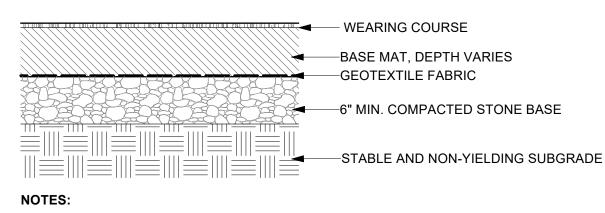

1. SAFETY SURFACE DEPTH MUST MEET OR EXCEED THAT WHICH IS REQUIRED TO MEET THE CRITICAL FALL HEIGHT CRITERIA OF EACH PIECE OF EQUIPMENT AND ASTM-F1292-13, OR MOST RECENT EDITION STANDARD.

4 POURED-IN-PLACE RUBBER SAFETY SURFACE, TYP.


Scale: 1 1/2" = 1'-0"

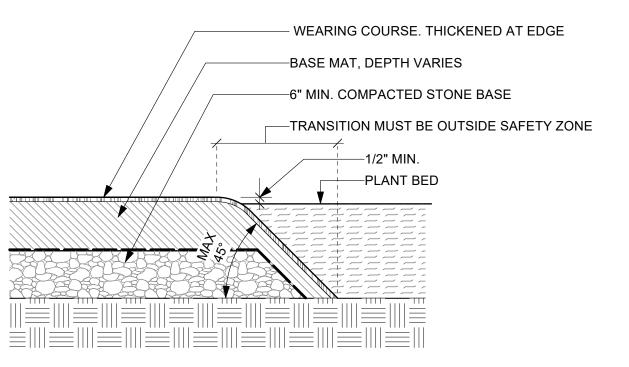


POURED-IN-PLACE RUBBER SAFETY

SURFACE / PLANTBED TRANSITION

L6.0 Scale: 1 1/2" = 1'-0"

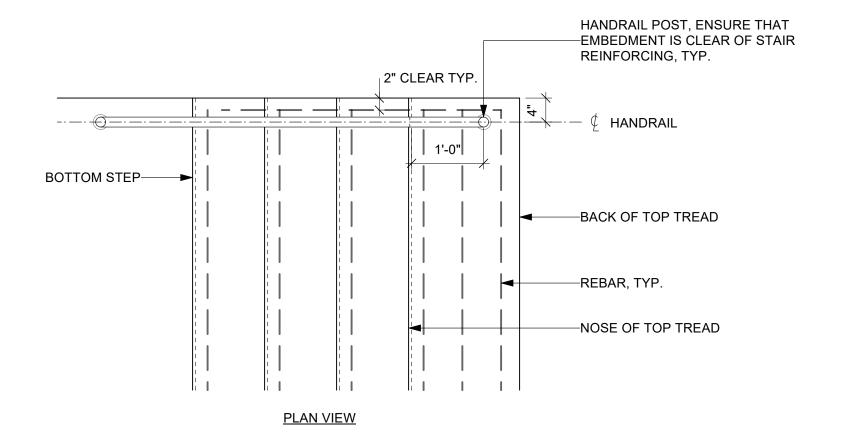

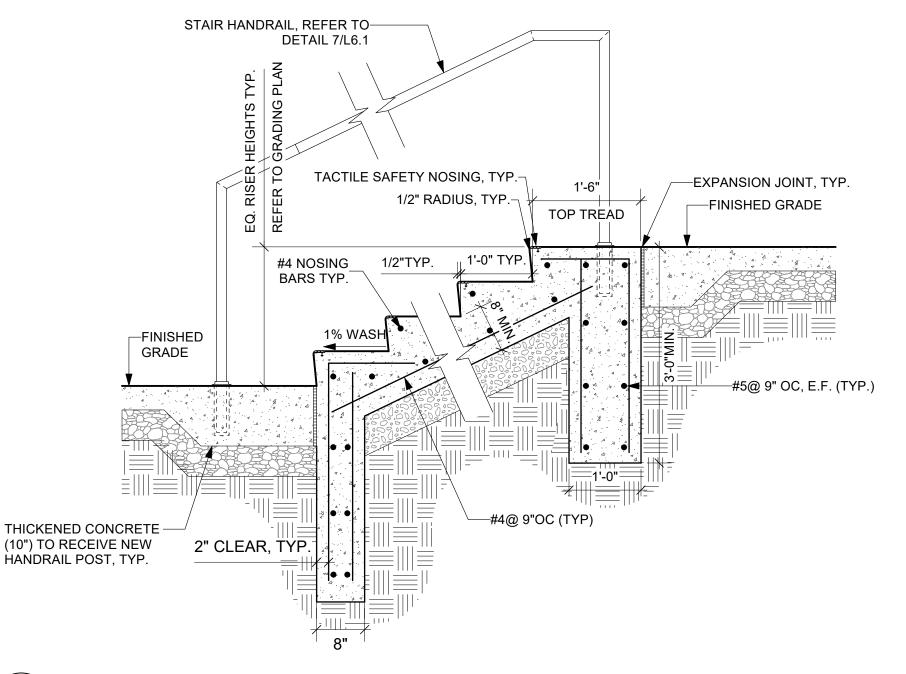

11 CIP CONCRETE STAIRS
L6.0 Scale: 3/4" = 1'-0"

ISSUE DATE REVISIONS



CONSTRUCTION DOCUMENTS

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LEEANN SUEN

SEALS



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ARORA ENGINEERS
www.aroraengineers.com
610 459 7900

DRAWING TITLE

PROJECT NO.

ROOFING CONSULTANT:
STEPHEN McLAUGHLIN ROOFING CONSULTANT
stevemclaughlin.biz
856 287 2424

CITY OF PHILADELPHIA
DEPARTMENT OF PARKS & RECREATION

1515 ARCH STREET 11TH FLOOR, ONE PARKWAY BUILDING

PHILADELPHIA PENNSYLVANIA
PROJECT TITLE

RENOVATIONS TO THE HAPPY HOLLOW RECREATION CENTER


SITE DETAILS


16315E-03-02

E 05/13/2025


LE AS NOTED

WWN BY XD/TM

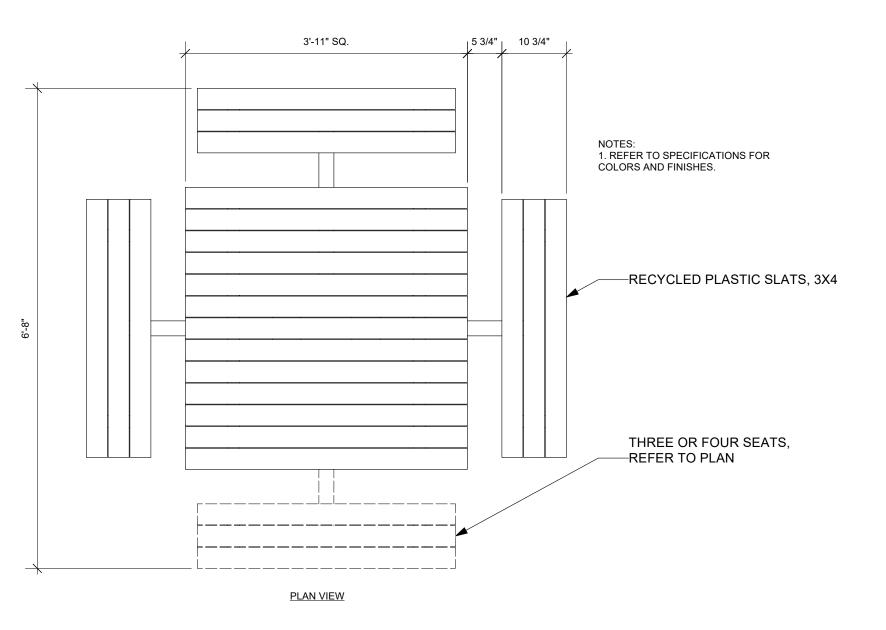

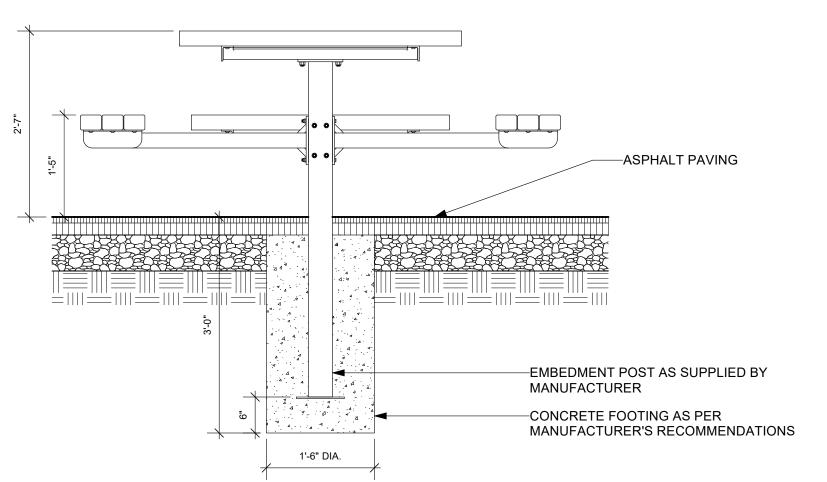




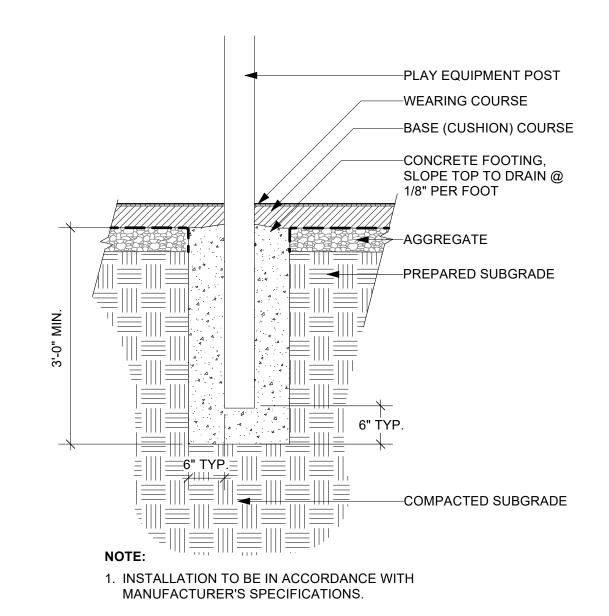


2 PLAY EQUIPMENT FOOTING IN PIP RUBBER SAFETY SURFACE, TYP.

Scale: 3/4" = 1'-0"

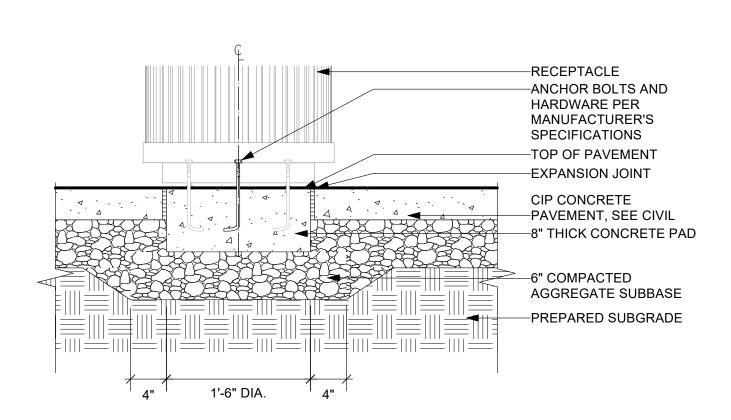


4 TRASH RECEPTACLE, TYP.

L6.1 Scale: 1" = 1'-0"

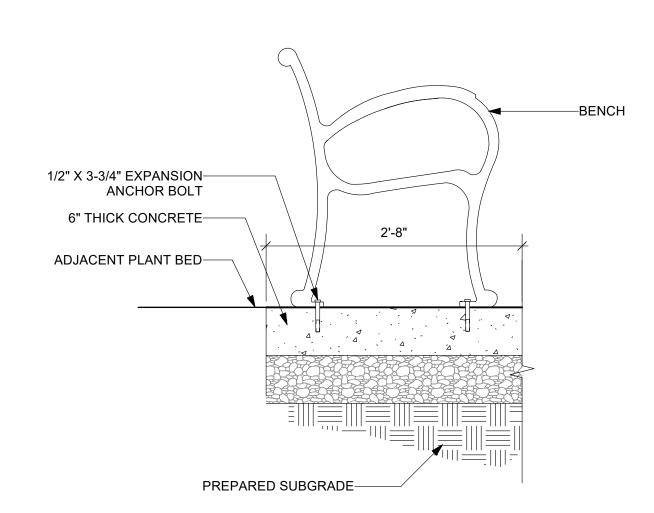


3 BENCH DETAIL, TYP.
L6.1 Scale: 1" = 1'-0"

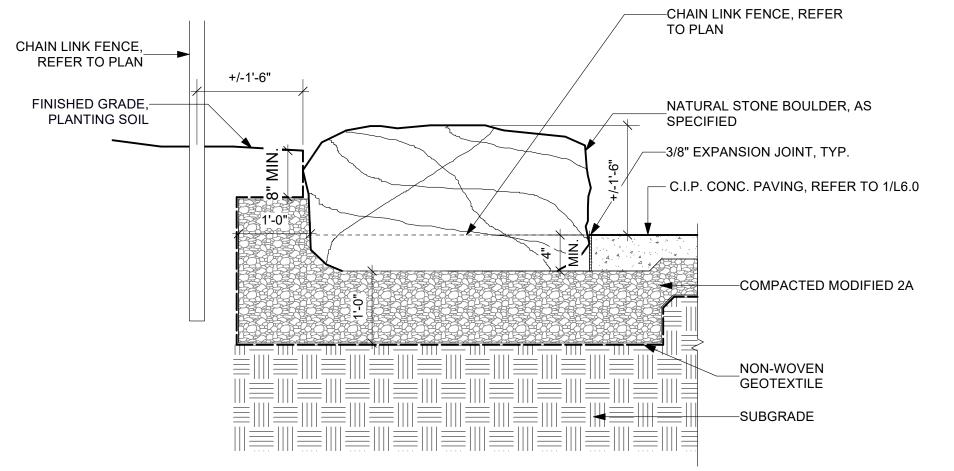



5 BOULDER SEATWALL, TYP.
L6.1 Scale: 3/4" = 1'-0"

-SLIP JOINT, (1) PER

HANDRAIL, TYP.

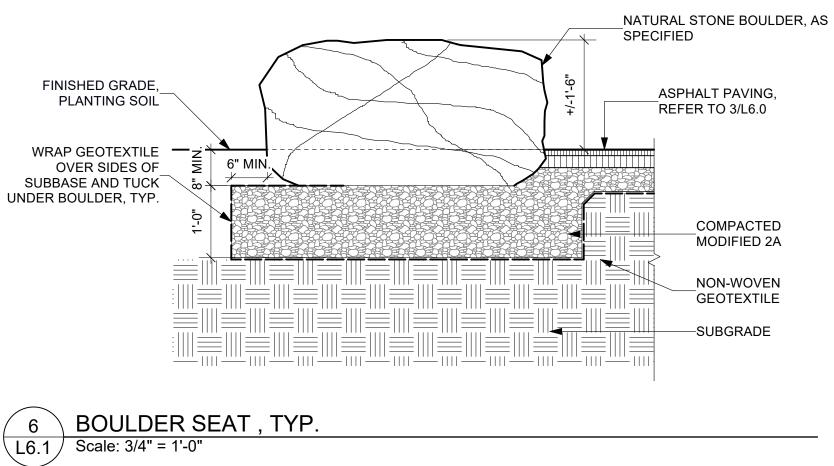

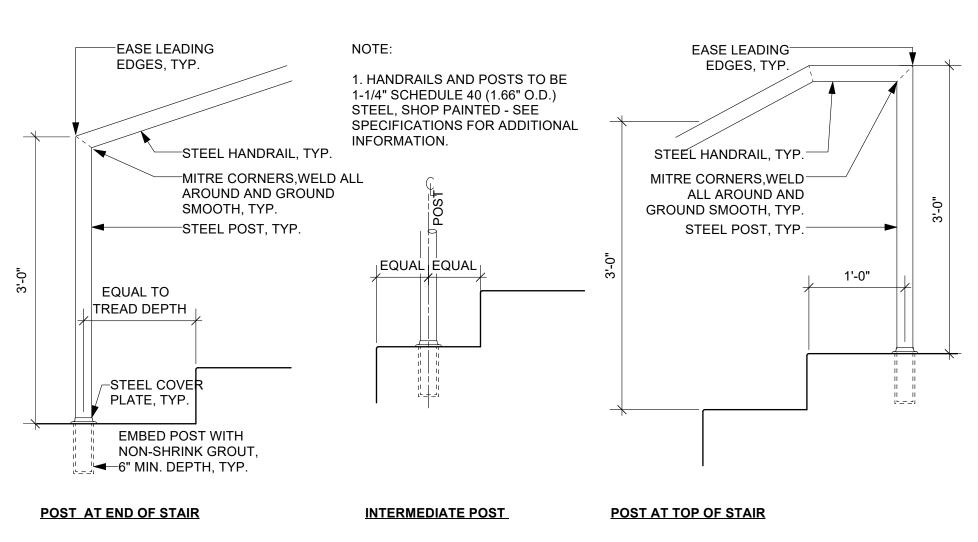

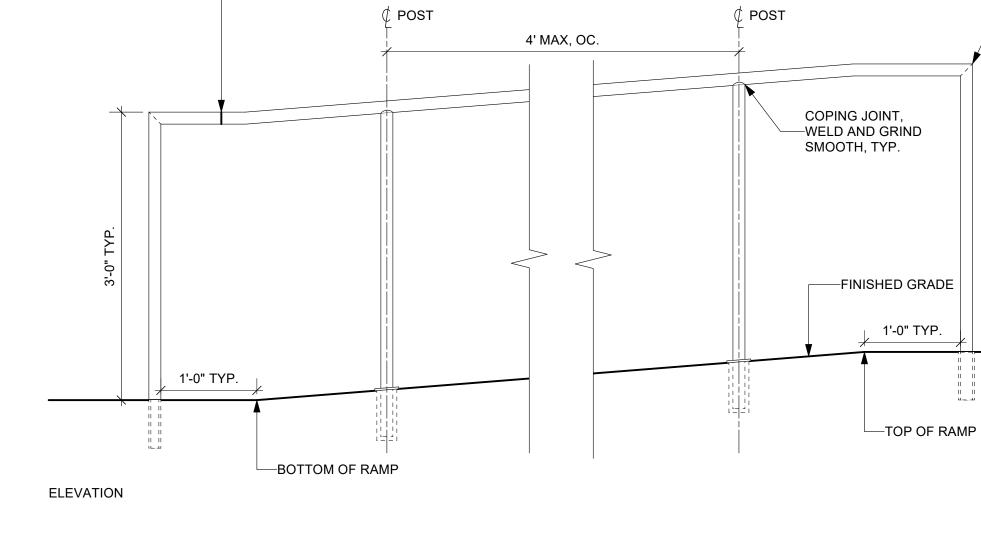

7 STAIR HANDRAIL, TYP.
L6.1 Scale: 1" = 1'-0"

8 RAMP HANDRAIL, TYP.
L6.1 Scale: 1" = 1'-0"

ISSUE DATE REVISIONS



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610 459 7900

EASE LEADING

EDGES, TYP.

ROOFING CONSULTANT:
STEPHEN McLAUGHLIN ROOFING CONSULTANT
stevemclaughlin.biz
856 287 2424

CITY OF PHILADELPHIA
DEPARTMENT OF PARKS & RECREATION

1515 ARCH STREET 11TH FLOOR, ONE PARKWAY BUILDING

RENOVATIONS TO THE HAPPY
HOLLOW RECREATION CENTER

PENNSYLVANIA

DRAWING TITLE

PROJECT NO.

PHILADELPHIA

SITE DETAILS

DRAWING NO.


16315E-03-02

DATE 05/13/2025

SCALE AS NOTED

DRAWN BY XD/TM

CHECKED BY ID

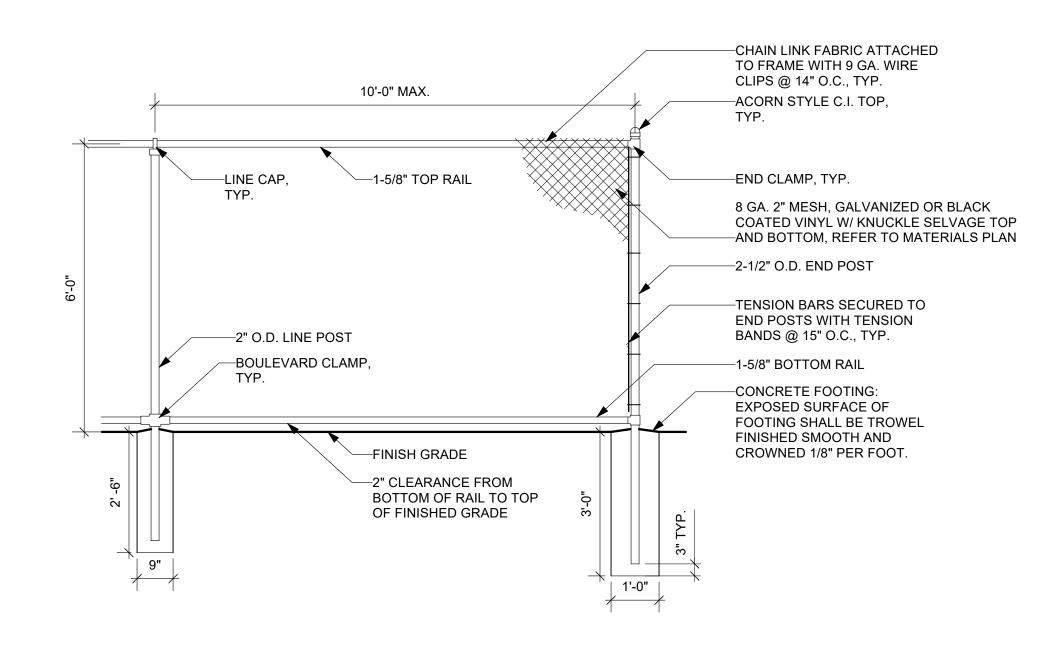


PSI @ 28 DAYS. PROVIDE 3" OF CONCRETE COVER

OVER ALL REINFORCEMENT BARS.

JUNCTION BOX, WIRING AND GROUNDING.


LUMINAIRE TYPE AND MOUNTING HEIGHT.

6' HT. CHAIN LINK FENCE L6.2 | Scale: 1/2" = 1'-0"

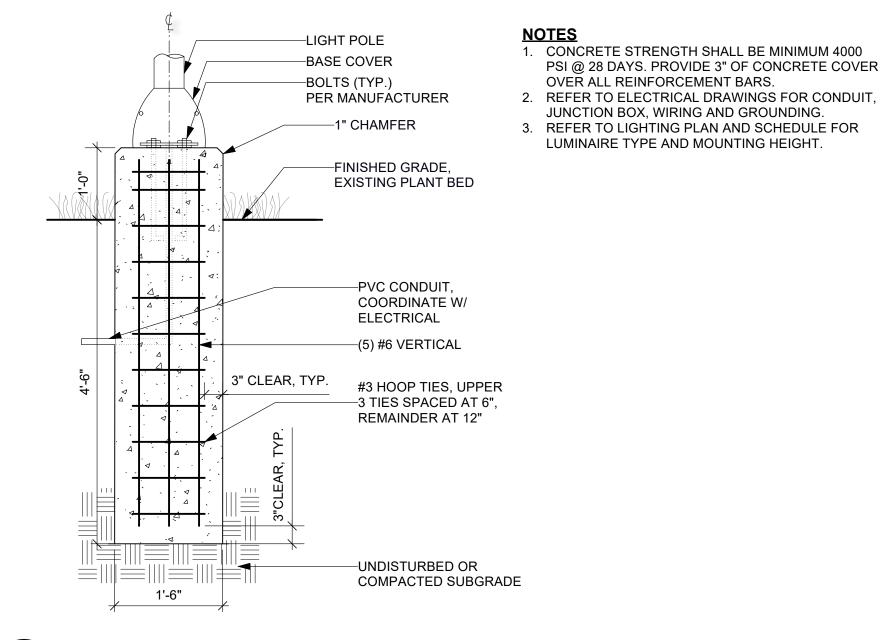

PEDESTRIAN LIGHTING FOOTING, TYP.


L6.2 Scale: 3/4" = 1'-0"

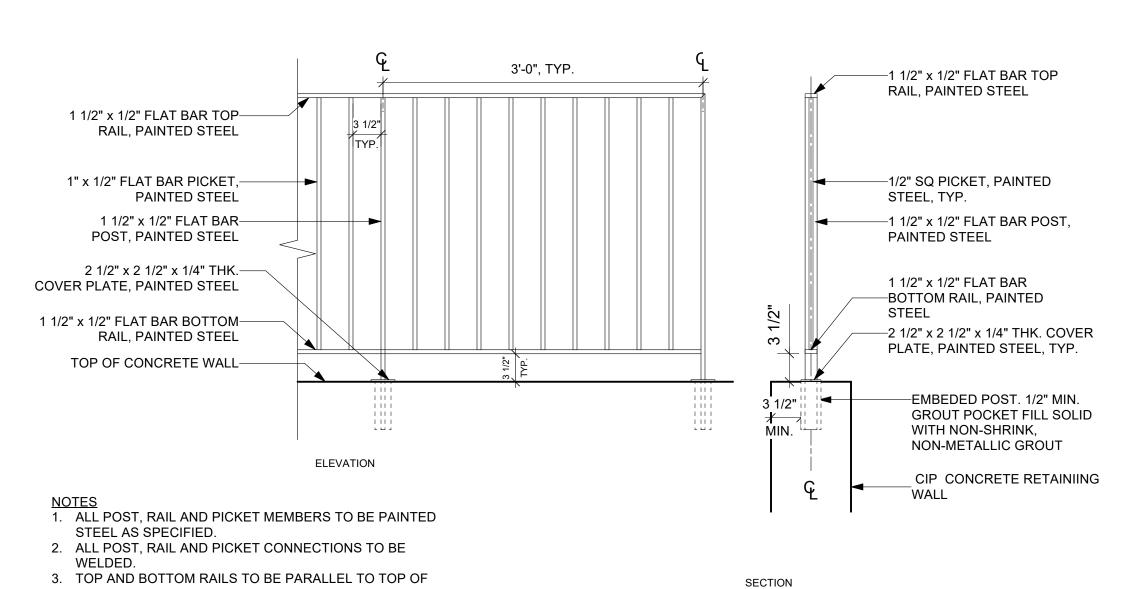


GUARDRAIL, TYP. L6.2 | Scale: 1" = 1'-0"

LOCATIONS.


4. PICKETS AND POSTS TO BE PLUMB VERTICAL IN ALL

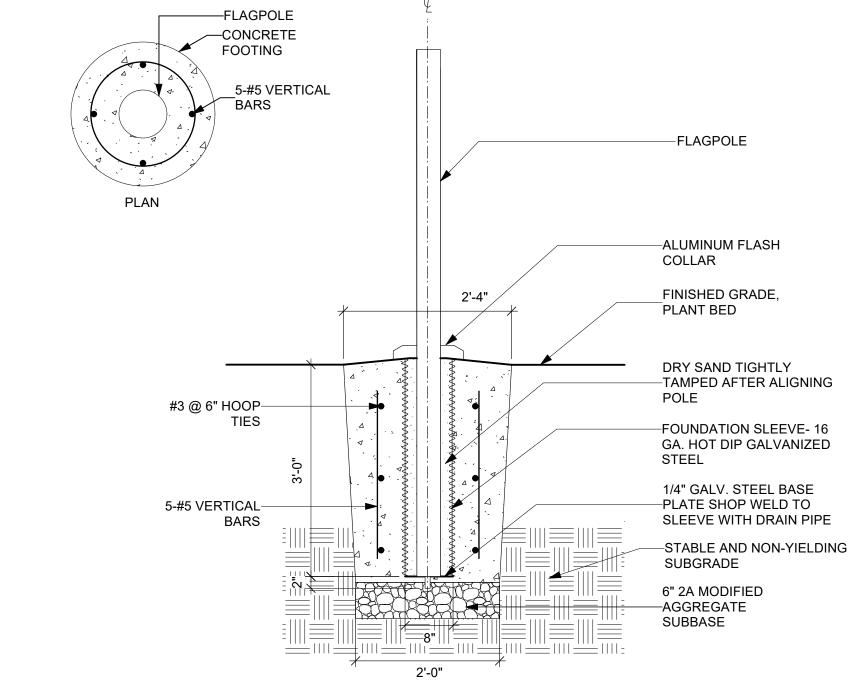



FLAG POLE, TYP. L6.2 | Scale: 3/4" = 1'-0"

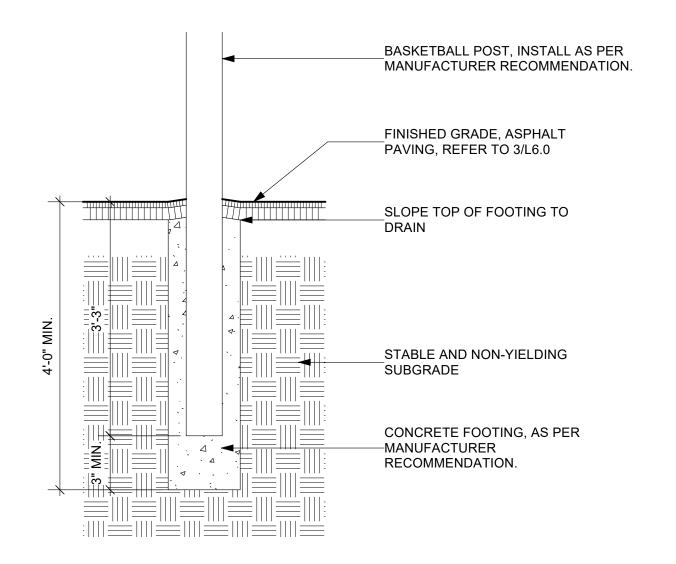

BASKETBALL GOAL FOOTING, TYP. L6.2 | Scale: 3/4" = 1'-0"

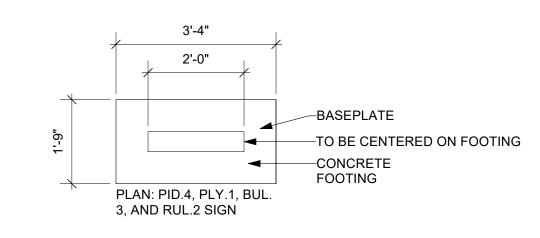


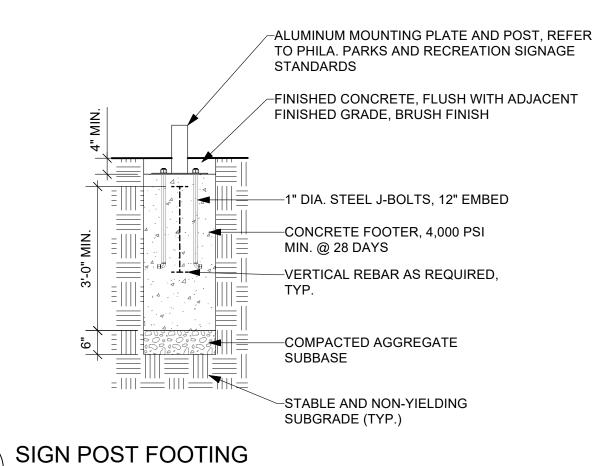

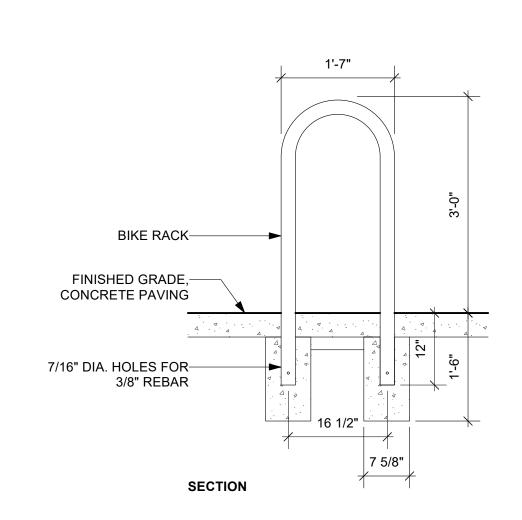


BIKE RACK, TYP. L6.2 | Scale: 3/4" = 1'-0"

L6.2 | Scale: 1/2" = 1'-0"

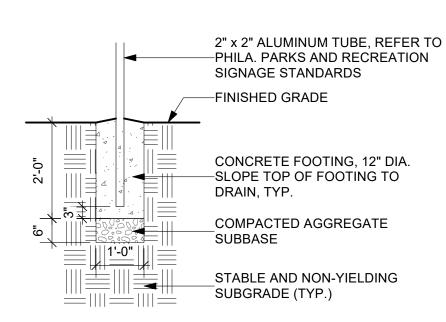

 $\binom{8}{}$ SIGN POST FOOTING, RUL.6 L6.2 | Scale: 1/2" = 1'-0"

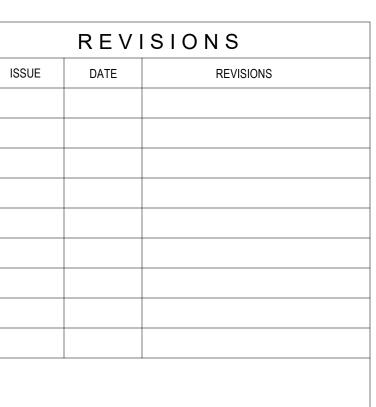



CONSTRUCTION DOCUMENTS

LEEANN SUEN

PROJECT COORDINATOR



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215 790 0727 **CIVIL ENGINEER: KS ENGINEERS** www.kseng.com 215 925 0425

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856 287 2424

ROOFING CONSULTANT: STEPHEN McLAUGHLIN ROOFING CONSULTANT stevemclaughlin.biz

CITY OF PHILADELPHIA DEPARTMENT OF PARKS & RECREATION

1515 ARCH STREET


11TH FLOOR, ONE PARKWAY BUILDING PENNSYLVANIA PHILADELPHIA


PROJECT TITLE RENOVATIONS TO THE HAPPY HOLLOW RECREATION CENTER

DRAWING TITLE

SITE DETAILS


PROJECT NO. 16315E-03-02 L6.2 05/13/2025 AS NOTED XD/TM CHECKED BY

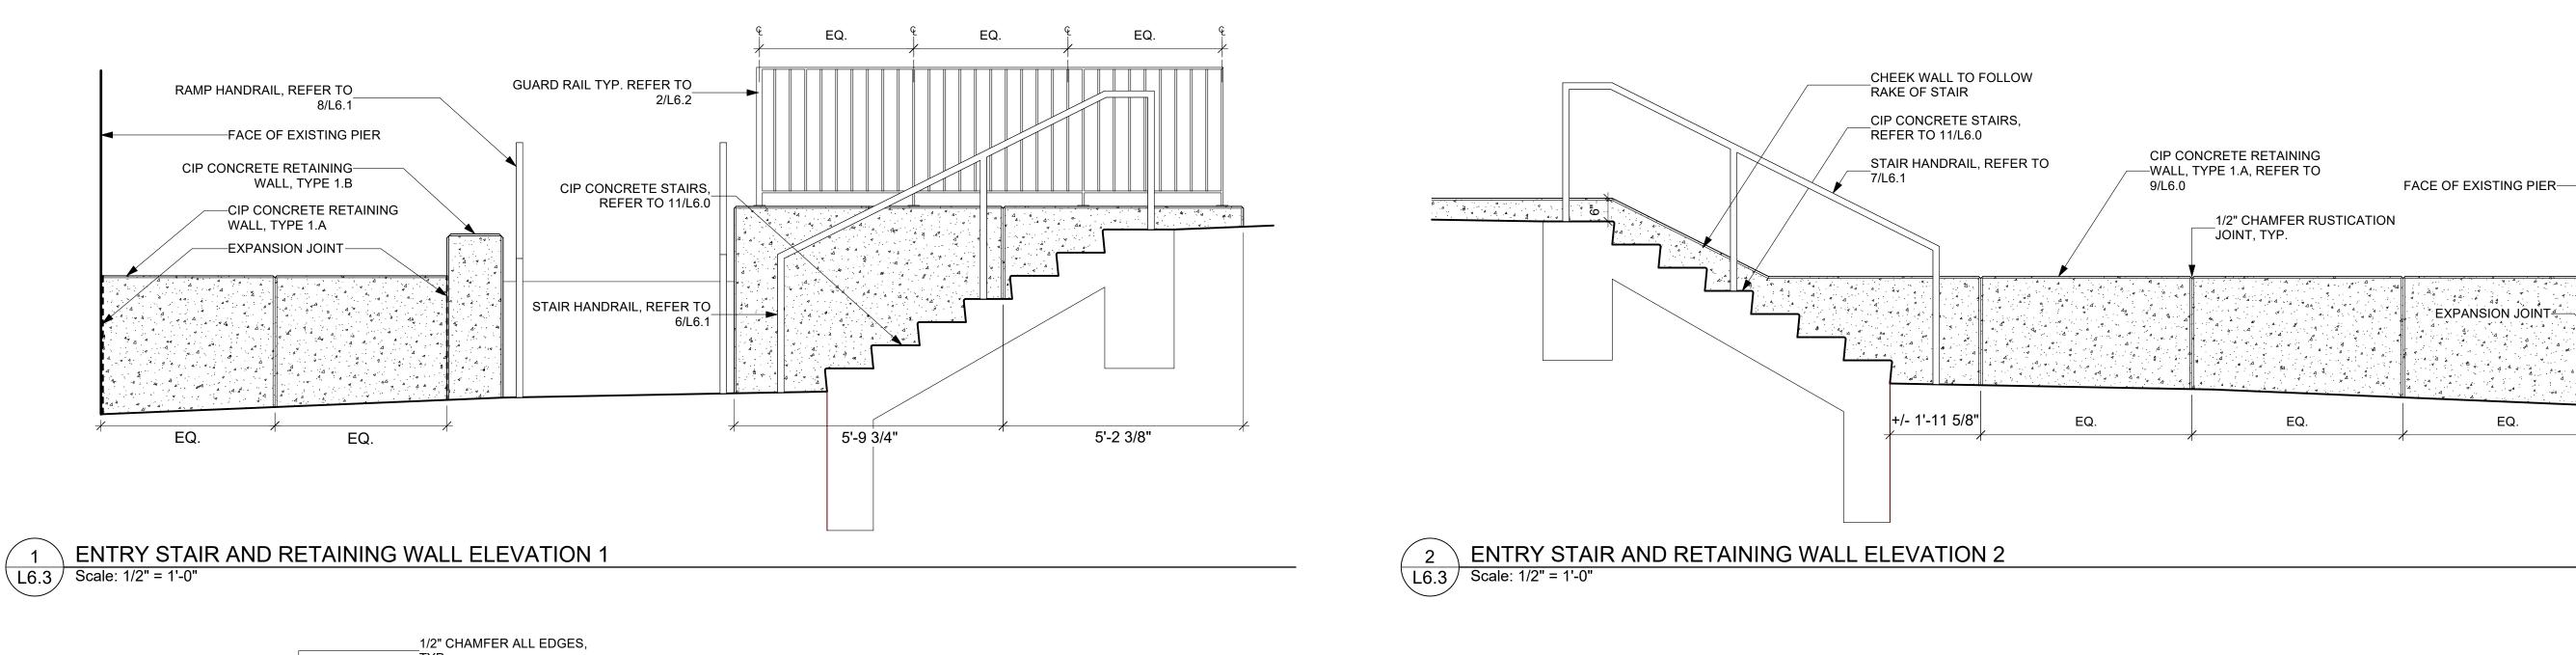

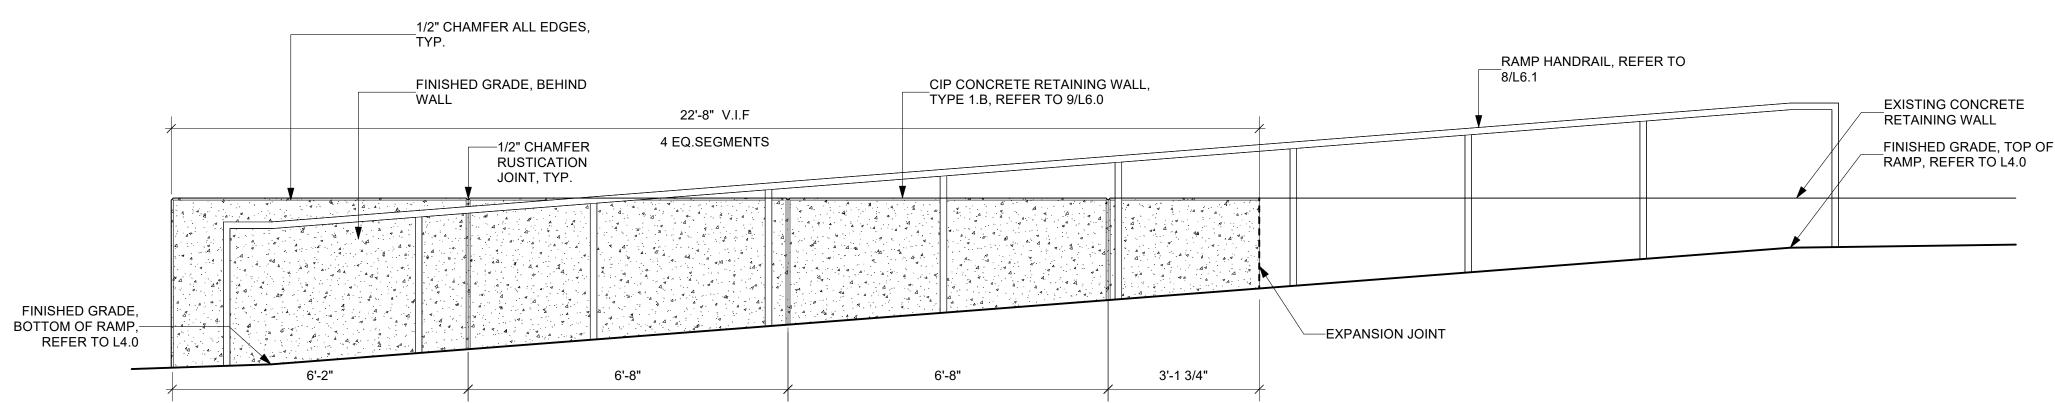

ADA RAMP EAST RETAINING WALL ELEVATION L6.3 Scale: 1/2" = 1'-0" 4'-0" 3'-4" 23'-4", (7) EQ. PANELS 4'-0" GUARD RAIL TYP. REFER TO 2/L6.2 RAMP HANDRAIL REFER TO 8/L6.1 ─ 1/2" CHAMFER RUSTICATION JOINT, TYP. CIP CONCRETE RETAINING WALL, TYPE-1, REFER TO 9/L6.0 FINISHED GRADE, REFER TO GRADING-PLAN 6'-8" 2'-10 3/8" 6'-8" 6'-2"

ADA RAMP/RETAINING WALL ELEVATION AT PLANT BED 2 L6.3 Scale: 1/2" = 1'-0"

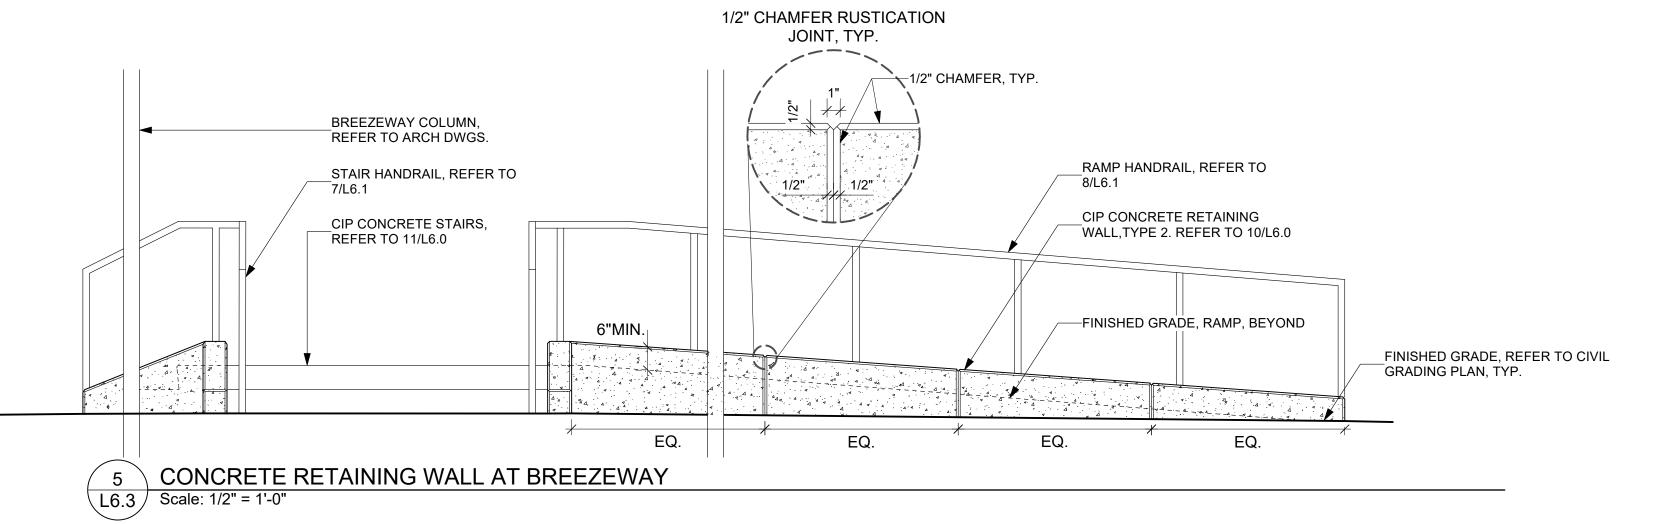

05/13/2025 AS NOTED XD/TM CHECKED BY

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CITY OF PHILADELPHIA DEPARTMENT OF PARKS & RECREATION

1515 ARCH STREET 11TH FLOOR, ONE PARKWAY BUILDING

PHILADELPHIA


RENOVATIONS TO THE HAPPY HOLLOW RECREATION CENTER

PENNSYLVANIA


DRAWING TITLE

SITE DETAILS

16315E-03-02

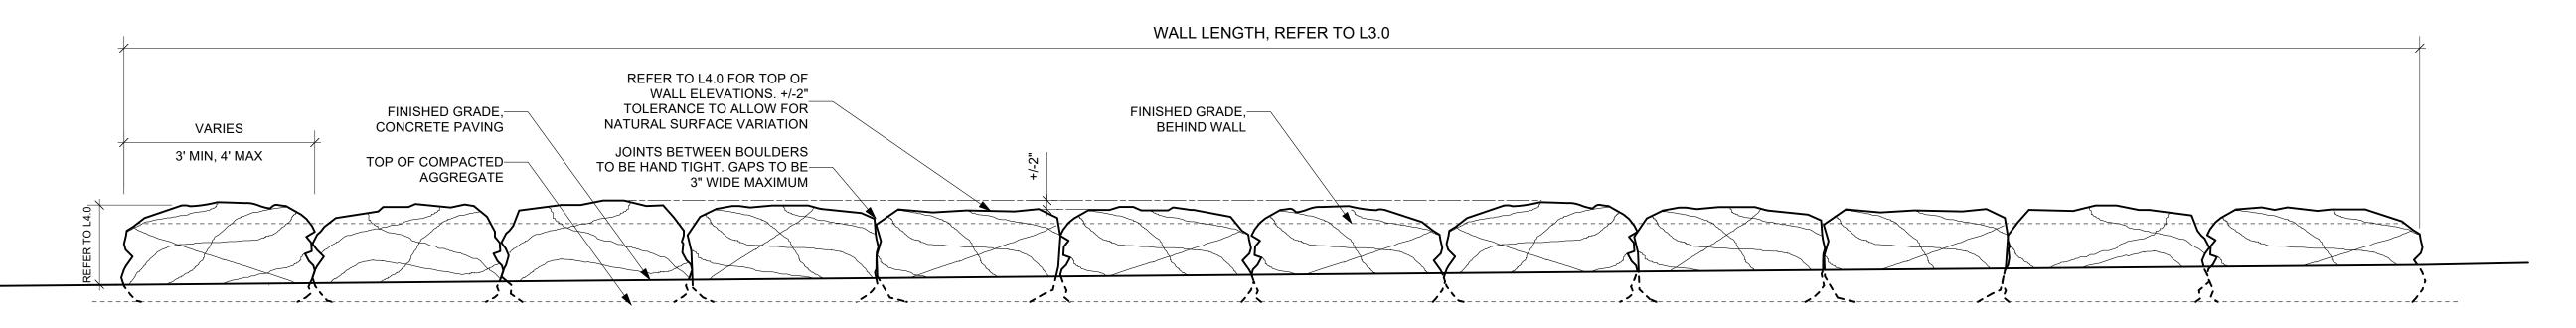

1 BOULDER SEATWALL FLATTENED ELEVATION
L6.4 Scale: 1/2" = 1'-0"

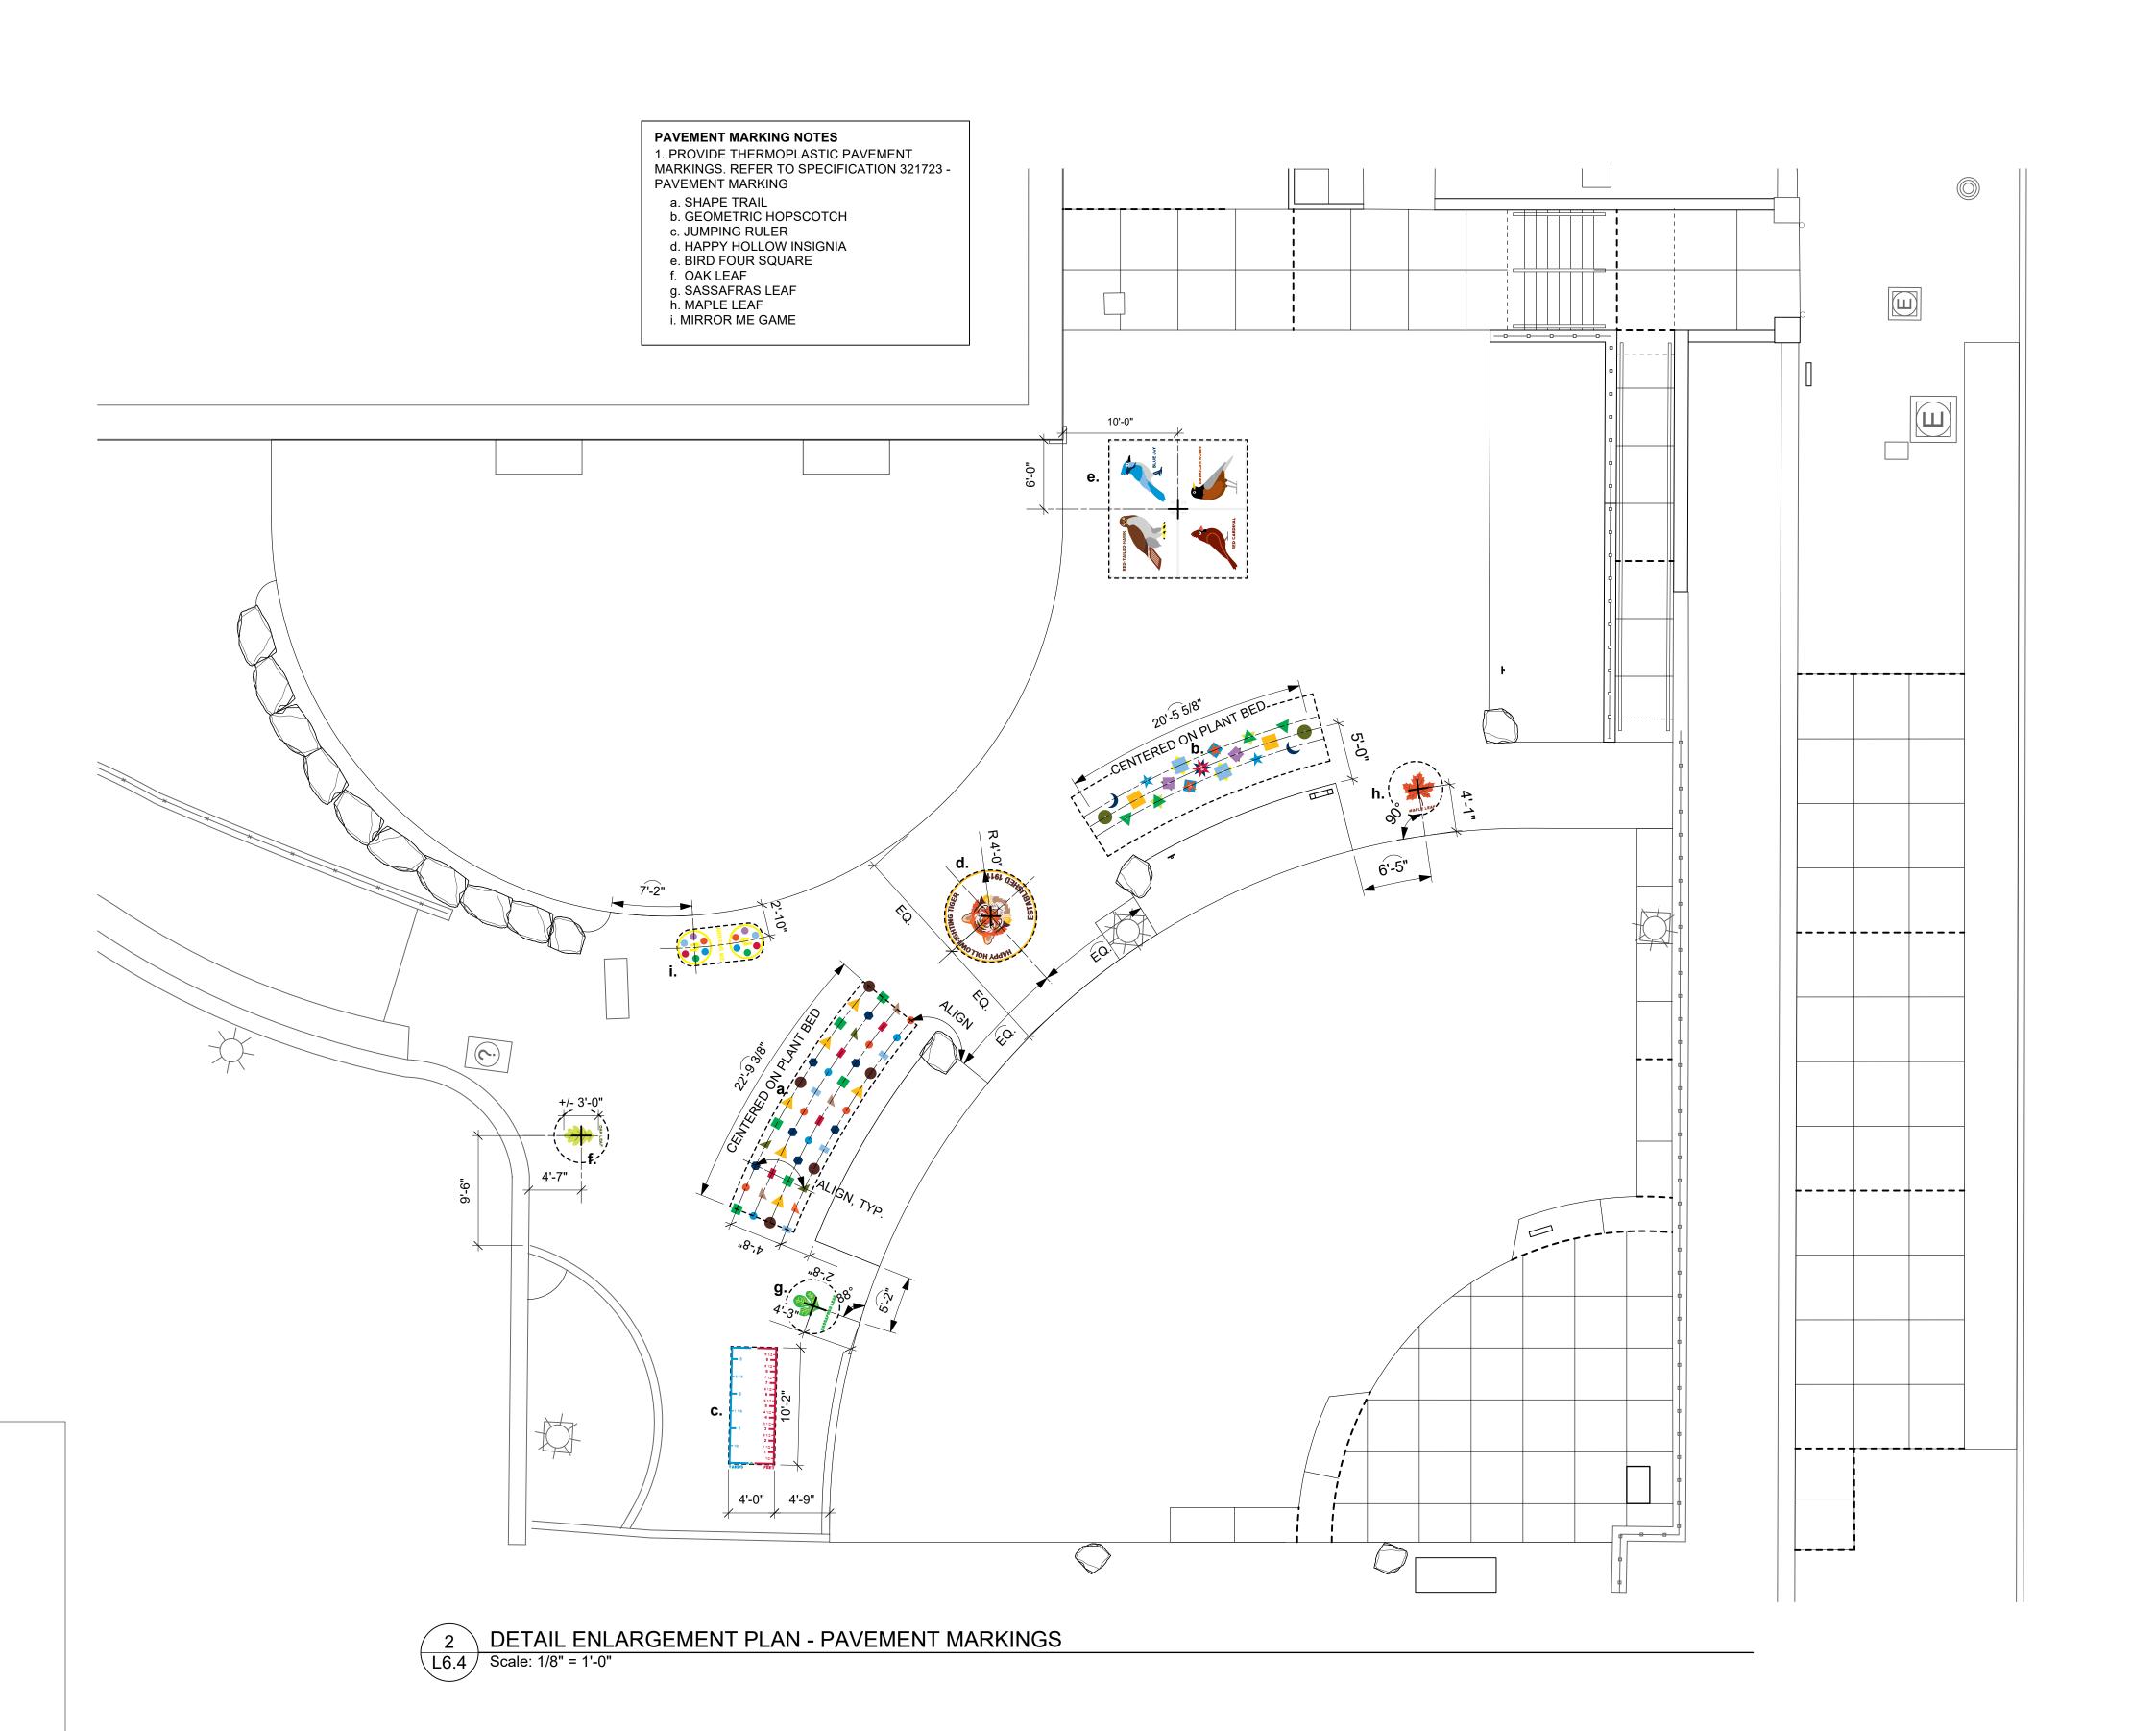

REVISIONS				
ISSUE	DATE	REVISIONS		



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CITY OF PHILADELPHIA DEPARTMENT OF PARKS & RECREATION

1515 ARCH STREET

11TH FLOOR, ONE PARKWAY BUILDING


PHILADELPHIA PENNSYLVANIA

RENOVATIONS TO THE HAPPY HOLLOW RECREATION CENTER

DRAWING TITLE

SITE DETAILS

PROJECT NO.		DRAWING NO.
16	315E-03-02	
DATE	05/13/2025	L6.4
SCALE	AS NOTED	
DRAWN BY	XD/TM	
CHECKED BY	JB	FILE:

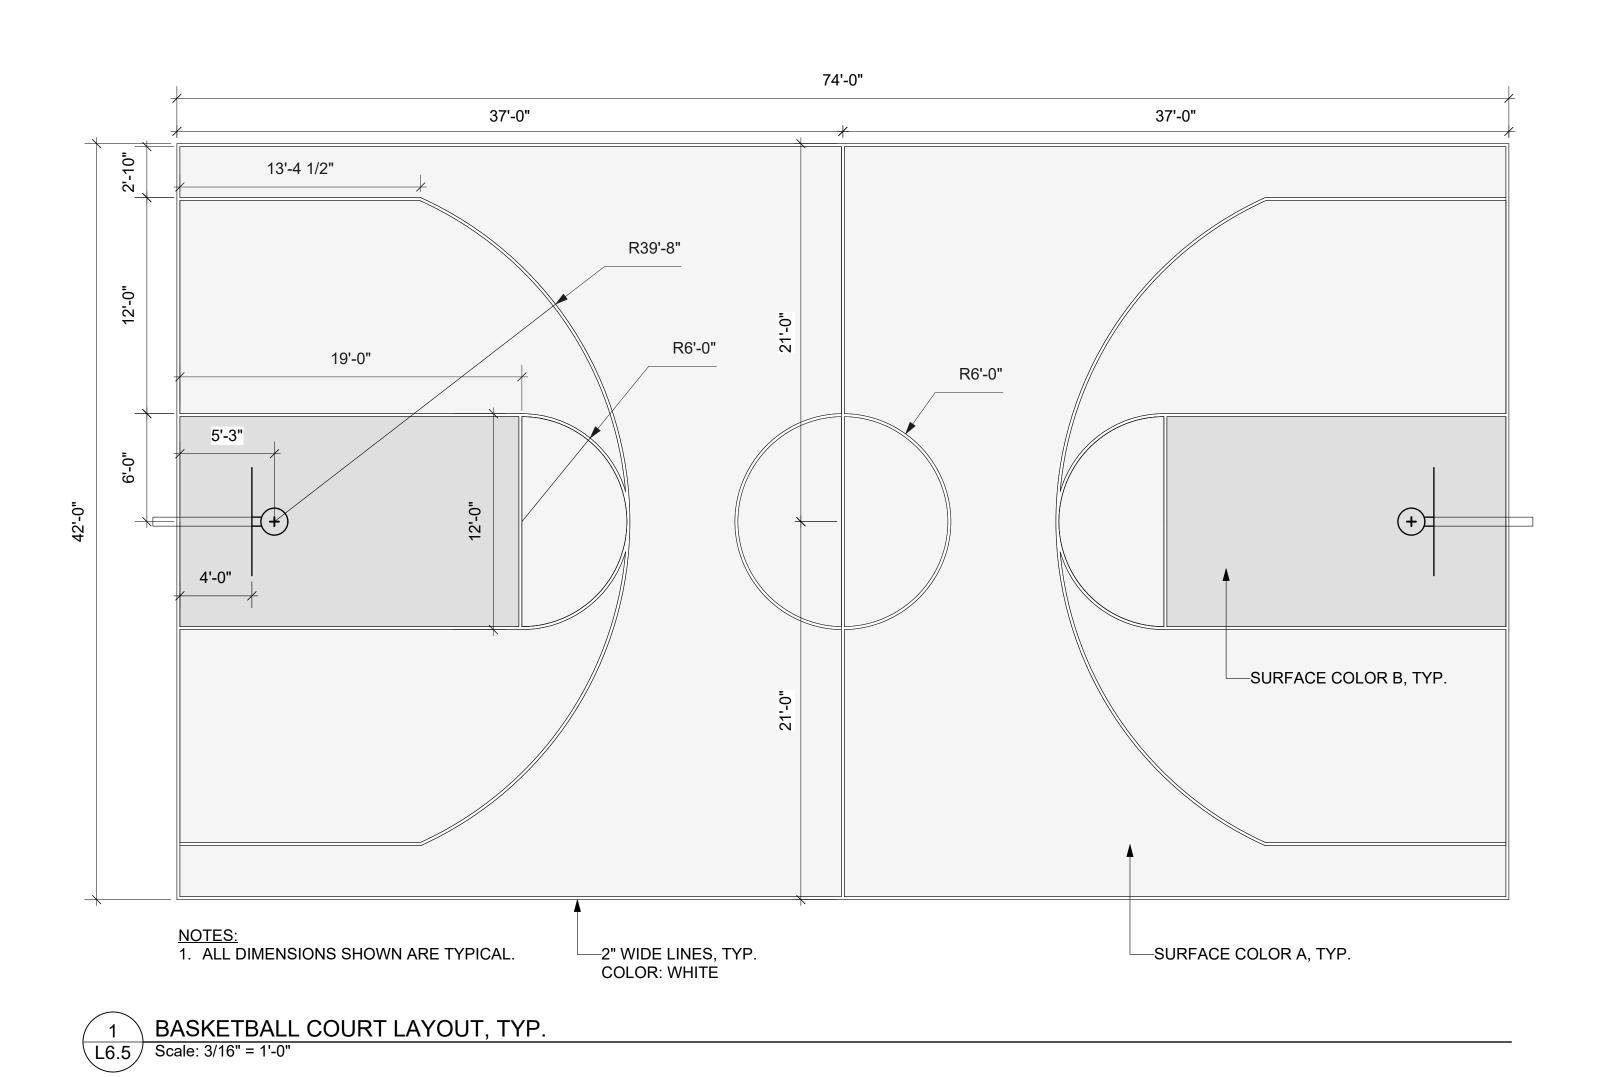

REVISIONS REVISIONS ISSUE



CONSTRUCTION DOCUMENTS

PROJECT COORDINATOR

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CITY OF PHILADELPHIA DEPARTMENT OF PARKS & RECREATION

1515 ARCH STREET

11TH FLOOR, ONE PARKWAY BUILDING

PHILADELPHIA

RENOVATIONS TO THE HAPPY HOLLOW RECREATION CENTER

PENNSYLVANIA

DRAWING TITLE

SCALE


PROJECT TITLE

SITE DETAILS


PROJECT NO. DRAWING NO. 16315E-03-02

05/13/2025


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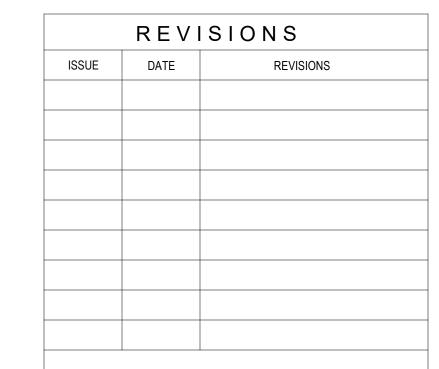
1 TREE PLANTING DETAIL L6.6 Scale: 3/4" = 1'-0"

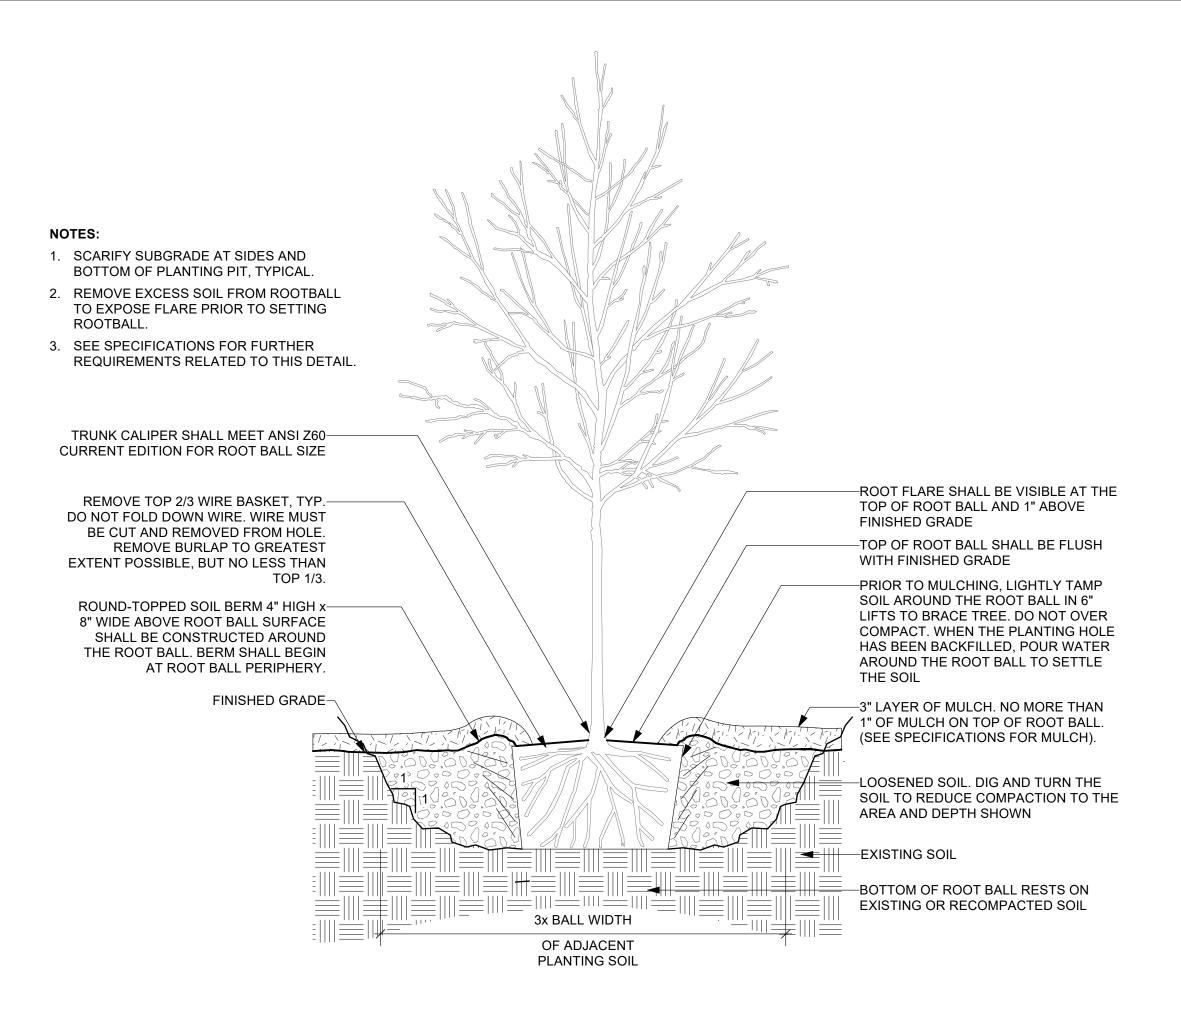

3 SHRUB PLANTING DETAIL
L6.6 Scale: 3/4" = 1'-0"

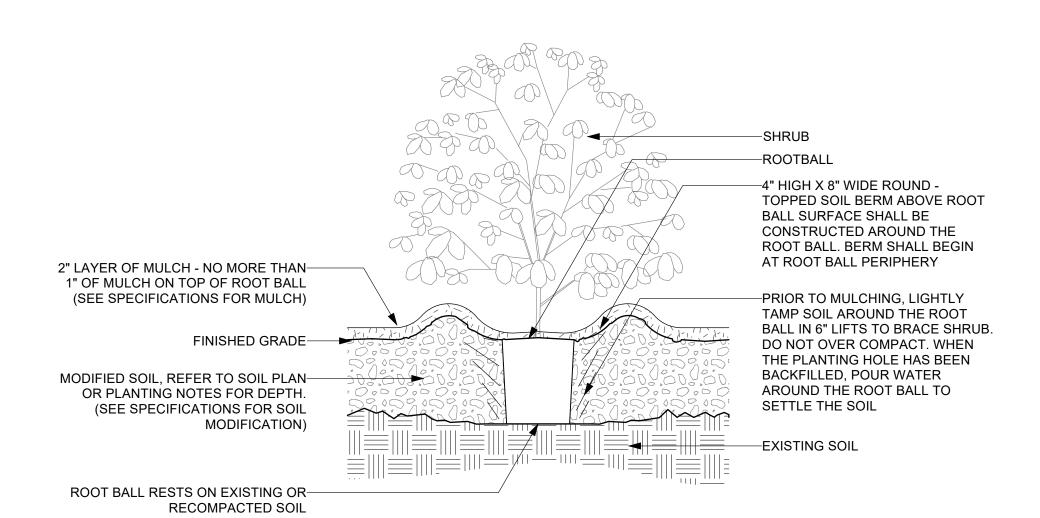



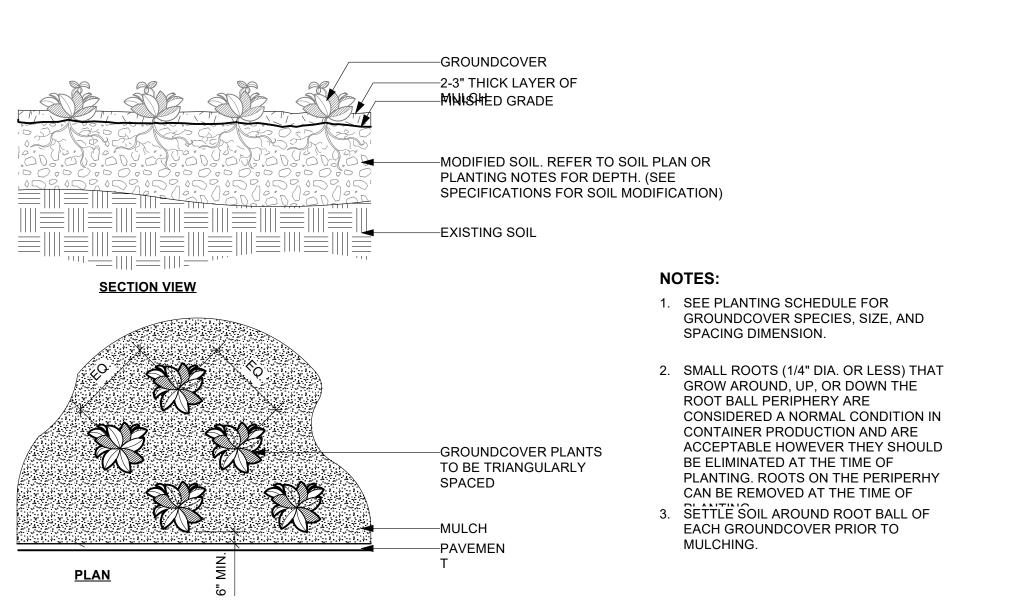



CONSTRUCTION DOCUMENTS

PROJECT COORDINATOR

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CITY OF PHILADELPHIA DEPARTMENT OF PARKS & RECREATION

1515 ARCH STREET

11TH FLOOR, ONE PARKWAY BUILDING

PHILADELPHIA

RENOVATIONS TO THE HAPPY

HOLLOW RECREATION CENTER

PENNSYLVANIA

DRAWING TITLE

PLANTING DETAILS


PROJECT	NO.	DRAWING NO.
,	16315E-03-02	
DATE	05/13/2025	16.
SCALE	AS NOTED	
	DATE	05/13/2025

DRAWN BY XD/TM


CHECKED BY ID

IOTE: ALL DIMENSIONS AND CONDITIONS SHALL BE VERIFIED BY THE

CONTACTOR AT THE SITE BEFORE PROCEEDING WITH THE WORK

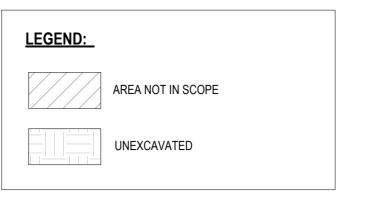

DEMOLITION KEY:

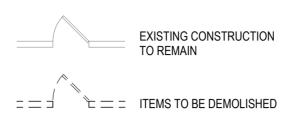

GENERAL DEMOLITION NOTES:

- ALL EXG CONDITIONS AND DIMENSIONS TO BE VERIFIED IN FIELD PRIOR TO CONSTRUCTION.
- ALL GLAZED BRICK LOCATIONS TO BE STRIPPED OF PAINT.
 REFER TO MEPFP DOCUMENTS FOR ADDITIONAL DEMOLITION REQUIREMENTS.
- 4. REMOVE ALL EXG INTERIOR DOORS, FRAMES & HARDWARE, UNO. 5. REMOVE ALL OVERHEAD INTERIOR LIGHTING, UNO, REF ELEC DWGS, UNO. REMOVE AND STORE ALL EXERCISE EQUIPMENT FOR REINSTALLATION, UNO.
- REMOVE EXG PLUMBING FIXTURES/EQUIPMENT, UNO.; SEE PLUMBING DWGS.
- . REMOVE MECHANICAL EQUIPMENT, UNO.; SEE MECHANICAL DWGS, UNO. 9. REMOVE ELECTRICAL FIXTURES/EQUIPMENT, UNO.; SEE ELEC DWGS.
- 10. REMOVE ALL SECURITY SYSTEM EQUIPMENT & ASSOCIATED WIRING, SEE ELEC DWGS.11. REMOVE ALL VEGETATION FROM BUILDING EXTERIOR SURFACES.
- 12. REMOVE ALL EXG CAST IRON DOWNSPOUT BOOTS.

KEYED DEMOLITION NOTES

DN-21 REMOVE BREEZEWAY ROOF, COLUMNS, FOOTINGS AND ALL ASSOCIATED STRUCTURE.

DN-33 REMOVE EXG WINDOW / LOUVER.

DN-40 REMOVE SECTION OF FOUNDATION WALL FOR HVAC REFRIGERANT LINE PENETRATION, SEE STRUCT & MECH DWGS.



REVISIONS

REVISIONS

DATE

ISSUE

CONSTRUCTION DOCUMENTS

PROJECT COORDINATOR

LEEANN SUEN



SMPARCHITECTS

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CITY OF PHILADELPHIA DEPARTMENT OF PARKS & RECREATION

1515 ARCH STREET 11TH FLOOR, ONE PARKWAY BUILDING

RENOVATIONS TO THE HAPPY HOLLOW RECREATION CENTER


BASEMENT DEMOLITION PLAN

16315E-03-02

05/13/2025


AS NOTED DRAWN BY JS/SCR CHECKED BY SCR

ALL DIMENSIONS AND CONDITIONS SHALL BE VERIFIED BY THE CONTACTOR AT THE SITE BEFORE PROCEEDING WITH THE WORK

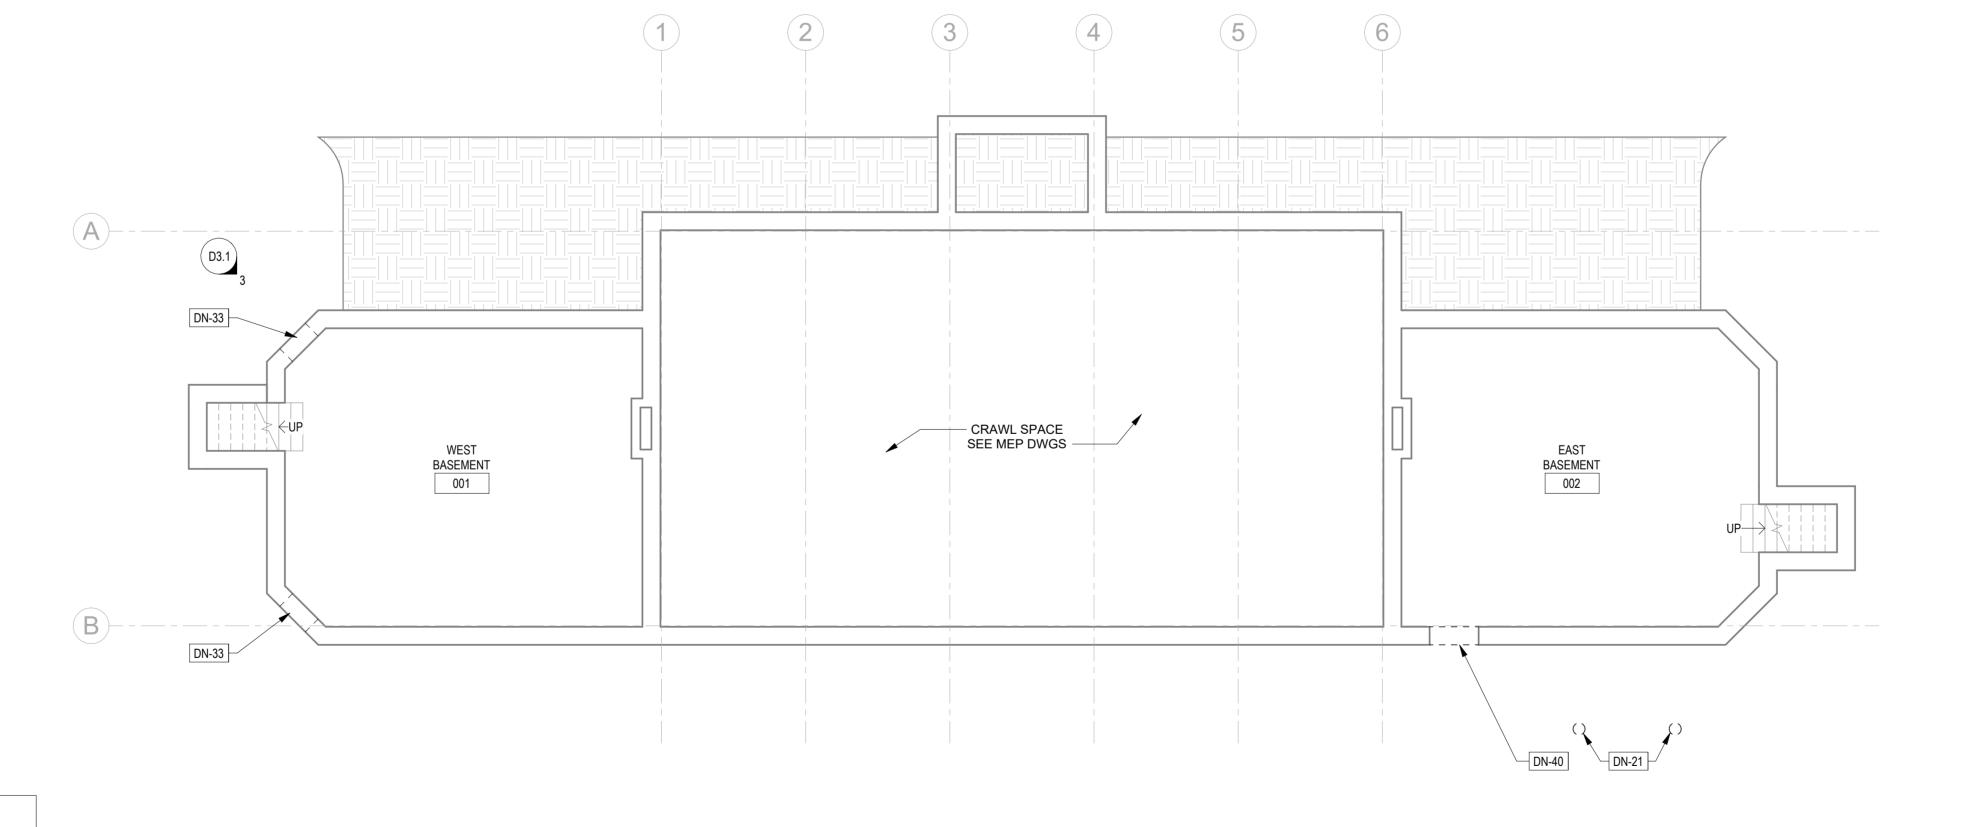


AREA NOT IN SCOPE

BASEMENT DEMOLITION PLAN

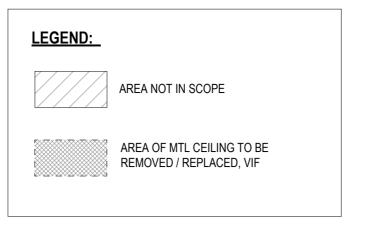

DEMOLITION KEY:

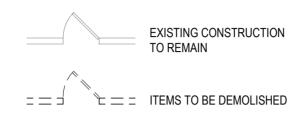

DN-41 OWNER TO COORDINATE REMOVAL OF REFRIGERATOR. DN-43 REMOVE/REPAIR DAMAGED WOOD CEILING BOARDS, VERIFY EXTENT IN FIELD; REVIEW CONDITION OF CEILING WITH A/E PRIOR TO REMOVAL. DN-45 REMOVE EXG SECURITY SCREEN TO ALLOW FOR FULLY OPERATIONAL WINDOW DN-46 REMOVE ALL FLOORING AND BUILD-UPS SO SUBFLOORING IS FLAT AND LEVEL EX-3 **BREAK ROOM** DN-46 EX-8 108 ACTIVITIES D3.1 2 ROOM 106 ─ DN-6 100 EX-9 DN-6 Ñ**⊸** DN-36 WEST 1 **(**D3.1) CORRIDOR DN-36 DN-4 STORAGE MEN'S OFFICE RESTROOM 111 RESTROOM_ 104 EX-6 - WOMEN' S RESTROOM DN-24 DN-1 DN-36 DN-30 DN-24 GYMNAŞIUM AREA NOT IN SCOPE

GENERAL DEMOLITION NOTES:

- 1. ALL EXG CONDITIONS AND DIMENSIONS TO BE VERIFIED IN FIELD PRIOR TO CONSTRUCTION.
- 2. ALL GLAZED BRICK LOCATIONS TO BE STRIPPED OF PAINT.
- 3. REFER TO MEPFP DOCUMENTS FOR ADDITIONAL DEMOLITION REQUIREMENTS. 4. REMOVE ALL EXG INTERIOR DOORS, FRAMES & HARDWARE, UNO.
- 5. REMOVE ALL OVERHEAD INTERIOR LIGHTING, UNO, REF ELEC DWGS, UNO. 6. REMOVE AND STORE ALL EXERCISE EQUIPMENT FOR REINSTALLATION, UNO.
- REMOVE EXG PLUMBING FIXTURES/EQUIPMENT, UNO.; SEE PLUMBING DWGS.
- REMOVE MECHANICAL EQUIPMENT, UNO.; SEE MECHANICAL DWGS, UNO. 9. REMOVE ELECTRICAL FIXTURES/EQUIPMENT, UNO.; SEE ELEC DWGS.
- 10. REMOVE ALL SECURITY SYSTEM EQUIPMENT & ASSOCIATED WIRING, SEE ELEC DWGS. 11. REMOVE ALL VEGETATION FROM BUILDING EXTERIOR SURFACES.

KEYED EXISTING NOTES

12. REMOVE ALL EXG CAST IRON DOWNSPOUT BOOTS.

- EX-3 EXG WINDOW AND SECURITY SCREEN TO REMAIN, TYP., UNO
- EX-6 EXG WINDOW WELL GRATE.
- EX-8 EXG WALL MURAL TO BE PRESERVED. EX-9 EXG WOODEN CASED OPENINGS TO REMAIN.

KEYED DEMOLITION NOTES

- DN-1 REMOVE EXG PLUMBING FIXTURES/EQUIPMENT, UNO.; SEE PLUMBING DWGS.
- DN-2 REMOVE TOILET PARTITIONS IN ENTIRETY.
- DN-3 REMOVE RESTROOM ACCESSORIES, PATCH AND REPAIR WALL SUBSTRATE AS NEEDED: PREPARE TO RECEIVE NEW INTERIOR FINISHES.
- DN-4 REMOVE INTERIOR WALL.COORDINATE EXTENT WITH NEW DOOR, PROVIDE TEMPORARY BRACING AS NECESSARY, SEE STRUCT DWGS.
- DN-5 REMOVE EXG KITCHEN SINK, COUNTERTOP AND CASEWORK.
- DN-6 REMOVE FINISH FLOOR AND WALL BASE IN ENTIRETY; PATCH AND REPAIR SUBFLOOR; PREPARE TO RECIEVE NEW INTERIOR FINISHES.
- DN-10 REMOVE COUNTERTOP & ASSOCIATED SUPPORTS.
- DN-11 REMOVE EXG CEILING LIGHT AT PORCH; PREPARE CEILING TO RECEIVE REPLACEMENT LIGHT
- DN-12 REMOVE EXG PORCH RAILINGS, TYP.
- DN-14 REMOVE PLYWOOD COVERING ON EXG MASONRY OPENING. PATCH, REPAIR, REPLACE GLAZED BRICK AT JAMB AND HEAD CONDITIONS AS NEEDED. REVIEW CONDITION OF BRICK ONCE EXPOSED WITH A/E PRIOR TO PATCHING, REPAIRING, OR REPLACING.
- DN-15 DEMOLISH CONCRETE STAIR AND MTL RAILING.
- DN-17 REMOVE EXG SECRUITY SCREEN AT BOTH SIDELITES. DN-21 REMOVE BREEZEWAY ROOF, COLUMNS, FOOTINGS AND ALL ASSOCIATED STRUCTURE.
- DN-24 REMOVE CONCRETE PAVING AND CURBS; SEE CIVIL DWGS.
- DN-27 REMOVE EXG WINDOW AC UNITS AND ASSOCIATED METAL FRAMING; PATCH AND REPAIR POINTS OF CONNECTION AT FACE OF EXTERIOR FINISH.
- DN-28 REMOVE EXT WALL INFILL, PROVIDE TEMPORARY BRACING AS NECESSARY, SEE STRUCT DN-30 REMOVE EXG DOOR HARDWARE ONLY; PREPARE EXISTING DOOR AND FRAME TO RECEIVE
- NEW HARDWARE.
- DN-31 REMOVE EXG EXTERIOR WOOD DOOR AND HARDWARE ONLY, PREPARE EXISTING FRAME TO RECEIVE NEW DOOR AND HARDWARE.
- DN-32 REMOVE EXG EXTERIOR GYMNASIUM DOOR, FRAME AND HARDWARE.
- DN-33 REMOVE EXG WINDOW / LOUVER.
- DN-34 REMOVE EXG EXHAUST VENT.
- DN-36 REMOVE DETERIORATED PORTION OF EXG MTL CEILING AS INDICATED ON DWGS, VERIFY
- EXTENT IN FIELD; REVIEW CONDITION OF CEILING WITH A/E PRIOR TO REMOVAL.
- DN-37 SCRAPE/REMOVE DEBRIS FROM EXG PLASTER WALL & PREP SURFACE FOR REFINISHING

- DN-47 REMOVE BOXING RING AND ALL ASSOCIATED ACCESSORIES INCLUDING PLATFORM AND



PROJECT COORDINATOR

REVISIONS

CONSTRUCTION DOCUMENTS

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REVISIONS

DATE

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CITY OF PHILADELPHIA DEPARTMENT OF PARKS & RECREATION

1515 ARCH STREET

11TH FLOOR, ONE PARKWAY BUILDING

PROJECT TITLE RENOVATIONS TO THE HAPPY **HOLLOW RECREATION CENTER**

CHECKED BY

FIRST FLOOR DEMOLITION PLAN

16315E-03-02

JS/SCR

05/13/2025 AS NOTED

ALL DIMENSIONS AND CONDITIONS SHALL BE VERIFIED BY THE CONTACTOR AT THE SITE BEFORE PROCEEDING WITH THE WORK

FIRST FLOOR DEMOLITION PLAN D2.1 1/8" = 1'-0"


LEGEND:		
	AREA NOT IN SCOPE	

GENERAL DEMOLITION NOTES:

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- 3. REFER TO MEPFP DOCUMENTS FOR ADDITIONAL DEMOLITION REQUIREMENTS.
- REMOVE ALL EXG INTERIOR DOORS, FRAMES & HARDWARE, UNO.
 REMOVE ALL OVERHEAD INTERIOR LIGHTING, UNO, REF ELEC DWGS, UNO.
- REMOVE AND STORE ALL EXERCISE EQUIPMENT FOR REINSTALLATION, UNO.
 REMOVE EXG PLUMBING FIXTURES/EQUIPMENT, UNO.; SEE PLUMBING DWGS.
 REMOVE MECHANICAL EQUIPMENT, UNO.; SEE MECHANICAL DWGS, UNO.
- 9. REMOVE ELECTRICAL FIXTURES/EQUIPMENT, UNO.; SEE ELEC DWGS.
 10. REMOVE ALL SECURITY SYSTEM EQUIPMENT & ASSOCIATED WIRING, SEE ELEC DWGS.
- 11. REMOVE ALL VEGETATION FROM BUILDING EXTERIOR SURFACES.12. REMOVE ALL EXG CAST IRON DOWNSPOUT BOOTS.

KEYED DEMOLITION NOTES

- DN-21 REMOVE BREEZEWAY ROOF, COLUMNS, FOOTINGS AND ALL ASSOCIATED STRUCTURE.
- DN-22 REMOVE EXG STANDING SEAM MTL ROOF DOWN TO SHEATHING, TYP.
- DN-23 PATCH, REPAIR, AND REPLACE EXISTING ROOF SHEATHING AS NEEDED; REVIEW CONDITION OF SHEATHING ONCE EXPOSED WITH A/E PRIOR TO PATCHING, REPAIRING, OR REPLACING. PREPARE SHEATHING TO RECEIVE NEW UNDERLAYMENT, AVB, AND ROOFING PER MANUFACTURER REQUIREMENTS.
- DN-25 REMOVE ALL VEGETATION FROM CHIMNEYS, TYP.
- DN-42 REMOVE EXG ROOF PENETRATIONS AND ASSOCIATED FLASHING, TYP.

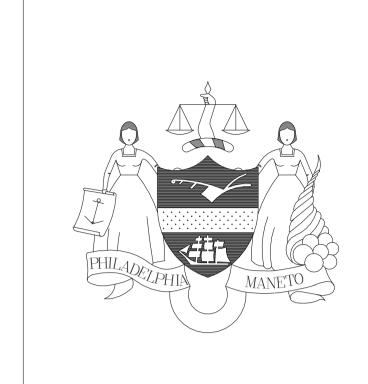

REVISIONS

REVISIONS


DATE

ISSUE

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CITY OF PHILADELPHIA DEPARTMENT OF PARKS & RECREATION

1515 ARCH STREET 11TH FLOOR, ONE PARKWAY BUILDING

11TH FLOOR, ONE PARKWAY BUILDING

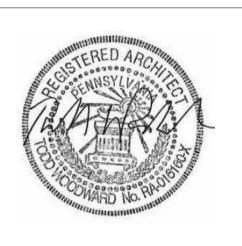ADELPHIA PENNSYL

RENOVATIONS TO THE HAPPY HOLLOW RECREATION CENTER

DRAWING TITLE

CHECKED BY

ROOF DEMOLITION PLAN

16315E-03-02

05/13/2025

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JS/SCR

NOTE:

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GENERAL DEMOLITION NOTES:


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- 5. REMOVE ALL OVERHEAD INTERIOR LIGHTING, UNO, REF ELEC DWGS, UNO. 6. REMOVE AND STORE ALL EXERCISE EQUIPMENT FOR REINSTALLATION, UNO.
- REMOVE EXG PLUMBING FIXTURES/EQUIPMENT, UNO.; SEE PLUMBING DWGS. 8. REMOVE MECHANICAL EQUIPMENT, UNO.; SEE MECHANICAL DWGS, UNO.
- 9. REMOVE ELECTRICAL FIXTURES/EQUIPMENT, UNO.; SEE ELEC DWGS. 10. REMOVE ALL SECURITY SYSTEM EQUIPMENT & ASSOCIATED WIRING, SEE ELEC DWGS.
- 11. REMOVE ALL VEGETATION FROM BUILDING EXTERIOR SURFACES. 12. REMOVE ALL EXG CAST IRON DOWNSPOUT BOOTS.

KEYED EXISTING NOTES


- EX-1 EXG WD CORNICE TO REMAIN, TYP, EXCEPT AT LOCATIONS NOTED FOR
- REPLACEMENT.
- EX-3 EXG WINDOW AND SECURITY SCREEN TO REMAIN, TYP., UNO EX-4 EXG DOWNSPOUTS TO REMAIN, TYP FOR ALL.
- EX-12 EXG DOOR FRAME & SIDELITES TO REMAIN.

KEYED DEMOLITION NOTES


- DN-9 REMOVE EXG CAST IRON DOWNSPOUT BOOT, TYP FOR ALL.
- DN-11 REMOVE EXG CEILING LIGHT AT PORCH; PREPARE CEILING TO RECEIVE REPLACEMENT LIGHT
- DN-12 REMOVE EXG PORCH RAILINGS, TYP.
- DN-16 REMOVE TIE-STYLE SIGNAGE, TYP.
- DN-17 REMOVE EXG SECRUITY SCREEN AT BOTH SIDELITES.
- DN-18 REMOVE ALL EXG WALL MOUNTED SIGNAGE NEAR ENTRY DOOR AND RETURN TO OWNER. DN-21 REMOVE BREEZEWAY ROOF, COLUMNS, FOOTINGS AND ALL ASSOCIATED STRUCTURE.
- DN-22 REMOVE EXG STANDING SEAM MTL ROOF DOWN TO SHEATHING, TYP.
- DN-23 PATCH, REPAIR, AND REPLACE EXISTING ROOF SHEATHING AS NEEDED; REVIEW CONDITION OF SHEATHING ONCE EXPOSED WITH A/E PRIOR TO PATCHING, REPAIRING, OR REPLACING. PREPARE SHEATHING TO RECEIVE NEW UNDERLAYMENT, AVB, AND ROOFING PER MANUFACTURER REQUIREMENTS.
- DN-25 REMOVE ALL VEGETATION FROM CHIMNEYS, TYP.
- DN-26 REMOVE KEYSTONE PANEL AND STORE FOR REINSTALLATION.
- DN-27 REMOVE EXG WINDOW AC UNITS AND ASSOCIATED METAL FRAMING; PATCH AND REPAIR POINTS OF CONNECTION AT FACE OF EXTERIOR FINISH.
- DN-28 REMOVE EXT WALL INFILL, PROVIDE TEMPORARY BRACING AS NECESSARY, SEE STRUCT DWGS. DN-30 REMOVE EXG DOOR HARDWARE ONLY; PREPARE EXISTING DOOR AND FRAME TO RECEIVE NEW
- DN-31 REMOVE EXG EXTERIOR WOOD DOOR AND HARDWARE ONLY, PREPARE EXISTING FRAME TO RECEIVE
- NEW DOOR AND HARDWARE. DN-34 REMOVE EXG EXHAUST VENT.

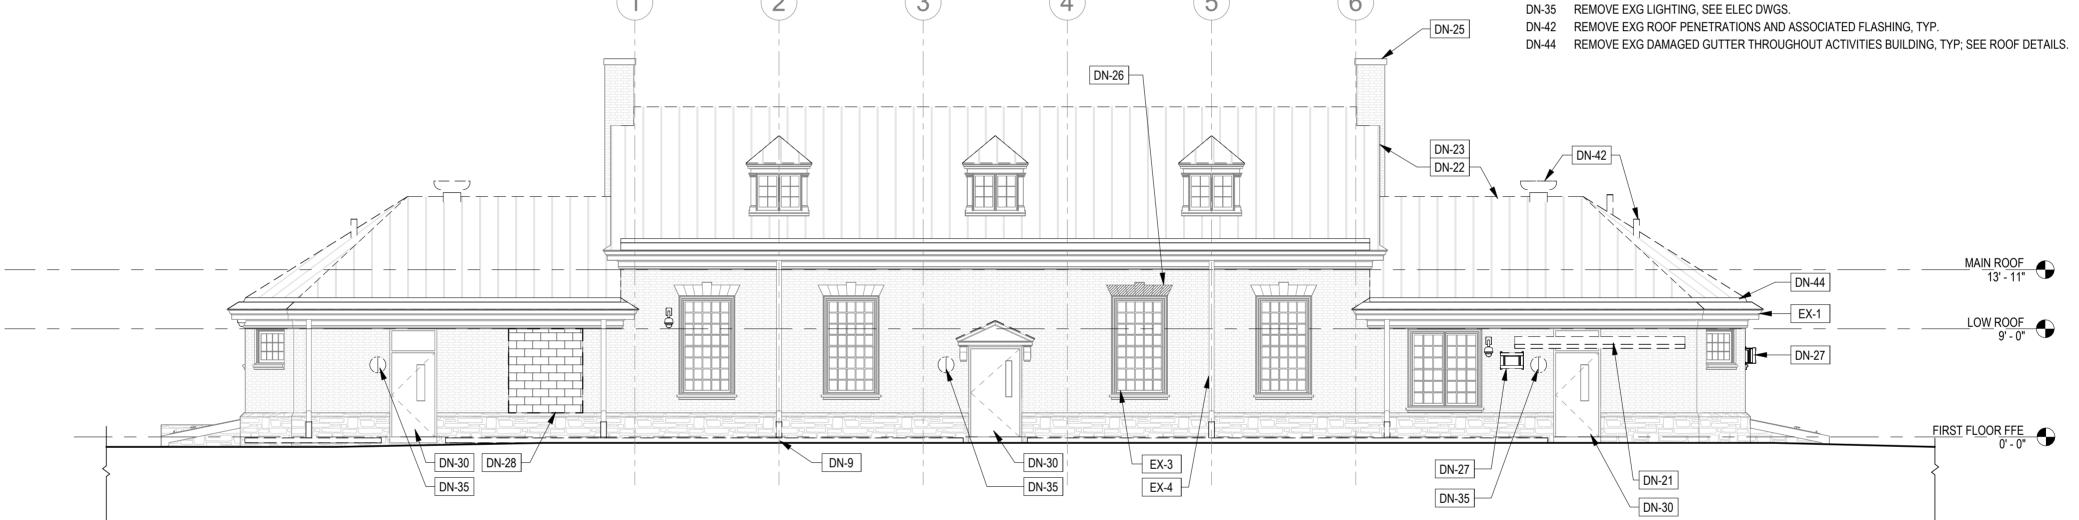

2 DEMOLITION - SOUTH ELEVATION

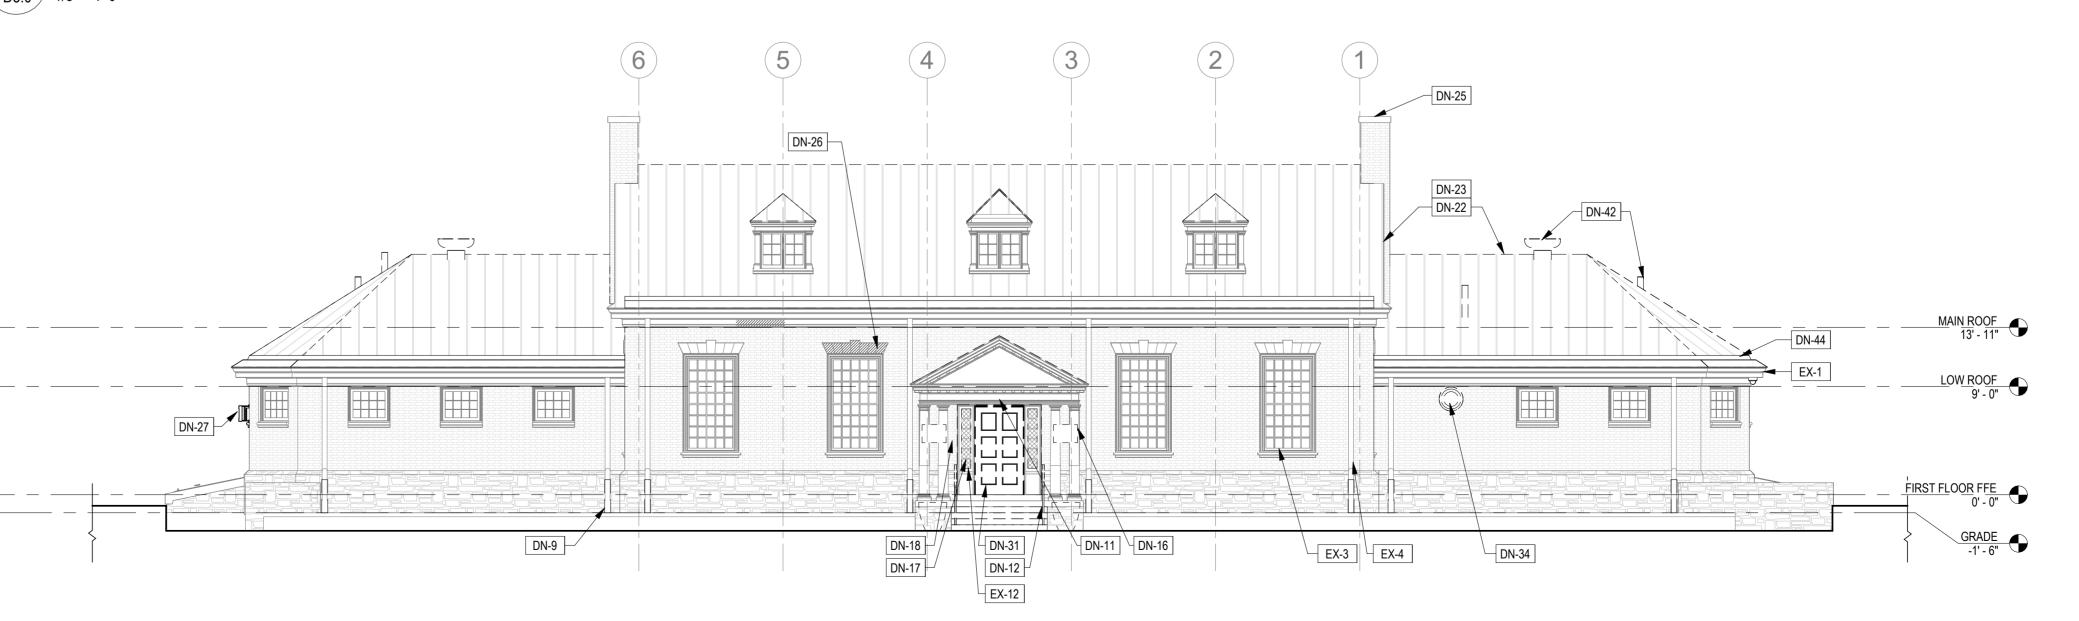

DEMOLITION - NORTH ELEVATION

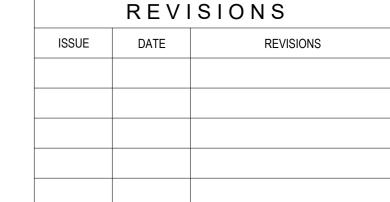



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PROJECT TITLE RENOVATIONS TO THE HAPPY **HOLLOW RECREATION CENTER**

DEMOLITION ELEVATIONS

16315E-03-02

CHECKED BY

05/13/2025 AS NOTED Author

Checker

D3.0



GENERAL DEMOLITION NOTES:

- 1. ALL EXG CONDITIONS AND DIMENSIONS TO BE VERIFIED IN FIELD PRIOR TO
- 2. ALL GLAZED BRICK LOCATIONS TO BE STRIPPED OF PAINT.
- . REFER TO MEPFP DOCUMENTS FOR ADDITIONAL DEMOLITION REQUIREMENTS.
- 4. REMOVE ALL EXG INTERIOR DOORS, FRAMES & HARDWARE, UNO. REMOVE ALL OVERHEAD INTERIOR LIGHTING, UNO, REF ELEC DWGS, UNO.
- REMOVE AND STORE ALL EXERCISE EQUIPMENT FOR REINSTALLATION, UNO. REMOVE EXG PLUMBING FIXTURES/EQUIPMENT, UNO.; SEE PLUMBING DWGS.
- . REMOVE MECHANICAL EQUIPMENT, UNO.; SEE MECHANICAL DWGS, UNO. 9. REMOVE ELECTRICAL FIXTURES/EQUIPMENT, UNO.; SEE ELEC DWGS. 10. REMOVE ALL SECURITY SYSTEM EQUIPMENT & ASSOCIATED WIRING, SEE ELEC DWGS.
- 11. REMOVE ALL VEGETATION FROM BUILDING EXTERIOR SURFACES. 12. REMOVE ALL EXG CAST IRON DOWNSPOUT BOOTS.
- KEYED EXISTING NOTES

REPLACEMENT.

- EX-1 EXG WD CORNICE TO REMAIN, TYP, EXCEPT AT LOCATIONS NOTED FOR
- EX-3 EXG WINDOW AND SECURITY SCREEN TO REMAIN, TYP., UNO EX-4 EXG DOWNSPOUTS TO REMAIN, TYP FOR ALL.

KEYED DEMOLITION NOTES

- DN-9 REMOVE EXG CAST IRON DOWNSPOUT BOOT, TYP FOR ALL.
- DN-11 REMOVE EXG CEILING LIGHT AT PORCH; PREPARE CEILING TO RECEIVE REPLACEMENT LIGHT
- DN-12 REMOVE EXG PORCH RAILINGS, TYP.
- DN-15 DEMOLISH CONCRETE STAIR AND MTL RAILING.
- DN-21 REMOVE BREEZEWAY ROOF, COLUMNS, FOOTINGS AND ALL ASSOCIATED STRUCTURE. DN-22 REMOVE EXG STANDING SEAM MTL ROOF DOWN TO SHEATHING, TYP.
- DN-23 PATCH, REPAIR, AND REPLACE EXISTING ROOF SHEATHING AS NEEDED; REVIEW CONDITION OF SHEATHING ONCE EXPOSED WITH A/E PRIOR TO PATCHING, REPAIRING, OR REPLACING. PREPARE SHEATHING TO RECEIVE NEW UNDERLAYMENT, AVB, AND ROOFING PER MANUFACTURER REQUIREMENTS.
- DN-25 REMOVE ALL VEGETATION FROM CHIMNEYS, TYP.
- DN-27 REMOVE EXG WINDOW AC UNITS AND ASSOCIATED METAL FRAMING; PATCH AND REPAIR POINTS OF CONNECTION AT FACE OF EXTERIOR FINISH.
- DN-32 REMOVE EXG EXTERIOR GYMNASIUM DOOR, FRAME AND HARDWARE.
- DN-33 REMOVE EXG WINDOW / LOUVER.


EX-4

MAIN ROOF 13' - 11"


LOW ROOF 9' - 0"

FIRST FLOOR FFE 0' - 0"

DN-42 REMOVE EXG ROOF PENETRATIONS AND ASSOCIATED FLASHING, TYP.

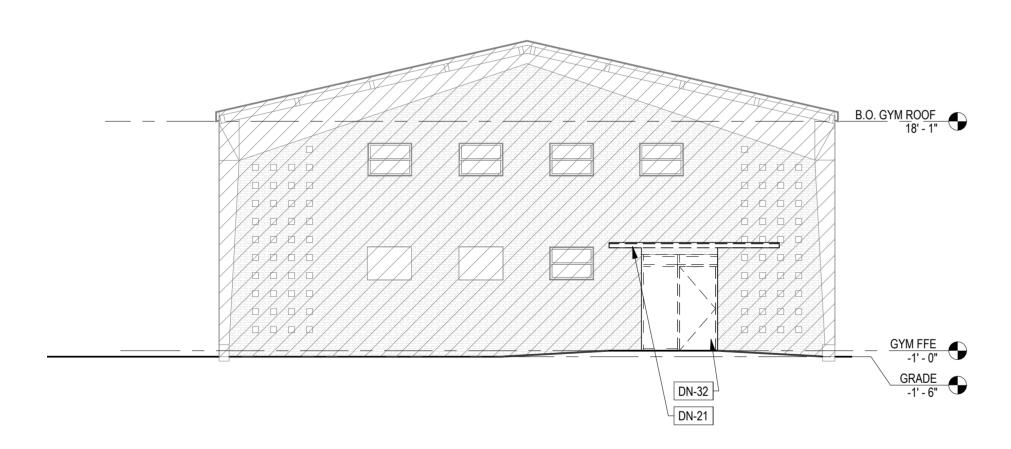


4 DEMOLITION - GYMNASIUM ELEVATION D3.1 1/8" = 1'-0"

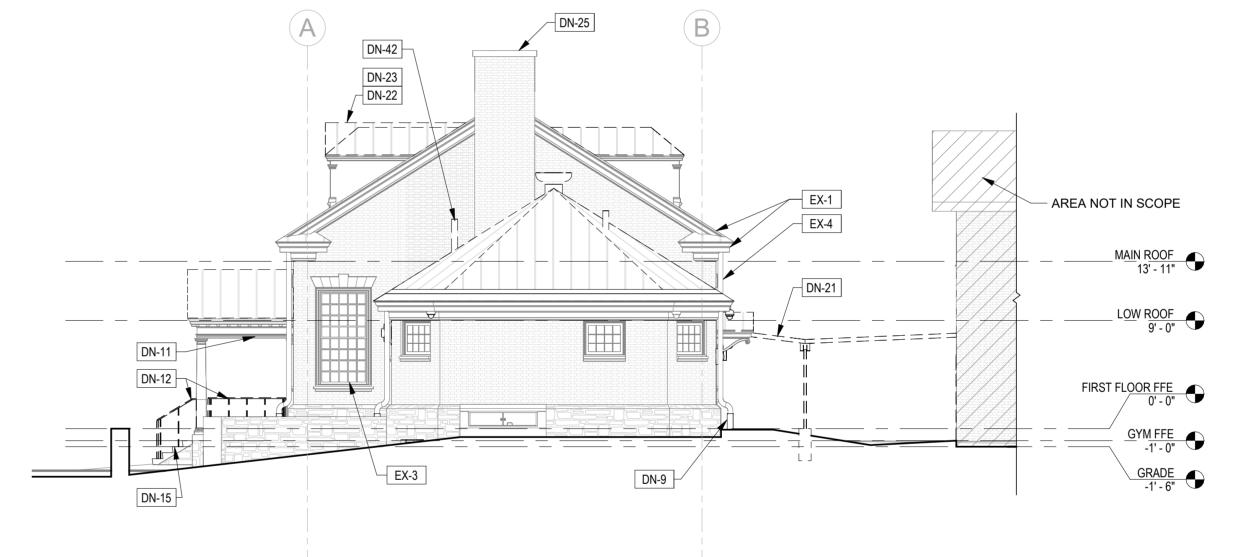

EX-3 -/-


² DEMOLITION - WEST ELEVATION

D3.1 / 1/8" = 1'-0"

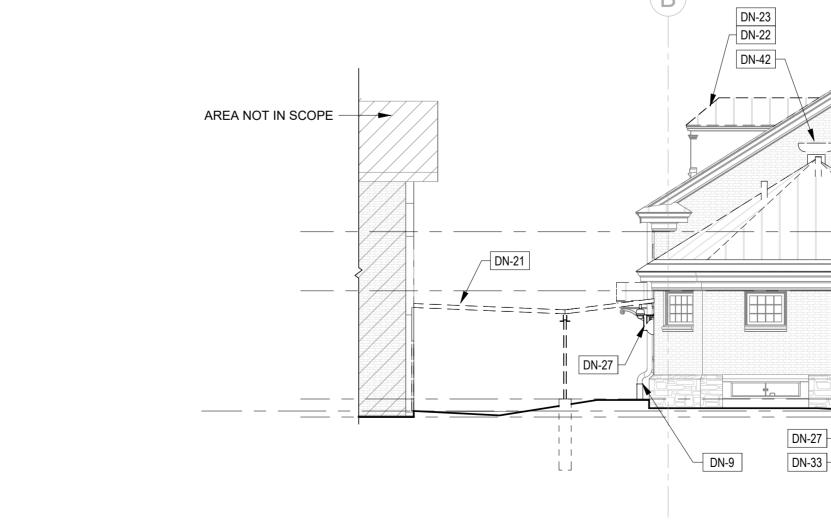


1 DEMOLITION - EAST ELEVATION

D3.1 1/8" = 1'-0"

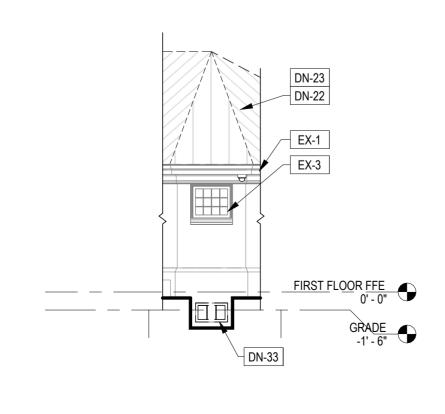

DEMOLITION - BELOW GRADE ELEVATION AT CHAMFER D3.1 1/8" = 1'-0"

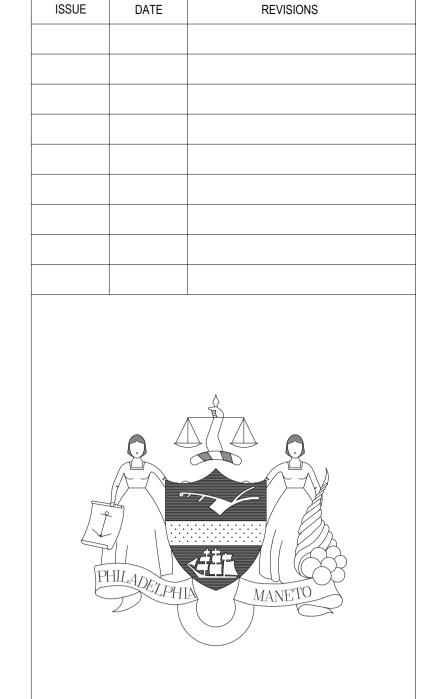

REVISIONS

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CITY OF PHILADELPHIA DEPARTMENT OF PARKS & RECREATION


1515 ARCH STREET

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RENOVATIONS TO THE HAPPY HOLLOW RECREATION CENTER

DEMOLITION ELEVATIONS

16315E-03-02 05/13/2025 AS NOTED JS/SCR

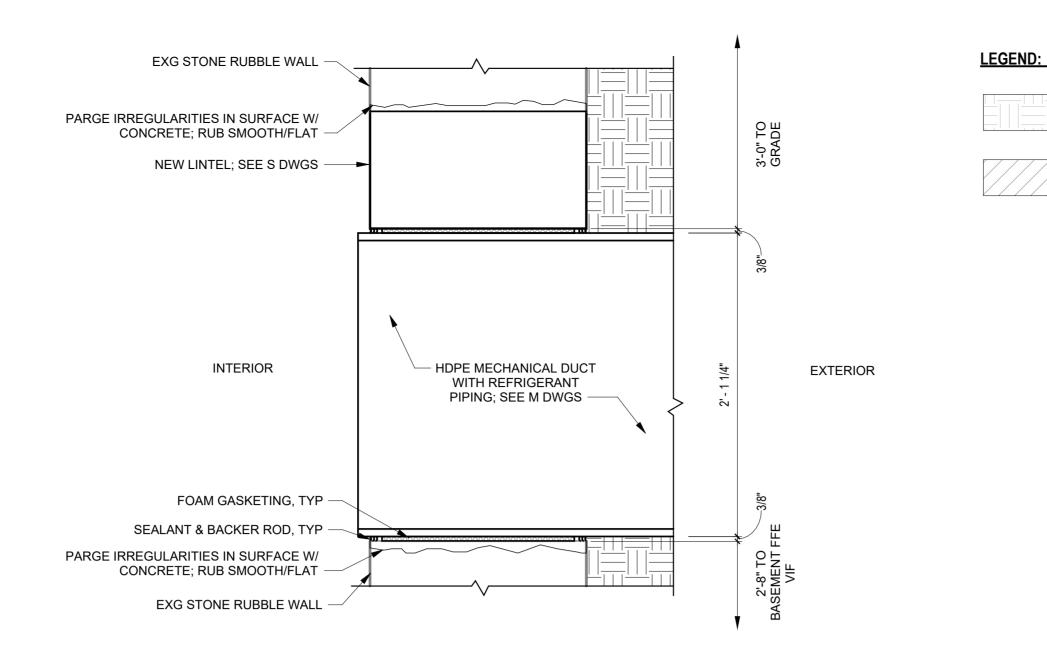

MECH DUCT PENETRATION DETAIL

A2.0 / 1 1/2" = 1'-0"

GENERAL NOTES:

UNEXCAVATED


AREA NOT IN SCOPE

- 1. FILL VOIDS AROUND PENETRATIONS AND JOINTS THROUGH NON-RATED PARTITIONS WITH MINERAL WOOL INSULATION AND SEAL AROUND THE OPENING WITH ACOUSTIC SEALANT.
- WHEN ARCHITECTURAL EQUIPMENT OR FINISHES INTERFERE WITH THE LOCATION OF RECEPTACLES, SWITCHES, CONTROLS, ETC. COORDINATE WITH A/E PRIOR TO CUTTING OR INSTALLATION OF THE EQUIPMENT OR FINISH.
- 3. LOCATE INTERIOR AND EXTERIOR CONTROL JOINTS AS INDICATED ON THE ARCHITECTURAL DRAWINGS AND IN SPECIFICATIONS. COORDINATE FINAL LOCATIONS WITH ARCHITECT.
- 4. PROVIDE CEMENTITIOUS FLOOR UNDERLAYMENT ON EXISTING CONCRETE SLAB WHERE REQUIRED UNDER NEW FINISHES.
- ALL EXG AND NEW METAL CEILINGS TO BE REPAINTED; PREPARE EXG AND NEW SURFACES AS NECESSARY TO PROVIDE SMOOTH/CONSISTENT FINISH.
- ALL EXG INT GLAZED BRICK AND MORTAR TO BE CLEANED AND FREE OF PAINT.
 ALL INTERIOR GWB/PLASTER SURFACES TO BE REPAINTED; PREPARE EXG AND NEW SURFACES AS NECESSARY TO PROVIDE SMOOTH/CONSISTENT FINISH . EXG MURALS IN ACTIVITIES ROOM 106 TO BE PRESERVED AND EXCLUDED FROM
- REPAINTING.
 8. ALL EXG INTERIOR CMU TO BE REPAINTED. PREPARE EXG AND NEW SURFACES AS NECESSARY TO PROVIDE
- SMOOTH/CONSISTENT FINISH.
- 9. REPLACE ALL INTERIOR DOORS, FRAMES, AND HARDWARE WITH NEW HM DOORS, METAL FRAMES, AND HARDWARE U.N.O.; SEE DOOR SCHEDULE.
- 10. REFER TO MEPFP DRAWINGS FOR ADDITIONAL INFO.
- 11. REFER TO STRUC DRAWINGS FOR LOCATIONS OF NEW AND EXISTING STRUCTURE.
- REFER TO LANDSCAPE DRAWINGS FOR PLAYGROUND FURNISHINGS/EQUIPMENT.
 PATCH AND REPAIR HOLES LEFT FROM REMOVAL OF EXERCISE EXQUIPMENT. REPAINT SURFACES, TYP.
- 14. ALL DOWNSPOUTS ETR; PROVIDE NEW CAST IRON BOOTS, TYP FOR EACH EXG DOWNSPOUT.

KEYED CONSTRUCTION NOTES

- CN-1 PROVIDE NEW PLUMBING EQUIPMENT & ACCESSORIES; SEE PLUMBING DWGS.
- CN-5 PROVIDE NEW MECH EQUIPMENT, TYP, SEE MECH DWGS.
- CN-21 PROVIDE NEW WINDOW TO MATCH EXG, SEE WINDOW TYPES AND DETAILS.
 CN-27 PROVIDE NEW BREEZEWAY COLUMNS AND FOOTINGS; SEE S DWGS.
- CN-45 PROVIDE NEW PENETRATION IN FOUNDATION WALL FOR NEW HVAC REFRIGERANT LINE, REF MECH DWGS.
- CN-59 PROVIDE NEW UNDERGROUND REFRIGERANT PIPING IN HDPE CONDUIT, SEE MECH DWGS.
- CN-61 NEW EQUIPMENT PAD, SEE STRUCT DWGS.

 CN-82 NEW DOMESTIC WATER UTILITY CONNECTION THROUGH EXISTING FOUNDATION WALL, SEE CIVIL AND PLUMBING DWGS;
 COORDINATE WITH MEP EQUIPMENT AND CONSULT ARCHITECT TO DETERMINE LOCATION

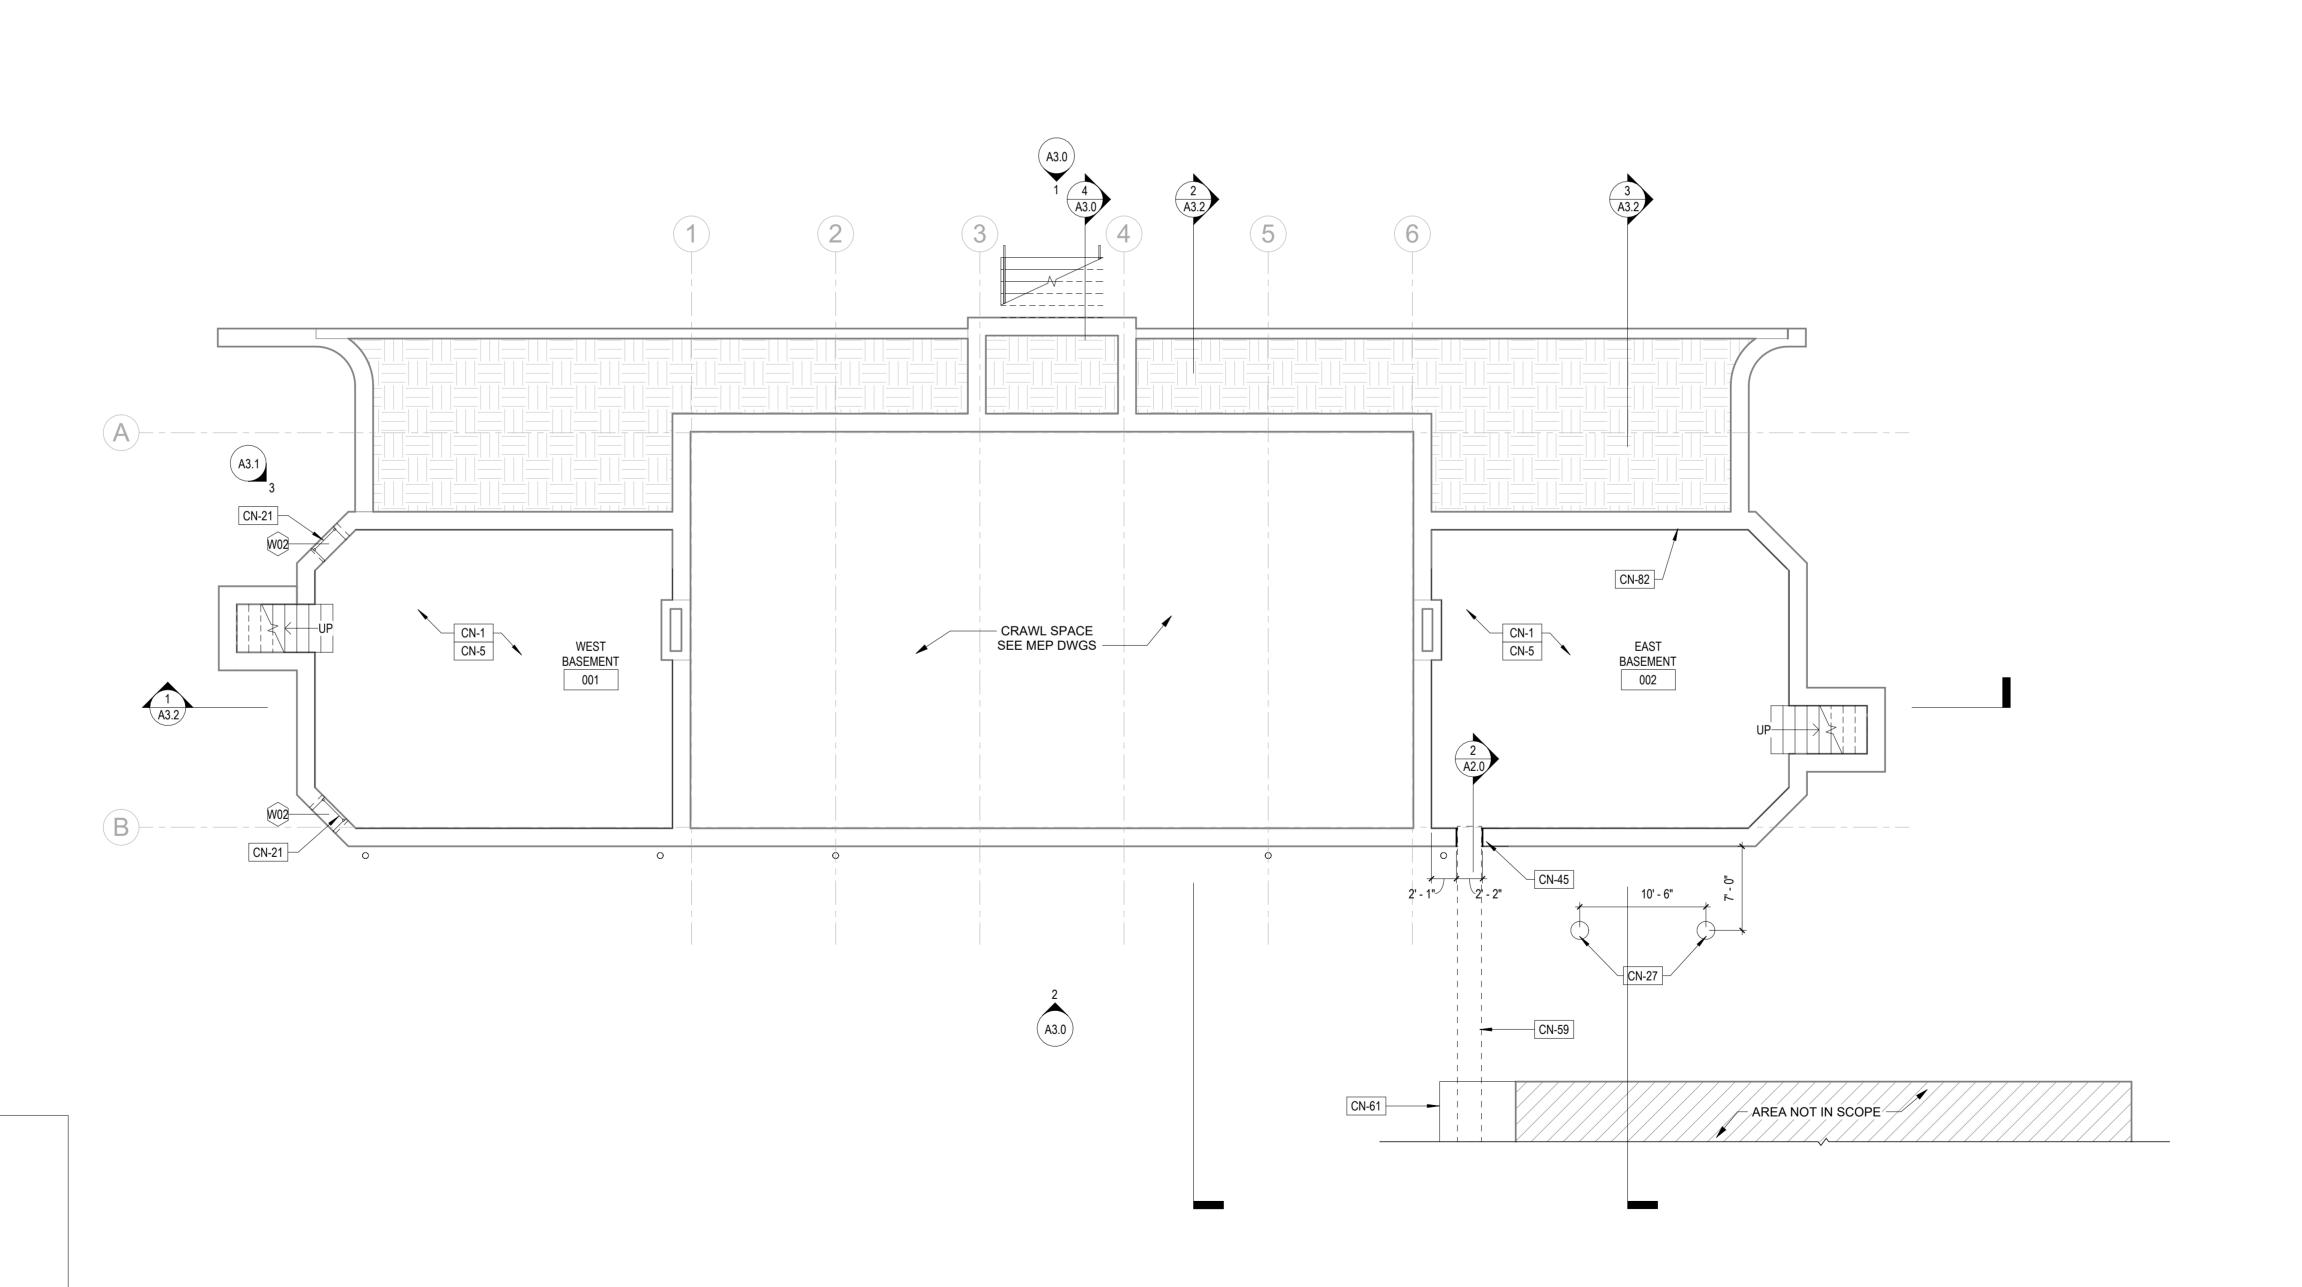

_ {

ISSUE DATE REVISIONS



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PROJECT COORDINATOR

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1515 ARCH STREET

11TH FLOOR, ONE PARKWAY BUILDING
ADELPHIA PENN

ROJECT TITLE

RENOVATIONS TO THE HAPPY HOLLOW RECREATION CENTER

DRAWING TITLE

BASEMENT PLAN

16315E-03-02

DATE 05/13/2025 SCALE

DRAWN BY

CHECKED BY

AS NOTED

JS/SCR

NOTE: ALL DIMENSIONS AND CONDITIONS SHALL BE VERIFIED BY THE CONTACTOR AT THE SITE BEFORE PROCEEDING WITH THE WORK

1 BASEMENT PLAN
A2.0 1/8" = 1'-0"

INTERIOR PARTITION TYPES						
TYPE	DESCRIPTION	HEIGHT	FIRE RATING UL NO.	STC RATING	DETAIL	SPECIFICATION
⟨P1⟩	4" CMU PARTITION	B.O. EXG CEILING JOISTS (+/- 10'-0" VIF)	-	-	35.8	NOM 4" CMU WITH 3/8" MORTAR.
⟨ P 2⟩	9" BRICK WALL	B.O. EXG CEILING JOISTS (+/- 10'-0" VIF)	-	-	50	2 WYTHE BRICK WALL WITH GLAZED FACING; MATCH EXG CONDITIONS.
⟨ P 3⟩	4 1/2" MTL STUD FURRING WITH GLAZED BRICK	B.O. EXG CEILING JOISTS (+/- 10'-0" VIF)	-	-		5/8" GWB, 3 5/8" MTL STUDS @ 16 O.C., 5/8 CONCRETE BACKERBOARD, 3 5/8" GLAZED BRICK ANCHORED WITH TIES TO MTL STUDS

1. PROVIDE CONTINUOUS NON-HARDENING SEALANT AROUND PERIMETER OF INTERIOR WALL BETWEEN ADJACENT WALLS, CEILINGS, AND STRUC.

EXTERIOR WALL TYPES					
TYPE	DESCRIPTION	CODE REQ'D INSUL MIN. R- VALUE	DETAIL	SPECIFICATION	
EW01	13" MASONRY INFILL	NO EXG WALL INSULATION, PER IECC 810.1 NO ADDITIONAL INSULATION IS REQD. FOR REPAIR ESTIMATED R-VALUE R3.4 (Open)/R7.1 (Closed)	= -	NOM 4" BRICK VENEER W FLEMISH BOND; ALIGN FINISH FACES WITH EXG CONSTRUCTION & ALIGN BRICK PATTERN WITH EXG, MASONRY TIES TO CMU BLOCK, MIN 3/4" AIR SPACE, 1" SPRAY FOAM INSUL, NOM 8" CMU WITH 3/8" MORTAR JOINTS.	

1. REFER TO STRUC DWGS FOR MASONRY / REINFORCEMENT REQUIREMENTS AND DETAILS.

2. ALL EXTERIOR MASONRY WALLS TO HAVE THERMALLY BROKEN TIES / ANCHORS.

KEYED EXISTING NOTES

- EX-3 EXG WINDOW AND SECURITY SCREEN TO REMAIN, TYP., UNO
- EX-4 EXG DOWNSPOUTS TO REMAIN, TYP FOR ALL.
- EX-5 EXG FINISH FLOOR TO REMAIN. EX-6 EXG WINDOW WELL GRATE.
- EX-9 EXG WOODEN CASED OPENINGS TO REMAIN.

PLAN KEY: LEGEND:



AREA OF PATCH & REPAIR AT EXG MTL CEILING, VIF



KEYED CONSTRUCTION NOTES

- CN-5 PROVIDE NEW MECH EQUIPMENT, TYP, SEE MECH DWGS.
- CN-6 PROVIDE NEW RESILIENT FLOOR & BASE, REFER TO FINISH PLAN FOR MORE INFORMATION.
- CN-7 PROVIDE NEW ACCESSIBLE DRINKING FOUNTAIN AND BOTTLE FILLING STATION.
- CN-11 PROVIDE NEW CONCRETE LANDING; REFER TO CIVIL DRAWINGS. CN-36 PROVIDE NEW STAINLESS STEEL SINK, BASE CABINETS AND WALL CABINETS.
- CN-37 PROVIDE NEW CONCRETE PAVING, SEE CIVIL & LANDSCAPE DWGS.
- CN-39 PROVIDE NEW ELEC EQUIPMENT/SYSTEMS; SEE ELEC DWGS.
- CN-40 PROVIDE NEW CONSOLE AND WALL CLOSET. CN-44 PROVIDE NEW PERFORATED ALUMINUM FENCING, ANCHORED TO PAD BELOW; COORD WITH STRUCTURE BELOW
- CN-46 REPAIR EXG WINDOW TO ALLOW FOR NORMAL OPERATION.
- CN-48 PROVIDE NEW WD BASE AT WD PILASTER, TYP FOR ALL, MATCH EXG.
- CN-50 REPOINT BRICK FLOORING.
- CN-53 PROVIDE NEW WOOD COUNTERTOP AND SUPPORTING BRACKETS AT 30" O.C.

CN-59 PROVIDE NEW UNDERGROUND REFRIGERANT PIPING IN HDPE CONDUIT, SEE MECH DWGS.

GENERAL NOTES:

- 1. FILL VOIDS AROUND PENETRATIONS AND JOINTS THROUGH NON-RATED PARTITIONS WITH MINERAL WOOL INSULATION
- AND SEAL AROUND THE OPENING WITH ACOUSTIC SEALANT. 2. WHEN ARCHITECTURAL EQUIPMENT OR FINISHES INTERFERE WITH THE LOCATION OF RECEPTACLES, SWITCHES,
- CONTROLS, ETC. COORDINATE WITH A/E PRIOR TO CUTTING OR INSTALLATION OF THE EQUIPMENT OR FINISH. 3. LOCATE INTERIOR AND EXTERIOR CONTROL JOINTS AS INDICATED ON THE ARCHITECTURAL DRAWINGS AND IN
- SPECIFICATIONS. COORDINATE FINAL LOCATIONS WITH ARCHITECT. 4. PROVIDE CEMENTITIOUS FLOOR UNDERLAYMENT ON EXISTING CONCRETE SLAB WHERE REQUIRED UNDER NEW
- 5. ALL EXG AND NEW METAL CEILINGS TO BE REPAINTED; PREPARE EXG AND NEW SURFACES AS NECESSARY TO PROVIDE
- SMOOTH/CONSISTENT FINISH. 6. ALL EXG INT GLAZED BRICK AND MORTAR TO BE CLEANED AND FREE OF PAINT. 7. ALL INTERIOR GWB/PLASTER SURFACES TO BE REPAINTED; PREPARE EXG AND NEW SURFACES AS NECESSARY TO
- PROVIDE SMOOTH/CONSISTENT FINISH. EXG MURALS IN ACTIVITIES ROOM 106 TO BE PRESERVED AND EXCLUDED FROM
- 8. ALL EXG INTERIOR CMU TO BE REPAINTED. PREPARE EXG AND NEW SURFACES AS NECESSARY TO PROVIDE SMOOTH/CONSISTENT FINISH.
- 9. REPLACE ALL INTERIOR DOORS, FRAMES, AND HARDWARE WITH NEW HM DOORS, METAL FRAMES, AND HARDWARE
- U.N.O.: SEE DOOR SCHEDULE.
- 10. REFER TO MEPFP DRAWINGS FOR ADDITIONAL INFO. 11. REFER TO STRUC DRAWINGS FOR LOCATIONS OF NEW AND EXISTING STRUCTURE.
- 12. REFER TO LANDSCAPE DRAWINGS FOR PLAYGROUND FURNISHINGS/EQUIPMENT. 13. PATCH AND REPAIR HOLES LEFT FROM REMOVAL OF EXERCISE EXQUIPMENT. REPAINT SURFACES, TYP.

14. ALL DOWNSPOUTS ETR; PROVIDE NEW CAST IRON BOOTS, TYP FOR EACH EXG DOWNSPOUT.

KEYED CONSTRUCTION NOTES

- CN-60 NEW REFRIGERATOR BY OTHERS.
- CN-61 NEW EQUIPMENT PAD, SEE STRUCT DWGS.
- CN-62 PROVIDE NEW ANCHOR INFILL MASONRY WITH HOHMAN & BARNARD SLIP-SET STABLIZER ANCHORS @ 32" VERTICAL SPACING, SEE STRUCT DWGS.
- CN-66 PROVIDE 2- C8 X 11.5 LINTELS, SEE STRUCT DWGS.
- CN-67 PROVIDE NEW FOUNDATION AND COLUMNS, SEE STRUCT DWGS.
- CN-69 PROVIDE NEW REFRIGERATOR.
- CN-70 PROVIDE NEW CAST IN PLACE STAIR. CN-71 PROVIDE NEW 36" HANDRAILS, TYP AT EITHER SIDE OF ENTRANCE STAIRS AND PORCH.
- CN-75 NEW BUILDING MTD SIGN BID.1, REF PPR SIGNAGE STANDARD MANUAL. CN-77 NEW GLAZED BRICK TO MATCH EXG. REFER TO PARTITION TYPES; RETURN NEW GLAZED BRICK AT SIDES AND PROVIDE
- RADIUS EDGE AT OUTSIDE CORNER.
- CN-79 PROVIDE NEW BOXING RING, ACCESSORIES, AND WOODEN PLATFORM
- CN-81 NEW ENTRANCE MAT



REVISIONS

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DATE

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CONSTRUCTION DOCUMENTS

PROJECT COORDINATOR

LEEANN SUEN



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CITY OF PHILADELPHIA

DEPARTMENT OF PARKS & RECREATION 1515 ARCH STREET

11TH FLOOR, ONE PARKWAY BUILDING

RENOVATIONS TO THE HAPPY **HOLLOW RECREATION CENTER**

FLOOR PLAN, EXTERIOR & INTERIOR WALL TYPES


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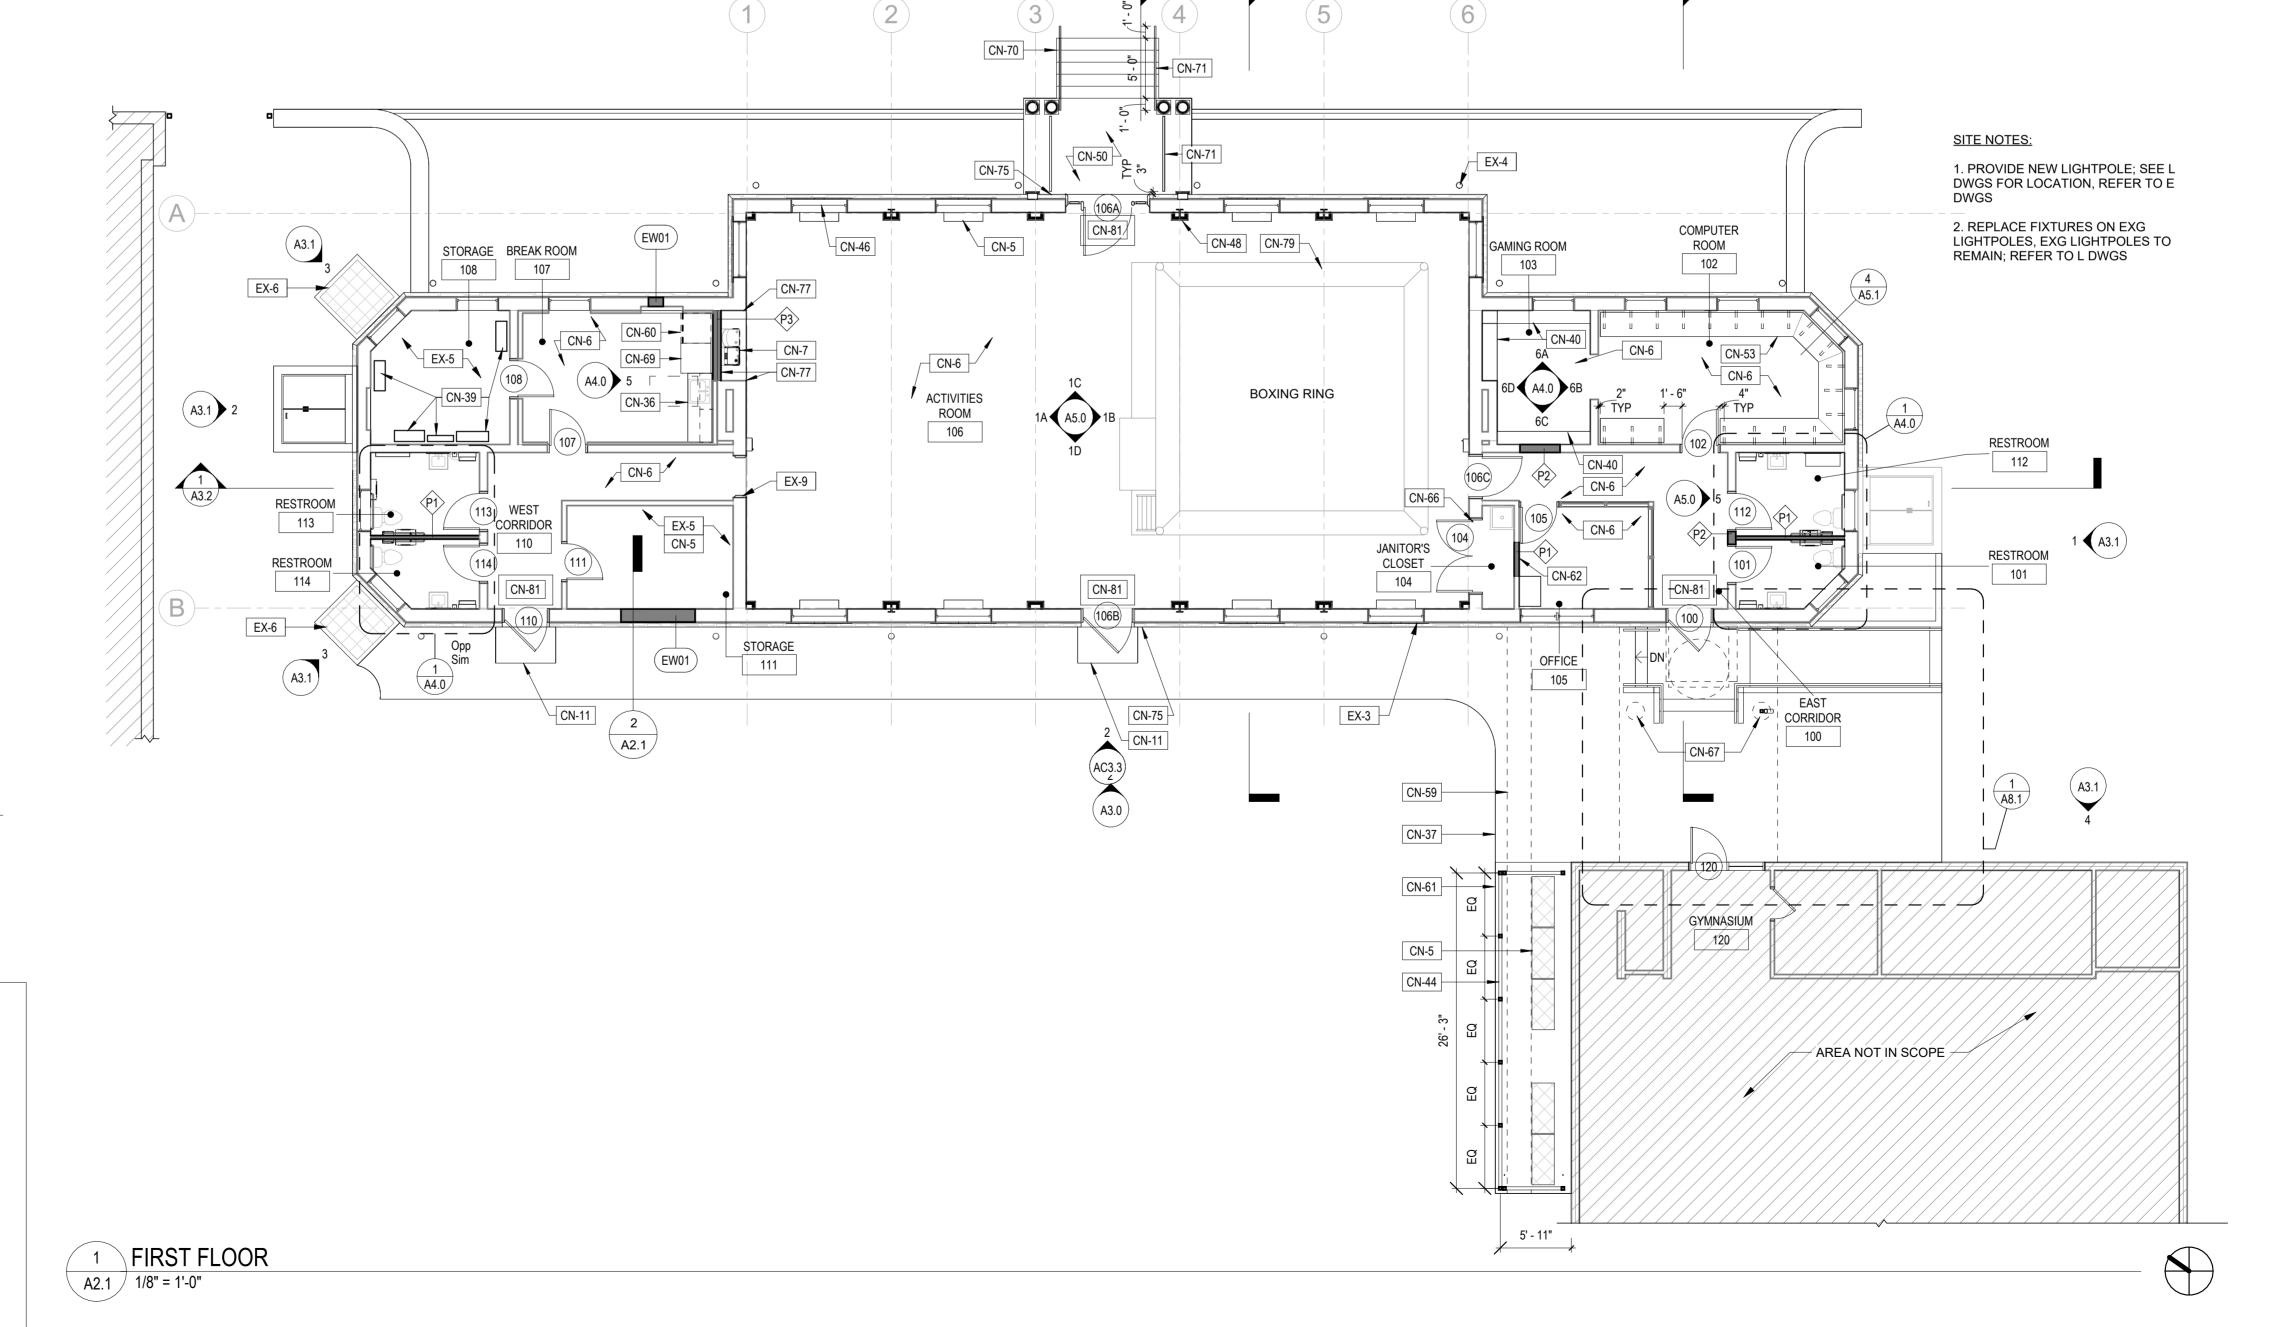
05/13/2025 AS NOTED

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2 MASONRY INFILL AT EXTERIOR WALL

A2.1 / 1 1/2" = 1'-0"



KEYED EXISTING NOTES

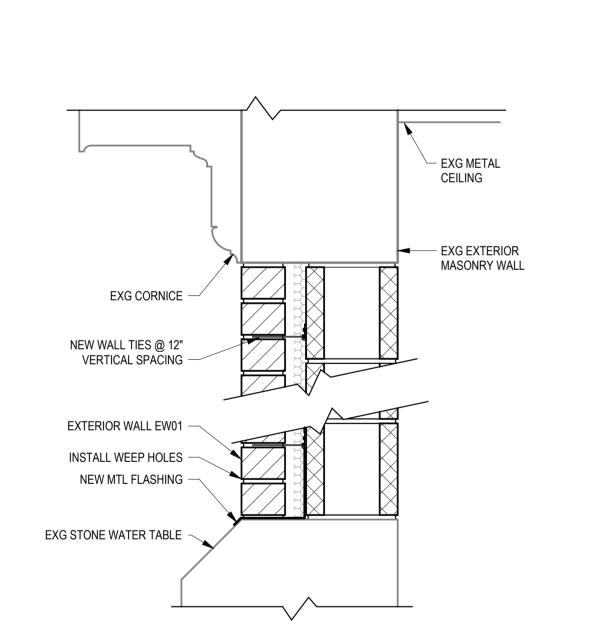EX-7 EXG EXTERIOR LIGHT TO REMAIN, NOT IN SCOPE.




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- 4. PROVIDE CEMENTITIOUS FLOOR UNDERLAYMENT ON EXISTING CONCRETE SLAB WHERE REQUIRED UNDER NEW
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14. ALL DOWNSPOUTS ETR; PROVIDE NEW CAST IRON BOOTS, TYP FOR EACH EXG DOWNSPOUT.

KEYED CONSTRUCTION NOTES

- CN-17 PROVIDE NEW CONCRETE SPLASH PAD BENEATH DOWNSPOUT. CN-26 PROVIDE NEW BREEZEWAY ROOF DECKING AND ROOF MEMBRANE; SEE STRUCT DWGS.
- CN-30 PROVIDE NEW STANDING SEAM MTL ROOF.
- CN-31 CAP CHIMNEY WITH CAST STONE SLAB WITH DRIP EDGE, EXTEND BEYOND MASONRY AT LEAST 4".
- CN-32 PROVIDE NEW ROOF SHEATHING WHERE EXISTING SHEATHING WAS REMOVED.
- CN-33 PROVIDE NEW BLOW-IN MINERAL WOOL INSULATION BETWEEN EXG 3X6 RAFTERS, TYP THROUGHOUT HIGH ROOF.
- CN-34 PROVIDE R-30 MINERAL WOOL BATT INSULATION AT LOW ROOFS. CN-42 PROVIDE NEW ROOF VENT AND EXHAUST VENTILATOR IN EXG LOCATIONS, SEE PLUMBING & MECHANICAL DWGS.
- CN-43 RECONSTRUCT INTEGRATED GUTTER THROUGHOUT ACTIVITIES BUILDING; SEE ROOF DETAILS.
- CN-47 PROVIDE NEW ROOF DRAIN WITH DRAIN GUARD, DOWNSPOUT & BOOT. NEW STORMWATER CONNECTION, SEE CIVIL



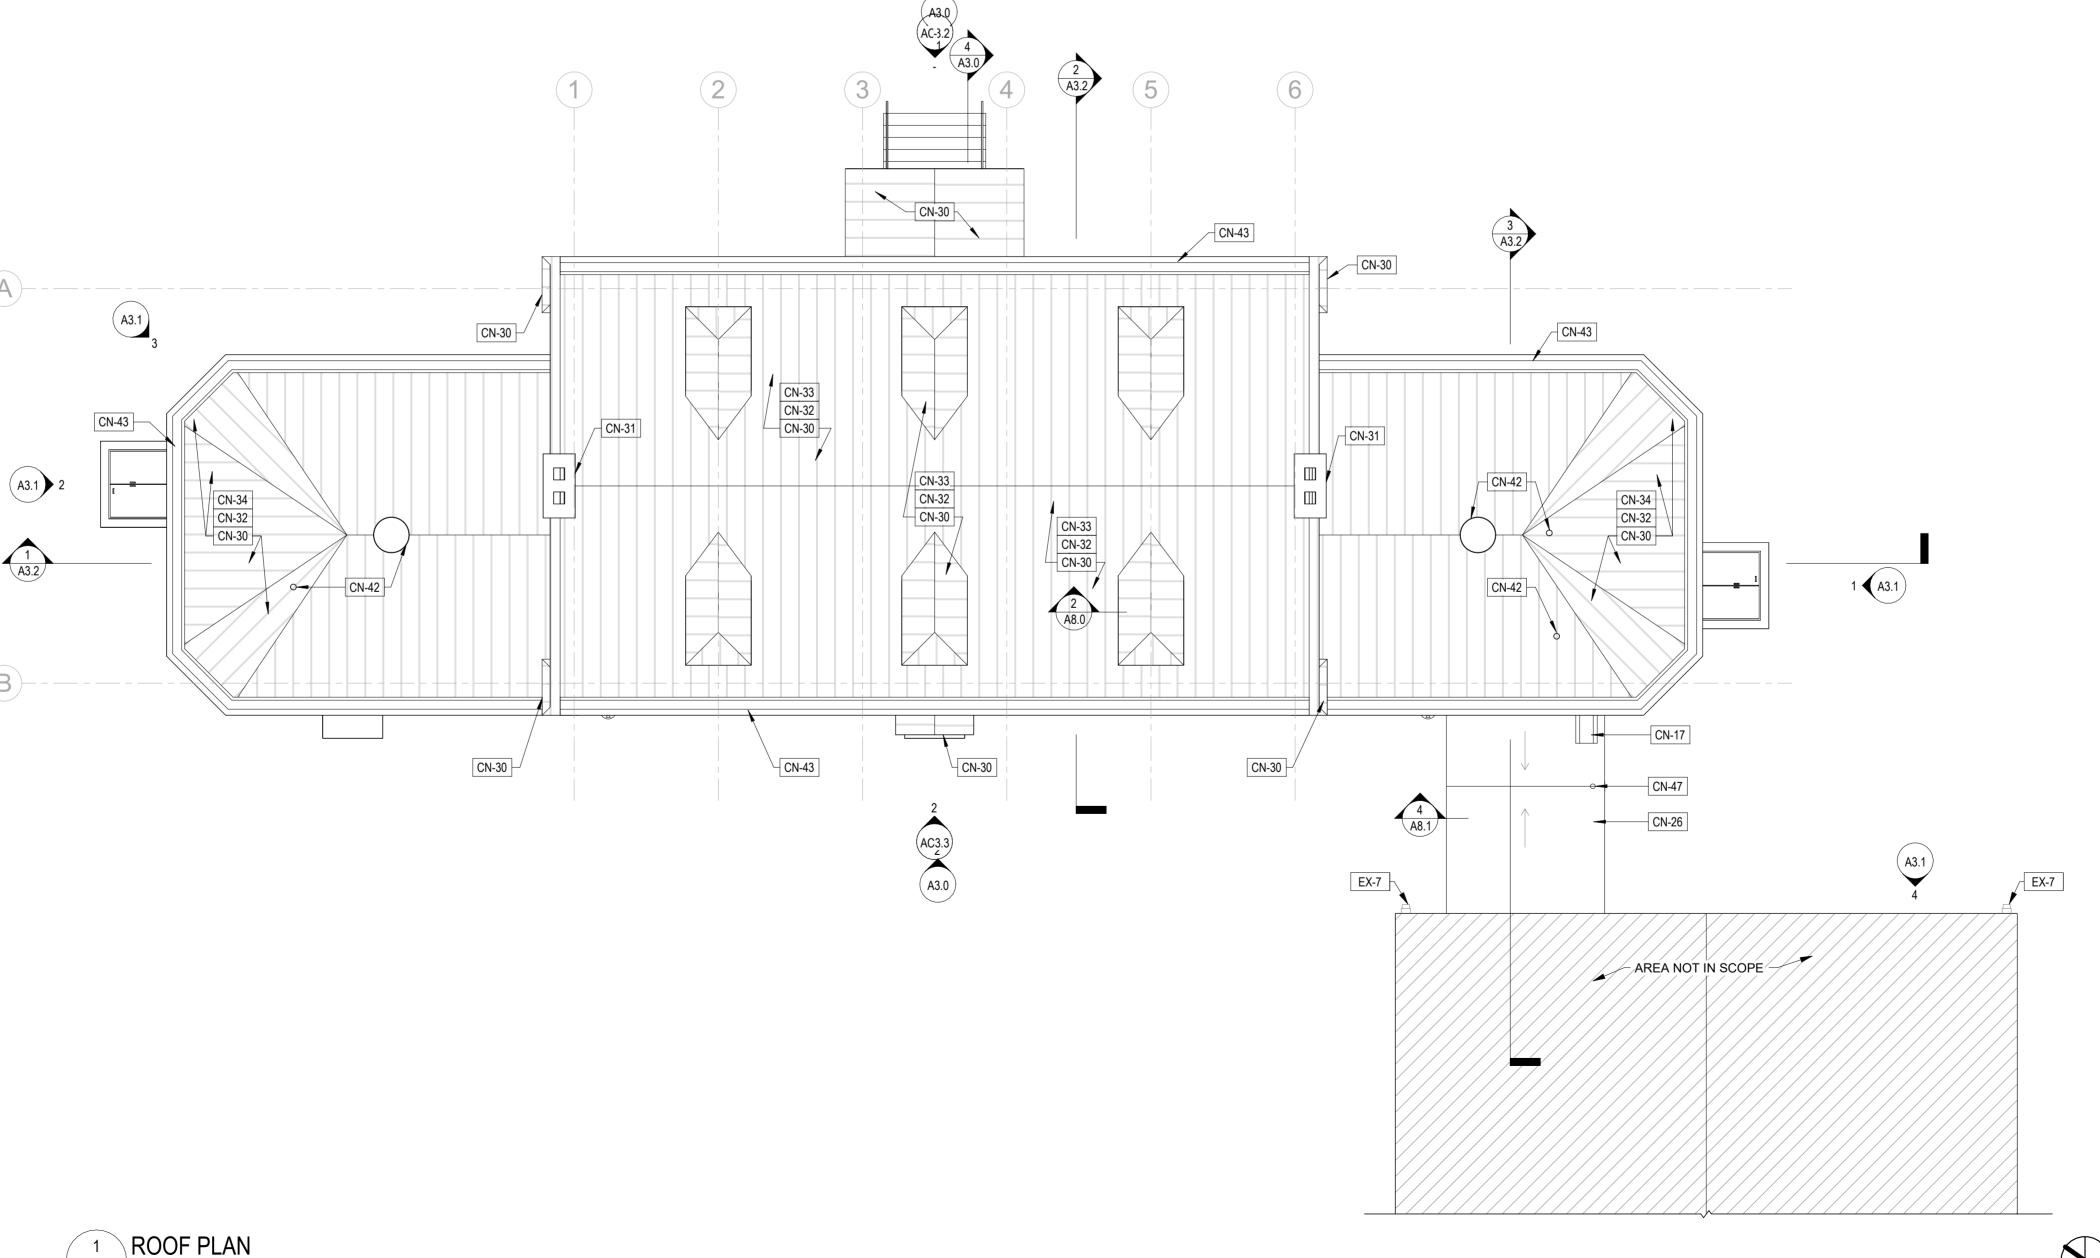

REVISIONS ISSUE DATE REVISIONS



CONSTRUCTION DOCUMENTS

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CITY OF PHILADELPHIA

DEPARTMENT OF PARKS & RECREATION 1515 ARCH STREET

11TH FLOOR, ONE PARKWAY BUILDING

RENOVATIONS TO THE HAPPY HOLLOW RECREATION CENTER

ROOF PLAN

16315E-03-02


05/13/2025

AS NOTED DRAWN BY JS/SCR CHECKED BY

ALL DIMENSIONS AND CONDITIONS SHALL BE VERIFIED BY THE CONTACTOR AT THE SITE BEFORE PROCEEDING WITH THE WORK

A2.2

A2.2 / 1/8" = 1'-0"

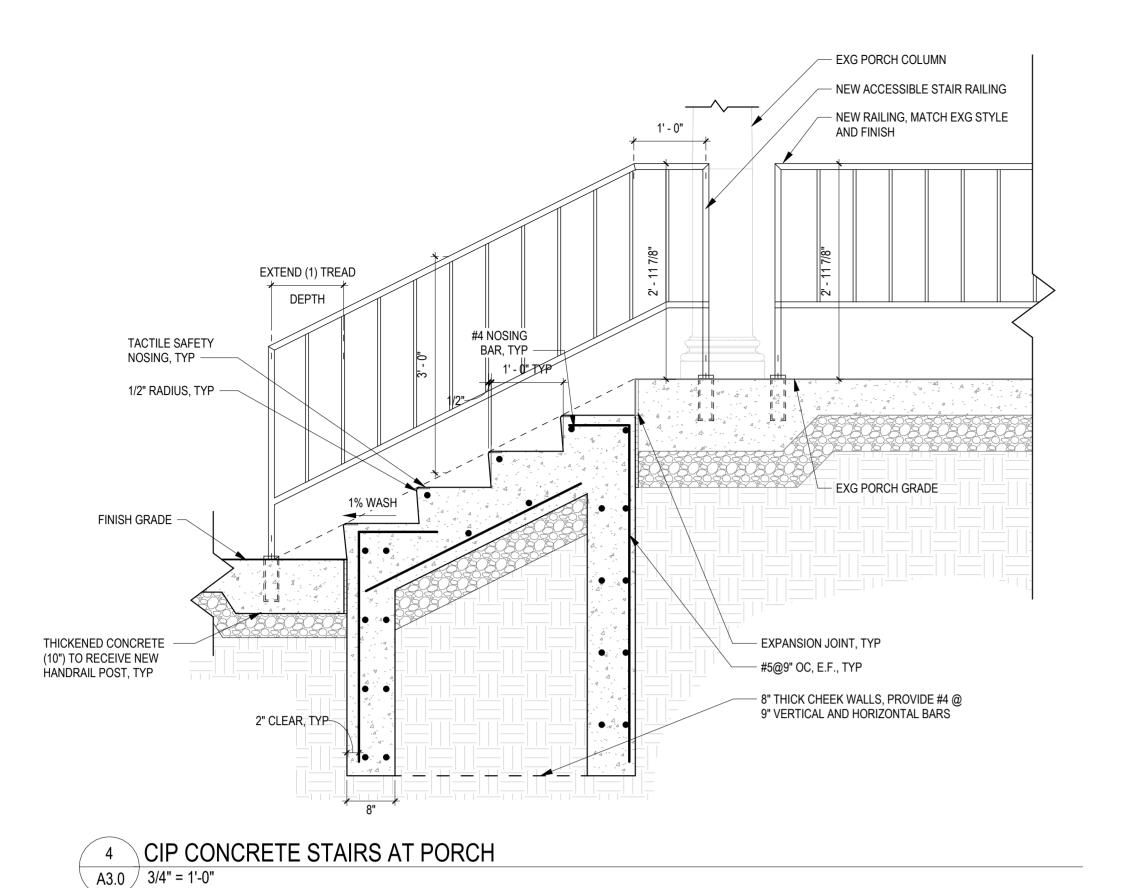

KEYED EXISTING NOTES

- EX-1 EXG WD CORNICE TO REMAIN, TYP, EXCEPT AT LOCATIONS NOTED FOR
- REPLACEMENT.
- EX-3 EXG WINDOW AND SECURITY SCREEN TO REMAIN, TYP., UNO
- EX-4 EXG DOWNSPOUTS TO REMAIN, TYP FOR ALL. EX-11 EXG CEILING LIGHT AT ENTRANCE PORCH TO REMAIN.

KEYED CONSTRUCTION NOTES

- CN-12 PROVIDE NEW CAST IRON DOWNSPOUT BOOTS, TYP, SEE PLUMBING DWGS.
- CN-15 PROVIDE NEW EXT LIGHTING, SEE ELEC DWGS.
- CN-20 REPOINT MASONRY, VERIFY EXTENTS IN FIELD.
- CN-22 PREPARE KEYSTONE PANEL AREA FOR REINSTALLATION AND REINSTALL KEYSTONE PANEL, USE APPROPRIATE SEALANTS.
- CN-23 PAINT EXG KEYSTONE PANEL, TYP.
- CN-24 REPLACE / REPAIR/PATCH DAMAGE / DETERIORATED EXTERIOR WOOD TRIM TO MATCH EXG.
- PROVIDE NEW EXTERIOR WALL INFILL, WITH FINISH FACE TO MATCH EXG.
- PROVIDE NEW BREEZEWAY ROOF DECKING AND ROOF MEMBRANE; SEE STRUCT DWGS.
- CN-29 PROVIDE NEW SECURITY CAMERA, SEE ELEC DWGS.
 - PROVIDE NEW STANDING SEAM MTL ROOF. CAP CHIMNEY WITH CAST STONE SLAB WITH DRIP EDGE, EXTEND BEYOND MASONRY AT LEAST 4".
 - PROVIDE NEW ROOF SHEATHING WHERE EXISTING SHEATHING WAS REMOVED.
- PROVIDE NEW BLOW-IN MINERAL WOOL INSULATION BETWEEN EXG 3X6 RAFTERS, TYP THROUGHOUT HIGH ROOF. PROVIDE R-30 MINERAL WOOL BATT INSULATION AT LOW ROOFS.
- PROVIDE NEW ROOF VENT AND EXHAUST VENTILATOR IN EXG LOCATIONS, SEE PLUMBING & MECHANICAL DWGS.
- RECONSTRUCT INTEGRATED GUTTER THROUGHOUT ACTIVITIES BUILDING; SEE ROOF DETAILS. CN-46 REPAIR EXG WINDOW TO ALLOW FOR NORMAL OPERATION.
- CN-50 REPOINT BRICK FLOORING.
- CN-70 PROVIDE NEW CAST IN PLACE STAIR.
- PROVIDE NEW 36" HANDRAILS, TYP AT EITHER SIDE OF ENTRANCE STAIRS AND PORCH.
- CN-72 PREP AND PAINT EXG SURFACE, PROVIDE NEW SIGNAGE TO MATCH EXG. CN-73 RE-ATTACH SALVAGED SIGNAGE AFTER PAINTING.
- CN-74 PAINT PEDIMENT, COLUMNS, DOORS, AND FRAMES TO MATCH EXG, TYP.
- CN-75 NEW BUILDING MTD SIGN BID.1, REF PPR SIGNAGE STANDARD MANUAL.


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14. ALL DOWNSPOUTS ETR; PROVIDE NEW CAST IRON BOOTS, TYP FOR EACH EXG DOWNSPOUT.

LEGEND:





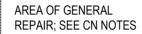

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CONSTRUCTION DOCUMENTS

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CITY OF PHILADELPHIA DEPARTMENT OF PARKS & RECREATION

1515 ARCH STREET

11TH FLOOR, ONE PARKWAY BUILDING


PROJECT TITLE RENOVATIONS TO THE HAPPY **HOLLOW RECREATION CENTER**

JS/SCR

EXTERIOR ELEVATIONS & DETAIL

16315E-03-02 A3.0 05/13/2025 AS NOTED DRAWN BY

CHECKED BY ALL DIMENSIONS AND CONDITIONS SHALL BE VERIFIED BY THE CONTACTOR AT THE SITE BEFORE PROCEEDING WITH THE WORK

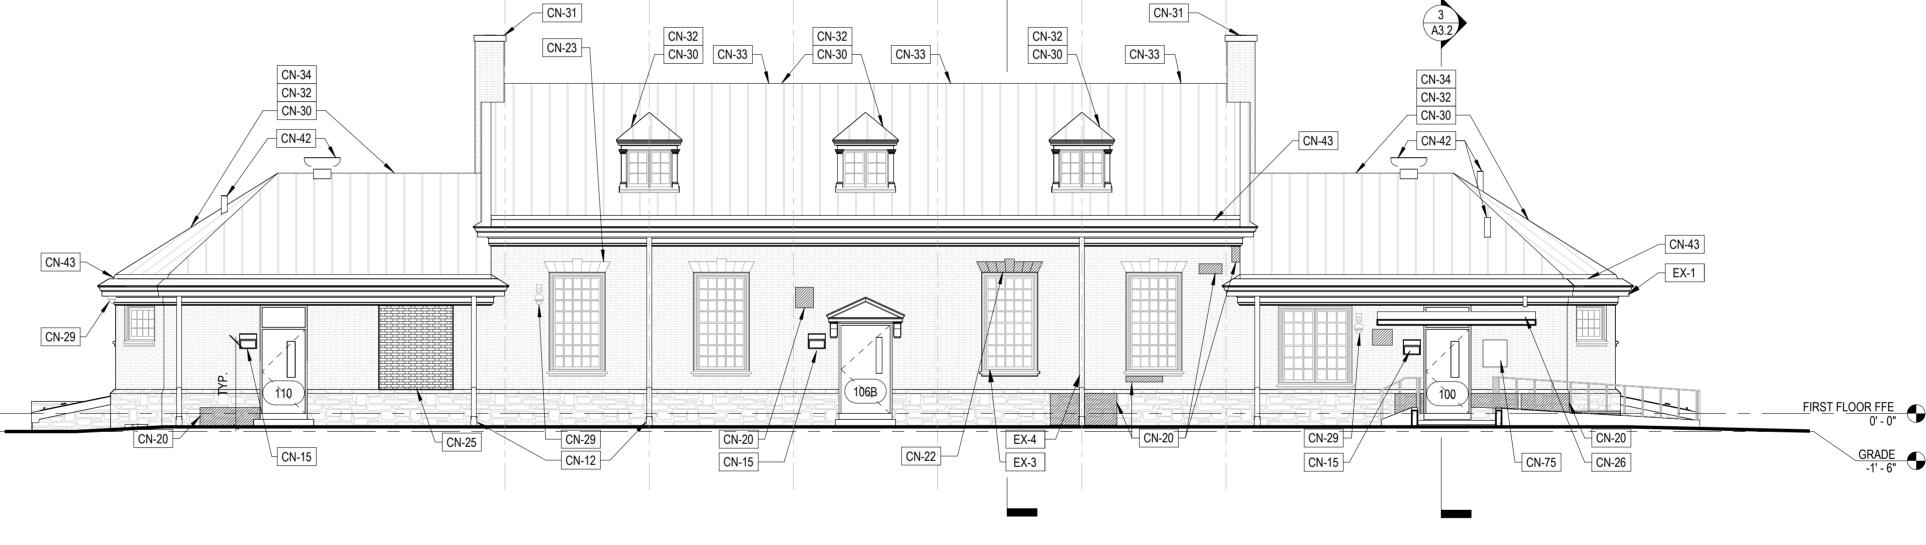




CN-71 CN-70

HAPPY HOLLOW PLAYGROUND __


8' - 6"

3 1/2"

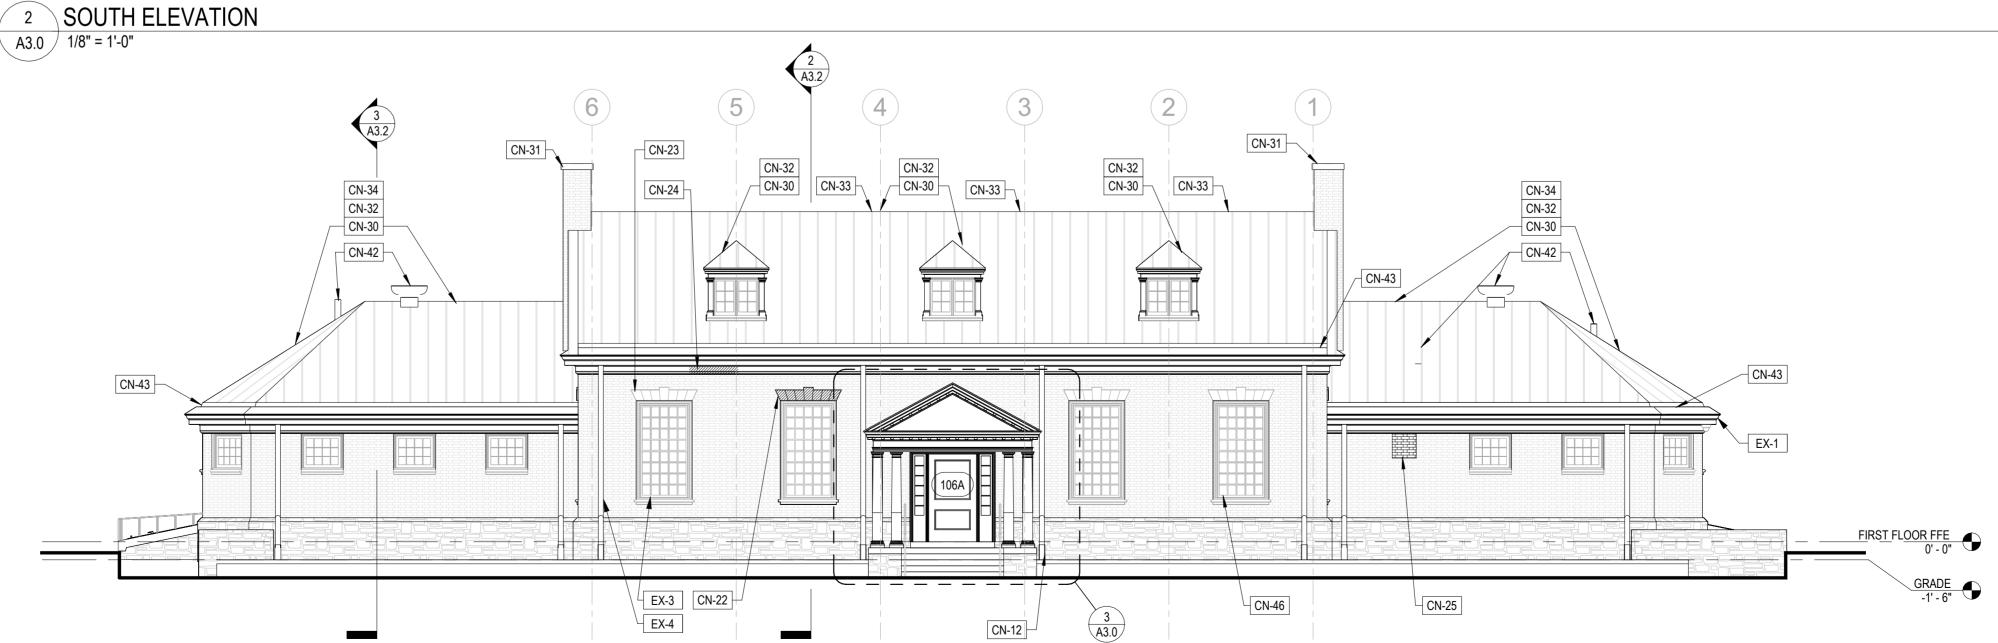


NORTH ELEVATION

A3.0 / 1/8" = 1'-0"

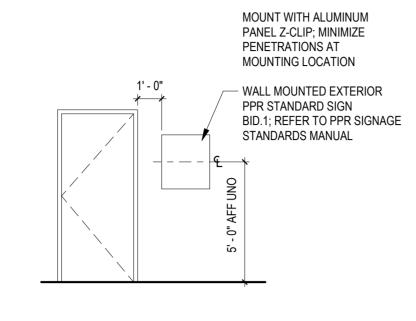


DOOR ACCESSORIES

EXTERIOR TYPICAL MOUNTING HEIGHTS A3.1 / 1/4" = 1'-0"

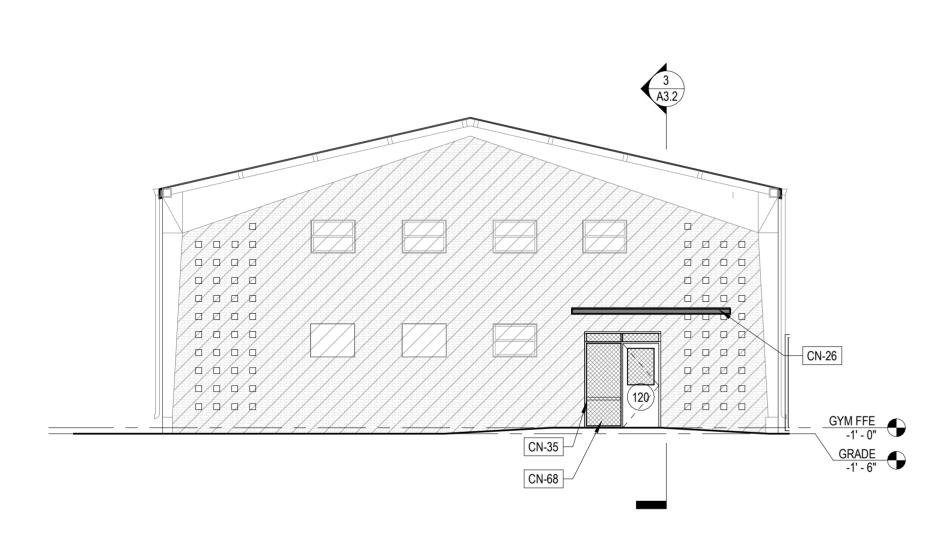

4 GYMNASIUM ELEVATION A3.1 / 1/8" = 1'-0"

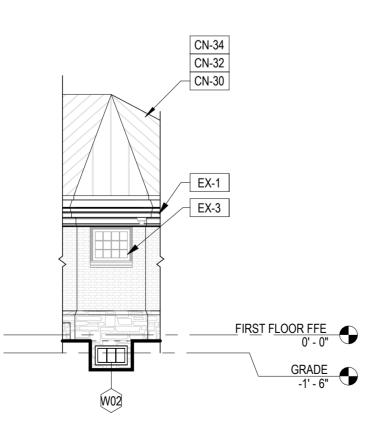

3 BELOW GRADE ELEVATION @ CHAMFER A3.1 1/8" = 1'-0"

KEYED EXISTING NOTES


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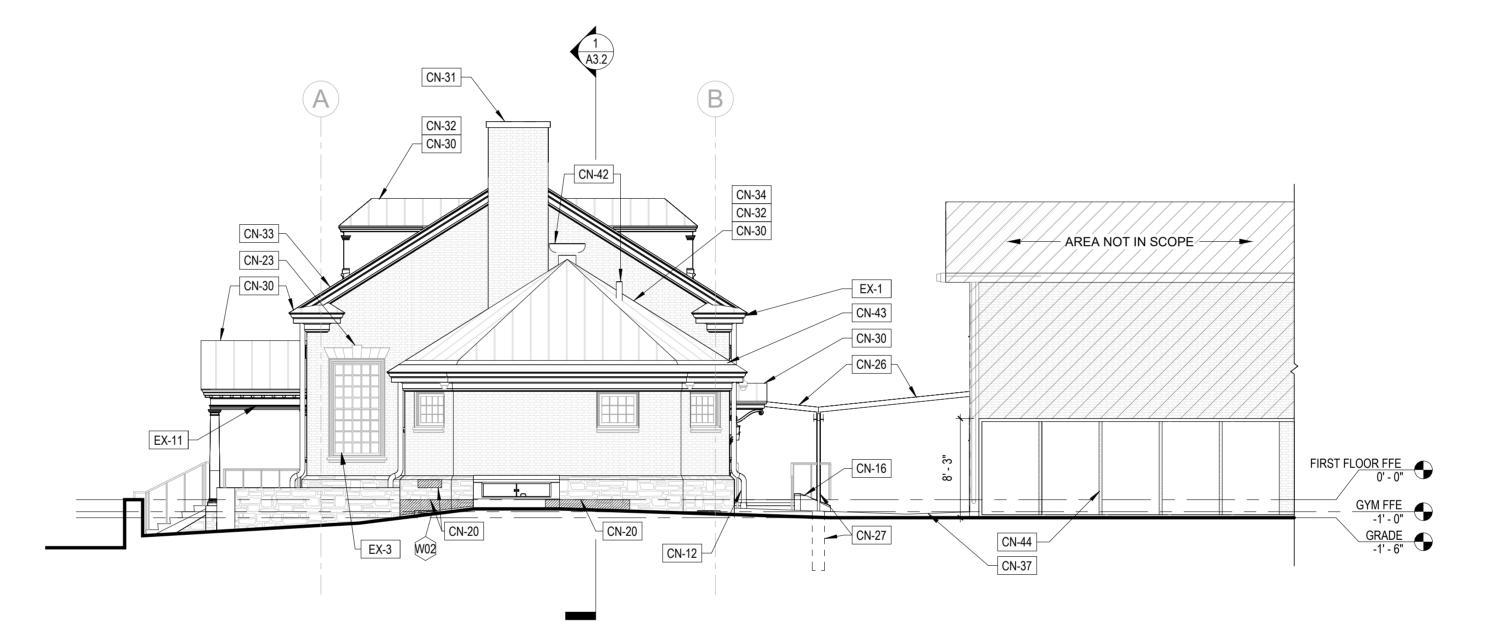
- **KEYED CONSTRUCTION NOTES** CN-12 PROVIDE NEW CAST IRON DOWNSPOUT BOOTS, TYP, SEE PLUMBING DWGS.
- CN-16 PROVIDE NEW CONCRETE LANDING, STAIRS, AND RAMP WITH CURB AND RAILING; SEE CIVIL DWGS FOR GRADING, SEE L DWGS FOR DETAILS.
- CN-20 REPOINT MASONRY, VERIFY EXTENTS IN FIELD.
- CN-23 PAINT EXG KEYSTONE PANEL, TYP. CN-26 PROVIDE NEW BREEZEWAY ROOF DECKING AND ROOF MEMBRANE; SEE STRUCT DWGS.
- PROVIDE NEW BREEZEWAY COLUMNS AND FOOTINGS; SEE S DWGS.
- CN-30 PROVIDE NEW STANDING SEAM MTL ROOF.
- CAP CHIMNEY WITH CAST STONE SLAB WITH DRIP EDGE, EXTEND BEYOND MASONRY AT LEAST 4".
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- PROVIDE R-30 MINERAL WOOL BATT INSULATION AT LOW ROOFS.
- PROVIDE NEW HM SYSTEM, SEE DOOR TYPES & DETAILS.
- PROVIDE NEW CONCRETE PAVING, SEE CIVIL & LANDSCAPE DWGS.
- PROVIDE NEW ROOF VENT AND EXHAUST VENTILATOR IN EXG LOCATIONS, SEE PLUMBING & MECHANICAL DWGS.
- RECONSTRUCT INTEGRATED GUTTER THROUGHOUT ACTIVITIES BUILDING; SEE ROOF DETAILS.
- PROVIDE NEW PERFORATED ALUMINUM FENCING, ANCHORED TO PAD BELOW; COORD WITH STRUCTURE BELOW
- CN-68 PROVIDE NEW SECURITY SCREENS, TYP.

GENERAL NOTES:


REPAINTING.

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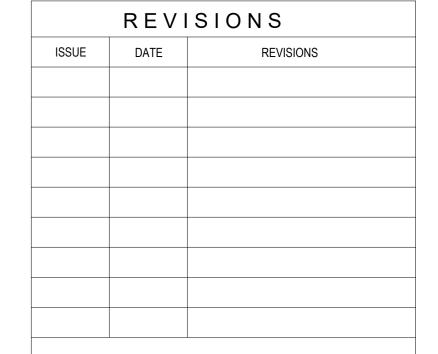


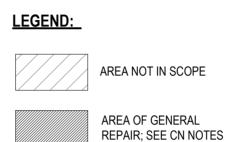

² WEST ELEVATION A3.1 / 1/8" = 1'-0"

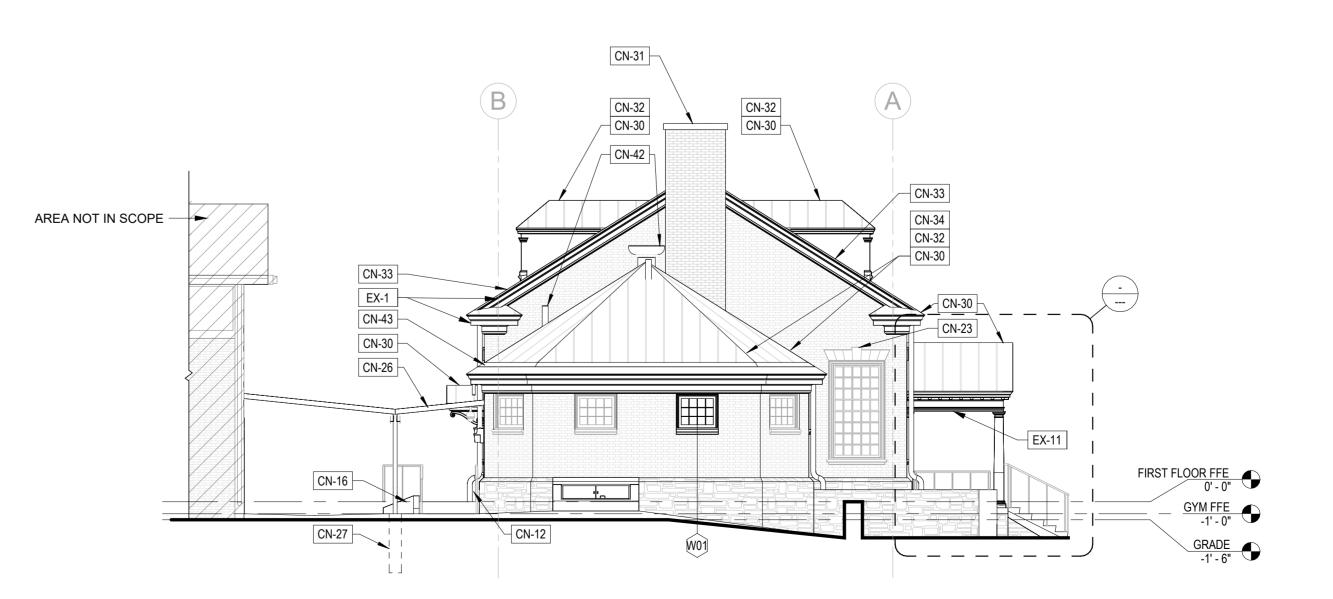

EAST ELEVATION A3.1 / 1/8" = 1'-0"





CONSTRUCTION DOCUMENTS

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PROJECT TITLE RENOVATIONS TO THE HAPPY **HOLLOW RECREATION CENTER**

EXTERIOR ELEVATIONS

16315E-03-02 A3.1 05/13/2025 AS NOTED JS/SCR

ROOF TYPES							
YPE	DESCRIPTION	CODE-REQ'D INSUL MIN R-VALUE	DETAIL	SPECIFICATION			
R1	STANDING SEAM MTL ROOF AT MAIN ROOF	NO EXG ROOF INSULATION, PER IECC 810.1 NO ADDITIONAL INSULATION IS REQD. FOR REPAIR		STANDING SEAM MTL ROOF SYSTEM PER SPECIFICATION, ROSIN PAPER, HIGH TEMPERATURE SELF ADHERING UNDERLAYMENT, 1/2" MARINE GRADE PLYWD, NEW MINERAL WOOL INSULATION BETWEEN EXG ROOF JOISTS, EXG WD CEILING BOARDS.			
		ESTIMATED R-VALUE R24					
R1A	STANDING SEAM MTL ROOF AT LOW ROOF	ESTIMATED R-VALUE R32		STANDING SEAM MTL ROOF SYSTEM PER SPECIFICATION, ROSIN PAPER, HIGH TEMPERATURE SELF ADHERING UNDERLAYMENT, 1/2" MARINE GRADE PLYWD, EXG WD CEILING BOARDS. NEW MINERAL WOOL INSULATION AT CEILING JOISTS, REFER TO SECTIONS ON THIS SHEET.			
R2	MEMBRANE ROOF AT BREEZEWAY	-		2 LAYERS MEMBRANE ROOFING, 3/4" MARINE GRADE PLYWOOD, 4x6 T&G DECKING			

COMPUTER

ROOM 102

> BASEMENT 002

GENERAL ROOF NOTES:

. SEE ROOF PLAN DWG AND A-8 SERIES DWGS FOR ADDITIONAL DETAILS.

2. MINIMUM INSUL R-VALUES ARE BASED ON YEAR IECC TABLE C402.13. PROJECT INSUL R-VALUES ARE BASED ON THE SPECIFIED B.O.D. AS FOLLOWS: X" MINERAL WOOL BATT = R4/INCH

KEYED EXISTING NOTES

- EX-1 EXG WD CORNICE TO REMAIN, TYP, EXCEPT AT LOCATIONS NOTED FOR
- REPLACEMENT. EX-4 EXG DOWNSPOUTS TO REMAIN, TYP FOR ALL.

KEYED CONSTRUCTION NOTES

- CN-29 PROVIDE NEW SECURITY CAMERA, SEE ELEC DWGS.
- CN-30 PROVIDE NEW STANDING SEAM MTL ROOF.
- CN-31 CAP CHIMNEY WITH CAST STONE SLAB WITH DRIP EDGE, EXTEND BEYOND MASONRY AT LEAST 4".
- CN-32 PROVIDE NEW ROOF SHEATHING WHERE EXISTING SHEATHING WAS REMOVED.
- CN-33 PROVIDE NEW BLOW-IN MINERAL WOOL INSULATION BETWEEN EXG 3X6 RAFTERS, TYP THROUGHOUT HIGH
- CN-34 PROVIDE R-30 MINERAL WOOL BATT INSULATION AT LOW ROOFS.
- CN-42 PROVIDE NEW ROOF VENT AND EXHAUST VENTILATOR IN EXG LOCATIONS, SEE PLUMBING & MECHANICAL

AREA NOT IN SCOPE

DROP CEILING 9' - 11"

FIRST FLOOR FFE


BASEMENT FF -9' - 4"

GENERAL NOTES:

- 1. FILL VOIDS AROUND PENETRATIONS AND JOINTS THROUGH NON-RATED PARTITIONS WITH MINERAL WOOL INSULATION AND SEAL AROUND THE OPENING WITH ACOUSTIC SEALANT.
- 2. WHEN ARCHITECTURAL EQUIPMENT OR FINISHES INTERFERE WITH THE LOCATION OF RECEPTACLES, SWITCHES,
- CONTROLS, ETC. COORDINATE WITH A/E PRIOR TO CUTTING OR INSTALLATION OF THE EQUIPMENT OR FINISH. 3. LOCATE INTERIOR AND EXTERIOR CONTROL JOINTS AS INDICATED ON THE ARCHITECTURAL DRAWINGS AND IN
- SPECIFICATIONS. COORDINATE FINAL LOCATIONS WITH ARCHITECT.
- 4. PROVIDE CEMENTITIOUS FLOOR UNDERLAYMENT ON EXISTING CONCRETE SLAB WHERE REQUIRED UNDER NEW
- 5. ALL EXG AND NEW METAL CEILINGS TO BE REPAINTED; PREPARE EXG AND NEW SURFACES AS NECESSARY TO PROVIDE SMOOTH/CONSISTENT FINISH.
- 6. ALL EXG INT GLAZED BRICK AND MORTAR TO BE CLEANED AND FREE OF PAINT. 7. ALL INTERIOR GWB/PLASTER SURFACES TO BE REPAINTED; PREPARE EXG AND NEW SURFACES AS NECESSARY TO PROVIDE SMOOTH/CONSISTENT FINISH. EXG MURALS IN ACTIVITIES ROOM 106 TO BE PRESERVED AND EXCLUDED FROM
- 8. ALL EXG INTERIOR CMU TO BE REPAINTED. PREPARE EXG AND NEW SURFACES AS NECESSARY TO PROVIDE
- SMOOTH/CONSISTENT FINISH. 9. REPLACE ALL INTERIOR DOORS, FRAMES, AND HARDWARE WITH NEW HM DOORS, METAL FRAMES, AND HARDWARE
- U.N.O.; SEE DOOR SCHEDULE.
- 10. REFER TO MEPFP DRAWINGS FOR ADDITIONAL INFO. 11. REFER TO STRUC DRAWINGS FOR LOCATIONS OF NEW AND EXISTING STRUCTURE.
- 12. REFER TO LANDSCAPE DRAWINGS FOR PLAYGROUND FURNISHINGS/EQUIPMENT.
- 13. PATCH AND REPAIR HOLES LEFT FROM REMOVAL OF EXERCISE EXQUIPMENT. REPAINT SURFACES, TYP. 14. ALL DOWNSPOUTS ETR; PROVIDE NEW CAST IRON BOOTS, TYP FOR EACH EXG DOWNSPOUT.


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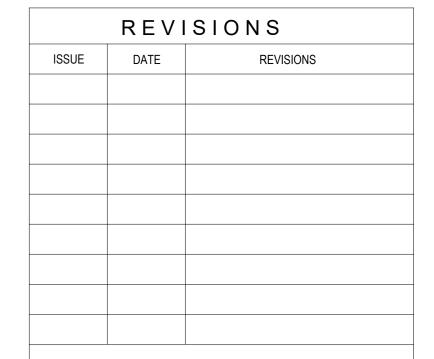


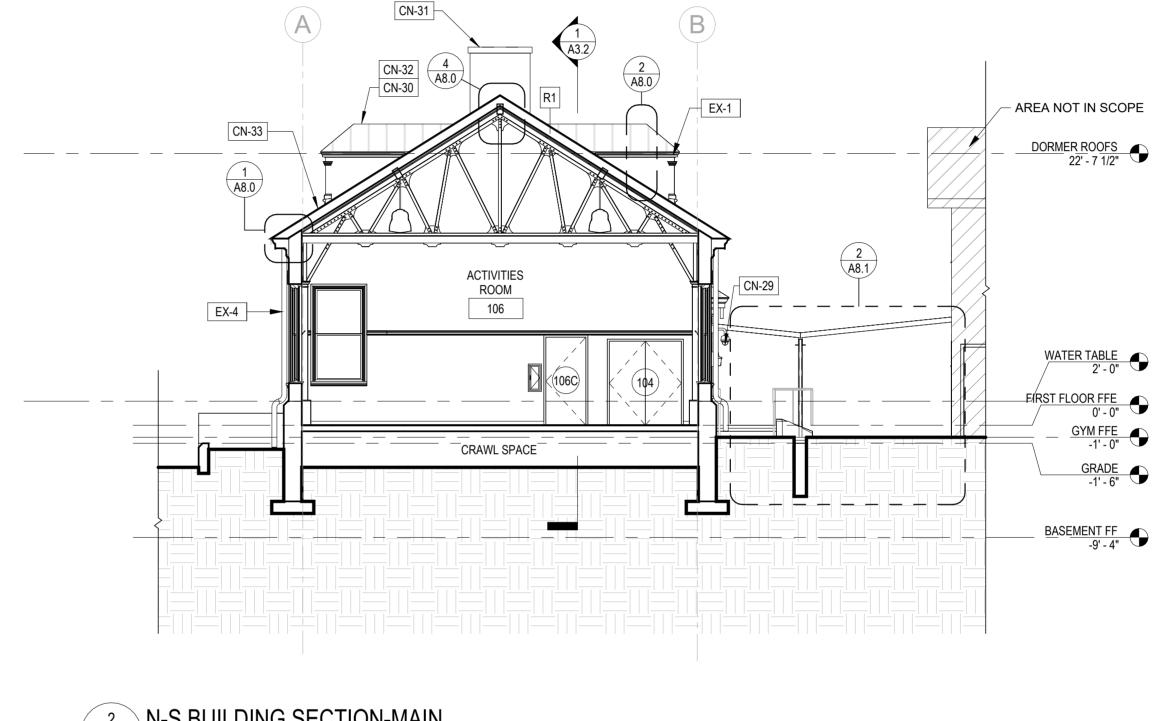

3 N-S BUILDING SECTION-WING A3.2 / 1/8" = 1'-0"

² N-S BUILDING SECTION-MAIN A3.2 / 1/8" = 1'-0"



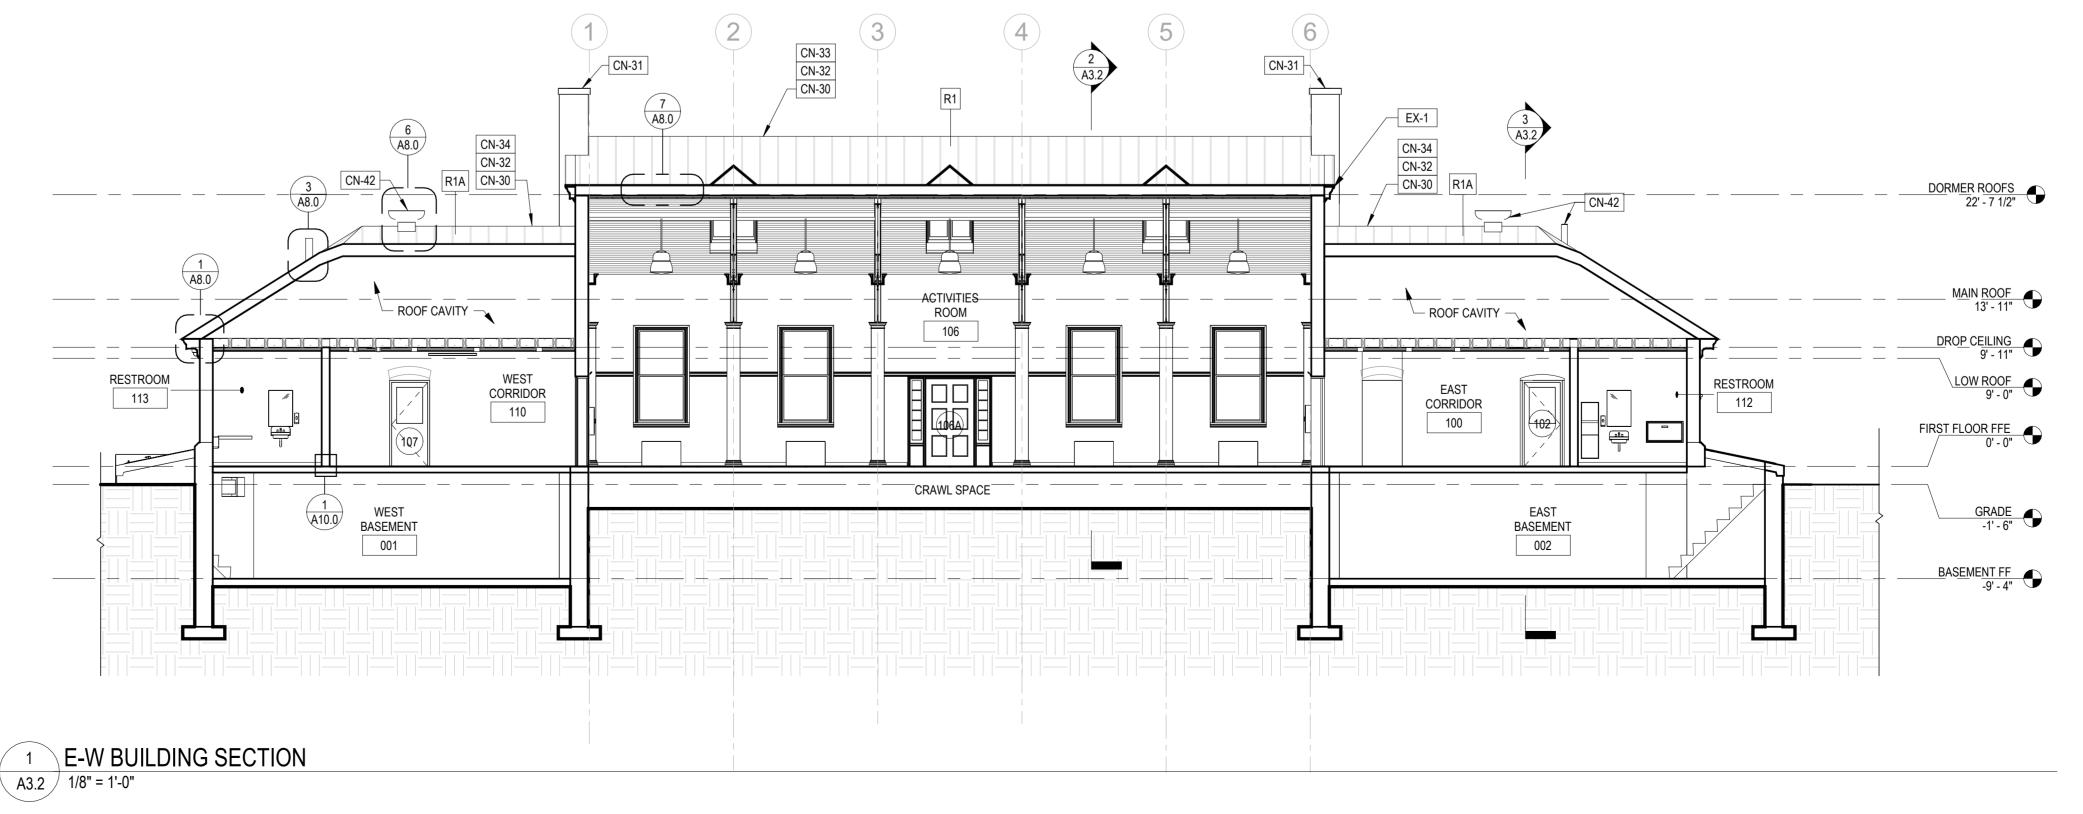



CONSTRUCTION DOCUMENTS

PROJECT COORDINATOR LEEANN SUEN



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610 459 7900° ROOFING CONSULTANT:
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CITY OF PHILADELPHIA DEPARTMENT OF PARKS & RECREATION

1515 ARCH STREET 11TH FLOOR, ONE PARKWAY BUILDING


PROJECT TITLE RENOVATIONS TO THE HAPPY **HOLLOW RECREATION CENTER**

BUILDING SECTIONS & ROOF TYPES

16315E-03-02 05/13/2025 AS NOTED

Author

CHECKED BY

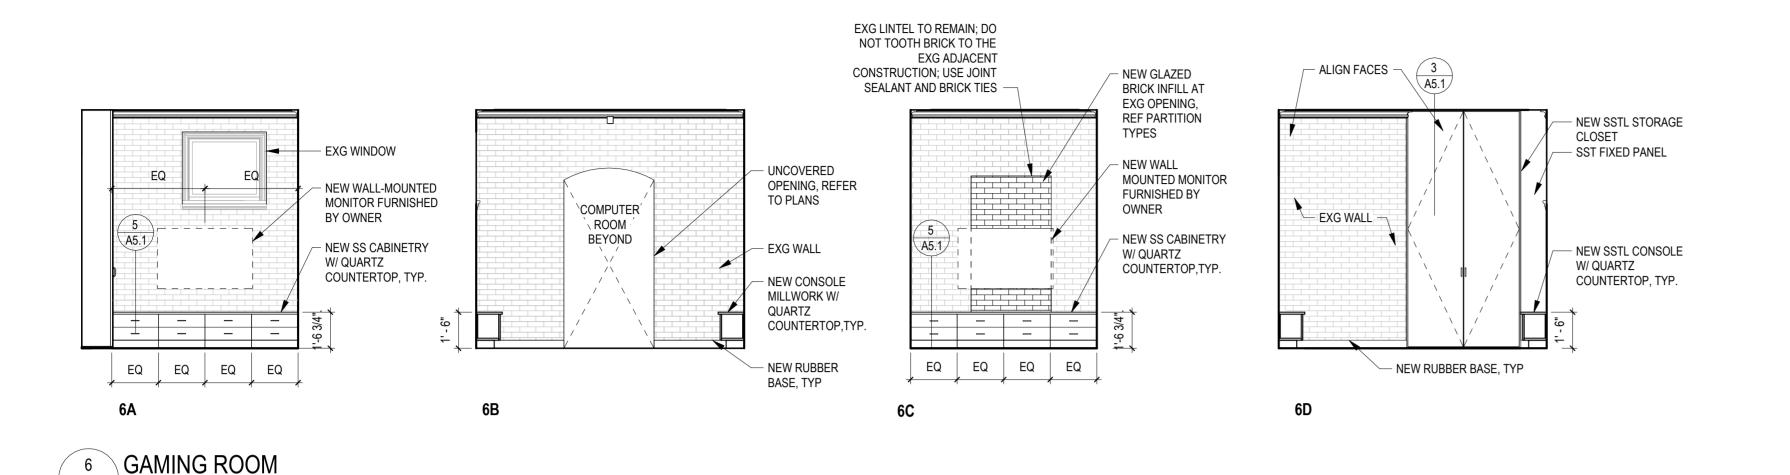


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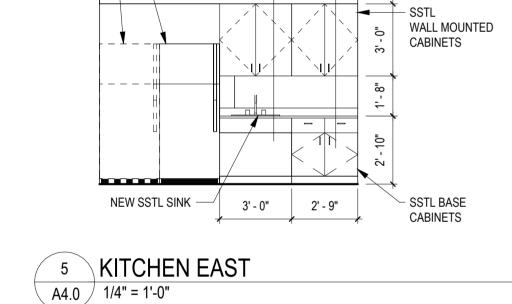
KEYED CONSTRUCTION NOTES

- PROVIDE NEW PLUMBING EQUIPMENT & ACCESSORIES; SEE PLUMBING DWGS.
- PROVIDE NEW TOILET ACCESSORIES; SEE TYP MOUNTING HEIGHTS.
- PROVIDE NEW EPOXY FINISH FLOOR AND BASE.
- CN-13 PROVIDE NEW FLOOR DRAIN; SEE PLUMBING DWGS.
- PROVIDE NEW ANCHOR INFILL MASONRY WITH HOHMAN & BARNARD SLIP-SET STABLIZER ANCHORS @ 32" VERTICAL SPACING, SEE STRUCT DWGS.
- CN-63 PROVIDE NEW 8X8 PRECAST LINTEL, SEE STRUCT DWGS; PAINT, COLOR AND FINISH TO MATCH NEW GLAZED BRICK.
- PROVIDE NEW 9"X12" BRICK PIER TO MATCH EXISTING PARTITION, SEE STRUCT DWGS.

PLUMBING FIXTURES

CN-65 PROVIDE NEW 4" CMU PARTITION ANCHOR TO CEILING AT THIRD POINTS, SEE STRUCT DWGS.



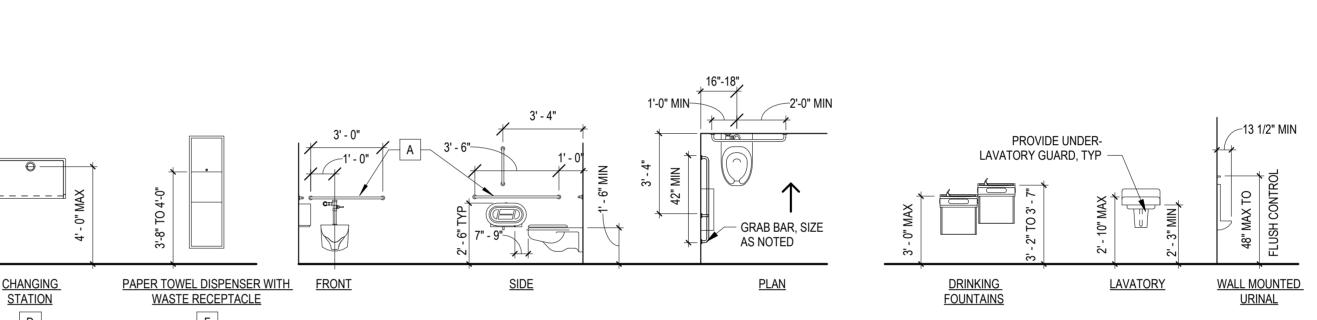

A4.0 / 1/4" = 1'-0"

NEW REFRIGERATOR

PROVIDE NEW REFRIGERATOR ¬ PNT NEW GWB SOFFIT

BY OTHERS



SANITARY NAPKIN DISPOSAL

SURFACE MOUNTED


TOILET PAPER DISPENSER -MULTI STACKED / MULTI ROLL




<u>SOAP</u>


DISPENSER

В

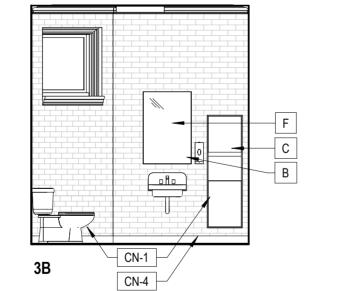

TOILET ACCESSORIES

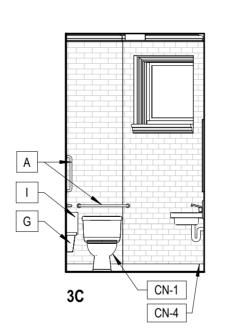

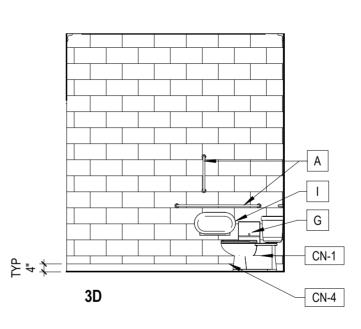


TYPICAL ADA STALL


3 RESTROOM 101 A4.0 / 1/4" = 1'-0"


A4.0 / 1/4" = 1'-0"


CN-4

3A

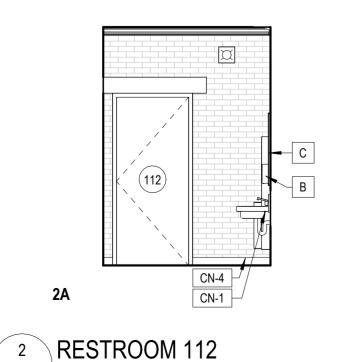

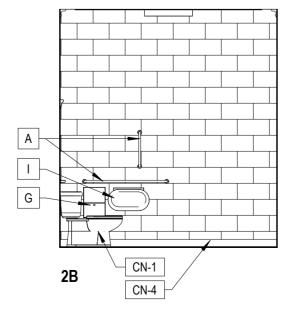

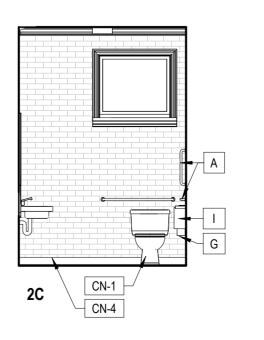

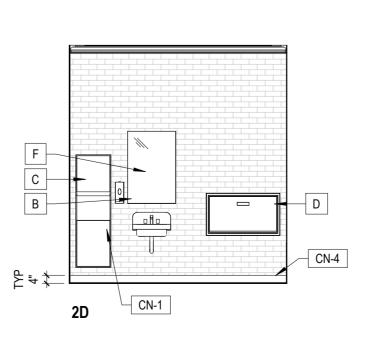



CN-3

CN-1

CN-4

CN-65

CN-62

ISSUE DATE REVISIONS

REVISIONS



CONSTRUCTION DOCUMENTS

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856 287 2424

112

RESTROOM

101

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CITY OF PHILADELPHIA DEPARTMENT OF PARKS & RECREATION

1515 ARCH STREET


11TH FLOOR, ONE PARKWAY BUILDING

PROJECT TITLE

RENOVATIONS TO THE HAPPY **HOLLOW RECREATION CENTER**

ENLARGED RESTROOM PLANS & INTERIOR ELEVATIONS

16315E-03-02 05/13/2025 AS NOTED JS/SCR

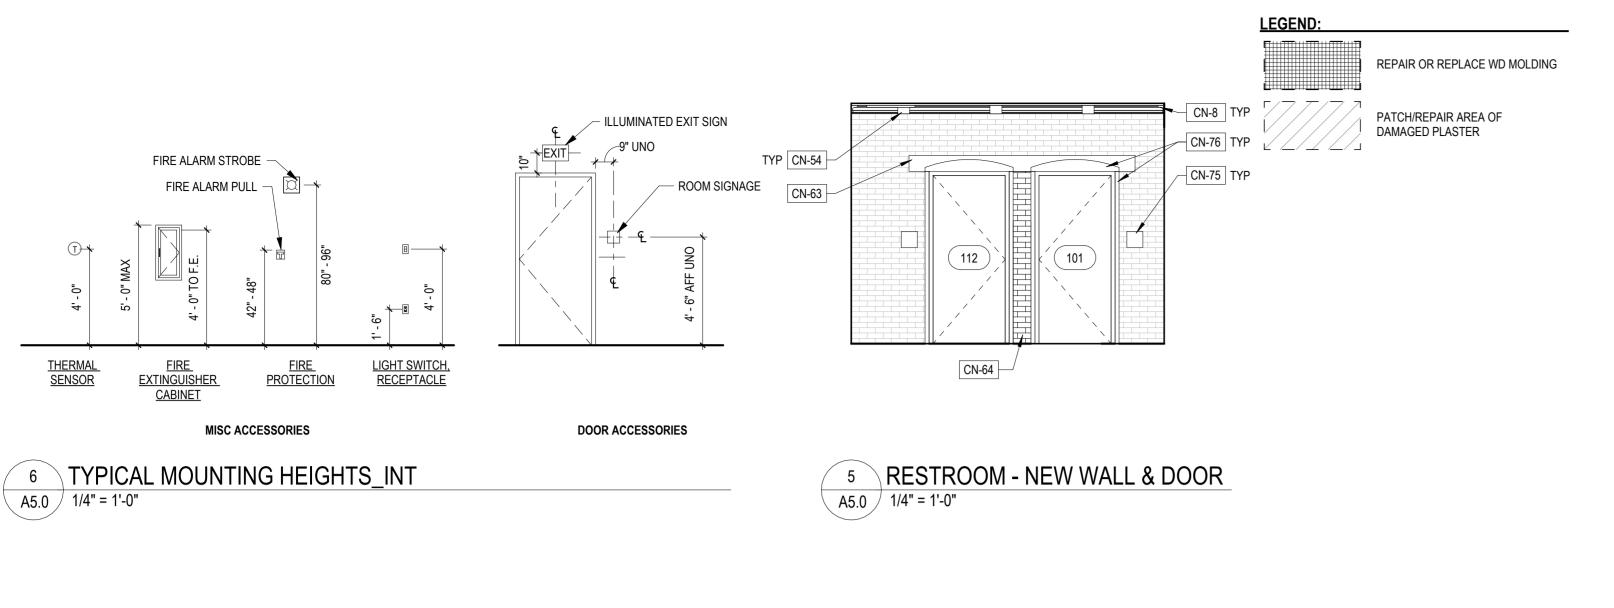

CN-51

CN-46

A5.0 1/4" = 1'-0"

4 ACTIVITY ROOM

CN-52

KEYED EXISTING NOTES

- EX-8 EXG WALL MURAL TO BE PRESERVED.
- EX-9 EXG WOODEN CASED OPENINGS TO REMAIN.

KEYED CONSTRUCTION NOTES


- CN-5 PROVIDE NEW MECH EQUIPMENT, TYP, SEE MECH DWGS.
- PROVIDE NEW RESILIENT FLOOR & BASE, REFER TO FINISH PLAN FOR MORE INFORMATION.
- PROVIDE NEW ACCESSIBLE DRINKING FOUNTAIN AND BOTTLE FILLING STATION.
- PATCH / REPLACE EXG MTL CEILING AS INDICATED ON THE DRAWINGS; VERIFY CONDITIONS IN THE FIELD AND CONSULT ARCHITECT ON THE EXTENTS
- CN-10 PROVIDE NEW WOOD TRANSITION MOLDING WHERE MISSING OR DAMAGED TO MATCH
- EXG: VERIFY EXTENTS IN FIELD.
- CN-46 REPAIR EXG WINDOW TO ALLOW FOR NORMAL OPERATION. CN-48 PROVIDE NEW WD BASE AT WD PILASTER, TYP FOR ALL, MATCH EXG. CN-49 REPAIR WATER DAMAGE & REPLACE SPALLED BRICKS, VERIFY EXTENT IN FIELD.
- CN-51 CLEAN AND PREP WALL BELOW SILL FOR NEW WD TRIM.
- CN-52 SCRAPE, CLEAN AND PAINT LINTEL.
- CN-54 PROVIDE NEW INT LIGHTING FIXTURES, TYP, SEE ELEC DWGS. CN-58 SCRAPE, CLEAN AND PAINT PLASTER PORTION OF WALL ABOVE WD TRIM.
- CN-63 PROVIDE NEW 8X8 PRECAST LINTEL, SEE STRUCT DWGS; PAINT, COLOR AND FINISH TO
- MATCH NEW GLAZED BRICK. CN-64 PROVIDE NEW 9"X12" BRICK PIER TO MATCH EXISTING PARTITION, SEE STRUCT DWGS.

CN-6

- CN-75 PROVIDE NEW ROOM SIGNAGE; REFER TO SIGNAGE TYPES AND TYPICAL MOUNTING CN-76 NEW WD DOOR TRIM, REFER TO DOOR DETAILS.
- CN-77 NEW GLAZED BRICK TO MATCH EXG, REFER TO PARTITION TYPES; RETURN NEW GLAZED BRICK AT SIDES AND PROVIDE RADIUS EDGE AT OUTSIDE CORNER.
- CN-78 NEW GYPSUM CEILING.

GENERAL NOTES:

- 1. FILL VOIDS AROUND PENETRATIONS AND JOINTS THROUGH NON-RATED PARTITIONS WITH MINERAL WOOL INSULATION
- AND SEAL AROUND THE OPENING WITH ACOUSTIC SEALANT. 2. WHEN ARCHITECTURAL EQUIPMENT OR FINISHES INTERFERE WITH THE LOCATION OF RECEPTACLES, SWITCHES, CONTROLS, ETC. COORDINATE WITH A/E PRIOR TO CUTTING OR INSTALLATION OF THE EQUIPMENT OR FINISH.
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- 9. REPLACE ALL INTERIOR DOORS, FRAMES, AND HARDWARE WITH NEW HM DOORS, METAL FRAMES, AND HARDWARE U.N.O.; SEE DOOR SCHEDULE.
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- 14. ALL DOWNSPOUTS ETR; PROVIDE NEW CAST IRON BOOTS, TYP FOR EACH EXG DOWNSPOUT.

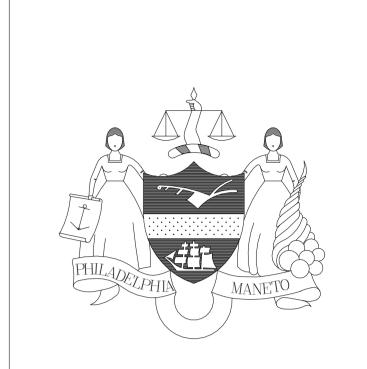

REVISIONS

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CONSTRUCTION DOCUMENTS

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CITY OF PHILADELPHIA DEPARTMENT OF PARKS & RECREATION

1515 ARCH STREET

11TH FLOOR, ONE PARKWAY BUILDING

PROJECT TITLE

RENOVATIONS TO THE HAPPY **HOLLOW RECREATION CENTER**

DRAWN BY

INTERIOR ELEVATIONS

16315E-03-02 05/13/2025

AS NOTED

JS/SCR


A5.0


SCR/TW ALL DIMENSIONS AND CONDITIONS SHALL BE VERIFIED BY THE CONTACTOR AT THE SITE BEFORE PROCEEDING WITH THE WORK


ACTIVITY ROOM SOUTH A5.0 / 1/4" = 1'-0"

1D

CN-5

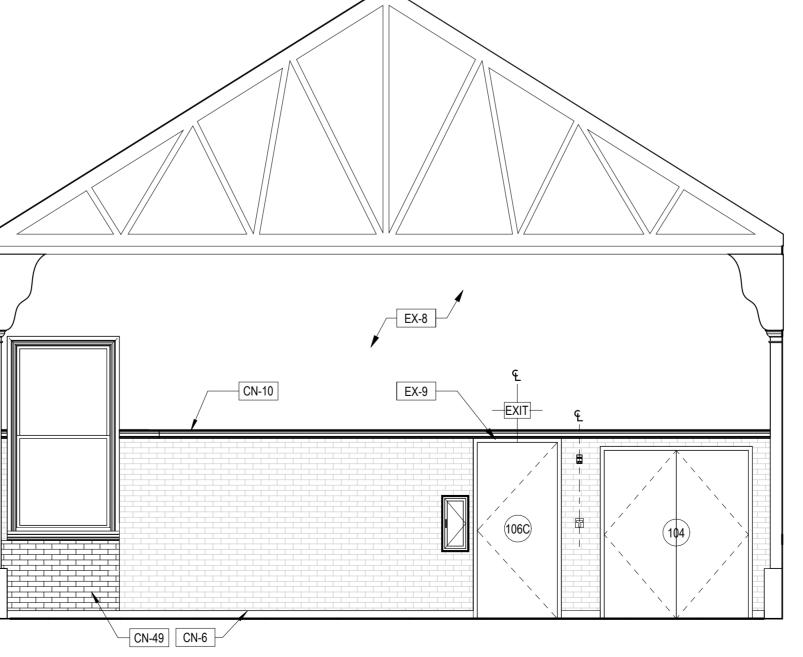


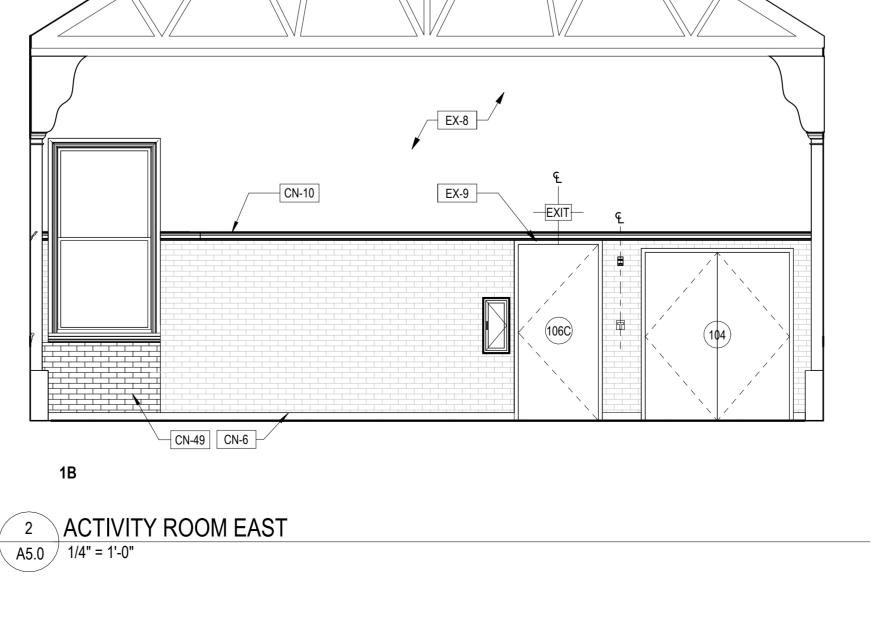

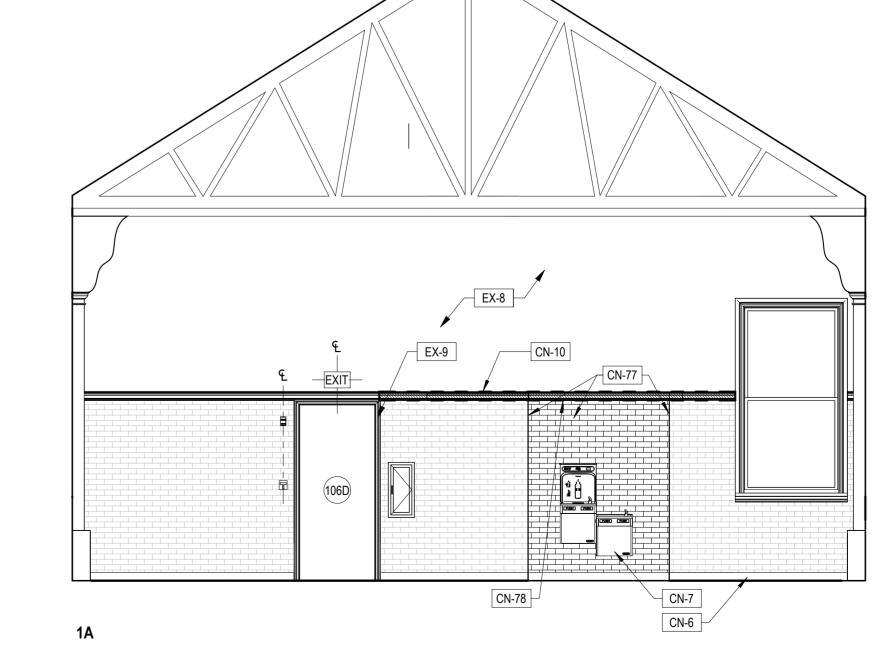

(106B)

1 ACTIVITY ROOM WEST A5.0 1/4" = 1'-0"

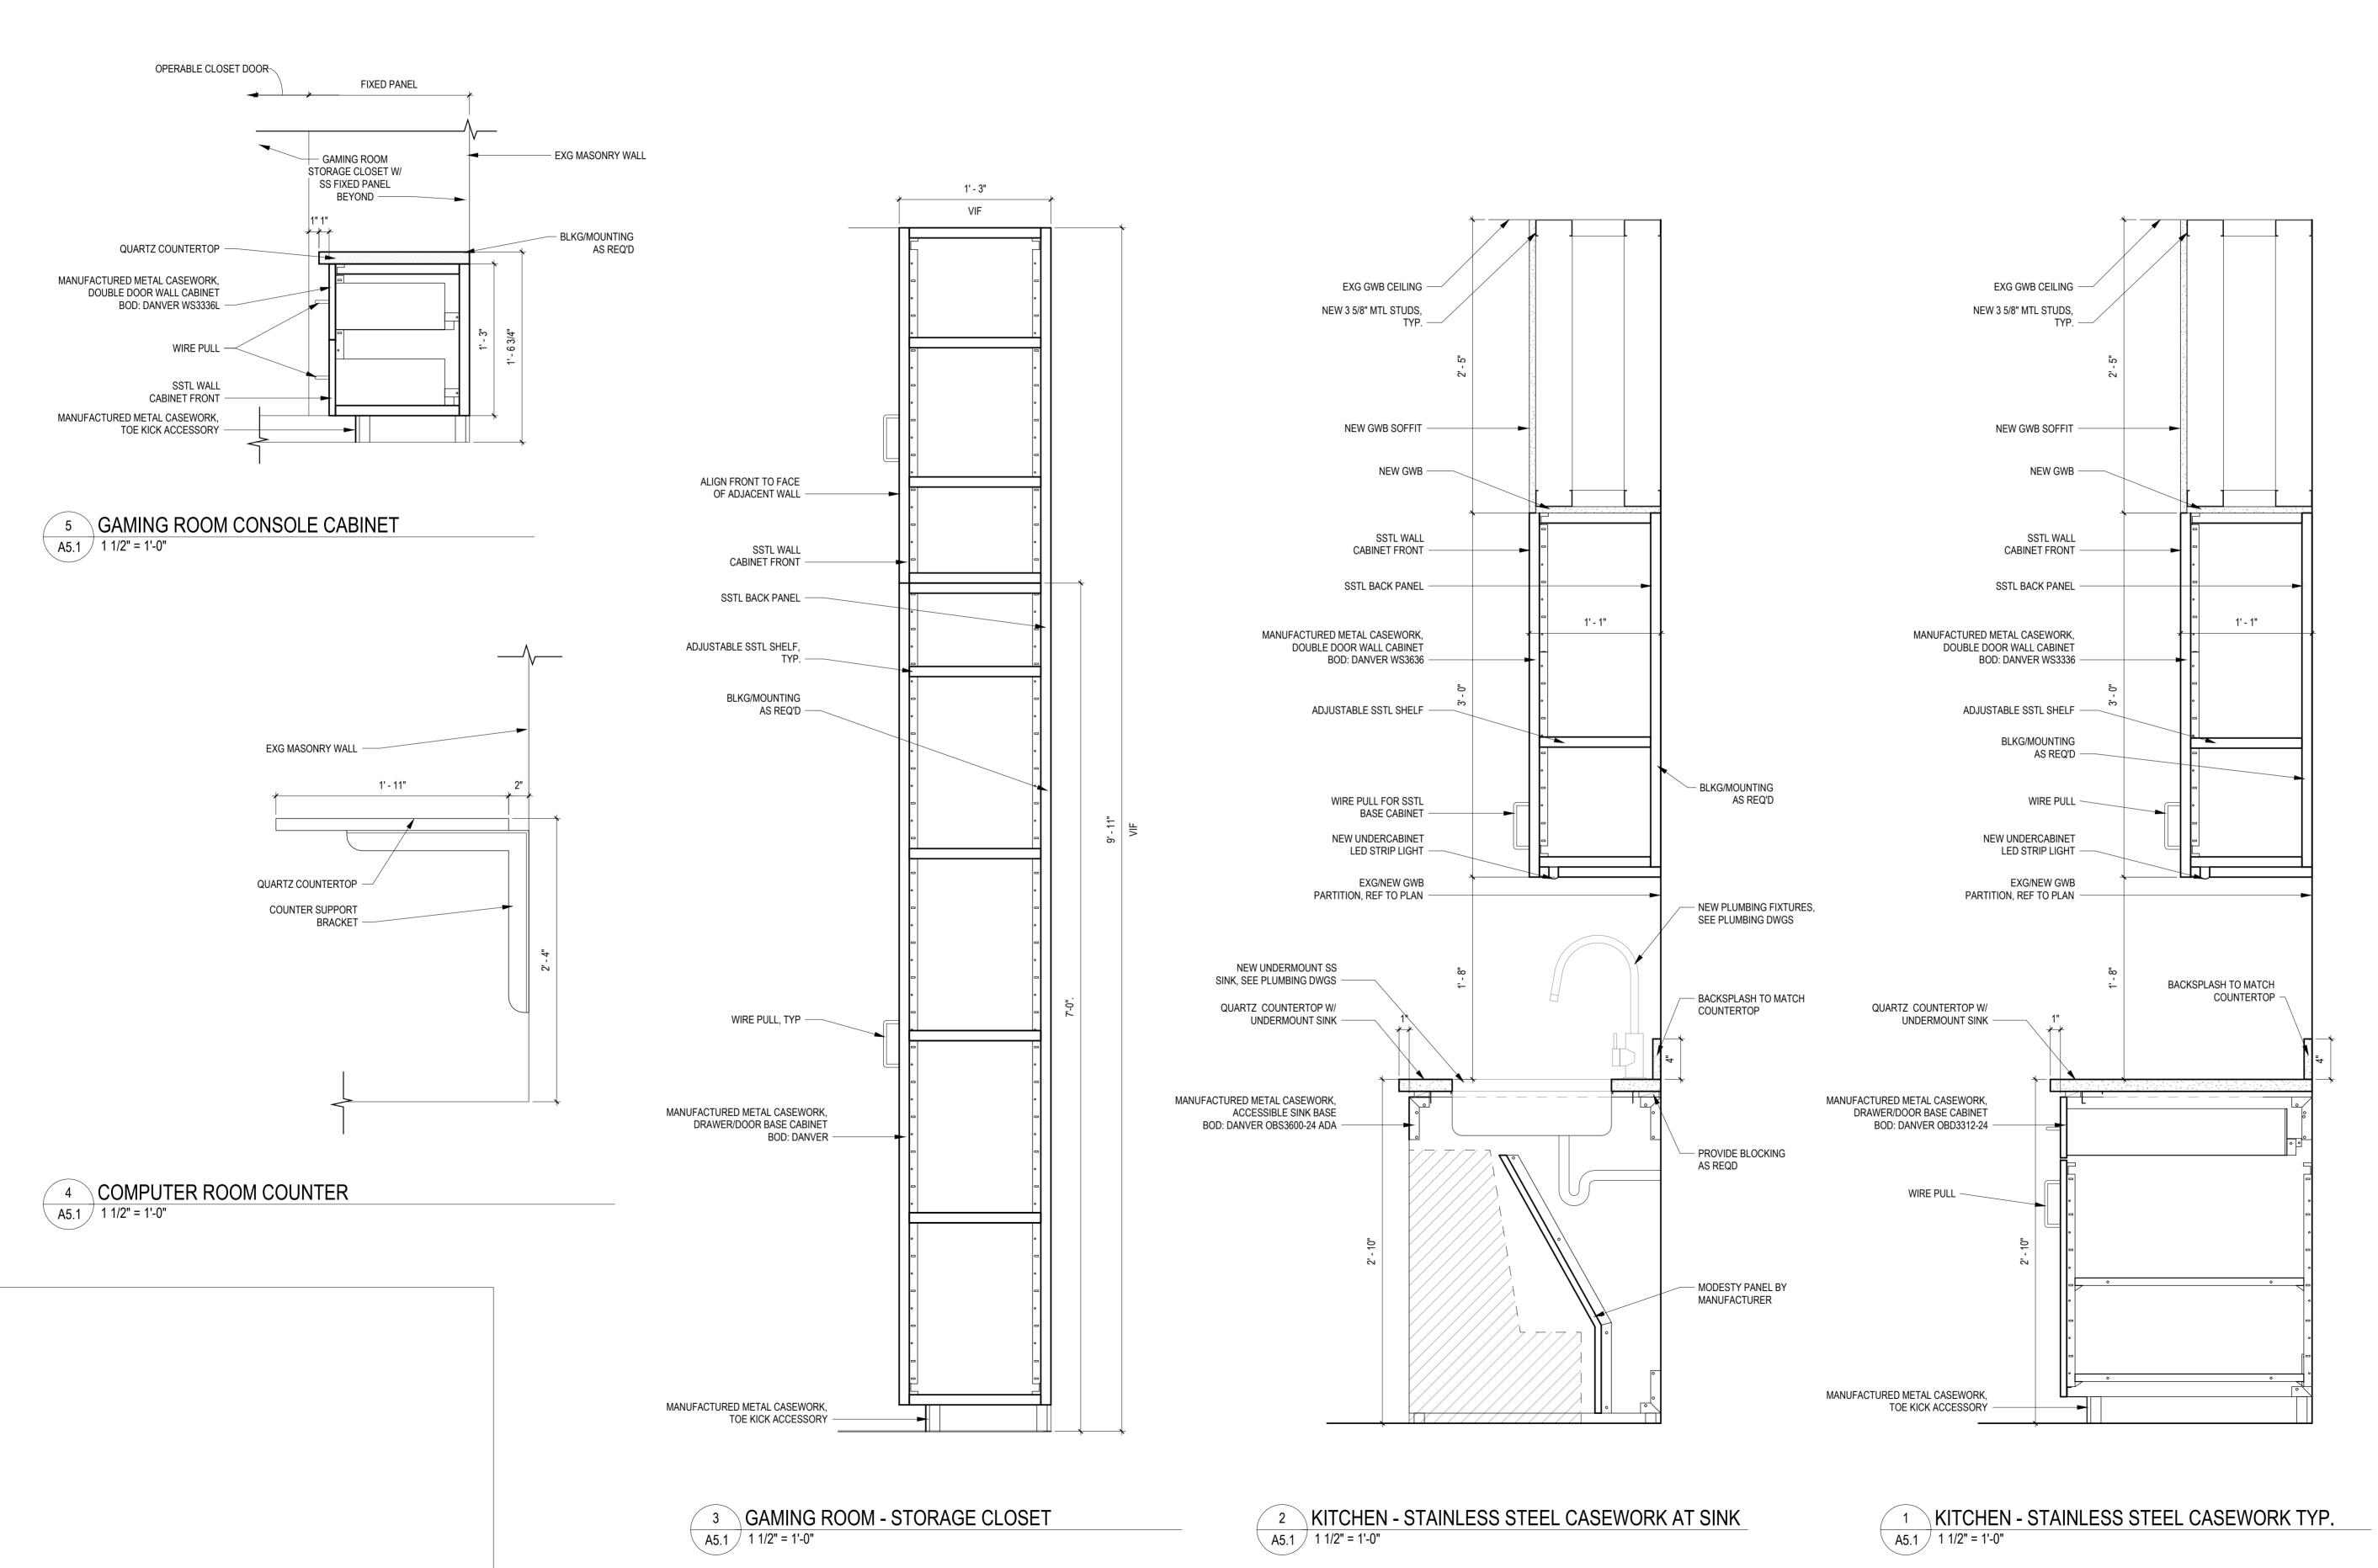

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CITY OF PHILADELPHIA
DEPARTMENT OF PARKS & RECREATION

1515 ARCH STREET 11TH FLOOR, ONE PARKWAY BUILDING

PHIA

RENOVATIONS TO THE HAPPY
HOLLOW RECREATION CENTER

DRAWING TITLE

CASEWORK DETAILS


PROJECT N	0.	DRAWING NO.
1	6315E-03-02	
DATE	05/13/2025	∃ A5 ′
SCALE	AS NOTED	
DRAWN BY	Author	
CHECKED B	Υ	


LEGEND:				GENERAL NOTES:
	EXG PRESSED METAL CEILING W/ 2' x 2' PANEL	(OC)	OCCUPANCY SENSOR - SEE MECH / ELEC DWGS	 FILL VOIDS AROUND PENETRATIONS AND JOINTS THROUGH NON-RATED PARTITIONS WITH MINERAL WOOL INSULATION AND SEAL AROUND THE OPENING WITH ACOUSTIC SEALANT. WHEN ARCHITECTURAL EQUIPMENT OR FINISHES INTERFERE WITH THE LOCATION OF RECEPTACLES, SWITCHES,
	EXG GYPSUM BOARD CEILING	M	FIRE HORN/STROBE - SEE ELEC DWGS	CONTROLS, ETC. COORDINATE WITH A/E PRIOR TO CUTTING OR INSTALLATION OF THE EQUIPMENT OR FINISH. 3. LOCATE INTERIOR AND EXTERIOR CONTROL JOINTS AS INDICATED ON THE ARCHITECTURAL DRAWINGS AND IN SPECIFICATIONS. COORDINATE FINAL LOCATIONS WITH ARCHITECT.
	EXG CEILING TO REPLACE, VERIFY EXTENTS IN FIELD	F	MANUAL PULL STATION	 PROVIDE CEMENTITIOUS FLOOR UNDERLAYMENT ON EXISTING CONCRETE SLAB WHERE REQUIRED UNDER NEW FINISHES. ALL EXG AND NEW METAL CEILINGS TO BE REPAINTED; PREPARE EXG AND NEW SURFACES AS NECESSARY TO PROVIDE SMOOTH/CONSISTENT FINISH.
	EXTENTS IN FIELD	(S)	SMOKE DETECTOR	 6. ALL EXG INT GLAZED BRICK AND MORTAR TO BE CLEANED AND FREE OF PAINT. 7. ALL INTERIOR GWB/PLASTER SURFACES TO BE REPAINTED; PREPARE EXG AND NEW SURFACES AS NECESSARY TO PROVIDE SMOOTH/CONSISTENT FINISH. EXG MURALS IN ACTIVITIES ROOM 106 TO BE PRESERVED AND EXCLUDED FROM
\odot	SUSPENDED ACTIVITIES ROOM FIXTURE - SEE LIGHTING DWGS	•	WALL OR CEILING MOUNTED ILLUMINATED EXIT SIGN - SEE LIGHTING DWGS	REPAINTING. 8. ALL EXG INTERIOR CMU TO BE REPAINTED. PREPARE EXG AND NEW SURFACES AS NECESSARY TO PROVIDE SMOOTH/CONSISTENT FINISH.
•	SUSPENDED LINEAR FIXTURE - SEE LIGHTING DWGS		WALL VRF UNIT - SEE MECH DWGS	 REPLACE ALL INTERIOR DOORS, FRAMES, AND HARDWARE WITH NEW HM DOORS, METAL FRAMES, AND HARDWARE U.N.O.; SEE DOOR SCHEDULE. REFER TO MEPFP DRAWINGS FOR ADDITIONAL INFO. REFER TO STRUC DRAWINGS FOR LOCATIONS OF NEW AND EXISTING STRUCTURE.
	SURFACE-MOUNTED LINEAR FIXTURE - SEE LIGHTING DWGS		EXHAUST FAN - SEE MECH DWGS	 REFER TO LANDSCAPE DRAWINGS FOR PLAYGROUND FURNISHINGS/EQUIPMENT. PATCH AND REPAIR HOLES LEFT FROM REMOVAL OF EXERCISE EXQUIPMENT. REPAINT SURFACES, TYP. ALL DOWNSPOUTS ETR; PROVIDE NEW CAST IRON BOOTS, TYP FOR EACH EXG DOWNSPOUT.
	SURFACE-MOUNTED FIXTURE - SEE LIGHTING DWGS	Н	CEILING HEATER - SEE MECH DWGS	
0	SURFACE-MOUNTED FIXTURE - SEE LIGHTING DWGS		LINEAR SUPPLY DIFFUSER - SEE MECH DWGS	KEYED EXISTING NOTES EX-1 EXG WD CORNICE TO REMAIN, TYP, EXCEPT AT LOCATIONS NOTED FOR
	SURFACE-MOUNTED EXTERIOR FIXTURE - SEE LIGHTING DWGS		LINEAR RETURN GRILLE - SEE MECH DWGS	REPLACEMENT.
	UNDERCABINET LED STRIP LIGHT			KEYED CONSTRUCTION NOTES
	UNDERGADINET LED STRIF LIGHT			CN-8 PATCH / REPLACE EXG MTL CEILING AS INDICATED ON THE DRAWINGS; VERIFY CONDITIONS IN THE FIELD AND CONSU ARCHITECT ON THE EXTENTS

CN-9 PROVIDE NEW CEILING ACCESS PANEL TO MATCH EXISTING. PATCH / REPAIR CEILING AS NEEDED.

CN-40 PROVIDE NEW CONSOLE AND WALL CLOSET.

CN-54 PROVIDE NEW INT LIGHTING FIXTURES, TYP, SEE ELEC DWGS.

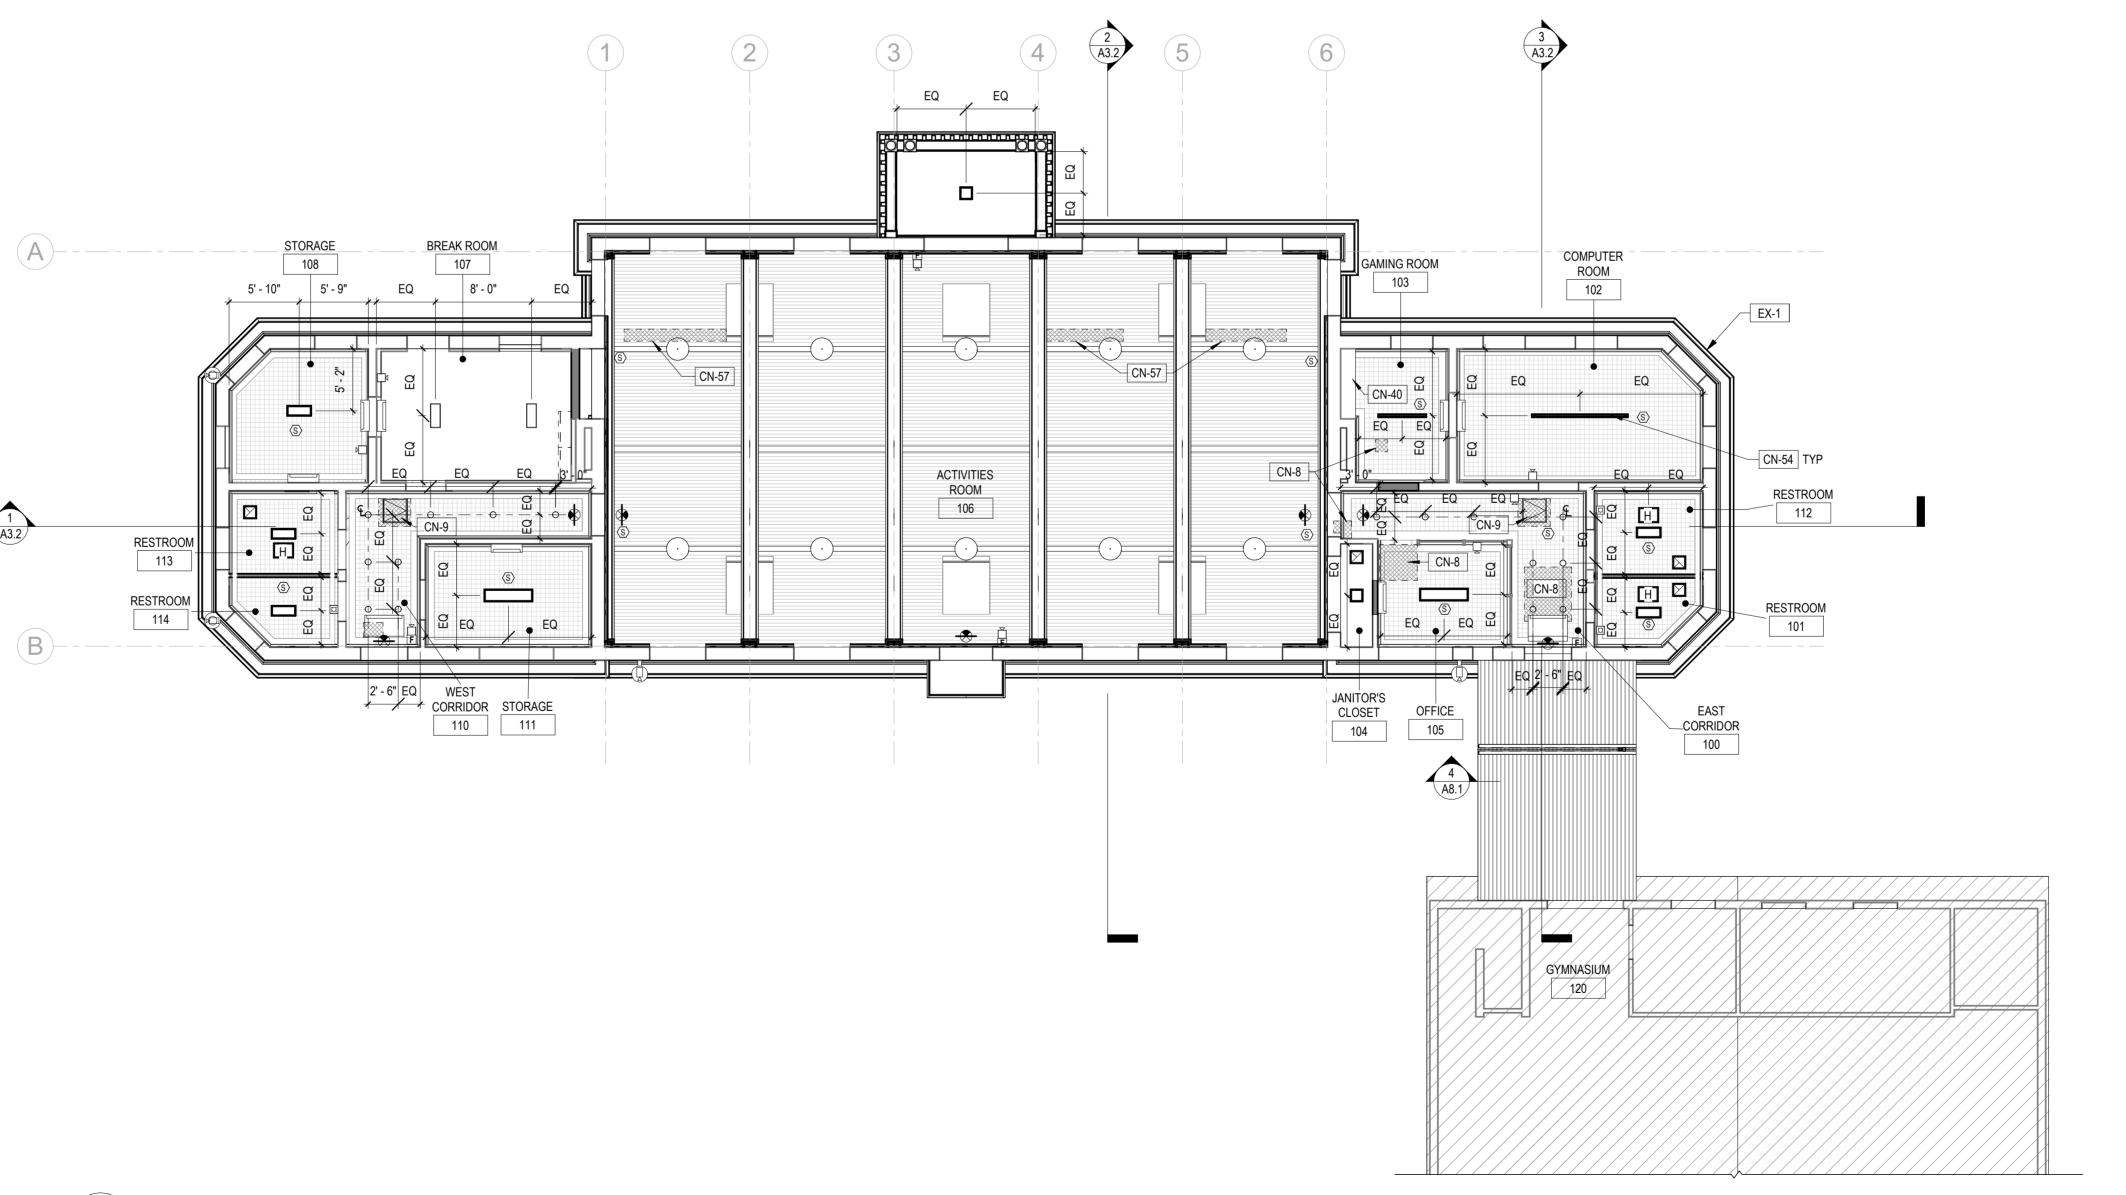

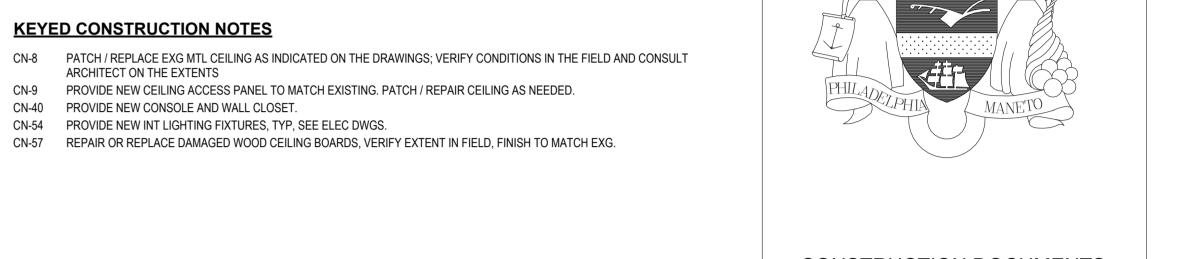

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CITY OF PHILADELPHIA DEPARTMENT OF PARKS & RECREATION

1515 ARCH STREET

11TH FLOOR, ONE PARKWAY BUILDING

RENOVATIONS TO THE HAPPY HOLLOW RECREATION CENTER

REFLECTED CEILING PLANS

16315E-03-02


Author

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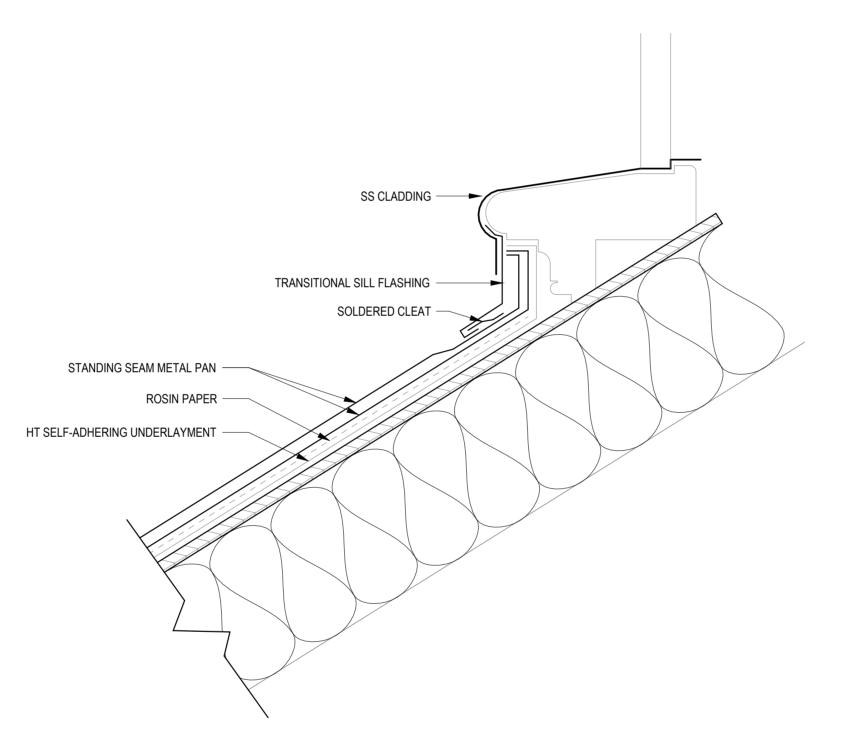
05/13/2025 AS NOTED

Checker ALL DIMENSIONS AND CONDITIONS SHALL BE VERIFIED BY THE CONTACTOR AT THE SITE BEFORE PROCEEDING WITH THE WORK

1 FIRST FLOOR RCP A6.0 1/8" = 1'-0"

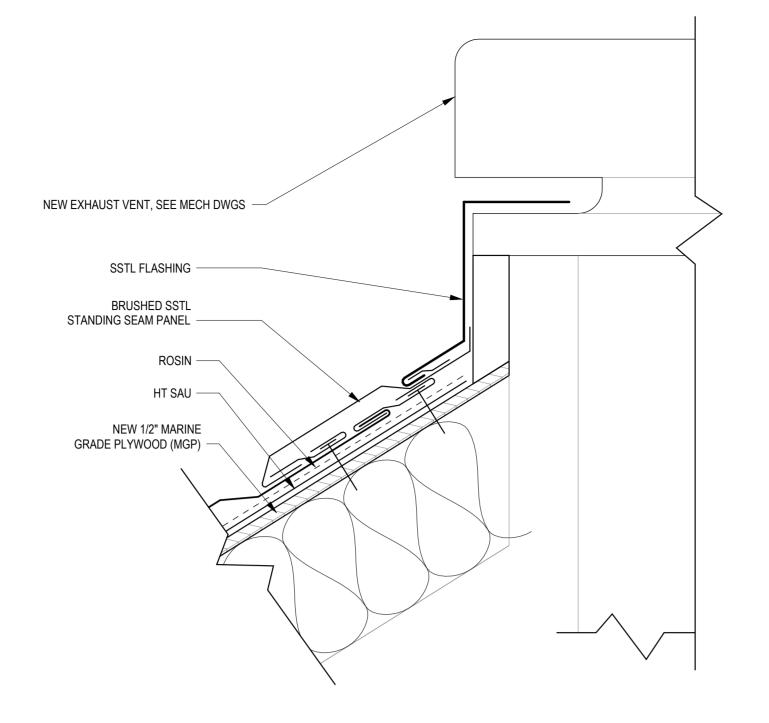

6 DETAIL AT EXHAUST VENT DETAIL



5 DORMER WINDOW SILL CLADDING DETAIL

8.0 3" = 1'-0"

PENETRATE EXG DECK AS

NECESSARY TO BLOW-IN INSULATION BETWEEN THE EXG

EXG ROOF DECK -

RAFTERS, PATCH OPENINGS


LOOSE INSULATION BLOWN-IN — BETWEEN EXG RAFTERS

EXG 3X6 RAFTER, TYP


EXG WD CEILING BOARDS -TO REMAIN IN PLACE

HIGH ROOF INSULATION DETAIL


ACTIVITIES ROOM INTERIOR

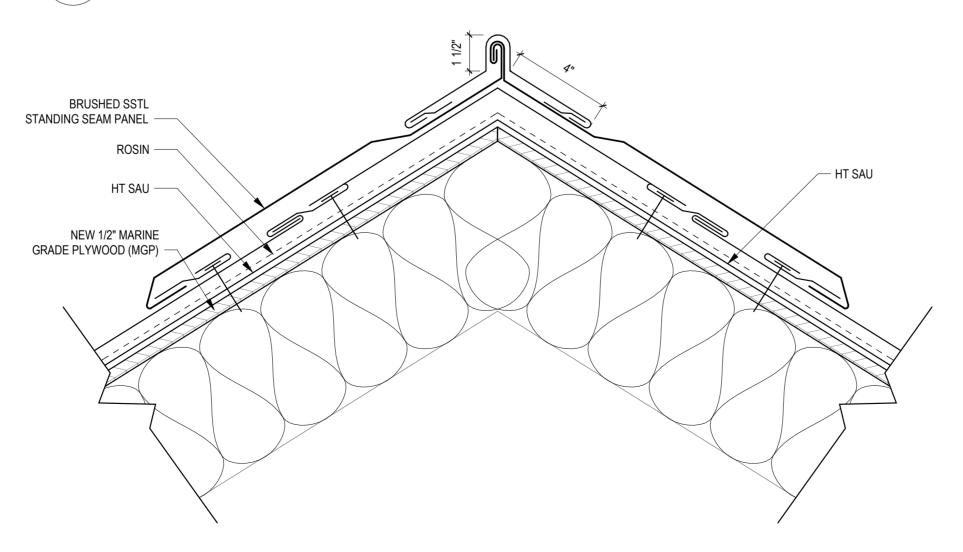


4 DETAIL AT ROOF HIP & RIDGE

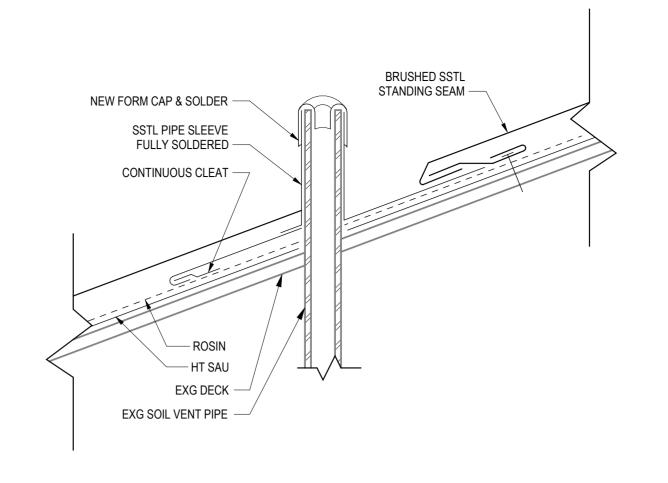

3 VENT PIPE DETAIL
A8.0 3" = 1'-0"

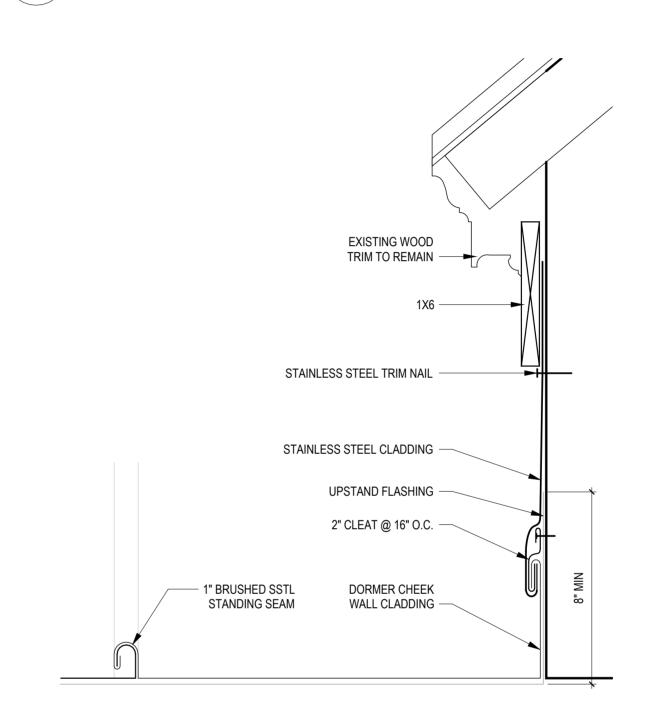

2 DORMER CHEEK WALL FLASHING DETAIL A8.0 3" = 1'-0"

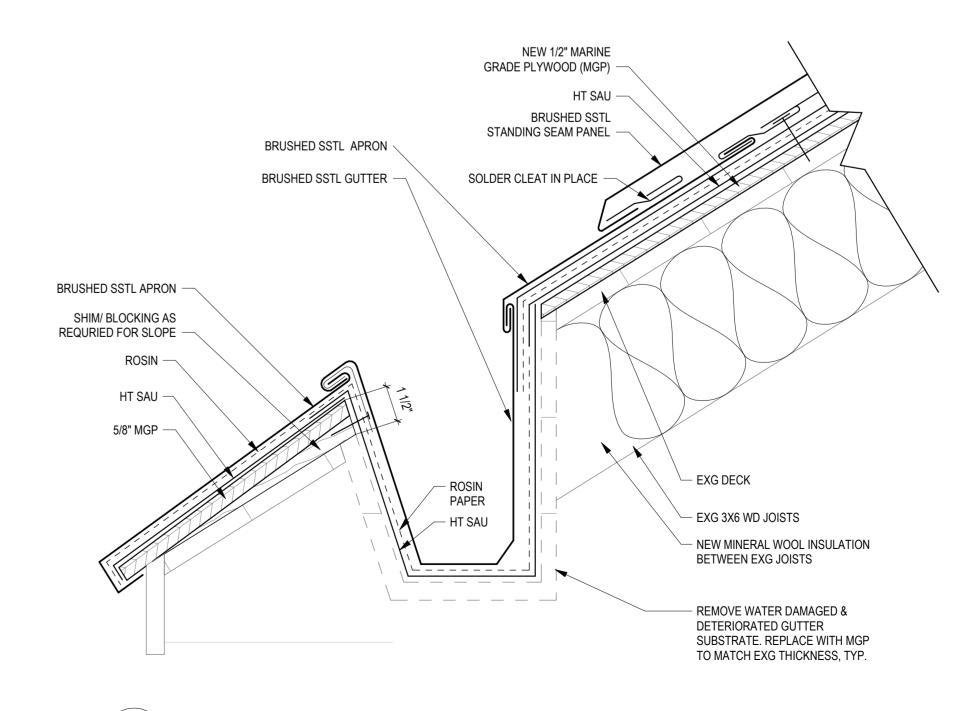

1 GUTTER DETAIL
A8.0 3" = 1'-0"

ISSUE DATE REVISIONS



CONSTRUCTION DOCUMENTS

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CITY OF PHILADELPHIA
DEPARTMENT OF PARKS & RECREATION

1515 ARCH STREET 11TH FLOOR, ONE PARKWAY BUILDING

11TH FLOOR, ONE PARKWAY BUILDING

LPHIA PENN

RENOVATIONS TO THE HAPPY HOLLOW RECREATION CENTER

ROOF DETAILS

16315E-03-02


DATE 05/13/2025

AS NOTED

Author

Checker

A8.0

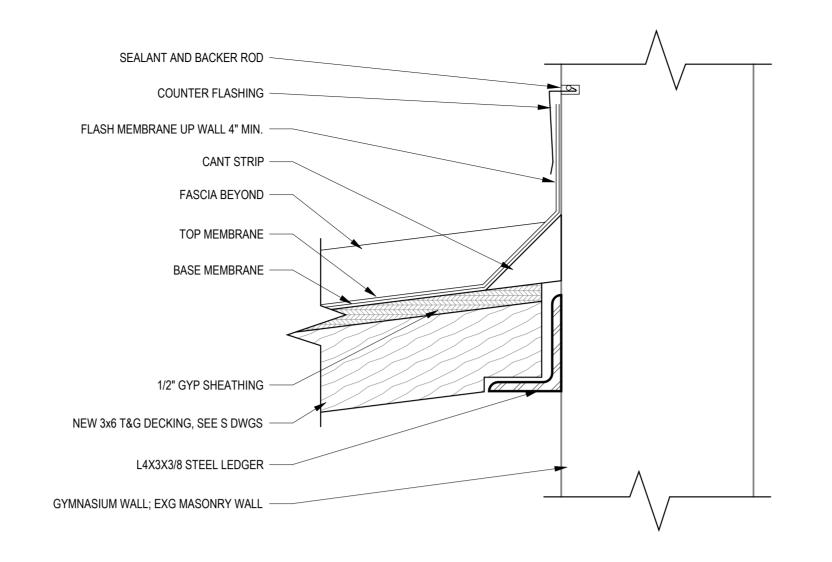



- ROOF DRAIN W/ DRAIN GUARD

NEW 3x6 T&G DECKING, SEE S DWGS

BREEZEWAY POST, SEE S DWGS

BREEZEWAY DETAIL AT COLUMNS

A8.1 3" = 1'-0"


BREEZEWAY GUTTER BEAM, SEE S DWGS

WD BLOCKING, MIN 1/4"/1'-0" SLOPE TOWARD DOWNSPOUT


— TOP MEMBRANE

- BASE MEMBRANE

- 1/2" GYP SHEATHING

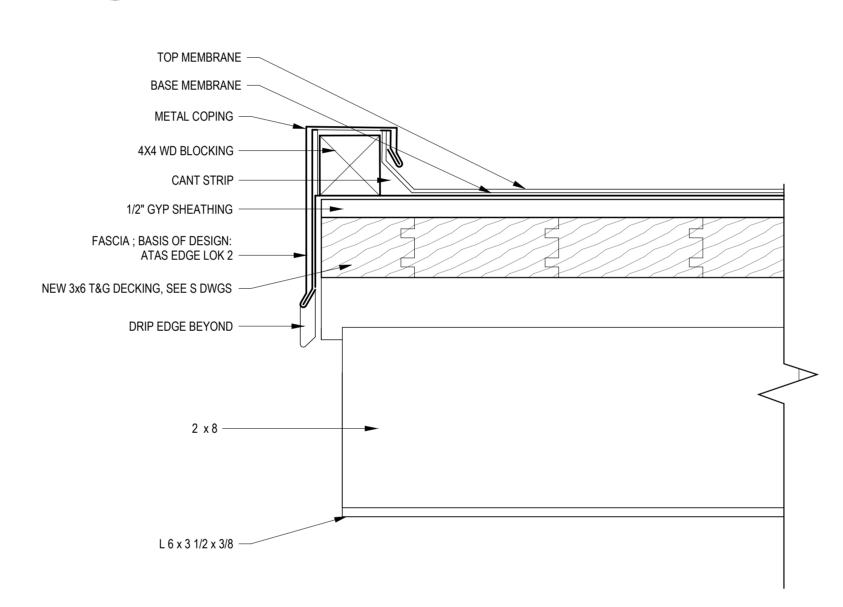

4 BREEZEWAY DETAIL @ FREE EDGE A8.1 3" = 1'-0"

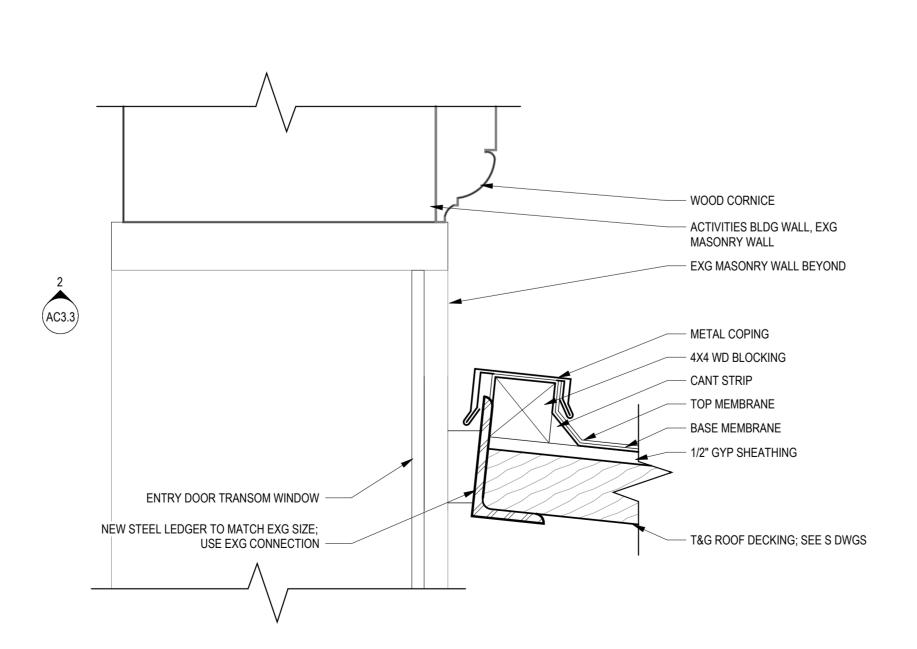

3 BREEZEWAY DETAIL AT ACTIVITIES BUILDING



PLAN KEY:

EXISTING CONSTRUCTION

TO REMAIN

NEW CONSTRUCTION


- 1. FILL VOIDS AROUND PENETRATIONS AND JOINTS THROUGH NON-RATED PARTITIONS WITH MINERAL WOOL INSULATION AND SEAL AROUND THE OPENING WITH ACOUSTIC SEALANT.
- 2. WHEN ARCHITECTURAL EQUIPMENT OR FINISHES INTERFERE WITH THE LOCATION OF RECEPTACLES, SWITCHES,
- CONTROLS, ETC. COORDINATE WITH A/E PRIOR TO CUTTING OR INSTALLATION OF THE EQUIPMENT OR FINISH. 3. LOCATE INTERIOR AND EXTERIOR CONTROL JOINTS AS INDICATED ON THE ARCHITECTURAL DRAWINGS AND IN
- SPECIFICATIONS. COORDINATE FINAL LOCATIONS WITH ARCHITECT. 4. PROVIDE CEMENTITIOUS FLOOR UNDERLAYMENT ON EXISTING CONCRETE SLAB WHERE REQUIRED UNDER NEW
- 5. ALL EXG AND NEW METAL CEILINGS TO BE REPAINTED; PREPARE EXG AND NEW SURFACES AS NECESSARY TO PROVIDE
- SMOOTH/CONSISTENT FINISH. 6. ALL EXG INT GLAZED BRICK AND MORTAR TO BE CLEANED AND FREE OF PAINT.
- 7. ALL INTERIOR GWB/PLASTER SURFACES TO BE REPAINTED; PREPARE EXG AND NEW SURFACES AS NECESSARY TO PROVIDE SMOOTH/CONSISTENT FINISH. EXG MURALS IN ACTIVITIES ROOM 106 TO BE PRESERVED AND EXCLUDED FROM
- 8. ALL EXG INTERIOR CMU TO BE REPAINTED. PREPARE EXG AND NEW SURFACES AS NECESSARY TO PROVIDE SMOOTH/CONSISTENT FINISH.
- 9. REPLACE ALL INTERIOR DOORS, FRAMES, AND HARDWARE WITH NEW HM DOORS, METAL FRAMES, AND HARDWARE
- U.N.O.; SEE DOOR SCHEDULE. 10. REFER TO MEPFP DRAWINGS FOR ADDITIONAL INFO.
- 11. REFER TO STRUC DRAWINGS FOR LOCATIONS OF NEW AND EXISTING STRUCTURE.
- 12. REFER TO LANDSCAPE DRAWINGS FOR PLAYGROUND FURNISHINGS/EQUIPMENT. 13. PATCH AND REPAIR HOLES LEFT FROM REMOVAL OF EXERCISE EXQUIPMENT. REPAINT SURFACES, TYP.
- 14. ALL DOWNSPOUTS ETR; PROVIDE NEW CAST IRON BOOTS, TYP FOR EACH EXG DOWNSPOUT.


KEYED EXISTING NOTES

EX-1 EXG WD CORNICE TO REMAIN, TYP, EXCEPT AT LOCATIONS NOTED FOR REPLACEMENT.

KEYED CONSTRUCTION NOTES

- CN-16 PROVIDE NEW CONCRETE LANDING, STAIRS, AND RAMP WITH CURB AND RAILING; SEE CIVIL DWGS FOR GRADING, SEE L DWGS FOR DETAILS.
- CN-26 PROVIDE NEW BREEZEWAY ROOF DECKING AND ROOF MEMBRANE; SEE STRUCT DWGS.
- CN-27 PROVIDE NEW BREEZEWAY COLUMNS AND FOOTINGS; SEE S DWGS.
- CN-35 PROVIDE NEW HM SYSTEM, SEE DOOR TYPES & DETAILS.
- CN-47 PROVIDE NEW ROOF DRAIN WITH DRAIN GUARD, DOWNSPOUT & BOOT. NEW STORMWATER CONNECTION, SEE CIVIL

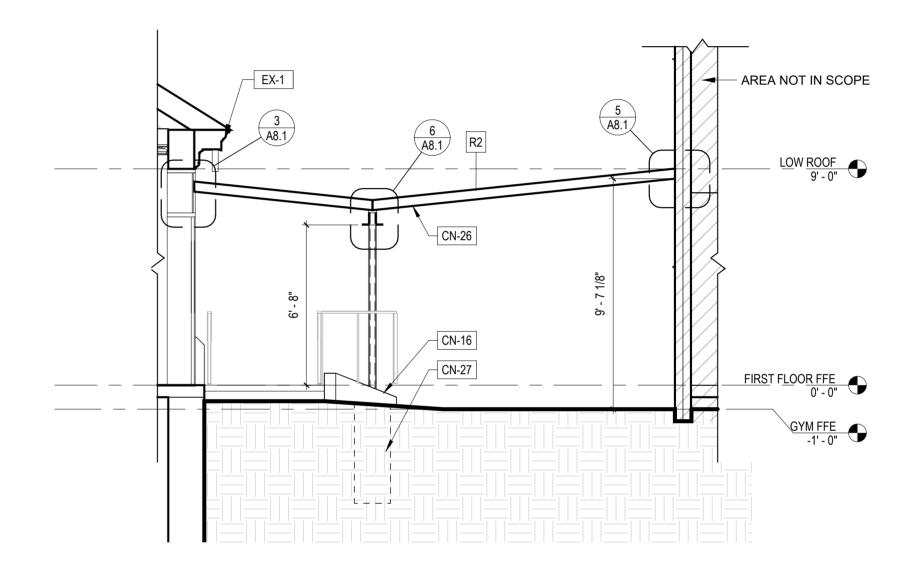

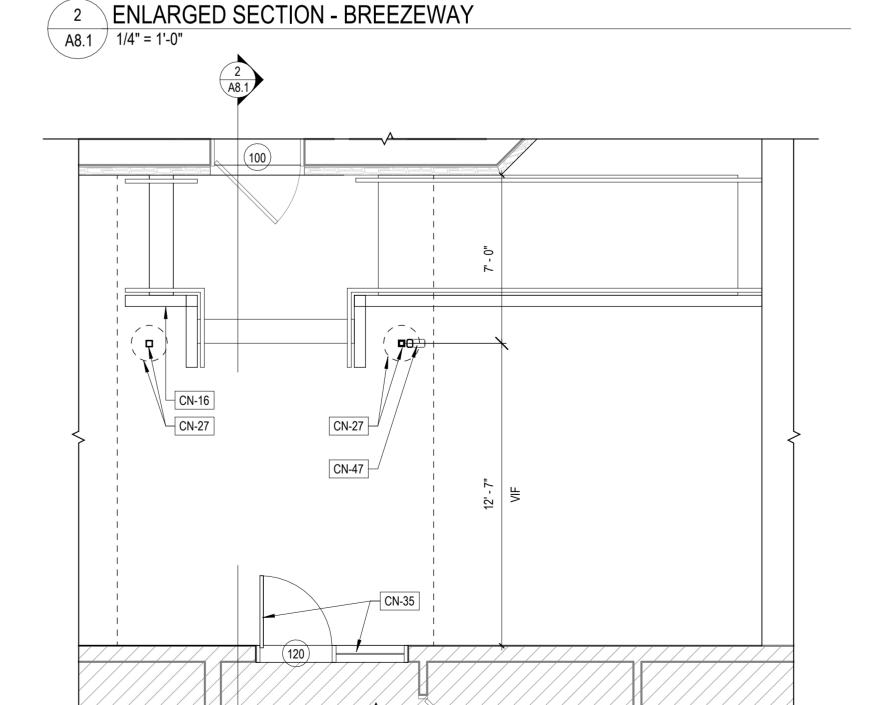

ENLARGED PLAN - BREEZEWAY FOOTINGS, STAIR & RAMP A8.1 1/4" = 1'-0"

REVISIONS ISSUE DATE REVISIONS



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CITY OF PHILADELPHIA DEPARTMENT OF PARKS & RECREATION


1515 ARCH STREET

11TH FLOOR, ONE PARKWAY BUILDING

RENOVATIONS TO THE HAPPY **HOLLOW RECREATION CENTER**

BREEZEWAY ENLARGED PLAN & **DETAILS**


16315E-03-02 05/13/2025 AS NOTED JS/SCR

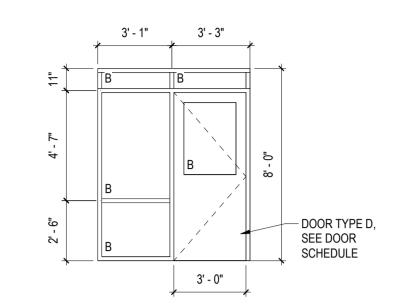


6 HM STOREFRONT TYPES

6E TYPICAL HEAD

A9.0 1/4" = 1'-0"

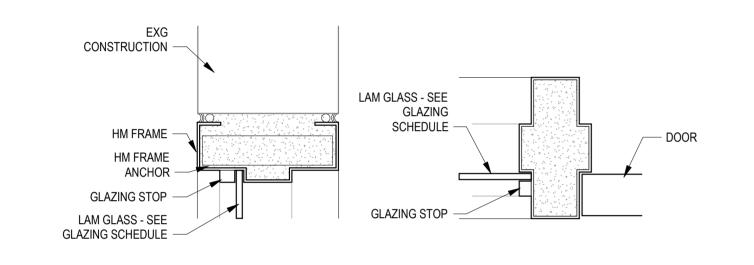

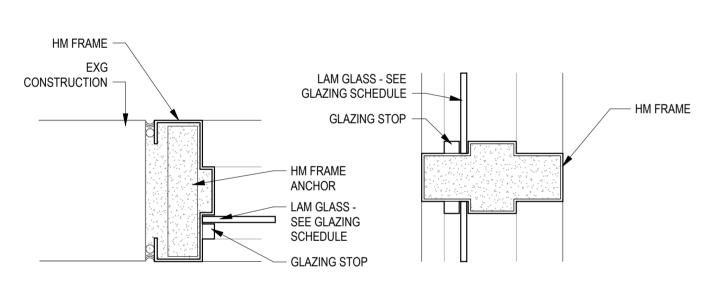


6D TYPICAL JAMB


6B HORIZONTAL MULLION


A9.0 3" = 1'-0"


6C SIDELIGHT JAMB

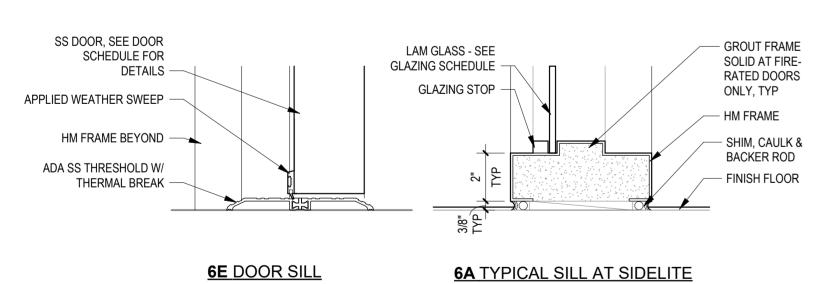


5 HM FRAMED GLAZING DETAILS

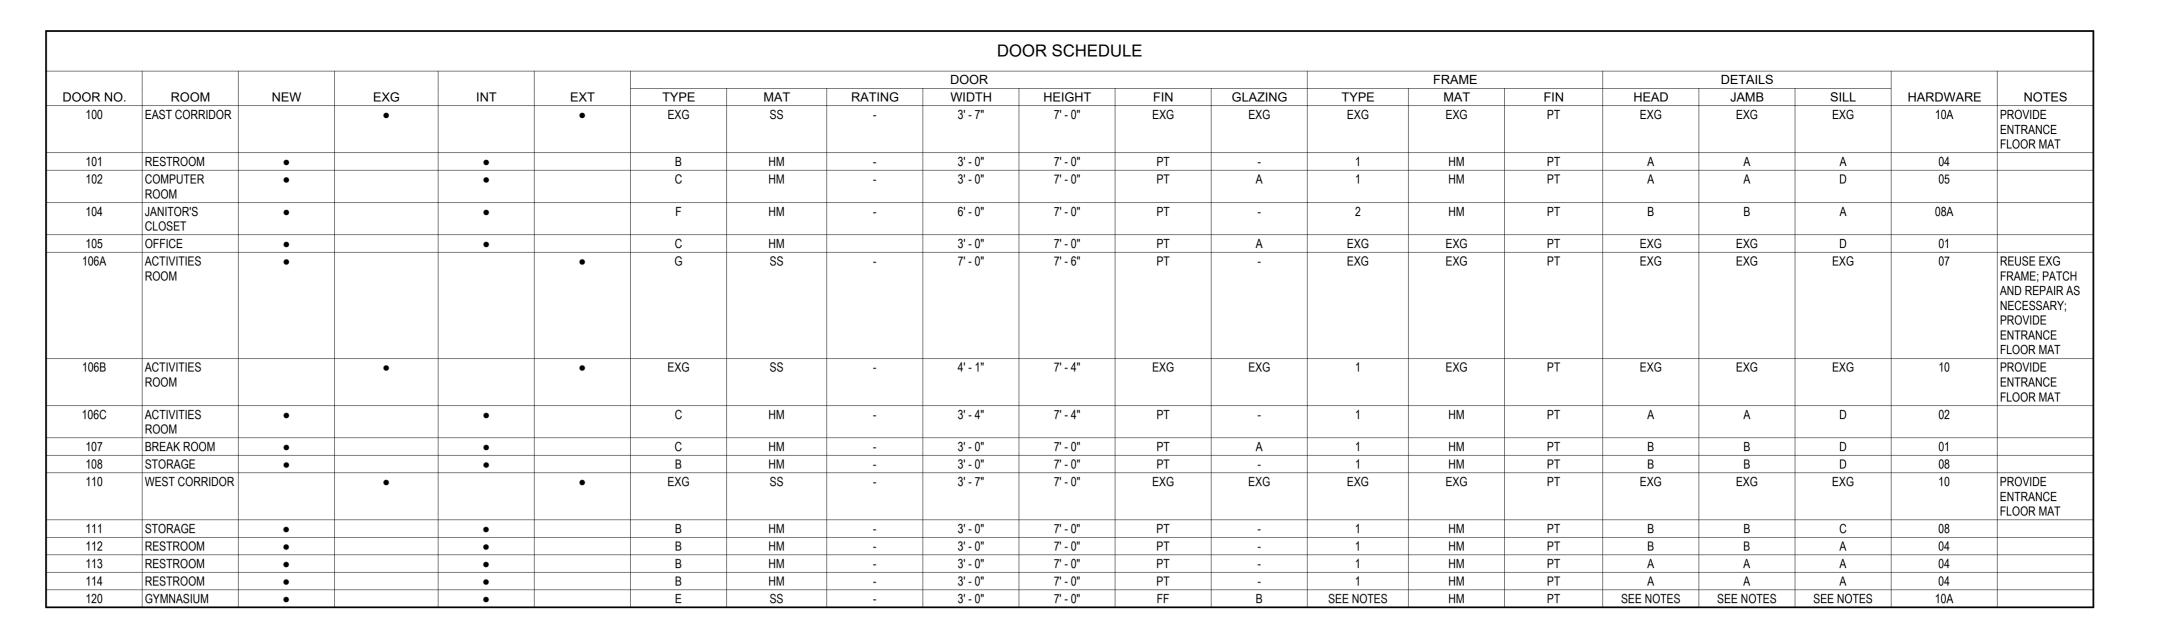

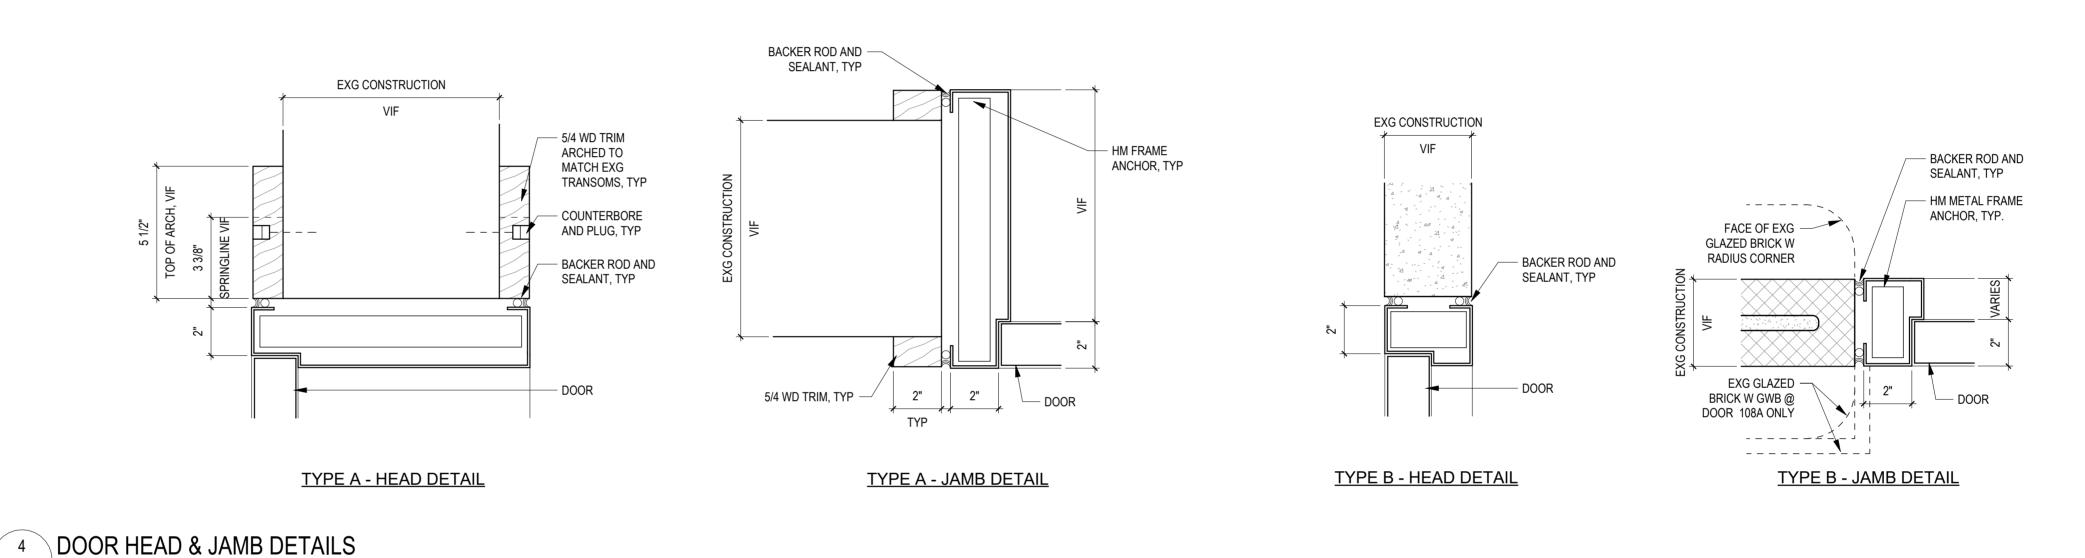

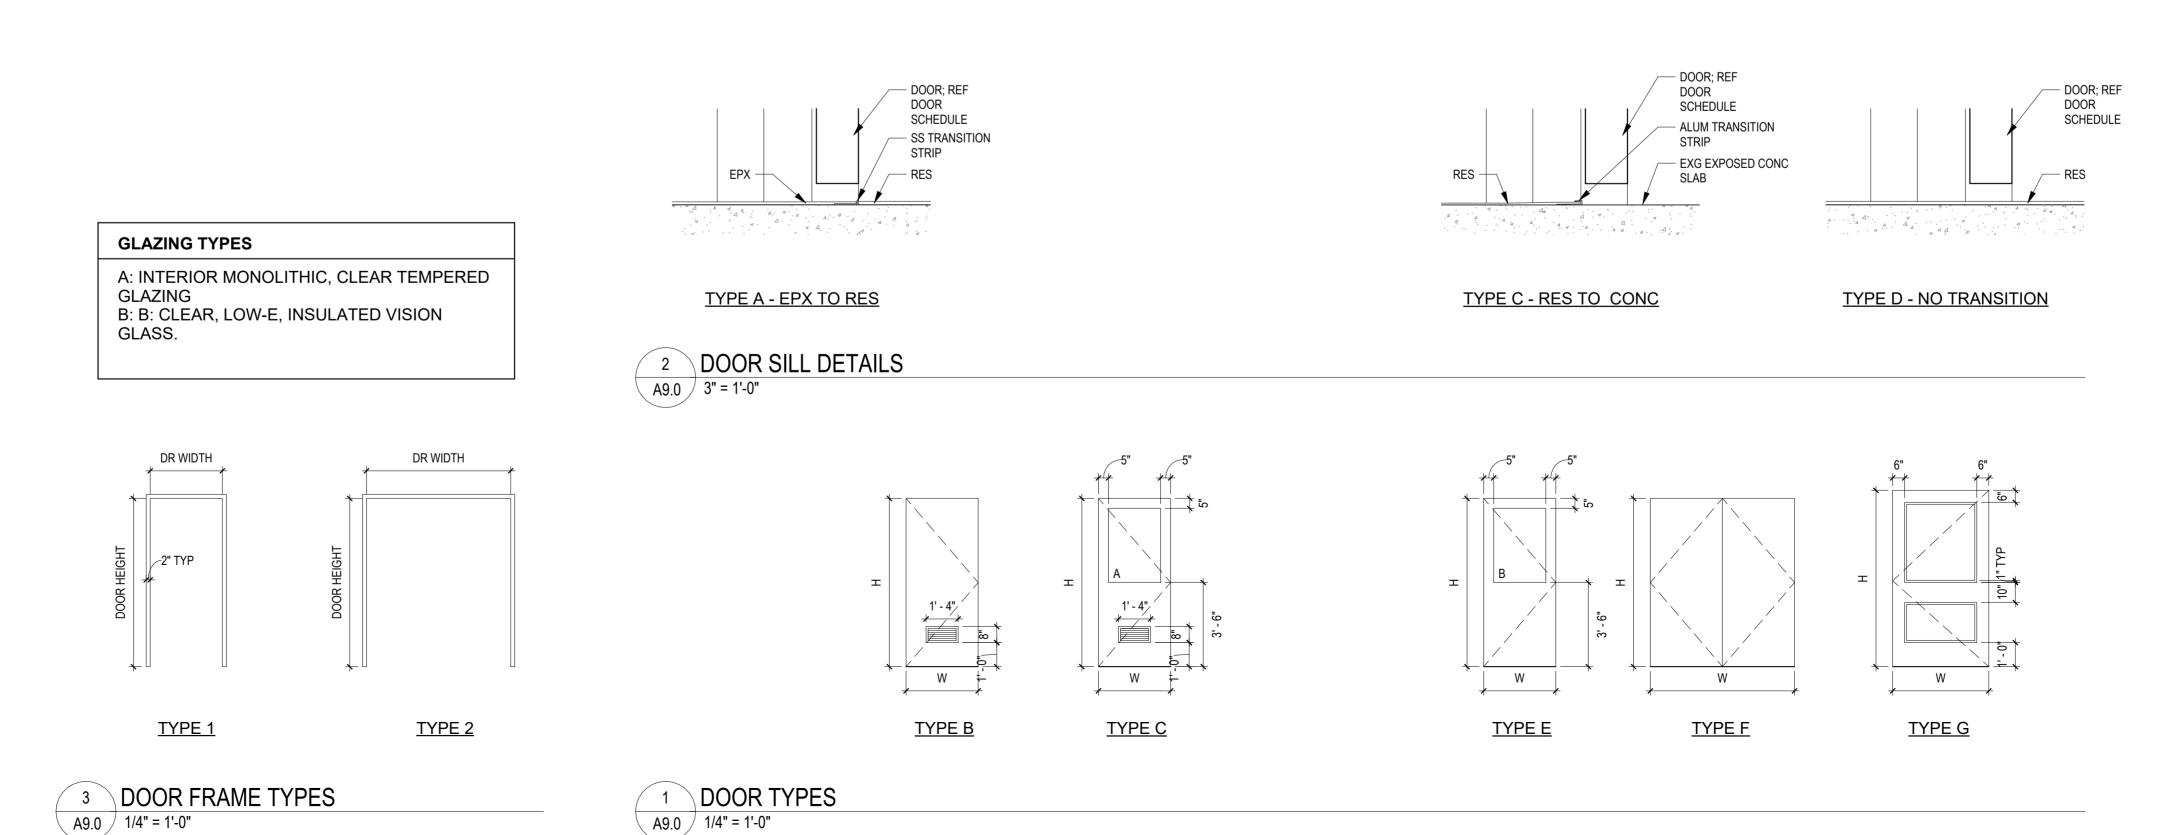

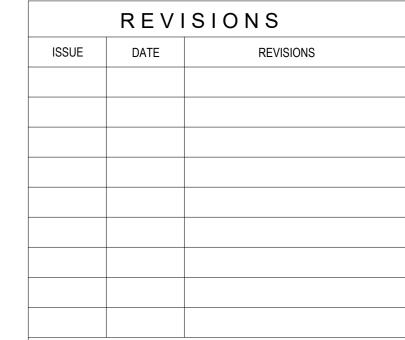



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CITY OF PHILADELPHIA
DEPARTMENT OF PARKS & RECREATION

1515 ARCH STREET

11TH FLOOR, ONE PARKWAY BUILDING

PHILADELPHIA
PROJECT TITLE

RENOVATIONS TO THE HAPPY HOLLOW RECREATION CENTER

DRAWING TITLE

DOOR SCHEDULE, TYPES & DETAILS

,	16315E-03-02	
DATE	05/13/2025	
SCALE	AS NOTED	

JS/SCR


SCR/TW

PROJECT NO.

DRAWN BY


CHECKED BY

A9.0

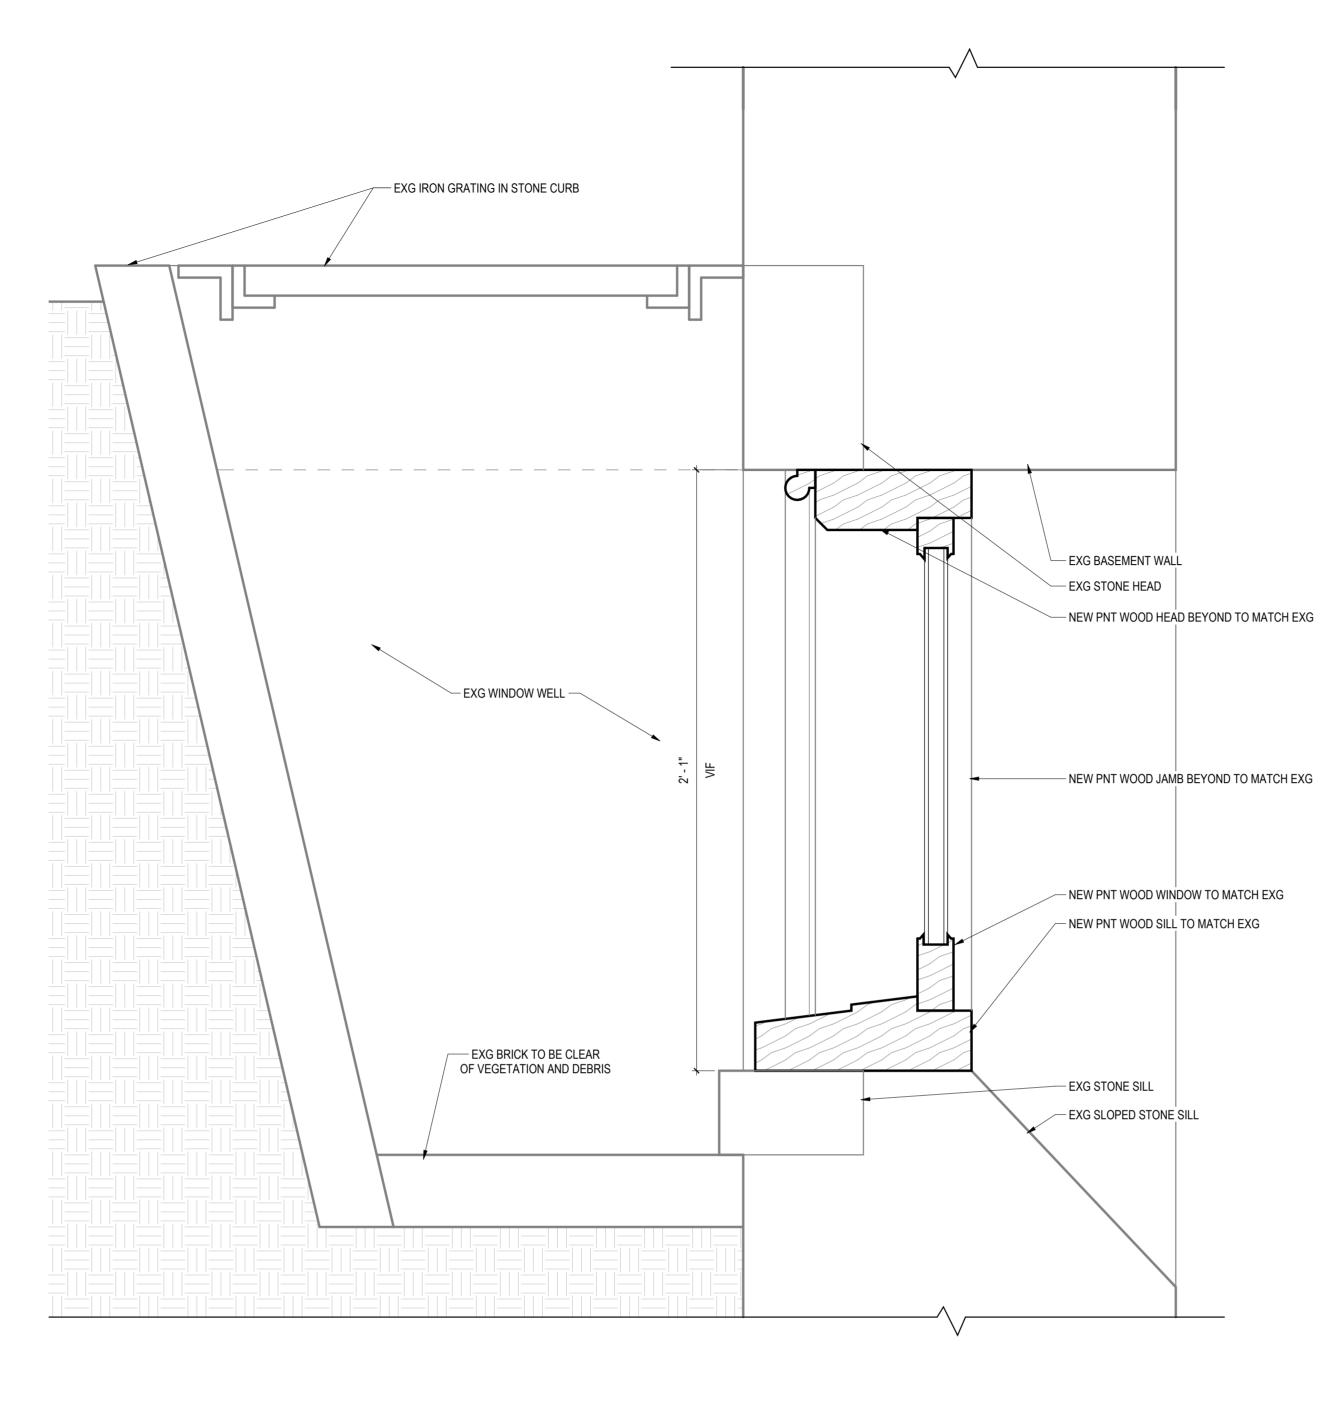


5 WINDOW TYPE W02 SILL & HEAD DETAIL


A9.1 3" = 1'

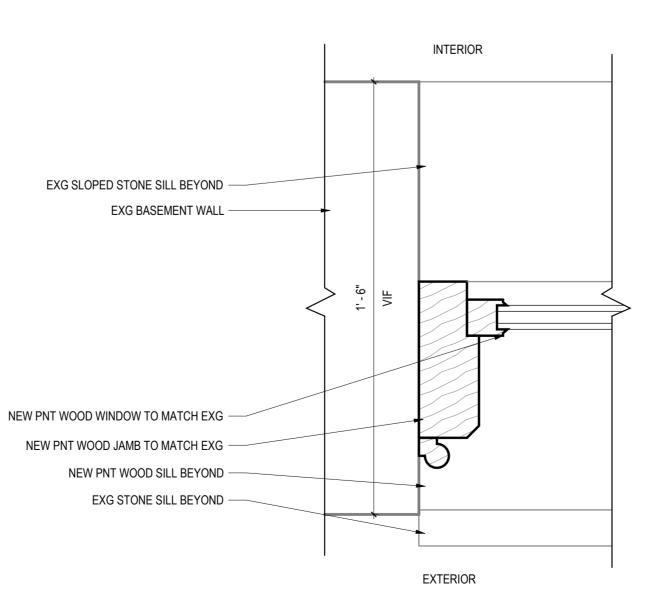

4 WINDOW TYPE W02 JAMB DETAIL
A9.1 3" = 1'-0"

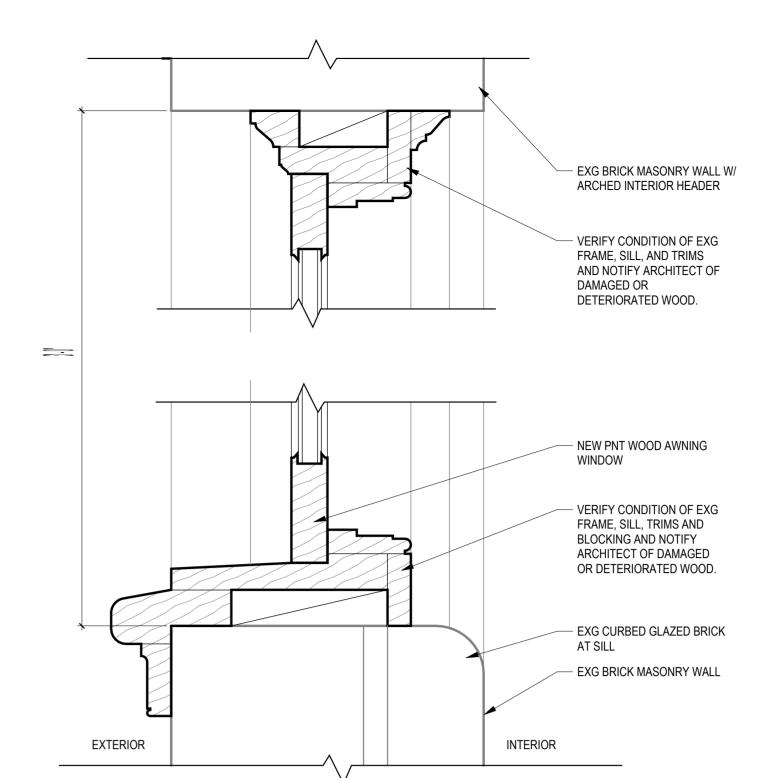


3 WINDOW TYPE W01 SILL & HEAD DETAIL
A9.1 3" = 1'-0"

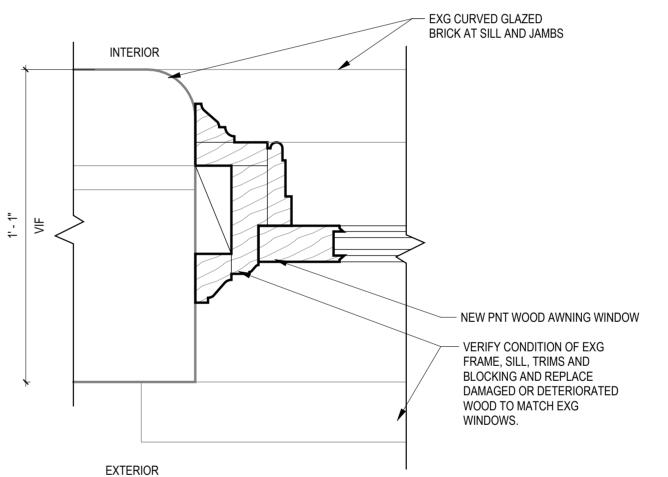


2 WINDOW TYPE W01 JAMB DETAIL A9.1 3" = 1'-0"

GLAZING TYPES

B: CLEAR, LOW-E, INSULATED VISION GLASS.

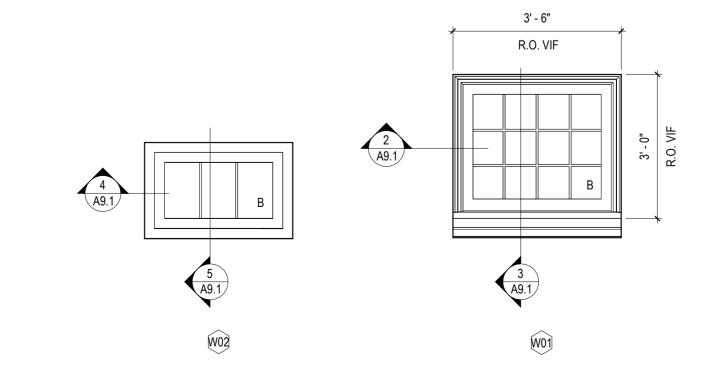

1 WINDOW TYPES
A9.1 1/2" = 1'-0"

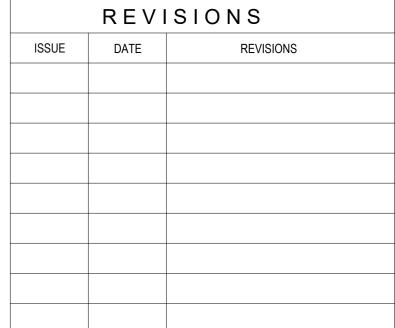



CONSTRUCTION DOCUMENTS

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SEALS



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CITY OF PHILADELPHIA
DEPARTMENT OF PARKS & RECREATION

1515 ARCH STREET
11TH FLOOR, ONE PARKWAY BUILDI

11TH FLOOR, ONE PARKWAY BUILDING

PHILADELPHIA

PENNS

PROJECT TITLE

RENOVATIONS TO THE HAPPY HOLLOW RECREATION CENTER

WINDOW TYPES & DETAILS

DATE 05/13/2025

SCALE AS NOTED

DRAWN BY SCR

CHECKED BY SCR/TW

CHECKED BY SCR/TW


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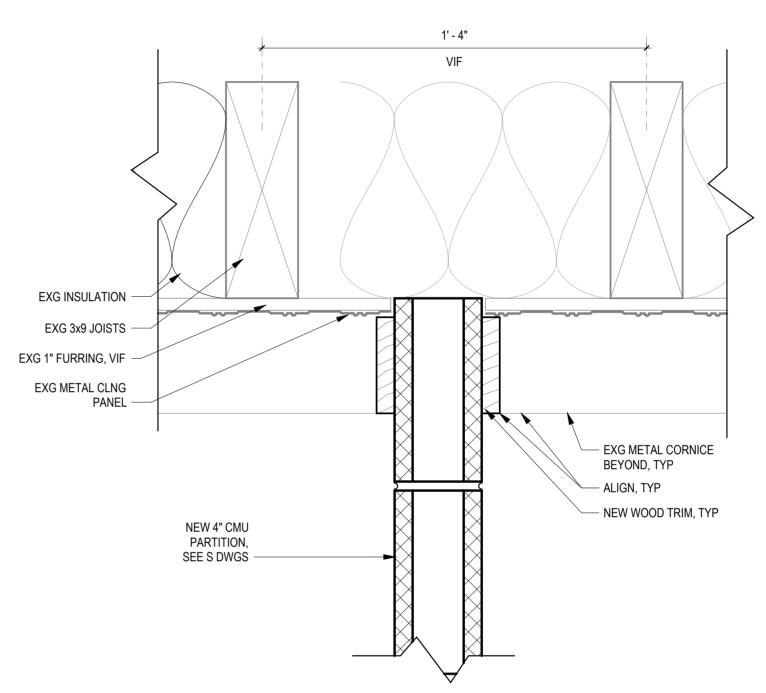
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DRAWING NO.


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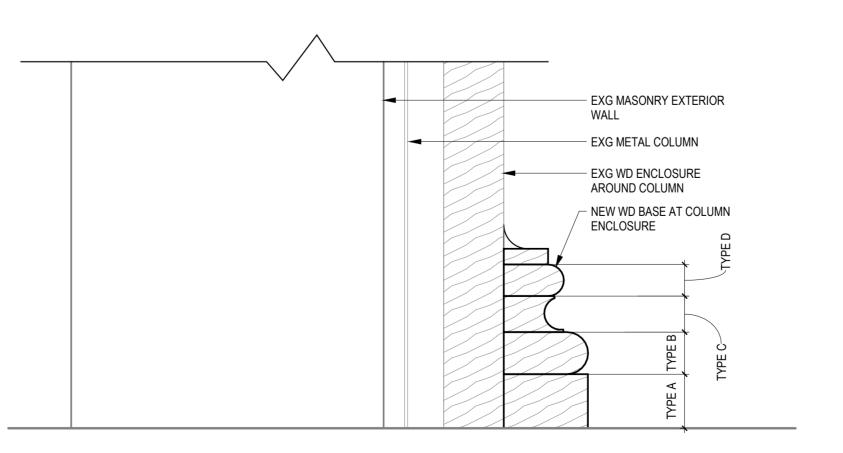
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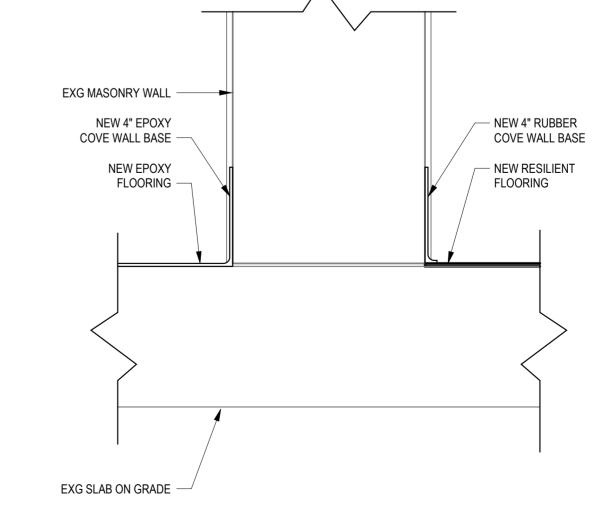


4 METAL CEILING INFILL WITH GRILLE




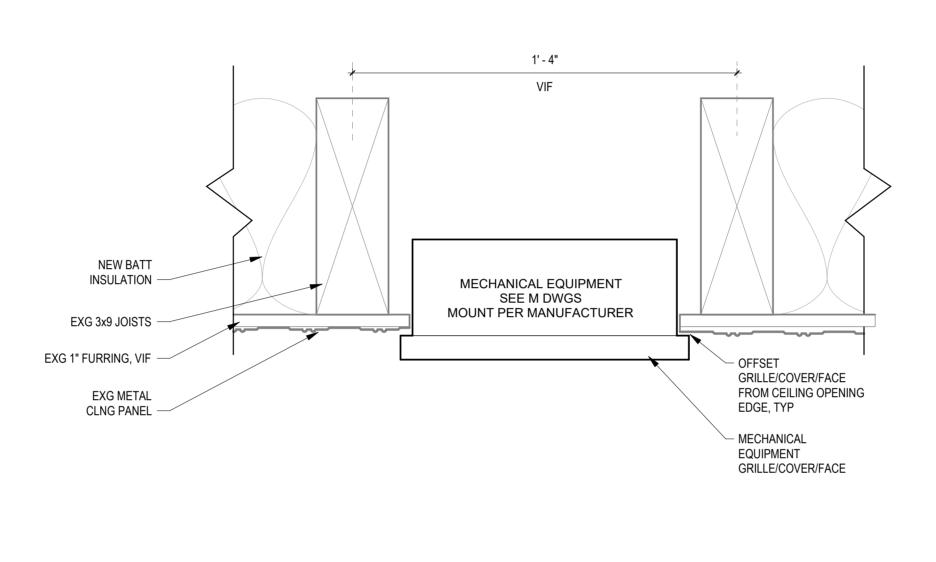

2 WOOD BASE AT COLUMN ENCLOSURE A10.0 3" = 1'-0"

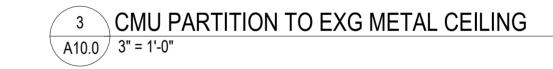

1 FLOORING AND BASE DETAILS

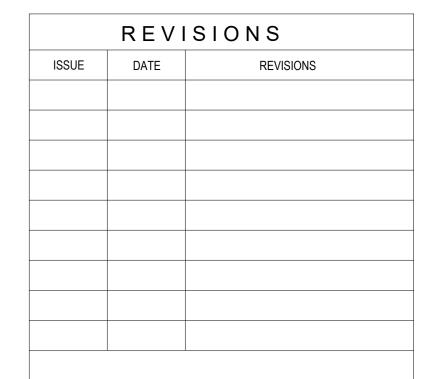



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PROJECT TITLE


RENOVATIONS TO THE HAPPY HOLLOW RECREATION CENTER


INTERIOR DETAILS


16315E-03-02


05/13/2025 AS NOTED


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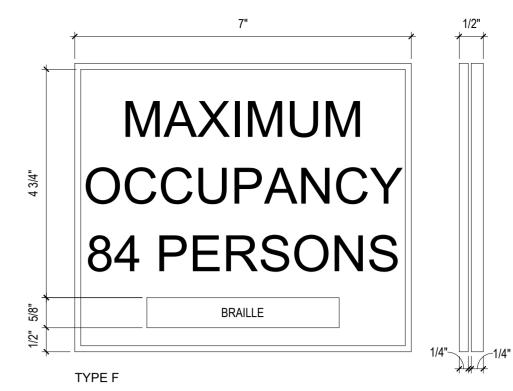
FINISH NOTES:

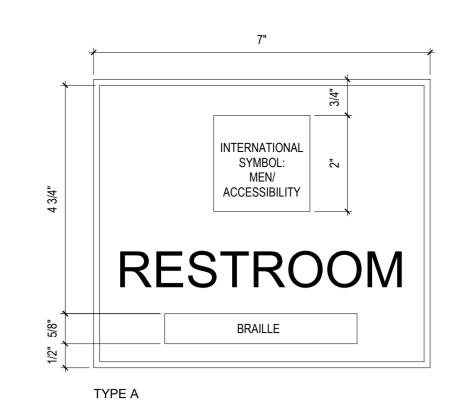RESTORATION MEASURES.

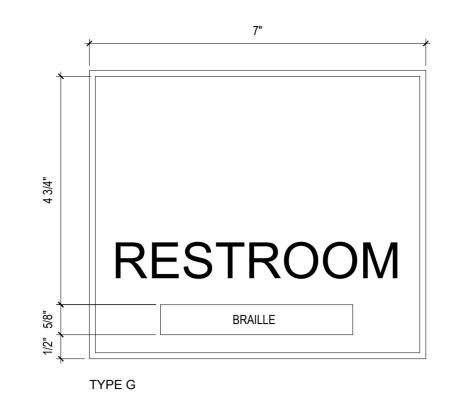5. PAINT NEW CONCRETE LINTEL 6. EXG MURAL TO BE PRESERVED

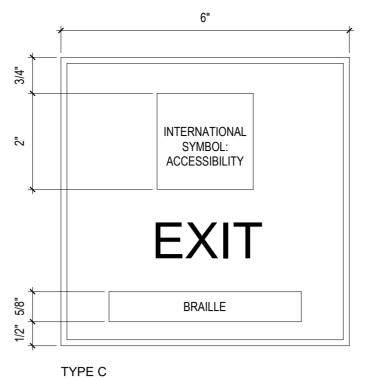KEYED EXISTING NOTES

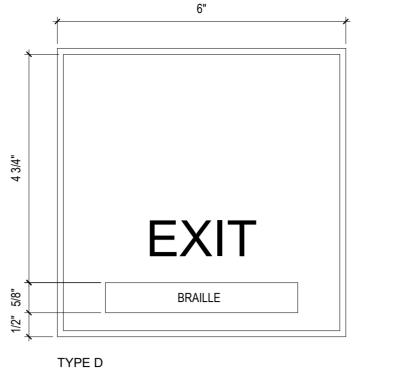EX-8 EXG WALL MURAL TO BE PRESERVED.

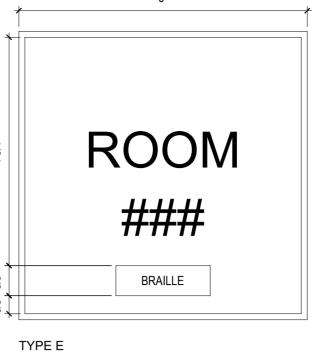

FINSH PLAN LEGEND:

EXISTING TO REMAIN

EPOXY FLOOR

1. ORIGINAL GLAZED BRICK TO REMAIN; REMOVE ALL EXG PAINT AND CONSULT ARCHITECT FOR ADDITIONAL

EXG SAFETY GLASS STOREFRONT TO REMAIN; PAINT FRAME, GLASS TO BE FREE OF PAINT AND ADHESIVE.
 ORIGINAL WOOD CEILING TO REMAIN; REPLACE DAMAGED PLANKS WHERE INDICATED, SEE RCP AND VIF

ÁREA NOT IN SCOPE


EXTENTS OF DAMAGE; FINISH NEW WD TO MATCH EXG AND CONSULT ARCHITECT.


4. RB AT BRICK LOCATIONS ONLY; WD PILASTERS TO RECEIVE NEW WOOD BASE

² SIGNAGE TYPES A9.2 6" = 1'-0"

							FINIS	SH SCHEDULI								
	ROOM	FLOOR		BASE		NOF	RTH	EA	ST	SOL	JTH	WE	ST	CEII	LING	
NO	NAME	MAT	MAT	FIN	HT	MAT	FIN	MAT	FIN	MAT	FIN	MAT	FIN	MAT	FIN	NOTES
001	WEST BASEMENT	ETR	-	-	-	ETR	ETR	ETR	ETR	ETR	ETR	ETR	ETR	ETR	ETR	
002	EAST BASEMENT	ETR	-	-	-	ETR	ETR	ETR	ETR	ETR	ETR	ETR	ETR	ETR	ETR	
100	EAST CORRIDOR	RT 2	RB	-	4"	BRK	ETR	BRK	ETR	BRK / CMU	ETR / PT	BRK / CMU	ETR	MTL	PT	NOTE 1, 2, & 5
101	RESTROOM	EPX	EPX COVE	FF	4"	CMU	PT	BRK	ETR	BRK	ETR	BRK	ETR	MTL	PT	NOTE 1 & 5
102	COMPUTER ROOM	RT 2	RB	FF	4"	BRK	ETR	BRK	ETR	BRK	ETR	BRK	ETR	MTL	PT	NOTE 1
103	GAMING ROOM	ETR	ETR	-	-	BRK	PT	BRK	PT	BRK	PT	BRK	PT	MTL	PT	
104	JANITOR'S CLOSET	EPX	EPX COVE	FF	4"	CMU	PT	CMU	PT	BRK	PT	BRK	PT	GWB	PT	
105	OFFICE	RT2	RB	FF	4"	CMU / GLAZ	PT	CMU / GLAZ	PT	BRK	ETR	CMU	PT	MTL	PT	NOTES 1 & 2
106	ACTIVITIES ROOM	RT 1/RT 2	RB	FF	4"	BRK / PLAS	ETR / PT	BRK / PLAS	ETR / PT	BRK / PLAS	ETR / PT	BRK / PLAS	ET/PT	WD	ETR	NOTES 1, 3, 4 &
107	BREAK ROOM	ETR	ETR	-	-	GWB	PT	GWB	PT	GWB	PT	GWB	PT	GWB	PT	
108	STORAGE	ETR	-	-	-	BRK	PT	BRK	PT	BRK	PT	BRK	PT	MTL	PT	
110	WEST CORRIDOR	RT 2	RB	FF	4"	BRK	ETR	BRK / CMU	ETR / PT	BRK / CMU	ETR / PT	BRK	ETR	MTL	PT	NOTE 1
111	STORAGE	ETR	-	-	-	CMU	PT	BRK	PT	BRK / CMU	PT	CMU	PT	MTL	PT	
112	RESTROOM	EPX	EPX COVE	FF	4"	BRK	ETR	BRK	ETR	CMU	PT	BRK	ETR	MTL	PT	NOTE 1
113	RESTROOM	EPX	EPX COVE	FF	4"	BRK	ETR	BRK	ETR	BRK	ETR	BRK	ETR	MTL	PT	NOTE 1
114	RESTROOM															

SIGNAGE SCHEDULE						
DOOR NO. ROOM SIGN TYP						
FIRST FLOOR FFE						
100	EAST CORRIDOR	TYPE C				
101	RESTROOM	TYPE G				
106A	ACTIVITIES ROOM	TYPE F				
106B	ACTIVITIES ROOM	TYPE D				
106C	ACTIVITIES ROOM	TYPE E				
108	STORAGE	TYPE E				
110	WEST CORRIDOR	TYPE D				
111	STORAGE	TYPE E				
112	RESTROOM	TYPE A				
113	RESTROOM	TYPE A				
114	RESTROOM	TYPE G				
107	BREAKROOM	TYPE E				
105	JANITOR'S CLOSET	TYPE E				
104	OFFICE	TYPE E				
102	COMPUTER ROOM	TYPE E				

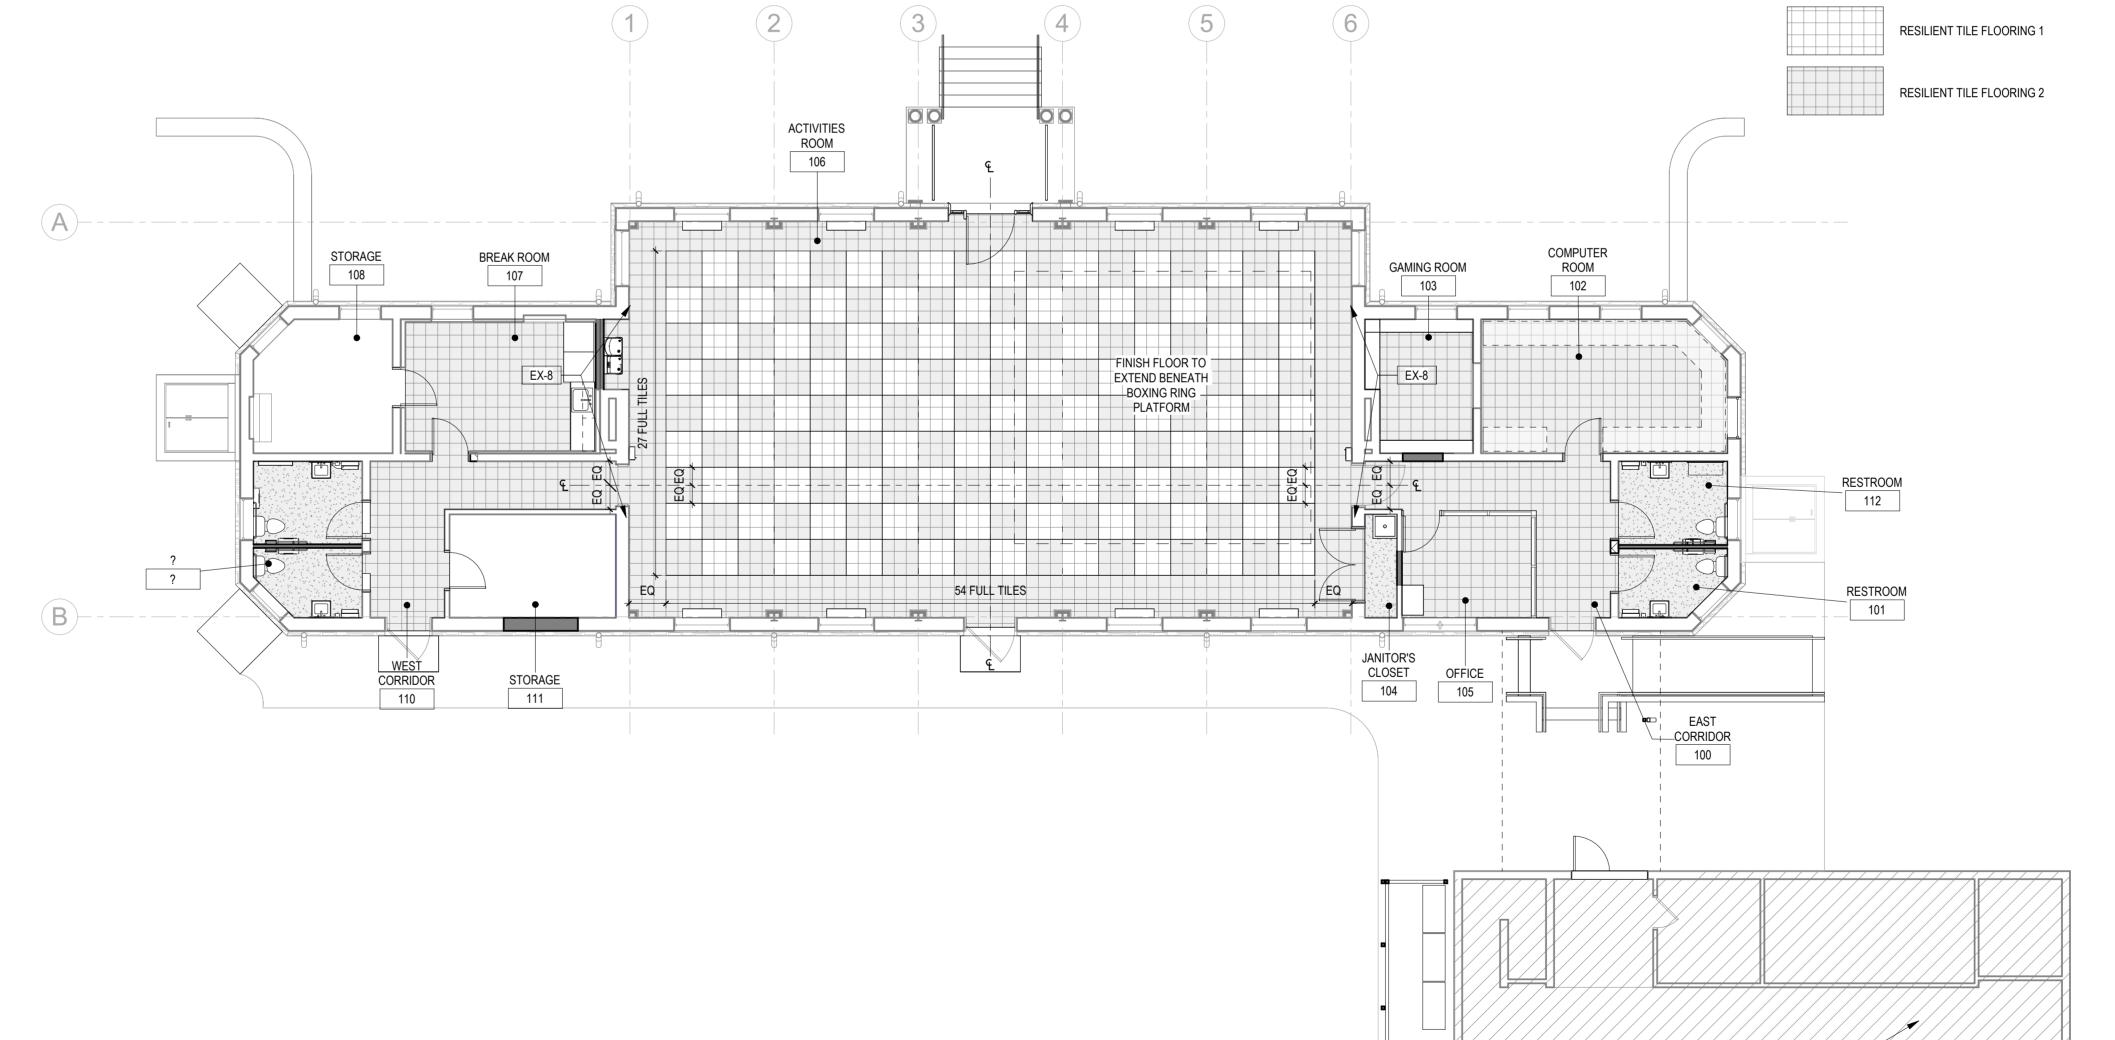

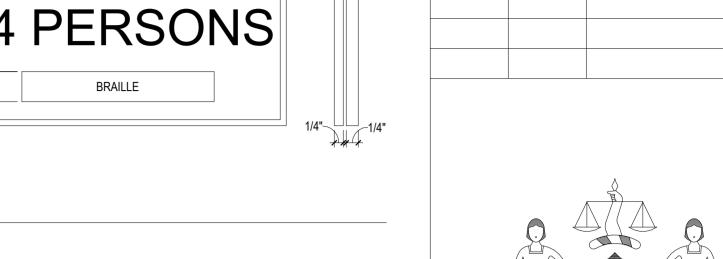



REVISIONS

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ISSUE

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CITY OF PHILADELPHIA DEPARTMENT OF PARKS & RECREATION

1515 ARCH STREET 11TH FLOOR, ONE PARKWAY BUILDING


RENOVATIONS TO THE HAPPY HOLLOW RECREATION CENTER

FINISH PLANS & SCHEDULE, SIGNAGE


16315E-03-02 AS NOTED


> SCR/TW ALL DIMENSIONS AND CONDITIONS SHALL BE VERIFIED BY THE CONTACTOR AT THE SITE BEFORE PROCEEDING WITH THE WORK

1 FIRST FLOOR

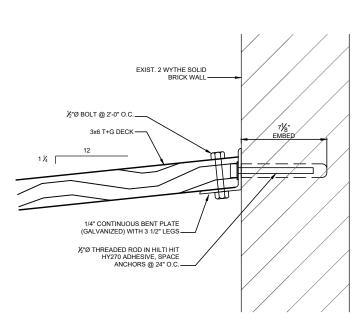





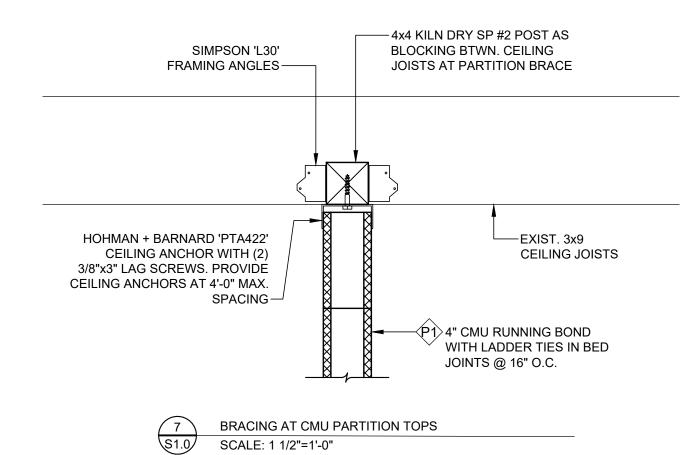


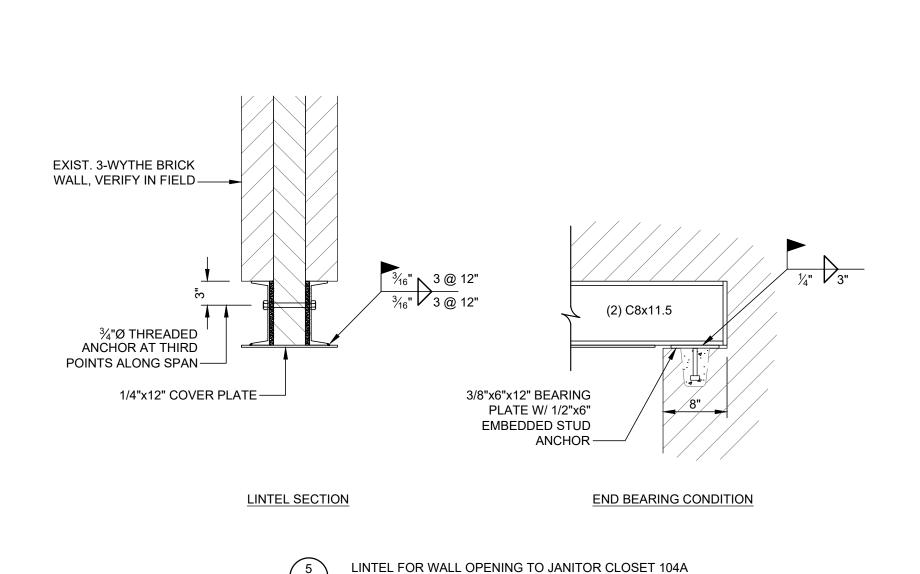



SCALE: 1"=1'-0"

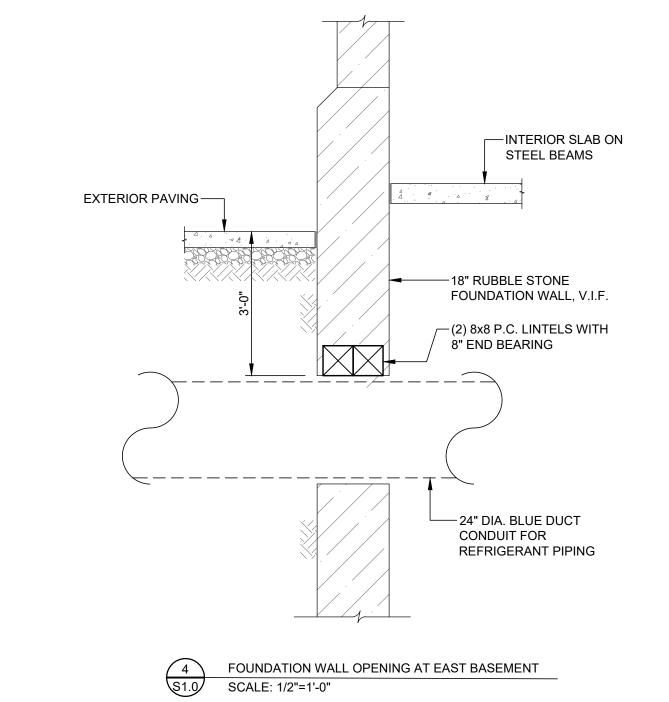

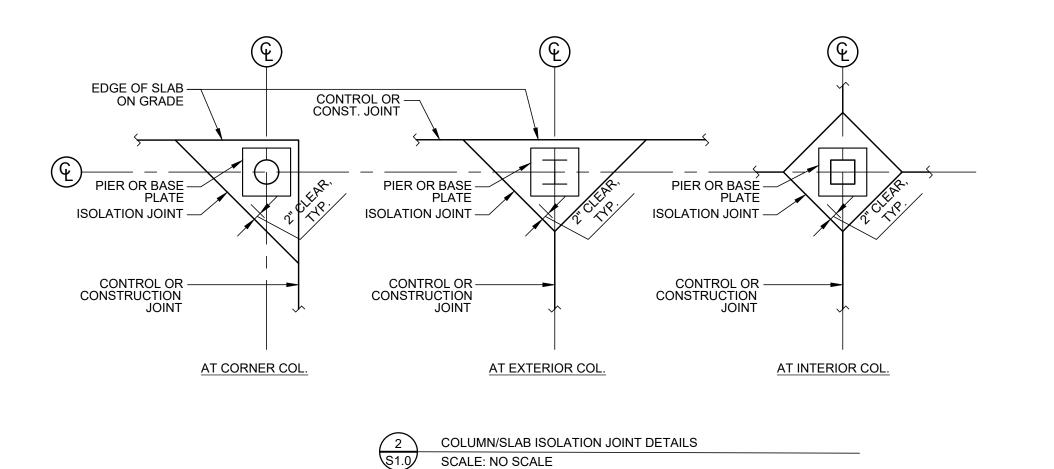

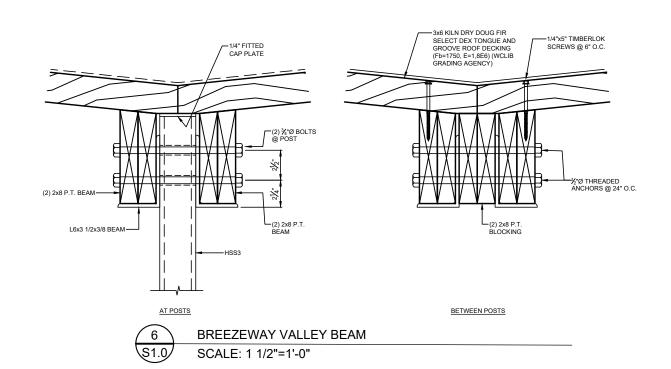

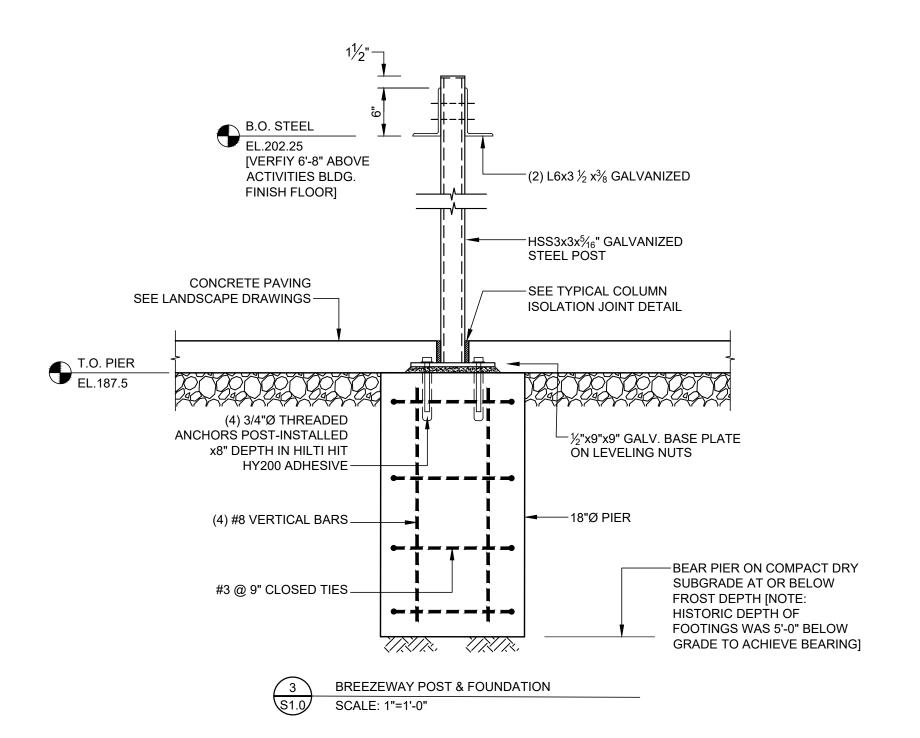

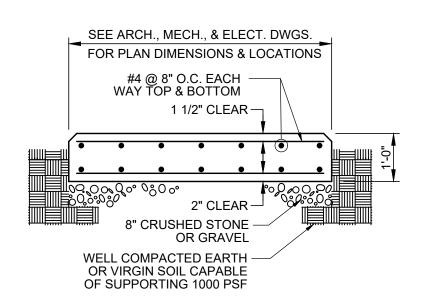


EQUIPMENT PAD

1. COORDINATE SIZE & LOCATION WITH EQUIPMENT REQUIREMENTS.
2. CHAMFER ALL EDGES 1" TYPICAL.

REFER TO S1.1 FOR GENERAL STRUCTURAL

	REVI	SIONS
ISSUE	DATE	REVISIONS

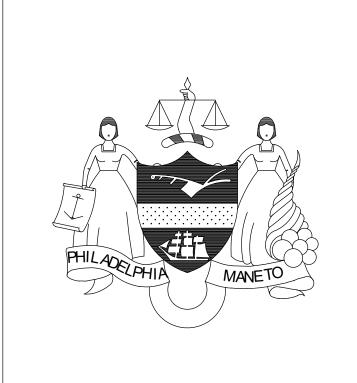

CONSTRUCTION DOCUMENTS

LEEANN SUEN

ALS

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1600 Walnut Street, 2nd Floor
Philadelphia, Pennsylvania 19103
215 985 4410

PROJECT COORDINATOR

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CITY OF PHILADELPHIA DEPARTMENT OF PARKS & RECREATION

1515 ARCH STREET 11TH FLOOR, ONE PARKWAY BUILDING

PHILADELPHIA PENNSYLVANIA
PROJECT TITLE

RENOVATIONS TO THE HAPPY HOLLOW RECREATION CENTER

STRUCTURAL DETAILS

PROJECT NO.

16315E-03-02

DATE 04/09/2025

SCALE AS NOTED

DRAWN BY SH

ALL DIMENSIONS AND CONDITIONS SHALL BE VERIFIED BY THE CONTACTOR AT THE SITE BEFORE PROCEEDING WITH THE WORK

NOTES + MATERIAL SPECIFICATIONS

NOTE: ALL DIMENSIONS AND CONT.

CHECKED BY

- 1. THIS PROJECT HAS BEEN DESIGNED USING THE 2018 INTERNATIONAL BUILDING CODE (IBC), AND APPLICABLE LOCAL REGULATIONS
- 2. ALL CONTRACTORS AND SUBCONTRACTORS ARE RESPONSIBLE FOR ADHERING TO THE REQUIREMENTS 3. STRUCTURAL SPECIAL INSPECTIONS ARE A REQUIREMENT FOR THIS PROJECT. A QUALIFIED INDEPENDENT
- INSPECTION AGENCY REGISTERED WITH THE CITY OF PHILADELPHIA SHALL BE SELECTED TO PERFORM THESE SERVICES. ALL INSPECTIONS AS REQUIRED BY CHAPTER 17 OF THE IBC ARE REQUIRED, AS A MINIMUM. SEE MATERIAL NOTES FOR SPECIFIC INSPECTIONS REQUIRED.
- 4. THIRD PARTY SPECIAL INSPECTIONS SHALL BE PERFORMED FOR THIS PROJECT AS FOLLOWS, AND IN ACCORDANCE

WITH PROJECT SPECIFICATIONS:		
STRUCTURAL STEEL (AISC 360)	VISUAL INSPECTION OF FIELD CONNECTIONS	PERIODIC
STRUCTURAL STEEL (AISC 360)	VISUAL INSPECTION OF FABRICATION, UNLESS	
	FABRICATOR IS AISC CERTIFIED	PERIODIC
CONCRETE MATERIAL TESTS (ACI)	VERIFY DESIGN MIX; SAMPLE AND TEST CONCRETE	PERIODIC
POST-INSTALLED ANCHOR INSTALLATION	HORIZONTAL & OVERHEAD INSTALLATION	CONTINUOUS
POST-INSTALLED ANCHOR INSTALLATION	DOWNWARD	PERIODIC
SITE SOIL CONDITIONS BENEATH SHALLOW	V FOUNDATIONS	PERIODIC

- 5. THE INDEPENDENT INSPECTIONS AGENCY SHALL PERFORM INSPECTIONS AND SUBMIT REPORTS THE ENGINEER OF RECORD (EOR) WITHIN 72 HOURS OF INSPECTION. ANY INADEQUACIES FOUND BY THE INSPECTOR SHALL BE REPORTED TO THE EOR WITHIN 24 HOURS. THE CONTRACTOR SHALL FACILITATE THESE INSPECTIONS BY SCHEDULING THE INSPECTIONS TO COORDINATE WITH THE WORK BEING PERFORMED BY THEIR SUB-CONTRACTORS.
- 6. THESE DRAWINGS REPRESENT THE COMPLETED PROJECT WHICH HAS BEEN DESIGNED FOR THE WEIGHTS OF THE MATERIALS INDICATED ON THE DRAWINGS AND FOR THE SUPERIMPOSED LOADS INDICATED IN THE DESIGN DATA. IT IS THE CONTRACTOR'S RESPONSIBILITY TO DETERMINE ALLOWABLE CONSTRUCTION OF FALSE WORK, FORMWORK, STAGING, BRACING, SHEETING, AND SHORING, ETC.
- 7. WHERE NEW LOADS ARE BEING ADDED TO EXISTING STRUCTURE, THE INTEGRITY OF THE EXISTING STRUCTURE AND FOUNDATIONS SHALL BE VERIFIED BY THE CONTRACTOR. REPORT ANY CRACKING, SETTLEMENT, DETERIORATION, AND SUBSTANDARD QUALITY OF EXISTING CONSTRUCTION OR MATERIALS SHALL BE REPORTED TO THE OWNER BEFORE PROCEEDING WITH CONSTRUCTION.
- 8. TAKE FIELD MEASUREMENTS AND VERIFY DIMENSIONS ON DRAWINGS BEFORE ORDERING MATERIALS.
- 9. NOTIFY ENGINEER IMMEDIATELY IF ANY EXISTING CONDITIONS CONFLICT WITH STRUCTURAL INFORMATION SHOWN IN THE CONSTRUCTION DOCUMENTS.
- 10.IMPLEMENTING JOB SITE SAFETY AND CONSTRUCTION PROCEDURES ARE THE SOLE RESPONSIBILITY OF THE CONTRACTOR.
- 11.IN CASE OF CONFLICT BETWEEN THE GENERAL NOTES, DETAILS AND SPECIFICATIONS, THE CONTRACTOR SHALL SUBMIT A REQUEST FOR CLARIFICATION.

FOUNDATIONS

- 1. BUILDING FOUNDATIONS SHALL BEAR ON UNDISTURBED SOIL HAVING MINIMUM BEARING CAPACITY OF 2500 PSF. ADJUST BOTTOM OF FOOTING ELEVATIONS AS REQUIRED TO BEAR ON UNIFORMLY DENSE INORGANIC SUBGRADE.
- 2. CONCRETE FOR FOUNDATIONS SHALL BE POURED ON THE SAME DAY SUBGRADE APPROVAL IS GIVEN BY THE SPECIAL INSPECTOR.
- 3. ALL EXTERIOR FOOTINGS SHALL BE PLACED A MINIMUM OF 3'-0" BELOW FINAL GRADE.
- 4. EXCAVATIONS FOR ANY PURPOSE SHALL NOT REMOVE LATERAL SUPPORT FROM ANY FOOTING OR FOUNDATION WITHOUT PROTECTING THE FOOTING OR FOUNDATION AGAINST SETTLEMENT OR LATERAL TRANSLATION.
- 5. SLABS ON GRADE SHALL BEAR ON SOIL COMPACTED TO 95% DRY DENSITY PER ASTM D1557. SLABS HAVE BEEN DESIGNED USING A MODULUS OF SUBGRADE REACTION OF 100 PSI/INCH. PROVIDE PADOT 2A WELL GRADED CRUSHED STONE AS A SUB-BASE WHEN EXISTING SOIL HAS BEEN DISTURBED.
- 6. PROVIDE DRAINAGE FILL BENEATH THE SLAB CONSISTING OF AT LEAST 6" OF AASHTO NO. 57 COMPACTED CRUSHED

CONCRETE

- SUBMIT CONCRETE MATERIALS AND REBAR SHOP DRAWINGS FOR APPROVAL
- 2. CEMENT SHALL CONFORM TO ASTM C150, TYPE 1 OR II.
- 3. AGGREGATES SHALL CONFORM TO ASTM C33 (NORMAL WEIGHT)
- 4. CONCRETE FOR EXTERIOR CONSTRUCTION SHALL BE AIR-ENTRAINED, 4% 6%. CONFORM TO ASTM C260.
- 5. CONCRETE ADMIXTURES CONTAINING CALCIUM CHLORIDE OR OTHER CHLORIDE SALTS SHALL NOT BE USED, EXCEPT WHEN WATER SOLUBLE CHLORIDE ION CONTENT IS LIMITED TO 0.30 PERCENT BY WEIGHT OF CEMENT.
- CONCRETE COMPRESSIVE STRENGTH (F'C) AT 28 DAYS SHALL BE: 4000 PSI.
- 7. GROUT BENEATH BASE PLATES, SHALL BE NON-SHRINK (ASTM C1107) WITH A ONE DAY COMPRESSIVE STRENGTH OF
- 8. REINFORCING STEEL SHALL BE DEFORMED BARS CONFORMING TO ASTM A615, GRADE 60. REINFORCING STEEL
- SHALL BE DETAILED ACCORDING TO THE ACI MANUAL OF STANDARD PRACTICE (ACI 315), LATEST EDITION. 9. WELDED WIRE REINFORCING (WWR) SHALL CONFORM TO ASTM A185, WITH A MINIMUM ULTIMATE TENSILE STRENGTH OF 70,000 PSI. WWR SHALL BE GALVANIZED.
- 10.WELDED WIRE REINFORCING SHALL BE SUPPLIED IN SHEETS. LAP TWO FULL MESH LENGTHS AT SPLICES AND WIRE
- 11.REINFORCING SPLICES SHALL BE LAPPED IN ACCORDANCE WITH ACI MINIMUMS. MAKE BARS CONTINUOUS AROUND
- CORNERS. LAPS SHALL, IN NO CASE, BE LESS THAN 48 BAR DIAMETERS. 12.THE FOLLOWING MINIMUM CONCRETE COVER SHALL BE PROVIDED FOR REINFORCEMENT:
- CONCRETE CAST AGAINST THE EARTH 3" CONCRETE EXPOSED TO EARTH OR WEATHER 1-1/2" (#5 BAR OR SMALLER), 2" (#6 BAR OR LARGER)
- INTERIOR CONCRETE SLABS, TOP SURFACE 3/4"
- 13.CONCRETE SLABS ON GRADE SHALL BE 4" THICK, POURED OVER A 6" LAYER OF POROUS FILL. PROVIDE 66 W2.0 X W2.0 WELDED WIRE REINFORCING PLACED 1" FROM TOP OF SLAB. PROVIDE A 10 MIL. POLYETHYLENE VAPOR BARRIER BENEATH ALL INTERIOR SLABS.
- 14.INSTALL WELDED WIRE REINFORCEMENT IN LONGEST PRACTICABLE LENGTHS ON BAR SUPPORTS SPACED TO MINIMIZE SAGGING. LAP EDGES AND ENDS OF ADJOINING SHEETS AT LEAST ONE MESH SPACING. OFFSET LAPS OF ADJOINING SHEET WIDTHS TO PREVENT CONTINUOUS LAPS IN EITHER DIRECTION. LACE OVERLAPS WITH WIRE.
- 15.WHEN CONCRETE IS PLACED AT OR BELOW A TEMPERATURE OF 400F OR WHEN THIS TEMPERATURE IS LIKELY TO OCCUR WITHIN 24 HOURS OF PLACEMENT, PROTECT IN ACCORDANCE WITH ACI 306, "RECOMMENDED PRACTICE FOR COLD WEATHER CONCRETING". DO NOT PLACE CONCRETE IN WATER OR ON SNOW, ICE OR FROZEN OR WATER SOFTENED GROUND.
- 16.WHEN HOT WEATHER CONDITIONS EXIST THAT WOULD SERIOUSLY IMPAIR QUALITY AND STRENGTH OF CONCRETE. PLACE CONCRETE IN COMPLIANCE WITH ACI 305, "RECOMMENDED PRACTICE FOR HOT WEATHER CONCRETING".
- 17.IMMEDIATELY AFTER PLACEMENT, PROTECT CONCRETE FROM PREMATURE DRYING. PRESERVE MOISTURE IN CONCRETE FOR AT LEAST 3 DAYS AFTER PLACEMENT BY EITHER: CONTINUOUS SPRINKLING. APPLICATION OF WET MATS, OR APPLICATION OF AN APPROVED CURING COMPOUND.
- 18.CONDUITS, PIPES AND SLEEVES SHALL NOT BE LARGER IN DIAMETER THAN 1/3 THICKNESS OF THE CONCRETE IN WHICH THEY ARE EMBEDDED, UNO. MINIMUM CONCRETE BETWEEN SLEEVES SHALL BE (3) SLEEVE DIAMETERS.
- 19. WHEN INSTALLING EXPANSION BOLTS OR ADHESIVE ANCHORS, THE CONTRACTOR SHALL TAKE MEASURES TO AVOID DRILLING OR CUTTING OF ANY EXISTING REINFORCING AND DESTRUCTION OF CONCRETE. INSTALLER SHALL BE TRAINED BY MANUFACTURER ON INSTALLATION PROCEDURES. CLEAN HOLE FREE OF DUST, DEBRIS, AND MOISTURE. USE COMPRESSED AIR AND WIRE BRUSH, IN ACCORDANCE WITH MANUFACTURERS
- VERIFY THAT ADHESIVES TO BE USED, ARE WITHIN EXPIRATION DATE. PROVIDE HILTI OR APPROVED ALTERNATIVE.
- 20.CHAMFER ALL EXPOSED CONCRETE CORNERS, UNLESS NOTED OTHERWISE ON ARCHITECTURAL DRAWINGS.
- 21.PROVIDE CRACK CONTROL JOINTS (OF DEPTH = 1/4 THE SLAB THICKNESS) FOR SLABS ON GRADE AT 15 FEET O.C. MAXIMUM SPACING. AT UNEXPOSED SLABS, JOINTS SHALL BE SAW-CUT WITHIN THE FIRST 12 HOURS OF CONCRETE
- PLACEMENT. AT EXPOSED SLABS, JOINTS SHALL BE FORMED. 22. WHERE SLABS ABUT MASONRY OR CONCRETE WALLS, PROVIDE 1/2" THICK PRE-MOLDED JOINT FILLER AT INTERFACE.
- 23.ANY STOP IN CONCRETE WORK MUST BE MADE WITH VERTICAL BULKHEADS AND HORIZONTAL KEYS, UNLESS OTHERWISE SHOWN. ALL REINFORCING IS TO BE CONTINUOUS THROUGH JOINTS.
- 24.THE CONCRETE SLABS SHALL BE FINISHED FLAT AND LEVEL TO WITHIN ASTM E1155 TOLERANCE, [FLATNESS: OVERALL F35; LOCAL F24. LEVELNESS: OVERALL F25; LOCAL F17], TO THE ELEVATION INDICATED ON THE DRAWINGS. CONTRACTOR SHALL PROVIDE ADDITIONAL CONCRETE REQUIRED DUE TO SUB GRADE VARIATION, OR FORMWORK AND FRAMING DEFLECTION TO ACHIEVE THIS FINISHED TOP OF SLAB ELEVATION.

CONCRETE MASONRY

- SUBMIT MASONRY MATERIALS FOR APPROVAL.
- 2. CONCRETE MASONRY UNITS SHALL CONFORM TO ASTM C90, WITH 3250 PSI UNIT STRENGTH. COMPLETED WALLS SHALL HAVE A COMPRESSIVE STRENGTH OF F'M = 2500 PSI ON NET AREA.
- 3. USE MASONRY UNITS WITH CORES THAT ALIGN VERTICALLY TO PROVIDE CONTINUOUS UNOBSTRUCTED CELLS FOR GROUTING AND REINFORCING STEEL PLACEMENT.
- 4. MORTAR SHALL BE ASTM C270, TYPE S.
- 5. GROUT SHALL CONFORM TO ASTM C476, AND HAVE A MINIMUM COMPRESSIVE STRENGTH OF 3000 PSI. ADMIXTURES CONTAINING CALCIUM CHLORIDE OR CHLORIDE SALTS SHALL NOT BE USED. 6. GROUT SHALL BE A PEA GRAVEL HIGH SLUMP MIX, GROUT SLUMP SHALL BETWEEN 8 TO 11", WITHOUT ADMIXTURES.
- 7. SUBMIT GROUT MIX DESIGN AND MASONRY UNIT CERTIFICATIONS TO THE STRUCTURAL ENGINEER FOR APPROVAL
- 8. ASSEMBLE MASONRY UNITS IN RUNNING BOND.
- 9. ALL CONCRETE BLOCK AT OR BELOW GRADE SHALL BE FILLED SOLID WITH GROUT.
- 10.ALL CONCRETE MASONRY SHALL HAVE GALVANIZED TRUSS OR LADDER TYPE, 9 GAGE, HORIZONTAL JOINT REINFORCEMENT CONFORMING TO ASTM A82, SPACED @ 16" O.C. VERTICALLY. PROVIDE CONTINUOUS REINFORCEMENT UNITS AROUND CORNERS.
- 11.LAP SPLICES FOR DEFORMED REINFORCING BARS USED IN MASONRY CONSTRUCTION SHALL BE 50 BAR DIAMETERS. 12.CONVENTIONAL GROUT SHALL NOT BE SUBJECT TO DROPS IN EXCESS OF 5'-4" FEET. VIBRATE TO FILL VOIDS COMPLETELY. DO NOT USE VIBRATOR TO TRANSPORT GROUT.
- 13.HIGH LIFT GROUTING METHODS MAY BE USED WITH SELF-CONSOLIDATING GROUT, CONFORMING TO (ASTM C1157). PROVIDE CLEAN OUT OPENINGS AT BASE OF ALL GROUTED COLUMNS.
- 14.BRACE NEW MASONRY WALL TO INTERSECTING EXISTING WALLS WITH HOHMANN & BARNARD SLIP-SET STABILIZER GALVANIZED TIES @ 16" VERTICAL SPACING. PROVIDE 1/2" COMPRESSIBLE FILLER JOINT WITH SEALANT AND BACKER
- 15.SHORE FRAMING DURING INSTALLATION OF LINTELS.
- 16.SAW CUT MASONRY TO INSTALL NEW PRECAST CONCRETE LINTELS.
- 17.PRECAST LINTELS SHALL BE PLACED IN FULLY MORTARED BED AND HEAD JOINTS. THE ENDS OF THE UNITS SHALL BE COMPLETELY BUTTERED. PROVIDE 8" LENGTH OF BEARING AT EACH END.
- 18.MASONRY JOINTS ON EXTERIOR FACE SHALL BE TROWELLED FLUSH TO PROVIDE A SMOOTH BASE FOR STUCCO.

BRICK MASONRY VENEER

- 1. BRICK VENEER ANCHORS TO MASONRY BACK-UP SHALL BE HOHMANN & BARNARD HB-5213 ADJUSTABLE VENEER ANCHOR, WITH THERMAL BREAK, OR EQUAL. PROVIDE 2" CLEAR CAVITY BETWEEN BRICK VENEER AND MASONRY BACK UP. SPACE ANCHORS AT A MAXIMUM OF 24" O.C. HORIZONTALLY AND 16" O.C. VERTICALLY. GROUT CAVITY BELOW GRADE AND WEEP ABOVE GRADE.
- 2. PROVIDE 3/8" GROUTED COLLAR JOINT BETWEEN BRICK AND CMU WYTHES.

BRICK MASONRY REPAIRS

- 1. REPOINT BRICK MASONRY IN AREAS WHERE THE FOLLOWING SIGNS OF DETERIORATION EXIST: DISINTEGRATING MORTAR, CRACKS IN MORTAR JOINTS, LOOSE BRICKS, DAMP WALLS, OR DAMAGED PLASTERWORK.
- 2. REPOINT EXISTING HISTORIC BRICK MASONRY WITH MORTAR THAT IS COMPATIBLE IN TEXTURE AND CONTENT WITH ORIGINAL BRICK AND MORTAR.
- 3. REPOINTING BRICKWORK SHALL BE UNDERTAKEN BY AN EXPERIENCED BRICK MASON, WITH A MINIMUM OF 5 YEARS
- OF SUCCESSFUL WORK OF SIMILAR SCOPE.
- 4. REPOINTING SHALL BE UNDERTAKEN WHEN THE WALL TEMPERATURES ARE BETWEEN 40 AND 95 DEGREES (F).
- 5. REPLACE MISSING, CRACKED, OR OTHERWISE DAMAGED BRICKS.
- 6. PROVIDE SOFT, HIGH-LIME, TYPE N MORTAR FOR REPOINTING HISTORIC BRICKWORK. CONFORM TO PROPORTIONS SPECIFIED IN ASTM C270, AND REFERENCED IN SPECIFICATION ACI 530.1
- 7. REPLACEMENT BRICKS SHALL BE HIGH-FIRED EXTERIOR GRADE BRICK, AND SHALL MATCH THE DIMENSIONS OF TYPICAL IN-PLACE BRICKS. BRICKS MAY BE RECYCLED, OR NEW. BRICKS SHALL BE WIRE BRUSH CLEANED AND FREE
- 8. MORTAR USED BELOW GRADE ON EXTERIOR, SHALL BE ASTM C270, TYPE S, (INCREASED CEMENT TO LIME RATIO). 9. GROUT SHALL BE A PEA GRAVEL HIGH SLUMP MIX, CONFORM TO ASTM C476. GROUT SLUMP SHALL BETWEEN 8 TO
- 11", WITHOUT ADMIXTURES. 10.PREPARE MASONRY JOINTS FOR REPOINTING BY CUTTING OUT EXISTING MORTAR TO A DEPTH OF AT LEAST 5/8". IF
- THE MORTAR IS UNSOUND, THE JOINT SHOULD BE CUT DEEPER UNTIL ONLY SOUND MATERIAL REMAINS, BUT NOT MORE THAN 1/2 THE TOTAL DEPTH OF THE JOINT.
- 11.USE HAND TOOLS TO PREVENT DAMAGE TO BRICKWORK.
- 12.MIX ALL CEMENTITIOUS MATERIALS AND AGGREGATES BETWEEN 3 AND 5 MINUTES IN A MECHANICAL BATCH MIXER WITH A SUFFICIENT AMOUNT OF WATER TO PRODUCE A WORKABLE CONSISTENCY. DISCARD ALL MORTAR WHICH IS NOT USED WITHIN 2-1/2 HOURS AFTER INITIAL MIXING.
- 13.CLEAN ALL MASONRY UNITS OF MATERIALS THAT WOULD AFFECT OR REDUCE THE BOND AT THE TIME MORTAR IS
- 14.COLLAR JOINTS WIDER THAN 3/4" REQUIRE GROUT INSTEAD OF MORTAR.
- 15.USE TOOLED CONCAVE OR VEE-STRUCK MORTAR JOINTS AT EXTERIOR FACE OF WALLS FOR RESISTANCE TO
- 16.SHORE FRAMING DURING INSTALLATION OF LINTELS.

RUBBLE STONE MASONRY

- 1. MORTAR FOR STONE MASONRY SHALL BE TYPE N AND SHALL CONFORM TO ASTM C270. PROVIDE MINIMUM COMPRESSIVE STRENGTH OF MORTAR AT 28 DAYS: 750 PSI. IN NO CASE SHALL CEMENT RATIO EXCEED (1) PARTS CEMENT TO (1) PARTS LIME. NO AIR ENTRAINING SHALL BE PERMITTED. LIMIT AIR CONTENT TO 8%.
- 2. MIX ALL CEMENTITIOUS MATERIALS AND AGGREGATES BETWEEN 3 AND 5 MINUTES IN A MECHANICAL BATCH MIXER WITH A SUFFICIENT AMOUNT OF WATER TO PRODUCE A WORKABLE CONSISTENCY. DISCARD ALL MORTAR WHICH IS NOT USED WITHIN 2-1/2 HOURS AFTER INITIAL MIXING.
- 3. CLEAN ALL STONES AND REINFORCEMENT OF MATERIALS THAT WOULD AFFECT OR REDUCE THE BOND AT THE TIME MORTAR IS PLACED.
- 4. MORTAR BED JOINT THICKNESS SHALL BE AT LEAST TWICE THE THICKNESS OF THE EMBEDDED ANCHOR, (5/16" MINIMUM JOINT).
- 5. RUBBLE STONE MASONRY, OF MULTIPLE WYTHES, SHALL HAVE BONDER UNITS WITH A MAXIMUM SPACING OF 3 FEET
- 6. COLLAR JOINTS WIDER THAN 3/4" REQUIRE GROUT INSTEAD OF MORTAR.

POST-INSTALLED ANCHORS IN MASONRY

- 1. PRE-CONSTRUCTION LOAD TESTING IS REQUIRED FOR EXPANSION AND ADHESIVE ANCHORS BEING INSTALLED INTO EXISTING MASONRY. TESTING SHALL BE PERFORMED BY A PROFESSIONAL STRUCTURAL ENGINEER LICENSED IN THE STATE OF PENNSYLVANIA. THE GENERAL CONTRACTOR SHALL FACILITATE TESTING BY AN APPROVED ACI ACCREDITED TESTING AGENCY, OR BY HILTI, INC.], TO TEST A REPRESENTATIVE SAMPLE OF 1-3 TEST ANCHORS IN EACH AREA DESIGNATED FOR ANCHORING. NOTIFY ENGINEER OF RECORD TO BE ON SITE TO OBSERVE AND REPORT ON TESTING. TESTING SHALL BE TO 2 X THE DESIGN TENSILE LOAD OF ANCHORS.
- 2. WHEN INSTALLING EXPANSION BOLTS OR ADHESIVE ANCHORS, THE CONTRACTOR SHALL TAKE MEASURES TO AVOID DAMAGING EXISTING MASONRY. HOLES SHALL BE BLOWN CLEAN PRIOR TO PLACING BOLTS OR ADHESIVE ANCHORS. INSTALLER SHALL BE TRAINED BY MANUFACTURER ON INSTALLATION PROCEDURES. CLEAN HOLE FREE OF DUST, DEBRIS, AND MOISTURE. USE COMPRESSED AIR AND WIRE BRUSH, IN ACCORDANCE WITH MANUFACTURERS
- VERIFY THAT ADHESIVES TO BE USED, ARE WITHIN EXPIRATION DATE. PROVIDE HILTI OR APPROVED ALTERNATIVE.

- 1. SUBMIT STEEL FABRICATION AND ERECTION DRAWINGS FOR APPROVAL.
- 2. ALL STRUCTURAL STEEL WORK SHALL CONFORM TO THE FOLLOWING GOVERNING STANDARDS: A. AISC "SPECIFICATION FOR STRUCTURAL STEEL BUILDINGS," CURRENT EDITION.
- B. THE AMERICAN WELDING SOCIETY (AWS D1.1) "CODE FOR WELDING IN BUILDING CONSTRUCTION," CURRENT EDITION.
- 3. ALL STRUCTURAL STEEL SHALL CONFORM TO THE FOLLOWING ASTM SPECIFICATIONS:
- A. PLATES AND ANGLES: ASTM A36, FY=36 KSI. B. W, WT & C SHAPES: ASTM A992, FY=50 KSI.
- B. HSS STRUCTURAL TUBING: ASTM A500 GRADE B, FY=46 KSI.
- C. STEEL PIPE SHALL CONFORM TO ASTM A53 TYPE E GRADE B SPECIFICATIONS. [STD. = SCHEDULE 40; XS = SCHEDULE 80; DS = SCHEDULE 160]
- D. BOLTED CONNECTIONS (STEEL TO STEEL): ASTM A325-N, (3/4" DIAM.), U.N.O. E. ANCHOR BOLTS AND CONNECTORS IN WOOD FRAMING: ASTM A307, (3/4" DIAM.), U.N.O.
- 4. BOLTS TO BE USED ON THE EXTERIOR SHALL BE HOT DIPPED GALVANIZED AND FIELD PAINTED. 5. ANCHORAGE BOLTS AND FITTINGS IN MASONRY SHALL BE GALVANIZED.
- 6. WELDING SHALL BE PERFORMED BY WELDERS CERTIFIED BY THE A.W.S. SUBMIT WELDER CERTIFICATES TO ENGINEER FOR RECORD.
- 7. WELDING ELECTRODES SHALL BE ASTM A233, CLASS E70XX. ALL WELDING SHALL CONFORM TO THE A.W.S. STANDARD CODE.
- 8. ALL SHOP AND FIELD WELDS SHALL BE 1/4" FILLET WELDS MINIMUM, U.N.O.
- 9. MINIMUM CENTER-CENTER SPACING BETWEEN BOLTS SHALL BE 3". MINIMUM EDGE DISTANCE SHALL BE 1-1/4" FROM CENTER OF BOLTS TO EDGE OF STEEL.
- 10.WHERE GALVANIZED STEEL IS NOTED ON DRAWINGS, PROVIDE BATCH HOT-DIP GALVANIZING IN ACCORDANCE WITH 11.PRIOR TO FIELD WELDING, GALVANIZED MEMBERS SHALL HAVE ZINC COATING GROUND SMOOTH IN WELD AREAS.
- ZINC RICH COATING. 12.TOUCH UP FIELD WELDS AND ANY DAMAGED AREAS OF PAINT WITH A ZINC RICH PAINT, IN FIELD AFTER WELDING.

(ZINC COATING IS NOT TO CONTAMINATE WELD FUSION METAL). AFTER WELDING, COAT AFFECTED SURFACE WITH

FRAMING LUMBER & SHEATHING

1. FRAMING LUMBER SHALL BE OF THE FOLLOWING MINIMUM STRENGTH FOR THE SPECIFIED USE, UNLESS OTHERWISE NOTED ON PLAN. ALL LUMBER SHALL BE GRADE-STAMPED BY A RECOGNIZED GRADING AGENCY AND SHALL BE SURFACED DRY. MOISTURE CONTENT NOT TO EXCEED 19%.

DIMENSION LUMBER, AT INTERIOR CONDITIONS.

GRADE NO.2, HEM-FIR, SPRUCE-PINE-FIR, OF SOUTHERN PINE.

DIMENSION LUMBER AT EXTERIOR EXPOSED CONDITIONS.

- GRADE NO.2, PRESSURE TREATED, SOUTHERN PINE OR EQUAL. PROVIDE LUMBER STAMPED KDAT (KILN-DRIED AFTER TREATMENT). ALTERNATIVELY, SEASON THE LUMBER FOR SEVERAL MONTHS AFTER TREATMENT, SO MOISTURE CONTENT MEETS EQUILIBRIUM CONDITIONS.
- 2. STORE FRAMING AND SHEATHING MATERIALS IN DRY LOCATION. REMOVE STANDING WATER FROM INSTALLED SHEATHING. ENSURE INSTALLED LUMBER MOISTURE CONTENT IS 19% OR LESS, BEFORE INSTALLING HOLD DOWN ANCHORS, STRAPS, OR FINISHES THAT WOULD BE AFFECTED BY LUMBER SHRINKING OR EXPANDING.
- 3. FASTENING SHALL CONFORM TO A MINIMUM AS SPECIFIED IN TABLE 2304.10.1 OF THE INTERNATIONAL BUILDING CODE
- 4. BUILT-UP MULTI-MEMBER WOOD GIRDERS SHALL HAVE MEMBER JOINTS STAGGERED SUCH THAT NOT MORE THAN (1) MEMBER SPLICE OCCURS BETWEEN SUPPORT POINTS. ORIENT ADJACENT MEMBERS WITH ALTERNATE GRAINS, AND CONNECT MEMBERS WITH GALVANIZED NAILS: 10D (.148") X 3" COMMON FOR (2) MEMBERS, 16D (.162") X 3-1/2" COMMON FOR (3) MEMBERS, AND 20D(.192") X 4" COMMON FOR (4) MEMBERS. NAIL AT TOP AND BOTTOM @ 24" OC, STAGGER OPPOSITE FACES, AND WITHIN 1-1/2" OF MEMBER ENDS.
- 5. FLOOR JOISTS SHALL NOT BE CUT, NOTCHED OR BORED, IN EXCESS OF THE LIMITATIONS SPECIFIED IN IRC SECTION R502.8, (SEE ILLUSTRATION). MEMBERS THAT EXCEED THESE LIMITATIONS SHALL BE SISTERED FULL LENGTH TO
- 6. ALL FRAMING MEMBERS SHALL HAVE LATERAL SUPPORT SUPPLIED AT ALL BEARING POINTS AS WELL AS CONTINUOUSLY ALONG THE COMPRESSION FACE.
- 7. PROVIDE SIMPSON LIGHT GAGE METAL CONNECTORS, OR APPROVED EQUAL, FOR ALL FLUSH FRAMING CONDITIONS. WHERE HANGER TYPE IS NOT SPECIFIED ON PLANS, PROVIDE HANGER CAPACITY EQUAL TO SHEAR CAPACITY OF FRAMING MEMBER. OR CONSULT ENGINEER. INSTALL ALL CONNECTORS ACCORDING TO MANUFACTURER'S RECOMMENDATIONS. NAILING SHALL CONFORM TO THE MANUFACTURER'S PUBLISHED TABLES TO PROVIDE MAXIMUM HANGER CAPACITY, UNLESS NOTED OTHERWISE ON DRAWINGS. PROVIDE SIMPSON 'BC' POST BASES AND CAPS FOR ALL WOOD POSTS. PROVIDE 'ZMAX' ZINC COATED CONNECTORS AT ALL CONDITIONS IN CONTACT WITH TREATED LUMBER.
- 8. PLYWOOD OR OSB SHEATHING SHALL BE APA GRADE STAMPED FOR SPECIFIC SPAN, SHALL BE MADE WITH EXTERIOR GLUE AND SHALL BE OF THE FOLLOWING THICKNESS:
- FLOOR: 23/32" THICK, EXPOSURE 1, SPAN RATING 48/24. EXTERIOR WALLS WITHIN 8" OF EARTH: PROVIDE PRESERVATIVE TREATED EXTERIOR GRADE PLYWOOD
- ROOF: 19/32" THICK, EXPOSURE 1, STRUCTURAL 1, SPAN RATING 40/20.
- INDEX STAMP SHALL BE VISIBLE ON ALL SHEETS.
- PROTECT SHEATHING FROM EXTENSIVE EXPOSURE TO WEATHER. 9. INSTALL PLYWOOD SHEATHING WITH FACE GRAIN PERPENDICULAR TO THE SUPPORTING MEMBERS, U.N.O.
- 10.FASTEN PLYWOOD ROOF SHEATHING TO FRAMING WITH 10D COMMON [.148"] NAILS @ 6" OC AT PANEL EDGES & 12" OC IN FIELD, UNLESS NOTED OTHERWISE. NAILS SHALL HAVE 3/8" MINIMUM EDGE DISTANCE IN LUMBER, AND 1-5/8" PENETRATION INTO LUMBER.
- 11.USE PLYCLIPS OR OTHER EDGE SUPPORT AS REQUIRED FOR ROOF SHEATHING.

115 MPH, EXPOSURE B

- 12.PRESERVATIVE TREATMENT: TREAT WOOD MEMBERS AND SHEATHING IN CONTACT WITH MASONRY OR CONCRETE, OR WITHIN 6" OF GROUND, [IRC-R317.1.5]. TREAT IN ACCORDANCE WITH CURRENT STANDARDS OF AMERICAN WOOD
- PRESERVERS ASSOCIATION (AWPA) STANDARD. USE CATEGORY 3B FOR EXPOSED EXTERIOR WOOD, NOT IN CONTACT WITH GROUND.

LUMBER AND SHEATHING SHALL BE VISIBLY STAMPED WITH AWPA USE CATEGORY STAMP.

USE CATEGORY 4A FOR WOOD IN CONTACT WITH GROUND.

STRUCTURAL DESIGN CRITERIA

GROUND SNOW LOAD

WIND SPEED:

DESIGN LOADS LIVE LOAD
MAIN FLOOR: 100 PSF
ROOF: <u>20 PSF</u>

25 PSF

REVISIONS ISSUE



CONSTRUCTION DOCUMENTS

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Olnn Rothmann, PE

SMPARCHITECTS Philadelphia, Pennsylvania 19103

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215 925 0425

arstructural.com

856 287 2424

CHECKED BY

215 985 4410

610 688 2566 MEP ENGINEER: ARORA ENGINEERS www.aroraengineers.com

STRUCTURAL ENGINEER:

610 459 7900 **ROOFING CONSULTANT:** STEPHEN McLAUGHLIN ROOFING CONSULTANT stevemclaughlin.biz

ANN ROTHMANN STRUCTURAL ENGINEERING

CITY OF PHILADELPHIA DEPARTMENT OF PARKS & RECREATION

RENOVATIONS TO THE HAPPY

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PENNSYLVANIA

1515 ARCH STREET 11TH FLOOR, ONE PARKWAY BUILDING

PHILADELPHIA PROJECT TITLE

DRAWING TITLE **GENERAL NOTES**

16315E-03-02 04/09/2025 AS NOTED

- ALL SYMBOLS AND ABBREVIATIONS MAY NOT APPLY TO THIS
- BOUNDARY LINES SHOWN ON THE DRAWINGS DO NOT LIMIT THE SCOPE OF WORK FOR THE PROJECT. CONTRACTOR SHALL BE RESPONSIBLE FOR ALL WORK NOTED ON THE DRAWINGS.
- CONTRACTOR SHALL COMPLY WITH ALL REGULATIONS AND LAWS OF AUTHORITIES HAVING JURISDICTION.
- CONTRACTOR SHALL VERIFY ALL EXISTING CONDITIONS AND NOTIFY THE ENGINEER AT ONCE OF ANY DISCREPANCIES.
- ALL PENETRATIONS THROUGH DESIGNATED FIRE RATED WALLS, CEILINGS AND FLOOR SLABS (WHICH ARE 2-HOUR RATED) SHALL BE PROPERLY SEALED WITH AN APPROVED RATED FIRE AND SMOKE STOPPING MATERIAL. ALL FIRE AND SMOKE STOPPING MATERIAL SHALL BE SUPPLIED AND WORK PERFORMED AS PER PROJECT SPECIFICATIONS. CONTRACTOR SHALL SUBMIT MANUFACTURER'S CATALOG DATA AND INSTALLATION DETAIL AS PER SPECIFICATIONS FOR FIRE AND SMOKE STOPPING TO THE ENGINEER FOR REVIEW AND APPROVAL PRIOR INSTALLATION.
- THE CONTRACTOR SHALL NOT BE ALLOWED ANY STORAGE AREA OTHER THAN THAT AVAILABLE WITHIN THE LIMITS OF THE STAGING AREA, CONFINES OF THE WORK AREA, OR AS DESIGNATED BY THE OWNER.
- ALL WORK AND MATERIALS SHALL COMPLY WITH APPLICABLE CODES, ORDINANCES AND REGULATIONS.
- A COPY OF THE CURRENT SET OF CONTRACT DOCUMENTS (WITH AS-BUILT INFORMATION) SHALL BE KEPT AT THE JOB SITE AT ALL TIMES BY THE CONTRACTOR.
- EACH CONTRACTOR SHALL REVIEW ALL PROJECT DOCUMENTS OF ALL TRADES FOR A THOROUGH UNDERSTANDING OF PROJECT AND ANY CROSS REFERENCING OF WORK. REVIEW ALL PROJECT REQUIREMENTS PRIOR TO BIDDING. IN CASE OF DISCREPANCIES, THE MOST STRINGENT SHALL GOVERN.
- THE CONTRACTOR SHALL GUARANTEE THE ENTIRE INSTALLATION FOR A PERIOD OF ONE YEAR (EXCEPT WHERE EXTENSIONS OF THIS ONE YEAR PERIOD ARE NOTED) FROM THE DATE OF ACCEPTANCE OF THE SYSTEM AS A WHOLE. ANY DEFECTS, IN WORKMANSHIP, MATERIALS, MALFUNCTION OF EQUIPMENT OR UNSATISFACTORY PERFORMANCE, AND ALL OTHER WORK OR PARTS OF THE BUILDING DAMAGED THEREBY, AS A RESULT OF THE WORK OF THE CONTRACTOR, SHALL BE THE RESPONSIBILITY OF THE CONTRACTOR. CONTRACTOR SHALL PAY ALL REPAIR COSTS ACCORDINGLY WITHOUT ADDITIONAL COSTS TO OWNER.
- IN ADDITION TO SPECIFICATIONS, AS MAY BE DEFINED HEREAFTER, THE CONTRACTOR SHALL PROTECT THE WORK SITE AND ALL HIS OR HER WORK AGAINST ANY DAMAGE (INCLUDING BUT NOT LIMITED TO WATER, DUST, HEAT, FREEZING, ETC.) UNTIL FINAL COMPLETION AND ACCEPTANCE BY THE OWNER.
- CONTRACTOR SHALL, UPON COMPLETION OF THE WORK, SUBMIT AS-BUILT RECORD DRAWINGS SHOWING ALL CHANGES FROM THE CONTRACT DRAWINGS MADE IN THE INSTALLATION, AND SHOWING DIMENSION LOCATIONS OF CONCEALED EQUIPMENT.
- PRIOR TO DELIVERY OF ANY MATERIALS TO THE SITE, THE CONTRACTOR SHALL PROVIDE MATERIAL SAFETY DATA SHEETS FOR ALL ITEMS AND MATERIALS USED IN THIS WORK.
- DRAWINGS ARE DIAGRAMMATIC AND INDICATE THE GENERAL CAPACITIES AND LOCATIONS OF EQUIPMENT TO BE REMOVED. CONTRACTOR SHALL BE RESPONSIBLE FOR VISITING THE SITE TO DETERMINE ACTUAL PHYSICAL SIZE, CAPACITIES, AND LOCATIONS OF EXISTING EQUIPMENT TO BE REMOVED.
- CONTRACTOR SHALL OBTAIN AND PAY FOR ALL REQUIRED PERMITS, COORDINATE ALL REQUIRED EQUIPMENT AND SYSTEMS SHUTDOWN WITH OWNER. AND PROVIDE OWNER TWO WEEKS NOTICE OF THE SAME.
- COORDINATE DEMOLITION WORK WITH ALL OTHER TRADES. PHASE WORK IN CONJUNCTION WITH OTHER TRADE PHASING AND PHASING
- CONTRACTOR SHALL FIELD VERIFY OTHER EQUIPMENT/UTILITIES NOT ASSOCIATED WITH THIS WORK BUT LYING WITHIN THE WORK AREA, AND WILL NOT DISTURB THOSE EQUIPMENT/UTILITIES. THOSE EQUIPMENT/UTILITIES SHALL BE PROTECTED SO THAT THE SERVICE IS NOT INTERRUPTED. CONTRACTOR SHALL REPAIR ANY DAMAGE DONE TO THE EQUIPMENT/UTILITIES IN PERFORMANCE OF THE
- CONTRACTOR SHALL KEEP WORK AREA CLEAN, ORDERLY, AND WORKMAN LIKE, AND REMOVE ALL DEMOLISHED TRASH/ RUBBLE/CONSTRUCTION DEBRIS ON A DAILY BASIS FROM THE WORK AREA AND OFF OWNERS PROPERTY. ALL TRASH/RUBBLE/CONSTRUCTION DEBRIS DEEMED AS HAZARDOUS WASTE/MATERIAL SHALL BE DISPOSED OF IN ACCORDANCE WITH EPA OR ANY OTHER PERTINENT GOVERNING AGENCY AND DISPOSED OF ACCORDINGLY AT AN APPROVED HAZARDOUS WASTE DUMPSITE

WITH ALL OF THE APPROVED/REQUIRED DOCUMENTATION.

- COORDINATE AND PHASE WORK IN CONJUNCTION WITH OTHER TRADE PHASING.
- DURING CONSTRUCTION, THE CONTRACTOR SHALL BE RESPONSIBLE FOR PROVIDING ALL HIS EMPLOYEES WITH SAFE AND HEALTHY WORKING CONDITIONS AS PRESCRIBED IN THE "SAFETY AND HEALTH REGULATIONS FOR CONSTRUCTION" OF THE OCCUPATIONAL SAFETY AND HEALTH ADMINISTRATION OF THE U.S. DEPARTMENT OF LABOR.
- SECURE AND DELIVER TO THE OWNER'S REPRESENTATIVE ALL CERTIFICATES OF COMPLIANCE REQUIRED BY LOCAL AUTHORITIES.

MECHANICAL GENERAL NOTES:

- CONTRACTOR SHALL FURNISH ALL LABOR, MATERIAL, AND EQUIPMENT REQUIRED FOR THE COMPLETION AND OPERATION OF ALL SYSTEMS IN THIS SECTION OF WORK IN ACCORDANCE WITH ALL APPLICABLE CODES.
- CONTRACTOR SHALL FURNISH AND COMPLETE ALL PIPING SYSTEMS TO ALL EQUIPMENT REQUIRING SUCH. VERIFY ALL ROUGH-IN LOCATIONS AND COORDINATE PIPING LOCATIONS WITH WORK UNDER OTHER DISCIPLINES AND DIVISIONS OF THE SPECIFICATIONS TO AVOID CONFLICTS.
- CONTRACTOR SHALL FURNISH AND INSTALL A COMPLETE HVAC DUCT SYSTEM TO ALL DIFFUSERS AND/OR EQUIPMENT REQUIRING SUCH. VERIFY ALL ROUGH-IN LOCATIONS AND COORDINATE HVAC LOCATIONS WITH WORK UNDER OTHER DIVISIONS OF THE SPECIFICATIONS TO AVOID CONFLICTS.
- CONTRACTOR SHALL SECURE AND PAY FOR ALL PERMITS, INSPECTION CERTIFICATES, ETC. REQUIRED UNDER THE PROJECT
- CONTRACTOR SHALL FIELD VERIFY CONDITIONS AND DIMENSIONS PRIOR TO CONSTRUCTION, AND NOTIFY ENGINEERS OF ANY DISCREPANCIES BETWEEN THE PLAN AND CONDITIONS AND/OR POTENTIAL PROBLEMS OBSERVED PRIOR TO CONTINUING WORK.
- DO NOT SCALE THE PLANS. FIELD VERIFY EXACT LOCATIONS OF DOORS, WINDOWS, WALL DIMENSIONS, ETC.
- CONTRACTOR WILL GIVE SUITABLE NOTICE TO ALL APPLICABLE UTILITY COMPANIES AND OWNER PRIOR TO PERFORMING WORK INVOLVING UTILITIES.
- ALL EQUIPMENT SHALL BE HANDLED, STORED, AND PROTECTED TO PREVENT DAMAGE BEFORE AND DURING INSTALLATION IN ACCORDANCE WITH MANUFACTURER'S INSTRUCTIONS.
- ALL EQUIPMENT SHALL BE LOCATED AND INSTALLED IN A READILY ACCESSIBLE LOCATION SO AS TO PERMIT ACCESS FOR SERVICE WITHOUT DAMAGE TO BUILDING OR FINISHED MATERIALS, PER MANUFACTURER'S INSTRUCTIONS AND APPLICABLE CODES.
- 10. ALL MATERIALS SHALL BE NEW AND SHALL FIT THE SPACE AVAILABLE. VERIFY DIMENSIONS AT SITE.
- 11. ALL PIPING, APPARATUS, AND EQUIPMENT, ETC. SHALL BE PROPERLY SUPPORTED, BRACED VERTICALLY AND HORIZONTALLY IN ACCORDANCE WITH APPLICABLE CODES
- VALVES AND FITTINGS SHALL BE OF THE SAME SIZE AS THE PIPING FOR WHICH THEY ARE INSTALLED, UNLESS OTHERWISE NOTED.
- CONTRACTOR SHALL VERIFY AND CORRECT SYSTEMS AS REQUIRED TO MEET ALL CODES AND REGULATIONS AND VERIFY AND CORRECT ANY/ALL POSSIBLE DISCREPANCIES BETWEEN TYPE AND SIZE OF CONNECTIONS SPECIFIED IN THE EQUIPMENT SCHEDULES AND EQUIPMENT ACTUALLY INSTALLED.
- 14. CONTRACTOR IS RESPONSIBLE FOR COORDINATING INSTALLATION OF ALL EQUIPMENT SHOWN ON PLANS, INCLUDING COORDINATION OF ANY EQUIPMENT OF ALTERNATE MANUFACTURER. CONTRACTOR SHALL PROVIDE COMPOSITE DRAWINGS AS REQUIRED FOR INSTALLATION OF EQUIPMENT SHOWN ON PLAN FOR APPROVAL BY ENGINEER.
- 15. ALL ROOF ACCESSORIES SHALL BE COMPATIBLE WITH ROOFING SYSTEMS AS REQUIRED.
- CONTRACTOR SHALL BECOME FAMILIAR WITH ALL CONDITIONS AFFECTING THIS PROJECT AND COORDINATE WITH ALL OTHER
- 17. PRIOR TO ACCEPTANCE OF THE SPACE, ALL SYSTEMS SHALL BE TESTED, BALANCED, AND OPERATED TO DEMONSTRATE TO THE OWNER. OR HIS OR HER DESIGNATED REPRESENTATIVE. THAT THE INSTALLATION AND PERFORMANCE OF THESE SYSTEMS AND/OR PARTS THEREOF CONFORM TO THE DESIGN INTENT.
- 18. CONTRACTOR SHALL INSTALL DUCTWORK SYSTEMS PER LATEST SMACNA MANUALS. DUCT WORK SYSTEMS SHALL BE GALVANIZED G90 SHELL STEEL RATED FOR A PRESSURE CLASS OF 2" WG.
- 19. CONTRACTOR SHALL REPAIR/PATCH ALL SURFACES/WALLS DAMAGED BY CONSTRUCTION.

SPECIFICATIONS:

IN ADDITION TO BELOW, PLEASE REFER TO BOOK SPECIFICATION SECTIONS.

DUCTWORK:

COMPLY WITH SMACNA'S "HVAC DUCT CONSTRUCTION STANDARDS-METAL AND FLEXIBLE" FOR ACCEPTABLE MATERIALS, MATERIAL THICKNESS, AND DUCT CONSTRUCTION METHODS UNLESS OTHERWISE INDICATED. SHEET METAL MATERIALS SHALL BE FREE OF PITTING, SEAM MARKERS, ROLLER MARKS, STAINS, DISCOLORATIONS, AND OTHER IMPERFECTIONS.

- 1. GALVANIZED SHEET STEEL SHALL COMPLY WITH ASTM A653/A653M WITH COATING DESIGNATION OF G90. DUCTWORK FINISHES FOR SURFACES EXPOSED TO VIEW SHALL BE MILL PHOSPHATIZED.
- DUCTWORK SHALL HAVE A PRESSURE CLASS OF POSITIVE 3 INCHES WITH MINIMUM SMACNA SEAL CLASS A.

3. DUCTWORK SHALL COMPLY WITH ASTM A653/A GALVANIZED STEEL.

CONDENSATE DRAIN PIPING CONDENSATE DRAIN PIPING SHALL BE TYPE M, DRAWN-TEMPER COPPER TUBING. WROUGHT COPPER FITTINGS, AND SOLDERED JOINTS. ROUTE PIPE TO SPLASH BLOCK.

NATURAL GAS PIPING:

NATURAL GAS PIPING SHALL BE STEEL PIPE COMLPYING WITH ASTM A53/A53M, BLACK STEEL, SCHEDULE 40, TYPE E OR S, GRADE B.

ABBREVIATIONS:

ABOVE

- ACCESS DOOR ABOVE FINISHED FLOOR

BOD

ACCESS PANEL BUILDING AUTOMATION SYSTEM

AIR CONDITIONING UNIT

- BALANCING (VOLUME) DAMPER BDD
- BACKDRAFT DAMPER BLW BELOW
- BOTTOM OF PIPE BRITISH THERMAL UNITS PER HOUR

BOTTOM OF DUCT

- CFM CUBIC FEET PER MINUTE CLG COOLING
- CONSTRUCTION MANAGER CNTRL CONTROL
- CLEAN OUT COND CONDENSATE
- CONTINUED CONT CONDENSATE PUMP
- CABINET UNIT HEATER DRY BULB TEMPERATURE
- DECIBEL DIAMETER
- DIM DIMENSION DOWN
- DUCT SMOKE DETECTOR DRAWING DWG
- **EXISTING** EXHAUST AIR
- ENTERING AIR TEMPERATURE
- ELECTRICAL CONTRACTOR
- ENTERING DRY BULB TEMPERATURE EER ENERGY EFFICIENCY RATIO
- EXHAUST FAN EXHAUST GRILLE
- **ELEVATION**
- ELECTRIC ELEC
- EQUIP **EQUIPMENT**
- EXHAUST REGISTER EST **ESTIMATED**
- ELECTRIC UNIT HEATER
- ENTERING WET BULB TEMPERATURE EXT EXTERNAL
- DEGREES FAHRENHEIT
- FLR FLOOR
- FSD FIRE/SMOKE DAMPER
- FEET
- NATURAL GAS PIPING GΑ GAUGE

FIRE DAMPER

- GALLONS PER HOUR GPH **GALVANIZED STEEL**
- **HORSEPOWER**
- **HEATING**
- INTEGRATED ENERGY EFFICIENCY RATIO INCH
- **INCHES WATER GAGE** IN WG INVERT ELEVATION INV EL
- JAN JANITOR'S KILOWATTS
- LEAVING AIR TEMPERATURE
- POUNDS LRA LOCKED ROTOR AMPS
- LOUVER LV
- LEAVING WET BULB TEMPERATURE

MISCELLANEOUS

BTU-H IN 1000'S MAXIMUM CIRCUIT AMPACITY

MISC

MAXIMUM FUSE SIZE

- MAXIMUM OVERCURRENT PROTECTION
- NORMALLY CLOSED NOT IN CONTRACT NORMALLY OPEN
- NOT TO SCALE OUTSIDE AIR OD OUTSIDE DIAMETER
- OED OPEN END DUCT RG RETURN GRILLE
- SCHEDULE

REVOLUTIONS PER MINUTE

- SEASONAL ENERGY EFFICIENCY RATIO SENSIBLE
- SUPPLY GRILLE SHEET METAL & AIR-CONDITIONING CONTRACTOR
- **SMACNA** NATIONAL ASSOCIATION SPECS SPECIFICATIONS
- SS STAINLESS STEEL STA STATION
- STANDARD STD SUCTION SUC
- **TYPICAL** UNIT HEATER
- UNLESS OTHERWISE NOTED VENT LINE
- V/PH/HZ VOLTS/PHASE/HERTZ VAV VARIABLE AIR VOLUME
- VOLUME DAMPER VFD VARIABLE FREQUENCY DRIVE
- WITHOUT
- WET BULB TEMPERATURE
- WIRE MESH SCREEN

APPLICABLE CODES:

- 2018 INTERNATIONAL MECHANICAL CODE (2018 IMC)
- NFPA-90A STANDARD FOR THE INSTALLATION OF AIR CONDITIONING AND VENTILATION SYSTEMS
- NFPA-90B STANDARD FOR THE INSTALLATION OF WARM AIR HEATING AND AIR-CONDITIONING SYSTEMS
- NFPA-72 NATIONAL FIRE ALARM AND SIGNALING CODE

- 2018 INTERNATIONAL FUEL GAS CODE (2018 IFGC)
- 2018 INTERNATIONAL ENERGY CONSERVATION CODE (2018 IECC)
- 2018 INTERNATIONAL BUILDING CODE (2018 IBC) 2018 INTERNATIONAL EXISTING BUILDING CODE (2018 IEBC)

DUCT SYMBOLS:

VALVES AND ACCESSORIES: SUPPLY DUCT TURNING UP (ROUND OR AUTOMATIC AIR VENT RECTANGULAR) AUTOMATIC FLOW CONTROL VALVE SUPPLY DUCT TURNING DOWN (ROUND OR RECTANGULAR) BALANCING VALVE WITH TEST PORTS RETURN DUCT TURNING UP BLIND FLANGE RETURN DUCT TURNING DOWN BOTTOM CONNECTION EXHAUST DUCT TURNING UP CAPPED PIPE EXHAUST DUCT TURNING DOWN **─**₹ CHECK VALVE CEILING RETURN, EXHAUST OR TRANSFER CONCENTRIC REDUCER CEILING SUPPLY DIFFUSER DIRECTION OF FLOW ECCENTRIC REDUCER MITERED ELBOW WITH TURNING VANES FLANGED CONNECTION SQUARE OR RECTANGULAR DUCTWORK EXPANSION COMPENSATOR RECTANGULAR TO ROUND DUCT TRANSITION FLOW MEASURING DEVICE

−∞4−

FLOW METER

GLOBE VALVE

MANUAL AIR VENT

PRESSURE/TEMPERATURE TEST PLUG

PRESSURE GAUGE WITH GAUGE COCK

STRAINER W/BLOW DOWN VALVE

TWO WAY CONTROL VALVE

THREE WAY CONTROL VALVE

SHUTOFF VALVE (SEE SPECIFICATIONS FOR

SECTION TAG

EQUIPMENT TAG

PRESSURE REDUCING VALVE

PRESSURE RELIEF VALVE

FLEXIBLE DUCT CONNECTOR FLEXIBLE DUCT FIRE DAMPER

INDICATES ROUND DUCTWORK (DIAMETER)

RECTANGULAR TO RECTANGULAR TO ROUND

VOLUME BALANCING DAMPER MOTORIZED DAMPER

TO ROUND DUCT TRANSITION

RETURN, EXHAUST OR TRANSFER AIR FLOW SUPPLY AIR FLOW AIR FLOW DIRECTION ARROW

TAG AIR TERMINAL TAG NECK SIZE CFM

CONTROLS:

ANALOG OUTPUT (OUT OF PANEL)

DIGITAL OUTPUT (OUT OF PANEL)

- CARBON DIOXIDE SENSOR
- DIFFERENTIAL PRESSURE SENSOR DUCT SMOKE DETECTOR
- FIRESTAT
- NORMALLY CLOSED

ANALOG INPUT (TO PANEL)

DIGITAL INPUT (TO PANEL)

- CONTROL WIRING (SIGNAL PATH)
- DIFFERENTIAL PRESSURE SWITCH
- FAN ON-OFF SWITCH
- FREEZESTAT
- MOTORIZED DAMPER
- NORMALLY OPENED STATIC PRESSURE SENSOR
- SWITCH
- ZONE TEMPERATURE SENSOR TEMPERATURE TRANSMITTER


THERMOSTAT

VARIABLE SPEED DRIVE

THERMOMETER

GENERAL SYMBOLS:

STRAINER

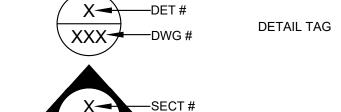

EQUIP TYPE

215 790 0727 CIVIL ENGINEER
KS ENGINEERS

856 287 2424

arstructural.com 610 688 2566

CITY OF PHILADELPHIA

1515 ARCH STREET 11TH FLOOR, ONE PARKWAY BUILDING

RENOVATIONS TO THE HAPPY

MECHANICAL GENERAL NOTES SYMBOLS AND ABBREVIATIONS

05/13/2025 AS NOTED WS

CONSTRUCTION DOCUMENTS

ALL DIMENSIONS AND CONDITIONS SHALL BE VERIFIED BY THE CONTACTOR AT THE SITE BEFORE PROCEEDING WITH THE WORL

REVISIONS

REVISIONS


DATE

ISSUE

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DEPARTMENT OF PARKS & RECREATION

PHILADELPHIA PENNSYLVANIA

HOLLOW RECREATION CENTER

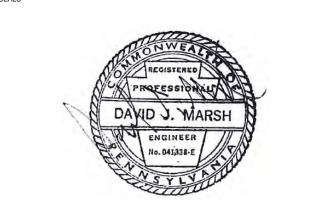16315E-03-02

(E) SUMP PUMP -(R) 1" HWR — – (R) 3/4" HWS LOCATION (R) 1" HWS — (R) 3/4" HWR (R) 1-1/2" HWR — (R) 3/4" HWS – (R) 2" HWS - (R) 1-1/2" HWS (R) 3/4" HWR (R) 2" HWR — (R) 1-1/2" HWR EXG CRAWL SPACE - (E) SUMP PUMP LOCATION BASEMENT BASEMENT (R) 1" HWS — (R) 1" HWR -– (R) 3/4" HWR (R) 3/4" HWR — (R) 3/4" HWS — (R) 3/4" HWS (R) 3/4" HWS — - (R) 3/4" HWS — (R) 3/4" HWS (R) 3/4" HWR — (R) 3/4" HWR (R) 3/4" HWR

1 MECHANICAL DEMOLITION BASEMENT PLAN MD-101 Scale: 1/8" = 1'-0"


GENERAL NOTES:

- 1. REFER TO DRAWING M001 FOR GENERAL NOTES, SYMBOLS AND ABBREVIATIONS.
- 2. REFER TO DRAWING M500 FOR MECHANICAL DETAILS.
- 3. REFER TO DRAWING M600 FOR MECHANICAL SCHEDULES.

AREA NOT IN SCOPE

TES: KEYED NOTES:

- 1 REMOVE EXISTING HEATING WATER SUPPLY PIPING IN ITS ENTIRETY INCLUDING SUPPORTS, HANGERS, FITTINGS, VALVES, ACTUATORS, POWER WIRING CONTROLS, COMPRESSED AIR PIPING, INSULATION, AND ACCESSORIES. PATCH WALL, AND FLOOR OPENINGS TO MATCH EXISTING CONSTRUCTION. ALL PATCHING SHALL BE SMOOTH AND READY FOR G.C. FINISH.
- REMOVE EXISTING HEATING WATER RETURN PIPING IN ITS ENTIRETY INCLUDING SUPPORTS, HANGERS, FITTINGS, VALVES, ACTUATORS, POWER WIRING CONTROLS, COMPRESSED AIR PIPING, INSULATION, AND ACCESSORIES. PATCH WALL AND FLOOR OPENINGS TO MATCH EXISTING CONSTRUCTION. ALL PATCHING SHALL BE SMOOTH AND READY FOR G.C. FINISH.
- REMOVE EXISTING BOILER IN ITS ENTIRETY INCLUDING EQUIPMENT SUPPORTS, BURNERS, IGNITERS, BLOWERS, GASKETS, FLUE, CONTROL BOARDS, DISPLAY BOARDS, TRANSFORMERS, AMPLIFIERS, SWITCHES, SENSORS, WIRING, HOT WATER PIPING, AQUASTATS, THERMOMETER, GAUGES, PUMPS, GAS, GAS PIPING, REGULATORS, GAS VALVES, RELIEF VALVES, FILTERS, AND ALL ACCESSORIES. PATCH FLOOR TO MATCH EXISTING CONSTRUCTION. ALL PATCHING SHALL BE SMOOTH AND READY FOR G.C. FINISH.
- REMOVE EXISTING HEATING WATER PUMP IN ITS ENTIRETY INCLUDING SUPPORTS HANGERS, VALVES, PIPING, INSULATION, MOTOR STARTER, VFD, DISCONNECT, SWITCH CONTROLS, POWER WIRING, AND ACCESSORIES.
- REMOVE EXISTING HEATING WATER SYSTEM EXPANSION TANK IN ITS ENTIRETY INCLUDING SUPPORTS, HANGERS, PIPING, VALVES, THERMOMETER, GAUGES, INSULATION, AND ACCESSORIES. PATCH CEILING OPENINGS TO MATCH EXISTING CONSTRUCTION. ALL PATCHING SHALL BE SMOOTH AND READY FOR G.C. FINISH.
- REMOVE EXISTING SUSPENDED CAST IRON RADIATOR IN ITS ENTIRETY INCLUDING SUPPORTS, COVERS, COILS, PIPING, VALVES, CONTROLS AND ACCESSORIES. PATCH CEILING OPENINGS TO MATCH EXISTING CONSTRUCTION. ALL PATCHING SHALL BE SMOOTH AND READY FOR G.C. FINISH.
- 7 REMOVE EXISTING HEATING WATER SYSTEM AIR SEPARATOR IN ITS ENTIRETY INCLUDING SUPPORTS, HANGERS, PIPING, VALVES, INSULATION, AND ACCESSORIES. PATCH CEILING OPENINGS TO MATCH EXISTING CONSTRUCTION. ALL PATCHING SHALL BE SMOOTH AND READY FOR G.C. FINISH.
- REMOVE EXISTING BREECHING AND FLUE VENT IN ITS ENTIRETY INCLUDING DUCT, DAMPERS, SUPPORTS, HANGERS, INSULATION, ROOF FLASHING, STORM COLLAR, CAP, AND ACCESSORIES. MECHANICAL CONTRACTOR TO COORDINATE THE INFILL OF THE EXISTING BREECHING'S ROOF PENETRATIONS WITH ROOFING CONTRACTOR. MECHANICAL CONTRACTOR TO PROVIDE TEMPORARY ROOF PATCHING DURING CONSTRUCTION.
- 9 REMOVE EXISTING CONCRETE PAD IN ITS ENTIRETY INCLUDING ALL REINFORCEMENT METAL AND PATCH FLOOR FLUSH AND READY FOR INSTALLATION OF NEW WORK.

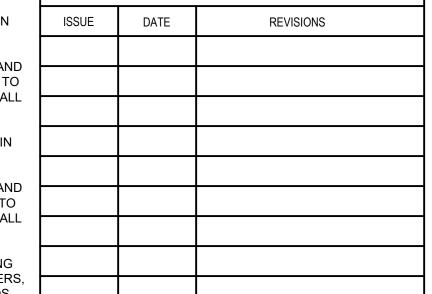

REVISIONS




CONSTRUCTION DOCUMENTS

PROJECT COORDINATOR

LEEANN SUEN

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CITY OF PHILADELPHIA
DEPARTMENT OF PARKS & RECREATION

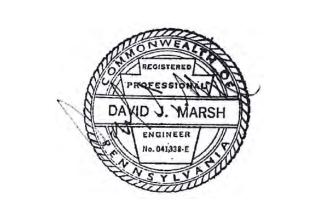1515 ARCH STREET

11TH FLOOR, ONE PARKWAY BUILDING

PENNSYLVANIA

PHILADELPHIA

JECT TITLE

RENOVATIONS TO THE HAPPY HOLLOW RECREATION CENTER

DRAWING TITLE

MECHANICAL DEMOLITION BASEMENT PLAN

DATE 05/13/2025

SCALE AS NOTED

DRAWN BY WS

CHECKED BY DM

DRAWNG NO.

DRAWNING NO.

DRAWNING NO.

PROJECT NO.

DRAWNING NO.

PROJECT NO.

DRAWNING NO.


FILE:

CONSTRUCTION DOCUMENTS

ALL DIMENSIONS AND CONDITIONS SHALL BE VERIFIED BY THE



- SYMBOLS AND ABBREVIATIONS.
- 3. REFER TO DRAWING M800 FOR MECHANICAL SCHEDULES.

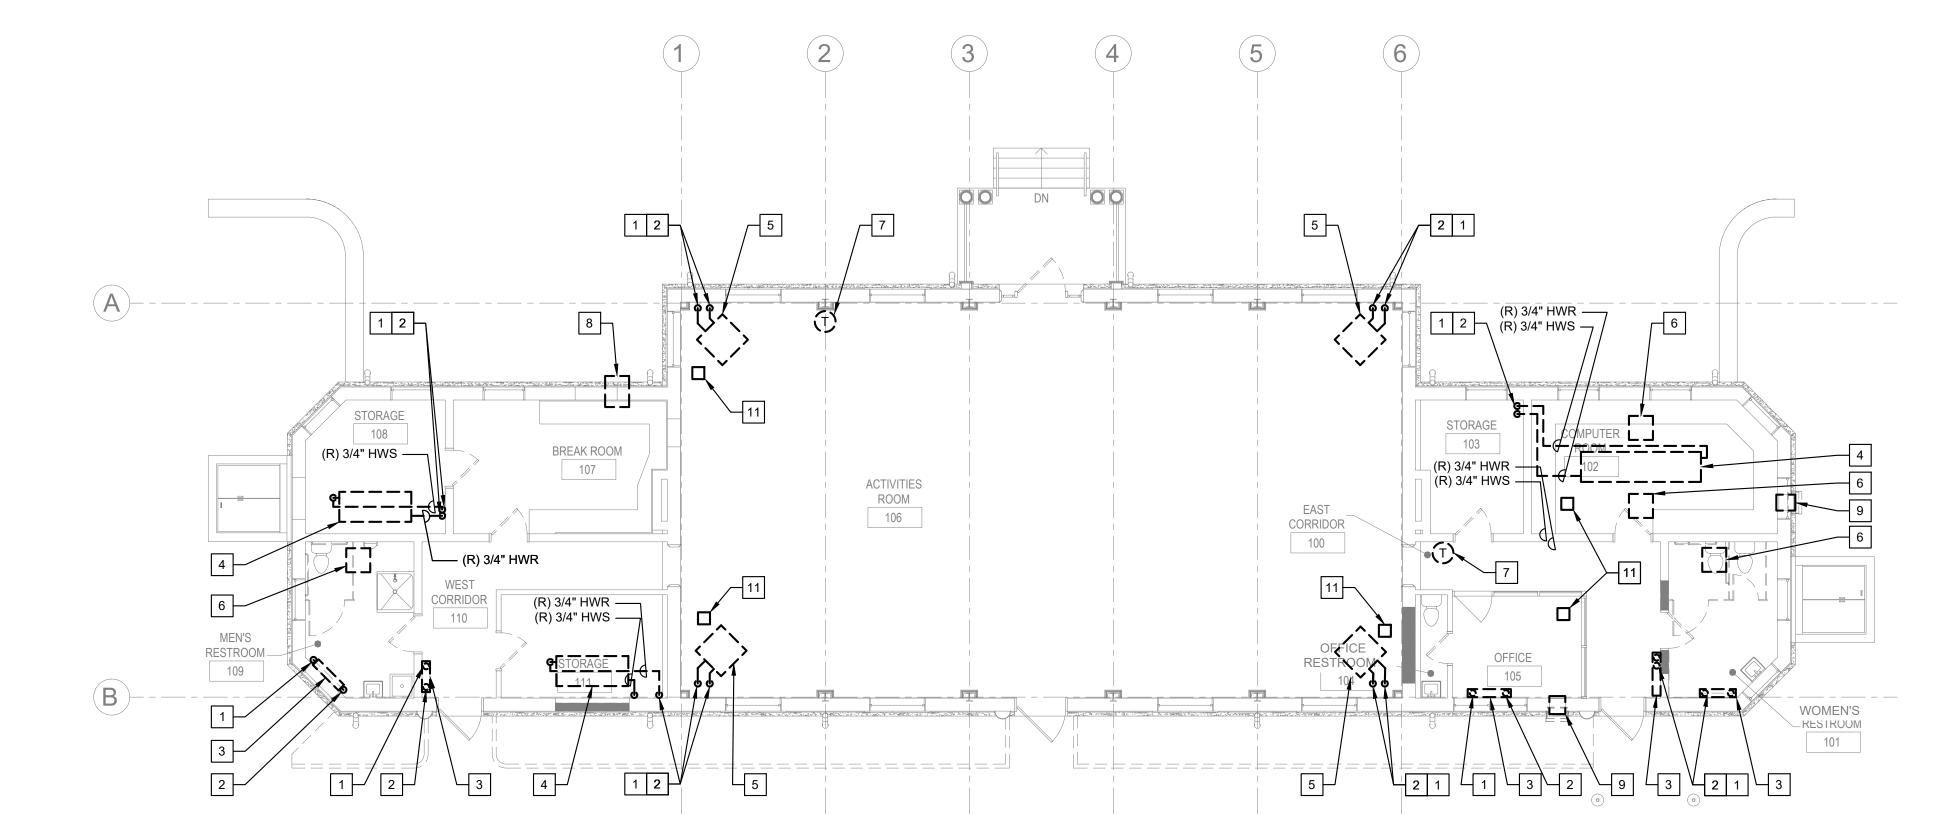



MECHANICAL DEMOLITION FIRST FLOOR PLAN Scale: 1/8" = 1'-0"

- 1. REFER TO DRAWING M001 FOR GENERAL NOTES,
- 2. REFER TO DRAWING M700 FOR MECHANICAL DETAILS.

KEYED NOTES:


- 1 REMOVE EXISTING HEATING WATER SUPPLY PIPING IN ITS ENTIRETY INCLUDING SUPPORTS, HANGERS, FITTINGS, VALVES, ACTUATORS, POWER WIRING CONTROLS, COMPRESSED AIR PIPING, INSULATION, AND ACCESSORIES. PATCH WALL, AND FLOOR OPENINGS TO MATCH EXISTING CONSTRUCTION. ALL PATCHING SHALL BE SMOOTH AND READY FOR
- 2 REMOVE EXISTING HEATING WATER RETURN PIPING IN ITS ENTIRETY INCLUDING SUPPORTS, HANGERS, FITTINGS, VALVES, ACTUATORS, POWER WIRING CONTROLS, COMPRESSED AIR PIPING, INSULATION, AND ACCESSORIES. PATCH WALL AND FLOOR OPENINGS TO MATCH EXISTING CONSTRUCTION. ALL PATCHING SHALL BE SMOOTH AND READY FOR G.C. FINISH.
- 3 REMOVE EXISTING CAST IRON RADIATOR IN ITS ENTIRETY INCLUDING SUPPORTS, COVERS, COILS, PIPING, VALVES, CONTROLS AND ACCESSORIES. PATCH WALL AND FLOOR OPENINGS TO MATCH EXISTING CONSTRUCTION. ALL PATCHING SHALL BE SMOOTH AND READY FOR G.C. FINISH.
- 4 REMOVE EXISTING SUSPENDED CAST IRON RADIATOR IN ITS ENTIRETY INCLUDING SUPPORTS, COVERS, COILS, PIPING, VALVES, CONTROLS AND ACCESSORIES. PATCH CEILING OPENINGS TO MATCH EXISTING CONSTRUCTION. ALL PATCHING SHALL BE SMOOTH AND READY FOR G.C. FINISH.
- 5 MECHANICAL CONTRACTOR SHALL REMOVE EXISTING UNIT HEATER IN ITS ENTIRETY INCLUDING SUPPORTS, CABINET, FANS, MOTORS, DAMPERS, COILS, PIPING, VALVES, CONTROLS, TRANSFORMERS, POWER WIRING, SENSORS, ACTUATORS, SWITCHES, AND ACCESSORIES. PATCH WALL OPENINGS TO MATCH EXISTING CONSTRUCTION. ALL PATCHING SHALL BE SMOOTH AND READY FOR G.C. FINISH.
- 6 REMOVE EXISTING RELIEF GRILLE IN ITS ENTIRETY INCLUDING ANY RELIEF DAMPER AT CEILING IN ITS ENTIRETY INCLUDING SUPPORTS, HANGERS, DUCTWORK, FITTINGS, DAMPER, ACTUATORS, POWER WIRING, CONTROL, COMPRESSED AIR, TUBING, AND ACCESSORIES. PATCH CEILING OPENINGS TO MATCH EXISTING CONSTRUCTION. ALL PATCHING SHALL BE SMOOTH AND READY FOR G.C. FINISH.
- 7 REMOVE EXISTING THERMOSTAT IN ITS ENTIRETY INCLUDING HANGERS, SUPPORTS, AIR TUBING, WIRING, CONTROLS AND ACCESSORIES. PATCH WALL TO MATCH EXISTING MATERIAL ALL PATCHING SHALL BE SMOOTH AND READY FOR G.C. FINISH.
- 8 REMOVE EXISTING EXHAUST FAN IN ITS ENTIRETY INCLUDING SUPPORTS, HANGERS, MOTORS, VIBRATION ISOLATORS, FITTINGS, INSULATION, DAMPERS, CONTROLS, TRANSFORMERS, POWER WIRING, SENSORS, ACTUATORS, SWITCHES, AND ACCESSORIES. PATCH WALL AND OR ROOF OPENINGS TO MATCH EXISTING CONSTRUCTION. ALL PATCHING SHALL BE SMOOTH AND READY FOR G.C. FINISH.
- 9 REMOVE EXISTING THRU-WALL AIR CONDITIONER IN ITS ENTIRETY. MECHANICAL CONTRACTOR TO GIVE PARKS AND RECREATION RIGHT TO FIRST REFUSAL BEFORE SCRAPPING THE UNITS.
- 10 REMOVE AND STORE EXISTING AIR PURIFIER IN ITS ENTIRETY.
- 11 CLIENT TO REMOVE EXISTING AIR PURIFIER PRIOR TO CONSTRUCTION.

	REVISIONS					
ISSUE	DATE	REVISIONS				



CONSTRUCTION DOCUMENTS

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1515 ARCH STREET

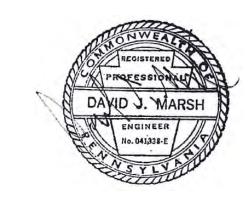11TH FLOOR, ONE PARKWAY BUILDING PHILADELPHIA PENNSYLVANIA

RENOVATIONS TO THE HAPPY **HOLLOW RECREATION CENTER**

MECHANICAL DEMOLITION FIRST FLOOR PLAN


16315E-03-02 MD-102 05/13/2025 AS NOTED DM ALL DIMENSIONS AND CONDITIONS SHALL BE VERIFIED BY THE

CONSTRUCTION DOCUMENTS

CONTACTOR AT THE SITE BEFORE PROCEEDING WITH THE WORK

SCALE: 1/8"=1'-0"

- REFER TO DRAWING M001 FOR GENERAL NOTES, SYMBOLS AND ABBREVIATIONS.
- 2. REFER TO DRAWING M500 FOR MECHANICAL DETAILS.
- 3. REFER TO DRAWING M600 FOR MECHANICAL SCHEDULES.
- 4. MECHANICAL CONTRACTOR SHALL COORDINATE ALL ROOF PENETRATIONS WITH GENERAL CONTRACTOR. GENERAL CONTRACTOR SHALL CUT AND PATCH ROOF.
- FOR SUITABLE ROOFING CONTRACTOR AS TO NOT VOID EXISTING ROOF WARRANTY.

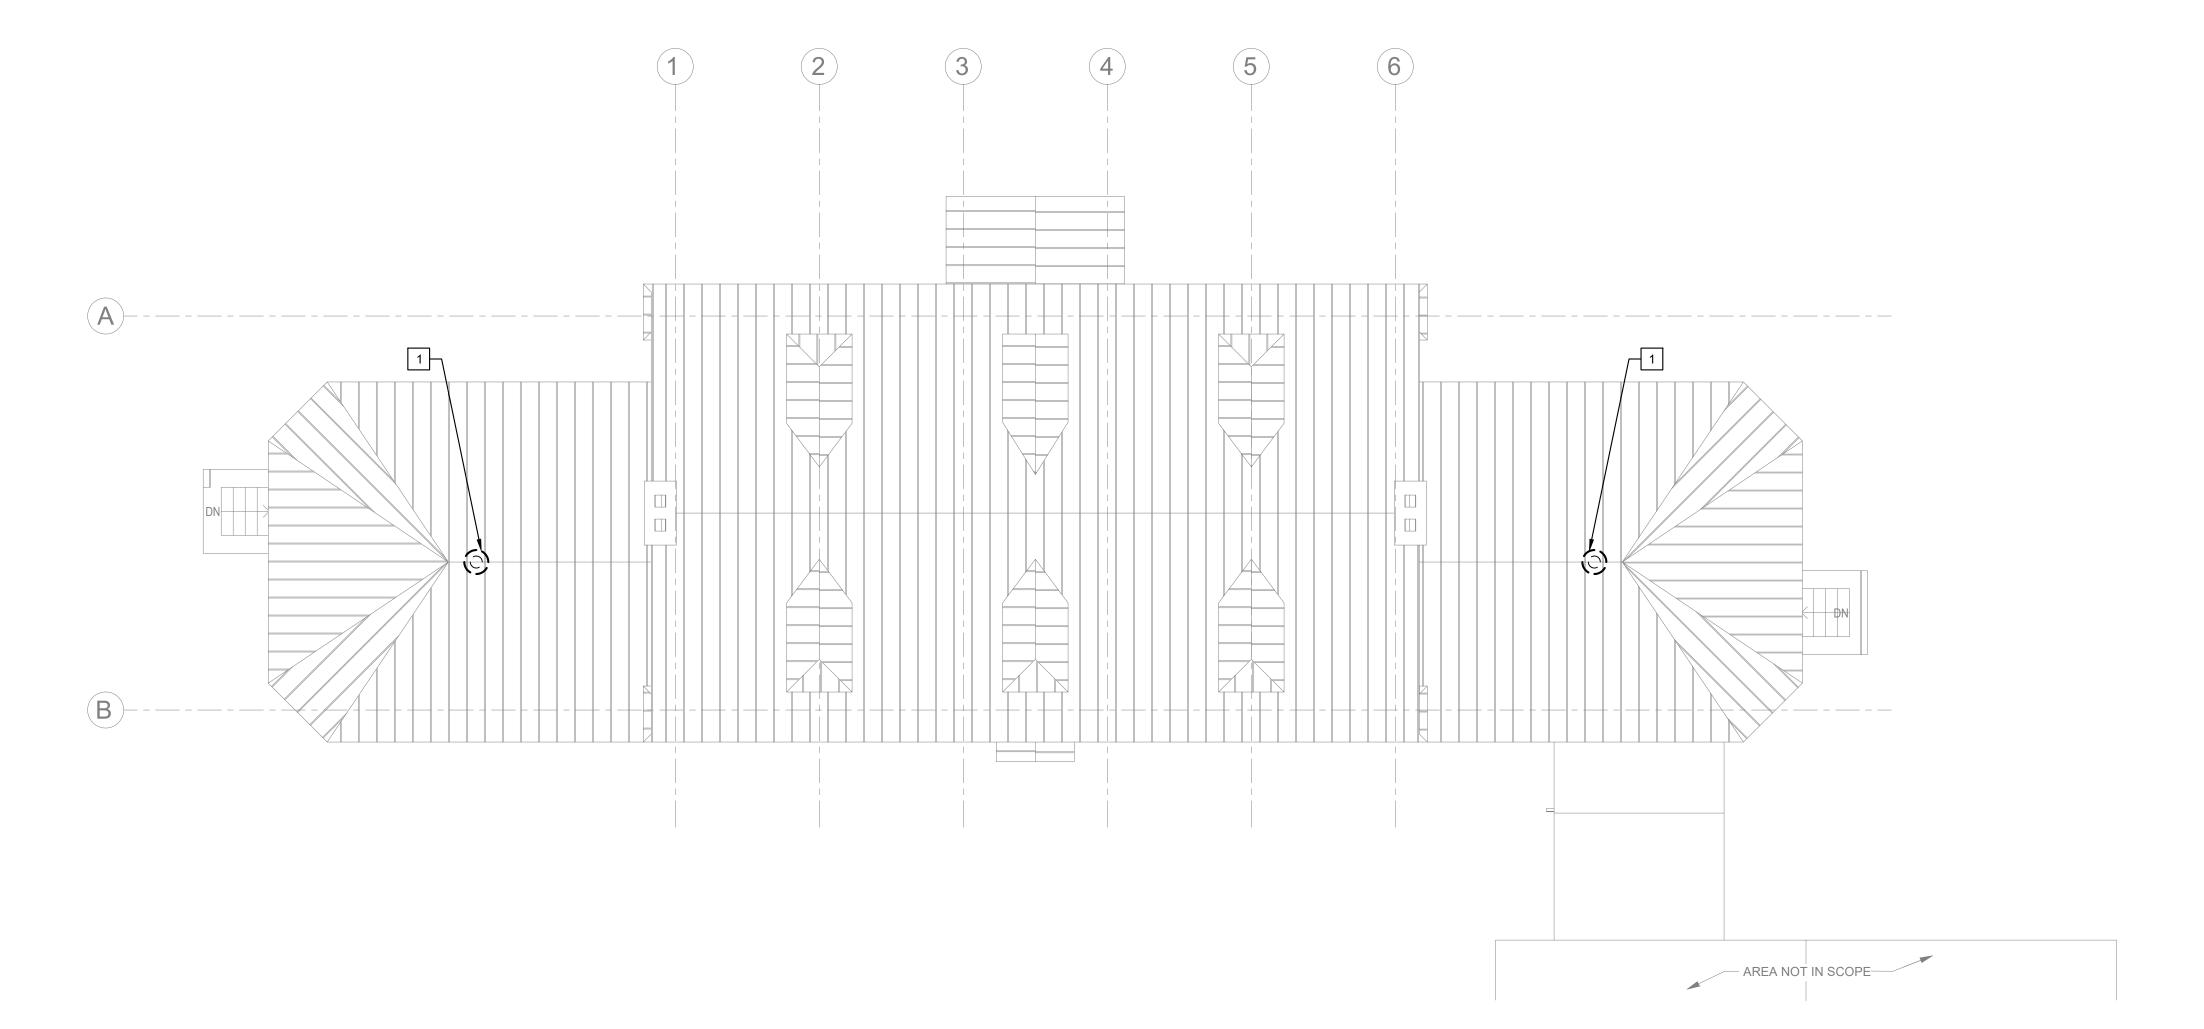



- 5. COORDINATE WITH OWNER'S REPRESENTATIVE

KEYED NOTES:

MECHANICAL CONTRACTOR SHALL REMOVE
EXISTING GRAVITY RELIEF VENT IN ITS ENTIRETY
INCLUDING CURB, DAMPER, AIR DEVICE, DUCTWORK
POWER AND CONTROL WIRING, CONTROLS, AND ACCESSORIES. PATCH ROOF TO MATCH EXISTING. COORDINATE WITH OWNER'S REPRESENTATIVE FO SUITABLE ROOFING CONTRACTOR AS TO NOT VOID ROOF WARRANTY. PROVIDE TEMPORARY ROOF PATCHING DURING CONSTRUCTION.

		REVI	SIONS
	ISSUE	DATE	REVISIONS
RK,			
). OD			
OR ID			



CONSTRUCTION DOCUMENTS

PROJECT COORDINATOR

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CITY OF PHILADELPHIA DEPARTMENT OF PARKS & RECREATION

1515 ARCH STREET

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PHILADELPHIA

RENOVATIONS TO THE HAPPY **HOLLOW RECREATION CENTER**


PENNSYLVANIA

MECHANICAL DEMOLITION ROOF PLAN

THOULDTHO		BIGHING NO.
16	6315E-03-02	100
DATE	05/13/2025	MD-103
SCALE	AS NOTED	
DRAWN BY	WS	
CHECKED BY	DM	FILE:

CONSTRUCTION DOCUMENTS



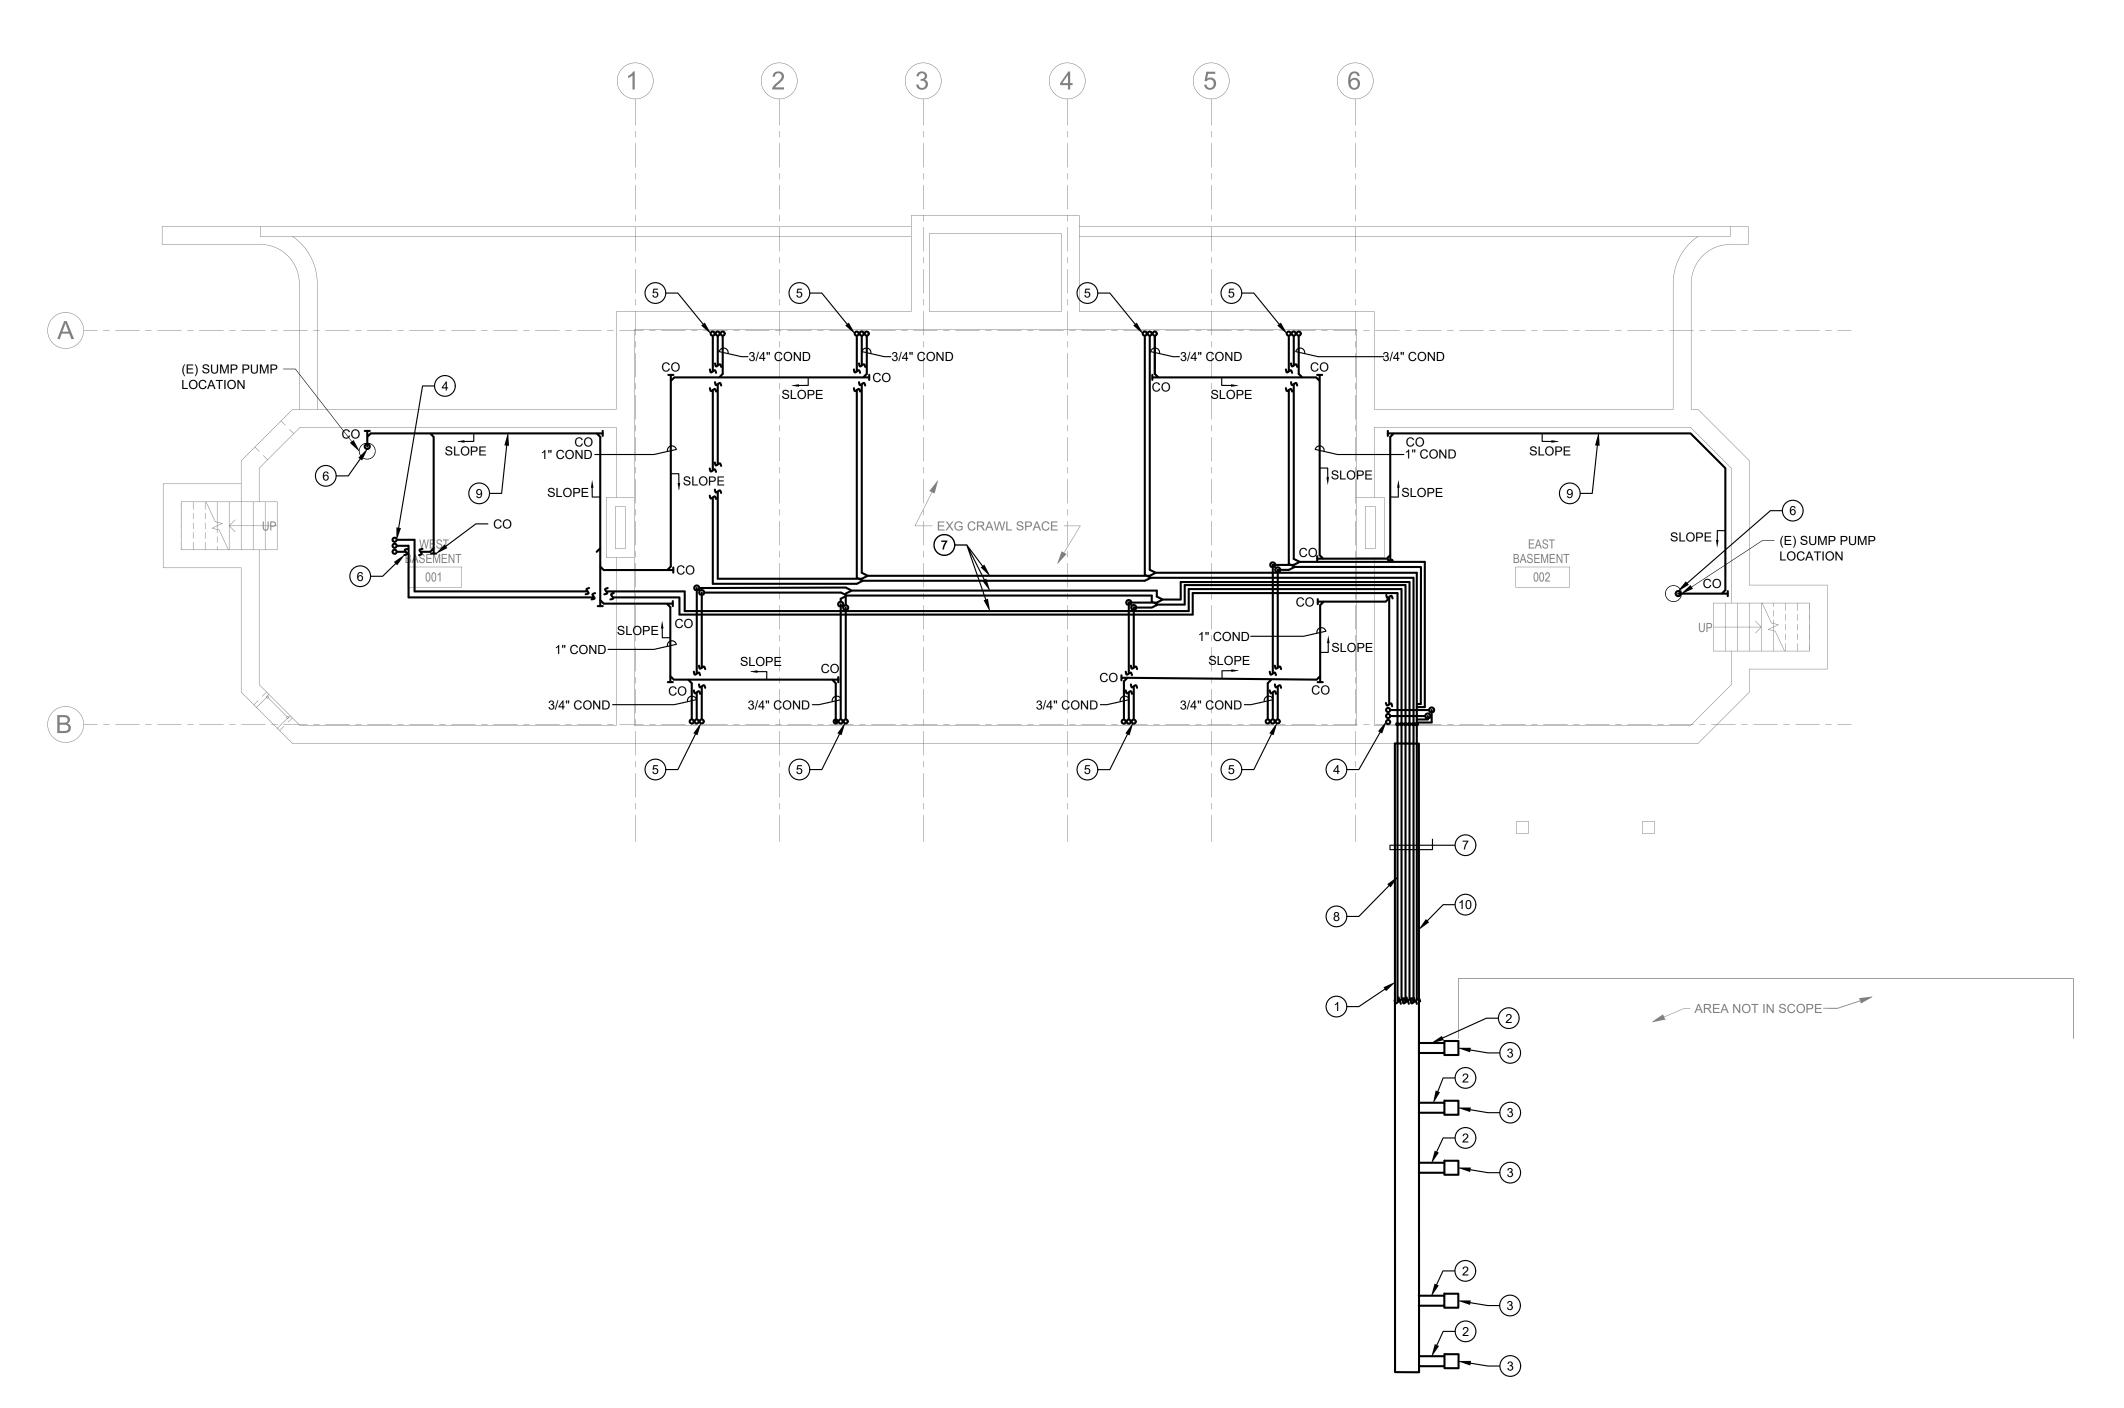

MECHANICAL BASEMENT PLAN Scale: 1/8" = 1'-0"

GENERAL NOTES:

- 1. REFER TO DRAWING M001 FOR GENERAL NOTES,
- 2. REFER TO DRAWING M500 FOR MECHANICAL DETAILS.
- 3. REFER TO DRAWING M600 FOR MECHANICAL SCHEDULES.
- 4. EQUIPMENT LOCATIONS SHOWN ARE DIAGRAMMATIC. PLEASE REFER TO ARCHITECTURAL PLANS FOR PRECISE LOCATIONS
- OF EQUIPMENT.

- 1) PROVIDE HDPE (HIGH DENSITY POLYETHYLENE) TO SYMBOLS AND ABBREVIATIONS. BE INSTALLED IN THE GROUND BELOW THE FROST LINE TO ENCASE THE REFRIGERANT PIPING GOING TO THE TERMINAL UNITS IN THE HAPPY HOLLOW RECREATION CENTER.
 - 2 PROVIDE HDPE (HIGH DENSITY POLYETHYLENE) 10Ø DUCT BRANCH TO HDPE 12X12 SQUARE PLENUM.

KEYED NOTES:

- (3) HDPE 12X12 HDPE (HIGH DENSITY POLYETHYLENE) SQUARE PLENUM 12" ABOVE GRADE.
- REFRIGERANT PIPING UP TO FIRST FLOOR AND CONDENSATE PIPING DOWN FROM FIRST FLOOR TERMINATING AT SUMP PUMP SUMP.
- 5 REFRIGERANT AND CONDENSATE PIPING UP TO FLOOR MOUNTED UNIT ON THE FIRST FLOOR
- 6 CONDENSATE PIPING TO DISCHARGE TO SUMP PUMP.
- 7 REFRIGERANT PIPING SHALL BE SIZED PER MANUFACTURER RECOMMENDATION.
- 8 PROVIDE SPECIFIED REFRIGERANT PIPING INSULATION ON PIPING IN THE HDPE (HIGH DENSITY POLYETHYLENE) DUCT.
- 9 CONDENSATE PIPING TO BE INSTALLED ALONG WALL.
- PROVIDE ALL EXCAVATING, BACKFILLING, AND WORK INCIDENTAL TO EXCAVATING. REQUIRED TO INSTALL THE HDPE (HIGH DENSITY POLYETHYLENE DUCTWORK). EXCAVATION AND BACKFILL SHALL BE COMPLETED PER MANUFACTURER RECOMMENDATIONS.


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)	ISSUE	DATE	REVISIONS
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CITY OF PHILADELPHIA DEPARTMENT OF PARKS & RECREATION

1515 ARCH STREET

11TH FLOOR, ONE PARKWAY BUILDING PHILADELPHIA PENNSYLVANIA

RENOVATIONS TO THE HAPPY **HOLLOW RECREATION CENTER**

MECHANICAL BASEMENT PLAN

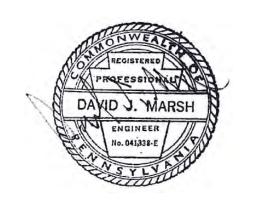PROJECT NO).	DRAWING NO.
1	6315E-03-02	
DATE	05/13/2025	M-101
SCALE	AS NOTED	
DRAWN BY	WS	
CHECKED B	Y DM	FILE:
NOTE:	ALL DIMENSIONS AND CONDITIONS SI CONTACTOR AT THE SITE BEFORE PRO	



STORAGE BREAK ROOM / DS \ DS ROOM 102 COND 3/4" COND **BOXING RING ACTIVITIES** ROOM ACC WOMEN'S 106 RESTROOM 112 RESTROOM 8x6 EA -ALL GENDER RESTROOM RESTROOM (NON ACC) 114 L_{3/4"} COND 101 /DS\ ∕bs\ CORRIDOR GYMNASIUM 120 AREA NOT IN SCOPE-

MECHANICAL FIRST FLOOR PLAN


Scale: 1/8" = 1'-0"

GENERAL NOTES:

- 1. REFER TO DRAWING M001 FOR GENERAL NOTES, SYMBOLS AND ABBREVIATIONS.
- 2. REFER TO DRAWING M500 FOR MECHANICAL DETAILS.
- 3. REFER TO DRAWING M600 FOR MECHANICAL SCHEDULES.
- 4. EQUIPMENT LOCATIONS SHOWN ARE
- DIAGRAMMATIC. PLEASE REFER TO ARCHITECTURAL PLANS FOR PRECISE LOCATIONS OF EQUIPMENT.

KEYED NOTES:

- REFRIGERANT PIPING DOWN TO CRAWL SPACE
- REFRIGERANT PIPING TO BE INSTALLED ABOVE CEILING. THE VRF REFRIGERANT PIPING TO CONTINUE TO EACH TERMINAL UNIT.
- REFRIGERANT AND CONDENSATE PIPING DOWN TO CRAWL SPACE.
- REFRIGERANT AND CONDENSATE PIPING TO BE INSTALLED ABOVE CEILING.
- SURFACE MOUNT INDOOR UNIT TO THE EXISTING CEILING AND SUPPORT FROM EXISTING STRUCTURE PER MANUFACTURER RECOMMENDATIONS.
- INSTALL CEILING EXHAUST FAN BETWEEN STRUCTURE. STRUCTURE IS 16 INCH ON CENTER. CONTRACTOR TO CONFIRM LOCATION IN THE FIELD AND COORDINATE LOCATION WITH GENERAL CONTRACTOR.
- INSTALL CEILING ELECTRIC UNIT HEATERS BETWEEN STRUCTURE. STRUCTURE IS 16 INCH ON CENTER. CONTRACTOR TO CONFIRM LOCATION IN THE FIELD AND COORDINATE LOCATION WITH GENERAL CONTRACTOR.
- PROVIDE STAINLESS STEEL CLAMPS AND MODULE CAP AROUND CONDUIT AND PIPE. PROVIDE THE PATE COMPANY CURB ASSEMBLIES MODEL PPC-1 CAP STYLE WITH B-3 MODULE CAP AND INSTALL ON 12X12 HPDE (HIGH DENSITY POLYETHYLENE) CURB. UNITS SHALL HAVE FOUR (4) BOOTS FOR REFRIGERANT LINES, CONTROL CONDUIT, AND ELECTRICAL POWER CONDUIT. DO NOT INSULATE THROUGH MODULE CAP. PROVIDE STAINLESS STEEL CLAMPS AND MODULE CAP AROUND CONDUIT AND PIPE. (FOR CU-1,2,3,4,5).
- PROVIDE THE PATE COMPANY EQUIPMENT SUPPORTS MODEL ES-1 SPACED MAXIMUM 48" APART (FOR CU-1,2,3, 4,5).
- REFRIGERANT PIPING SHALL BE INSTALLED GOING THROUGH HDPE (HIGH DENSITY POLYETHYLENE) PLENUM DOWN TO THE HDPE DUCT ENCASING THE REFRIGERANT PIPING BELOW GROUND.
- REFER TO CONDENSING UNIT PIPING CURB DETAIL (TYPICAL FOR CU-1,2,3,4,5).
- CONDENSING UNITS (CU-1,2,3,4,5) SHALL BE ON OUTSIDE CONCRETE PADS. CONDENSERS SHALL BE OFFSET BY A MINIMUM OF TWENTY INCHES FROM THE GYMNASIUM WALL PER MANUFACTURER RECOMMENDATIONS.
- EQUIPMENT CLEARANCES (TYPICAL).
- REFRIGERANT PIPING SIZED PER
- MANUFACTURER RECOMMENDATION.
- CONDENSATE PIPING TO BE INSTALLED ABOVE CEILING. THE CONDENSATE PIPING TO CONTINUE TO EACH TERMINAL UNIT.
- CONDENSERS SHALL BE OFFSET BY A MINIMUM OF 24 INCHES FROM THE ENCLOSURE PER THE MANUFACTURER RECOMMENDATIONS (TYPICAL FOR CU-1,2,3,4,5).
- 24 INCH HDPE (HIGH DENSITY POLYETHYLENE) DUCT BURIED BELOW THE FROST LINE (36 INCHES) BENEATH CONCRETE PAD.
- ALL EXTERIOR HVAC EQUIPMENT SHALL BE PROTECTED BY STEEL COMMERCIAL THEFT/VANDALISM SECURITY PROTECTION CAGES. THE PHYSICAL SIZE, ETC. OF EACH SECURITY CAGE SHALL BE UNIQUELY DETERMINED BY THE SECURITY CAGE PROVIDER TO MATCH THE DIMENSIONS AND OPERATING REQUIREMENTS OF EACH UNIT PROTECTED. THE SECURITY CAGES SHALL BE OF SUFFICIENTLY ROBUST CONSTRUCTION AND SECURELY ATTACHED TO THE STEEL DUNNAGE OR ROOF TO PROTECT THE EQUIPMENT FROM ALL THEFT AND VANDALISM. THE SECURITY CAGES SHALL HAVE SUFFICIENT OPEN FREE AREA FOR ALL REQUIRED AIR MOVEMENT FOR PROPER EQUIPMENT OPERATION. THE SECURITY CAGES SHALL BE PROVIDED WITH SUFFICIENTLY LARGE OPERABLE OR DEMOUNTABLE NORMALLY SECURED ACCESS MEAN TO PREFORM ALL REQUIRED EQUIPMENT MAINTENANCE, WHILE PREVENTING UNAUTHORIZED ENTRY. THE ACTUAL DESIGN OF THE SECURITY CAGES SHALL BE PERFORMED BY THE SECURITY CAGE PROVIDED AS A DELEGATED DESIGN AND SUBMITTED TO THE ARCHITECT/ENGINEER FOR REVIEW AND APPROVAL PRIOR TO FABRICATION. THE DESIGN OF THE SECURITY CAGES SHALL BE BASED UPON THE REQUIREMENTS OF THE ACTUAL EQUIPMENT (MAKE/MODEL) INSTALLED UNDER THIS PROJECT.
- PROVIDE MOTOR OPERATED DAMPER FOR EXHAUST VENT (EV-1). MOD SHALL BE INTERLOCKED WITH EXHAUST FAN (EF-4).
- PROVIDE MOTOR OPERATED DAMPER FOR EXHAUST VENT (EV-2). MOD SHALL BE INTERLOCKED WITH EXHAUST FAN (EF-1, EF-2, &
- 8X8 EXHAUST AIR DUCTWORK UP TO EV-1.
- 10X10 EXHAUST AIR DUCTWORK UP TO EV-1
- PROVIDE PIPE ENCLOSURE AND CONDENSATE PUMP COVER FOR WALL MOUNTED UNIT. REFER TO DETAIL 5 ON M-501. TYPICAL FOR ALL WALL MOUNTED UNITS.
- GENERAL CONTRACTOR TO PROVIDE 0.5 SQUARE FEET FREE AREA LOUVER IN DOOR.

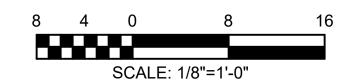


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CONSTRUCTION DOCUMENTS

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CITY OF PHILADELPHIA DEPARTMENT OF PARKS & RECREATION

1515 ARCH STREET 11TH FLOOR, ONE PARKWAY BUILDING PHILADELPHIA PENNSYLVANIA

RENOVATIONS TO THE HAPPY **HOLLOW RECREATION CENTER**

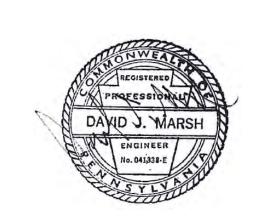MECHANICAL FIRST FLOOR PLAN


16315E-03-02 M-102 05/13/2025 AS NOTED DM ALL DIMENSIONS AND CONDITIONS SHALL BE VERIFIED BY THE

CONSTRUCTION DOCUMENTS

CONTACTOR AT THE SITE BEFORE PROCEEDING WITH THE WORK

- SCHEDULES.
- CONTRACTOR. GENERAL CONTRACTOR SHALL CUT AND PATCH ROOF.

- 2. REFER TO DRAWING M500 FOR MECHANICAL
- 3. REFER TO DRAWING M600 FOR MECHANICAL
- VOID EXISTING ROOF WARRANTY.

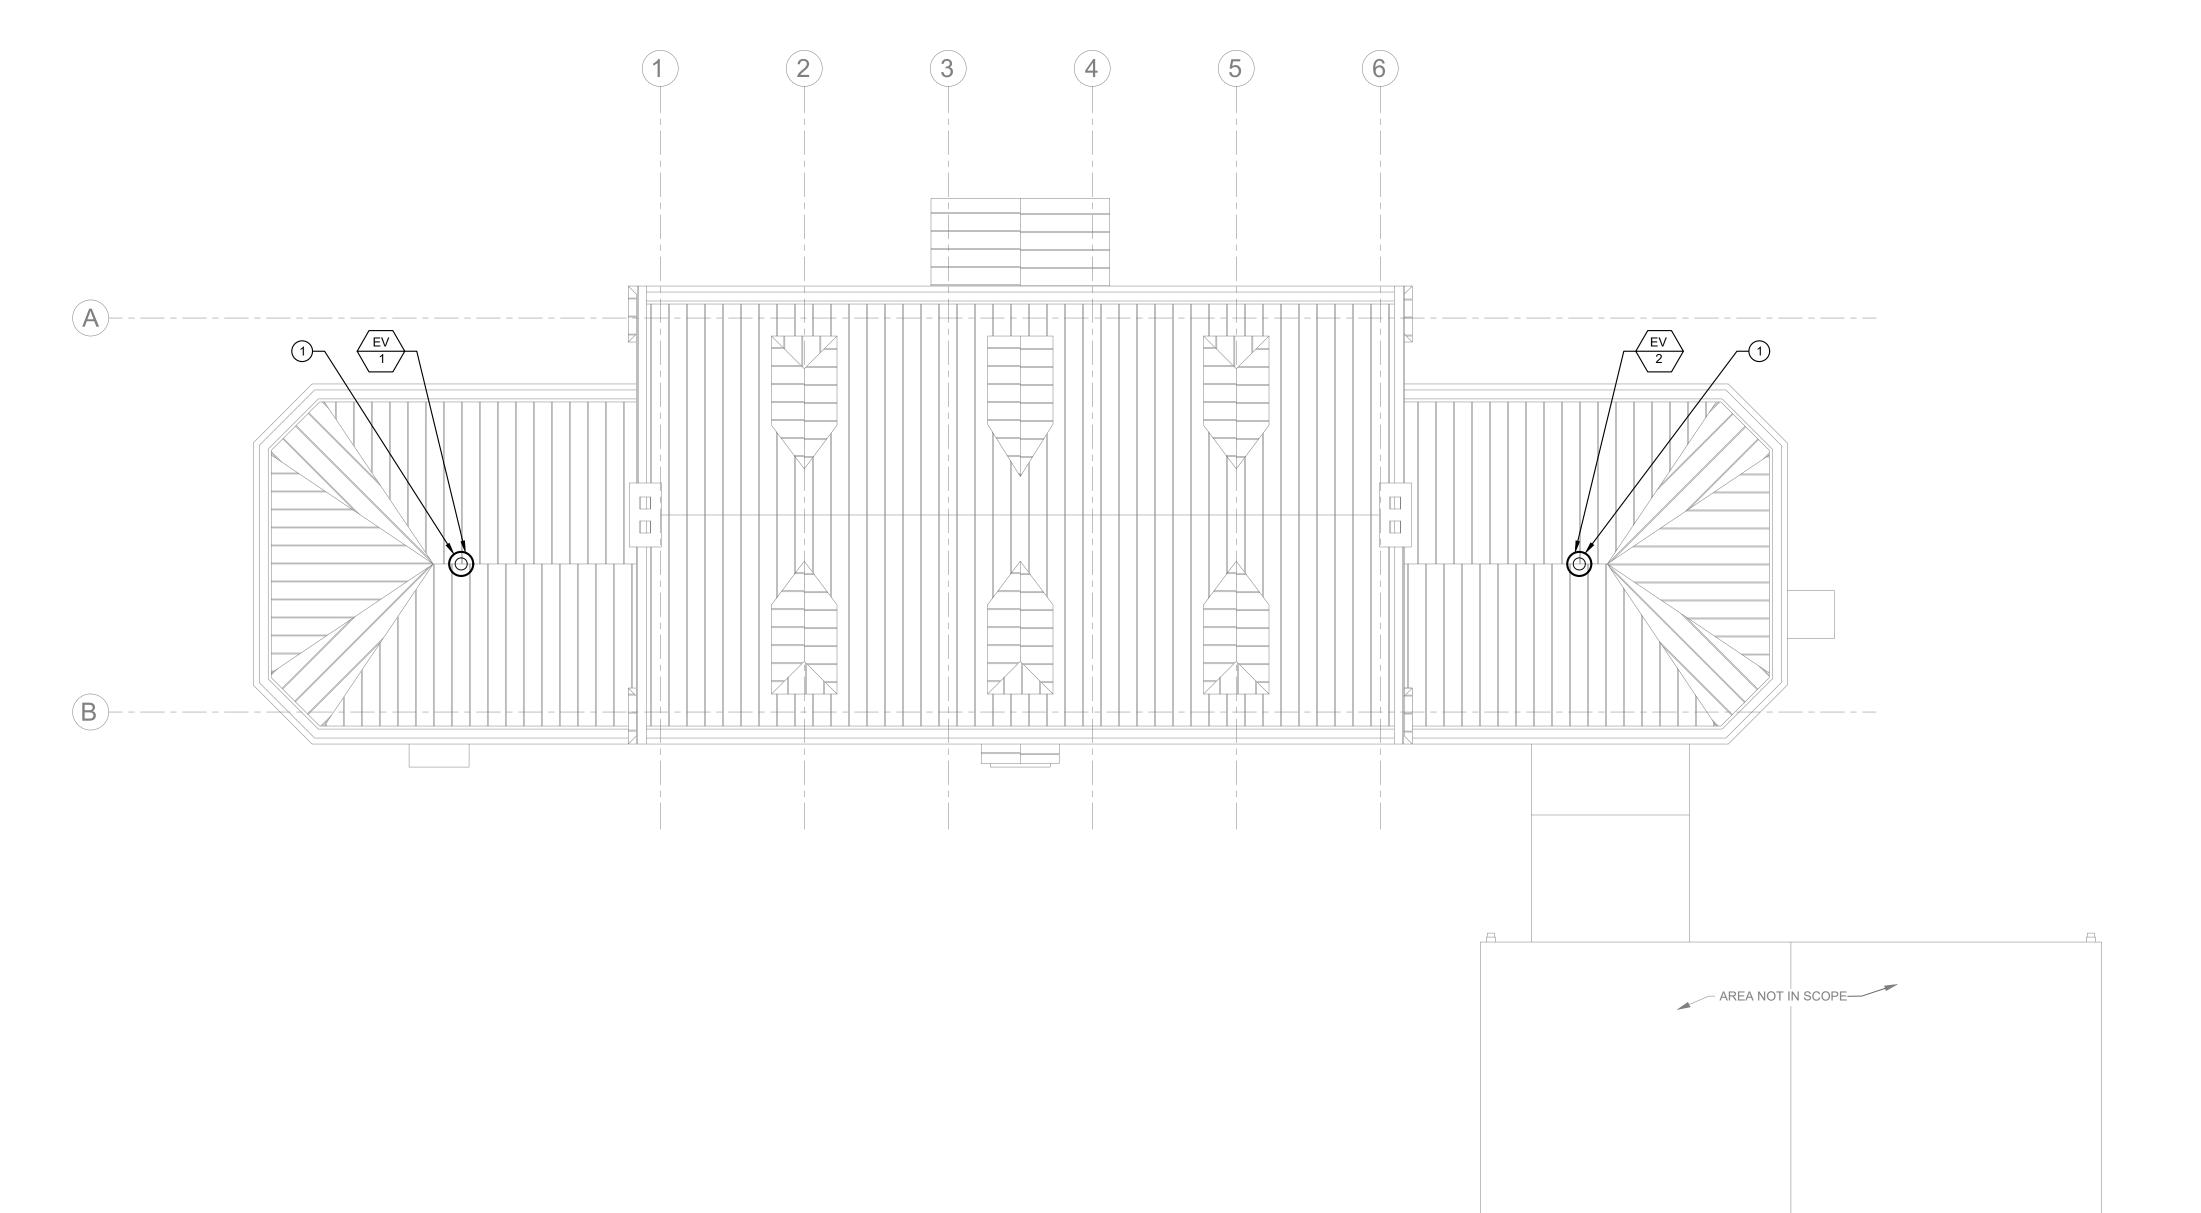



- REFER TO DRAWING M001 FOR GENERAL NOTES, SYMBOLS AND ABBREVIATIONS.
- DETAILS.
- 4. MECHANICAL CONTRACTOR SHALL COORDINATE ALL ROOF PENETRATIONS WITH GENERAL
- 5. COORDINATE WITH OWNER'S REPRESENTATIVE FOR SUITABLE ROOFING CONTRACTOR AS TO NOT

KEYED NOTES:


1 MECHANICAL CONTRACTOR SHALL COORDINATE ALL ROOF PENETRATIONS WITH GENERAL CONTRACTOR. GENERAL CONTRACTOR SHALL CUT AND PATCH ROOF FOR EXHAUST VENT (EV-1 AND EV-2).

	REVI	SIONS
ISSUE	DATE	REVISIONS



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CITY OF PHILADELPHIA DEPARTMENT OF PARKS & RECREATION

1515 ARCH STREET

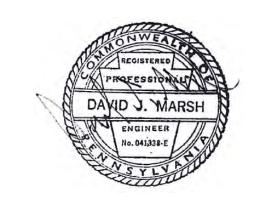
11TH FLOOR, ONE PARKWAY BUILDING PENNSYLVANIA PHILADELPHIA

RENOVATIONS TO THE HAPPY **HOLLOW RECREATION CENTER**

MECHANICAL ROOF PLAN


PROJECT NO.		DRAWING NO.
16	315E-03-02	
DATE	05/13/2025	M-103
SCALE	AS NOTED	
DRAWN BY	WS	
CHECKED BY	DM	FILE:



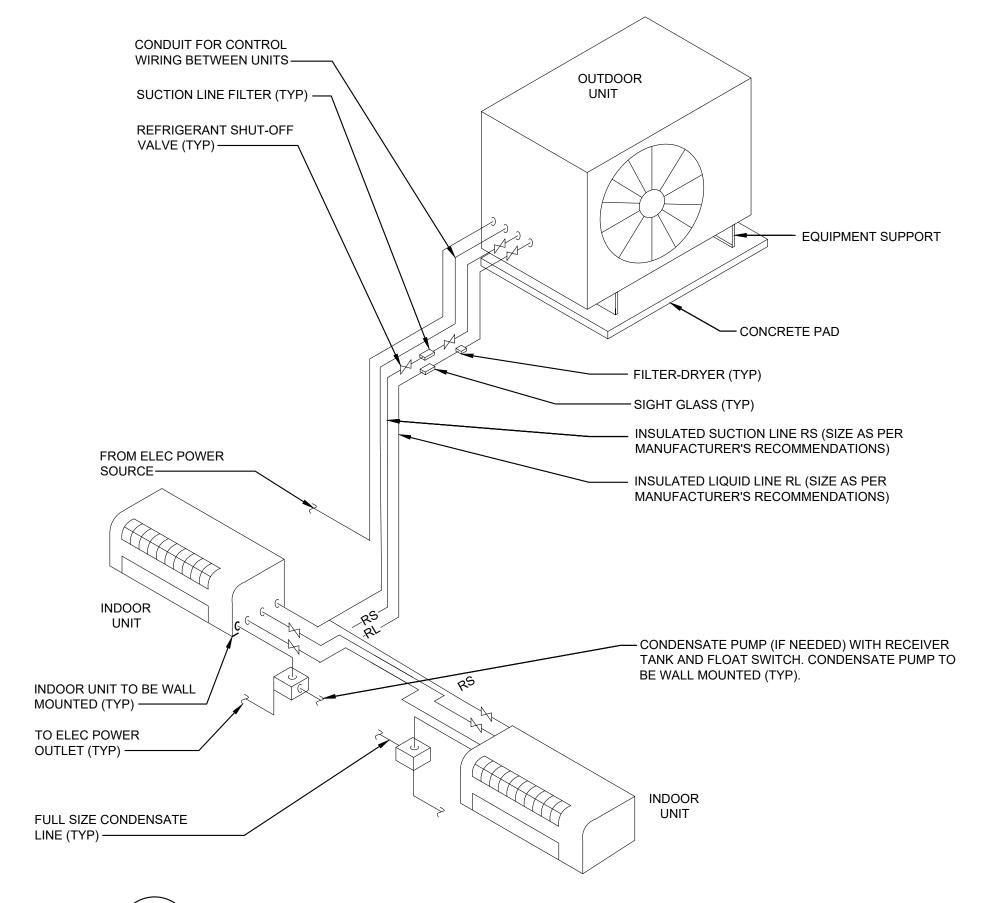



DX DUCTLESS SPLIT HEAT PUMP MULTIZONE SYSTEM DETAIL NOT TO SCALE M-500

1. COORDINATE LOCATION OF ROOF CURB TO ENSURE CONDUITS FOR ALL SERVICES PASS THROUGH SINGLE PIPE PORTAL.

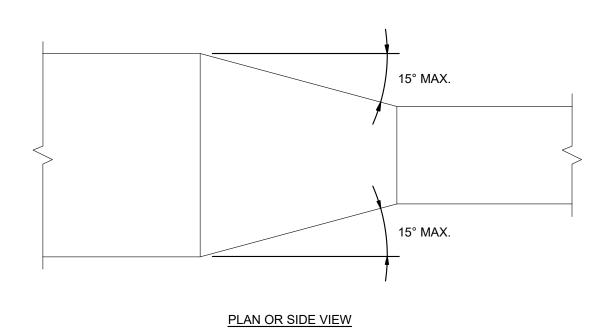


DUCT TRANSITION DETAIL NOT TO SCALE M-500

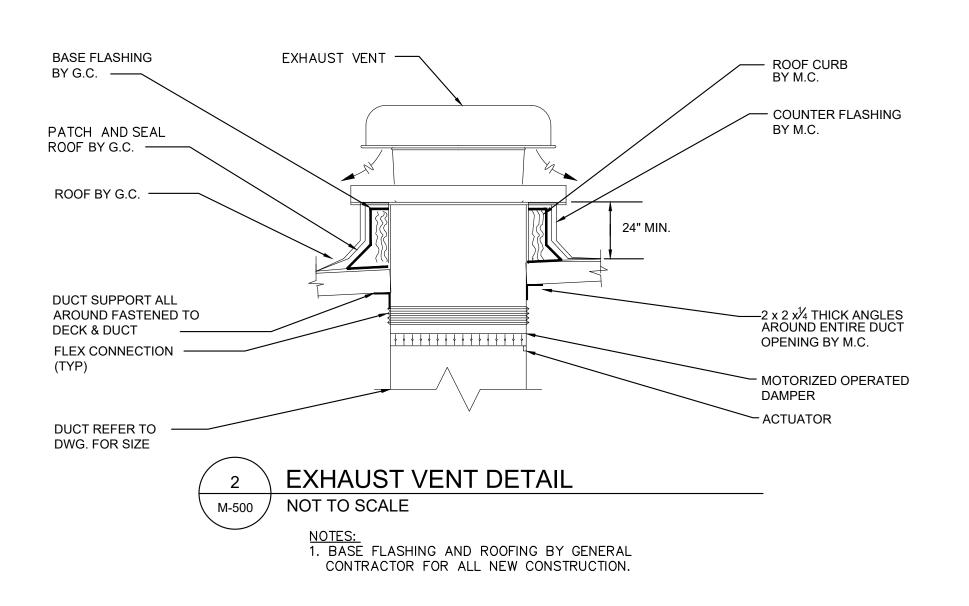


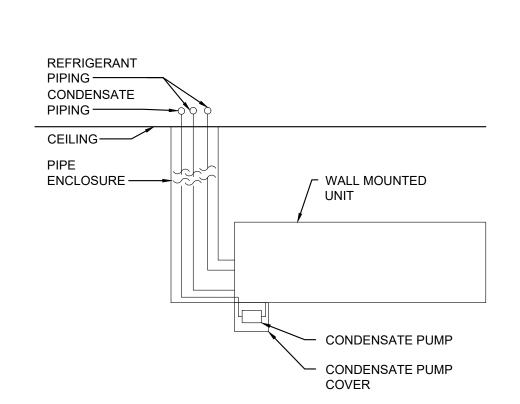


WALL MOUNTED UNIT WITH PIPE ENCLOSURE NOT TO SCALE M-500

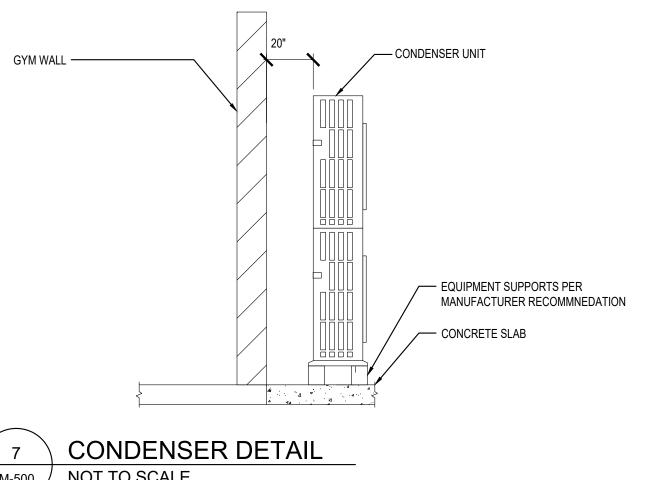

NOT TO SCALE M-500

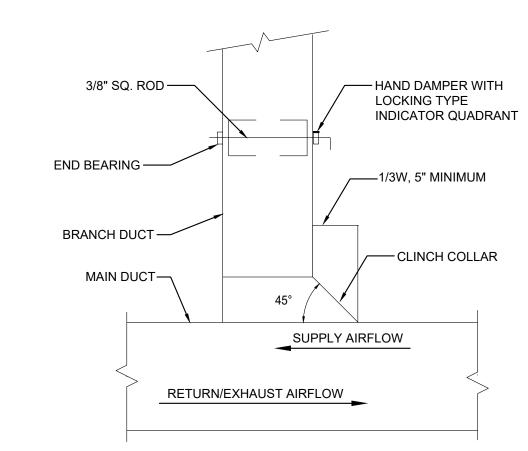


BRANCH DUCT CONNECT DETAIL NOT TO SCALE M-500

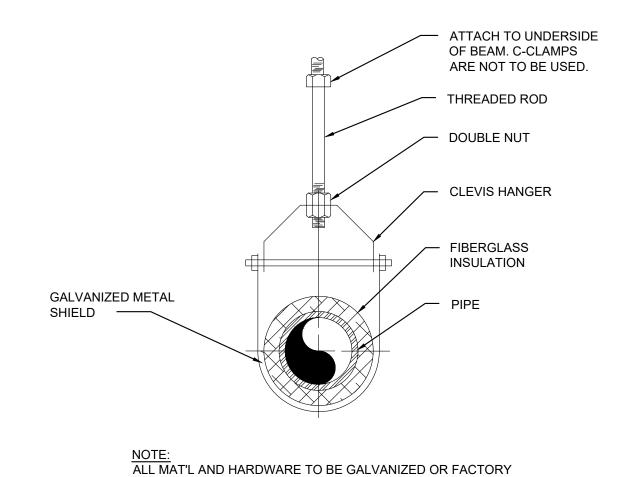

WHITE POWDER

CLEVIS HANGER DETAIL FOR 2" AND LESS NOT TO SCALE M-500

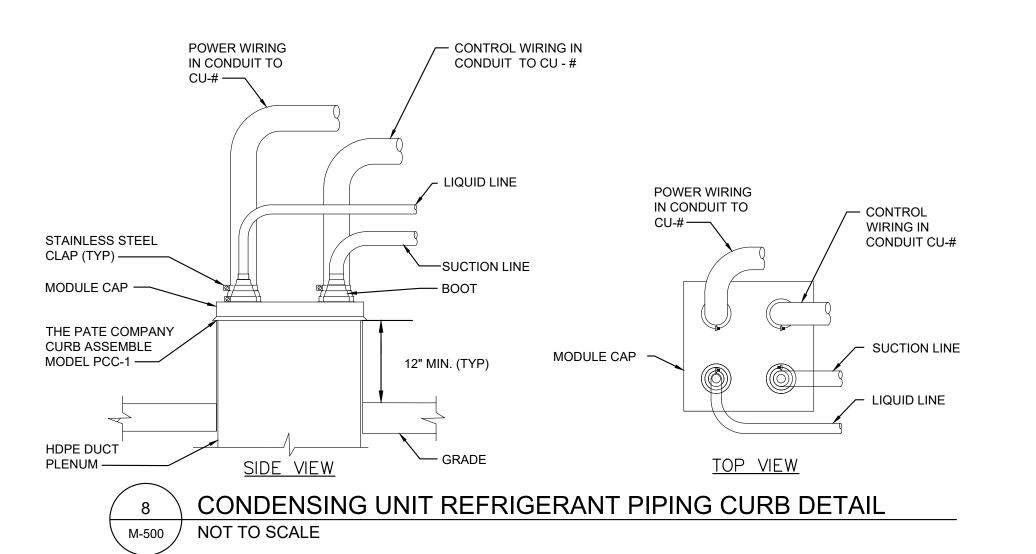

REVISIONS ISSUE DATE REVISIONS



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www.groundreconsidered.com 215 790 0727

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215 925 0425

610 688 2566

STRUCTURAL ENGINEER:
ANN ROTHMANN STRUCTURAL ENGINEERING arstructural.com

MEP ENGINEER: ARORA ENGINEERS www.aroraengineers.com 610 459 7900

ROOFING CONSULTANT:
STEPHEN McLAUGHLIN ROOFING CONSULTANT stevemclaughlin.biz 856 287 2424

CITY OF PHILADELPHIA

DEPARTMENT OF PARKS & RECREATION 1515 ARCH STREET

11TH FLOOR, ONE PARKWAY BUILDING PENNSYLVANIA

PHILADELPHIA

RENOVATIONS TO THE HAPPY **HOLLOW RECREATION CENTER**

MECHANICAL DETAILS

16315E-03-02 M-500 05/13/2025 AS NOTED ALL DIMENSIONS AND CONDITIONS SHALL BE VERIFIED BY THE CONTACTOR AT THE SITE BEFORE PROCEEDING WITH THE WORK

						MULT	I-SPLIT UI	NIT (INDOOR UI	NIT) SCHEDU	_E																
TAG	BASIS OF DESIGN	MODEL	LOCATION	SERVICE	ASSOCIATED	STYLE	SEER	REFRIGERANT	DE:	SIGN				COOLING					HEA	TING		ELE	C SERVIC	E	OPER	REMARKS
	MANUFACTURER	NUMBER			CONDENSER			TYPE	AMBIENT	CONDITIONS	TOT	SENS	FLOW	ENT	ENT	LEAV	LEAV	TOT	FLOW	ENT	LEAV	VOLTS HER	TZ PHASI	MCA	WT	
									MAX	MIN	CAP	CAP	MAX	DB	WB	DB	WB	CAP	MAX	DB	DB					
									°F	°F	MBH	MBH	CFM	°F	°F	°F	°F	MBH	CFM	°F	°F				LB	
DS-1	MITSUBISHI	PKFY-P18NLMU-ER1.TH	COMPUTER ROOM 102	COMPUTER ROOM 102	CU-1	WALL-MOUNTED	20	R-410A	115	-17	18	N/A	494	80.0	67.0	55.0	54.0	20	494	70.0		230V 60	0 1	0.24	40	SEE NOTES
DS-2	MITSUBISHI	PKFY-P08NLMU-ER1.TH	GAMING ROOM 103	GAMING ROOM 103	CU-1	WALL-MOUNTED	20	R-410A	115	-17	8	N/A	237	80.0	67.0	55.0	54.0	9	237	70.0		230V 60	0 1	0.24	20	SEE NOTES
DS-3	MITSUBISHI	PKFY-P08NLMU-ER1.TH	OFFICE 105	OFFICE 105	CU-1	WALL-MOUNTED	20	R-410A	115	-17	8	N/A	237	80.0	67.0	55.0	54.0	9	237	70.0	105.0	230V 60	0 1	0.24	20	SEE NOTES
DS-4	MITSUBISHI	PCFY-P15NKMU-ER2.TH	EAST CORRIDOR 100	EAST CORRIDOR 100	CU-1	CEILING, MOUNTED	20	R-410A	115	-17	15	N/A	400	80.0	67.0	55.0	54.0	17	460	70.0	104.0	230V 60	0 1	0.44	55	SEE NOTES
DS-5	MITSUBISHI	PFFY-P24NRMU-E	ACTIVITY 106	ACTIVITY 106	CU-2	FLOOR MOUNTED	20	R-410A	115	-17	24	N/A	600	80.0	67.0	55.0	54.0	27	600	70.0	120.6	230V 60	0 1	0.59	55	SEE NOTES
DS-6	MITSUBISHI	PFFY-P12NRMU-E	ACTIVITY 106	ACTIVITY 106	CU-2	FLOOR MOUNTED	20	R-410A	115	-17	12	N/A	400	80.0	67.0	55.0	54.0	13.5	400	70.0	109.3	230V 60	0 1	0.34	50	SEE NOTES
DS-7	MITSUBISHI	PFFY-P12NRMU-E	ACTIVITY 106	ACTIVITY 106	CU-2	FLOOR MOUNTED	20	R-410A	115	-17	12	N/A	400	80.0	67.0	55.0	54.0	13.5	400	70.0	109.3	230V 60	0 1	0.34	50	SEE NOTES
DS-8	MITSUBISHI	PFFY-P24NRMU-E	ACTIVITY 106	ACTIVITY 106	CU-3	FLOOR MOUNTED	20	R-410A	115	-17	24	N/A	600	80.0	67.0	55.0	54.0	27	600	70.0	120.6	230V 60	0 1	0.59	50	SEE NOTES
DS-9	MITSUBISHI	PFFY-P24NRMU-E	ACTIVITY 106	ACTIVITY 106	CU-3	FLOOR MOUNTED	20	R-410A	115	-17	24	N/A	600	80.0	67.0	55.0	54.0	27	600	70.0	120.6	230V 60	0 1	0.59	50	SEE NOTES
DS-10	MITSUBISHI	PFFY-P12NRMU-E	ACTIVITY 106	ACTIVITY 106	CU-4	FLOOR MOUNTED	20	R-410A	115	-17	12	N/A	400	80.0	67.0	55.0	54.0	13.5	400	70.0	109.3	230V 60	0 1	0.34	50	SEE NOTES
DS-11	MITSUBISHI	PFFY-P12NRMU-E	ACTIVITY 106	ACTIVITY 106	CU-4	FLOOR MOUNTED	20	R-410A	115	-17	12	N/A	400	80.0	67.0	55.0	54.0	13.5	400	70.0	109.3	230V 60	0 1	0.34	50	SEE NOTES
DS-12	MITSUBISHI	PFFY-P24NRMU-E	ACTIVITY 106	ACTIVITY 106	CU-4	FLOOR MOUNTED	20	R-410A	115	-17	24	N/A	600	80.0	67.0	55.0	54.0	27	600	70.0	120.6	230V 60	0 1	0.59	50	SEE NOTES
DS-13	MITSUBISHI	PKFY-P18NLMU-ER1.TH	BREAK ROOM 107	BREAK ROOM 107	CU-5	WALL-MOUNTED	20	R-410A	115	-17	18	N/A	494	80.0	67.0	55.0	54.0	20	494	70.0	112.1	230V 60	0 1	0.24	40	SEE NOTES
DS-14	MITSUBISHI	PKFY-P08NLMU-ER1.TH	STORAGE 108	STORAGE 108	CU-5	WALL-MOUNTED	20	R-410A	115	-17	8	N/A	237	80.0	67.0	55.0	54.0	9	237	70.0	105.0	230V 60	0 1	0.24	20	SEE NOTES
DS-15	MITSUBISHI	PKFY-P08NLMU-ER1.TH	STORAGE 111	STORAGE 111	CU-5	WALL-MOUNTED	20	R-410A	115	-17	8	N/A	237	80.0	67.0	55.0	54.0	9	237	70.0	105.0	230V 60	0 1	0.24	20	SEE NOTES
DS-16	MITSUBISHI	PCFY-P15NKMU-ER2.TH	WEST CORRIDOR 110	WEST CORRIDOR 110	CU-5	CEILING, MOUNTED	20	R-410A	115	-17	15	N/A	400	80.0	67.0	55.0	54.0	13.5	460	70.0	104.1	230V 60	0 1	0.44	55	SEE NOTES

- 1. CAPACITY CONTROL BY VARIABLE SPEED COMPRESSOR WITH INVERTER.
- 2. PROVIDE INTERGRAL CONDENSATE PUMPS FOR CEILING MOUNTED UNITS (IF INTEGRAL PUMPS ARE NOT AVAILABLE SEE NOTE 3).
- 3. PROVIDE SEPARATE WALL-MOUNTED 120-V COOLING-COIL CONDENSATE PUMP (MFR: BLUE
- DIAMOND, MODEL X87-711, WITH MFR'S SAFETY OVERFLOW SWITCH, CHECK VALVE, ANTI-SWEAT S/S WALL BRACKET AND ANTI-SWEAT TANK SLEEVE). 2-YR WARRANTY.
- WIRE TO POWER SOURCE. EXTEND DISCHARGE PIPE TO CONDENSATE DRAIN PIPING SYSTEM.
- WIRE SAFETY OVERFLOW SWITCH TO SHUT-OFF A/C UNIT AND TO SIGNAL ALARM. 4. PROVIDE INTEGRAL AIR FILTER.
- 5. PROVIDE INSULATED REFRIGERATION-PIPE LINE SETS FROM UNIT MFR. SIZES APPROVED BY MANUFACTURER.
- 6. PROVIDE POWER AND CONTROL WIRING BETWEEN INDOOR AND OUTDOOR UNIT.
- 7. PROVIDE OUTSIDE AIR KNOCKOUT FOR CEILING MOUNTED UNIT. 8. REFER TO SPECIFICATIONS FOR ADDITIONAL INFORMATION.

					CC	NDENSING U	NIT SCHEDU	LE										
					COOLING	HEATING	COOLING A	MBIENT DB	HEATING A	MBIENT DB				ELEC SEF	RVICE			
TAG	BASIS OF DESIGN MANUFACTURER	MODEL NUMBER	LOCATION	SERVING	CAPACITY TONS	CAPACITY MBH	MAX °F	MIN °F	MAX °F	MIN °F	EER	REFRIGERANT TYPE	VOLTS	HERTZ	PHASE	MCA	OPER WT LB	REMARKS
CU-1	MITSUBISHI	MXZ-SM48NAMHZ2-U1	OUTSIDE GYMNASIUM	DS-1, DS-2, DS-3, DS-4	4	54	115	23	70	-17	19.5	R-410a	230V	60	1	45	265	SEE NOTES
CU-2	MITSUBISHI	MXZ-SM48NAMHZ2-U1	OUTSIDE GYMNASIUM	DS-5,DS-6,DS-7	4	54	115	23	70	-17	19.5	R-410a	230V	60	1	45	265	SEE NOTES
CU-3	MITSUBISHI	MXZ-SM48NAMHZ2-U1	OUTSIDE GYMNASIUM	DS-8,DS-9	4	54	115	23	70	-17	19.5	R-410a	230V	60	1	45	265	SEE NOTES
CU-4	MITSUBISHI	MXZ-SM48NAMHZ2-U1	OUTSIDE GYMNASIUM	DS-10,DS-11, DS-12	4	54	115	23	70	-17	19.5	R-410a	230V	60	1	45	265	SEE NOTES
CU-5	MITSUBISHI	MXZ-SM48NAMHZ2-U1	OUTSIDE GYMNASIUM	DS-13, DS-14, DS-15, DS-	4	54	115	23	70	-17	19.5	R-410a	230V	60	1	45	265	SEE NOTES

- 1. INCLUDE LOW-AMBIENT CONTROL AND ACCESSORIES TO ALLOW COOLING AT SCHEDULED MINIMUM AMBIENT DB.
- 2. CAPACITY CONTROL BY VARIABLE-SPEED COMPRESSOR WITH INVERTER.
- 3. PROVIDE POWER AND CONTROL WIRING BETWEEN INDOOR AND OUTDOOR UNITS.
- 4. PROVIDE WIND BAFFLE KIT FOR COOLING TO 0F.

										FAN SCHEDULE								
	BASIS OF DESIGN	MODEL	LOCATION	SERVICE	FAN TYPE	DRIVE AIR	FAN	FAN SPEE	ED	FAN-CAPACITY CONTROL METHOD	FAN AIRFLOW ISOLATION			MOTOR		ELECTRICAL	OPER	REMARKS
	MANUFACTURER	NUMBER				TYPE FLOW	STATIC	MAX DES	SIGN			TYPE	SIZE DUTY		VIBRATION		WT	
							PRESS							SPEED)			
						CFM	IN WG	RPM R	RPM				HP HP	RPM			LB	
EF-1	GREENHECK	SP-B110	WOMEN'S RESTROOM	WOMEN'S RESTROOM	CEILING CABINET FAN	DIRECT 75	0.50	950 8	306	ON/OFF MOTION SENSOR TIED TO LIGHTS	FAN MFR'S INTEGRAL BACKDRAFT DAMPER	₹ ECM	80 W NA	NA	ELASTOMERIC HANGE	RS 120/60/1	35	SEE NOTES
EF-2	GREENHECK	SP-B110	ALL GENDER RESTROOM	ALL GENDER RESTROOM	CEILING CABINET FAN	DIRECT 75	0.50	950 8	306 (ON/OFF MOTION SENSOR TIED TO LIGHTS	FAN MFR'S INTEGRAL BACKDRAFT DAMPER	₹ ECM	80 W NA	NA	ELASTOMERIC HANGE	RS 120/60/1	35	SEE NOTES
EF-3	GREENHECK	SP-B110	JANITOR CLOSET	JANITOR CLOSET	CEILING CABINET FAN	DIRECT 75	0.50	950 8	306	ON/OFF MOTION SENSOR TIED TO LIGHTS	FAN MFR'S INTEGRAL BACKDRAFT DAMPER	₹ ECM	80 W NA	NA	ELASTOMERIC HANGE	RS 120/60/1	35	SEE NOTES
EF-4	GREENHECK	SP-B110	RESTROOM 113	RESTROOM 113	CEILING CABINET FAN	DIRECT 75	0.50	950 8		ON/OFF MOTION SENSOR TIED TO LIGHTS			80 W NA	NA	ELASTOMERIC HANGE	RS 120/60/1	35	SEE NOTES
EF-5	GREENHECK	SP-B110	RESTROOM 114	RESTROOM 114	CEILING CABINET FAN	DIRECT 75	0.50	950 8	306	ON/OFF MOTION SENSOR TIED TO LIGHTS	FAN MFR'S INTEGRAL BACKDRAFT DAMPER	₹ ECM	80 W NA	NA	ELASTOMERIC HANGE	RS 120/60/1	35	SEE NOTES

- 1. PROVIDE FAN MFR'S FACTORY-WIRED DISCONNECT SWITCH.
- 2. PROVIDE MOTOR WITH THERMAL OVERLOAD.
- 3. FOR CEILING CABINET FANS, SWITCH ON AND OFF BY DIV 26 OCCUPANCY SENSOR AND WIRING.

				ELECT	TRIC CEILING HEAT	TER SCHE	DULE							
TAG	BASIS OF DESIGN	MODEL	LOCATION	SERVICE	ARRANGEMENT	FA	.N	CAPACITY	CONTROL	EAT	LAT	ELECTRICAL	AMPS	REMARKS
	MANFACTURER	NUMBER				AIRFLOW	SPEED							
						CFM		WATTS		°F	°F			
EH-1	BERKO	QCH1151F	WOMEN'S ROOM	WOMEN'S ROOM	CEILING RECESSED	175	SINGLE	1500	ON/OFF BY TSTAT	60	96	120/60/1	12.5	SEE NOTES
EH-2	BERKO	QCH1151F	ALL GENDER RESTROOM	ALL GENDER RESTROOM	CEILING RECESSED	175	SINGLE	1500	ON/OFF BY TSTAT	60	96	120/60/1	12.5	SEE NOTES
EH-3	BERKO	QCH1151F	JAMITOR CLOSET	JAMITOR CLOSET	CEILING RECESSED	175	SINGLE	1500	ON/OFF BY TSTAT	60	96	120/60/1	12.5	SEE NOTES
EH-4	BERKO	QCH1151F	RESTROOM 113	RESTROOM 113	CEILING RECESSED	175	SINGLE	1500	ON/OFF BY TSTAT	60	96	120/60/1	12.5	SEE NOTES
EH-5	BERKO	QCH1151F	RESTROOM 114	RESTROOM 114	CEILING RECESSED	175	SINGLE	1500	ON/OFF BY TSTAT	60	96	120/60/1	12.5	SEE NOTES

- 1. PROVIDE THE FOLLOWING:
 - a. COLOR AS SELECTED BY ARCHITECT
 - b. DISCONNECT SWITCH
 - c. UNIT TO BE RECESSED MOUNTED IN CEILING (PROVIDE RECESSED MOUNTING KIT)
 - d. TOTALLY-ENCLOSED STEEL FIN SHEALTH ELEMENT
- PROVIDE FACTORY SINGLE POLE THERMOSTAT/SENSOR.

				EXHAUST V	ENTIL	ATOR SC	HEDULE			
TAG	MAKE	MODEL	LOCATION	SERVICE	AIR FLOW (CFM)		THROAT VELOCITY (FPM)	TOTAL PRESSURE DROP (WC)	VENTILATOR ISOLATION	REMARKS
EV-1	GREENHECK	GRSR-8	ROOF	EF-4,5	150	0.50	405	0.028	DUCT-MOUNTED MOTORIZED DAMPER	SEE NOTES
EV-2	GREENHECK	GRSR-8	ROOF	EF-1,2,3	225	0.57	608	0.038	DUCT-MOUNTED MOTORIZED DAMPER	SEE NOTES


- . PROVIDE ALL ALUMINUM CONSTRUCTION
- 2. PROVIDE BIRDSCREEN. SCHEDULED PRESSURE DROP INCLUDES INSECT SCREEN.
- 3. INCLUDE BASE WITH CURB CAP FOR INSTALLING ON ROOF CURB.
- PROVIDE VENTILATOR MANUFACTURER'S 24-INCH-HIGH ROOF CURB SUITABLE FOR INSTALLING ON SLOPED ROOF TO PROVIDE TOP HORIZONTAL SURFACE FOR MOUNTING VENTILATOR. INCLUDE CURB DAMPER TRAY.
- 5. PROVIDE RELAY (RIB) RATED FOR DAMPER MOTOR, WIRED TO OPEN DAMPER WHEN EF IS ENERGIZED, AND CLOSES WHEN EF IS DENERGIZED.

	REVI	SIONS
ISSUE	DATE	REVISIONS



CONSTRUCTION DOCUMENTS

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CITY OF PHILADELPHIA DEPARTMENT OF PARKS & RECREATION

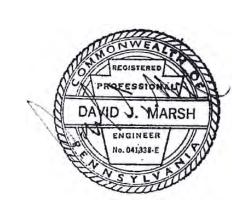PENNSYLVANIA

1515 ARCH STREET 11TH FLOOR, ONE PARKWAY BUILDING

PHILADELPHIA

RENOVATIONS TO THE HAPPY

HOLLOW RECREATION CENTER

MECHANICAL SCHEDULES

16315E-03-02 05/13/2025 AS NOTED WS CHECKED BY DM ALL DIMENSIONS AND CONDITIONS SHALL BE VERIFIED BY THE CONTACTOR AT THE SITE BEFORE PROCEEDING WITH THE WORK

ASHRAE 15 REFRIGERANT CONCENTRATION COMPLIANCE CALCULATION										
SYSTEM NAME:	FUJITSU AOU48RLAVM4	CU-1								
REFRIGERANT TYPE:	R-410A									
IMC ALLOWABLE CONCENTRATION:	26	LBS/1000 CFT								
SYSTEM REFRIGERANT:	11.7	LBS								

ASHRAE 15 COMPLIANCE CALCULATIONS - EAST WING								
SPACE	ZONE NUMBER	SPACE AREA (SF)	SPACE HEIGHT (FT)	SPACE VOLUME (CFT)	REF. CONCENTRATION (LBS\1000 CFT)	REMARKS		
COMPUTER ROOM	102	223.0	10	2230	5.2	N/A		
STORAGE	103	92.0	10	920	12.7	N/A		
OFFICE	105	90.0	10	900	13.0	N/A		
EAST CORRIDOR	100	140.0	10	1400	8.4	N/A		

ASHRAE 15 REFRIGERANT CONCENTRATION COMPLIANCE CALCULATION							
SYSTEM NAME:	FUJITSU AOU48RLAVM4	CU-2/CU-3/CU-4					
REFRIGERANT TYPE:	R-410A						
IMC ALLOWABLE CONCENTRATION:	26	LBS/1000 CFT					
SYSTEM REFRIGERANT	35.1	LBS					

	ASHRAE 15 COMPLIAN	CE CALCULATIONS - A	ACTIVITY ROOM			
SPACE	ZONE NUMBER	SPACE AREA (SF)	AVG. SPACE HEIGHT (FT)	SPACE VOLUME (CFT)	REF. CONCENTRATION (LBS\1000 CFT)	REMARKS
ACTIVITY ROOM 106	106	1980.0	21	41580	0.8	N/A

ASHRAE 15 REFRIGERANT CONCENTRATION COMPLIANCE CALCULATION						
SYSTEM NAME:	FUJITSU AOU48RLAVM4	CU-5				
REFRIGERANT TYPE:	R-410A					
IMC ALLOWABLE CONCENTRATION:	26	LBS/1000 CFT				
SYSTEM REFRIGERANT:	11.7	LBS				

ASHRAE 15 COMPLIANCE CALCULATIONS - WEST WING							
SPACE	ZONE NUMBER	SPACE AREA (SF)	SPACE HEIGHT (FT)	SPACE VOLUME (CFT)	REF. CONCENTRATION (LBS\1000 CFT)	REMARKS	
BREAK ROOM	107	192.0	10	1920	6.1	N/A	
STORAGE	108	124.0	10	1240	9.4	N/A	
STORAGE	111	120.0	10	1200	9.8	N/A	
WEST CORRIDOR	110	136.0	10	1360	8.6	N/A	

						VENTILAT	ION CALC	ULATIONS	6								
SPACE	FLOOR AREA (SF)	CODE USE GROUP	NUMBER OF OCC/100	NUMB OF OCC	NUMB OF PLUMB FIXT	OA CFM PER OCC	OCC OA REQD (CFM)	OA CFM PER SF REQD	AREA OA REQD (CFM)		ZONE EFFECTIVENESS (Ez)	TOT. OA REQD (CFM)	TOT. SA (CFM)	TOT. OA (CFM)	EA CFM REQD	FIXT EA CFM REQD	TOT. EA (CFM)
JANITOR CLOSET 104	50.0	RESTROOM	0	0.0	1											70	70
ACC WOMEN'S RESTROOM 112	63.0	RESTROOM	0	0.0	1											70	70
ALL GENDER RESTROOM 101	50.0	RESTROOM	0	0.0	1											70	70
RESTROOM 113	63.0	RESTROOM	0	0.0	1											70	70
RESTROOM 114	50.0	CLOSET	0	0.0	1											70	70
TOTAL	276			0	5		0		0	0			0	0	0	350	350
NOTES: 1. MECHANICAL VENTILATION PROVIDED PER SECTION 403 OF THE 2018 IMC.																	
	2. OCCUP	ANCIES DETERMI	NED FROM	ACTUAL N	NUMBER OF	OCCUPA	NTS BASE	D UPON F	URNITURE	SHOWN	ON ARCHITECTURA	L DRAWIN	NGS WHEF	RE NUMBE	R/1000 SF	IS SHOWN	1 AS "N/A"


		NATURAL VENTILATIO	N CALCULATIONS -	HAPPY HOLLOW		
SPACE	FLOOR AREA (SF)	CODE USE GROUP	REQUIRED VENTILATION AREA (SF)	ACTUAL VENTIALTION AREA (SF)	NATURALLY VENTILATED? (Y/N)	MEANS OF NATURAL VENTILATION
STORAGE 1	95	STORAGE ROOM	3.8	10	Y	OPERABLE WINDOW
STORAGE 2	120	STORAGE ROOM	4.8	0	N	N/A
GAMING ROOM 103	100	COMPUTER LAB	4	17	Y	OPERABLE WINDOWS
EAST CORRIDOR	140	CORRIDOR	5.6	38	Υ	EXTERIOR DOOR
WEST CORRIDOR	140	CORRIDOR	5.6	38	Y	EXTERIOR DOOR
OFFICE	100	OFFICE SPACE	4	40	Y	OPERABLE WINDOWS
COMPUTER ROOM	225	COMPUTER LAB	9	37	Υ	OPERABLE WINDOWS
ACTIVITIES ROOM	1985	GYMNASIUM	79.4	363	Y	OPERABLE WINDOWS AND EXTERIOR DOORS
TOILET	25	JANITOR'S CLOSET	1	0	N	N/A
WOMEN'S RESTROOM	115	RESTROOM	4.6	17	Y	OPERABLE WINDOWS
MEN'S RESTROOM	115	RESTROOM	4.6	18	Y	OPERABLE WINDOWS
KITCHEN	195	BREAKROOM	7.8	10	Y	OPERABLE WINDOW
WEST BASEMENT	750	MECHANICAL ROOM	30	30	Y	EXTERIOR DOOR
EAST BASEMENT	750	MECHANICAL ROOM	30	30	Y	EXTERIOR DOOR
NOTES:	1. NATUR	AL VENTILATION PROVIDED P	ER SECTION 402 OF	THE 2018 IMC.		
	2. UNOCC	UPIED SPACES NOT REQUIRE	D TO BE VENTILATED	PER SECTION 401.2	OF THE 2019 IM	IC.

	REVI	SIONS
ISSUE	DATE	REVISIONS



CONSTRUCTION DOCUMENTS

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CITY OF PHILADELPHIA DEPARTMENT OF PARKS & RECREATION

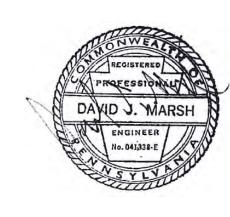PENNSYLVANIA

1515 ARCH STREET

11TH FLOOR, ONE PARKWAY BUILDING PHILADELPHIA

RENOVATIONS TO THE HAPPY HOLLOW RECREATION CENTER

MECHANICAL SCHEDULES

PROJECT NO		DRAWING NO.
10	6315E-03-02	
DATE	05/13/2025	M-601
SCALE	AS NOTED	
DRAWN BY	WS	
CHECKED BY	DM	FILE:

CONSTRUCTION DOCUMENTS

ELECTRICAL GENERAL NOTES:

- ALL WORK SHALL BE IN ACCORDANCE WITH ALL APPLICABLE LAWS, CODES, AND REGULATIONS ADOPTED BY MUNICIPAL, COUNTY, STATE, AND FEDERAL AUTHORITIES, INCLUDING THE LATEST ADOPTED EDITION OF THE NATIONAL ELECTRICAL CODE (NEC) NFPA 70. AND WITH THE REQUIREMENTS/AMENDMENTS OF THE LOCAL AUTHORITY HAVING JURISDICTION (AHJ).
- CONTRACT DRAWINGS ARE DIAGRAMMATIC IN NATURE AND ARE INTENDED TO CONVEY SCOPE, DESIGN INTENT, AND GENERAL ARRANGEMENT ONLY. ELECTRICAL CONTRACTOR IS RESPONSIBLE FOR COORDINATING ALL WORK OF ALL TRADES INCLUDING RESOLUTION OF FIELD CONFLICTS THAT MAY ARISE.
- EACH FEEDER AND BRANCH CIRCUIT SHALL INCLUDE AN INSULATED EQUIPMENT GROUNDING CONDUCTOR. BOND ALL ELECTRICAL EQUIPMENT, OUTLET BOXES, GROUNDING TYPE RECEPTACLES, ETC., IN ACCORDANCE WITH NEC ARTICLE 250.
- MULTI-WIRE BRANCH CIRCUITS SHALL NOT BE PERMITTED. EACH 120V AND 277V BRANCH CIRCUIT SHALL INCLUDE DEDICATED NEUTRAL AND INSULATED GROUNDING CONDUCTORS. BOND ALL ELECTRICAL EQUIPMENT, OUTLET BOXES, GROUNDING TYPE RECEPTACLES, ETC., IN ACCORDANCE WITH NEC ARTICLE 250.
- TRUNKING OR GROUPING OF BRANCH CIRCUITS AND FEEDERS SHALL BE PERMITTED, PROVIDED THAT THE NEC RULES PERTAINING TO MAXIMUM ALLOWABLE PERCENT FILL OF RACEWAYS, AND AMPACITY OF ADJUSTMENT FACTORS FOR MORE THAN 3 CURRENT CARRYING CONDUCTORS IN A RACEWAY ARE STRICTLY COMPLIED WITH. THE ELECTRICAL CONTRACTOR SHALL EXERCISE GREAT CAUTION IN PROVIDING AN EQUAL NUMBER OF A, B, AND C PHASE CONDUCTORS WHEN GROUPING CIRCUITS.
- TROUGHS, JUNCTION AND PULL BOXES ARE NOT NECESSARILY INDICATED. BUT SHALL BE PROVIDED WHERE MANDATED BY THE NEC. AND AS REQUIRED FOR EASE OF INSTALLATION. BOXES SHALL BE SIZED (MINIMUM) IN ACCORDANCE WITH NEC ARTICLE 314. TROUGHS SHALL BE SIZED PER NEC ARTICLE 366.
- FEEDER AND BRANCH CIRCUIT WIRING ARE DEPICTED BY ASSIGNMENT OF CIRCUIT NUMBERS, INTERCONNECTING WIRING AND HOMERUNS, OR HOMERUNS ONLY (FOR SINGULAR LOADS). ALL FEEDERS AND BRANCH CIRCUITS ARE NEW TO BE PROVIDED UNDER THIS CONTRACT UNLESS OTHERWISE NOTED. INTERIOR WIRING SHALL BE INSTALLED IN RIGID METALLIC CONDUIT AND/OR EMT, 3/4" MINIMUM. FLEXIBLE METAL CONDUIT, LIQUID-TIGHT FLEXIBLE METAL CONDUIT SHALL BE UTILIZED IN LIMITED LENGTHS AS NECESSARY, OR AS REQUIRED/ALLOWED BY CODE.
- ALL NEW 600V OVER-CURRENT PROTECTIVE DEVICES SHALL HAVE INTERRUPTING CAPABILITIES OR RATINGS (AIC OR AIR) IN RMS AMPERES SYMMETRICAL. ALL DEVICES SHALL BE FULLY RATED FOR AVAILABLE FAULT CURRENT. ALL PANELBOARDS, SWITCHBOARDS, MDPS, DEVICES, ETC. SHALL BE FULLY RATED.
- ALL BUILDING WIRE SHALL BE COPPER CONDUCTORS, TYPE THHN/THWN-2 (DUAL LISTED) 90 DEGREE CELSIUS RATED INSULATION, #12 AWG MINIMUM. UTILIZE #10 AWG WIRE FOR ANY 15A OR 20A, 120V CIRCUIT THAT EXCEEDS 100 FEET FROM SOURCE TO LAST DEVICE OR OUTLET.
- 10. ELECTRICAL CONTRACTOR SHALL PROVIDE AND INSTALL AN APPROVED, UL LISTED, FIRE STOP SEALANT, TOTALLY ENCLOSING ALL PENETRATIONS THROUGH RATED CEILINGS, WALLS, ROOFS, FLOORS, ETC. ALL FLOOR PENETRATIONS SHALL BE CORE-DRILLED, SLEEVED AND SEALED WITH AN APPROVED FIRE RATED SEALANT. ELECTRICAL CONTRACTOR SHALL SUBMIT LETTER TO OWNER THAT THE REQUIRED FIRE SEALANT WAS INSTALLED PER MANUFACTURER'S REQUIREMENTS. ALL EXISTING PENETRATIONS BETWEEN FLOORS AND WALLS MUST BE CLOSED TO MAINTAIN FIRE RATING.
- 11. THE ELECTRICAL CONTRACTOR SHALL PERFORM THE WORK AS INDICATED ON THE DRAWINGS. ANY DEVIATIONS FROM THE DRAWINGS SHALL BE SUBMITTED TO THE ENGINEER FOR REVIEW AND APPROVAL IN WRITING. IF CHANGES ARE MADE WITHOUT THE ENGINEER'S WRITTEN CONSENT, THE ELECTRICAL CONTRACTOR SHALL BE LIABLE FOR ANY ISSUES THAT MAY ARISE DUE TO THE CHANGES.
- 12. UNLESS OTHERWISE NOTED, ALL WIRE SIZES SHALL BE BASED ON THE
 - a. #12 THROUGH #1 OR 100A OR LESS TABLE 310.16 60° COLUMN b. #1/0 AND GREATER OR 101A OR GREATER - TABLE 310.16 75° COLUMN
 - c. OTHER ALLOWANCES OF 110.14(C)
- UNLESS OTHERWISE NOTED, FEEDER TAPS AND TRANSFORMER SECONDARY CONDUCTOR TAPS ARE DESIGNED BASED ON THE 10' RULE OF 240.21(B)(1) & 240.21(C)(2).
- 16. UNLESS OTHERWISE NOTED, ALL CONDUIT SIZES SHALL BE BASED ON EMT, RMC, OR RNC (PVC SCHEDULE 40).
- 17. ALL ELECTRICAL MATERIALS, DEVICES, APPLIANCES AND EQUIPMENT SHALL BE NEW, LABELED AND LISTED BY A NATIONALLY RECOGNIZED TESTING LABORATORY OR AGENCY (E.G. UL), UNLESS OTHERWISE
- 18. THE ELECTRICAL CONTRACTOR SHALL FOLLOW ALL MANUFACTURER'S INSTRUCTIONS FOR INSTALLATION OF ALL EQUIPMENT IF NOT INDICATED ON DRAWINGS. IF THERE IS A DISCREPANCY, MANUFACTURER'S INSTRUCTIONS TAKE PRECEDENCE.
- 19. THE ELECTRICAL CONTRACTOR SHALL FURNISH ALL EQUIPMENT. LABOR, SERVICES, AND MATERIALS REQUIRED FOR COMPLETE INSTALLATION OF THE WORK INDICATED. UNLESS OTHERWISE NOTED, ALL MATERIALS SHALL BE NEW.
- 20. ALL WIRING, EQUIPMENT, STARTERS AND CONTROLS SHALL CONFORM TO THE NATIONAL ELECTRIC CODE AND TO THE REQUIREMENTS OF THE LOCAL UTILITY COMPANY.
- DO NOT SCALE DRAWINGS. ELECTRICAL CONTRACTOR SHALL VERIFY AND CONFIRM ALL DIMENSIONS IN THE FIELD AND NOTIFY THE ENGINEER OF ANY AND ALL DISCREPANCIES ON THE DRAWINGS. COPIES OF THIS DRAWING WITHOUT A PROFESSIONAL ENGINEER'S SEAL AND ORIGINAL SIGNATURE SHALL NOT BE CONSIDERED VALID AND ARE FOR CONVENIENCE TO THE USER AT THEIR OWN RISK.

- 22. ALL WORK SHALL COMPLY WITH THE LATEST REVISION OF THE LOCAL UTILITY'S ELECTRICAL SERVICE REQUIREMENTS (PECO ENERGY'S BLUE BOOK) - COORDINATE ALL SERVICE WORK WITH UTILITY PRIOR TO INSTALLATION. OBTAIN UTILITY APPROVAL BEFORE ENERGIZING NEW WORK. NOTIFY PECO'S NEW BUSINESS SERVICES (FORMERLY CBS) VIA S&M APPLICATION. OBTAIN PECO REQUIREMENTS & DELINEATION OF RESPONSIBILITIES IN WRITING.
- 23. CALL BEFORE YOU DIG (PA ONE CALL SYSTEM 1-800-242-1776 OR DIAL 811). ELECTRICAL CONTRACTOR TO HIRE AN INDEPENDENT UTILITY LOCATING COMPANY TO MARK-OUT CUSTOMER OWNED/PRIVATE PROPERTY FACILITIES BEFORE DIGGING AT ELECTRICAL CONTRACTOR'S EXPENSE.
- 24. THE ELECTRICAL CONTRACTOR TO PLACE NEW EQUIPMENT, RELOCATE CURRENTLY INSTALLED EQUIPMENT, OR RE-WORK EXISTING ROOM AS REQUIRED TO COMPLY WITH WORKING CLEARANCE ISSUES, DEDICATED SPACE ISSUES, AND WITH APPLICABLE CODES.
- 25. ALL NEW BREAKERS AND/OR DEVICES BEING INSTALLED IN EXISTING ELECTRICAL PANELS OR EQUIPMENT SHALL MATCH THE CHARACTERISTICS OF THE EXISTING EQUIPMENT IN MANUFACTURER, TYPE, MINIMUM SHORT CIRCUIT RATING, ETC.
- 26. ELECTRICAL CONTRACOTR TO RE-FEED AND/OR CONNECT NEW FEEDERS TO EXISTING EQUIPMENT AS REQUIRED. ELECTRICAL CONTRACTOR IS RESPONSIBLE TO MAKE ANY REQUIRED AND/OR NECESSARY CHANGES TO THE EXISTING INSTALLATION TO ALLOW FOR NEW SERVICE/FEEDER CONFIGURATION.
- 27. WITH RESPECT TO CONSTRUCTION BASED ON THESE DRAWINGS, THE ELECTRICAL CONTRACTOR IS ULTIMATELY RESPONSIBLE FOR ALL INSTALLED MEANS AND METHODS MEETING ALL APPLICABLE CODES
- 28. ALL SWITCHES AND CIRCUIT BREAKERS INSTALLED IN WET AND DAMP LOCATIONS SHALL MEET NEC 404.4.
- 29. UNLESS OTHERWISE NOTED, ALL CIRCUIT BREAKERS ARE BASED ON INVERSE TIME TYPE AND ALL FUSES ARE BASED ON DUAL ELEMENT TIME-DELAY TYPE.
- 30. ALL WORK SHALL BE SCHEDULED AND COORDINATED WITH THE OWNER SO THAT DISRUPTION TO THE AREAS INVOLVED OR OTHER PARTS OF THE BUILDING ARE KEPT TO A MINIMUM. ELECTRICAL CONTRACTOR SHALL GIVE OWNER A MINIMUM OF FIVE (5) WORKING DAYS NOTICE OF ANY AND ALL WORK THAT WILL INTERFERE WITH OWNER'S OPERATIONS SO A SCHEDULE SUITABLE TO THE OWNER CAN BE ARRANGED.
- 31. PRIOR TO ACCEPTANCE OF THE SPACE, ALL SYSTEMS SHALL BE TESTED, BALANCED AND OPERATED TO DEMONSTRATE TO THE OWNER THAT THE INSTALLATION AND PERFORMANCE OF THE INSTALLED SYSTEMS AND/OR PARTS THEREOF CONFORM TO THE
- 32. THE ELECTRICAL CONTRACTOR SHALL GUARANTEE THE ENTIRE INSTALLATION FOR A MINIMUM PERIOD OF ONE YEAR (EXCEPT WHERE EXTENSIONS OF THIS ONE YEAR PERIOD ARE NOTED) FROM THE DATE OF ACCEPTANCE OF THE SYSTEM AS A WHOLE. ANY DEFECTS IN WORKMANSHIP, MATERIALS, MALFUNCTION OF EQUIPMENT OR UNSATISFACTORY PERFORMANCE, AND ALL OTHER PARTS OF THE BUILDING DAMAGED THEREBY, SHALL BE REPAIRED, REPLACED OR OTHERWISE REMEDIED WITHOUT EXPENSE TO THE OWNER. SUCH REPAIRS OR REPLACEMENTS SHALL BE MADE IN A TIMELY MANNER AND AT THE CONVENIENCE OF THE OWNER.
- 33. ALL ITEMS MARKED WITH A AN (R) ON PLAN SHALL BE DISCONNECTED AND REMOVED BY THE ELECTRICAL CONTRACTOR UNLESS OTHERWISE NOTED. REMOVE EXISTING CONDUCTORS/CABLES WHERE NO LONGER REQUIRED. REMOVE WIRE FROM ALL ABANDONED CONDUIT. RECONNECT DISTURBED FACILITIES WHICH ARE TO REMAIN AND PLACE IN OPERATING CONDITION.
- 34. UPON COMPLETION OF THE CONTRACT, THE ELECTRICAL CONTRACTOR SHALL PROVIDE THE OWNER WITH THREE (3) COMPLETE SETS OF MANUFACTURERS' OPERATING, MAINTENANCE AND PREVENTIVE MAINTENANCE INSTRUCTIONS (IN BOUND BOOK FORM) INCLUDING PARTS LIST, AND COMPLETE PROCUREMENT INFORMATION SPECIFYING EQUIPMENT NUMBERS AND DESCRIPTIONS. OPERATING STAFF PERSONNEL SHALL BE INSTRUCTED AS TO PROPER OPERATING AND SERVICE REQUIREMENTS OF THE SYSTEMS AND EQUIPMENT.
- 35. ELECTRICAL CONTRACTOR SHALL UPON COMPLETION OF THE WORK, SUBMIT A SET OF RECORD DRAWINGS SHOWING ALL BURIED OR CONCEALED EQUIPMENT OF PARTS OF THE WORK.
- 36. UPON COMPLETION OF ALL WORK, THOROUGHLY CLEAN ALL SYSTEMS OF OBSTRUCTIONS, DEBRIS, SCALE, DUST, DIRT, ETC. AND PLACE SYSTEMS IN OPERATION.
- 37. THE ELECTRICAL CONTRACTOR SHALL APPLY FOR AND PAY FOR ALL REQUIRED PERMITS, INSPECTIONS, ETC.
- 38. MAINTAIN CONTINUITY OF EXISTING SYSTEMS. PROVIDE TEMPORARY SERVICE AS NECESSARY. COORDINATE SHUTDOWNS WITH OWNER. RELOCATE, REROUTE, REMOVE OR ABANDON EXISTING WORK THAT INTERFERES WITH THE NEW ARRANGEMENT. REMOVE EXISTING ITEMS AS REQUIRED TO ACCOMMODATE NEW WORK.

ELECTRICAL SYMBOLS:

DUPLEX RECEPTACLE, NEMA 5-20R, 20A, 125V

DUPLEX RECEPTACLE, NEMA 5-20R, 20A, 125V WITH (GFCI) GROUND FAULT CURRENT INTERRUPTER DUPLEX RECEPTACLE, NEMA 5-20R, 20A, 125V WITH (GFCI) GROUND FAULT CURRENT INTERRUPTER PROTECTION (+) INDICATES MOUNTING HEIGHT IN INCHES DUPLEX RECEPTACLE, NEMA 5-20R, 20A, 125V WITH (GFCI) GROUND FAULT CURRENT INTERRUPTER

PROTECTION IN A WEATHER-PROOF ENCLOSURE

SIMPLEX RECEPTACLE, NEMA 5-20R, 20A, 125V

QUADRUPLEX RECEPTACLE, NEMA 5-20R, 20A, 125V SPECIAL RECEPTACLE, CONFIGURATION NOTED ON

PLANS 20A, 120/277 VAC, SINGLE POLE TOGGLE SWITCH

WEATHER PROOF SWITCH OCCUPANCY SENSOR SWITCH 20A, 120/277 VAC, THREE-WAY SWITCH

 \rightarrow

MANUAL MOTOR RATED SWITCH NON-FUSIBLE DISCONNECT SWITCH, 30A/3P, 600V

UNLESS OTHERWISE NOTED

CIRCUIT BREAKER NUMBER

COMBINATION MAGNETIC STARTER, SIZE AS REQUIRED

FUSIBLE DISCONNECT SWITCH, SIZE AS NOTED

BRANCH CIRCUIT HOMERUN INDICATES PANEL AND

LOOP LINE INDICATES CIRCUIT CONDUCTORS AND CONDUIT CONNECTING IDENTIFIED DEVICES.

JUNCTION BOX

CEILING MOUNTED OCCUPANCY SENSOR **PANELBOARD**

LINE VOLTAGE THERMOSTAT FURNISHED BY HVAC

CIRCUIT BREAKER, RATINGS AS INDICATED

CONTRACTOR DUCT SMOKE DETECTOR

METER **POWER POLE**

HANDHOLE **TRANSFORMER**

DAYLIGHT SENSOR, "Z#" INDICATES ZONES CONTROLLED

SECURITY & TELECOMMUNICATION SYMBOLS:

EXISTING CAMERA AND ASSOCIATED CABLING TO BE REMOVED. COORDINATE WORK WITH CITY OF PHILADELPHIA IT. EXISTING CONDUIT TO REMAIN. TURN OVER EXISTING CAMERAS TO CITY OF PHILADELPHIA IT.

NEW CAMERA. PROVIDE (1) CAT 6 CABLE IN EXISTING PATHWAY BACK TO EXISTING PATCH PANEL IN EXISTING CCTV CABINET IN THE OFFICE. TERMINATE CAT 6 CABLE ON 1-PORT RJ45 SURFACE MOUNTED BISCUIT JACK IN JUNCTION BOX AT THE CAMERA. PROVIDE (2) 36-INCH CAT 6 PATCH CORDS TO CITY OF PHILADELPHIA IT FOR FINAL CONNECTIONS. CAMERA AND CAMERA MOUNT TO BE PROVIDED BY CITY OF PHILADELPHIA IT.


DATA CONNECTION - SINGLE GANG JUNCTION BOX WITH SINGLE GANG FACEPLATE. (2) TWO CAT 6 CABLES FOR (2) TWO DATA OUTLETS. MOUNT 18" AFF. HOMERUN CABLES IN CONDUIT UP TO ABOVE CEILING AND DOWN INTO COMPUTER ROOM. INSTALL CABLES ABOVE CEILING USING J-HOOKS. COORDINATE FINAL CONNECTIONS WITHIN THE COMPUTER ROOM WITH CITY OF PHILADELPHIA IT.

FIRE ALARM SYMBOLS:

MANUAL PULL STATION WITH WIRE GUARD SMOKE DETECTOR, PHOTOELECTRIC WITH WIRE GUARD FIRE ALARM CONTROL PANEL FACP


FIRE ALARM ANNUNCIATOR PANEL

STANDARD MOUNT

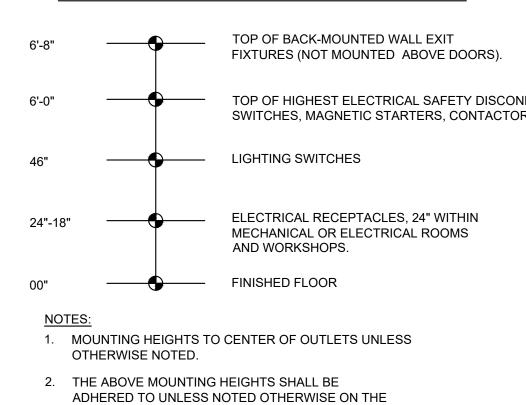

DETAIL CALLOUT S

DRAWINGS OR SPECIFICATION.

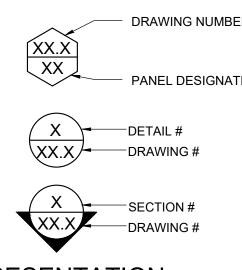

PRESENTATION:

ELECTRICAL EQUIPMENT DESIGNATED BY SOLID HEAV LINE WEIGHT INDICATES NEW WORK TO BE FURNISHEI AND INSTALLED.	ATED BY SOLID HEAVY RK TO BE FURNISHED
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 _		
\bigcirc	∇ L	ELECTRICAL EQUIPMENT DESIGNATED BY SOLID LIG
H		ELECTRICAL EQUIPMENT DESIGNATED BY SOLID LIG LINE WEIGHT INDICATES EXISTING EQUIPMENT TO
		LINE WEIGHT INDIGNIEG EXIGHTING EQUIT MENT TO
		REMAIN, UNLESS OTHERWISE INDICATED.

IN T.1 ELECTRICAL EQUIPMENT DESIGNATED BY DASHED HEAVY LINE WEIGHT REPRESENTS EXISTING EQUIPMENT TO BE REMOVED AND DISPOSED, UNLESS INDICATED TO BE REMOUNTED, RELOCATED, OR

TURNED OVER TO OWNER.

GENERAL DEMOLITION NOTES:

- 1. ELECTRICAL CONTRACTOR SHALL BECOME FAMILIAR WITH EXISTING CONDITIONS AFFECTING THIS PROJECT AND COORDINATE WITH ALL OTHER TRADES.
- 2. THE EXISTING CONDITION/DEMOLITION DRAWINGS ARE INTENDED AS A GENERAL GUIDE TO THE DEMOLITION REQUIRED FOR THIS PROJECT.
- 3. DEMOLITION IS NOT SHOWN IN COMPLETE DETAIL AND IT WILL BE THE RESPONSIBILITY OF THE GENERAL CONTRACTOR TO REMOVE EXISTING CONSTRUCTION AS REQUIRED FOR COMPLETE DEMOLITION.
- 4. REFER TO WORK SHOWN ON OTHER DRAWINGS IN THE SET FOR THE EXTENT OF DEMOLITION REQUIRED TO PERFORM WORK INTENT. (I.E. ARCHITECTURAL, MECHANICAL, ELECTRICAL DEMOLITION SHEETS/NOTES).
- 5. THE GENERAL CONTRACTOR OR ELECTRICAL CONTRACTOR ARE RESPONSIBLE FOR THE REMOVAL OF ALL DEMOLITION DEBRIS GENERATED FROM HIS WORK, TAKING CARE TO PREVENT OVERLOADING OF FLOOR ASSEMBLY AND PROTECTION OF ADJACENT EXISTING CONSTRUCTION.
- DURING DEMOLITION, TAKE ALL PRECAUTIONS NECESSARY TO PREVENT STRUCTURAL AND OTHER DAMAGE TO THE BUILDINGS EXISTING WALLS AND FINISHES.
- PRIOR TO DEMOLITION, ELECTRICAL CONTRACTOR SHALL VERIFY BY MEANS OF VOLTAGE TESTING THAT ALL DEVICES, EQUIPMENT, ETC, TO BE REMOVED BY GENERAL CONTRACTOR ARE DE-ENERGIZED AND SAFE-OFF.
- 8. ELECTRICAL CONTRACTOR SHALL UPDATE PANELBOARD DIRECTORIES INDICATING WHICH CIRCUIT BREAKERS BECOME SPARES DUE TO

TELECOMMUNICATION GENERAL NOTES:

INSTALLATION OF CATEGORY 6 UTP CABLE SHALL BE IN ACCORDANCE WITH TIA GUIDELINES. CABLE INSTALLATION AND TERMINATIONS THAT DO NOT COMPLY SHALL BE REPLACED BY THE CONTRACTOR AT NO ADDITIONAL COST TO THE OWNER.

THAN 4X THE OUTSIDE DIAMETER OF THE CABLE.

- THE MAXIMUM PULLING FOR A SINGLE CABLE SHALL NOT EXCEED 25 THE MINIMUM BENDING RADIOS OF THE CABLE SHALL NOT BE LESS
- THE CABLE SHALL BE INSTALLED WITHOUT KINKS OR TWISTS AND THE APPLICATION OF THE CABLE TIES SHALL NOT DEFORM THE CABLE BUNDLE. CONDUITS SHALL TRANSITION INTO CABLE TRAYS USING CONDUIT AND BELLS, NO CABLE SHALL BE INSTALLED OVER ROUGH EDGES IN ANY TRANSITION.
- STRIP BACK ONLY AS MUCH CABLE JACKET AS IS REQUIRED TO TERMINATE THE CABLE. CABLE PAIRS SHALL NOT BE UNTWISTED MORE THAN 1/2 INCH. CABLES SHALL BE TESTED PER THE SPECIFICATIONS, CABLES WHICH
- DO NOT PASS TESTS SHALL BE REPLACED, OR RECTIFIED BY THE CONTRACTOR AT NO ADDITIONAL COST. THE CONTRACTOR SHALL NOT INSTALL ANY NEW CATEGORY 6 CABLE AT LENGTHS GRATER THAN 90 METERS FROM PATCH PANEL TO OUTLET BOX. THE CONTRACTOR SHALL BRING ANY CONDITIONS

EXCEEDING THE CABLE LIMIT DISTANCE TO THE ENGINEER.

2. CONTRACTOR SHALL BE RESPONSIBLE FOR FURNISHING AND INSTALLING CABLING. CONTRACTOR SHALL ALSO BE RESPONSIBLE FIR FURNISHING AND INSTALLING CONDUIT FROM EQUIPMENT DEVICE LOCATIONS TO DESIGNATED TERMINATION ROOMS. ALL NEW CABLING SHALL BE INSTALLED IN CONDUIT UNLESS OTHER

ING HEIGHTS: ELE	CTRICA	AL ABBREVIATIONS:
ACK-MOUNTED WALL EXIT	A, AMP	AMPERES
(NOT MOUNTED ABOVE DOORS).	AC	ALTERNATING CURRENT
	AFCI	ARC FAULT CIRCUIT INTERRUPTER
IGHEST ELECTRICAL SAFETY DISCONNECT 3, MAGNETIC STARTERS, CONTACTORS.	AFF	ABOVE FINISHED FLOOR
S, MAGNETIC STARTERS, CONTACTORS.	AFG	ABOVE FINISHED GRADE
SWITCHES	AIC	AMP INTERRUPTING CAPACITY
SWITCHES	AT	AMP TRIP
	AF	AMP FRAME
AL RECEPTACLES, 24" WITHIN	ATC	AUTOMATIC TEMPERATURE CONTROL
CAL OR ELECTRICAL ROOMS	AWG	AMERICAN WIRE GAUGE
KSHOPS.	BKR	BREAKER
FLOOR	C, CND	CONDUIT
. 2001.	C.B.	CIRCUIT BREAKER
	CKT	CIRCUIT
OUTLETS UNLESS	CU	COPPER
	DC	DIRECT CURRENT
IALL BE	DDC	DIGITAL DATA CONTROL
RWISE ON THE	DWG	DRAWING
	(E)	EXISTING WORK/EQUIPMENT TO REMAIN
	(ER)	EXISTING WORK/EQUIPMENT TO BE REMOVED AND RELOCATED
YMBOLS:	EC	ELECTRICAL CONTRACTOR
	EF	EXHAUST FAN
UMBER	ELEC	ELECTRICAL
	EQUIP	EQUIPMENT
	EM	EMERGENCY
GNATION	EMH	ELECTRICAL MANHOLE
	EMT	ELECTRICAL METALLIC TUBING
	EUH	ELECTRIC UNIT HEATER
	FT	FOOT (FEET)

G, GND GROUND GFCI, GFI GROUND FAULT CIRCUIT INTERRUPTER ΗZ **HERTZ**

KILO AMPERES INTERRUPTING CURRENT KVA KILO VOLTS AMPERES

MECHANICAL CONTRACTOR

KW KILOWATTS LFMC LIQUID TIGHT FLEXIBLE METAL CONDUIT

MCB MAIN CIRCUIT BREAKER MCA MAXIMUM CIRCUIT AMPACITY MIN MINIMUM

JUNCTION BOX

MISC **MISCELLANEOUS** MLO MAIN LUG ONLY

MOCE MAXIMUM OVER CURRENT PROTECTION

MOCD MAXIMUM OVER CURRENT PROTECTIVE DEVICE (N) NEW

NATIONAL ELECTRIC CODE NOT IN CONTRACT NOT TO SCALE

POLE PHASE PWR

POWER (R) **EXISTING EQUIPMENT TO BE DISCONNECTED & REMOVED**

(RE) RELOCATED EXISTING WORK RCP1 RECEPTACLE RGS RIGID GALVANIZED STEEL

RIGID METAL CONDUIT RNC RIGID NON-METALLIC CONDUIT SCCR SHORT CIRCUIT CURRENT RATING

SURFACE METAL RACEWAY SWITCH SPECS SPECIFICATIONS

TBD TO BE DETERMINED TRANSIENT VOLTAGE SURGE SUPPRESSION

TWISTED SHIELDED TYP. TYPICAL UE UNDERGROUND ELECTRIC

UH **UNIT HEATER** UON **UNLESS OTHERWISE NOTED**

UNINTERRUPTIBLE POWER SUPPLY VOLTS VFD VARIABLE FREQUENCY DRIVE

WEATHER PROOF TRANSFORMER

REVISIONS

REVISIONS

DATE

ISSUE

PROJECT COORDINATOR

CONSTRUCTION DOCUMENTS

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CITY OF PHILADELPHIA DEPARTMENT OF PARKS & RECREATION

1515 ARCH STREET 11TH FLOOR, ONE PARKWAY BUILDING

PHILADELPHIA

RENOVATIONS TO THE HAPPY HOLLOW RECREATION CENTER

ELECTRICAL GENERAL NOTES. SYMBOLS AND ABBREVIATIONS

PENNSYLVANIA

16315E-03-02 05/13/2025 AS NOTED TM ALL DIMENSIONS AND CONDITIONS SHALL BE VERIFIED BY THE

CONSTRUCTION DOCUMENTS

CONTACTOR AT THE SITE BEFORE PROCEEDING WITH THE WORL

AREA NOT IN SCOPE

EAST BASEMENT

002

- REFER TO DRAWING E-001 FOR GENERAL NOTES, SYMBOLS AND ABBREVIATIONS.
- 2. REFER TO SHEET E-601 AND E-602 FOR ELECTRICAL SCHEDULES.

OUTSIDE OF THE WORK AREA.

KEYED NOTES:

1 CONTRACTOR SHALL FIELD INVESTIGATE AND VERIFY THE LOADS THAT ARE FED BY THE EXISTING DISCONNECTS IN THE WEST BASEMENT. NOTIFY ENGINEER IF ANY CIRCUITS REQUIRE SPLICING AND CONTINUATION OF SERVICE

REVISIONS		
ISSUE	DATE	REVISIONS



CONSTRUCTION DOCUMENTS

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CITY OF PHILADELPHIA DEPARTMENT OF PARKS & RECREATION

1515 ARCH STREET

11TH FLOOR, ONE PARKWAY BUILDING PENNSYLVANIA

PHILADELPHIA

RENOVATIONS TO THE HAPPY **HOLLOW RECREATION CENTER**

SCALE: 1/8"=1'-0"

ELECTRICAL DEMOLITION BASEMENT POWER PLAN

PROJECT NO).	DRAWING NO.
1	6315E-03-02	
DATE	05/13/2025	ED-101
SCALE	AS NOTED	
DRAWN BY	TM	
CHECKED BY	PL	FILE:
NOTE:	ALL DIMENSIONS AND CONDITIONS SI CONTACTOR AT THE SITE BEFORE PRO	

CONSTRUCTION DOCUMENTS



WEST BASEMENT

001

EXG CRAWL SPACE


(R) (3) TIMERS AND — (3) LIGHTING CONTACTORS

- REFER TO DRAWING E-001 FOR GENERAL NOTES, SYMBOLS AND ABBREVIATIONS.
- 2. REFER TO SHEET E-601 AND E-602 FOR ELECTRICAL SCHEDULES.
- 3. ALL SHOWN IS NEW UNLESS OTHERWISE NOTED AS (E) EXISTING TO REMAIN OR (R) EXISTING TO BE

1 REMOVE ALL POWER DEVICES IN BUILDING AND DEMOLISH CIRCUITRY WIRING BACK TO THE PANELBOARDS. SEE SHEET E-102 FOR NEW WORK.

KEYED NOTES:

- 2 DISCONNECT THE EXISTING CIRCUIT FEEDING THE COMPUTER ROOM 102 FROM THE GYMNASIUM BUILDING. LOCK OUT/TAG CIRCUIT BREAKER #15 IN PANEL 'B' LOCATED IN THE GYMNASIUM BUILDING.
- 3 ALL EXISTING DATA AND PHONE CABLING, CONNECTIONS, CONDUITS AND DEVICES TO REMAIN AND PROTECTED DURING CONSTRUCTION. COORDINATE WITH CITY OF PHILADELPHIA IT. ALL EXISTING COMPUTERS AND PRINTERS WILL BE DISCONNECTED AND REMOVED PRIOR TO START OF CONSTRUCTION AND WILL BE RE-INSTALLED AFTER COMPLETION OF CONSTRUCTION BY CITY OF PHILADELPHIA IT.
- 4 EXISTING CCTV HEADEND EQUIPMENT WILL BE DISCONNECTED AND REMOVED PRIOR TO START OF CONSTRUCTION AND WILL BE RE-INSTALLED AFTER COMPLETION OF CONSTRUCTION BY CITY OF PHILADELPHIA IT.

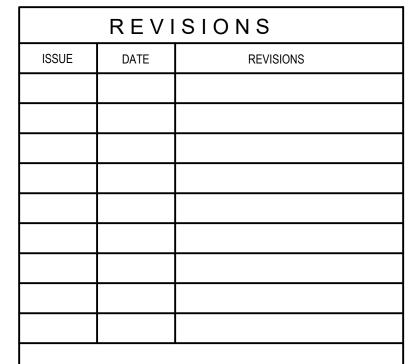



CONSTRUCTION DOCUMENTS

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CITY OF PHILADELPHIA DEPARTMENT OF PARKS & RECREATION

1515 ARCH STREET

11TH FLOOR, ONE PARKWAY BUILDING PHILADELPHIA PENNSYLVANIA

RENOVATIONS TO THE HAPPY **HOLLOW RECREATION CENTER**

ELECTRICAL DEMOLITION FIRST FLOOR POWER AND SECURITY PLAN

PROJECT NO.		DRAWING NO.
16	6315E-03-02	
DATE	05/13/2025	LD-102
SCALE	AS NOTED	
DRAWN BY	TM	
CHECKED BY	PL	FILE:
NOTE:	ALL DIMENSIONS AND CONDITIONS SI	

CONSTRUCTION DOCUMENTS

ELECTRICAL DEMOLITION FIRST FLOOR POWER AND SECURITY PLAN Scale: 1/8" = 1'-0"

(R) PANEL 'K'

MEN'S

RESTROOM -

109

— (R) UNIT HEATER

ACTIVITIES ROOM 106

(R) UNIT HEATER —

OFFICE

RESTROOM

(R) UNIT HEATER -

(E) CCTV MONITOR ABOVE DOOR (E) CCTV CABINET


— (R) PANEL 'F'

WOMEN'S _KESTKOOM


101

AREA NOT IN SCOPE


STORAGE

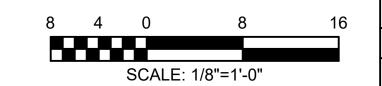

- REFER TO DRAWING E-001 FOR GENERAL NOTES, SYMBOLS AND ABBREVIATIONS.
- 2. REFER TO SHEET E-601 AND E-602 FOR ELECTRICAL SCHEDULES.
- 3. EXISTING LIGHT FIXTURE SHALL BE DISCONNECTED AND REMOVED. REMOVE AND DEMOLISH CIRCUITS AND CONDUIT ASSOCIATED WITH LIGHT FIXTURES BACK TO SOURCE. DISCONNECT, REMOVE AND DEMOLISH ALL EXISTING LIGHTING CONTROLS AND ASSOCIATED WIRING/CONDUIT BACK TO SOURCE.

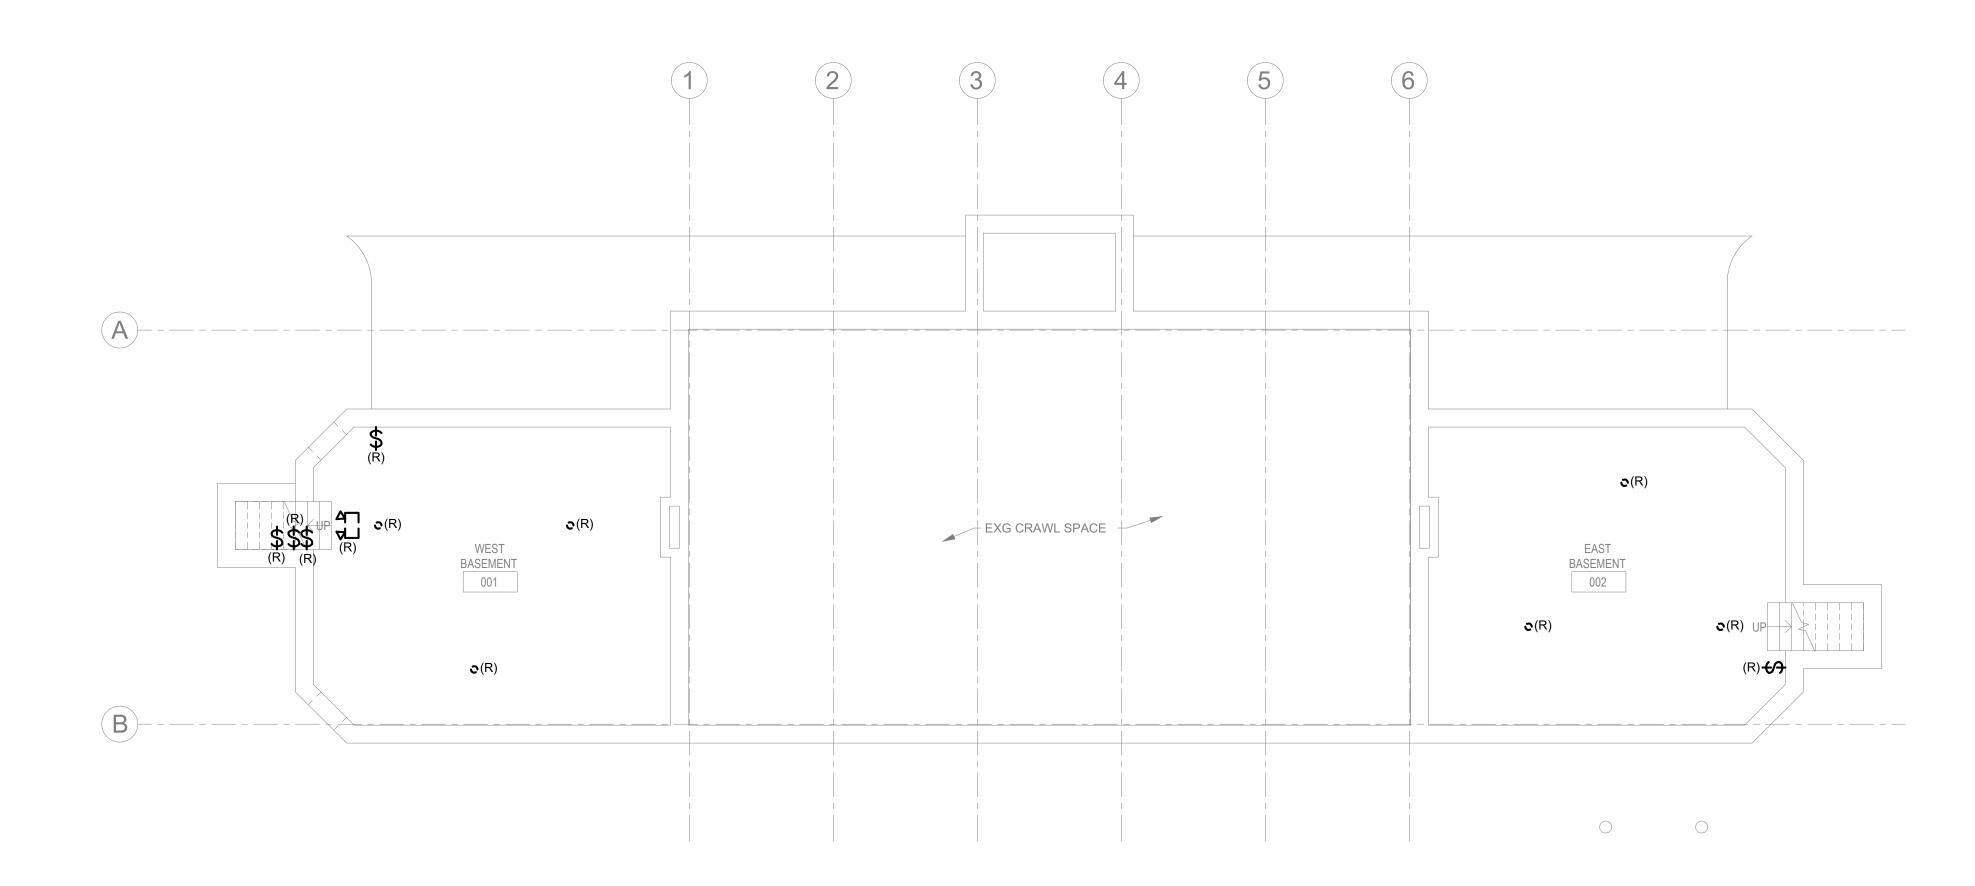

AREA NOT IN SCOPE

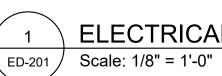

ELECTRICAL DEMOLITION BASEMENT LIGHTING PLAN

SCALE: 1/8"=1'-0"

IONS
REVISIONS



CONSTRUCTION DOCUMENTS

PROJECT COORDINATOR LEEANN SUEN



SMP ARCHITECTS

1600 Walnut Street, 2nd Floor Philadelphia, Pennsylvania 19103 215 985 4410

LANDSCAPE ARCHITECT: GROUND RECONSIDERED www.groundreconsidered.com 215 790 0727

CIVIL ENGINEER: KS ENGINEERS

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STRUCTURAL ENGINEER:
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MEP ENGINEER: ARORA ENGINEERS

www.aroraengineers.com 610 459 7900

ROOFING CONSULTANT:
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856 287 2424

CITY OF PHILADELPHIA DEPARTMENT OF PARKS & RECREATION

1515 ARCH STREET

11TH FLOOR, ONE PARKWAY BUILDING PENNSYLVANIA PHILADELPHIA


RENOVATIONS TO THE HAPPY **HOLLOW RECREATION CENTER**

ELECTRICAL DEMOLITION BASEMENT LIGHTING PLAN


PROJECT NO.		DRAWING NO.
16	315E-03-02	
DATE	05/13/2025	ED-201
SCALE	AS NOTED	
DRAWN BY	TM	
CHECKED BY	PL	FILE:

CONSTRUCTION DOCUMENTS

- REFER TO DRAWING E-001 FOR GENERAL NOTES, SYMBOLS AND ABBREVIATIONS.
- 2. REFER TO SHEET E-601 AND E-602 FOR ELECTRICAL SCHEDULES.
- ALL SHOWN IS NEW UNLESS OTHERWISE NOTED AS (E) EXISTING TO REMAIN OR (R) EXISTING TO BE REMOVED.
- 4. EXISTING LIGHT FIXTURE SHALL BE DISCONNECTED AND REMOVED. REMOVE AND DEMOLISH CIRCUITS AND CONDUIT ASSOCIATED WITH LIGHT FIXTURES BACK TO SOURCE. DISCONNECT, REMOVE AND DEMOLISH ALL EXISTING LIGHTING CONTROLS AND ASSOCIATED WIRING/CONDUIT BACK TO SOURCE.

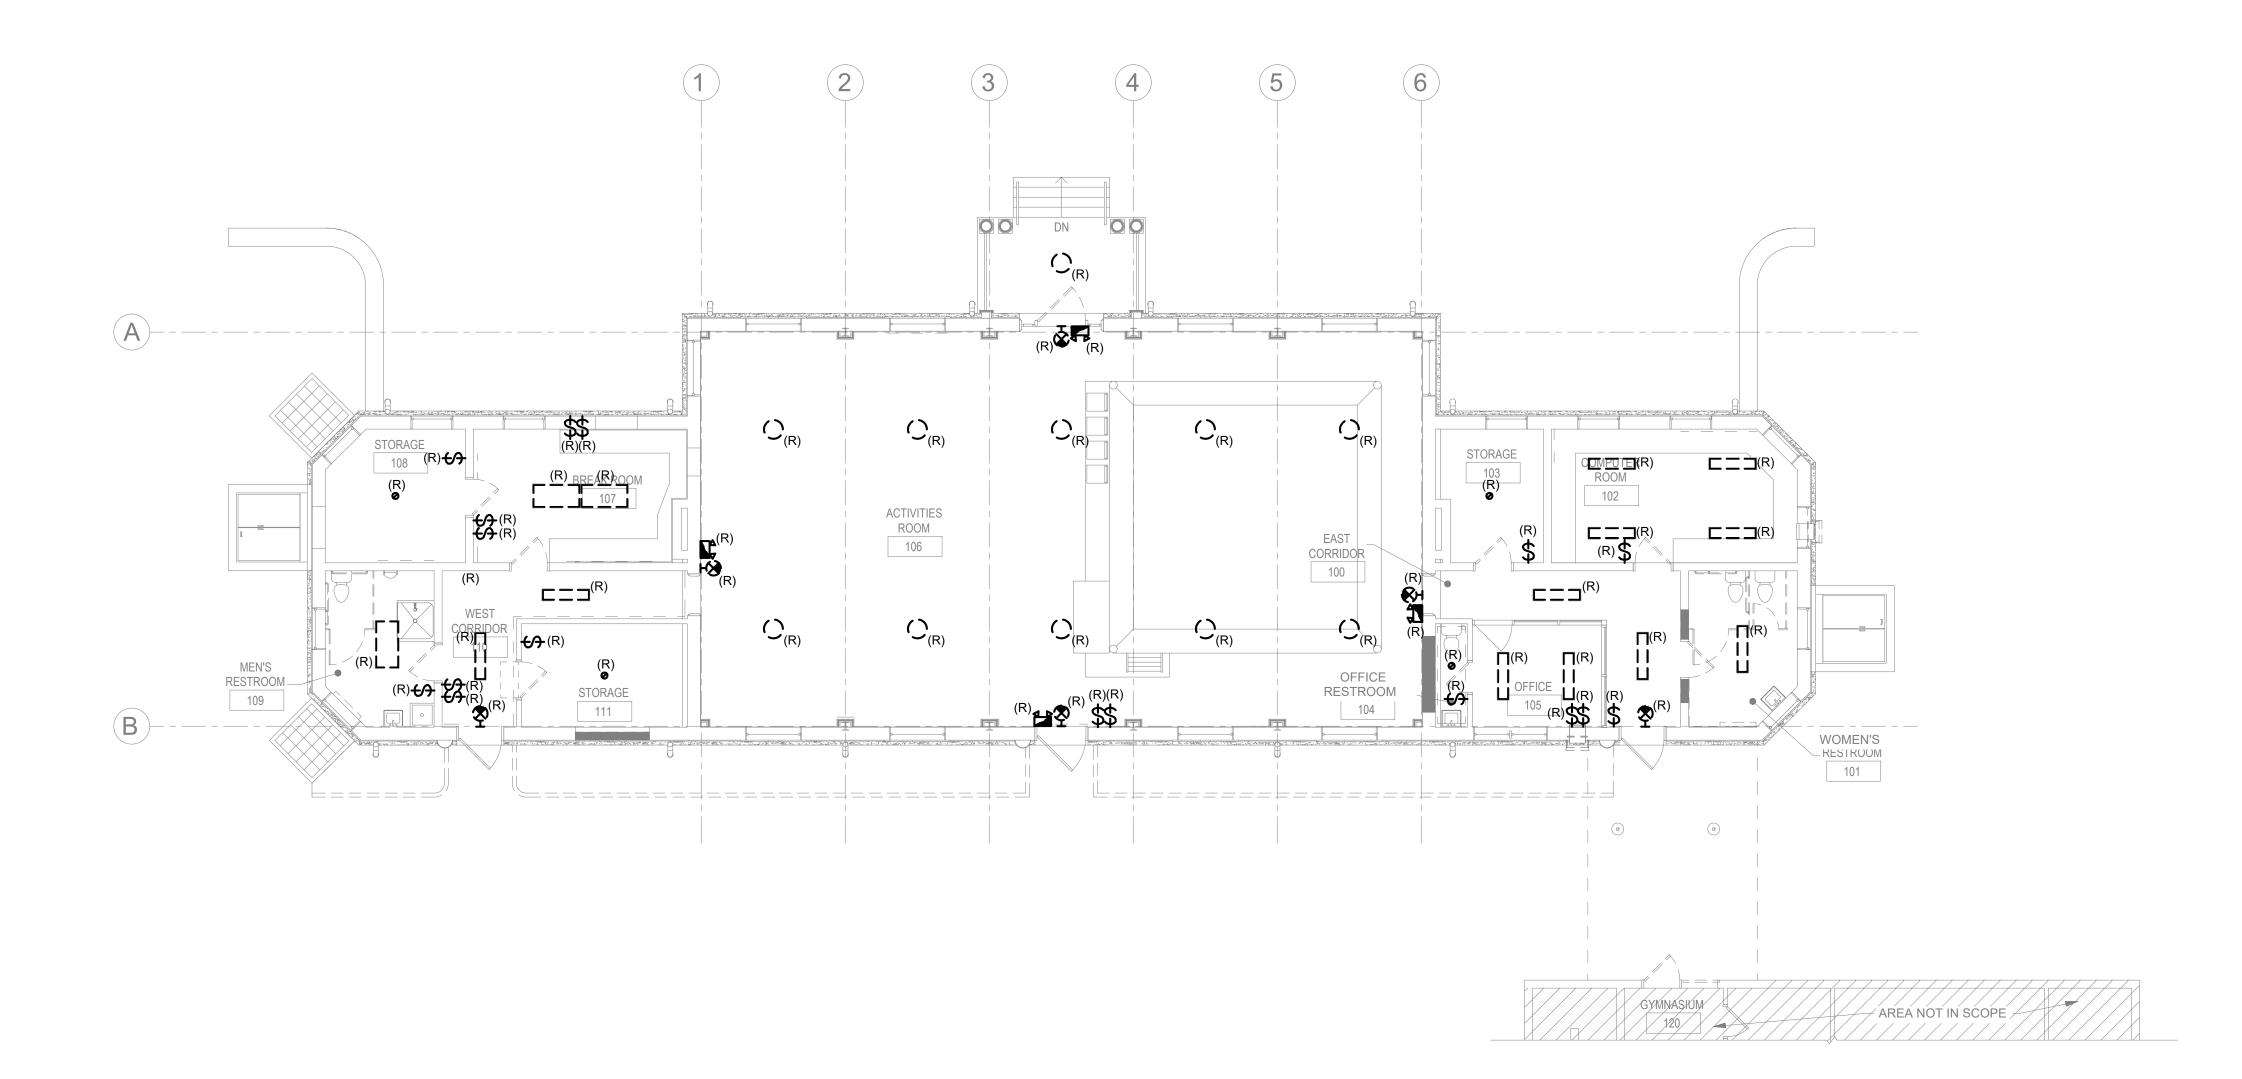



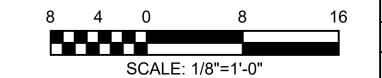

REVISIONS		
ISSUE	DATE	REVISIONS



CONSTRUCTION DOCUMENTS

LEEANN SUEN

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CITY OF PHILADELPHIA DEPARTMENT OF PARKS & RECREATION

1515 ARCH STREET

11TH FLOOR, ONE PARKWAY BUILDING

111H FLOOR, ONE PARKWAY BUILDING

PHILADELPHIA PENNSYLVANIA

ROJECT TITLE


RENOVATIONS TO THE HAPPY HOLLOW RECREATION CENTER

DRAWING TITLE

ELECTRICAL DEMOLITION FIRST FLOOR LIGHTING PLAN


PROJECT N	NO.	DRAWING NO.
1	6315E-03-02	
DATE	05/13/2025	LD-202
SCALE	AS NOTED	
DRAWN BY	TM	
CHECKED E	PL PL	FILE:
NOTE:	ALL DIMENSIONS AND CONDITIONS CONTACTOR AT THE SITE BEFORE PF	

- REFER TO DRAWING E-001 FOR GENERAL NOTES, SYMBOLS AND ABBREVIATIONS.
- 2. REFER TO SHEET E-601 AND E-602 FOR ELECTRICAL SCHEDULES.
- 3. EQUIPMENT LOCATIONS SHOWN ARE DIAGRAMMATIC. PLEASE REFER TO
 ARCHITECTURAL PLANS FOR PRECISE LOCATIONS
 OF EQUIPMENT.

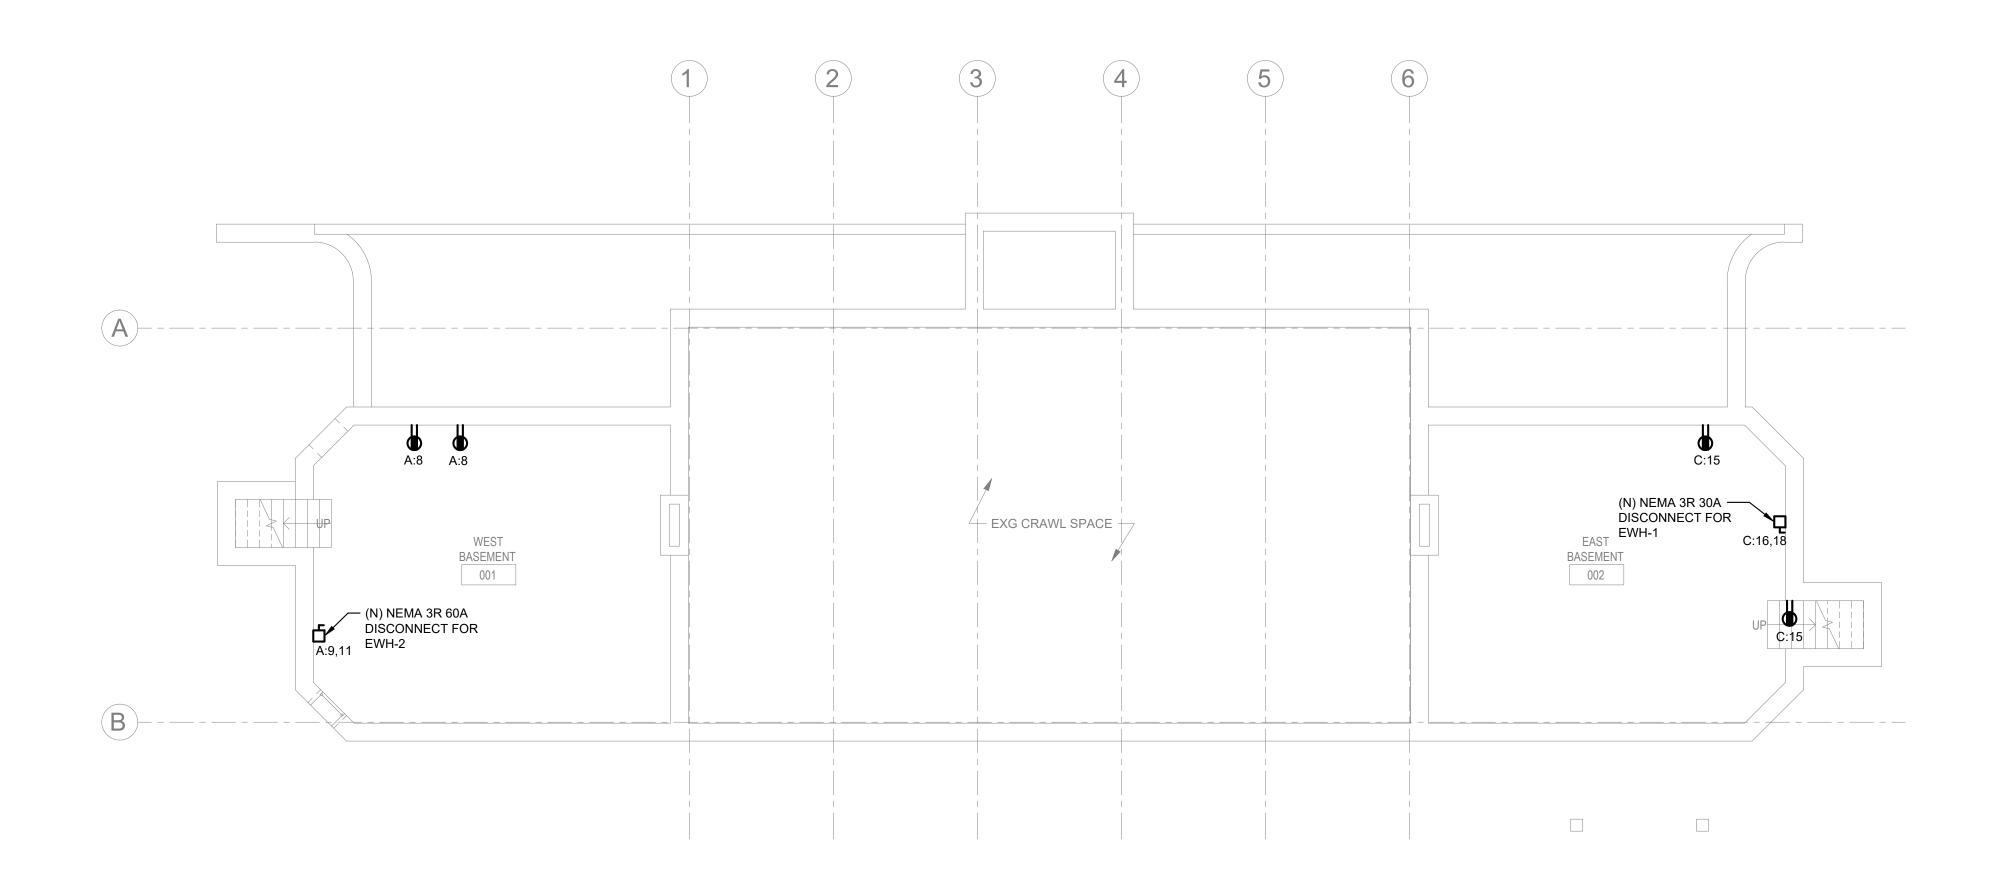





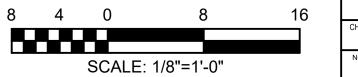

	REVISIONS			
ISSUE	DATE	REVISIONS		



CONSTRUCTION DOCUMENTS

PROJECT COORDINATOR

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CITY OF PHILADELPHIA DEPARTMENT OF PARKS & RECREATION

1515 ARCH STREET

11TH FLOOR, ONE PARKWAY BUILDING PHILADELPHIA PENNSYLVANIA

RENOVATIONS TO THE HAPPY HOLLOW RECREATION CENTER

ELECTRICAL POWER BASEMENT PLAN


PROJECT NO.		DRAWING NO.
16	315E-03-02	
DATE	05/13/2025	L -101
SCALE	AS NOTED	
DRAWN BY	TM	
CHECKED BY	PL	FILE:

CONSTRUCTION DOCUMENTS

- REFER TO DRAWING E-001 FOR GENERAL NOTES, SYMBOLS AND ABBREVIATIONS.
- 2. REFER TO SHEET E-601 AND E-602 FOR ELECTRICAL SCHEDULES.
 - INILESS OTHERWISE NOTED AS
- ALL SHOWN IS NEW UNLESS OTHERWISE NOTED AS (E) EXISTING TO REMAIN OR (R) EXISTING TO BE REMOVED.

KEYED NOTES:

- (N) 400A MAIN DISTRIBUTION PANEL 'MDP' 120/240V, 1Ø, 3W
- (N) 100A PANEL 'A' 120/240V, 1Ø, 3W
- (3) (N) LIGHTING CONTROL PANEL
- (N) 100A PANEL 'D' 120/240V, 1Ø, 3W
- 5 SPRAYGROUND CONTROLS. REFER TO SITE PLAN FOR EXACT LOCATION.

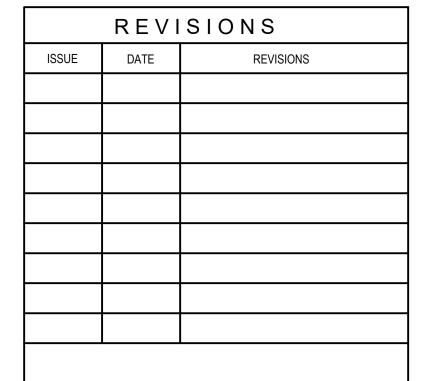



CONSTRUCTION DOCUMENTS

LEEANN SUEN

EALS

PROJECT COORDINATOR



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856 287 2424

CITY OF PHILADELPHIA
DEPARTMENT OF PARKS & RECREATION

1515 ARCH STREET 11TH FLOOR, ONE PARKWAY BU

11TH FLOOR, ONE PARKWAY BUILDING
PHILADELPHIA PENNSYLVANIA

JECT TITLE

RENOVATIONS TO THE HAPPY HOLLOW RECREATION CENTER

DRAWING TITLE

ELECTRICAL POWER AND SECURITY
FIRST FLOOR PLAN

TATE 05/13/2025

CALE AS NOTED

RAWN BY TM

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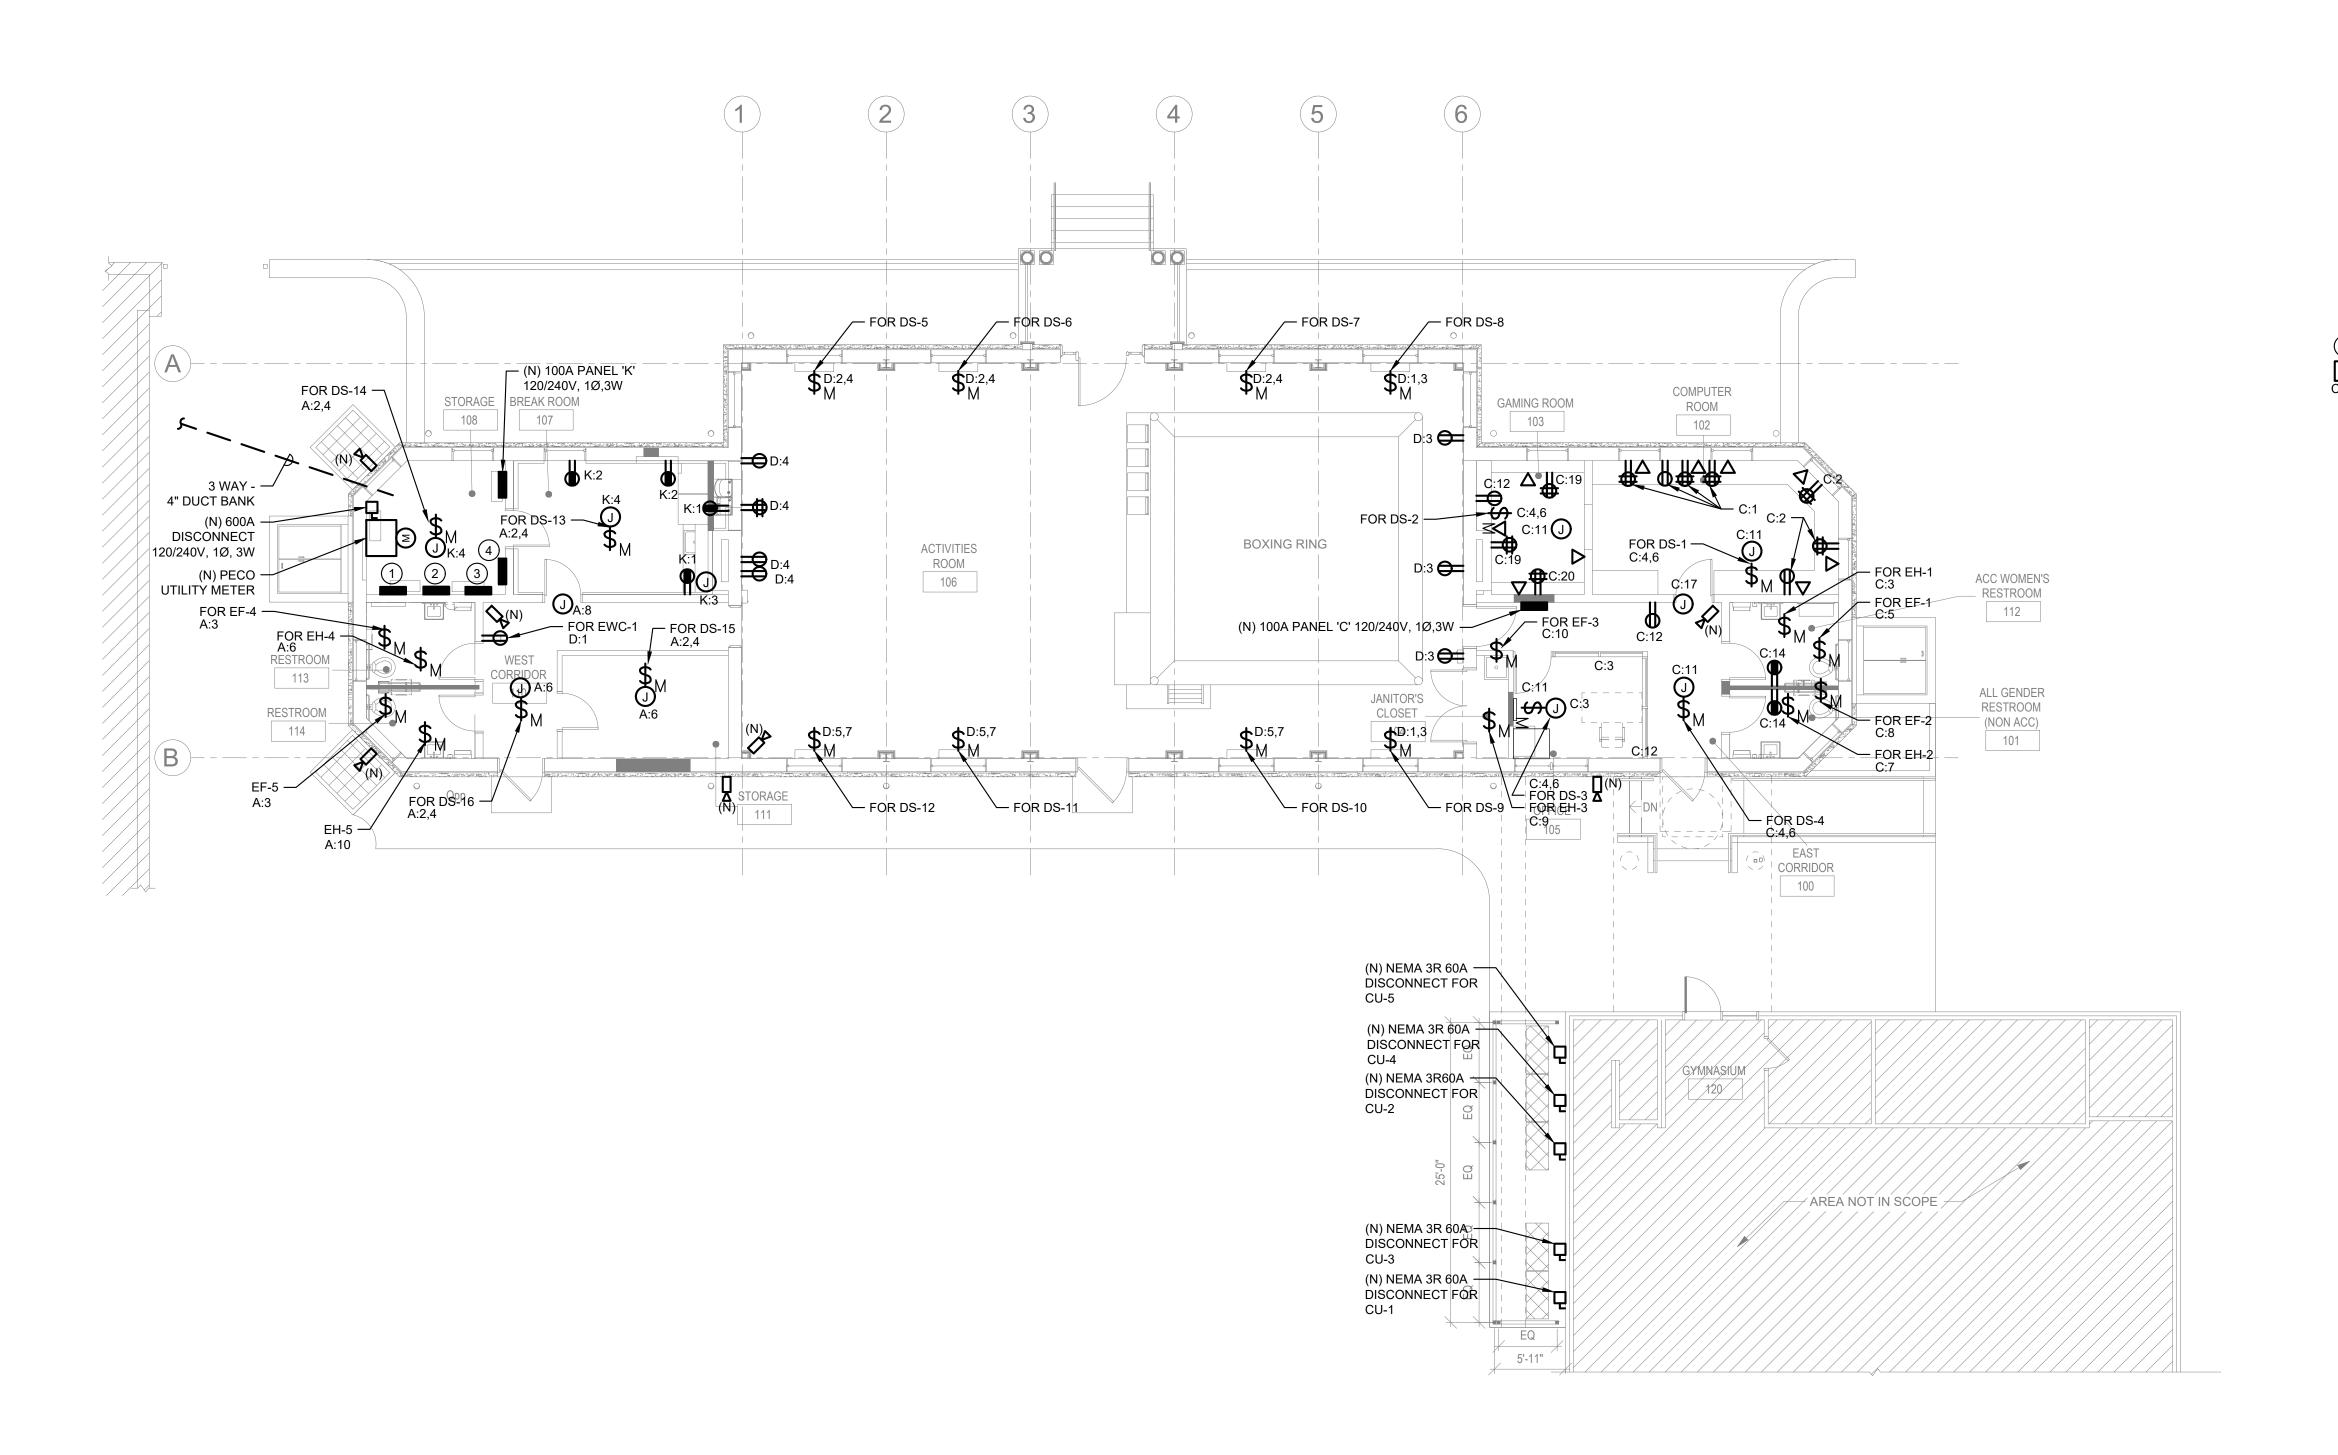
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DRAWING NO.

E-102

CONSTRUCTION DOCUMENTS

ALL DIMENSIONS AND CONDITIONS SHALL BE VERIFIED BY THE CONTACTOR AT THE SITE BEFORE PROCEEDING WITH THE WORK




1 E-102

ELECTRICAL POWER AND SECURITY FIRST FLOOR PLAN

Scale: 1/8" = 1'-0"


8 4 0 8 16 SCALE: 1/8"=1'-0"

- REFER TO DRAWING E-001 FOR GENERAL NOTES, SYMBOLS AND ABBREVIATIONS.
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- 3. ALL SHOWN IS NEW UNLESS OTHERWISE NOTED AS (E) EXISTING TO REMAIN OR (R) EXISTING TO BE REMOVED.

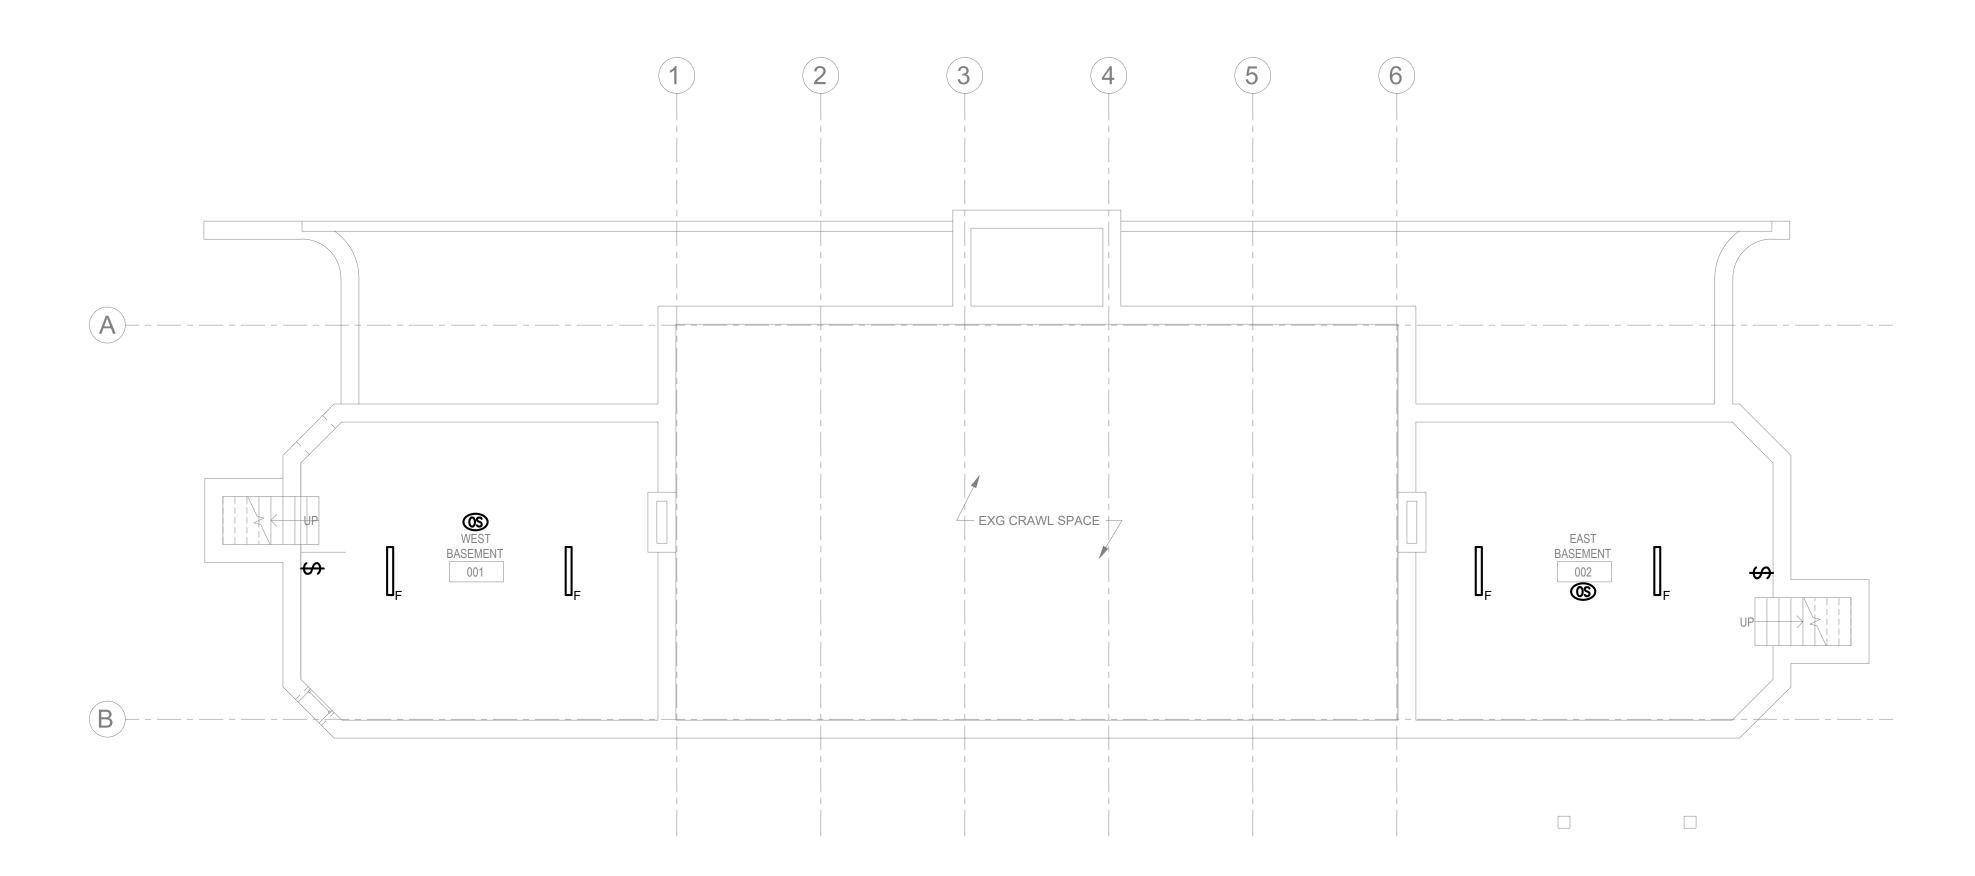

AREA NOT IN SCOPE



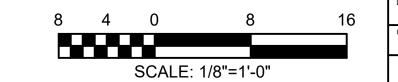

	REVISIONS			
ISSUE	DATE	REVISIONS		



CONSTRUCTION DOCUMENTS

PROJECT COORDINATOR

LEEANN SUEN



SMP ARCHITECTS

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CITY OF PHILADELPHIA DEPARTMENT OF PARKS & RECREATION

1515 ARCH STREET 11TH FLOOR, ONE PARKWAY BUILDING

PHILADELPHIA

RENOVATIONS TO THE HAPPY HOLLOW RECREATION CENTER

PENNSYLVANIA

ELECTRICAL LIGHTING BASEMENT PLAN

PROJECT NO.		DRAWING NO.
16	6315E-03-02	
DATE	05/13/2025	L-201
SCALE	AS NOTED	
DRAWN BY	TM	
CHECKED BY	PL	FILE:
NOTE:	ALL DIMENSIONS AND CONDITIONS SI	


- REFER TO DRAWING E-001 FOR GENERAL NOTES, SYMBOLS AND ABBREVIATIONS.
- 2. REFER TO SHEET E-601 AND E-602 FOR ELECTRICAL SCHEDULES.
- ALL SHOWN IS NEW UNLESS OTHERWISE NOTED AS (E) EXISTING TO REMAIN OR (R) EXISTING TO BE REMOVED.
- REFER TO LANDSCAPE DRAWINGS FOR EXACT LOCATIONS OF LIGHT POLES.

KEYED NOTES:

- EXISTING LIGHT POLE TO REMAIN. REPLACE
 EXISTING FIXTURE HEADS WITH NEW LED
 LUMINAIRES.
- 2 PROVIDE 2#12, 1#12G IN 1"C AND FEED NEW LIGHT POLE FROM THE ADJACENT POLE LIGHT.

P1 1

SCALE: 1/8"=1'-0"

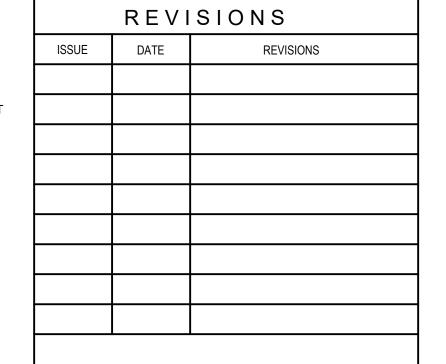



CONSTRUCTION DOCUMENTS

LEEANN SUEN

PROJECT COORDINATOR



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CITY OF PHILADELPHIA DEPARTMENT OF PARKS & RECREATION

1515 ARCH STREET

11TH FLOOR, ONE PARKWAY BUILDING
PHILADELPHIA PENN

OJECT TITLE

RENOVATIONS TO THE HAPPY HOLLOW RECREATION CENTER


PENNSYLVANIA

DRAWING TITLE

ELECTRICAL LIGHTING FIRST FLOOR PLAN


PROJECT N	0.	DRAWING NO.
1	6315E-03-02	
DATE	05/13/2025	E-202
SCALE	AS NOTED	
DRAWN BY	TM	
CHECKED B	Y PL	FILE:
NOTE: ALL DIMENSIONS AND CONDITIONS SHALL BE VERIFIED BY THE CONTACTOR AT THE SITE BEFORE PROCEEDING WITH THE WORK		

CONSTRUCTION DOCUMENTS

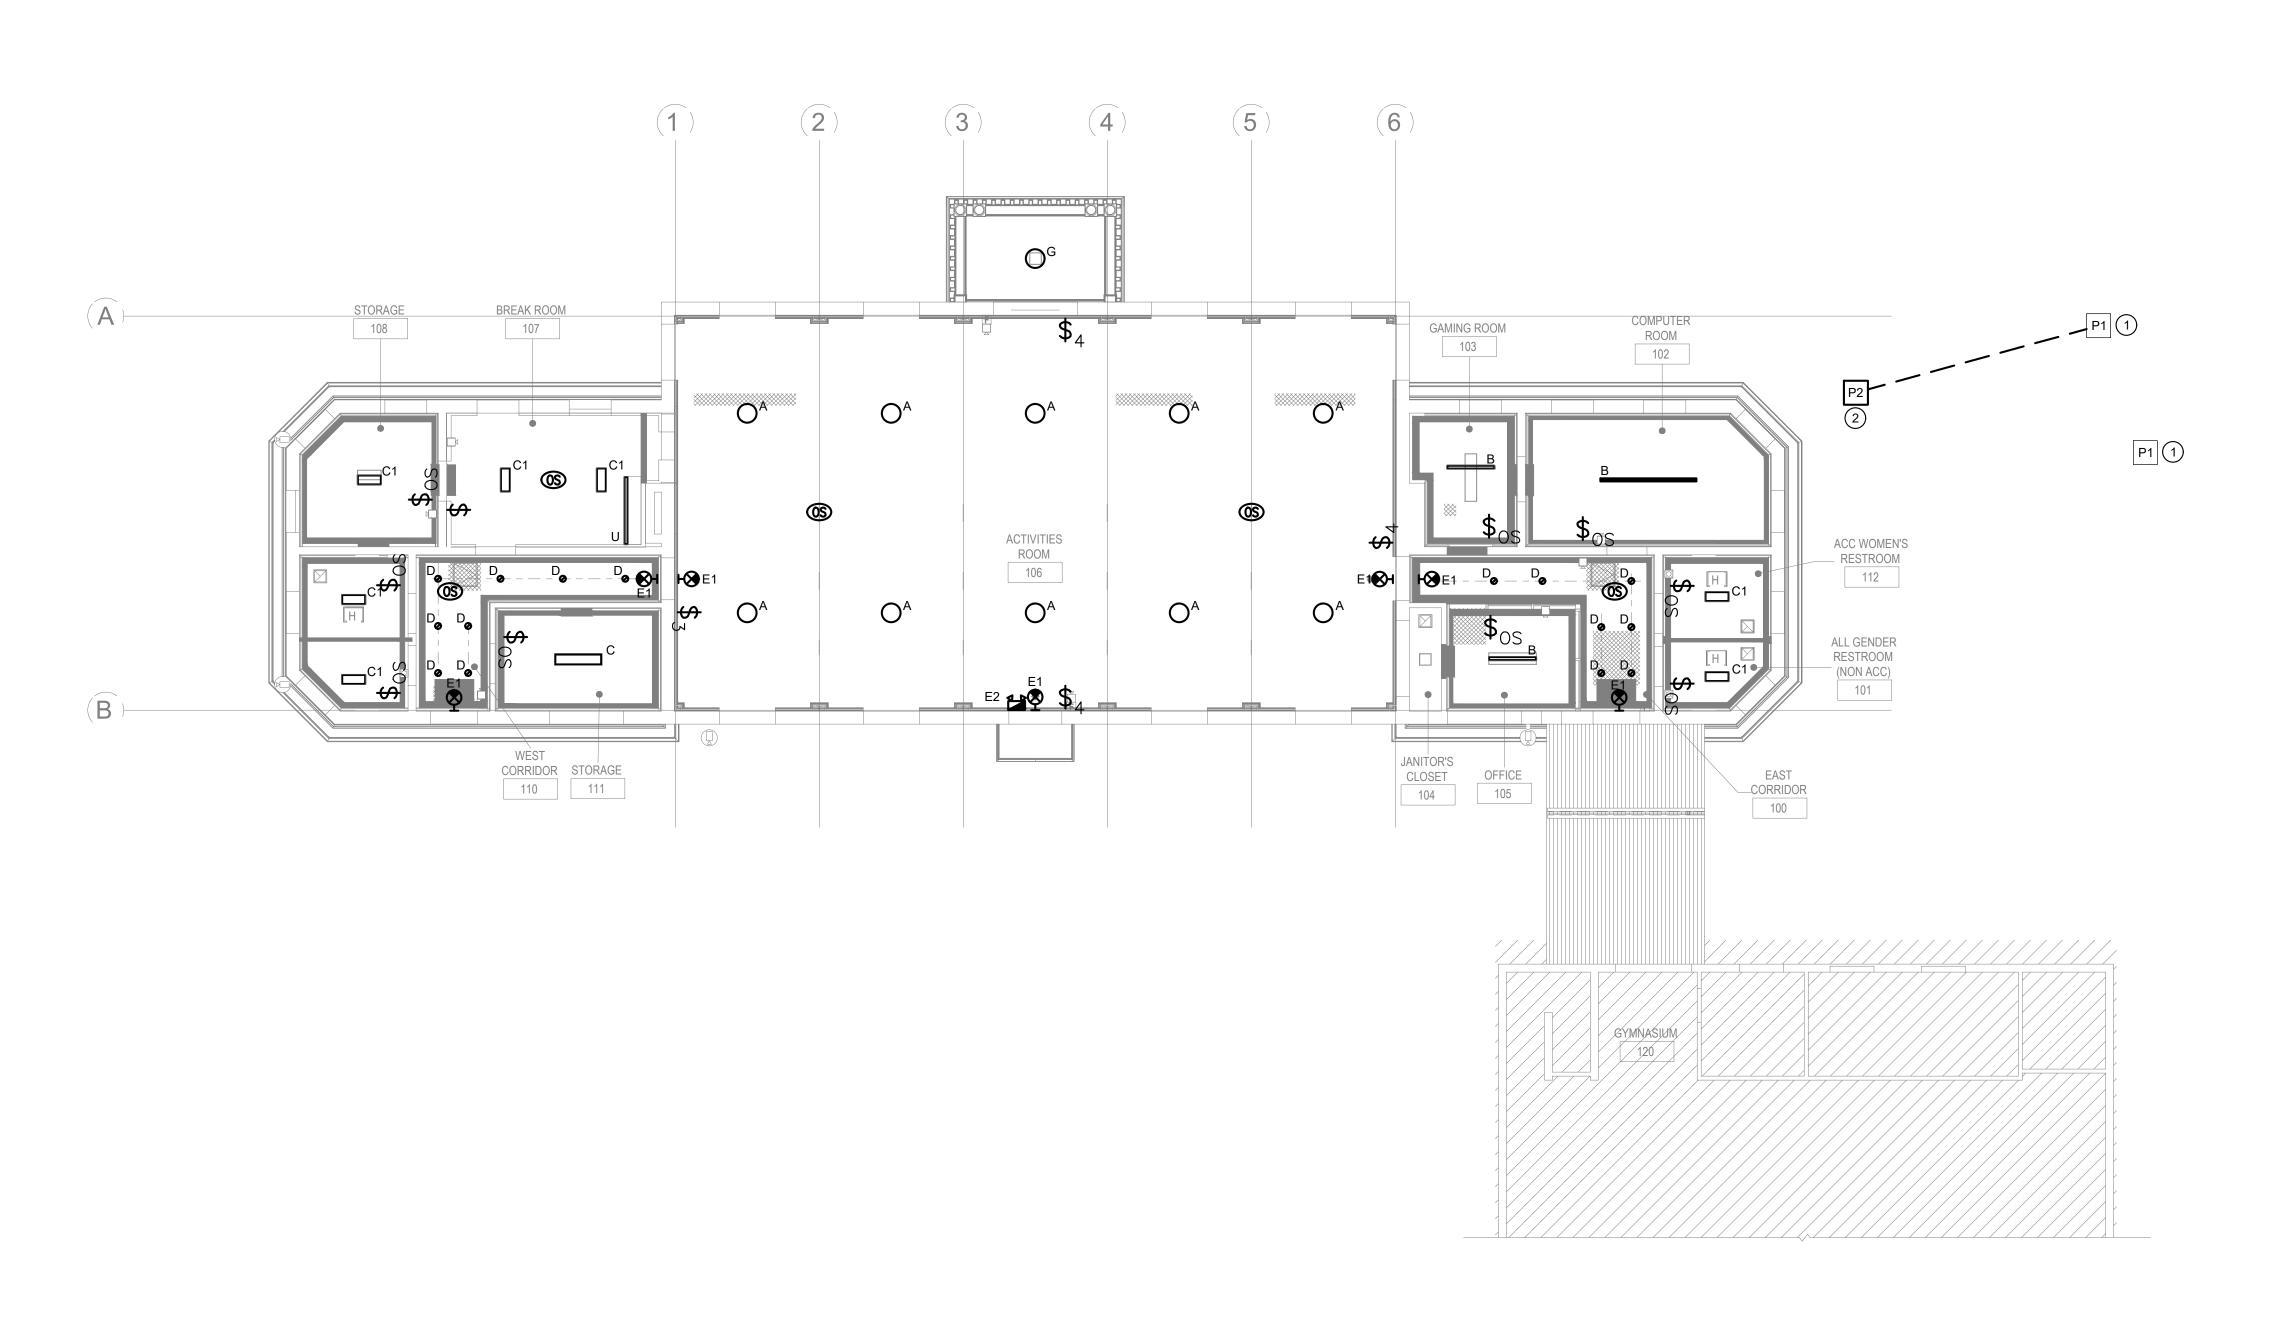


ELECTRICAL LIGHTING FIRST FLOOR PLAN

Scale: 1/8" = 1'-0"

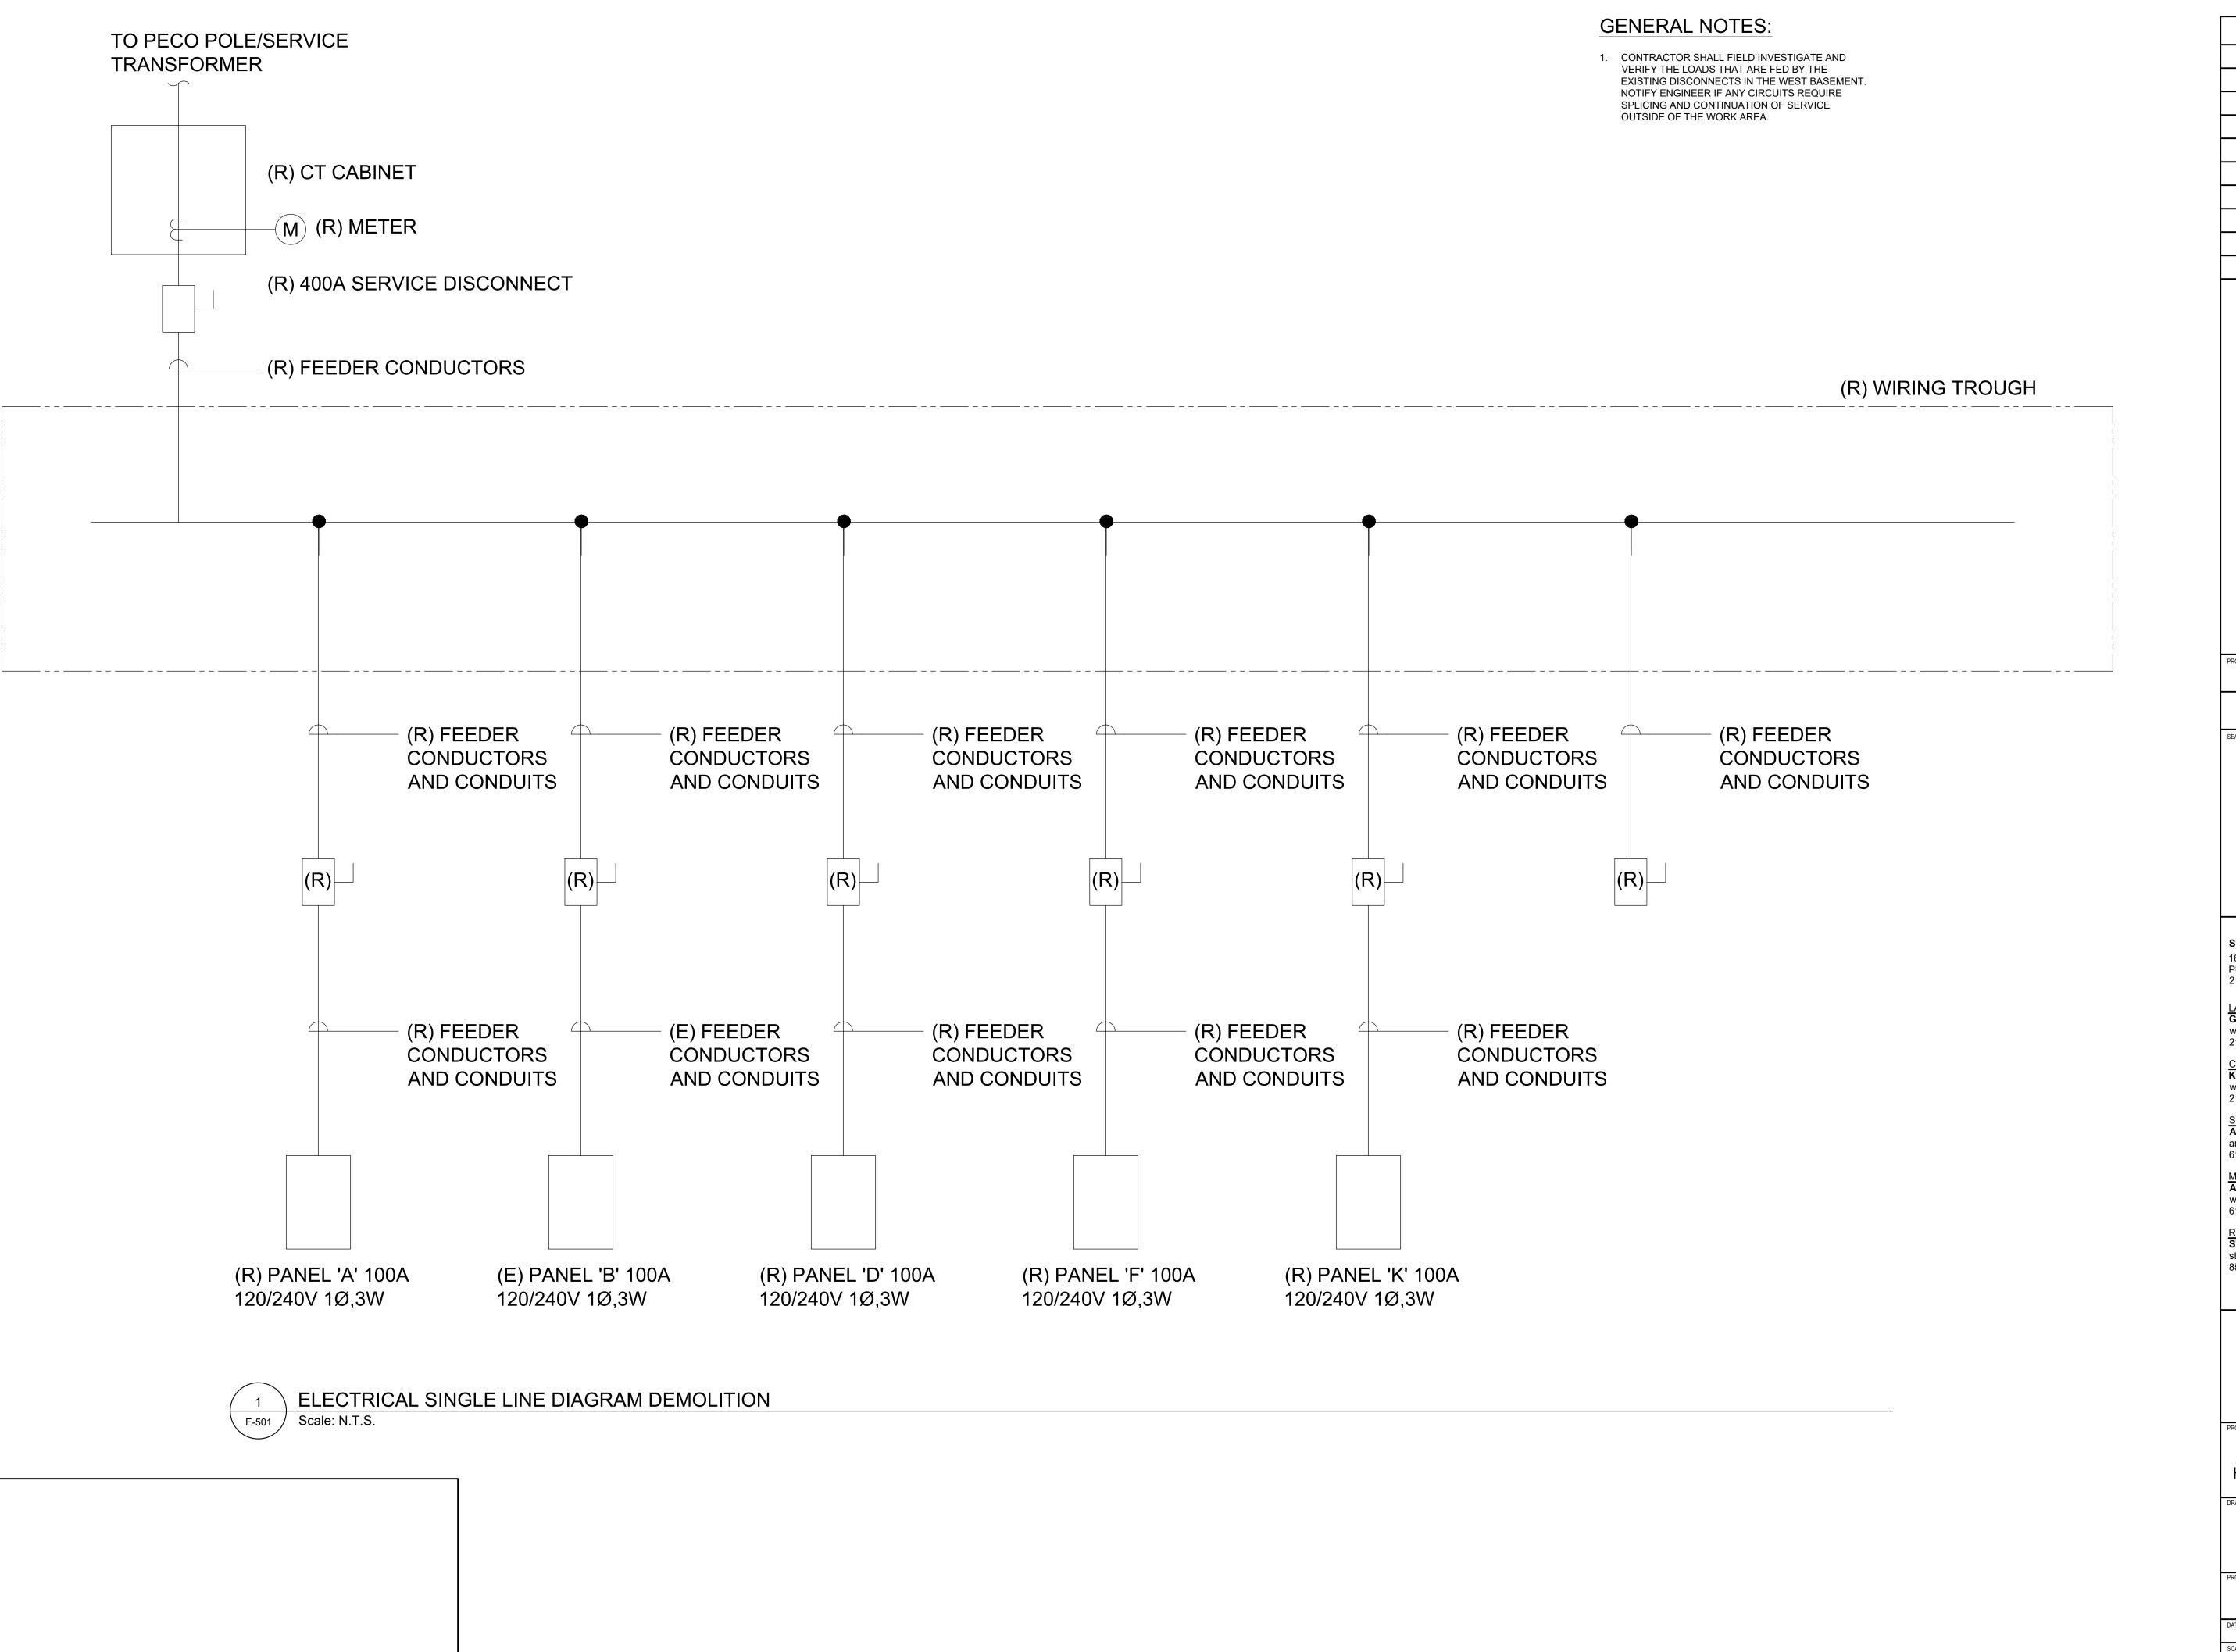

	REVI	SIO	NS		
ISSUE	DATE		REVISIONS		
CONSTRUCTION DOCUMENTS PROJECT COORDINATOR LEEANN SUEN					
REGISTERED PROFESSIONAL FARES AL JUHESHI ENGINEER PE095554					
Philadelphia 215 985 44 ² LANDSCAP GROUND R www.ground	t Street, 2nd F I, Pennsylvani I0 E ARCHITEC ECONSIDER dreconsidered	a 19103 <u>:T:</u> :ED			
215 790 072 CIVIL ENGI KS ENGINE www.kseng 215 925 042	NEER: ERS .com				
STRUCTURAL ENGINEER: ANN ROTHMANN STRUCTURAL ENGINEERING arstructural.com 610 688 2566					
MEP ENGINEER: ARORA ENGINEERS www.aroraengineers.com 610 459 7900 ROOFING CONSULTANT: STEPHEN McLAUGHLIN ROOFING CONSULTANT stevemclaughlin.biz 856 287 2424					
	RTMENT C)F PARI	NDELPHIA (S & RECREATION		
1515 ARCH STREET 11TH FLOOR, ONE PARKWAY BUILDING PHILADELPHIA PENNSYLVANIA PROJECT TITLE					
RENOVATIONS TO THE HAPPY HOLLOW RECREATION CENTER					
ELE		SINGLE EMOLIT			
	15E-03-0)2			
SCALE	/13/2025		E-501		
DRAWN BY TM	NOTED 1				
CHECKED BY PL			FILE:		
			HALL BE VERIFIED BY THE DCEEDING WITH THE WORK		

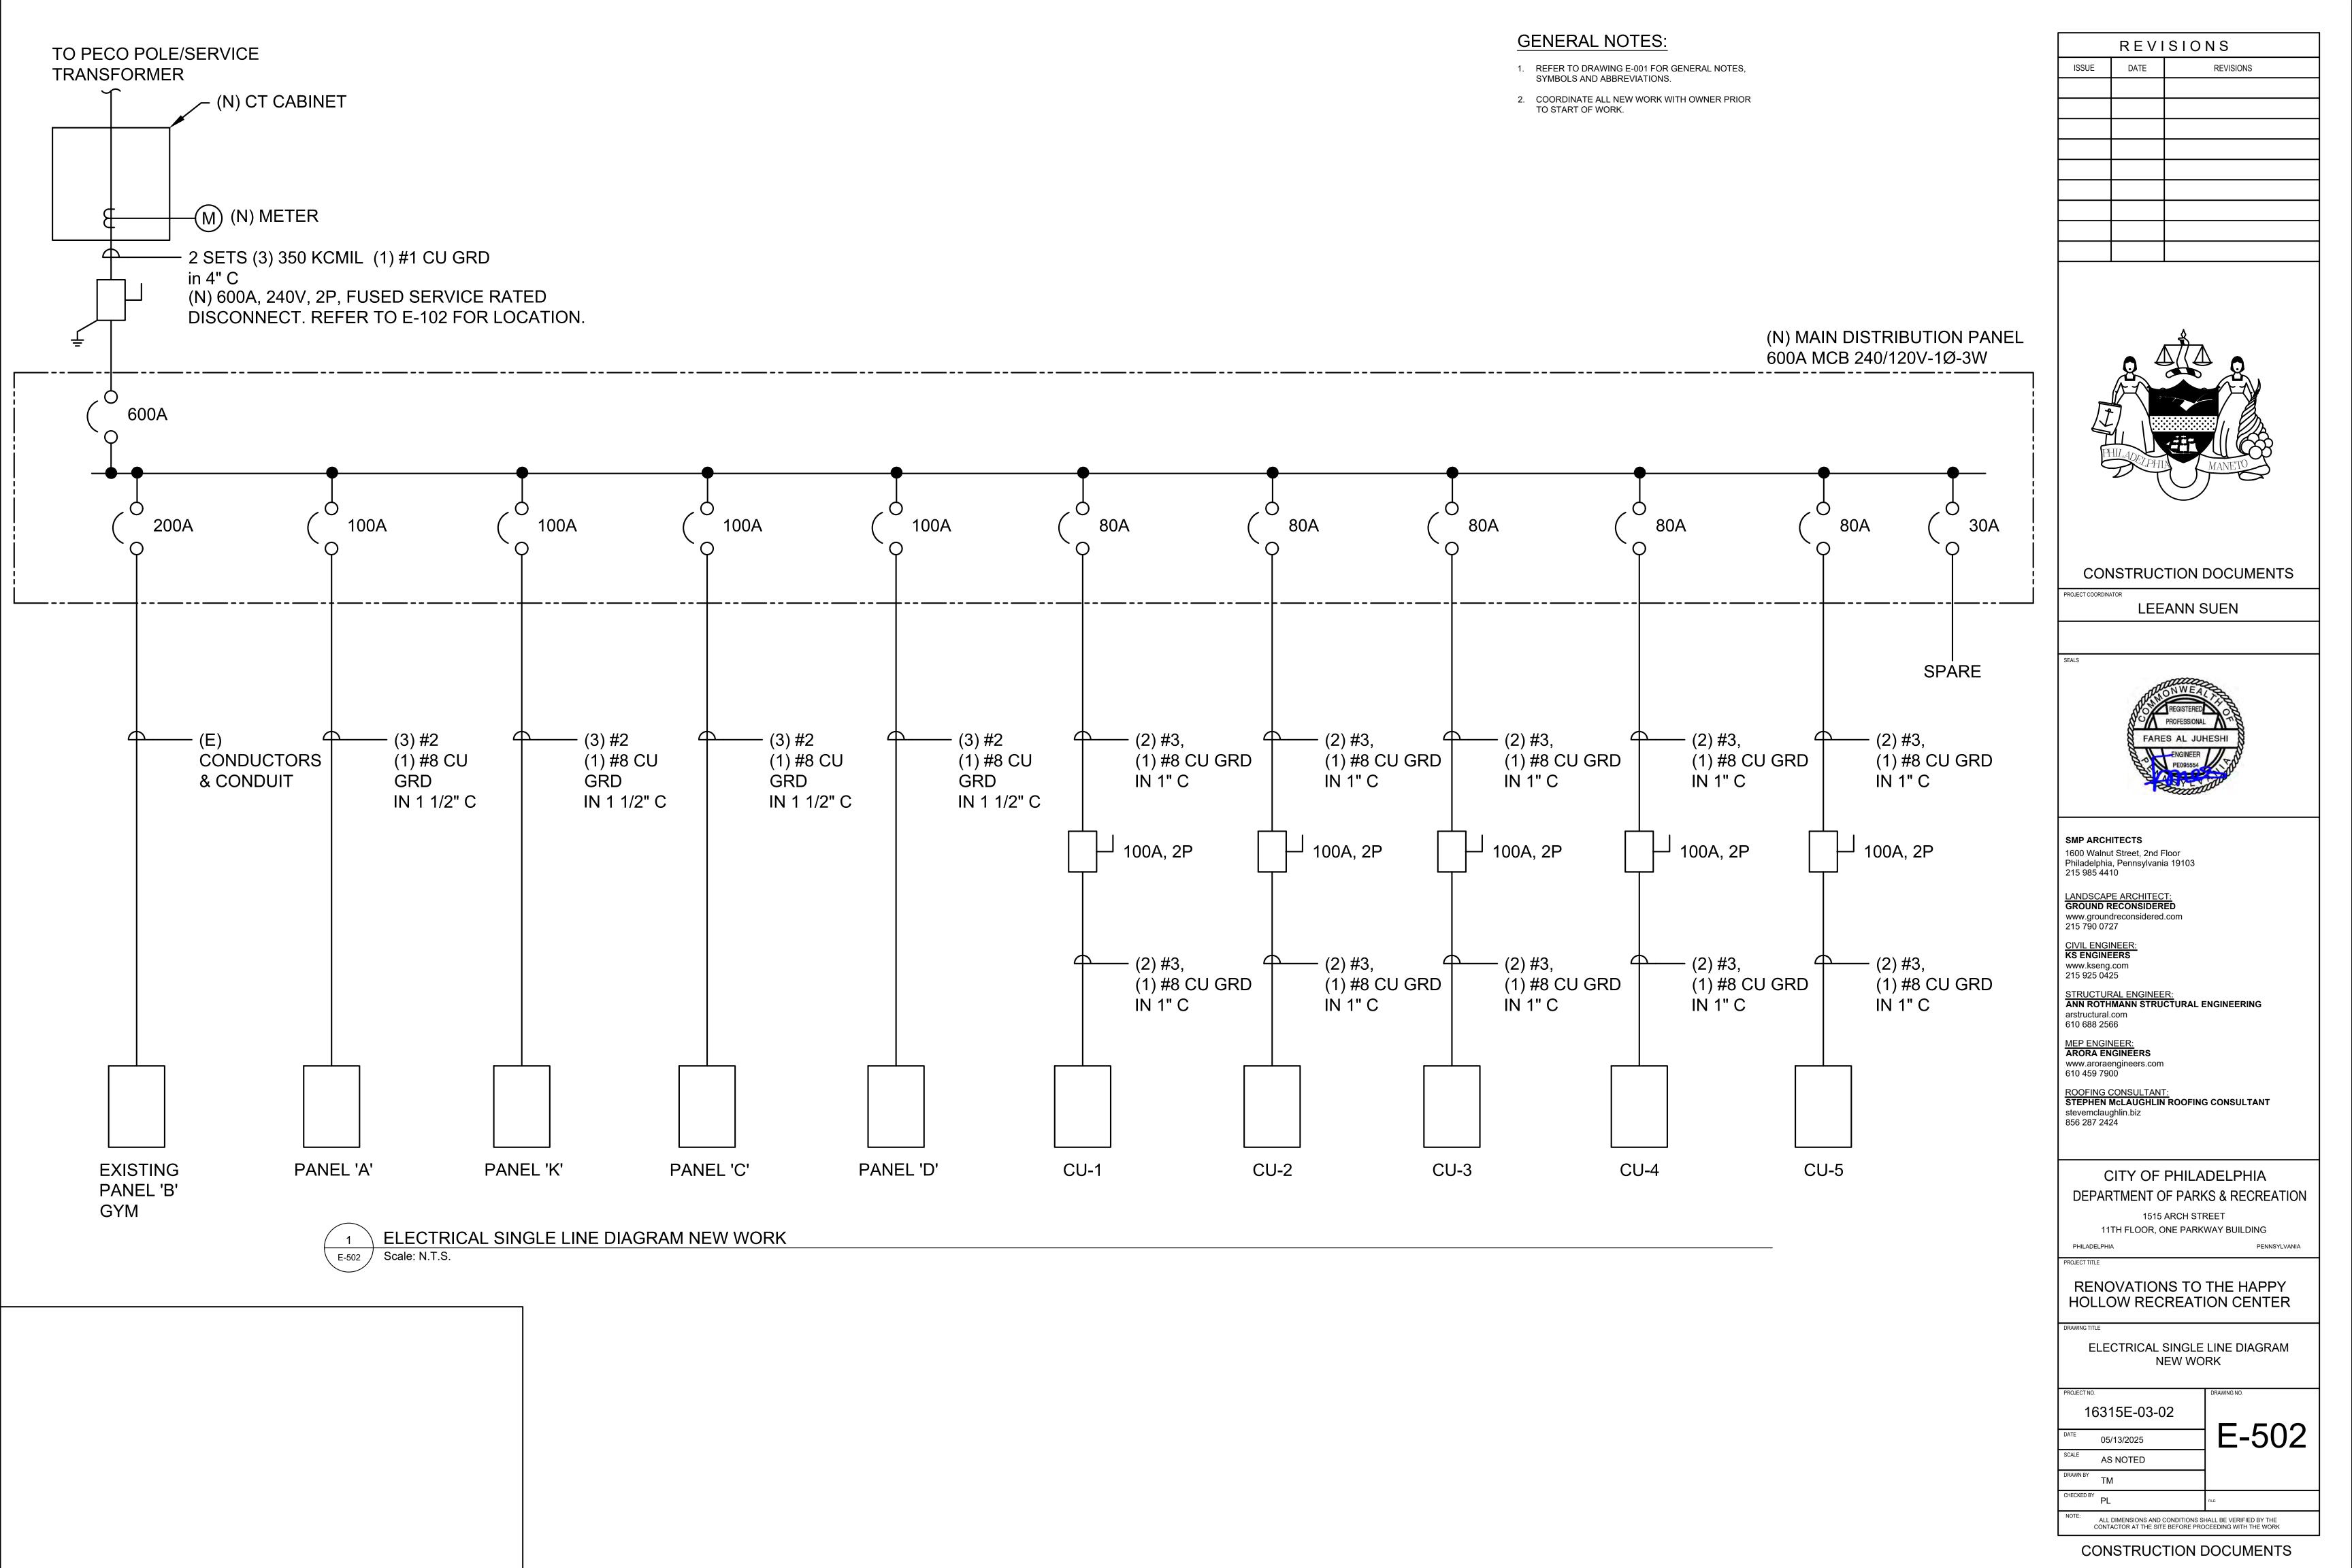

	LUMINAIRE SCHEDULE								
TYPE	TYPE DESCRIPTION MOUNTING		MANUFACTURER	CATALOG NO.	MANUFACTURER	CATALOG NO. (ALTERNATE)	BASIS OF DESIGN		
			(BASIS OF DESIGN)	(BASIS OF DESIGN)	(ALTERNATE)	,	TYPE	WATTS	VOLTS
А	22" INDUSTRIAL HIGH-BAY LUMINAIRE WITH MODERN LAMP TECHNOLOGY	PENDANT	LITHONIA LIGHTING	JCBL-9000LM-ACFR-MVOLT-GZ10 -35K-80CRI	-	-	LED 3500K 9000LM	63	120
AE	22" INDUSTRIAL HIGH-BAY LUMINAIRE WITH MODERN LAMP TECHNOLOGY WITH INTEGRAL EMERGENCY BATTERY PACK	PENDANT	LITHONIA LIGHTING	JCBL-9000LM-ACFR-MVOLT-GZ10 -35K-80CRI-E10WCP	-	-	LED 3500K 9000LM	63	120
В	OPEN CEILING LED SUSPENDED LINEAR (4 OR 8 FEET)	PENDANT	LITHONIA LIGHTING	LL8-6000LM-80CRI-35K-CPD-MIN10 -MVOLT	-	-	LED 3500K 6000LM	50	120
BE	OPEN CEILING LED SUSPENDED LINEAR WITH INTEGRAL EMERGENCY BATTERY PACK	SURFACE	LITHONIA LIGHTING	LL8-6000LM-80CRI-80K-CPD-MIN10 -MVOLT-1E10WCP	-	-	LED 3500K 6000LM	50	120
С	4' LOW-PROFILE CURVED-BASKET LED WRAPAROUND	SURFACE	LITHONIA LIGHTING	LBL4W-6500LM-80CRI-35K-MIN10- MVOLT	-	-	LED 3500K 6490LM	50.1	120
CE	4' LOW-PROFILE CURVED-BASKET LED WRAPAROUND WITH INTEGRAL EMERGENCY BATTERY PACK	SURFACE	LITHONIA LIGHTING	LBL4W-6500LM-80CRI-35K-MIN10- MVOLT-E10WLCP	-	-	LED 3500K 6490LM	50.1	120
C1	2' LOW-PROFILE CURVED-BASKET LED WRAPAROUND	SURFACE	LITHONIA LIGHTING	LBL2-2000LM-80CRI-35K-MIN10- MVOLT	-	-	LED 3500K 2014LM	16.9	120
C1E	2' LOW-PROFILE CURVED-BASKET LED WRAPAROUND WITH INTEGRAL EMERGENCY BATTERY PACK	SURFACE	LITHONIA LIGHTING	LBL2-2000LM-80CRI-35K-MIN10- MVOLT-EMG	-	-	LED 3500K 2014LM	16.9	120
D	COMPACT CEILING MOUNTED DOWNLIGHT WITH ASYMMETRIC DISTIBUTION	WALL	BEGA	B19538	-	-	LED 3500K 766LM	12	120
E1	EXIT SIGN - GREEN	CEILING / WALL	LITHONIA LIGHTING	EXRG EL M6	-	-	LED	5	120
E2	EXTERIOR LED EMERGENCY LIGHT WITH INTEGRAL EMERGENCY BATTERY PACK	WALL	LITHONIA LIGHTING	WDGE3 LED-P1-30K-80CRI-MVOLT- E20WC	-	-	LED 5500K	10	120
F	VAPOR TIGHT LED STRIP LIGHT	PENDANT	LITHONIA LIGHTING	CSVT-L48-3000LM-MVOLT-80CRI	-	-	LED 3500K 3033LM	24	120
G	EXTERIOR ROUND LIGHT	CEILING	LUMINIS	SN800-L1L23-35K-120	-	-	LED	29	120
U	UNDER CABINET LIGHT	UNDER CABINET	LITHONIA LIGHTING	UCES 36IN SWW6 90CRI WH M6	-	-	LED	16	120
P1	POLE LIGHT (FIXTURE ONLY)	POLE	SELUX	DSC4L-R5R-S2-5G530-40-BK	-	-	LED	47	120
P2	POLE LIGHT	POLE	SELUX	DSC4L-R5R-S2-5G530-40-BK	-	-	LED	47	120

DEVICIONO					
REVISIONS					
ISSUE	DATE	REVISIONS			



CONSTRUCTION DOCUMENTS

PROJECT COORDINATOR

LEEANN SUEN

SEALS



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CITY OF PHILADELPHIA DEPARTMENT OF PARKS & RECREATION

1515 ARCH STREET

11TH FLOOR, ONE PARKWAY BUILDING

PHILADELPHIA PENNSYLVANIA

PROJECT TITLE

RENOVATIONS TO THE HAPPY HOLLOW RECREATION CENTER

DRAWING TITLI

ELECTRICAL LUMINAIRE SCHEDULE

PROJECT NO. 16315E-03-02

E-601

O5/13/2025

SCALE AS NOTED

DRAWN BY TM

NOTE:

ALL DIMENSIONS AND CONDITIONS SHALL BE VERIFIED BY THE CONTACTOR AT THE SITE BEFORE PROCEEDING WITH THE WORK

			1)	۷)	PANI	EL S	CHEC	ULE	E ' /	۸'				
	PANEL: A FED FROM: MDP			INTERRUPTING RATING: 22 KAIC MOUNTING: SURFACE										
	VOLTAGE: 240/120V	PHASE:		1		WIRE: 3 BUS			S AMPS: 100A MAIN: 100 MLO					
	NEMA 1	NEUTRAL:	: 10	0%		COPPER GND BUS			LOCATION: STORAGE RM 111					
CIRCUIT	CIRCUIT DESCRIPTION	BRANCH CIRCUIT CONDUCTORS AND CONDUIT	POLES	BKR SIZE	VA	VA / F	PHASE B	VA	BKR SIZE	POLES	BRANCH CIRCUIT CONDUCTORS AND CONDUIT	CIRCUIT DESCRIPTION	CIRCUIT	
1	ELECTRICAL WATER COOLER	2#12, 1#12G IN 3/4"C	1	20	500	600		100					2	
3	EXHAUST FAN EF-4 & EF-5	2#12, 1#12G IN 3/4"C		20	80		180	100	20	2	2#12, 1#12G IN 3/4"C	DS-13,DS14, DS-15,DS-16	4	
5	RCPT: STORAGE RM	2#12, 1#12G IN 3/4"C	1	20	180	1680		1500	20	1	2#12, 1#12G IN 3/4"C	ELECTRIC HEATER EH-4	6	
7	RCPT: WEST BASEMENT	2#12, 1#12G IN 3/4"C	1	20	360		460	100	20	1	2#12, 1#12G IN 3/4"C	MOTORIZED DAMPER	8	
9	ELECTRIC WATER HEATER	2#6, 1#10G IN 1"C	2#6 1#10C IN 1"C			7500	9000		1500	20	1	2#12, 1#12G IN 3/4"C	ELECTRIC HEATER EH-5	10
11	EWH-2		1	50	7500		7500	0	20	1	-	SPARE	12	
13	SPARE	-	1	20	0	0		0	20	1	-	SPARE	14	
15	SPARE	-	1	20	0		0	0	20	1	-	SPARE	16	
17	SPARE	-	1	20	0	0		0	20	1	-	SPARE	18	
19	SPARE	-	1	20	0		0	0	20	1	-	SPARE	20	
21	SPARE	-	1	20	0	0		0	20	1	-	SPARE	22	
23	SPARE	-	1	20	0		0	0	20	1	-	SPARE	24	
25	SPARE	-	1	20	0	0		0	20	1	-	SPARE	26	
27	SPARE	-	1	20	0		0	0	20	1	-	SPARE	28	
29	SPARE	-	1	20	0	0		0	20	1	-	SPARE	30	
31	SPARE	-	1	20	0		0	0	20	1	-	SPARE	32	
33	SPARE	-	1	20	0	0		0	20	1	-	SPARE	34	
35	SPARE	-	1	20	0		0	0	20	1	-	SPARE	36	
37	SPARE	-	1	20	0	0		0	20	1	-	SPARE	38	
39	SPARE	-	1	20	0		0	0	20	1	-	SPARE	40	
41	SPARE	-	1	20	0	0		0	20	1	-	SPARE	42	
	NOTES:					11280	8140 0 VA					80.92 AMPS		

			1)	۱)	PAN	EL S	CHEC	ULE	E 'C)'			
	PANEL: D FED FROM: MDP INTERRUPTIN			RUPTING	RATING:	22 KAIC	<u> </u>			MC	DUNTING: SURFACE		
	VOLTAGE: 240/120V	PHASE		1		V	/IRE: 3	BUS AN	MPS:	100/	A MAIN: 100 MLO		
	NEMA 1	NEUTRAL: 100%						BUS			LC	OCATION: STORAGE RM 111	
CIRCUIT	CIRCUIT DESCRIPTION	BRANCH CIRCUIT CONDUCTORS AND CONDUIT	POLES	BKR SIZE	VA	VA / F	PHASE B	VA	BKR SIZE	POLES	BRANCH CIRCUIT CONDUCTORS AND CONDUIT	CIRCUIT DESCRIPTION	CIRCUIT
1	DS-8, DS-9	2#12, 1#12G IN 3/4"C	2	20	100	200	200	100 100	20	2	2#12, 1#12G IN 3/4"C	DS-5, DS-6, DS-7	2
5	- DS-10, DS-11, DS-12	2#12, 1#12G IN 3/4"C	2	20	100	1000		900	20	1	2#12, 1#12G IN 3/4"C	RCPT: ACTIVITIES RM	6
7	RCPT: ACTIVITIES RM	2#12, 1#12G IN 3/4"C	1	20	100 720	720	100	0	20	1	-	SPARE SPARE	10
	SPARE	-	1	20	0		0	0	20	1	-	SPARE	12
	SPARE	-	1	20	0	0		0	20	1	-	SPARE	14
15		-	1	20	0		0	0	20	1		SPARE	16
17	SPARE	-	1	20	0	0		0	20	1	-	SPARE	18
19	SPARE	-	1	20	0		0	0	20	1	-	SPARE	20
21	SPARE	-	1	20	0	0		0	20	1	-	SPARE	22
23	SPARE	-	1	20	0		0	0	20	1	-	SPARE	24
25	SPARE	-	1	20	0	0		0	20	1	-	SPARE	26
27	SPARE	-	1	20	0		0	0	20	1	-	SPARE	28
29	SPARE	-	1	20	0	0		0	20	1	-	SPARE	30
31	SPARE	-	1	20	0		0	0	20	1	-	SPARE	32
33	SPARE	-	1	20	0	0		0	20	1	-	SPARE	34
35	SPARE	-	1	20	0		0	0	20	1	-	SPARE	36
37	SPARE	-	1	20	0	0		0	20	1	-	SPARE	38
39	SPARE	-	1	20	0		0	0	20	1	-	SPARE	40
41	SPARE	-	1	20	0	0		0	20	1	-	SPARE	42
	NOTES:					TOT 1920	ALS 300		•				
) VA					9.25 AMPS	

	PANEL: C	FED FROM: MDP	IN	TERF	RUPTING	RATING:	22 KAI				M	OUNTING: SURFACE	_
	VOLTAGE: 240/120V	PHASE		1			/IRE: 3	BUS AM	1PS:	100/		MAIN: 100 MLO	_
	NEMA 1	NEUTRAL		0%		COPF	PER GND	BUS			LOCATION: STORAGE RM 103		
CIRCUIT	CIRCUIT DESCRIPTION	BRANCH CIRCUIT CONDUCTORS AND CONDUIT	POLES	BKR SIZE	VA	VA / P	PHASE B	VA	BKR SIZE	POLES	BRANCH CIRCUIT CONDUCTORS AND CONDUIT	CIRCUIT DESCRIPTION	
1	RCPT: COMPUTER RM	2#12, 1#12G IN 3/4"C	1	20	1200	2100		900	20	1	2#12, 1#12G IN 3/4"C	RCPT: COMPUTER RM	T
3	ELECTRIC HEATER EH-1	2#12, 1#12G IN 3/4"C	1	20	1500		1600	100	00		0#40 4#400 IN 0/4#0	DC 4 DC 2 DC 2 DC 4	1
5	EXHAUST FAN EF-1	2#12, 1#12G IN 3/4"C	1	20	80	180		100	20	20 2	2#12, 1#12G IN 3/4"C	DS-1, DS-2, DS-3, DS-4	
7	EXHAUST FAN EH-2	2#12, 1#12G IN 3/4"C	1	20	1500		1580	80	20	1	2#12, 1#12G IN 3/4"C	EXHAUST FAN EF-2	
9	ELECTRIC HEATER EH-3	2#12, 1#12G IN 3/4"C	1	20	1500	1580		80	20	1	2#12, 1#12G IN 3/4"C	EXHAUST FAN EF-3	
11	CONDENSATE PMP RM 102,103	2#12, 1#12G IN 3/4"C	1	20	168		708	540	20	1	2#12, 1#12G IN 3/4"C	RCPT: STOR AND EAST CORR	
13	CONDENSATE PMP RM 100,105	2#12, 1#12G IN 3/4"C	1	20	168	528		360	20	1	2#12, 1#12G IN 3/4"C	RCPT: RESTROOMS	
15	RCPT: EAST BASEMENT	2#12, 1#12G IN 3/4"C	1	20	360		4860	4500	30		2#40_4#40C_INL2/4"C	ELECTRICAL WATER HEATER	
17	MOTORIZED DAMPER	2#12, 1#12G IN 3/4"C	1	20	100	4600		4500	30	2	2#10, 1#10G IN 3/4"C	EWH-1	
19	RCPT: COMPUTER RM	2#12, 1#12G IN 3/4"C	1	20	720		1080	360	20	1	2#12, 1#12G IN 3/4"C	RCPT: COMPUTER RM	
21	SPARE	-	1	20	0	0		0	20	1	2#12, 1#12G IN 1"C	SPRAYGROUND CONTROLS	
23	SPARE	-	1	20	0		0	0	20	1	-	SPARE	
25	SPARE	-	1	20	0	0		0	20	1	-	SPARE	
27	SPARE	-	1	20	0		0	0	20	1	-	SPARE	
29	SPARE	-	1	20	0	0		0	20	1	-	SPARE	
31	SPARE	-	1	20	0		0	0	20	1	-	SPARE	
33	SPARE	-	1	20	0	0		0	20	1	-	SPARE	
35	SPARE	-	1	20	0		0	0	20	1	-	SPARE	
37	SPARE	-	1	20	0	0		0	20	1	-	SPARE	
39	SPARE	-	1	20	0		0	0	20	1	-	SPARE	
41	SPARE	-	1	20	0	0		0	20	1	-	SPARE	

	PANEL: K	FED FROM: MDP	IN	TERI	RUPTING	OUNTING: SURFACE								
	VOLTAGE: 240/120V	PHASE		1		W	/IRE: 3	BUS AN	MPS:	100	A .	MAIN: 100 MLO		
	NEMA 1	NEUTRAL	: 10	0%		COPI	PER GND	BUS			L	LOCATION: STORAGE RM 108		
CIRCUIT	CIRCUIT DESCRIPTION	BRANCH CIRCUIT CONDUCTORS AND CONDUIT	POLES	BKR SIZE	VA	VA / F	PHASE B	VA	BKR SIZE	POLES	BRANCH CIRCUIT CONDUCTORS AND CONDUIT	CIRCUIT DESCRIPTION	CIRCUIT	
1	RCPT: KITCHEN	2#12, 1#12G IN 3/4"C	1	20	360	720		360	20	1	2#12, 1#12G IN 3/4"C	RCPT: KITCHEN	2	
3	MOTORIZED DAMPER	2#12, 1#12G IN 3/4"C	1	20	100		268	168	20	1	2#12, 1#12G IN 3/4"C	CONDENSATE PMP RM 107,108	4	
5	SPARE	-	1	20	0	0		0	20	1	-	SPARE	6	
7	SPARE	-	1	20	0		0	0	20	1	-	SPARE	8	
9	SPARE	-	1	20	0	0		0	20	1	-	SPARE	10	
11	SPARE	-	1	20	0		0	0	20	1	-	SPARE	12	
13	SPARE	-	1	20	0	0		0	20	1	-	SPARE	14	
15	SPARE	-	1	20	0		0	0	20	1	-	SPARE	16	
17	SPARE	-	1	20	0	0		0	20	1	-	SPARE	18	
19	SPARE	-	1	20	0		0	0	20	1	-	SPARE	20	
21	SPARE	-	1	20	0	0		0	20	1	-	SPARE	22	
23	SPARE	-	1	20	0		0	0	20	1	-	SPARE	24	
25	SPARE	-	1	20	0	0		0	20	1	-	SPARE	26	
27	SPARE	-	1	20	0		0	0	20	1	-	SPARE	28	
29	SPARE	-	1	20	0	0		0	20	1	-	SPARE	30	
31	SPARE	-	1	20	0		0	0	20	1	-	SPARE	32	
33	SPARE	-	1	20	0	0		0	20	1	-	SPARE	34	
35	SPARE	-	1	20	0		0	0	20	1	<u>-</u>	SPARE	36	
37	SPARE	-	1	20	0	0		0	20	1	<u>-</u>	SPARE	38	
39	SPARE	-	1	20	0		0	0	20	1	-	SPARE	40	
41	SPARE	-	1	20	0	0		0	20	1	-	SPARE	42	

	REVI	SIONS
ISSUE	DATE	REVISIONS



CONSTRUCTION DOCUMENTS

LEEANN SUEN



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www.groundreconsidered.com
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ANN ROTHMANN STRUCTURAL ENGINEERING arstructural.com 610 688 2566

MEP ENGINEER:
ARORA ENGINEERS
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610 459 7900

ROOFING CONSULTANT:
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856 287 2424

CITY OF PHILADELPHIA DEPARTMENT OF PARKS & RECREATION

1515 ARCH STREET

11TH FLOOR, ONE PARKWAY BUILDING PENNSYLVANIA

PHILADELPHIA

RENOVATIONS TO THE HAPPY HOLLOW RECREATION CENTER

ELECTRICAL PANELBOARD SCHEDULES


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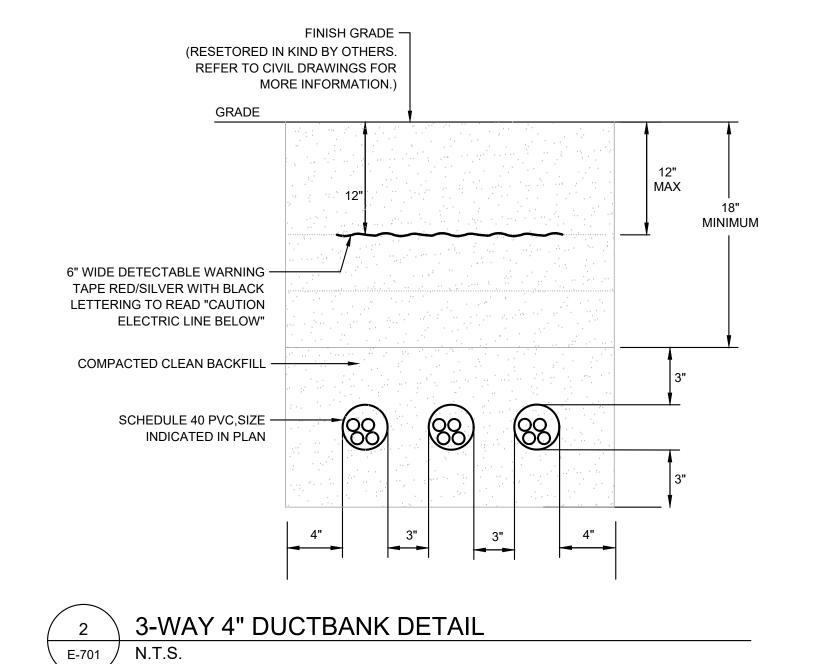
05/13/2025

E-602

AS NOTED DRAWN BY TM

ALL DIMENSIONS AND CONDITIONS SHALL BE VERIFIED BY THE CONTACTOR AT THE SITE BEFORE PROCEEDING WITH THE WORK



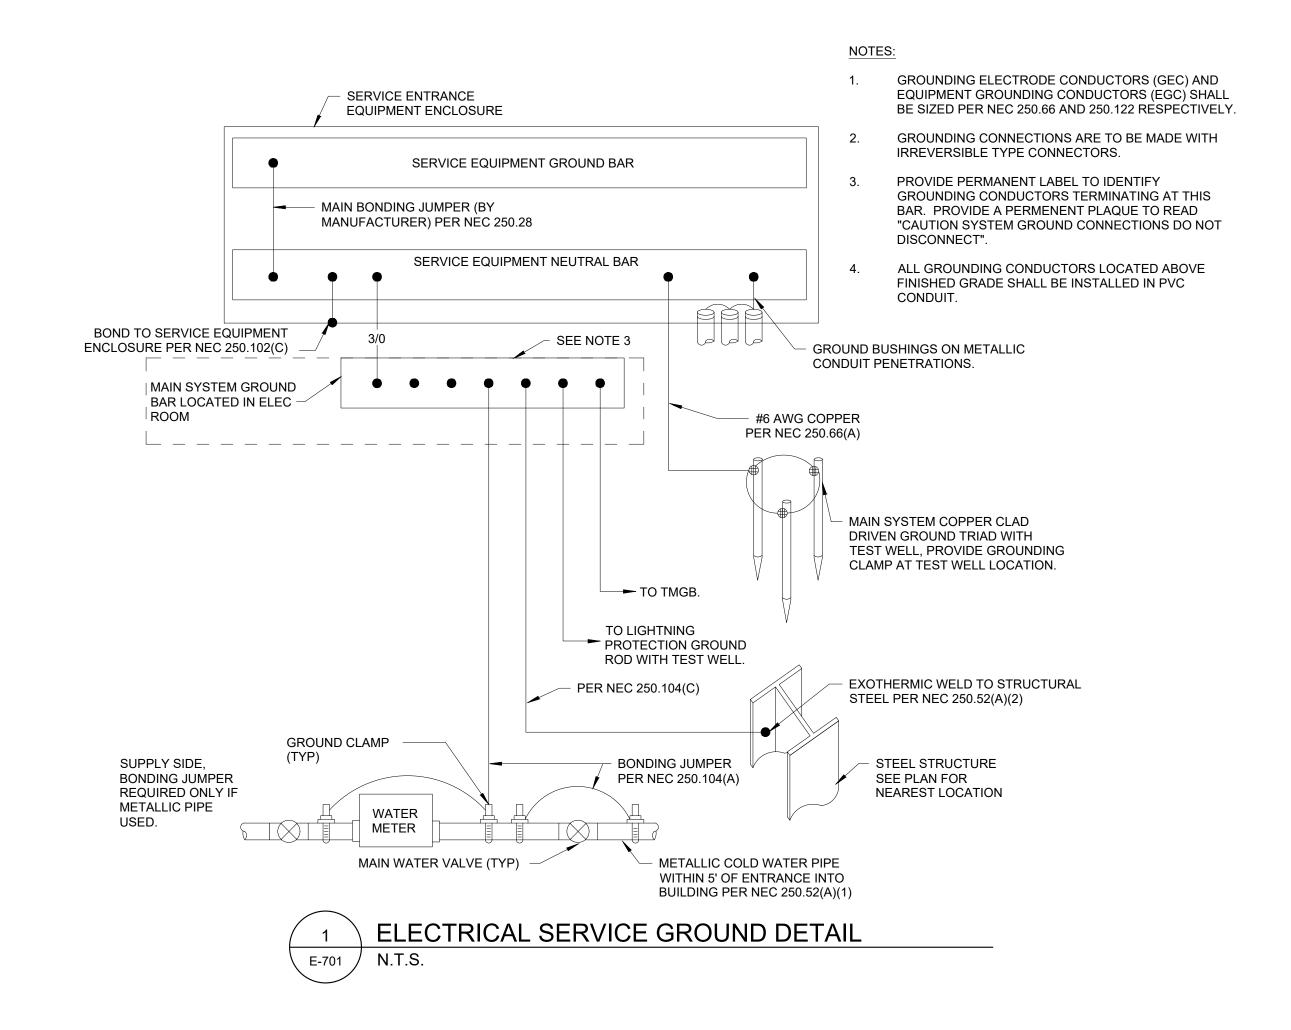

R E V I S I O N S
ISSUE DATE REVISIONS



CONSTRUCTION DOCUMENTS

PROJECT COORDINATOR

LEEANN SUEN

SEALS



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CITY OF PHILADELPHIA DEPARTMENT OF PARKS & RECREATION

1515 ARCH STREET

11TH FLOOR, ONE PARKWAY BUILDING

PHILADELPHIA PENNSYLVANIA

OJECT TITLE

RENOVATIONS TO THE HAPPY HOLLOW RECREATION CENTER

DRAWING TITLI

ELECTRICAL DETAILS

PROJECT N	О.	DRAWING NO.
1	6315E-03-02	— 7 04
DATE	05/13/2025	L-/ 01
SCALE	AS NOTED	
DRAWN BY	TM	
CHECKED B	Y PL	FILE:
NOTE:	ALL DIMENSIONS AND CONDITIONS SI CONTACTOR AT THE SITE BEFORE PRO	

- ALL SYMBOLS AND ABBREVIATIONS MAY NOT APPLY TO THIS PROJECT.
- CONTRACTOR SHALL COMPLY WITH ALL REGULATIONS AND LAWS OF AUTHORITIES HAVING JURISDICTION.
- CONTRACTOR SHALL VERIFY ALL EXISTING CONDITIONS AND NOTIFY THE ENGINEER AT ONCE OF ANY DISCREPANCIES.
- ALL PENETRATION THROUGH DESIGNATED FIRE RATED WALLS, CEILINGS AND FLOOR SLABS (WHICH ARE 2-HOUR RATED) SHALL BE PROPERLY SEALED WITH AN APPROVED RATED FIRE AND SMOKE STOPPING MATERIAL. ALL FIRE AND SMOKE STOPPING MATERIAL SHALL BE SUPPLIED AND WORK PERFORMED AS PER PROJECT SPECIFICATIONS. CONTRACTOR SHALL SUBMIT MANUFACTURER'S CATALOG DATA AND INSTALLATION DETAIL AS PER SPECIFICATIONS FOR FIRE AND SMOKE STOPPING TO THE ENGINEER FOR REVIEW AND APPROVAL PRIOR INSTALLATION.
- THE CONTRACTOR SHALL NOT BE ALLOWED ANY STORAGE AREA OTHER THAN THAT AVAILABLE WITHIN THE LIMITS OF THE STAGING AREA, CONFINES OF THE WORK AREA, OR AS DESIGNATED BY THE OWNER.
- ALL MATERIALS SHALL COMPLY WITH APPLICABLE CODES, ORDINANCES AND REGULATIONS.
- A COPY OF THE CURRENT SET OF CONTRACT DOCUMENTS (WITH AS-BUILT INFORMATION) SHALL BE KEPT AT THE JOB SITE AT ALL TIMES BY THE CONTRACTOR
- EACH CONTRACTOR SHALL REVIEW ALL PROJECT DOCUMENTS OF ALL TRADES FOR A THOROUGH UNDERSTANDING OF PROJECT AND ANY CROSS REFERENCING OF WORK. REVIEW ALL PROJECT REQUIREMENTS PRIOR TO BIDDING. IN CASE OF DISCREPANCIES, THE MOST STRINGENT SHALL GOVERN.
- THE CONTRACTOR SHALL GUARANTEE THE ENTIRE INSTALLATION FOR A PERIOD OF ONE YEAR (EXCEPT WHERE EXTENSIONS OF THIS ONE YEAR PERIOD ARE NOTED) FROM THE DATE OF ACCEPTANCE OF THE SYSTEM AS A WHOLE, ANY DEFECTS, IN WORKMANSHIP, MATERIALS, MALFUNCTION OF EQUIPMENT OR UNSATISFACTORY PERFORMANCE, AND ALL OTHER WORK OR PARTS OF THE BUILDING DAMAGED THEREBY, AS A RESULT OF THE WORK OF THE CONTRACTOR, SHALL BE THE RESPONSIBILITY OF THE CONTRACTOR. CONTRACTOR SHALL PAY ALL REPAIR COSTS ACCORDINGLY WITHOUT ADDITIONAL COSTS TO OWNER.
- IN ADDITION TO SPECIFICATIONS, AS MAY BE DEFINED HEREAFTER, THE CONTRACTOR SHALL PROTECT THE WORK SITE AND ALL HIS OR HER WORK AGAINST ANY DAMAGE (INCLUDING BUT NOT LIMITED TO WATER, DUST, HEAT, FREEZING, ETC.) UNTIL FINAL COMPLETION AND ACCEPTANCE BY THE OWNER.
- CONTRACTOR SHALL, UPON COMPLETION OF THE WORK, SUBMIT AS-BUILT RECORD DRAWINGS SHOWING ALL CHANGES FROM THE CONTRACT DRAWINGS MADE IN THE INSTALLATION, AND SHOWING DIMENSION LOCATIONS OF CONCEALED EQUIPMENT.
- PRIOR TO DELIVERY OF ANY MATERIALS TO THE SITE, THE CONTRACTOR SHALL PROVIDE MATERIAL SAFETY DATA SHEETS FOR ALL ITEMS AND MATERIALS USED IN THIS WORK.
- DRAWINGS ARE DIAGRAMMATIC AND INDICATE THE GENERAL CAPACITIES AND LOCATIONS OF EQUIPMENT TO BE REMOVED. CONTRACTOR SHALL BE RESPONSIBLE FOR VISITING THE SITE TO DETERMINE ACTUAL PHYSICAL SIZE, CAPACITIES, AND LOCATIONS OF EXISTING EQUIPMENT TO BE REMOVED.
- CONTRACTOR SHALL COORDINATE ALL REQUIRED EQUIPMENT AND SYSTEMS SHUTDOWN WITH OWNER, AND PROVIDE OWNER TWO WEEKS NOTICE OF THE SAME.
- COORDINATE DEMOLITION WORK WITH ALL OTHER TRADES. PHASE WORK IN CONJUNCTION WITH OTHER TRADE PHASING AND PHASING DRAWINGS.
- CONTRACTOR SHALL FIELD VERIFY OTHER EQUIPMENT/UTILITIES NOT ASSOCIATED WITH THIS WORK BUT LYING WITHIN THE WORK AREA, AND WILL NOT DISTURB THOSE EQUIPMENT/UTILITIES. THOSE EQUIPMENT/UTILITIES SHALL BE PROTECTED SO THAT THE SERVICE IS NOT INTERRUPTED. CONTRACTOR SHALL REPAIR ANY DAMAGE DONE TO THE EQUIPMENT/UTILITIES IN PERFORMANCE OF THE WORK.
- CONTRACTOR SHALL KEEP WORK AREA CLEAN, ORDERLY, AND WORKMAN LIKE, AND REMOVE ALL DEMOLISHED TRASH/ RUBBLE/CONSTRUCTION DEBRIS ON A DAILY BASIS FROM THE WORK AREA AND OFF OWNERS PROPERTY. ALL TRASH/RUBBLE/CONSTRUCTION DEBRIS DEEMED AS HAZARDOUS WASTE/MATERIAL SHALL BE DISPOSED OF IN ACCORDANCE WITH EPA OR ANY OTHER PERTINENT GOVERNING AGENCY AND DISPOSED OF ACCORDINGLY AT AN APPROVED HAZARDOUS WASTE DUMPSITE WITH ALL OF THE APPROVED/REQUIRED DOCUMENTATION.
- ALL EXISTING ABANDONED PIPING OR PIPING MADE ABANDONED BY THE WORK OF THIS PROJECT SHALL BE REMOVED FROM WITHIN THE PROJECT BOUNDARIES. CUT AND CAP PIPING BACK TO A POINT 6" BEYOND (OUTSIDE OF) THE PROJECT BOUNDARIES, UNLESS OTHERWISE NOTED ON THE DRAWINGS. PROVIDE CUTTING AND PATCHING OF ALL CEILINGS, FLOORS, AND WALLS AS REQUIRED.
- PRIOR TO ACCEPTANCE OF THE SPACE, ALL SYSTEMS SHALL BE TESTED, BALANCED, AND OPERATED TO DEMONSTRATE TO THE OWNER, OR HIS OR HER DESIGNATED REPRESENTATIVE. THAT THE INSTALLATION AND PERFORMANCE OF THESE SYSTEMS AND/OR PARTS THEREOF CONFORM TO THE DESIGN INTENT.
- JUNCTION BOXES OR ANY EQUIPMENT REQUIRING CEILING ACCESS SHALL ONLY BE PERMITTED/LOCATED IN ACCESSIBLE TYPE CEILING AREAS (I.E. LAY-IN TYPE CEILING) OR WHERE ACCESS PANELS HAVE BEEN LOCATED. REFER TO ARCHITECTURAL DRAWINGS.
- COORDIANTE WITH GENERAL CONTRACTOR FOR ITEMS SUCH AS ONE-CALL NOTIFICATIONS.

PLUMBING GENERAL NOTES:

- CONTRACTOR SHALL FURNISH ALL LABOR, MATERIALS, AND EQUIPMENT REQUIRED FOR THE COMPLETION AND OPERATION OF ALL SYSTEMS IN THIS SECTION OF WORK IN ACCORDANCE WITH ALL STATE AND LOCAL APPLICABLE CODES.
- CONTRACTOR SHALL FURNISH AND INSTALL A COMPLETE PIPING SYSTEM TO ALL FIXTURES AND/OR EQUIPMENT REQUIRING SUCH. VERIFY ALL ROUGH-IN LOCATIONS AND COORDINATE PIPING LOCATIONS WITH WORK UNDER OTHER DIVISIONS OF THE SPECIFICATIONS TO AVOID CONFLICTS.
- CONTRACTORS SHALL SECURE AND PAY FOR ALL PERMITS, INSPECTION CERTIFICATES, ETC. REQUIRED UNDER THE PROJECT SCOPE.
- CONTRACTOR SHALL FIELD VERIFY ALL EXISTING CONDITIONS AND DIMENSIONS PRIOR TO CONSTRUCTION AND NOTIFY ENGINEER OF RECORD OF ANY DISCREPANCIES BETWEEN THE PLANS AND EXISTING CONDITIONS AND/OR POTENTIAL PROBLEMS OBSERVED PRIOR TO CONTINUING WORK.
- DO NOT SCALE THE PLANS. SEE ARCHITECTURAL PLANS FOR EXACT LOCATION OF DOORS, WINDOWS, FIXTURES, WALL DIMENSIONS, ETC.
- CONTRACTOR SHALL GIVE SUITABLE NOTICE TO ALL APPLICABLE UTILITY COMPANIES AND OWNER PRIOR TO PERFORMING WORK INVOLVING UTILITIES.
- ALL EQUIPMENT SHALL BE HANDLED, STORED, AND PROTECTED TO PREVENT DAMAGE BEFORE AND DURING INSTALLATION IN ACCORDANCE WITH MANUFACTURER'S INSTRUCTIONS.
- ALL EQUIPMENT, ETC, SHALL BE SO LOCATED AND INSTALLED IN A READILY ACCESSIBLE LOCATION SO AS TO PERMIT ACCESS FOR SERVICE WITHOUT DAMAGE TO BUILDING OR FINISHED MATERIALS, PER MANUFACTURER'S INSTRUCTION AND APPLICABLE CODES.
- CONTRACTOR SHALL SUPPLY ACCESS DOORS FOR ACCESS TO EACH CONCEALED VALVE, PIECE OF EQUIPMENT, ETC. ACCESS DOORS SHALL BE HANDED OVER TO THE GC FOR INSTALLATION.
- 10. ALL MATERIAL SHALL BE NEW AND FIT THE SPACE AVAILABLE. VERIFY DIMENSIONS
- 11. ALL PIPING, APPARATUS, EQUIPMENT, ETC. SHALL BE PROPERLY SUPPORTED, BRACED VERTICALLY AND HORIZONTALLY IN ACCORDANCE WITH APPLICABLE CODES AND AS REQUIRED TO PREVENT EXCESSIVE MOVEMENT DURING SEISMIC CONDITIONS.
- 12. VALVES AND FITTINGS SHALL BE OF THE SAME SIZE AS THE PIPING FOR WHICH THEY ARE INSTALLED, UNLESS OTHERWISE NOTED.
- STERILIZE DOMESTIC WATER PIPING IN ACCORDANCE WITH HEALTH DEPARTMENT REGULATIONS.
- ALL SANITARY PIPING SHALL BE PITCHED IN ACCORDANCE WITH APPLICABLE CODE.
- WATER PIPING SHALL NOT BE RUN IN AREAS SUBJECT TO FREEZING TEMPERATURES UNLESS OTHERWISE NOTED. WATER PIPING IN EXTERIOR WALLS SHALL BE RUN ON THE SIDE OF THE WALL INSULATION THAT BORDERS THE
- PROVIDE DRAIN VALVES AT ALL LOW POINTS OF DOMESTIC WATER SYSTEMS FOR COMPLETE DRAINAGE AND INDICATE LOCATION OF SAME ON RECORD DRAWINGS
- PROVIDE VACUUM BREAKERS AND WATER HAMMER ARRESTORS AS REQUIRED BY CODE.
- CONTRACTOR SHALL VERIFY AND CORRECT SYSTEMS AS REQUIRED TO MEET ALL CODES AND REGULATIONS AND VERIFY AND CORRECT ANY AND ALL POSSIBLE DISCREPANCIES BETWEEN TYPE AND SIZE OF CONNECTIONS SPECIFIED IN THE EQUIPMENT SCHEDULES AND EQUIPMENT ACTUALLY INSTALLED.
- ALL PIPING SHALL BE ROUTED AS TO BE CONCEALED ABOVE CEILINGS, WITHIN WALLS, OR IN CHASES, EXCEPT FINAL CONNECTIONS TO FIXTURES, OR IN MECHANICAL ROOMS, UNLESS SPECIFICALLY NOTED OTHERWISE.
- CONTRACTOR SHALL VERIFY EXACT INVERT ELEVATIONS OF EXISTING PIPING TO WHICH NEW PIPING IS TO BE CONNECTED BEFORE INSTALLATION OF NEW PIPING.
- CONTRACTOR IS RESPONSIBLE FOR COORDINATING INSTALLATION OF ALL EQUIPMENT SHOWN ON PLANS, INCLUDING COORDINATION OF ANY EQUIPMENT OF ALTERNATIVE MANUFACTURER. CONTRACTOR SHALL PROVIDE COMPOSITE DRAWINGS AS REQUIRED FOR INSTALLATION OF EQUIPMENT SHOWN ON PLAN FOR APPROVAL BY ENGINEER.
- CONTRACTOR SHALL BECOME FAMILIAR WITH ALL CONDITIONS AFFECTING THIS PROJECT AND COORDINATE WITH ALL OTHER DISCIPLINES.
- PROVIDE A SHUT OFF VALVE ON COLD, HOT AND HOT WATER RETURN PIPING

CONNECTION TO EACH PLUMBING FIXTURE AND PIPE BRANCHING FROM THE MAIN.

APPLICABLE CODES:

- 2018 PHILADELPHIA PLUMBING CODE.
- 2018 INTERNATIONAL BUILDING CODE (IBC)
- 2018 INTERNATIONAL ENERGY CONSERVATION CODE (IECC)

GENERAL DEMOLITION NOTES:

- ALL DEMOLITION WORK SHALL BE IN ACCORDANCE WITH LOCAL CODES AND
- ITEMS SHOWN DASHED AND BOLD SHALL BE DISCONNECTED AND REMOVED BY THE PLUMBING CONTRACTOR UNLESS OTHERWISE NOTED.
- PRIOR TO THE DEMOLITION OF PLUMBING ITEMS, INCLUDING BUT NOT LIMITED TO PIPE, FIXTURES, EQUIPMENT, ETC. PLUMBING CONTRACTOR SHALL FIELD VERIFY LOCATION OF EXISTING PLUMBING SYSTEMS.

ABBREVIATIONS:

- ABV ABOVE
- AFF ABOVE FINISHED FLOOR
- AHJ AUTHORITIES HAVING JURISDICTION
- AP ACCESS PANEL
- ASPE AMERICAN SOCIETY OF PLUMBING ENGINEERS

- BLW BELOW
- BOP BOTTOM OF PIPE

- CI CAST IRON
- CO CLEANOUT
- CONT CONTINUED

- DN DOWN
- **EQUIP EQUIPMENT**
- EWC ELECTRIC WATER COOLER
- EWH ELECTRIC WATER HEATER
- FD FLOOR DRAIN
- FU FIXTURE UNITS
- GAL GALLONS
- GWH GAS-FIRED HOT WATER HEATER
- HP HORSEPOWER
- HW DOMESTIC HOT WATER

- IN INCHES
- IPC INTERNATIONAL PLUMBING CODE

- IN INCH
- INV EL INVERT ELEVATION
- JAN JANITOR'S
- KW KILOWATTS LAV LAVATORY
- MC MECHANICAL CONTRACTOR
- MFR MANUFACTURER
- MOCP MAXIMUM OVERCURRENT PROTECTION

SIZE

ALL

BELOW GRADE

ABOVE GRADE

2" LESS

OVER 2"

ALL

MR MOP RECEPTOR

SERVICE

DOMESTIC WATER

SANITARY/STORM

SANITARY/STORM

VENT

VENT

SRAYGROUND EQUIPMENT

PIPING

(N) NEW

- AD AREA DRAIN ADA AMERICANS WITH DISABILITIES ACT
- AG AIR GAP

- BFP BACK FLOW PREVENTER
- BFF BELOW FINISHED FLOOR
- BTU BRITISH THERMAL UNIT(S)
- CD CONDENSATE DRAIN
- CL CENTERLINE CM CONSTRUCTION MANAGER
- CW DOMESTIC COLD WATER
- DFU DRAINAGE FIXTURE UNITS
- DIA DIAMETER
- (E) EXISTING
- EC ELECTIRCAL CONTRACTOR
- ET EXPANSION TANK
- FCO FLOOR CLEANOUT
- FLA FULL LOAD AMPS
- GB GAS BOOSTER SYSTEM
- GPM GALLONS PER MINUTE
- HB HOSE BIBB
- H&CW HOT AND COLD WATER
- HWR HOT WATER RETURN IBC INTERNATIONAL BUILDING CODE
- ID INSIDE DIAMETER IMC INTERNATIONAL MECHANICAL CODE
- INV EL INVERT ELEVATION
- KW KILOWATTS
- IEER INTEGRATED ENERGY EFFICIENCY RATIO
- IN WG INCHES WATER GAGE
- M METERS

- - NC NORMALLY CLOSED NIC NOT IN CONTRACT
 - NO NORMALLY OPEN (FAIL SAFE OPEN)
 - NPW NON-POTABLE WATER
 - NTS NOT TO SCALE OC ON CENTER
 - OD OUTSIDE DIAMETER P PUMP
 - PC PLUMBING CONTRACTOR
 - POC POINT OF CONNECTION
 - (R) REMOVE RAC RUN ABOVE CEILING
 - RBF RUN BELOW FLOOR RD ROOF DRAIN
 - RP RECIRCULATION PUMP RWL RAIN WATER LEADER S SANITARY STACK
 - SAN SANITARY SFU SUPPLY FIXTURE UNITS
 - SK SINK SP SUMP PUMP
 - SPECS SPECIFICATIONS STD STANDARD
 - TDH TOTAL DYNAMIC HEAD TMV THERMOSTATIC MIXING VALVE
 - TP AUTOMATIC TRAP PRIMER TSFU TOTAL SUPPLY FIXTURE UNITS

UON UNLESS OTHERWISE NOTED

- TYP TYPICAL UF UNDER FLOOR
- UR URINAL V VENT
- VOLTS/PHASE/HERTZ VB VACUUM BREAKER
- VS VENT STACK W WASTE
- W/ WITH W/O WITHOUT
- WC WATER CLOSET WCO WALL CLEANOUT

WHA WATER HAMMER ARRESTOR

PLUMBING SYMBOLS:

CAPPED PIPE

BACK FLOW PREVENTOR BALANCING VALVE WITH TEST PORTS —

→ BOTTOM CONNECTION

CHECK VALVE CLEAN OUT DIRECTION OF FLOW ── FLANGED CONNECTION

FLOW METER FLOOR DRAIN FLOOR CLEAN OUT

——— MANUAL AIR VENT PIPE TURNING UP —⇒ PIPE TURNING DOWN —→ PITCH → BALL VALVE

<u>Ψ</u> VACUUM BREAKER GAS SHUT-OFF

—
→
TOP CONNECTION

—⊢ UNION

GENERAL SYMBOLS:

DET # DWG #	DETAIL TAG
X—SECT # XXX DWG #	SECTION TAG
EQUIP TYF	E EQUIPMENT TAG
	POINT OF CONNECTION
4	POINT OF DISCONNECTION

PIPING LEGEND:

——— — DOMESTIC COLD WATER ————— DOMESTIC HOT WATER — – – DOMESTIC HOT WATER RETURN ----- SANITARY - - - - - VENT - - - - DEMOLITION (REFER TO TAG FOR PIPE TYPE)

PIPE SCHEDULE MATERIAL JOINTS REMARKS IN ACCORDANCE WITH PHILADELPHIA PLUMBING CODE SECTION 605 MATERIALS COPPER TYPE "L" HARD PRESS CONNECT JOINTS JOINTS AND CONNECTIONS IN ACCORDANCE WITH PHILADELPHIA PLUMBING CODE, SECTION 702, MATERIALS SERVICE WEIGHT CAST IRON LEAD AND OAKUM ELECTROMETRIC SLEEVE WITH STAINLESS SERVICE WEIGHT CAST IRON N ACCORDANCE WITH PHILADELPHIA PLUMBING CODE, SECTION 702 MATERIALS STEEL BANDS IN ACCORDANCE WITH PHILADELPHIA PLUMBING CODE, SECTION 702 MATERIALS PRESS CONNECT JOINTS DWV COPPER ELECTROMETRIC SLEEVE WITH STAINLESS N ACCORDANCE WITH PHILADELPHIA PLUMBING CODE, SECTION 702 MATERIALS SERVICE WEIGHT CAST IRON STEEL BANDS PVC SHALL BE USED FROM THE SPRAYGROUND MANIFOLD TO THE SPRAY SCHEDULE 80 PVC SOLVENT GROUND FEATURE. IN ACCORDANCE WITH PHILADELPHIA PLUMBING CODE, SECTION 605 MATERIALS, JOINTS AND CONNECTIONS

REVISIONS

REVISIONS

DATE

ISSUE

CONSTRUCTION DOCUMENTS

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CITY OF PHILADELPHIA

11TH FLOOR, ONE PARKWAY BUILDING

PENNSYLVANIA

STEPHEN McLAUGHLIN ROOFING CONSULTANT

DEPARTMENT OF PARKS & RECREATION 1515 ARCH STREET

RENOVATIONS TO THE HAPPY

PLUMBING GENERAL NOTES, SYMBOLS AND ABBREVIATIONS

HOLLOW RECREATION CENTER


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> ALL DIMENSIONS AND CONDITIONS SHALL BE VERIFIED BY THE CONTACTOR AT THE SITE BEFORE PROCEEDING WITH THE WORL


- REFER TO DRAWING P000 FOR PLUMBING GENERAL NOTES, SYMBOLS AND ABBREVIATIONS.
- 2. REFER TO DRAWING P400 FOR RISER DIAGRAMS

AREA NOT IN SCOPE

- 3. REFER TO DRAWING P500 AND P501 FOR PLUMBING DETAILS.
- 4. REFER TO DRAWING P600 FOR PLUMBING SCHEDULES.
- 5. REMOVE ALL ABANDONED ELECTRIC WATER HEATERS.



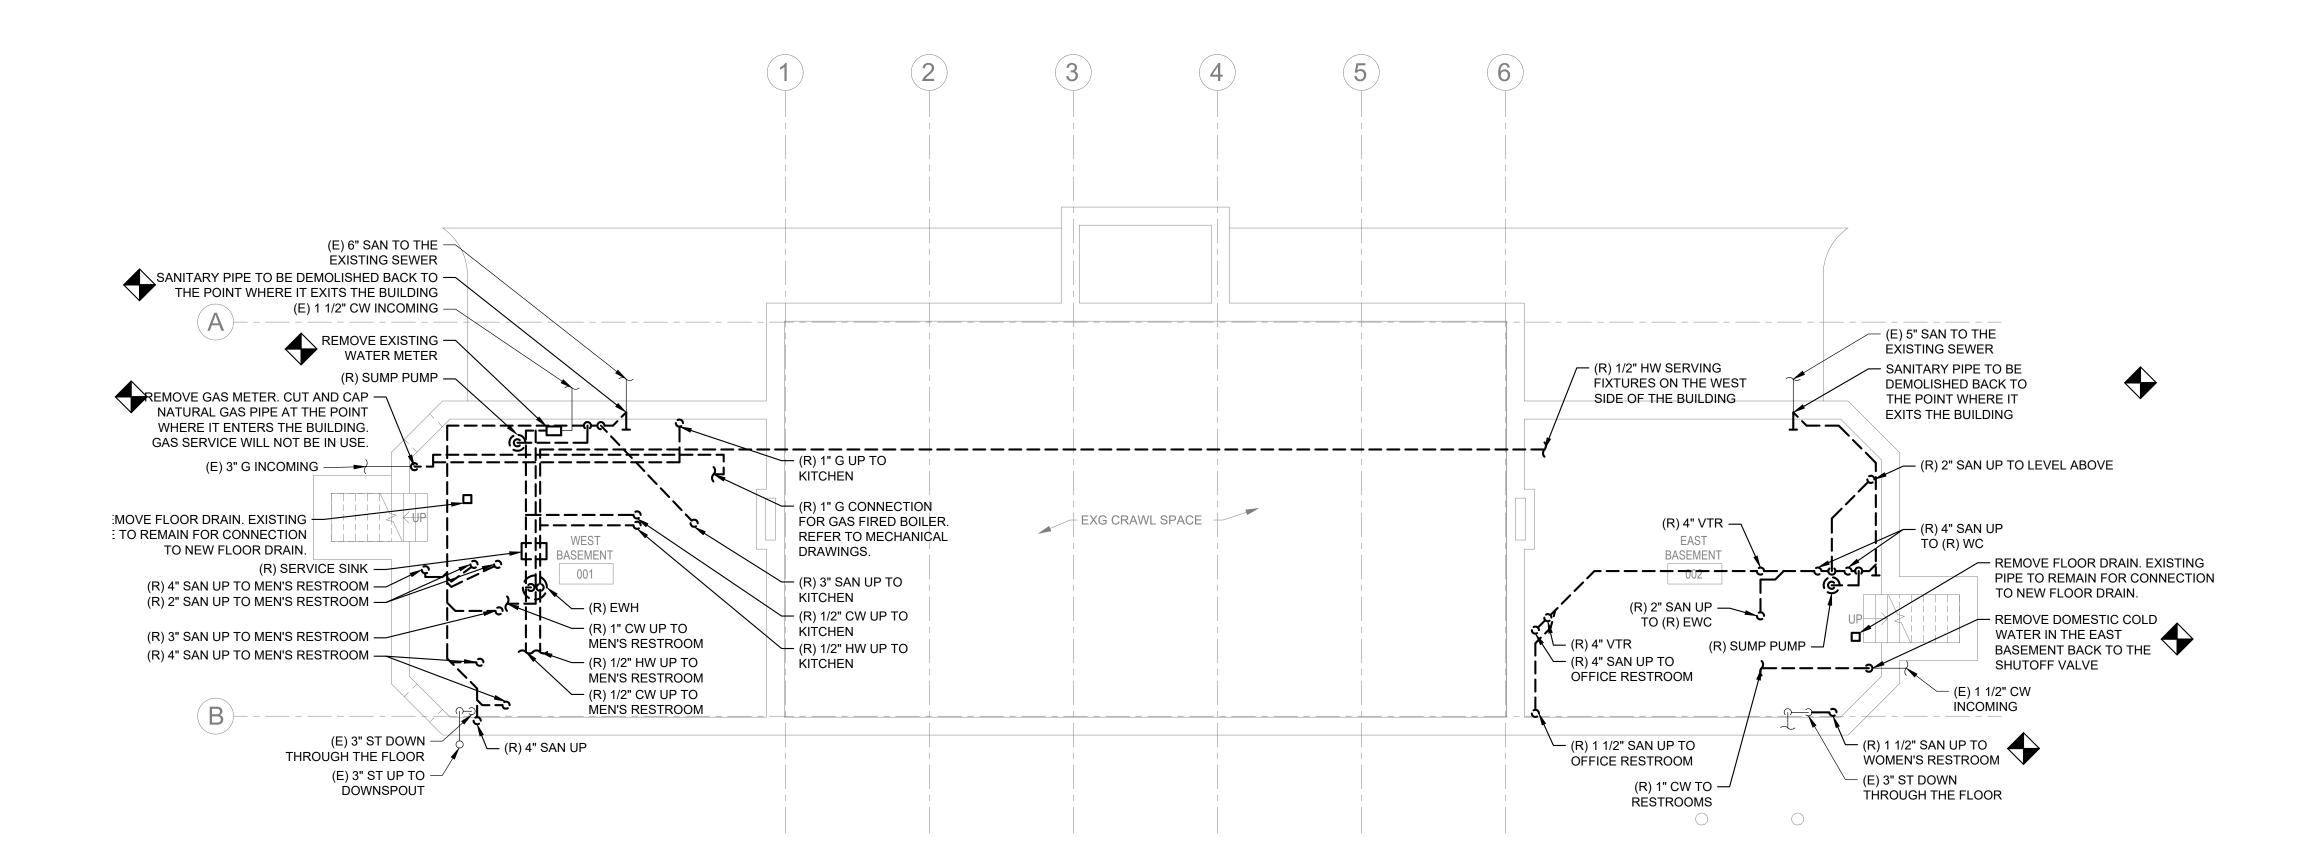

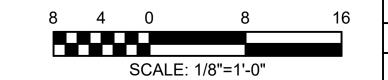

	REVI	SIONS
ISSUE	DATE	REVISIONS



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CITY OF PHILADELPHIA DEPARTMENT OF PARKS & RECREATION

1515 ARCH STREET

11TH FLOOR, ONE PARKWAY BUILDING
PHILADELPHIA PENNSYLVANIA

PROJECT TITLE

RENOVATIONS TO THE HAPPY HOLLOW RECREATION CENTER

DRAWING TITLE

PLUMBING DEMOLITION BASEMENT PLAN

DATE 05/13/2025

SCALE AS NOTED

DRAWN BY TM

CHECKED BY PL

DRAWN SOLUTION DRAWN BY TM

CHECKED BY PL

DRAWN BY TM

FILE:

CONSTRUCTION DOCUMENTS

STORAGE STORAGE COMPUTER ROOM ACTIVITIES ROOM 106 CORRIDOR 100 OFFICE RESTROOM_ RESTROOM 109 104 WOMEN'S _KESTROOM 101 (R) 4" V UP FROM ─ BASEMENT AREÁ NOT IN SCOPE

1 PLUMBING DEMOLITION FIRST FLOOR PLAN PD-102 Scale: 1/8" = 1'-0"

GENERAL NOTES:

- 1. REFER TO DRAWING P000 FOR PLUMBING GENERAL NOTES, SYMBOLS AND ABBREVIATIONS.
- 2. REFER TO DRAWING P400 FOR RISER DIAGRAMS
- 3. REFER TO DRAWING P500 AND P501 FOR PLUMBING DETAILS.
- 4. REFER TO DRAWING P600 FOR PLUMBING SCHEDULES.
- TEMPORARILY CAP PIPING TO FACILITATE FUTURE FIXTURES CONNECTIONS. REFER TO NEW WORK.

 3. DISCONNECT AND REMOVE EXISTING SERVICE SINK IN ITS ENTIRETY INCLUDING SUPPORTS, FAUCET, SANITARY PIPING, VENT PIPING, COLD WATER PIPING, HOT WATER PIPING, AND ACCESSORIES. TEMPORARILY CAP PIPING TO FACILITATE FUTURE FIXTURES CONNECTIONS. REFER TO NEW WORK.

 4. DISCONNECT AND REMOVE EXISTING URINAL IN ITS ENTIRETY INCLUDING SUPPORTS, FAUCET, SANITARY PIPING, VENT PIPING, COLD WATER PIPING, HOT WATER PIPING, AND ACCESSORIES. TEMPORARILY CAP PIPING TO FACILITATE FUTURE FIXTURES CONNECTIONS. REFER TO NEW WORK.

 5. DISCONNECT AND REMOVE EXISTING SHOWER IN ITS ENTIRETY INCLUDING SUPPORTS, FAUCET, SANITARY PIPING, VENT PIPING. COLD WATER PIPING. HOT

KEYED NOTES ():

1. DISCONNECT AND REMOVE EXISTING WATER CLOSET

CARRIER, SUPPORTS, AND ACCESSORIES.

IN ITS ENTIRETY INCLUDING SANITARY PIPING, VENT PIPING, COLD WATER PIPING, FLUSH VALVES, TANK,

TEMPORARILY CAP PIPING TO FACILITATE FUTURE FIXTURES CONNECTIONS. REFER TO NEW WORK.

2. DISCONNECT AND REMOVE EXISTING LAVATORY IN


ITS ENTIRETY INCLUDING SUPPORTS, FAUCET, SANITARY PIPING, VENT PIPING, COLD WATER PIPING,

HOT WATER PIPING, AND ACCESSORIES.

- 5. DISCONNECT AND REMOVE EXISTING SHOWER IN ITS ENTIRETY INCLUDING SUPPORTS, FAUCET, SANITARY PIPING, VENT PIPING, COLD WATER PIPING, HOT WATER PIPING, AND ACCESSORIES. TEMPORARILY CAP PIPING TO FACILITATE FUTURE FIXTURES CONNECTIONS. REFER TO NEW WORK.
- WATER HEATER IN ITS ENTIRETY INCLUDING SUPPORTS, COLD WATER PIPING, HOT WATER PIPING, AND ACCESSORIES. TEMPORARILY CAP PIPING TO FACILITATE FUTURE FIXTURES CONNECTIONS. REFER TO NEW WORK.

6. DISCONNECT AND REMOVE EXISTING DOMESTIC

- 7. DISCONNECT AND REMOVE EXISTING FLOOR DRAIN IN ITS ENTIRETY INCLUDING SANITARY PIPING AND VENT PIPING. TEMPORARILY CAP PIPING TO FACILITATE FUTURE FIXTURES CONNECTIONS. REFER TO NEW WORK.
- 8. DISCONNECT AND REMOVE EXISTING ELECTRIC WATER COOLER IN ITS ENTIRETY INCLUDING SUPPORTS, FAUCET, SANITARY PIPING, VENT PIPING, COLD WATER PIPING, AND ACCESSORIES.
 TEMPORARILY CAP PIPING TO FACILITATE FUTURE FIXTURES CONNECTIONS. REFER TO NEW WORK.
- 9. DISCONNECT AND REMOVE EXISTING INTEGRAL STAINLESS STEEL SINK IN ITS ENTIRETY INCLUDING SUPPORTS, FAUCET, SANITARY PIPING, VENT PIPING, COLD WATER PIPING, AND ACCESSORIES.
- 10. EXISTING 3" DOWNSPOUT TO REMAIN.
- REMOVE DETERIORATED CAST IRON DOWNSPOUT BOOT FOR REPLACEMENT IN NEW WORK.
- 12. VERIFY IN FIELD THE CONDITION OF THE CAST IRON DOWNSPOUT BOOT. IF DETERIORATED, RUSTED, OR DAMAGED, REMOVE DOWNSPOUT BOOT FOR REPLACEMENT IN NEW WORK.
- 13. DEMOLISH GAS PIPING CONNECTED TO EXISTING KITCHEN STOVE. STOVE TO BE REMOVED.

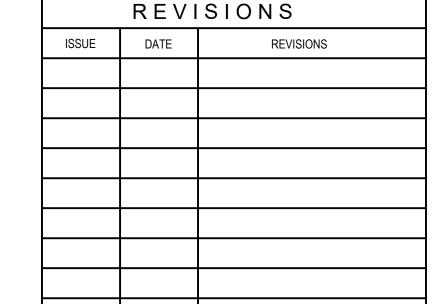



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CITY OF PHILADELPHIA
DEPARTMENT OF PARKS & RECREATION

1515 ARCH STREET

11TH FLOOR, ONE PARKWAY BUILDING
PHILADELPHIA PENNSYLVANIA

DJECT TITLE

RENOVATIONS TO THE HAPPY HOLLOW RECREATION CENTER

DRAWING TITLE


PLUMBING DEMOLITION FIRST FLOOR
PLAN

PROJECT NO	0.	DRAWING NO.
1	6315E-03-02	
DATE	05/13/2025	PD-102
SCALE	AS NOTED	
DRAWN BY	TM	
CHECKED B	Y PL	FILE:
NOTE:	ALL DIMENSIONS AND CONDITIONS S CONTACTOR AT THE SITE BEFORE PRO	


CONSTRUCTION DOCUMENTS

8 4 0 8 16 SCALE: 1/8"=1'-0"

- REFER TO DRAWING P000 FOR PLUMBING GENERAL NOTES, SYMBOLS AND ABBREVIATIONS.
- 2. REFER TO DRAWING P400 FOR RISER DIAGRAMS
- 3. REFER TO DRAWING P500 AND P501 FOR PLUMBING DETAILS.
- 4. REFER TO DRAWING P600 FOR PLUMBING SCHEDULES.

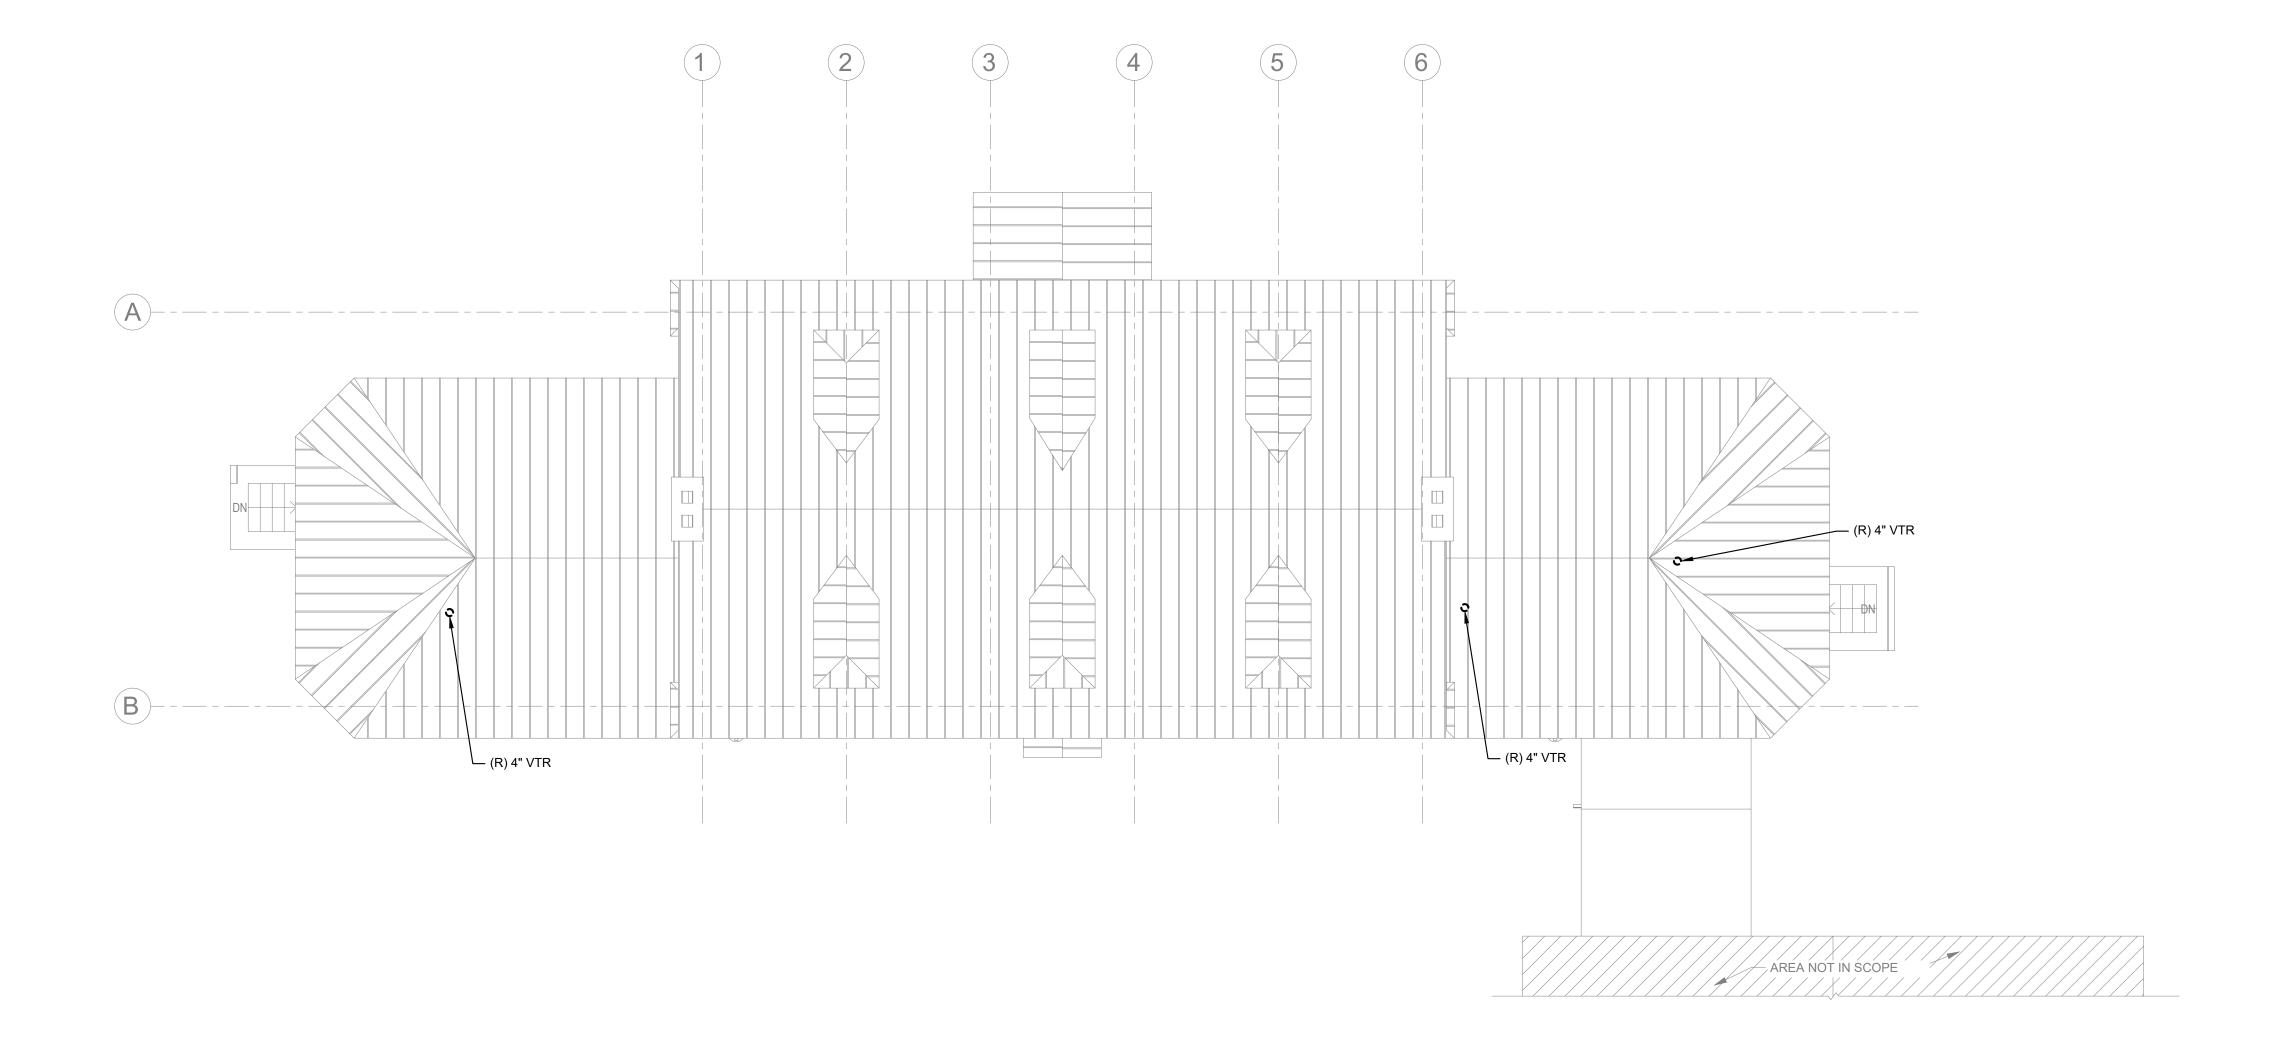



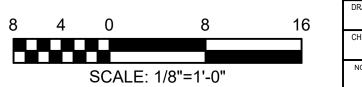

	REVI	SIONS
ISSUE	DATE	REVISIONS



CONSTRUCTION DOCUMENTS

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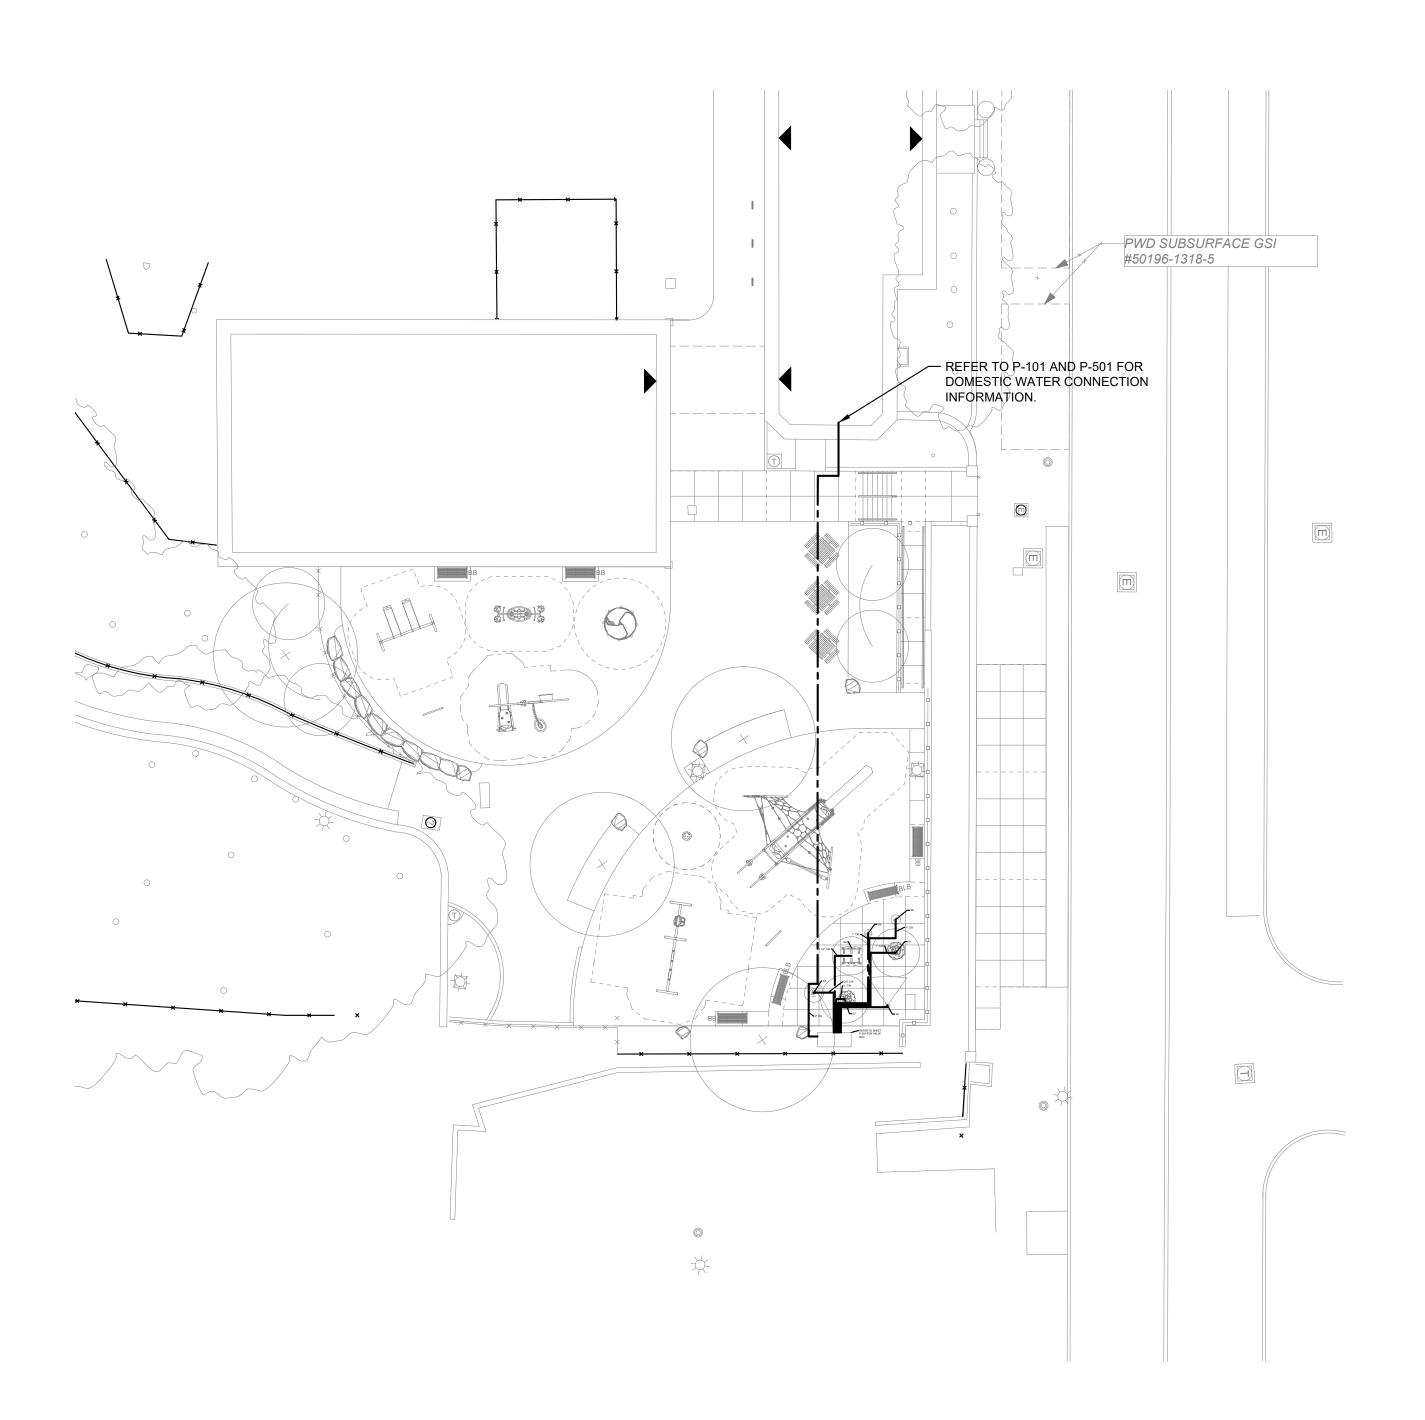
1515 ARCH STREET

11TH FLOOR, ONE PARKWAY BUILDING PHILADELPHIA PENNSYLVANIA

RENOVATIONS TO THE HAPPY HOLLOW RECREATION CENTER

PLUMBING DEMOLITION ROOF PLAN


16315E-03-02 05/13/2025 AS NOTED ALL DIMENSIONS AND CONDITIONS SHALL BE VERIFIED BY THE CONTACTOR AT THE SITE BEFORE PROCEEDING WITH THE WORK





1 PLUMBING SITE PLAN
P-100 Scale: 1" = 20'-0"

GENERAL NOTES:

- REFER TO DRAWING P000 FOR PLUMBING GENERAL NOTES, SYMBOLS AND ABBREVIATIONS.
- 2. REFER TO DRAWING P400 FOR RISER DIAGRAMS
- 3. REFER TO DRAWING P500 AND P501 FOR PLUMBING DETAILS.
- 4. REFER TO DRAWING P600 FOR PLUMBING SCHEDULES.

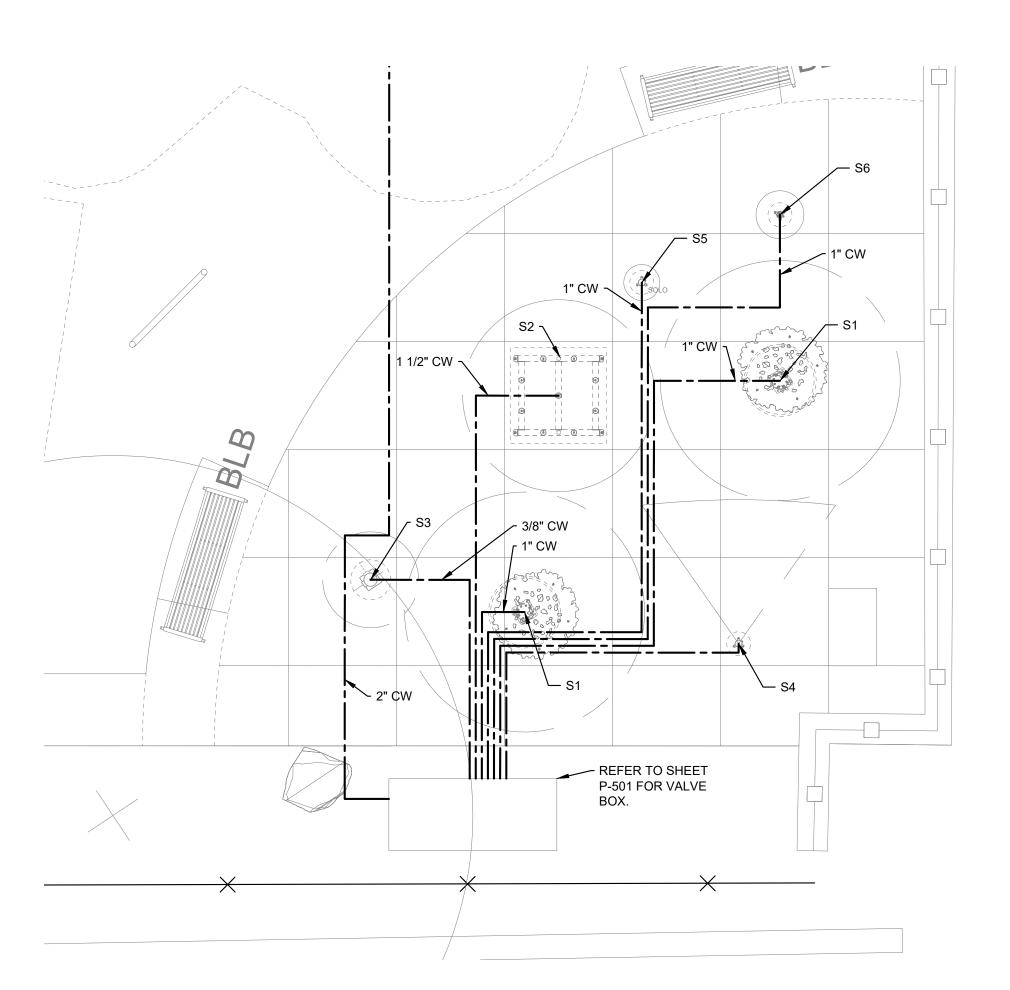

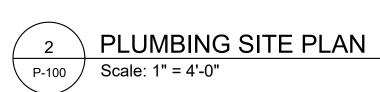

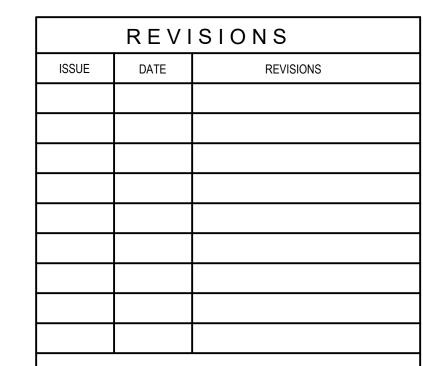



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CITY OF PHILADELPHIA DEPARTMENT OF PARKS & RECREATION

1515 ARCH STREET 11TH FLOOR, ONE PARKWAY B

11TH FLOOR, ONE PARKWAY BUILDING
PHILADELPHIA PENNSYLVANIA

PROJECT TITLE

RENOVATIONS TO THE HAPPY HOLLOW RECREATION CENTER


DRAWING TITLE

PLUMBING SITE PLAN

PROJECT NO.		DRAWING NO.
16	6315E-03-02	D 400
DATE	05/13/2025	P-100
SCALE	AS NOTED	
DRAWN BY	TM	
CHECKED BY	PL	FILE:
NOTE:	ALL DIMENSIONS AND CONDITIONS SECONTACTOR AT THE SITE BEFORE PRO	

(E) 6" SAN TO THE -EXISTING SEWER SANITARY PIPE (E) 1 1/2" CW INCOMING — (E) 5" SAN TO THE CONNECT TO EXISTING CW EXISTING SEWER — CONNECT TO EXISTING SANITARY PIPE - 2" CW INCOMING. REFER — 2" SAN UP TO EWC-1 TO CIVIL DRAWINGS FOR 4" SAN ---1/2" CW UP TO EWC-1 NEW CONNECTION. (E) 3" G INCOMING — → 1/2" CW UP TO LAV-1 — 2" SAN UP TO LAV-1 -– 2" CW TO └─ 2" SAN 1/2" HW UP TO LAV-1 — — 1/2" HW UP TO SK-1 — 2" SAN UP TO SK-1 (5) FD SPRAYGROUND. REFER − EXG CRAWL SPACE + 4" V UP -TO P-100 AND P-501. - 1/2" CW UP TO SK-1 CO 4" SAN — 3" SAN UP TO FD-2 1/2" HW UP TO MR-1 — 1/2" HW UP TO LAV-1 — 2" SAN UP TO LAV-1 — — 3" SAN UP TO FD-2 1/2" CW UP TO MR-1 -- 1" CW UP TO WC-2 1/2" CW UP TO LAV-1 — - 4" SAN UP TO WC-2 1" CW UP TO WC-2 -4" SAN UP TO WC-2 — 1" CW UP TO WC-1 3" SAN UP TO MR-1 -- 4" SAN UP TO WC-1 3" SAN UP TO FD-2 — 4" SAN UP TO WC-1 — 3" V UP — 2" V UF 3" SAN UP TO FD-1 — INCOMING — CONNECT TO \bigcirc EXISTING CW 1/2" CW UP TO LAV-1 — 1/2" HW UP TO LAV-1 — THROUGH THE FLOOR - 2" SAN UP TO LAV-1 2" SAN UP TO LAV-1 — (E) 3" ST UP TO — ─ 1/2" CW UP TO LAV-1 — (E) 3" ST DOWN THROUGH THE FLOOR

1 PLUMBING BASEMENT PLAN P-101 Scale: 1/8" = 1'-0"

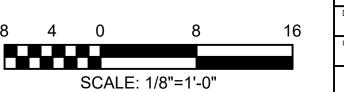

GENERAL NOTES:

AREA NOT IN SCOPE

- REFER TO DRAWING P000 FOR PLUMBING GENERAL NOTES, SYMBOLS AND ABBREVIATIONS.
- 2. REFER TO DRAWING P400 FOR RISER DIAGRAMS
- 3. REFER TO DRAWING P500 AND P501 FOR PLUMBING DETAILS.
- 4. REFER TO DRAWING P600 FOR PLUMBING SCHEDULES.

KEYED NOTES (1):

- 3, 1. PROVIDE NEW DOMESTIC WATER METER AND BACKFLOW PREVENTER, BFP-1.
- PROVIDE NEW SUMP PUMP IN EXISTING SUMP PIT. REFER TO ELECTRICAL DRAWINGS FOR RECEPTACLE LOCATION.
- 3. PROVIDE NEW ELECTRIC WATER HEATER. REFER TO ELECTRICAL DRAWINGS FOR
- 4. PROVIDE INDIRECT WASTE RECEPTOR FOR SUMP PUMP DRAINAGE.
- 5. INSTALL NEW FD-2 IN THE SAME LOCATION AS THE BASEMENT FLOOR DRAIN THAT WAS REMOVED DURING DEMOLITION. CONNECT TO EXISTING SANITARY PIPE BELOW BASEMENT FLOOR. EXISTING SANITARY LINE SHALL BE CLEANED.
- PROVIDE 1/2" CW TRAP PRIMER CONNECTION TO FLOOR DRAIN PIPING.
- PROVIDE NEW DOMESTIC WATER METER AND BACKFLOW PREVENTER, BFP-2.
- 8. PROVIDE 2" VENT FROM SUMP PUMP PIT.

	REVISIONS							
ISSUE	DATE	REVISIONS						



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CITY OF PHILADELPHIA DEPARTMENT OF PARKS & RECREATION

1515 ARCH STREET

11TH FLOOR, ONE PARKWAY BUILDING

PHILADELPHIA

PENNSYLVANIA

OJECT TITLE

RENOVATIONS TO THE HAPPY HOLLOW RECREATION CENTER

DRAWING TITLE

PLUMBING BASEMENT PLAN

PROJECT NO.

16315E-03-02

DATE 05/13/2025

SCALE AS NOTED

DRAWN BY TM


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NOTE: ALL DIMENSIONS AND CONDITIONS SHALL BE VERIFIED BY THE

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- 3. REFER TO DRAWING P500 AND P501 FOR PLUMBING DETAILS.
- 4. REFER TO DRAWING P600 FOR PLUMBING SCHEDULES.

KEYED NOTES (1):

- REFER TO ENLARGED PLANS FOR RESTROOM NEW WORK.
- PROVIDE NEW SANITARY PIPING, COLD WATER PIPING, AND HOT WATER PIPING TO NEW PANTRY SINK.
- 3. EXISTING 3" DOWNSPOUT TO REMAIN.
- PROVIDE NEW 3" CAST IRON DOWNSPOUT BOOT.
- IF THE EXISTING 3" CAST IRON DOWNSPOUT BOOT WAS FOUND TO BE IN POOR CONDITION AND REMOVED AS PART OF THE DEMOLITION, PROVIDE NEW 3" CAST IRON DOWNSPOUT BOOT.



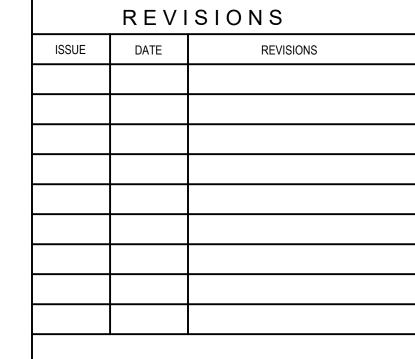

CONSTRUCTION DOCUMENTS

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CITY OF PHILADELPHIA
DEPARTMENT OF PARKS & RECREATION

1515 ARCH STREET

11TH FLOOR, ONE PARKWAY BUILDING

PHILADELPHIA

RENOVATIONS TO THE HAPPY HOLLOW RECREATION CENTER


PENNSYLVANIA

DRAWING TITLE


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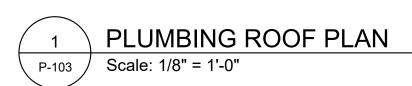
PLUMBING FIRST FLOOR PLAN


PROJECT NO.		DRAWING NO.
16	6315E-03-02	D 400
DATE	05/13/2025	P-102
SCALE	AS NOTED	
DRAWN BY	TM	
CHECKED BY	PL	FILE:
NOTE:	ALL DIMENSIONS AND CONDITIONS SI	HALL BE VERIFIED BY THE

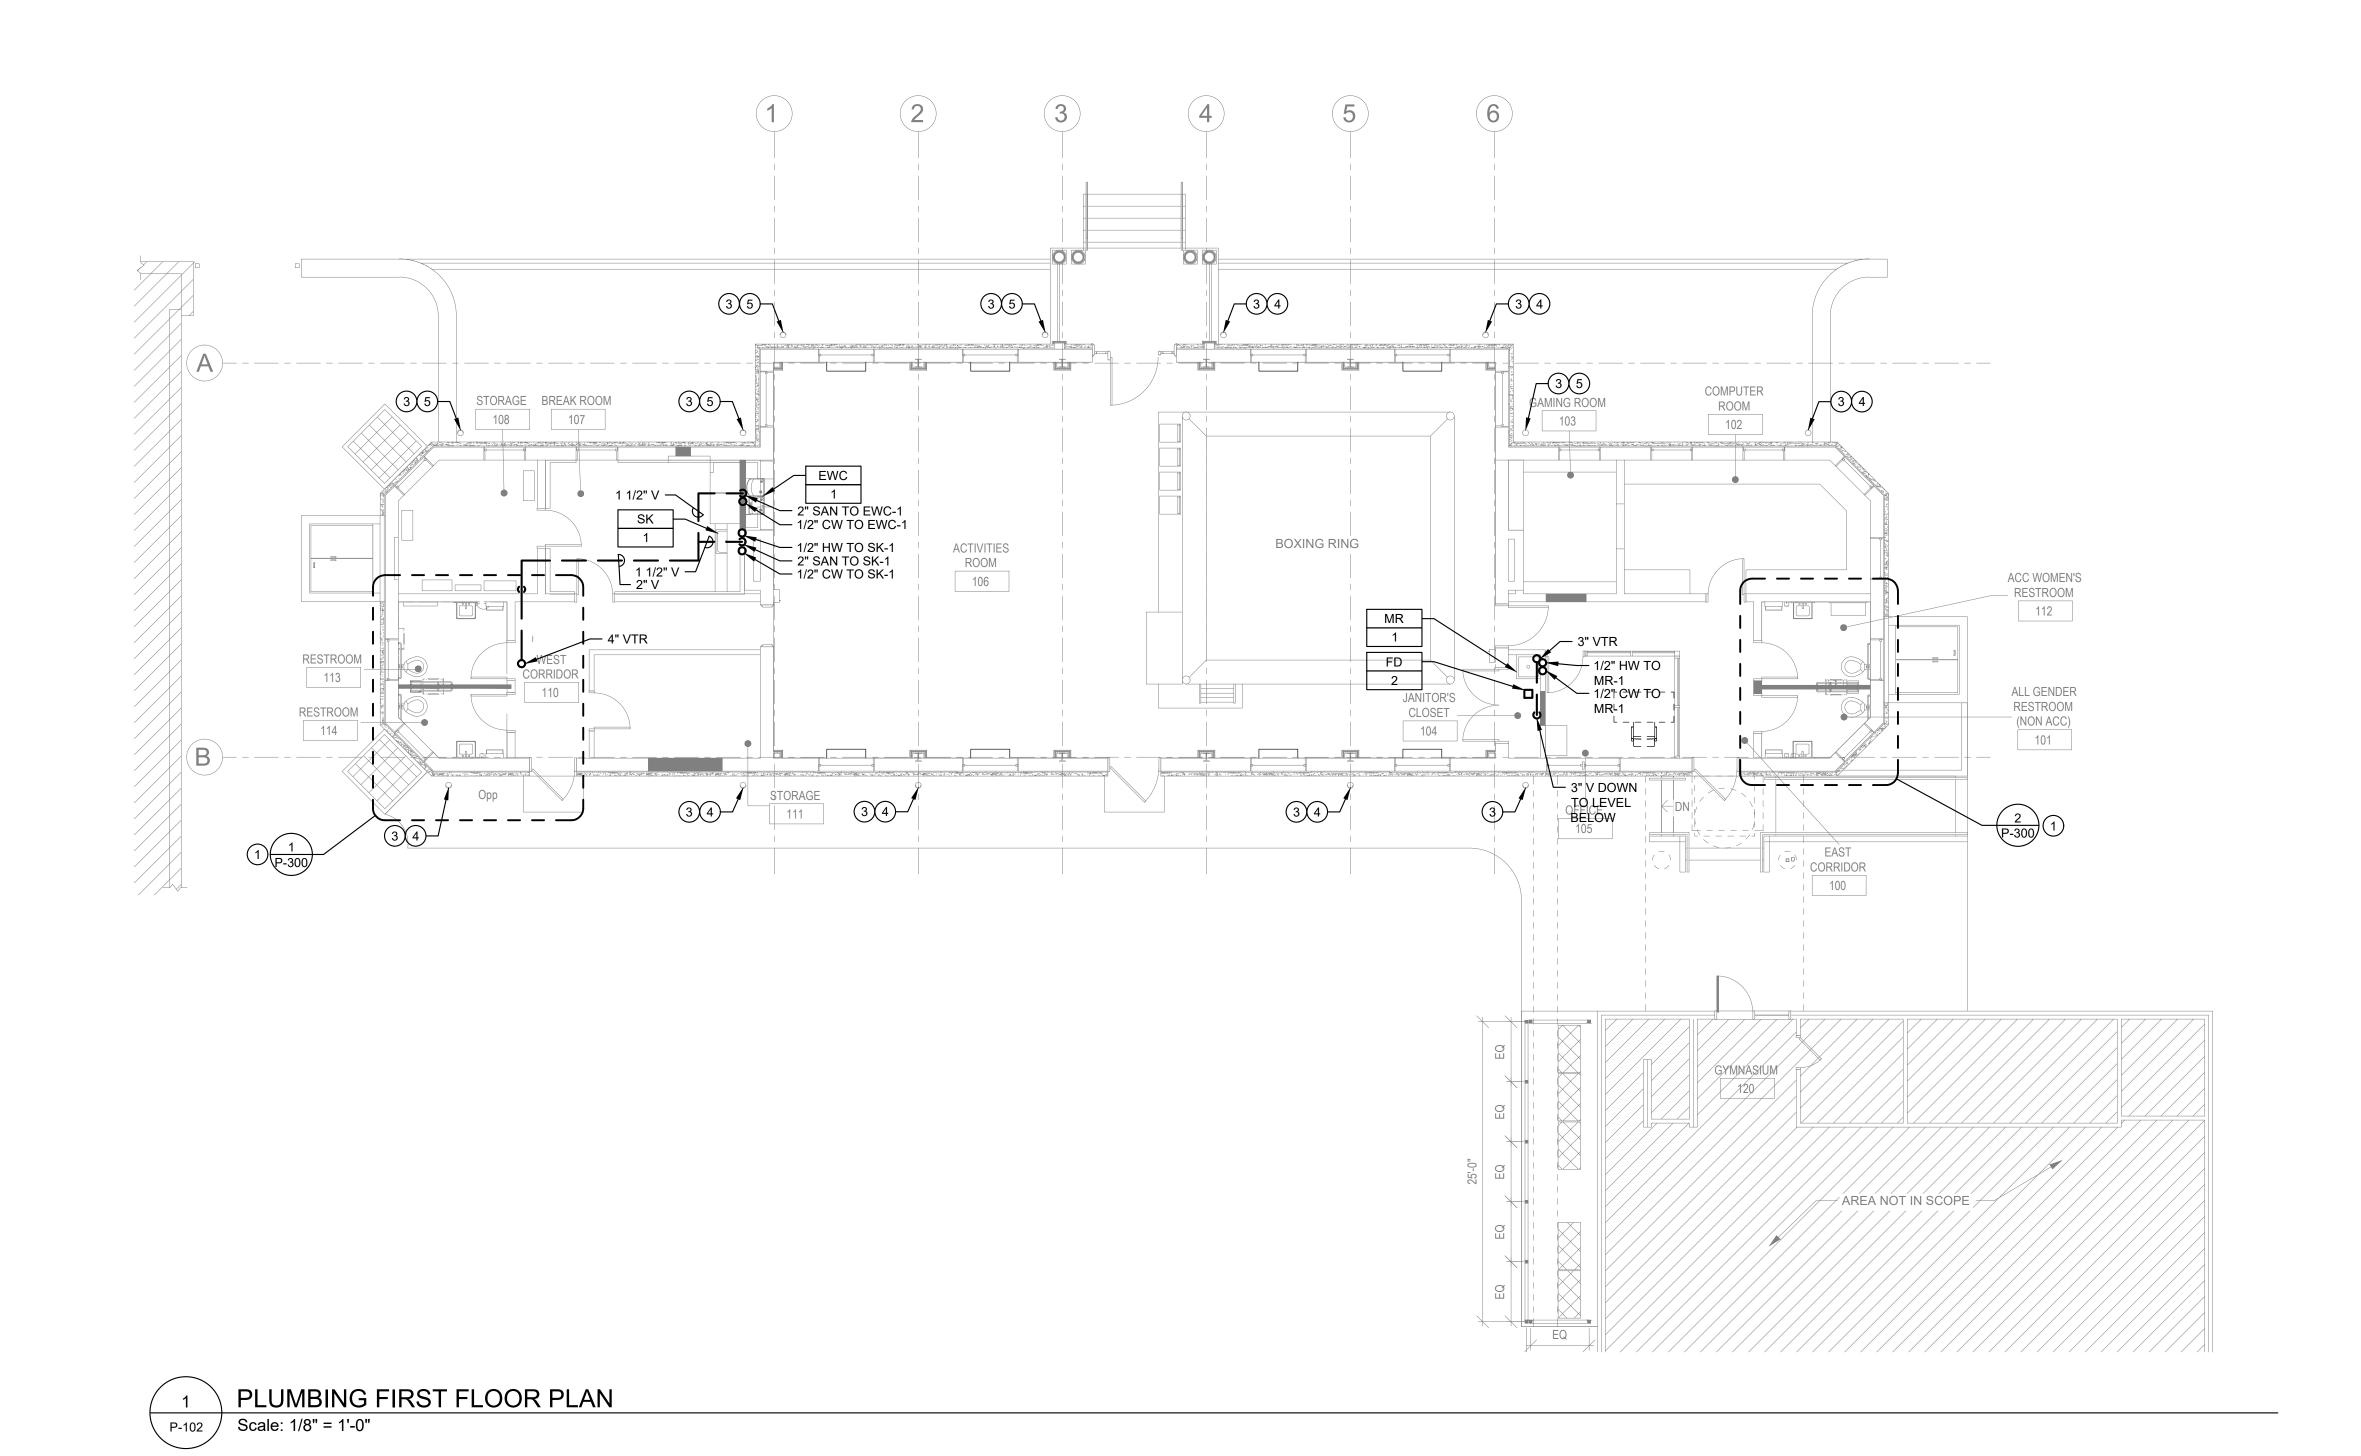

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- 4. REFER TO DRAWING P600 FOR PLUMBING SCHEDULES.



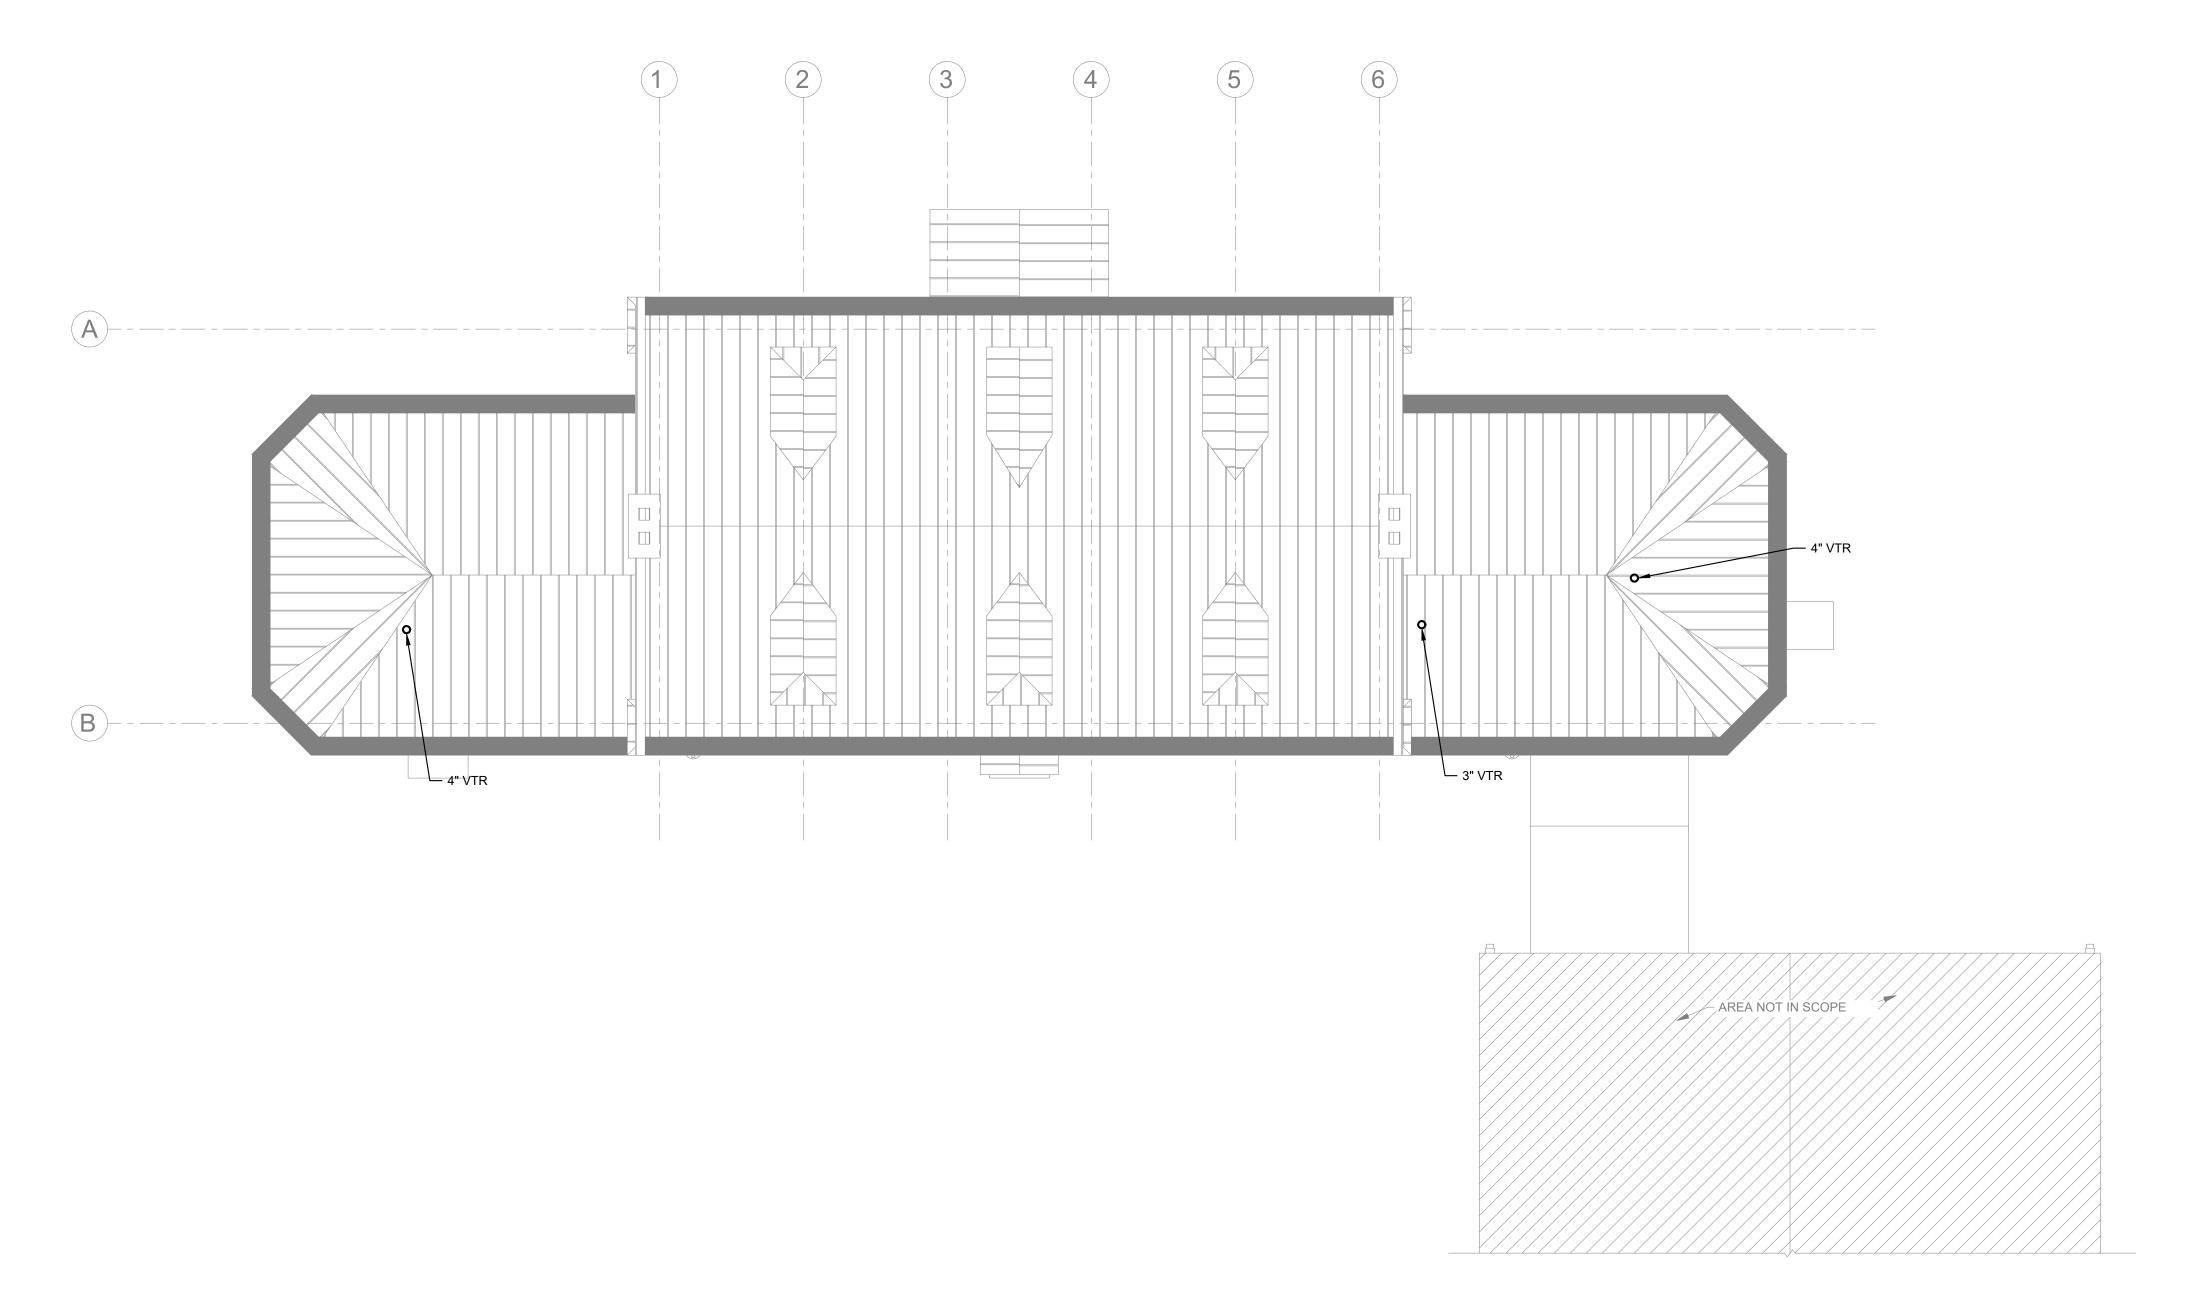

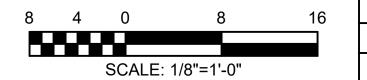

ISSUE DATE REVISIONS



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CITY OF PHILADELPHIA
DEPARTMENT OF PARKS & RECREATION

1515 ARCH STREET

11TH FLOOR, ONE PARKWAY BUILDING
PHILADELPHIA PENNSYLVANIA


PROJECT TITLE

RENOVATIONS TO THE HAPPY HOLLOW RECREATION CENTER

DRAWING TITLE


PLUMBING ROOF PLAN

CONSTRUCTION DOCUMENTS

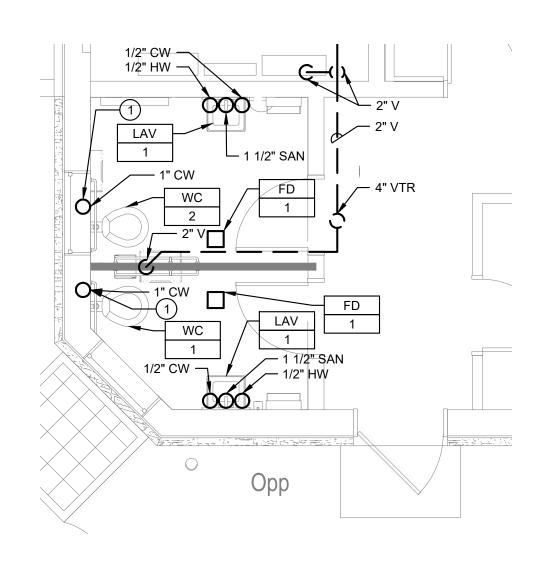

PLUMBING ENLARGED PLANS

Scale: 1/4" = 1'-0"

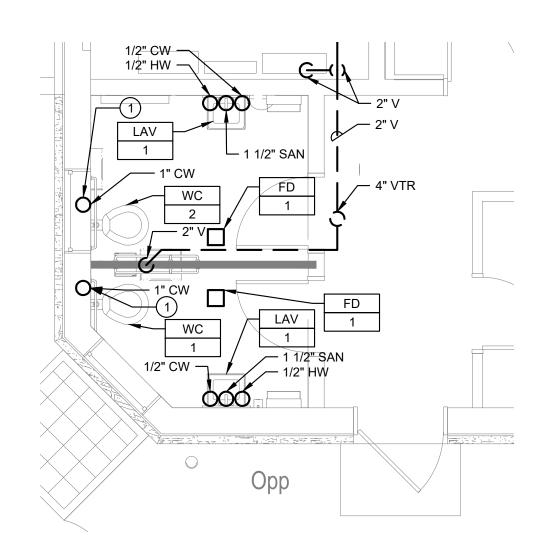

GENERAL NOTES:

REFER TO DRAWING P000 FOR PLUMBING GENERAL NOTES, SYMBOLS AND ABBREVIATIONS.

2. REFER TO DRAWING P400 FOR RISER DIAGRAMS

3. REFER TO DRAWING P500 AND P501 FOR PLUMBING DETAILS.

4. REFER TO DRAWING P600 FOR PLUMBING SCHEDULES.

PROVIDE CONNECTION TO TP-1. RUN TRAP PRIMER PIPING ON THE LEVEL BELOW TO FLOOR DRAINS.

KEYED NOTES:

ISSUE	DATE	REVISIONS
		-

REVISIONS



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MEP ENGINEER: ARORA ENGINEERS

www.aroraengineers.com 610 459 7900

ROOFING CONSULTANT: STEPHEN McLAUGHLIN ROOFING CONSULTANT stevemclaughlin.biz 856 287 2424

CITY OF PHILADELPHIA

DEPARTMENT OF PARKS & RECREATION

1515 ARCH STREET

11TH FLOOR, ONE PARKWAY BUILDING PENNSYLVANIA PHILADELPHIA


RENOVATIONS TO THE HAPPY **HOLLOW RECREATION CENTER**


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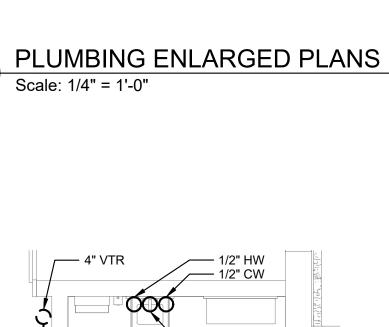
PLUMBING ENLARGED PLANS

TROJECTIVO.		DIVAWING NO.
16	315E-03-02	
DATE	05/13/2025	P-300
SCALE	AS NOTED	
DRAWN BY	TM	
CHECKED BY	PL	FILE:

CONSTRUCTION DOCUMENTS



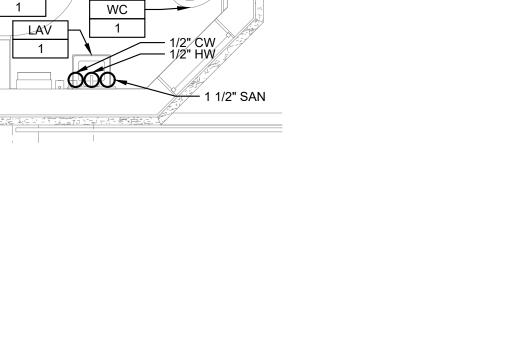


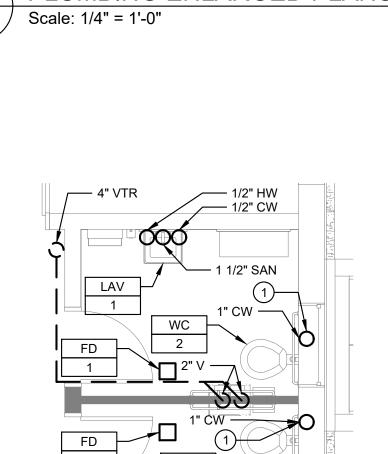

- 1. REFER TO DRAWING P000 FOR PLUMBING GENERAL NOTES, SYMBOLS AND ABBREVIATIONS.
- 2. REFER TO DRAWING P500 AND P501 FOR PLUMBING DETAILS.
- 3. REFER TO DRAWING P600 FOR PLUMBING SCHEDULES.

KEYED NOTES (1):

- 1. EXISTING 3" CAST IRON DOWNSPOUT BOOT TO
- 2. PROVIDE NEW 3" CAST IRON DOWNSPOUT
- 3. IF THE EXISTING 3" CAST IRON DOWNSPOUT BOOT WAS FOUND TO BE IN POOR CONDITION AND REMOVED AS PART OF THE DEMOLITION, PROVIDE NEW 3" CAST IRON DOWNSPOUT

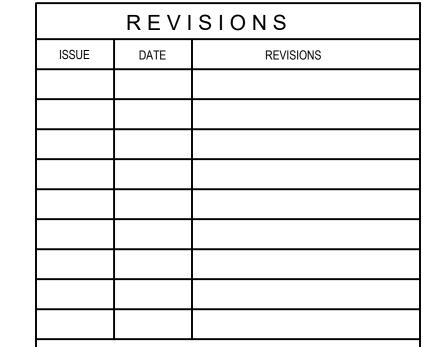



CONSTRUCTION DOCUMENTS

PROJECT COORDINATOR

LEEANN SUEN



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CITY OF PHILADELPHIA DEPARTMENT OF PARKS & RECREATION

1515 ARCH STREET

11TH FLOOR, ONE PARKWAY BUILDING

PHILADELPHIA

RENOVATIONS TO THE HAPPY **HOLLOW RECREATION CENTER**


PENNSYLVANIA


PLUMBING RISER DIAGRAMS

PROJECT NO.		DRAWING NO.
16	315E-03-02	D 400
DATE	05/13/2025	P-400
SCALE	AS NOTED	
DRAWN BY	TM	
CHECKED BY	DI	FILE:

CONTACTOR AT THE SITE BEFORE PROCEEDING WITH THE WORK **CONSTRUCTION DOCUMENTS**

ALL DIMENSIONS AND CONDITIONS SHALL BE VERIFIED BY THE

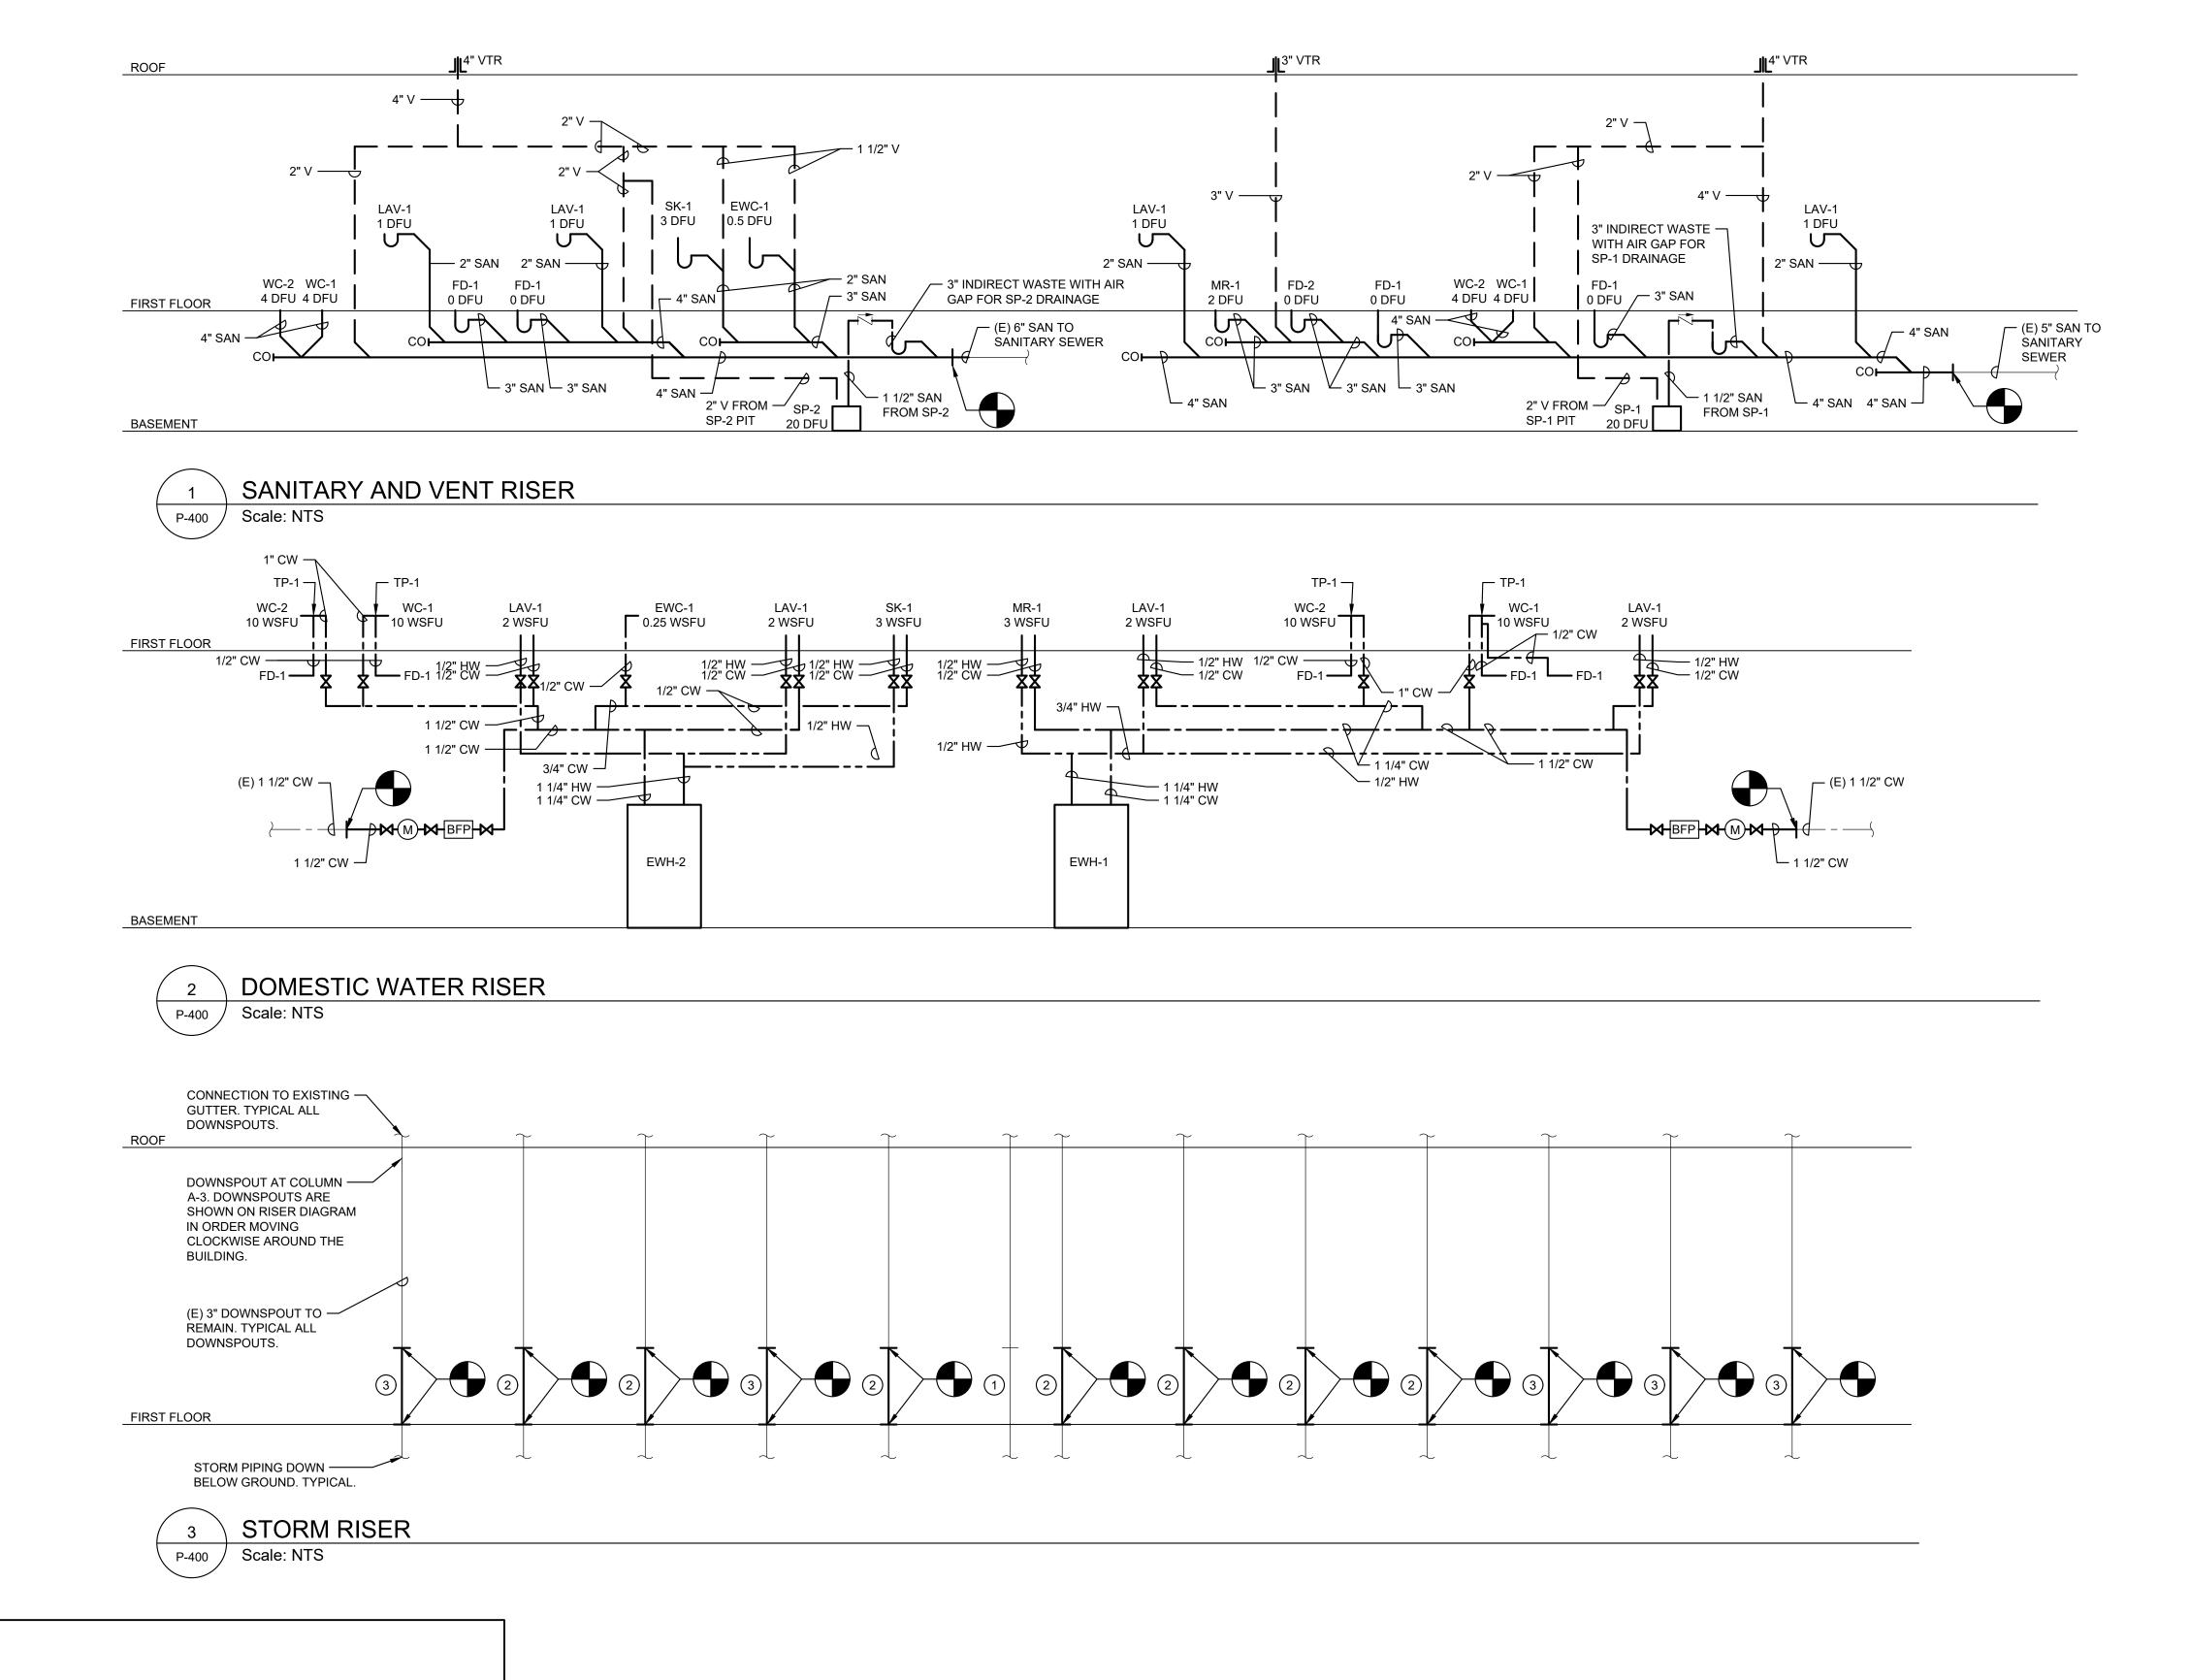

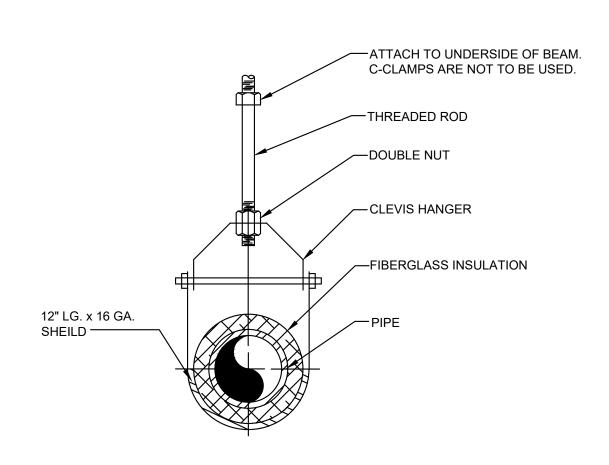

CONNECT ROD TO UNDERSIDE OF CONSTRUCTION W/ BEAM, CLAMPS, OR ANCHOR BOLTS — HANGER ROD WHERE APPLICABLE. - FORGED STEEL **CLEVIS HANGER** - INSULATION (WHEN REQUIRED) 12" LG. x 16 GA. 12" LG. HALF SECTION OF CALCIUM SILICATE W/ SHEILD — VAPOR BARRIER EXTENDED 2" OVER EA. 2" & LARGER


PIPE SLEEVE PIPE INSULATION (WHERE REQ'D) PIPE - FIRE RESISTANT SILICONE FOAM SEALER CUT OPENING IN EXISTING MANSONRY WALL LARGER THAN SLEEVE AND FORM & FILL WITH EXPANSIVE TYPE

INTERIOR PIPE SLEEVE THROUGH EXISTING WALL DETAIL NOT TO SCALE


CLEVIS HANGER DETAIL (FOR PIPING 2" AND LESS) P700


NOT TO SCALE

PIPE HANGER DETAIL (FOR PIPING 2" AND LARGER) NOT TO SCALE P700

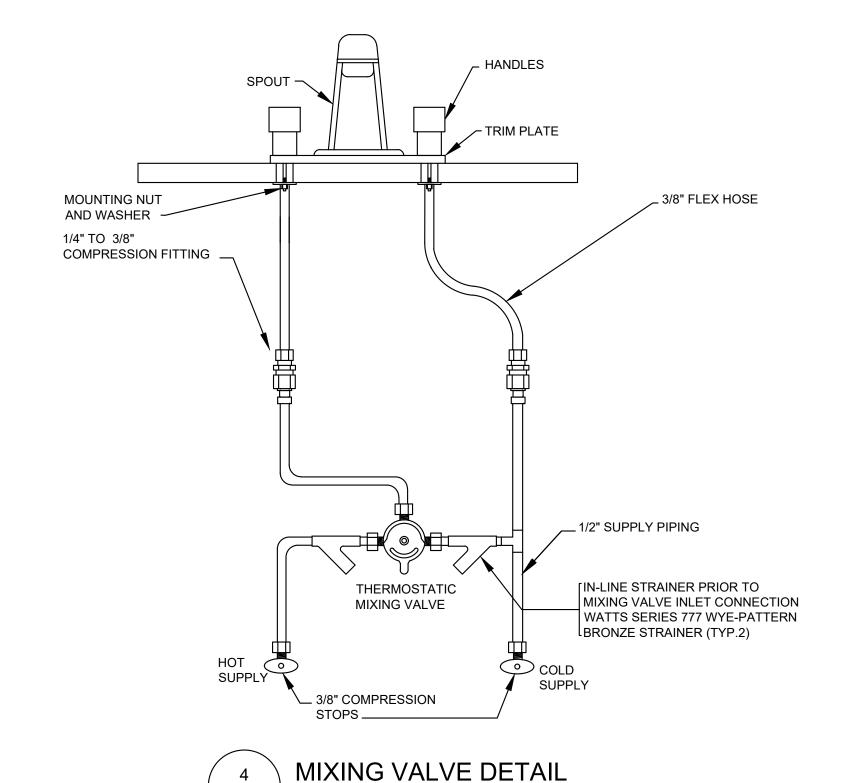



NOT TO SCALE

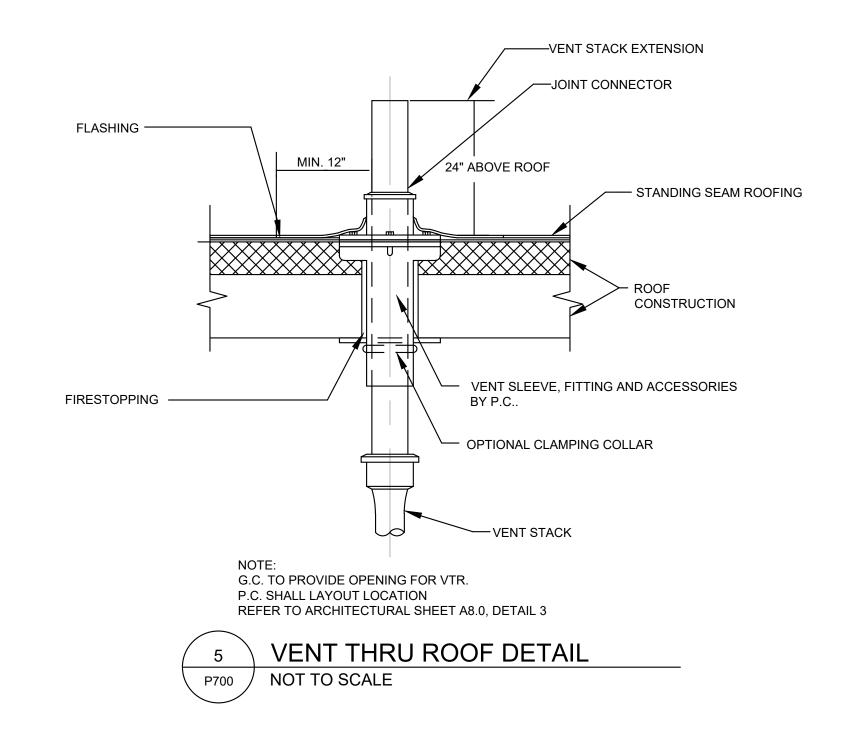

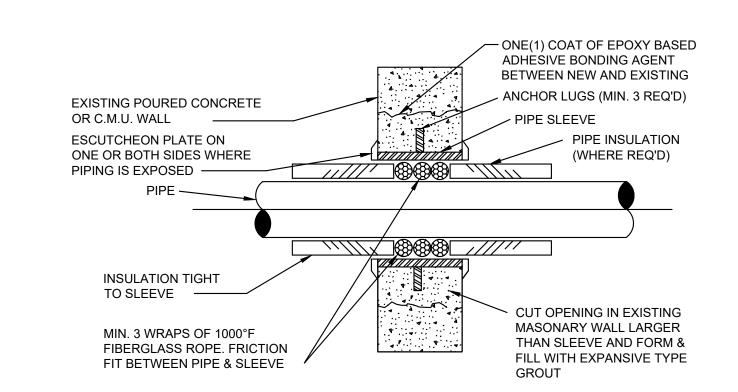

PIPE SLEEVE DETAIL - INTERIOR NOT TO SCALE P700

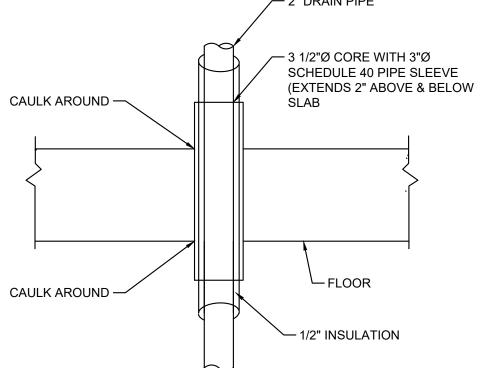

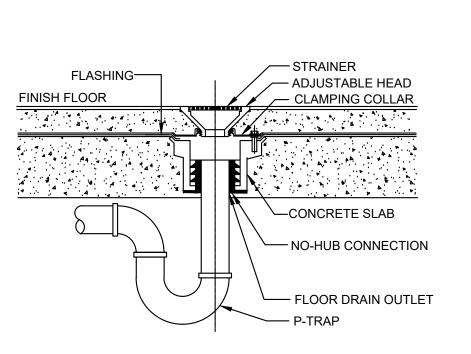


WATER INLET SUPPORT STRAINER WITH THREADED PLUG ON THE STRAINER FLANGE PLATE WITH A BALL VALVE & HOSE CONNECTION FOR DRAINING (TYP.)-AIR GAP

1. REFER TO SCHEDULE SHEET FOR BFP MODEL AND ENLARGED DOMESTIC WATER PLAN FOR LOCATION.


PREVENTER TO MEET CROSS CONNECTION CONTROL PER LOCAL GUIDELINES.

BACK FLOW PREVENTOR DETAIL NOT TO SCALE P700

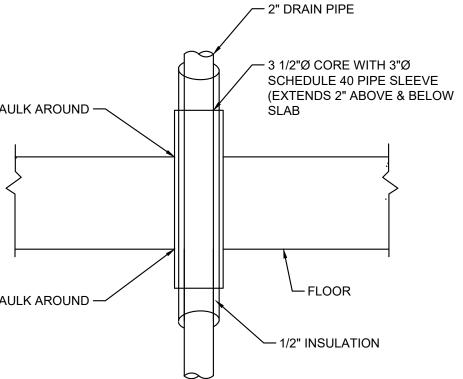







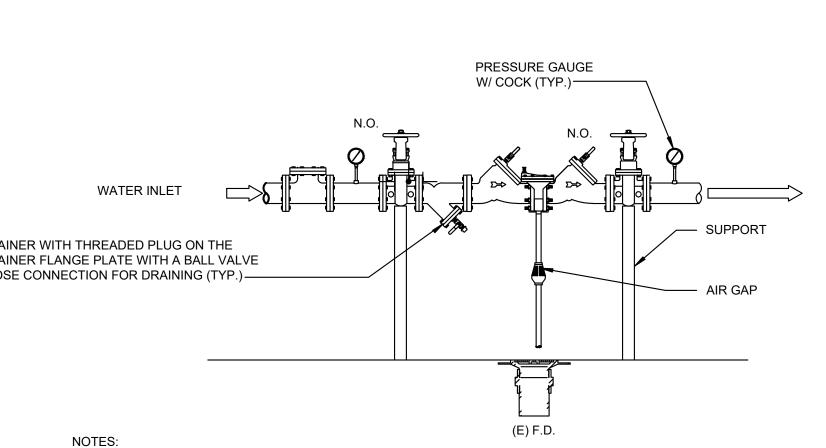

2. INSTALLATION SHALL COMPLY WITH ALL APPLICABLE PHILADELPHIA, PLUMBING CODES AND PROVIDE BACKFLOW

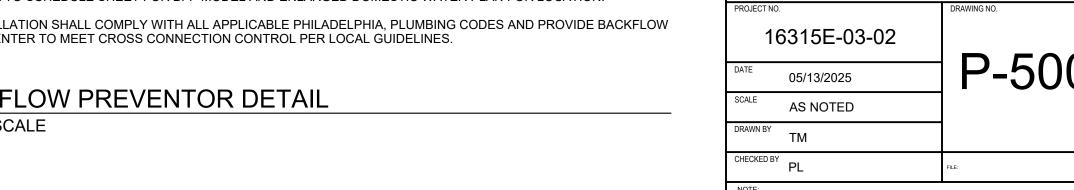

CONTACTOR AT THE SITE BEFORE PROCEEDING WITH THE WORK

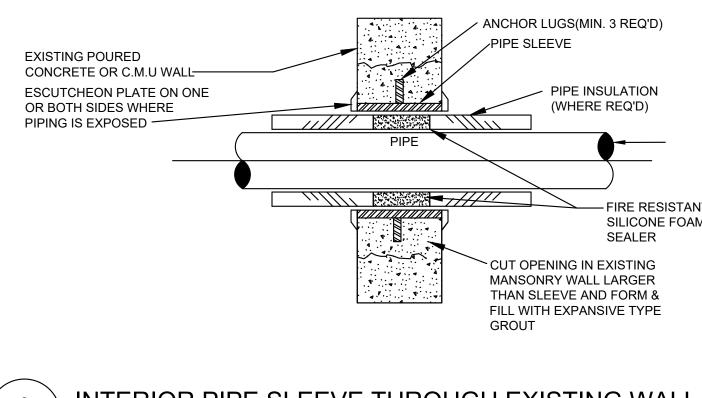



REVISIONS

REVISIONS

DATE

ISSUE

CONSTRUCTION DOCUMENTS

PROJECT COORDINATOR LEEANN SUEN



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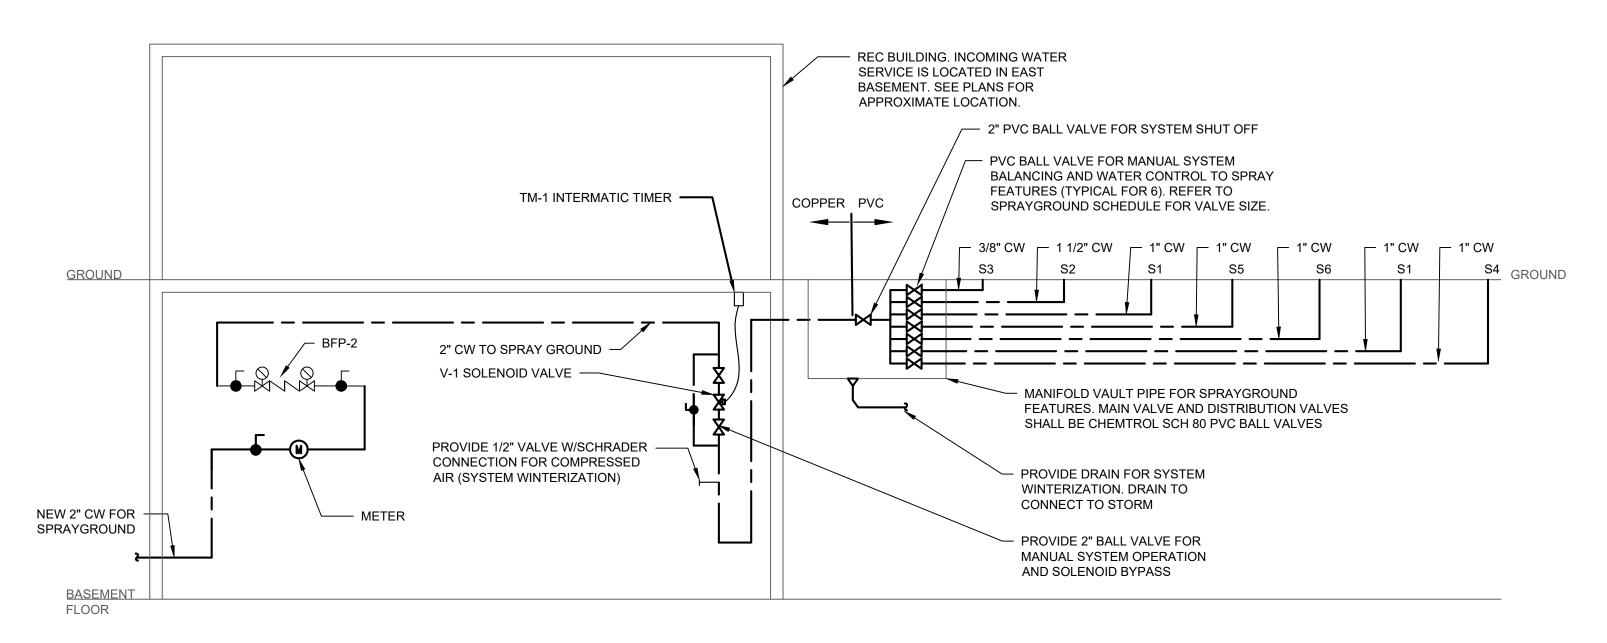
1515 ARCH STREET 11TH FLOOR, ONE PARKWAY BUILDING

PHILADELPHIA PENNSYLVANIA


RENOVATIONS TO THE HAPPY **HOLLOW RECREATION CENTER**


PLUMBING DETAILS

P-500 ALL DIMENSIONS AND CONDITIONS SHALL BE VERIFIED BY THE



1 SPRAY GROUND RISER DIAGRAM P-501 Scale: NONE

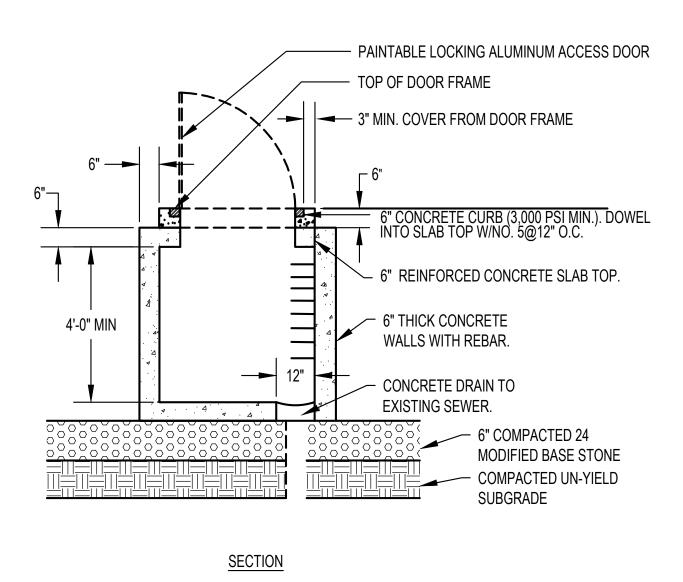

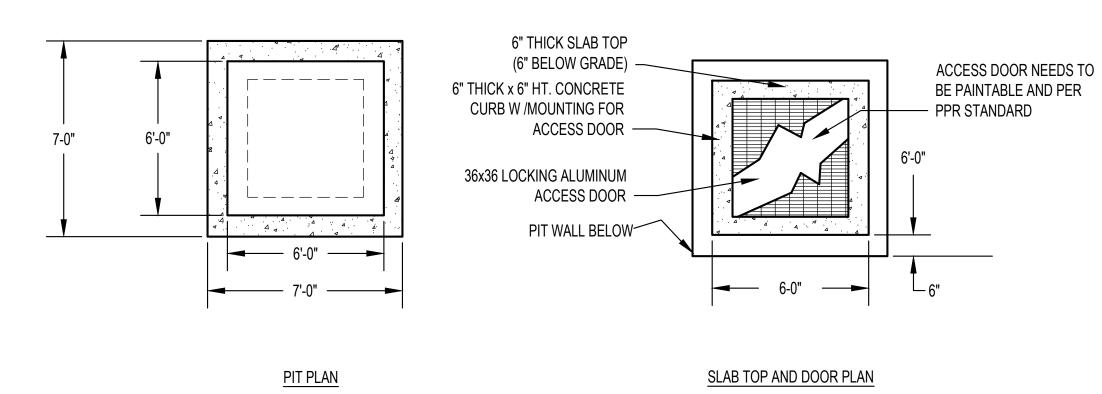


NOTE:

CONCRETE VAULT SHALL BE MANUFACTUREED BY ALTOMORE PRECAST CONCRETE.
 CONTRACTOR TO CONFIRM REQUIRED INTERIOR DIMENSIONS OF CONCRETE VAULT PRIOR TO FABRICATION; COORDINATE WITH SPRAYGROUND EQUIPMENT SUPPLIER.



GENERAL NOTES:

- 1. REFER TO DRAWING P000 FOR PLUMBING GENERAL NOTES, SYMBOLS AND ABBREVIATIONS.
- 2. REFER TO DRAWING P400 FOR RISER DIAGRAMS
- 3. REFER TO DRAWING P500 FOR PLUMBING DETAILS.
- 4. REFER TO DRAWING P600 FOR PLUMBING SCHEDULES.

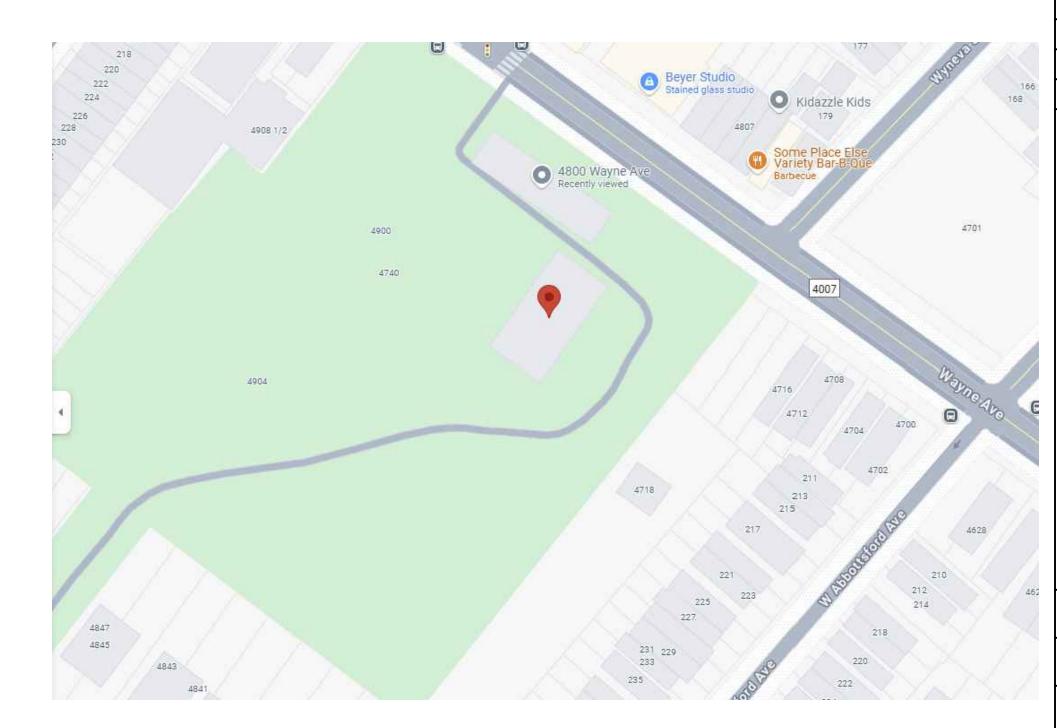



HAPPY HOLLOW SPRAYGROUND LOCATION

INSTAL	FLOW RATE	TOTAL (ODM)			
COMPONENT NAME	TAG	CONNECTION SIZE	QTY	(GPM)	TOTAL (GPM)
FS ANETH BLOOM 1	S1	1"	2	6	12
GS GROUP VOLCANO	S2	1-1/2"	1	10	10
GS TILTY POP- IT	S3	3/8"	1	1	1
GS SPLIT SPURT	S4	1"	1	1.5	1.5
GS SOLO SPURT	S5	1"	1	1	1
GS MISTER MISTER	S6	1"	1	1	1

SPRAY TIMER CONTROL									
SYMBOL	DESCRIPTION	MANUFACTURER, MODEL, NOTES & ACCESSORIES							
TM-1	INTERMATIC TIMER	INTERMATIC 24 HOUR TIMER WITH MECHANICAL ON/OFF SWITCH. TIMER TO HAVE 120 V OUTPUT FOR SOLENOID CONTROL. TIMER TO BE LOCATED IN BASEMENT IN CLOSE PROXIMITY TO THE SOLENOID							

NOTE:

1. SPRAYGROUND OPERATION AND SCHEDULE TO BE COORDINATED WITH REPRESENTATIVE FROM PPR.

2. SPRAYGROUND CAN BE SCHEDULED FOR OPERATION FOR UP TO 6 HOURS.

3. SPRAYGROUND CONTROL TO BE CONNECTED TO ELECTRICAL OUTLET IN MECHANICAL ROOM.

SOLENOID VALVE SCHEDULE										
SYMBOL	DESCRIPTION	SIZE	MANUFACTURER, MODEL, NOTES & ACCESSORIES							
V-1	SPRAYGROUND SHUT OFF VALVE	2"	WATTS LEAD FREE LF-133-12 FULL PORT SINGLE CHAMBER VALVE. MAIN VALVE SHALL BE F100 WITH 3 WAY SOLENOID AND ISOLATION COCKS. PROVIDE WITH ACS FOR ADJUSTABLE CLOSING SPEED							

	REVISIONS											
ISSUE	DATE	REVISIONS										



CONSTRUCTION DOCUMENTS

PROJECT COORDINATOR

LEEANN SUEN



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CITY OF PHILADELPHIA
DEPARTMENT OF PARKS & RECREATION

1515 ARCH STREET

11TH FLOOR, ONE PARKWAY BUILDING
PHILADELPHIA PENNSYLVANIA

IFCT TITLE

RENOVATIONS TO THE HAPPY HOLLOW RECREATION CENTER

IG TITLE

SPRAYGROUND DETAILS

PROJEC	CT NO.	DRAWING NO.
	16315E-03-02	D 504
DATE	05/13/2025	TP-501
SCALE	AS NOTED	
DRAWN	TM	
CHECKI	PL PL	FILE:
NOTE:	ALL DIMENSIONS AND CONI	DITIONS SHALL BE VERIFIED BY THE FORE PROCEEDING WITH THE WORK

							PLUM	BING FIXTUR	RE SCHEDULE	
TAG	FIXTURE	FLOW RATE	TRAP SIZE	ELECTRICAL	CONNECTION SIZE				MANUFACTURER / MODEL #	REMARKS
TAG	FIXTURE	FLOW RATE	(IN)	ELECTRICAL	CW (IN)	HW (IN)	SAN (IN)	VENT	(BASIS OF DESIGN)	REWARKS
WC-1	WATER CLOSET	1.6 GPF	4"	-	1-1/4"	-	4"	2"	AMERICAN STANDARD MODEL 2234.001	FLOOR MOUNTED WATER CLOSET WITH BOTTOM OUTLET AND TOP SPUD. PROVIDE WITH SLOAN ROYAL 111-1.6 FLUSHOMETER AND AMERICAN STANDARD 5901.100SS TOILET SEAT. FLUSH LEVER ON FLUSHOMETER SHALL BE LOCATED TO OPEN SIDE OF ROOM.
WC-2	ADA WATER CLOSET	1.6 GPF	4"	-	1-1/4"	-	4"	2"	AMERICAN STANDARD MODEL 3043.001	FLOOR MOUNTED WATER CLOSET WITH BOTTOM OUTLET AND TOP SPUD. PROVIDE WITH SLOAN ROYAL 111-1.6 FLUSHOMETER AND AMERICAN STANDARD 5901.100SS TOILET SEAT. FLUSH LEVER ON FLUSHOMETER SHALL BE LOCATED TO OPEN SIDE OF ROOM.
UR-1	URINAL	1 GPF	2"	-	3/4"	-	2"	1-1/2"	AMERICAN STANDARD 6590.001EC	WALL MOUNTED TOP SPUD URINAL WITH WASHOUT FLUSH ACTION PROVIDE WITH SLOAN ROYAL 186-1.0 FLUSHOMETER.
LAV-1	21 X 18 LAVATORY	0.35 GPM	2"	-	1/2"	1/2"	2"	1-1/2"	AMERICAN STANDARD 0355.012.020	WALL MOUNTED LAVATORY WITH FRONT OVERFLOW AND HOLES FOR CONCEALED ARMS SUPPORT. PROVIDE WITH GRID DRAIN. PROVIDE WITH AMERICAN STANDARD 5500.174 0.35 GPM 4" CENTERSET MANUAL FAUCET WITH WRIST BLADE HANDLES AND WATTS LFUSG-B MIXING VALVE. PROVIDE UNDER LAVATORY GUARD.
SK-1	PANTRY SINK	1.5 GPM	2"	-	1/2"	1/2"	2"	1-1/2"	ELKAY ELUHAD211545PD	COUNTER MOUNTED PANTRY SINK. PROVIDE WITH KOHLER K-810T20-5AHA FAUCET.
FD-1	LIGHT DUTY FLOOR DRAIN	-	3"	-	-	-	3"	1-1/2"	JAY R SMITH 2005YB	PROVIDE WITH 6" SQUARE TOP, NICKEL BRONZE STRAINER, AND VANDAL PROOF SCREWS. PROVIDE WITH JAY R SMITH 2692 QUAD CLOSE TRAP SEAL DEVICE.
FD-2	MEDIUM DUTY FLOOR DRAIN	-	3"	-	-	-	3"	1-1/2"	ZURN Z1727	PROVIDE WITH 6" SQUARE TOP, STAINLESS STEEL STRAINER, AND VANDAL PROOF SCREWS. PROVIDE WITH JAY R SMITH 2692 QUAD CLOSE TRAP SEAL DEVICE.
TP-1	TRAP PRIMER	0.01 GPM	-	-		-	-	-	PRECISION PLUMBING PRODUCTS P2-500	INSTALL ON LINE FEEDING WATER CLOSET FLUSH VALVE. INSTALL PER MANUFACTURER'S INSTRUCTIONS.
MR-1	24 X 24 MOP SINK	1.5 GPM	3"	-	1/2"	1/2"	3"	1-1/2"	FIAT TSB3000	TERAZZO MOP SERVICE BASIN WITH 6" DROP FRONT. PROVIDE WITH AMERICAN STANDARD 8344.212 WALL-MOUNT FAUCET WITH INTEGRAL VACUUM BREAKER, HOSE END, AND BUCKET HOOK.
EWC-1	BI-LEVEL ELECTRIC WATER COOLER	8 GPH	1 1/2"	115V/60HZ	1/2"	-	2"	1-1/2"	ELKAY BI-LEVEL MODEL LZSTL8WSLK	PROVIDE BI-LEVEL WALL MOUNTED COOLER WITH FILTER AND REFRIGERATED CHILLING CAPACITY OF 8 GPH WITH BOTTLE FILLER. PROVIDE PUSH BUTTON ACTIVATION.

	ELECTRIC WATER HEATER SCHEDULE												
TAG AREA SERVED MAN		MANUFACTURER / MODEL #	ELECTRICAL		CONNECTION	CAPACITY	WATER TEMPERARTURE	WATER TEMPERATURE	GPH AT 100	REMARKS			
IAG	AREA SERVED	(BASIS OF DESIGN)	VOLTAGE	PHASE	AMPERAGE	SIZE	(GAL)	IN (F)	OUT (F)	DEG F RISE	ILIMARKS		
EWH-1	EAST WING	AO SMITH DSE-20A-9	240V	3	21.7 A	1-1/4"	20	40	140	37	PROVIDE WITH AMTROL ST-5C-DD EXPANSION TANK.		
EWH-2	WEST WING	AO SMITH DSE-20A-15	240V	3	36.1 A	1-1/4"	20	40	140	61	PROVIDE WITH AMTROL ST-5C-DD EXPANSION TANK.		

	SUMP PUMP SCHEDULE													
TAG	AREA SERVED	MANUFACTURER / MODEL # (BASIS OF DESIGN)		ELECT	TRICAL			CAPACITY	HEAD (FT)	RATING (HP)	REMARKS			
170	ANLA SERVED		VOLTAGE	PHASE	HERTZ	AMPERAGE		(GPM)			KLIMAKKO			
SP-1	EAST BASEMENT	ZOELLER WM49	115V	1	60 HZ	4 A	1-1/2"	10	15	1 1//	CAST IRON SUBMERSIBLE SUMP PUMP. AUTOMATIC WITH INTEGRAL FLOAT. PROVIDE WITH 20 INCH CORD.			
SP-2	WEST BASEMENT	ZOELLER WM49	115V	1	60 HZ	4 A	1-1/2"	10	15	1 1/4	CAST IRON SUBMERSIBLE SUMP PUMP. AUTOMATIC WITH INTEGRAL FLOAT. PROVIDE WITH 20 INCH CORD.			

	BACKFLOW PREVENTER SCHEDULE						
TAG	AREA SERVED	MANUFACTURER / MODEL # (BASIS OF DESIGN)	SIZE	REMARKS			
BFP-1	EAST AND WEST BASEMENTS	WATTS LF009	1-1/2"	15 PSI PRESSURE DROP AT 50 GPM. PROVIDE WITH SHUTOFF VALVES, STRAINER, AND AIR GAP.			

REVISIONS								
ISSUE	DATE	REVISIONS						



CONSTRUCTION DOCUMENTS

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PHILADELPHIA

RENOVATIONS TO THE HAPPY

PENNSYLVANIA

HOLLOW RECREATION CENTER

PLUMBING SCHEDULES

16315E-03-02

P-600 05/13/2025

AS NOTED DRAWN BY TM

CONSTRUCTION DOCUMENTS

- CONTRACTOR SHALL COMPLY WITH ALL REGULATIONS & LAWS OF AUTHORITIES HAVING JURISDICTION.
- ALL MATERIALS, MEANS AND METHODS SHALL COMPLY WITH APPLICABLE CODES, ORDINANCES, REGULATIONS AND STANDARDS.
- CONTRACTOR SHALL PERFORM A SITE SURVEY TO VERIFY ALL EXISTING CONDITIONS AND NOTIFY THE ENGINEER AT ONCE OF ANY DISCREPANCIES.
- CONTRACTOR SHALL TAKE STEPS REQUIRED TO ASSURE THE EXISTING FIRE ALARM SYSTEM TO BE EXPANDED / MODIFIED SHALL BE ASSESSED TO CONFIRM THAT IT IS A CURRENT PRODUCT SUPPORTED BY THE MANUFACTURER AND HAS CAPACITY
- EACH CONTRACTOR SHALL REVIEW ALL PROJECT DOCUMENTS OF ALL TRADES FOR A THOROUGH UNDERSTANDING OF PROJECT AND ANY CROSS REFERENCING OF WORK. REVIEW ALL PROJECT REQUIREMENTS PRIOR TO BIDDING. DISCREPANCIES BETWEEN DOCUMENTS SHALL BE REPORTED TO THE ENGINEER PRIOR TO BIDDING. IN THE CASE OF ANY DISCREPANCIES, THE MOST STRINGENT REQUIREMENT SHALL
- THE CONTRACTOR SHALL PROVIDE SECURITY WITHIN THE CONSTRUCTION AREA AND WILL LIMIT SITE ACCESS TO AUTHORIZED PERSONNEL ONLY.
- ALL CONSTRUCTION TRAFFIC SHALL ENTER AND EXIT THE PROJECT AREA THROUGH DESIGNATED ACCESS POINTS AS DETERMINED BY THE OWNER OR THEIR DESIGNATED REPRESENTATIVE.
- THE CONTRACTOR SHALL NOT BE ALLOWED ANY STORAGE AREA OTHER THAN THAT AVAILABLE WITHIN THE LIMITS OF THE STAGING AREA OR CONFINES OF THE WORK
- CONTRACTOR SHALL BE RESPONSIBLE FOR REMOVAL AND DISPOSAL OF CONSTRUCTION DEBRIS AND REFUSE ON A DAILY BASIS.
- A COPY OF THE CURRENT SET OF CONTRACT DOCUMENTS (WITH AS-BUILT INFORMATION) SHALL BE KEPT AT THE JOB SITE AT ALL TIMES BY THE CONTRACTOR.
- ALL PENETRATIONS, THROUGH DESIGNATED FIRE RATED WALLS, CEILINGS AND FLOOR SLABS SHALL BE PROPERLY SEALED WITH AN APPROVED RATED FIRE STOPPING MATERIAL. ALL FIRE STOPPING MATERIAL SHALL BE SUPPLIED AND WORK PERFORMED AS PER PROJECT SPECIFICATIONS.
- CONTRACTOR SHALL REPLACE IN-KIND ANY EQUIPMENT OR ARCHITECTURAL ELEMENTS DAMAGED BY WORK OF THIS PROJECT AT NO ADDITIONAL COSTS TO THE
- CONTRACTOR SHALL COMPLETE ALL CUTTING AND PATCHING REQUIRED FOR THE INSTALLATION OF THE WORK. CUTTING AND PATCHING SHALL BE COMPLETED IN A NEAT AND WORKMAN LIKE MANNER. PATCHING MATERIALS SHALL MATCH EXISTING MATERIALS TO THE GREATEST EXTENT POSSIBLE. PROVIDE TOUCH UP PAINT AS REQUIRED TO MATCH PAINT FINISH AND COLOR OF EXISTING ADJACENT AREAS. CONTRACTOR SHALL SALVAGE MATERIALS FOR RE-USE IN AREAS WHERE SUBSTRATES/SURFACES ARE TO BE PATCHED/REPAIRED (I.E. TILES, WALLS, CEILING
- THE CONTRACTOR SHALL GUARANTEE THE ENTIRE INSTALLATION FOR A PERIOD OF ONE YEAR (EXCEPT WHERE EXTENSIONS OF THIS ONE YEAR PERIOD ARE NOTED) FROM THE DATE OF ACCEPTANCE OF THE SYSTEM AS A WHOLE. ANY DEFECTS IN WORKMANSHIP, MATERIALS, MALFUNCTION OF EQUIPMENT OR UNSATISFACTORY PERFORMANCE, AND ALL OTHER WORK OR PARTS OF THE BUILDING DAMAGED THEREBY, AS A RESULT OF WORK OF THE PROJECT BY THE CONTRACTOR, SHALL BE THE RESPONSIBILITY OF THE CONTRACTOR. CONTRACTOR SHALL PAY ALL REPAIR COSTS ACCORDINGLY WITHOUT ADDITIONAL COSTS TO THE OWNER.
- IN ADDITION TO SPECIFICATIONS, AS MAY BE DEFINED HEREAFTER, THE CONTRACTOR SHALL PROTECT THE WORK SITE AND ALL HIS OR HER WORK AGAINST ANY DAMAGE UNTIL FINAL COMPLETION AND ACCEPTANCE BY THE OWNER.
- CONTRACTOR SHALL, UPON COMPLETION OF THE WORK, SUBMIT AS-BUILT RECORD DRAWINGS SHOWING ALL CHANGES FROM THE CONTRACT DRAWING MADE IN THE INSTALLATION, AND SHOWING DIMENSION LOCATIONS OF CONCEALED EQUIPMENT.
- PRIOR TO DELIVERY OF ANY MATERIALS TO THE SITE. THE CONTRACTOR SHALL PROVIDE MATERIAL SAFETY DATA SHEETS FOR ALL ITEMS AND MATERIALS USED IN
- PERCUSSIVE FASTENING SYSTEMS, INCLUDING BUT NOT LIMITED TO POWDER, GAS AND PNEUMATIC ACTUATED ANCHORS, WILL NOT BE PERMITTED ANYWHERE ON THE PROJECT. CONTRACTORS ARE PERMITTED TO USE MECHANICAL TYPE UNISTRUT FASTENING DEVICES ONLY.
- PRIOR TO ACCEPTANCE OF THE SPACE, ALL SYSTEMS SHALL BE INSPECTED, TESTED AND OPERATED TO DEMONSTRATE TO THE OWNER, OR HIS DESIGNATED REPRESENTATIVE, THAT THE INSTALLATION AND PERFORMANCE OF THESE SYSTEMS AND/OR PARTS THEREOF CONFORM TO THE DESIGN INTENT.
- THE BUILDING IS A WORK OF A COMPLEX NATURE WHICH WILL REQUIRE ACCURATE PLANNING, CAREFUL PREPARATION AND EXECUTION, ATTENTION TO DETAIL AND CLOSE SUPERVISION BY THE CONTRACTOR. THE CONTRACTOR SHALL BE REQUIRED TO DO THIS WORK IN FULL COOPERATION WITH ALL CONSTRUCTION TRADES AND SUBJECT TO SCHEDULING ARRANGED TO MINIMIZE DISRUPTION OF NORMAL ACTIVITIES OF THE BUILDING. PHASING OF ALL WORK SHALL BE DONE IN

COORDINATION WITH THE ARCHITECTURAL PHASING PLAN.

- PRIOR TO ANY CORE DRILLING, THE CONTRACTOR SHALL OBTAIN THE SERVICES OF A UTILITY LOCATOR FIRM WITH ABILITY TO LOCATE CONDUIT IN CONCRETE SLABS. CONTRACTOR SHALL IDENTIFY THE LOCATION OF CONDUITS IN SLAB, THEN PRESENT THE FINDINGS TO THE ENGINEER FOR REVIEW PRIOR TO CORE DRILLING. ALL PENETRATIONS, BOTH NEW AND EXISTING, THROUGH DESIGNATED FIRE RATED WALLS, CEILINGS AND FLOOR SLABS SHALL BE PROPERLY SEALED WITH AN APPROVED RATED FIRE STOPPING MATERIAL. ALL FIRE STOPPING MATERIAL SHALL BE SUPPLIED AND WORK PERFORMED AS PER PROJECT SPECIFICATIONS.
- ALL EXISTING ABANDONED CONDUIT/PIPING OR CONDUIT/PIPING MADE ABANDONED BY WORK OF THIS PROJECT SHALL BE REMOVED FROM WITHIN THE PROJECT BOUNDARIES. CUT AND CAP CONDUIT/PIPING BACK TO IT'S SOURCE BEYOND (OUTSIDE OF) THE PROJECT BOUNDARIES, UNLESS OTHERWISE NOTED ON THE DRAWINGS. PROVIDE CUTTING AND PATCHING OF ALL CEILINGS, FLOORS AND WALLS AS REQUIRED.
- JUNCTION BOXES, VALVES, DAMPERS, OR ANY CONCEALED EQUIPMENT REQUIRING ACCESS SHALL ONLY BE PERMITTED / LOCATED IN ACCESSIBLE TYPE AREAS (I.E. LAY-IN TYPE CEILING, ETC.) OR SHALL BE PROVIDED WITH ACCESS PANELS.
- WHERE UTILITIES AND/OR SERVICES REQUIRE SHUTDOWN FOR THE WORK TO BE PERFORMED, NOTIFY THE PORT AUTHORITY PROJECT ENGINEER. REQUESTS FOR

GENERAL NOTES CONT'D):

- UTILITY AND/OR SERVICES SHUTDOWNS SHALL BE SUBMITTED TO THE PORT AUTHORITY PROJECT ENGINEER, IN WRITING, A MINIMUM OF ONE WEEK PRIOR TO THE SCHEDULED SHUTDOWN.
- ALL SYSTEMS SHALL BE RETURNED TO SERVICE PRIOR TO COMPLETION OF APPROVED SHIFT AND AT THE END OF EACH WORK DAY. IN THE EVENT A SYSTEM CANNOT BE RETURNED TO SERVICE THE CONTRACTOR SHALL PROVIDE A FIRE
- ALL PAINT SHALL MEET THE REQUIREMENTS OF THE NFPA FOR FLAME SPREAD AND SMOKE DENSITY. PAINT PROCESS SHALL MEET ENVIRONMENTAL STANDARDS FOR VENTILATION AS ESTABLISHED BY OSHA. ALL PAINTS, SOLVENTS, RAGS AND OTHER PAINTING REFUSE SHALL BE DISPOSED OF PROPERLY OFF SITE IN ACCORDING TO STATE AND FEDERAL ENVIRONMENTAL REGULATIONS. EVIDENCE OF SUCH COMPLIANCE SHALL BE FURNISHED TO THE OWNER PRIOR TO THE START OF
- PRIOR TO THE APPLICATION OF PAINT, CONTRACTOR SHALL PROPERLY PREPARE AND CLEAN PIPING AND EQUIPMENT PER PAINT MANUFACTURES GUIDELINES.
- 28. THE CONTRACTOR SHALL TAKE ANY/ALL PREVENTIVE MEASURES TO CURTAIL THE NOISE LEVEL AT ALL TIMES. THE OWNER RESERVES THE RIGHT TO CURTAIL ANY ACTIVITY IT DEEMS OBTRUSIVE TO OPERATIONS.

GENERAL DEMOLITION NOTES:

- THE CONTRACTOR SHALL BECOME FAMILIAR WITH EXISTING CONDITIONS AFFECTING THIS PROJECT AND COORDINATE WITH ALL OTHER DISCIPLINES.
- THE DRAWINGS ARE DIAGRAMMATIC AND INDICATE THE GENERAL CAPACITIES & LOCATIONS OF EQUIPMENT TO BE REMOVED. THE CONTRACTOR SHALL BE RESPONSIBLE FOR VISITING THE SITE TO DETERMINE ACTUAL PHYSICAL SIZE, CAPACITIES, AND LOCATIONS OF EXISTING EQUIPMENT TO BE REMOVED.
- THE CONTRACTOR SHALL TAKE STEPS REQUIRED TO ASSURE THE EXISTING FIRE ALARM SYSTEM TO BE EXPANDED / MODIFIED SHALL BE ASSESSED TO CONFIRM THAT IT IS A CURRENT PRODUCT SUPPORTED BY THE MANUFACTURER AND HAS CAPACITY FOR NEW WORK.
- THE CONTRACTOR SHALL OBTAIN ALL REQUIRED PERMITS, COORDINATE ALL REQUIRED EQUIPMENT AND SYSTEMS SHUTDOWN WITH OWNER, AND PROVIDE OWNER TWO WEEKS NOTICE OF SAME.
- THE CONTRACTOR SHALL BE RESPONSIBLE FOR ALL CUTTING & PATCHING AS IT MAY APPLY TO THE AREAS OF DEMOLITION, OR MAY BE AFFECTED BY PIPE, DUCTWORK, EQUIPMENT & APPURTENANCES. PATCH & REPAIR SHALL MATCH EXISTING BUILDING CONDITIONS.
- COORDINATE THE DEMOLITION WORK WITH ALL OTHER TRADES. PHASE WORK IN CONJUNCTION WITH OTHER TRADE PHASING & PHASING DRAWINGS.
- 7. THE DEMOLITION/REMOVAL OF ITEMS BY THE CONTRACTOR SHALL BE AS FOLLOWS: UNLESS SPECIFICALLY NOTED OTHERWISE, ITEMS SHOWN IN HEAVY LINEWEIGHT DASHED LINES ON DEMOLITION SHEETS ARE EXISTING ITEMS TO BE REMOVED AND ITEMS SHOWN IN LIGHT LINEWEIGHT ITEMS ARE EXISTING ITEMS TO
- DEMOLISHED EQUIPMENT/SERVICES SHALL BE REMOVED BACK TO THE LIMIT OF DEMOLITION AS INDICATED ON DRAWINGS, OR TO THE NEAREST HEADER OR JUNCTION. PROVIDE CAPS AS NECESSARY.
- THE CONTRACTOR SHALL FIELD VERIFY OTHER EQUIPMENT/UTILITIES NOT ASSOCIATED WITH THIS WORK BUT LYING WITHIN THE WORK AREA, AND SHALL NOT DISTURB THAT EQUIPMENT/UTILITIES. THESE EQUIPMENT/UTILITIES SHALL BE PROTECTED SO THAT THE SERVICE IS NOT INTERRUPTED. THE CONTRACTOR SHALL REPAIR ANY DAMAGE DONE TO THE EQUIPMENT/UTILITIES IN PERFORMANCE OF THE WORK.
- 10. ALL ITEMS BEING REMOVED SHALL BE TURNED OVER TO OWNER OR REMOVED FROM SITE AS DIRECTED, UNLESS OTHERWISE DESIGNATED.
- THE CONTRACTOR SHALL KEEP WORK AREA CLEAN, ORDERLY, AND WORKMAN LIKE, AND REMOVE ALL DEMOLISHED TRASH/RUBBLE/CONSTRUCTION DEBRIS FROM THE SITE DAILY.
- 12. UNLESS OTHERWISE INDICATED, DEMOLITION WASTE BECOMES PROPERTY OF THE CONTRACTOR.
- 13. NOTIFY ARCHITECT OF DISCREPANCIES BETWEEN EXISTING CONDITIONS AND DRAWINGS BEFORE PROCEEDING WITH SELECTIVE DEMOLITION.
- 14. IF SUSPECTED HAZARDOUS MATERIALS ARE ENCOUNTERED, DO NOT DISTURB; IMMEDIATELY NOTIFY ARCHITECT AND OWNER. HAZARDOUS MATERIALS SHALL BE REMOVED BY OWNER UNDER A SEPARATE CONTRACT.
- 15. REVIEW RECORD DOCUMENTS OF EXISTING CONSTRUCTION PROVIDED BY THE OWNER. THE OWNER DOES NOT GUARANTEE THAT EXISTING CONDITIONS ARE THE SAME AS THOSE INDICATED IN RECORD DOCUMENTS.
- 16. WHEN UNANTICIPATED ELEMENTS THAT CONFLICT WITH INTENDED FUNCTION OR DESIGN ARE ENCOUNTERED, INVESTIGATE AND MEASURE THE NATURE AND EXTEND OF CONFLICT. PROMPTLY SUBMIT A WRITTEN REPORT TO THE ARCHITECT.
- 17. COMPLY WITH HAULING AND DISPOSAL REGULATIONS OF AUTHORITIES HAVING JURISDICTION.
- 18. PROCEED WITH SELECTIVE DEMOLITION SYSTEMATICALLY, FROM HIGHER TO LOWER LEVEL. COMPLETE SELECTIVE DEMOLITION OPERATIONS ABOVE EACH FLOOR OR TIER BEFORE DISTURBING SUPPORTING MEMBERS ON THE NEXT LOWER LEVEL.
- 19. NEATLY CUT OPENINGS AND HOLES PLUMB, SQUARE, AND TRUE TO DIMENSIONS REQUIRED. USE CUTTING METHODS LEAST LIKELY TO DAMAGE CONSTRUCTION TO REMAIN OR ADJOINING CONSTRUCTION.
- 20. USE HAND TOOLS OR SMALL POWER TOOLS DESIGNED FOR SAWING OR GRINDING, NOT HAMMERING AND CHOPPING, TO MINIMIZE DISTURBANCE OF ADJACENT SURFACES. TEMPORARILY COVER OPENINGS TO REMAIN. CUT OR DRILL FROM THE EXPOSED OR FINISHED SIDE INTO CONCEALED SURFACES TO AVOID MARRING EXISTING FINISHED SURFACES.
- 21. DO NOT USE CUTTING TORCHES UNTIL WORK AREA IS CLEARED OF FLAMMABLE MATERIALS. AT CONCEALED SPACES, VERIFY CONDITION AND CONTENTS OF HIDDEN SPACE BEFORE STARTING FLAME-CUTTING OPERATIONS. MAINTAIN FIRE WATCH AND PORTABLE FIRE-SUPPRESSION DEVICES DURING FLAME-CUTTING OPERATIONS. MAINTAIN ADEQUATE VENTILATION WHEN USING CUTTING TORCHES.

FIRE ALARM NOTES:

- 1. THE SCOPE OF WORK INCLUDES FURNISHING MATERIALS AND LABOR FOR ALL DEMOLITION, INSTALLATION, PHASING, TESTING AND ACCEPTANCE OF THE FIRE ALARM SYSTEM(S) AS SHOWN IN THE CONTRACT DOCUMENTS. THE PROJECT SCOPE INCLUDES:
 - DEMOLITION OF THE HORN/STROBE IN THE MEN'S RESTROOM, DEMOLITION OF THE AREA SMOKE DETECTORS IN THE ACTIVITIES ROOM, DEMOLITION OF THE HORN/STROBE AND THE SMOKE DETECTOR IN THE WOMEN'S RESTROOM
 - DEMOLITION OF THE EXISTING FIRE ALARM WIRE AND **EQUIPMENT AS INDICATED ON THE DRAWINGS**
 - INSTALLATION OF A HORN/STROBE IN THE WEST BASEMENT AND THE EAST BASEMENT, INSTALLATION OF A STROBE IN THE MEN'S RESTROOM, INSTALLATION OF BEAM SMOKE DETECTION IN THE ACTIVITIES ROOM, AND INSTALLATION OF A STROBE AND SMOKE DETECTOR IN THE WOMEN'S RESTROOM AND THE ALL GENDER RESTROOM INSTALLATION OF THE NEW FIRE ALARM AND
 - **EQUIPMENT AS INDICATED ON THE DRAWINGS** INSTALLATION OF PROTECTIVE GUARDS ON ALL NEW FIRE ALARM DEVICES AND EQUIPMENT.
- THE PROJECT SHALL BE DESIGNED, INSTALLED, TESTED & COMMISSIONED IN ACCORDANCE WITH ALL APPLICABLE CODES AND STANDARDS, AS DEFINED BY THE AUTHORITY HAVING JURISDICTION AND THE PROJECT REQUIREMENTS. THESE INCLUDE 18. BUT ARE NOT LIMITED TO THOSE LISTED BELOW AND ANY ADOPTED REVISIONS THAT ARE APPLICABLE AT THE TIME OF PROJECT PERMITTING:
 - PHILADELPHIA BUILDING CODE, IBC 2018 AMENDED PHILADELPHIA EXISTING BUILDING CODE, IEBC 2018
 - PHILADELPHIA FIRE CODE, IFC 2018 AMENDED PHILADELPHIA MECHANICAL CODE, IMC 2018 AMENDED
 - PHILADELPHIA ACCESSIBILITY CODE, A117.1, 2009 NOT PHILADELPHIA ELECTRICAL CODE 2017, NFPA 70 2017
 - NOT AMENDED PHILADELPHIA FIRE ALARM CODE 2016, NFPA 72 2016
 - **NOT AMENDED**
 - 2010 ADA STANDARDS UNDERWRITER'S LABORATORIES, INC. (UL): FIRE PROTECTION EQUIPMENT DIRECTORY
 - MANUFACTURERS INSTALLATION INSTRUCTIONS PROJECT SPECIFICATIONS
- ALL NEW DEVICES SHALL ADHERE TO THE EXISTING FIRE ALARM PROGRAMMING MATRIX.
- THE CONTRACTOR SHALL BE RESPONSIBLE TO TAKE STEPS REQUIRED TO ASSURE THE EXISTING FIRE ALARM SYSTEM TO BE EXPANDED / MODIFIED SHALL BE ASSESSED TO CONFIRM THAT IT IS A CURRENT PRODUCT SUPPORTED BY THE MANUFACTURER AND HAS CAPACITY FOR NEW WORK.
- THE CONTRACTOR SHALL VERIFY THE CONDITION OF EACH INITIATING AND NOTIFICATION DEVICE TO REMAIN. IN THE EVENT THAT ANY OF THESE DEVICES ARE IMPROPERLY MOUNTED, THEN IT SHALL BE THE CONTRACTOR'S RESPONSIBILITY TO RE-INSTALL THE DEVICE PROPERLY
- THE CONTRACTOR SHALL BE RESPONSIBLE FOR DETERMINING IS TO BE EXTENDED. LOCATIONS AND POINTS SHOWN ON THE PLANS ARE DIAGRAMMATICAL AND FOR REFERENCE ONLY. THE CONTRACTOR SHALL SHOW FINAL INFORMATION ON SHOP DRAWINGS AND INSTALLATION SHALL NOT BEGIN UNTIL THESE PLANS ARE APPROVED
- THE ELECTRICAL CONTRACTOR SHALL COORDINATE THE FIELD CONDITIONS AS PART OF THIS CONTRACT.
- 8. ALL WIRING SHALL COMPLY WITH PROJECT SPECIFICATIONS, AND ALL LOCAL AND NATIONAL ELECTRICAL CODES.
- SUBSTITUTIONS OF TYPE FPLP OR CERTIFIED FIRE ALARM CABLES SHALL NOT BE PERMITTED. 10. ALL WIRE AND CABLE SHALL HAVE A WIRE MARKER ON EACH END,
- BRADY OR EQUAL. ALL MARKERS SHALL BE TYPED. 11. SHIELDS ON ALL SHIELDED CABLE SHALL BE CONTINUOUS, GROUNDED AT THE FIRE ALARM CONTROL PANEL ONLY, AND ISOLATED FROM GROUND ELSEWHERE.
- 12. NPLFA CIRCUIT CONDUCTORS INSULATION SHALL BE SUITABLE FOR 600 VOLTS, MULTI-CONDUCTOR NPLFA CIRCUIT CABLES, TYPES NPLFP, NPLFR, AND NPLF, SHALL NOT BE INSTALLED EXPOSED IN DUCTS, PLENUMS OR HOISTWAYS (SHAFTS).
- 13. POWER-LIMITED FIRE ALARM CIRCUIT CABLES AND CONDUCTORS SHALL NOT BE PLACED IN ANY CABLE, CABLE TRAY, COMPARTMENT, ENCLOSURE, MANHOLE, OUTLET BOX, DEVICE BOX, RACEWAY, OR SIMILAR FITTING WITH CONDUCTORS OF ELECTRIC LIGHT, POWER. CLASS 1, NON-POWER-LIMITED FIRE ALARM CIRCUITS, AND MEDIUM-POWER NETWORK-POWERED BROADBAND
- 14. INSTALLATION OF RACEWAYS, BOXES, ENCLOSURES, CABINETS, AND WIRING SHALL CONFORM TO THE FOLLOWING REQUIREMENTS:

FLOORS SHALL BE FIRE STOPPED.

COMMUNICATIONS CIRCUITS.

OR BOX.

- COVERS OF BOXES, ENCLOSURES AND CABINETS SHALL BE PAINTED RED AND PERMANENTLY IDENTIFIED AS TO
- PENETRATIONS THROUGH RATED WALLS, CEILINGS AND
- RACEWAYS OR WIRING SHALL NOT PENETRATE THE TOP OF ANY CONTROL EQUIPMENT CABINET OR ENCLOSURE. RACEWAYS INSTALLED UP TO 8 FT IN STAIRWAYS SHALL 31.
- RADIUS OR EGRESS PATH CABLES SHALL BE SECURED BY CABLE TIES, STRAPS OR 32. SIMILAR FITTINGS DESIGNED AND INSTALLED SO AS NOT TO DAMAGE THE CABLES. SUCH FITTING SHALL BE SECURED IN PLACE AT INTERVALS NOT EXCEEDING 5 FT ON CENTER AND WITHIN 1 FT OF ASSOCIATED CABINET

NOT REDUCE OR OBSTRUCT REQUIRED STAIRWAY

- NEW JUNCTION BOXES AND/OR EXISTING JUNCTION BOXES AFFECTED BY THIS PROJECT SHALL BE PROPERLY LABELED "FIRE ALARM JUNCTION BOX" PER THE SPECIFICATIONS.
- 14. ALL CABLE SHALL BE UL LISTED AND MARKED PER NEC. WIRING SPECIFICATION SHALL BE AS FOLLOWS: MOUNTING FOR ALL DEVICES SHALL COMPLY WITH THE BUILDING CODE, NFPA 72, NEC, AND ADAAG.

FIRE ALARM NOTES (CONT'D):

- 15. INSTALLATION OF NOTIFICATION AND VISUAL APPLIANCES SHALL CONFORM TO THE FOLLOWING REQUIREMENTS:
 - A. FIRE ALARM DEVICES SHALL BE ACCESSIBLE TO ALLOW PERIODIC INSPECTION, CLEANING AND MAINTENANCE. A FIRE ALARM DEVICE SHALL BE CONSIDERED ACCESSIBLE IF IT CAN BE READILY AND SAFELY ACCESSED WITH THE USE OF A LADDER OR A BOOM
 - B. FIRE ALARM DEVICES SHALL NOT BE INSTALLED WHERE ACCESS IS IMPEDED BY MECHANICAL SYSTEMS, DUCTS. PIPES OR CONDUITS.
 - C. FIRE ALARM DEVICES SHALL NOT BE INSTALLED WHERE THEY CANNOT BE MAINTAINED WITHOUT SHUTTING DOWN POWER OR ENDANGERING A MAINTENANCE
- ALL WALL MOUNTED NOTIFICATION APPLIANCES INSIDE THE AREA OF WORK SHALL BE LOCATED SUCH THAT THE BOTTOM OF THE LENS IS ABOVE 80" FROM THE FINISHED FLOOR AND THE TOP OF THE LENS IS NOT HIGHER THAN 96" FROM THE FINISHED FLOOR.
- 17. ALL NOTIFICATION APPLIANCES SHALL BE SYNCHRONIZED PER NFPA 72. ALL HARDWARE, EQUIPMENT, PANEL MODIFICATIONS AND LABOR NECESSARY TO PERFORM SYNCHRONIZATION SHALL BE
- VISUAL NOTIFICATION APPLIANCES SHALL BE SET TO THE CANDELA RATING ASSIGNED ON THE DRAWINGS.
- MINIMUM DECIBEL AMBIENT RATING SHALL BE 55db. HORN STROBE DECIBEL RATING SHALL BE 15db ABOVE AMBIENT.

PART OF THIS CONTRACT.

- 20. CIRCUIT MODIFICATIONS, TERMINATIONS AND SPLICES SHALL BE MADE WITH TERMINAL BLOCKS AND IN LISTED FITTINGS, BOXES, ENCLOSURES, FIRE ALARM DEVICES OR UTILIZATION EQUIPMENT. SPLICES SHALL BE LIMITED TO LOCATIONS WHERE THE CONDITIONS OF INSTALLATION REQUIRE THE USE OF SPLICES. SPLICES AND TERMINATIONS IN RISER CABLES ARE PROHIBITED EXCEPT WHERE MADE IN FIRE ALARM EQUIPMENT TERMINAL CABINETS. MECHANICAL CONNECTIONS LISTED UNDER UNDERWRITERS LABORATORIES ("UL") 486-03, A & C SHALL BE USED FOR THE CONDUCTORS, OR IF SOLDERED, FIRST JOINED SO AS TO BE MECHANICALLY AND ELECTRICALLY SECURE PRIOR TO SOLDERING. TEMPERATURE RATING OF THE COMPLETED SPLICES SHALL EQUAL OR EXCEED THE TEMPERATURE RATING OF THE HIGHEST RATED CONDUCTOR.
- 21. FIRE ALARM CONDUITS SHALL BE LABELED AND IDENTIFIED PER THE PROJECT SPECIFICATIONS. ALL "EXPOSED" FIRE ALARM CONDUIT SHALL BE PAINTED TO MATCH EXISTING FINISHES UNLESS DIRECTED OTHERWISE.
- ACCESSIBLE ABANDONED FIRE ALARM SYSTEM CABLES, CONDUIT, AND ELECTRICAL EQUIPMENT SHALL BE REMOVED.

SUBMIT ALL DEVICE ADDRESSES FOR THIS PROJECT AS A PART OF

- THIS CONTRACT'S SHOP DRAWING SUBMISSION. CONTRACTOR TO SUBMIT SHOP DRAWINGS CONTAINING ALL THE ELEMENTS REQUIRED BY THE PROJECT STANDARDS, CODES, AND
- SPECIFICATIONS AS WELL AS ANY TENANT/OWNER DESIGN GUIDELINES IN USE FOR THE PROJECT. SHOP DRAWINGS SHALL BE SIGNED AND SEALED BY A QUALIFIED PROFESSIONAL EXACT CIRCUIT TIE-IN LOCATIONS, IN THE EVENT THAT THE CIRCUIT 25. CONTRACTOR TO SUBMIT BATTERY CALCULATIONS FOR ALL FIRE ALARM PANELS, DATA GATHERING PANELS, NOTIFICATION APPLIANCE CIRCUIT BOOSTER PANELS, AUXILIARY POWER SUPPLIES, OR SIMILAR APPURTENANCES TO ENSURE SUFFICIENT

BACKUP POWER FOR THE MINIMUM STANDBY AND OPERATING

PERIODS AS INDICATED BY CODE OR SPECIFICATION, WHICHEVER

IS MORE STRINGENT. CALCULATIONS TO BE MADE USING VENDOR

- SPECIFIC TEMPLATES WHERE AVAILABLE. CALCULATIONS SHALL BE SIGNED AND SEALED BY A QUALIFIED PROFESSIONAL. 26. CONTRACTOR TO SUBMIT VOLTAGE DROP CALCULATIONS FOR ALL FIRE ALARM ELECTRICAL CIRCUITS EXTENDING BEYOND THEIR RESPECTIVE ENCLOSURES TO ENSURE PROPER OPERATION OF SAID CIRCUITS. CALCULATIONS TO BE PROVIDED SHALL INCLUDE BUT NOT BE LIMITED TO SIGNAL LINE CIRCUITS, INDICATING DEVICE CIRCUITS, ANNUNCIATOR CIRCUITS, AUDIO RISER CIRCUITS, NOTIFICATION APPLIANCE CIRCUITS, AND PANEL NETWORK CIRCUITS. CALCULATIONS TO BE MADE USING VENDOR SPECIFIC
- 27. CONTRACTOR TO SUBMIT PRODUCT DATA SHEETS (CUT SHEETS) FOR ALL MATERIAL INTENDED TO BE INCORPORATED AS A PART OF THE WORK. DATA SHEETS SHALL HAVE SUFFICIENT DETAIL TO ALLOW ENGINEER TO ASSESS WHETHER MATERIAL MEETS

QUALIFIED PROFESSIONAL.

- 28. INSTALLATION SHALL NOT BEGIN WITHOUT THE APPROVAL OF THE FIRE ALARM SHOP DRAWINGS BY THE ENGINEER. PLEASE REFER
- 29. IN THE EVENT THAT A DEVICE IS LOCATED ON A SURFACE THAT IS UNSUITABLE FOR PROPER MOUNTING, THEN THE CONTRACTOR SHALL OCCUR PRIOR TO CONDUIT AND JUNCTION BOX ROUGH-IN.
- 30. CONTRACTOR SHALL COMPLETE ALL CUTTING AND PATCHING REQUIRED FOR THE INSTALLATION OF THE WORK, CUTTING AND MANNER, PATCHING MATERIALS SHALL MATCH EXISTING UP PAINT AS REQUIRED TO MATCH PAINT FINISH AND COLOR OF EXISTING ADJACENT AREAS. CONTRACTOR SHALL SALVAGE
- THE FIRE ALARM DEMOLITION AND NEW WORK WILL BE A PHASED PROCESS.
- NO TROUBLES OR ALARM CONDITIONS WILL BE PERMITTED AT THE COMPLETION OF EACH WORKDAY. ANY AND ALL ISSUES WILL BE CORRECTED PRIOR TO THE ELECTRICAL CONTRACTOR LEAVES THE PREMISES.
- 33. IN THE EVENT OF A SYSTEM FAILURE OR AN UNRESOLVED TROUBLE AND MAINTAINED UNTIL THE CONDITION IS RETURNED TO A
- 34. ALL SMOKE DETECTORS SHALL BE PROVIDED WITH NUISANCE ALARM REDUCTION FEATURES.

SCHEDULE AND PHASING NOTES:

THE FIRE ALARM CONTRACTOR SHALL BE RESPONSIBLE FOR COORDINATING THEIR SCHEDULE WITH THE MASTER PROJECT SCHEDULE. THE SCHEDULE SHALL BE COORDINATED WITH ALL OTHER TRADES AND SUBMITTED TO THE OWNER EVERY TWO WEEKS. ALL CONTRACTORS SHALL BEAR THE COST OF ANY SCOPE IMPACTS CAUSED BY CHANGES TO THE MASTER PROJECT SCHEDULE. PRIOR TO THE START OF INSTALLATION, A MASTER SCHEDULE SHALL BE SUBMITTED FOR OWNER APPROVAL. ALL WORK SHALL BE COMPLETE (INCLUDING TESTING AND FINAL APPROVAL BY AHJ) IN ACCORDANCE WITH MASTER SCHEDULE.

FIRE ALARM WORK SHALL COMMENCE IN THE FOLLOWING PHASES

- 1. CONSTRUCTION COORDINATION AND SUBMITTALS: PERFORM DETAILED ANALYSIS OF THE PROJECT SITE AND ALL CONTRACT DOCUMENTS. DEVELOP AND SUBMIT CONSTRUCTION SUBMITTALS, COORDINATED WITH ALL TRADES, FOR APPROVAL BY OWNER AND OWNER'S REPRESENTATIVE.
- SYSTEM INSTALLATION: UPON APPROVAL OF CONSTRUCTION SUBMITTALS PERFORM INSTALLATION IN ACCORDANCE WITH MASTER SCHEDULE AND COORDINATE INSTALLATION WITH ALL OTHER TRADES.

PRE TESTING: PRIOR TO SUBMITTING A REQUEST FOR A

- DEMONSTRATION TO OWNER THE CONTRACTOR SHALL TEST AND OPERATE ALL FIRE ALARM EQUIPMENT, DEVICES AND INTEGRATED BUILDING SYSTEMS TO VERIFY THE PROPER OPERATION AND INSTALLATION OF THE FIRE ALARM SYSTEM AND BUILDING SYSTEM INTERFACES. ANY AND ALL ISSUES SHALL BE CORRECTED AND ADDITIONAL TESTING SHALL BE REPEATED UNTIL ISSUES ARE CORRECTED AT NO ADDITIONAL COST TO THE OWNER. CONTRACTOR SHALL COORDINATE ALL TRADES NECESSARY FOR TESTING. UPON COMPLETION SUBMIT DRAFT NFPA-72 RECORD OF COMPLETION DOCUMENTATION TO
- 4. ACCEPTANCE TESTING/OPERATIONAL DEMONSTRATION TO OWNER: PRIOR TO SUBMITTING A REQUEST FOR FINAL INSPECTION THE CONTRACTOR SHALL SATISFACTORILY DEMONSTRATE TO OWNER'S REPRESENTATIVE THE PROPER OPERATION AND FUNCTION OF THE FIRE ALARM SYSTEM. DEMONSTRATION SHALL INCLUDE THE TESTING AND OPERATION OF ALL FIRE ALARM EQUIPMENT, DEVICES AND INTEGRATED BUILDING SYSTEMS. ANY AND ALL ISSUES SHALL BE CORRECTED AND ADDITIONAL TESTING SHALL BE REPEATED AS NECESSARY AT NO ADDITIONAL COST TO THE OWNER. CONTRACTOR SHALL COORDINATE ALL TRADES NECESSARY FOR TESTING.
- TESTING CONTRACTOR SHALL REQUEST, COORDINATE AND PERFORM ALL INSPECTIONS AND TESTS REQUIRED BY THE AHJ. ADDITIONAL INSPECTIONS SHALL BE PERFORMED UNTIL AHJ APPROVAL AND SHALL BE PERFORMED AT NO ADDITIONAL COST TO OWNER. CONTRACTOR SHALL COORDINATE ALL TRADES NECESSARY FOR THE INSPECTION(S). UPON COMPLETION SUBMIT FINAL, SIGNED NFPA-72 RECORD OF COMPLETION AND ALL AHJ APPROVAL DOCUMENTATION TO OWNER.

5. FINAL INSPECTION: UPON COMPLETION OF ACCEPTANCE

FIRE ALARM SYMBOLS & **DESCRIPTION:**

WALL MOUNTED FIRE ALARM STROBE NUMBER DENOTES CANDELA RATING WALL MOUNTED FIRE ALARM HORN/STROBE

ADDRESSABLE SMOKE DETECTOR

ADDRESSABLE OUTPUT MODULE

ADDRESSABLE INPUT MODULE

FIRE ALARM CONTROL PANEL

FIRE ALARM ANNUNCIATOR

SURGE SUPPRESSION DEVICE

NEW WORK/NEW DEVICES.

REPRESENT DEMO WORK.

--- - *HEAVY DASHED LINEWEIGHTS SHALL

*HEAVY LINEWEIGHTS SHALL REPRESENT

*LIGHT/LIGHTER LINEWEIGHTS SHALL

REPRESENT EXISTING DEVICES.

NUMBER DENOTES. CANDELA RATING WALL MOUNTED FIRE ALARM HORN MANUAL PULL STATION

BEAM SMOKE DETECTOR - RECEIVER TEMPLATES. CALCULATIONS SHALL BE SIGNED AND SEALED BY A BEAM SMOKE DETECTOR - TRANSMITTER

| FACP |

ANN

SUR

- PROJECT SPECIFICATIONS, WHERE APPLICABLE.
- TO THE SPECIFICATIONS FOR REQUIREMENTS. SHALL NOTIFY THE ENGINEER DURING THE SHOP DRAWINGS PHASE FOR APPROVAL OF AN ALTERNATE LOCATION. THIS NOTIFICATION
- PATCHING SHALL BE COMPLETED IN A NEAT AND WORKMAN LIKE MATERIALS TO THE GREATEST EXTENT POSSIBLE, PROVIDE TOUCH MATERIALS FOR RE-USE IN AREAS WHERE SUBSTRATES/SURFACES ARE TO BE PATCHED/REPAIRED (I.E. TILES, WALLS, CEILING TILE).
- OR ALARM CONDITION, AN APPROVED FIREWATCH WILL BE POSTED NORMAL CONDITION.

FIRE ALARM **ABBREVIATIONS:**

ADAAG

ALM

DGP

EOL

(ER)

FACP

FAS

FFJ

FFP

GUIDELINES ABOVE FINISHED FLOOR ABOVE FINISHED GRADE ALARM AUTHORITY HAVING JURISDICTION **ACCESS PANEL** AUTOPLEX LOOPS, 2 CONDUCTOR W/SHIELD ADDRESSABLE RELAY WIRE GAUGE **BOOSTER POWER SUPPLY** CANDELA CIRCUIT CONTACT MONITOR CEILING MOUNTED **DUCT SMOKE DETECTOR** DATA GATHERING PANEL DIAMETER DOWN DRAWING **ELECTRICAL CONTRACTOR ELECTRICAL METALLIC TUBING END-OF-LINE RESISTOR EXISTING TO REMAIN** ELEVATION EXISTING TO BE RELOCATED DEGREE FAHRENHEIT FIRE ALARM CONTROL PANEL FIRE ALARM SPEAKER FIRE ALARM SPEAKER / STROBE

AMERICANS WITH DISABILITIES

AMERICANS WITH DISABILITIES

FIRE ALARM SYSTEM FIRE FIGHTER PHONE JACK FIGHTER FIGHTER PHONE FACTORY MUTUAL FIRE ALARM POWER-LIMITED PLENUM RATED (WIRE/CABLE) FLOW SWITCH GENERAL CONTRACTOR HEAT DETECTOR INTERNATIONAL BUILDING CODE INITIATING DEVICE CIRCUIT INTERNATIONAL FIRE CODE INCHES

NEW/PROPOSED NOTIFICATION APPLIANCE CIRCUIT NATIONAL ELECTRICAL CODE NFPA NATIONAL FIRE PROTECTION ASSOCIATION NON-POWER LIMITED FIRE ALARM (WIRE/CABLE) NOT IN CONTRACT NATIONAL INSTITUTE FOR **CERTIFICATION IN ENGINEERING**

TECHNOLOGIES

JUNCTION BOX

NOT IN SCOPE NOT TO SCALE POC POINT OF CONNECTION POINT OF DEMOLITION POWER-LIMITED FIRE ALARM (WIRE/CABLE) PRESSURE SWITCH EXISTING TO BE DEMOLISHED / RELOCATED FROM EXISTING

LOCATION

TROUBLE

CURRENT

TAMPER SWITCH

WEATHER PROOF

VOLTAGE - ALTERNATING

VOLTAGE - DIRECT CURRENT

SECURITY ALARM

SIGNALING LINE CIRCUIT SLC SMK SMOKE DETECTOR SPK SPEAKER CIRCUIT STROBE CIRCUIT STB SS SECURITY SURVEILLANCE SQFT SQUARE FEET SUP SUPERVISORY

VAC

VDC

REVISIONS

REVISIONS

DATE

ISSUE



CONSTRUCTION DOCUMENTS PROJECT COORDINATOR

LEEANN SUEN

PROFESSIONAL / CHASE MILLER \ENGINEER / PE096224 /

SMP ARCHITECTS 1600 Walnut Street, 2nd Floor Philadelphia, Pennsylvania 19103

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CITY OF PHILADELPHIA DEPARTMENT OF PARKS & RECREATION

PENNSYLVANIA

1515 ARCH STREET 11TH FLOOR, ONE PARKWAY BUILDING

PHILADELPHIA

AS NOTED

RENOVATIONS TO THE HAPPY HOLLOW RECREATION CENTER


FIRE ALARM GENERAL NOTES.

SYMBOLS AND ABBREVIATIONS 16315E-03-02 05/13/2025

> AAS ALL DIMENSIONS AND CONDITIONS SHALL BE VERIFIED BY THE


CONTACTOR AT THE SITE BEFORE PROCEEDING WITH THE WORL

- REFER TO DRAWING FA-001 FOR FIRE ALARM GENERAL NOTES, SYMBOLS AND ABBREVIATIONS.
- 2. EXISTING FIRE ALARM SYSTEM SHALL REMAIN OPERATIONAL DURING CONSTRUCTION.
- 3. THIS DRAWING IS SHOWN FOR REFERENCE ONLY TO INDICATE THE FIRE ALARM EXISTING CONDITIONS. THERE IS NO FIRE ALARM DEMOLITION SCOPE ON THIS DRAWING.

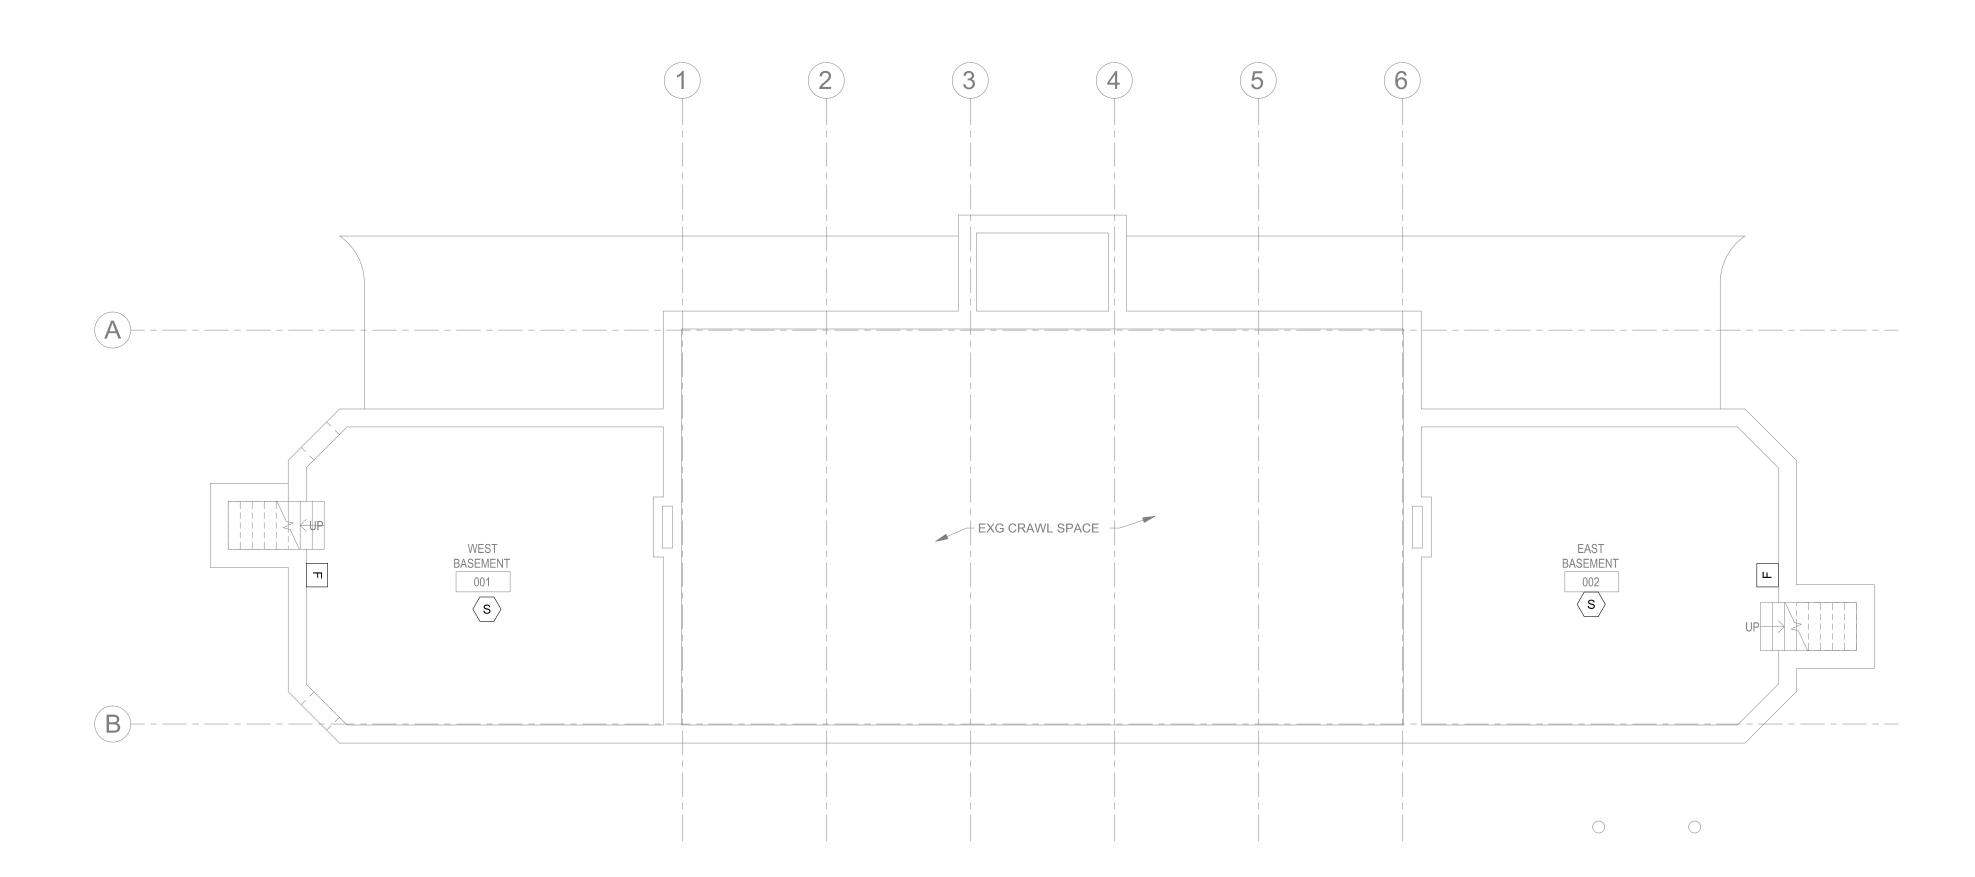





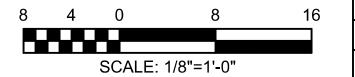


REVISIONS								
ISSUE	DATE	REVISIONS						



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CITY OF PHILADELPHIA DEPARTMENT OF PARKS & RECREATION

1515 ARCH STREET 11TH FLOOR, ONE PARKWAY BUILDING

PHILADELPHIA PENNSYLVANIA

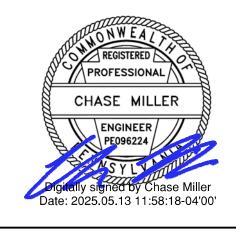RENOVATIONS TO THE HAPPY HOLLOW RECREATION CENTER

FIRE ALARM DEMOLITION BASEMENT PLAN


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	16315E-03-02	
DATE	05/13/2025	ℍ AD-10′
SCALE	AS NOTED	
DRAWN	BY AAS	
CHECKE	AJB	FILE:

CONSTRUCTION DOCUMENTS

- REFER TO DRAWING FA-001 FOR FIRE ALARM GENERAL NOTES, SYMBOLS AND ABBREVIATIONS.
- EXISTING FIRE ALARM SYSTEM SHALL REMAIN OPERATIONAL DURING CONSTRUCTION.

KEYED NOTES:


- 1 DEMOLISH EXISTING SMOKE DETECTOR. REMOVE CONDUIT AND WIRING BACK TO NEAREST JUNCTION BOX OR DEVICE TO REMAIN WHILE MAINTAINING CIRCUIT INTEGRITY.
- DEMOLISH EXISTING NOTIFICATION APPLIANCES.
 REMOVE CONDUIT AND WIRING BACK TO NEAREST
 JUNCTION BOX OR APPLIANCE TO REMAIN WHILE
 MAINTAINING CIRCUIT INTEGRITY.

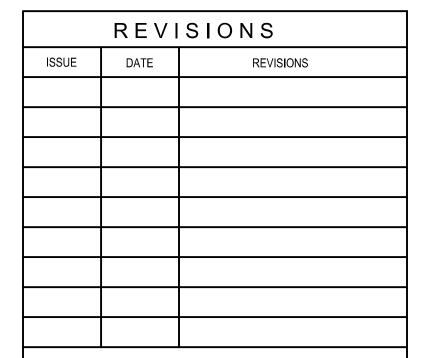



CONSTRUCTION DOCUMENTS

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CITY OF PHILADELPHIA DEPARTMENT OF PARKS & RECREATION

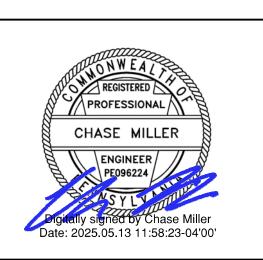1515 ARCH STREET 11TH FLOOR, ONE PARKWAY B

11TH FLOOR, ONE PARKWAY BUILDING
PHILADELPHIA PENNSYLVANIA

JECT TITLE


RENOVATIONS TO THE HAPPY HOLLOW RECREATION CENTER

DRAWING TITLE

SCALE: 1/8"=1'-0"

FIRE ALARM DEMOLITION FIRST FLOOR PLAN

PROJECT NO	•	DRAWING NO.
16	6315E-03-02	
DATE	05/13/2025	†AD-102
SCALE	AS NOTED]
DRAWN BY	AAS	
CHECKED BY	AJB	FILE:
NOTE:	ALL DIMENSIONS AND CONDITIONS S CONTACTOR AT THE SITE BEFORE PR	

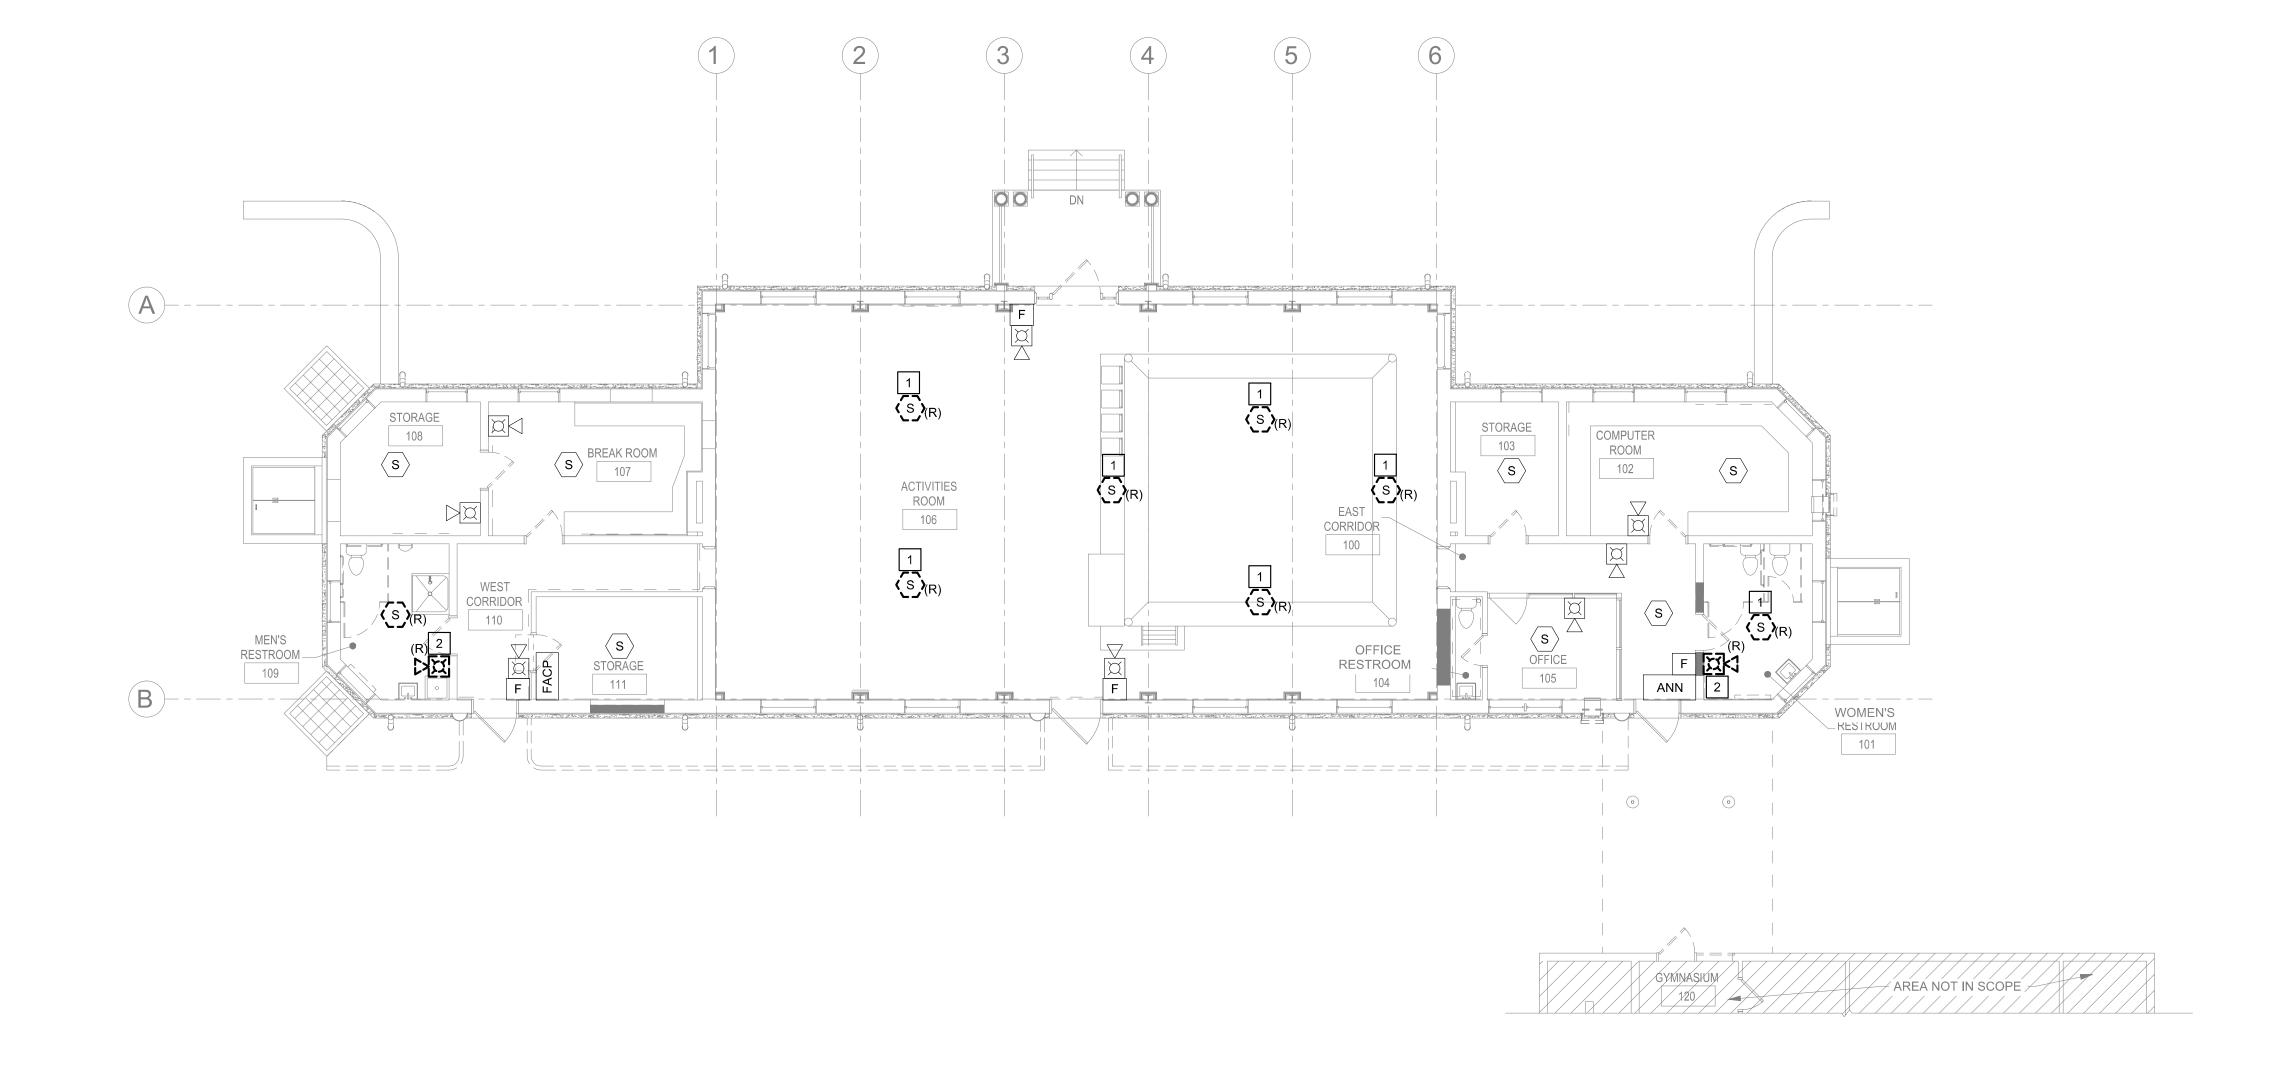



AREA NOT IN SCOPE

- REFER TO DRAWING FA-001 FOR FIRE ALARM GENERAL NOTES, SYMBOLS AND ABBREVIATIONS.

- EXISTING FIRE ALARM SYSTEM SHALL REMAIN OPERATIONAL DURING CONSTRUCTION.

KEYED NOTES:

1) PROVIDE NEW FIRE ALARM NOTIFICATION APPLIANCE. PROVIDE WITH A PROTECTIVE GUARD.

	REVISIONS								
,	ISSUE	DATE	REVISIONS						
).									



CONSTRUCTION DOCUMENTS

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CITY OF PHILADELPHIA DEPARTMENT OF PARKS & RECREATION

PENNSYLVANIA

1515 ARCH STREET

11TH FLOOR, ONE PARKWAY BUILDING

PHILADELPHIA


RENOVATIONS TO THE HAPPY HOLLOW RECREATION CENTER

SCALE: 1/8"=1'-0"

FIRE ALARM BASEMENT PLAN

	,			
1	6315E-03-02			
DATE	05/13/2025	FA-101		
SCALE	AS NOTED			
DRAWN BY	AAS			
CHECKED B	Y AJB	FILE:		
NOTE:	ALL DIMENSIONS AND CONDITIONS SHALL BE VERIFIED BY THE CONTACTOR AT THE SITE BEFORE PROCEEDING WITH THE WORK			

CONSTRUCTION DOCUMENTS

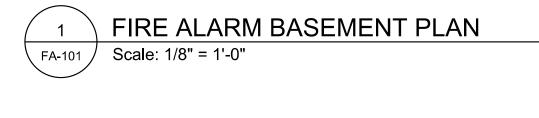


EXG CRAWL SPACE +

- REFER TO DRAWING FA-001 FOR FIRE ALARM GENERAL NOTES, SYMBOLS AND ABBREVIATIONS.
- 2. REFER TO DRAWINGS FA-500 AND FA-501 FOR ASSOCIATED DETAILS.
- 3. EXISTING FIRE ALARM SYSTEM SHALL REMAIN OPERATIONAL DURING CONSTRUCTION.
- 4. ALL FIRE ALARM FIELD DEVICES AND EQUIPMENT SHALL REQUIRE A PROTECTIVE GUARD.

1) ALTERNATE TRANSMITTER AND RECEIVER / REFLECTOR DIRECTIONS. MOUNT BEAM SMOKE DETECTOR AND RECEIVER / REFLECTOR TO THE WALL AND ALIGN AT A HEIGHT TO BE ABOVE THE LARGE OPEN CEILING BEAMS IN ACCORDANCE WITH THE MANUFACTURER'S INSTALLATION INSTRUCTIONS. PROVIDE WITH A PROTECTIVE

KEYED NOTES:


- 2 PROVIDE ADDRESSABLE DUAL INPUT MODULES AT EACH BEAM SMOKE DETECTOR TO MONITOR ALARM AND TROUBLE CONDITIONS IN ACCORDANCE WITH THE MANUFACTURER'S INSTALLATION INSTRUCTIONS. PROVIDE WITH A PROTECTIVE GUARD.
- PROVIDE NEW FIRE ALARM NOTIFICATION
 APPLIANCE PER THE NEW ARCHITECTURAL FLOOR
 PLAN. PROVIDE WITH A PROTECTIVE GUARD.
- PROVIDE NEW SMOKE DETECTOR PER THE NEW ARCHITECTURAL FLOOR PLAN. PROVIDE WITH A PROTECTIVE GUARD.

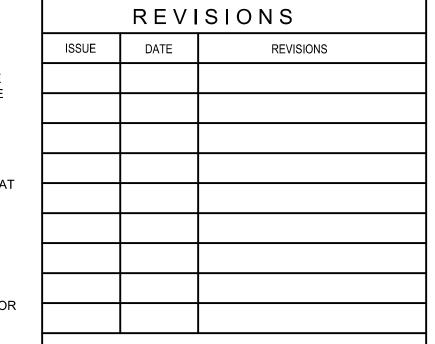



CONSTRUCTION DOCUMENTS

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CITY OF PHILADELPHIA DEPARTMENT OF PARKS & RECREATION

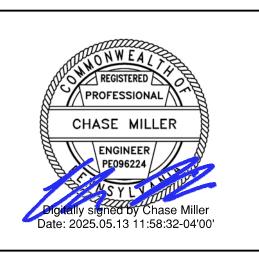1515 ARCH STREET 11TH FLOOR, ONE PARKWAY BUILDING PHILADELPHIA


PENNSYLVANIA

RENOVATIONS TO THE HAPPY **HOLLOW RECREATION CENTER**

FIRE ALARM FIRST FLOOR PLAN

PROJECT NO.		DRAWING NO.
16	6315E-03-02	
DATE	05/13/2025	FA-102
SCALE	AS NOTED	
DRAWN BY	TM	
CHECKED BY	PL	FILE:
NOTE:	ALL DIMENSIONS AND CONDITIONS SI	


CONSTRUCTION DOCUMENTS

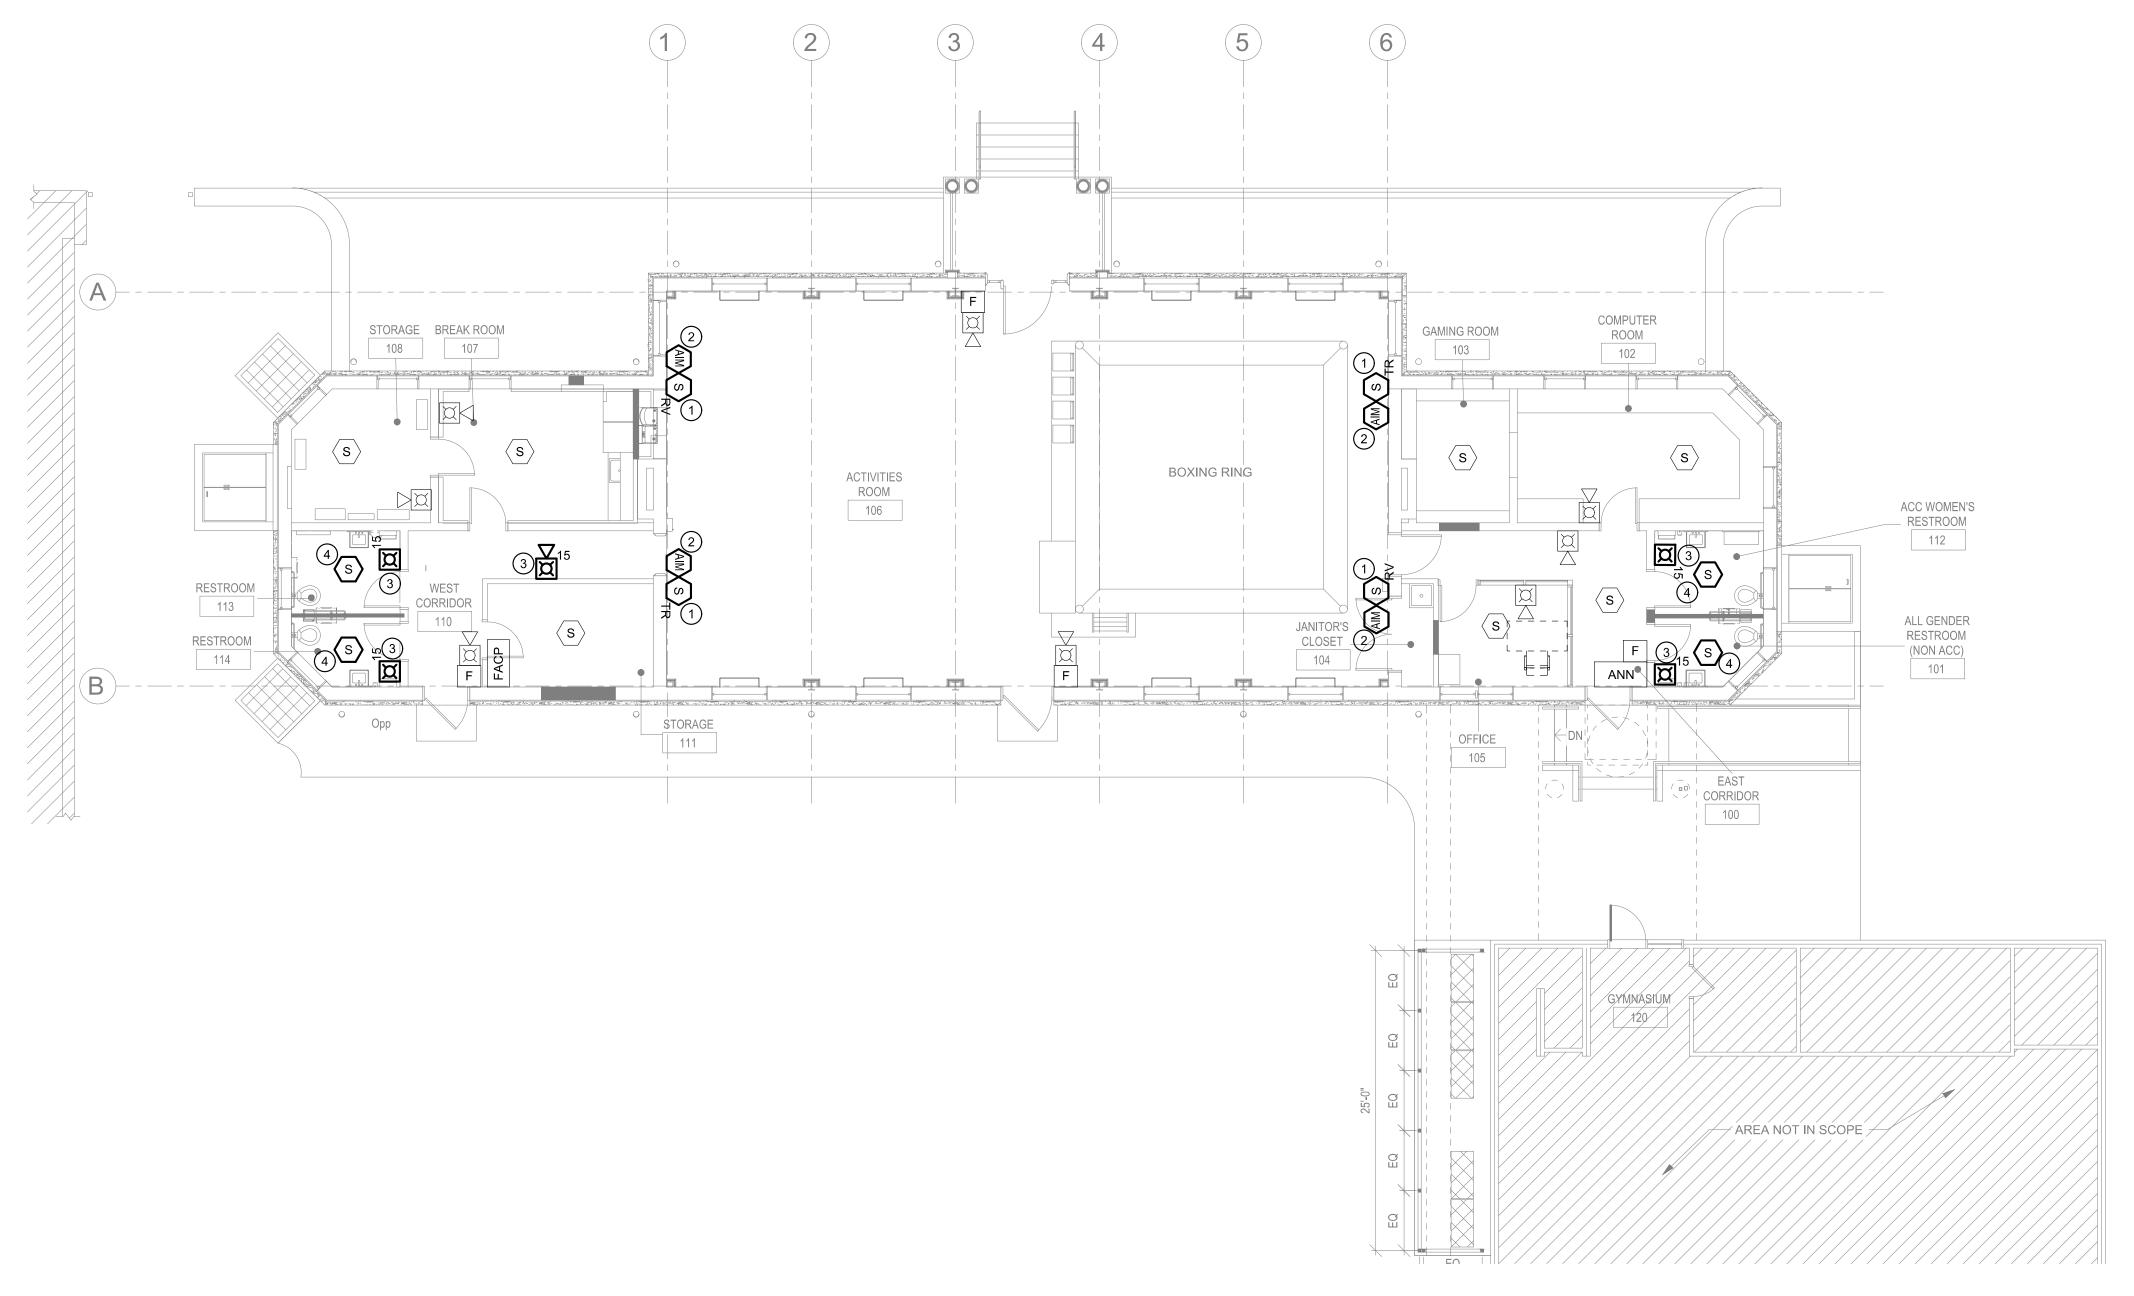

FIRE ALARM FIRST FLOOR PLAN


Scale: 1/8" = 1'-0"

SCALE: 1/8"=1'-0"

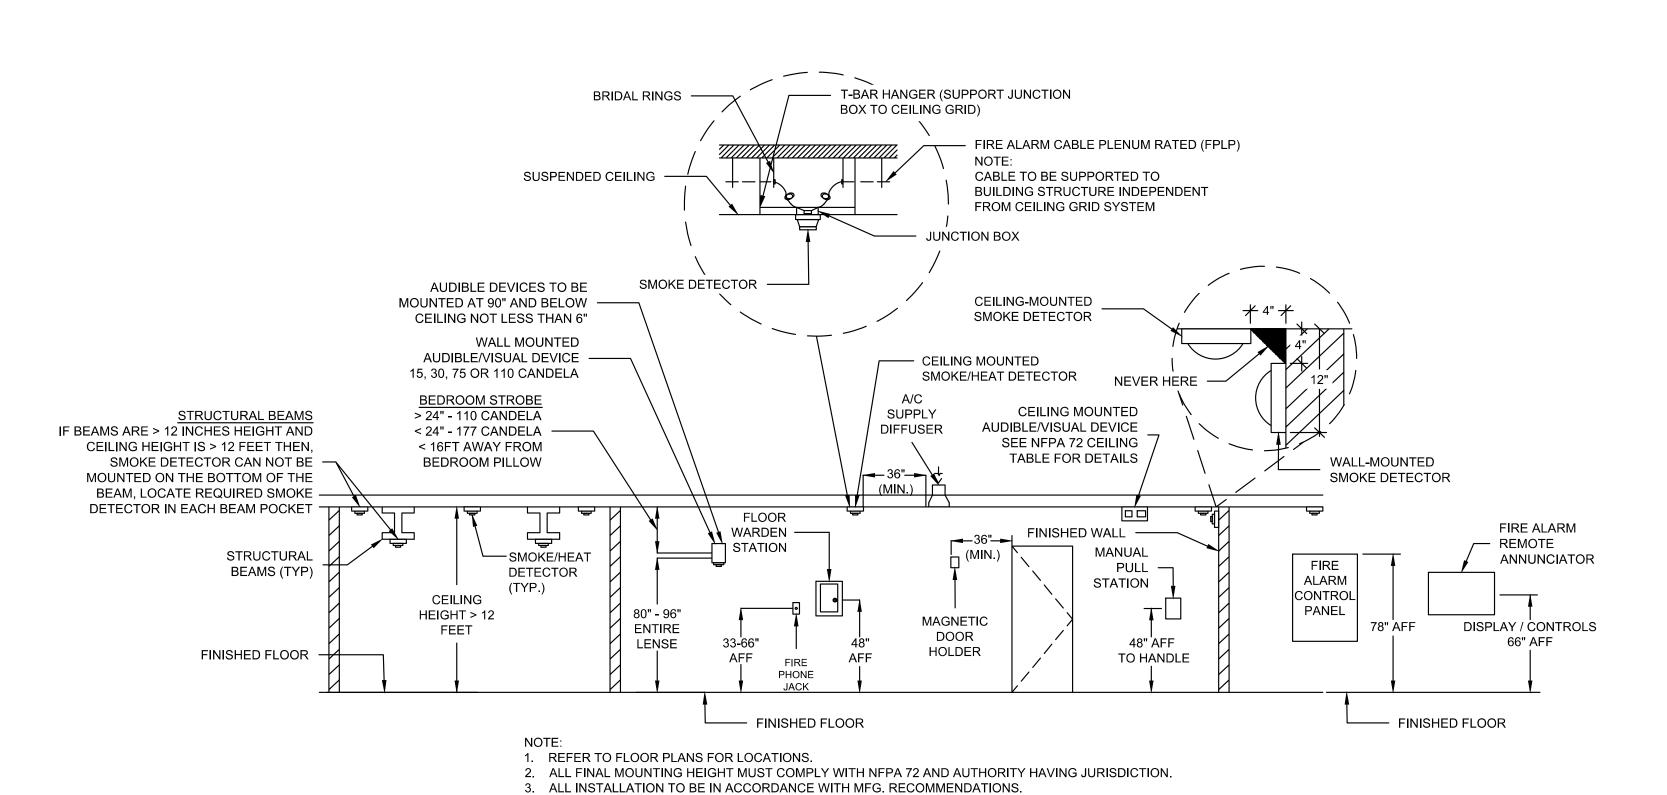

4. FLOOR WARDEN STATION AND FIRE PHONE JACK TO BE LOCATED TEN FEET AWAY FROM SPEAKER AND HORN.


1 STANDARD FIRE ALARM DEVICE MOUNTING HEIGHTS FA-500 NOT TO SCALE

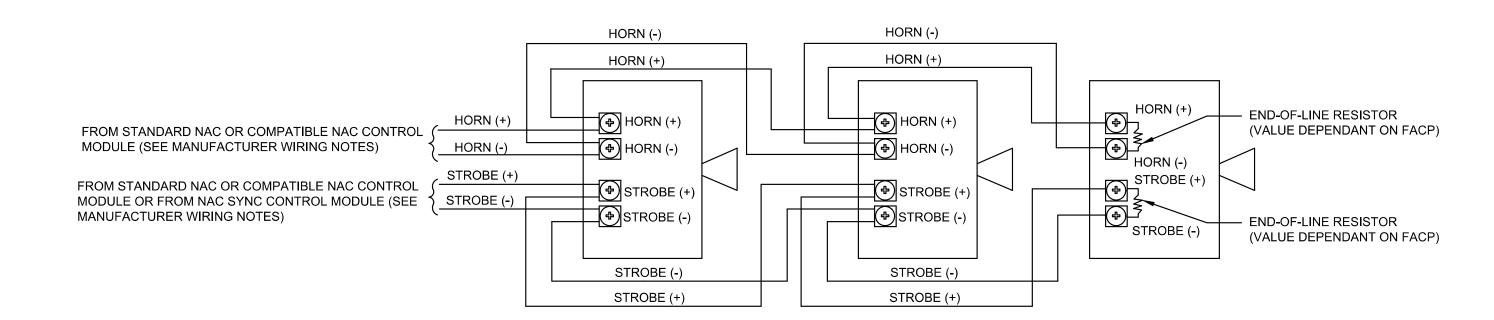


TYPICAL HORN/STROBE WIRING CONFIGURATION
NOT TO SCALE


GENERAL NOTES:

- 1. REFER TO SHEET FA-001 FOR FIRE ALARM GENERAL NOTES, SYMBOLS, AND ABBREVIATIONS.
- 2. DETAILS SHOWN ARE TYPICAL IN NATURE AND NOT INTENDED TO BE THE ACTUAL DEVICE OR EQUIPMENT. DETAILS ARE INCLUDED TO PROVIDE INTENT FOR INSTALLATION AND OPERATION. FIRE ALARM VENDOR SHALL SUPPLY REQUIRED DETAILS WITH INSTALLATION INSTRUCTIONS.

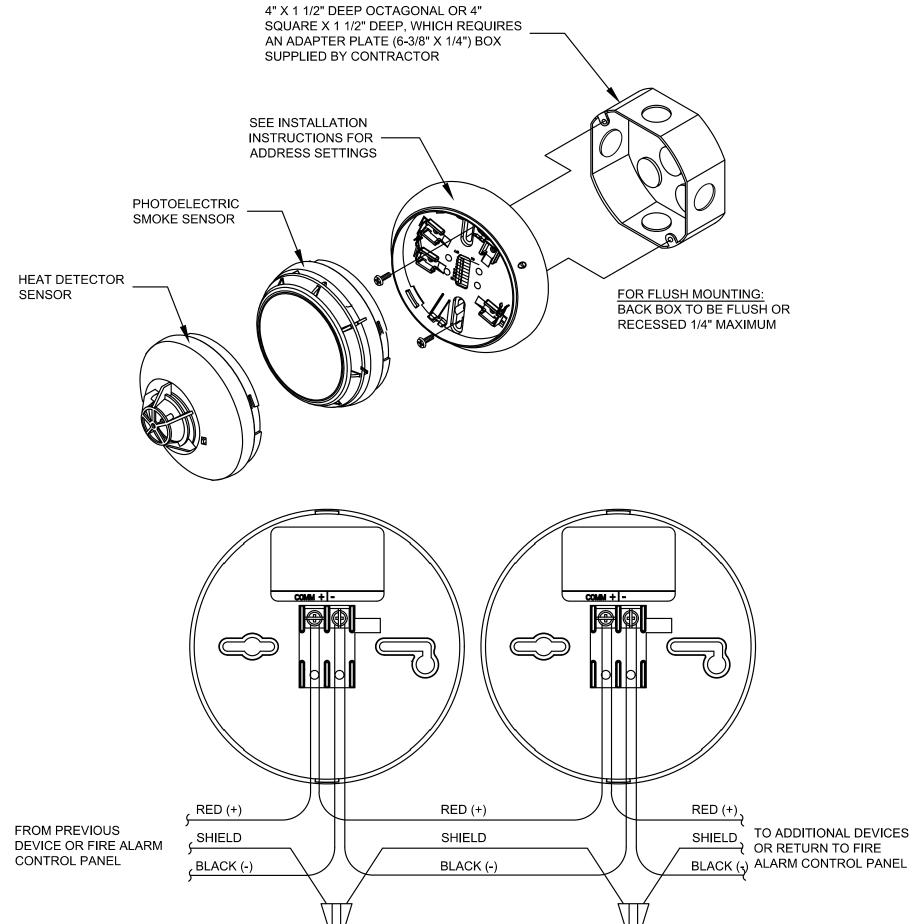

2 SMOKE / HEAT DETECTOR MOUNTING - TYPICAL NOT TO SCALE

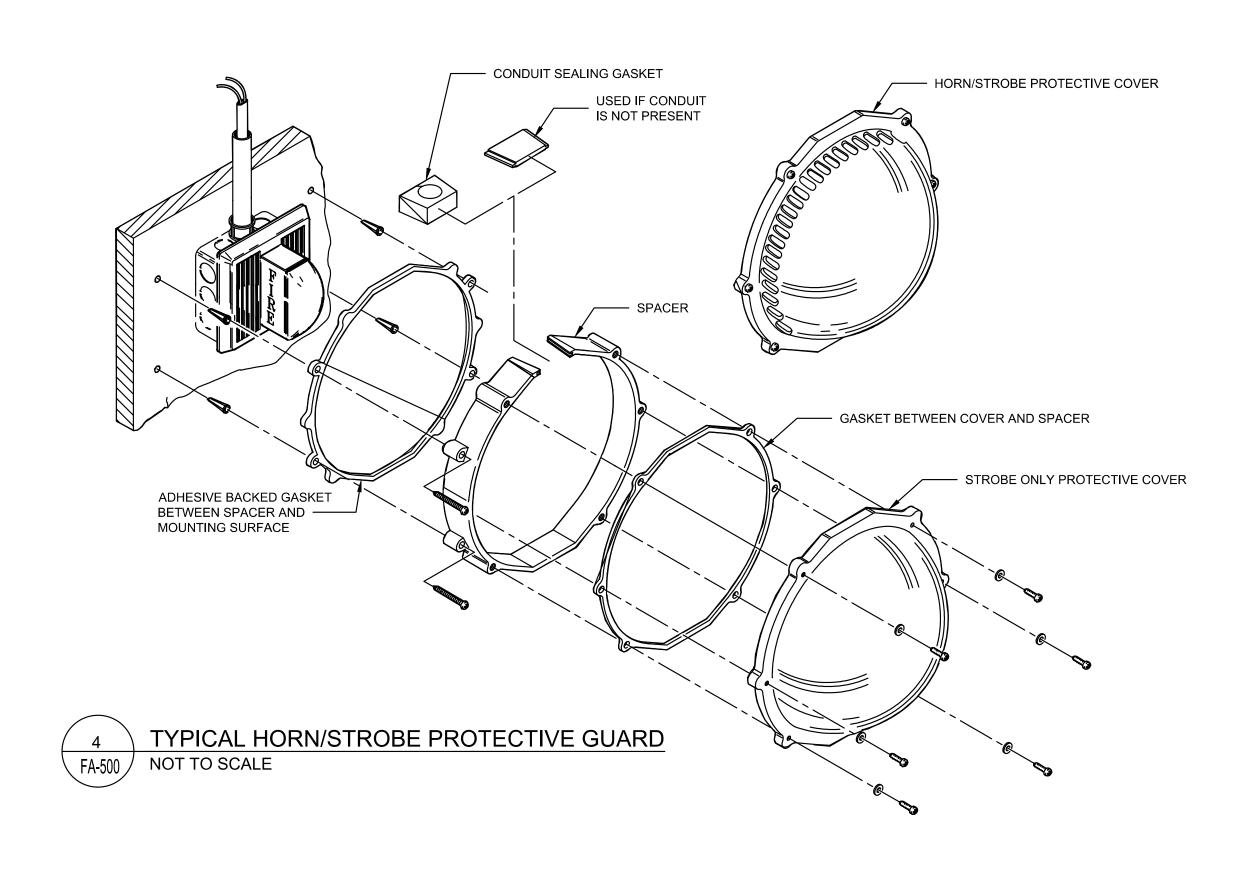

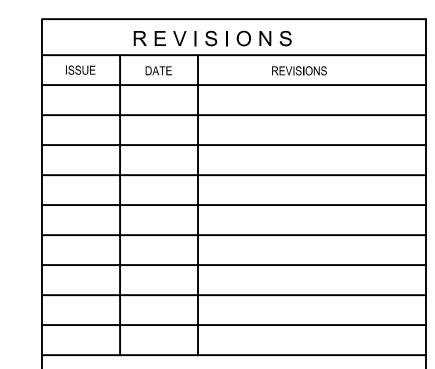



CONSTRUCTION DOCUMENTS

PROJECT COORDINATOR

LEEANN SUEN

PROFESSIONAL

CHASE MILLER

ENGINEER
PE096224

Digitally signed by Chase Miller
Date: 2025.05.13 11:58:37-04'00'

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CITY OF PHILADELPHIA
DEPARTMENT OF PARKS & RECREATION

1515 ARCH STREET 11TH FLOOR, ONE PARKWAY BUILDING

PHILADELPHIA PENNSYLVANIA


RENOVATIONS TO THE HAPPY HOLLOW RECREATION CENTER

FIRE ALARM DETAILS

CONSTRUCTION DOCUMENTS


ALL DIMENSIONS AND CONDITIONS SHALL BE VERIFIED BY THE

- REFER TO SHEET FA-001 FOR FIRE ALARM GENERAL NOTES, SYMBOLS, AND ABBREVIATIONS.
- 2. DETAILS SHOWN ARE TYPICAL IN NATURE AND NOT INTENDED TO BE THE ACTUAL DEVICE OR EQUIPMENT. DETAILS ARE INCLUDED TO PROVIDE INTENT FOR INSTALLATION AND OPERATION. FIRE ALARM VENDOR SHALL SUPPLY REQUIRED DETAILS WITH INSTALLATION INSTRUCTIONS.

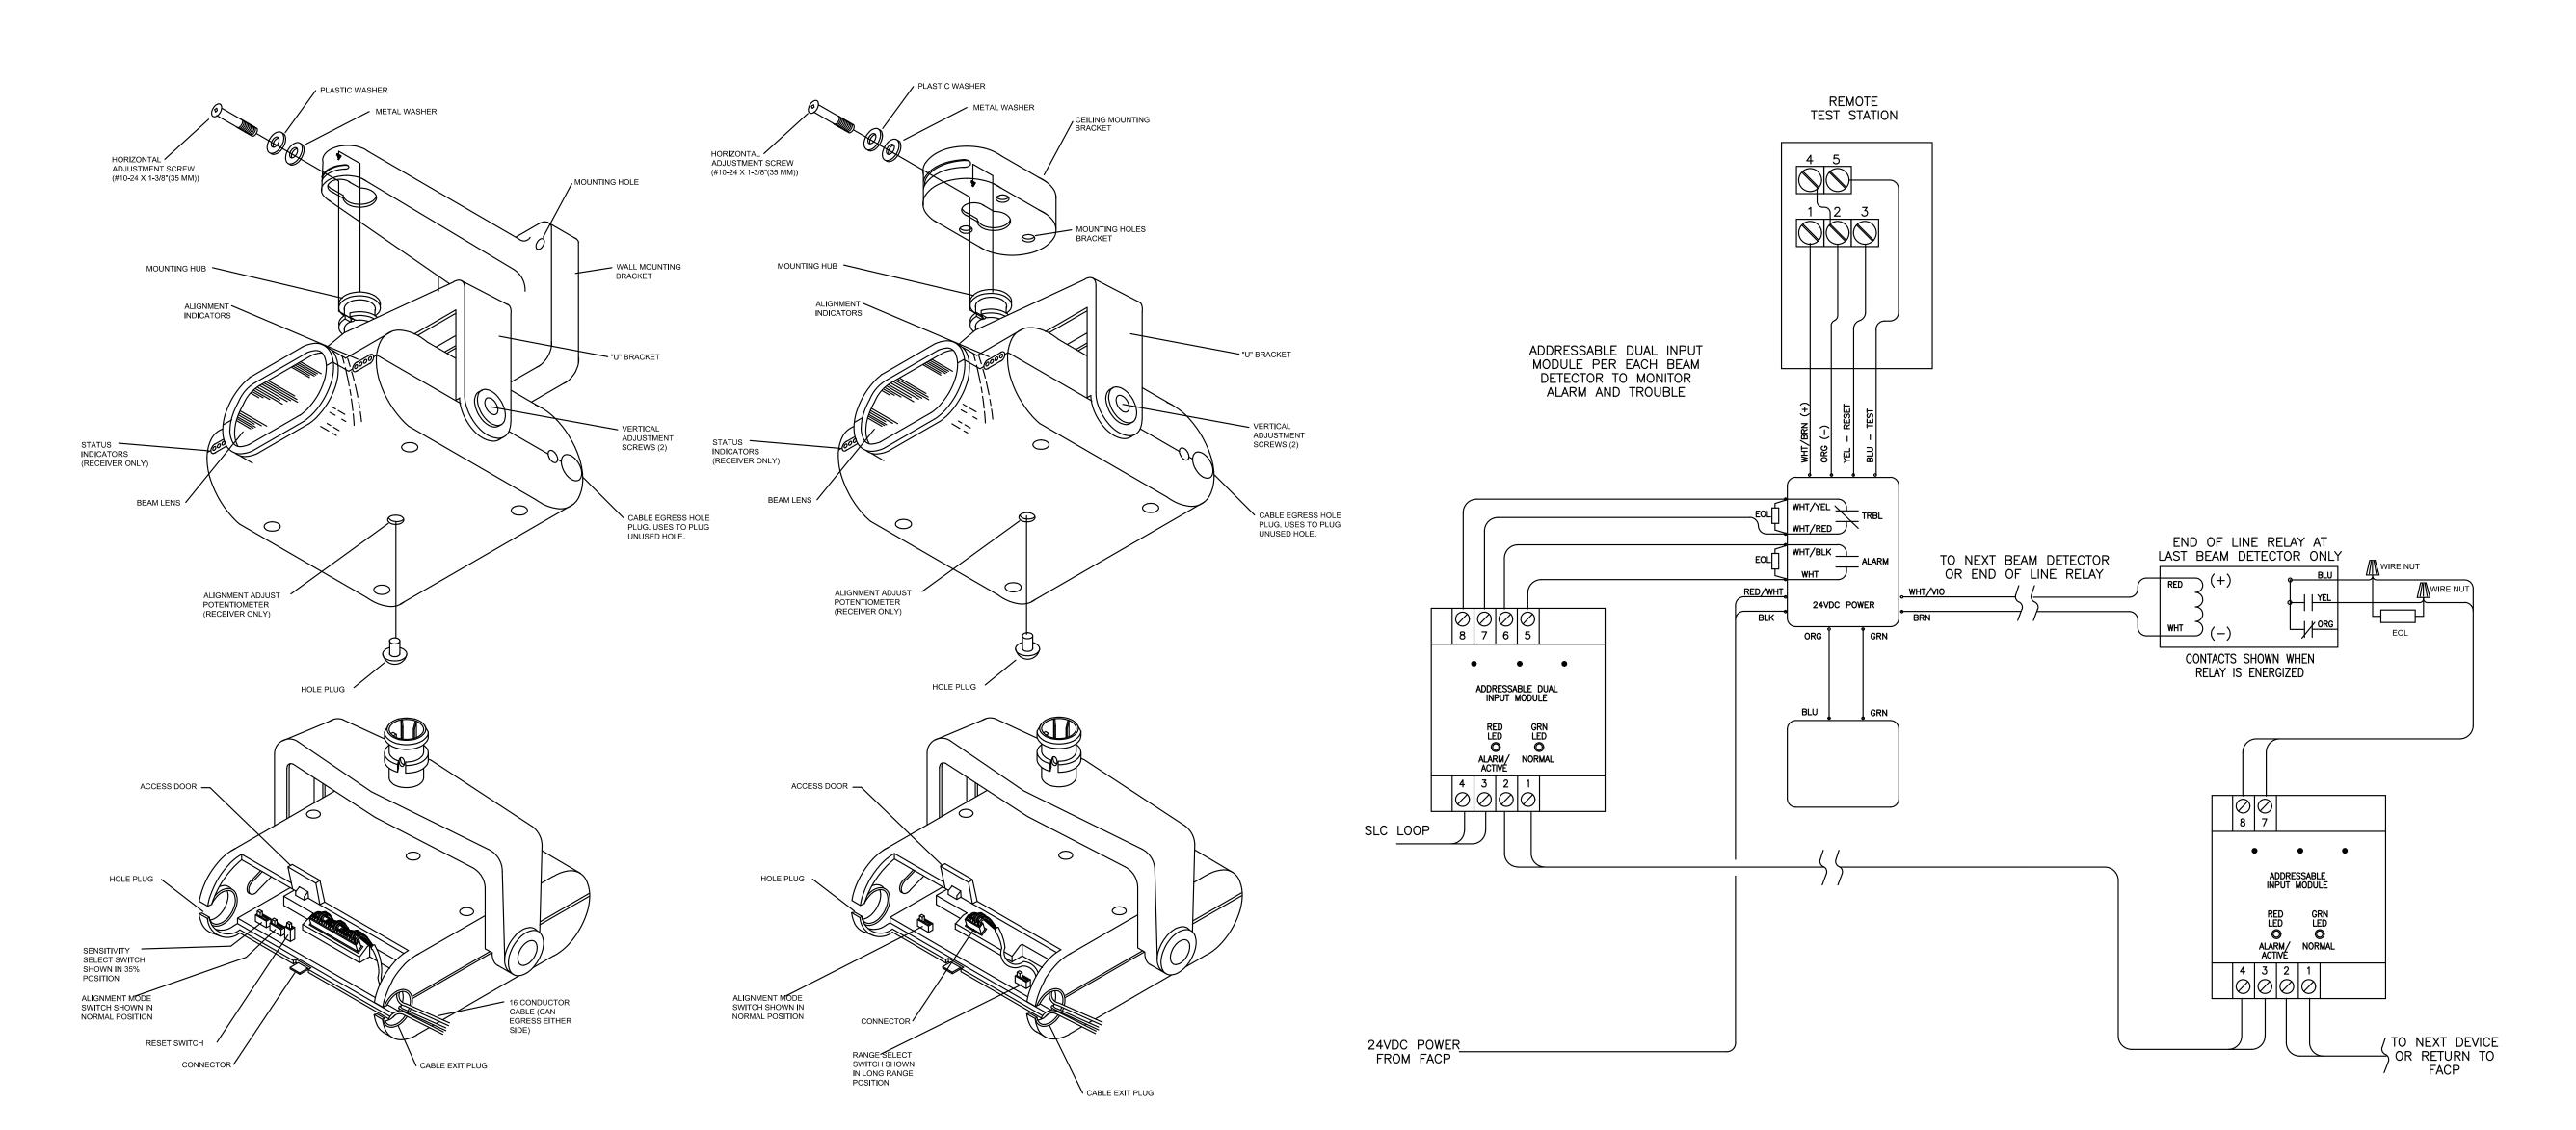

1 BEAM SMOKE DETECTOR MOUNTING DETAIL
NOT TO SCALE



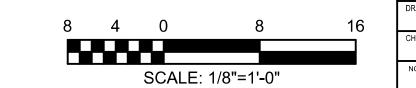

REVISIONS							
ISSUE	DATE	REVISIONS					




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CITY OF PHILADELPHIA
DEPARTMENT OF PARKS & RECREATION

1515 ARCH STREET 11TH FLOOR, ONE PARKWAY BUILDING

111H FLOOR, ONE PARKWAY BUILDING

PHILADELPHIA PENNSYLVANIA

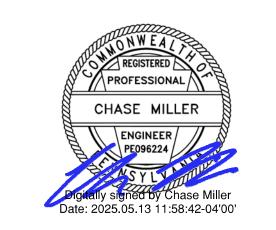RENOVATIONS TO THE HAPPY

HOLLOW RECREATION CENTER

WING TITLE

FIRE ALARM DETAILS

DJECT NO.		DRAWING NO.
16	315E-03-02	
ΓE	05/13/2025	FA-501
ALE	AS NOTED	
AWN BY	AAS	
ECKED BY	AJB	FILE:
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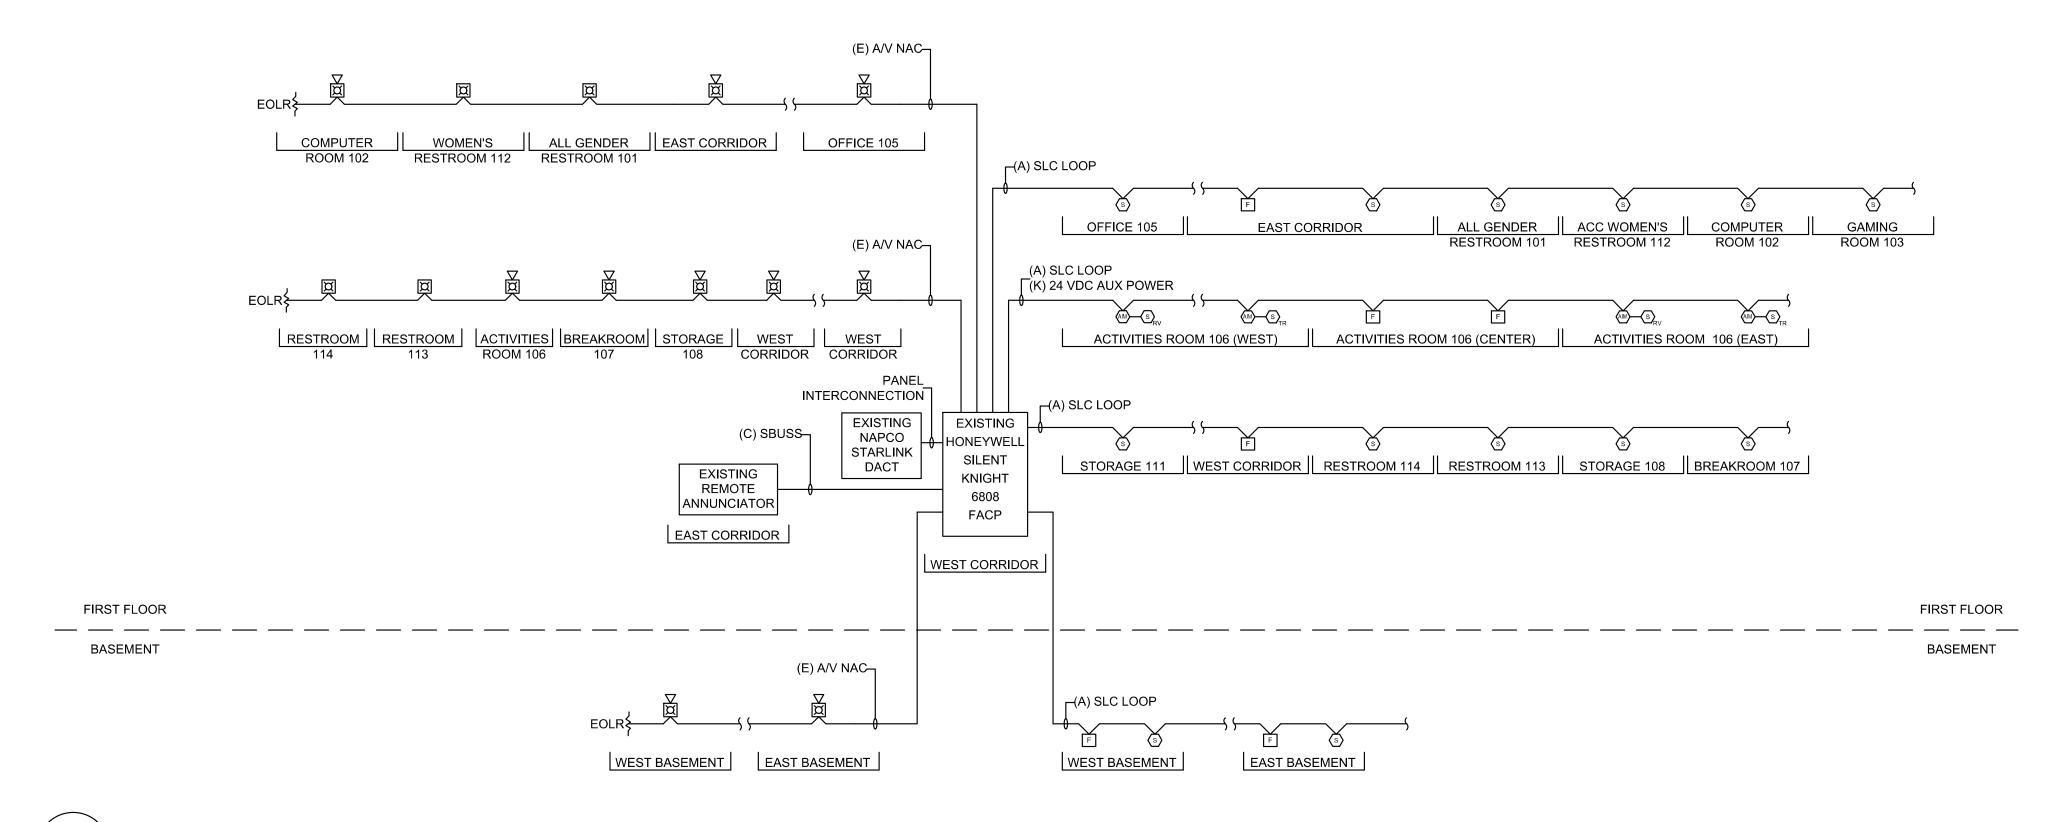
CONSTRUCTION DOCUMENTS

- 1. RISER DIAGRAM IS DIAGRAMMATIC AND INTENDED TO SHOW THE CONNECTIVITY BETWEEN ALL CONTROL
- EQUIPMENT AND FIELD DEVICES. 2. THE CONTRACTOR SHALL PROVIDE A COMPLETE RISER DIAGAM AS PART OF THE SHOP DRAWING
- 3. A FINAL UPDATED VERSION OF THE AS-BUILT RISER DIAGRAM SHALL BE INCLUDED WITH CLOSE-OUT DOCUMENTATION PER SPECIFICATIONS.

CIRCUIT SCHEDULE

CIRCUIT ID	PATHWAY DESCRIPTION	WIRE TYPE	MINIMUM CONDUIT SIZE	OUTDOOR UNDERGROUND	OUTDOOR ABOVE GROUND - NON CORROSIVE AREA	OUTDOOR ABOVE GROUND - CORROSIVE AREA	INDOOR	PATHWAY CLASS	MINIMUM NFPA 72 (2010 ED.) SURVIVABILITY REQUIREMENT
А	SIGNALING LINE CIRCUITS (SLC)	2#16 AWG TWISTED SHEILDED	3/4" C	PVC	RGS	RGS W/ PVC COATING	RGS	Х	LEVEL 0
В	FIBER OPTIC NETWORK	12-STRAND SINGLE MODE FIBER	3/4" C	PVC	RGS	RGS W/ PVC COATING	RGS	В	LEVEL 0
С	DATA COMMUNICATIONS BETWEEN PANELS	2#14 AWG TWISTED SHIELDED	3/4" C	PVC	RGS	RGS W/ PVC COATING	RGS	В	LEVEL 0
D	DIGITAL AUDIO COMMUNICATIONS BETWEEN PANELS	2#14 AWG TWISTED SHIELDED	3/4" C	PVC	RGS	RGS W/ PVC COATING	RGS	В	LEVEL 0
E	AUDIBLE/VISUAL CIRCUITS	2#14 AWG TWISTED SHIELDED	3/4" C	PVC	RGS	RGS W/ PVC COATING	RGS	В	LEVEL 0
F	STROBE CIRCUITS	2#14 AWG TWISTED	3/4" C	PVC	RGS	RGS W/ PVC COATING	RGS	В	LEVEL 0
G	CONTROL CIRCUITS	2#16 AWG TWISTED	3/4" C	PVC	RGS	RGS W/ PVC COATING	RGS	N/A	LEVEL 0
Н	MONITORING CIRCUITS	2#16 AWG TWISTED	3/4" C	PVC	RGS	RGS W/ PVC COATING	RGS	В	LEVEL 0
ı	ANNUNCIATOR CIRCUIT	2#14 AWG TWISTED	3/4" C	PVC	RGS	RGS W/ PVC COATING	RGS	В	LEVEL 0
J	PANEL AC POWER	2#12 TWISTED WITH GROUND	3/4" C	PVC	RGS	RGS W/ PVC COATING	RGS	N/A	LEVEL 0
К	24V DC AUXILIARY POWER	2#14 AWG TWISTED	3/4" C	PVC	RGS	RGS W/ PVC COATING	RGS	N/A	LEVEL 0
L	SYNC COMMUNICATIONS BETWEEN PANELS	2#12 AWG TWISTED SHIELDED	3/4" C	PVC	RGS	RGS W/ PVC COATING	RGS	N/A	LEVEL 0
М	DATA COMMUNICATIONS BETWEEN PANELS UNDERGROUND	2-STRANDS SINGLE MODE FIBER	3/4" C	PVC	RGS	RGS W/ PVC COATING	RGS	В	LEVEL 0
N	DIGITAL AUDIO COMMUNICATIONS BETWEEN PANELS UNDERGROUND	2-STRANDS SINGLE MODE FIBER	3/4" C	PVC	RGS	RGS W/ PVC COATING	RGS	В	LEVEL 0

FIRE ALARM CIRCUIT AND CONDUIT SCHEDULE



FIRE ALARM PARTIAL DIAGRAMMITIC RISER DIAGRAM

REVISIONS							
ISSUE	DATE	REVISIONS					



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CITY OF PHILADELPHIA DEPARTMENT OF PARKS & RECREATION

1515 ARCH STREET 11TH FLOOR, ONE PARKWAY BUILDING

PHILADELPHIA

RENOVATIONS TO THE HAPPY **HOLLOW RECREATION CENTER**

PENNSYLVANIA

FIRE ALARM DETAILS, SCHEDULES AND RISER DIAGRAM

16315E-03-02 05/13/2025 AS NOTED AAS CHECKED BY AJB ALL DIMENSIONS AND CONDITIONS SHALL BE VERIFIED BY THE CONTACTOR AT THE SITE BEFORE PROCEEDING WITH THE WORK