ADDENDUM COVER SHEET

Addendum No. 2 Fotteral Square RFP (2400 N. 11th Street) Philadelphia Redevelopment Authority

Issue Date: July 21, 2022

ITEMS:

 Questions and Answers (Attached with accompanying 	z int	formation
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Bidders must acknowledge receipt of Addendum No. 2. The signed acknowledgement must be included in you bid proposal. Please sign and date below:

Acknowledgement of Addendum No. 2

1. Is it possible to extend the bid due date?

Response: No

2. In the 002113-1 spec for project to be completed in 120 days.

Response: The bid completion time is updated from 120 to 190 calendar days from the Notice to Proceed.

a. Is there a schedule available that shows this schedule?

Response: No

b. 60 days from bid due to award a NTP is an end of September start, 120 calendar days would be a beginning of February 2023 finish. Is this correct?

Response: The bid completion time is updated from 120 to 190 calendar days from the Notice to Proceed.

c. Will any delays beyond our control be allowed to adjust the completion date. Response: See Specifications regarding allowable time extensions.

d. Will the Contractor be responsible for specified materials deliveries that are not available within this 120 day schedule after the required contracted buyout, submittal, approval &/or fabrication time have been allocated on the schedule?
 Response: See Specifications regarding allowable time extensions.

e. Will anyone besides the Contractor have access to the construction work area?
 Response: No

- 3. Will any work not shown be required outside of a curb to curb construction work limit lines? Response: Only if necessary for the work of this contract, for example utility connections.
- 4. 012200-1 specified unit prices for additional work due to unforeseen conditions, with the City reserving the right to negotiate or bid out this additional work.
 - a. If this work is to occur, will the job completion date equitably adjusted? Response: See Specifications regarding allowable time extensions.
 - b. These unit prices listed are all shown on the plans. What about unforeseen conditions as specified or not specified in the plans or specs?

Response: See Specifications regarding change orders and unit prices.

- 013113 Project Coordination specifies separate Prime Contractors. Will there be other Prime Contractors on the site at the same time as the General Contractor?
 Response: This is a single prime bid. See Specifications regarding the City's rights to perform other work if necessary.
- 6. 012600 specifies Owner or Contractor initialed change orders for unforeseen conditions, but further specifications contradict this spec section. Please clarify the following:

a. 024119-2 E specifies Haz Mat remediation is this to be included unclassified and within the 120 days?

Response: All work that is part of this contract is to be completed within the allowed contract time. See Specifications regarding allowable time extensions.

b. 312000 excavation unsuitable and materials requiring special handling is this to be included unclassified and within the 120 days?

Response: All work that is part of this contract is to be completed within the allowed contract time. See Specifications regarding allowable time extensions. Include a unit price per CY for excavation and removal of unclassified soil conditions.

7. Drawing E-001 General Note #30: Please confirm "all underground conduit will be galvanized rigid steel" instead of PVC which is the Recreation Dept. norm. This will add over 20% to the electrical quote in manhours and material.

Response: Rigid PVC conduit shall be used for all underground raceways in areas not regularly subject to vehicular traffic, for raceways in concrete walls, floors, and ceilings, and for raceways to be run through cinder fill. Provide a separate, code-sized ground wire in each PVC conduit.

8. Drawing E-001-Pole and Base Detail: Are two Polymer-Concrete junction boxes required at each pole, one for power and one for cameras? Pole diameter is too small to loop conduits in and out.

Response: A single junction box may be used at each pole if it complies with all codes.

9. At the pre-bid meeting it was stated ground disturbance would need not to exceed one acre or contractor was responsible for additional permit costs. Did this one acre limit include the conduit excavation (1500'L X 2'W X 3'D) and the approx.. 500 square feet for pole bases and the junction boxes?

Response: Yes, the 1 acre disturbance limit includes all disturbance associated with the work on this project regardless of discipline. The Contractor will be responsible for ensuring that the work performed is limited to the Disturbance shown on the plan and the Contractor will be responsible should any delays or fees occur due to excessive disturbance.

10. Do we mount head end equipment for CCTV cameras in existing storage shed? Is space available for the equipment? Drawings show none of the equipment needed to support the Cameras System.

Response: Yes, Contractor to mount head end equipment for CCTV cameras in existing storage shed. Yes, there is space available for equipment. Please refer to the specifications section 282300 – Video Surveillance for equipment information.

11. Drawing E-200-Owner furnished pole lights: Will lights be furnished with all accessories (2" slip fitter) for contractor to install?

Response: Two new lights will be added to the existing pole to face the mini-pitch. The City will provide two light heads (cutsheet attached). The Contractor must provide all mounting hardware and accessories as necessary for a complete installation.

12. Electric Drawings do not meet L & I requirements for electrical permit. Will City supply the signed and sealed drawings with all electric information, or do we include costs to hire electrical engineer to prepare these drawings? This would take permit acquisition to four or five months.

Response: The city will supply signed and sealed drawings to the electrical contractor with all information require for electrical permit application. Contractor is not required to hire an electrical engineer to prepare the drawings.

13. Note on drawing E-200 "New light pole and head to replace existing (TYPICAL). Trace, identify and reuse existing conduit and circuit runs where practical. Where conduit is deemed unusable, provide wiring and conduit to connect. The existing wiring to poles is direct burial aluminum wire fed off the street from PECO. The new pole is 3 ½" and will not fit on existing bases. We also need camera wiring at 23 of the 25 poles which isn't addressed. How do you get conduit and wiring into an existing concrete pole base?

Response: Contractors to assume installation of all new pole bases, conduit, power wiring and camera wiring.

END

GENERAL ELECTRICAL NOTES:

- 1. ALL WORK SHALL CONFORM TO THE LATEST REQUIREMENTS OF THE NATIONAL ELECTRICAL CODE, PENNSYLVANIA CODES, NFPA, UL, THE LATEST ENERGY CONSERVATION CONSTRUCTION CODE, AND ALL OTHER GOVERNING AGENCIES HAVING JURISDICTION. ALL WORK SHALL BE PERFORMED BY A LICENSED ELECTRICAL CONTRACTOR AND FILED WILL ALL AUTHORITIES HAVING JURISDICTION.
- 2. THE ELECTRICAL CONTRACTOR SHALL VISIT AND CAREFULLY EXAMINE THE AREAS AFFECTED BY THIS WORK TO BECOME FAMILIAR WITH EXISTING CONDITIONS AND WITH DIFFICULTIES THAT WILL AFFECT THE EXECUTION OF THE WORK. CONTRACTOR SHALL PERFORM THIS PRIOR TO SUBMITTING HIS PROPOSAL. SUBMISSION OF A PROPOSAL WILL BE CONSTRUED AS EVIDENCE THAT SUCH AN EXAMINATION HAS BEEN MADE AND LATER CLAIMS WILL NOT BE RECOGNIZED FOR EXTRA LABOR, EQUIPMENT OR MATERIALS REQUIRED BECAUSE OF DIFFICULTIES ENCOUNTERED WHICH COULD HAVE BEEN FORESEEN HAD SUCH AN EXAMINATION BEEN MADE.
- 3. SUBSEQUENT TO AWARD OF THE CONTRACT, THE ELECTRICAL CONTRACTOR SHALL SUBMIT A PROPOSED SCHEDULE OF WORK TO THE ARCHITECT. THE SCHEDULE SHALL BE MODIFIED AS NECESSARY AND RE-ISSUED WHEN ANY CHANGES THERETO ARE REQUIRED.
- 4. THE DRAWINGS INDICATE SIZE AND GENERAL LOCATION OF WORK. SCALED DIMENSIONS SHALL NOT BE USED. THE EXACT LOCATIONS AND ELEVATIONS OF ALL LIGHTING FIXTURES, ETC., SHALL BE DETERMINED BY THE ARCHITECT AND OWNER.
- 5. THE ELECTRICAL CONTRACTOR SHALL MAKE AN APPLICATION TO THE UTILITY COMPANY FOR A NEW ELECTRICAL SERVICE AND SHALL INSTALL THE NEW ELECTRICAL SERVICE IN ACCORDANCE WITH THE UTILITY COMPANY SERVICE LAYOUT AND REQUIREMENTS. SERVICE EQUIPMENT INTERRUPTING RATINGS SHALL BE COORDINATED WITH THE SHORT CIRCUIT AVAILABILITY AS PROVIDED BY THE UTILITY COMPANY.
- 6. CIRCUIT NUMBERS INDICATED ON PLANS ARE FOR GROUPING PURPOSES ONLY. WHERE DRAWINGS CALL FOR SEPARATE NEUTRAL WIRES OR DEDICATED CIRCUITS, THE ELECTRICAL CONTRACTOR SHALL PROVIDE CIRCUITS WITH PROPER PHASE SEQUENCING FOR EVERY SHARED NEUTRAL WIRE.
- 7. BRANCH CIRCUITS SHALL BE ARRANGED TO BALANCE LOADS TO THE EXTENT POSSIBLE. LOADS IMBALANCES BETWEEN PHASES SHALL NOT EXCEED 10%.
- 8. ALL PANELS SHALL HAVE COMPLETE DIRECTORIES INDICATING LOADS SERVED AS WELL AS SPARES AND SPACES.
- 9. ELECTRIC PANEL COVERS SHALL NOT BE LEFT OFF AT ANY TIME UNLESS CONTRACTOR'S PERSONNEL ARE WORKING ON SAME. COVERS SHALL BE REPLACED AT THE END OF THE WORK DAY.
- PROVIDE GROUND WIRE IN ALL FEEDERS TO MOTORIZED EQUIPMENT.
- 11. PROVIDE ARC FAULT CIRCUIT BREAKERS OR RECEPTACLES WHERE
- 12. PROVIDE GROUND FAULT CIRCUIT BREAKERS OR RECEPTACLES WHERE INDICATED OR WHERE REQUIRED BY CODE.
- 13. ANY ELECTRICAL EQUIPMENT INDICATED OUTDOORS SHALL BE WEATHERPROOF IN NEMA 3R ENCLOSURES.

INDICATED OR WHERE REQUIRED BY CODE.

- 14. ALL DEVICE COLORS AND FINISHES. AND MOUNTING HEIGHTS OF ELECTRICAL DEVICES SHALL BE IN ACCORDANCE TO ARCHITECTURAL DRAWINGS.
- 15. 1/2" CONDUIT SHALL BE THE MINIMUM SIZE CONDUIT INSTALLED.
- 16. ARMOR CLAD (AC) OR METAL-CLAD CABLE (MC) MAY BE USED AS PERMITTED BY CODE. ELECTRICAL METALLIC TUBING (EMT) MAY BE USED WITH SET SCREW TYPE FITTINGS.
- 17. FLEXIBLE METALLIC CONDUIT (FMC) (GREENFIELD) SHALL BE USED FOR FINAL CONNECTION TO MOTORS AND TO RECESSED MOUNTED LIGHTING FIXTURES. LENGTH SHALL NOT EXCEED 6 FEET.
- 18. WHERE MORE THAN ONE SWITCH IS INSTALLED IN THE SAME LOCATION, THEY SHALL BE INSTALLED IN A MULTI- GANG BOX UNDER ONE COVER PLATE.
- 19. ALL MATERIALS SHALL BE NEW AND SHALL CONFORM WITH THE STANDARDS OF THE UNDERWRITERS LABORATORIES, INC. (UL) WHERE SUCH A STANDARD HAS BEEN ESTABLISHED FOR THE PARTICULAR TYPE OF MATERIAL IN QUESTION, UNLESS OTHERWISE NOTED.
- 20. THE CONTRACTOR SHALL SUBMIT CATALOG CUTS AND SHOP DRAWINGS OF ALL DEVICES, EQUIPMENT AND MATERIAL PROPOSED TO BE USED TO THE ARCHITECT AND ENGINEER FOR REVIEW AND APPROVAL. A SHOP DRAWING LOG SHALL BE MAINTAINED BY THE CONTRACTOR AND STATUS OF SUBMISSIONS SHALL BE UPDATED AT LEAST BI-WEEKLY.
- 21. THE ELECTRICAL CONTRACTOR SHALL COORDINATE HIS WORK WITH OTHER TRADES AND CONTRACTORS WHOSE WORK MIGHT AFFECT THIS INSTALLATION.
- 22. BEFORE INSTALLING ANY WORK, THE CONTRACTOR, SHALL CONFIRM THAT IT DOES NOT INTERFERE WITH CLEARANCES REQUIRED FOR EQUIPMENT, FINISHES AND OTHER ITEMS, AS SHOWN ON THE ARCHITECTURAL DRAWINGS AND DETAILS. IF ANY WORK IS SO INSTALLED AND IT LATER DEVELOPS THAT SUCH DETAILS OR DESIGN CANNOT BE FOLLOWED, THIS CONTRACTOR AT HIS OWN EXPENSE SHALL MAKE SUCH CHANGES IN THE WORK AS NECESSARY AND AS DIRECTED BY THE ARCHITECT, TO PERMIT THE INSTALLATION OF THE ARCHITECTURAL WORK AS SHOWN ON THE PLANS AND DETAILS.
- 23. DURING THE PROJECT DURATION, THE ARCHITECT AND ENGINEER WILL INSPECT THE WORK PROGRESS. ANY WORK WHICH IS JUDGED UNSATISFACTORY FOR ANY REASON OR NOT IN COMPLIANCE WITH THE CONTRACT, CODE, OR STANDARDS SHALL BE REMOVED AND REPLACED AS DIRECTED AND AT THE EXPENSE OF THE CONTRACTOR.
- 24. CHOPPING OR CHASING OF MASONRY MUST BE COORDINATED WITH THE ENGINEER AND ARCHITECT PRIOR TO COMMENCING WORK.
- 25. UPON COMPLETION OF THE WORK, A SET OF "AS-BUILT" DRAWINGS SHALL BE SUBMITTED TO THE ENGINEER FOR REVIEW AND ACCEPTANCE. FINAL AS-BUILTS SHALL BE SUBMITTED TO THE OWNER PRIOR TO PROJECT CLOSEOUT.
- 26. THE ENERGIZATION OF THE ELECTRICAL INSTALLATION DOES NOT CONSTITUTE AN ACCEPTANCE OF THE WORK BY THE OWNER. FINAL ACCEPTANCE IS TO BE MADE AFTER THE CONTRACTOR HAS DEMONSTRATED THAT THE WORK FULFILLS THE REQUIREMENTS OF THE PLANS AND SPECIFICATIONS AND HAS FURNISHED ALL REQUIRED CERTIFICATES OF APPROVAL FROM THE STATE AUTHORITIES, MUNICIPAL AUTHORITIES AND UNDERWRITERS.
- 27. ELECTRICAL CONTRACTOR SHALL FILE FOR NECESSARY INSPECTIONS AND SHALL PROVIDE AN ELECTRICAL INSPECTION APPROVAL CERTIFICATE TO THE ARCHITECT UPON COMPLETION OF THE WORK.
- 28. ALL ELECTRICAL WORK TO CONFORM TO NEC AND LOCAL ELECTRICAL CODES.
- 29. THE ELECTRICAL SYSTEM SHALL BE GROUNDED IN ACCORDANCE WITH NEC REQUIREMENTS. ALL NON-CURRENT METAL PARTS SHALL BE CONNECTED TO THE GROUNDING SYSTEM. PROVIDE GROUND ROD IN FIRST BOX & BOND TO CONDUIT.

30. ALL UNDERGROUND CONDUIT SHALL BE HOT DIPPED GALVANIZED STEEL

- WITH WARNING TAPE ABOVE IT. RIGID PVC CONDUIT IS ACCEPTABLE TO USE FOR ALL UNDERGROUND RACEWAYS IN AREAS NOT REGULARLY SUBJECT TO VEHICULAR TRAFFIC. PROVIDE CODE-SIZED GROUND WIRE IN EACH PVC CONDUIT AS PER NEC 250. \wedge
- 31. FOR EXACT LAYOUT & EQUIPMENT LOCATIONS SEE LANDSCAPE PLAN
- 32. COORDINATE CONDUIT ROUTING/LAYOUT TO AVOID ANY EQUIPMENT FOOTINGS & TREE ROOTS.
- 33. EXCAVATION AROUND TREES SHALL BE PERFORMED BY HAND TO NOT DISTURB EXISTING ROOT SYSTEM.
- 34. MINIMUM SIZE WIRING SHALL BE #12. ELECTRICAL CONTRACTOR SHALL INCREASE WIRE SIZE AND CONDUIT AS NECESSARY TO MEET ALL VOLTAGE DROP LIMITATIONS

35. CONTRACTOR SHALL INSTALL PULL BOXES AS REQUIRED BY CODE AND TO FACILITATE CABLE INSTALLATION. COORDINATE LOCATIONS OF PULL BOXES WITH LANDSCAPE ARCHITECT PRIOR TO INSTALLATION.

TRENCHING NOTES

- 1. CONTRACTOR SHALL LOCATE ALL EXISTING UNDERGROUND UTILITIES PRIOR TO DIGGING.
- 2. ALL EXCAVATION IN THE AREA OF THE EXISTING UNDERGROUND EQUIPMENT, PIPES AND CONDUITS SHALL BE PERFORMED BY HAND.
- 3. ANY AREA PLANTS OR LANDSCAPING OR PAVEMENT DISTURBED DURING THE EXCAVATION SHALL BE RESTORED OR REPLACED TO MATCH
- 4. ANY EXISTING BURIED CONDUITS, DRAINAGE, SPRINKLER PIPING, ETC. THAT IS DISTURBED AND/OR DAMAGED DURING CONSTRUCTION SHALL BE REPAIRED BY THE CONTRACTOR AT NO COST TO THE OWNER.

EXISTING CONDITIONS BY THE CONTRACTOR AT NO COST TO THE OWNER.

5. CONTRACTOR SHALL VERIFY AND COORDINATE FOR EXISTING UNDERGROUND UTILITIES AND UTILITIES OF ALL OTHER TRADES TO BE INSTALLED AS PART OF THIS CONTRACT TO LOCATE FEEDERS SHOWN ON THESE DRAWINGS. THE CONTRACTOR IS WARNED THAT THE EXACT OR EVEN APPROXIMATE LOCATION OF SUCH UTILITY PIPELINES, SUBSURFACE STRUCTURES AND/OR UTILITIES IN THE AREA MAY OR MAY NOT BE SHOWN OR EXACTLY DEPICTED ON THE PLANS. IT IS RESPONSIBILITY OF THIS CONTRACTOR TO PROCEED WITH GREAT CARE IN EXECUTING ANY WORK.

SECURITY CAMERA NOTES

- 1. SECURITY CAMERA SHALL BE MOUNTED ON LIGHT POLES AS INDICATED ON THE DRAWINGS.
- 2. ALL SECURITY EQUIPMENT AND CAMERAS SHALL BE INSTALLED BY A GENETEC CERTIFIED INSTALLER.
- 3. GENETIC CERTIFIED INSTALLER SHALL AIM CAMERAS AND DEMONSTRATE TO THE OWNER COVERAGE, OPERABILITY AND TRAIN OWNER'S STAFF.
- 4. REFER TO SPECIFICATIONS SECTION 28 23 00 FOR CAMERA AND CABLING
- _SPECIFICATIONS._ VIDEO SURVEILLANCE SYSTEM SHALL BE GENETEC STANDARD OMNICAST PACKAGE WITH SECURITY CENTER BASE PACKAGE, OR APPROVED
- PRODUCT CODES ARE AS FOLLOWS: BASE PACKAGE: GSC-BASE-5.10
- a. CLIENT & WEB CONNECTION: GSC-1STU
- b. MOBILE CONNECTION: GSC-1MOBILESTU c. FAILOVER DIRECTORY: GSC-1FOD
- d. CAMERA INTEGRITY MONITOR: GSC-OM-1CIM-5K (ONE PER CAMERA
- NEEDED) e. OMNICAST STANDARD BASE PACKAGE: GSC-OM-S
- f. CAMERA CONNECTION: GSC-OM-S-1C
- g. DEMO LICENSE: GSC-DEMO-ACCESSVIDEO
- h. SERVER: SEE SPECS ATTACHED
- i. WORKSTATION: SEE SPECS ATTACHED

ELECTRICAL ABBREVIATIONS

(Up to 300 Mbps)

techdocs.genetec.com | Security Center System Requiremer EN.500.100-V5.10.0.0(1) | Last updated: April 9, 2021

Intel[®] Xeon[®] Silver 4210 2.2 GHz or better

Intel® Xeon® E5-2620 v4 2.10 GHz or bette

Dedicated video disks of at least 12 drives in RAID 5 or 6

Playback or Archive transfer should not exceed 100 Mbps³

80 GB SATA II hard drive or better for OS and Security Center applications, with a minimum of 15 GB of free disk space to install a Security Center server


64-bit operating system

32 GB of RAM or better 64-bit operating system

GbE network interface card

	(NOT ALL ABBREVIATIONS COULD BE USED))	
A	AMPERES	HZ	HERTZ
ACT AFF	ABOVE COUNTER TOP ABOVE FINISH FLOOR	JB	JUNCTION BOX
AWG	AMERICAN WIRE GAUGE	KVA	KILOVOLT AMPERES
BLDG	BUILDING	KW	KILOWATTS
С	CONDUIT	LP	PANEL DESIGNATION
CAT	CATALOG	LTG	LIGHTING
CAM	CAMERA	MAX	MAXIMUM
СВ	CIRCUIT BREAKER		
CKT	CIRCUIT	MCB	MAIN CIRCUIT BREAKER
CLG	CEILING	MECH	MECHANICAL
DGP	DATA GATHERING PANEL	MER	MECHANICAL EQUIPMENT ROOM
		MFS	MAIN FUSED SWITCH
DISC	DISCONNECT	MIN	MINIMUM
DN DR	DOWN DOOR RELEASE	MLO	MAIN LUGS ONLY
DWG	DRAWING	MTD	MOUNTED
		MW	MICROWAVE
ELEC	ELECTRICAL		
EM	EMERGENCY	N	NEUTRAL
EQUIP	EQUIPMENT	NC	NORMALLY CLOSED
		NIC	NOT IN CONTRACT
FACP	FIRE ALARM CONTROL PANEL	No.	NUMBER
FBO	FURNISH BY OTHER DIVISION OF WORK	NL	NIGHT LIGHT
FIXT	FIXTURE	NTS	NOT TO SCALE
FL	FLOOR	Р	POLE
FLEX	FLEXIBLE	PL	PROPERTY LINE BOX
FT	FEET OR FOOT	PC	PERSONAL COMPUTER (COMPUTER CIRCUIT)
GA	GAUGE	PNL	PANEL
G, GRD, GND	GROUND	Ø	PHASE
GC	GENERAL CONTRACTOR	SW	SWITCH
GFI	GROUND FAULT INTERRUPTER	SWBD	SWITCHBOARD
HD	HAND DRYER	SEB	SERVICE END BOX
HP	HORSEPOWER	TEL	TELEPHONE
HVAC	HEATING, VENTILATING AND AIR	TYP	TYPICAL
	CONDITIONING DIVISION OF WORK	U.O.N	UNLESS OTHERWISE NOTED
		UL	UNDERWRITERS LABORATORIES
		V	VOLTAGE

WP WEATHERPROOF

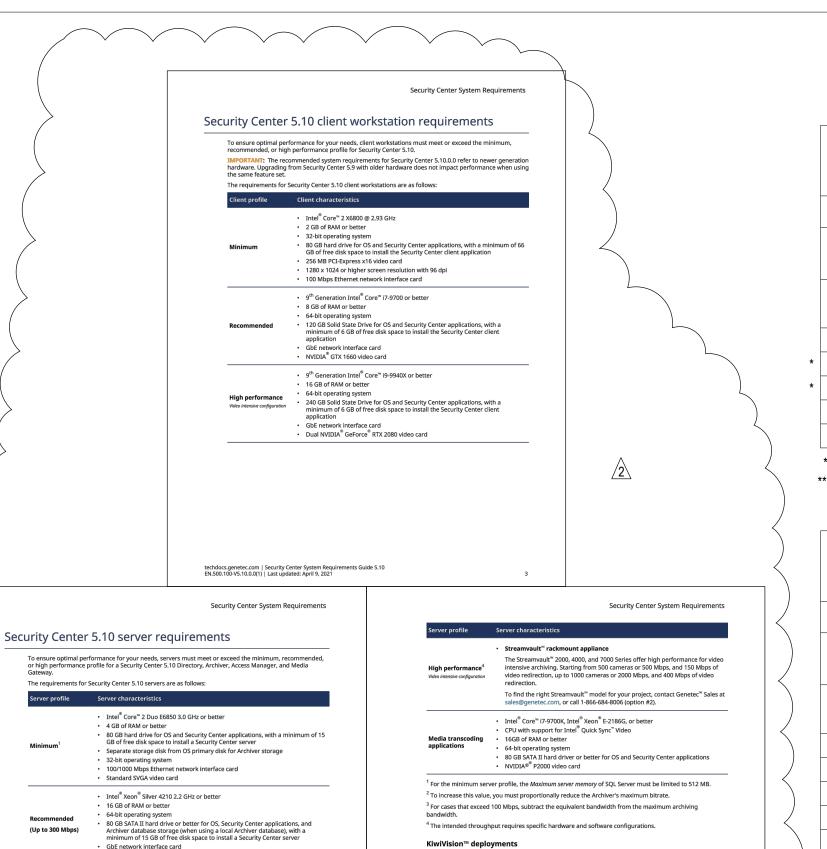

For the deployment of KiwiVision™ modules, use the KiwiVision™ Hardware Calculator.

techdocs.genetec.com | Security Center System Requiremen EN.500.100-V5.10.0.0(1) | Last updated: April 9, 2021

													VOLTS: 120/ PHASE: 1 20000 AIC FEEDER: SE		CHEDULE			
Е	BRANCH	CIRCUIT										В	RANCH CIRCUIT					
CIR(BRE/	CUIT AKER	LOAD	СО	NDUCTOR	СС	NDUIT	KW	MLB:1			_	RCUIT EAKER	LOAD	COI	NDUCTOR	СО	NDUIT	KW
Pole #	Trip AMP	DESIGNATION	No.	AWG MCM	No.	Size		A	В		Pole #	Trip AMP	DESIGNATION	No.	AWG MCM	No.	Size	
								lacksquare										
1	20	LIGHTING	2	12+1#12G	1	3/4"C	1	 •			2	20	GFCI	2	12+1#12G	1	3/4"C	
3	20	GFCI	2	12+1#12G	1	3/4"C	1	-	•	— —	4	20	SPACE					<u> </u>
5	20	SITE LIGHTING (NEW)	2	12+1#12G	1	3/4"C	1	•			6	2P /	PORTLAND LOO	3	SEE ONE			
7	20	SPACE						_	•	<u> </u>	8	60	PANEL (NEW)	3	LINE			5
		CUIT BREAKERS TO RE	MA	IN					<u> </u>								ТОТ	AL 10 KW 41 A
													VOLTS: 120/ PHASE: 1 20000 AIC FEEDER: SE		CHEDULE			
E	BRANCH	CIRCUIT										В	RANCH CIRCUIT					

														PHA 2000	TS: 120/ SE: 1 00 AIC DER: SE		CHEDULE			
E	BRANCH	CIRCUIT											E	BRANCH CIRC	UIT					
	CUIT AKER	LOAD	C	CONDUCTOR		CONDUIT		KW		MCA:60A		_	RCUIT EAKER	LOAD		CON	NDUCTOR	COI	NDUIT	KW
Pole #	Trip AMP	DESIGNATION	N	0.	AWG MCM	No.	Size		Α	\	В	Pole #	Trip AMP	DESIGNATIO	N	No.	AWG MCM	No.	Size	
1	20	INT LIGHTING		2 12	2+1#12G	1	3/4"C	1				2	20	GFI RECER	PT	2	12+1#12G	1	3/4"C	1
3	20	SITE LIGHTING		-	2+1#12G		3/4"C	1			•	4	20	HEAT TRA			12+1#12G		3/4"C	 1
5	20	PLBG HOTBO	X	2 12	2+1#12G	1	3/4"C	1		•		6	20	SPARE						
7	20	SPACE									•	8	20	SPACE						
₋lG⊦	ITING	FIXTUR	E SC	HE	EDUL	Ε										'				
CODE	SPECIFICATION LIGHT FIXTURE HEAD LIGHT FIXTURE POLE MANUFACTURER/ CATALOG NO.							LAMP TYPE	WATT	S	NOTES									
A ⊕						PTACLE A	ND	LED	32		0-10V DIM MOTION S REFER TO	SENSO	OR INTEG							
B ⊕	DSC4L (SELUX DSC4L-F	85R-S	1-5G350-	30-25	-BK-UNV-	MS	SELUX A35- AND CONCF					LED	32		0-10V DIM			RATED

REFER TO SPECIFICATION

OLE MOUNTED SECTION 28 23 00


DUPLEX RECEPTACLE GFIC DUPLEX RECEPTACLE W/ GROUND FAULT INTERRUPTER DISCONNECT SWITCH NEW ELECTRIC PANEL FLUSH MOUNTED U.O.N HOMERUN J		ELECTRIC LEGEND
DISCONNECT SWITCH NEW ELECTRIC PANEL FLUSH MOUNTED U.O.N HOMERUN J	Ф	
NEW ELECTRIC PANEL FLUSH MOUNTED U.O.N HOMERUN J	^{GFIC} ∯	DUPLEX RECEPTACLE W/ GROUND FAULT INTERRUPTER
HOMERUN		DISCONNECT SWITCH
J		NEW ELECTRIC PANEL FLUSH MOUNTED U.O.N
M		HOMERUN
\widehat{M}	J	
	M	

TABULAR ANALYSIS							
LIC	SHTIN	IG ALLOV	VANCE EXT	ER	IOR		
FIXTURE	WA	TTAGE	QUANTIT	Y	TOTAL		
POLE	;	32	25		800		
			FINAL		790 WATTS		
ALLOWABLE LIGHT DENSITY							
500W+ 0.05 W/SQS	SF	70,500	0 SQ FT		3525 WATTS		

ENERGY CODE COMPLIANCE NOTE:

1. ALL LIGHT DENSITY COMPLIES WITH


	DRAWING LIST	
E-001	ELECTRICAL NOTES, SYMBOLS & ABBREVIATIONS & SCHEDULES	
E-200	ELECTRICAL SITE PLAN	

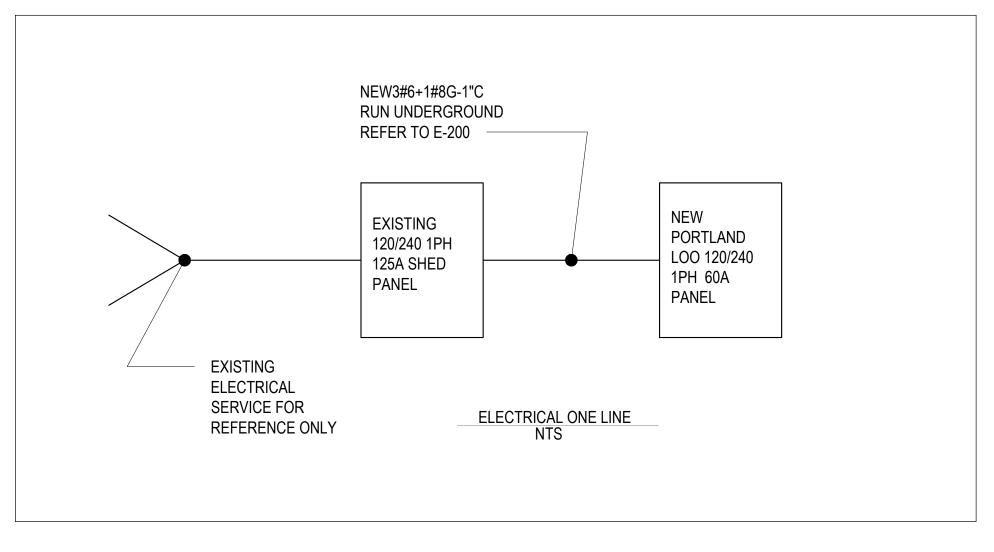


SECURITY CAMERA SCHEDULE


MANUFACTURER/ CATALOG NO.


AUTOVU SHARP V - POLE MOUNTED

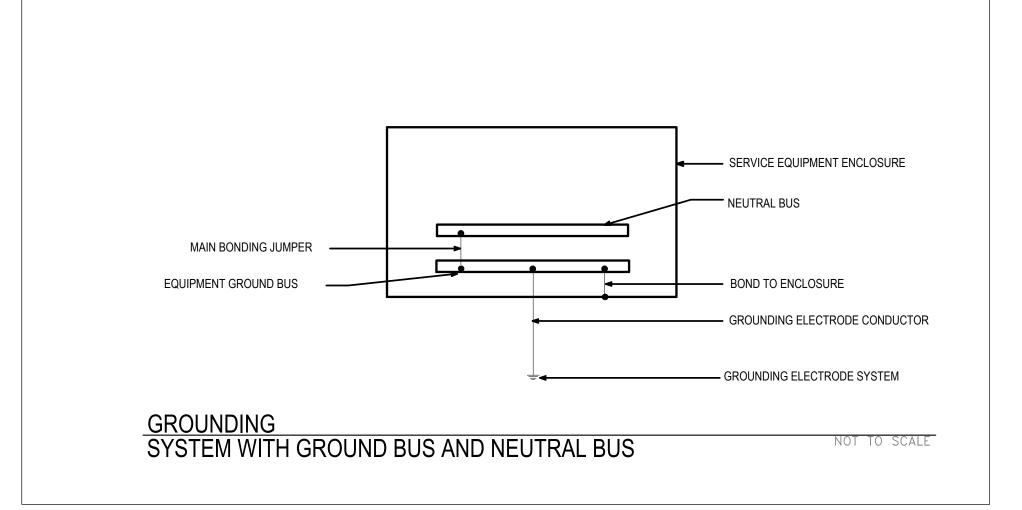

REFER TO LIGHT POLE DETAIL

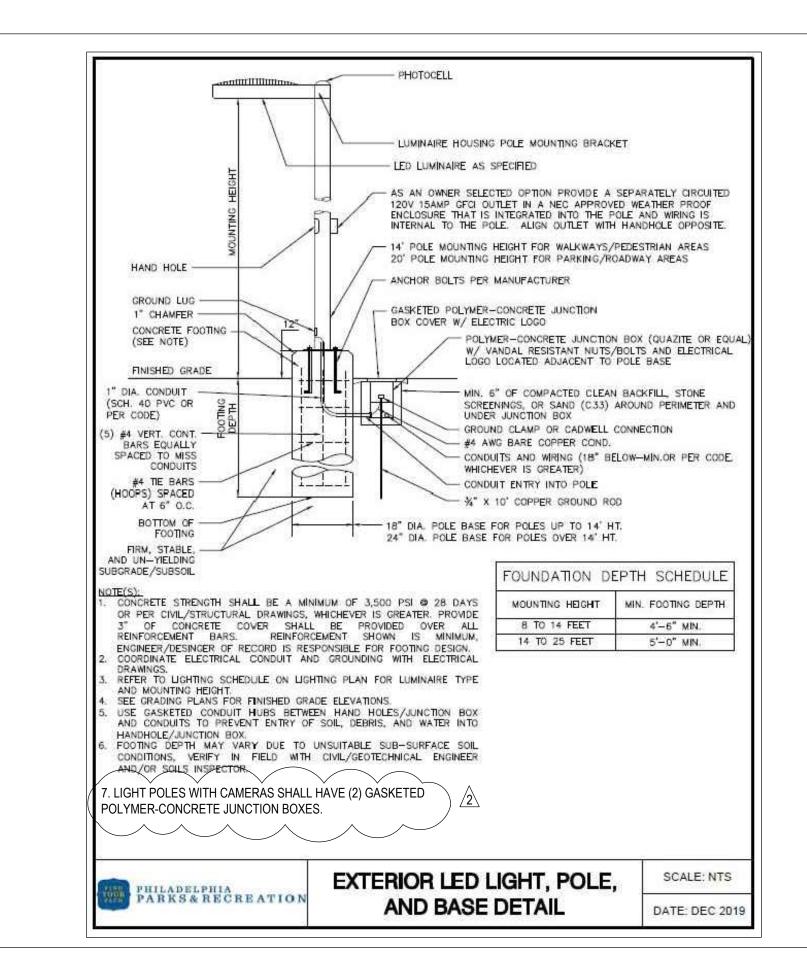

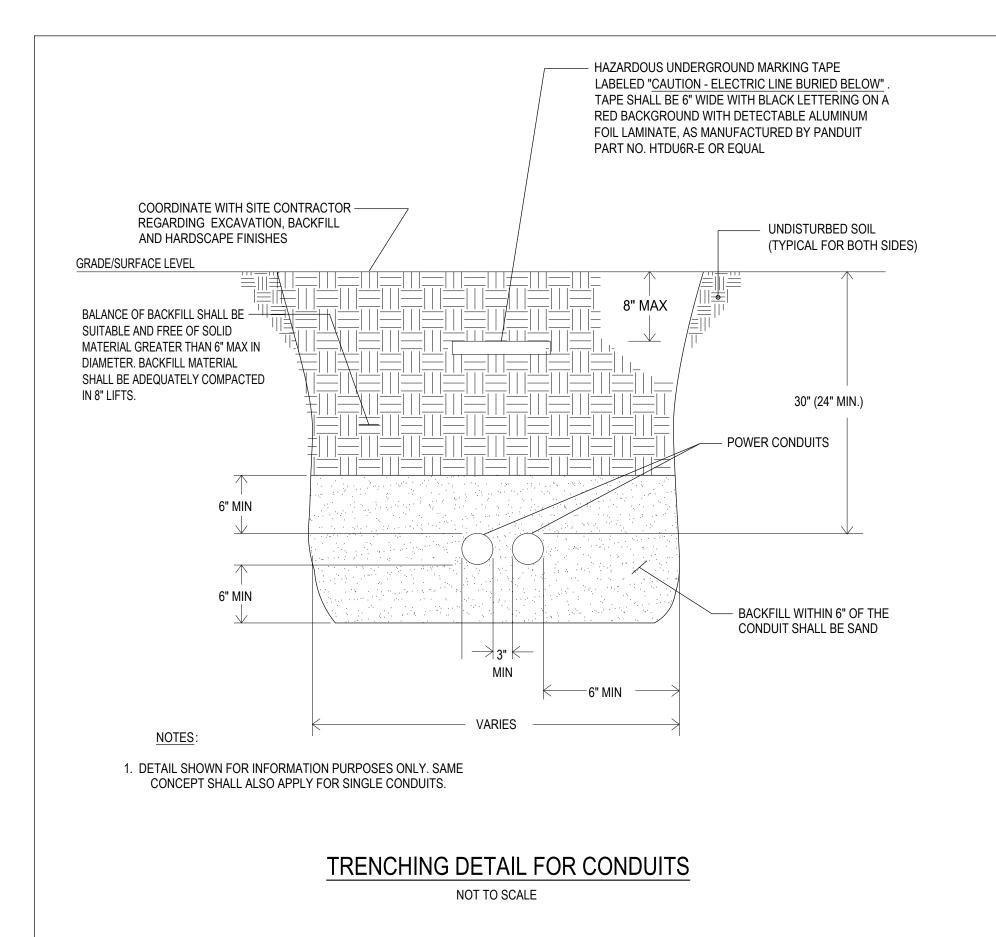

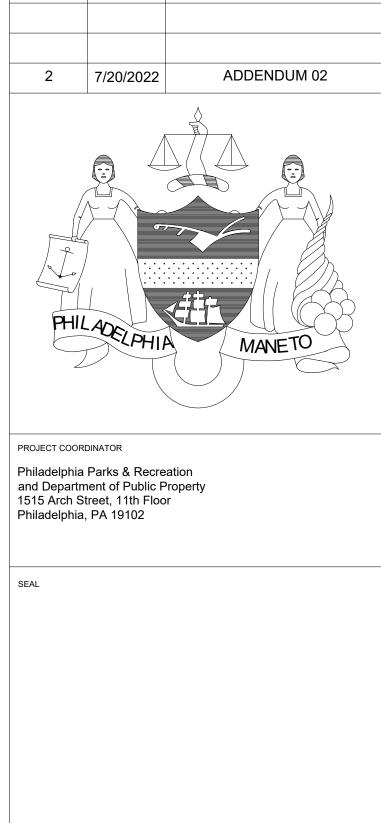

REVISIONS

DATE

REVISIONS

SPACE FOR CONSULTANT RECOGNITION

LANDSCAPE ARCHITECT: Ground Reconsidered 203 S. Broad Street, Suite 604 Philadelphia PA 19102 www.groundreconsidered.com

CIVIL ENGINEERS KSE Engineering 530 Walnut St., Suite 640 Philadelphia, PA 19106 www.kseng.com

STRUCTURAL ENGINEERS: **David Mason Associates** 123 South Broad Street, Suite 1130 Philadelphia PA 19109 www.davidmason.com

MEP ENGINEERS:

37 West 39th Street, Suite 1005 New York, NY 10018 www.srw-eng.com

CITY OF PHILADELPHIA


1515 ARCH STREET 11TH FLOOR, ONE PARKWAY BUILDING

FOTTERAL SQUARE RENOVATIONS

ELECTRICAL NOTES, SYMBOLS AND ABBREIVATIONS

DRAWING NO. 2020-513 07/20/2022 E-001 SCALE AS NOTED DRAWN BY MS CHECKED BY IR

ALL DIMENSIONS AND CONDITIONS SHALL BE VERIFIED BY THE CONTRACTOR AT THE SITE BEFORE PROCEEDING WITH THE WORK.

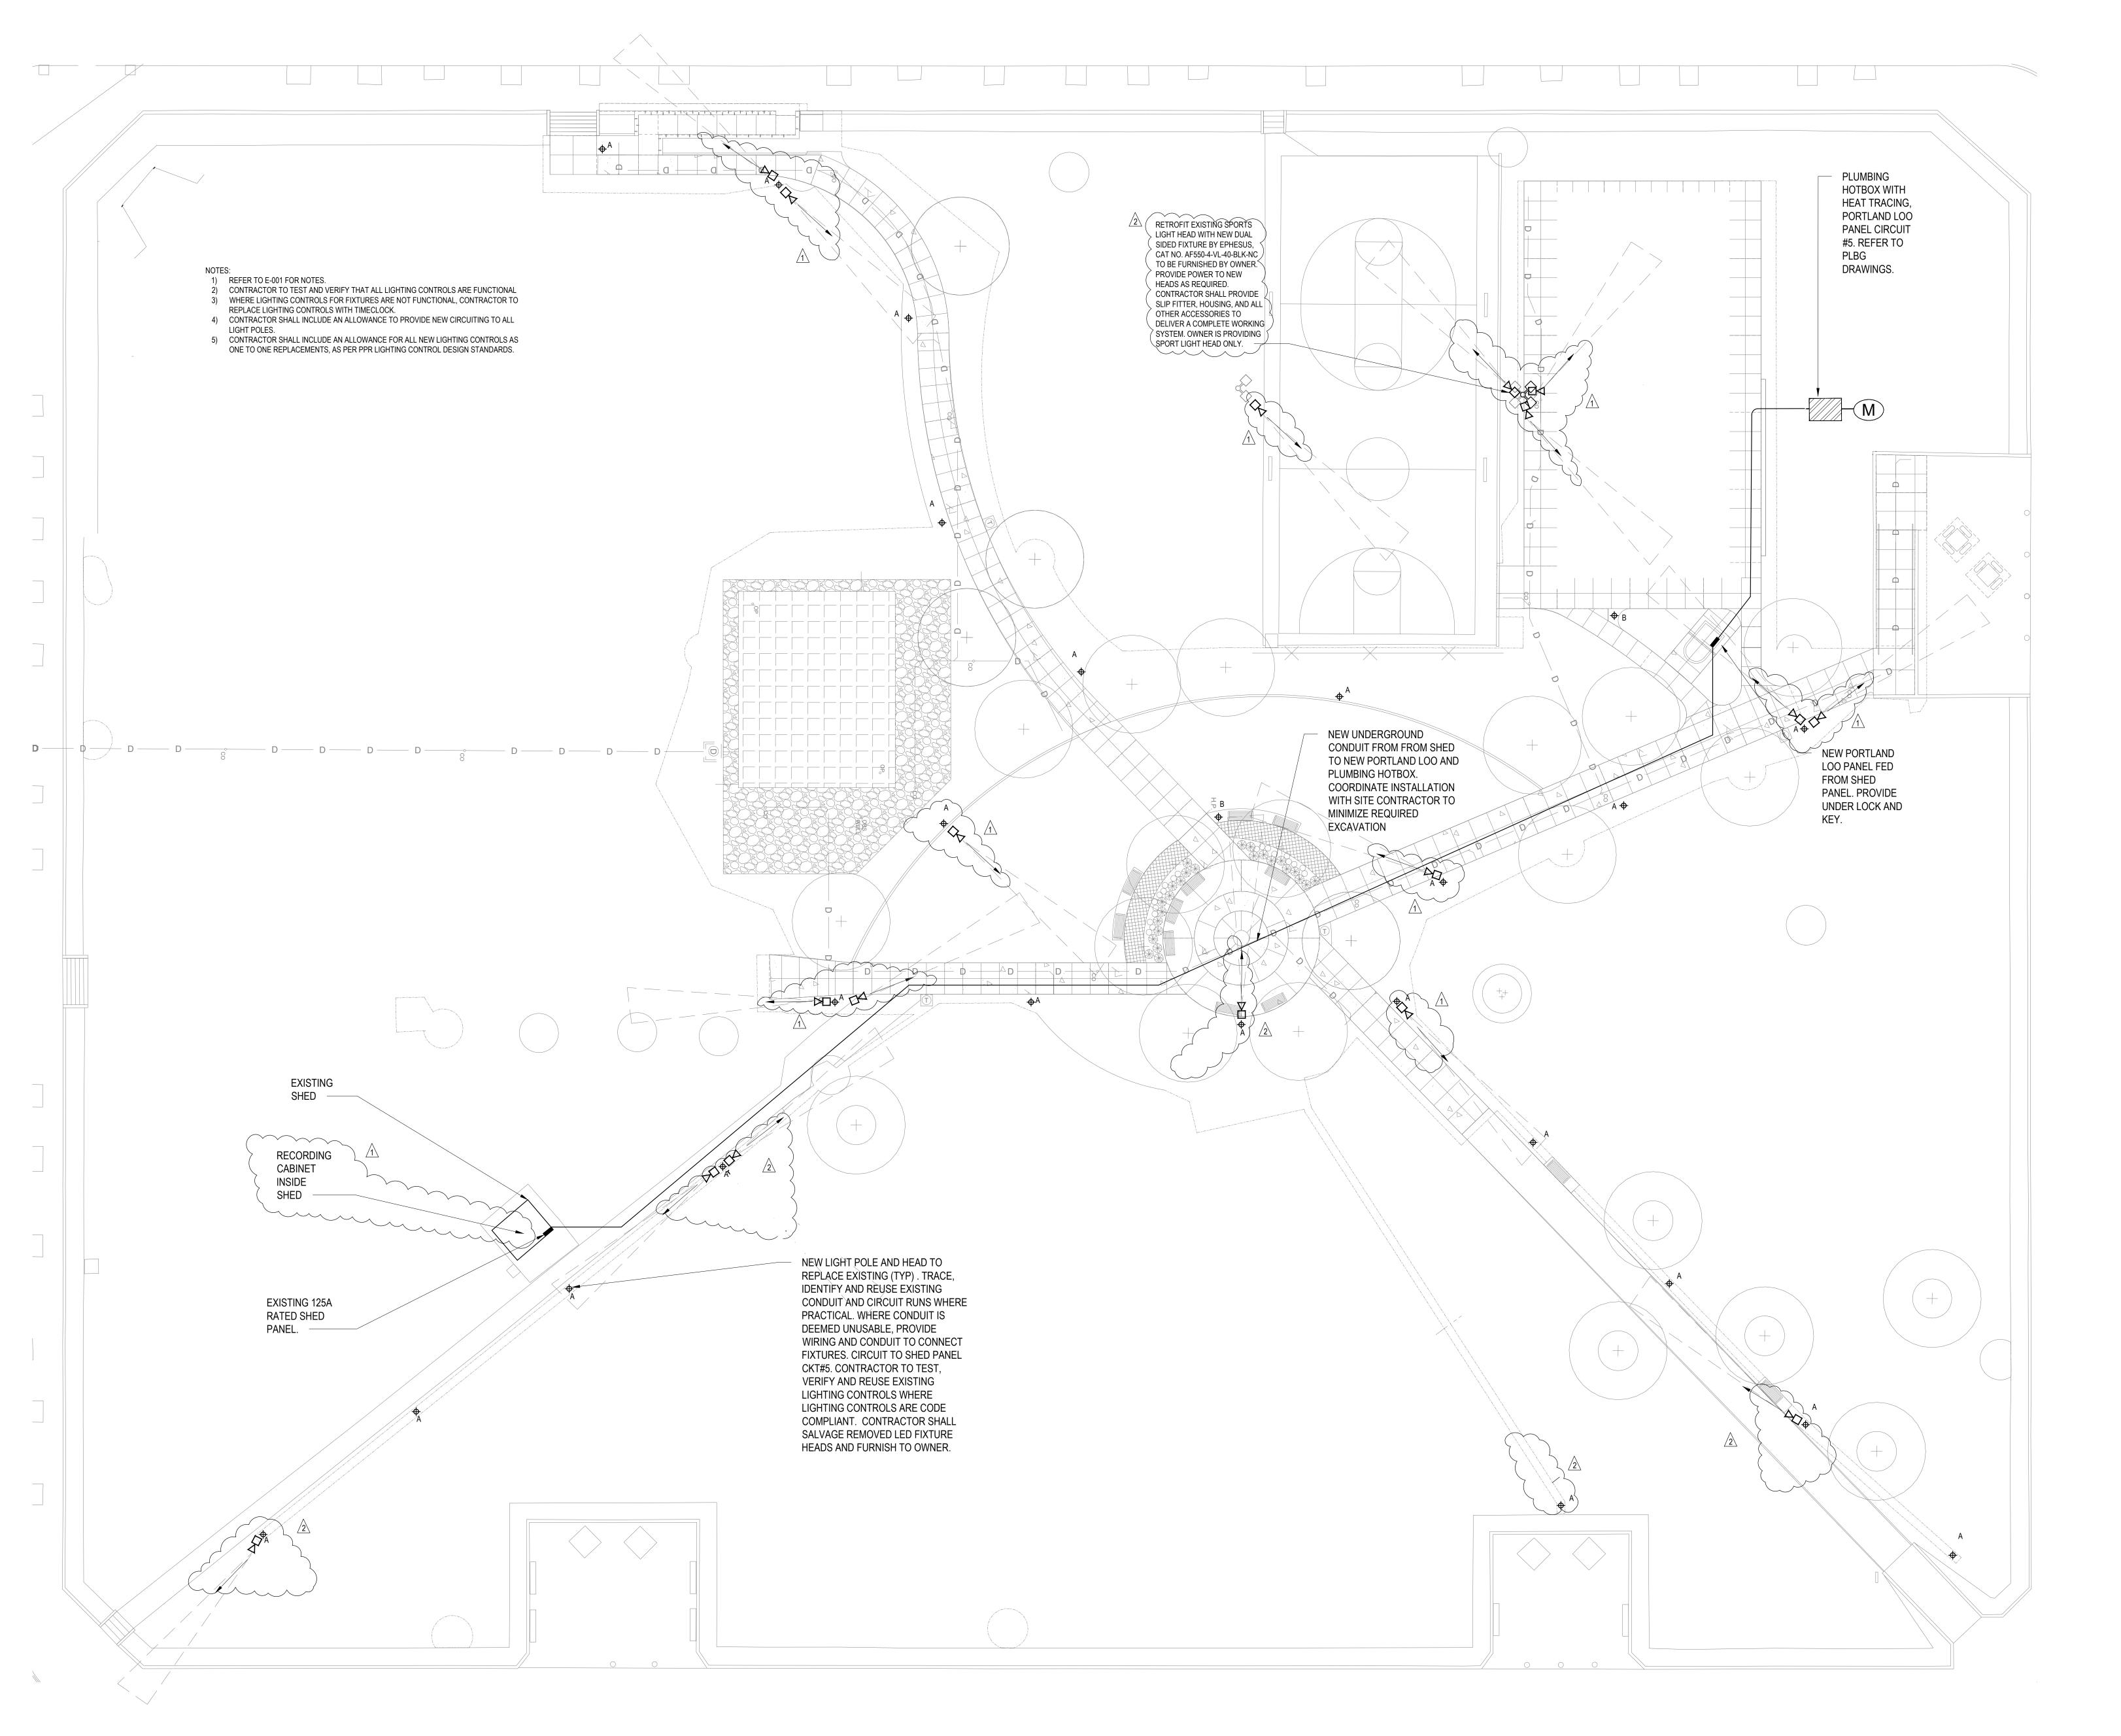

2 7/20/2022 ADDENDUM 02 1 7/15/2022 ADDENDUM 01

REVISIONS

PROJECT COORDINATOR

Philadelphia Parks & Recreation and Department of Public Property 1515 Arch Street, 11th Floor Philadelphia, PA 19102

SEAL

SPACE FOR CONSULTANT RECOGNITION

LANDSCAPE ARCHITECT: Ground Reconsidered 203 S. Broad Street, Suite 604

www.groundreconsidered.com

CIVIL ENGINEERS:

KSE Engineering

530 Walnut St., Suite 640

Philadelphia PA 19102

Philadelphia, PA 19106 www.kseng.com

STRUCTURAL ENGINEERS:
David Mason Associates
123 South Broad Street, Suite 1130

MEP ENGINEERS:

Philadelphia PA 19109

www.davidmason.com

SRW 37 West 39th Street, Suite 1005 New York, NY 10018 www.srw-eng.com

CITY OF PHILADELPHIA

1515 ARCH STREET
11TH FLOOR, ONE PARKWAY BUILDING

PHILADELPHIA, PENNSYLVANIA

FOTTERAL SQUARE RENOVATIONS

DRAWING TITLE

ELECTRICAL SITE PLAN

DATE 07/20/2022

SCALE AS NOTED

DRAWN BY MS

DRAWING NO.

DRAWING NO.

DRAWING NO.

DRAWING NO.

NOTE: ALL DIMENSIONS AND CONDITIONS SHALL BE VERIFIED BY THE CONTRACTOR AT THE SITE BEFORE PROCEEDING WITH THE WORK.

ELECTRICAL SITE PLAN SCALE: 1/16"=1'-0"

SUBMITTAL STATUS REPORT LIGHTING FIXTURE SUBMITTAL

LIGHTING FIXTURE DATA SHEET

FIXTURE TYPE: FOT-C-5-4 FIXTURE INFORMATION

FIXTURE MFR : EPHESUS LIGHTIN	VOLTAGE : Per Spec	MOUNTING:
FIXTURE CATALOG NUMBER : AF550-	-4-VL-40-BLK-NC	
DESCRIPTION:		
LAMP : LED SUPPLIED		
CONTRACTOR'S COMMENTS	:	
ARCHITECT'S COMMENTS :		
ENGINEER'S COMMENTS:		

SOME FIXTURE TYPES MAY REQUIRE CUSTOMER SUPPLIED INFORMATION PRIOR TO RELEASE. CSI EXAMPLES INCLUDE:

- 1. CUSTOM COLOR IF REQUIRED
- 2. STEM OR AIRCRAFT CABLE LENGTH IF REQUIRED
- 3. ROW LENGTHS OR LAYOUT INFORMATION4. CEILING TYPE

NOT SUPPLYING INFORMATION PRIOR TO RELEASE WILL STOP FIXTURES FROM BEING RELEASED AND COULD DELAY PROJECT.

Colonial submit date: 5/3/2022

DESCRIPTION

The All Field series is the ideal solution for professional caliber outdoor sports lighting with features designed with municipal, high school, collegiate and semi-professional outdoor sports venues in mind. Offering versatility for any outdoor sport including football, soccer, baseball, lacrosse and field hockey, the All Field luminaire delivers maintenance-free, professional sports lighting with a great return on investment.

Catalog #	Туре
Project	FOT-C-5-4
Comments	Date
Prepared by	

SPECIFICATION FEATURES

Construction

Solid-state design means no moving parts and nothing to wear out or replace, providing maintenance-free operation for hundreds of thousands of hours.

Optics

Custom-engineered optics direct light precisely where needed while minimizing glare.

Feedback

Telemetry to monitor health and status of each light is enabled through AirMesh control system capabilities.

Customization

Multiple control options available for operational flexibility and fan experience effects.

Electrical

Ultra-low EMI noise generation eliminates interference with surrounding electrical systems.

Finish

Rugged, weather-tight design ensures durability even in harsh environments.





ephesus


ALL FIELD SERIES

SPORTS LIGHTING

DIMENSIONS

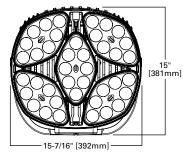

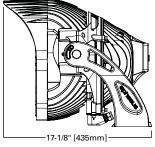

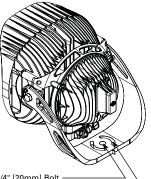

Clearance for 3/4" [20mm] Bolt —— 2-7/8" [73mm] Slot diameter Clearance for 3/8" Bolt





CERTIFICATION DATA

IP66 Rated

DesignLights Consortium® Qualified*

EPA

Effective Projected Area (Sq. Ft.): 1.4

SHIPPING DATA Approximate Net Weight: 45 lbs. (20.41 kgs.)



ORDERING INFORMATION

Sample Number: AF-550-2-VL-57-BLK-AM

Series 1, 2	Model	Optics	Voltage	сст	Fixture Color	Controls
AF =All Field	400 =400 550 =550 750 =750	2=NEMA2 3=NEMA3 4=NEMA4 5=NEMA6	VH=High Voltage (277-480VAC) VL=Low Voltage (120-240VAC)	40 =4000K 57 =5700K	WHT=White BLK=Black	AM=All Field AirMesh LB10=All Field LandBurst 0-10V 3 LB=All Field LandBurst DMX NC=No Controls - ON/OFF 4

ENERGY AND PERFORMANCE DATA

	All Field 400	All Field 550	All Field 750
Lumen Output	>48,000	>64,000	>85,000
System Wattage	400	550	750
Input Voltage (High Voltage)	277-480VAC	277-480VAC	277-480VAC
Input Voltage (Low Voltage)	120-240VAC	120-240VAC	120-240VAC
CRI (Color Rendering Index)	>70	>70	>70
L70 Hours	>160,000 at 25°C	>160,000 at 25°C	>160,000 at 25°C
Operating Temperature Range	-40°C to 55°C	-40°C to 55°C	-40°C to 55°C
Surge (Common Mode / Differential Mode)	6kV	6kV	6kV
IP Rating	IP66	IP66	IP66
NEMA Rating	NEMA 4X	NEMA 4X	NEMA 4X
Effective Projected Area (EPA)	1.4 (sq. ft.)	1.4 (sq. ft.)	1.4 (sq. ft.)
Approximate Weight ⁴	45 lbs. (20.45 kgs.)	45 lbs. (20.45 kgs.)	45 lbs. (20.45 kgs.)

NOTES:

- 1. DesignLights Consortium® Qualified. Refer to www.designlights.org Qualified Products under Family Models for details.
- 2. The specifications listed were obtained under optimal testing conditions. Changes in options, features and conditions may result in slightly different performance specifications among fixtures.

 3. To provide full range dimming capability across a wide array of 0-10V dimming systems, the Landburst 0-10V controls provide 1%-100% dimming across a control voltage input range of 1V to 7.5V. Full dimming curve is available upon request. Eaton cannot guarantee compatibility with all dimming control systems from all manufacturers. To ensure compatibility, please consult our control compatibility reference guide or contact Eaton for further assistance.
- 4. If the "no controls" option is selected, note that it is not possible to install a control system at a later time.
- 5. Weight may vary depending on mounting bracket selection.
- 6. The All Field is equipped with rapid switching protection that requires a time delay between ON/OFF/ON switching. In the event of a power disruption, the power must remain off for a period of 6 seconds (at 480VAC) and 12 seconds (at 120VAC) to ensure proper fixture operation.

dimensions subject to

change without notice.