ADDENDUM COVER SHEET

Addendum No. 1
Fotteral Square RFP (2400 N. 11th Street)
Philadelphia Redevelopment Authority

Issue Date: July 18, 2022

ITEMS:

- Addition of: General Requirements Section 015639 "Temporary Tree & Plant Protection"
- Addition of: Project Drawing No. C500
- Addition of: Project Drawing No. C600
- Addition of: Project Drawing No. C702
- Addition of: Project Drawing No. E200
- Bidders must acknowledge receipt of Addendum No. 1. The signed acknowledgement must be included in you bid proposal. Please sign and date below:

Acknowledgement of Addendum No. 1

SECTION 015639

TEMPORARY TREE AND PLANT PROTECTION

PART 1 - GENERAL

1.1 STIPULATIONS

A. The specifications sections "General Conditions of Contract", "Special Conditions" and "Division 1 General Requirements" form a part of this section by reference thereto and shall have the same force and effect as if printed herewith in full.

1.2 SUMMARY

- A. Section includes general protection and pruning of existing trees and plants that are affected by execution of the Work, whether temporary or permanent construction.
- B. Related Sections:
 - 1. Division 01 Section "Construction Waste Management"
 - 2. Division 01 Section "Sustainable Design Requirements"
 - 3. Division 01 Section "Field Engineering" for field engineering and surveying.
 - 4. Division 02 Section "Selective Demolition" for partial demolition of buildings or structures.
 - 5. Division 31 Section "Site Clearing and Erosion Control".

1.3 DEFINITIONS

- A. Caliper: Diameter of a trunk measured by a diameter tape at 6 inches above the ground for trees up to, and including, 6-inch size; and breast height (DBH) for trees larger than 6-inch size.
- B. Plant-Protection Zone: Area surrounding individual trees, groups of trees, shrubs, or other vegetation to be protected during construction, and indicated on Drawings.
- C. Tree-Protection Zone: Area surrounding individual trees or groups of trees to be protected during construction, and indicated on Drawings.
- D. Vegetation: Trees, shrubs, groundcovers, grass, and other plants.

1.4 SUBMITTALS

- A. Product Data: For each type of product indicated.
- B. Samples for Verification: For each type of the following:
 - 1. Organic Mulch: One (1) gallon of organic mulch; in sealed plastic bags labeled with composition of materials by percentage of weight and source of mulch.
 - 2. Protection-Zone Fencing: Manufacturer's cut sheets

Fotteral Square Renovations 015639-1 TEMPORARY TREE AND PLANT PROTECTION

- 3. Protection-Zone Signage: Manufacturer's cut sheets.
- C. Tree Pruning Schedule: Written schedule detailing scope and extent of pruning of trees to remain that interfere with or are affected by construction.
 - 1. Species and size of tree.
 - 2. Location on site plan. Include unique identifier for each.
 - 3. Reason for pruning.
 - 4. Description of pruning to be performed.
- D. Qualification Data: For qualified arborist and tree service firm.
- E. Certification: From arborist, certifying that trees indicated to remain have been protected during construction according to recognized standards and that trees were promptly and properly treated and repaired when damaged.
- F. Maintenance Recommendations: From arborist, for care and protection of trees affected by construction during and after completing the Work.
- G. Existing Conditions: Documentation of existing trees and plantings indicated to remain, which establishes preconstruction conditions that might be misconstrued as damage caused by construction activities.
 - 1. Use sufficiently detailed photographs or videotape.
 - 2. Include plans and notations to indicate specific wounds and damage conditions of each tree or other plants designated to remain.

1.5 QUALITY ASSURANCE

- A. Arborist Qualifications: Certified Arborist as certified by ISA.
- B. Tree Service Firm Qualifications: An experienced tree service firm that has successfully completed temporary tree and plant protection work similar to that required for this Project and that will assign an experienced, qualified arborist to Project site during execution of the Work.
- C. Preinstallation Conference: Conduct conference at Project site.
 - 1. Review methods and procedures related to temporary tree and plant protection including, but not limited to, the following:
 - a. Construction schedule. Verify availability of materials, personnel, and equipment needed to make progress and avoid delays.
 - b. Enforcing requirements for protection zones.
 - c. Arborist's responsibilities.
 - d. Field quality control.

1.6 PROJECT CONDITIONS

A. The following practices are prohibited within protection zones:

- 1. Storage of construction materials, debris, or excavated material.
- 2. Parking vehicles or equipment.
- 3. Foot traffic.
- 4. Erection of sheds or structures.
- 5. Impoundment of water.
- 6. Excavation or other digging unless otherwise indicated.
- 7. Attachment of signs to or wrapping materials around trees or plants unless otherwise indicated.
- B. Do not direct vehicle or equipment exhaust toward protection zones.
- C. Prohibit heat sources, flames, ignition sources, and smoking within or near protection zones and organic mulch.
- D. Protection fencing must be approved by the Owner's Representative prior to commencing with any demolition or construction work.
- E. Install protection fencing before installing erosion and sedimentation controls. Trenched silt fence is prohibited within plant protection zones. Utilize tubular sediment control device, such as Filtrexx® Sediment Control or similar product in accordance with the manufacturers instructions, in lieu of silt fencing. Trenching is prohibited within plant protection zones.
- F. Flows of water redirected from construction areas or generated by construction activity are prohibited from entering or crossing plant protection zones. Protect root systems from ponding, eroding, or excessive wetting caused by dewatering operations.
- G. Work within the plant protection zone must be approved by and supervised by Owner's Representative.
- H. The Owner's Representative may require additional protection fencing or relocation of fencing as work progresses.
- I. Bring any unforeseen site conditions, such as structural roots, that will impact new construction to the attention of the Owner's Representative. Do not proceed with work without written authorization.
- J. Arborist may require crown pruning to compensate for root loss caused by damaging or cutting of the root system. Provide subsequent maintenance during contract period as recommended by arborist.
- K. Campus care manager or his representative should be present when any work is done to or around campus plantings.

PART 2 - GENERAL

2.1 MATERIALS

A. Topsoil: Refer to 32 91 00 'Soil Preparation'.

- B. Organic Mulch: Free from deleterious materials and suitable as a top dressing for trees and shrubs, consisting of one of the following:
 - 1. Type: Shredded hardwood.
 - 2. Size Range: 3 inches (76 mm) maximum, 1/2 inch (13 mm) minimum.
 - 3. Color: Natural.
- C. Protection-Zone Fencing: Fencing fixed in position and meeting the following requirements.
 - 1. Safety Fence: 4' high plastic orange safety fence; 6' tall steel posts with tie wires, and other accessories for a complete fence system.
- D. Protection-Zone Signage: Shop-fabricated, rigid plastic or metal sheet with attachment holes prepunched and reinforced; legibly printed with nonfading lettering and as follows:
 - 1. Size and Text: TREE PROTECTION AREA DO NOT ENTER
 - 2. Lettering: 3-inch high minimum, white characters on red background.

PART 3 - EXECUTION

3.1 CONSTRUCTION WASTE MANAGEMENT (LEED)

A. The contractor, subcontractors, and their personnel shall follow the procedures and practices for waste separation, collection and transport as defined in the contractor's "Waste Management Plan" as required by Division 01 Section "Construction Waste Management."

3.2 EXAMINATION

- A. Erosion and Sedimentation Control: Examine the site to verify that temporary erosion- and sedimentation-control measures are in place. Verify that flows of water redirected from construction areas or generated by construction activity do not enter or cross protection zones.
- B. For the record, prepare written report, endorsed by arborist, listing conditions detrimental to tree and plant protection.

3.3 PREPARATION

A. Protect tree root systems from damage caused by runoff or spillage of noxious materials while mixing, placing, or storing construction materials. Protect root systems from ponding, eroding, or excessive wetting caused by dewatering operations.

3.4 TREE- AND PLANT-PROTECTION ZONES

A. Protection-Zone Fencing: Install protection-zone fencing along edges of protection zones before materials or equipment are brought on the site and construction operations begin in a manner that will prevent people from easily entering protected area except by entrance gates.

Fotteral Square Renovations 015639-4 TEMPORARY TREE AND PLANT PROTECTION Construct fencing so as not to obstruct safe passage or visibility at vehicle intersections where fencing is located adjacent to pedestrian walkways or in close proximity to street intersections, drives, or other vehicular circulation.

- B. Protection-Zone Signage: Install protection-zone signage in visibly prominent locations in a manner approved by Architect. Install one sign spaced approximately every 35 feet on protection-zone fencing, but no fewer than four signs with each facing a different direction.
- C. Maintain protection zones free of weeds and trash.
- D. Repair or replace trees, shrubs, and other vegetation indicated to remain or be relocated that are damaged by construction operations, in a manner approved by Architect.
- E. Maintain protection-zone fencing and signage in good condition as acceptable to Architect and remove when construction operations are complete and equipment has been removed from the site.
 - 1. Do not remove protection-zone fencing, even temporarily, to allow deliveries or equipment access through the protection zone.
 - 2. Temporary access is permitted subject to preapproval in writing by arborist if a root buffer effective against soil compaction is constructed as directed by arborist. Maintain root buffer so long as access is permitted.

3.5 EXCAVATION

- A. General: Excavate at edge of protection zones and for trenches indicated within protection zones according to requirements in Section 312000 "Earth Moving."
- B. Trenching near Trees: Where utility trenches are required within protection zones, hand excavate and/or air-spade under or around tree roots or tunnel under the roots by drilling, auger boring, or pipe jacking. Do not cut main lateral tree roots or taproots; cut only smaller roots that interfere with installation of utilities. Cut roots as required for root pruning.
- C. Do not allow exposed roots to dry out before placing permanent backfill. Provide temporary earth cover or pack with peat moss and wrap with burlap. Water and maintain in a moist condition. Temporarily support and protect roots from damage until they are permanently relocated and covered with soil.

3.6 ROOT PRUNING

- A. Prune roots that are affected by temporary and permanent construction. Prune roots as follows:
 - 1. Cut roots manually by digging a trench and cutting exposed roots with sharp pruning instruments; do not break, tear, chop, or slant the cuts. Do not use a backhoe or other equipment that rips, tears, or pulls roots.
 - 2. Cut Ends: Do not coat cut ends of roots with an emulsified asphalt or similar coatings.
 - 3. Temporarily support and protect roots from damage until they are covered with soil.
 - 4. Cover exposed roots with burlap and water regularly.
 - 5. Backfill as soon as possible according to requirements in Section 312000 "Earth Moving."

- B. Root Pruning at Edge of Protection Zone: Prune roots 6 inches inside of the protection zone, by cleanly cutting all roots to the depth of the required excavation.
- C. Root Pruning within Protection Zone: Clear and excavate by hand to the depth of the required excavation to minimize damage to root systems. Use narrow-tine spading forks, comb soil to expose roots, and cleanly cut roots as close to excavation as possible.

3.7 CROWN PRUNING

- A. Prune branches that are affected by temporary and permanent construction. Prune branches as follows:
 - Prune trees to remain to compensate for root loss caused by damaging or cutting root system. Provide subsequent maintenance during Contract period as recommended by arborist.
 - 2. Pruning Standards: Prune trees according to ANSI A300 (Part 1) and the following:
 - a. Type of Pruning: Cleaning, Thinning, and/or Reduction.
 - b. Specialty Pruning: Restoration.
 - 3. Cut branches with sharp pruning instruments; do not break or chop.
 - 4. Do not apply pruning paint to wounds
- B. Chip removed branches and dispose of off-site.

3.8 REGRADING

- A. Lowering Grade: Where new finish grade is indicated below existing grade around trees, slope grade beyond the protection zone. Maintain existing grades within the protection zone.
- B. Root Pruning: Prune tree roots exposed by lowering the grade. Do not cut main lateral roots or taproots; cut only smaller roots. Cut roots as required for root pruning.
 - 1. Root Pruning: Prune tree roots exposed by lowering the grade. Do not cut main lateral roots or taproots; cut only smaller roots. Cut roots as required for root pruning.
- C. Raising Grade: Where new finish grade is indicated above existing grade around trees, slope grade beyond the protection zone. Maintain existing grades within the protection zone.
- D. Minor Fill within Protection Zone: Where existing grade is 2 inches or less below elevation of finish grade, fill with topsoil. Place topsoil in a single uncompacted layer and hand grade to required finish elevations.

3.9 FIELD QUALITY CONTROL

A. Inspections: Engage a qualified arborist to direct plant-protection measures in the vicinity of trees, shrubs, and other vegetation indicated to remain and to prepare inspection reports.


3.10 REPAIR AND REPLACEMENT


- A. General: Repair or replace trees, shrubs, and other vegetation indicated to remain or be relocated that are damaged by construction operations, in a manner approved by Architect.
 - 1. Submit details of proposed root cutting and tree and shrub repairs.
 - 2. Have arborist perform the root cutting, branch pruning, and damage repair of trees and shrubs.
 - 3. Treat damaged trunks, limbs, and roots according to arborist's written instructions.
 - 4. Perform repairs within 24 hours.
 - 5. Replace vegetation that cannot be repaired and restored to full-growth status, as determined by Architect.
- B. Trees: Remove and replace trees indicated to remain that are more than 25 percent dead or in an unhealthy condition before the end of the corrections period or are damaged during construction operations that Landscape Architect determines are incapable of restoring to normal growth pattern.
 - 1. Provide new trees of same size and species as those being replaced for each tree that measures 6 inches or smaller in caliper size.
 - 2. Provide two new trees of 4-inch caliper size for each tree being replaced that measure between 6-inch caliper and 8-inch caliper in size at a location directed by the Owner or Owner's Representative.
 - 3. Provide 6-inch caliper size for each tree being replaced that measure greater than 8-inch caliper in size at a location directed by the Owner or Owner's Representative. Quantity of trees shall equal the total diameter at breast height (DBH) size of the tree removed unless directed otherwise by the Owner. For example, a 32-inch DBH shall require five new trees.
 - 4. Species: Species selected by Landscape Architect.
 - 5. Plant and maintain new trees as specified in Section 32 93 00 'Plants'.
- C. Soil Aeration: Where directed by Landscape Architect, aerate surface soil compacted during construction. Aerate to extent as directed by Landscape Architect beyond drip line and no closer than 36 inches to tree trunk. Drill 2-inch diameter holes a minimum of 12 inches deep at 24 inches o.c. Backfill holes with approved Compost.

3.11 DISPOSAL OF SURPLUS AND WASTE MATERIALS

A. Disposal: Remove excess excavated material, displaced trees, trash and debris, and legally dispose of them off Owner's property.

END OF SECTION 01 56 39

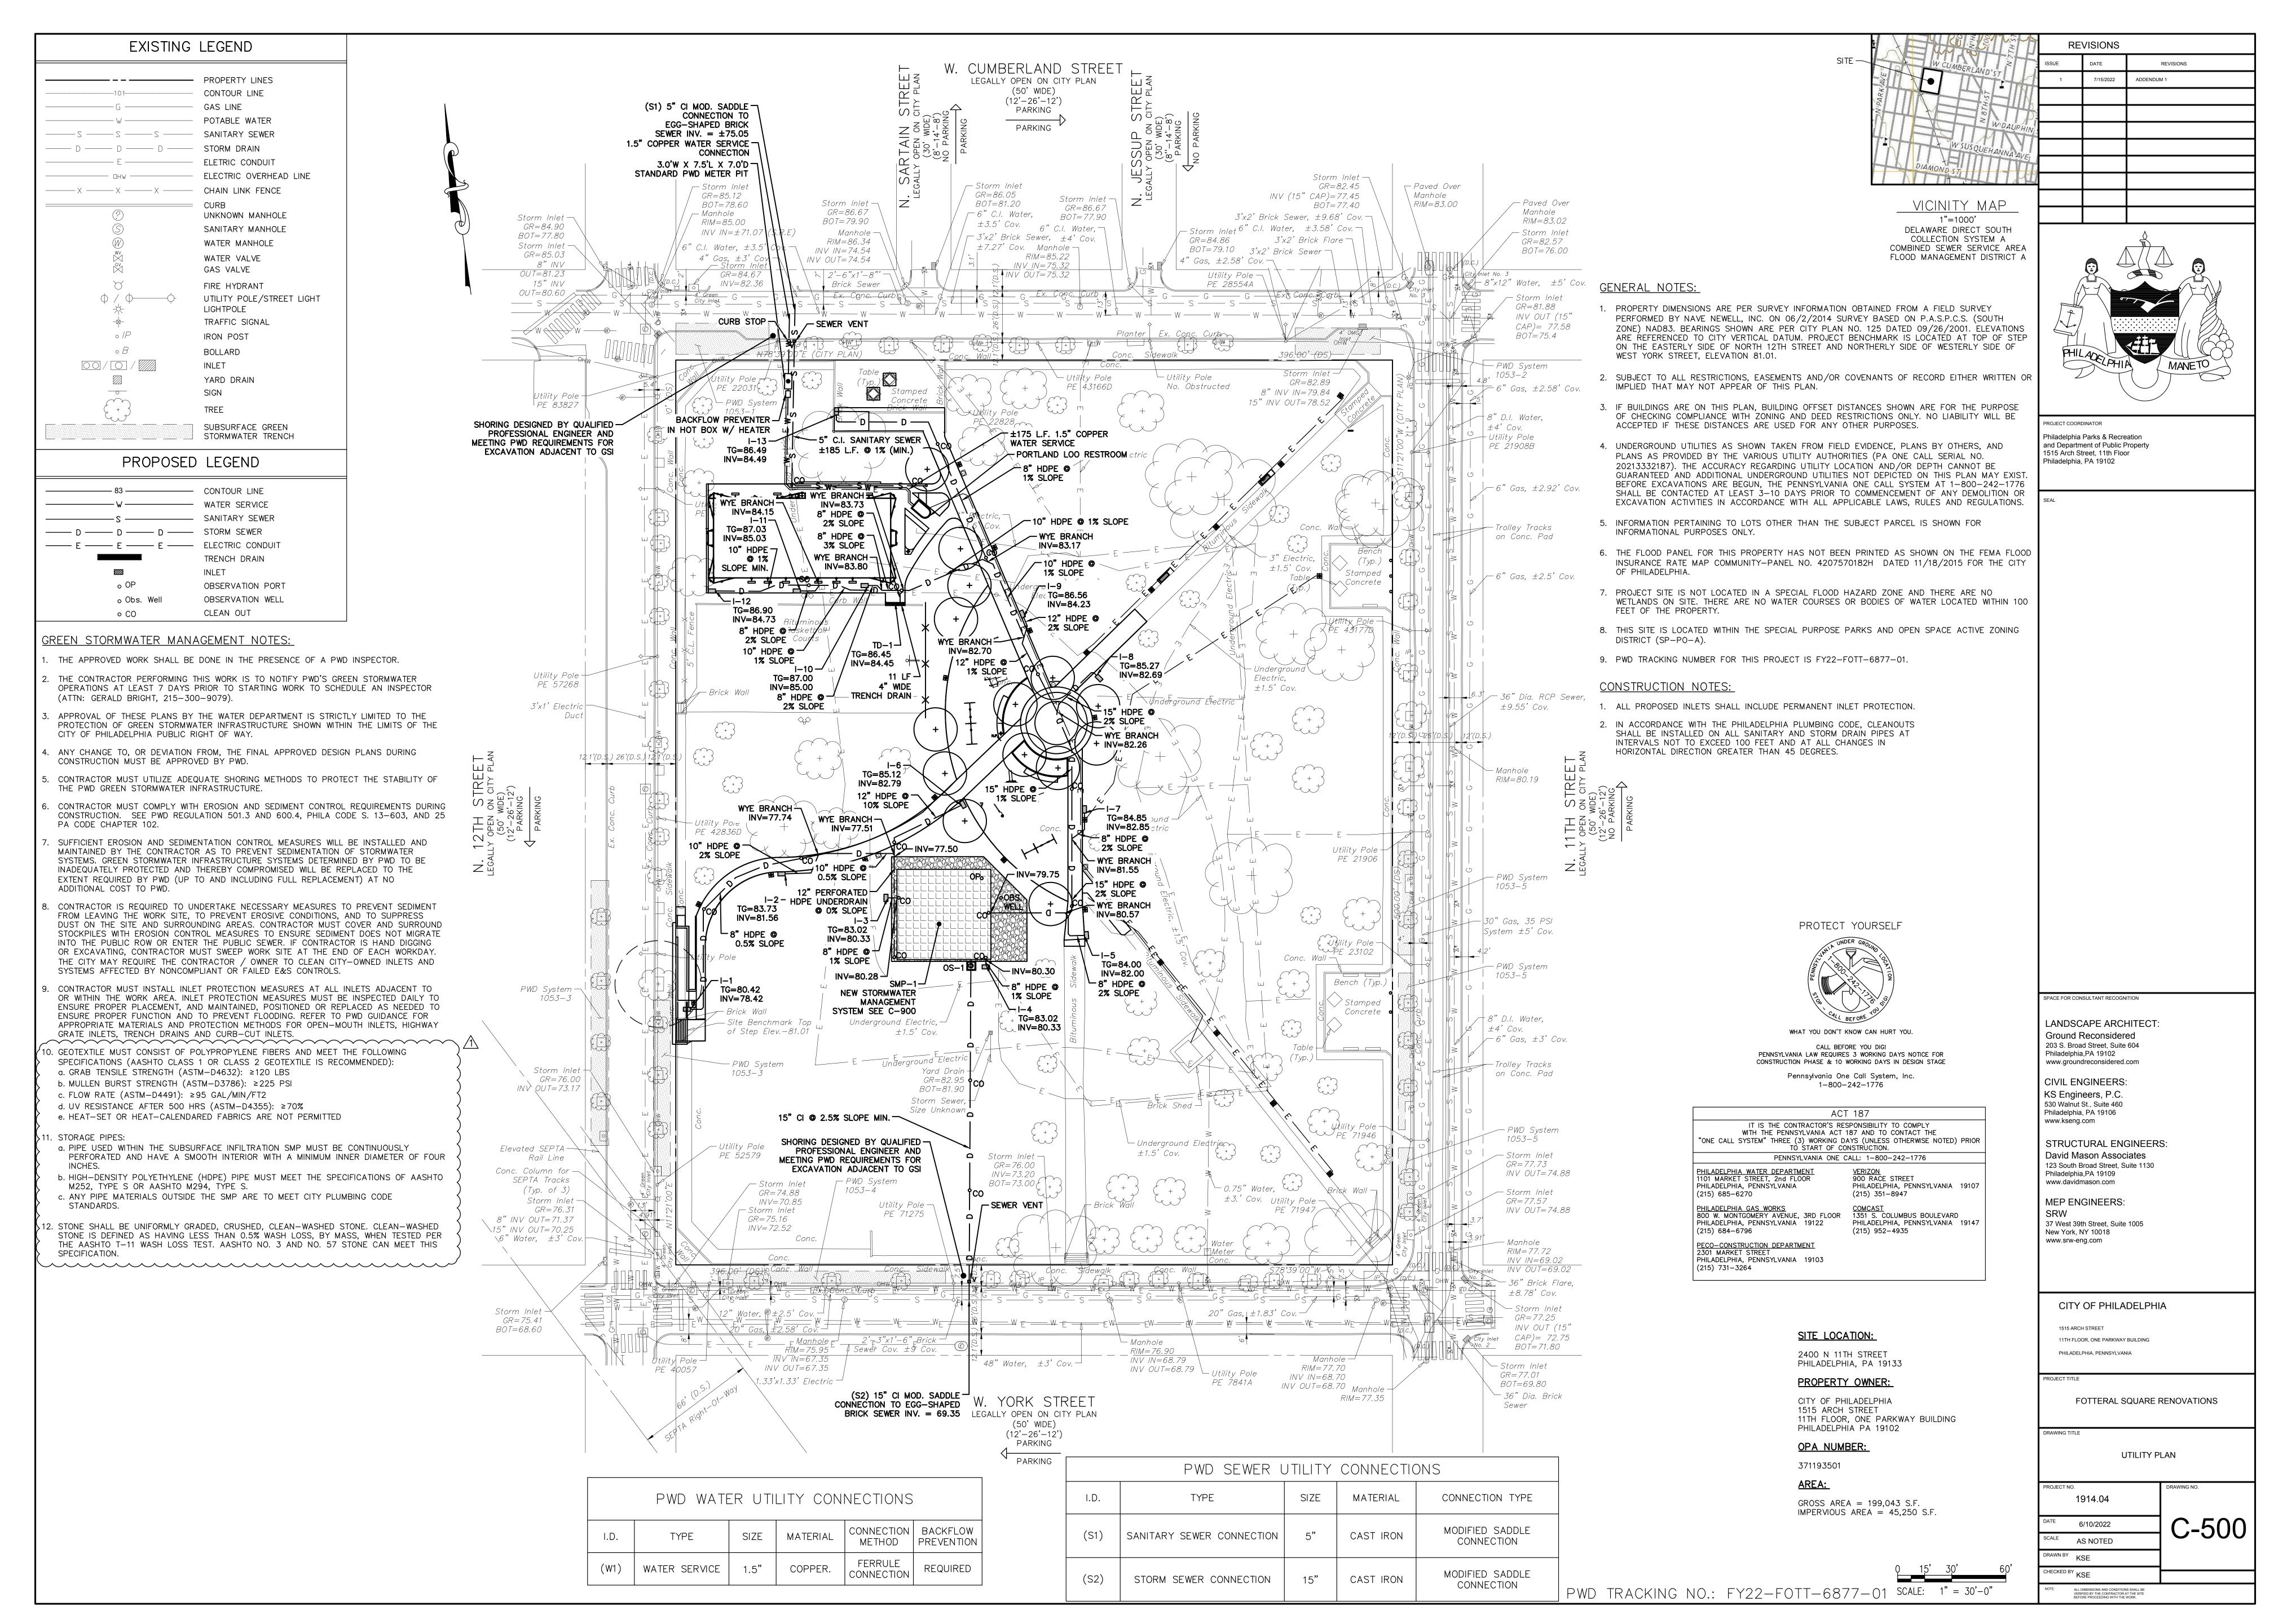

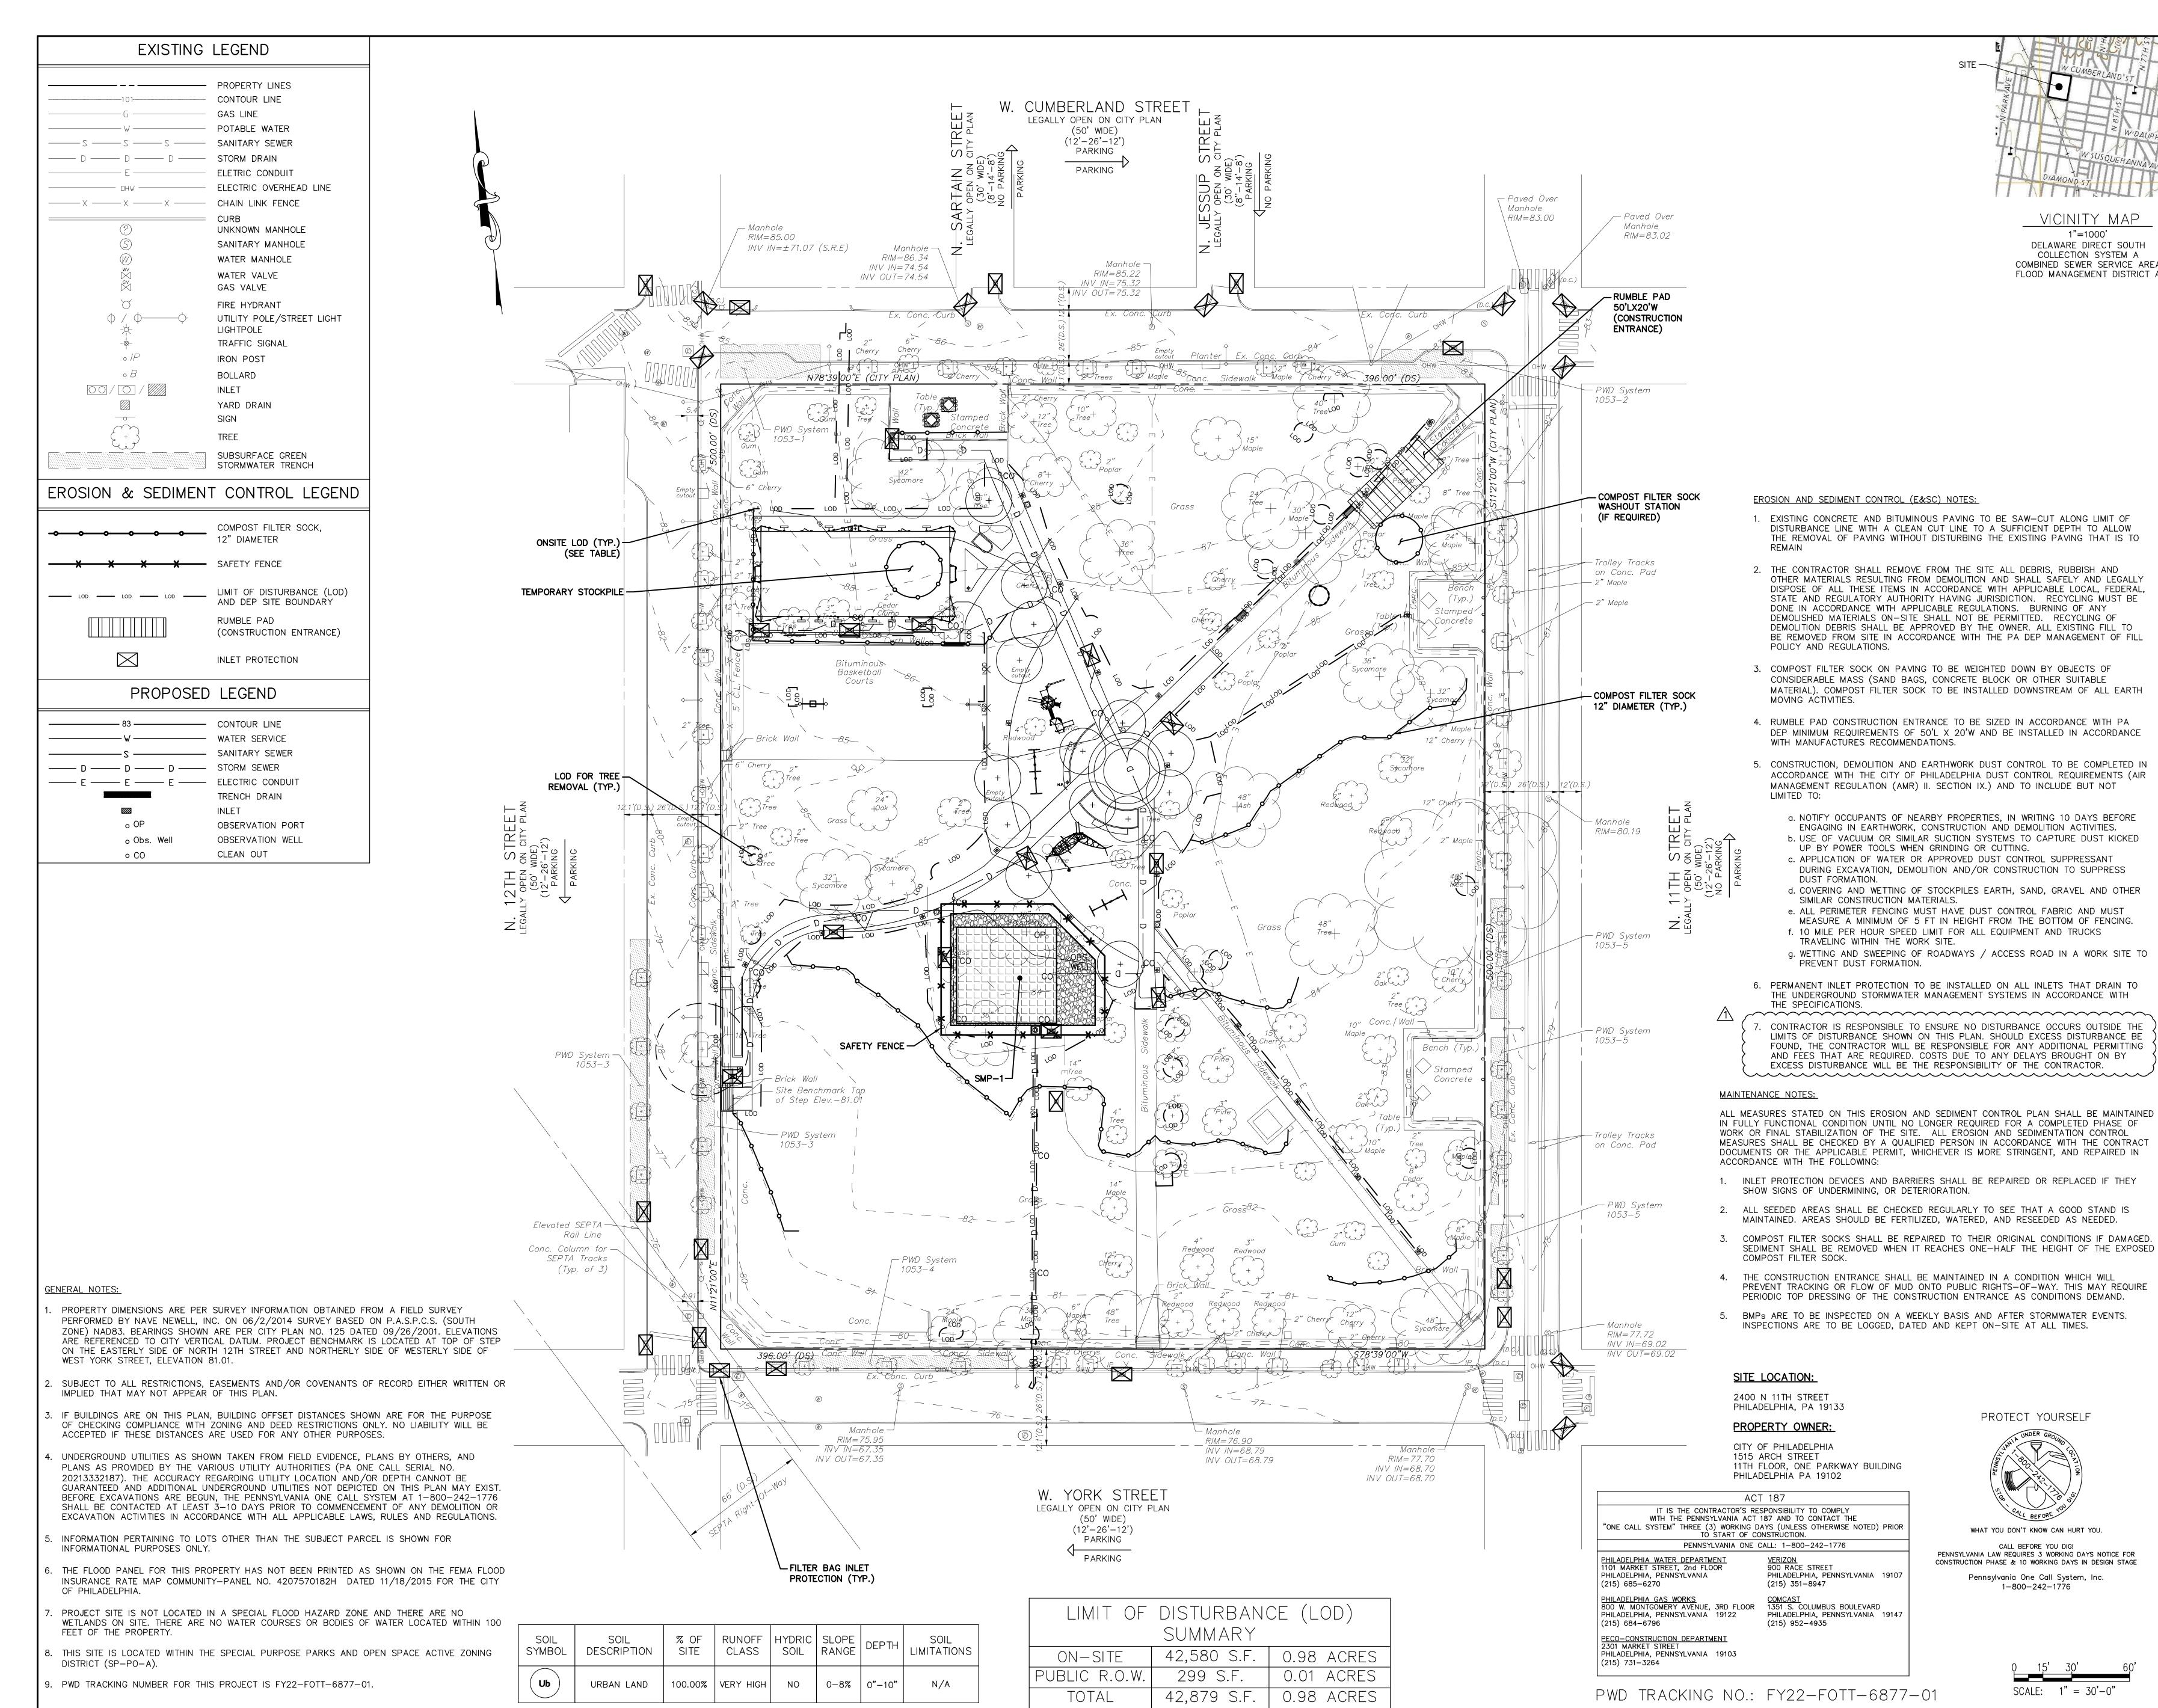

VICINITY MAP 1"=1000' DELAWARE DIRECT SOUTH COLLECTION SYSTEM A COMBINED SEWER SERVICE AREA FLOOD MANAGEMENT DISTRICT A

REVISIONS

7/15/2022

ADDENDUM 1

PROJECT COORDINATOR Philadelphia Parks & Recreation and Department of Public Property 1515 Arch Street, 11th Floor Philadelphia, PA 19102

SPACE FOR CONSULTANT RECOGNITION

LANDSCAPE ARCHITECT:

Ground Reconsidered 203 S. Broad Street, Suite 604 Philadelphia,PA 19102 www.groundreconsidered.com

CIVIL ENGINEERS: KS Engineers, P.C. 530 Walnut St., Suite 460

STRUCTURAL ENGINEERS: **David Mason Associates** 123 South Broad Street, Suite 1130

www.davidmason.com MEP ENGINEERS:

Philadelphia,PA 19109

Philadelphia, PA 19106

www.kseng.com

37 West 39th Street, Suite 1005

New York, NY 10018 www.srw-eng.com

CITY OF PHILADELPHIA

1515 ARCH STREET 11TH FLOOR, ONE PARKWAY BUILDING

FOTTERAL SQUARE RENOVATIONS

CKED BY KSE


ALL DIMENSIONS AND CONDITIONS SHALL BE VERIFIED BY THE CONTRACTOR AT THE SITE BEFORE PROCEEDING WITH THE WORK.

EROSION AND SEDIMENT CONTROL PLAN

1914.04 C-600 6/10/2022 AS NOTED KSE

SCALE: 1" = 30' - 0"

/ S

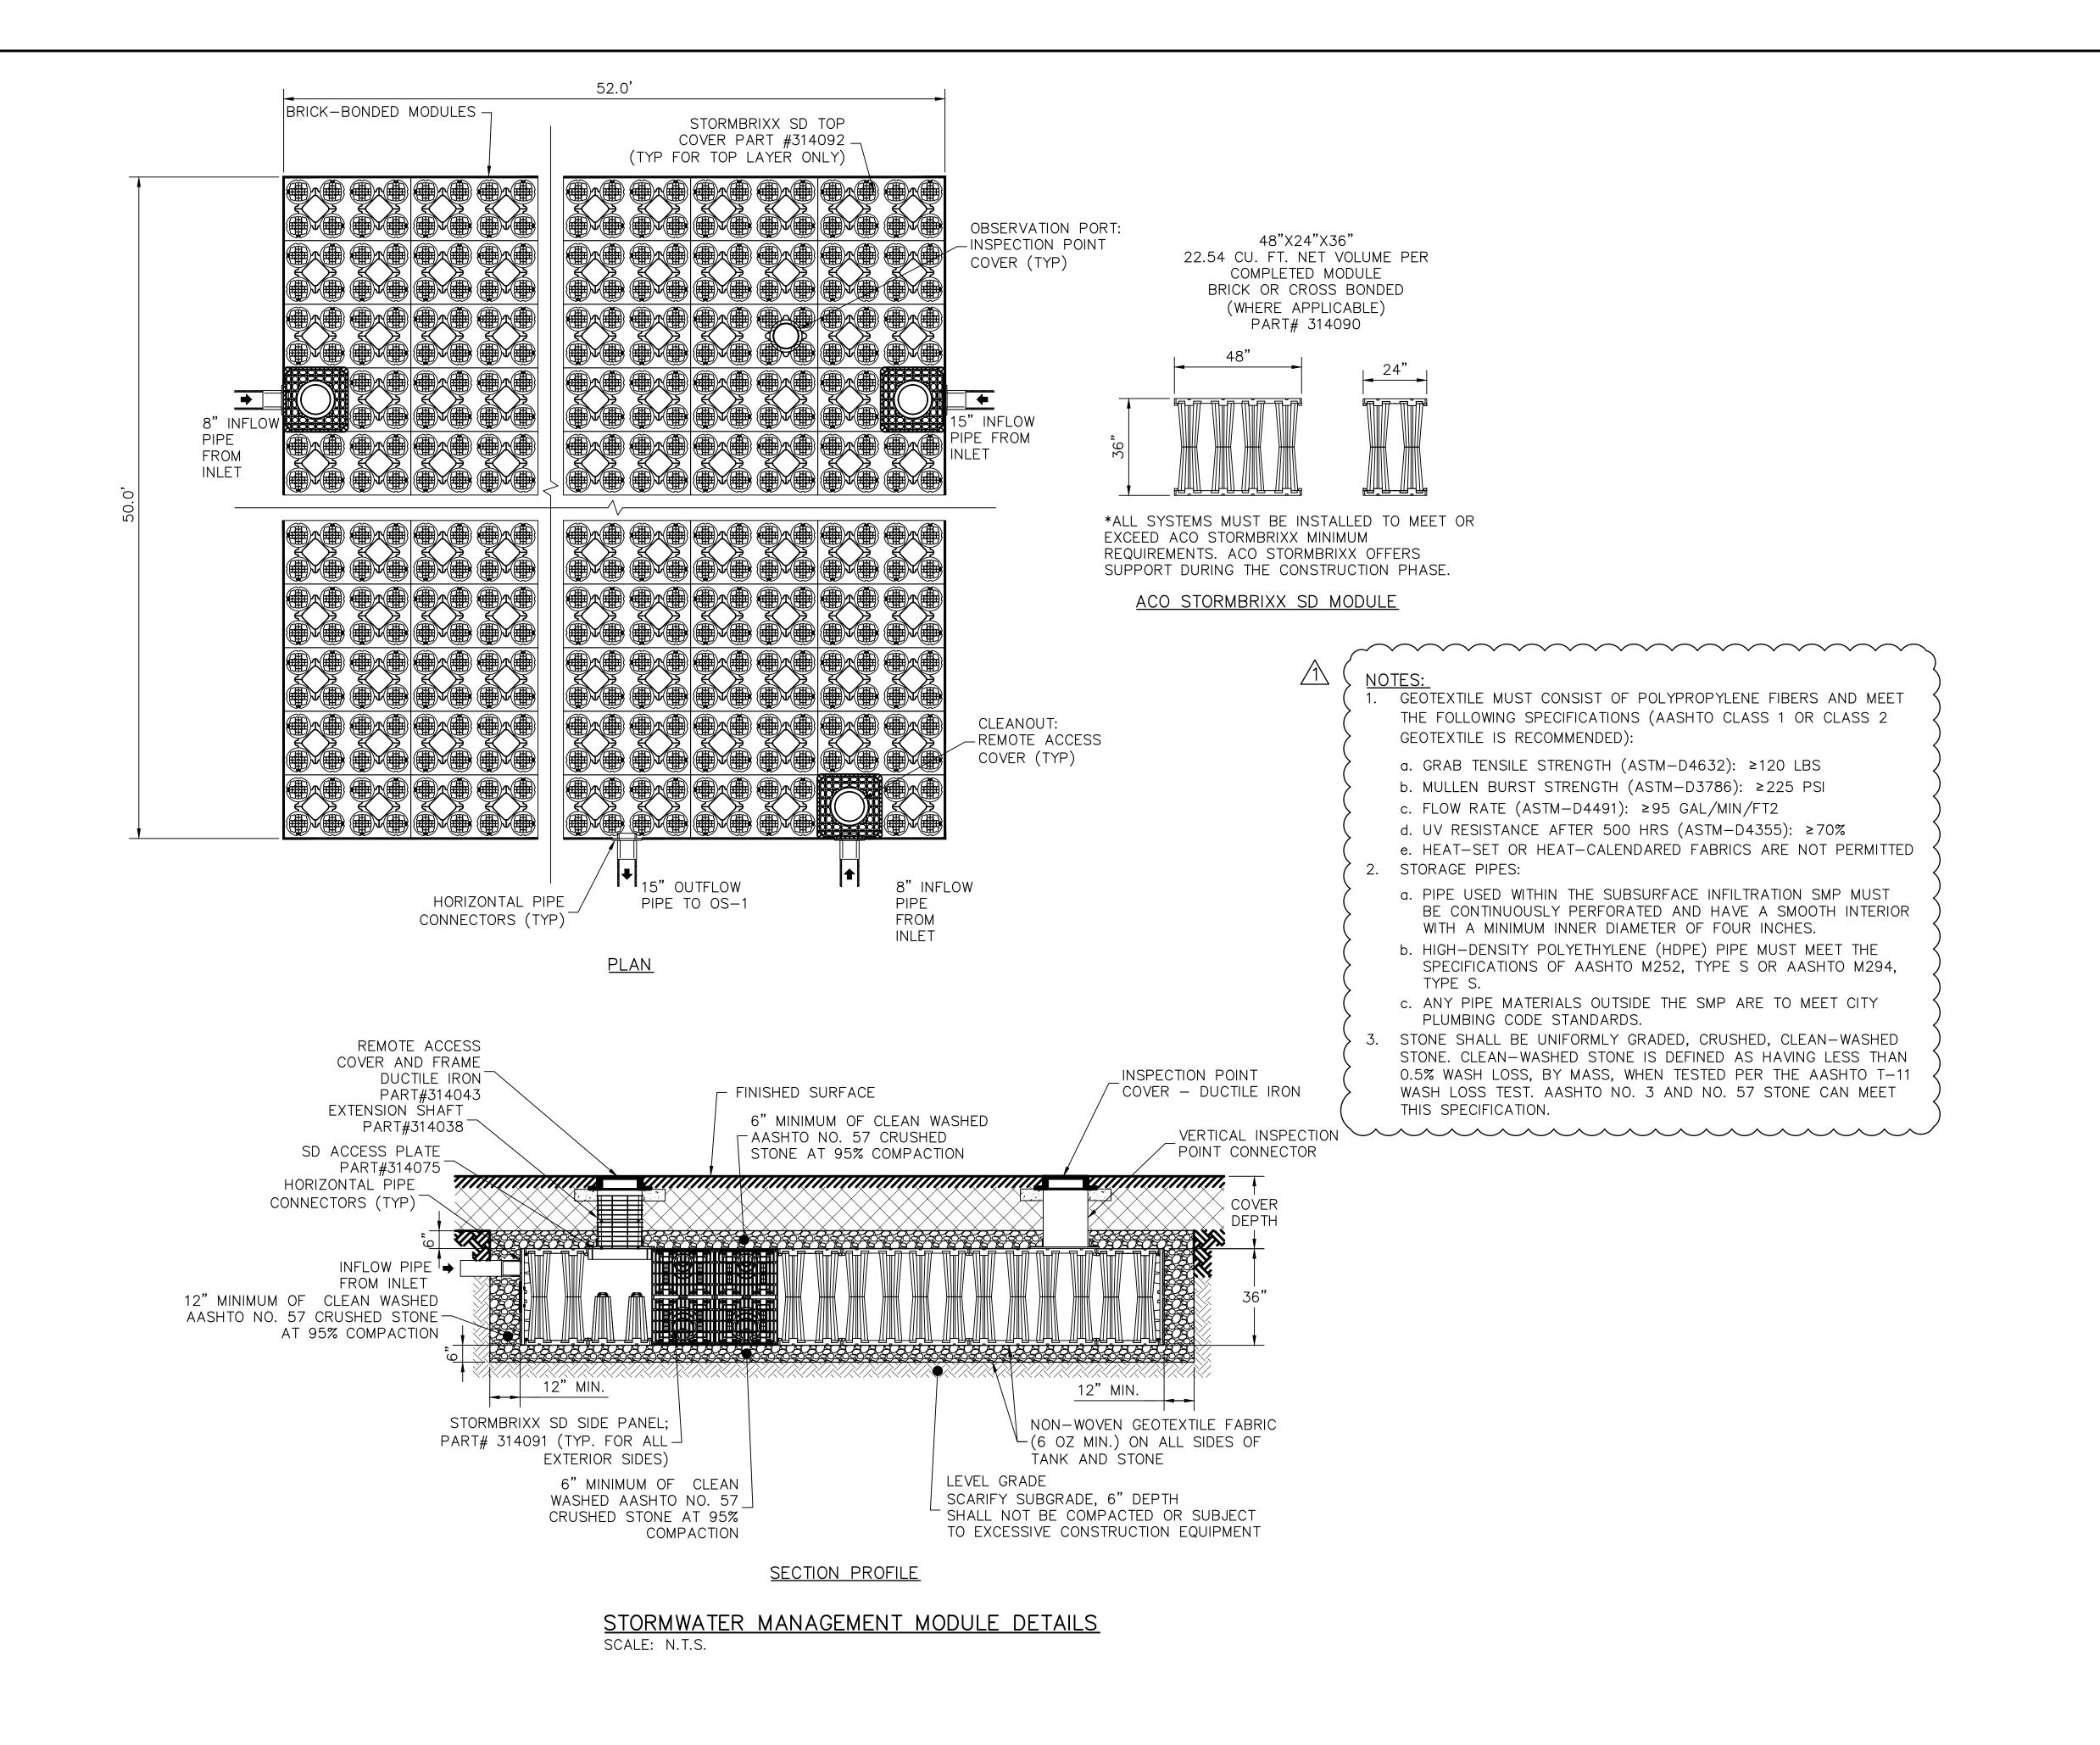

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SEAL

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CITY OF PHILADELPHIA

1515 ARCH STREET

11TH FLOOR, ONE PARKWAY BUILDING

PHILADELPHIA, PENNSYLVANIA

PROJECT TITLE

FOTTERAL SQUARE RENOVATIONS

DRAWING TITLE


UTILITY DETAILS (3)

DATE 6/10/2022

SCALE AS NOTED

DRAWN BY KSE

DRAWN BY KSE

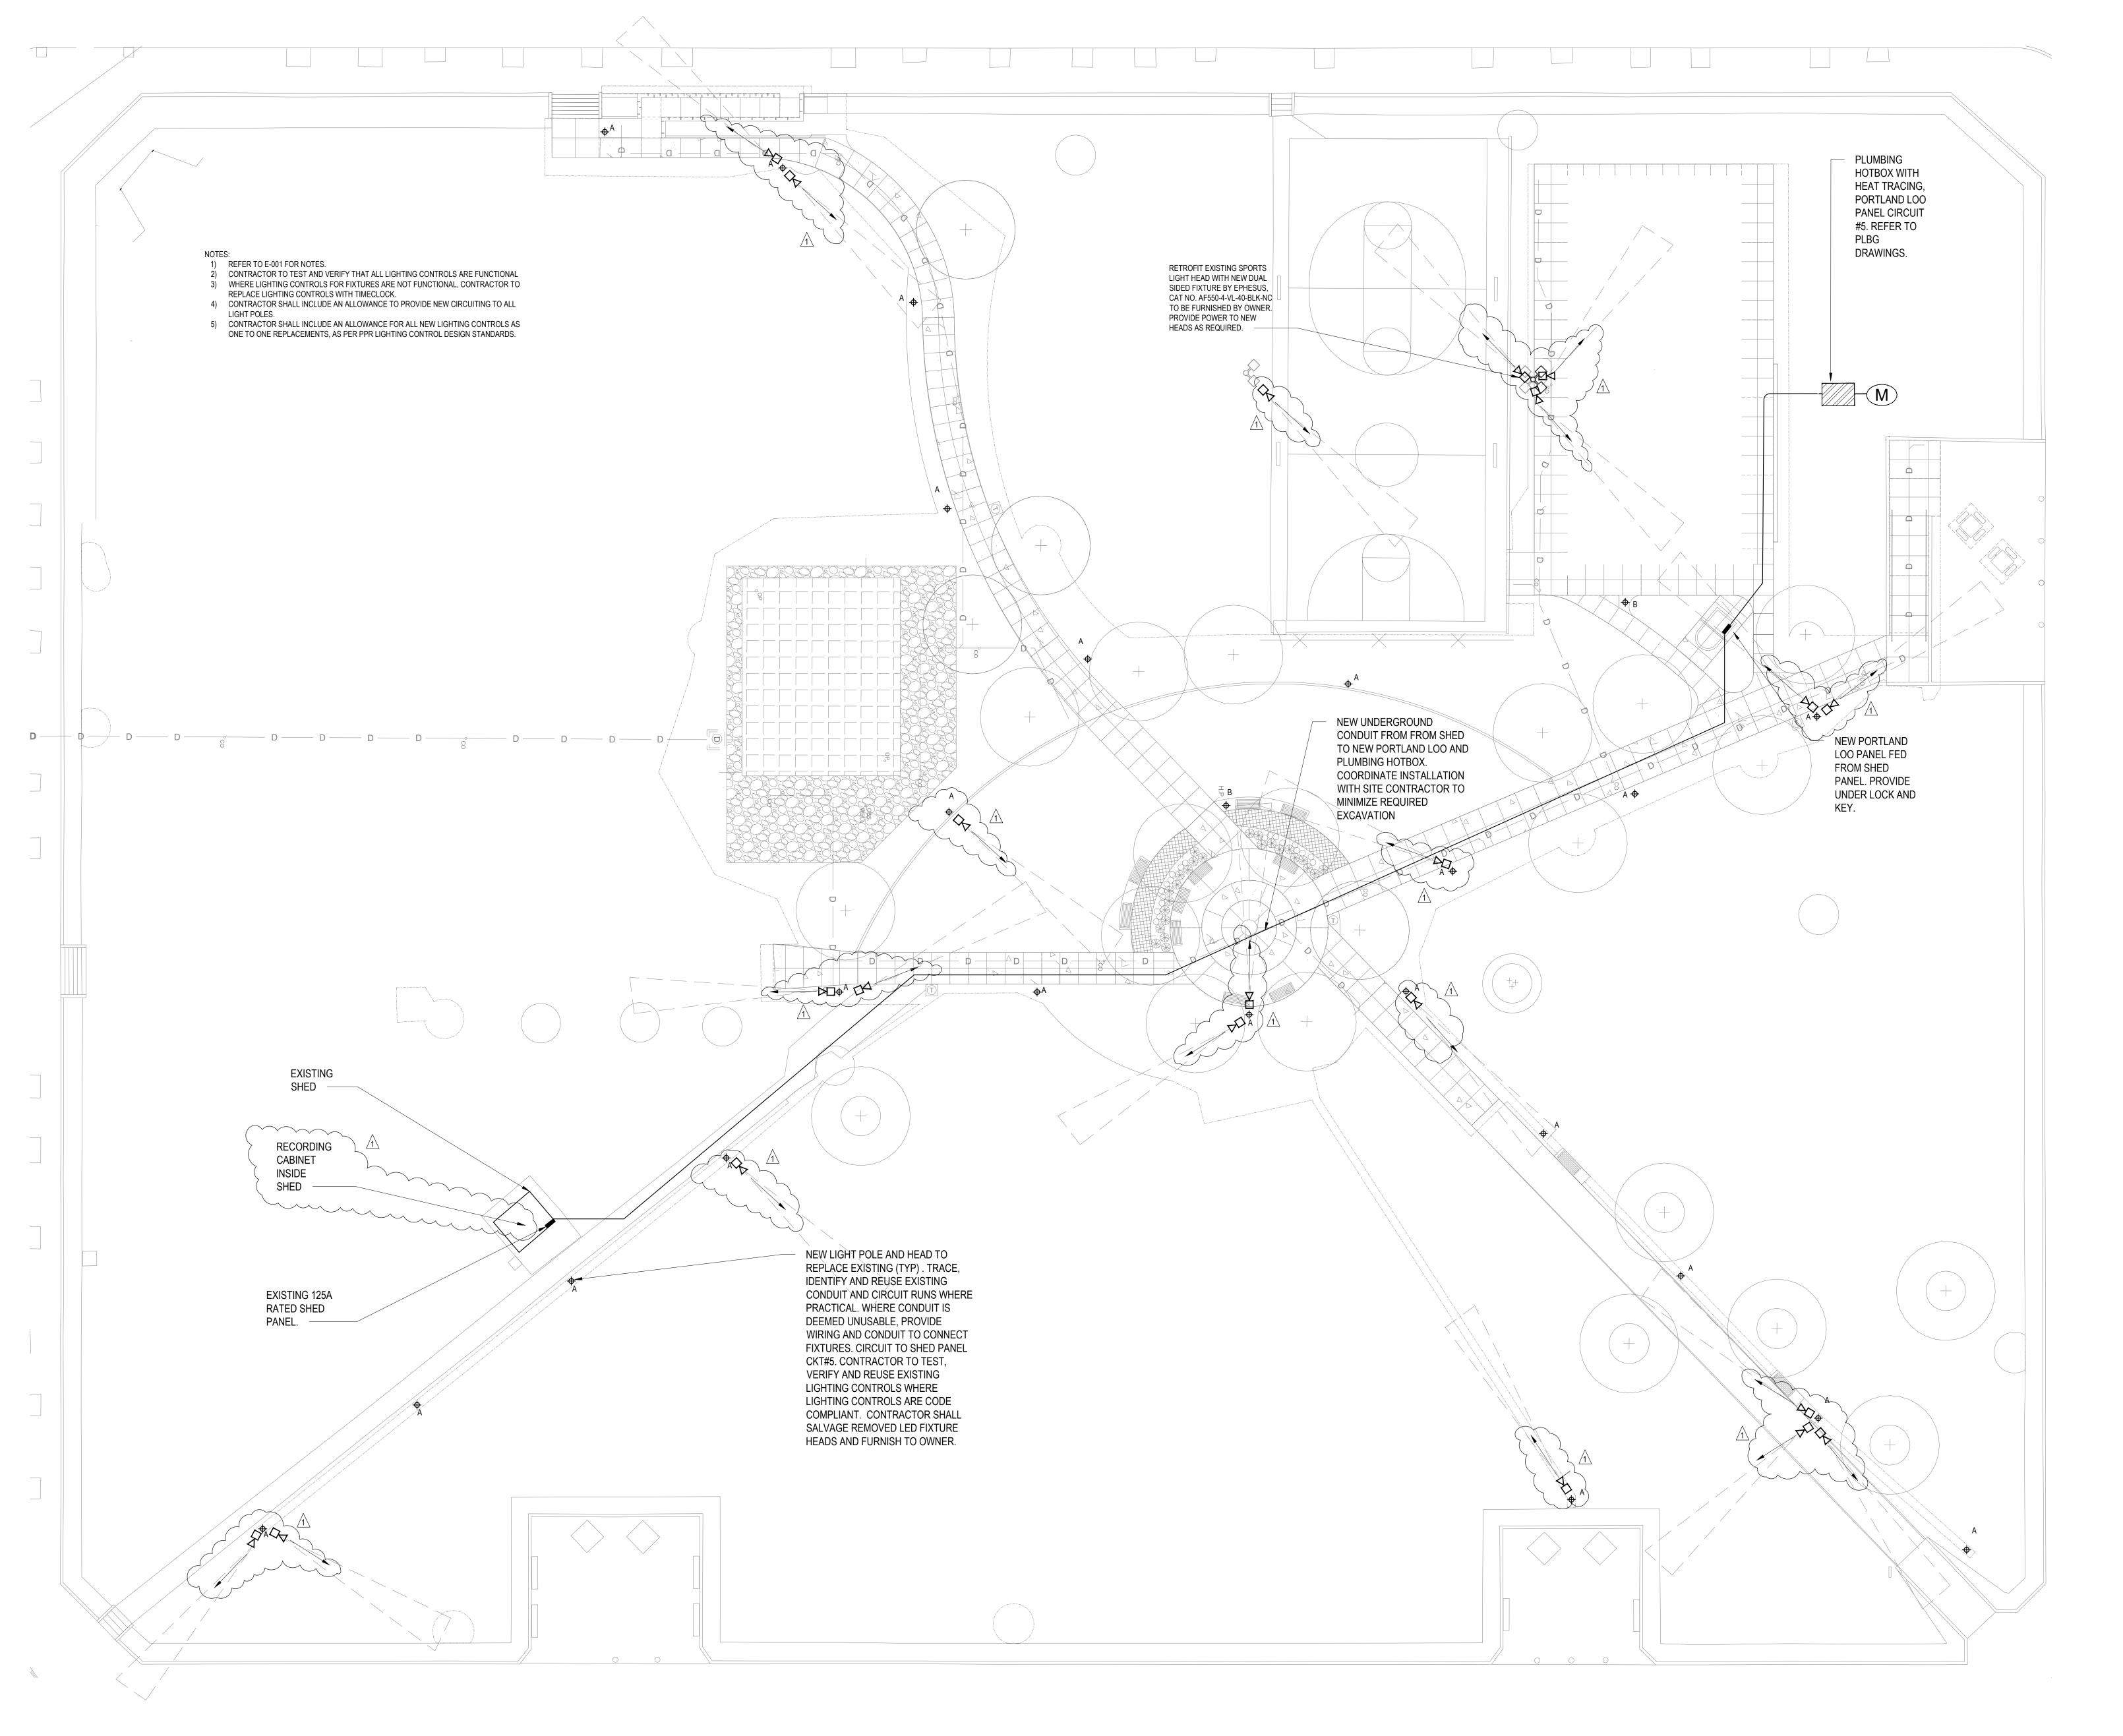

1 7/15/2022 ADDENDUM 01

PHILADELPHIA MANETO

REVISIONS

PROJECT COORDINATOR

Philadelphia Parks & Recreation and Department of Public Property 1515 Arch Street, 11th Floor Philadelphia, PA 19102

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CITY OF PHILADELPHIA

1515 ARCH STREET

11TH FLOOR, ONE PARKWAY BUILDING

PROJECT TIT

FOTTERAL SQUARE RENOVATIONS

DRAWING TITLE

ELECTRICAL SITE PLAN

DRAWING NO.

2020-513

DATE 6/10/2022

SCALE AS NOTED

DRAWN BY MS

DRAWING NO.

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IOTE: ALL DIMENSIONS AND CONDITIONS SHALL BE VERIFIED BY THE CONTRACTOR AT THE SITE BEFORE PROCEEDING WITH THE WORK.

ELECTRICAL SITE PLAN SCALE: 1/16"=1'-0"