

CITY OF PHILADELPHIA DEPARTMENT OF PUBLIC PROPERTY

MAYOR - JAMES F. KENNEY

MANAGING DIRECTOR - TUMAR ALEXANDER

COMMISSIONER OF PUBLIC PROPERTY - BRIDGET COLLINS-GREENWALD

COMMISSIONER OF FIRE DEPARTMENT - ADAM K THIEL

ENGINE 56 ENVELOPE RENOVATIONS

PROJECT NO. 13-18-4014-01

PHILADELPHIA FIRE DEPARTMENT - ENGINE 56 832 RHAWN STREET PHILADELPHIA, PA 19111

CONSTRUCTION DOCUMENTS

SMPARCHITECTS
1600 Walnut Street, 2nd Floor
Philadelphia, Pennsylvania 19103

TBS SERVICES, INC.


BUILDING ENVELOPE CONSULTANT
617 STATION AVENUE
HADDON HEIGHTS, NEW JERSEY 08035

ANN ROTHMANN


STRUCTURAL ENGINEERING

100 E. LANCASTER AVENUE, SUITE 203
WAYNE, PENNSYLVANIA 19087
610 688 2566

DHARAM CONSULTING
COST CONSULTANT
1719 CHESTNUT STREET, SUITE 300
PHILADELPHIA, PENNSYLVANIA 19103
610 554 6560

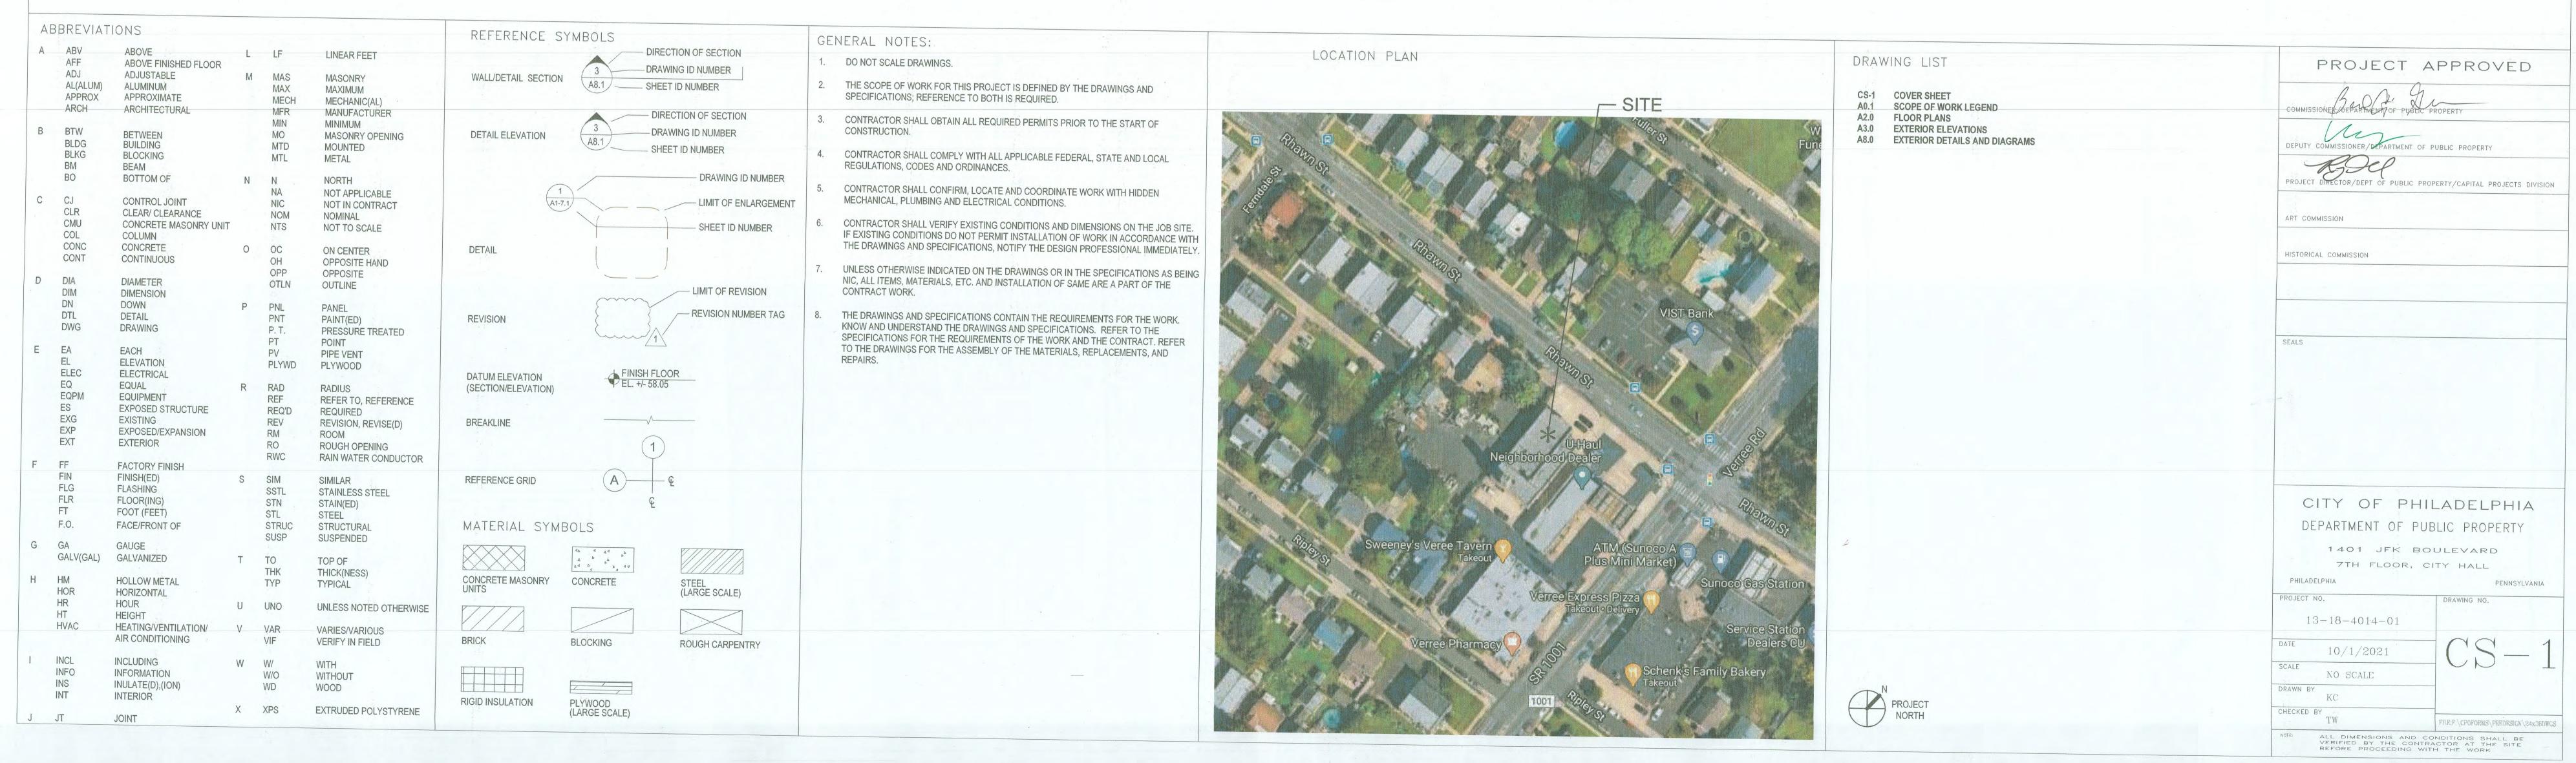

DESCRIPTION	ID DESCRIPTION	QTY	REFERENCE	l ID	DESCRIPTION	REPAIR	REFERENC
		QIT	DETAIL	CN-6	PARAPET/VERTICAL WALLS AT ROOF:	QTY	DETAIL
REPRESENTATIVE DETAILS, PROFILES, AND DIMENSIONS NOTED ARE APPROXIMATE. FIELD VERIFY CONDITIONS, DIMENSIONS, AND ASSEMBLIES. DETAILS SHOWN ARE INTENDED FOR SPECIFIC LOCATIONS AND CONDITIONS. MINOR MODIFICATIONS MAY BE REQUIRED TO SUIT SIMILAR CONDITIONS AND SHALL BE CONSIDERED PART OF THE WORK. CONTRACTOR SHALL EXERCISE CARE SO AS NOT TO DAMAGE EXISTING BUILDING DURING CONSTRUCTION. CONTRACTOR IS RESPONSIBLE FOR ANY DAMAGE TO	CN-1 LIMESTONE COPING REMOVE, RESET, AND REPOINT 100% OF LIMESTONE COPING CAREFULLY REMOVE EXG COPING STONES AND STORE FOR RE- INSTALLATION. PROTECT ALL EXG ROOF SURFACES DURING WORK WITH PLYWD SHEATHING OR APPROVED ALT. MATERIAL. CLEAN LIMESTONE COPING STONES PRIOR TO REINSTALLATION. SEE SPEC FOR CLEANING SCOPE. CLEAN WALL AREAS AS NECESSARY TO PREPARE FOR NEW CAP FLASHING INSTALLATION.			GIV-0	 AT EXPOSED FACE OF MASONRY ON ROOF SIDE PARAPET WALLS, COMPLETELY REMOVE ALL PREVIOUS COATINGS, SEALANTS, AND DEBRIS. PREP WALL TO RECEIVE NEW COATING PER MFR'S REQ. APPLY NEW BREATHABLE MASONRY COATING TO EXPOSED BRICK. REPOINT EXG MORTAR JOINTS (SEE MORTAR NOTES). GRIND OUT/REMOVE SEALANT JOINT AT EXG MTL FLASHING TO REMAIN. PROVIDE NEW CONT. SEALANT. 	SEE DWGS FOR QTY	
THE EXISTING BUILDING, SITE, AND EQUIPMENT DURING CONSTRUCTION, INCLUDING DAMAGE FROM THE ELEMENTS. CONTRACTOR SHALL REPAIR ANY DAMAGE IMMEDIATELY AND TO THE SATISFACTION OF THE OWNER.	 PROVIDE CONTINUOUS SSTL CAP FLASHING (304, 28GA). EXTEND NEW CAP FLASHING ACROSS FULL WIDTH OF PARAPET WALL. TERMINATE OUTSIDE EDGE FLUSH W/ EXTERIOR F.O. STONE AND ROOF SIDE EDGE W/ A 3/4" HEM BEND. SET OUTSIDE EDGE OF FLASHING IN CONT. BEAD OF MASTIC. MODIFY EXG COPPER FLASHING AT ROOF TERMINATION AS REQ'D TO FACILITATE NEW CAP FLASHING INSTALLATION. HEM BEND OF NEW CAP FLASHING TO FLASH OVER EXG COPPER FLASHING TO REMAIN. SET WEEP MATERIAL ON FLASHING IN A CONT. BELT ALIGNED W/ THE OUTSIDE EDGE AND LEGS EXTENDING TOWARD THE ROOF. PLACE FULL BED OF MORTAR ACROSS WEEP MATERIAL AND FLASHING AND INSTALL COPING STONES INTO MORTAR BED. 	100% OF COPING SEE DWGS FOR LF		CN-7	VERTICAL WALLS AT ROOF: GRIND OUT/REMOVE SEALANT JOINT AT EXG MTL FLASHING TO REMAIN. PROVIDE NEW CONT. SEALANT.	SEE DWGS FOR QTY	
WINDOW REMOVEL AND REPLACEMENT IS N.I.C. EXG WINDOWS SHALL BE REMOVED/REPLACED UNDER SEPARATE CONTRACT BY SEPARATE CITY CONTRACTOR, CONCURRENT WITH THIS PROJECT. CONTRACTOR TO COORDINATE SCHEDULE AND WORK WITH WINDOW CONTRACTOR				CN-8A	LIMESTONE CRACKS/CHIPPING/HOLES: ONLY SPECIFIC LOCATIONS ARE KEYED ON ELEVATIONS. OTY INCLUDES KEYED LOCATIONS AND ASSUMED SF OF ADDITIONAL REPAIR. EXG LIMESTONE TO REMAIN IN PLACE; PROVIDE PATCHING COMPOUND TO MATCH EXG. AT CHIPPED CORNERS AND EDGES, PROVIDE DUTCHMAN REPAIR AND PATCHING	10% OF LIMESTONE SF PER ELEVATION 20% EAST	
NORTH ELEVATION / APPARATUS ENTRY: AT LEAST (1) OVERHEAD OPENING AT THE NORTH (RHAWN ST) ELEV MUST REMAIN CLEAR AND OPEN FOR EMERGENCY VEHICLES THROUGHOUT CONSTRUCTION. GC TO COORD SCAFFOLDING LOCATIONS AND SCHEDULE W/ OWNER.	 PIN COPING STONES ENDS TO END. DRILL 7/16" X 3" LONG HOLES INTO CENTER OF ENDS OF 8" LIMESTONE CAP. INSTALL 3/8" X 6" LONG A304 SSTL SMOOTH DOWEL INTO ADJACENT STONES AND GROUT FACE JOINT. TOOL BED JOINT TO MATCH EXG AND LIGHTLY SCORE WEEP LEGS AT FACE OF WALL WHILE MORTAR IS STILL PLASTIC. 			CN-8B	COMPOUND TO MATCH EXG. CONTRACTOR TO PROVIDE UNIT PRICE (SEE SPECS). BROKEN LIMESTONE UNITS: TYPICAL UNITS ARE APPROX 44"L X 8"H (VIF)	ELEV ONLY	
SCOPE OF WORK NOTES (GENERAL)	OF WALL WHILE MORTAR IS STILL PLASTIC. PROVIDE NEW MORTAR JOINTS AT COPING STONE HEAD AND SKYWARD FACING JOINTS. BRICK CRACK REPAIR (LARGER THAN 1/16" HAIRLINE) - GENERAL SEE ELEVATION DWGS FOR GENERAL CRACK LOCATIONS; SEE NOTES CN-2 AND CN-3 BELOW FOR DESCRIPTION OF REPAIR WORK UNIT OF MEASUREMENT (LF) REFERS TO APPROX. LENGTH OF CRACKING PER FACADE. SEE REPAIR DIAGRAM AND NOTES BELOW FOR EXTENT OF WORK IN REPAIR AREA. CONTRACTOR TO PROVIDE UNIT PRICE FOR CRACK REPAIR (SEE SPECS).			CN-9	 REMOVE UNIT, PROVIDE DUTCHMAN AND MECHANICAL REPAIR WITH SSTL PINS AND GROUT. PROVIDE PATCHING COMPOUND TO MATCH EXG AND REINSTALL. CONTRACTOR TO PROVIDE UNIT PRICE (SEE SPECS). 	3 UNITS	
MORTAR: REPOINT 100% OF MORTAR JOINTS REMOVE/GRIND OUT EXG MORTAR TO UNIFORM DEPTH 3/4" MIN BACK TO SOUND MATERIAL REPOINT W/ NEW MORTAR; SEE SPECS FOR DETAILS EXTERIOR CLEANING:					OUT OF PLANE WALLS: (SEE ELEV FOR LOCATIONS) REPAIR WALL TO REALIGN W/ ADJACENT BRICK AND PARAPET REMOVE OUTER WYTHE OF FACE BRICK DOWN TO EXG LIMESTONE BAND, SALVAGING SOUND BRICK FOR REINSTALLATION. PREP BACK-UP BRICK WALL TO PROVIDE FLUSH CONDITION W/ REINSTALLED COPING.	EAST 32SF WEST 104SF	
 CLEAN 100% OF EXG BRICK AND LIMESTONE (COPING, SURROUNDS, BANDS, BASE, CHIMNEY CAP); SEE SPEC FOR DETAILS. SEE EXG MOCKUP AREA FOR LEVEL OF CLEANING BENCHMARK. 	CN-2 BRICK CRACK REPAIR (NORTH AND NORTHEAST ELEV ONLY) REMOVE AND REPLACE CRACKED BRICK • WHERE SPALLING OR CRACKING LARGER THAN 1/16" HAIRLINE OCCURS				 REINSTALL SALVAGED OR NEW BRICK TO MATCH, PROVIDING RETROFIT WALL TIES SPACED AT ONE TIE PER 2 SF OF WALL SURFACE. SEE MORTAR NOTES. CONTRACTOR TO PROVIDE UNIT PRICE (SEE SPEC) 		
WALL-MOUNTED EQPM: ERE WALL-MOUNTED EQPM IS TO REMAIN, REMOVE AND RESEAL AROUND LL PENETRATIONS.	THROUGH BRICK (NOT AT JOINTS), CAREFULLY REMOVE CRACKED BRICK AND ADJACENT BRICKS AS SHOWN, SALVAGING UNDAMAGED BRICK UNITS WHERE POSSIBLE. CLEAN AND STORE BRICKS FOR REUSE. REMOVE ENTIRE UNITS FROM JOINT TO JOINT WITHOUT DAMAGING SURROUNDING MASONRY IN A MANNER THAT PERMITS REPLACEMENT WITH FULL-SIZE UNITS. SUPPORT AND PROTECT REMAINING MASONRY AND WALL COMPONENTS SURROUNDING AREA OF REMOVAL. INSTALL SALVAGED AND/OR NEW BRICK UNITS (TO MATCH) TOOTHED INTO EXG WALL. BONDING AND COURSING PATTERN TO MATCH EXG.	NORTH 226LF NORTHEAST 25LF	1/A8.0	CN-9A	OUT OF PLANE WALLS AT ROOF: ON BACKSIDE OF PARAPET WALL AT ROOF, REPAIR WALL TO REALIGN W/ ADJACENT BRICK AND PARAPET • REMOVE TOP TWO COURSES OF FACE BRICK UNDER THE LENGTH OF (1) COPING. • PREP BACK-UP BRICK WALL TO PROVIDE FLUSH CONDITION W/REINSTALLED COPING. • REINSTALL SALVAGED OR NEW BRICK TO MATCH, PROVIDING RETROFIT WALL TIES SPACED AT ONE TIE PER 2 SF OF WALL SURFACE. • SEE MORTAR NOTES.	SEE DWGS FOR QTY	
	MAX. 2 SF (4" HORIZONTAL SPACING ON BOTH SIDES FROM CENTER OF CRACK LINE, 16" VERTICAL SPACING) • SEE MORTAR REPOINTING NOTES. NORTHEAST PIER ONLY • REMOVE EXG MTL GATE HINGES • TEMPORARILY REMOVE AND SALVAGE EXG LIMESTONE CAP, CLEAN CAP BEFORE REINSTALLATION • REBUILD END OF EXG BRICK PIER	PIER 8SF		CN-10	INTERIOR GLAZED TILE AT WINDOW HEADS - DISPLACED RESET DISPLACED GLAZED TILE • TEMPORARILY REMOVE EXG WINDOW SHADES; REINSTALL WHEN WORK IS COMPLETE • REMOVE AND SALVAGE (1) ROW OF EXG GLAZED TILE AT UNDERSIDE OF WINDOW HEAD • PREP SUBSTRATE TO PROVIDE A FLUSH CONDITION FOR REINSTALLATION. • RE-ATTACH SALVAGED TILES IN MORTAR BED AND REGROUT TO MATCH TYPE, COLOR, AND PROFILE OF EXG. • CONTRACTOR TO PROVIDE UNIT PRICE (SEE SPECS)	SEE DWGS FOR QTY	2/A8.0
	CN-3 BRICK CRACK REPAIR (NORTH AT ROOF, SOUTH, WEST, EAST ELEV ONLY) CRACKED BRICK TO REMAIN IN PLACE, NEW MORTAR IN CRACKS REMOVE/GRIND OUT EXG MORTAR OR SEALANT INFILL IN CRACKED BRICK. PREP EDGES OF BRICK AT CRACKS TO PROVIDE CONSISTENT EDGE. PROVIDE NEW MORTAR IN CRACKS (SEE MORTAR REPOINTING NOTES). ANCHOR BRICK AREAS WITH HELIFIX OR SPIRALOK TIES AT MAX. 2 SF (4" HORIZONTAL SPACING ON BOTH SIDES FROM CENTER OF CRACK LINE, 16" VERTICAL SPACING)	SOUTH 80LF WEST 146LF EAST 138LF NORTH AT ROOF 47LF		CN-11	INTERIOR GLAZED TILE AT WINDOW HEADS - REGROUT: REGROUT EXG GLAZED TILE TO REMAIN • TEMPORARILY REMOVE EXG WINDOW SHADES; REINSTALL WHEN WORK IS COMPLETE *NO EXG SHADES AT APPARATUS ROOM WINDOWS • EXG GLAZED TILE TO REMAIN IN PLACE • REMOVE HORIZONTAL GROUT JOINT AT UNDERSIDE OF WINDOW HEAD. CLEAN EDGES OF TILE AND PREP FOR NEW GROUT. • PROVIDE NEW GROUT JOINT TO MATCH TYPE, COLOR, AND PROFILE OF EXG. • CONTRACTOR TO PROVIDE UNIT PRICE (SEE SPECS)	SEE DWGS FOR QTY	2/A8.0
	CN-4 WINDOW LINTELS: REPLACE OUTER LINTELS AT WINDOW OPENINGS REMOVE EXG BRICK/LIMESTONE HEADER REMOVE EXG BRICK ABOVE HEADER AS REQ'D TO INSTALL NEW THRU-WALL FLASHING (ASSUME 3 WYTHES MIN). SUPPORT EXG BRICK ABOVE OPEN AREAS. INSTALL NEW GALV STL LINTEL. PROVIDE PROTECTIVE COATING FINISH. CLEAN AREAS AS NECESSARY TO PREP FOR NEW FLASHING SYSTEM INSTALL. CUT A CONTINUOUS REGLET 1-1/2" MIN IN EXG BED JOINT OF BACK-UP BRICK. PROVIDE NEW 2-PIECE CONT. S.S. FLASHING (304, 28GA). LAP VERT FLASHING LEGS 3" MIN AND SEAL W/ CONT SEALANT. TURN UP/END DAM FLASHING 2" MIN AT ENDS OF LINTEL. END DAMS SHALL BE OF BENT METAL AND/OR HAVE SOLDERED SEAMS. SET FLASHING IN CONT. BEAD OF MASTIC. RESET SALVAGED OR NEW BRICK/LIMESTONE TO MATCH EXG AND CONFIGURATION. SEE MORTAR REPOINTING NOTES. PROVIDE FULL DEPTH HORIZ AND VERT MORTAR JOINTS.	100% OF LINTELS SEE DWG A8.0 FOR LINTEL SCHEDULE	2/A8.0	CN-13	ROOF LADDERS: REMOVE EXG MTL ROOF LADDERS FOR BRICK/MORTAR REPAIR WORK PROVIDE NEW LADDERS IN EXG LOCATIONS PATCH AND INFILL EXG FASTENER HOLES W/ MORTAR. EAST FACADE LOWER LADDER: REPLACE (2) BROKEN BRICKS AT WALL SUPPORT. TOWER REMOVAL: REMOVE EXG MASONRY TOWER TO (8) BRICK COURSES ABV EXG COPING SALVAGE UNDAMAGED FACE BRICK UNITS WHERE POSSIBLE. CLEAN AND STORE BRICKS FOR REUSE. PROVIDE NEW MTL ROOF DECK AND SBS ROOFING SYSTEM ON EXG BRICK TOWER WALLS TO REMAIN. AT WALLS TO REMAIN, INFILL RECESSED FACE BRICK AT CENTER OF WALL TO BE FLUSH W/ ADJ PROVIDE ROOF PROTECTION FOR EXG ADJACENT ROOFING AND FLASHING TO REMAIN.	3 LADDERS; SEE DWGS FOR HT SEE DWGS FOR QTY	4/A8.0 5/A8.0 6/A8.0
	CN-5 DOOR LINTELS: REPLACE OUTER LINTELS, REPLACE CRACKED BRICK JAMBS TEMPORARILY REMOVE EXG LIGHTING ABV DOOR; REINSTALL AFTER COMPLETION OF WORK. REMOVE AND SALVAGE EXG BRICK HEADER REMOVE AND SALVAGE EXG BRICK ABOVE HEADER AS REQ'D TO INSTALL NEW THRU-WALL FLASHING (ASSUME 3 WYTHES MIN). SUPPORT EXG BRICK ABOVE OPEN AREAS. REMOVE AND REPLACE CRACKED BRICK AT TOP OF JAMBS (16" MIN) INSTALL NEW GALV STL LINTEL. PROVIDE PROTECTIVE COATING FINISH. CLEAN AREAS AS NECESSARY TO PREP FOR NEW FLASHING SYSTEM INSTALL. CUT A CONTINUOUS REGLET 1-1/2" MIN IN EXG BED JOINT OF BACK-UP BRICK. PROVIDE NEW 2-PIECE CONT. S.S. FLASHING (304, 28GA). LAP VERT FLASHING LEGS 3" MIN AND SEAL W/ CONT SEALANT. TURN UP/END DAM FLASHING 2" MIN AT ENDS OF LINTEL. END DAMS SHALL BE OF BENT METAL AND/OR HAVE SOLDERED SEAMS. SET FLASHING IN CONT. BEAD OF MASTIC. RESET SALVAGED OR NEW BRICK/LIMESTONE TO MATCH EXG AND CONFIGURATION. SEE ABOVE FOR MORTAR. PROVIDE FULL DEPTH HORIZ AND VERT MORTAR JOINTS. SEE DWG. A8.0 FOR LINTEL SCHEDULE.		2/A8.0 SIM	CN-14	• EXG STL DOOR SOFFIT/LINTELS TO REMAIN AT OVERHEAD DOORS. PREP AND REPAINT ONLY.	SEE DWGS FOR QTY	
		100% OF LINTELS		CN-15	 CRACKED POLISHED GRANITE BASE: CRACKED POLISHED GRANITE TO REMAIN IN PLACE PREP EDGES OF GRANITE AT CRACK TO PROVIDE CONSISTENT EDGE. PROVIDE NEW PATCHING REPAIR COMPOUND IN CRACK TO MATCH EXG COLOR. 	NORTH / NORTHEAST 2LF	
		SEE DWG A8.0 FOR LINTEL SCHEDULE			 EXG CONDUIT/WIRES: (NORTH AND EAST FACADE) CONTRACTOR TO PROVIDE TEMPORARY SUPPORTS FOR CONDUIT/ WIRING ATTACHED TO BUILDING FACADE TO ALLOW FOR MASONRY WORK. ABANDON/REMOVE EMPTY CONDUIT. REPLACE SECTIONS OF RUSTED CONDUIT AND BOXES. PROVIDE NEW CLAMPS/ANCHORS AND REATTACH EXG CONDUIT. CONSOLIDATE AND BUNDLE WIRING, PROVIDE CABLE TIES PROVIDE NEW 2" SSTL J-HOOKS WITH RETAINER CLIPS EVERY 8' (HORIZ), AND 2" BRIDLE RING W/ WIRE HARNESS (VERTICAL); PROVIDE NON-CORROSIVE ANCHORS AND WASHERS. HOOKS/HARNESS TO BE DATA SENSITIVE. CONSOLIDATE INTO A SINGLE PENETRATION THROUGH WINDOW OPENING EW1 AND COORD W/ WINDOW CONTRACTOR MOURNING BUTTONS: (NORTH FACADE ONLY) PROVIDE NEW SSTL MOURNING BUTTONS PROVIDE MASONRY ANCHOR SLEEVE AND INSTALL MORTAR JOINT (NOT IN 	REPLACE CONDUIT 75LF CABLE MGMT 120LF	

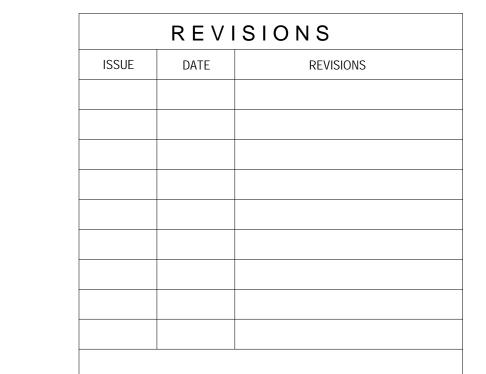



CONSTRUCTION DOCUMENTS

ROY CONARD

SPACE FOR CONSULTANT RECOGNITION

SMPARCHITECTS

1600 Walnut Street, 2nd Floor
Philadelphia, Pennsylvania 19103
215 985 4410

BUILDING ENVELOPE CONSULTANT

TBS Services, Inc. 617 Station Avenue Haddon Heights, New Jersey 08035 856 547 6254

PROJECT DIRECTOR

STRUCTURAL ENGINEER
Ann Rothmann Structural Engineering
100 East Lancaster Avenue, Suite 203
Wayne, Pennsylvania 19087
610 688 2566

COST CONSULTANT

Dharam Consulting
1719 Chestnut Street, Suite 300
Philadelphia, Pennsylvania 19103
610 554 6560

CITY OF PHILADELPHIA
DEPARTMENT OF PUBLIC PROPERTY

1401 JFK BOULEVARD

7TH FLOOR, CITY HALL

PHILADELPHIA
PROJECT TITLE


ENGINE 56 EXTERIOR ENVELOPE RENOVATIONS


PENNSYLVANIA

DRAWING TITLE

SCOPE OF WORK LEGEND

PROJECT NO.	DRAWING NO.
13-18-4014-01	
DATE 07/11/2022	AO 1
AS NOTED	
DRAWN BY KC	
CHECKED BY TW	FILE:
	IONS SHALL BE VERIFIED BY THE RE PROCEEDING WITH THE WORK

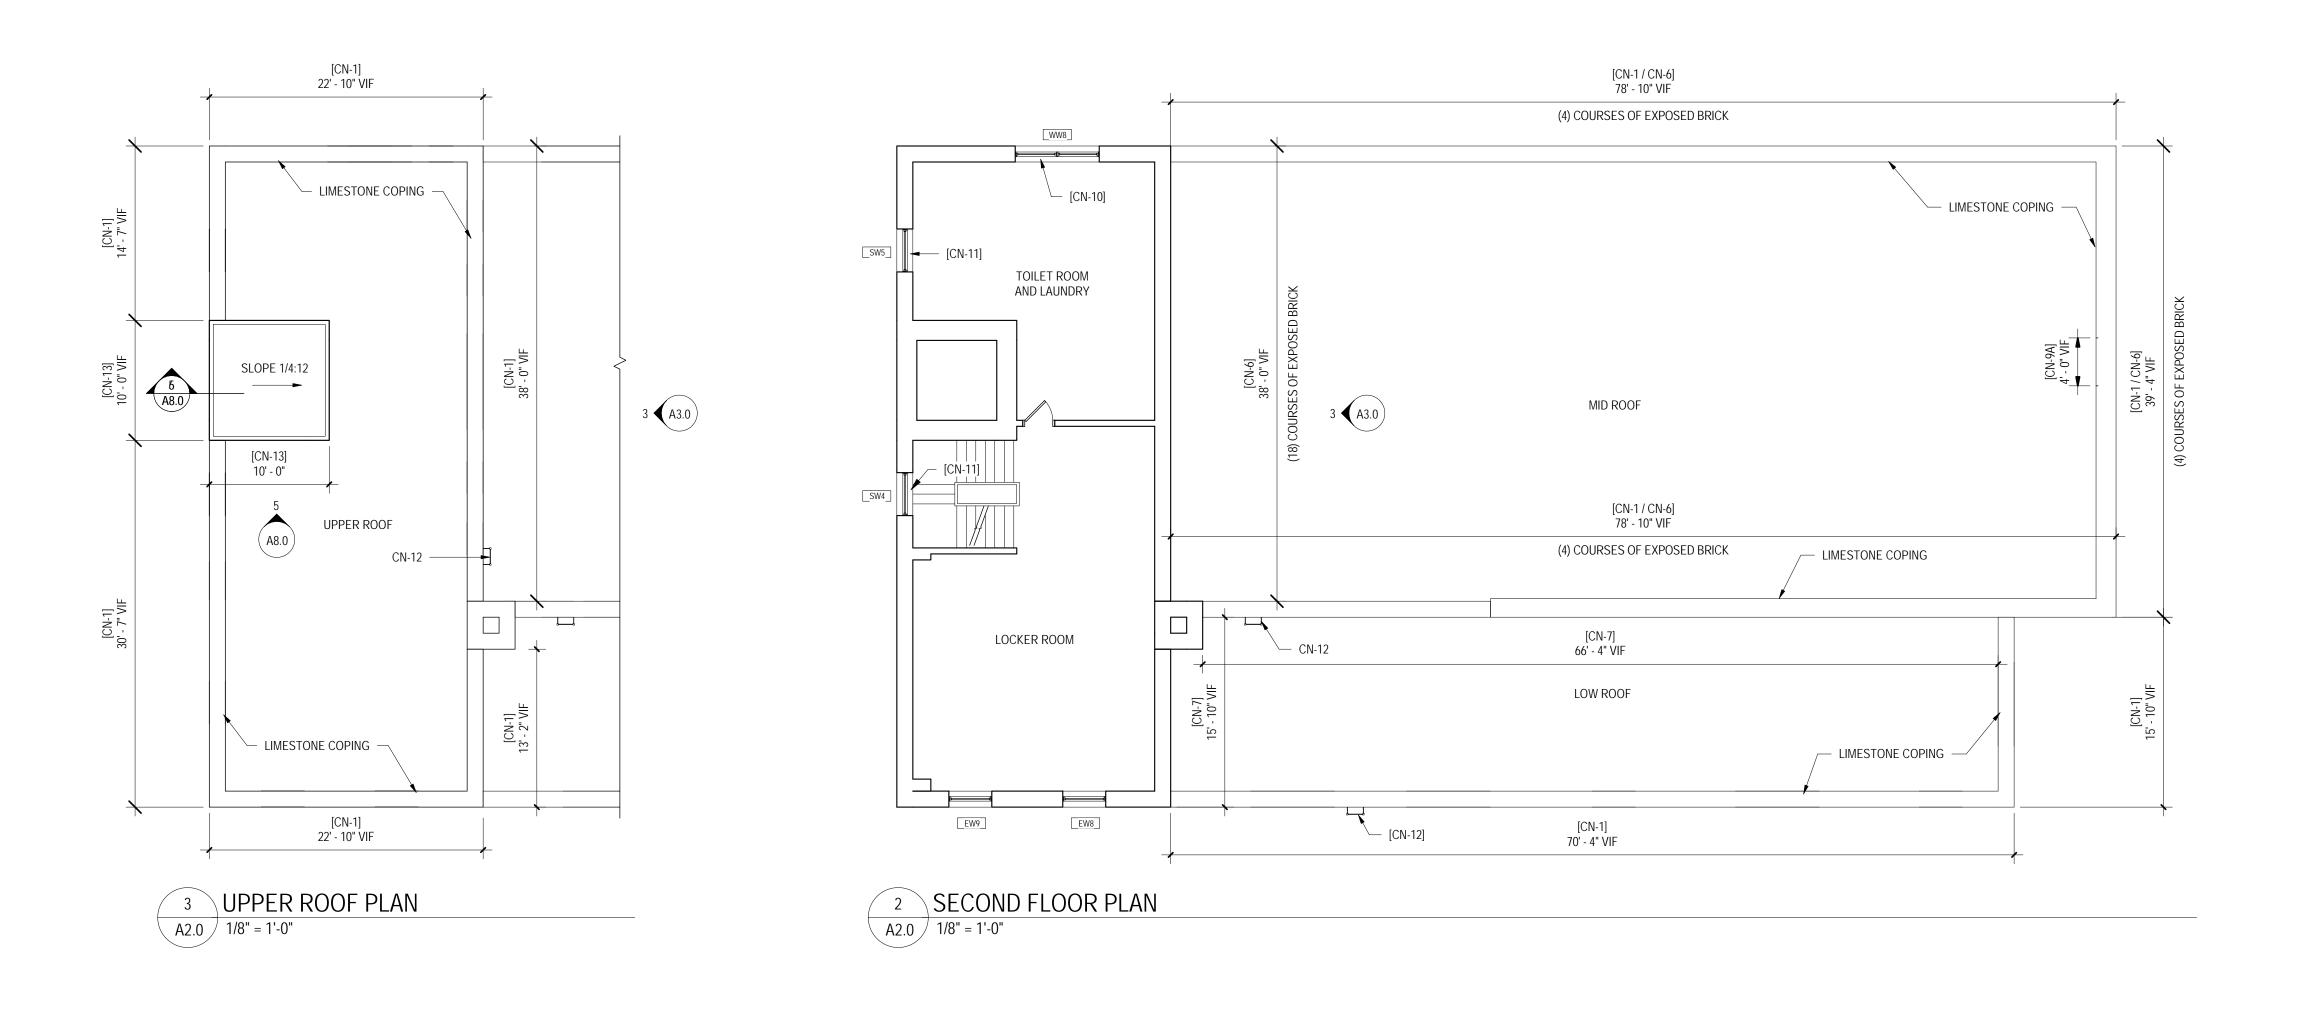

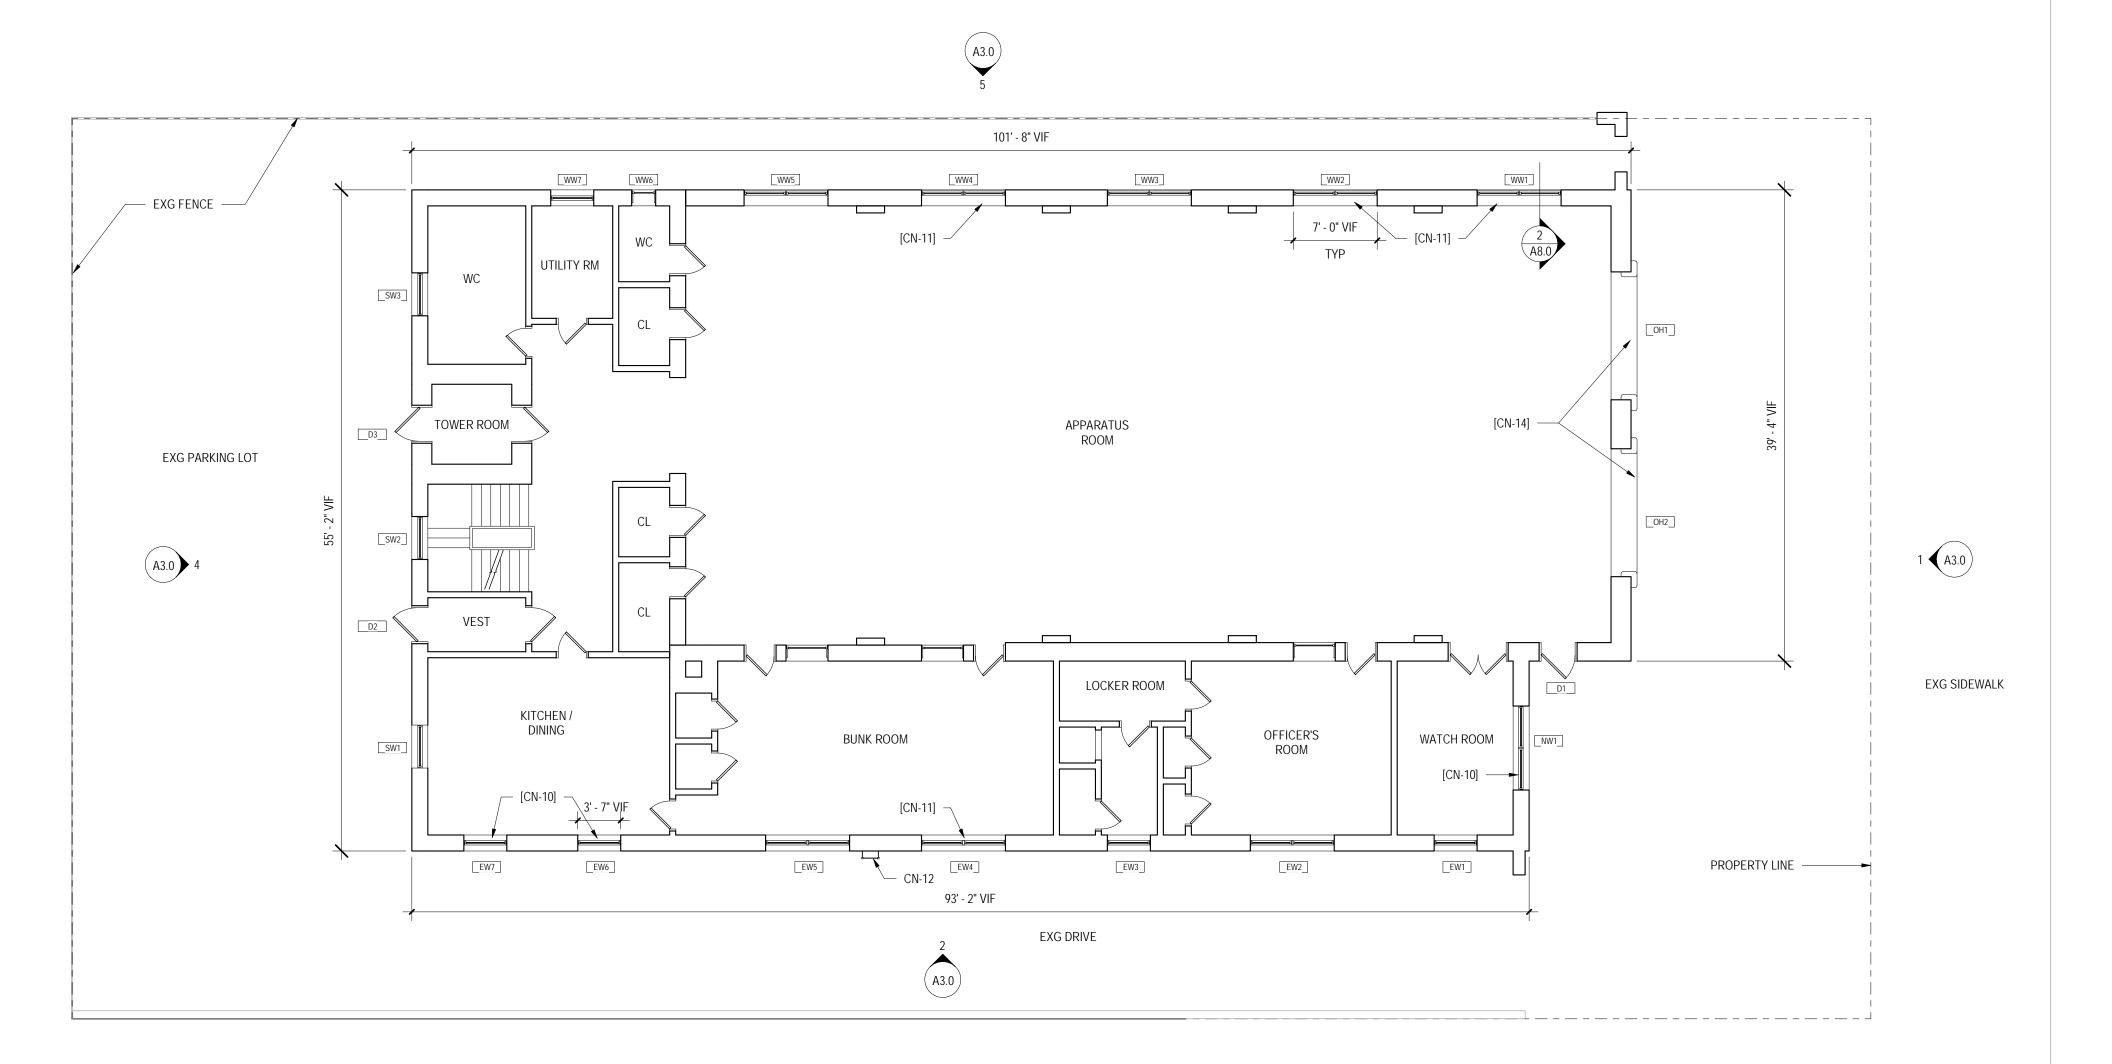


FIRST FLOOR PLAN A2.0 1/8" = 1'-0"

GENERAL NOTES

- 1. PLANS AND DIMENSIONS ARE SHOWN FOR REFERENCE ONLY.
- 2. INTERIOR WORK IS LIMITED; SEE KEYED NOTES BELOW FOR SPECIFIC INTERIOR REPAIR WORK.
- 3. CONTRACTOR IS TO PROVIDE PROTECTION FOR EXISTING ROOF SYSTEMS IN AREAS OF WORK, INCLUDING BUT NOT LIMITED TO RIGID INSULATION BOARDS COVERED BY PLYWD SHEET.
- 4. SEE EXTERIOR ELEVATIONS FOR ADDITIONAL WORK NOT SHOWN ON PLANS.

KEYED NOTES
SEE A0.1 SCOPE OF WORK LEGEND FOR FULL DESCRIPTION OF WORK NOTED IN KEYED NOTES. KEYED NOTES BELOW ARE FOR PLAN LOCATION REFERENCE ONLY.

- CN-1: LIMESTONE COPING
- CN-6: PARAPET/VERTICAL WALLS (ROOF SIDE)
- CN-7: VERTICAL WALLS (ROOF SIDE)
- CN-9A: OUT OF PLANE WALLS (ROOF SIDE PARAPET)
- CN-10: DISPLACED INTERIOR GLAZED TILE AT WINDOW HEADS
- CN-11: INTERIOR GLAZED TILE AT WINDOW HEADS REGROUT
- CN-12: ROOF LADDERS CN-13: TOWER REMOVAL
- CN-14: OVERHEAD DOOR LINTELS

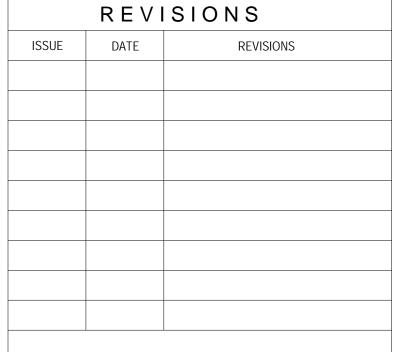



CONSTRUCTION DOCUMENTS

PROJECT DIRECTOR

SEALS

ROY CONARD

SPACE FOR CONSULTANT RECOGNITION **SMP**ARCHITECTS

BUILDING ENVELOPE CONSULTANT TBS Services, Inc. 617 Station Avenue Haddon Heights, New Jersey 08035 856 547 6254

1600 Walnut Street, 2nd Floor Philadelphia, Pennsylvania 19103 215 985 4410

STRUCTURAL ENGINEER
Ann Rothmann Structural Engineering
100 East Lancaster Avenue, Suite 203 Wayne, Pennsylvania 19087 610 688 2566

COST CONSULTANT Dharam Consulting 1719 Chestnut Street, Suite 300 Philadelphia, Pennsylvania 19103 610 554 6560

CITY OF PHILADELPHIA DEPARTMENT OF PUBLIC PROPERTY

> 1401 JFK BOULEVARD 7TH FLOOR, CITY HALL

PENNSYLVANIA

PROJECT TITLE ENGINE 56 EXTERIOR ENVELOPE

RENOVATIONS


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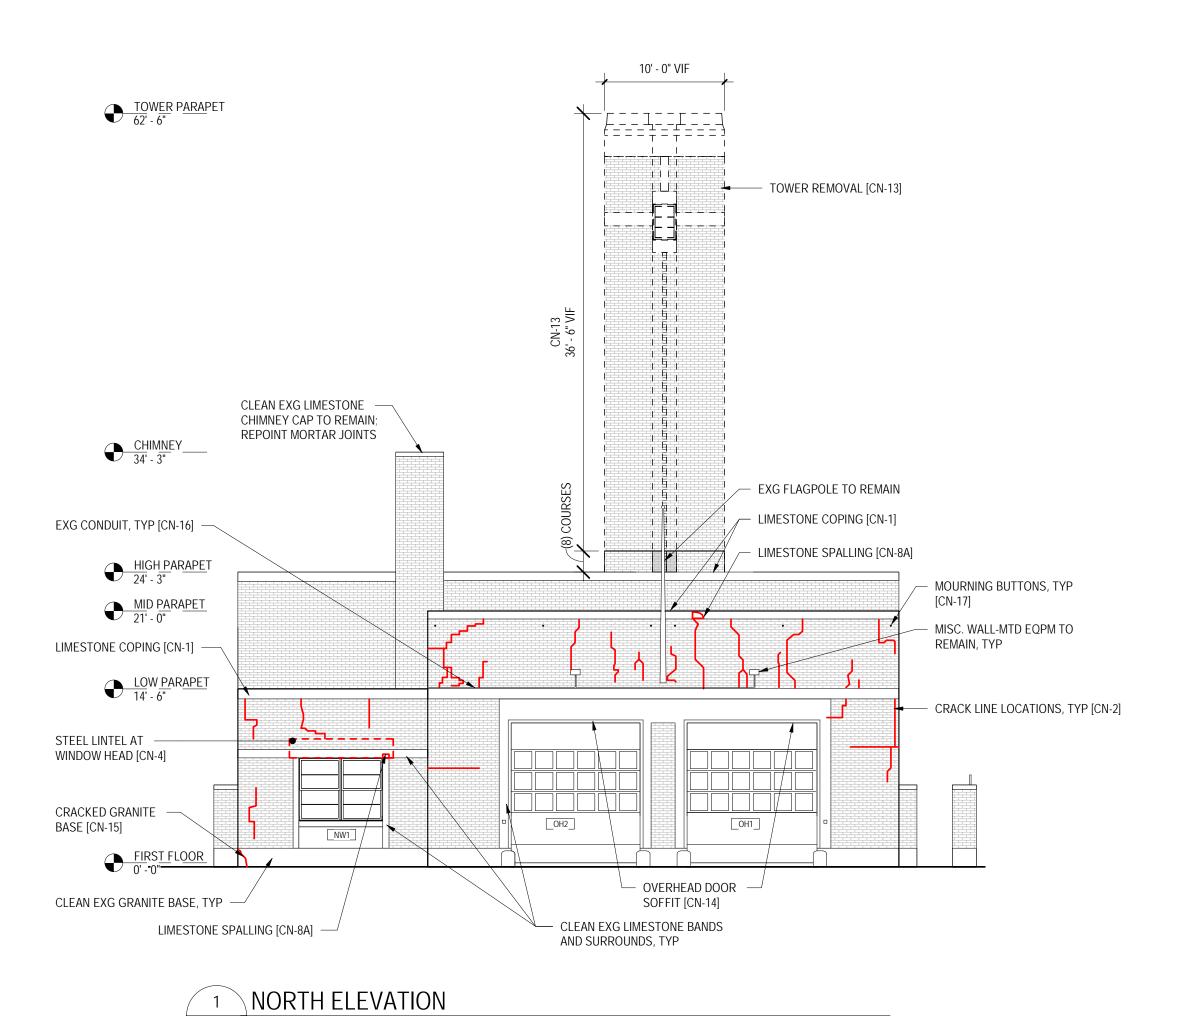
PHILADELPHIA

FLOOR PLANS





PROJECT NO.	DRAWING NO.
13-18-4014-01	
DATE 07/11/2022	A2.0
SCALE AS NOTED	, , , , ,
DRAWN BY KC	
CHECKED BY TW	FILE:
NOTE: ALL DIMENSIONS AND CONDITIONS S CONTACTOR AT THE SITE BEFORE PR	



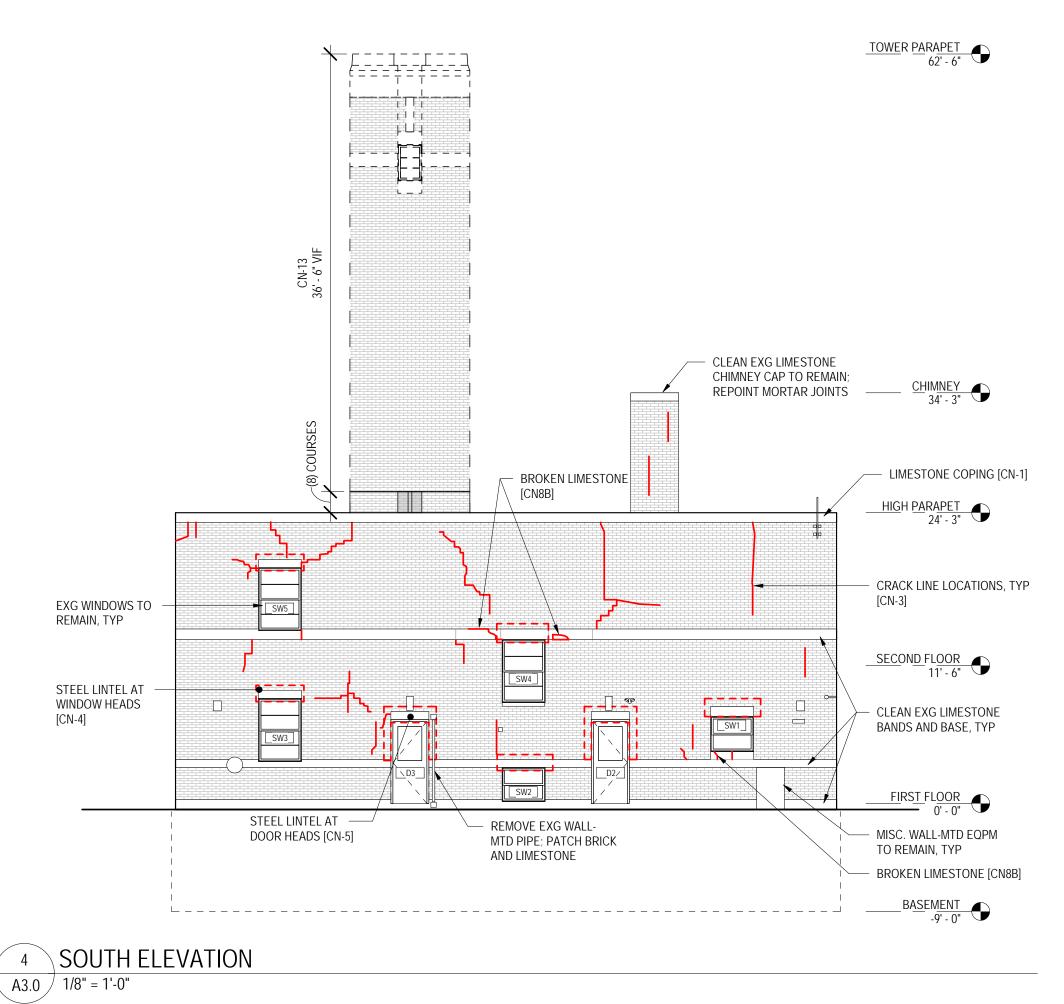

A3.0 1/8" = 1'-0"

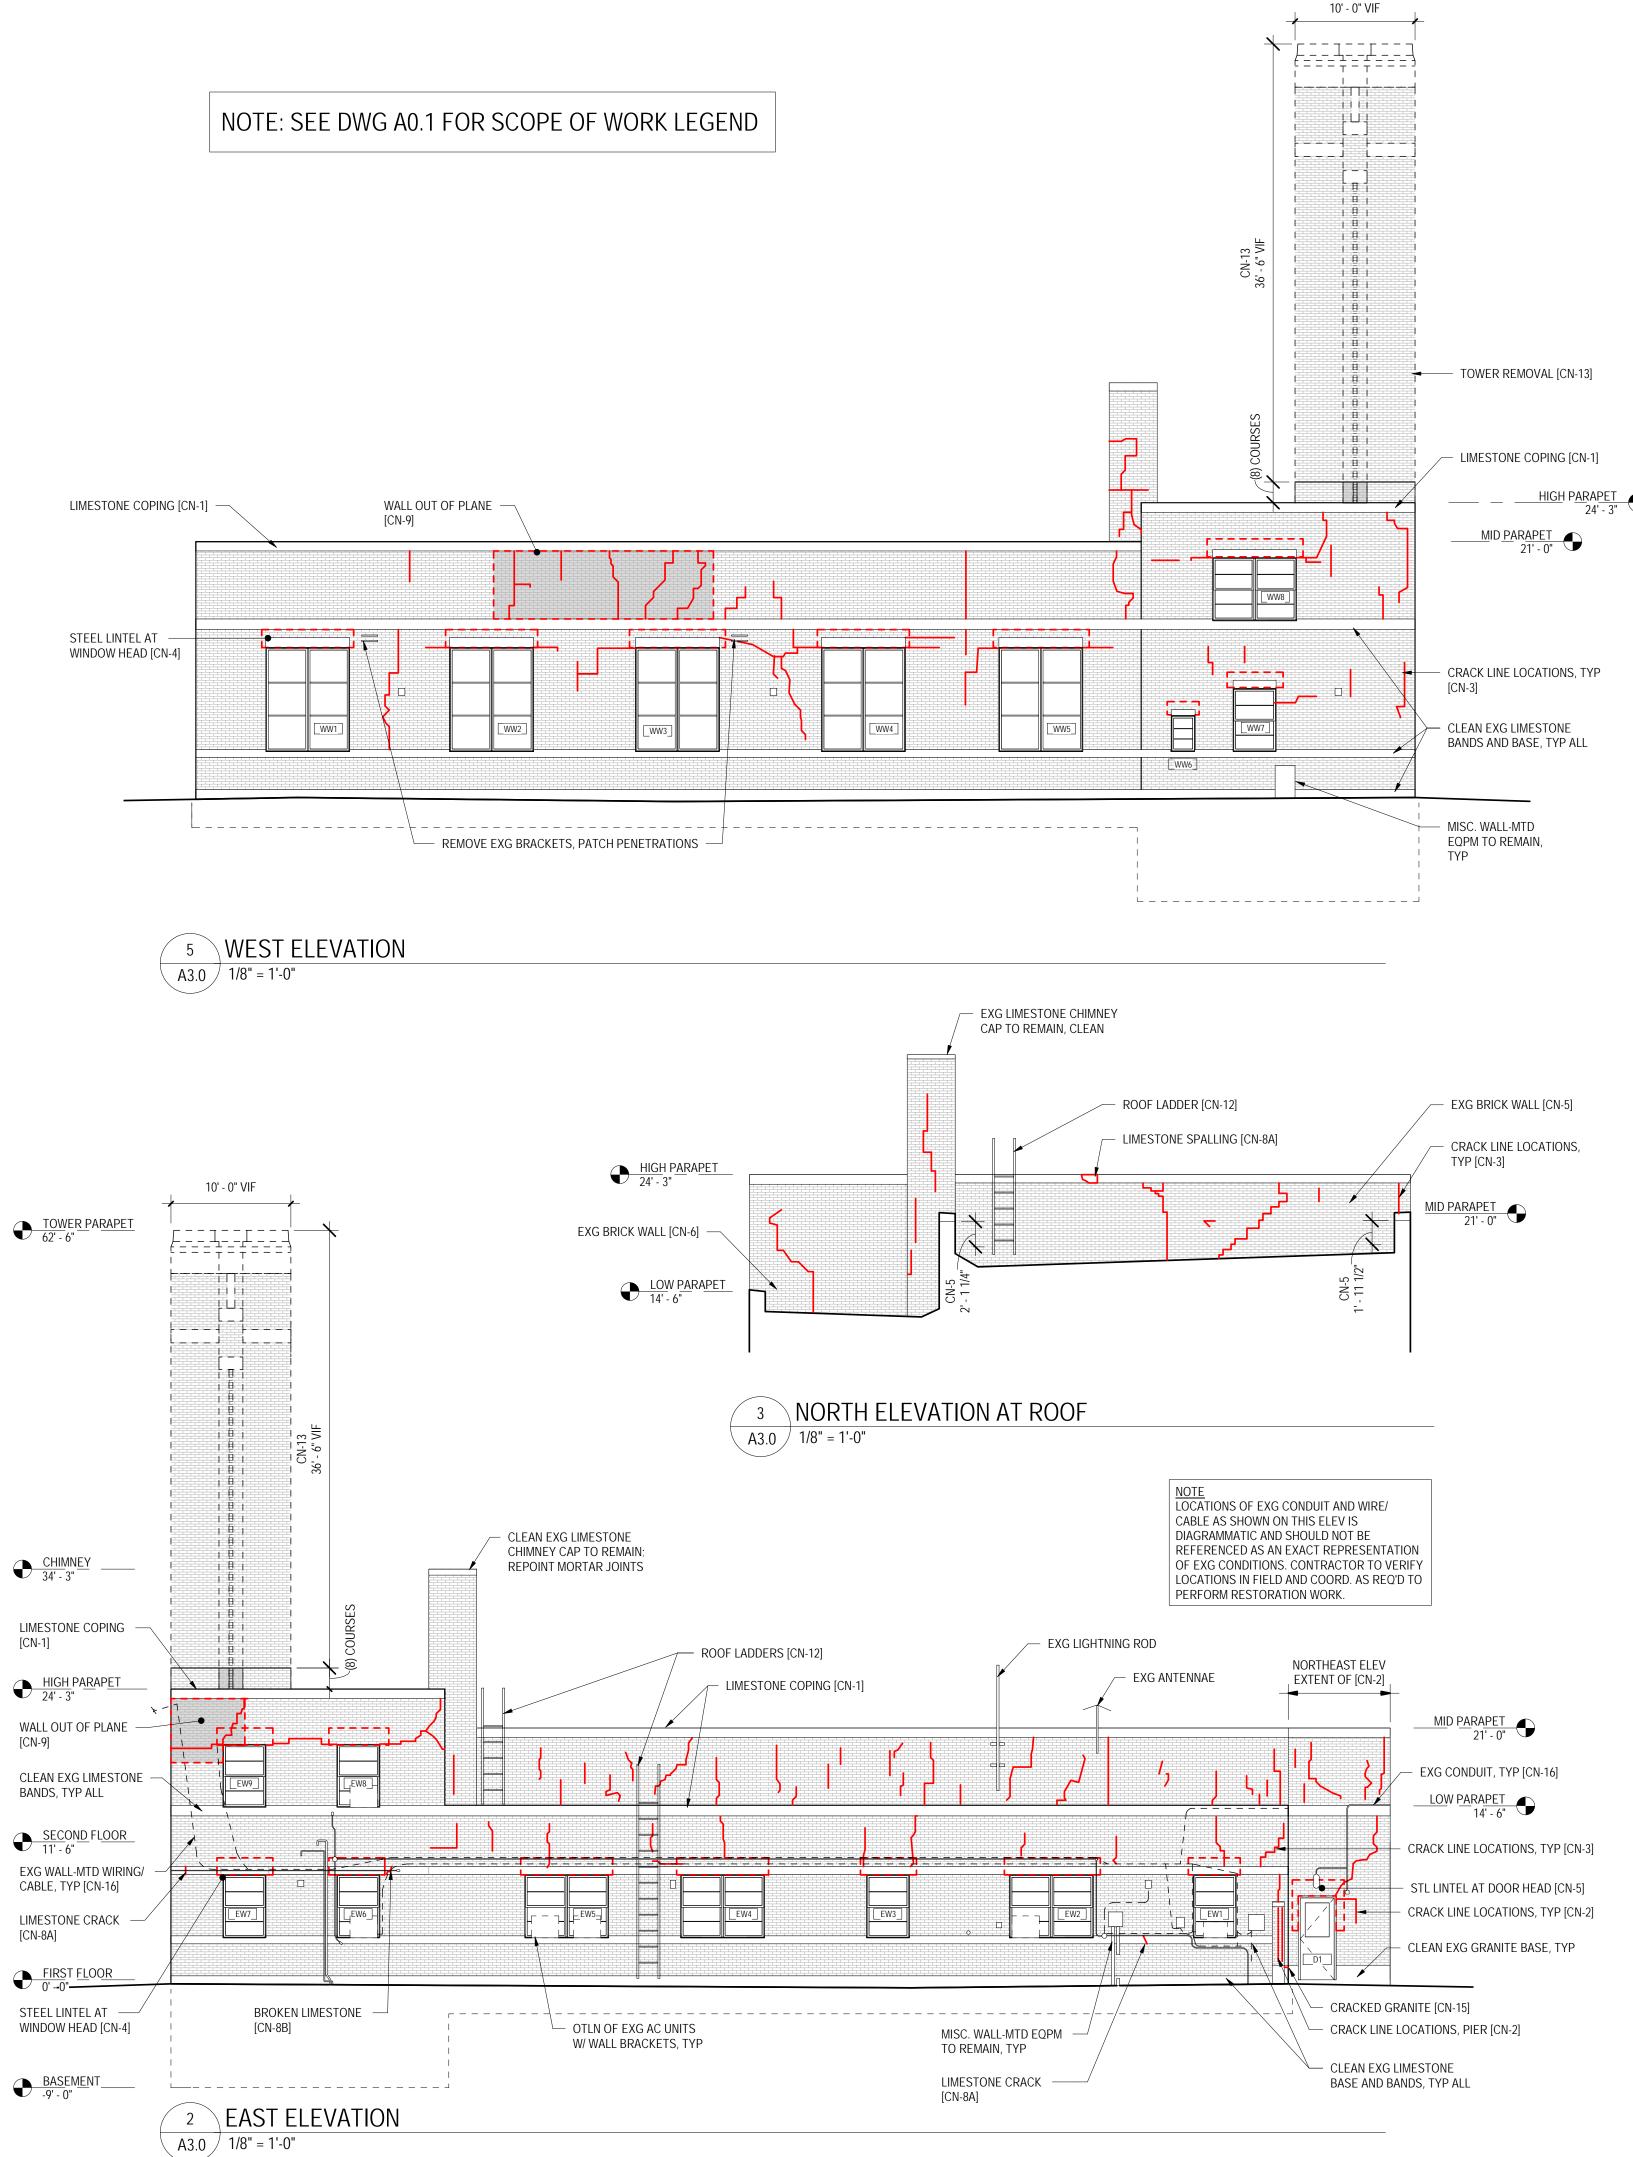

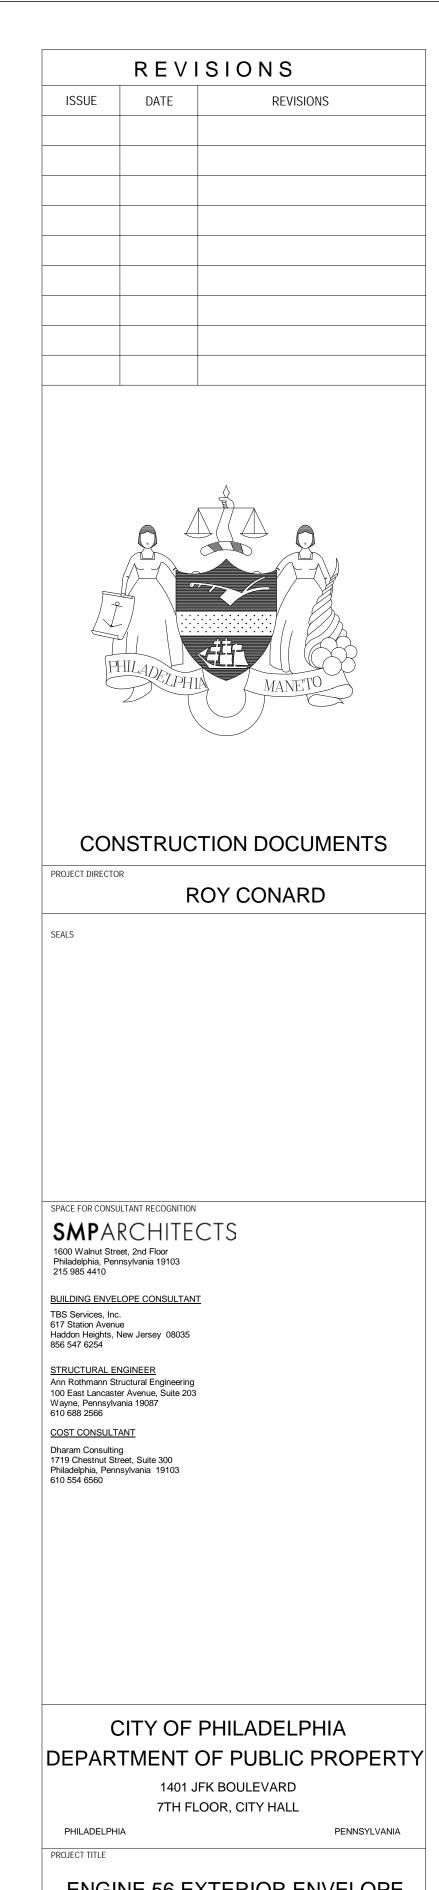


ENGINE 56 EXTERIOR ENVELOPE RENOVATIONS

EXTERIOR ELEVATIONS

DRAWING TITLE

PROJECT NO.	DRAWING NO.
13-18-4014-01	
DATE 07/11/2022	- A3 0
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	IONS SHALL BE VERIFIED BY THE RE PROCEEDING WITH THE WORK

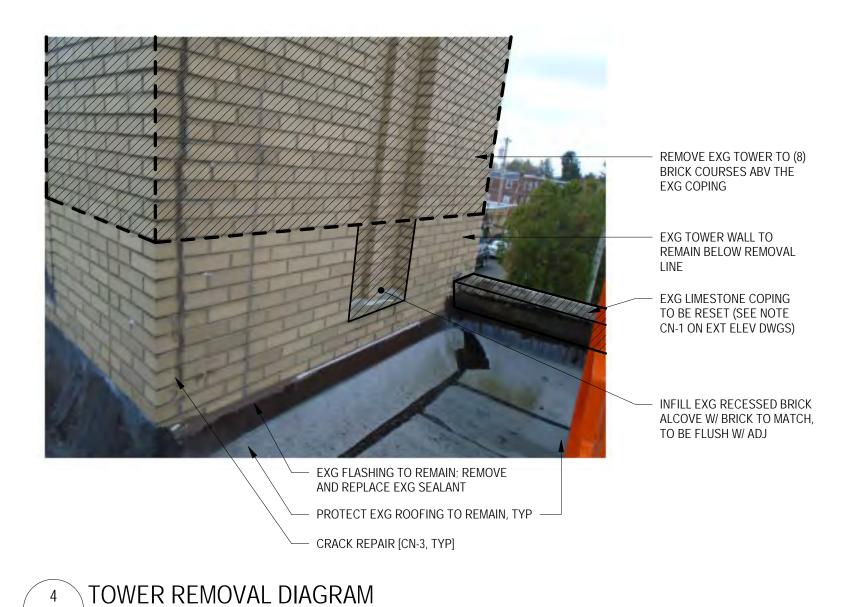

INFILL RECESSED BRICK
AREA TO BE FLUSH WI ADJ


EXG TOWER BRICK WALLS

EXG TOWER BRICK WALLS

PROTECT EXG ROOFING
TO REMAIN

EXG MTL ROOF FLASHING TO
REMAIN: REMOVE AND
REPLACE EXG SEALANT

5 TOWER ROOF - ELEVATION A8.0 1/2" = 1'-0"

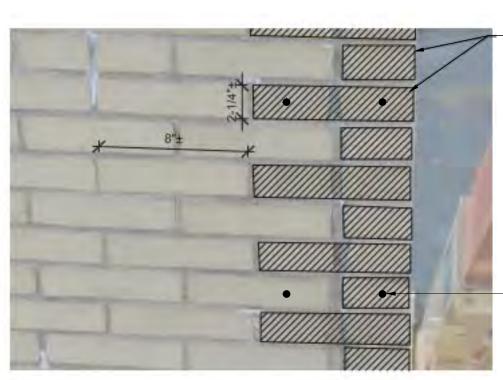


A8.0 N.T.S.

AT EXG CORNERS, CAREFULLY REMOVE BRICKS ADJACENT TO EXG LARGE CRACKS (GREATER THAN 1/16") WHERE THE BRICK HAS SEPARATED, SALVAGING UNDAMAGED BRICK UNITS.
CLEAN AND STORE FOR REUSE. REMOVE ENTIRE UNITS FROM

JOINT TO JOINT W/O DAMAGING SURROUNDING MASONRY IN A MANNER THAN PERMITS REPLACEMENT W/ FULL-SIZE UNITS.
SUPPORT AND PROTECT REMAINING MASONRY AND WALL COMPONENTS SURROUNDING AREA OF REMOVAL. NOTIFY ARCHITECT OF ANY UNFORESEEN DETRIMENTAL CONDITIONS.

INSTALL EXG SALVAGED AND/OR NEW BRICK UNITS INTO BONDING AND COURSING PATTERN OF EXG BRICK. MATCH EXG MORTAR JOINT SIZE.

- PROVIDE NEW ANCHORS 4" HORIZONTALLY FROM EXG CRACK, AT 16" VERTICAL SPACING.

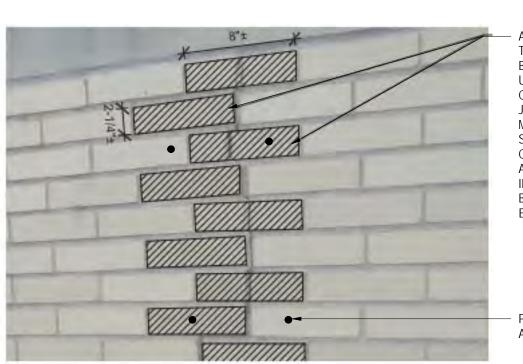


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CLEAN AND STORE FOR REUSE. REMOVE ENTIRE UNITS FROM JOINT TO JOINT W/O DAMAGING SURROUNDING MASONRY IN A MANNER THAT PERMITS REPLACEMENT W/ FULL-SIZE UNITS. SUPPORT AND PROTECT REMAINING MASONRY AND WALL COMPONENTS SURROUNDING AREA OF REMOVAL. NOTIFY ARCHITECT OF ANY UNFORESEEN DETRIMENTAL CONDITIONS. INSTALL EXG SALVAGED AND/OR NEW BRICK UNITS INTO BONDING AND COURSING PATTERN OF EXG BRICK. MATCH EXG MORTAR JOINT SIZE.


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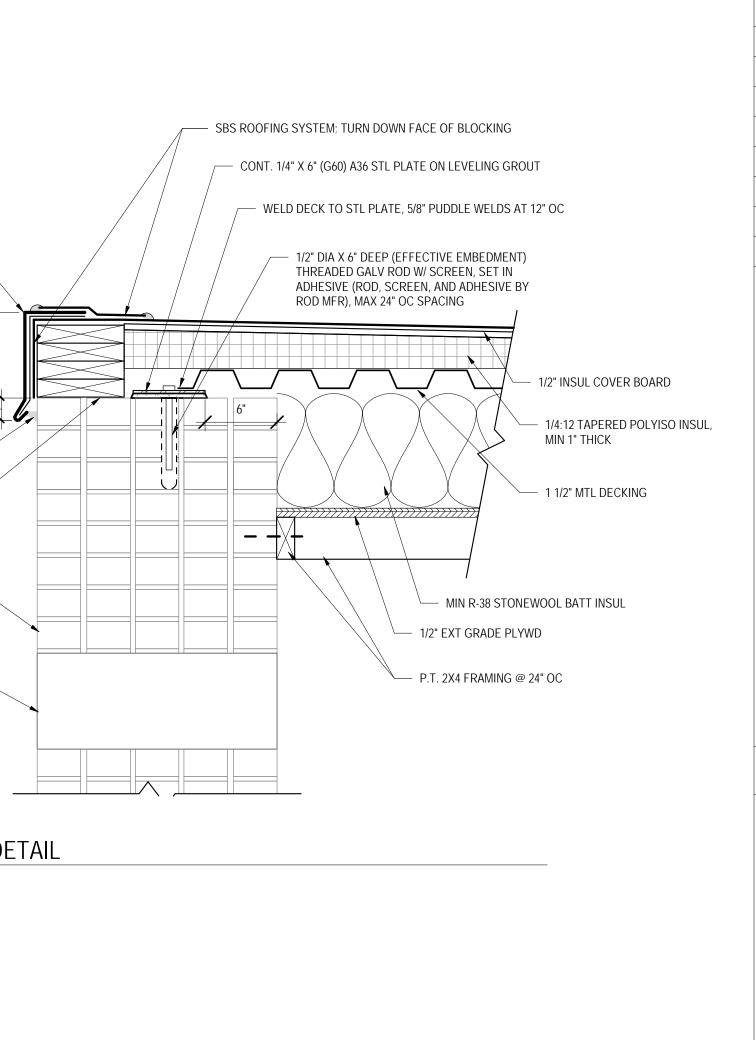
1 BRICK CRACK REPAIR DIAGRAM

N.T.S.



2 LINTEL AND INTERIOR TILE REPAIR DETAIL

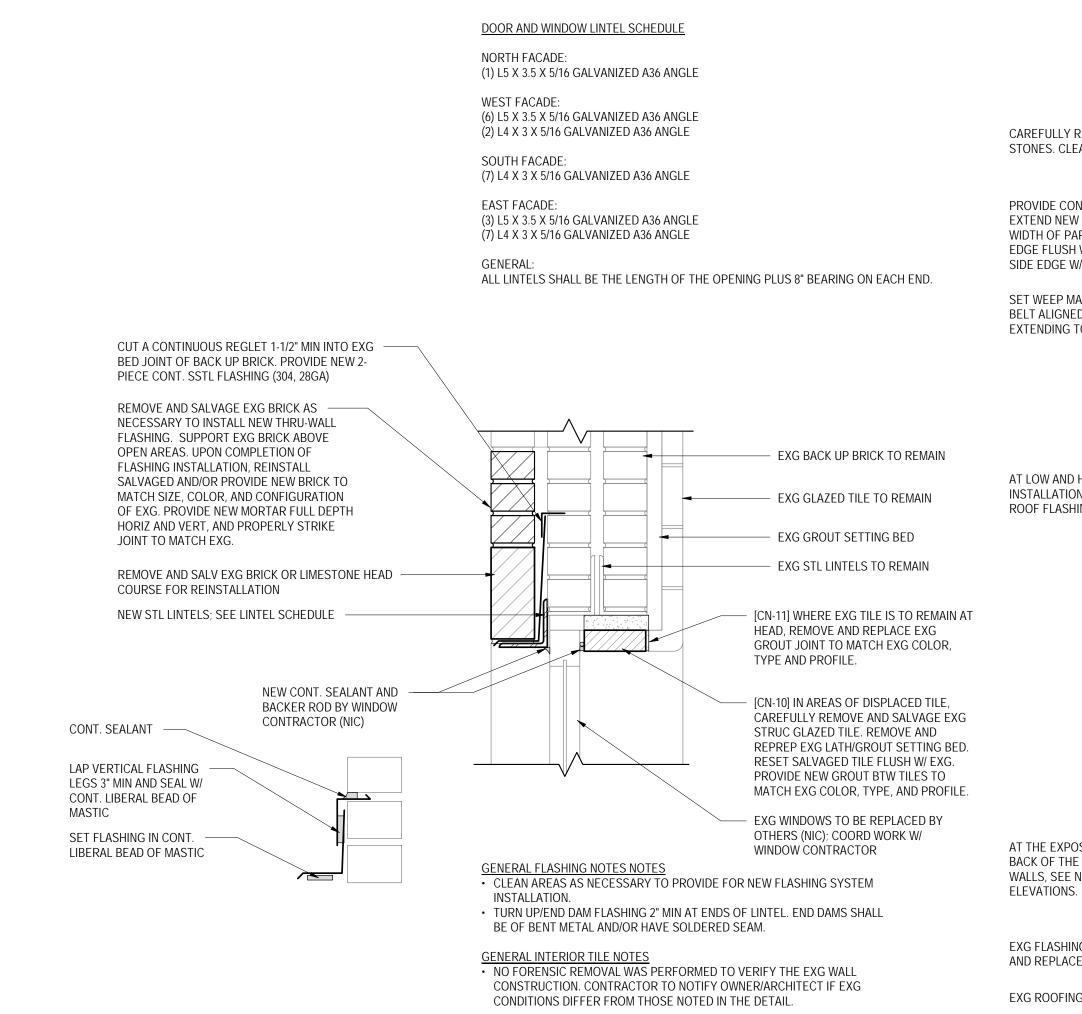

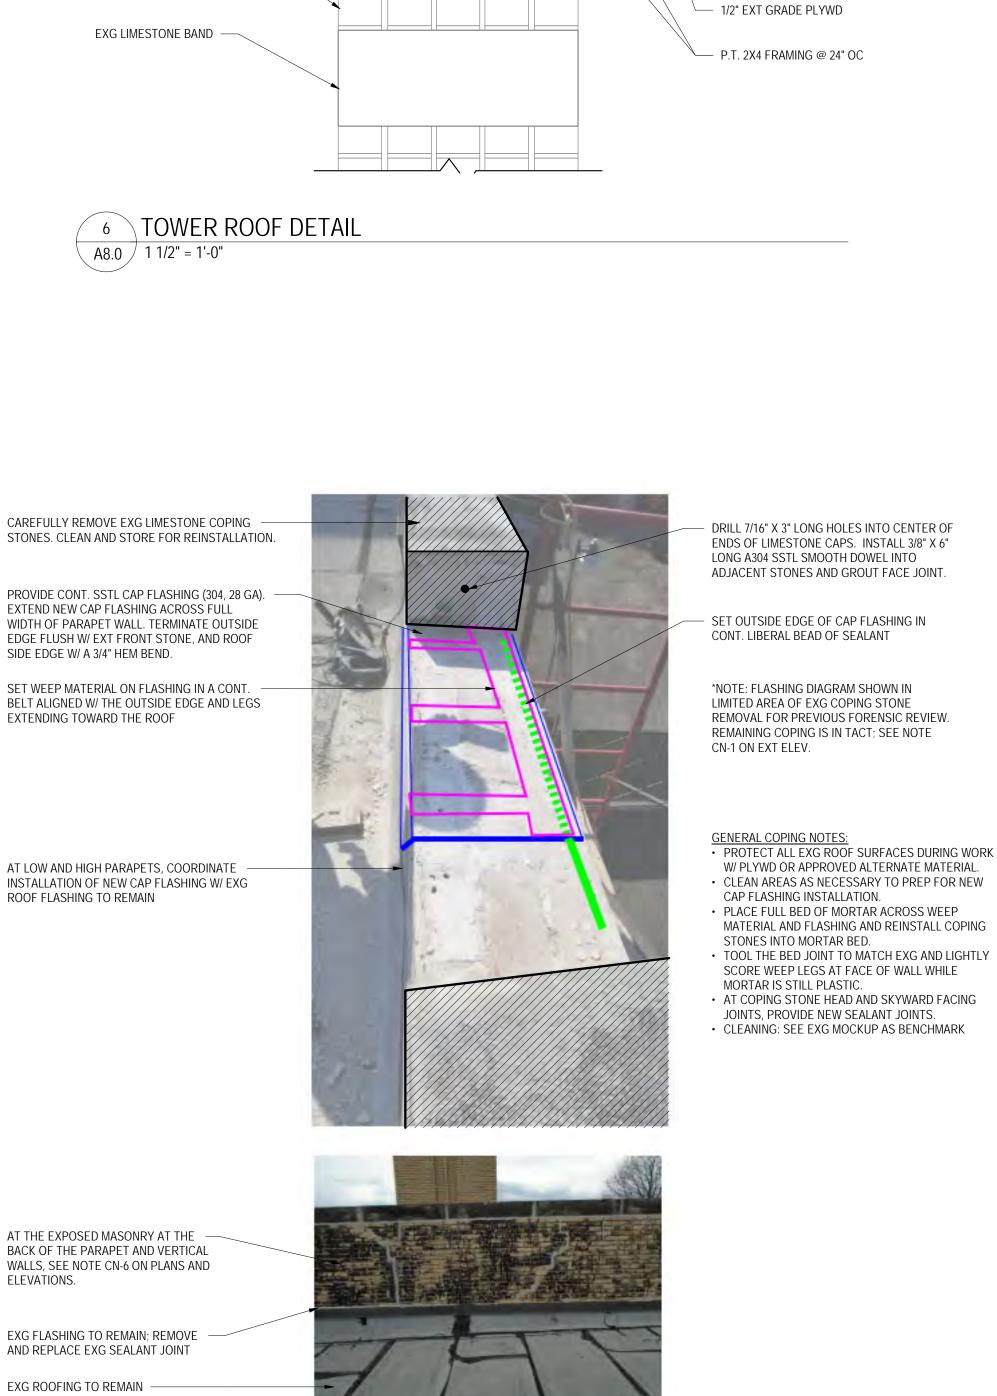

DRIP-EDGE MTL FASCIA BY

ROOFING MFR; COLOR TO

MATCH EXG LIMESTONE


CONT. SEALANT

2X8 P.T. WD BLOCKING

EXG TOWER BRICK WALL

COPING STONE DIAGRAM

AROUND PERIMETER

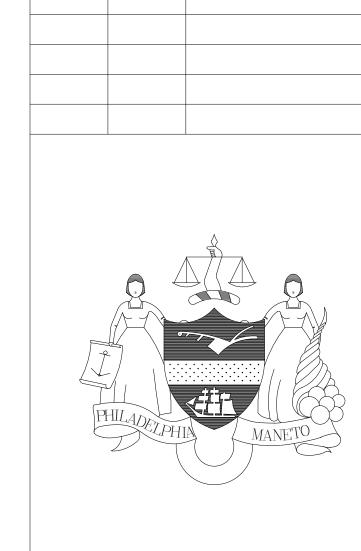

REVISIONS

REVISIONS

DATE

ISSUE

CONSTRUCTION DOCUMENTS

ROY CONARD

SMPARCHITECTS

PROJECT DIRECTOR

SEALS

1600 Walnut Street, 2nd Floor Philadelphia, Pennsylvania 19103 215 985 4410 BUILDING ENVELOPE CONSULTANT

TBS Services, Inc. 617 Station Avenue

Haddon Heights, New Jersey 08035 856 547 6254 STRUCTURAL ENGINEER

Ann Rothmann Structural Engineering

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7TH FLOOR, CITY HALL

PHILADELPHIA

ENGINE 56 EXTERIOR ENVELOPE

RENOVATIONS

PENNSYLVANIA

DRAWING TITLE

PROJECT TITLE

EXTERIOR DETAILS AND DIAGRAMS

PROJECT NO.

13-18-4014-01

DATE

07/11/2022

SCALE

AS NOTED

DRAWN BY

KC

CHECKED BY

TW

NOTE:

ALL DIMENSIONS AND CONDITIONS SHALL BE VERIFIED BY THE

CONTACTOR AT THE SITE BEFORE PROCEEDING WITH THE WORK