

CITY OF PHILADELPHIA PHILADELPHIA PARKS & RECREATION

MAYOR - JAMES F. KENNEY

MANAGING DIRECTOR - BRIAN ABERNATHY

COMMISSIONER - PARKS AND RECREATION - KATHRYN OTT LOVELL

PROJECT TITLE: EAST POPLAR PLAYGROUND

PROJECT ADDRESS: 820 N. 8th St. Philadelphia, PA 19123

PROJECT NO: 10-19-4631-01

100% CONSTRUCTION DOCUMENTATION

February 7, 2020

Client:

Philadelphia Parks & Recreation & Rebuild 1515 Arch Street, 11th Floor Philadelphia, PA 19102 215.683.3657

Landscape Architect (Project Lead):
Ground Reconsidered
230 South Broad Street, Suite 604
Philadelphia, PA 19102
215.790.0727

Civil Engineer: KS Engineers, P.C. 35 S 3rd St. Philadelphia, PA 19106 215-925-0425

Plumbing, Electrical, & Mechanical Engineer:
Arora Engineers, LLC
1600 Market Street, Suite 1630
Philadelphia, PA 19103
620.459.7900

Cost Consultant:
VJ Associates Inc. of Suffolk
1090 King Georges Post Rd. Suite 306
Edison, NJ 08837
732.661.9600

nt:

PLUMBING P-1 General Notes, Symbols, and Abbreviations P-2 Plumbing Site Plan Demolition P-3 Plumbing Site Plan New Work P-4 Plumbing Schedules and Details E-1 General Notes, Symbols, and Abbreviations P-2 Plumbing Site Plan Demolition P-3 Plumbing Schedules and Details P-4 Plumbing Schedules and Details


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LOCATION MAP



Add Alternates

Drawing List

Materials Plan

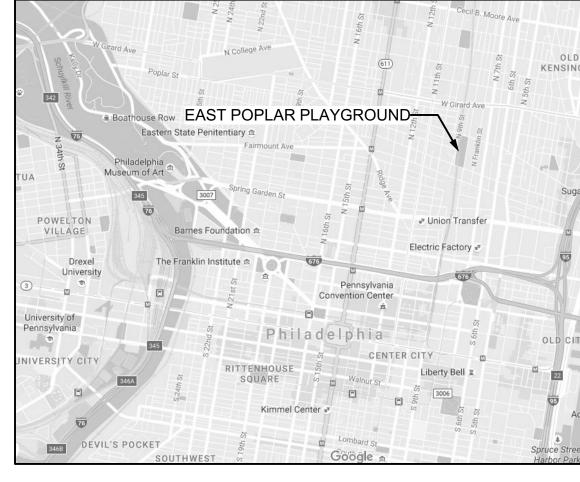Layout Plan
Grading Plan

Planting Plan

Site Details

Site Details

Site Details

Planting Details

Drainage Plan

Drainage Details

Erosion & Sediment Pollution Control Plan

Erosion & Sediment Pollution Control Details

Erosion & Sediment Pollution Control Notes

L-2.3

CIVIL D-1

Existing Conditions Plan

Tree Protection & Demolition Plan

1	Fitness Equipment	

REVISIO	NS	
ISSUE	DATE	REVISION
PROJECT	APPROVED	
COMMISSIONER / PPR		
DEPUTY COMMISSIONER / PPR		
EXECUTIVE DIRECTOR / REBUILD		
PROJECT DIRECTOR / CAPITAL PROJECTS DIVISION		
SEAL	معمرين الله	A Processor
	HEGIST THEOLOGY	TRATION TO BE SEED OF THE SEED

CITY OF PHILADELPHIA

DRAWN BY: GROUND RECONSIDERED

CHECKED BY: GROUND RECONSIDERED FILE:

PROJECT NO.

10-19-4631-01

DATE: 02.07.2020


SCALE: NTS

PHILADELPHIA PARKS & RECREATION


NOTE: ALL DIMENSIONS AND CONDITIONS SHALL BE VERIFIED BY THE CONTRACTOR AT THE SITE BEFORE PROCEEDING WITH THE WORK.

DRAWING NO.

1515 ARCH STREET 11TH FLOOR, ONE PARKWAY BUILDING PHILADELPHIA, PENNSYLVANIA

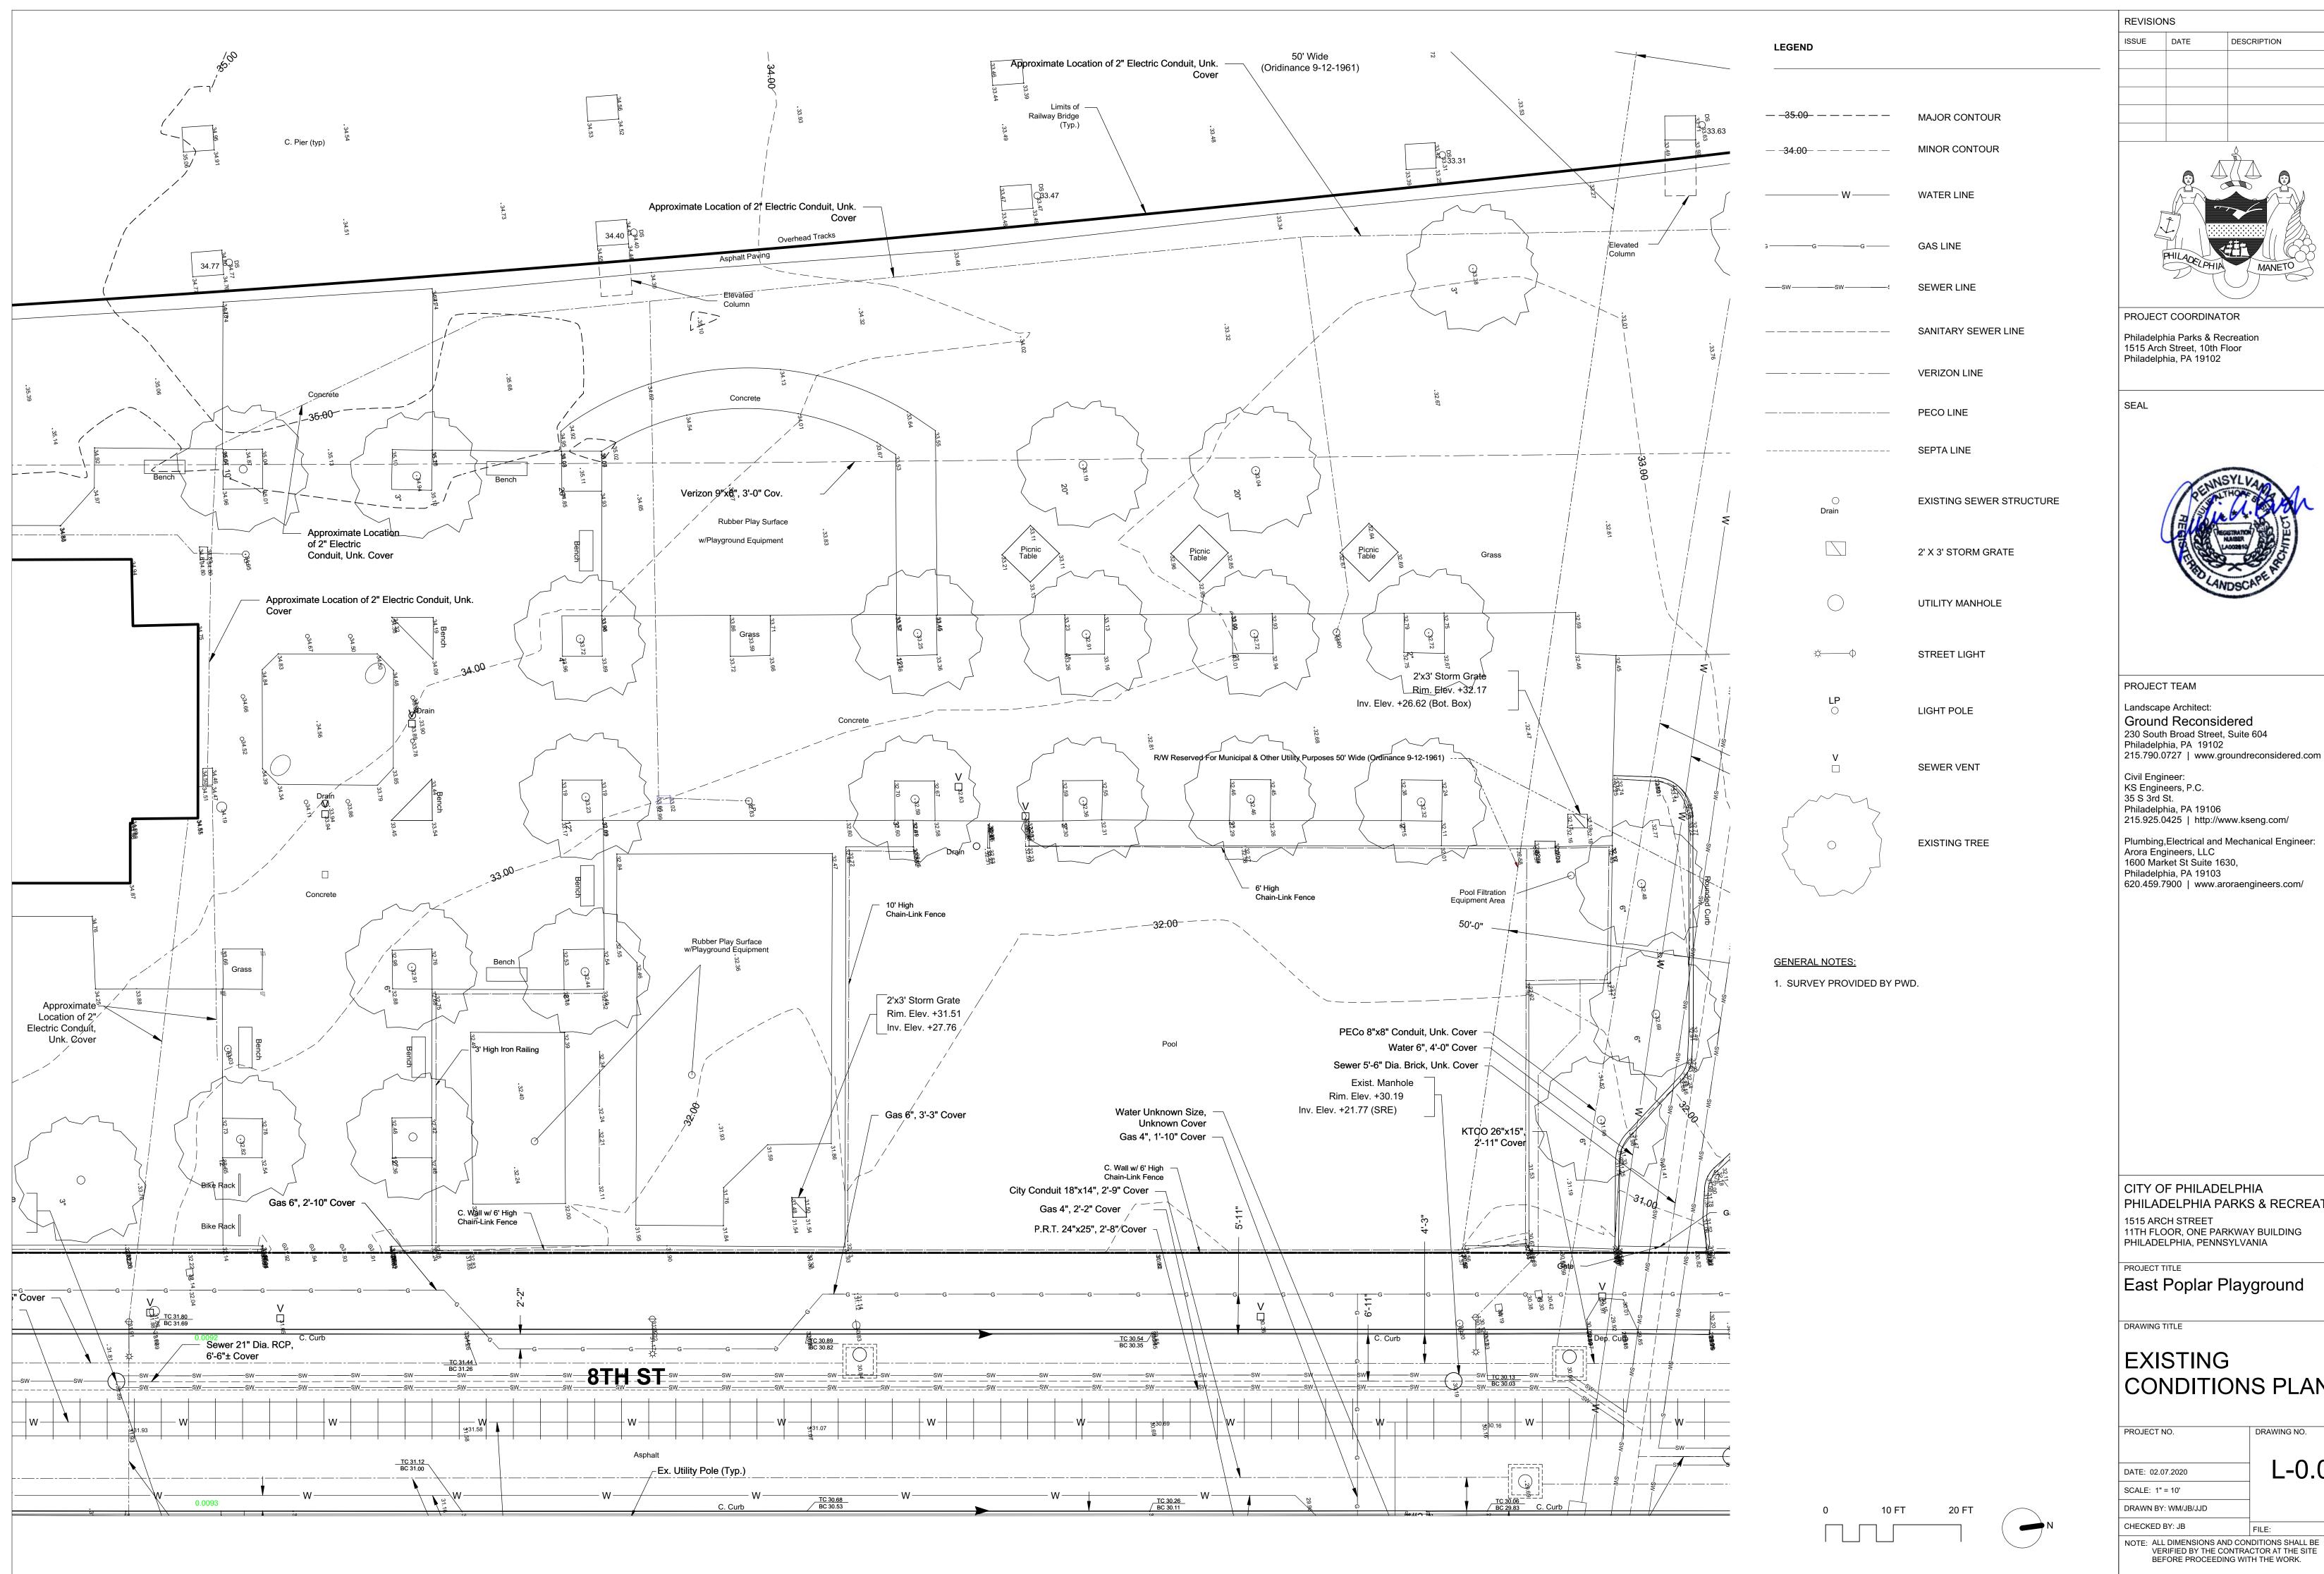

DESCRIPTION

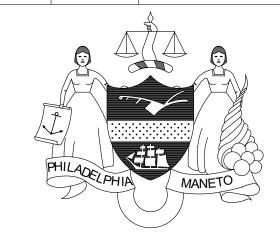



215.790.0727 | www.groundreconsidered.com


215.925.0425 | http://www.kseng.com/

CITY OF PHILADELPHIA PHILADELPHIA PARKS & RECREATION

East Poplar Playground

CONDITIONS PLAN

PROJECT NO.	DRAWING NO.
	1 0 0
DATE: 02.07.2020	L-0.0
SCALE: 1" = 10'	
DRAWN BY: WM/JB/JJD	
CHECKED BY: JB	FILE:
NOTE: ALL DIMENSIONS AND CO	NDITIONS SHALL BE

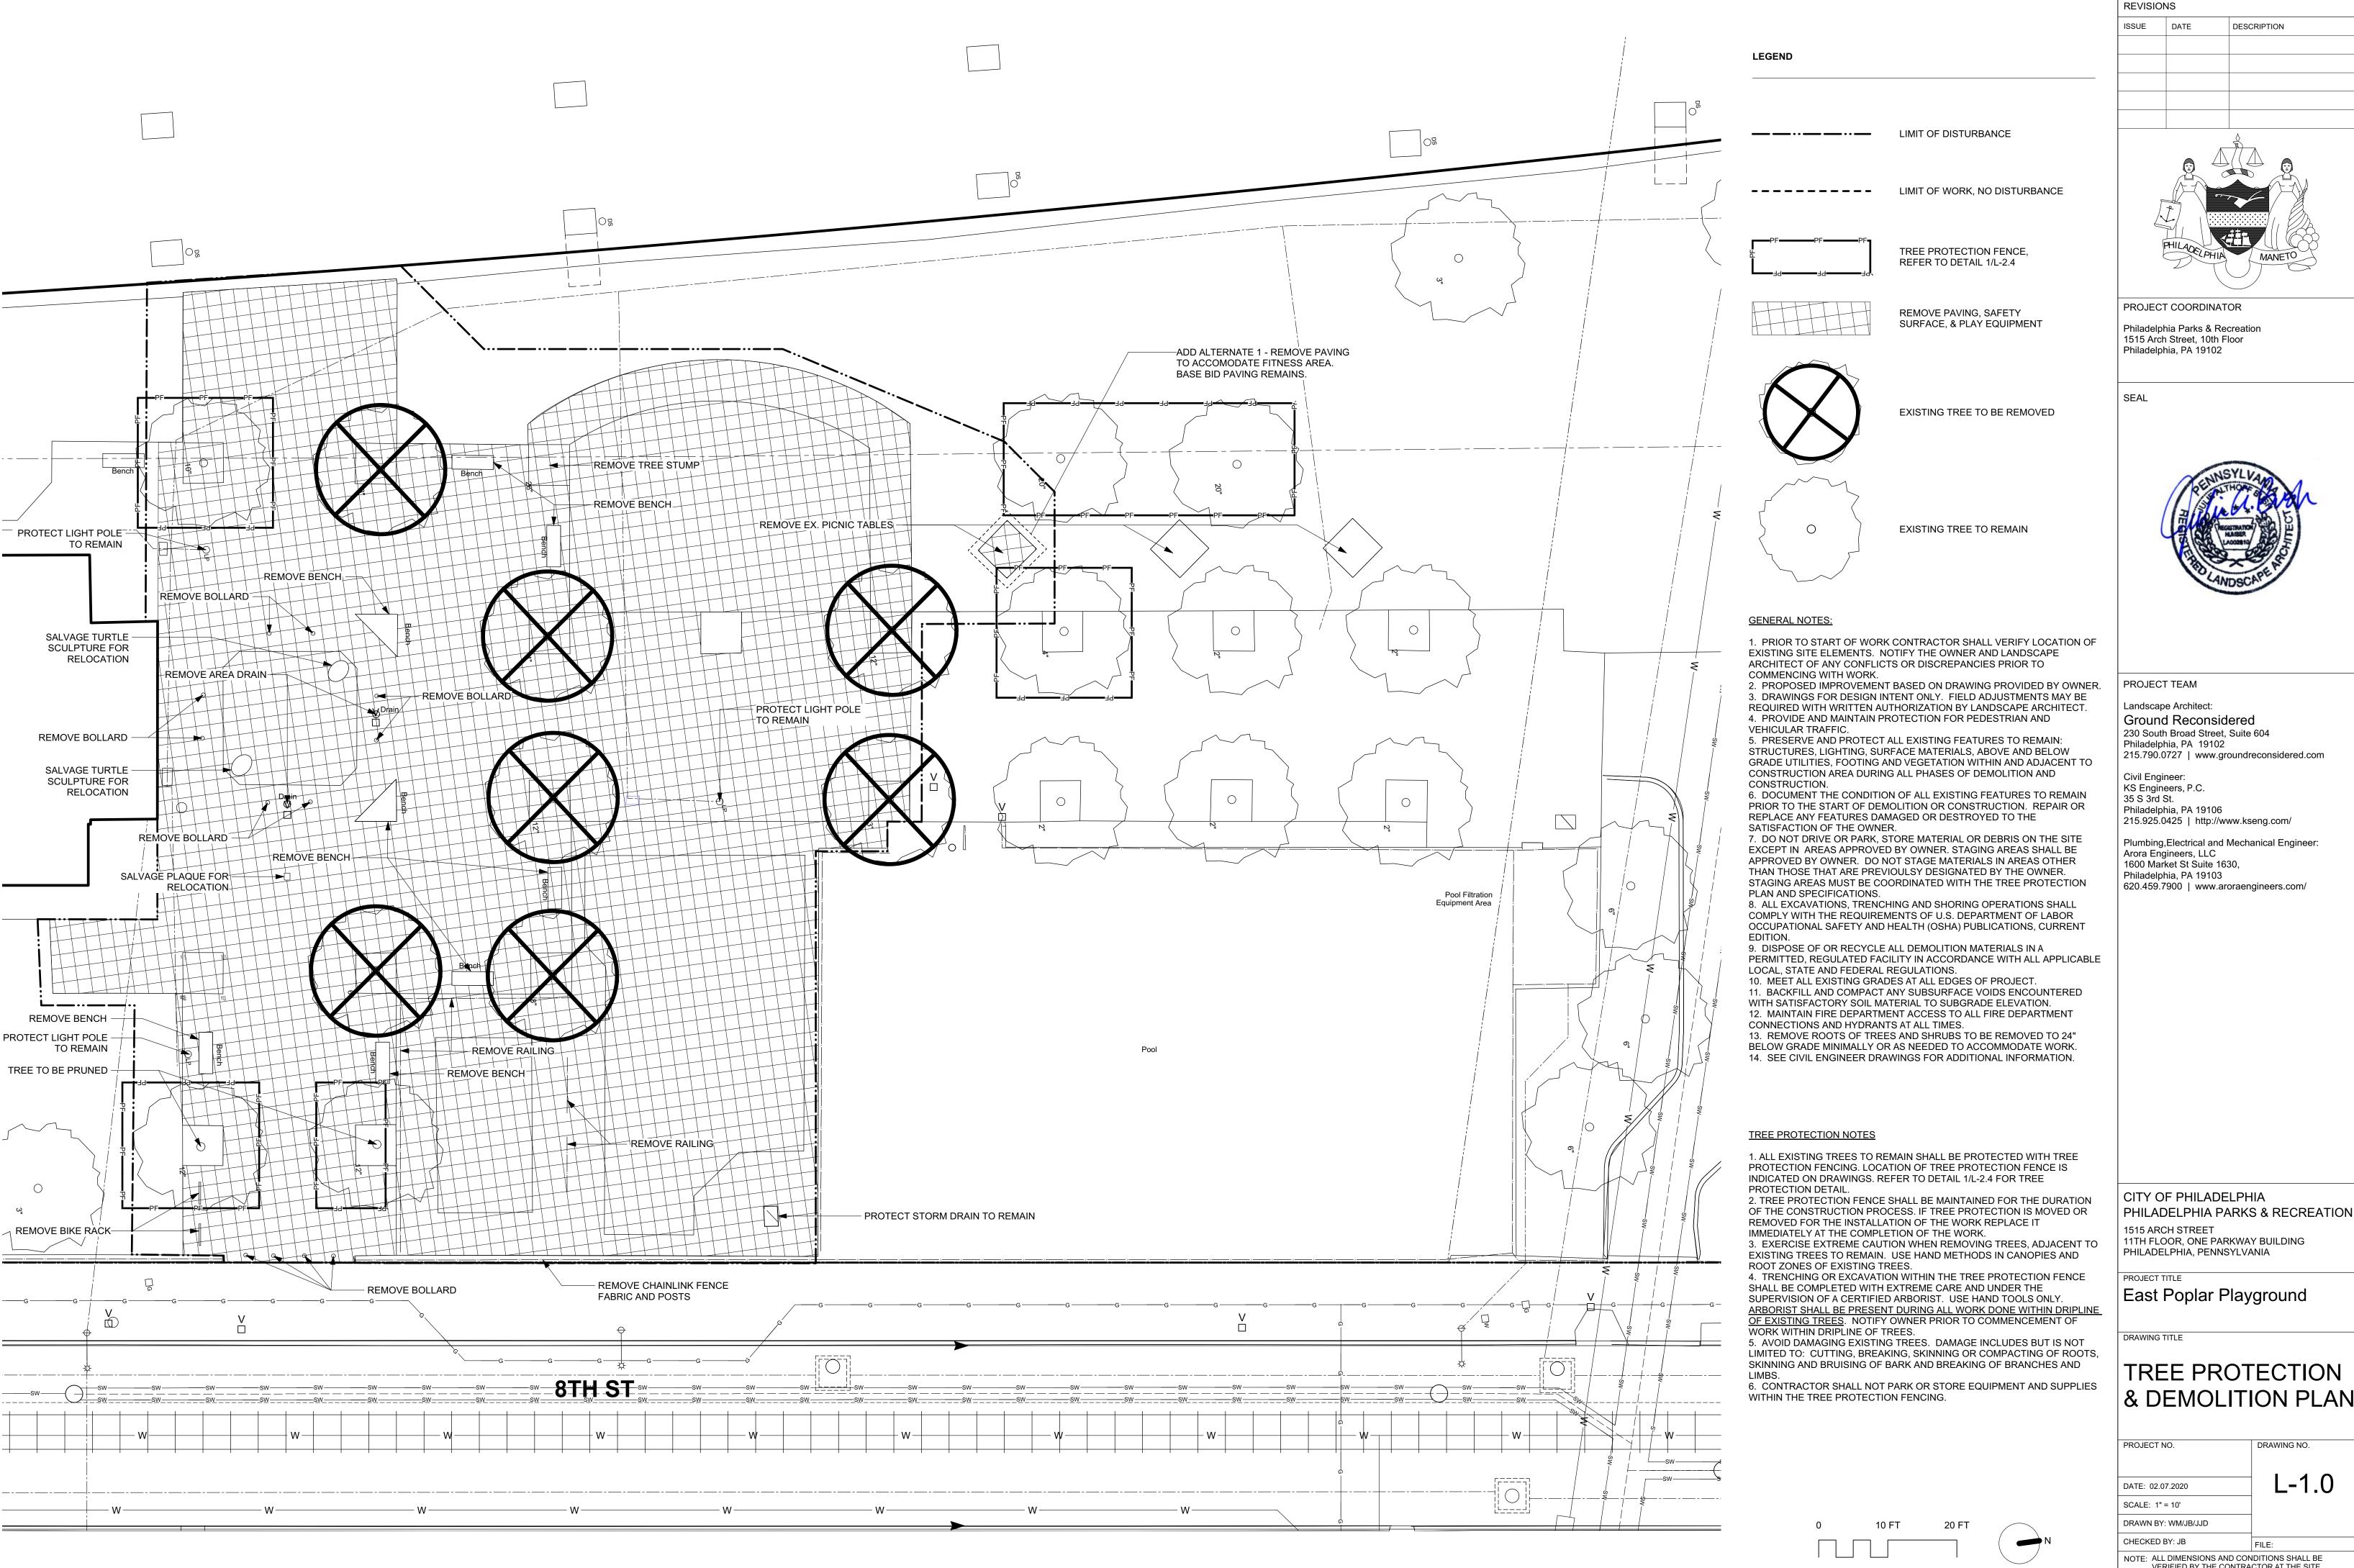

DESCRIPTION

Philadelphia Parks & Recreation 1515 Arch Street, 10th Floor




Ground Reconsidered 230 South Broad Street, Suite 604 Philadelphia, PA 19102


Philadelphia, PA 19106


Plumbing, Electrical and Mechanical Engineer: Arora Engineers, LLC 1600 Market St Suite 1630, Philadelphia, PA 19103

& DEMOLITION PLAN

PROJECT NO.	DRAWING NO.
DATE: 02.07.2020	L-1.0
SCALE: 1" = 10'	
DRAWN BY: WM/JB/JJD	
CHECKED BY: JB	FILE:
NOTE: ALL DIMENSIONS AND VERIFIED BY THE CO	O CONDITIONS SHALL BE NTRACTOR AT THE SITE

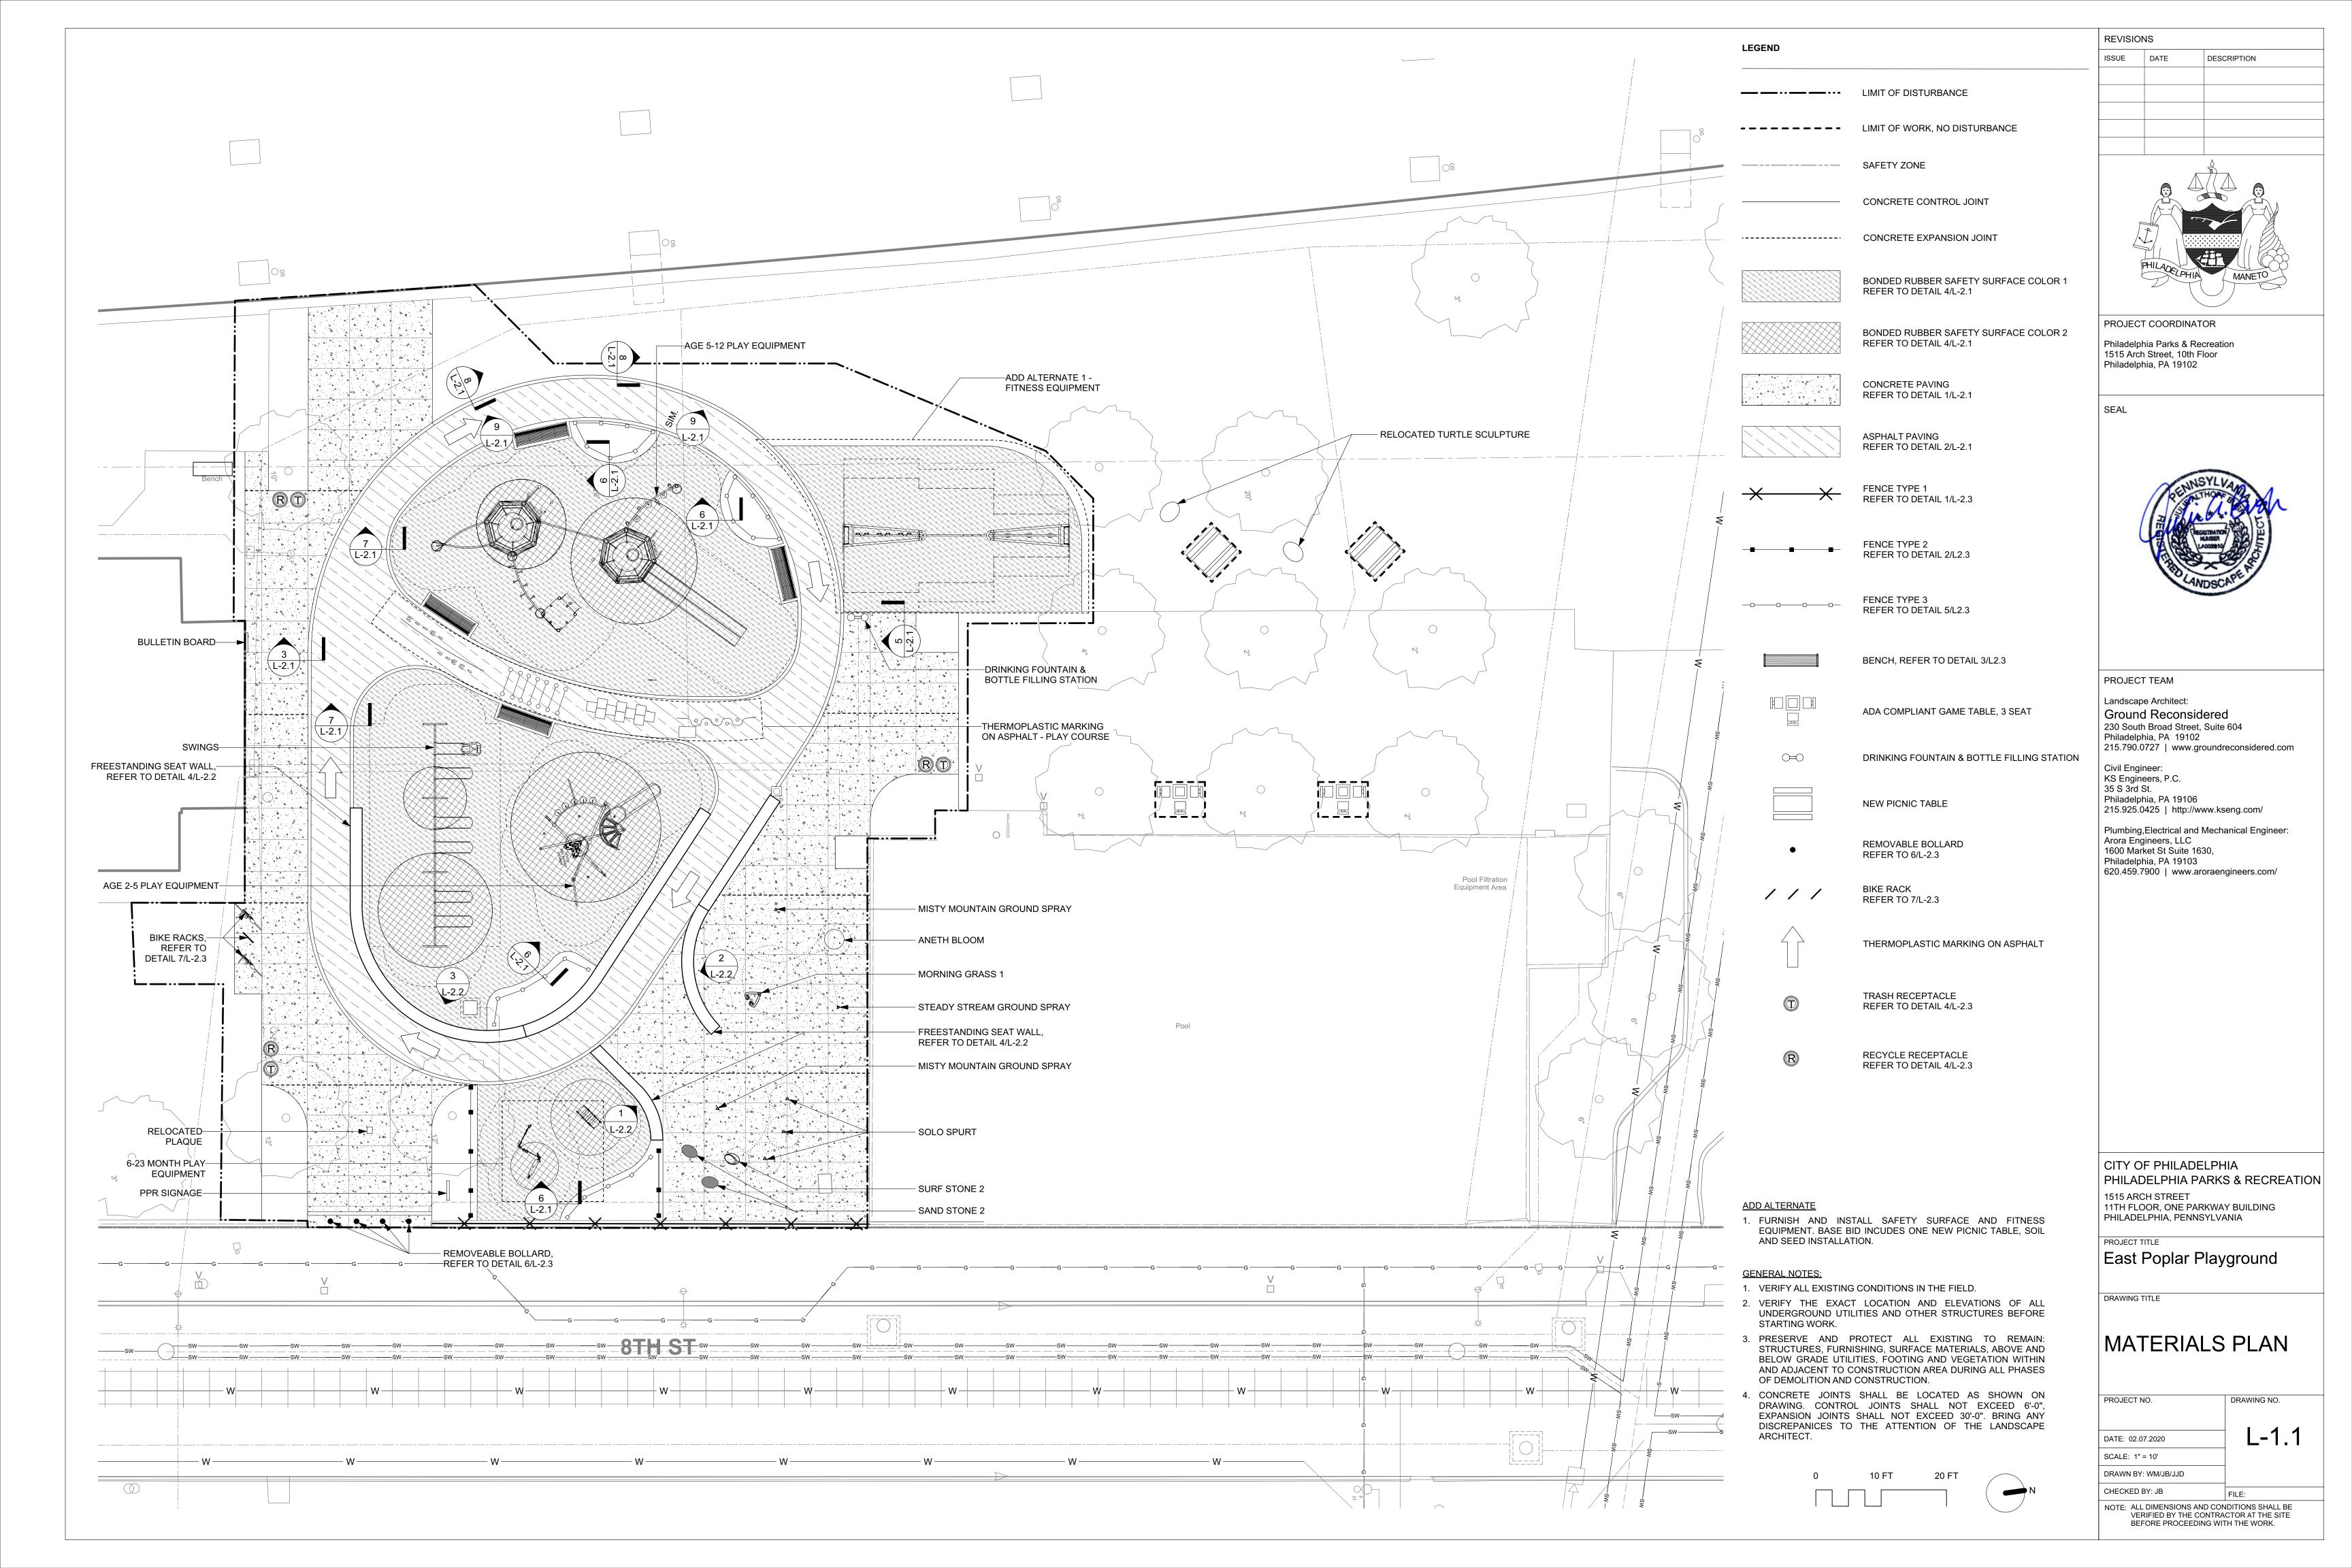

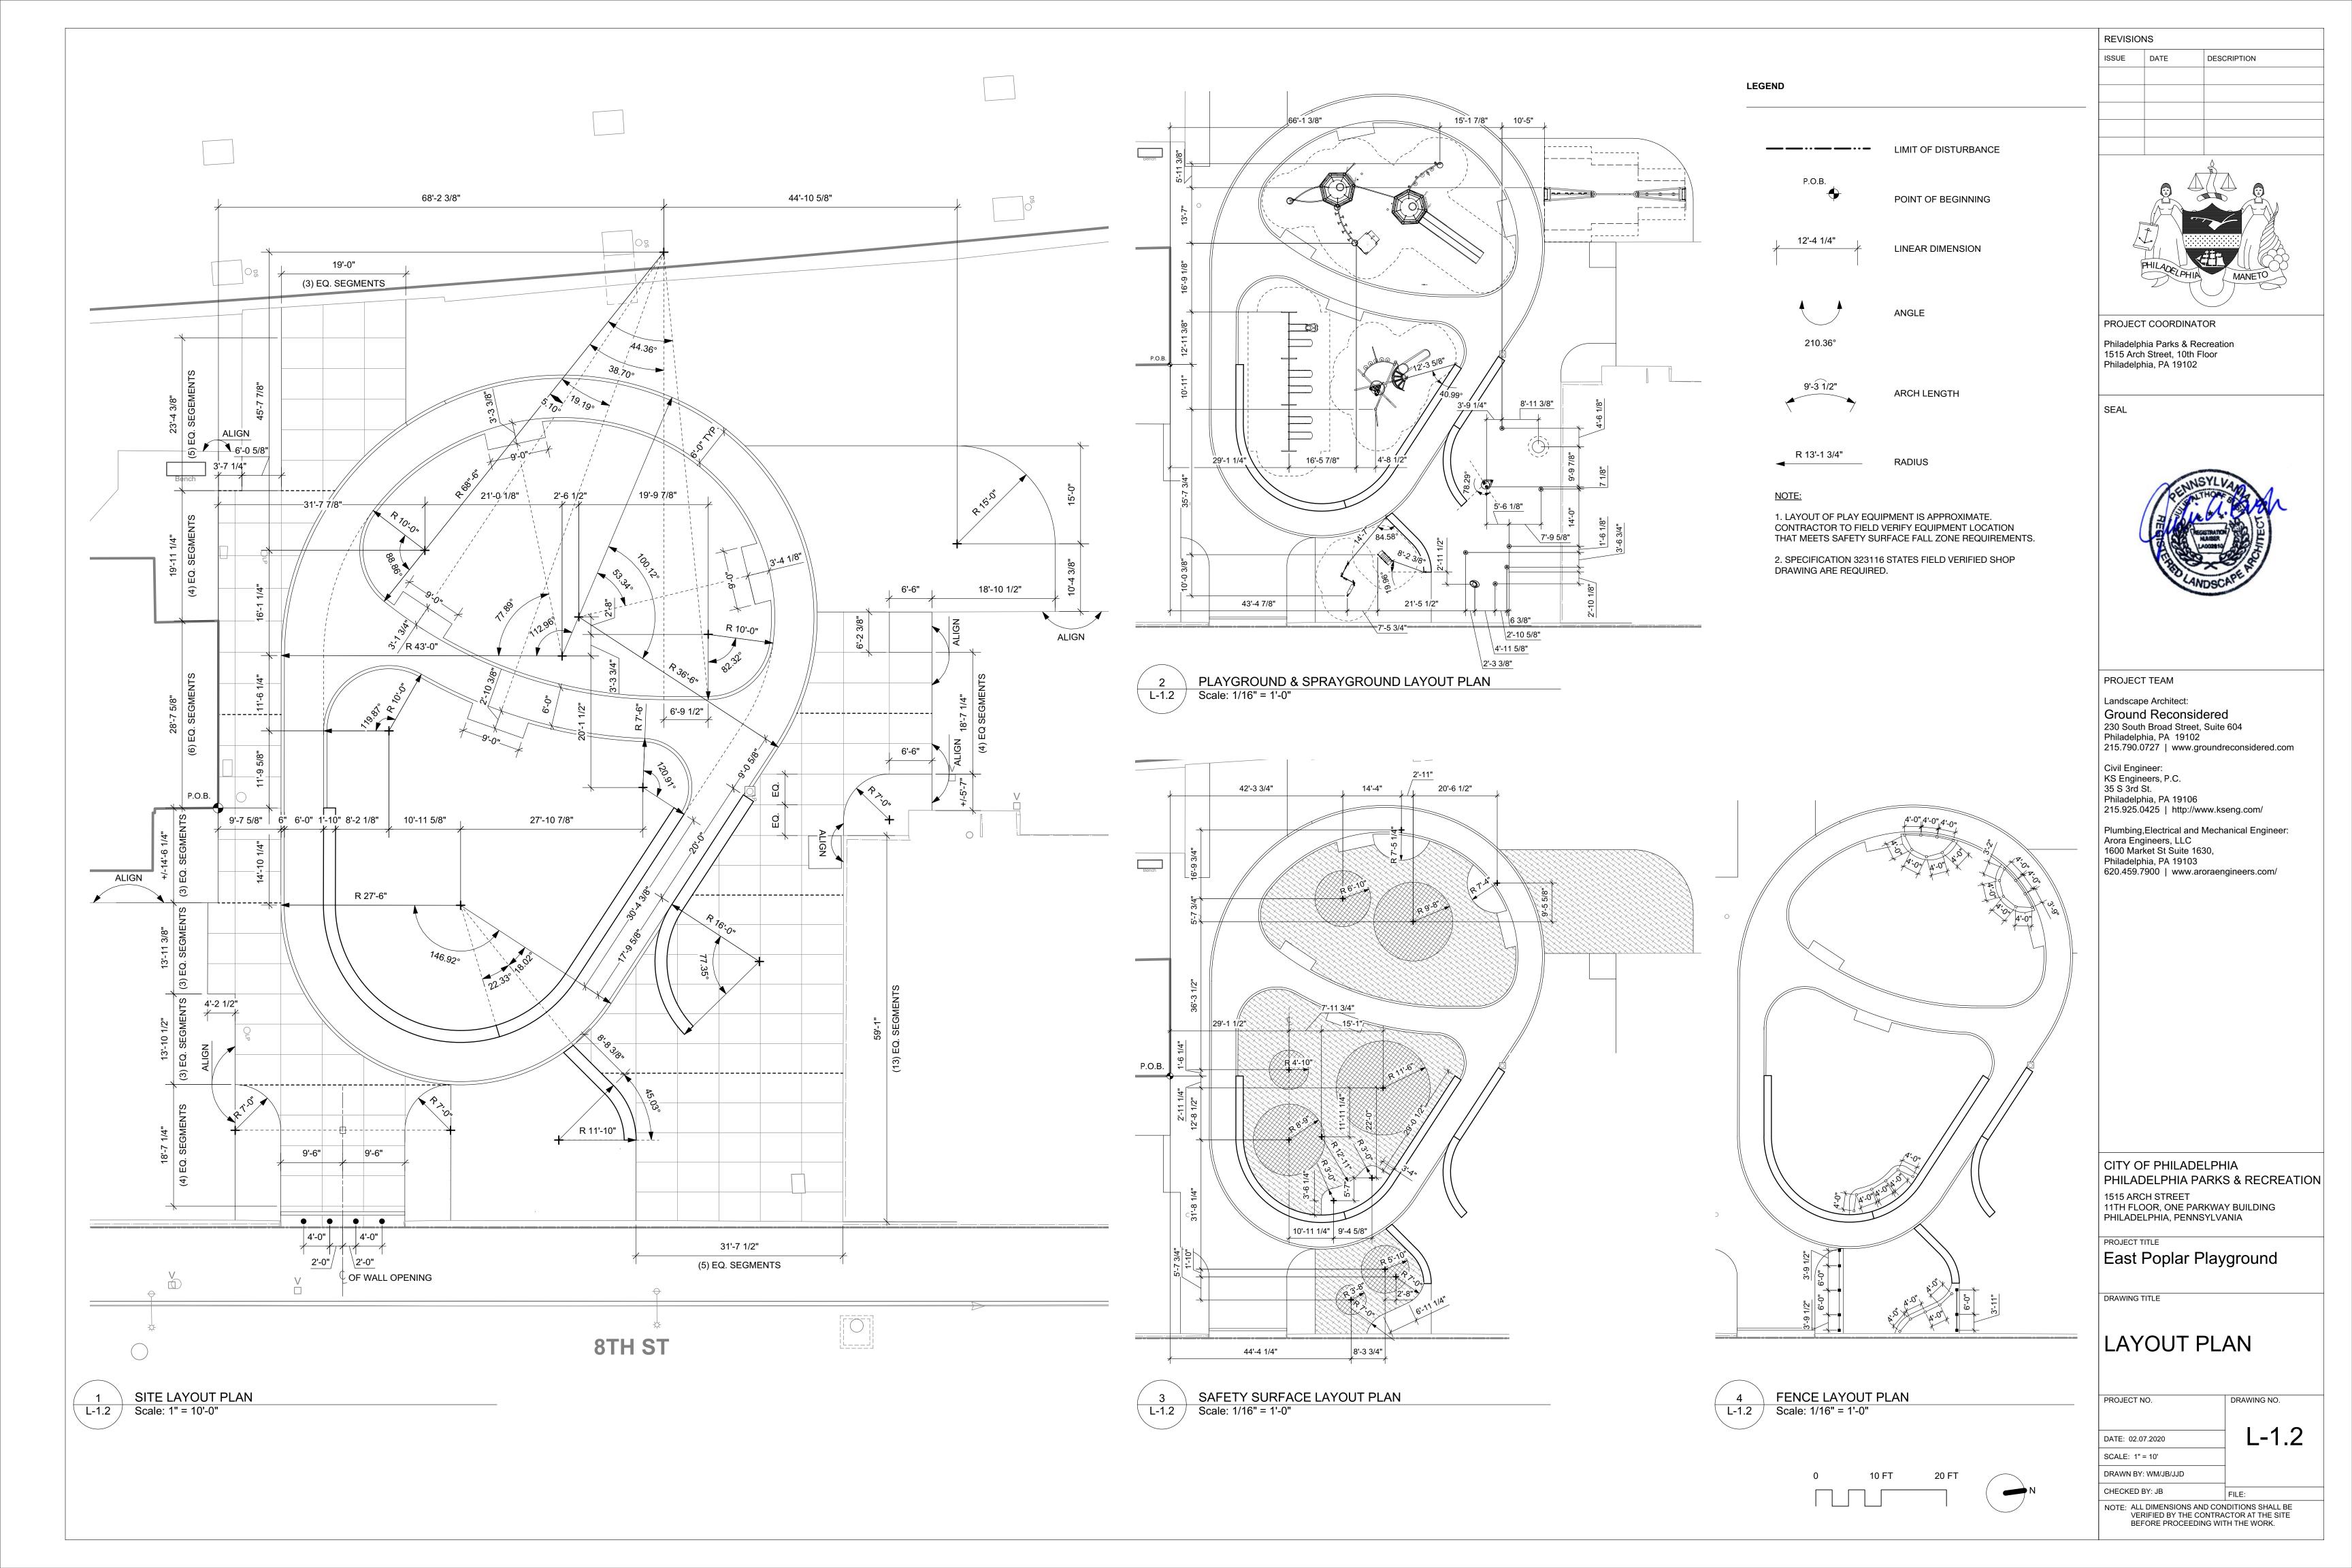


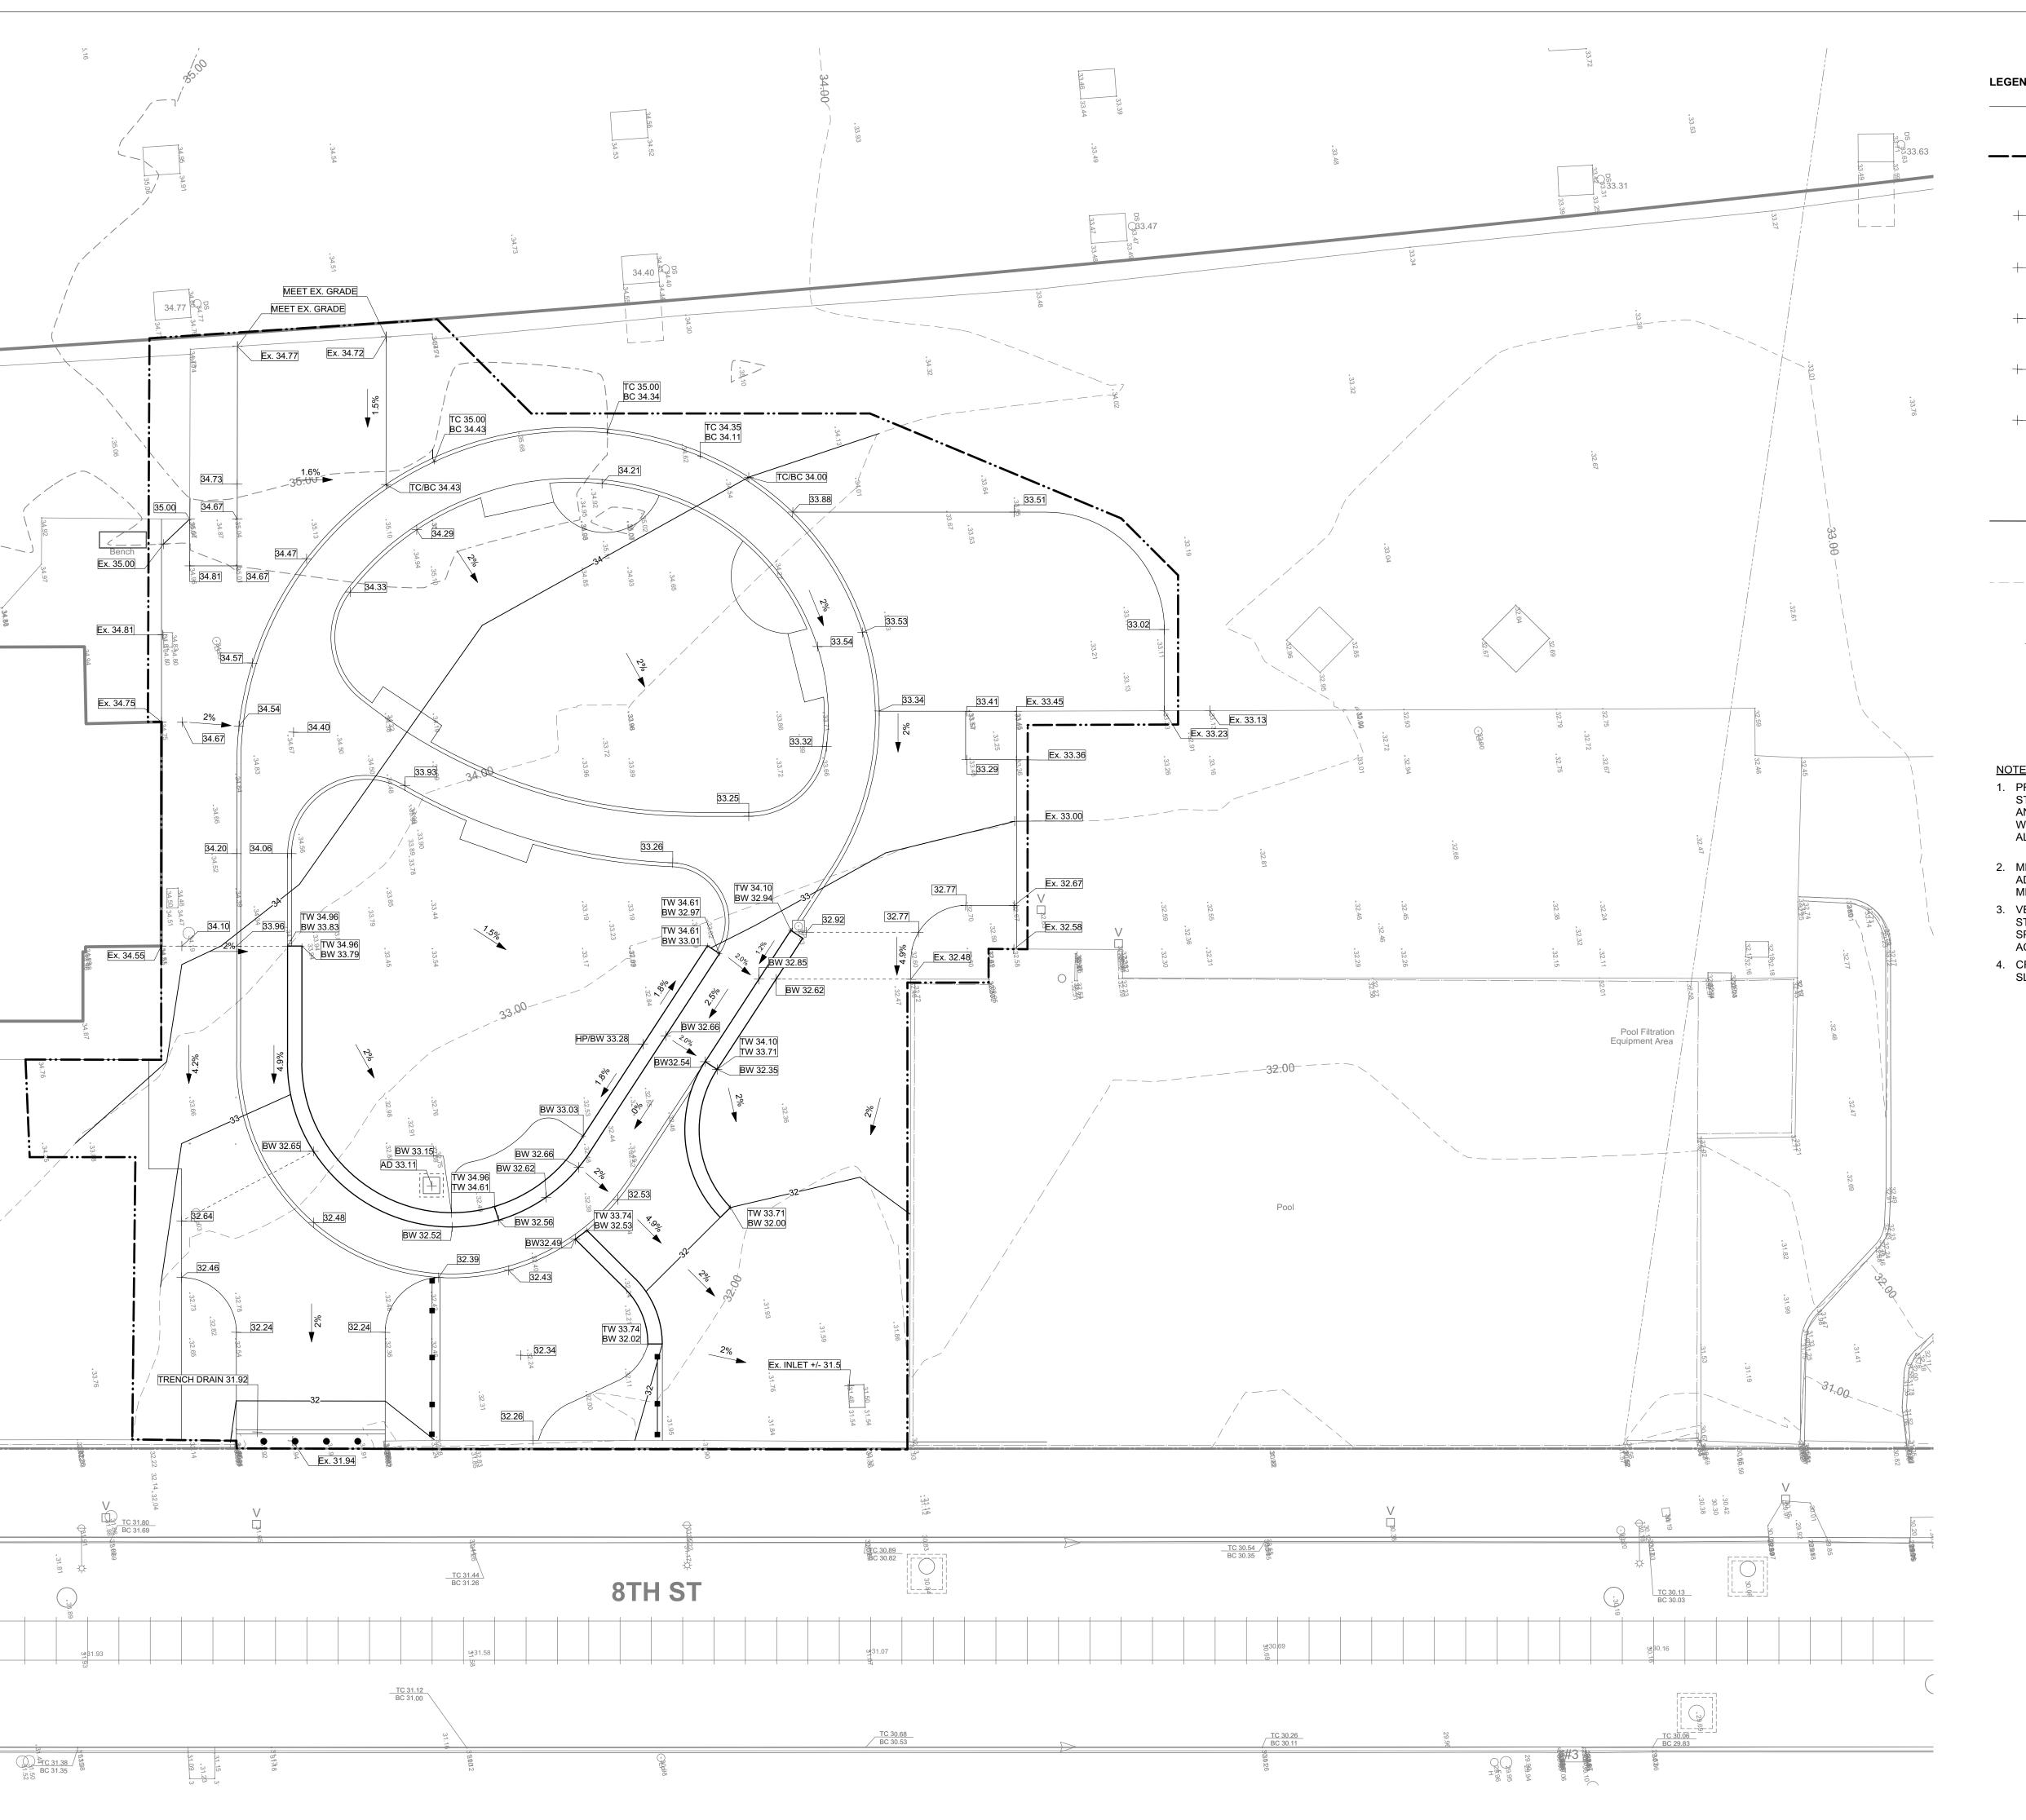


LEGEND

LIMIT OF DISTURBANCE _____ 29.20 PROPOSED SPOT ELEVATION TC 35.00 TOP OF CURB BC 34.50 BOTTOM OF CURB TW 33.88 TOP OF WALL BW 32.38 BOTTOM OF WALL EXISTING SPOT ELEVATION PROPOSED CONTOUR EXISTING CONTOUR 2%

- 1. PRESERVE AND PROTECT ALL EXISTING TO REMAIN: STRUCTURES, FURNISHING, SURFACE MATERIALS, ABOVE AND BELOW GRADE UTILITIES, FOOTING AND VEGETATION WITHIN AND ADJACENT TO CONSTRUCTION AREA DURING ALL PHASES OF DEMOLITION AND CONSTRUCTION.
- 2. MEET ALL EXISTING GRADES AT ALL EDGES OF PROJECT. ADJUST EXISTING INLETS, DRAINS, VENTS, VALVE, ETC. TO MEET FINISH GRADES.
- 3. VERIFY EXISTING CONDITION SPOT ELEVATIONS PRIOR TO START OF WORK. NOTIFY LANDSCAPE ARCHITECT IF EX. SPOT ELEVATIONS OR PROPOSED SLOPES CANNOT BE ACHIEVED.
- 4. CROSS SLOPE SHALL NOT EXCEED 2%. LONGITUDINAL SLOPE SHALL NOT EXCEED 4.9%.

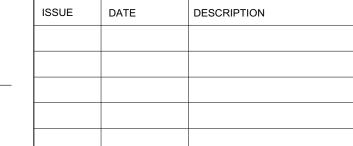

REVISIONS

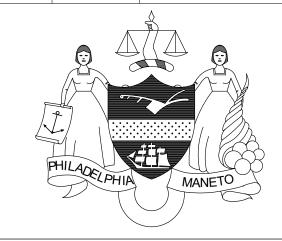

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CITY OF PHILADELPHIA PHILADELPHIA PARKS & RECREATION 1515 ARCH STREET 11TH FLOOR, ONE PARKWAY BUILDING PHILADELPHIA, PENNSYLVANIA


PROJECT TITLE East Poplar Playground


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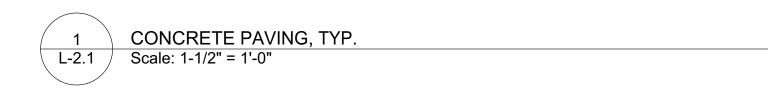
GRADING PLAN


PROJECT NO. DRAWING NO. L-1.3 DATE: 02.07.2020 DRAWN BY: WM/JB/JJD

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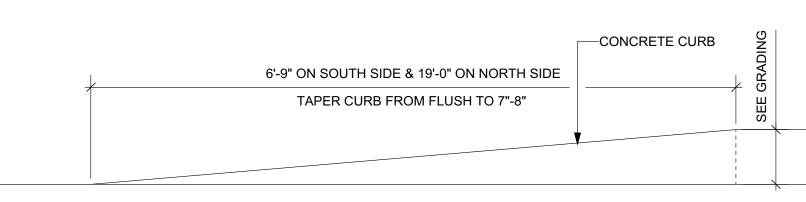





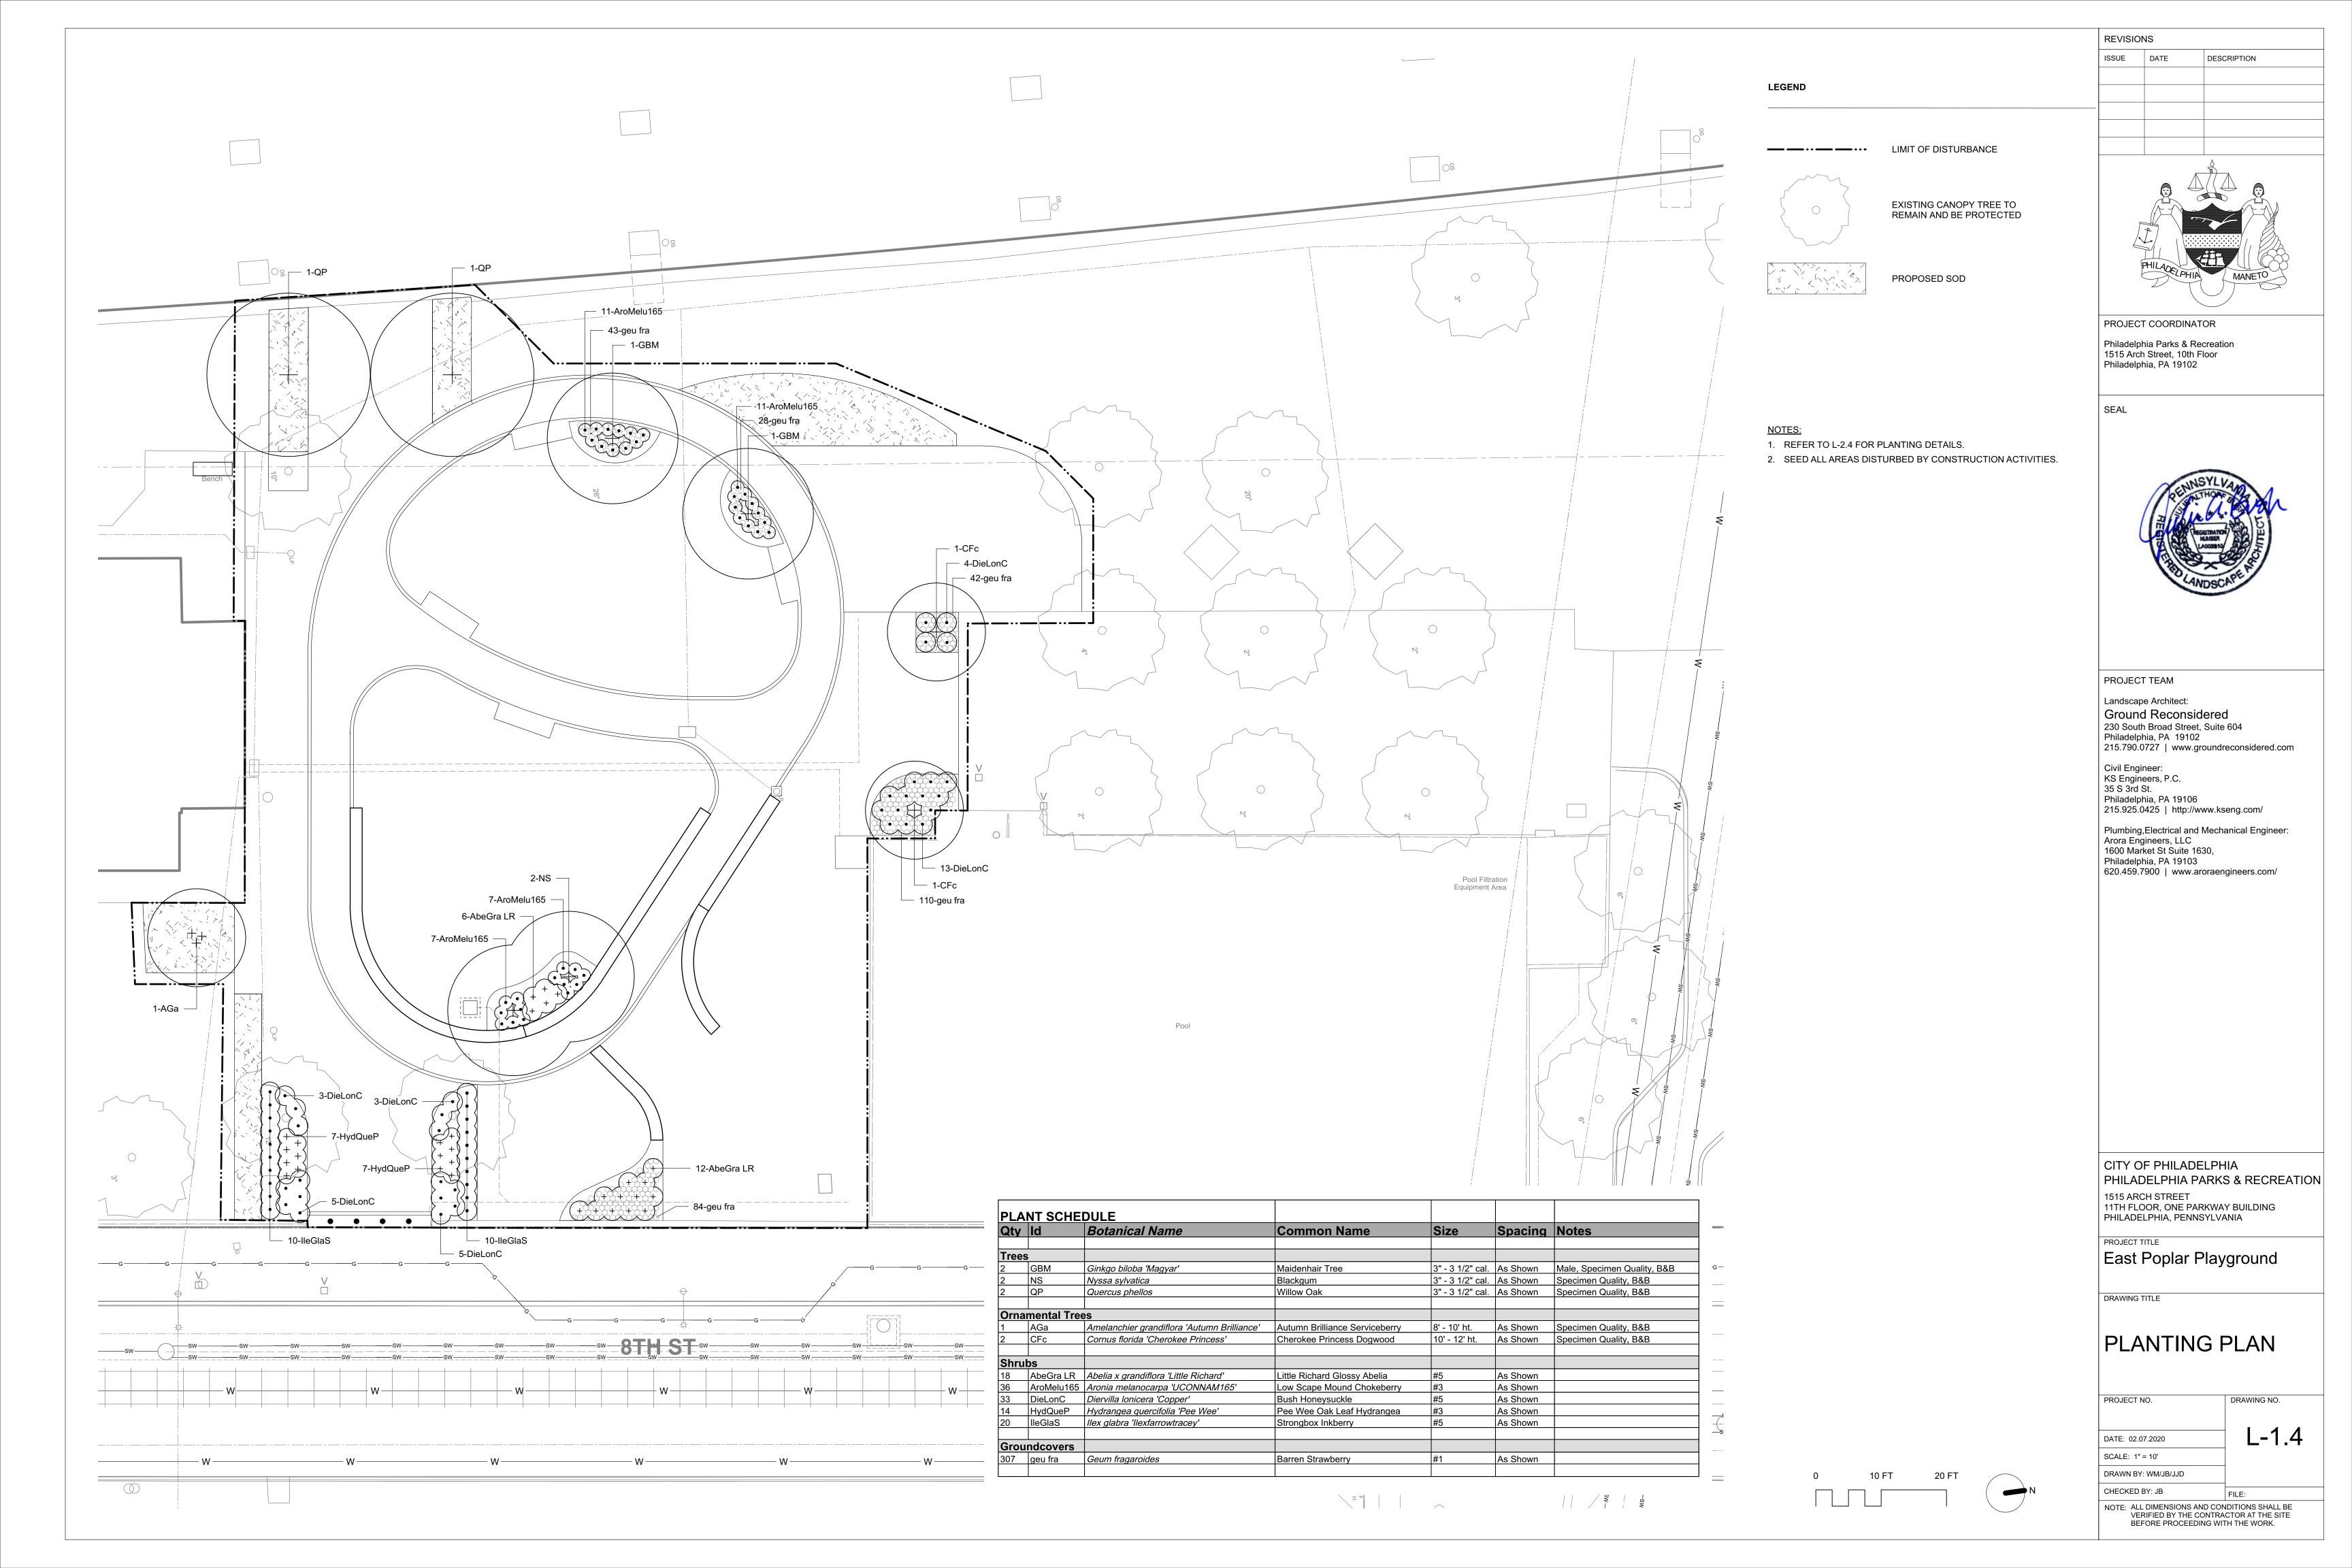


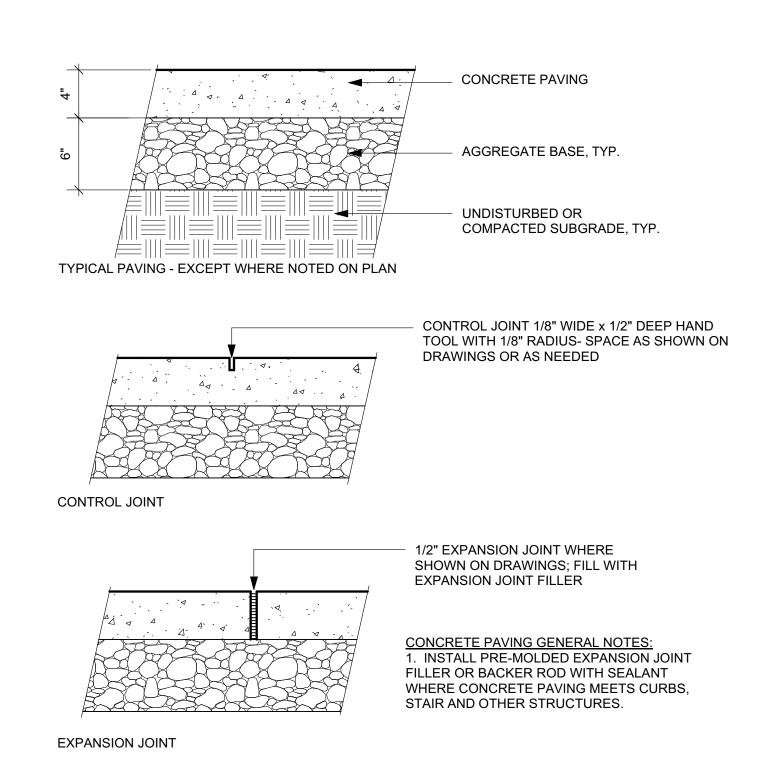

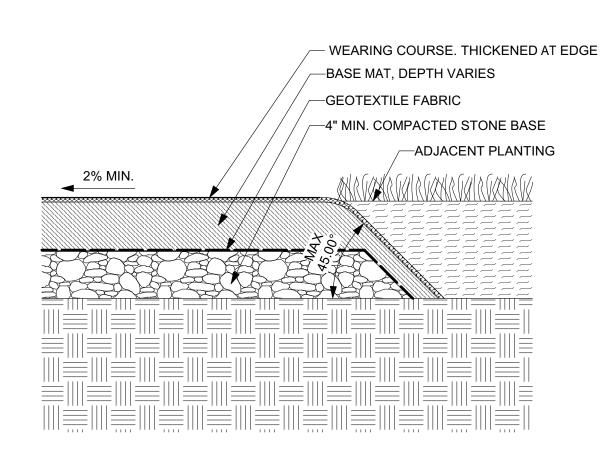BONDED RUBBER SAFETY SURFACE / PLANT BED TRANSITION L-2.1 Scale: 1-1/2" = 1'-0"




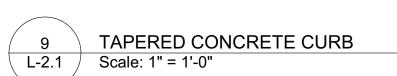

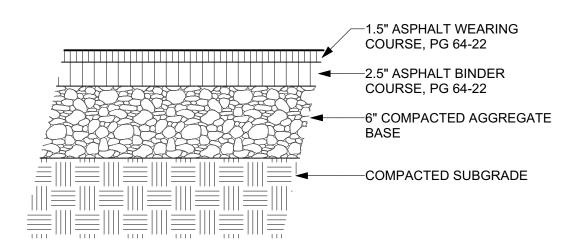


ASPHALT PAVING, TYP. Scale: 1-1/2" = 1'-0"


> 1. SAFETY SURFACE DEPTH MUST MEET OR EXCEED THAT WHICH IS REQUIRED TO MEET THE CRITICAL FALL HEIGHT CRITERIA OF EACH PIECE OF EQUIPMENT, PPR STANDARDS, ASTM-F1292-13, OR MOST RECENT EDITION STANDARD.

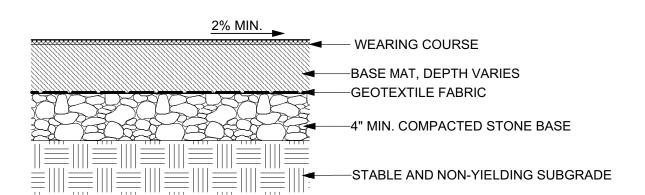


BONDED RUBBER SAFETY SURFACE, TYP. Scale: 1-1/2" = 1'-0"

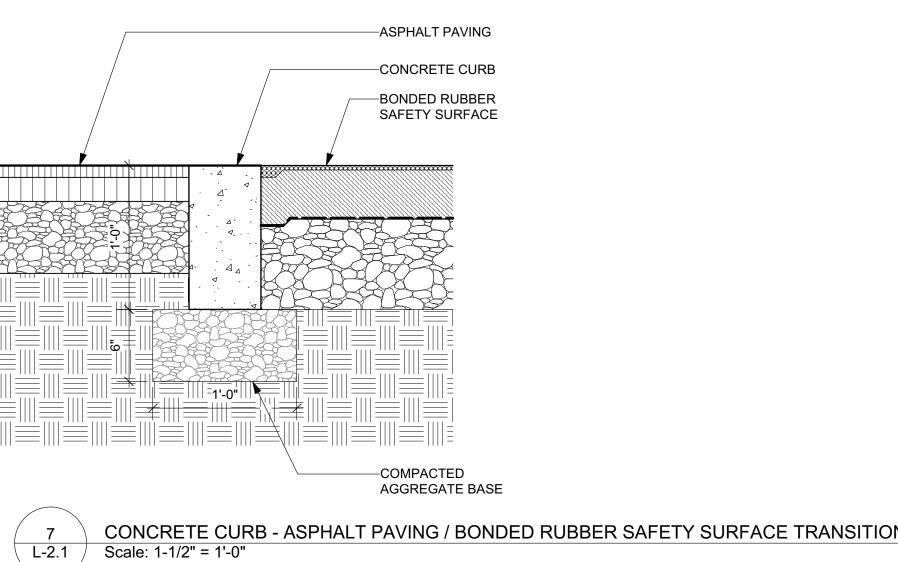


CONCRETE CURB - ASPHALT PAVING / BONDED RUBBER SAFETY SURFACE TRANSITION

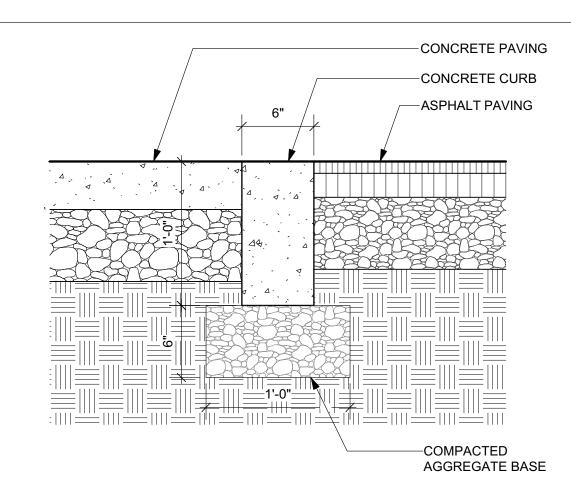


CONCRETE CURB - CONCRETE PAVING / ASPHALT PAVING Scale: 1-1/2" = 1'-0"

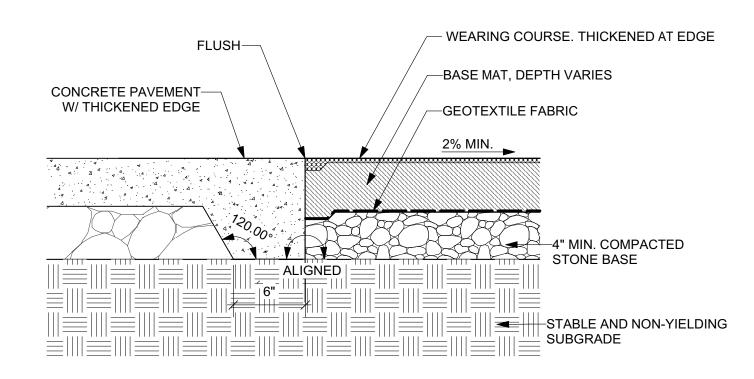

BONDED RUBBER SAFETY SURFACE / CONCRETE TRANSITION Scale: 1-1/2" = 1'-0"

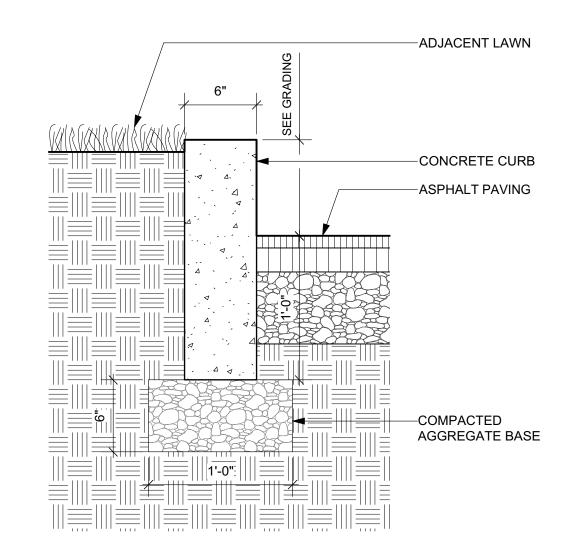

CONCRETE CURB Scale: 1-1/2" = 1'-0"

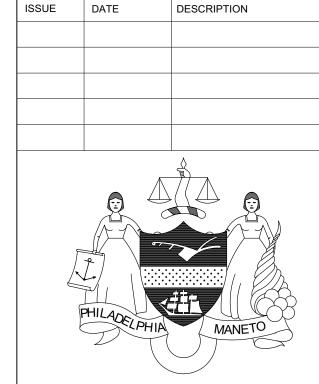

PROJECT COORDINATOR

Philadelphia Parks & Recreation and Department of Public Property 1515 Arch Street, 10th Floor Philadelphia, PA 19102 Contact: Nancy Q. O'Donnell, 215.832.2174

SEAL

REVISIONS



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Landscape Architect: Ground Reconsidered 230 South Broad Street, Suite 604 Philadelphia, PA 19102 215.790.0727 | www.groundreconsidered.com

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CITY OF PHILADELPHIA DEPARTMENT OF PUBLIC PROPERTY 1515 ARCH STREET 11TH FLOOR, ONE PARKWAY BUILDING

PROJECT TITLE East Poplar Playground

PHILADELPHIA, PENNSYLVANIA


DRAWING TITLE


CHECKED BY: JB

SITE DETAILS

PROJECT NO. DRAWING NO. DATE: 02.07.2020 SCALE: AS SHOWN DRAWN BY: WM/JB/JJD


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1 FLATTENED CURVED CONCRETE WALL ELEVATION - 6-23 MONTH PLAY AREA Scale: 1/4" = 1'-0"

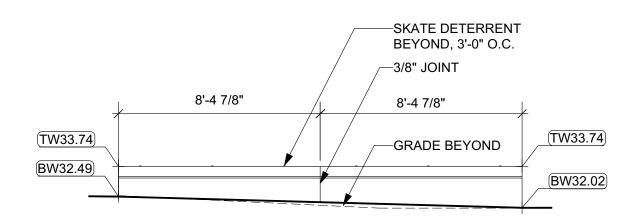
2 FLATTENED CURVED CONCRETE WALL ELEVATION - SPRAYGROUND
L-2.2 Scale: 1/4" = 1'-0"

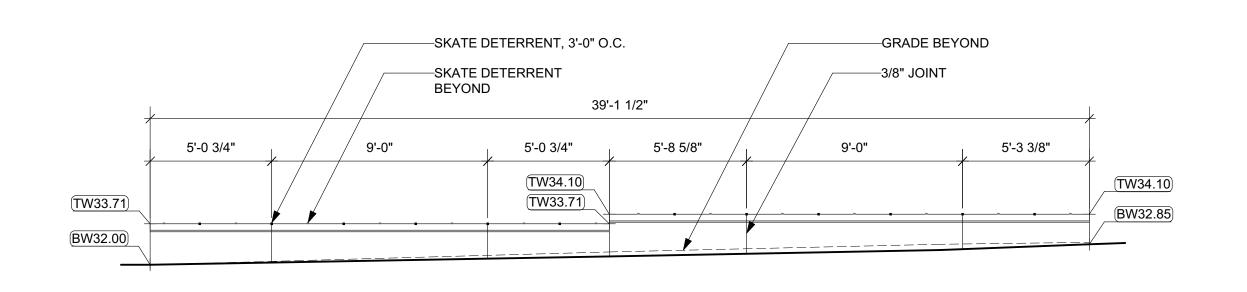

3 FLATTENED CURVED CONCRETE WALL ELEVATION - AGE 2-5 PLAY AREA
L-2.2 Scale: 1/4" = 1'-0"

NOTE:

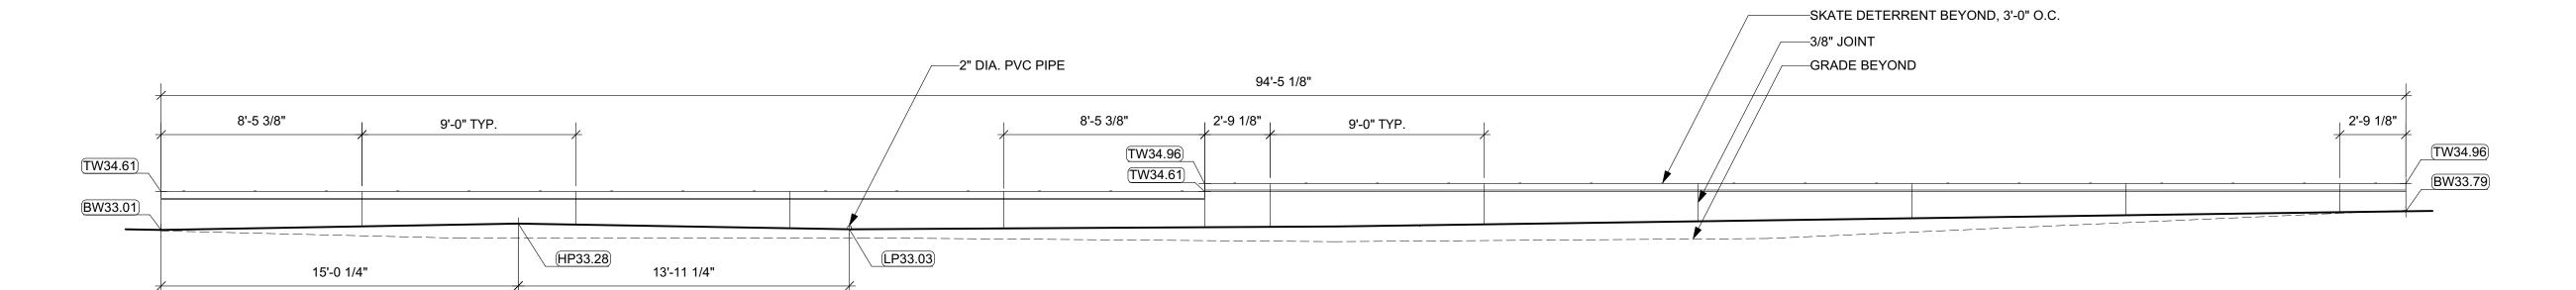1. ASSUME 9'-0" O.C. VERTICAL JOINTING 2. SKATE DETERRENTS SHALL BE INSTALLED ON SIDES OF WALLS ADJACENT TO ASPHALT AND CONCRETE, NOT SAFETY SURFACE.

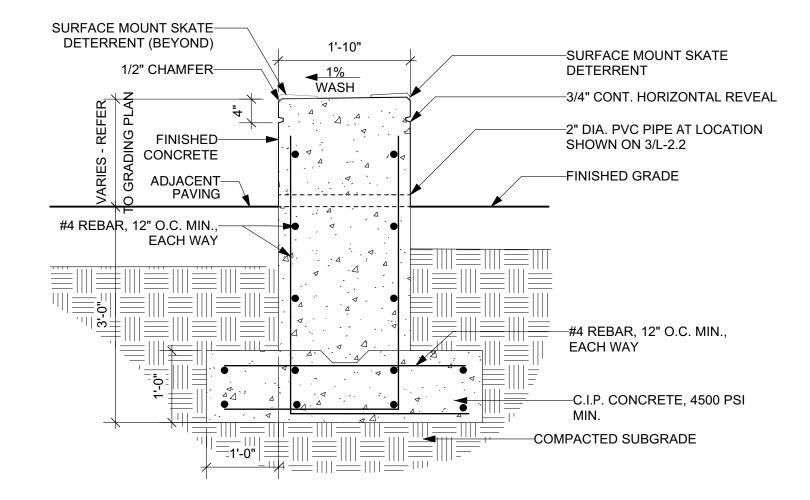

4 FREESTANDING SEAT WALL SECTION
L-2.2 Scale: 3/4" = 1'-0"

CITY OF PHILADELPHIA
DEPARTMENT OF PUBLIC PROPERTY
1515 ARCH STREET
11TH FLOOR, ONE PARKWAY BUILDING
PHILADELPHIA, PENNSYLVANIA

East Poplar Playground

DRAWING TITLE

CHECKED BY: JB

REVISIONS

ISSUE DATE

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Philadelphia, PA 19106

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Philadelphia Parks & Recreation and Department of Public Property 1515 Arch Street, 10th Floor


Contact: Nancy Q. O'Donnell, 215.832.2174

DESCRIPTION

SITE DETAILS


PROJECT NO.	DRAWING NO.
DATE: 02.07.2020	L-2.2
SCALE: AS SHOWN	
DRAWN BY: WM/JB/JJD	

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REVISIONS
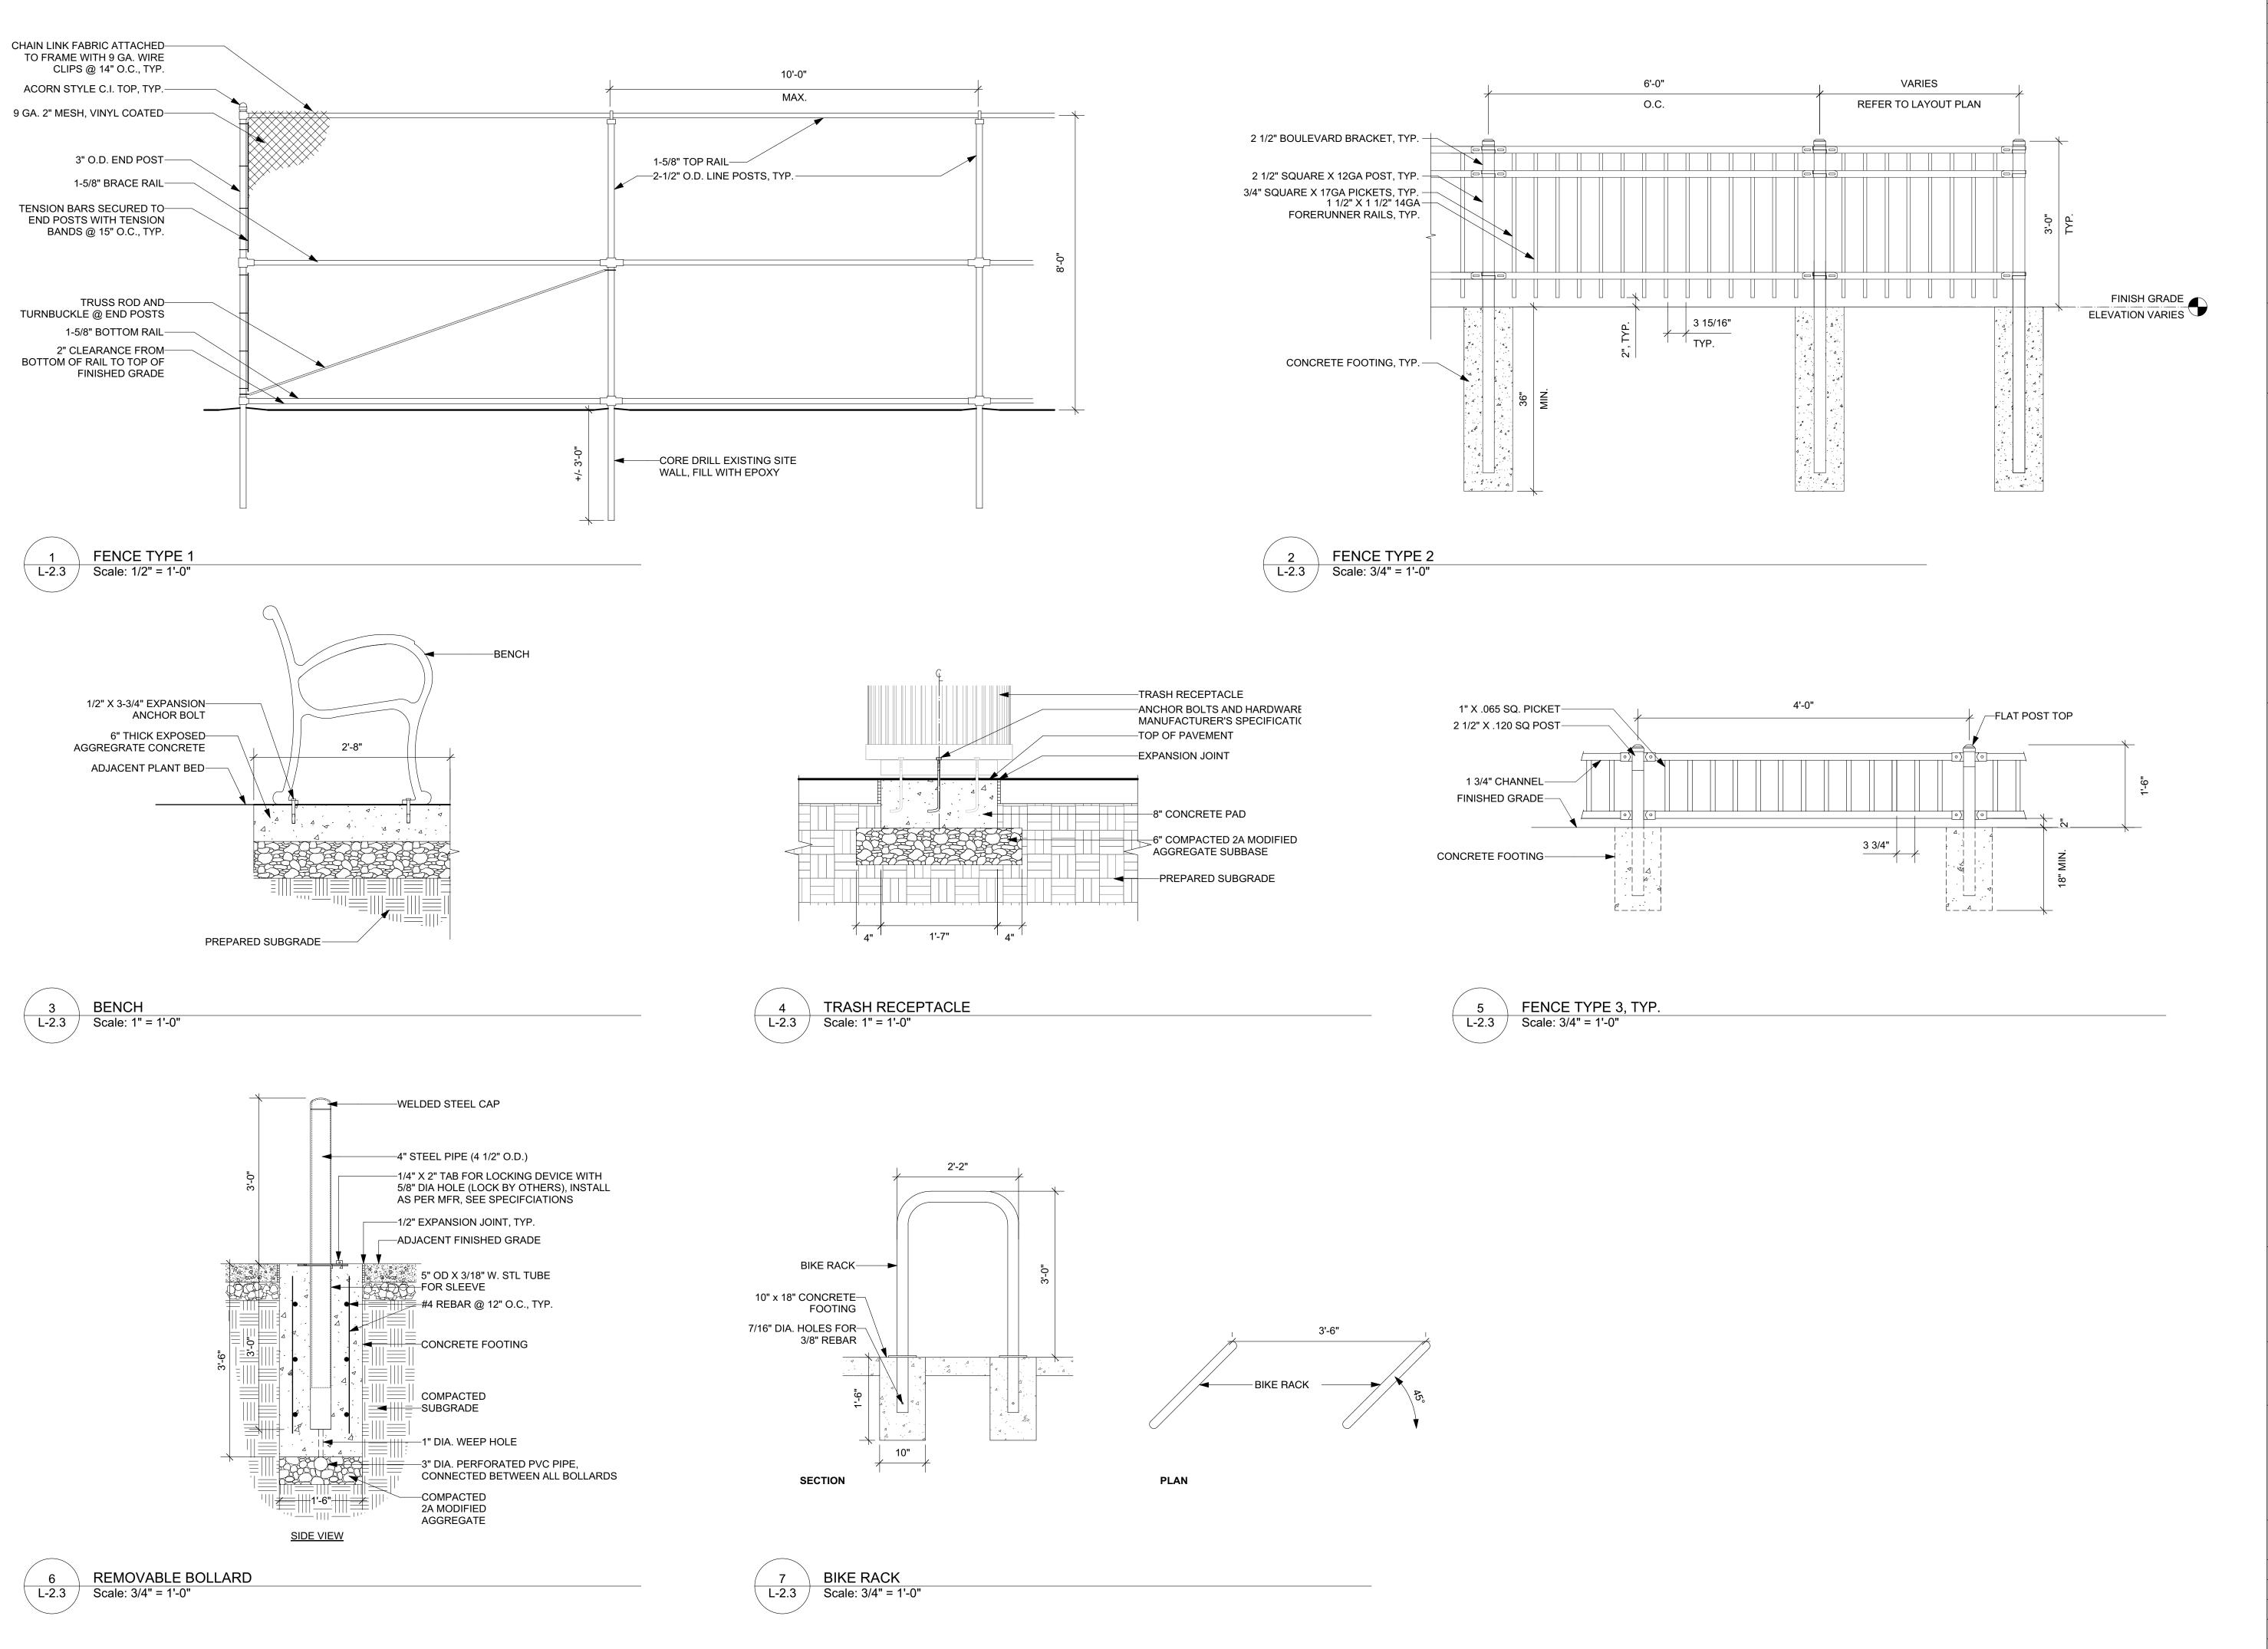
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CITY OF PHILADELPHIA
DEPARTMENT OF PUBLIC PROPERTY
1515 ARCH STREET
11TH FLOOR, ONE PARKWAY BUILDING
PHILADELPHIA, PENNSYLVANIA

East Poplar Playground


DRAWING TITLE

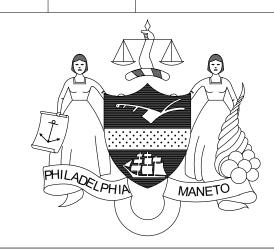SITE DETAILS

PROJECT NO.	DRAWING NO.
	1 0 0
DATE: 02.07.2020	L-2.3
SCALE: AS SHOWN	
DRAWN BY: WM/JB/JJD	
CHECKED BY: IB	

CHECKED BY: JB FILE:

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L-2.4 Scale: 1/4" = 1'-0"

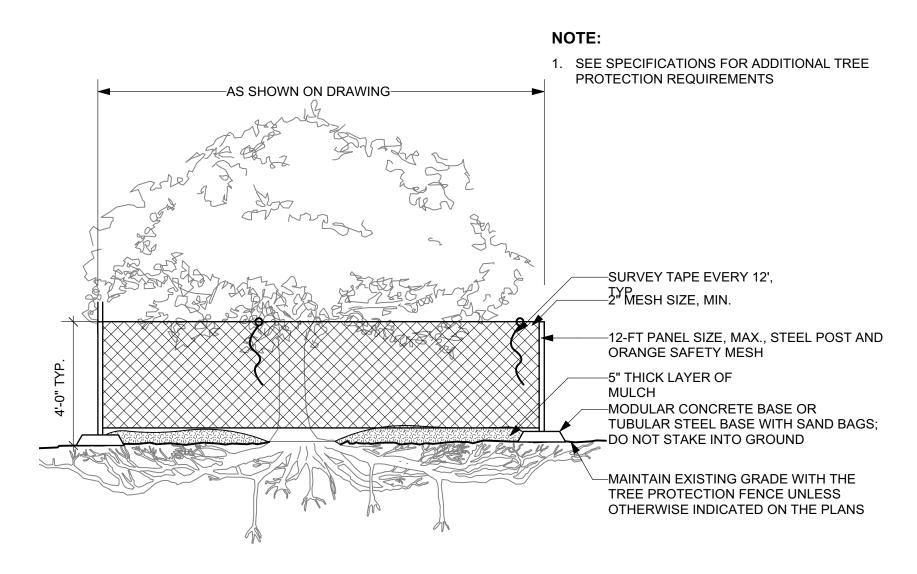TREE PROTECTION FENCE

1. SHRUBS SHALL BE OF QUALITY PRESCRIBED IN THE ROOT OBSERVATIONS DETAIL AND SPECIFICATIONS. 2. SEE SPECIFICATIONS FOR FURTHER REQUIREMENTS RELATED TO THIS DETAIL. ROOT BALL SHRUB -4" HIGH X 8" WIDE ROUND -TOPPED SOIL BERM ABOVE ROOT BALL SURFACE SHALL BE 4" LAYER OF MULCH. CONSTRUCTED AROUND THE NO MORE THAN 1" OF ROOT BALL. BERM SHALL BEGIN AT MULCH ON TOP OF ROOT BALL PERIPHERY. ROOT BALL. (SEE PRIOR TO MULCHING, LIGHTLY TAMP SPECIFICATIONS FOR SOIL AROUND THE ROOT BALL IN 6" MULCH). LIFTS TO BRACE SHRUB. DO NOT OVER COMPACT. WHEN THE FINISHED GRADE PLANTING HOLE HAS BEEN BACKFILLED, POUR WATER AROUND THE ROOT BALL TO SETTLE THE SOIL. AMENDED TOPSOIL. DEPTH VARIES. (SEE SPECIFICATIONS FOR SOIL MODIFICATION). **EXISTING SOIL** ROOT BALL RESTS ON -

SECTION VIEW



EXISTING OR

RECOMPACTED SOIL

SHRUB PLANTING, TYP. Scale: 3/4" = 1'-0"

NOTES:

 SCARIFY SUBGRADE AT SIDES AND BOTTOM OF PLANTING PIT, TYPICAL.

2. REMOVE EXCESS SOIL FROM ROOTBALL TO EXPOSE FLARE PRIOR TO SETTING ROOTBALL

3. SEE SPECIFICATIONS FOR FURTHER REQUIREMENTS RELATED TO THIS DETAIL.

TRUNK CALIPER SHALL MEET ANSI Z60-CURRENT EDITION FOR ROOT BALL SIZE

REMOVE TOP 2/3 WIRE BASKET, TYP. DO-NOT FOLD DOWN WIRE. WIRE MUST BE CUT AND REMOVED FROM HOLE. REMOVE BURLAP TO GREATEST

EXTENT POSSIBLE, BUT NO LESS THAN ROUND-TOPPED SOIL BERM 4" HIGH x 8" WIDE-ABOVE ROOT BALL SURFACE SHALL BE CONSTRUCTED AROUND THE ROOT BALL.

BERM SHALL BEGIN AT ROOT BALL PERIPHERY. FINISHED GRADE

> 3x BALL WIDTH OF ADJACENT PLANTING

> > SOIL

-PRIOR TO MULCHING, LIGHTLY TAMP SOIL AROUND THE ROOT BALL IN 6" LIFTS TO BRACE TREE. DO NOT OVER COMPACT. WHEN THE PLANTING HOLE HAS BEEN BACKFILLED, POUR WATER AROUND THE ROOT BALL TO SETTLE THE SOIL

-TOP OF ROOT BALL SHALL BE FLUSH WITH FINISHED

3" LAYER OF MULCH. NO MORE THAN 1" OF MULCH ON TOP OF ROOT BALL. (SEE SPECIFICATIONS FOR MULCH). LOOSENED SOIL. DIG AND TURN THE SOIL TO REDUCE

COMPACTION TO THE AREA AND DEPTH SHOWN EXISTING SOIL

GRADE

-BOTTOM OF ROOT BALL RESTS ON EXISTING OR RECOMPACTED SOIL

L-2.4 / Scale: 1/2" = 1'-0"

TREE PLANTING, TYP.

2 - 3" THICK LAYER OF MULCH FINISHED GRADE AMENDED TOPSOIL. DEPTH VARIES. (SEE SPECIFICATIONS FOR SOIL MODIFICATION). EXISTING SOIL SECTION VIEW GROUNDCOVER PLANTS TO BE TRIANGULARLY SPACED MULCH WALL <u>PLAN</u> MAINTAIN SUFFICIENT SPACE FOR SPECIES TO GROW - ____ CONSULT LANDSCAPE ARCHITECT FOR SPACING REQUIREMENTS

NOTES:

1. SMALL ROOTS (1#4" OR LESS) THAT GROW AROUND, UP, OR DOWN THE ROOT BALL PERIPHERY ARE CONSIDERED A NORMAL CONDITION IN CONTAINER PRODUCTION AND ARE ACCEPTABLE HOWEVER THEY SHOULD BE ELIMINATED AT THE TIME OF PLANTING. ROOTS ON THE PERIPERHY CAN BE REMOVED AT THE TIME OF PLANTING. (SEE ROOT BALL SHAVING CONTAINER

2. SETTLE SOIL AROUND ROOT BALL OF EACH GROUNDCOVER PRIOR TO MULCHING.



HERBACEOUS PLANTING, TYP. Scale: 3/4" = 1'-0"

REVISIONS

ISSUE DATE DESCRIPTION



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PROJECT TITLE East Poplar Playground

PHILADELPHIA, PENNSYLVANIA

DRAWING TITLE

PLANTING DETAILS

PROJECT NO. DRAWING NO.


L-2.4


DATE: 02.07.2020

SCALE: AS SHOWN


DRAWN BY: WM/JB/JJD CHECKED BY: JB

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AREA DRAIN NOT TO SCALE

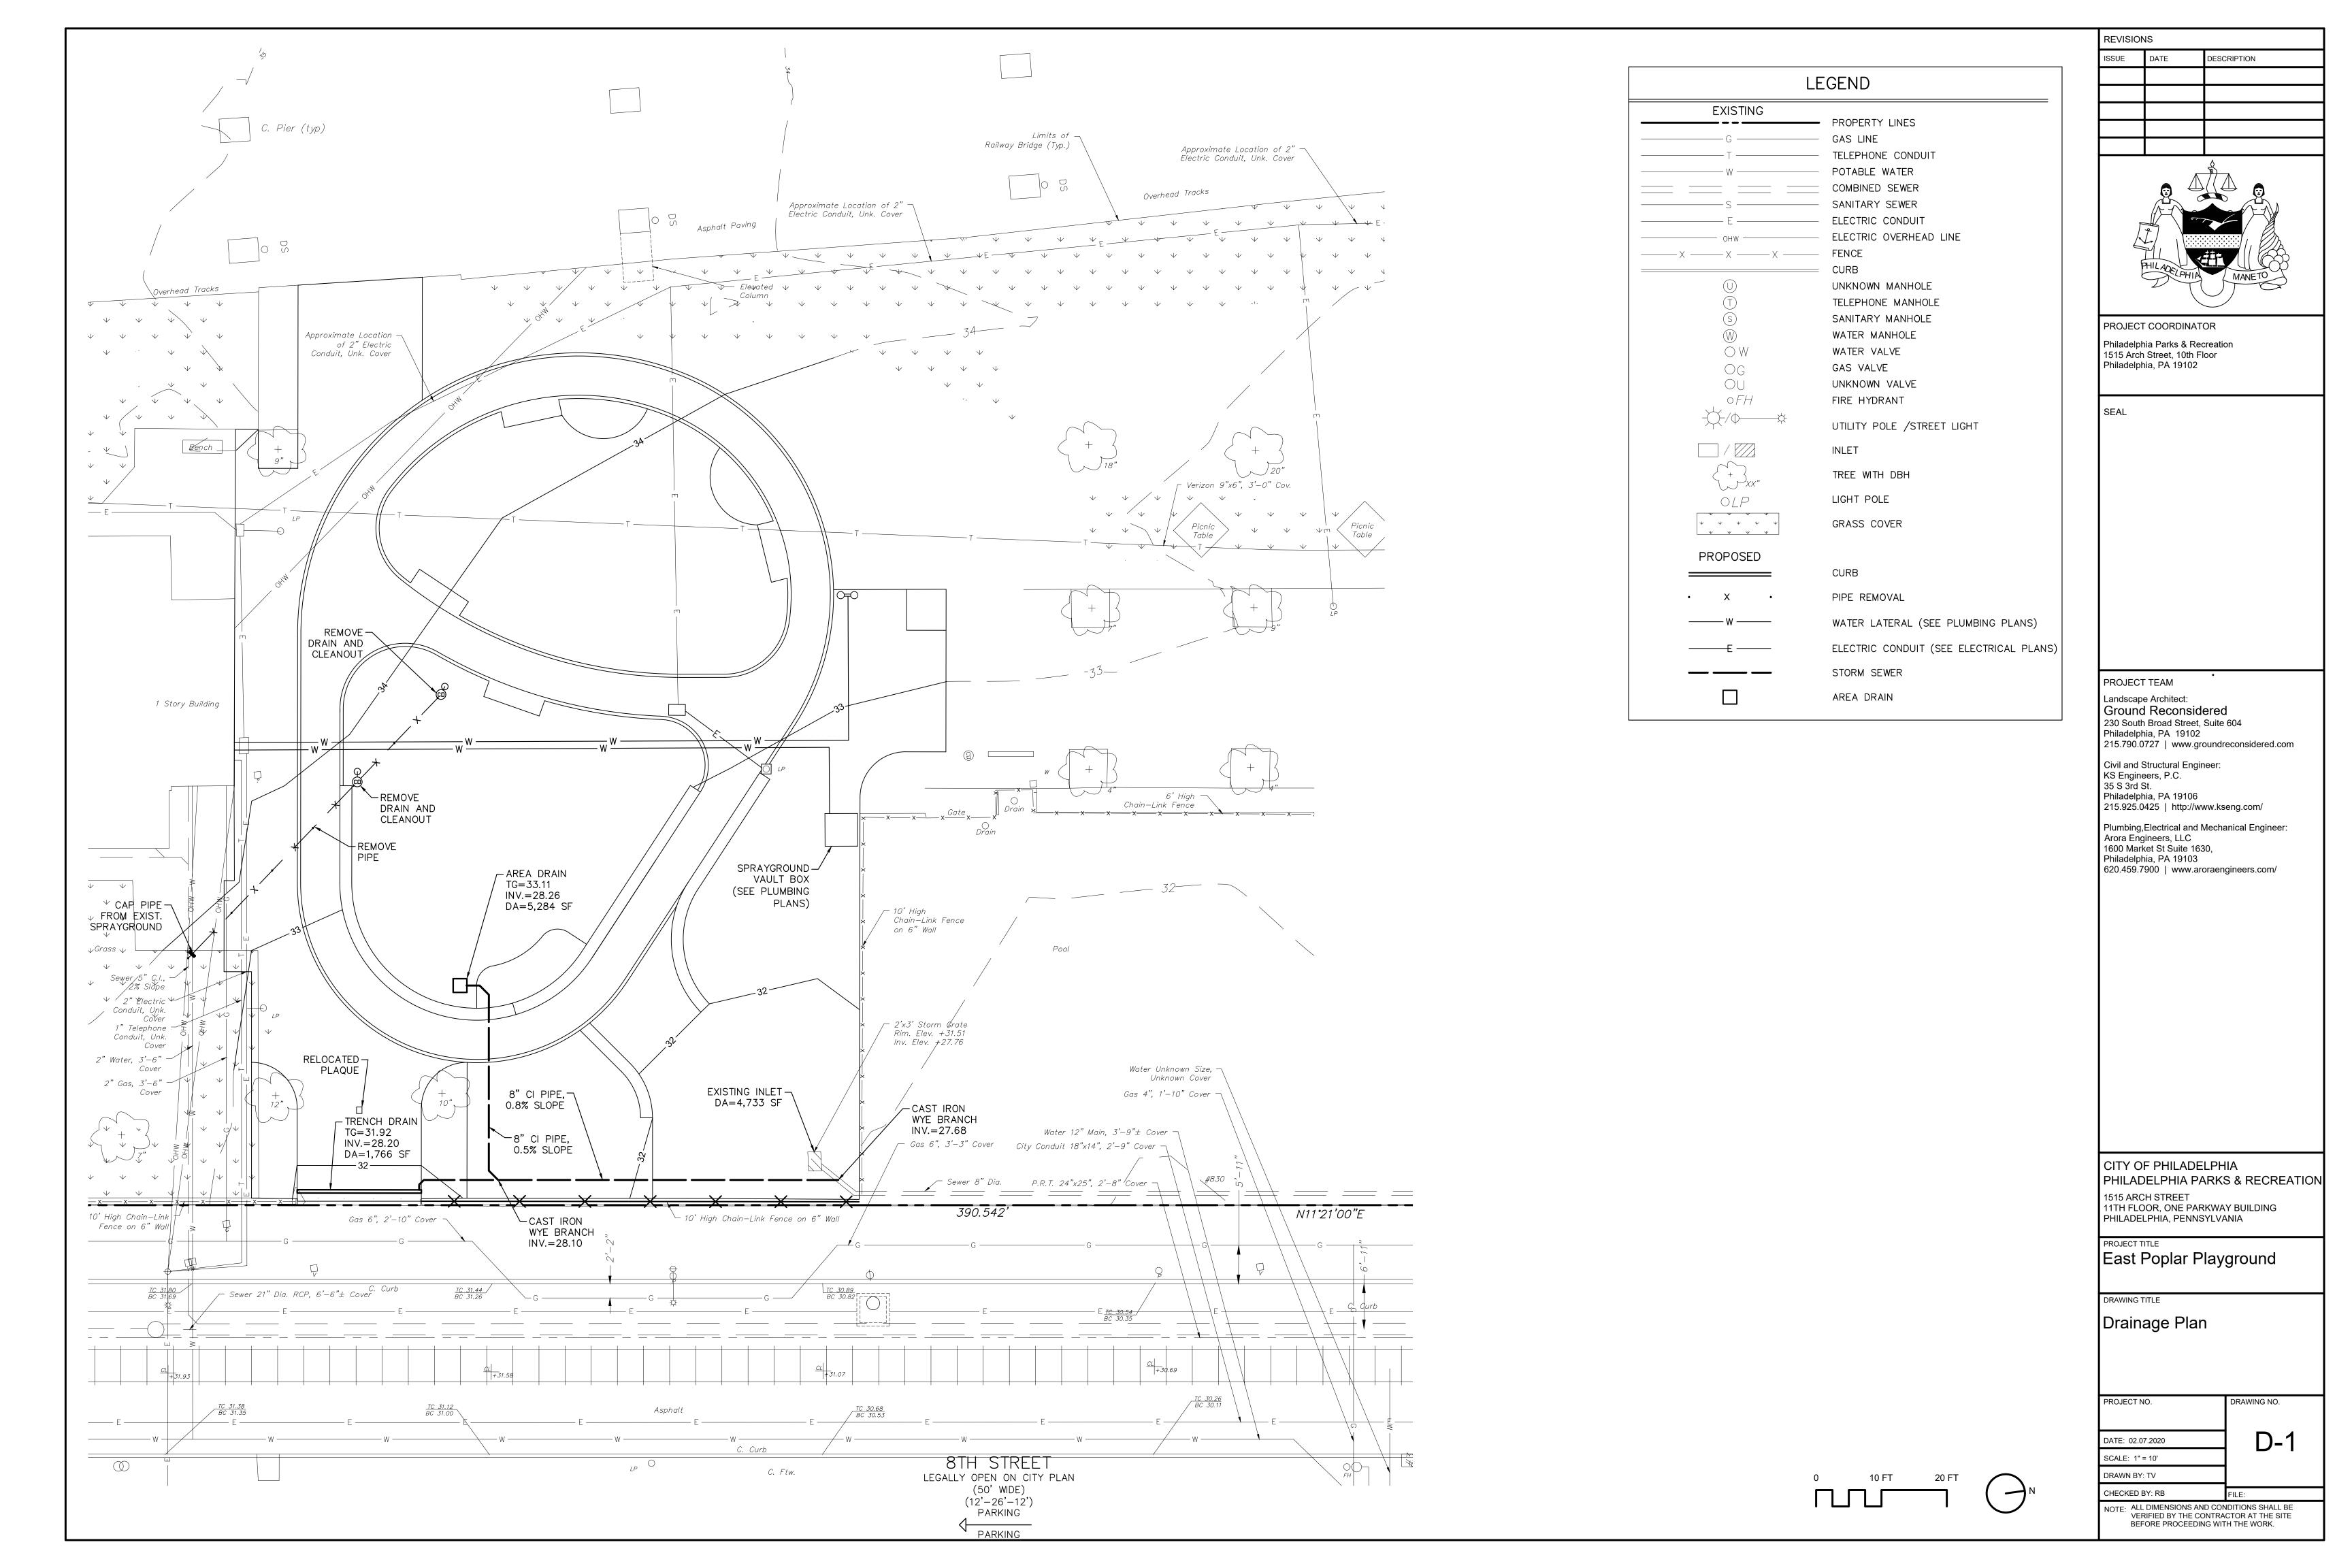


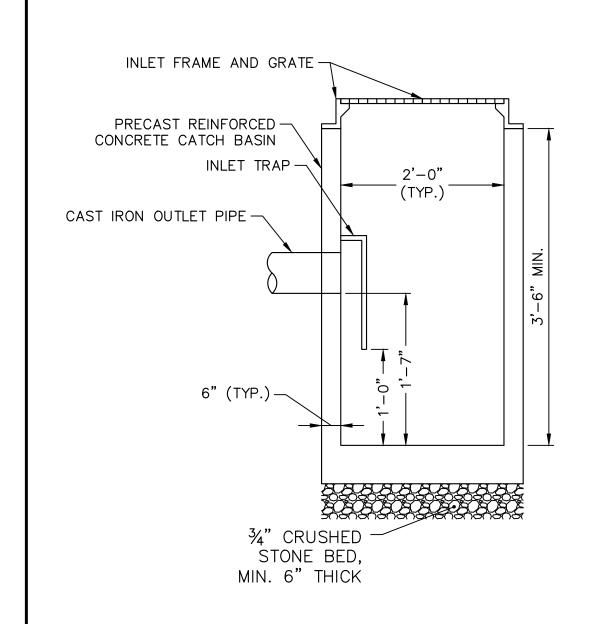1. MINIMUM COVER: NO STRUCTURE SHALL BE PLACED LESS THAN 24-INCHES BELOW THE CARTWAY OR 15-INCHES BELOW THE FOOTWAY. 2. REPLACE ALL DISTURBED PAVEMENT MARKINGS WITH THERMOPLASTIC TAPE. 3. PAVEMENT MARKINGS MUST BE RESTORED


WITHIN 7 DAYS OF TRENCH RESTORATION. 4. ALL RESTORATION TO BE IN ACCORDANCE WITH THE LATEST STREETS DEPARTMENT STANDARDS.

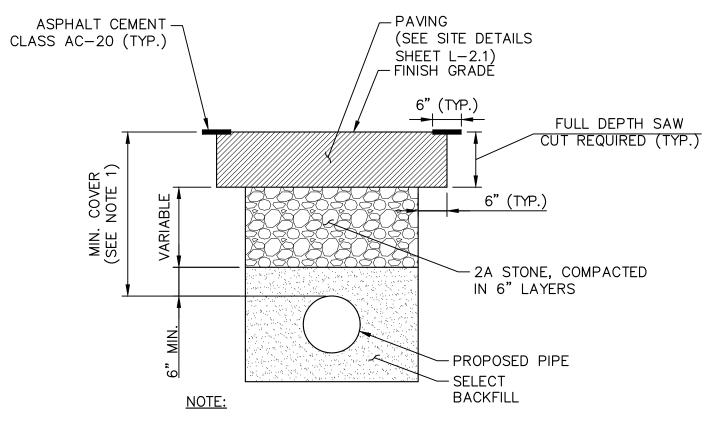PERMANENT TRENCH RESTORATION

NOT TO SCALE

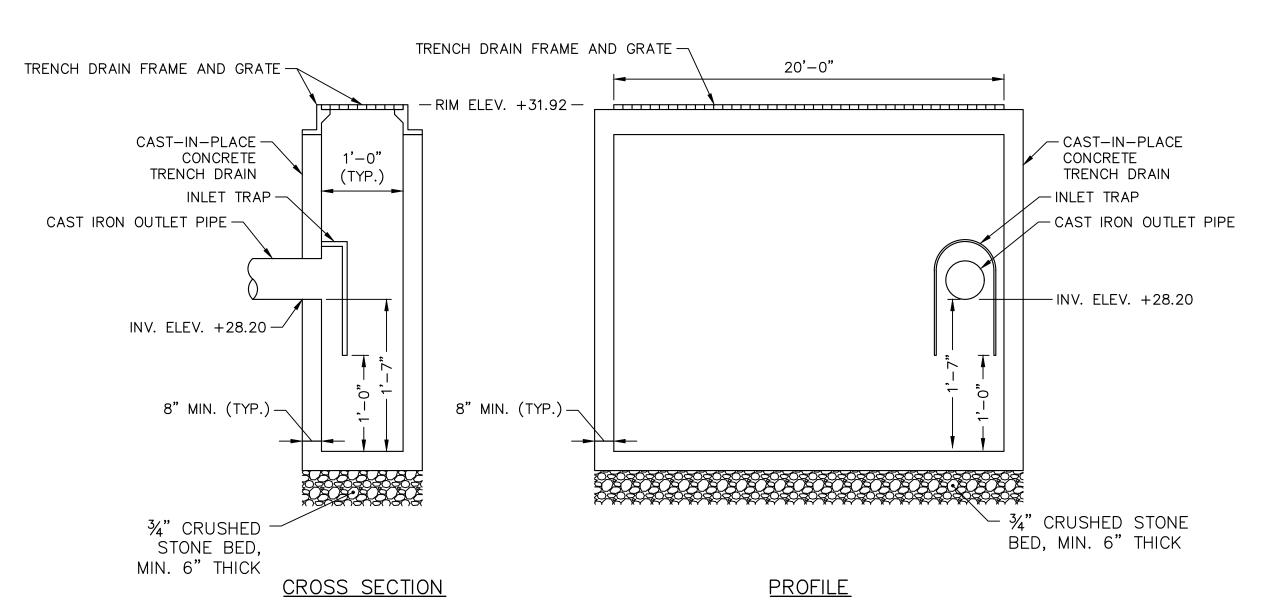

TRENCH DRAIN NOT TO SCALE

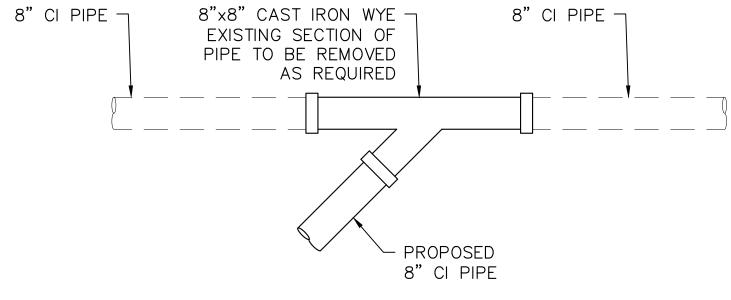

NOT TO SCALE

CAST IRON WYE BRANCH

DESCRIPTION

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CITY OF PHILADELPHIA PHILADELPHIA PARKS & RECREATION 1515 ARCH STREET

11TH FLOOR, ONE PARKWAY BUILDING PHILADELPHIA, PENNSYLVANIA

PROJECT TITLE East Poplar Playground


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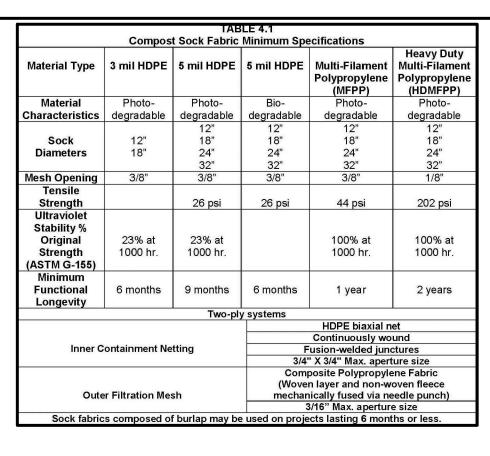
Drainage Details


PROJECT NO. DRAWING NO. D-2 DATE: 02.07.2020


SCALE: 1" = 10' DRAWN BY: TV

CHECKED BY: RB NOTE: ALL DIMENSIONS AND CONDITIONS SHALL BE VERIFIED BY THE CONTRACTOR AT THE SITE



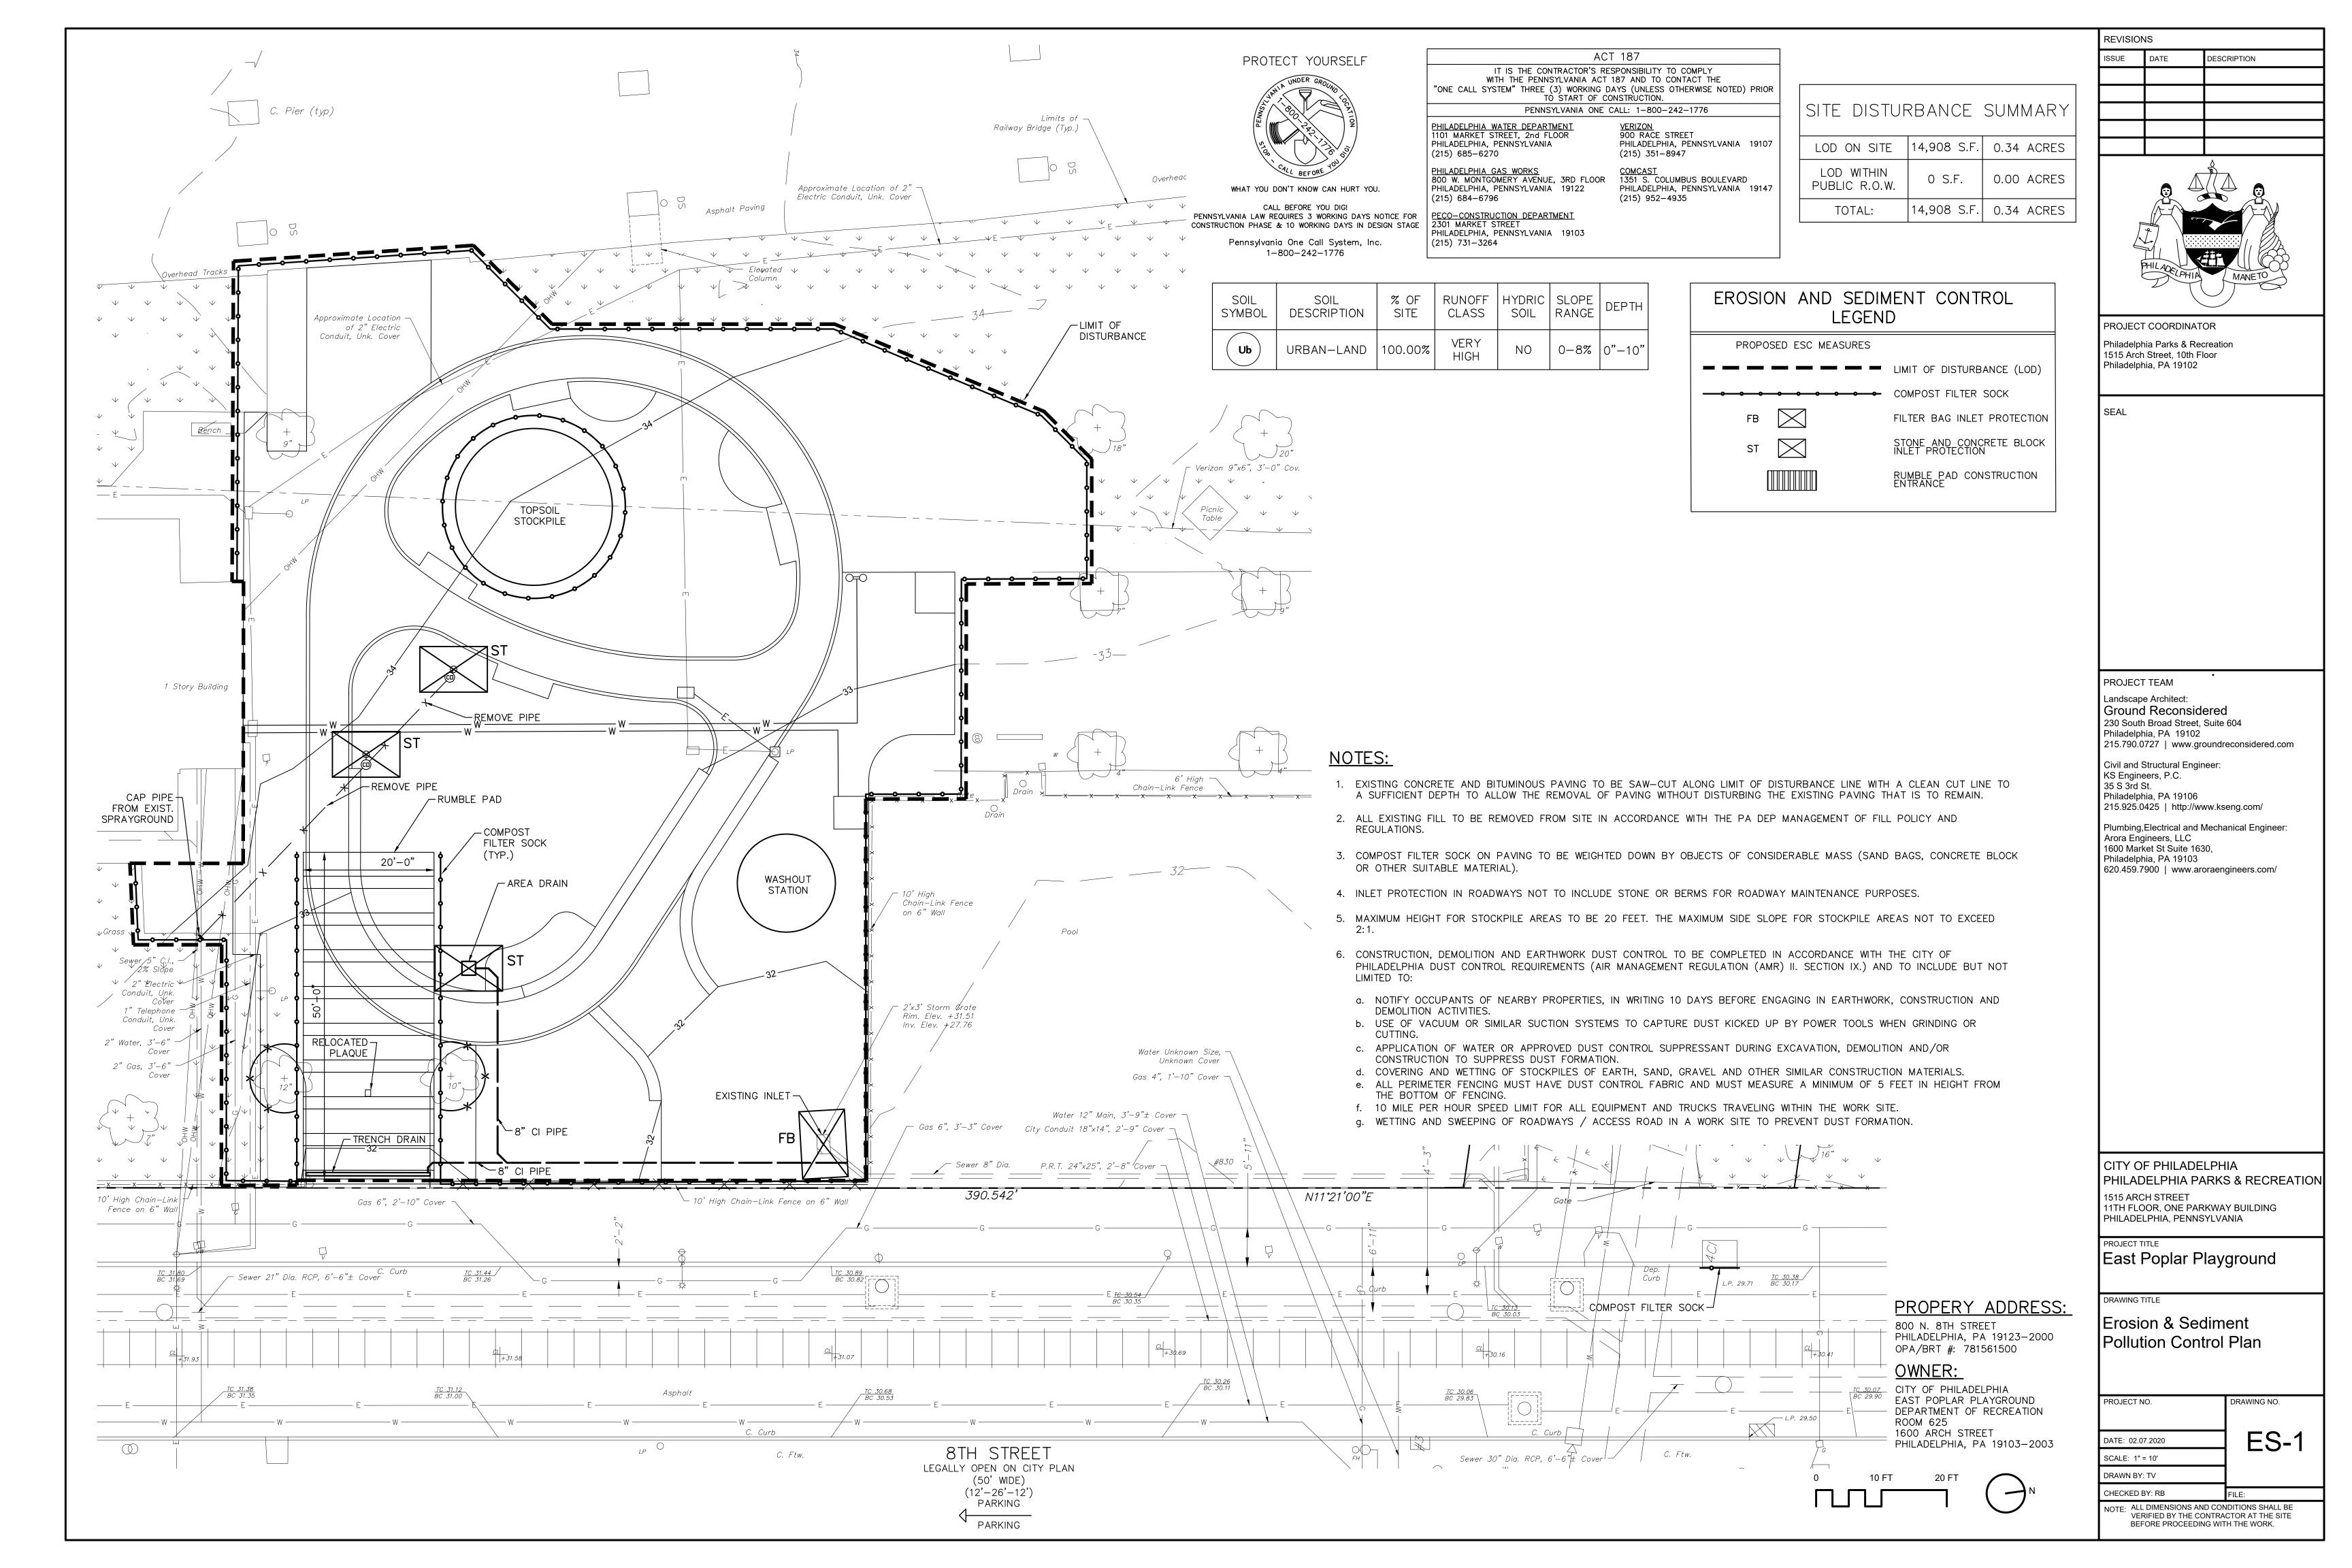

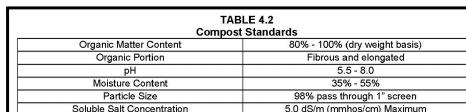


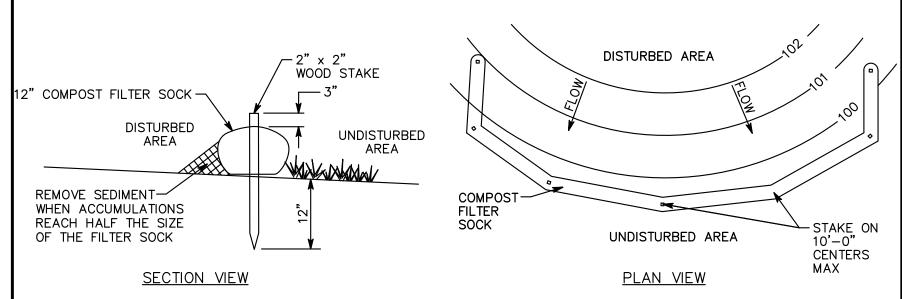



- 1. REMOVE DEPOSITS WHEN SEDIMENT ACCUMULATION IS ONE HALF THE HEIGHT OF THE EXPOSED COMPOST FILTER SOCK.
- 2. PLACE COMPOST FILTER SOCK ON LEVEL GRADE. EXTEND BOTH ENDS OF THE COMPOST FILTER
- SOCK AT LEAST 8'-0" UPSLOPE AT 45 DEGREES TO THE MAIN ALIGNMENT.

 3. REPLACE BIODEGRADABLE FILTER SOCK AFTER 6 MONTHS; PHOTODEGRADABLE AFTER 12 MONTHS.
- 4. ALL DIMENSIONS ARE IN U.S. CUSTOMARY UNITS.
 5. CONTRACTOR SHALL PROVIDE SAND BAGS, CONCRETE BLOCKS, OR OTHER SUITABLE MATERIAL TO
- STABILIZE COMPOST FILTER SOCK ON PAVED AREAS AND PREVENT IT FROM MOVING OR SHIFTING.
- 6. STABILIZING DEVICES SHALL BE SPACED 10 FEET ON CENTER OR AS RECOMMENDED BY THE MANUFACTURER, WHICHEVER IS LESS.

COMPOST FILTER SOCK, 12" DIAMETER

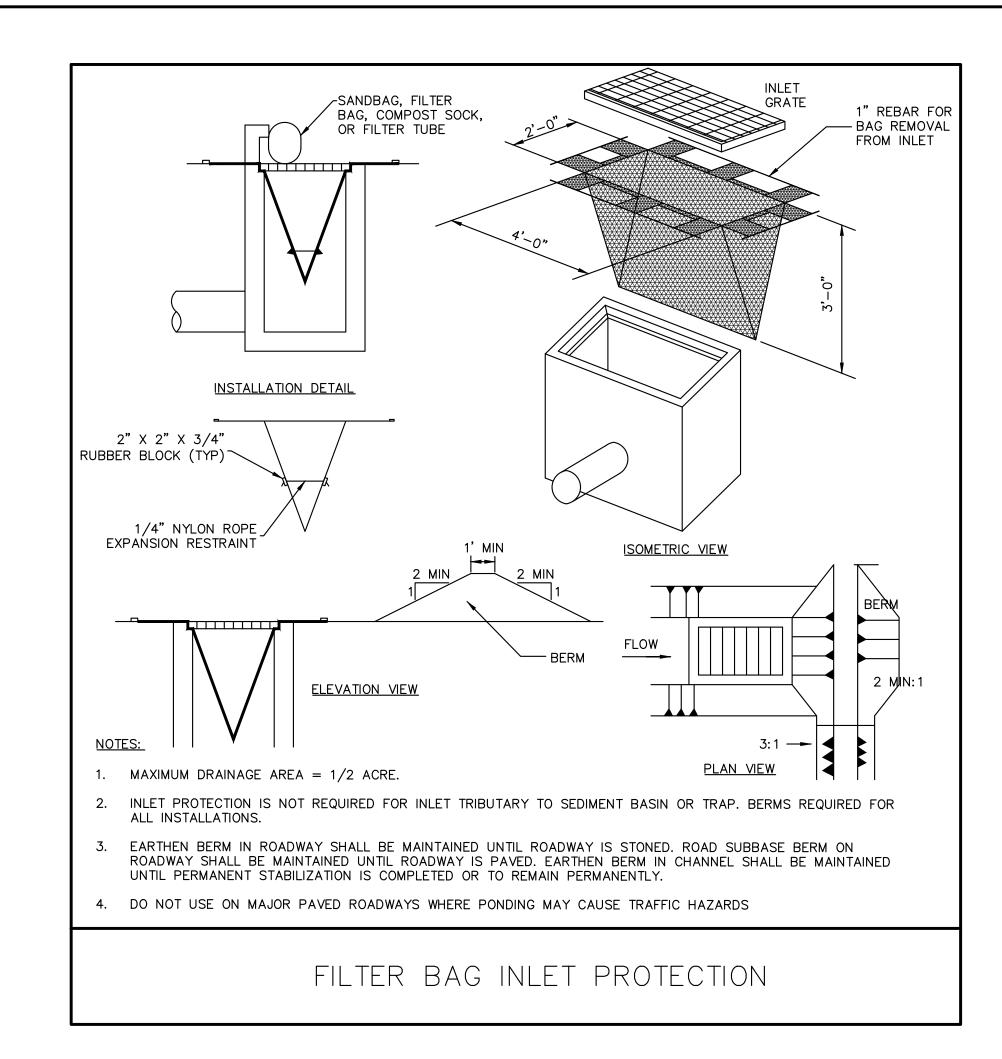

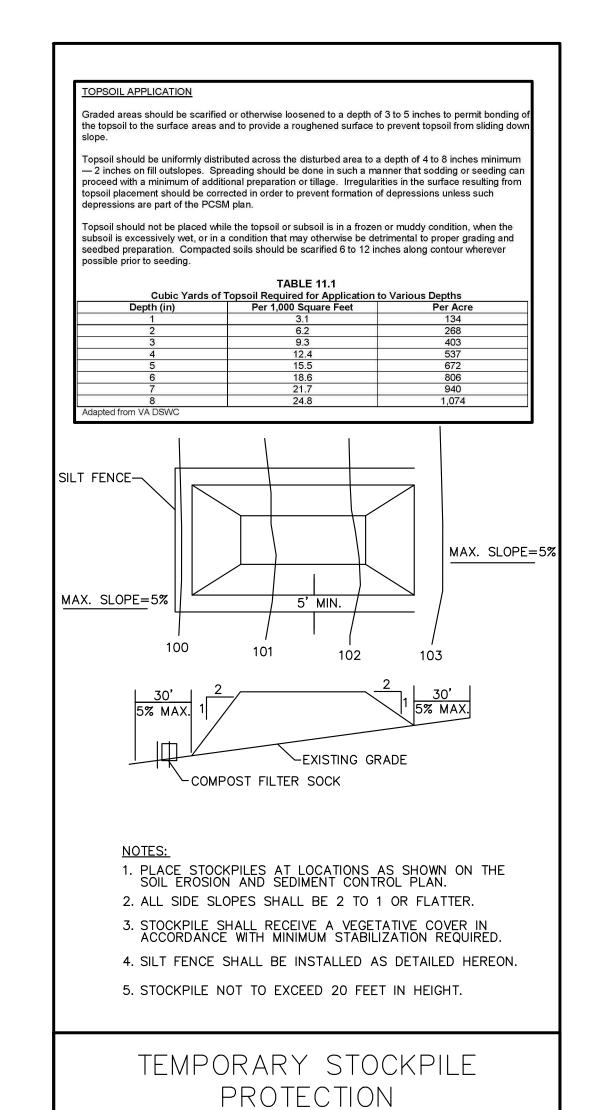

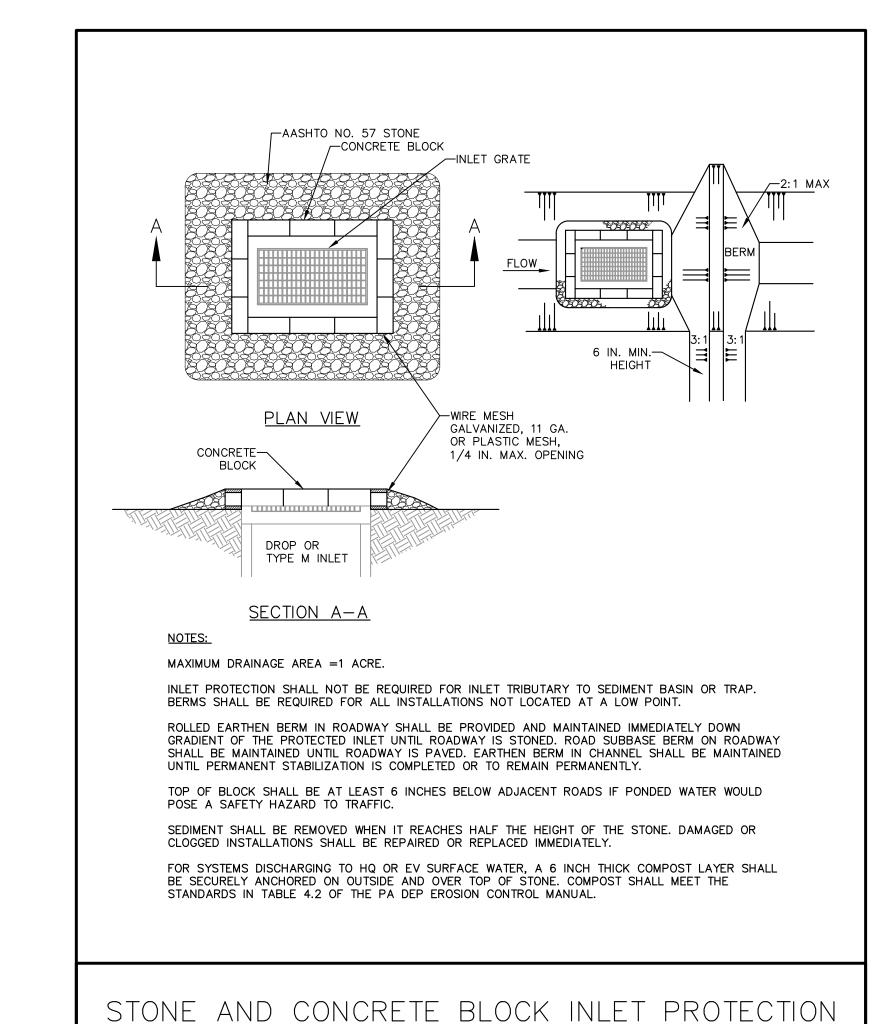

REVISIONS

PROJECT COORDINATOR

1515 Arch Street, 10th Floor

Philadelphia, PA 19102

PROJECT TEAM

Landscape Architect:

KS Engineers, P.C. 35 S 3rd St.

Philadelphia, PA 19102

Philadelphia, PA 19106

Arora Engineers, LLC 1600 Market St Suite 1630,

Philadelphia, PA 19103

Civil and Structural Engineer:

Ground Reconsidered

230 South Broad Street, Suite 604

215.790.0727 | www.groundreconsidered.com

215.925.0425 | http://www.kseng.com/

Plumbing, Electrical and Mechanical Engineer:

620.459.7900 | www.aroraengineers.com/

CITY OF PHILADELPHIA

PHILADELPHIA, PENNSYLVANIA

Erosion & Sediment

1515 ARCH STREET

DRAWING TITLE

PROJECT NO.

DATE: 02.07.2020 SCALE: 1" = 10'

DRAWN BY: TV

CHECKED BY: RB

PHILADELPHIA PARKS & RECREATION

11TH FLOOR, ONE PARKWAY BUILDING

East Poplar Playground

Pollution Control Details


NOTE: ALL DIMENSIONS AND CONDITIONS SHALL BE VERIFIED BY THE CONTRACTOR AT THE SITE BEFORE PROCEEDING WITH THE WORK.


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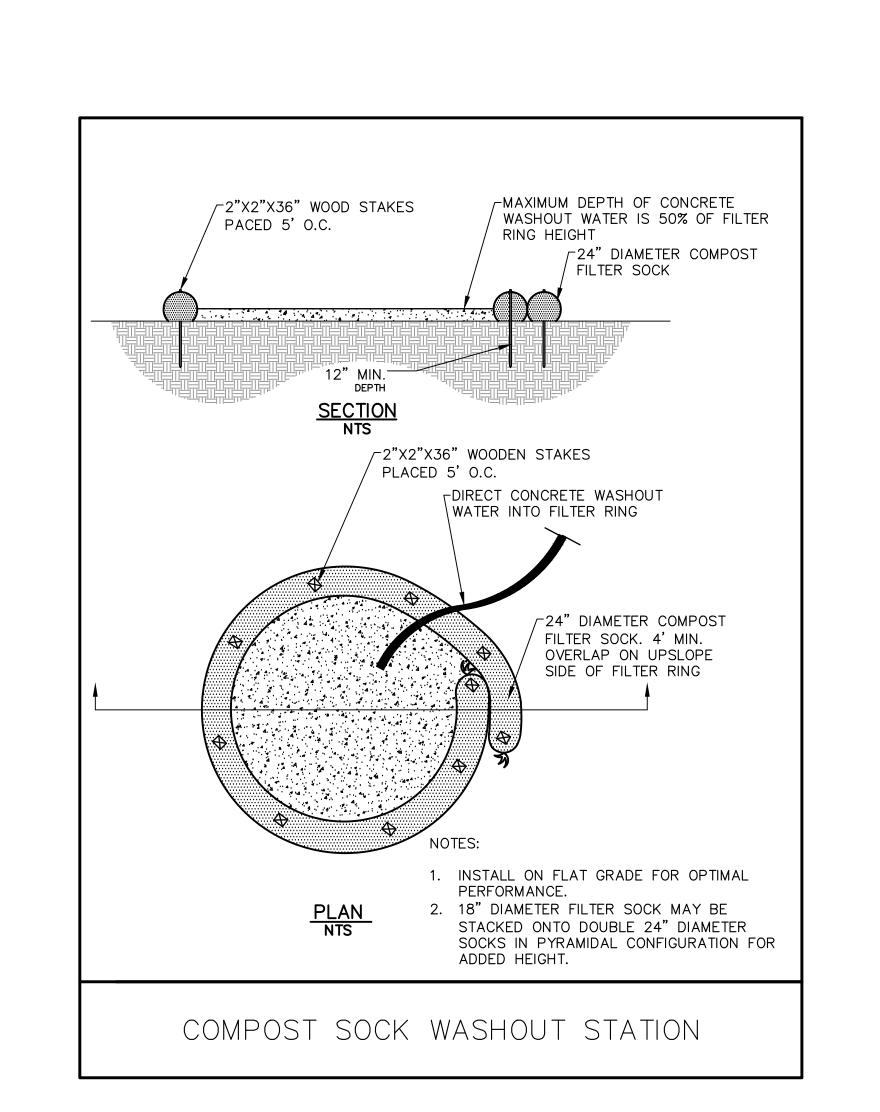
ES-2

Philadelphia Parks & Recreation

DESCRIPTION



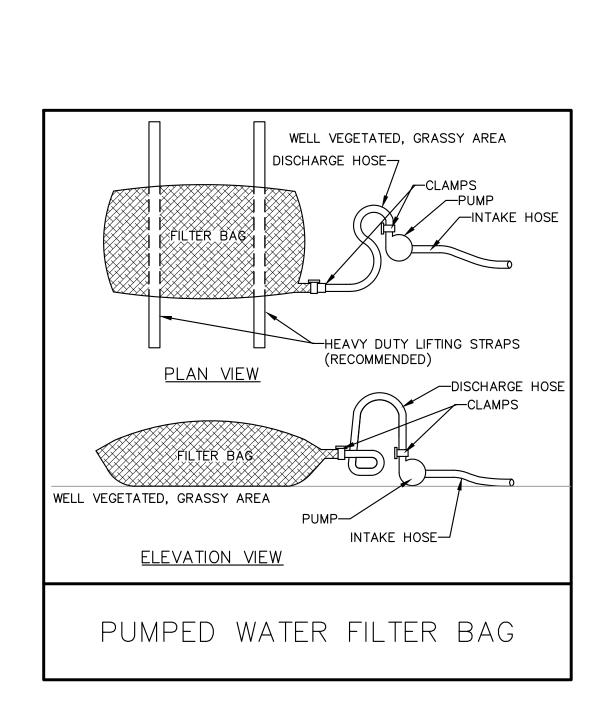

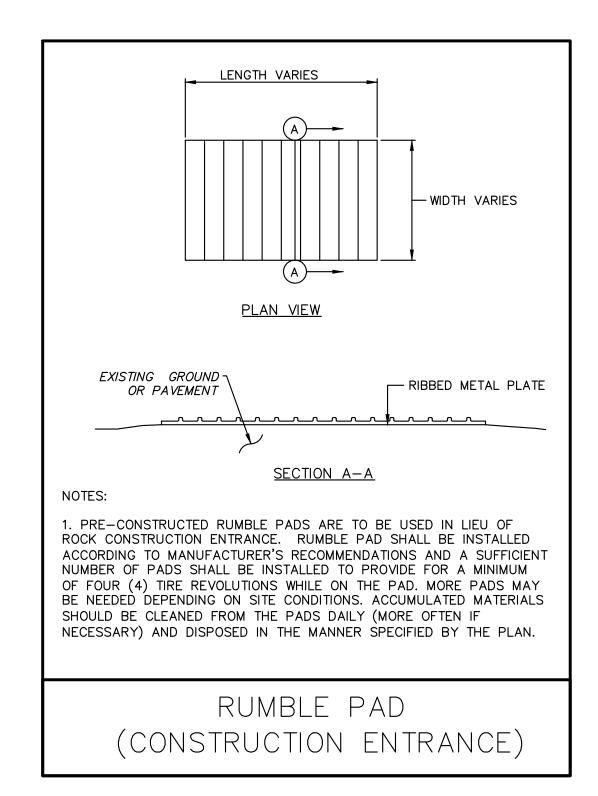

STANDARD EROSION AND SEDIMENT CONTROL NOTES:

- 1. AN INDUSTRIAL WASTE PERMIT WILL BE REQUIRED SHOULD PUMPING TO CITY-OWNED INFRASTRUCTURE BECOME NECESSARY DURING CONSTRUCTION. ALL PUMPING OF WATER FROM ANY WORK AREA SHALL BE DONE ACCORDING TO THE PROCEDURE DESCRIBED IN THIS PLAN, OVER UNDISTURBED VEGETATED AREAS.
- 2. INLET PROTECTION SHOULD BE PROVIDED FOR ALL INLETS OWNED BY PWD THAT ARE LOCATED WITHIN ONE BLOCK OF THE PROJECT SITE.
- 3. PWD IS NOT RESPONSIBLE FOR ANY CLEANING OR REPAIRS NEEDED ON CITY-OWNED INFRASTRUCTURE DUE TO FAILURE OF ANY EROSION AND SEDIMENT CONTROL PRACTICES. CONTRACTOR IS RESPONSIBLE TO CLEAN OR REPAIR CITY-OWNED INFRASTRUCTURE DUE TO FAILURE OF ANY EROSION AND SEDIMENT CONTROL PRACTICES.
- 4. INSPECTION AND MAINTENANCE OF ALL EROSION AND SEDIMENT CONTROL BEST MANAGEMENT PRACTICES SHALL OCCUR ON A WEEKLY BASIS, BEFORE ANY ANTICIPATED PRECIPITATION EVENTS, AND AFTER ALL PRECIPITATION EVENTS.
- 5. THE MAXIMUM HEIGHT FOR STOCKPILES AREAS SHALL BE 20 FEET. THE MAXIMUM SIDE SLOPE FOR STOCKPILE AREAS SHALL NOT EXCEED 2:1.
- 6. THE ROCK CONSTRUCTION ENTRANCE THICKNESS SHALL BE CONSTANTLY MAINTAINED ON—SITE. A STOCKPILE SHALL BE MAINTAINED ON—SITE FOR THIS PURPOSE. AT THE END OF EACH CONSTRUCTION DAY, ALL SEDIMENT DEPOSITED ON PAVED ROADWAYS SHALL BE REMOVED AND RETURNED TO THE CONSTRUCTION SITE. IN NO CASE SHALL THE SEDIMENT BE WASHED, SHOVELED, OR SWEPT INTO ANY ROADSIDE DITCH, STORM SEWER, OR SURFACE WATER.
- 7. FILTER FABRIC FENCE SHOULD BE INSTALLED AT LEVEL GRADE. BOTH ENDS OF EACH FENCE SECTION SHOULD BE EXTENDED AT LEAST 8 FEET UPSLOPE AT 45 DEGREES TO THE MAIN BARRIER ALIGNMENT. SUPPORT STAKES SHALL BE SPACED AT A MAXIMUM OF 8 FEET. SEDIMENT MUST BE REMOVED WHEN ACCUMULATIONS REACH 1/2 THE ABOVE GROUND HEIGHT OF THE FILTER FENCE.
- 8. ANY FENCE SECTION WHICH HAS BEEN UNDERMINED OR TOPPED MUST BE IMMEDIATELY REPLACED WITH A ROCK FILTER OUTLET. SEDIMENT MUST BE REMOVED WHEN ACCUMULATIONS REACH 1/3 THE HEIGHT OF THE OUTLET.
- 9. EROSION CONTROL BLANKETING SHALL BE INSTALLED ON ALL SLOPES 3H:1V OR STEEPER WITHIN 50 FEET OF A SURFACE WATER AND ON ALL OTHER DISTURBED AREAS SPECIFIED ON THE PLAN MAPS AND/OR DETAIL SHEETS.
- 10. IMMEDIATELY UPON DISCOVERING UNFORESEEN CIRCUMSTANCES POSING THE POTENTIAL FOR ACCELERATED EROSION AND/OR SEDIMENT POLLUTION, THE OPERATOR SHALL IMPLEMENT APPROPRIATE BEST MANAGEMENT PRACTICES TO MINIMIZE THE POTENTIAL FOR EROSION AND SEDIMENT POLLUTION AND NOTIFY PWD AND PA DEP.
- 11. UNTIL THE SITE IS STABILIZED, ALL E&S BMPS SHALL BE MAINTAINED PROPERLY. MAINTENANCE SHALL INCLUDE INSPECTIONS OF ALL E&S BMPS PRIOR TO ANY ANTICIPATED STORM EVENT, AFTER EACH RUNOFF EVENT AND ON A WEEKLY BASIS. ALL PREVENTATIVE AND REMEDIAL MAINTENANCE WORK, INCLUDING CLEAN OUT, REPAIR, REPLACEMENT, REGRADING, RESEEDING, REMULCHING, AND RENETTING, MUST BE PERFORMED IMMEDIATELY. IF THE E&S BMPS FAIL TO PERFORM AS EXPECTED, REPLACEMENT BMPS, OR MODIFICATIONS OF THOSE INSTALLED, WILL BE REQUIRED.
- 12. ALL EARTH DISTURBANCES, INCLUDING CLEARING AND GRUBBING, AS WELL AS CUTS AND FILLS, SHALL BE DONE IN ACCORDANCE WITH THE APPROVED E&S PLAN. A COPY OF THE APPROVED DRAWINGS MUST BE AVAILABLE AT THE PROJECT SITE AT ALL TIMES. PWD SHALL BE NOTIFIED OF ANY CHANGES TO THE APPROVED PLAN PRIOR TO IMPLEMENTATION OF THOSE CHANGES. PWD MAY REQUIRE A WRITTEN SUBMITTAL OF THOSE CHANGES FOR REVIEW AND APPROVAL AT ITS DISCRETION.
- 13. AT LEAST THREE (3) DAYS PRIOR TO STARTING ANY EARTH DISTURBANCE ACTIVITIES, OR EXPANDING INTO AN AREA PREVIOUSLY UNMARKED, THE PENNSYLVANIA ONE CALL SYSTEM INC. SHALL BE NOTIFIED AT 1-800-242-1776 FOR THE LOCATION OF EXISTING UNDERGROUND UTILITIES.
- 14. ALL EARTH DISTURBANCE ACTIVITIES SHALL PROCEED IN ACCORDANCE WITH THE SEQUENCE PROVIDED ON THE PLAN DRAWINGS. DEVIATION FROM THAT SEQUENCE MUST BE APPROVED IN WRITING BY PWD AND THE PA DEP PRIOR TO IMPLEMENTATION.
- 15. AREAS TO BE FILLED ARE TO BE CLEARED, GRUBBED, AND STRIPPED OF TOPSOIL TO REMOVE TREES, VEGETATION, ROOTS, AND OTHER OBJECTIONABLE MATERIAL.
- 16. CLEARING, GRUBBING, AND TOPSOIL STRIPPING SHALL BE LIMITED TO THOSE AREAS DESCRIBED IN EACH STAGE OF THE CONSTRUCTION SEQUENCE. GENERAL SITE CLEARING, GRUBBING, AND TOPSOIL STRIPPING MAY NOT COMMENCE IN ANY STAGE OF THE PROJECT UNTIL THE E&S BMPS SPECIFIED BY THE BMP SEQUENCE FOR THAT STAGE HAVE BEEN INSTALLED AND ARE FUNCTIONING AS DESCRIBED IN THIS E&S PLAN.
- 17. AT NO TIME SHALL CONSTRUCTION VEHICLES BE ALLOWED TO ENTER AREAS OUTSIDE THE LIMIT OF DISTURBANCE BOUNDARIES SHOWN ON THE PLAN MAPS. THESE AREAS MUST BE CLEARLY MARKED AND FENCED OFF BEFORE CLEARING AND GRUBBING OPERATIONS BEGIN.
- 18. A LOG SHOWING DATES THAT E&S BMPS WERE INSPECTED AS WELL AS ANY DEFICIENCIES FOUND AND THE DATE THEY WERE CORRECTED SHALL BE MAINTAINED ON THE SITE AND BE MADE AVAILABLE TO PWD AT THE TIME OF INSPECTION.
- 19. ALL SEDIMENT REMOVED FROM BMPS SHALL BE DISPOSED OF IN THE FOLLOWING MANNER: SEDIMENT IS TO BE DISPOSED OF OFF-SITE IN ACCORDANCE WITH ANY AND ALL CITY, STATE, AND FEDERAL REGULATIONS.
- 20. AREAS WHICH ARE TO BE TOPSOILED SHALL BE SCARIFIED TO A MINIMUM DEPTH OF THREE TO FIVE INCHES —— SIX TO 12 INCHES ON COMPACTED SOILS —— PRIOR TO PLACEMENT OF TOPSOIL. AREAS TO BE VEGETATED SHALL HAVE A MINIMUM FOUR INCHES OF TOPSOIL IN PLACE PRIOR TO SEEDING AND MULCHING. FILL OUTSLOPES SHALL HAVE A MINIMUM OF TWO INCHES OF TOPSOIL.
- 21. ALL FILLS SHALL BE COMPACTED AS REQUIRED TO REDUCE EROSION, SLIPPAGE, SETTLEMENT, SUBSIDENCE, OR OTHER RELATED PROBLEMS. FILL INTENDED TO SUPPORT BUILDINGS, STRUCTURES, AND CONDUITS, ETC. SHALL BE COMPACTED IN ACCORDANCE WITH LOCAL REQUIREMENTS OR CODES.
- 22. ALL EARTHEN FILLS SHALL BE PLACED IN COMPACTED LAYERS NOT TO EXCEED NINE INCHES IN THICKNESS.
- 23. FILL MATERIALS SHALL BE FREE OF FROZEN PARTICLES, BRUSH, ROOTS, SOD, OR OTHER FOREIGN OR OBJECTIONABLE MATERIALS THAT WOULD INTERFERE WITH OR PREVENT CONSTRUCTION OF SATISFACTORY FILLS.
- 24. FROZEN MATERIALS OR SOFT, MUCKY, OR HIGHLY COMPRESSIBLE MATERIALS SHALL NOT BE INCORPORATED INTO FILLS.
- 25. FILL SHALL NOT BE PLACED ON SATURATED OR FROZEN SURFACES.
- 26. SEEPS OR SPRINGS ENCOUNTERED DURING CONSTRUCTION SHALL BE HANDLED IN ACCORDANCE WITH THE STANDARD AND SPECIFICATION FOR SUBSURFACE DRAIN OR OTHER APPROVED METHOD.
- 27. ALL GRADED AREAS SHALL BE PERMANENTLY STABILIZED IMMEDIATELY UPON REACHING FINISHED GRADE. CUT SLOPES IN COMPETENT BEDROCK AND ROCK FILLS NEED NOT BE VEGETATED. SEEDED AREAS WITHIN 50 FEET OF A SURFACE WATER, OR AS OTHERWISE SHOWN ON THE PLAN DRAWINGS, SHALL BE BLANKETED ACCORDING TO THE STANDARDS OF THIS PLAN.

- 28. IMMEDIATELY AFTER EARTH DISTURBANCE ACTIVITIES CEASE IN ANY AREA OR SUBAREA OF THE PROJECT, THE OPERATOR SHALL STABILIZE ALL DISTURBED AREAS. DURING NON-GERMINATING MONTHS, MULCH OR PROTECTIVE BLANKETING SHALL BE APPLIED AS DESCRIBED IN THE PLAN. AREAS NOT AT FINISHED GRADE, WHICH WILL BE REACTIVATED WITHIN ONE YEAR, MAY BE STABILIZED IN ACCORDANCE WITH THE TEMPORARY STABILIZATION SPECIFICATIONS. THOSE AREAS WHICH WILL NOT BE REACTIVATED WITHIN ONE YEAR SHALL BE STABILIZED IN ACCORDANCE WITH THE PERMANENT STABILIZATION SPECIFICATIONS.
- 29. PERMANENT STABILIZATION IS DEFINED AS A MINIMUM UNIFORM, PERENNIAL 70% VEGETATIVE COVER OR OTHER PERMANENT NON-VEGETATIVE COVER WITH A DENSITY SUFFICIENT TO RESIST ACCELERATED EROSION. CUT AND FILL SLOPES SHALL BE CAPABLE OF RESISTING FAILURE DUE TO SLUMPING, SLIDING, OR OTHER MOVEMENTS.
- 30. E&S BMPS SHALL REMAIN FUNCTIONAL AS SUCH UNTIL ALL AREAS TRIBUTARY TO THEM ARE PERMANENTLY STABILIZED OR UNTIL THEY ARE REPLACED BY ANOTHER BMP APPROVED BY PWD AND PA DEP.
- 31. AFTER FINAL SITE STABILIZATION HAS BEEN ACHIEVED, TEMPORARY E&S BMPS MUST BE REMOVED OR CONVERTED TO PERMANENT POST—CONSTRUCTION STORMWATER MANAGEMENT PRACTICES. AREAS DISTURBED DURING REMOVAL OR CONVERSION OF THE E&S BMPS SHALL BE STABILIZED IMMEDIATELY. IN ORDER TO ENSURE RAPID REVEGETATION OF DISTURBED AREAS, SUCH REMOVAL/CONVERSIONS ARE TO BE DONE ONLY DURING THE GERMINATING SEASON.
- 32. ALL WORK ASSOCIATED WITH PWD WATER CONVEYANCE AND SEWER INFRASTRUCTURE SHALL BE DONE IN ACCORDANCE WITH THE CITY OF PHILADELPHIA WATER DEPARTMENT "WATER MAIN STANDARD DETAILS AND CORROSION CONTROL SPECIFICATIONS", 1985 EDITION, AND "STANDARD DETAILS AND STANDARD SPECIFICATIONS FOR SEWERS", 1985 EDITION.
- 33. CONTACT PWD WATER TRANSPORT RECORDS (1101 MARKET STREET, 2ND FLOOR, PHONE: 215-685-6271) FOR ADDITIONAL APPROVALS AND PERMITS REQUIRED FOR ALL WATER SERVICES, METERS, AND CONNECTIONS TO THE EXISTING AND/OR PROPOSED PWD FACILITIES.
- 34. ALL BUILDING MATERIALS AND WASTES SHALL BE REMOVED FROM THE SITE AND RECYCLED FROM THE SITE AND RECYCLED OR DISPOSED OF IN ACCORDANCE WITH THE PADEP'S SOLID WASTE MANAGEMENT REGULATIONS AT 25 PA CODE 260.1 ET SEQ., 271.1, AND 287.1 ET SEQ. NO BUILDING MATERIALS OR WASTES OR UNUSED BUILDING MATERIALS SHALL BE BURNED, BURIED, DUMPED, OR DISCHARGED AT THE SITE.

SITE STABILIZATION METHODS (TEMPORARY & PERMANENT STABILIZATION)

- 1. HAY OR STRAW MULCH MUST BE APPLIED AT 3.0 TONS PER ACRE.
- 2. MULCH WITH MULCH CONTROL NETTING OR EROSION CONTROL BLANKETS MUST BE INSTALLED ON ALL SLOPES GREATER THAN 3:1.
- 3. STRAW MULCH SHALL BE APPLIED IN LONG STRANDS, NOT CHOPPED OR FINELY BROKEN.

TEMPORARY SEEDING

- 1. THE FOLLOWING SURFACES OF THE SITE SHALL BE TEMPORARILY SEEDED AND
- A. THE SURFACE OF TOPSOIL STOCKPILES.
 B. THE SURFACE OF EXPOSED EARTH AREAS THAT WILL BE EXPOSED WITHOUT CONSTRUCTION ACTIVITY THEREON.
- 2. SEEDING SHALL OCCUR IMMEDIATELY AFTER ESTABLISHMENT OF THE TOPSOIL STOCKPILES OR ROUGH GRADED AREAS. THE FOLLOWING SHALL BE PLANTED: A. 40 LBS./ACRE ANNUAL RYE GRASS COMMON, 100% P.L.S.
- 3. PREPARE AREAS TO BE SEEDED AS FOLLOWS:
 A. REMOVE ALL DEBRIS, INCLUDING LARGE STONES. APPLY LIME AT A RATE OF 3
 TONS PER ACRE AND FERTILIZER AT THE RATE OF 50-50-50 PER ACRE AND
- WORK INTO SOIL.

 B. SOW SEED AT THE INDICATED RATE. DIVIDE SEED INTO TWO EQUAL LOTS. SOW ONE LOT IN ONE DIRECTION. SOW SECOND LOT AT RIGHT ANGLE TO FIRST. RAKE SEEDED AREA SLIGHTLY. ROLL SURFACE LIGHTLY TO FIRM SOIL AROUND SEED.
- 4. PLACE CLEAN DRY STRAW OR HAY MULCH WITHIN 48 HOURS AFTER SEEDING. PLACE AT THE RATE OF 3 TONS PER ACRE.
- 5. SEEDING DATES SHALL BE BETWEEN MARCH 1 AND NOVEMBER 15.

TEMPORARY MULCHING

- 1. MULCH PROPOSED LANDSCAPE AREAS OR TOPSOIL STOCKPILES IF EARTHWORK IS COMPLETED OUTSIDE OF THE RECOMMENDED PLANTING SEASONS FOR TEMPORARY SEEDING OR DUE TO UNFAVORABLE WEATHER CONDITIONS.
- 2. MULCH SHALL BE APPLIED IMMEDIATELY FOLLOWING THE ESTABLISHMENT OF THE TOPSOIL STOCKPILE OR ROUGH GRADING.
- 3. MULCH WITH SUITABLE FIBROUS GROUND, SHREDDED AGED HARDWOOD, PINE WOOD BARK OR STRAW, UNIFORMLY AND CONTINUOUSLY TO A LOOSE DEPTH OF 3 INCHES MINIMUM. ANCHOR AS REQUIRED.
- 4. PROPERLY MAINTAIN MULCHED AREAS UNTIL PERMANENT STABILIZATION MEASURES ARE COMPLETE. REAPPLY MULCH MATERIALS WHICH BECOME DISLODGED AS INITIAL OR MODIFIED RATES AS NECESSARY. IF A SLOPE FAILURE OCCURS WHICH REQUIRES REDRESSING, EXCAVATION, OR THE ESTABLISHMENT OF A NEW SLOPE, REPLACE MULCH AS NECESSARY.

PERMANENT SEEDING

- 1. PERMANENT SEEDING SHALL OCCUR IMMEDIATELY AFTER THE FINAL GRADING IS COMPLETED. THE FOLLOWING SEED SHALL BE PLACED UNLESS OTHERWISE SPECIFIED ON THE PLANS OR DIRECTED IN THE FIELD.

 THE FOLLOWING SEED MIX SHALL BE USED:
- A. 40% PENNLAWN FINE FESCUE B. 3% RED TOP
- C. 20% CHAMPION PERENNIAL RYE GRASS QUANTITIES ARE OF PURE LIVE SEED (P.L.S.) SPREAD AT A RATE OF 63 LBS. PER ACRE.
- 2. REMOVE ALL DEBRIS, INCLUDING LARGE STONES. TILL SOIL TO A DEPTH OF FOUR INCHES TO SIX INCHES. APPLY LIME AT A RATE OF 4 TONS PER ACRE. APPLY COMMERCIAL 10-20-20 FERTILIZER AT A RATE OF 930 LBS. PER ACRE. WORK FERTILIZER INTO TOP INCH OF SOIL.
- 3. SEED ONLY AT THE FOLLOWING TIMES: A. SPRING: MARCH 1 TO APRIL 30
- B. LATE SUMMER/EARLY FALL: AUGUST 15 TO NOVEMBER 15
- 4. DIVIDE SEED INTO TWO EQUAL LOTS. SOW ONE LOT IN ONE DIRECTION. SOW SECOND LOT AT RIGHT ANGLE TO FIRST LOT. RAKE SEEDED AREA SLIGHTLY. ROLL SURFACE LIGHTLY TO FIRM SOIL AROUND SEED.
- 5. MULCH SEEDED AREAS WITH STRAW OR HAY AT THE RATE OF 3 TONS PER ACRE. ANCHOR MULCH. COMPLY WITH THE REQUIREMENTS OF SECTION 805 MULCHING, PENNDOT PUBLICATION 408. ANCHOR MULCH AS SPECIFIED.

- 6. MULCHING SHALL BE DONE AT THE MINIMUM RATE OF 3 TONS PER ACRE WITH SALT HAY, HAY OR STRAW MULCHES. PLACE MULCH IMMEDIATELY AFTER SEEDING OR WITHIN 48 HOURS AFTER SEEDING IS COMPLETED. PROPERLY MAINTAIN MULCHED AREAS UNTIL THE ENTIRE PROJECT HAS BEEN COMPLETED. PROMPTLY REAPPLY MULCH MATERIALS WHICH BECOME DISLODGED OR LOST DUE TO WIND, RAIN, OR OTHER CAUSES AT INITIAL RATES OR AS DIRECTED.
- 7. LIQUID MULCH BINDERS MAY BE USED TO ANCHOR SALT HAY, HAY OR STRAW MULCHES.
- A. APPLICATIONS SHOULD BE HEAVIER AT EDGES WHERE WIND CATCHES THE MULCH IN VALLEYS AND AT CRESTS OF BANKS. REMAINDER OF AREAS SHOULD BE UNIFORM IN APPEARANCE.

 B. USE ONE OF THE FOLLOWING: EMULSIFIED ASPHALT. CLASS E-1 OR E-6. APPLY
- 31 GALLONS PER 1,000 SQUARE YARDS ON SLOPES LESS THAN 8 FEET HIGH.
 ON SLOPES 8 FEET HIGH OR MORE, USE 58 GALLONS PER 1,000 SQUARE YARDS.
 CUTBACK ASPHALT. CLASS RC-250. APPLY 31 GALLONS PER 1,000 SQUARE
 YARDS ON FLAT AREAS AND ON SLOPES LESS THAN 8 FEET HIGH. ON SLOPES
 8 FEET HIGH OR MORE, USE 58 GALLONS PER 1,000 SQUARE YARDS.
 NON-ASPHALTIC EMULSION NATURAL VEGETABLE GUM BLENDED WITH GELLING
 AND HARDENING AGENTS (TERRA TACK, AR) AS MANUFACTURED BY GRASS
 GROWERS COMPANY OR EQUAL. APPLY 25 LBS. PER 1,000 SQUARE YARDS.

MAINTENANCE PROGRAM

- 1. THE CONTRACTOR WILL BE RESPONSIBLE FOR THE PROPER CONSTRUCTION STABILIZATION, AND MAINTENANCE OF ALL TEMPORARY EROSION AND SEDIMENTATION CONTROL MEASURES AND RELATED ITEMS INCLUDED WITHIN THIS PLAN. THE CONTRACTOR WILL ALSO BE RESPONSIBLE FOR THE PROPER CONSTRUCTION AND STABILIZATION OF PERMANENT CONTROL MEASURES AND RELATED ITEMS INCLUDED WITHIN THIS PLAN.
- 2. THE OWNER WILL BE RESPONSIBLE FOR THE MAINTENANCE OF ALL PERMANENT CONTROL MEASURES.
- 3. UNTIL THE SITE IS STABILIZED, ALL EROSION AND SEDIMENT BMP'S MUST BE MAINTAINED PROPERLY. MAINTENANCE MUST INCLUDE INSPECTIONS OF ALL EROSION AND SEDIMENT CONTROL BMP'S AFTER EACH RUNOFF EVENT AND ON A WEEKLY BASIS. ALL PREVENTATIVE AND REMEDIAL MAINTENANCE WORK, INCLUDING CLEAN OUT, REPAIR, REPLACEMENT, REGRADING, RESEEDING, REMULCHING, AND RENETTING, MUST BE DONE IMMEDIATELY. IF EROSION AND SEDIMENT CONTROL BMP'S FAIL TO PERFORM AS EXPECTED, REPLACEMENT BMP'S, OR MODIFICATIONS TO THOSE INSTALLED WILL BE REQUIRED.
- 4. SEDIMENT REMOVED FROM BMP'S SHALL BE DISPOSED OF IN LANDSCAPE AREAS OUTSIDE OF STEEP SLOPES, WETLANDS, FLOOD PLAINS OR DRAINAGE SWALES AND IMMEDIATELY STABILIZED, OR PLACED IN TOPSOIL STOCKPILES.
- 5. SOIL SEDIMENT REMOVED FROM ANY TEMPORARY CONTROL MEASURE DURING REGULAR MAINTENANCE WILL BE INCORPORATED BACK INTO THE EARTHWORK AS FILL ON THE SITE. SOIL SEDIMENT MATERIAL SHALL BE DISTRIBUTED ON—SITE WITHOUT CHANGING DRAINAGE PATTERNS DURING A SPECIFIC CONSTRUCTION STAGE. SILT FENCE INSTALLED ON THE PROJECT SITE SHALL BE MAINTAINED AS FOLLOWS:

 A. THE FENCE CONDITION WILL BE INSPECTED ONCE A WEEK OR AFTER EVERY STORM EVENT, WHICHEVER COMES FIRST. ANY NECESSARY REPAIRS WILL BE MADE
- IMMEDIATELY.
 B. ACCUMULATED SEDIMENTS WILL BE REMOVED AS REQUIRED TO KEEP THE FENCE FUNCTIONAL. DEPOSITS WILL BE REMOVED WHERE ACCUMULATIONS REACH ONE—HALF THE ABOVE—GROUND HEIGHT OF THE FENCE.
- C. UNDERCUTTING OR EROSION OF THE TOE ANCHOR WILL BE REPLACED IMMEDIATELY WITH ROCK FILTER OUTLETS.
- D. ANY MANUFACTURER'S RECOMMENDATIONS WILL BE ADHERED TO WHEN REPLACING FILTER FABRIC FENCE DUE TO WEATHERING.
- 6. AT THE END OF EACH CONSTRUCTION DAY, ANY SEDIMENT DEPOSITED ON PUBLIC ROADWAYS, WILL BE REMOVED AND RETURNED TO THE CONSTRUCTION SITE. WASHING OF THE ROADWAY WITH WATER WILL NOT BE PERMITTED.

7. OTHER BMP'S

A. SEDIMENT MUST BE REMOVED FROM STORM WATER INLET PROTECTION AFTER EACH RUNOFF EVENT.

CONSTRUCTION SEQUENCE:

- 1. AT LEAST SEVEN (7) DAYS PRIOR TO STARTING ANY EARTH DISTURBANCE ACTIVITIES, THE INSPECTIONS COORDINATOR OF PWD (OFFICE: 215-685-6387) MUST BE CALLED TO SCHEDULE A PRECONSTRUCTION MEETING. THE OPERATOR SHALL INVITE ALL CONTRACTORS INVOLVED IN EARTH MOVING ACTIVITIES, THE LANDOWNER, ALL APPROPRIATE CITY OFFICIALS, THE EROSION AND SEDIMENT CONTROL PREPARER, AND REPRESENTATIVE OF THE CITY OF PHILADELPHIA EROSION AND SEDIMENT CONTROL OFFICE TO AN ON-SITE MEETING.
- 2. AT LEAST 3 DAYS BEFORE STARTING ANY EARTH DISTURBANCE ACTIVITIES, ALL CONTRACTORS INVOLVED IN THOSE ACTIVITIES SHALL NOTIFY THE PENNSYLVANIA ONE CALL SYSTEM INCORPORATED AT 1-800-242-1776 FOR BURIED UTILITY LOCATIONS.
- 3. CONSTRUCTION FENCE TO BE INSTALLED AT THE DISCRETION OF THE SITE CONTRACTOR/CONSTRUCTION MANAGER. CONSTRUCTION FENCE LOCATION SHALL BE INSTALLED TO PROTECT THE PUBLIC FROM LAND DISTURBANCE ACTIVITIES AND TO MAINTAIN PEDESTRIAN ACCESS.
- 4. INSTALL COMPOST FILTER SOCK DOWNHILL FROM ALL EARTH MOVING ACTIVITIES.
 ALTHOUGH OFF—SITE AREAS ARE PAVED, COMPOST FILTER SOCK OR OTHER EROSION
 CONTROL PRACTICES SHALL BE INSTALLED AROUND THE PERIMETER OF THE SITE AS
 SHOWN ON THE PLAN.
- 5. INSTALL INLET PROTECTION AS SHOWN ON THE PLAN. EXISTING INLETS SHALL BE PROTECTED THROUGHOUT THE DURATION OF THE CONSTRUCTION.
- 6. PLACE TREE PROTECTION FENCE AROUND TREES WITHIN THE LIMIT OF DISTURBANCE THAT ARE TO REMAIN AS SHOWN ON THE PLANS.
- 7. INSTALL RUMBLE PAD AS SHOWN ON THE PLAN AND IN ACCORDANCE WITH THE DETAIL.
- 8. CLEAR AND GRUB THE SITE, DEMOLISH EXISTING PAVING, CURBING, AND FENCING AS REQUIRED. REMOVE TREES AND STUMPS MARKED FOR REMOVAL TO BELOW EXISTING GRADE. EXCAVATE TRENCHES FOR PROPOSED PIPE CONNECTIONS. DEMOLISHED MATERIAL SHALL BE REMOVED FROM THE SITE AND DISCARDED IN ACCORDANCE WITH APPLICABLE CITY, STATE AND FEDERAL REGULATIONS.
- 9. REMOVE DRAINS, CLEANOUTS, AND PIPE FOR EXISTING SPRAYGROUND AS SHOWN ON THE PLAN. CAP THE PIPE AT THE DOWNSTREAM CONNECTION TO THE SEWER LATERAL AS SHOWN ON THE PLAN.
- 10. INSTALL PROPOSED INLETS/AREA DRAINS AND STORM SEWERS AS SHOWN ON THE PLAN. PLACE INLET PROTECTION AS THE INLETS/AREA DRAINS BECOME FUNCTIONAL.
- 11. INSTALL WATER SUPPLY LINE FOR PROPOSED SPRAYGROUND AS SHOWN ON THE PLANS.
- 12. INSTALL LIGHT POLES AS SHOWN ON THE PLANS. INSTALL ELECTRICAL CONDUIT NECESSARY FOR PROPOSED LIGHTING FIXTURES AS SHOWN ON THE PLANS.
- 13. CONSTRUCT PROPOSED CURBS AND WALLS AS SHOWN ON THE PLANS.
- 14. INSTALL FOOTINGS AND FOUNDATIONS FOR PLAYGROUND, SPRAYGROUND, AND EXERCISE EQUIPMENT IN ACCORDANCE WITH MANUFACTURER'S REQUIREMENTS.
- 15. ROUGH GRADE SUBBASE TO REQUIRED DEPTHS FOR PROPOSED SURFACE TREATMENTS.
- 16. AS SOON AS SLOPES, CHANNELS, DITCHES, AND OTHER DISTURBED AREAS REACH FINAL GRADE, THEY MUST BE STABILIZED. CESSATION OF ACTIVITY FOR FOUR (4) DAYS OR LONGER REQUIRES TEMPORARY STABILIZATION.
- 17. CONSTRUCT ASPHALT PAVEMENT, CONCRETE PAVEMENT, AND BONDED RUBBER SAFETY SURFACE.
- 18. INSTALL SITE FURNISHINGS.
- 19. INSTALL TOPSOIL IN GRASS AND PLANTING AREAS AS SHOWN ON THE PLANS. SEED GRASS COVER AREAS AND PLACE STRAW, AS APPLICABLE. INSTALL PLANTINGS IN ACCORDANCE WITH THE PLAN AND PLACE MULCH, AS APPLICABLE.
- 20. SWEEP PAVED AREAS TO PREVENT TRACKING OF SOIL OFF-SITE.
- 21. UPON COMPLETION OF ALL EARTH DISTURBANCE ACTIVITIES AND PERMANENT STABILIZATION OF ALL DISTURBED AREAS, THE OWNER AND/OR OPERATOR SHALL CONTACT INSPECTIONS COORDINATOR OF PWD (OFFICE: 215-685-6387) FOR A FINAL INSPECTION PRIOR TO REMOVAL OF THE E&SC BMPS.
- 22. REMOVE SOIL EROSION MEASURES AFTER SITE HAS BEEN INSPECTED AND STABILIZED.

DESCRIPTION

PROJECT COORDINATOR

Philadelphia Parks & Recreation 1515 Arch Street, 10th Floor Philadelphia, PA 19102

AL		

REVISIONS

PROJECT TEAM

Landscape Architect:
Ground Reconsidered
230 South Broad Street, Suite 604
Philadelphia, PA 19102
215.790.0727 | www.groundreconsidered.com

Civil and Structural Engineer: KS Engineers, P.C. 35 S 3rd St. Philadelphia, PA 19106 215.925.0425 | http://www.kseng.com/

Plumbing,Electrical and Mechanical Engineer: Arora Engineers, LLC 1600 Market St Suite 1630, Philadelphia, PA 19103 620.459.7900 | www.aroraengineers.com/

CITY OF PHILADELPHIA
PHILADELPHIA PARKS & RECREATION
1515 ARCH STREET

PROJECT TITLE

East Poplar Playground

PHILADELPHIA, PENNSYLVANIA

11TH FLOOR, ONE PARKWAY BUILDING

DRAWING TITLE

PROJECT NO.

Erosion & Sediment Pollution Control Notes

DATE: 02.07.2020

SCALE: 1" = 10'

DRAWN BY: TV

DRAWING NO.

CHECKED BY: RB

FILE:

NOTE: ALL DIMENSIONS AND CONDITIONS SHALL BE
VERIFIED BY THE CONTRACTOR AT THE SITE
BEFORE PROCEEDING WITH THE WORK.

ELECTRICAL ABBREVIATIONS:

A, AMP **AMPERES** ALTERNATING CURRENT AFCI ARC FAULT CIRCUIT INTERRUPTER AFF ABOVE FINISHED FLOOR AFG ABOVE FINISHED GRADE AHU AIR HANDLING UNIT AIC AMP INTERRUPTING CAPACITY ΑT AMP TRIP ΑF AMP FRAME ATC AUTOMATIC TEMPERATURE CONTROL ATS **AUTOMATIC TRANSFER SWITCH** AWG AMERICAN WIRE GAUGE BKR BREAKER C, CND CONDUIT C.B. CIRCUIT BREAKER CKT CIRCUIT CLG CEILING, EQUIPMENT MOUNTED EITHER ON OR IN CEILING AREA CU COPPER (D) DEMOLITION DC DIRECT CURRENT DWG DRAWING (E) EXISTING WORK/EQUIPMENT TO REMAIN (ER) EXISTING WORK/EQUIPMENT TO BE REMOVED AND RELOCATED EC **ELECTRICAL CONTRACTOR ELEC** ELECTRICAL **EQUIP EQUIPMENT** EMH **ELECTRICAL MANHOLE** EMT **ELECTRICAL METALLIC TUBING** EUH ELECTRIC UNIT HEATER FT FOOT (FEET) G, GND GROUND GFCI, GFI **GROUND FAULT CIRCUIT INTERRUPTER** HΖ HERTZ JB JUNCTION BOX KA KILO AMPERES KAIC KILO AMPERES INTERRUPTING CURRENT KVA KILO VOLTS AMPERES KW **KILOWATTS** LIQUID TIGHT FLEXIBLE METAL CONDUIT MC MECHANICAL CONTRACTOR MCB MAIN CIRCUIT BREAKER MCA MAXIMUM CIRCUIT AMPACITY MIN MINIMUM MISC MISCELLANEOUS MLO MAIN LUG ONLY MOCP MAXIMUM OVER CURRENT PROTECTION MOCD MAXIMUM OVER CURRENT PROTECTIVE DEVICE (N) NEW NEC NATIONAL ELECTRIC CODE NIC NOT IN CONTRACT NTS NOT TO SCALE POLE PH, Ø PHASE PNL PANEL **PWR POWER** (RE) RELOCATE EXISTING RCP REFLECTED CEILING PLAN RCPT RECEPTACLE RGS RIGID GALVANIZED STEEL RGM RIGID METAL CONDUIT RNC RIGID NON-METALLIC CONDUIT SCCR SHORT CIRCUIT CURRENT RATING SMR SURFACE METAL RACEWAY **SPECS SPECIFICATIONS** TBD TO BE DETERMINED TVSS TRANSIENT VOLTAGE SURGE SUPPRESSION TYP. TYPICAL UE UNDERGROUND ELECTRIC UH UNIT HEATER

UNLESS OTHERWISE NOTED

VOLTS

VERIFY IN FIELD

WEATHER PROOF

TRANSFORMER

UON

V

VIF

WP

XFMR

ELECTRICAL SYMBOLS:

DUPLEX RECEPTACLE, NEMA 5-20R, 20A, 125V DUPLEX RECEPTACLE, NEMA 5-20R, 20A, 125V ⇒ GFI , WITH (GFCI) GROUND FAULT CURRENT INTERRUPTER PROTECTION 20A, 120/277 VAC, SINGLE POLE TOGGLE SWITCH WEATHER PROOF SWITCH NON-FUSIBLE DISCONNECT SWITCH, SIZE AS NOTED

J JUNCTION BOX

ELECTRICAL HANDHOLE 18" L x 24" W x 12" D. TIER 15 RATED PRECAST CONCRETE

COMBINATION MAGNETIC STARTER, SIZE AS

FUSIBLE DISCONNECT SWITCH, SIZE AS NOTED

CONDUIT (UNDERGROUND)

DEMOLITION

REQUIRED BY NEC


PANELBOARD

EXISTING/BY OTHERS/FOR REFERENCE ONLY

GENERAL ELECTRICAL NOTES:

- 1. ALL WORK SHALL BE IN ACCORDANCE WITH ALL APPLICABLE LAWS, CODES, AND REGULATIONS ADOPTED BY MUNICIPAL, COUNTY, STATE, AND FEDERAL AUTHORITIES, INCLUDING THE LATEST ADOPTED EDITION OF THE NATIONAL ELECTRICAL CODE (NEC 2017) NFPA 70, AND WITH THE REQUIREMENTS/AMENDMENTS OF THE LOCAL AUTHORITY HAVING JURISDICTION (AHJ).
- 2. CONTRACT DRAWINGS ARE DIAGRAMMATIC IN NATURE AND ARE INTENDED TO CONVEY SCOPE, DESIGN INTENT, AND GENERAL ARRANGEMENT ONLY. CONTRACTOR IS RESPONSIBLE FOR COORDINATING ALL WORK INCLUDING RESOLUTION OF FIELD CONFLICTS THAT MAY ARISE
- 3. EACH FEEDER AND BRANCH CIRCUIT SHALL INCLUDE AN INSULATED EQUIPMENT GROUNDING CONDUCTOR. BOND ALL ELECTRICAL EQUIPMENT, OUTLET BOXES, ETC., IN ACCORDANCE WITH NEC ARTICLE 250.
- 4. ALL FEEDERS AND BRANCH CIRCUITS ARE NEW TO BE PROVIDED UNDER THIS CONTRACT UNLESS OTHERWISE NOTED. WIRING SHALL BE INSTALLED IN RNC (PVC SCHEDULE 40) UNLESS OTHERWISE SHOWN.
- 5. ALL NEW 600V OVER-CURRENT PROTECTIVE DEVICES SHALL HAVE INTERRUPTING CAPABILITIES OR RATINGS (AIC OR AIR) IN RMS AMPERES SYMMETRICAL. ALL DEVICES SHALL BE FULLY RATED FOR AVAILABLE FAULT CURRENT.
- ALL WIRE SHALL BE COLOR-CODED, SINGLE CONDUCTOR, COPPER WIRE OF THE SPECIFIED SIZE, 600V, TYPE USE, XLP INSULATION, #12 AWG MINIMUM.
- 7. THE CONTRACTOR SHALL PERFORM THE WORK AS INDICATED ON THE DRAWINGS. ANY DEVIATIONS FROM THE DRAWINGS SHALL BE SUBMITTED TO THE ENGINEER FOR REVIEW AND APPROVAL IN WRITING. IF CHANGES ARE MADE WITHOUT THE ENGINEER'S WRITTEN CONSENT, THE CONTRACTOR SHALL BE LIABLE FOR ANY ISSUES THAT MAY ARISE DUE TO THE CHANGES.
- UNLESS OTHERWISE NOTED, ALL WIRE SIZES SHALL BE BASED ON THE FOLLOWING:
 - a. #12 THROUGH #1 OR 100A OR LESS TABLE 310.16 60° COLUMN
 - b. #1/0 AND GREATER OR 101A OR GREATER TABLE 310.16 75° COLUMN
 - c. OTHER ALLOWANCES OF 110.14(C)
- 9. UNLESS OTHERWISE NOTED, ALL CONDUIT SIZES SHALL BE BASED ON RNC (PVC SCHEDULE 40).
- 10. ALL ELECTRICAL MATERIALS, DEVICES, APPLIANCES AND EQUIPMENT SHALL BE NEW, LABELED AND LISTED BY A NATIONALLY RECOGNIZED TESTING LABORATORY OR AGENCY (E.G. UL), UNLESS OTHERWISE NOTED.
- 11. ELECTRICAL CONTRACTOR SHALL FOLLOW ALL MANUFACTURER'S INSTRUCTIONS FOR INSTALLATION OF ALL EQUIPMENT IF NOT INDICATED ON DRAWINGS. IF THERE IS A DISCREPANCY, MANUFACTURER'S INSTRUCTIONS TAKE PRECEDENCE.
- 12. THE EC SHALL FURNISH ALL EQUIPMENT, LABOR, SERVICES, AND MATERIALS REQUIRED FOR COMPLETE INSTALLATION OF THE WORK INDICATED. UNLESS OTHERWISE NOTED. ALL MATERIALS SHALL BE NEW.
- 13. ALL WIRING, EQUIPMENT, AND CONTROLS SHALL CONFORM TO THE NATIONAL ELECTRIC CODE AND TO THE REQUIREMENTS OF THE LOCAL UTILITY COMPANY.
- 14. ALL WIRING METHODS SHALL BE NEC COMPLIANT AND MEET THE REQUIREMENTS OF THE SPACE, OCCUPANCY & CONDITION OF USE.
- 15. CONTRACTOR SHALL FIELD VERIFY THE EXISTING CONDITIONS AND REPORT ANY DISCREPANCIES TO THE ENGINEER FOR CORRECTION, EDITING, RECALCULATION, ETC. AS REQUIRED.
- 16. DO NOT SCALE DRAWINGS. CONTRACTOR SHALL VERIFY AND CONFIRM ALL DIMENSIONS IN THE FIELD AND NOTIFY THE ENGINEER OF ANY AND ALL DISCREPANCIES ON THE DRAWINGS. COPIES OF THIS DRAWING WITHOUT A PROFESSIONAL ENGINEER'S SEAL AND ORIGINAL SIGNATURE SHALL NOT BE CONSIDERED VALID AND ARE FOR CONVENIENCE TO THE USER AT THEIR OWN RISK.
- 17. CALL BEFORE YOU DIG (PA ONE CALL SYSTEM 1-800-242-1776 OR DIAL 811). EC TO HIRE AN INDEPENDENT UTILITY LOCATING COMPANY TO MARK-OUT CUSTOMER OWNED/PRIVATE PROPERTY FACILITIES BEFORE DIGGING AT EC'S EXPENSE
- 18. CONTRACTOR TO PLACE NEW EQUIPMENT AS REQUIRED TO COMPLY WITH WORKING CLEARANCE ISSUES, DEDICATED SPACE ISSUES, AND WITH APPLICABLE CODES
- 19. FURNISH ALL NECESSARY MATERIALS, TOOLS AND LABOR AND INSTALL A COMPLETE AND FULLY OPERABLE WIRING SYSTEM AS INDICATED OR REASONABLY IMPLIED. UNLESS NOTED OTHERWISE, ALL MATERIALS SHALL BE NEW, FREE OF DEFECTS AND BE UL LISTED.
- 20. THE EC IS RESPONSIBLE FOR THE CONSTRUCTABILITY OF THE DRAWINGS FROM A PRACTICAL AND EXISTING FIELD CONDITIONS PERSPECTIVE.

- 21. WITH RESPECT TO CONSTRUCTION BASED ON THESE DRAWINGS, THE EC IS ULTIMATELY RESPONSIBLE FOR ALL INSTALLED MEANS AND METHODS MEETING ALL APPLICABLE CODES AND STANDARDS.
- 22. ALL ELECTRICAL EQUIPMENT THAT IS LIKELY TO REQUIRE EXAMINATION, ADJUSTMENT, SERVICING, OR MAINTENANCE WHILE ENERGIZED SHALL BE FIELD MARKED PER NEC 110.16.
- 23. THE EC SHALL VISIT SITE AND BECOME FAMILIAR WITH ALL EXISTING CONDITIONS THAT MAY EFFECT HIS WORK. THE EC SHALL NOT BE ENTITLED TO CHANGE ORDER(S) DUE TO FAILURE TO COMPLY.
- 24. CONTRACTOR SHALL SUBMIT SHOP DRAWINGS ON ALL EQUIPMENT AND MATERIAL (AND METHODS WHEN SPECIFICALLY REQUESTED) BEING USED IN THE COURSE OF THE WORK. A MINIMUM OF TWO (2) COPIES AND PDF, AND/OR AS REQUESTED BY OWNER SHALL BE SUBMITTED FOR REVIEW. PURCHASE OF OR INSTALLATION OF MATERIALS OR SYSTEM PARTS SHALL NOT PROCEED UNTIL REVIEWED SHOP DRAWINGS/CATALOG CUTS ARE RETURNED TO THE SUBMITTING CONTRACTOR. ACCESSORIES SCHEDULED SHALL BE PROVIDED BY THE UNIT MANUFACTURER OR, IF NOT A FACTORY STANDARD. BY THE CONTRACTOR.
- 25. ALL WORK SHALL BE SCHEDULED AND COORDINATED WITH THE OWNER SO THAT DISRUPTION TO THE AREAS INVOLVED OR OTHER PARTS OF THE PARK ARE KEPT TO A MINIMUM. CONTRACTOR SHALL GIVE OWNER A MINIMUM OF FIVE (5) WORKING DAYS NOTICE OF ANY AND ALL WORK THAT WILL INTERFERE WITH OWNER'S OPERATIONS SO A SCHEDULE SUITABLE TO THE OWNER CAN BE ARRANGED.
- 26. PRIOR TO ACCEPTANCE, ALL SYSTEMS SHALL BE TESTED, BALANCED AND OPERATED TO DEMONSTRATE TO THE OWNER THAT THE INSTALLATION AND PERFORMANCE OF THE INSTALLED SYSTEMS AND/OR PARTS THEREOF CONFORM TO THE DESIGN INTENT.
- 27. UPON COMPLETION OF THE CONTRACT, THE CONTRACTOR SHALL PROVIDE THE OWNER WITH THREE (3) COMPLETE SETS OF MANUFACTURERS' OPERATING, MAINTENANCE AND PREVENTIVE MAINTENANCE INSTRUCTIONS (IN BOUND BOOK FORM AND PDF) INCLUDING PARTS LIST, AND COMPLETE PROCUREMENT INFORMATION SPECIFYING EQUIPMENT NUMBERS AND DESCRIPTIONS. OPERATING STAFF PERSONNEL SHALL BE INSTRUCTED AS TO PROPER OPERATING AND SERVICE REQUIREMENTS OF THE SYSTEMS AND EQUIPMENT.
- 28. CONTRACTOR SHALL UPON COMPLETION OF THE WORK, SUBMIT A SET OF RECORD DRAWINGS SHOWING ALL BURIED OR CONCEALED EQUIPMENT OF PARTS OF THE WORK
- 29. UPON COMPLETION OF ALL WORK, THOROUGHLY CLEAN ALL SYSTEMS OF OBSTRUCTIONS, DEBRIS, SCALE, DUST, DIRT, ETC. AND PLACE SYSTEMS IN OPERATION.
- 30. THE CONTRACTOR SHALL APPLY FOR AND PAY FOR ALL REQUIRED PERMITS, INSPECTIONS, ETC.

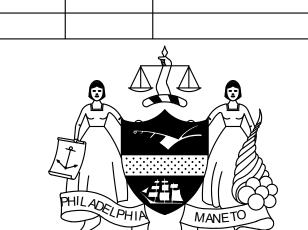


DESCRIPTION

PROJECT COORDINATOR

Philadelphia Parks & Recreation 1515 Arch Street, 10th Floor Philadelphia, PA 19102

REVISIONS

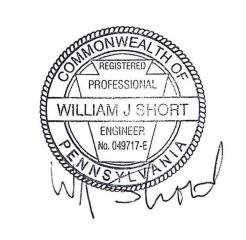

PROJECT TEAM

Landscape Architect: Ground Reconsidered 230 South Broad Street, Suite 604 Philadelphia, PA 19102 215.790.0727 | www.groundreconsidered.com

Civil and Structural Engineer: KS Engineers, P.C. 35 S 3rd St. Philadelphia, PA 19106 215.925.0425 | http://www.kseng.com/



Arora Engineers, Inc. 61 Wilmington-West Chester Pike Chadds Ford, PA 19317

P (610) 459-7900 | F (610) 459-7950 | aroraengineers.com

CITY OF PHILADELPHIA PHILADELPHIA PARKS AND RECREATION


1515 ARCH STREET 11TH FLOOR, ONE PARKWAY BUILDING PHILADELPHIA. PENNSYLVANIA


PROJECT TITLE East Poplar Playground

GENERAL NOTES, SYMBOLS, AND **ABBREVIATIONS**

PROJECT NO. DRAWING NO. E-1 DATE: 02.07.2020 SCALE: 1" = 10' DRAWN BY: AA

> CHECKED BY: VD NOTE: ALL DIMENSIONS AND CONDITIONS SHALL BE VERIFIED BY THE CONTRACTOR AT THE SITE BEFORE PROCEEDING WITH THE WORK

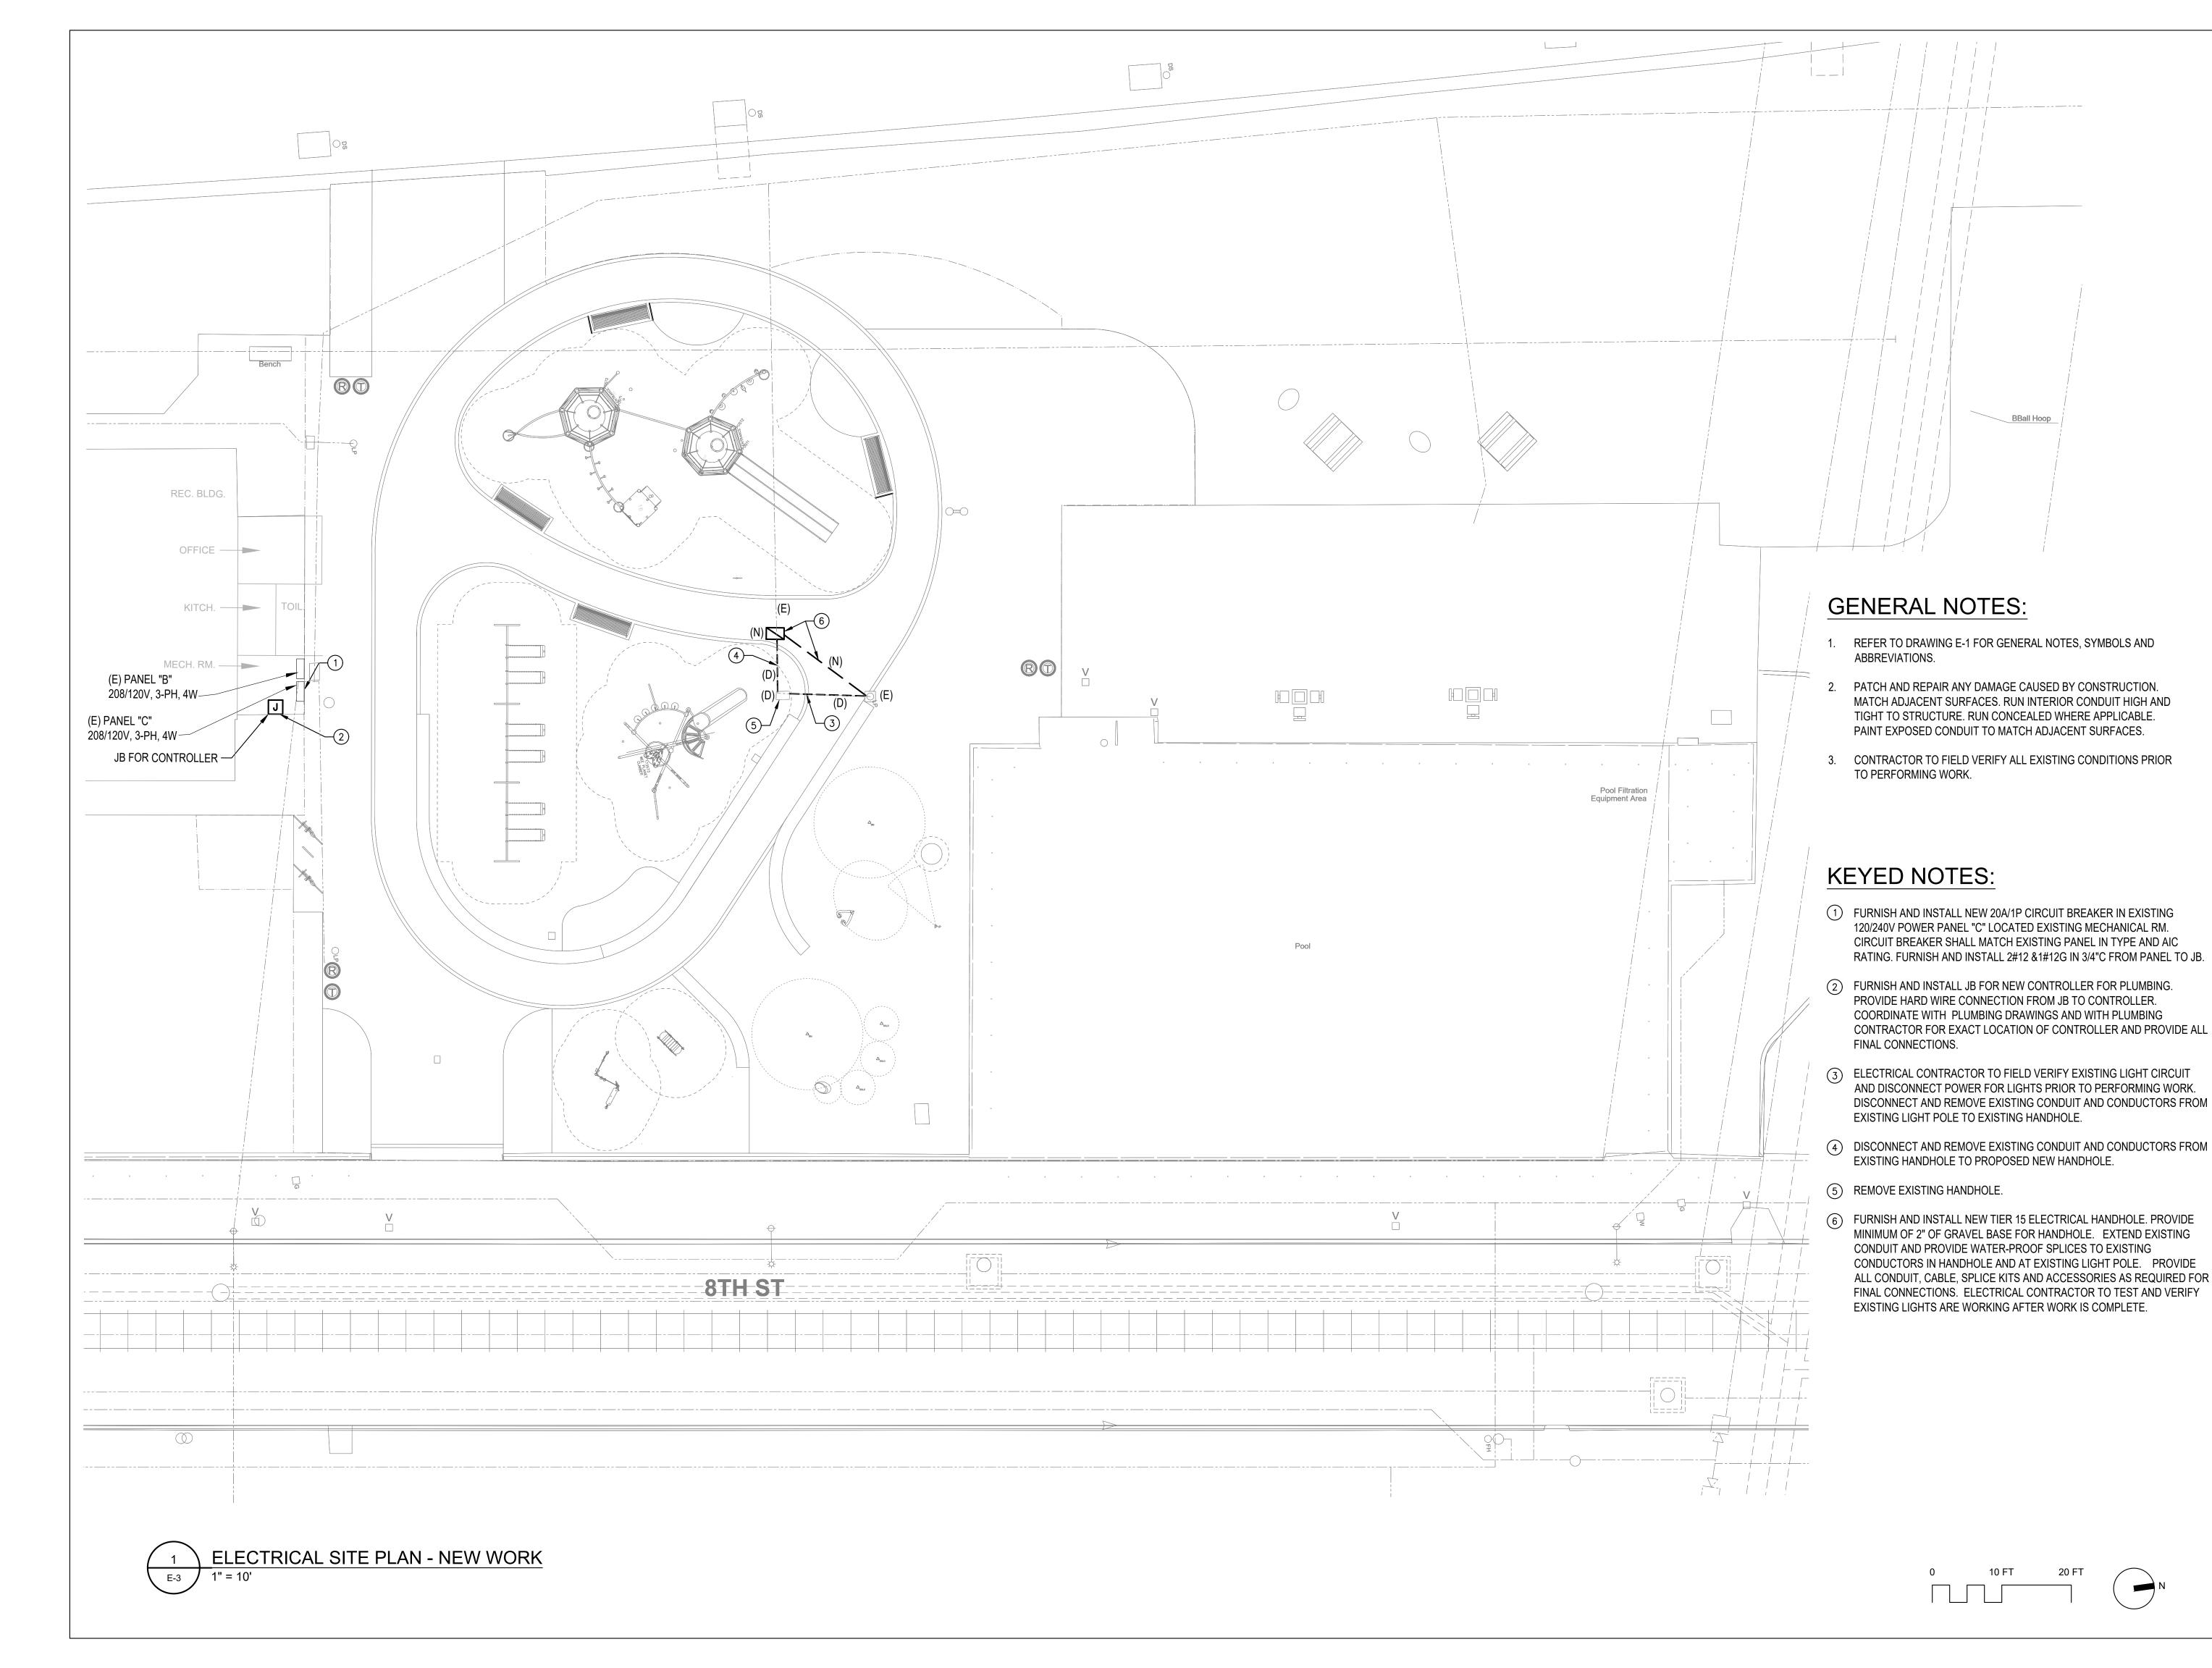

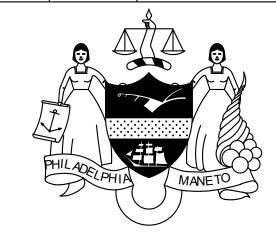

PROJECT COORDINATOR

Philadelphia Parks & Recreation 1515 Arch Street, 10th Floor Philadelphia, PA 19102

SEAL



PROJECT TEAM

Landscape Architect:
Ground Reconsidered
230 South Broad Street, Suite 604
Philadelphia, PA 19102
215.790.0727 | www.groundreconsidered.com

Civil and Structural Engineer: KS Engineers, P.C. 35 S 3rd St. Philadelphia, PA 19106

215.925.0425 | http://www.kseng.com/

ARORA

Arora Engineers, Inc.
61 Wilmington-West Chester Pike
Chadds Ford, PA 19317

P (610) 459-7900 | F (610) 459-7950 | aroraengineers.com

PHILADELPHIA PARKS AND RECREATION

1515 ARCH STREET

11TH FLOOR, ONE PARKWAY BUILDING
PHILADELPHIA, PENNSYLVANIA

CITY OF PHILADELPHIA

PROJECT TITLE
East Poplar Playground

DRAWING TITLE

ELECTRICAL SITE PLAN - NEW WORK

PROJECT NO.

DATE: 02.07.2020

SCALE: 1" = 10'

DRAWN BY: AA

CHECKED BY: VD FILE:

NOTE: ALL DIMENSIONS AND CONDITIONS SHALL BE VERIFIED BY THE CONTRACTOR AT THE SITE


ABB	REVIATIONS:		
ABV	ABOVE	M	METER
AD	AREA DRAIN/ ACCESS DOOR	M.C.	MECHANICAL CONTRACTOR
ADA	AMERICAN WITH DISABILITIES ACT	MFR	MANUFACTURER
AFF	ABOVE FINISH FLOOR	(N)	NEW
AFWH	ANTI-FREEZE WALL HYDRANT	NC	NORMALLY CLOSED
AG	AIR GAP	NIC	NOT IN CONTRACT
AHJ	AUTHORITIES HAVING JURISDICTION	NO	NORMALLY OPEN (FAIL SAFE OPEN)
ASPE	AMERICAN SOCIETY OF PLUMBING ENGINEERS	NPW	NON-POTABLE WATER
BEL	BELOW	NTS	NOT TO SCALE
BFP	BACK FLOW PREVENTER	OC	ON CENTER
BFF	BELOW FINISHED FLOOR	OD	OUTSIDE DIAMETER
CI	CAST IRON	Р	PUMP
CL	CENTERLINE	P.C.	PLUMBING CONTRACTOR
CO	CLEANOUT	PD	PUMP DISCHARGE
CV	CONTROL VALVE	PG	PRESSURE GAUGE
CW	DOMESTIC COLD WATER	POC	POINT OF CONNECTION
CWFU	COLD WATER FIXTURE UNITS	PRV	PRESSURE REDUCING VALVE
DFU	DRAINAGE FIXTURE UNITS	PS	PRESSURE SWITCH
DIA	DIAMETER	PW	POTABLE WATER
DIM	DIMENSION	PWD	PHILADELPHIA WATER DEPARTMENT
DN	DOWN	(R)	REMOVE
(E)	EXISTING	SAN	SANITARY
E.C.	ELECTRICAL CONTRACTOR	SD	STORM DRAIN
EQUIP	EQUIPMENT	SFU	SUPPLY FIXTURE UNITS
ET	EXPANSION TANK		
(ER)	EXISTING TO REMAIN	STD SW	STANDARD STORM WATER
FD	FLOOR DRAIN	TD	TRENCH DRAIN
FLA	FULL LOAD AMPS	TDH	TOTAL DYNAMIC HEAD
FU	FIXTURE UNITS		
GAL	GALLON	TSFU TYP.	TOTAL SUPPLY FIXTURE UNITS TYPICAL
GPM	GALLONS PER MINUTE	U.F.	UNDER FLOOR
HB	HOSE BIBB	UG	UNDER GROUND OR UNDER SLAB
HP	HORSEPOWER	UON	UNLESS OTHERWISE NOTED
IBC	INTERNATIONAL BUILDING CODE		
ID	INSIDE DIAMETER	V/Ø/HZ	VOLTS/PHASE/HZ
IMC	INTERNATIONAL MECHANICAL CODE	VB	VACUUM BREAKER
		\ A /	VA/A OTE

WASTE

WITHOUT

WITH

PLUMBING SYMBOLS:

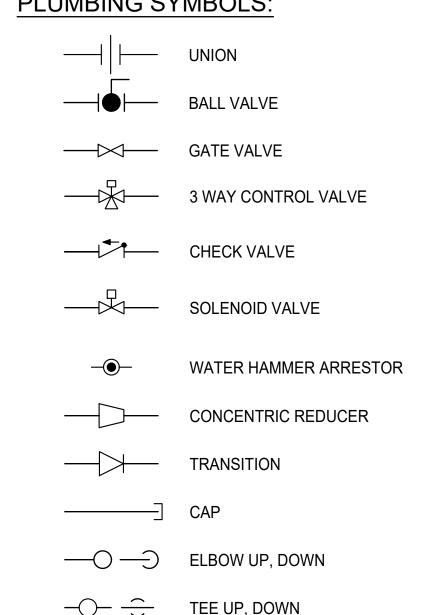

PIPE SLOPE

DRAIN

()FCO

BFP

DIRECTION OF FLOW

FLOOR CLEAN OUT

BACK FLOW PREVENTER

WATER OR GAS METER

PUMP AND FLOW DIRECTION

PIPING LEGEND:

INCHES


INV EL INVERT ELEVATION

IPC INTERNATIONAL PLUMBING CODE

IN

	DOMESTIC COLD WATER
	SANITARY (UNDERGROUND)
	SANITARY ABOVE GROUND
	DEMO PIPE
—— sw ——	STORM WATER

GENERAL SYMBOLS:

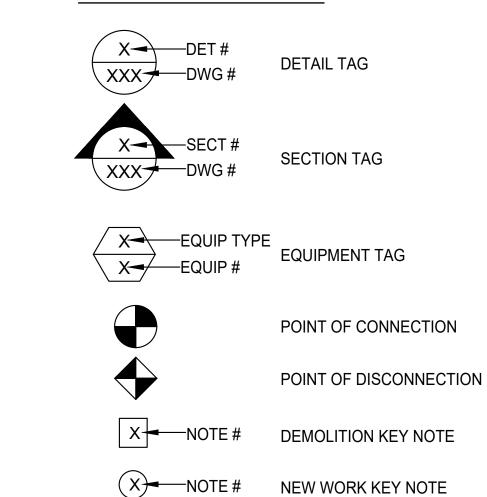

GENERAL PLUMBING NOTES:

- ALL SYMBOLS AND ABBREVIATIONS MAY NOT APPLY TO THIS PROJECT.
- CONTRACTOR SHALL COMPLY WITH ALL REGULATIONS AND LAWS OF AUTHORITIES HAVING JURISDICTION. INSTALLATION SHALL BE IN ACCORDANCE WITH 2018 PHILADELPHIA PLUMBING CODE, ADOPTED OCTOBER 1, 2019 AND THE PHILADELPHIA WATER DEPARTMENT CROSS CONNECTION CONTROL MANUAL.
- CONTRACTOR SHALL BE RESPONSIBLE TO FIELD LOCATE AND IDENTIFY ALL UNDERGROUND UTILITIES WITHIN THE CONSTRUCTION AREA, WHETHER INDICATED ON DRAWINGS OR NOT. THE CONTRACTOR SHALL BE RESPONSIBLE FOR REPAIRS TO UNDERGROUND UTILITIES DAMAGED DURING CONSTRUCTION. NO REIMBURSEMENT WILL BE ALLOWED FOR UTILITY REPAIR/OR REPLACEMENT.
- THE CONTRACTOR SHALL NOT BE ALLOWED ANY STORAGE AREA OTHER THAN THAT AVAILABLE WITHIN THE LIMITS OF THE STAGING AREA, CONFINES OF THE WORK AREA, OR AS DESIGNATED BY THE OWNER.
- CONTRACTOR SHALL FIELD VERIFY ALL DIMENSIONS. CONTRACTOR SHALL NOT SCALE DRAWINGS FOR DIMENSIONS.
- ALL MATERIAL SHALL COMPLY WITH APPLICABLE CODES, ORDINANCES AND REGULATIONS.
- ALL PENETRATIONS THROUGH DESIGNATED FIRE RATED WALLS, CEILINGS AND FLOOR SLABS (WHICH ARE 2-HOUR RATED) SHALL BE PROPERLY SEALED WITH AN APPROVED RATED FIRE AND SMOKE STOPPING MATERIAL. CONTRACTOR SHALL SUBMIT MANUFACTURER'S CATALOG DATA AND INSTALLATION DETAIL FOR FIRE AND SMOKE STOPPING TO THE ENGINEER FOR REVIEW AND APPROVAL PRIOR TO INSTALLATION.
- PRIOR TO DELIVERY OF ANY MATERIALS TO THE SITE, THE CONTRACTOR SHALL PROVIDE MATERIAL SAFETY DATA SHEETS FOR ALL ITEMS AND MATERIALS USED IN THE WORK.
- PRIOR TO ACCEPTANCE, ALL SYSTEMS SHALL BE TESTED AND OPERATED TO DEMONSTRATE TO THE OWNER, OR HIS DESIGNATED REPRESENTATIVE, THAT THE INSTALLATION AND PERFORMANCE OF THESE SYSTEMS AND/OR PARTS THEREOF CONFIRM TO THE DESIGN INTENT.
- CONTRACTOR SHALL FURNISH AND INSTALL ALL MATERIALS & EQUIPMENT REQUIRED FOR THE COMPLETION & OPERATION OF ALL SYSTEMS IN ACCORDANCE WITH ALL APPLICABLE CODES.
- CONTRACTOR SHALL OBTAIN ALL NECESSARY PERMITS AND AND APPROVAL AND PAY ALL RELATED FEES.
- DURING CONSTRUCTION, THE CONTRACTOR SHALL BE RESPONSIBLE FOR PROVIDING ALL HIS EMPLOYEES WITH SAFE AND HEALTHY WORKING CONDITIONS AS PRESCRIBED IN THE "SAFETY AND HEALTH REGULATIONS FOR CONSTRICTION" OF THE OCCUPATIONAL SAFETY AND HEALTH ADMINISTRATION OF THE U.S. DEPARTMENT OF LABOR.
- 13. SECURE AND DELIVER TO THE OWNER'S REPRESENTATIVE ALL CERTIFICATES OF COMPLIANCE REQUIRED BY THE AHJ.
- 14. CONTRACTOR SHALL GIVE SUITABLE NOTICE TO ALL APPLICABLE UTILITY COMPANIES AND OWNER PRIOR TO PERFORMING WORK INVOLVING UTILITIES.
- ALL EQUIPMENT SHALL BE HANDLED, STORED AND PROTECTED TO PREVENT DAMAGE BEFORE AND DURING INSTALLATION IN ACCORDANCE WITH MANUFACTURER'S INSTRUCTIONS.
- CONTRACTOR SHALL PROVIDE AND INSTALL ACCESS DOORS FOR ACCESS TO EACH CONCEALED VALVE, PIECE OF EQUIPMENT, ETC.
- 17. ALL EQUIPMENT, ETC. SHALL BE LOCATED AND INSTALLED IN A READILY ACCESSIBLE LOCATION SO AS TO PERMIT ACCESS FOR SERVICE WITHOUT DAMAGE TO BUILDING OR FINISHED MATERIALS, PER MANUFACTURER'S INSTRUCTIONS AND APPLICABLE CODES.
- ALL MATERIAL SHALL BE NEW AND SHALL FIT THE SPACE AVAILABLE. VERIFY DIMENSIONS AT SITE.
- 19. ALL PIPING, APPARATUS, EQUIPMENT, ETC. SHALL BE PROPERLY SUPPORTED, BRACED VERTICALLY AND HORIZONTALLY IN ACCORDANCE WITH APPLICABLE CODES AND AS REQUIRED TO PREVENT EXCESSIVE MOVEMENT.
- VALVES AND FITTINGS SHALL BE OF THE SAME SIZE AS THE PIPING FOR WHICH THEY ARE INSTALLED, UNLESS OTHERWISE NOTED.
- 21. STERILIZE DOMESTIC WATER PIPING IN ACCORDANCE WITH HEALTH DEPARTMENT REGULATIONS.
- WATER PIPING SHALL NOT BE RUN IN AREAS SUBJECTED TO FREEZING TEMPERATURES UNLESS OTHERWISE NOTED.
- 23. PROVIDE DRAIN VALVES AT ALL LOW POINTS OF DOMESTIC WATER PIPING SYSTEMS FOR COMPLETE DRAINAGE AND INDICATE LOCATION OF SAME ON RECORD DRAWINGS.
- PROVIDE VACUUM BREAKERS AS REQUIRED.
- 25. CONTRACTOR SHALL REPAIR/PATCH ALL FINISHED SURFACES INCLUDING BUT NOT LIMITED TO, WALLS AND FLOORS DAMAGED BY CONSTRUCTION.

DESCRIPTION

REVISIONS

PROJECT COORDINATOR Philadelphia Parks & Recreation 1515 Arch Street, 10th Floor Philadelphia, PA 19102


SEAL



PROJECT TEAM Landscape Architect: Ground Reconsidered 230 South Broad Street, Suite 604

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Arora Engineers, Inc. 61 Wilmington-West Chester Pike Chadds Ford, PA 19317

P (610) 459-7900 | F (610) 459-7950 | aroraengineers.com

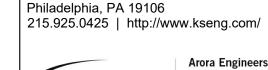CITY OF PHILADELPHIA PHILADELPHIA PARKS AND RECREATION


1515 ARCH STREET 11TH FLOOR, ONE PARKWAY BUILDING PHILADELPHIA, PENNSYLVANIA

PROJECT TITLE East Poplar Playground


GENERAL NOTES, SYMBOLS, AND ABBREVIATIONS

PROJECT NO. DRAWING NO. DATE: 02.07.2020 SCALE: 1" = 10' DRAWN BY: DAG

CHECKED BY: DM NOTE: ALL DIMENSIONS AND CONDITIONS SHALL BE VERIFIED BY THE CONTRACTOR AT THE SITE BEFORE PROCEEDING WITH THE WORK.

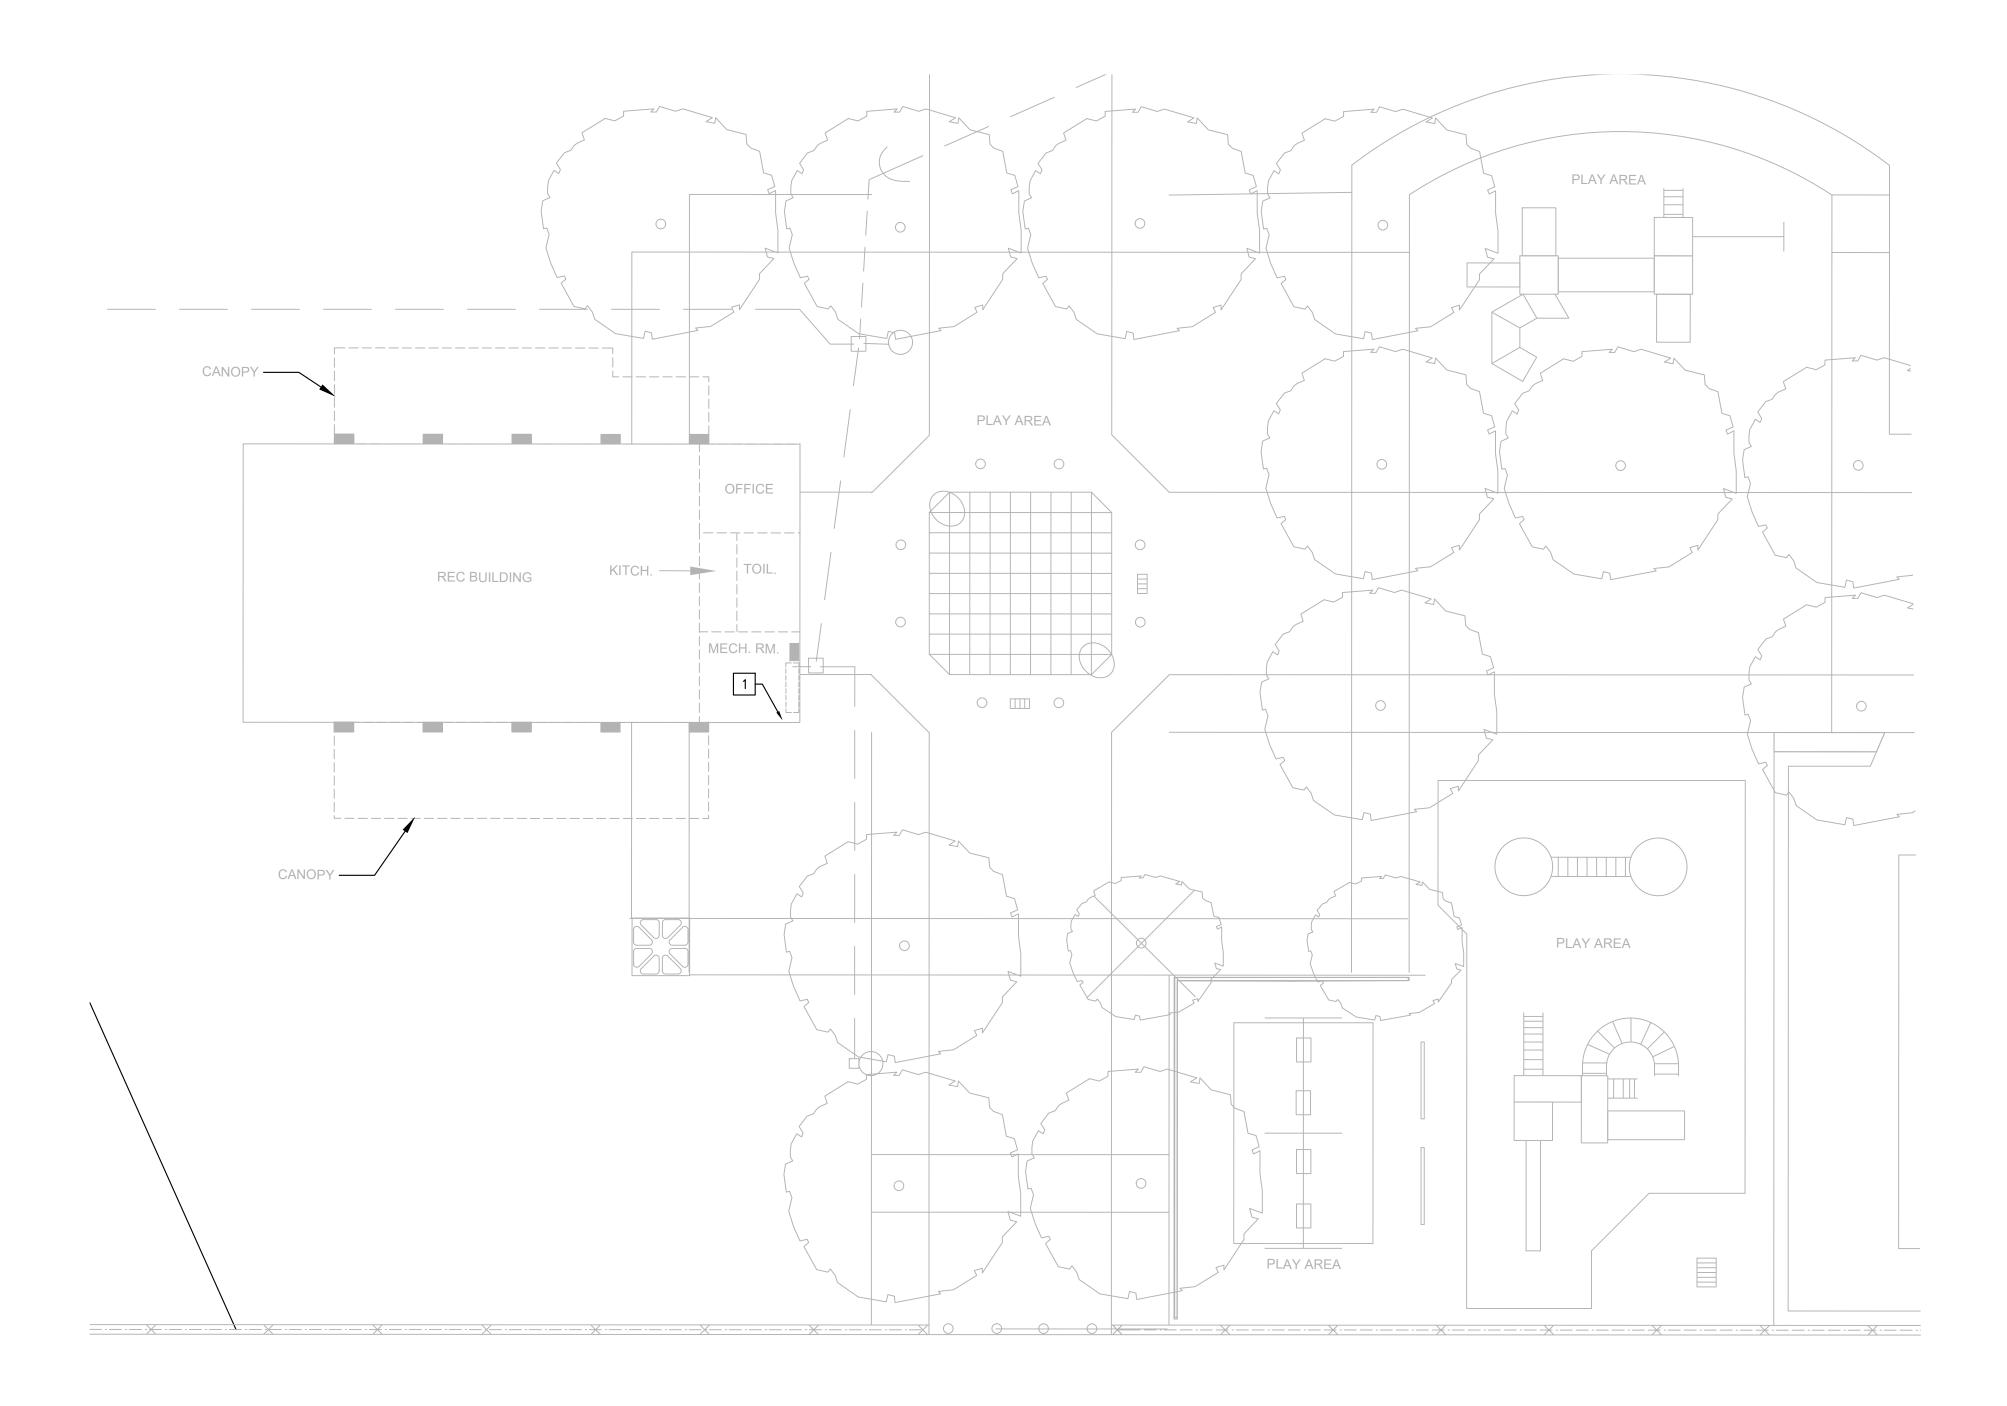

PLUMBING SITE PLAN - DEMOLITION NOT TO SCALE

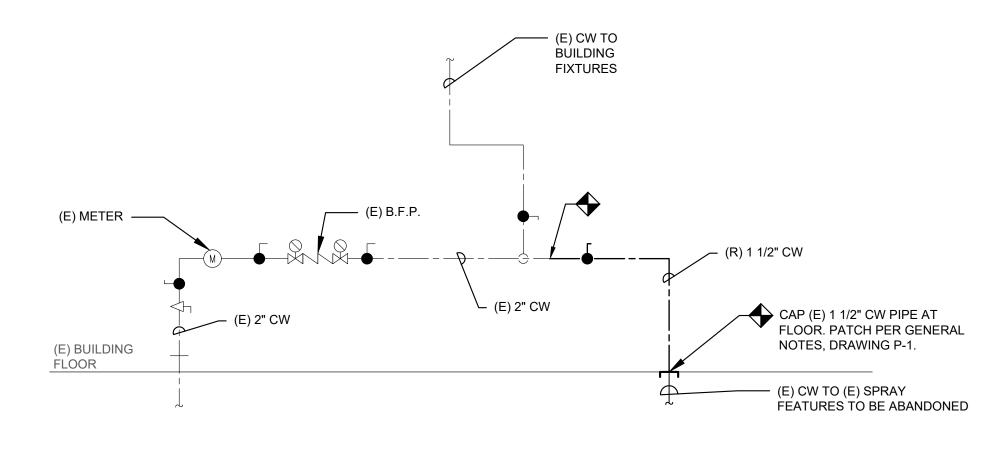

DOMESTIC RISER - DEMOLITION NOT TO SCALE




- 1. AN ADDITION TO THE EXISTING BUILDING ALONG WITH ASSOCIATED WALKWAYS AND SUPPORTING INFRASTRUCTURE IS SHOWN AS EXISTING CONDITIONS FOR REFERENCE. SEE ARCHITECTURAL AND CIVIL ENGINEERING PLANS FOR DETAILS OF THESE PROPOSED IMPROVEMENTS.
- 2. REFER TO DRAWING P-1 FOR GENERAL NOTES, SYMBOLS AND ABBREVIATIONS.
- 3. REFER TO ARCHITECTURAL PLANS FOR ADDITIONAL DEMOLITION SCOPE TO PROVIDE CLEAR WORK AREA FOR NEW SPRAY FEATURES.

KEYED NOTES:

1 EXISTING INCOMING DOMESTIC WATER SERVICE AND PIPE FOR EXISTING SPRAY FEATURES. REFER TO DETAIL 2, THIS PAGE FOR EXTENT OF DEMOLITION OF DOMESTIC WATER PIPE.



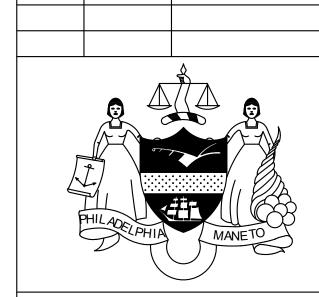

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CITY OF PHILADELPHIA PHILADELPHIA PARKS AND RECREATION


1515 ARCH STREET 11TH FLOOR, ONE PARKWAY BUILDING PHILADELPHIA, PENNSYLVANIA


PROJECT TITLE East Poplar Playground


DRAWING TITLE

PLUMBING SITE PLAN DEMOLITION

PROJECT NO. DRAWING NO. P-2 SCALE: 1" = 10' DRAWN BY: DAG CHECKED BY: DM NOTE: ALL DIMENSIONS AND CONDITIONS SHALL BE VERIFIED BY THE CONTRACTOR AT THE SITE

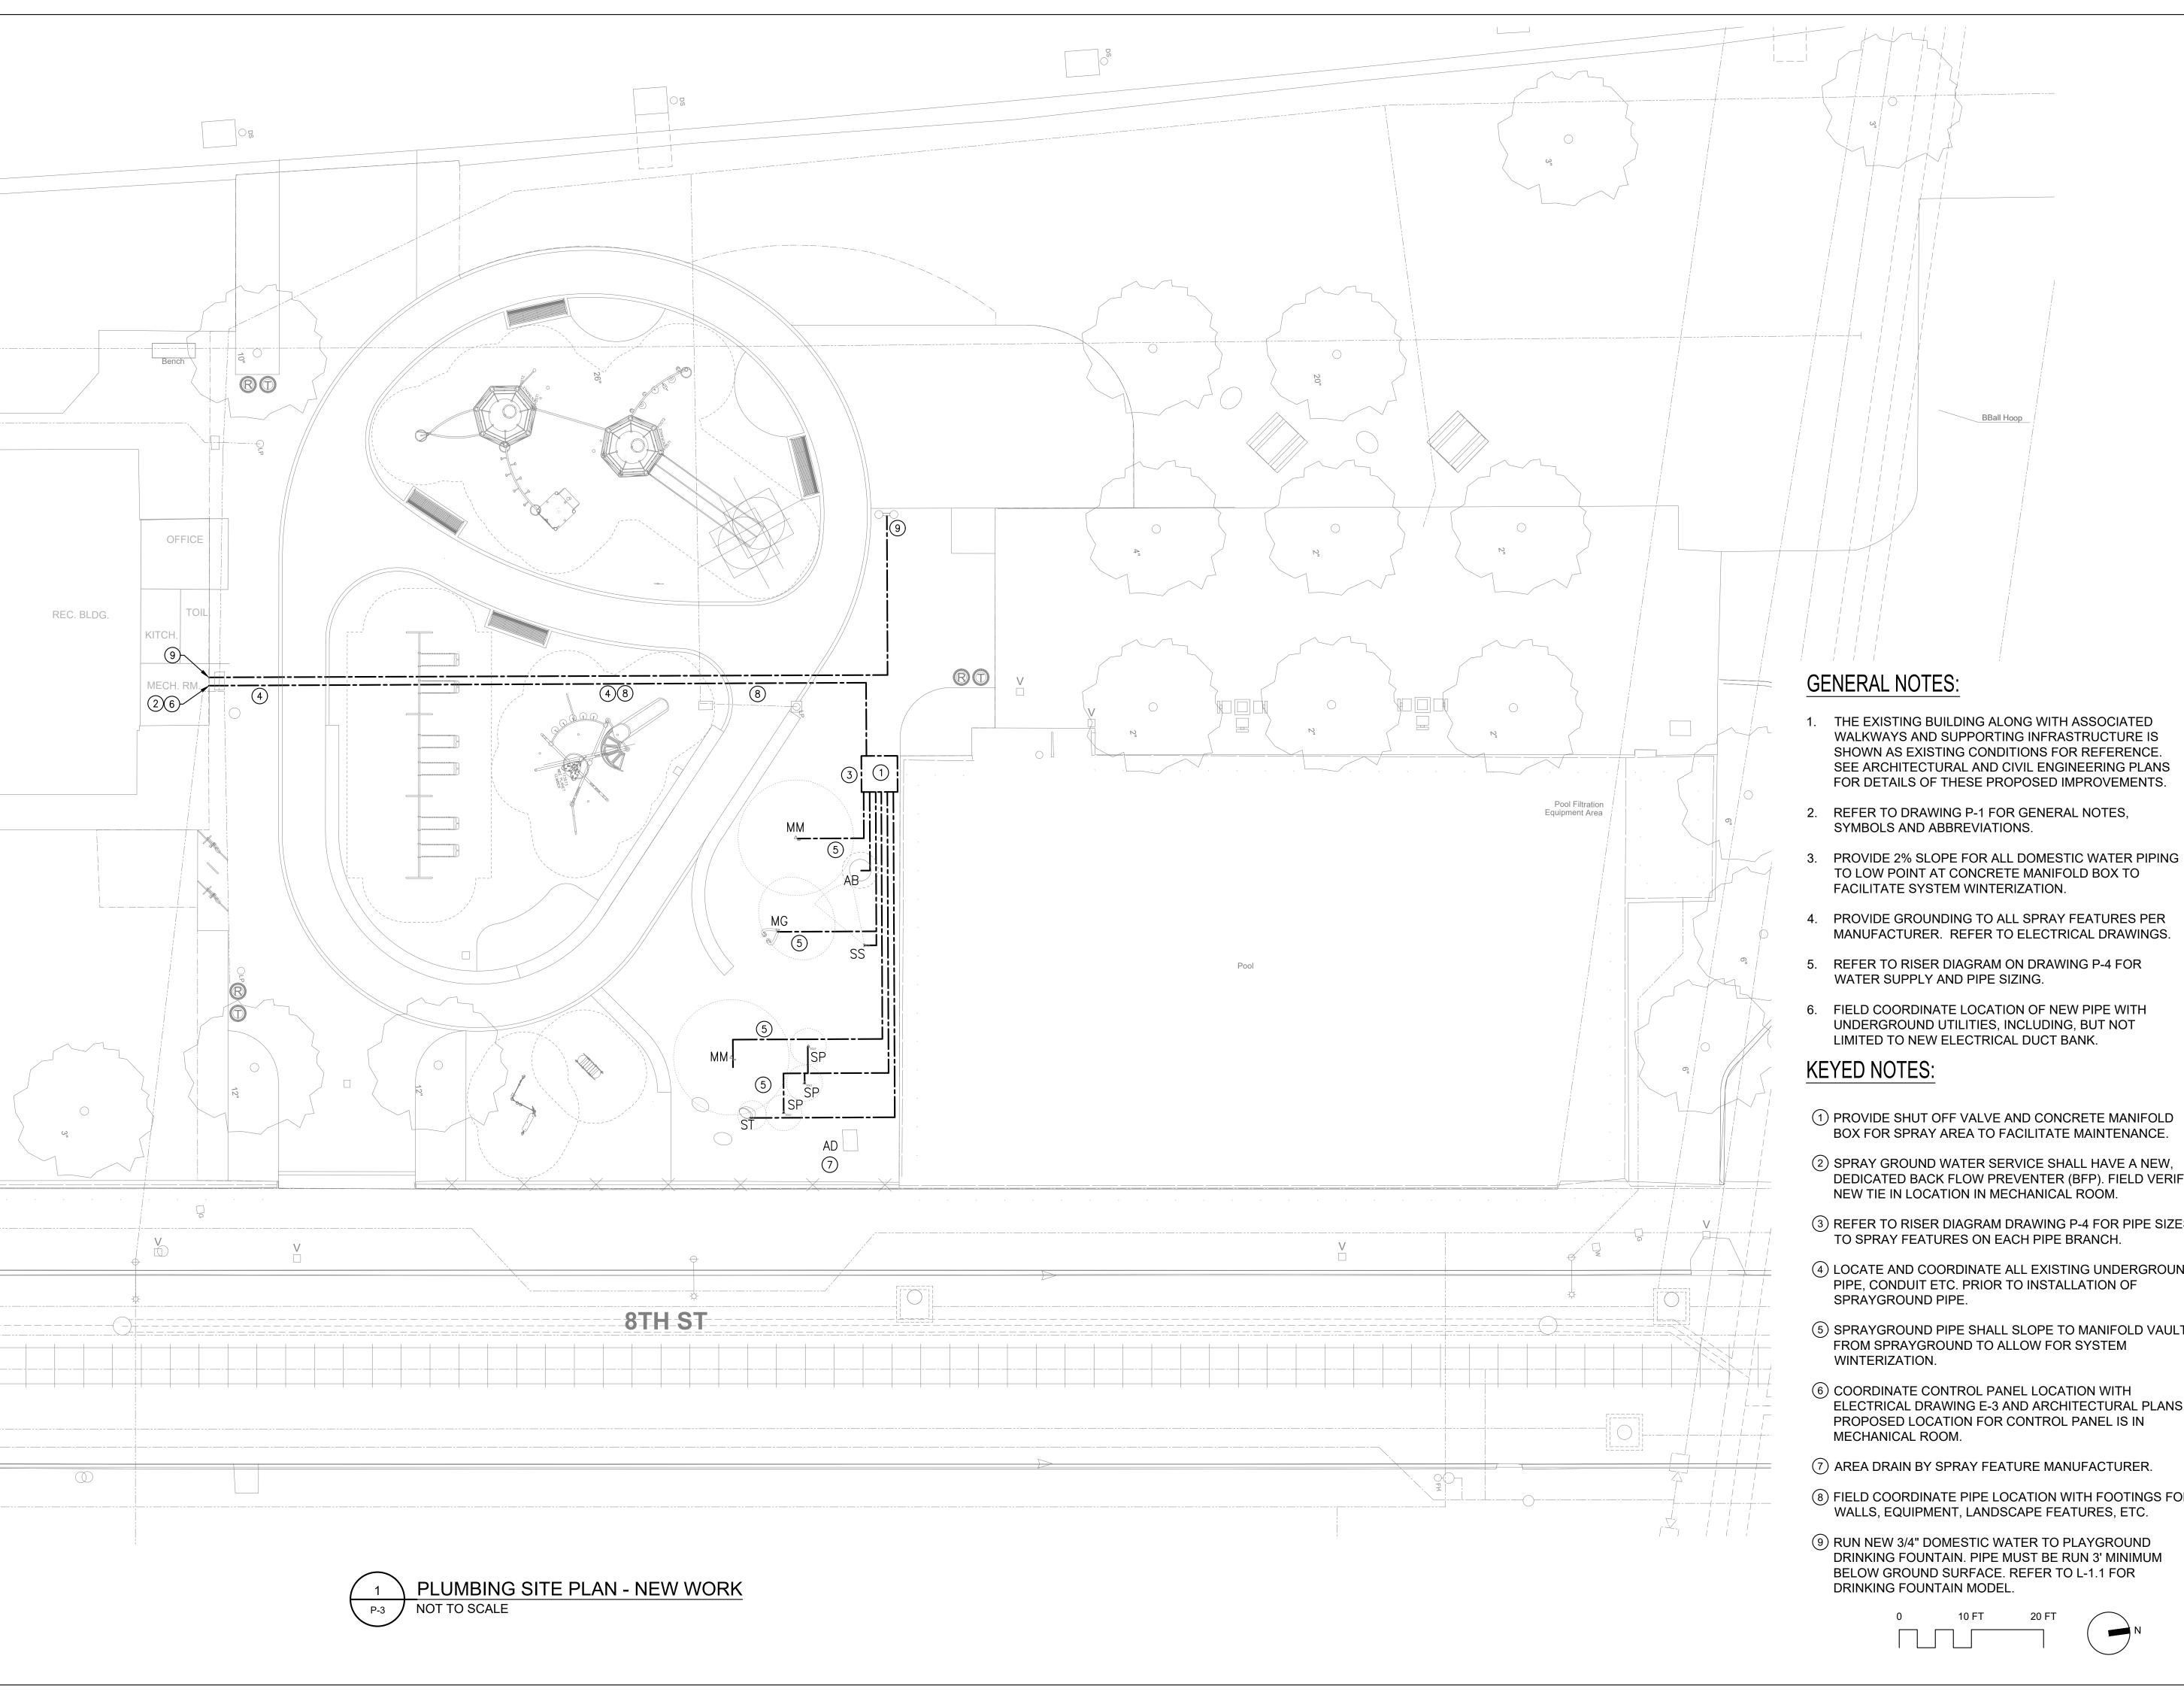

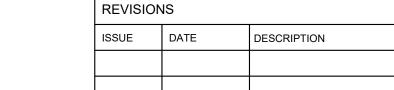

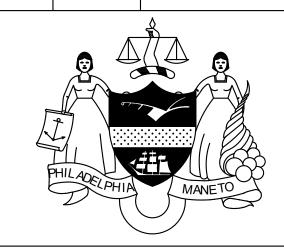

PROJECT COORDINATOR Philadelphia Parks & Recreation 1515 Arch Street, 10th Floor Philadelphia, PA 19102



PROJECT TEAM Landscape Architect: Ground Reconsidered 230 South Broad Street, Suite 604 Philadelphia, PA 19102

Civil and Structural Engineer: KS Engineers, P.C. 35 S 3rd St. Philadelphia, PA 19106

215.925.0425 | http://www.kseng.com/

215.790.0727 | www.groundreconsidered.com



Arora Engineers, Inc. 61 Wilmington-West Chester Pike Chadds Ford, PA 19317

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1) PROVIDE SHUT OFF VALVE AND CONCRETE MANIFOLD BOX FOR SPRAY AREA TO FACILITATE MAINTENANCE.

BBall Hoop

- 2 SPRAY GROUND WATER SERVICE SHALL HAVE A NEW, DEDICATED BACK FLOW PREVENTER (BFP). FIELD VERIFY NEW TIE IN LOCATION IN MECHANICAL ROOM.
- 3 REFER TO RISER DIAGRAM DRAWING P-4 FOR PIPE SIZES TO SPRAY FEATURES ON EACH PIPE BRANCH.
- (4) LOCATE AND COORDINATE ALL EXISTING UNDERGROUND PIPE, CONDUIT ETC. PRIOR TO INSTALLATION OF SPRAYGROUND PIPE.
- (5) SPRAYGROUND PIPE SHALL SLOPE TO MANIFOLD VAULT FROM SPRAYGROUND TO ALLOW FOR SYSTEM WINTERIZATION.
- 6 COORDINATE CONTROL PANEL LOCATION WITH ELECTRICAL DRAWING E-3 AND ARCHITECTURAL PLANS. PROPOSED LOCATION FOR CONTROL PANEL IS IN MECHANICAL ROOM.
- 7 AREA DRAIN BY SPRAY FEATURE MANUFACTURER.
- (8) FIELD COORDINATE PIPE LOCATION WITH FOOTINGS FOR WALLS, EQUIPMENT, LANDSCAPE FEATURES, ETC.
- 9 RUN NEW 3/4" DOMESTIC WATER TO PLAYGROUND DRINKING FOUNTAIN. PIPE MUST BE RUN 3' MINIMUM BELOW GROUND SURFACE. REFER TO L-1.1 FOR DRINKING FOUNTAIN MODEL.

1515 ARCH STREET 11TH FLOOR, ONE PARKWAY BUILDING PHILADELPHIA, PENNSYLVANIA

CITY OF PHILADELPHIA

PROJECT TITLE East Poplar Playground


PHILADELPHIA PARKS AND RECREATION

DRAWING TITLE

PLUMBING SITE PLAN NEW WORK


PROJECT NO.	DRAWING NO.
DATE: 02.07.2020	P-3
SCALE: 1" = 10'	
DRAWN BY: DAG	
CHECKED BY: DM	FILE:

NOTE: ALL DIMENSIONS AND CONDITIONS SHALL BE VERIFIED BY THE CONTRACTOR AT THE SITE BEFORE PROCEEDING WITH THE WORK.

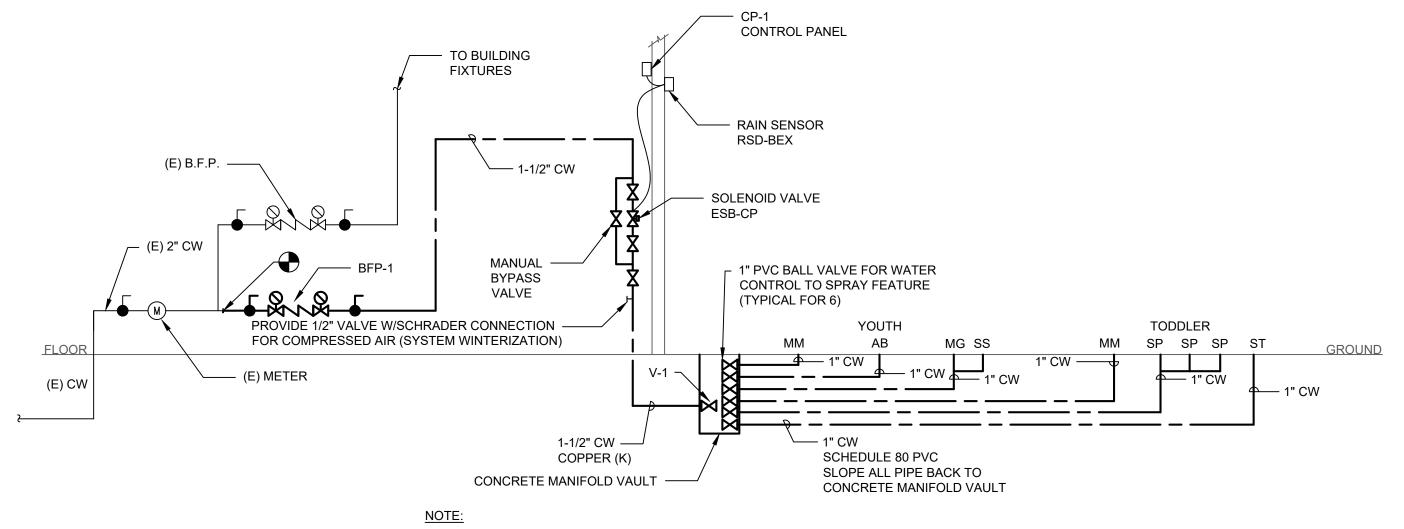

1. PIPING SYSTEM FOR SPRAYGROUND FEATURES SHALL COMPLY WITH CITY OF PHILADELPHIA CROSS CONNECTION CONTROL MANUAL. 2. SEE SCHEDULES BELOW FOR FLOW TO INDIVIDUAL FEATURES. VERIFY PIPE

SIZE TO EACH FEATURE WITH MANUFACTURER OF SPRAY FEATURE. RISER DIAGRAM FOR NEW WORK AND SPRAYGROUND

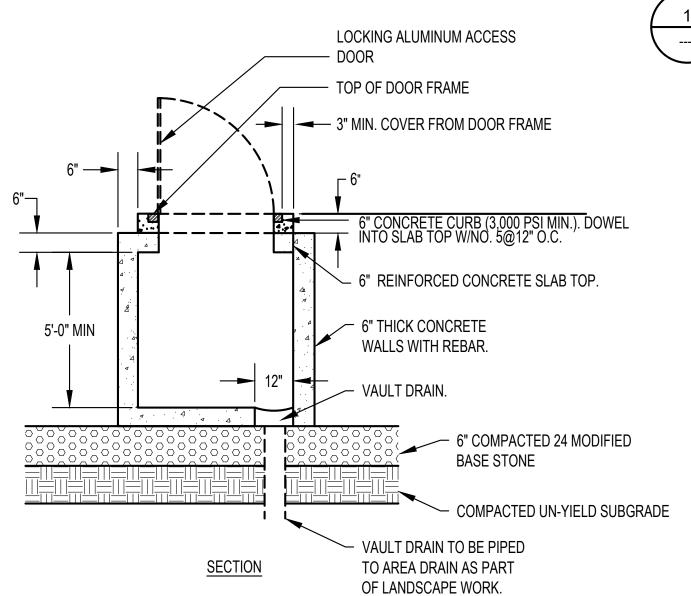


FLOW TEST DATA - AUGUST 23, 2019


PRESSURE DISTRICT IS EAST PARK. FLOW TEST LOCATION

IS 8TH AND BROWN STREETS, ADJACENT TO PLAYGROUND. LOCATION MAP AT RIGHT IS PROVIDED FOR REFERENCE

ONLY AND IS NOT TO SCALE.

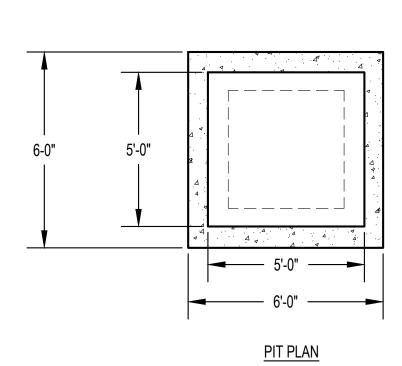

NOT TO SCALE

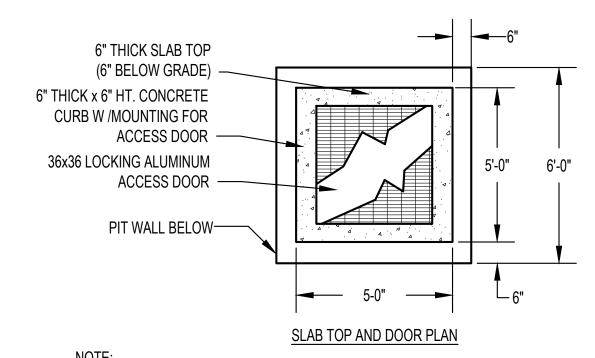

CONCRETE VAULT SHALL BE MANUFACTURED BY ALTOMORE PRECAST CONCRETE. CONTRACTOR TO CONFIRM REQUIRED INTERIOR DIMENSIONS OF CONCRETE VAULT

PRIOR TO FABRICATION; COORDINATE WITH SPRAYGROUND EQUIPMENT SUPPLIER.

2	1	CONCRETE MANIFOLD VAULT DETAIL
	J	NOT TO SCALE

SPRAY FEATURE CONTROL			
SYMBOL	DESCRIPTION	MANUFACTURER, MODEL, NOTES & ACCESSORIES	
CP-1	RAINBIRD ESP-12LX	PROVIDE CONTROL WIRING TO RAIN SENSOR RSD-BEX AND SOLENOID VALVE, RAINBIRD EFB-CP GENERAL SERVICE BRASS NORMALLY CLOSED, OR SIMILAR.	

NOTE: COORDINATE TIMER WITH RECREATION CENTER HOURS OF OPERATION.

DESCRIPTION	NOTES	35		N Darier n St in St	all St
LOCATION	800 NORTH 8TH STREET, PHILADELI	1.61	George St	N 9th St N Bth St N Franklin St	N Marshall St
SIZE OF MAIN	12"	Ogden St			Z
				Poplar St	
RESIDUAL F	PRESSURE AND FLOW	-1.31	Parrish Pl	din St	
PRESSURE (PSI) FLOW (GPM)			N Franklin St	
43 (STATIC)	0			EAST POPLAR	Parrish St
40	1890			Brown St	
30	4170	-St	Fairm		
20 (CALCULATED)) 5680	N 10th St	Fairmount		
			7///	Melon To	THI

MANUAL SHUT OFF VALVE SCHEDULE (MAIN SHUT OFF)					
	SYMBOL	DESCRIPTION	CW	MANUFACTURER, MODEL, NOTES & ACCESSORIES	
	V-1	MAIN SPRAYGROUND SHUT OFF VALVE	1-1/2"	WATTS 2 PIECE LEAD FREE BRASS BALL VALVE, LFFBVS, OR EQUAL.	

PLUN	PLUMBING EQUIPMENT SCHEDULE					
SYMBOL	DESCRIPTION	FITTING	CW	SAN	MANUFACTURER, MODEL, NOTES & ACCESSORIES	
BFP-1	BACK FLOW PREVENTER REDUCED PRESSURE ASSEMBLY	AIR GAP 909AG-F	1-1/2"		WATTS LF 709 DOUBLE CHECK VALVE BODY WITH STAINLESS STEEL SEAT. REFER TO NOTE 1. PROVIDE WITH AIR GAP, PIPE TO CLOSEST FLOOR DRAIN.	

BACKFLOW PREVENTER SHALL BE IN COMPLIANCE WITH THE PHILADELPHIA WATER DEPARTMENT CROSS CONNECTION CONTROL MANUAL FOR APPROVED BACK FLOW PREVENTERS AND INSTALLATION.

GENERAL NOTES:

- 1. BACKFLOW PREVENTER SHALL BE IN COMPLIANCE WITH THE PWD CROSS CONNECTION CONTROL MANUAL AND APPROVED BACK FLOW
- 2. LAYOUT AND SIZING SHOWN FOR GENERAL REFERENCE ONLY. PIPE LAYOUT AND MANIFOLD BOX LOCATION SHALL BE COORDINATED WITH LANDSCAPE FEATURES AND SPRAY GROUND MANUFACTURER.

PIPE SCHEDULE						
SERVICE	SIZE	MATERIAL				
ABOVE GROUND, INTERIOR SPACES	ALL	COPPER TYPE "L"				
BELOW GROUND	ALL	COPPER TYPE "K" FROM BACK FLOW PREVENTER TO VALVE BOX AND DRINKING FOUNTAIN.				
BELOW GROUND	ALL	SCHEDULE 80 PVC FROM CONCRETE MANIFOLD VAULT TO SPRAYGROUND FEATURES.				


POPLAR STREET- TODDLER (AGES 2-5)						
BASIS OF DESIGN SPRAY FEATURES BY WATERPLAY SOLUTIONS (SEE SCHEDULE NOTE)			PRESSURE (PSI)	Flow	TOTAL (GPM)	
COMPONENT NAME	ABR	QTY	Rate (GPM)			
MISTY MOUNTAIN	MM	1	10	1	1	
SOLO SPURT	SP	3	3	2	6	
SURF STONE	ST	1	5	5	5	
			MAXIMUM FL	LOW	12	

NOTE SPRAY FEATURE EQUIPMENT PRESSURE AND FLOW RATE IS BASED ON MANUFACTURER FEATURE SELECTION AT TIME OF DESIGN. ALL SPRAY FEATURES ARE LOW FLOW FOR WATER CONSERVATION. VERIFY MANUFACTURER SPRAY FEATURE FLOW RATE, REQUIRED PRESSURE ETC. REFER TO MANUFACTURER'S LAYOUT FOR SPRAY FEATURE PIPING SIZES.

		•	· 1		
ASIS OF DESIGN SPRAY FEATURES BY WATERPLAY SOLUTIONS (SEE SCHEDULE NOTE)			PRESSURE (PSI)	Flow	TOTAL (GPM)
COMPONENT NAME	ABR	QTY		Rate (GPM)	
MISTY MOUNTAIN	MM	1	10	1	1
ANETH BLOOM	AB	1	N/A	3	3
MORNING GRASS	MG	1	4	3	3
STEADY STREAM	SS	1	3	2	2
			MAXIMUM FL	_OW	9

NOTE SPRAY FEATURE EQUIPMENT PRESSURE AND FLOW RATE IS BASED ON MANUFACTURER FEATURE SELECTION AT TIME OF DESIGN. ALL SPRAY FEATURES ARE LOW FLOW FOR WATER CONSERVATION. VERIFY MANUFACTURER SPRAY FEATURE FLOW RATE, REQUIRED PRESSURE ETC. REFER TO MANUFACTURER'S LAYOUT FOR SPRAY FEATURE PIPING SIZES.

	TOTAL WATER REQUIREMENT FOR SPRAY FEATURES				
TODDLER	12 GPM				
YOUTH	9 GPM				
MAXIMUM FLOW	21 GPM				

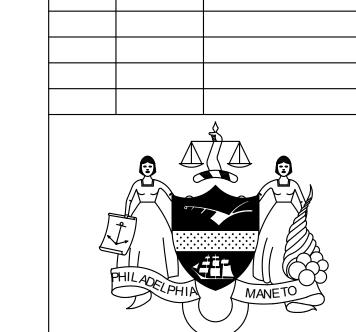

DESCRIPTION

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REVISIONS



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1515 ARCH STREET 11TH FLOOR, ONE PARKWAY BUILDING PHILADELPHIA, PENNSYLVANIA

PROJECT TITLE East Poplar Playground

PLUMBING SCHEDULES AND DETAILS

PROJECT NO. DRAWING NO. P-4 DATE: 02.07.2020 SCALE: 1" = 10' DRAWN BY: DAG

CHECKED BY: DM NOTE: ALL DIMENSIONS AND CONDITIONS SHALL BE VERIFIED BY THE CONTRACTOR AT THE SITE BEFORE PROCEEDING WITH THE WORK.