Attachment D-

Contract Drawings



1.01.10.00,122

COBBS CREEK PLAYGROUND

AT COBBS CREEK ENVIRONMENTAL CENTER 63RD AND CATHARINE STREETS, PHILADELPHIA, PA 19143

PREPARED FOR:

REBUILD PHILADELPHIA & PHILADELPHIA PARKS AND RECREATION CONTRACT #1920644





PREPARED BY:



100% CONSTRUCTION DOCUMENTS ISSUE DATE: 07/22/2022

	COVER AND LOCATION PLAN
G-000	DRAWING LIST AND GENERAL NOTES
G-100	EXISTING CONDITIONS PLAN
L-100	TREE PROTECTION AND DEMO PLAN
L-101	OVERALL SITE PLAN
L-102	MATERIALS, FURNISHING & EQUIPMENT PLAN
L-103	LAYOUT PLANS
L-104	DETAIL LAYOUT PLANS
L-105	DETAIL LAYOUT PLANS
L-200	SITE DETAILS
L-201	SITE DETAILS
L-202	SITE DETAILS
L-203	DEDUCT ALT 2: SITE DETAILS
L-300	PLANTING PLAN & DETAILS
C-100	GRADING AND UTILITY PLAN
C-200	EROSION CONTROL PLAN
C-250	E&S CONTROL DETAILS
C-251	E&S CONTROL NOTES
C-500	UTILITY DETAILS
E-000	GENERAL NOTES, SYMBOLS AND ABBREVIATIONS
E-100	ELECTRICAL SITE PLAN
E-200	DETAILS
E-300	SCHEDULES

GENERAL NOTES

- 1. THE HORIZONTAL AND VERTICAL SURVEY DATA SHOWN HERE TO ON THE PLANS ARE FROM A DIGITAL FILE SUPPLIED BY SCI-TEK CONSULTANTS,
- 2. THE CONTRACTOR SHALL SECURE ALL PERMITS REQUIRED FOR WORK BY ANY FEDERAL, STATE OR LOCAL DEPARTMENTS, UTILITY COMPANIES OR JURISDICTION AFFECTED BY WORK.
- 3. THE CONTRACTOR SHALL PERFORM ALL WORK AND SERVICES SPECIFICALLY DESCRIBED IN AND REQUIRED BY THE CONTRACT DOCUMENTS (AS DEFINED IN THE CONTRACT) INCLUDING, WITHOUT LIMITATION, THE SCOPE OF WORK DOCUMENTS AND THE DRAWINGS AND DESIGN SPECIFICATIONS.
- 4. THE CONTRACTOR SHALL VERIFY DIMENSIONS AND FIELD CONDITIONS, NOTIFY ARCHITECT OF ANY DISCREPANCIES IN CONTRACT DOCUMENTS AND OBTAIN CLARIFICATION BEFORE PROCEEDING WITH WORK AFFECTED BY THE DISCREPANCIES.
- 5. THE CONTRACTOR SHALL NOTIFY ARCHITECT OF ANY DISCREPANCIES BETWEEN THE EXISTING CONDITIONS AND THE CONTRACT DOCUMENTS PRIOR TO PROCEEDING WITH THAT PORTION OF THE WORK. FAILURE TO NOTIFY ARCHITECT WILL NOT RELIEVE CONTRACTOR OF RESPONSIBILITY TO COMPLETE THE WORK AS INDICATED BY THE CONTRACT DOCUMENTS. CONTRACTOR SHALL BE RESPONSIBLE FOR ANY WORK RESULTING FROM SUCH FAILURE TO COORDINATE DISCREPANCIES WITHOUT THE ARCHITECT'S APPROVAL.
- 6. IN THE EVENT OF DISCREPANCIES BETWEEN DRAWINGS AND SPECIFICATIONS, CONTRACTOR TO NOTIFY ARCHITECT AND OBTAIN RESOLUTION PRIOR TO PROCEEDING WITH THAT PORTION OF WORK. FOR PRICING PURPOSES, THE ALTERNATE WITH THE GREATER VALUE IS TO BE USED UNTIL THE DISCREPANCY IS RESOLVED BY THE ARCHITECT.
- 7. THE CONTRACTOR SHALL BE RESPONSIBLE FOR THE COORDINATION WITH ALL LOCAL UTILITY COMPANIES. THE CONTRACTOR SHALL NOTIFY THE OWNER 48 HOURS PRIOR TO DIGGING IN ORDER THAT UNDERGROUND UTILITIES IN THE AREA CAN BE LOCATED.
- 8. THE CONTRACTOR SHALL LOCATE, PROTECT AND IDENTIFY ALL UNDERGROUND AND OVERHEAD UTILITIES AND SERVICES. THE CONTRACTOR SHALL BE RESPONSIBLE FOR OBTAINING INFORMATION

AND SATISFYING THEMSELVES AS TO THE LOCATION OF UTILITIES, SHOWN AND NOT SHOWN. ALL REPAIRS OR RELOCATIONS NECESSARY SHALL BE MADE AS REQUIRED BY THE OWNER OF THE UTILITIES OR STRUCTURES. THE COST OF SUCH REPAIRS OR RELOCATIONS NECESSARY SHALL BE BORNE BY THE CONTRACTOR.

- 9. EXISTING CONSTRUCTION INCLUDING UTILITIES, SUBSURFACE GRADING, DRAINAGE, BUILDING FOUNDATION WORK, AND OTHER MISCELLANEOUS IS TO REMAIN UNDISTURBED AND TO BE PROTECTED UNLESS OTHERWISE
- 10. CONTRACTOR SHALL ADJUST ALL EXISTING UTILITY STRUCTURES AS REQUIRED TO MEET PROPOSED GRADES, INCLUDING DRAIN INLETS, MANHOLES AND LIGHT POLE BASES. CONTRACTOR SHALL MEET EXISTING GRADES AT ALL EDGES OF LIMITS OF WORK.
- 11. THE CONTRACTOR SHALL PROTECT THE WORK AND ALL NEARBY PEOPLE AND PROPERTY INCLUDING EXISTING BUILDINGS, PAVING, DRAINAGE STRUCTURES, FENCES, LAWNS, PLANTING, ETC. FROM DAMAGE. COST OF REPAIR, RESTORATION OR REPLACEMENT TO THEIR ORIGINAL OR BETTER CONDITION TO SITE COMPONENTS REMAINING OR WORK AREAS OUTSIDE OF LIMIT OF WORK SHALL BE AT CONTRACTOR'S EXPENSE UNLESS PROVISION FOR PAYMENT IS MADE IN THE PROPOSAL. ALL CONSTRUCTION AREAS SHALL BE RESTORED, INCLUDING GRADING, PAVING, SEEDING, ETC.
- 12. THE CONTRACTOR SHALL BE RESPONSIBLE FOR CLEAN-UP OF ANY MATERIALS DEPOSITED OUTSIDE THE WORK AREA. EXISTING CONSTRUCTION DRAINAGE SYSTEM AND EROSION CONTROL SHALL BE MAINTAINED, MODIFIED, AND/OR REMOVED AS NOTED ON CIVIL ENGINEERING PLANS.
- 13. THE CONTRACTOR SHALL ABIDE BY ALL APPLICABLE FEDERAL, STATE AND LOCAL ENVIRONMENTAL PROTECTION STANDARDS, LAWS AND REGULATIONS.
- 14. THE CONTRACTOR SHALL SCHEDULE WORK IN ACCORDANCE WITH ALL APPLICABLE FEDERAL, STATE AND LOCAL ENVIRONMENTAL PROTECTION STANDARDS, LAWS AND REGULATIONS.
- 15. FOLLOW FIGURED DIMENSIONS AND DO NOT SCALE CONTRACT DRAWINGS.

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1315 Walnut Street, Suite 1108 Philadelphia, PA. 19107

CIVIL ENGINEER KS Engineers, P.C. 530 Walnut Street, Suite 460 Philadelphia, PA. 19106

MEP ENGINEER Arora Engineers, Inc. 61 Wilmington-West Chester Pike, Chadds Ford, PA 19317

SREEK OUND PHA PA



STAMP:

JOB NO: 2131 DATE: 07/22/2022 DRAWN: NJ CHECKED: CM DRAWING TITLE:

DRAWING LIST AND GENERAL NOTES

DRAWING NO: G-000

AGGREGATE

CONCRETE

ALUMINUM

SHEET 01 OF 22

SYMBOL LEGEND

ABBREVIATIONS

SQUARE

LINEAR FOOT

FOOT

GAUGE

TYPICAL

EXISTING

VERIFY IN FIELD

POURED IN PLACE

CRITICAL ROOT ZONE

FINISH GRADE


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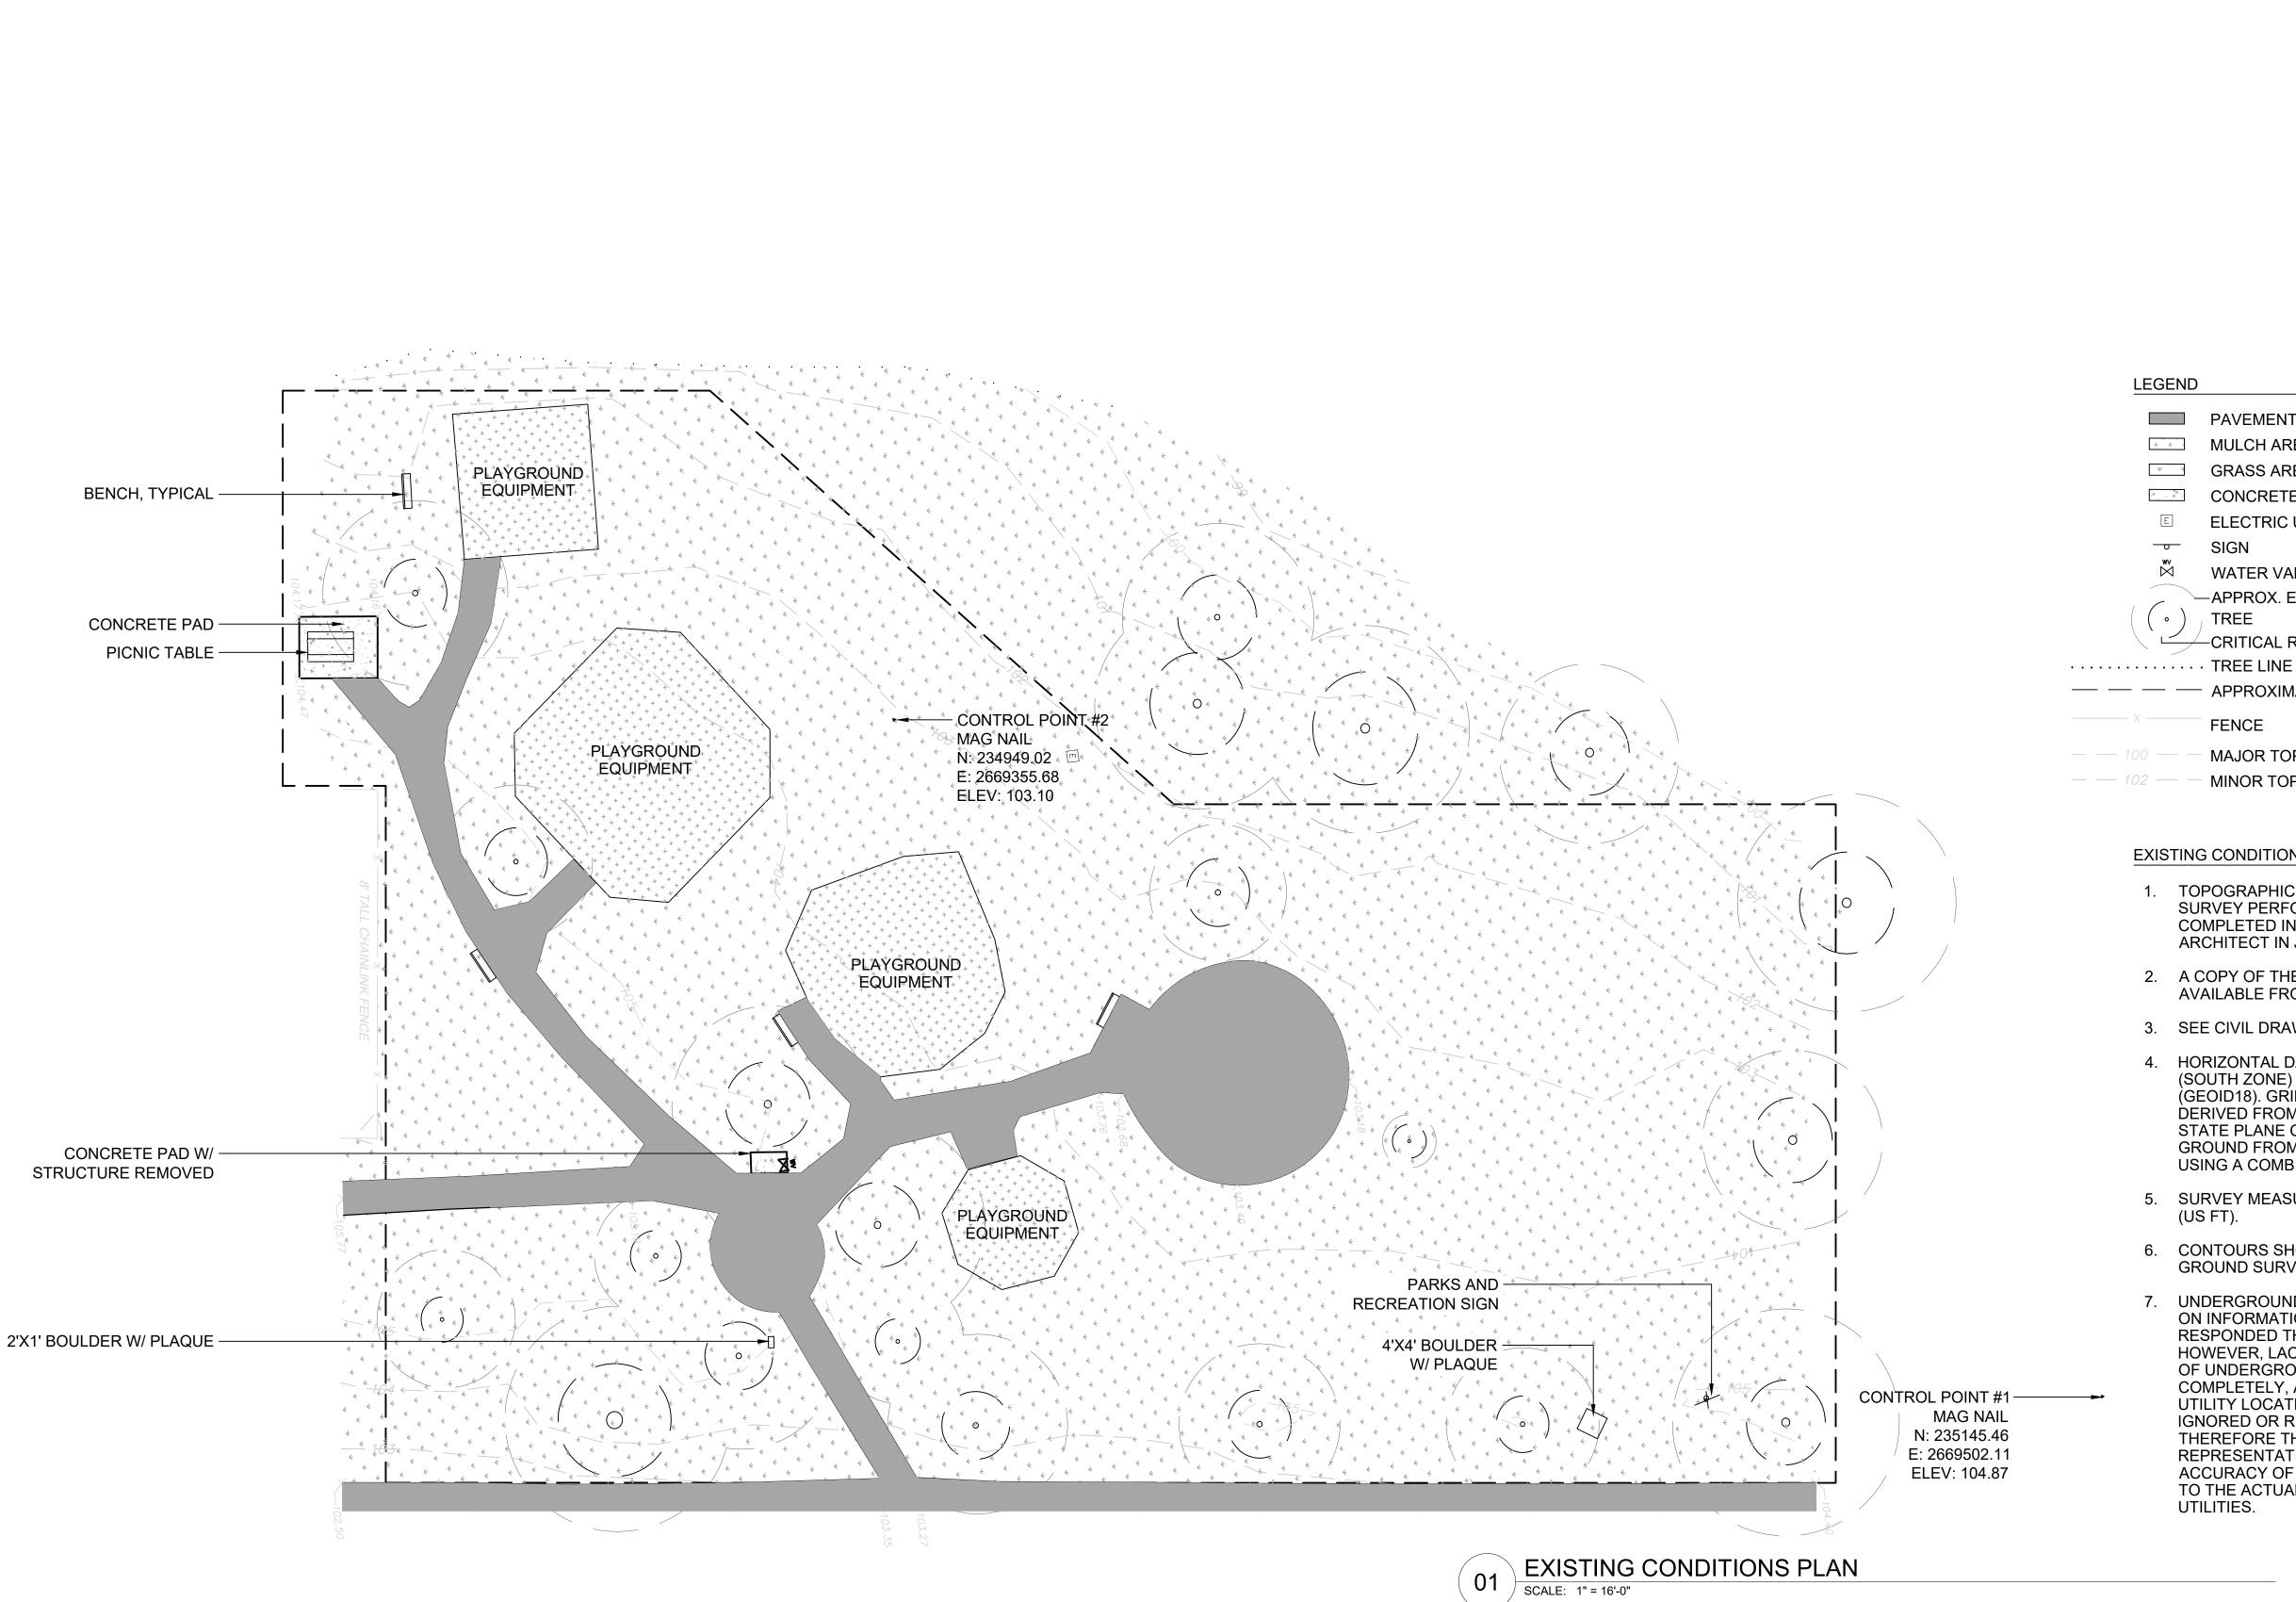
TO BE DETERMINED

POINT OF BEGINNING

PHILADELPHIA PARKS & RECREATION



MATERIAL TAGS

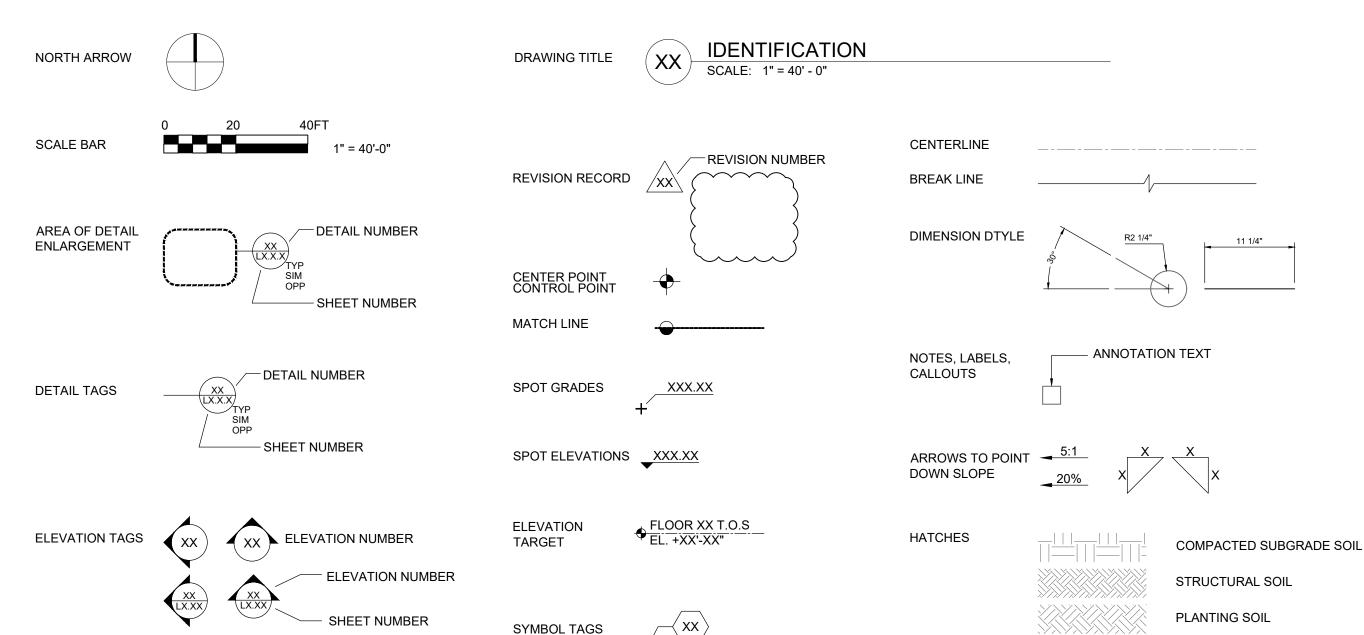

LEGEND

PAVEMENT AREAS

MULCH AREAS

GRASS AREAS

CONCRETE AREAS

ELECTRIC UTILITY VAULT

WATER VALVE

—APPROX. EXTENTS OF CANOPY

CRITICAL ROOT ZONE

APPROXIMATE ROAD RIGHT OF WAY LINE

FENCE


MAJOR TOPOGRAPHIC CONTOUR LINE WITH ELEVATION

MINOR TOPOGRAPHIC CONTOUR LINE WITH ELEVATION

EXISTING CONDITIONS NOTES:

- 1. TOPOGRAPHIC INFORMATION SHOWN IS BASED ON A FIELD SURVEY PERFORMED BY SCI-TEK CONSULTANTS, INC., COMPLETED IN JANUARY 2021 AND PROVIDED TO THE ARCHITECT IN JUNE 2021.
- 2. A COPY OF THE SIGNED AND STAMPED SURVEY IS AVAILABLE FROM THE CLIENT UPON REQUEST.
- 3. SEE CIVIL DRAWINGS FOR UTILITY LOCATIONS.
- 4. HORIZONTAL DATUM: PA STATE PLANE COORDINATES (SOUTH ZONE) NAD83(2011); VERTICAL DATUM: NAVD88 (GEOID18). GRID NORTH, BÉARINGS AND ELEVATIONS DERIVED FROM THE KEYNET GPS VRS NETWORK. THE STATE PLANE COORDINATES HAVE BEEN SCALED TO GROUND FROM A POINT AT N: 234949.02 AND E:2669355.68 USING A COMBINED FACTOR OF 1.0000024745.
- 5. SURVEY MEASUREMENTS WERE MADE IN US SURVEY FEET (US FT).
- 6. CONTOURS SHOWN WERE PRODUCED FROM AN ACTUAL GROUND SURVEY. CONTOUR INTERVAL IS 1 FOOT.
- 7. UNDERGROUND UTILITY LOCATIONS SHOWN ARE BASED ON INFORMATION PROVIDED BY UTILITY COMPANIES THAT RESPONDED THROUGH THE PA ONE CALL SYSTEM. HOWEVER, LACKING EXCAVATION, THE EXACT LOCATION OF UNDERGROUND UTILITIES CANNOT BE ACCURATELY, COMPLETELY, AND RELIABLY DEPICTED. IN ADDITION, UTILITY LOCATION REQUESTS FROM SURVEYORS MAY BE IGNORED OR RESULT IN AN INCOMPLETE RESPONSE. THEREFORE THE SURVEYOR MAKES NO REPRESENTATIONS AS TO THE COMPLETENESS OR ACCURACY OF THE PROVIDED MARKINGS WITH RESPECT TO THE ACTUAL LOCATIONS OF THE UNDERGROUND UTILITIES.



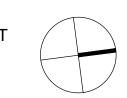



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Philadelphia, PA. 19106

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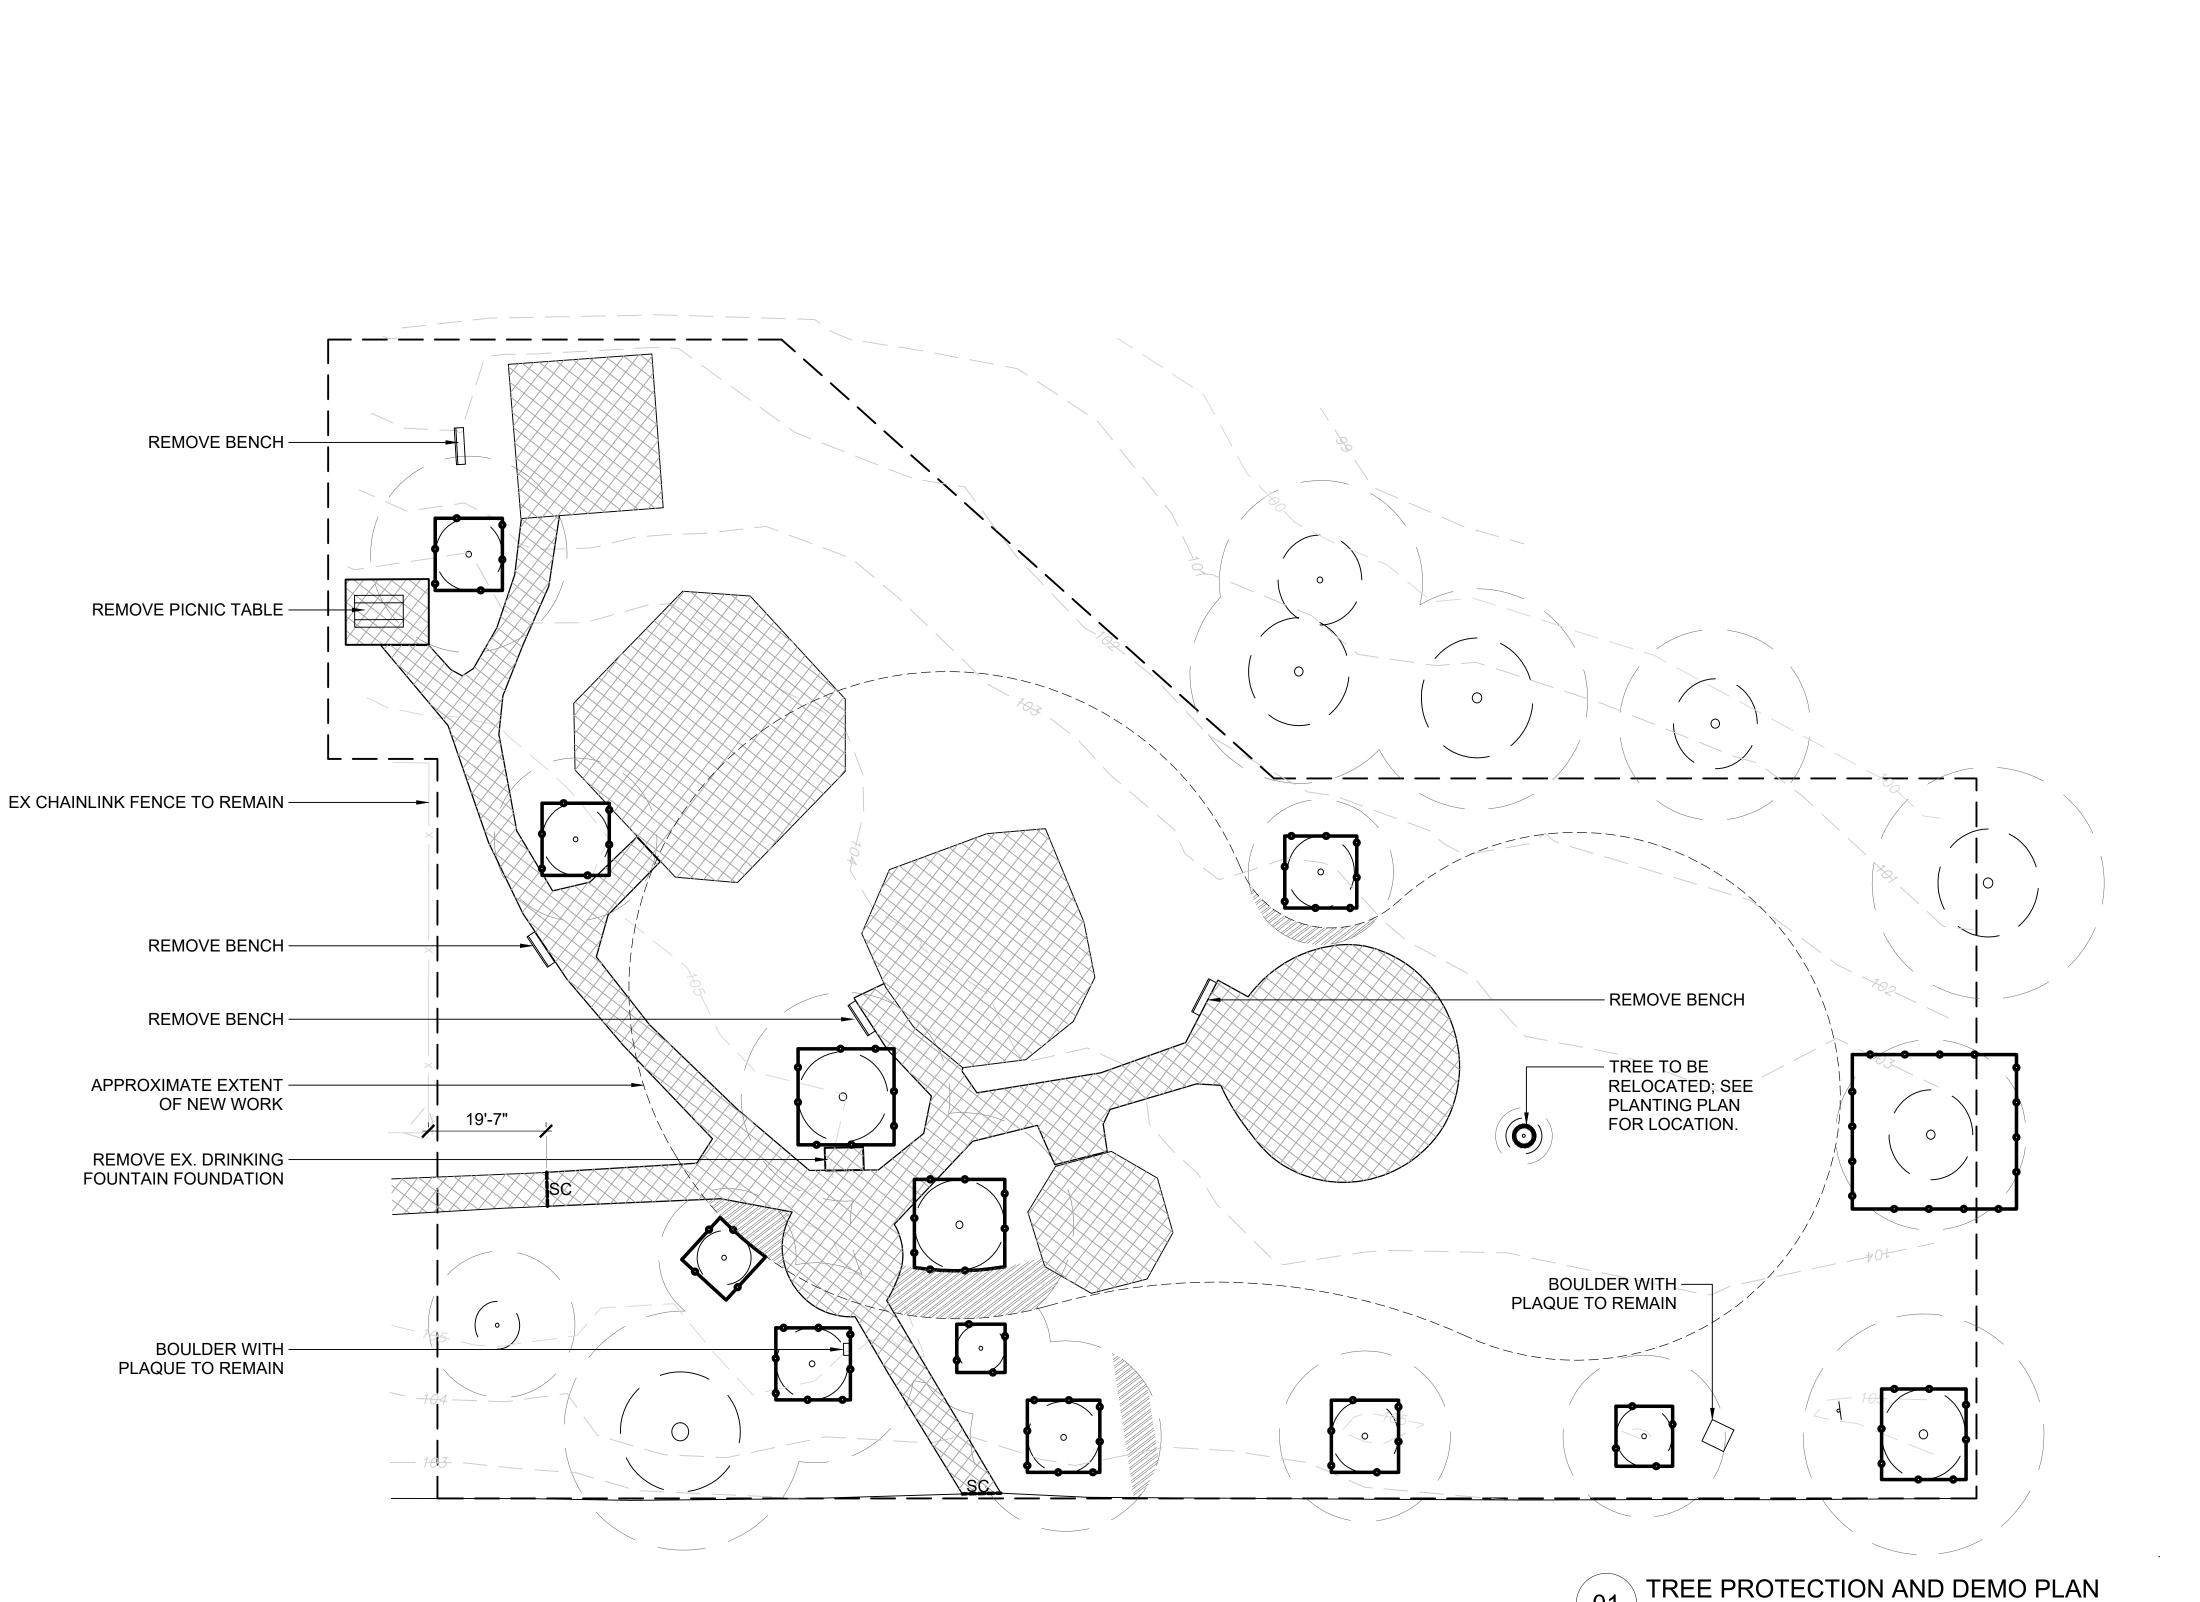
KS Engineers, P.C. 530 Walnut Street, Suite 460

JOB NO: 2131 DATE: 07/22/2022 DRAWN: NJ CHECKED: CM **DRAWING TITLE:**

EXISTING CONDITIONS **PLAN**

DRAWING NO:

G-100 SHEET 02 OF 22



LEGEND


LIMIT OF WORK, NO DISTURBANCE

APPROXIMATE EXTENT OF NEW WORK

TREE PROTECTION FENCE, REFER TO 1/L202 FOR DETAILS

REMOVE ASPHALT, CONCRETE, SAFETY SURFACE, & PLAY EQPT

AIR EXCAVATION + ROOT PRESERVATION ZONE. REFER TO 2/L202 FOR DETAILS. REFER TO SPECIFICATIONS FOR PROCEDURES.

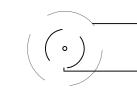

-APPROX. EXTENTS OF CANOPY EXISTING TREE TO REMAIN -CRITICAL ROOT ZONE





EXISTING TREE TO BE REMOVED AND RELOCATED

SAW CUT EXISTING PAVEMENT

TREE PROTECTION NOTES

- 1. ALL EXISTING TREES TO REMAIN SHALL BE PROTECTED WITH TREE PROTECTION FENCING. LOCATION OF TREE PROTECTION FENCING IS INDICATED ON DRAWINGS.
- 2. TREE PROTECTION FENCE SHALL BE MAINTAINED FOR THE DURATION OF THE CONSTRUCTION PROCESS. IF TREE PROTECTION IS MOVED OR REMOVED FOR THE INSTALLATION OF THE WORK REPLACE IT IMMEDIATELY AT THE COMPLETION OF THE WORK.
- 3. TRENCHING OR EXCAVATION WITHIN THE TREE PROTECTION FENCE SHALL BE COMPLETED WITH EXTREME CARE AND UNDER THE SUPERVISION OF A CERTIFIED ARBORIST. USE HAND TOOLS ONLY.
- 4. AVOID DAMAGING EXISTING TREES. DAMAGE INCLUDES BUT IS NOT LIMITED TO: CUTTING, BREAKING, SKINNING, OR COMPACTING OF ROOTS, SKINNING AND BRUISING OF BARK AND BREAKING OF BRANCHES AND LIMBS.
- 5. CONTRACTOR SHALL NOT PARK OR STORE EQUIPMENT AND SUPPLIES WITHIN THE TREE PROTECTION FENCING.
- IF AREA WITHIN DRIP LINES OF TREES IS IMPACTED BY CONSTRUCTION ACTIVITY, TREES SHALL BE REPLACED AT THE CONTRACTOR'S EXPENSE. IF REPLACEMENT TREES ARE NEEDED, ARCHITECT WILL SPECIFY TREE SPECIES, SIZE, AND EXACT REPLACEMENT LOCATIONS.

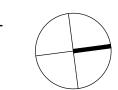

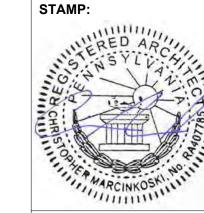

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Philadelphia, PA. 19106

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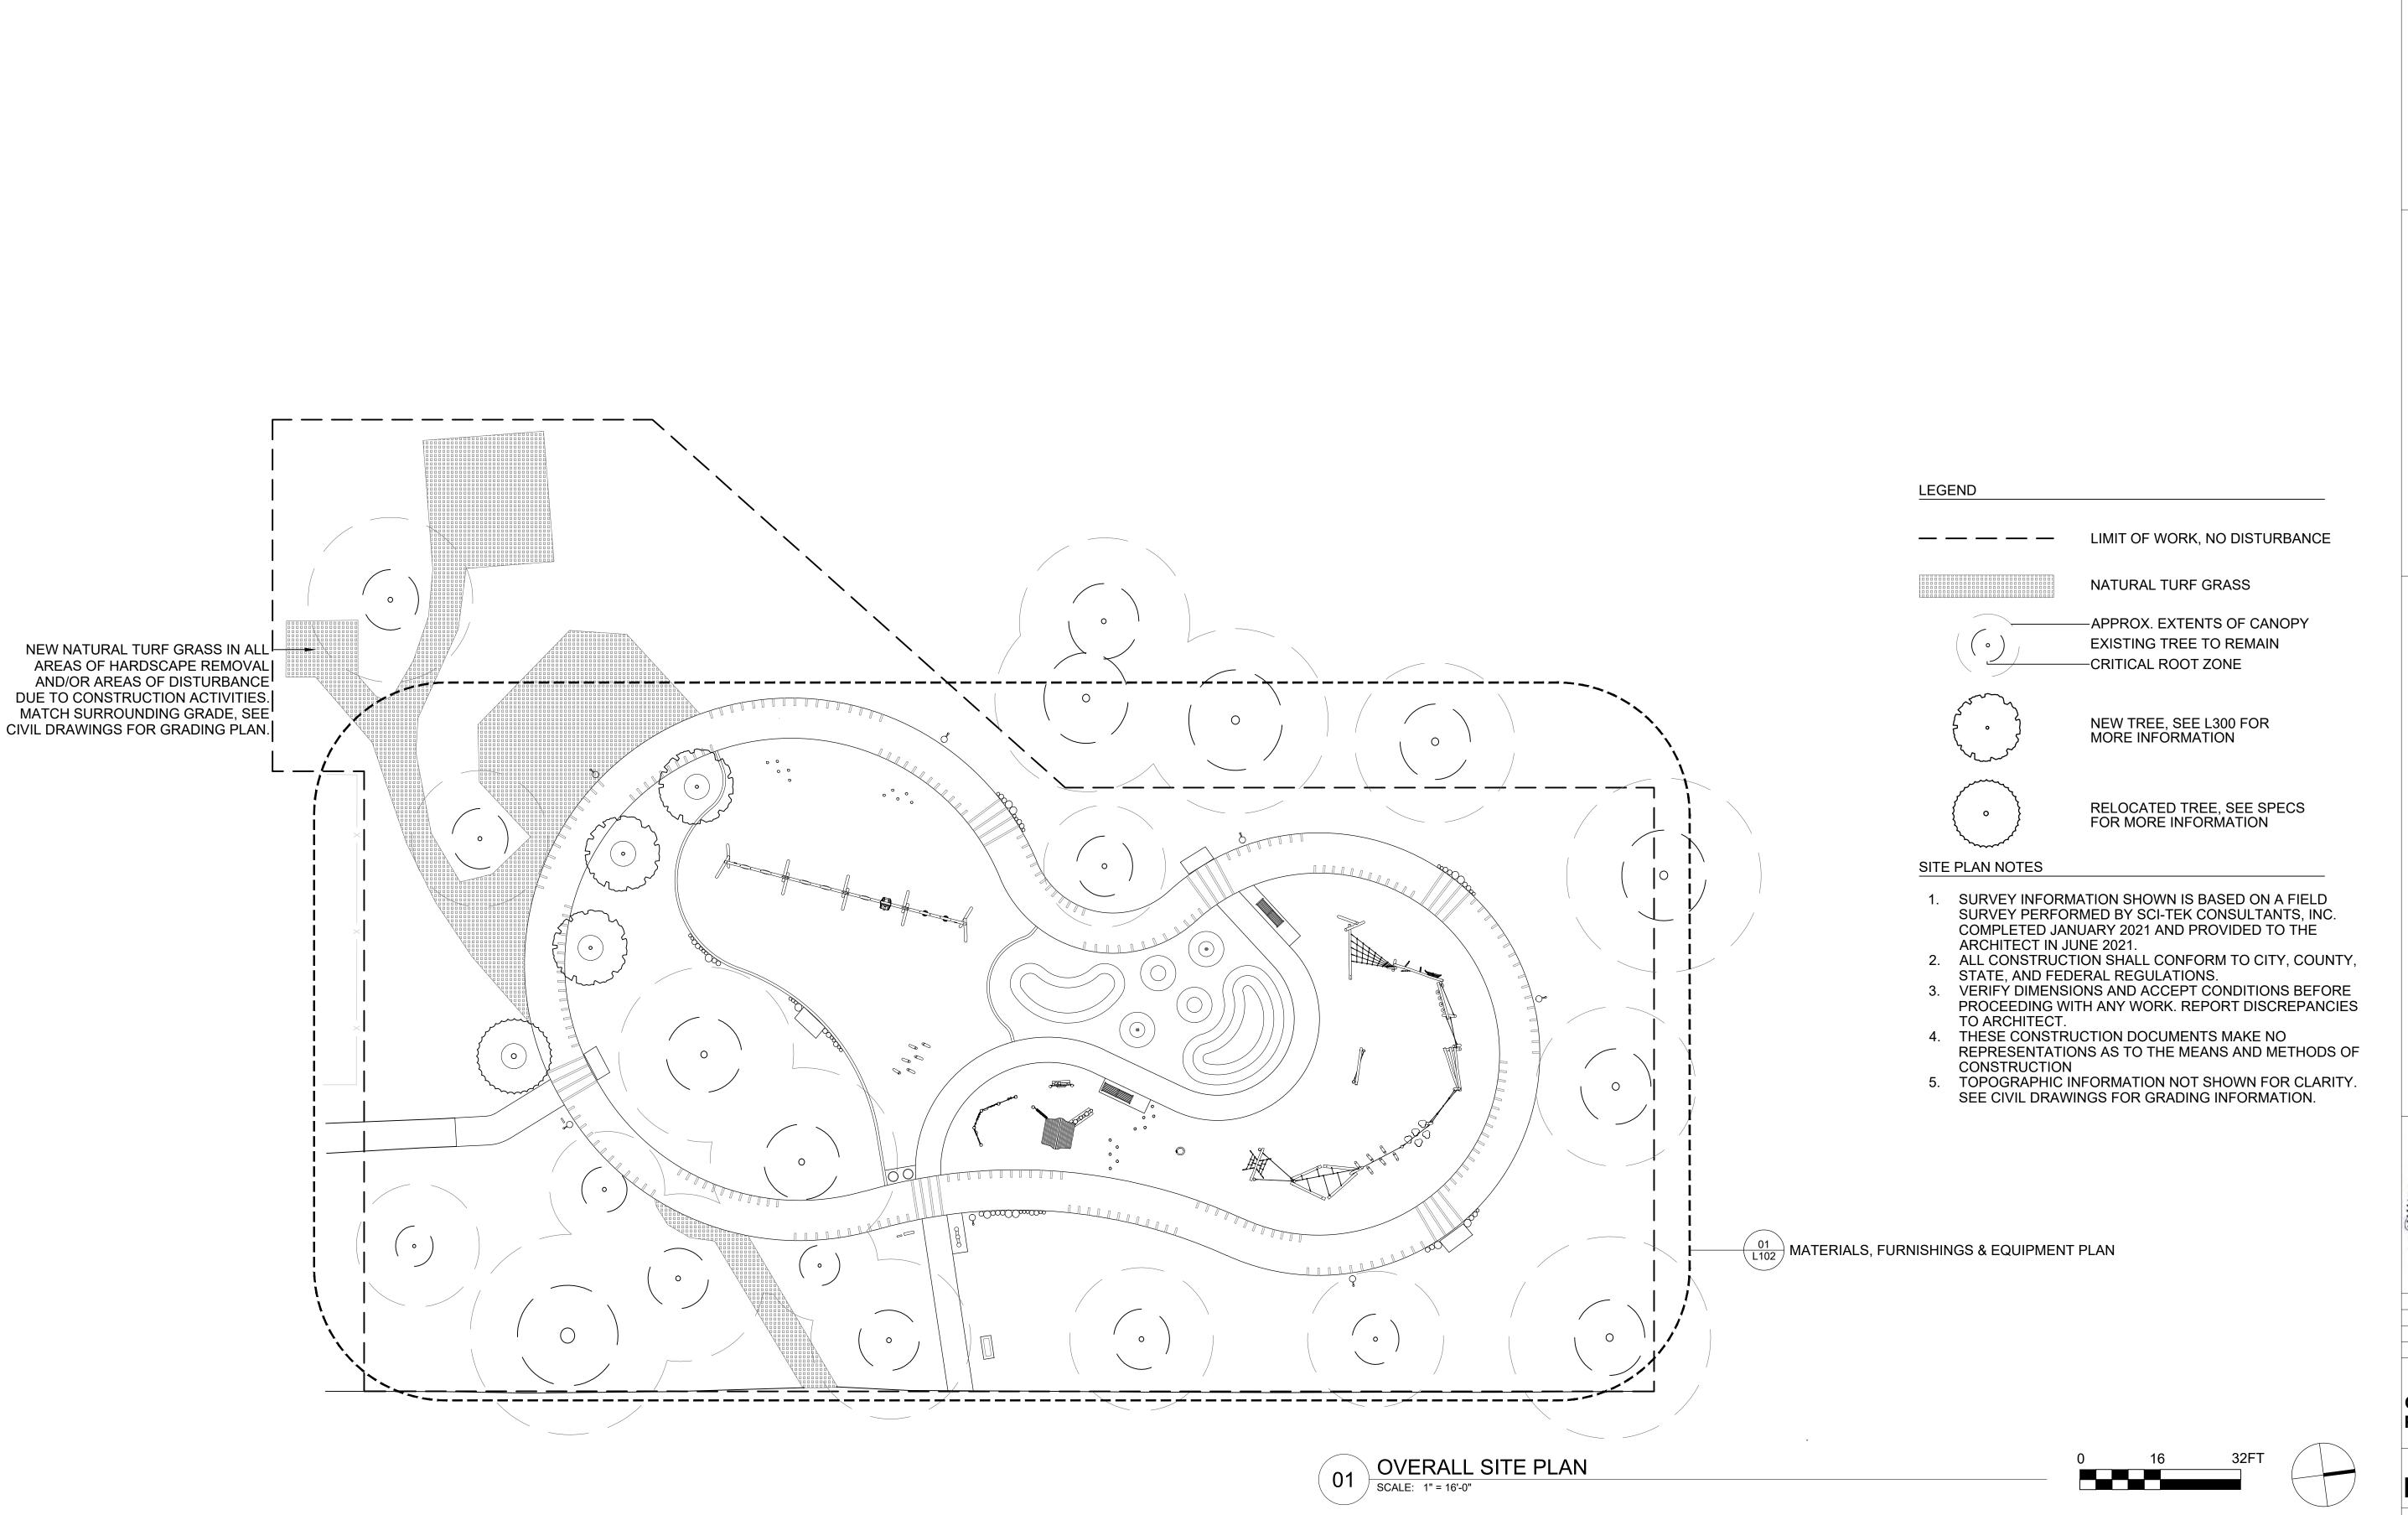
JOB NO: 2131 DATE: 07/22/2022 DRAWN: NJ CHECKED: CM DRAWING TITLE:

TREE PROTECTION AND **DEMO PLAN**

DRAWING NO:

L-100 SHEET 03 OF 22

SCALE: 1" = 16'-0"



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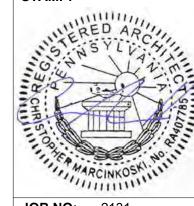
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OBBS CREEK LAYGROUND HILADELPHIA, PA

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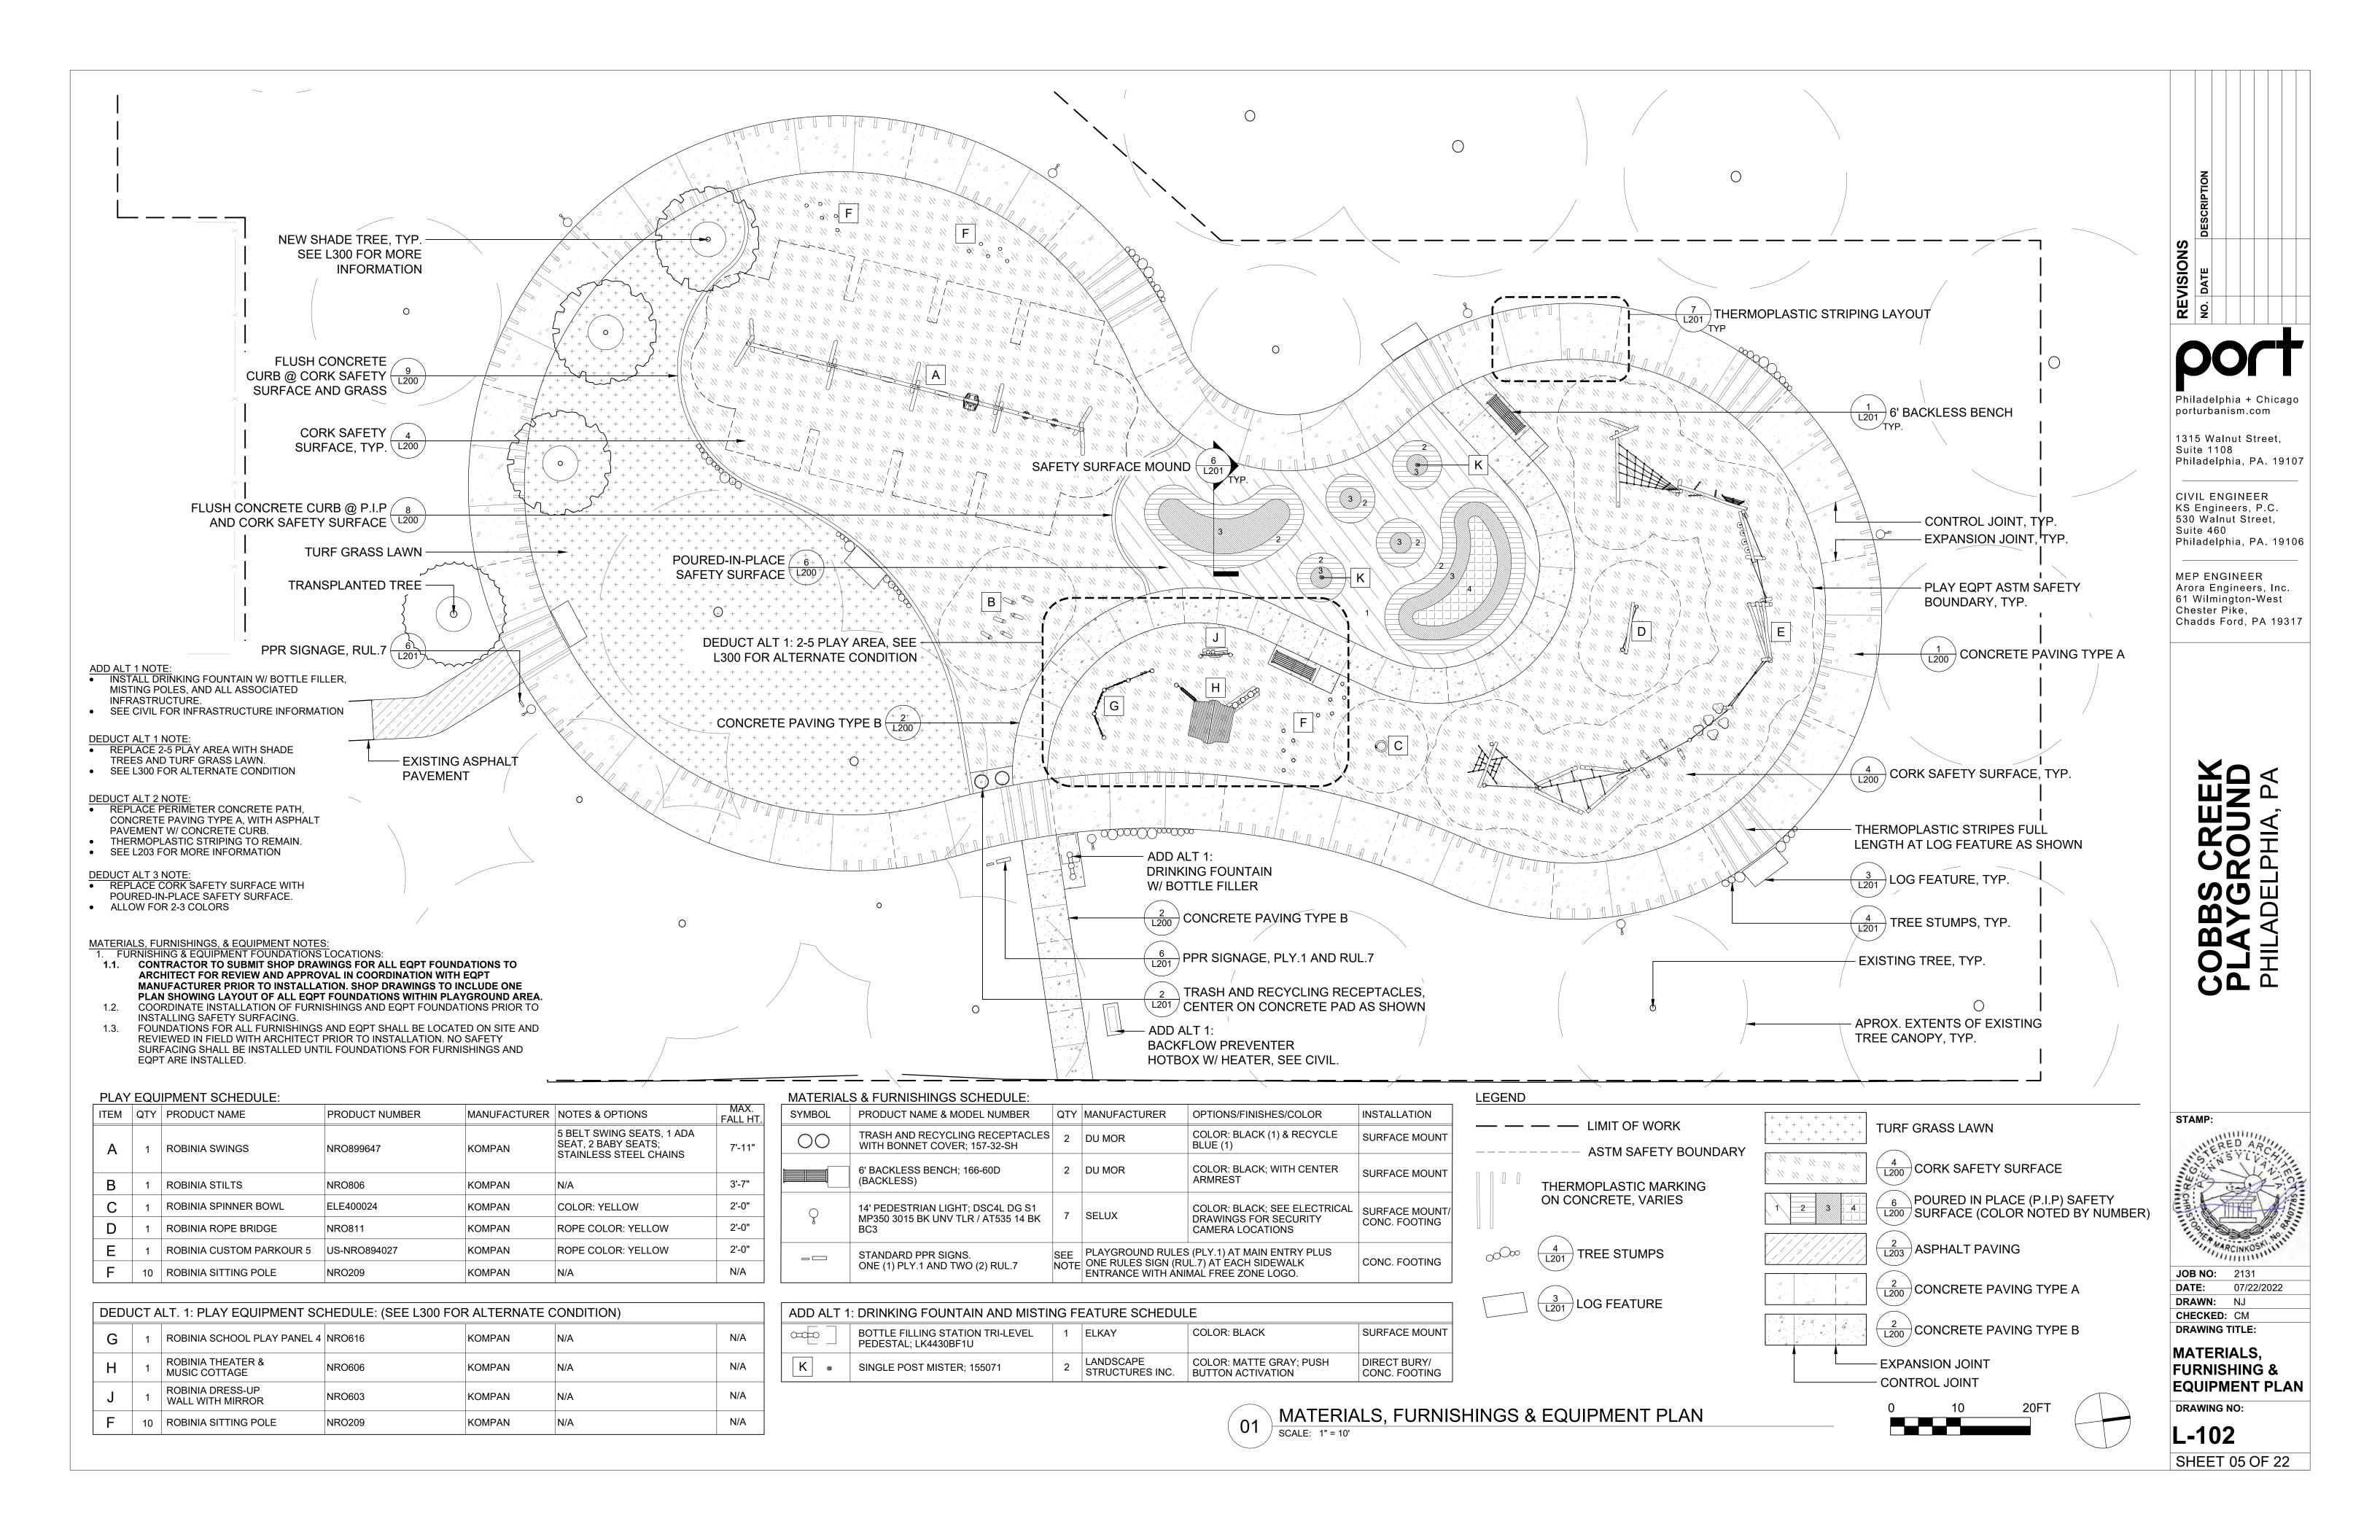



JOB NO: 2131
DATE: 07/22/2022
DRAWN: NJ
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OVERALL SITE PLAN

DRAWING NO:

L-101SHEET 04 OF 22



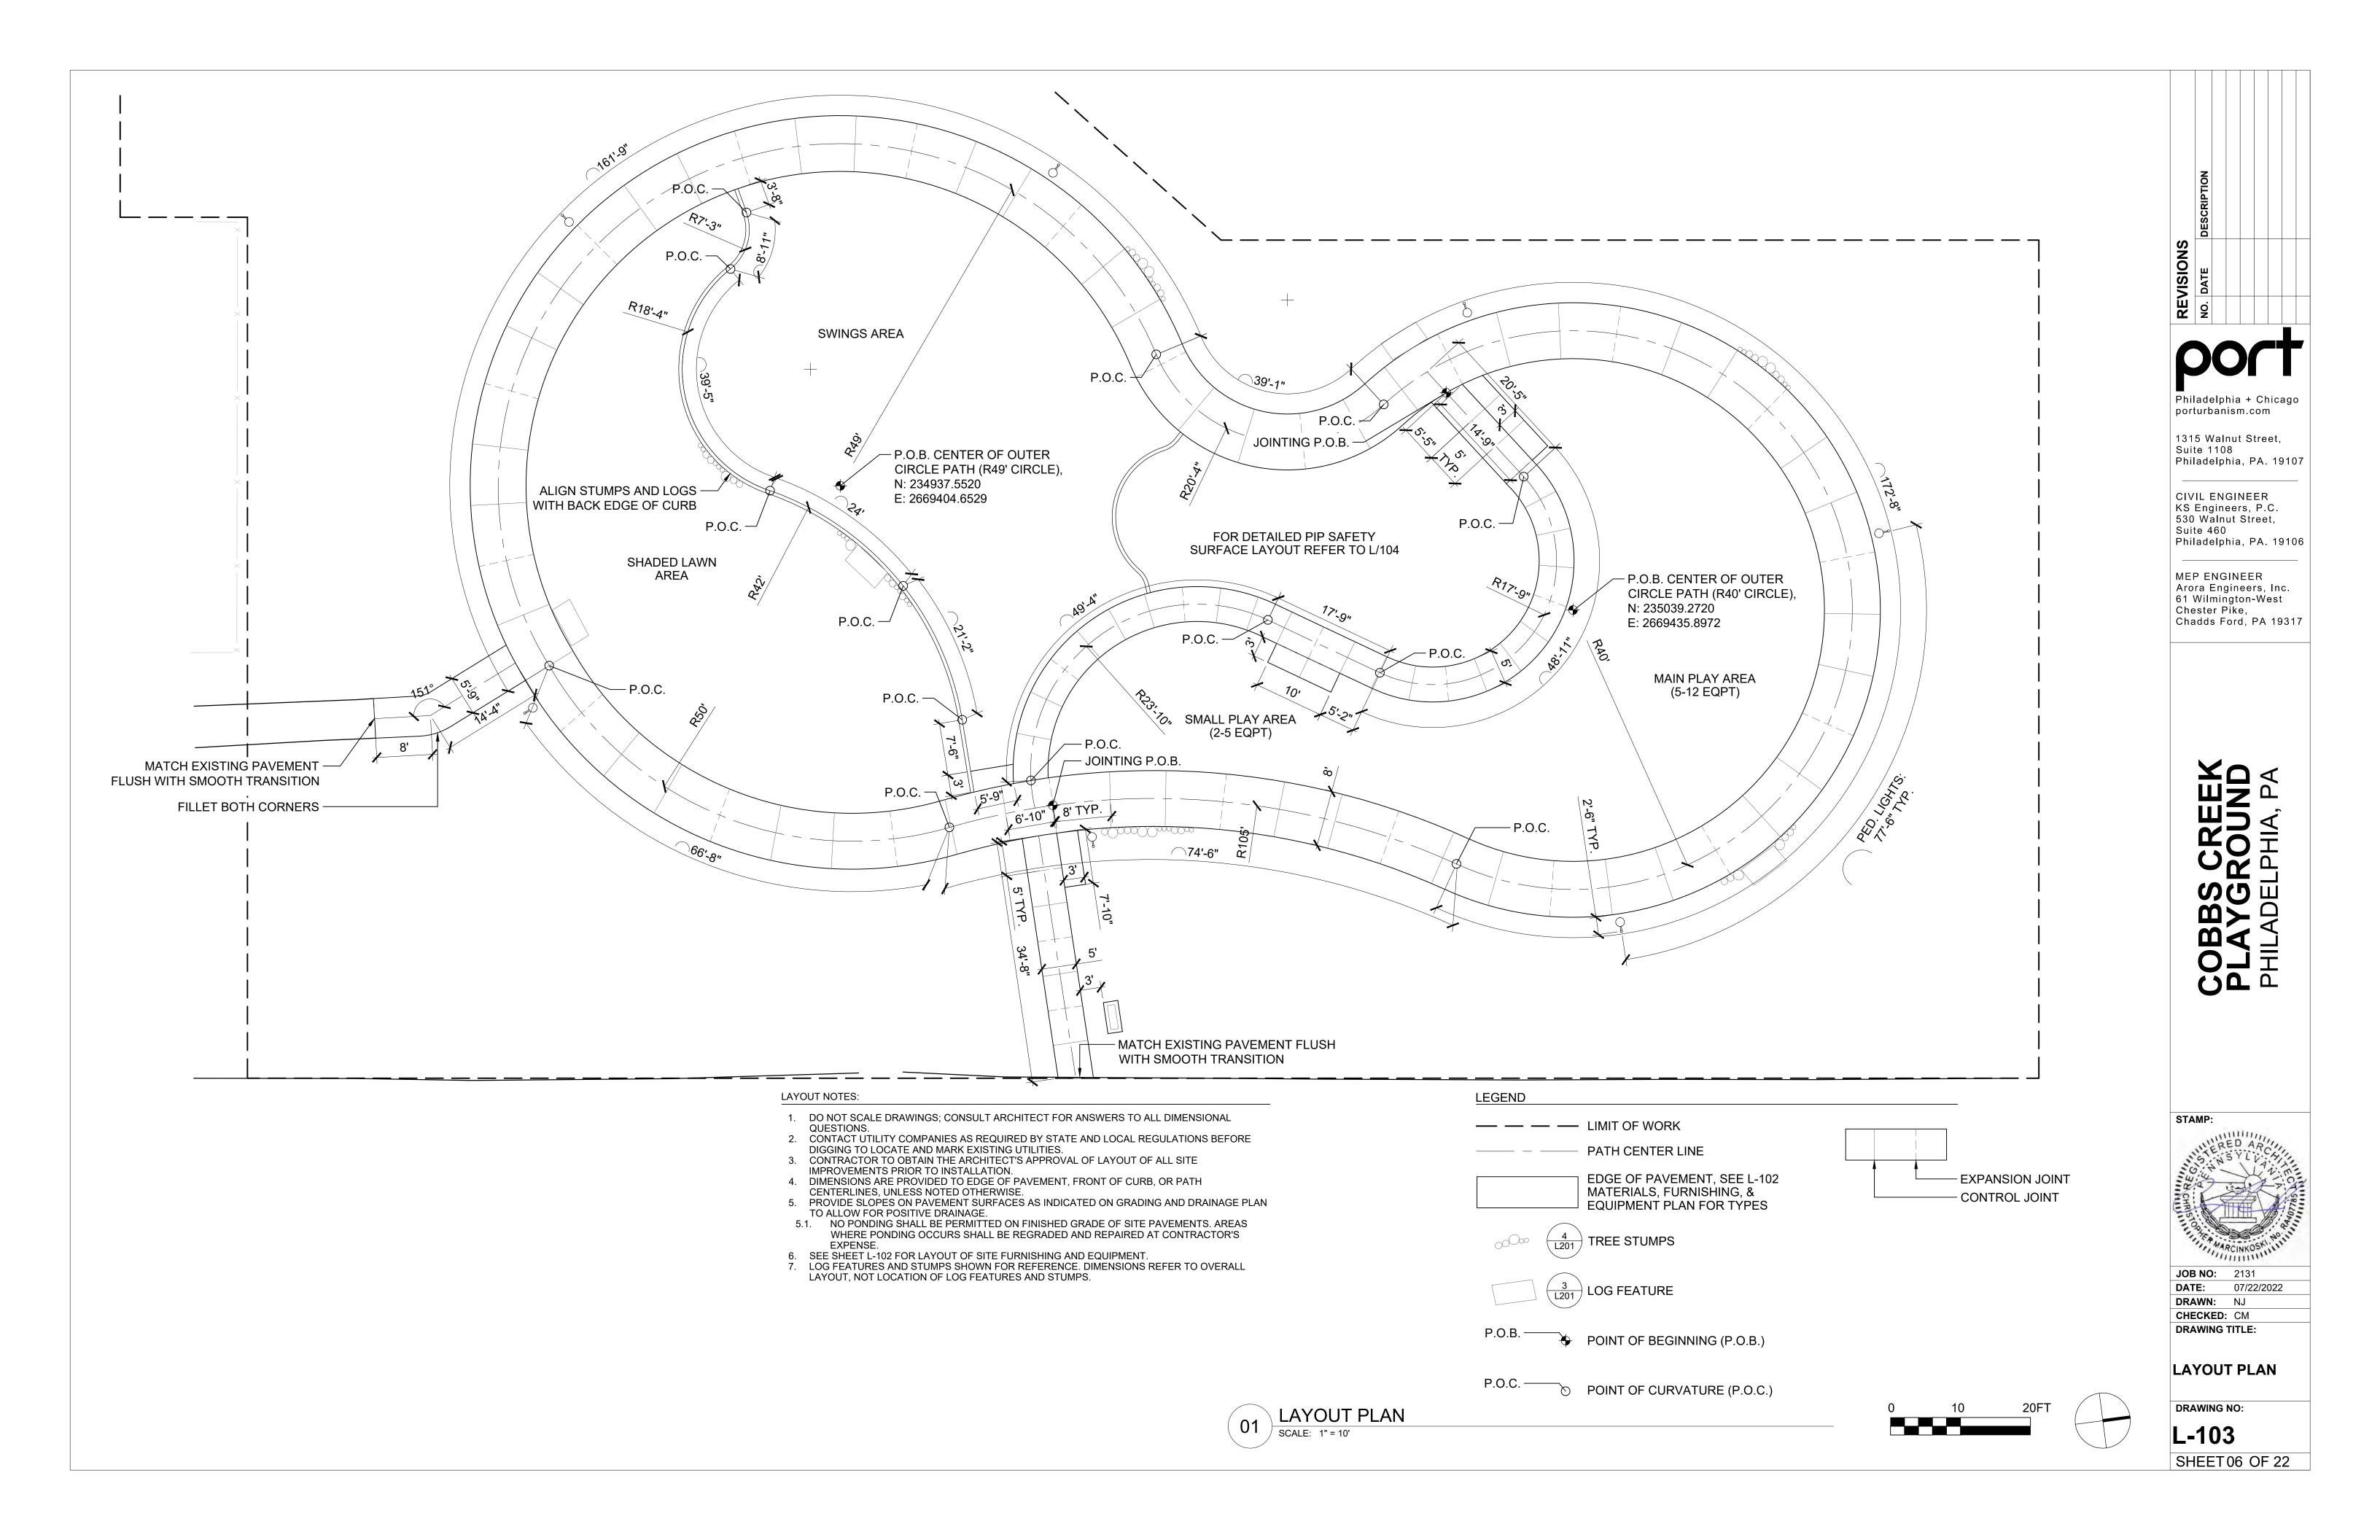


NO MOUND IF MISTING -FEATURE INCLUDED SMALL MOUND, TYP. -**◯**34'-3" R10' R3'-6"\TYP. R1'-6" TYP. [\]_ R5' MEDIUM MOUND R13' — LARGE MOUND P.O.C. — **─18'-4**" NO MOUND IF MISTING -FEATURE INCLUDED 3'-1" PIP SAFETY SURFACE DETAIL LAYOUT PLAN

SCALE: 1/4" = 1'-0"

NOTE:


1. SEE 5 / L201 FOR TYPICAL MOUND DETAIL

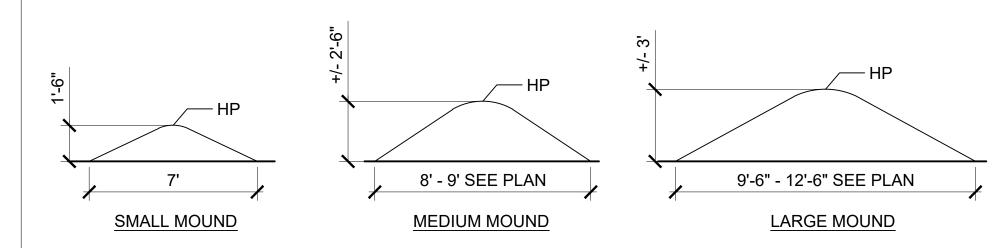

2 PLAY MOUND TYPICAL ELEVATIONS
SCALE: 1/4" = 1'-0"





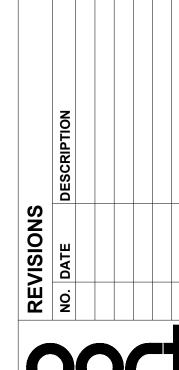


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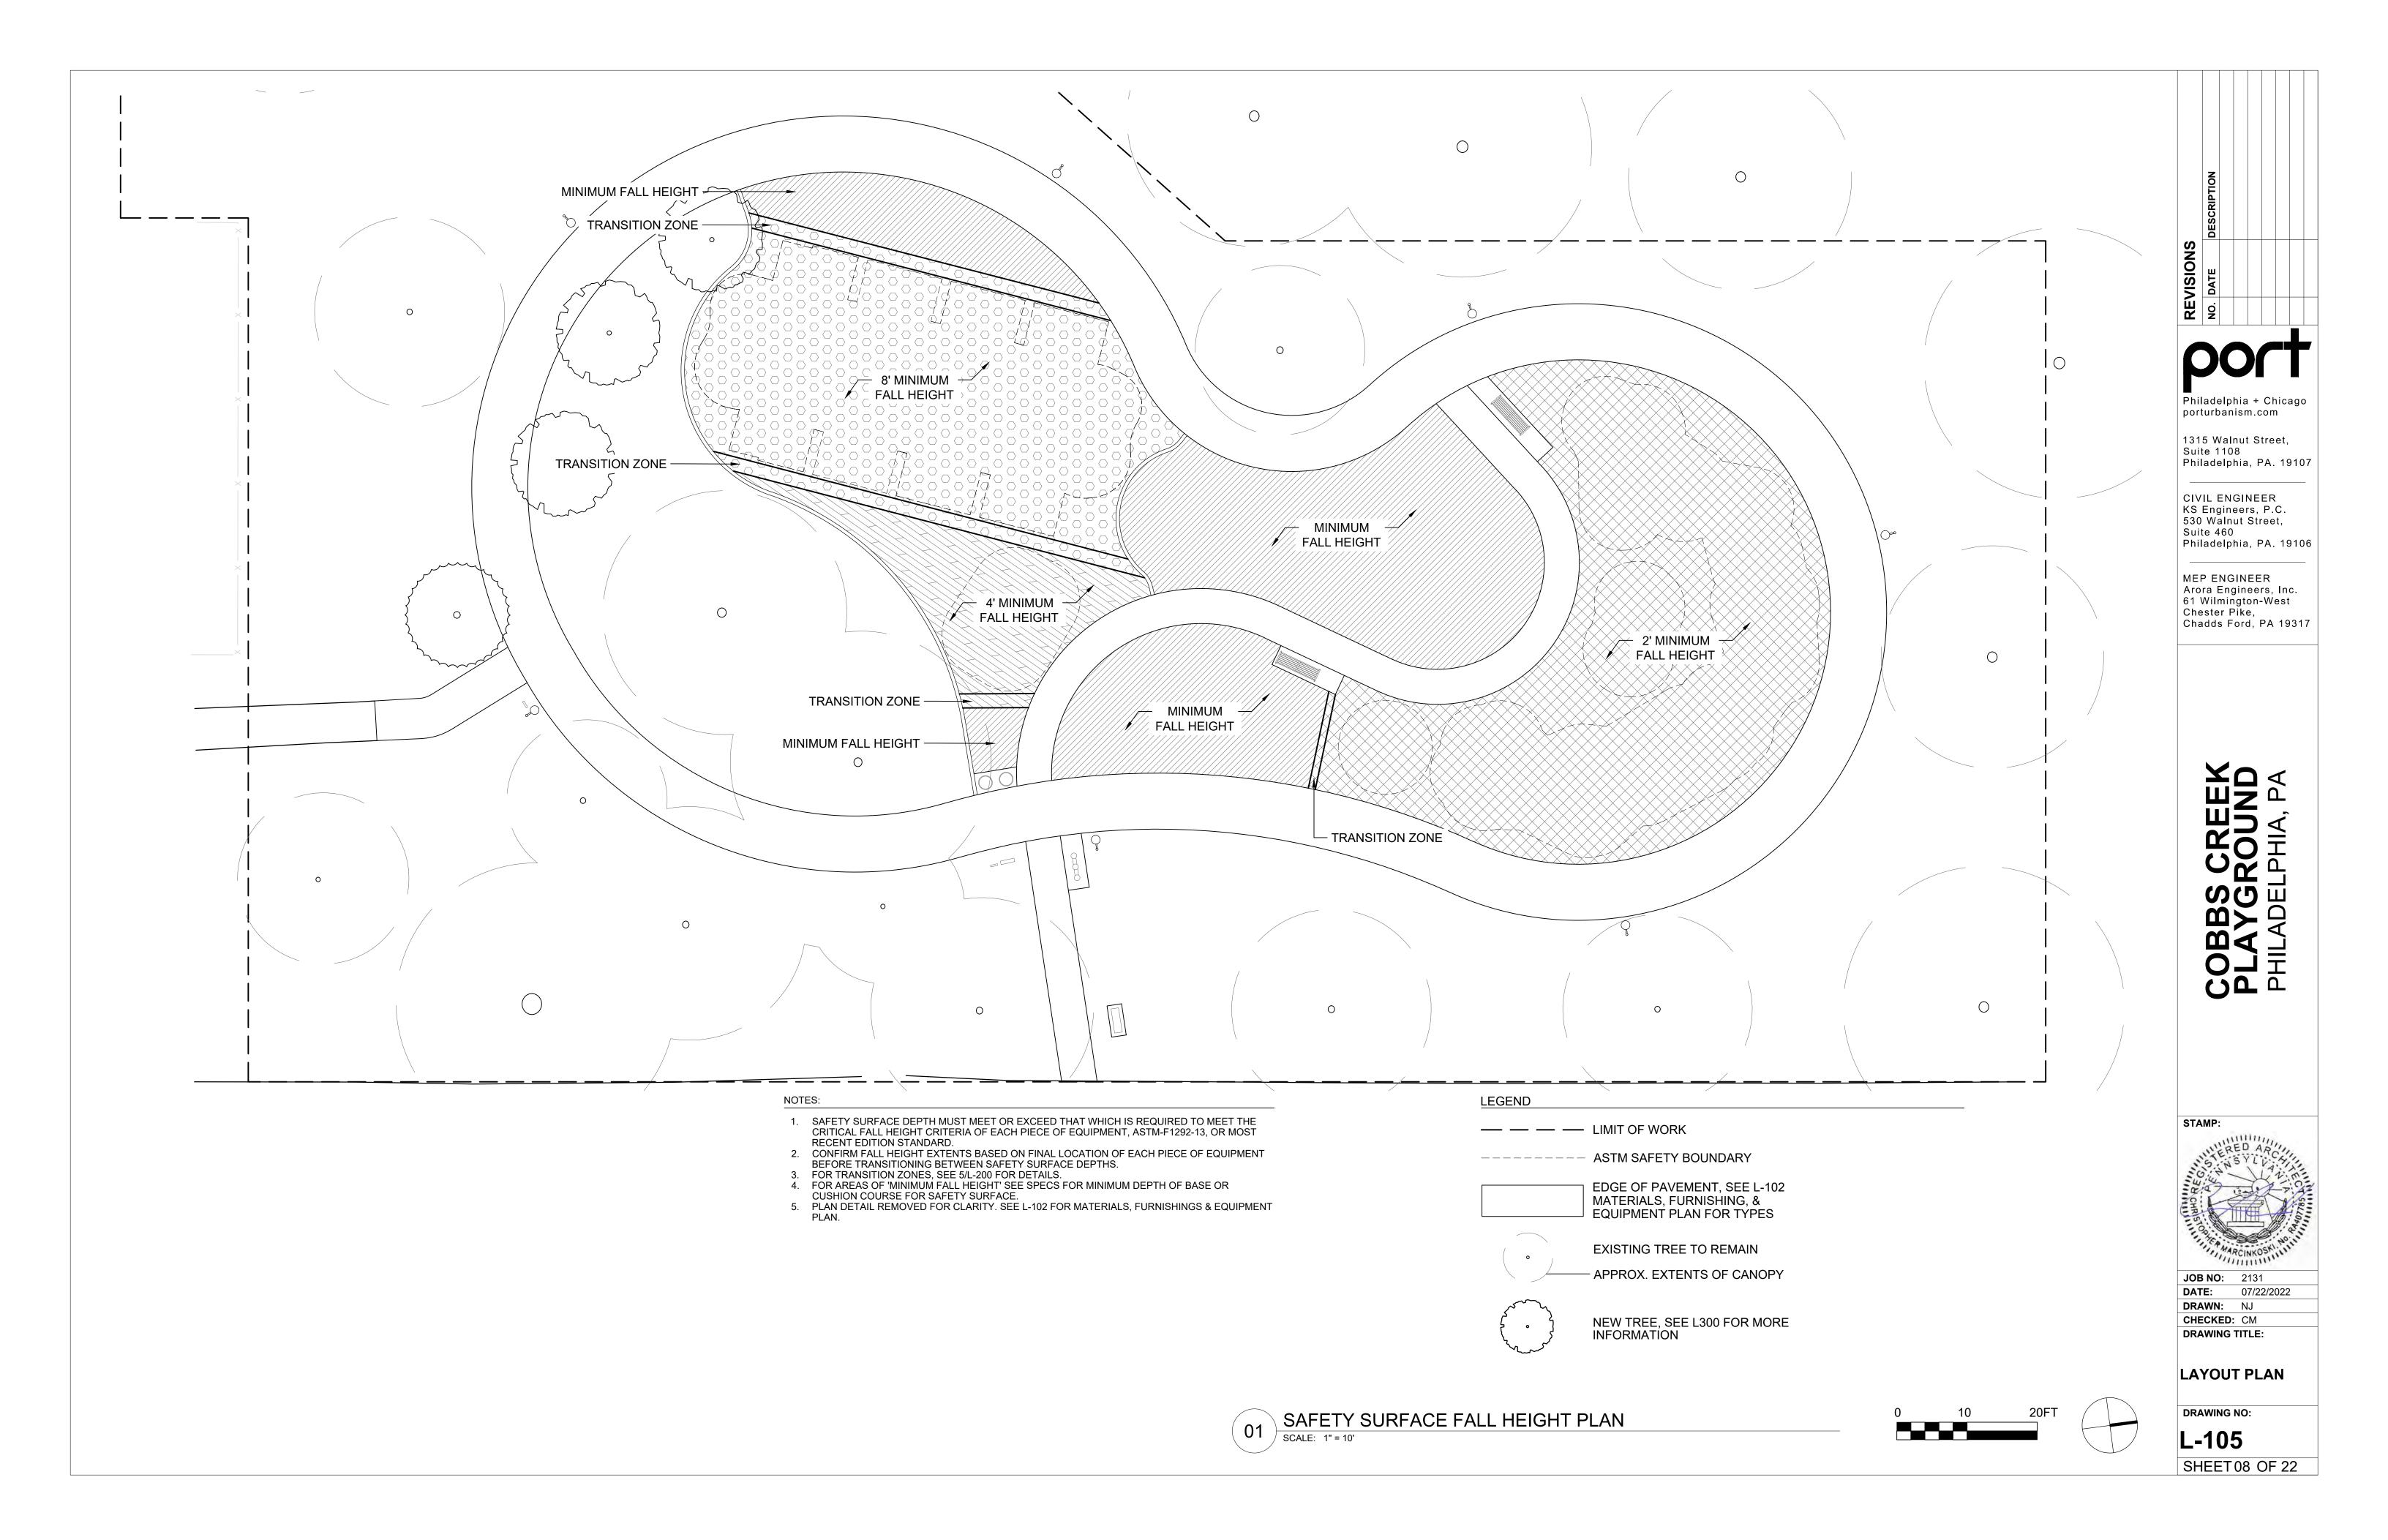



JOB NO: 2131 07/22/2022 DATE: DRAWN: NJ CHECKED: CM DRAWING TITLE:

DETAIL LAYOUT PLANS

DRAWING NO:

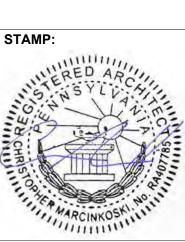L-104 SHEET 07 OF 22



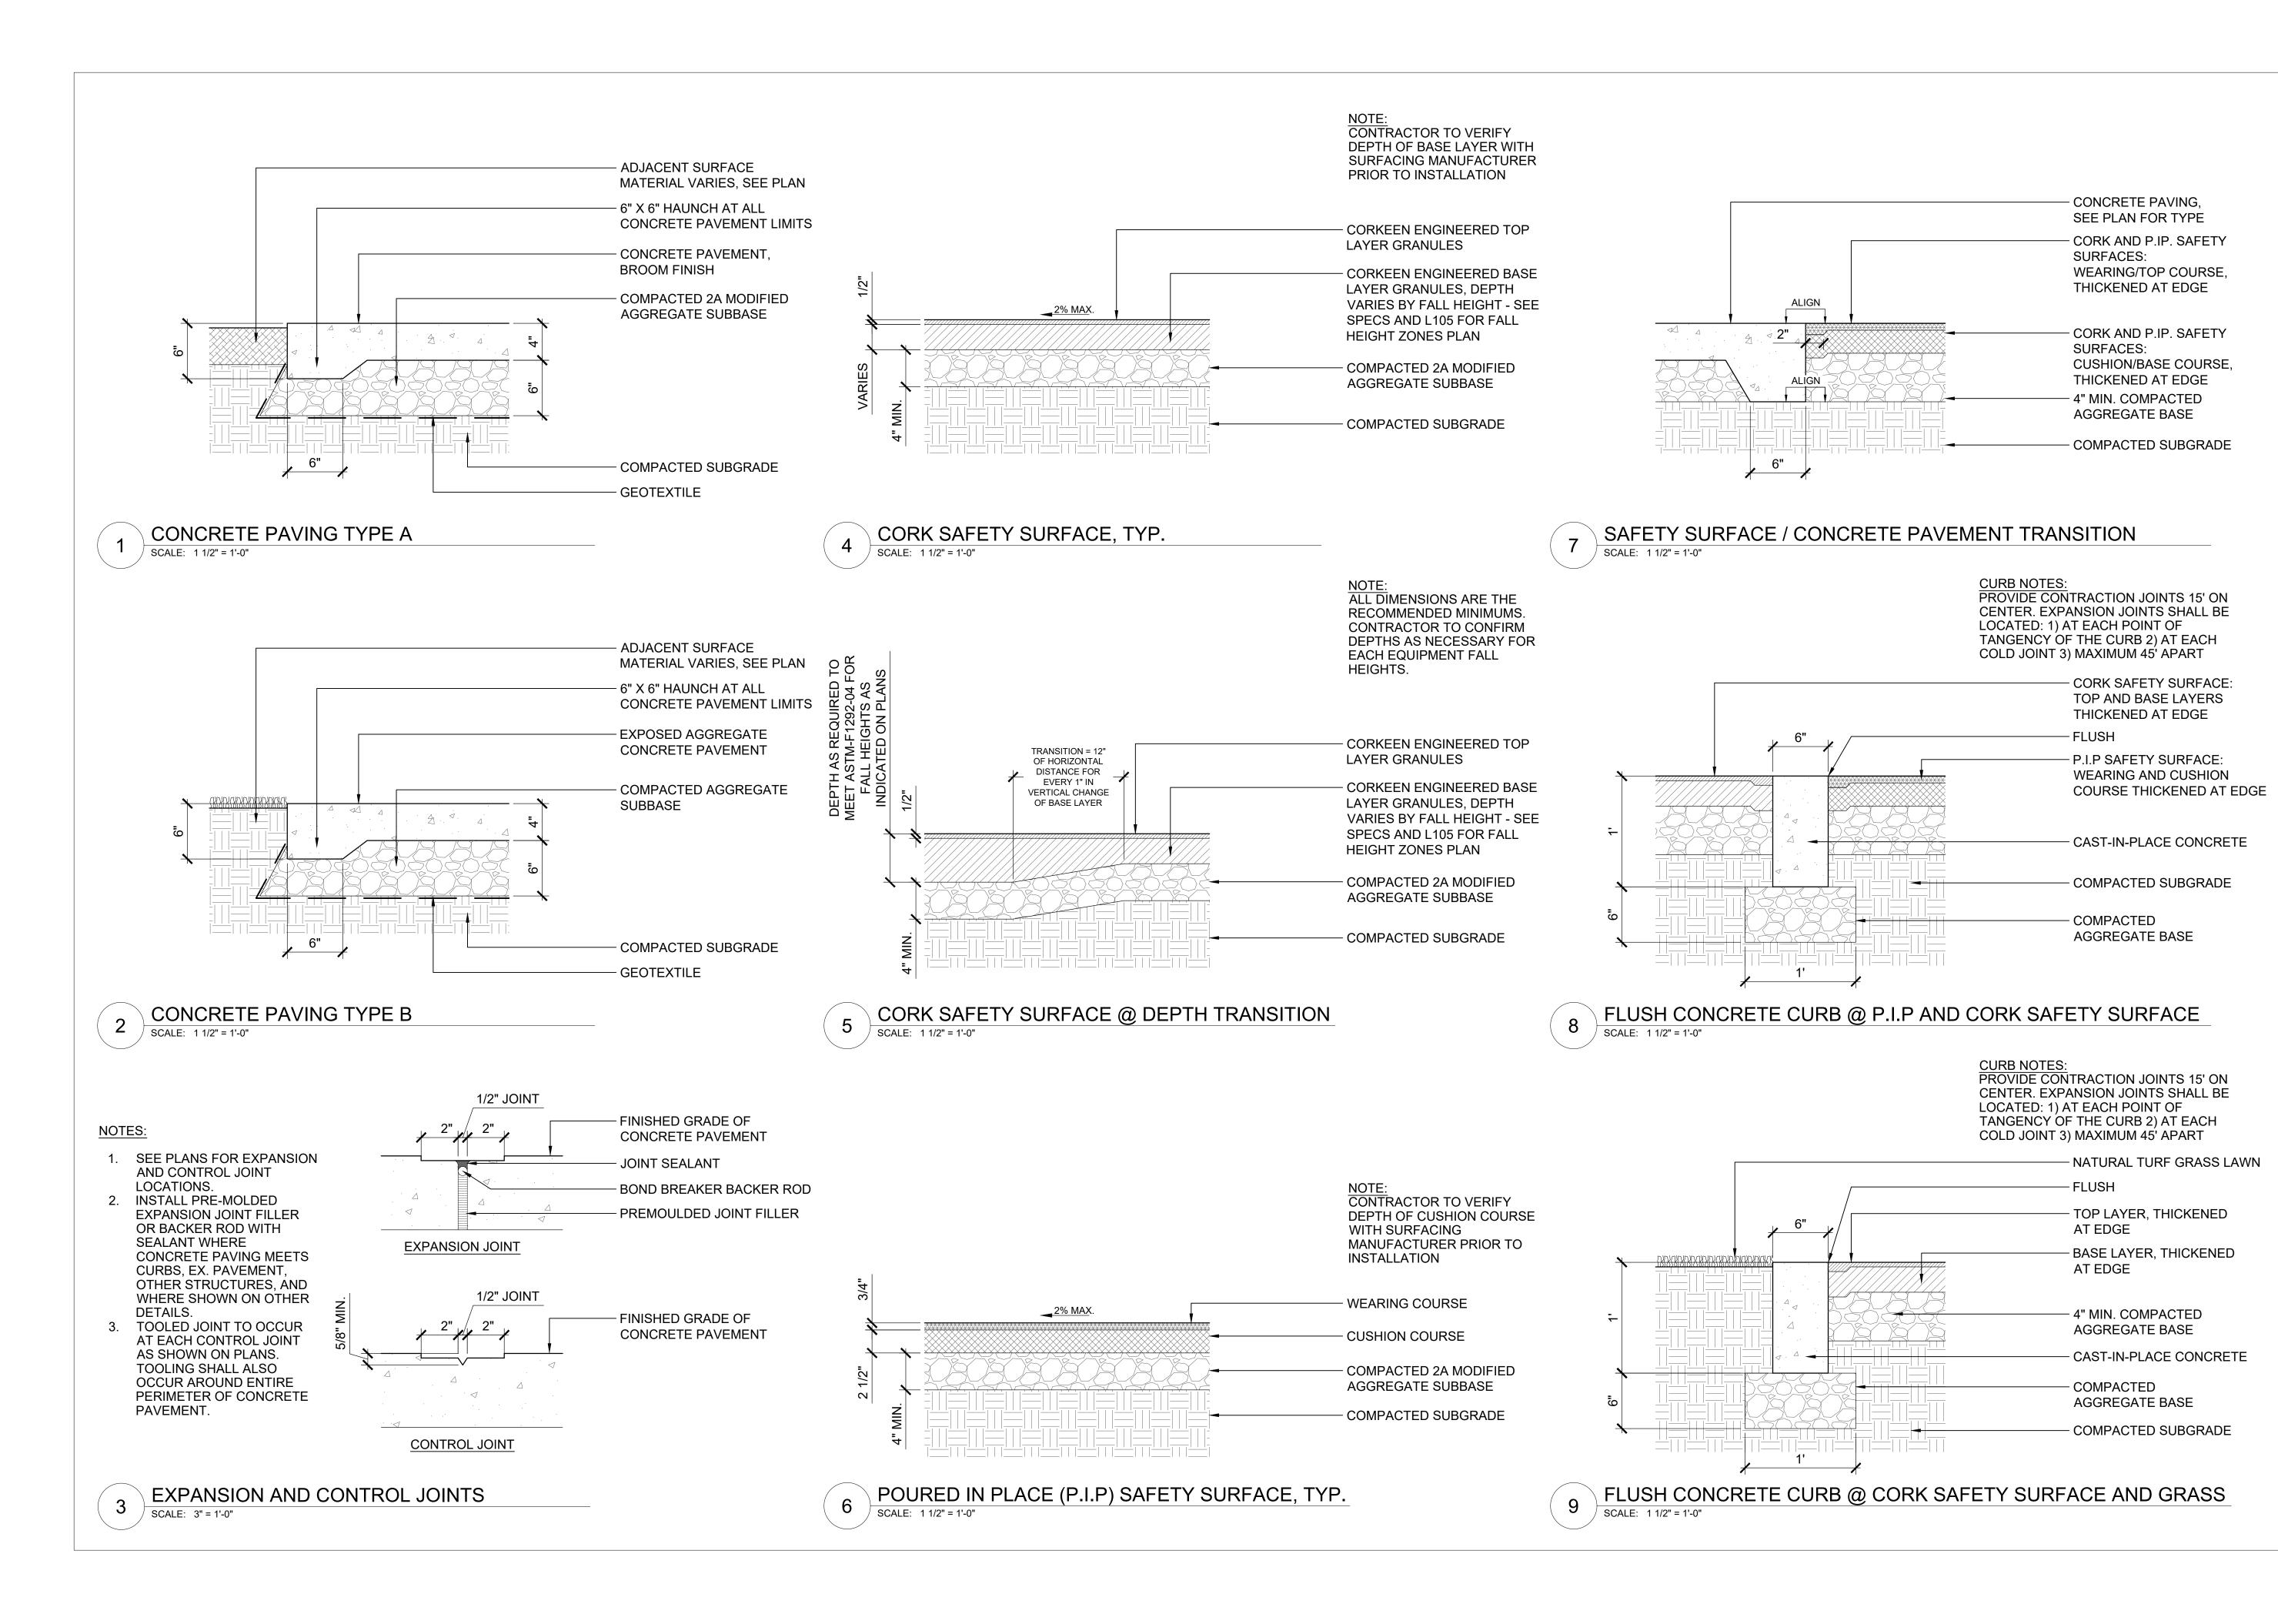

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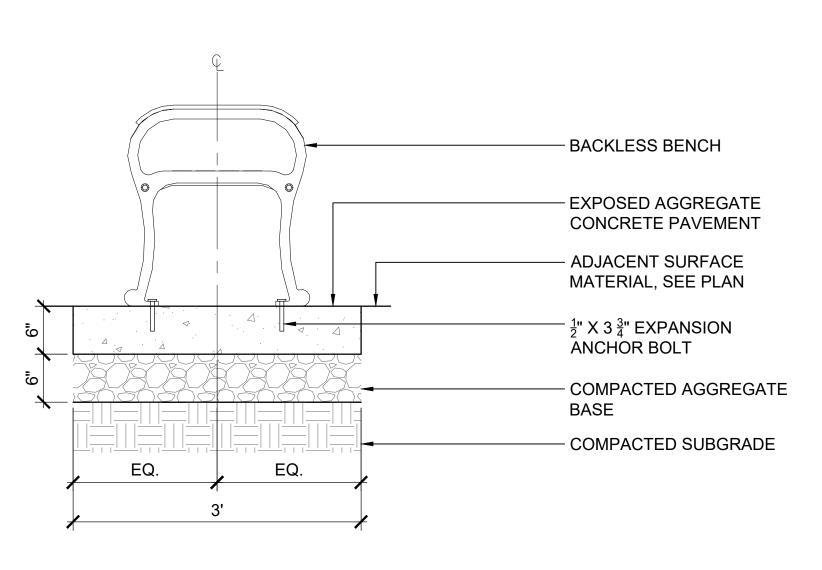
JOB NO: 2131 DATE: 07/22/2022 DRAWN: NJ CHECKED: CM **DRAWING TITLE:**

SITE DETAILS


SHEET 09 OF 22

DRAWING NO:

L-200




6' BACKLESS BENCH SCALE: 1" = 1'-0"

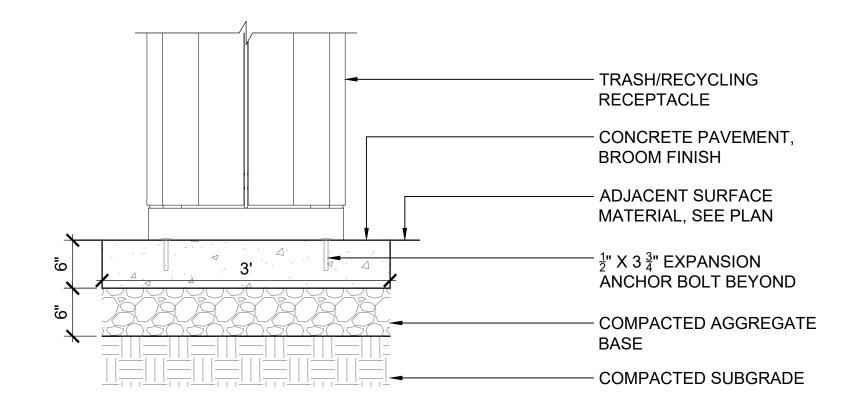

TRASH AND RECYCLING RECEPTACLES SCALE: 1" = 1'-0"

NOTES:


- LOGS FOR FEATURES MAY BE OBTAINED FROM CITY OF PHILADELPHIA RECYCLING CENTER. 3850 W. FORD ROAD, PHILADELPHIA, PA 19131.
- 2. LOGS SHALL BE TAGGED BY ARCHITECT. IF LOGS ARE NOT AVAILABLE AT RECYCLING CENTER, CONTRACTOR SHALL IDENTIFY OTHER MATERIAL SOURCE AND SUBMIT TO ARCHITECT FOR APPROVAL. CONTRACTOR SHALL COORDINATE WITH ARCHITECT TO TAG MATERIALS AT SOURCE.

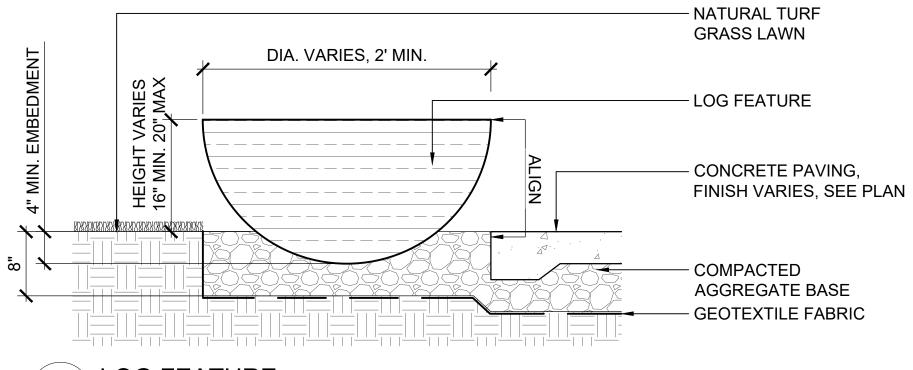


LOG FEATURE SCALE: 1" = 1'-0"

NOTES:

- 1. TREE STUMPS FOR FEATURES MAY BE OBTAINED FROM CITY OF PHILADELPHIA RECYCLING CENTER. 3850 W. FORD ROAD, PHILADELPHIA, PA 19131.
- 2. LOGS SHALL BE TAGGED BY ARCHITECT. IF LOGS ARE NOT AVAILABLE AT RECYCLING CENTER, CONTRACTOR SHALL IDENTIFY OTHER MATERIAL SOURCE AND SUBMIT TO ARCHITECT FOR APPROVAL. CONTRACTOR SHALL COORDINATE WITH ARCHITECT TO TAG MATERIALS AT SOURCE.

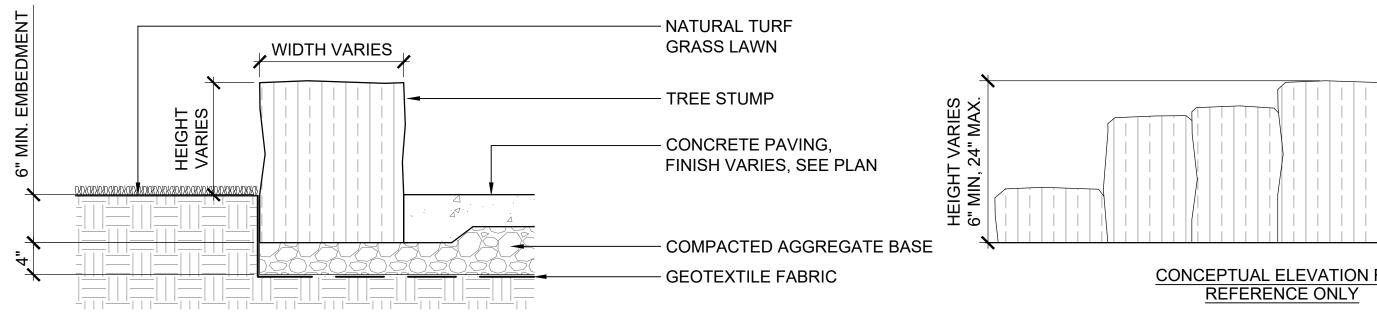

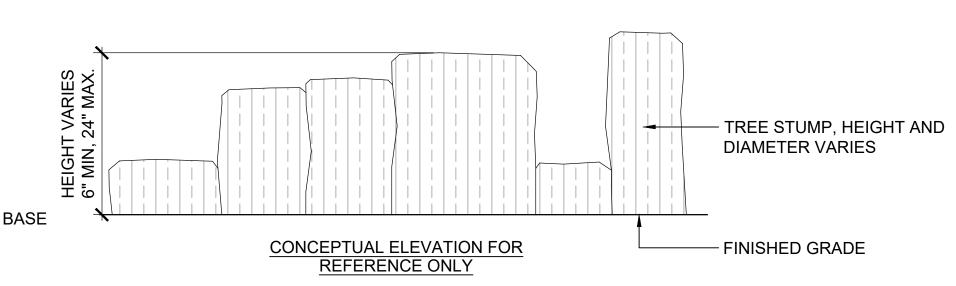


TREE STUMPS SCALE: 1" = 1'-0"

NOTES:

- 1. FOR FORMATION OF PLAY MOUNDS, 2A MODIFIED AGGREGATE SHALL BE INSTALLED IN 6" LIFTS. LIGHTLY MOISTEN EACH LAYER TO ENSURE SOLID COMPACTION. DO NOT OVER SATURATE AGGREGATE.
- 2. APPLY BINDING PRIMER COAT TO TOP OF CONCRETE SKIM COAT TO ENSURE SAFETY SURFACE COURSES ADHERE TO CONCRETE. INSTALL POURED-IN-PLACE
- RECOMMENDATIONS. 4. HEIGHTS AND WIDTHS OF MOUNDS VARY; SEE 2/L-104

MANUFACTURER'S


SAFETY SURFACE PER

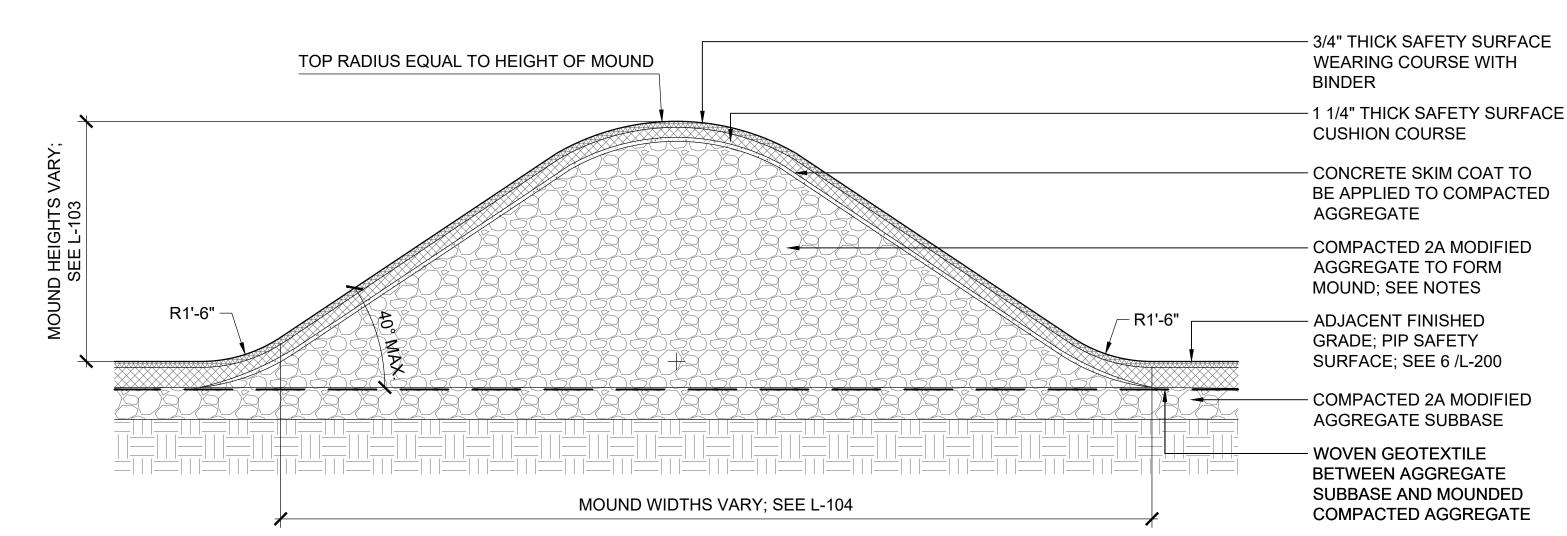

SAFETY SURFACE MOUND SCALE: 1" = 1'-0"

1. DETAIL AND ELEVATION **INFORMATION FOR** REFERENCE ONLY. REFER TO 'PHILADELPHIA PARKS & **RECREATION SIGNAGE** STANDARDS MANUAL' VERSION 1.1, JUNE 2018 OR MOST RECENT. 2. SEE SPECIFICATIONS FOR

MORE INFORMATION. 3. ALL FINAL GRAPHICS TO BE APPROVED BY CLIENT/PPR.

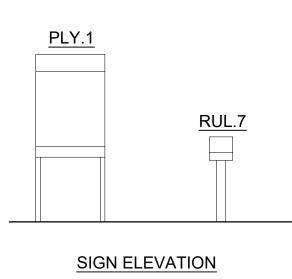

SCALE: NTS

- FINISHED CONCRETE, BROOM FINISHED, FLUSH AT GRADE ALUMINUM PLATE, $\frac{1}{4}$ " THICK. DRILL AND TAP AS REQUIRED. ATTACH PLATE TO CONCRETE FOOTER. SECURE SIGN CHANNELS TO FOOTER ATTACHMENTS. J-BOLTS, 1" DIA. STEEL REINFORCING STEEL - POURED-IN-PLACE CONCRETE, 5,400 PSI AT 28 DAYS. PROVIDE WEATER SEAL SAND AND GRAVEL AT FOOTING. COMPACTED CRUSHED STONE AS **FOOTING DETAIL** REQUIRED.

ALUMINUM CHANNEL

CONCRETE PAVING TYPE A 4" TYP. CONTROL OR **EXPANSION JOINT** THERMOPLASTIC STRIPE, 4 STRIPES CENTERED **BETWEEN** EQ. EQ. CONTROL/EXPANSION JOINTS, BOTH EDGES

FOR DEDUCT ALT. 2 CONFIGURATION, INCLUDE THERMOPLASTIC STRIPE SAME AS SHOWN HERE. NO CONTROL OR EXPANSION JOINTS.



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MEP ENGINEER

Chester Pike,

Arora Engineers, Inc.

61 Wilmington-West

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Suite 1108

Suite 460

JOB NO: 2131 DATE: 07/22/2022 DRAWN: NJ CHECKED: CM **DRAWING TITLE:**

SITE DETAILS


DRAWING NO:

L-201

SHEET 10 OF 22

PARK SIGNAGE

THERMOPLASTIC STRIPING LAYOUT SCALE: 1/4" = 1'-0"

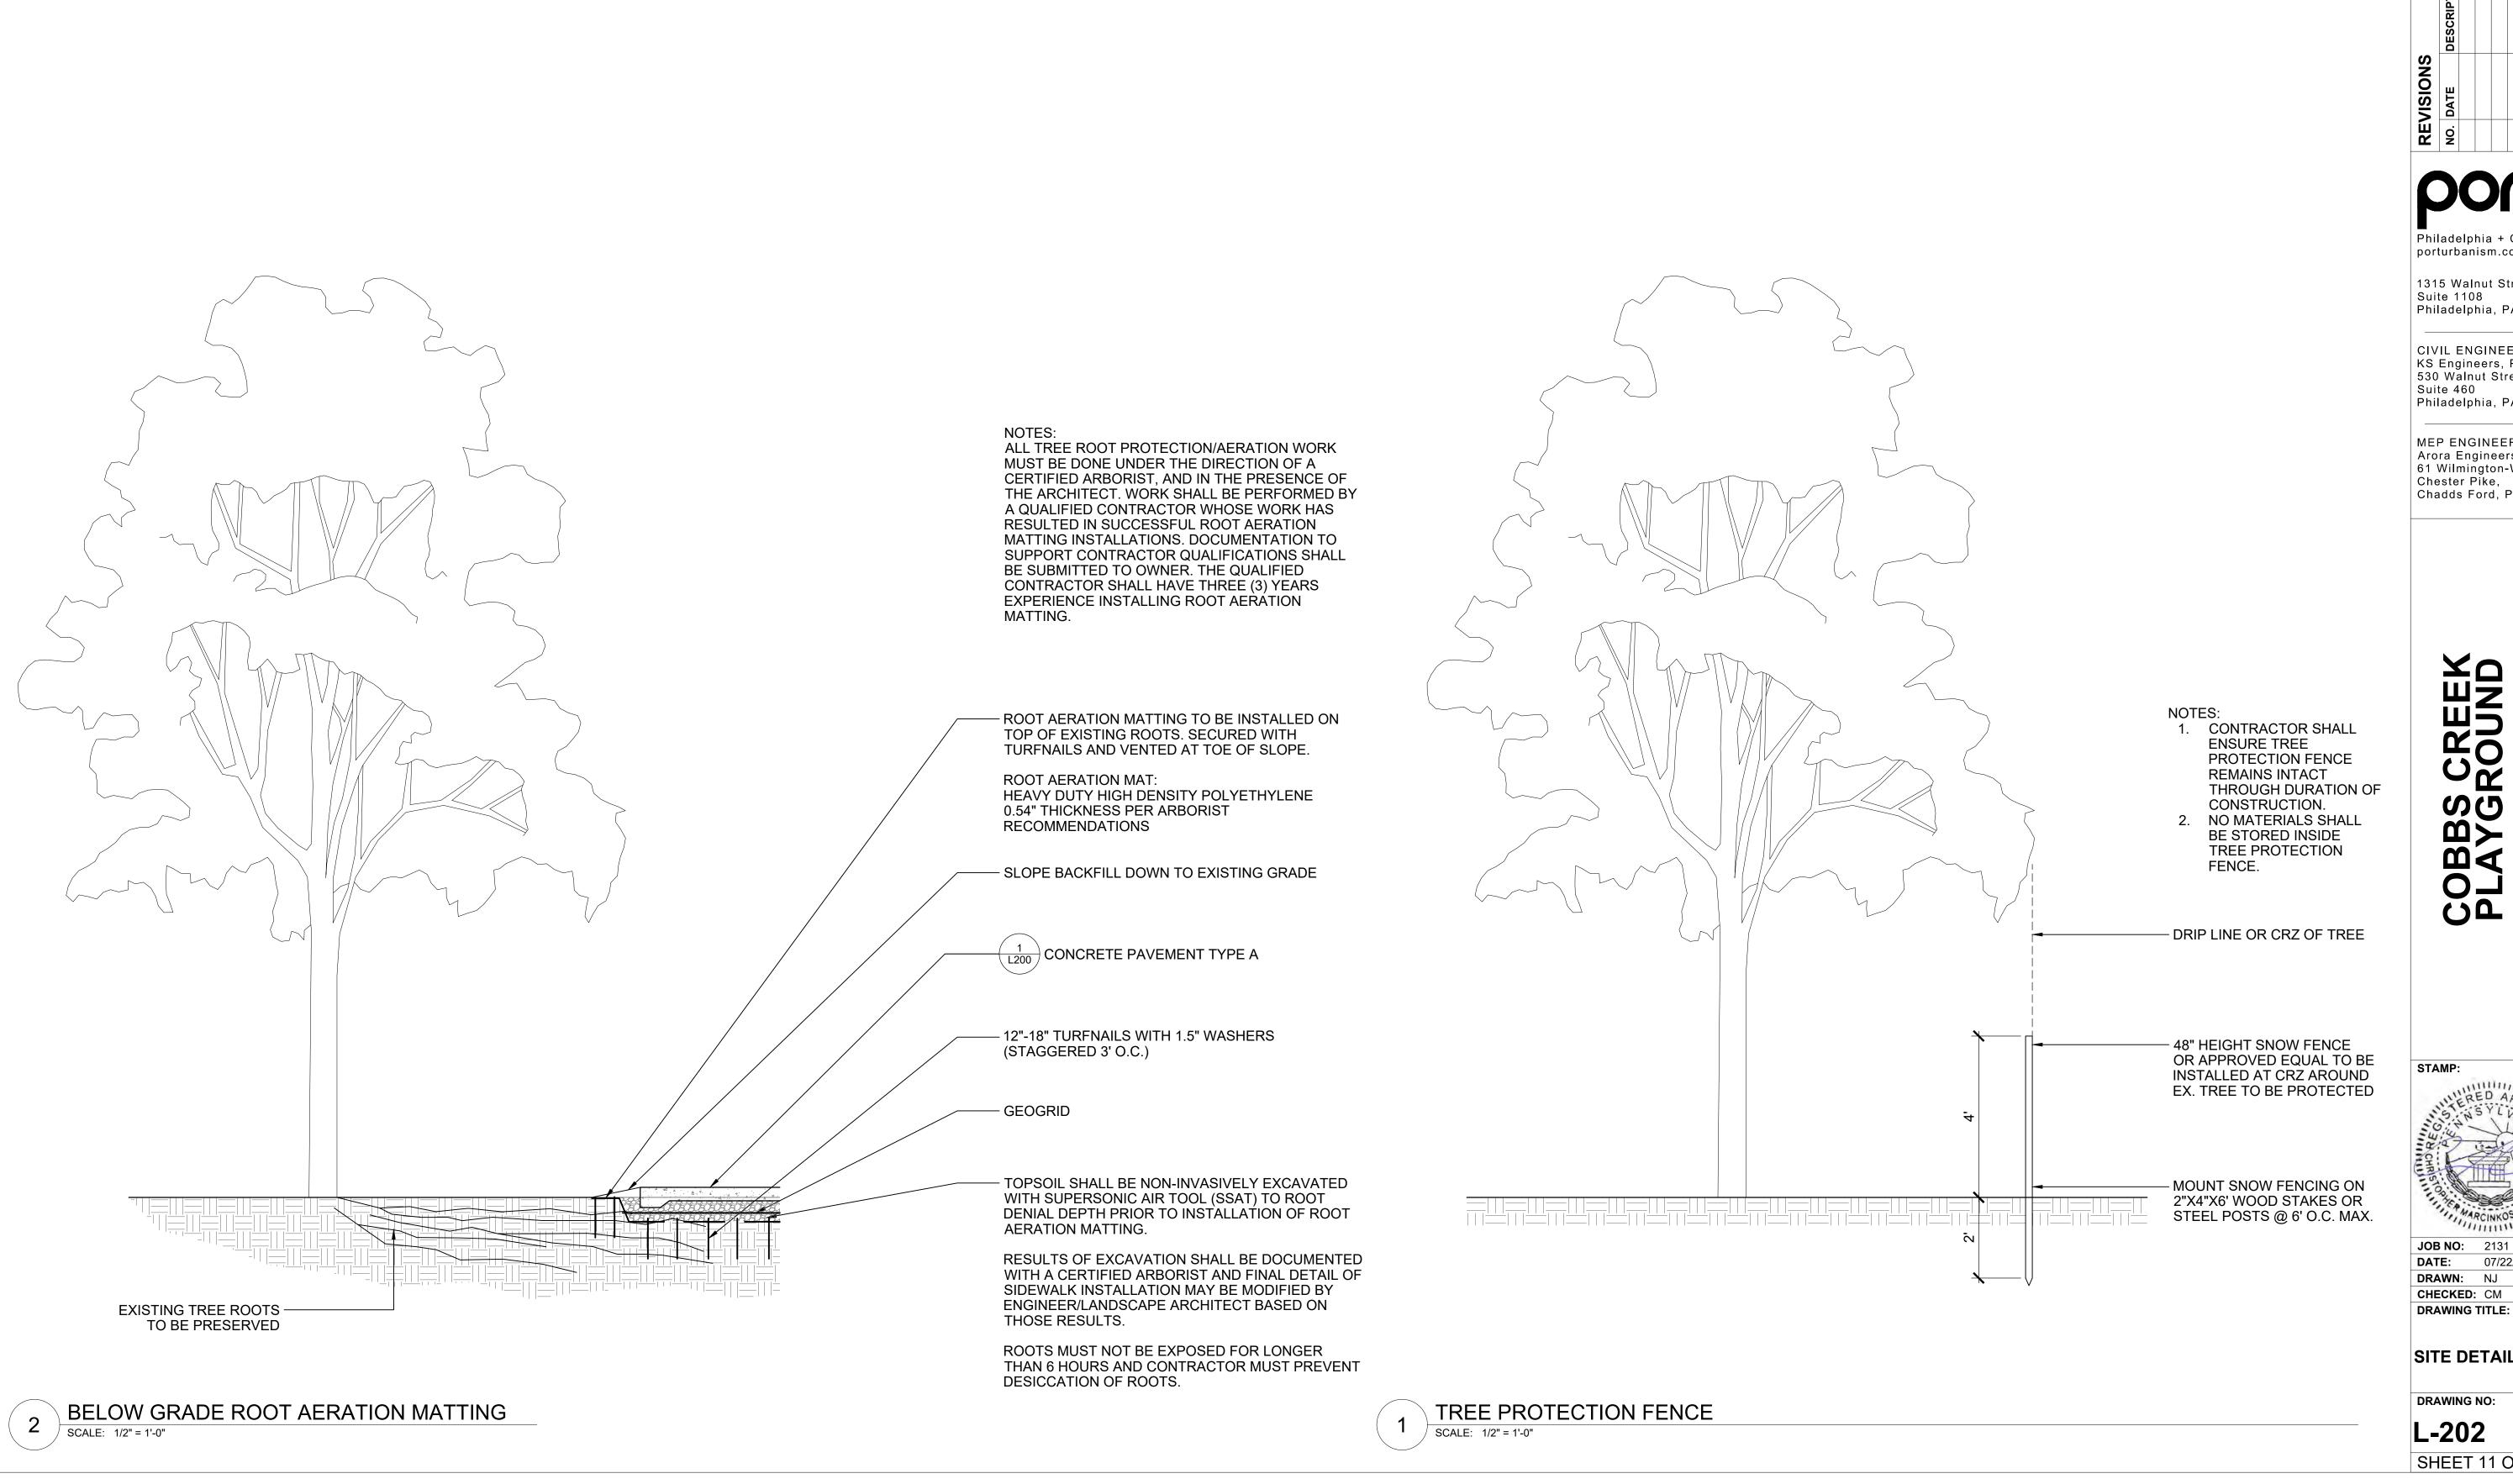

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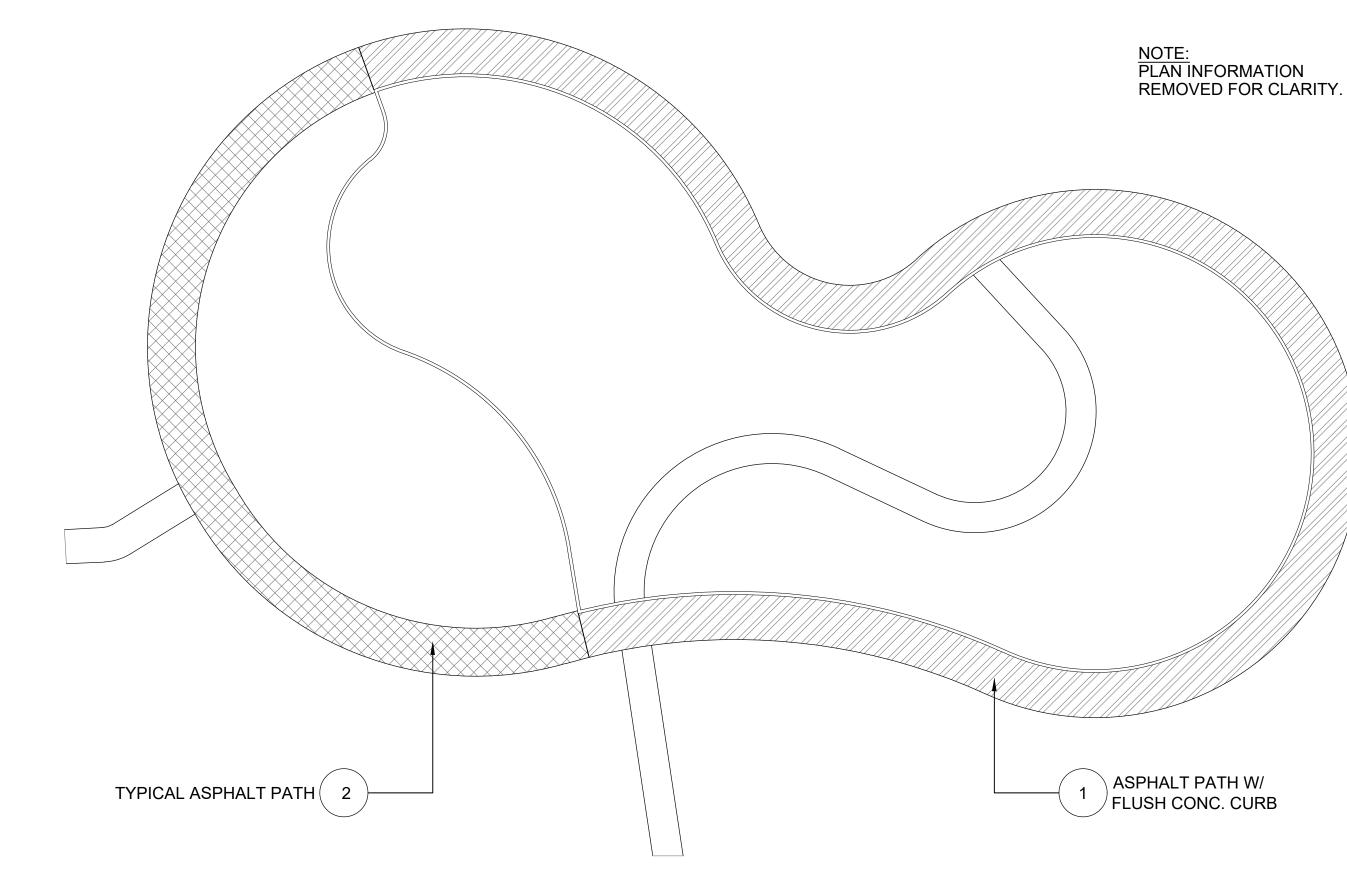


JOB NO: 2131 07/22/2022 DRAWN: NJ CHECKED: CM


SITE DETAILS

L-202

SHEET 11 OF 22



3 DEDUCT ALT 2: ASPHALT PATH KEY PLAN

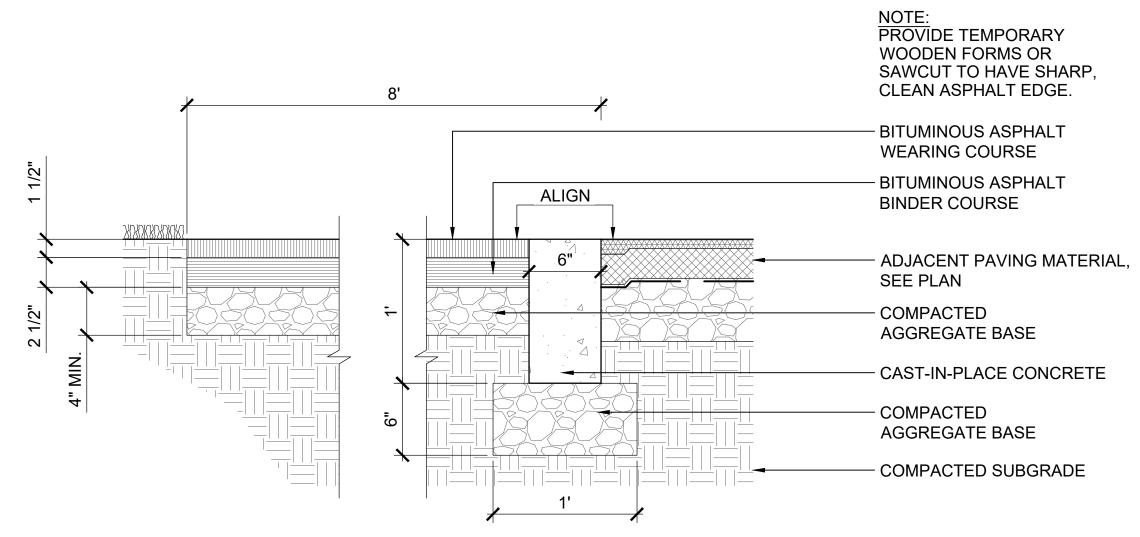

DEDUCT ALT 2: ASPHALT PATH W/ FLUSH CONCRETE CURB

SCALE: 1 1/2" = 1'-0"

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Philadelphia, PA. 19107

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KS Engineers, P.C.
530 Walnut Street,
Suite 460
Philadelphia, PA. 19106

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COBBS CREEK
PLAYGROUND
PHILADELPHIA, PA

STAMP:

JOB NO: 2131

DATE: 07/22/2022

DRAWN: NJ


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DRAWING TITLE:

DEDUCT ALT 2: SITE DETAILS


DRAWING NO:

L-203SHEET 12 OF 22

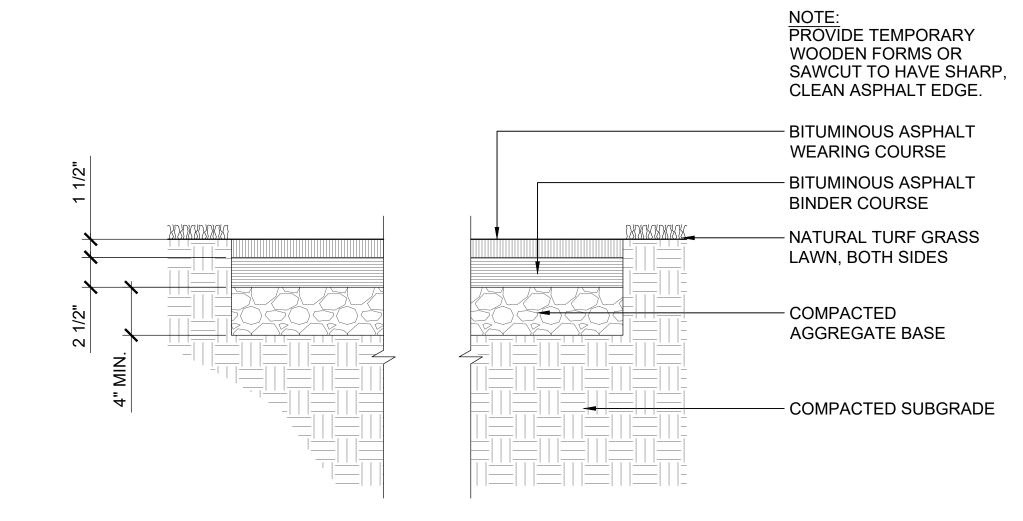

2 DEDUCT ALT 2: TYPICAL ASPHALT PATH

SCALE: 1 1/2" = 1'-0"

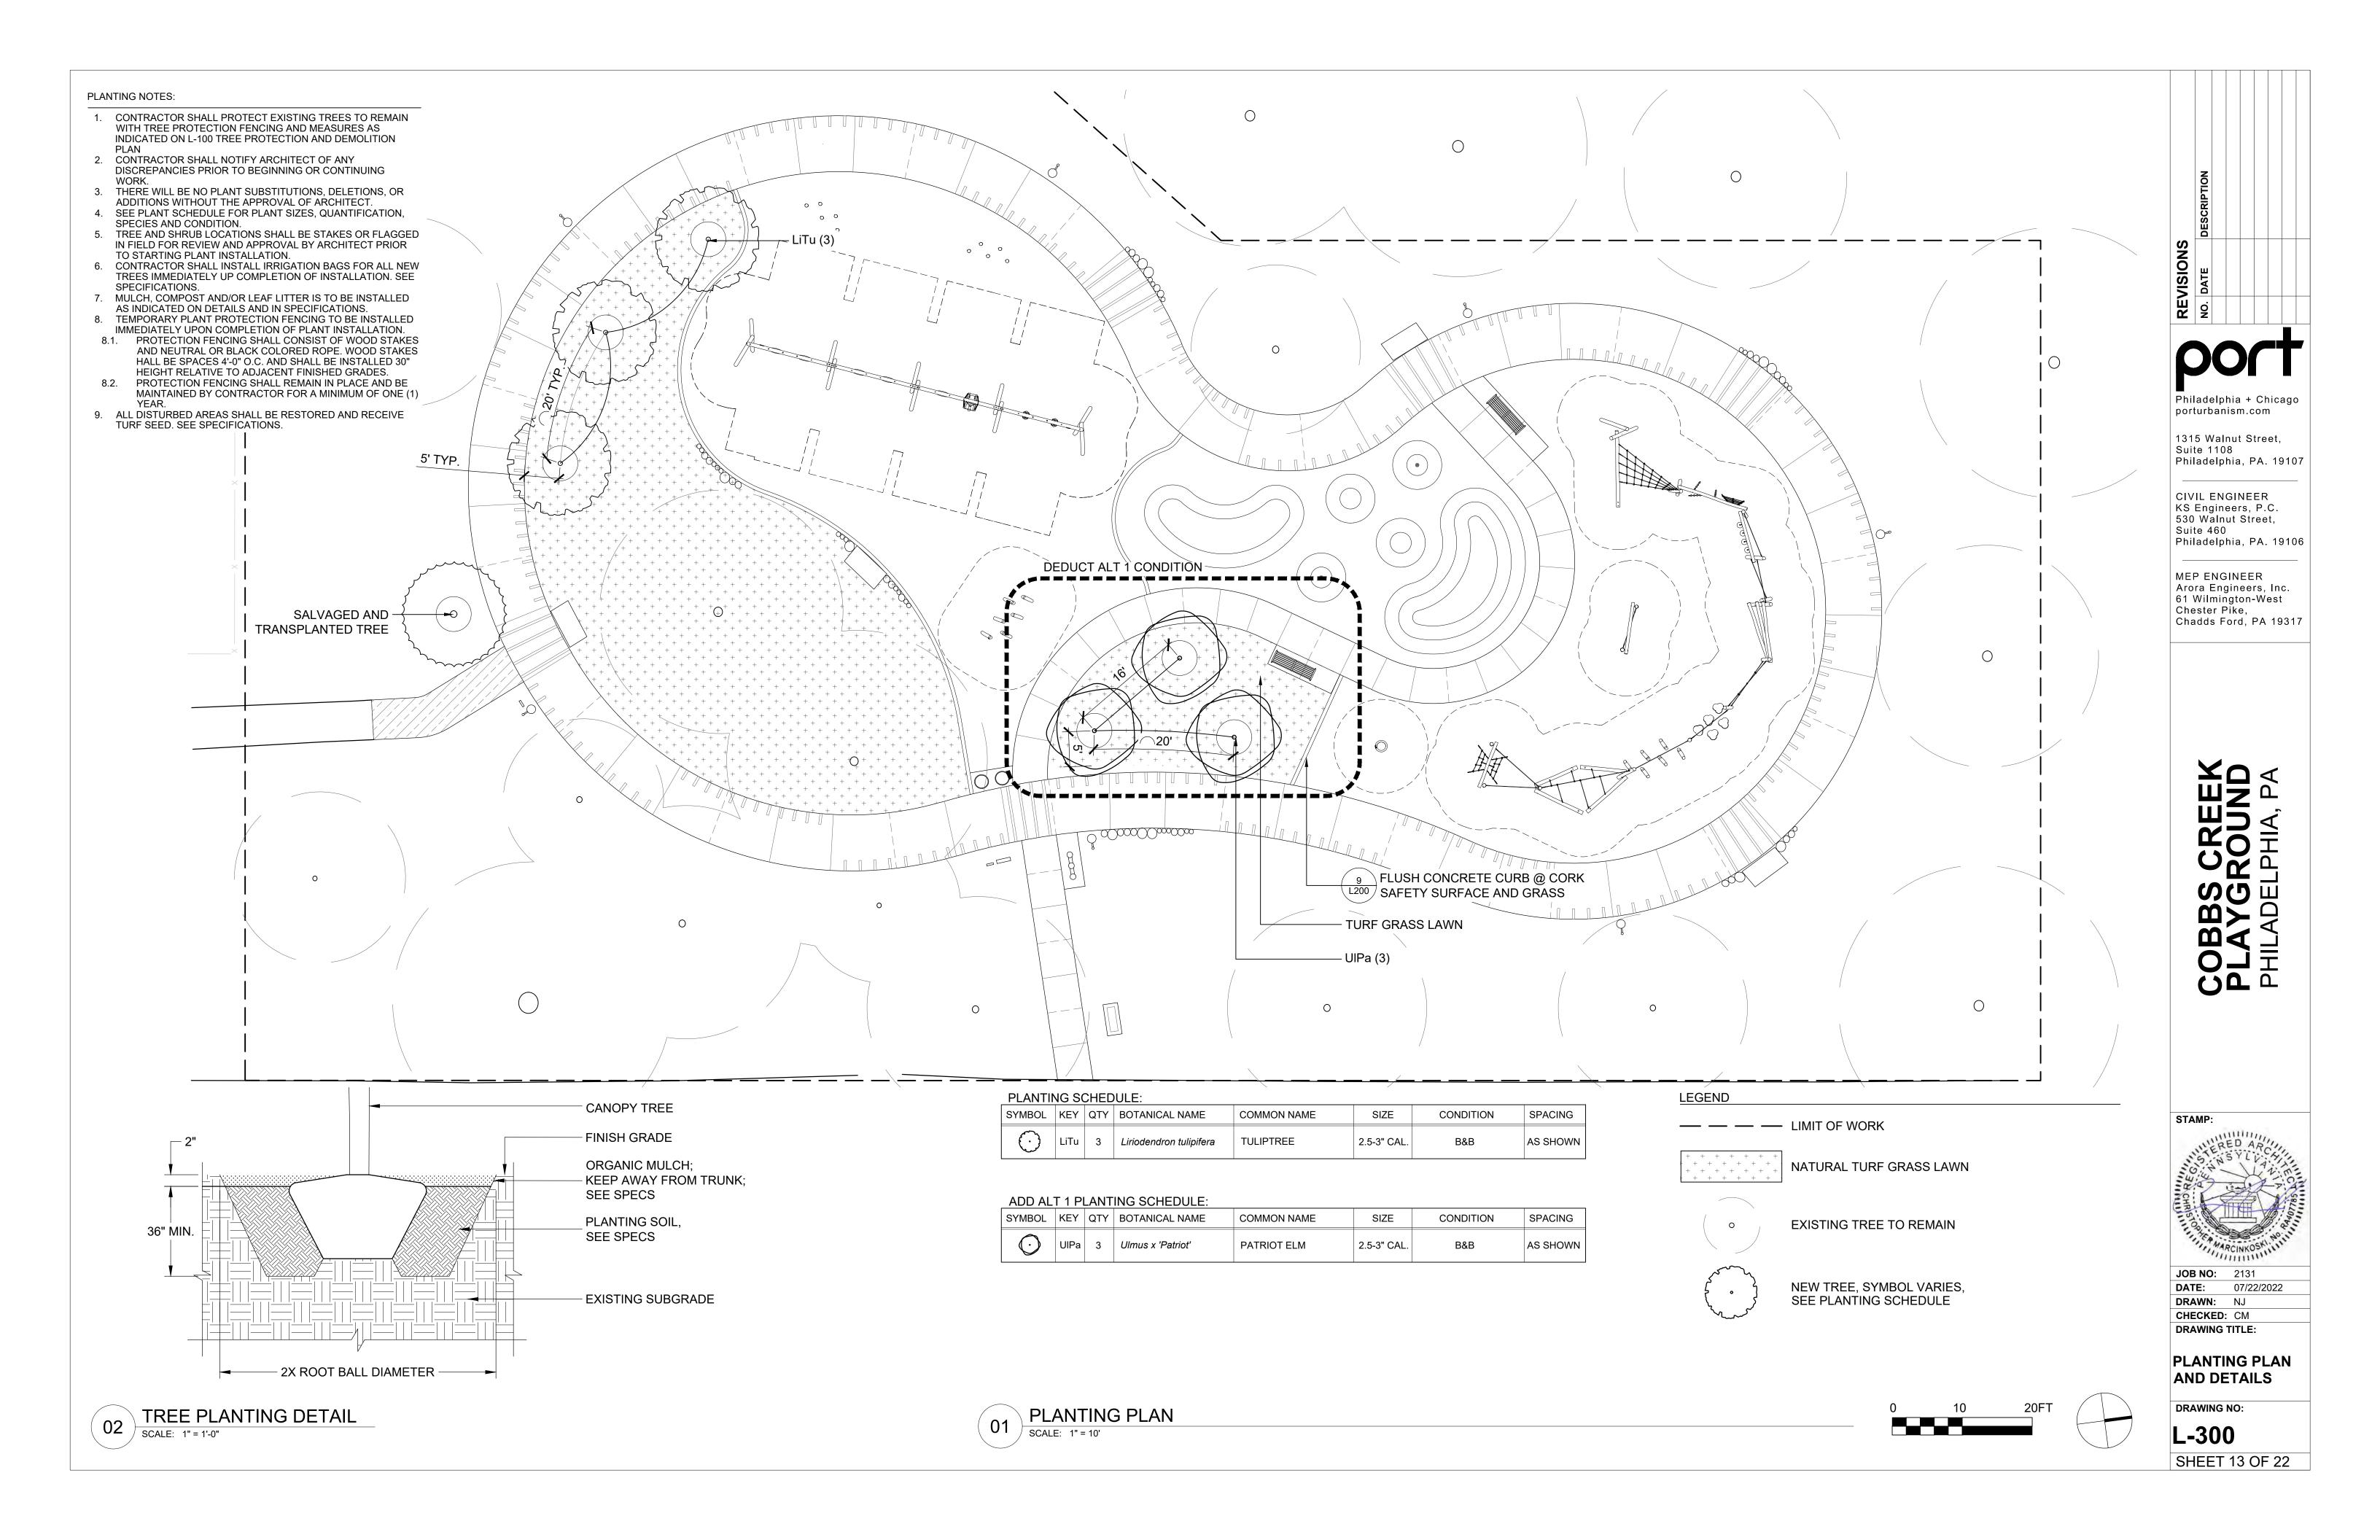


UTILITY LEGEND BENCH TRASH RECPTACLE DRINKING FOUNTAIN WATER LATERAL

GENERAL NOTES:

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- 2. HORIZONTAL DATUM: PA STATE PLANE COORDINATES (SOUTH ZONE) NAD83(2011); VERTICAL DATUM: NAVD88 (GEOID 18). GRID NORTH, BEARINGS AND ELEVATIONS WERE DERIVED FROM THE KEYNET GPS VRS NETWORK. THE STATE PLANE COORDINATES HAVE BEEN SCALED TO GROUND FROM A POINT AT N: 234949.02 AND E: 2669355.68 USING A COMBINED FACTOR OF 1.0000024745.
- 3. SURVEY MEASUREMENTS WERE MADE IN US SURVEY FEET (US FT).
- 4. THE ACCURACY REGARDING LOCATION AND OR DEPTH OF ALL UTILITIES CANNOT BE GUARANTEED. PRIOR TO ANY DIGGING, DRILLING, TRENCHING OR OTHER EARTHMOVING ACTIVITIES, THE CONTRACTOR SHALL VERIFY DIMENSIONS AND EXISTING CONDITIONS AT THE SITE. FOR INFORMATION REGARDING UTILITIES, CONSULT PENNSYLVANIA ONE CALL 1-800-242-1776.
- 5. CONTOURS SHOWN WERE PRODUCED FROM AN ACTUAL GROUND SURVEY. CONTOUR INTERVAL IS 1 FOOT.
- 6. ALL SITE WORK TO BE COMPLETED IN ACCORDANCE WITH LOCAL ORDINANCES AND SPECIFICATIONS INCLUDING. BUT NOT LIMITED TO, PHILADELPHIA DEPARTMENT OF STREETS, PHILADELPHIA WATER DEPARTMENT, AND THE PHILADELPHIA CODE.
- 7. COBBS CREEK IS LOCATED APPROXIMATELY 285 L.F. TO THE WEST OF THE PROJECT SITE.

munimum minimum,

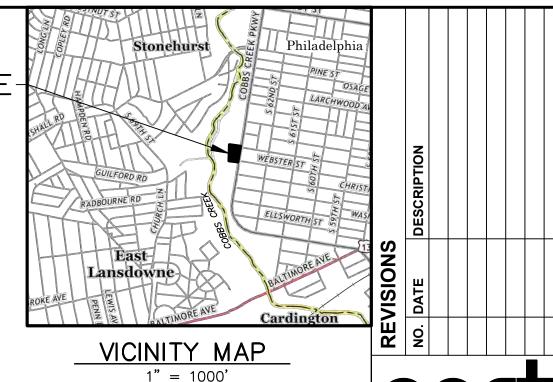

DARBY & COBBS CREEKS WATERSHED FLOOD MANAGEMENT DISTRICT B-2 COMBINED SEWER SERVICE AREA



1315 Walnut Street, Suite 1108

Philadelphia, PA. 19107 CIVIL ENGINEER

KS Engineers, P.C. 530 Walnut Street, Suite 460 Philadelphia, PA. 19106

MEP ENGINEER Arora Engineers, Inc. 61 Wilmington-West Chester Pike, Chadds Ford, PA 19317

REEK OUND HA, PA

PROPERTY OWNER:

CITY OF PHILADELPHIA


COBBS NATURE PLAYGROUND

6300 SPRUCE STREET

OPA/BRT ACCOUNT NO.:

783500205

PROTECT YOURSELF

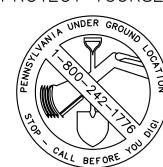

WHAT YOU DON'T KNOW CAN HURT YOU.

CALL BEFORE YOU DIG! PENNSYLVANIA LAW REQUIRES 3 WORKING DAYS NOTICE FOR CONSTRUCTION PHASE & 10 WORKING DAYS IN DESIGN STAGE

ACT 187

IT IS THE CONTRACTOR'S RESPONSIBILITY TO COMPLY WITH THE PENNSYLVANIA ACT 187 AND TO CONTACT THE "ONE CALL SYSTEM" THREE (3) WORKING DAYS (UNLESS OTHERWISE NOTED) PRIOR TÒ START OF CONSTRUCTION.

PENNSYLVANIA ONE CALL: 1-800-242-1776

<u>PHILADELPHIA WATER DEPARTMENT</u> 1101 MARKET STREET, 2nd FLOOR PHILADELPHIA, PENNSYLVANIA (215) 685-6270

-4" Electric Conduit, 2'-0" Cov.

PHILADELPHIA, PENNSYLVANIA 19107 (215) 351-8947 PHILADELPHIA GAS WORKS

800 W. MONTGOMERY AVENUE, 3RD FLOOR

1351 S. COLUMBUS BOULEVARD

PHILADELPHIA, PENNSYLVANIA 19147 PHILADELPHIA, PENNSYLVANIA 19122 (215) 952-4935

<u>VERIZON</u> 900 RACE STREET

PECO-CONSTRUCTION DEPARTMENT 2301 MARKET STREET PHILADELPHIA, PENNSYLVANIA 19103 (215) 731-3264

KSE KS ENGINEERS, P.C.

ENGINEERS • SURVEYORS • CONSTRUCTION MANAGERS 530 WALNUT STREET SUITE 460 PHILADELPHIA, PENNSYLVANIA 19106

PHONE: 215.925.0425 • FAX: 215.925.0430

DRAWING TITLE:

DRAWING NO: SHEET 14 OF 22

----E----E-----ELECTRIC CONDUIT ----- MINOR CONTOUR LINE -BACKFLOW PREVENTER CURB STOP-HOTBOX W/ HEATER └METER PIT ¹ WATER LATERAL (215) 684-6796 ─ 8" Water Main, 38" Cov. -3'-0"x2-0" Brick Sewer, $\pm 13'$ deep COBBS CREEK PARKWAY (S.R. 3015) 6" Gas Main, 3'-0" Cov. -(100' WIDE) (25'-50'-25')PARKING PARKING

6300 SPRUCE STREET CITY OF PHILADELPHIA COBBS NATURE PLAYGROUND OPA/BRT: 783500205 AREA = 461,213 SQ FEETAREA = 10.59 ACRES103.23 103.38 K104.93 102.40 **≭**102.40 **/**√

1401 JOHN F. KENNEDY BLVD. PHILADELPHIA, PA 19102-1617 PROPERTY ADDRESS:

PHILADELPHIA, PA 19122




Pennsylvania One Call System, Inc. 1-800-242-1776


PA ONE CALL SERIAL NO. 20221513052


FRANK ANTHONY FREGA


JOB NO: 2131 **DATE:** 07/22/2022 DRAWN: RDC CHECKED: RSB

> **GRADING AND UTILITY PLAN**

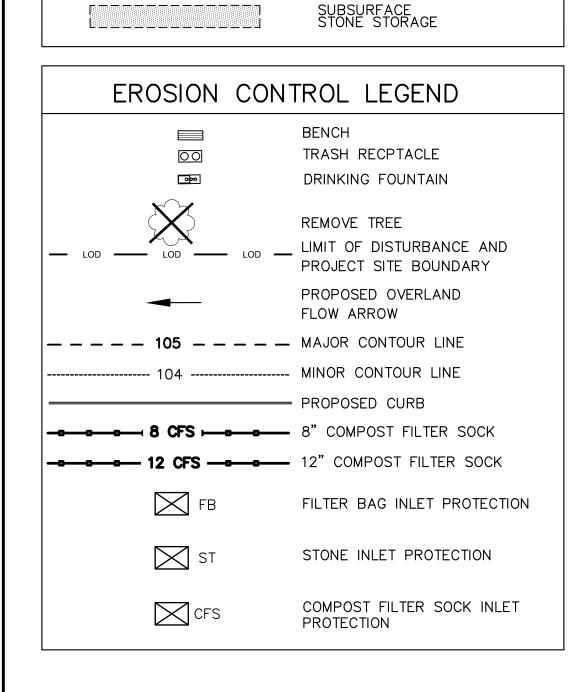

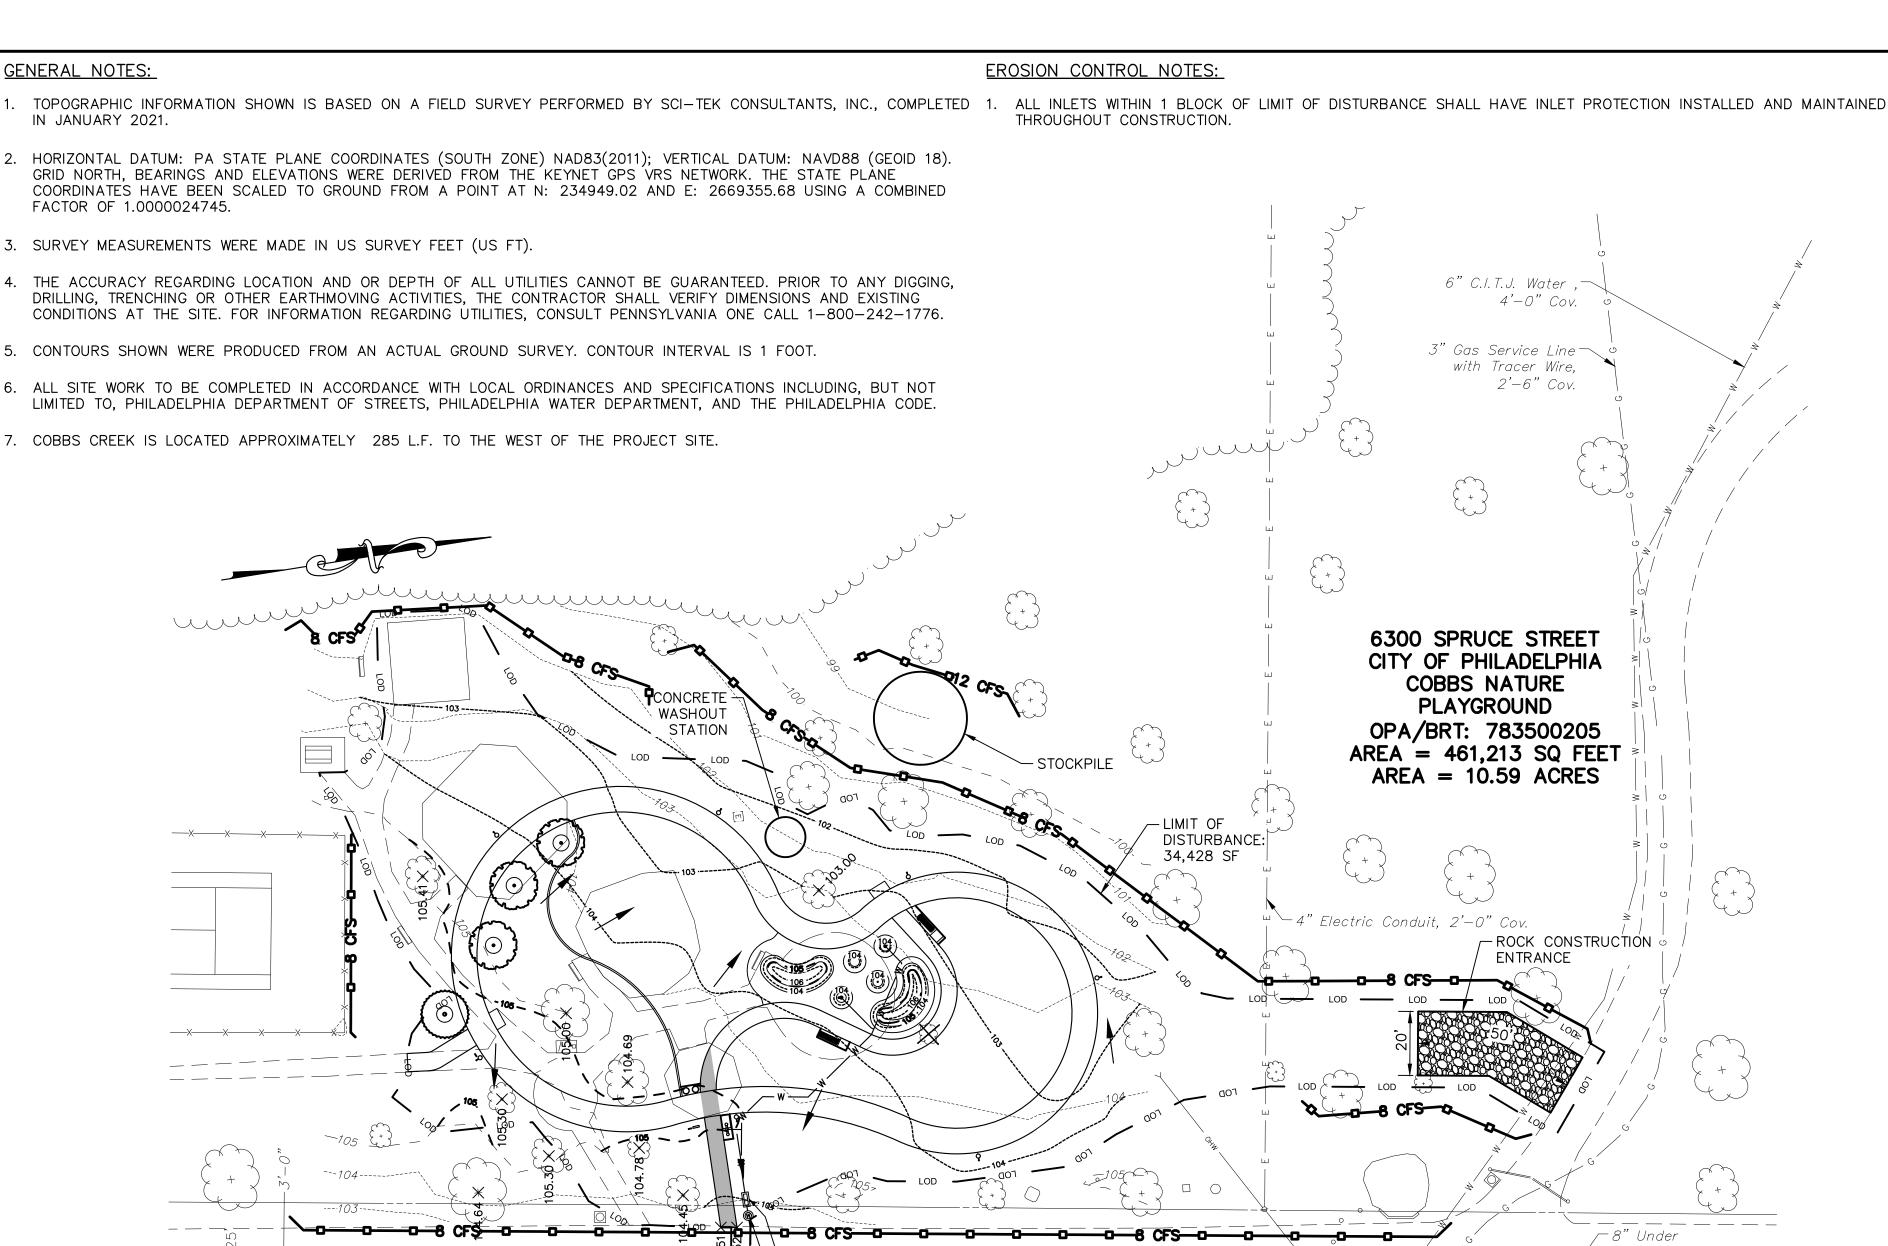

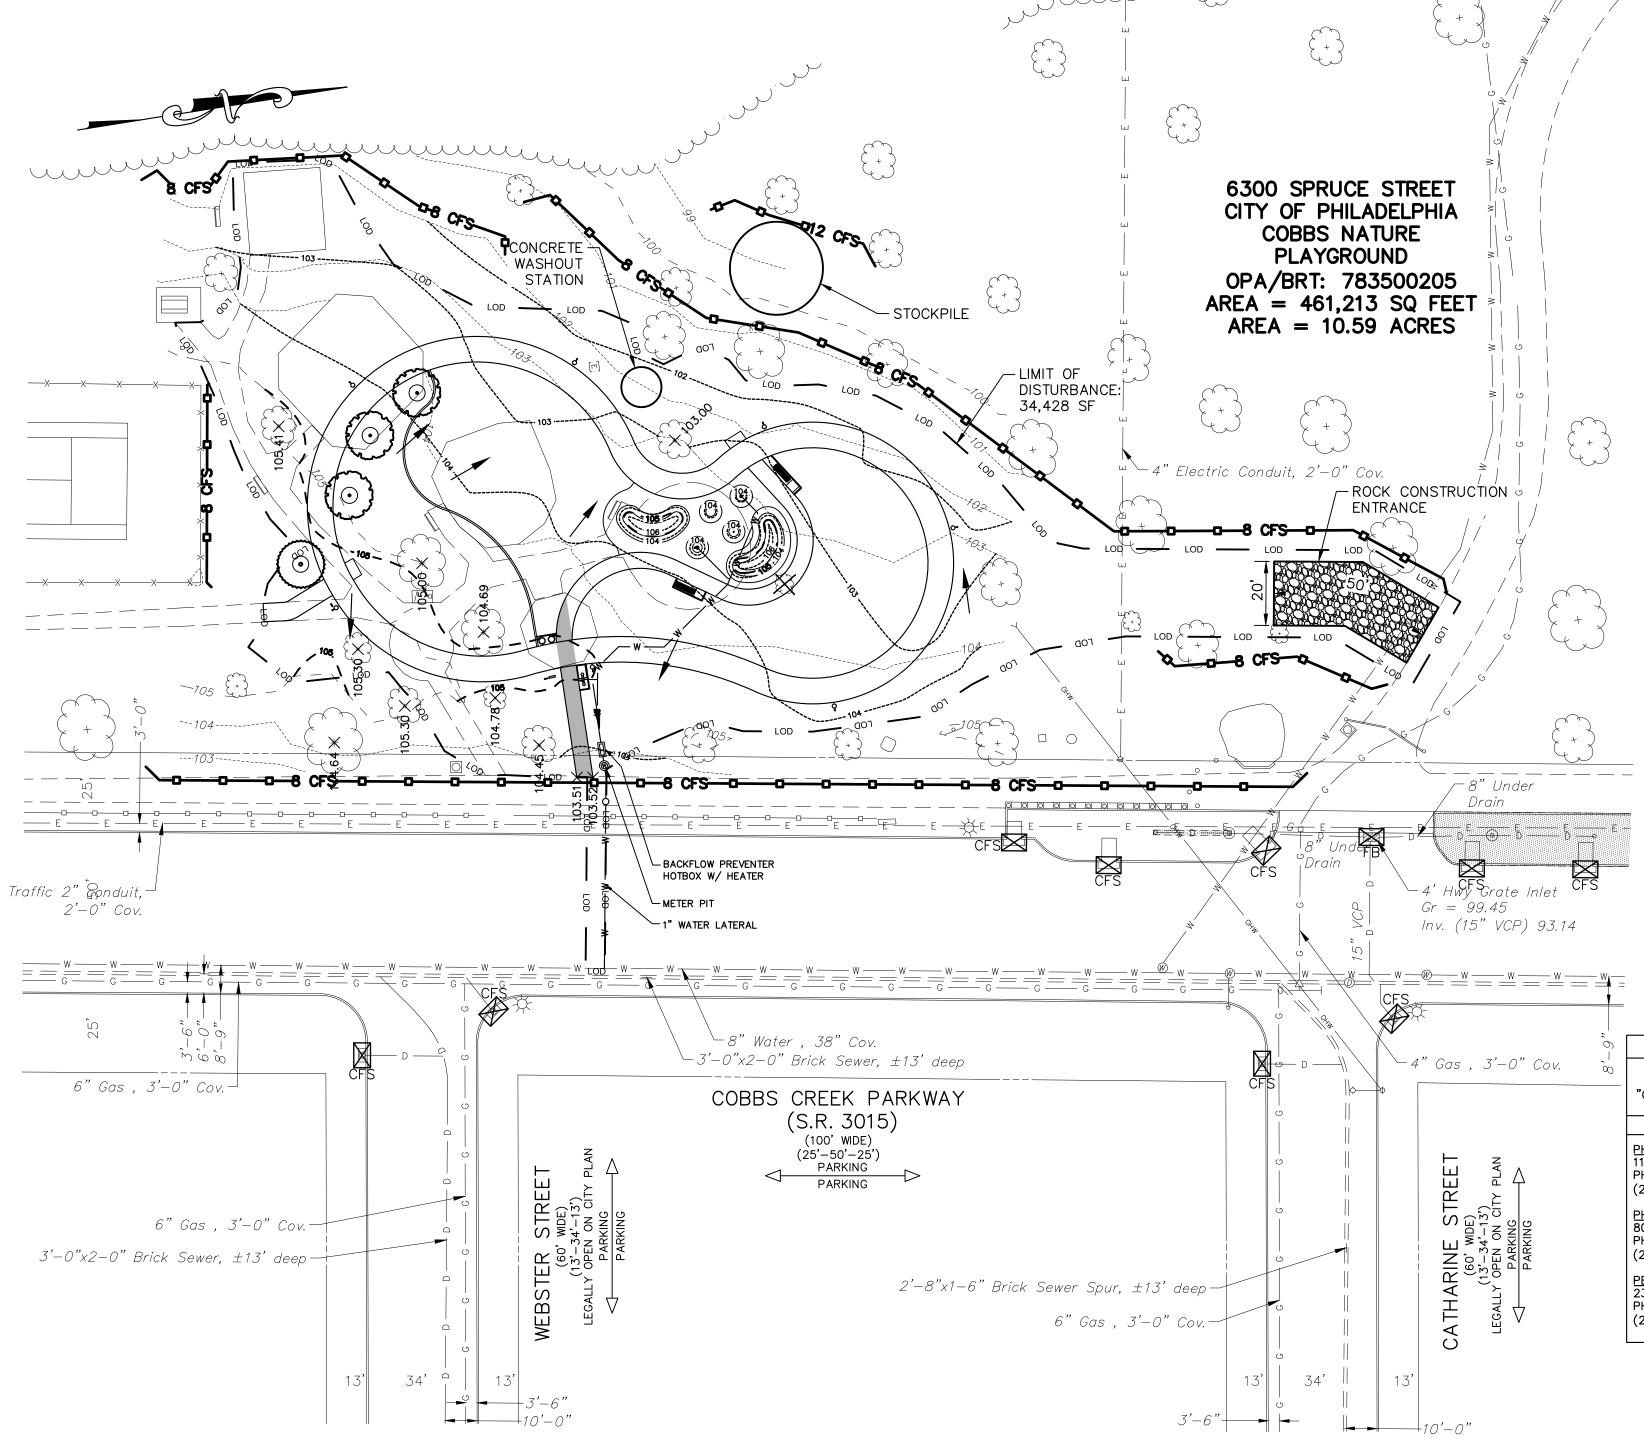

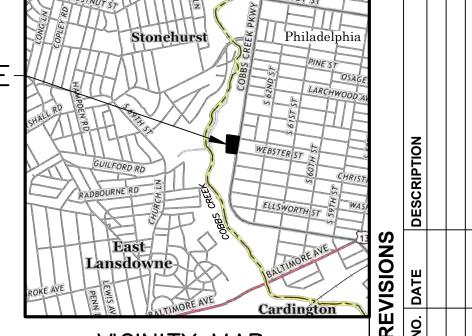

VICINITY MAP

1" = 1000'DARBY & COBBS CREEKS WATERSHED FLOOD MANAGEMENT DISTRICT B-2 COMBINED SEWER SERVICE AREA

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PROPERTY ADDRESS:

PROPERTY OWNER:

CITY OF PHILADELPHIA

COBBS NATURE PLAYGROUND

1401 JOHN F. KENNEDY BLVD.


PHILADELPHIA, PA 19102-1617

6300 SPRUCE STREET PHILADELPHIA, PA 19122

OPA/BRT ACCOUNT NO.:

783500205

PROTECT YOURSELF

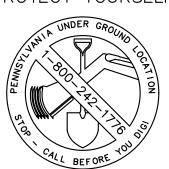

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Pennsylvania One Call System, Inc. 1-800-242-1776

PA ONE CALL SERIAL NO. 20221513052

ACT 187

IT IS THE CONTRACTOR'S RESPONSIBILITY TO COMPLY WITH THE PENNSYLVANIA ACT 187 AND TO CONTACT THE "ONE CALL SYSTEM" THREE (3) WORKING DAYS (UNLESS OTHERWISE NOTED) PRIOR TO START OF CONSTRUCTION. PENNSYLVANIA ONE CALL: 1-800-242-1776

PHILADELPHIA WATER DEPARTMENT 1101 MARKET STREET, 2nd FLOOR PHILADELPHIA, PENNSYLVANIA (215) 685-6270

PHILADELPHIA GAS WORKS 800 W. MONTGOMERY AVENUE, 3RD FLOOR PHILADELPHIA, PENNSYLVANIA 19122 (215) 684-6796

PECO-CONSTRUCTION DEPARTMENT 2301 MARKET STREET PHILADELPHIA, PENNSYLVANIA 19103 (215) 731-3264

SCALE: 1" = 30'-0"

VERIZON 900 RACE STREET PHILADELPHIA, PENNSYLVANIA 19107 (215) 351–8947

COMCAST 1351 S. COLUMBUS BOULEVARD PHILADELPHIA, PENNSYLVANIA 19147 (215) 952-4935

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KS ENGINEERS, P.C.

ENGINEERS • SURVEYORS • CONSTRUCTION MANAGERS 530 WALNUT STREET SUITE 460 PHILADELPHIA, PENNSYLVANIA 19106 PHONE: 215.925.0425 • FAX: 215.925.0430

JOB NO: 2131 **DATE**: 07/22/2022 DRAWN: RDC

FRANK ANTHONY FREGA
PA P.E. LICENSE NO. PEO41605R


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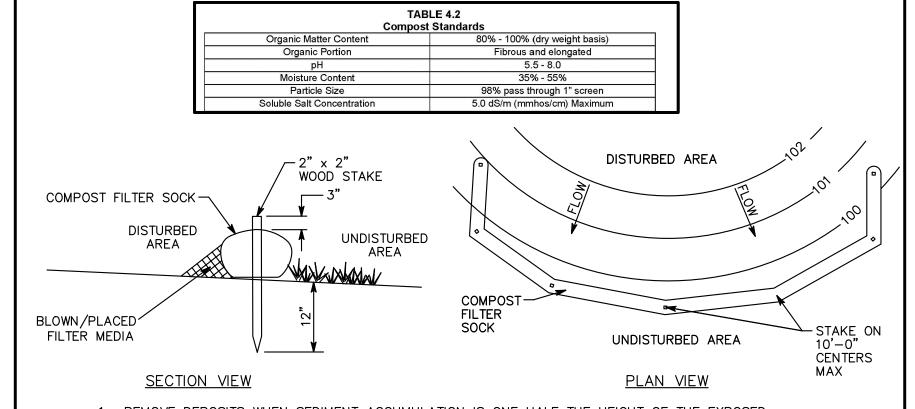
EROSION CONTROL PLAN

CHECKED: RSB

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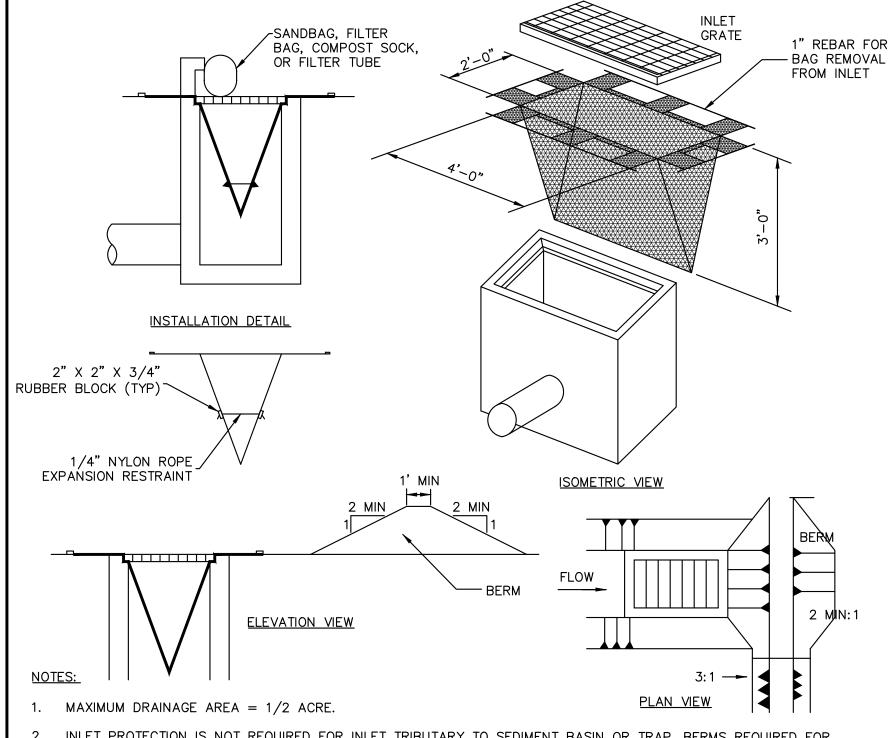
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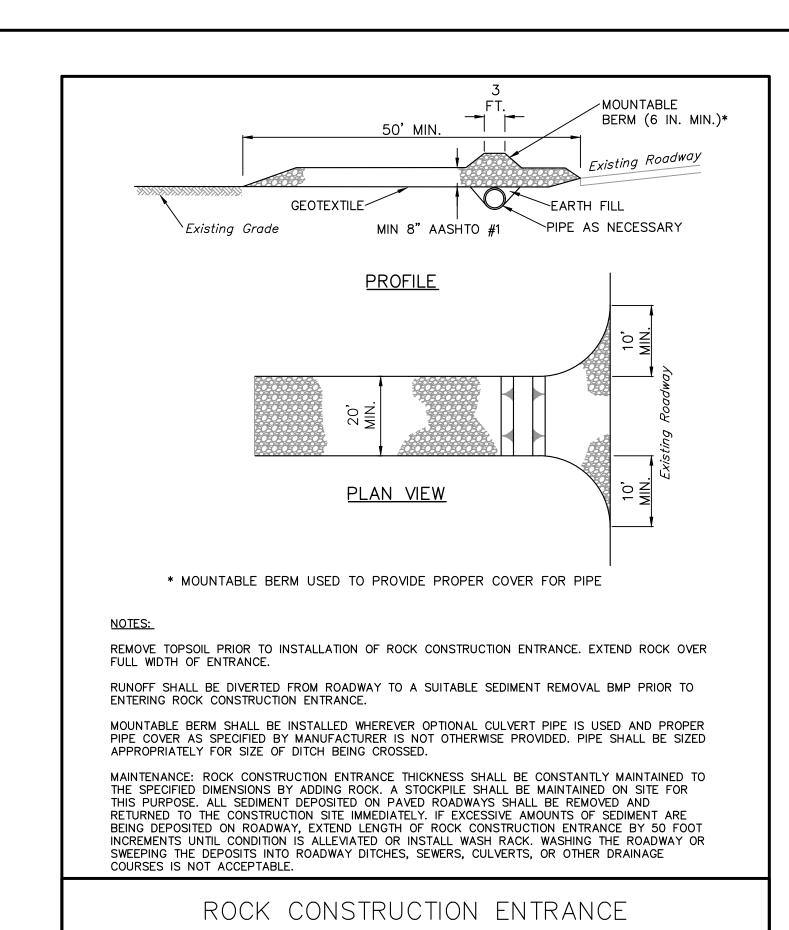
- 1. REMOVE DEPOSITS WHEN SEDIMENT ACCUMULATION IS ONE HALF THE HEIGHT OF THE EXPOSED
- 2. PLACE COMPOST FILTER SOCK ON LEVEL GRADE. EXTEND BOTH ENDS OF THE COMPOST FILTER SOCK AT LEAST 8'-0" UPSLOPE AT 45 DEGREES TO THE MAIN ALIGNMENT.
- REPLACE BIODEGRADABLE FILTER SOCK AFTER 6 MONTHS; PHOTODEGRADABLE AFTER 12 MONTHS.
- 4. ALL DIMENSIONS ARE IN U.S. CUSTOMARY UNITS.
- 5. CONTRACTOR SHALL PROVIDE SAND BAGS, CONCRETE BLOCKS, OR OTHER SUITABLE MATERIAL TO STABILIZE COMPOST FILTER SOCK ON PAVED AREAS AND PREVENT IT FROM MOVING OR SHIFTING.
- 6. STABILIZING DEVICES SHALL BE SPACED 10 FEET ON CENTER OR AS RECOMMENDED BY THE
- MANUFACTURER, WHICHEVER IS LESS. 7. SOCKS SHALL BE INSPECTED WEEKLY AND AFTER EACH RUNOFF EVENT. DAMAGED SOCKS SHALL BE REPAIRED ACCORDING TO MANUFACTURER'S SPECIFICATIONS OR REPLACED WITHIN 24 HOURS OF
- 8. TRAFFIC SHALL NOT BE PERMITTED TO CROSS FILTER SOCKS.


COMPOST FILTER SOCK

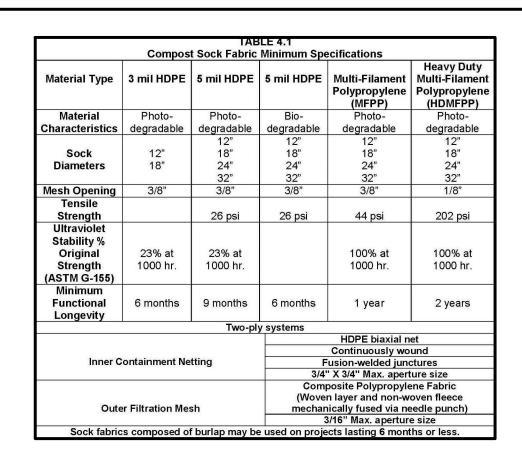

- INLET PROTECTION IS NOT REQUIRED FOR INLET TRIBUTARY TO SEDIMENT BASIN OR TRAP. BERMS REQUIRED FOR
- EARTHEN BERM IN ROADWAY SHALL BE MAINTAINED UNTIL ROADWAY IS STONED. ROAD SUBBASE BERM ON ROADWAY SHALL BE MAINTAINED UNTIL ROADWAY IS PAVED. EARTHEN BERM IN CHANNEL SHALL BE MAINTAINED UNTIL PERMANENT STABILIZATION IS COMPLETED OR TO REMAIN PERMANENTLY.
- 4. DO NOT USE ON MAJOR PAVED ROADWAYS WHERE PONDING MAY CAUSE TRAFFIC HAZARDS


FILTER BAG INLET PROTECTION



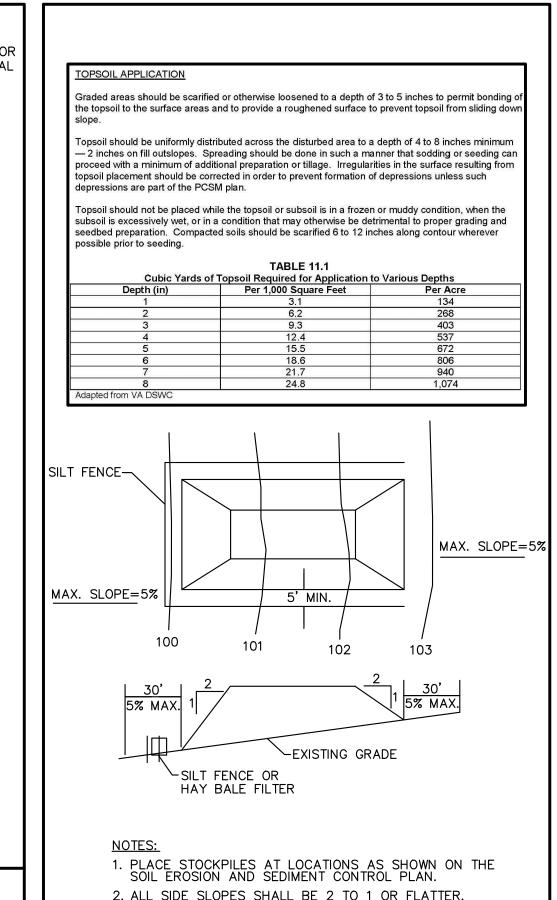

2. ALL SIDE SLOPES SHALL BE 2 TO 1 OR FLATTER. 3. STOCKPILE SHALL RECEIVE A VEGETATIVE COVER IN ACCORDANCE WITH MINIMUM STABILIZATION REQUIRED. 4. SILT FENCE SHALL BE INSTALLED AS DETAILED HEREON. 5. STOCKPILE NOT TO EXCEED 20 FEET IN HEIGHT.

TEMPORARY STOCKPILE

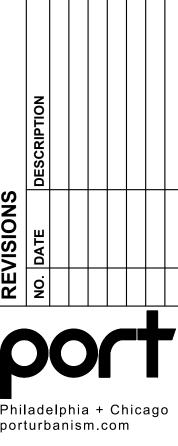

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FRANK ANTHONY FREGA

JOB NO: 2131 **DATE:** 07/22/2022 DRAWN: RDC CHECKED: RSB DRAWING TITLE:

CONTROL

DRAWING NO: | SHEET 16 OF 22

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- 2. INLET PROTECTION SHOULD BE PROVIDED FOR ALL INLETS OWNED BY PWD THAT ARE LOCATED WITHIN ONE BLOCK OF THE PROJECT SITE.
- 3. PWD IS NOT RESPONSIBLE FOR ANY CLEANING OR REPAIRS NEEDED ON CITY-OWNED INFRASTRUCTURE DUE TO FAILURE OF ANY EROSION AND SEDIMENT CONTROL PRACTICES. IT IS THE RESPONSIBILITY OF THE CONTRACTOR TO ENSURE THAT ALL EROSION AND SEDIMENT CONTROL PRACTICES ARE FUNCTIONING IN ACCORDANCE WITH THE APPROVED PLANS.
- 4. INSPECTION AND MAINTENANCE OF ALL EROSION AND SEDIMENT CONTROL BEST MANAGEMENT PRACTICES SHALL OCCUR ON A WEEKLY BASIS, BEFORE ANY ANTICIPATED PRECIPITATION EVENTS, AND AFTER ALL PRECIPITATION EVENTS.
- 5. THE MAXIMUM HEIGHT FOR STOCKPILES AREAS SHALL BE 20 FEET. THE MAXIMUM SIDE SLOPE FOR STOCKPILE AREAS SHALL NOT EXCEED 2:1.
- 6. THE ROCK CONSTRUCTION ENTRANCE THICKNESS SHALL BE CONSTANTLY MAINTAINED ON-SITE. A STOCKPILE SHALL BE MAINTAINED ON-SITE FOR THIS PURPOSE. AT THE END OF EACH CONSTRUCTION DAY, ALL SEDIMENT DEPOSITED ON PAVED ROADWAYS SHALL BE REMOVED AND RETURNED TO THE CONSTRUCTION SITE. IN NO CASE SHALL THE SEDIMENT BE WASHED, SHOVELED, OR SWEPT INTO ANY ROADSIDE DITCH, STORM SEWER, OR SURFACE WATER.
- 7. FILTER FABRIC FENCE SHOULD BE INSTALLED AT LEVEL GRADE. BOTH ENDS OF EACH FENCE SECTION SHOULD BE EXTENDED AT LEAST 8 FEET UPSLOPE AT 45 DEGREES TO THE MAIN BARRIER ALIGNMENT. SUPPORT STAKES SHALL BE SPACED AT A MAXIMUM OF 8 FEET. SEDIMENT MUST BE REMOVED WHEN ACCUMULATIONS REACH 1/2 THE ABOVE GROUND HEIGHT OF THE FILTER FENCE.
- 8. ANY FENCE SECTION WHICH HAS BEEN UNDERMINED OR TOPPED MUST BE IMMEDIATELY REPLACED WITH A ROCK FILTER OUTLET. SEDIMENT MUST BE REMOVED WHEN ACCUMULATIONS REACH 1/3 THE HEIGHT OF THE OUTLET.
- 9. FROSION CONTROL BLANKETING SHALL BE INSTALLED ON ALL SLOPES 3H:1V OR STEEPER WITHIN 50 FEET OF A SURFACE WATER AND ON ALL OTHER DISTURBED AREAS SPECIFIED ON THE PLAN MAPS AND/OR DETAIL SHEETS.
- 10. IMMEDIATELY UPON DISCOVERING UNFORESEEN CIRCUMSTANCES POSING THE POTENTIAL FOR ACCELERATED EROSION AND/OR SEDIMENT POLLUTION, THE OPERATOR SHALL IMPLEMENT APPROPRIATE BEST MANAGEMENT PRACTICES TO MINIMIZE THE POTENTIAL FOR EROSION AND SEDIMENT POLLUTION AND NOTIFY PWD
- 11. UNTIL THE SITE IS STABILIZED, ALL E&S BMP'S SHALL BE MAINTAINED PROPERLY. MAINTENANCE SHALL INCLUDE INSPECTIONS OF ALL E&S BMP'S PRIOR TO ANY ANTICIPATED STORM EVENT, AFTER EACH RUNOFF EVENT AND ON A WEEKLY BASIS. ALL PREVENTATIVE AND REMEDIAL MAINTENANCE WORK, INCLUDING CLEAN OUT, REPAIR, REPLACEMENT, REGRADING, RESEEDING, REMULCHING, AND RENETTING, MUST BE PERFORMED IMMEDIATELY. IF THE E&S BMP'S FAIL TO PERFORM AS EXPECTED, REPLACEMENT BMP'S, OR MODIFICATIONS OF THOSE INSTALLED, WILL BE REQUIRED.
- 12. ALL EARTH DISTURBANCES, INCLUDING CLEARING AND GRUBBING, AS WELL AS CUTS AND FILLS, SHALL BE DONE IN ACCORDANCE WITH THE APPROVED E&S PLAN. A COPY OF THE APPROVED DRAWINGS MUST BE AVAILABLE AT THE PROJECT SITE AT ALL TIMES. PWD SHALL BE NOTIFIED OF ANY CHANGES TO THE APPROVED PLAN PRIOR TO IMPLEMENTATION OF THOSE CHANGES. PWD MAY REQUIRE A WRITTEN SUBMITTAL OF THOSE CHANGES FOR REVIEW AND APPROVAL AT ITS DISCRETION.
- 13. AT LEAST THREE (3) DAYS PRIOR TO STARTING ANY EARTH DISTURBANCE ACTIVITIES, OR EXPANDING INTO AN AREA PREVIOUSLY UNMARKED, THE PENNSYLVANIA ONE CALL SYSTEM INC. SHALL BE NOTIFIED AT 1-800-242-1776 FOR THE LOCATION OF EXISTING UNDERGROUND UTILITIES.
- SEQUENCE PROVIDED ON THE PLAN DRAWINGS. DEVIATION FROM THAT SEQUENCE MUST BE APPROVED IN WRITING BY PWD AND THE PA DEP PRIOR TO

14. ALL EARTH DISTURBANCE ACTIVITIES SHALL PROCEED IN ACCORDANCE WITH THE

- 15. AREAS TO BE FILLED ARE TO BE CLEARED, GRUBBED, AND STRIPPED OF TOPSOIL TO REMOVE TREES, VEGETATION, ROOTS, AND OTHER OBJECTIONABLE MATERIAL.
- 16. CLEARING, GRUBBING, AND TOPSOIL STRIPPING SHALL BE LIMITED TO THOSE AREAS DESCRIBED IN EACH STAGE OF THE CONSTRUCTION SEQUENCE. GENERAL SITE CLEARING, GRUBBING, AND TOPSOIL STRIPPING MAY NOT COMMENCE IN ANY STAGE OF THE PROJECT UNTIL THE E&S BMP'S SPECIFIED BY THE BMP'S SEQUENCE FOR THAT STAGE HAVE BEEN INSTALLED AND ARE FUNCTIONING AS DESCRIBED IN THIS E&S PLAN.
- 17. AT NO TIME SHALL CONSTRUCTION VEHICLES BE ALLOWED TO ENTER AREAS OUTSIDE THE LIMIT OF DISTURBANCE BOUNDARIES SHOWN ON THE PLAN MAPS. THESE AREAS MUST BE CLEARLY MARKED AND FENCED OFF BEFORE CLEARING AND GRUBBING OPERATIONS BEGIN.
- 18. A LOG SHOWING DATES THAT E&S BMP'S WERE INSPECTED AS WELL AS ANY DEFICIENCIES FOUND AND THE DATE THEY WERE CORRECTED SHALL BE MAINTAINED ON THE SITE AND BE MADE AVAILABLE TO PWD AT THE TIME OF INSPECTION.
- 19. ALL SEDIMENT REMOVED FROM BMP'S SHALL BE DISPOSED OF IN THE FOLLOWING MANNER: REMOVAL AND DISPOSAL TO BE AT AN OFF-SITE LOCATION IN ACCORDANCE WITH ALL LOCAL, STATE AND FEDERAL REGULATIONS.
- 20. AREAS WHICH ARE TO BE TOPSOILED SHALL BE SCARIFIED TO A MINIMUM DEPTH OF THREE TO FIVE INCHES -- SIX TO 12 INCHES ON COMPACTED SOILS --PRIOR TO PLACEMENT OF TOPSOIL. AREAS TO BE VEGETATED SHALL HAVE A MINIMUM FOUR INCHES OF TOPSOIL IN PLACE PRIOR TO SEEDING AND MULCHING. FILL OUTSLOPES SHALL HAVE A MINIMUM OF TWO INCHES OF TOPSOIL.
- 21. ALL FILLS SHALL BE COMPACTED AS REQUIRED TO REDUCE EROSION, SLIPPAGE, SETTLEMENT, SUBSIDENCE, OR OTHER RELATED PROBLEMS. FILL INTENDED TO SUPPORT BUILDINGS, STRUCTURES, AND CONDUITS, ETC. SHALL BE COMPACTED IN ACCORDANCE WITH LOCAL REQUIREMENTS OR CODES.
- 22. ALL EARTHEN FILLS SHALL BE PLACED IN COMPACTED LAYERS NOT TO EXCEED NINE INCHES IN THICKNESS.
- 23. FILL MATERIALS SHALL BE FREE OF FROZEN PARTICLES, BRUSH, ROOTS, SOD, OR OTHER FOREIGN OR OBJECTIONABLE MATERIALS THAT WOULD INTERFERE WITH OR PREVENT CONSTRUCTION OF SATISFACTORY FILLS.
- 24. FROZEN MATERIALS OR SOFT, MUCKY, OR HIGHLY COMPRESSIBLE MATERIALS SHALL NOT BE INCORPORATED INTO FILLS.
- 25. FILL SHALL NOT BE PLACED ON SATURATED OR FROZEN SURFACES.
- 26. SEEPS OR SPRINGS ENCOUNTERED DURING CONSTRUCTION SHALL BE HANDLED IN ACCORDANCE WITH THE STANDARD AND SPECIFICATION FOR SUBSURFACE DRAIN OR OTHER APPROVED METHOD.
- 27. ALL GRADED AREAS SHALL BE PERMANENTLY STABILIZED IMMEDIATELY UPON REACHING FINISHED GRADE. CUT SLOPES IN COMPETENT BEDROCK AND ROCK FILLS NEED NOT BE VEGETATED. SEEDED AREAS WITHIN 50 FEET OF A SURFACE WATER, OR AS OTHERWISE SHOWN ON THE PLAN DRAWINGS, SHALL BE BLANKETED

- ACCORDING TO THE STANDARDS OF THIS PLAN.
- 28. IMMEDIATELY AFTER EARTH DISTURBANCE ACTIVITIES CEASE IN ANY AREA OR SUB-AREA OF THE PROJECT, THE OPERATOR SHALL STABILIZE ALL DISTURBED AREAS. DURING NON-GERMINATING MONTHS, MULCH OR PROTECTIVE BLANKETING SHALL BE APPLIED AS DESCRIBED IN THE PLAN. AREAS NOT AT FINISHED GRADE, 5. WHICH WILL BE REACTIVATED WITHIN ONE YEAR, MAY BE STABILIZED IN ACCORDANCE WITH THE TEMPORARY STABILIZATION SPECIFICATIONS. THOSE AREAS WHICH WILL NOT BE REACTIVATED WITHIN ONE YEAR SHALL BE STABILIZED IN ACCORDANCE WITH THE PERMANENT STABILIZATION SPECIFICATIONS.
- 29. PERMANENT STABILIZATION IS DEFINED AS A MINIMUM UNIFORM, PERENNIAL 70% VEGETATIVE COVER OR OTHER PERMANENT NON-VEGETATIVE COVER WITH A DENSITY SUFFICIENT TO RESIST ACCELERATED EROSION. CUT AND FILL SLOPES SHALL BE CAPABLE OF RESISTING FAILURE DUE TO SLUMPING, SLIDING, OR OTHER MOVEMENTS.
- 30. E&S BMP'S SHALL REMAIN FUNCTIONAL AS SUCH UNTIL ALL AREAS TRIBUTARY TO THEM ARE PERMANENTLY STABILIZED OR UNTIL THEY ARE REPLACED BY ANOTHER BMP'S APPROVED BY PWD AND PA DEP.
- 31. AFTER FINAL SITE STABILIZATION HAS BEEN ACHIEVED, TEMPORARY E&S BMP'S MUST BE REMOVED OR CONVERTED TO PERMANENT POST-CONSTRUCTION STORMWATER MANAGEMENT PRACTICES. AREAS DISTURBED DURING REMOVAL OR CONVERSION OF THE E&S BMP'S SHALL BE STABILIZED IMMEDIATELY. IN ORDER TO ENSURE RAPID REVEGETATION OF DISTURBED AREAS, SUCH REMOVAL/CONVERSIONS ARE TO BE DONE ONLY DURING THE GERMINATING
- 32. SEDIMENT BASINS AND/OR TRAPS SHALL BE KEPT FREE OF ALL CONSTRUCTION WASTE, WASH WATER, AND OTHER DEBRIS HAVING POTENTIAL TO CLOG THE BASIN/TRAP OUTLET STRUCTURES AND/OR POLLUTE THE SURFACE WATERS. (WHEN APPLICABLE)
- 33. DURING CONSTRUCTION, THE SELECTED CONTRACTOR IS EXPECTED TO FOLLOW THE PCSMP APPROVED BY PWD (WHERE APPLICABLE). NO CHANGE OR DEVIATION FROM THE APPROVED PCSMP IS PERMITTED WITHOUT PRIOR APPROVAL FROM PWD.
- 34. ALL WORK ASSOCIATED WITH PWD WATER CONVEYANCE AND SEWER INFRASTRUCTURE SHALL BE DONE IN ACCORDANCE WITH THE CITY OF PHILADELPHIA WATER DEPARTMENT "WATER MAIN STANDARD DETAILS AND CORROSION CONTROL SPECIFICATIONS", 1985 EDITION, AND "STANDARD DETAILS AND STANDARD SPECIFICATIONS FOR SEWERS", 1985 EDITION.
- 35. CONTACT PWD WATER TRANSPORT RECORDS (1101 MARKET STREET, 2ND FLOOR, PHONE: 215-685-6271) FOR ADDITIONAL APPROVALS AND PERMITS REQUIRED FOR ALL WATER SERVICES, METERS, AND CONNECTIONS TO THE EXISTING AND/OR PROPOSED PWD FACILITIES.
- 36. ALL BUILDING MATERIALS AND WASTES SHALL BE REMOVED FROM THE SITE AND RECYCLED OR DISPOSED OF IN ACCORDANCE WITH THE PADEP'S SOLID WASTE MANAGEMENT REGULATIONS AT 25 PA CODE 260.1 ET SEQ., 271.1 AND 287.1 ET SEQ. NO BUILDING MATERIALS OR WASTES OR UNUSED BUILDING MATERIALS SHALL BE BURNED, BURIED, DUMPED, OR DISCHARGED AT THE SITE.

SITE STABILIZATION METHODS (TEMPORARY & PERMANENT STABILIZATION)

- 1. STRAW MULCH MUST BE APPLIED AT 3.0 TONS PER ACRE.
- 2. MULCH WITH MULCH CONTROL NETTING OR EROSION CONTROL BLANKETS MUST BE INSTALLED ON ALL SLOPES GREATER THAN 3:1.
- 3. STRAW MULCH SHALL BE APPLIED IN LONG STRANDS, NOT CHOPPED OR FINELY

TEMPORARY SEEDING

- 1. THE FOLLOWING SURFACES OF THE SITE SHALL BE TEMPORARILY SEEDED AND MULCHED:
- A. THE SURFACE OF TOPSOIL STOCKPILES. B. THE SURFACE OF EXPOSED EARTH AREAS THAT WILL BE EXPOSED WITHOUT CONSTRUCTION ACTIVITY THEREON.
- 2. SEEDING SHALL OCCUR IMMEDIATELY AFTER ESTABLISHMENT OF THE TOPSOIL STOCKPILES OR ROUGH GRADED AREAS. THE FOLLOWING SHALL BE PLANTED: A. 40 LBS. / ACRE ANNUAL RYE GRASS - COMMON, 100% P.L.S.
- 3. PREPARE AREAS TO BE SEEDED AS FOLLOWS: A. REMOVE ALL DEBRIS, INCLUDING LARGE STONES. APPLY LIME AT A RATE OF 3 TONS PER ACRE AND FERTILIZER AT THE RATE OF 50-50-50 PER ACRE AND WORK INTO SOIL
- B. SOW SEED AT THE INDICATED RATE. DIVIDE SEED INTO TWO EQUAL LOTS. SOW ONE LOT IN ONE DIRECTION. SOW SECOND LOT AT RIGHT ANGLE TO FIRST. RAKE SEEDED AREA SLIGHTLY. ROLL SURFACE LIGHTLY TO FIRM SOIL AROUND
- 4. PLACE CLEAN DRY STRAW OR HAY MULCH WITHIN 48 HOURS AFTER SEEDING. PLACE AT THE RATE OF 3 TONS PER ACRE.
- 5. SEEDING DATES SHALL BE BETWEEN MARCH 1 AND NOVEMBER 15.

TEMPORARY MULCHING

- 1. MULCH PROPOSED LANDSCAPE AREAS OR TOPSOIL STOCKPILES IF EARTHWORK IS 3. COMPLETED OUTSIDE OF THE RECOMMENDED PLANTING SEASONS FOR TEMPORARY SEEDING OR DUE TO UNFAVORABLE WEATHER CONDITIONS.
- TOPSOIL STOCKPILE OR ROUGH GRADING.
- 3. MULCH WITH SUITABLE FIBROUS GROUND, SHREDDED AGED HARDWOOD, PINE WOOD 5. MAXIMUM HEIGHT FOR STOCKPILE AREAS TO BE 20 FEET. THE MAXIMUM SIDE SLOPE FOR BARK OR STRAW. UNIFORMLY AND CONTINUOUSLY TO A LOOSE DEPTH OF 3 INCHES MINIMUM. ANCHOR AS REQUIRED.
- 4. PROPERLY MAINTAIN MULCHED AREAS UNTIL PERMANENT STABILIZATION MEASURES ARE COMPLETE. REAPPLY MULCH MATERIALS WHICH BECOME DISLODGED AS INITIAL OR MODIFIED RATES AS NECESSARY. IF A SLOPE FAILURE OCCURS WHICH REQUIRES REDRESSING, EXCAVATION, OR THE ESTABLISHMENT OF A NEW SLOPE, REPLACE MULCH AS NECESSARY.

PERMANENT SEEDING

- 1. PERMANENT SEEDING SHALL OCCUR IMMEDIATELY AFTER THE FINAL GRADING IS COMPLETED. THE FOLLOWING SEED SHALL BE PLACED UNLESS OTHERWISE SPECIFIED ON THE PLANS OR DIRECTED IN THE FIELD. THE FOLLOWING SEED MIX SHALL BE USED: A. 40% PENNLAWN FINE FESCUE
- B. 3% RED TOP C. 20% CHAMPION PERENNIAL RYE GRASS QUANTITIES ARE OF PURE LIVE SEED (P.L.S.) SPREAD AT A RATE OF 63 LBS. PER ACRE.
- 2. REMOVE ALL DEBRIS, INCLUDING LARGE STONES. TILL SOIL TO A DEPTH OF FOUR INCHES TO SIX INCHES. APPLY LIME AT A RATE OF 4 TONS PER ACRE. APPLY COMMERCIAL 10-20-20 FERTILIZER AT A RATE OF 930 LBS. PER ACRE. WORK FERTILIZER INTO TOP INCH OF SOIL.
- 3. SEED ONLY AT THE FOLLOWING TIMES: A. SPRING: MARCH 1 TO APRIL 30 B. LATE SUMMER/EARLY FALL: AUGUST 15 TO NOVEMBER 15

- 4. DIVIDE SEED INTO TWO EQUAL LOTS. SOW ONE LOT IN ONE DIRECTION. SOW SECOND LOT AT RIGHT ANGLE TO FIRST LOT. RAKE SEEDED AREA SLIGHTLY. ROLL SURFACE LIGHTLY TO FIRM SOIL AROUND SEED.
- MULCH SEEDED AREAS WITH STRAW OR HAY AT THE RATE OF 3 TONS PER ACRE. ANCHOR MULCH. COMPLY WITH THE REQUIREMENTS OF SECTION 805 - MULCHING, PENNDOT PUBLICATION 408. ANCHOR MULCH AS SPECIFIED.
- 6. MULCHING SHALL BE DONE AT THE MINIMUM RATE OF 3 TONS PER ACRE WITH SALT HAY, HAY OR STRAW MULCHES. PLACE MULCH IMMEDIATELY AFTER SEEDING OR WITHIN 48 HOURS AFTER SEEDING IS COMPLETED. PROPERLY MAINTAIN MULCHED AREAS UNTIL THE ENTIRE PROJECT HAS BEEN COMPLETED. PROMPTLY REAPPLY MULCH MATERIALS WHICH BECOME DISLODGED OR LOST DUE TO WIND, RAIN, OR OTHER CAUSES AT INITIAL RATES OR AS DIRECTED.
- 7. LIQUID MULCH BINDERS MAY BE USED TO ANCHOR SALT HAY, HAY OR STRAW MULCHES. A. APPLICATIONS SHOULD BE HEAVIER AT EDGES WHERE WIND CATCHES THE MULCH IN VALLEYS AND AT CRESTS OF BANKS. REMAINDER OF AREAS SHOULD
- BE UNIFORM IN APPEARANCE. B. USE ONE OF THE FOLLOWING: EMULSIFIED ASPHALT. CLASS E-1 OR E-6. APPLY 31 GALLONS PER 1,000 SQUARE YARDS ON SLOPES LESS THAN 8 FEET HIGH. ON SLOPES 8 FEET HIGH OR MORE. USE 58 GALLONS PER 1,000 SQUARE YARDS. CUTBACK ASPHALT. CLASS RC-250. APPLY 31 GALLONS PER 1,000 SQUARE YARDS ON FLAT AREAS AND ON SLOPES LESS THAN 8 FEET HIGH. ON SLOPES 8 FEET HIGH OR MORE, USE 58 GALLONS PER 1,000 SQUARE YARDS. NON-ASPHALTIC EMULSION - NATURAL VEGETABLE GUM BLENDED WITH GELLING AND HARDENING AGENTS (TERRA TACK, AR) AS MANUFACTURED BY GRASS GROWERS COMPANY OR EQUAL. APPLY 25 LBS. PER 1,000 SQUARE YARDS.

MAINTENANCE PROGRAM

- THE CONTRACTOR WILL BE RESPONSIBLE FOR THE PROPER CONSTRUCTION STABILIZATION, AND MAINTENANCE OF ALL TEMPORARY EROSION AND SEDIMENTATION CONTROL MEASURES AND RELATED ITEMS INCLUDED WITHIN THIS PLAN. THE CONTRACTOR WILL ALSO BE RESPONSIBLE FOR THE PROPER CONSTRUCTION AND STABILIZATION OF PERMANENT CONTROL MEASURES AND RELATED ITEMS INCLUDED WITHIN THIS PLAN.
- 2. THE OWNER WILL BE RESPONSIBLE FOR THE MAINTENANCE OF ALL PERMANENT CONTROL MEASURES.
- 3. UNTIL THE SITE IS STABILIZED, ALL EROSION AND SEDIMENT BMP'S MUST BE MAINTAINED PROPERLY. MAINTENANCE MUST INCLUDE INSPECTIONS OF ALL EROSION AND SEDIMENT CONTROL BMP'S AFTER EACH RUNOFF EVENT AND ON A WEEKLY BASIS. ALL PREVENTATIVE AND REMEDIAL MAINTENANCE WORK INCLUDING CLEAN OUT, REPAIR, REPLACEMENT, REGRADING, RESEEDING, REMULCHING, AND RENETTING, MUST BE DONE IMMEDIATELY. IF EROSION AND SEDIMENT CONTROL BMP'S FAIL TO PERFORM AS EXPECTED, REPLACEMENT BMP'S, OR MODIFICATIONS TO THOSE INSTALLED WILL BE REQUIRED.
- SEDIMENT REMOVED FROM BMP'S SHALL BE DISPOSED OF AT AN OFF-SITE LOCATION IN ACCORDANCE WITH ALL LOCAL, STATE AND FEDERAL REGULATIONS.
- 5. SOIL SEDIMENT REMOVED FROM SILT FENCE DURING REGULAR MAINTENANCE WILL BE INCORPORATED BACK INTO THE EARTHWORK AS FILL ON THE SITE. SOIL SEDIMENT MATERIAL SHALL BE DISTRIBUTED ON-SITE WITHOUT CHANGING DRAINAGE PATTERNS DURING A SPECIFIC CONSTRUCTION STAGE. SILT FENCE INSTALLED ON THE PROJECT SITE SHALL BE MAINTAINED AS FOLLOWS:
- STORM EVENT, WHICHEVER COMES FIRST. ANY NECESSARY REPAIRS WILL BE MADE IMMEDIATELY. B. ACCUMULATED SEDIMENTS WILL BE REMOVED AS REQUIRED TO KEEP THE FENCE

A. THE FENCE CONDITION WILL BE INSPECTED ONCE A WEEK OR AFTER EVERY

- FUNCTIONAL. DEPOSITS WILL BE REMOVED WHERE ACCUMULATIONS REACH ONE-HALF THE ABOVE-GROUND HEIGHT OF THE FENCE. C. UNDERCUTTING OR EROSION OF THE TOE ANCHOR WILL BE REPLACED
- IMMEDIATELY WITH ROCK FILTER OUTLETS. D. ANY MANUFACTURER'S RECOMMENDATIONS WILL BE ADHERED TO WHEN REPLACING FILTER FABRIC FENCE DUE TO WEATHERING.
- 6. AT THE END OF EACH CONSTRUCTION DAY, ANY SEDIMENT DEPOSITED ON PUBLIC ROADWAYS, WILL BE REMOVED AND RETURNED TO THE CONSTRUCTION SITE. WASHING OF THE ROADWAY WITH WATER WILL NOT BE PERMITTED.
- A. SEDIMENT MUST BE REMOVED FROM STORM WATER INLET PROTECTION AFTER EACH RUNOFF EVENT.

EROSION AND SEDIMENT CONTROL (E&SC)

- EXISTING CONCRETE AND BITUMINOUS PAVING TO BE SAW-CUT ALONG LIMIT OF DISTURBANCE LINE WITH A CLEAN CUT LINE TO A SUFFICIENT DEPTH TO ALLOW THE REMOVAL OF PAVING WITHOUT DISTURBING THE EXISTING PAVING THAT IS TO REMAIN
- 2. THE CONTRACTOR SHALL REMOVE FROM THE SITE ALL DEBRIS, RUBBISH AND OTHER MATERIALS RESULTING FROM DEMOLITION AND SHALL SAFELY AND LEGALLY DISPOSE OF ALL THESE ITEMS IN ACCORDANCE WITH APPLICABLE LOCAL, FEDERAL, STATE AND REGULATORY AUTHORITY HAVING JURISDICTION. RECYCLING MUST BE DONE IN ACCORDANCE WITH APPLICABLE REGULATIONS. BURNING OF ANY DEMOLISHED MATERIALS ON-SITE SHALL NOT BE PERMITTED. RECYCLING OF DEMOLITION DEBRIS SHALL BE APPROVED BY THE OWNER. ALL EXISTING FILL TO BE REMOVED FROM SITE IN ACCORDANCE WITH THE PA DEP MANAGEMENT OF FILL POLICY AND REGULATIONS.
- COMPOST FILTER SOCK ON PAVING TO BE WEIGHTED DOWN BY OBJECTS OF CONSIDERABLE MASS (SAND BAGS, CONCRETE BLOCK OR OTHER SUITABLE MATERIAL). COMPOST FILTER SOCK TO BE INSTALLED DOWNSTREAM OF ALL EARTH MOVING ACTIVITIES.
- 2. MULCH SHALL BE APPLIED IMMEDIATELY FOLLOWING THE ESTABLISHMENT OF THE 4. INLET PROTECTION IN ROADWAYS NOT TO INCLUDE STONE OR BERMS FOR ROADWAY MAINTENANCE PURPOSES.
 - STOCKPILE AREAS NOT TO EXCEED 2:1.
 - 6. RUMBLE PAD CONSTRUCTION ENTRANCE TO BE SIZED IN ACCORDANCE WITH PA DEP MINIMUM REQUIREMENTS OF 50'L X 20'W AND BE INSTALLED IN ACCORDANCE WITH MANUFACTURES RECOMMENDATIONS.
 - CONSTRUCTION, DEMOLITION AND EARTHWORK DUST CONTROL TO BE COMPLETED IN ACCORDANCE WITH THE CITY OF PHILADELPHIA DUST CONTROL REQUIREMENTS (AIR MANAGEMENT REGULATION (AMR) II. SECTION IX.) AND TO INCLUDE BUT NOT LIMITED TO:
 - a. NOTIFY OCCUPANTS OF NEARBY PROPERTIES, IN WRITING 10 DAYS BEFORE ENGAGING IN EARTHWORK, CONSTRUCTION AND DEMOLITION ACTIVITIES.
 - b. USE OF VACUUM OR SIMILAR SUCTION SYSTEMS TO CAPTURE DUST KICKED UP BY POWER TOOLS WHEN GRINDING OR CUTTING. c. APPLICATION OF WATER OR APPROVED DUST CONTROL SUPPRESSANT DURING EXCAVATION, DEMOLITION AND/OR CONSTRUCTION TO SUPPRESS DUST FORMATION.
 - d. COVERING AND WETTING OF STOCKPILES EARTH, SAND, GRAVEL AND OTHER SIMILAR CONSTRUCTION MATERIALS. e. ALL PERIMETER FENCING MUST HAVE DUST CONTROL FABRIC AND MUST MEASURE A MINIMUM OF 5 FT IN HEIGHT FROM THE BOTTOM OF FENCING.

f. 10 MILE PER HOUR SPEED LIMIT FOR ALL EQUIPMENT AND TRUCKS TRAVELING WITHIN

- THE WORK SITE. g. WETTING AND SWEEPING OF ROADWAYS / ACCESS ROAD IN A WORK SITE TO PREVENT DUST FORMATION.
- 8. PERMANENT INLET PROTECTION TO BE INSTALLED ON ALL INLETS THAT DRAIN TO THE UNDERGROUND STORMWATER MANAGEMENT SYSTEMS IN ACCORDANCE WITH THE SPECIFICATIONS.

CONSTRUCTION SEQUENCE:

- 1. AT LEAST 7 DAYS PRIOR TO STARTING ANY FARTH DISTURBANCE ACTIVITIES. THE OPERATOR SHALL INVITE ALL CONTRACTORS INVOLVED IN EARTH MOVING ACTIVITIES, THE LANDOWNER, ALL APPROPRIATE CITY OFFICIALS, THE EROSION AND SEDIMENT CONTROL PREPARER, AND REPRESENTATIVE OF THE CITY OF PHILADELPHIA EROSION AND SEDIMENT CONTROL OFFICE TO AN ON-SITE MEETING. INCLUDE A REPRESENTATIVE FROM PWD'S EROSION AND SEDIMENT CONTROL INSPECTION GROUP BY CONTACTING THE INSPECTIONS COORDINATOR OF PWD (OFFICE 215-685-6387).
- 2. AT LEAST 3 DAYS BEFORE STARTING ANY EARTH DISTURBANCE ACTIVITIES, ALL CONTRACTORS INVOLVED IN THOSE ACTIVITIES SHALL NOTIFY THE PENNSYLVANIA ONE CALL SYSTEM INCORPORATED AT 1-800-242-1776 FOR BURIED UTILITY LOCATIONS.
- 3. CONSTRUCTION FENCE TO BE INSTALLED WHERE NEEDED TO PROTECT THE PUBLIC FROM LAND DISTURBANCE ACTIVITIES AND TO MAINTAIN PEDESTRIAN ACCESS.
- 4. INSTALL COMPOST FILTER SOCK DOWNHILL FROM ALL EARTH MOVING ACTIVITIES. COMPOST FILTER SOCK OR OTHER EROSION CONTROL PRACTICES SHALL BE INSTALLED AROUND THE PERIMETER OF THE SITE AS SHOWN ON THE PLAN.
- 5. INSTALL INLET PROTECTION AS SHOWN ON THE PLAN. EXISTING INLETS SHALL BE PROTECTED THROUGHOUT THE DURATION OF THE CONSTRUCTION.
- INSTALL CONSTRUCTION ENTRANCE AS SHOWN AND IN ACCORDANCE WITH THE CONSTRUCTION ENTRANCE DETAIL.
- 7. CONTRACTOR SHALL PROVIDE PROTECTION OF ANY EXISTING UTILITIES, SURFACE FEATURES AND PAVEMENTS THAT ARE TO REMAIN THROUGHOUT THE DURATION OF PROJECT CONSTRUCTION.
- 8. CLEAR SITE WITHIN LIMIT OF DISTURBANCE AREA, DEMOLISH EXISTING ASPHALT AND CONCRETE PAVING, PLAYGROUND EQUIPMENT, AND TREES MARKED FOR REMOVAL. SAWCUT PAVED AREAS AS NEEDED TO MINIMIZE EARTH DISTURBANCE. DEMOLISHED MATERIAL SHALL BE REMOVED FROM THE SITE AND DISCARDED IN ACCORDANCE WITH APPLICABLE CITY, STATE AND FEDERAL REGULATIONS.
- 9. EXCAVATE AND INSTALL PROPOSED METER PIT AND BACKFLOW PREVENTER PAD AS SHOWN
- 10. EXCAVATE TRENCHES FOR PROPOSED WATER SERVICE CONNECTION.
- 11. INSTALL NEW WATER SERVICE LATERAL AS SHOWN ON THE PLANS.
- 12. INSTALL PROPOSED PLAYGROUND EQUIPMENT, BENCHES, SPRAYGROUND EQUIPMENT, AND DRINKING FOUNTAIN AS SHOWN ON THE PLANS.
- 13. ROUGH GRADE REMAINING SUBBASE TO REQUIRED DEPTHS.
- 14. AS SOON AS SLOPES, CHANNEL DITCHES AND OTHER DISTURBED AREAS REACH FINAL GRADE, THEY MUST BE STABILIZED. CESSATION OF ACTIVITY FOR FOUR (4) DAYS OR LONGER REQUIRES TEMPORARY STABILIZATION.
- 15. CONSTRUCT FULL DEPTH PAVEMENT AS SHOWN ON THE PLANS.
- 16. TOPSOIL AND SEED GRASSED AREAS, INSTALL PLANTS, TREES, AND MULCH AS REQUIRED.
- 17. SWEEP PAVED AREAS DAILY TO PREVENT TRACKING OF SOIL OFF-SITE.
- 18. UPON COMPLETION OF ALL EARTH DISTURBANCE ACTIVITIES AND PERMANENT STABILIZATION OF ALL DISTURBED AREAS, THE CONTRACTOR AND/OR OPERATOR SHALL CONTACT INSPECTIONS COORDINATOR OF PWD (OFFICE: 215-685-6387) FOR A FINAL INSPECTION PRIOR TO REMOVAL ON THE E&SC BMP'S.
- 19. REMOVE SOIL EROSION MEASURES AFTER SITE HAS BEEN INSPECTED AND STABILIZED.

MAINTENANCE NOTES:

ALL MEASURES STATED ON THIS EROSION AND SEDIMENT CONTROL PLAN SHALL BE MAINTAINED IN FULLY FUNCTIONAL CONDITION UNTIL NO LONGER REQUIRED FOR A COMPLETED PHASE OF WORK OR FINAL STABILIZATION OF THE SITE. ALL FROSION AND SEDIMENTATION CONTROL MEASURES SHALL BE CHECKED BY A QUALIFIED PERSON IN ACCORDANCE WITH THE CONTRACT DOCUMENTS OR THE APPLICABLE PERMIT, WHICHEVER IS MORE STRINGENT, AND REPAIRED IN ACCORDANCE WITH THE FOLLOWING:

- 1. INLET PROTECTION DEVICES AND BARRIERS SHALL BE REPAIRED OR REPLACED IF THEY SHOW SIGNS OF UNDERMINING, OR DETERIORATION.
- 2. ALL SEEDED AREAS SHALL BE CHECKED REGULARLY TO SEE THAT A GOOD STAND IS MAINTAINED. AREAS SHOULD BE FERTILIZED, WATERED, AND RESEEDED AS NEEDED.
- 3. COMPOST FILTER SOCKS SHALL BE REPAIRED TO THEIR ORIGINAL CONDITIONS IF DAMAGED. SEDIMENT SHALL BE REMOVED WHEN IT REACHES ONE-HALF THE HEIGHT OF THE EXPOSED
- 4. THE CONSTRUCTION ENTRANCE SHALL BE MAINTAINED IN A CONDITION WHICH WILL PREVENT TRACKING OR FLOW OF MUD ONTO PUBLIC RIGHTS-OF-WAY. THIS MAY REQUIRE PERIODIC TOP DRESSING OF THE CONSTRUCTION ENTRANCE AS CONDITIONS DEMAND.

INSPECTIONS ARE TO BE LOGGED, DATED AND KEPT ON-SITE AT ALL TIMES.

BMPs ARE TO BE INSPECTED ON A WEEKLY BASIS AND AFTER STORMWATER EVENTS.

Philadelphia + Chicago porturbanism.com

1315 Walnut Street, Suite 1108 Philadelphia, PA. 19107

CIVIL ENGINEER KS Engineers, P.C. 530 Walnut Street, Suite 460 Philadelphia, PA. 19106

MEP ENGINEER Arora Engineers, Inc. 61 Wilmington-West Chester Pike, Chadds Ford, PA 19317

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FRANK ANTHONY FREG PA P.E. LICENSE NO. PE041605R

JOB NO: 2131 DATE: 07/22/2022 **DRAWN:** RDC CHECKED: RSB DRAWING TITLE: CONTROL

ENGINEERS • SURVEYORS • CONSTRUCTION MANAGERS 530 WALNUT STREET SUITE 460 PHILADELPHIA, PENNSYLVANIA 19106 PHONE: 215.925.0425 • FAX: 215.925.0430

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NOTES: 1. LOCATE METER PIT OUTSIDE TRAFFIC LANES. 2. PLUMBER SHALL SPECIFY THE TYPE OF CONNECTIONS THE COPPERSETTER WILL BE EQUIPPED WITH. 3. PLUMBER ALSO TO SPECIFY THE EXACT LAYING LENGTH NEEDED IN THE COPPERSETTER FOR BACKFLOW PREVENTER. 4. WALL OPENING FOR PIPE SHALL BE CIRCULAR WITH DIAMETER 1" GREATER THAN THE PIPE.

5. BACKFLOW PREVENTION PLAN MUST BE

GRAVEL

OFFICE.

REVIEWED BY THE BACKFLOW COMPLIANCE

UNOBSTRUCTED 6½"x6½" AREA --MINIMUM 20" DIAMETER COVER AND 1700 OHOLE FOR METER TRANSMITTER PIT MOUNT (FORD No.36 MONITOR COVER WITH DOUBLE EXTRA HEAVY LID AND INNER LID OR APPROVED EQUAL) 36" DIAMETER-CONCRETE PIPE METER ASSEMBLY - COPPERSETTER SUPPORT BRACE (FORD MODEL 70 SERIES W/ BALL VALVE AND SADDLE NUTS OR APPROVED EQUAL) CONCRETE -FOOTING DIMENSION

SECTION VIEW

PLAN VIEW

WATER METER NOTES: 1. WATER METER SHALL BE CONNECTED TO THE SERVICE PIPE WITH FLANGES

2. SERVICE PIPE SHALL BE DUCTILE IRON FLANGED PIPE IN ACCORDANCE WITH ANSI/AWWA C115/A21.15.

3. FLANGES SHALL BE PRODUCES OF BRONZE AND SHALL BE FACED, DRILLED AND TAPPED IN CONFORMANCE WITH ANSI B.2.1. FLANGE DIMENSION SHALL CONFORM TO AWWA C700.

4. FLANGED FITTINGS SHALL BE PRODUCED OF DUCTILE IRON AND CONFORM TO THE APPLICABLE REQUIREMENTS FOR DUCTILE IRON FITTINGS SPECIFIED IN ANSI/AWWA C110/A21.10

5. FLANGES OF BOTH DUCTILE IRON FLANGED PIPE AND FITTINGS SHALL BE ADEQUATE FOR WATER SERVICE OF 250 PSI WORKING PRESSURE. THE BOLT CIRCLE AND BOLT HOLES OF THE FLANGES SHALL MATCH THOSE OF THE CLASS 125 FLANGES SHOWN IN ANSI B16.1.

6. NUTS AND BOLTS SHALL BE IN ACCORDANCE WITH ASTM STANDARD A 193-B7 AND A 194, GRADE 4.

7. GASKETS SHALL BE 1 THICK AND MADE OF EITHER SBR OR NEOPRENE RUBBER MEETING THE MATERIAL REQUIREMENTS OF ANSI/AWWA C111/A21.11 MECHANICAL JOINT GASKETS

8. GATE VALVES SHALL BE SUITABLE FOR WATER SERVICE OF 150 PSI WORKING PRESSURE AND SHALL BE IN ACCORDANCE WITH AWWA C500.

9. PRECAST METER PITS AND MANUFACTURES SHALL BE CERTIFIED IN ACCORDANCE WITH QC-1 FOR PRECAST CONCRETE PRODUCTS BY THE PWD CERTIFICATION STAFF.

10. METER PITS SHALL BE DESIGNED FOR H-20 LOADING AND ALL PRECAST SEGMENTS SHALL BE KEYED AND THEIR JOINTS WATERTIGHT.

11. CONCRETE SHALL CONSIST OF PORTLAND CEMENT WHICH CONFORMS TO ASTM C150 AND AGGREGATE WHICH CONFORMS TO ASTM C33. MINIMUM COMPRESSIVE STRENGTH SHALL BE 4000 PSI.

12. REINFORCING STEEL SHALL CONFORM TO ASTM A615 GRADE 60 FOR BARS OR ASTM A185 FOR WELDED WIRE FABRIC.

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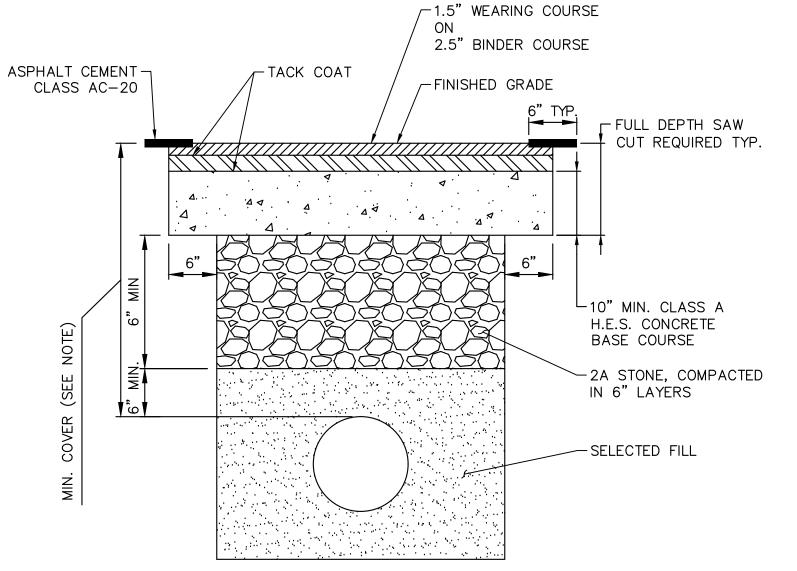
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FRANK ANTHONY FREGA PA P.E. LICENSE NO. PE041605R

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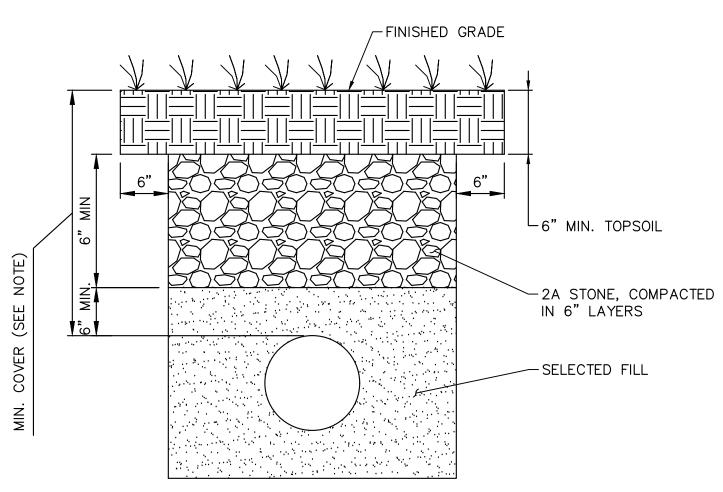
METER PIT SCALE: N.T.S.



NOTE:

- 1. MINIMUM COVER: NO STRUCTURE SHALL BE PLACED LESS THAN 24-INCHES BELOW THE CARTWAY OR 15-INCHES BELOW THE FOOTWAY.
- 2. REPLACE ALL DISTURBED PAVEMENT MARKINGS WITH THERMOPLASTIC TAPE.
- 3. PAVEMENT MARKINGS MUST BE RESTORED WITHIN 7 DAYS OF
- TRENCH RESTORATION. 4. ALL RESTORATION TO BE IN ACCORDANCE WITH THE LATEST STREETS DEPARTMENT STANDARDS.

PERMANENT TRENCH RESTORATION DETAIL FOR ROADWAY REPAIR SCALE: N.T.S.



NOTE:

SCALE: N.T.S.

- 1. MINIMUM COVER: NO STRUCTURE SHALL BE PLACED LESS THAN 24-INCHES BELOW THE CARTWAY OR 15-INCHES BELOW THE FOOTWAY.
- 2. ALL RESTORATION TO BE IN ACCORDANCE WITH THE LATEST STREETS DEPARTMENT STANDARDS.

-3,000 PSI CONCRETE PAD RPZ ENCLOSURE <u>PLAN</u> SIZE IN ACCORDANCE WITH BACKFLOW PREVENTER REDUCED PRESSURE BACKFLOW PREVENTION ASSEMBLY -3,000 PSICONCRETE PAD FROM METER PIT

PIPE SIZE

10 - 3/4"

5/8"

7 - 1/2"

BACKFLOW PREVENTER SCALE: N.T.S.

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KS ENGINEERS, P.C.

ENGINEERS • SURVEYORS • CONSTRUCTION MANAGERS 530 WALNUT STREET SUITE 460 PHILADELPHIA, PENNSYLVANIA 19106 PHONE: 215.925.0425 • FAX: 215.925.0430

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DRAWING TITLE:

UTILITY

DETAILS

07/22/2022

DATE:

PERMANENT TRENCH RESTORATION DETAIL FOR EARTH REPAIR

ELECTRICAL GENERAL NOTES:

- 1. ALL WORK SHALL BE IN ACCORDANCE WITH ALL APPLICABLE LAWS, CODES, AND REGULATIONS ADOPTED BY MUNICIPAL, COUNTY, STATE, AND FEDERAL AUTHORITIES, INCLUDING THE LATEST ADOPTED EDITION OF THE NATIONAL ELECTRICAL CODE (NEC) NFPA 70, AND WITH THE REQUIREMENTS/AMENDMENTS OF THE LOCAL AUTHORITY HAVING JURISDICTION (AHJ).
- 2. CONTRACTOR SHALL COORDINATE EXISTING SECURITY SYSTEM INFRASTRUCTURE, FINAL INSTALLATION, AND REQUIRED DEVICE/EQUIPMENT FOR A FULLY OPERATIONAL SYSTEM WITH THE SECURITY SYSTEM (FIDELITY ALARM) REPRESENTATIVE FOR THE NEW SECURITY CAMERA INSTALLATION PRIOR TO BIDDING.
- CONTRACT DRAWINGS ARE DIAGRAMMATIC IN NATURE AND ARE INTENDED TO CONVEY SCOPE, DESIGN INTENT, AND GENERAL ARRANGEMENT ONLY. CONTRACTOR IS RESPONSIBLE FOR COORDINATING ALL WORK OF ALL TRADES INCLUDING RESOLUTION OF FIELD CONFLICTS THAT MAY ARISE.
- 4. WIREWAY, JUNCTION AND PULL BOXES ARE NOT NECESSARILY INDICATED, BUT SHALL BE PROVIDED WHERE MANDATED BY THE NEC, AND AS REQUIRED FOR EASE OF INSTALLATION. BOXES SHALL BE SIZED (MINIMUM) IN ACCORDANCE WITH NEC ARTICLE 314. TROUGHS SHALL BE SIZED PER NEC ARTICLE 376.
- 5. PROVIDE A DEDICATED NEUTRAL FOR ALL 120V CIRCUITS.
- 6. VERIFY EXACT LOCATION OF ALL EQUIPMENT WITH EQUIPMENT INSTALLER PRIOR TO ROUGH-IN.
- 7. CONTRACTOR SHALL FIELD VERIFY DIMENSIONS AND LOCATIONS OF FINISHED CONSTRUCTION PRIOR TO FABRICATION AND INSTALLATION OF FIXTURES AND EQUIPMENT. ANY DISCREPANCIES SHALL BE REPORTED TO THE ARCHITECT/ENGINEER.
- 8. EXISTING CONDITIONS AND UTILITIES INDICATED ARE TAKEN FROM EXISTING CONSTRUCTION DOCUMENTS, VARIOUS SURVEYS AND FIELD INVESTIGATIONS. CONTRACTOR IS TO FIELD VERIFY DIMENSIONS OF ALL SITE UTILITIES, ETC., PRIOR TO BID AND INCLUDE ANY DEVIATIONS IN THE CONTRACT.
- 9. LOCATE ALL EXISTING UTILITIES AND PROTECT THEM FROM DAMAGE.
- 10. ELECTRICAL CONTRACTOR SHALL FURNISH, INSTALL, CONNECT AND MAINTAIN TEMPORARY ELECTRICAL SERVICES AND LIGHTING THROUGHOUT THE ENTIRE PROJECT AREA WHERE REQUIRED BY OTHER TRADES UNTIL NEW, PERMANENT SERVICES ARE INSTALLED. CONTRACTOR SHALL RELOCATE OR OTHERWISE MODIFY TEMPORARY SERVICES AS MANY TIMES AS NECESSARY FOR THE WORK OF ALL CONTRACTORS TO PROCEED UNTIL COMPLETION OF THE PROJECT. ALL TEMPORARY ELECTRICAL WIRING AND/OR ELECTRICAL DEVICES SHALL HAVE GROUND FAULT PROTECTION DURING THE ENTIRE CONSTRUCTION PROJECT LENGTH. THE INSTALLATION AND MAINTENANCE OF ALL TEMPORARY SERVICES SHALL COMPLY WITH APPLICABLE NEC AND OSHA REQUIREMENTS.
- 11. CONTRACTOR SHALL, UPON COMPLETION OF THE WORK, SUBMIT AS-BUILT RECORD DRAWINGS SHOWING ALL CHANGES FROM THE CONTRACT DRAWINGS MADE DURING THE INSTALLATION. DIMENSION LOCATIONS OF CONCEALED EQUIPMENT.
- 12. UNLESS OTHERWISE NOTED, ALL PARTS, EQUIPMENT, MATERIALS SHALL BE NEW AND FROM SAME MANUFACTURER AND UL LISTED.
- 13. UPON COMPLETION OF WORK, CONTRACTOR SHALL THOROUGHLY CLEAN ALL WORK AREAS AND EQUIPMENT AS REQUIRED.
- 14. COORDINATE ALL CONDUIT ROUTING WITH EXISTING CONDITIONS AND UTILITIES.
- 15. ALL EXPOSED CONDUITS SHALL BE RGS UNLESS OTHERWISE NOTED.
- 16. PROVIDE PULL STRINGS IN ALL EMPTY CONDUIT, RACEWAYS AND LABEL AT EACH END.
- 17. ALL CONDUCTORS INCREASED IN SIZE FOR VOLTAGE DROP CONSIDERATION SHALL BE SPLICED TO APPROPRIATE SIZE CONDUCTORS FOR TERMINATING ONTO EQUIPMENT AND DEVICES. SPLICES SHALL BE MADE INSIDE THE EQUIPMENT AS ALLOWED BY THE NEC OR AT THE CLOSEST JUNCTION BOX TO THE EQUIPMENT OR DEVICE. THE SPLICED CONDUCTOR SHALL BE SIZED AS THE LARGEST ACCEPTABLE CONDUCTOR BASE ON THE TERMINATION OF THE EQUIPMENT OR DEVICE.
- 18. CALL BEFORE YOU DIG (PA ONE CALL SYSTEM 1-800-242-1776 OR DIAL 811). ELECTRICAL CONTRACTOR TO HIRE AN INDEPENDENT UTILITY LOCATING COMPANY TO MARK-OUT CUSTOMER OWNED/PRIVATE PROPERTY FACILITIES BEFORE DIGGING AT ELECTRICAL CONTRACTOR'S EXPENSE.
- 19. THE CONTRACTOR SHALL DETERMINE THE EXTENT, EXACT LOCATION AND DEPTH OF ALL EXISTING UTILITIES AND UNDERGROUND VAULTS PRIOR TO COMMENCING WORK.
- 20. ALL CONDUCTORS SHALL BE COLOR-CODED, SINGLE CONDUCTOR, COPPER WIRE OF THE SPECIFIED SIZE, 600V, TYPE XHHW/XHHW-2 INSULATION, #12 AWG MINIMUM, UNLESS NOTED OTHERWISE.
- 21. THE ELECTRICAL CONTRACTOR HAS FULL RESPONSIBILITY FOR MEETING WITH THE LOCAL ELECTRIC UTILITY AND COORDINATING WITH THE LOCAL ELECTRIC UTILITY COMPANY'S REQUIREMENTS BEFORE INSTALLATION BEGINS.

CONVENTIONS:

ELECTRICAL EQUIPMENT DESIGNATED BY SOLID HEAVY LINE WEIGHT INDICATES NEW WORK TO BE HEAVY LINE WEIGHT INDICATES NEW WORK TO BE FURNISHED AND INSTALLED. ELECTRICAL EQUIPMENT DESIGNATED BY SOLID LIGHT LINE WEIGHT INDICATES EXISTING EQUIPMENT TO REMAIN. UNLESS OTHERWISE INDICATED.

ELECTRICAL EQUIPMENT DESIGNATED BY DASHED HEAVY LINE WEIGHT REPRESENTS EXISTING EQUIPMENT TO BE REMOVED AND DISPOSED. UNLESS INDICATED TO BE REMOUNTED, RELOCATED, OR TURNED OVER TO OWNER.


ELECTRICAL LINE TYPE:

UNDERGROUND DUCTBANK AND CONDUCTOR, (FURNISH AND INSTALL)

ELECTRICAL SYMBOLS: DUPLEX RECEPTACLE, NEMA 5-20R, 20A, 125V \Rightarrow DUPLEX RECEPTACLE, NEMA 5-20R, 20A, 125V WITH ⇒ GFI (GFCI) GROUND FAULT CURRENT INTERRUPTER $\Longrightarrow_{\mathsf{WP}}$ DUPLEX RECEPTACLE, NEMA 5-20R, 20A, 125V WITH (GFCI) GROUND FAULT CURRENT INTERRUPTER PROTECTION IN A WEATHER-PROOF ENCLOSURE \rightarrow SIMPLEX RECEPTACLE, NEMA 5-20R, 20A, 125V QUADRUPLEX RECEPTACLE, NEMA 5-20R, 20A, 125V 20A, 120/277 VAC, SINGLE POLE TOGGLE SWITCH WEATHER PROOF SWITCH MANUAL MOTOR RATED SWITCH NON-FUSIBLE DISCONNECT SWITCH, SIZE AS NOTED \boxtimes COMBINATION MAGNETIC STARTER, SIZE AS REQUIRED BY NEC FUSIBLE DISCONNECT SWITCH, SIZE AS NOTED LOOP LINE INDICATES CIRCUIT CONDUCTORS AND CONDUIT CONNECTING IDENTIFIED DEVICES. INDICATES HOMERUN CIRCUIT CONDUCTORS AND CONDUIT CONNECTING IDENTIFIED DEVICES TO PANEL XX:X **ENCLOSED CIRCUIT BREAKER BOX** J JUNCTION BOX TRANSFORMER

SURFACE MOUNTED PANELBOARD

PHOTO CELL

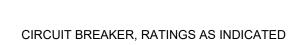



ELECTRICAL HANDHOLE 24" L x 24" W x 12" D, TIER 15 RATED PRECAST CONCRETE



FIXED CCTV SURVEILLANCE CAMERA COORDINATE FINAL SELECTION WITH REBUILD/PPR REPRESENTATIVE PRIOR TO

LIGHT SYMBOLS:




POLE MOUNTED LIGHT FIXTURE, TYPE AS NOTED

ELEC ₁	TRICAL ABBREVIATIONS:
A, AMP	AMPERES
AC	ALTERNATING CURRENT
AFCI	ARC FAULT CIRCUIT INTERRUPTER
AFF	ABOVE FINISHED FLOOR
AFG	ABOVE FINISHED GRADE
AHU	AIR HANDLING UNIT
AIC	AMP INTERRUPTING CAPACITY
AT	AMP TRIP
AF	AMP FRAME
ATS	AUTOMATIC TRANSFER SWITCH
AWG	AMERICAN WIRE GAUGE
BKR	BREAKER
C, CND	CONDUIT
C.B.	CIRCUIT BREAKER
CKT	CIRCUIT
COMM	COMMUNICATION
CU DC	COPPER
DWG	DIRECT CURRENT DRAWING
(E)	EXISTING WORK/EQUIPMENT TO REMAIN
(ER)	
EC	EXISTING WORK/EQUIPMENT TO BE REMOVED AND RELOCATED ELECTRICAL CONTRACTOR
ELEC	ELECTRICAL
EQUIP	EQUIPMENT
EM	EMERGENCY
EMT	ELECTRICAL METALLIC TUBING
FT	FOOT (FEET)
G, GND	GROUND
GFCI, GFI	GROUND FAULT CIRCUIT INTERRUPTER
HZ	HERTZ
HOA	HAND OFF AUTO SWITCH
JB	JUNCTION BOX
KA	KILO AMPERES
KAIC KVA	KILO AMPERES INTERRUPTING CURRENT
KVA KW	KILO VOLTS AMPERES
LFMC	KILOWATTS LIQUID TIGHT FLEXIBLE METAL CONDUIT
MC	MECHANICAL CONTRACTOR
MCB	MAIN CIRCUIT BREAKER
MCA	MAXIMUM CIRCUIT AMPACITY
MIN	MINIMUM
MISC	MISCELLANEOUS
MLO	MAIN LUG ONLY
MOCP	MAXIMUM OVER CURRENT PROTECTION
MOCD	MAXIMUM OVER CURRENT PROTECTIVE DEVICE
(N)	NEW
NEC NIC	NATIONAL ELECTRIC CODE
NTS	NOT IN CONTRACT NOT TO SCALE
P	POLE
PH, Ø	PHASE
PNL	PANEL
PWR	POWER
(R)	EXISTING EQUIPMENT TO BE DISCONNECTED AND REMOVED
(RE)	RELOCATED EXISTING WORK
RCPT	RECEPTACLE
RGS	RIGID GALVANIZED STEEL
RMC	RIGID METAL CONDUIT
RM BNC	ROOM
RNC SCCR	RIGID NON-METALLIC CONDUIT
SER	SHORT CIRCUIT CURRENT RATING SERVICE ENTRANCE RATED
SPECS	SPECIFICATIONS
TYP.	TYPICAL
UE	UNDERGROUND ELECTRIC
HON	LINE FOR OTHERWISE NOTED

UNLESS OTHERWISE NOTED

VERIFY IN FIELD WEATHER PROOF TRANSFORMER

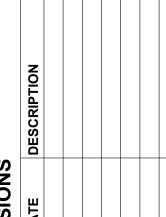



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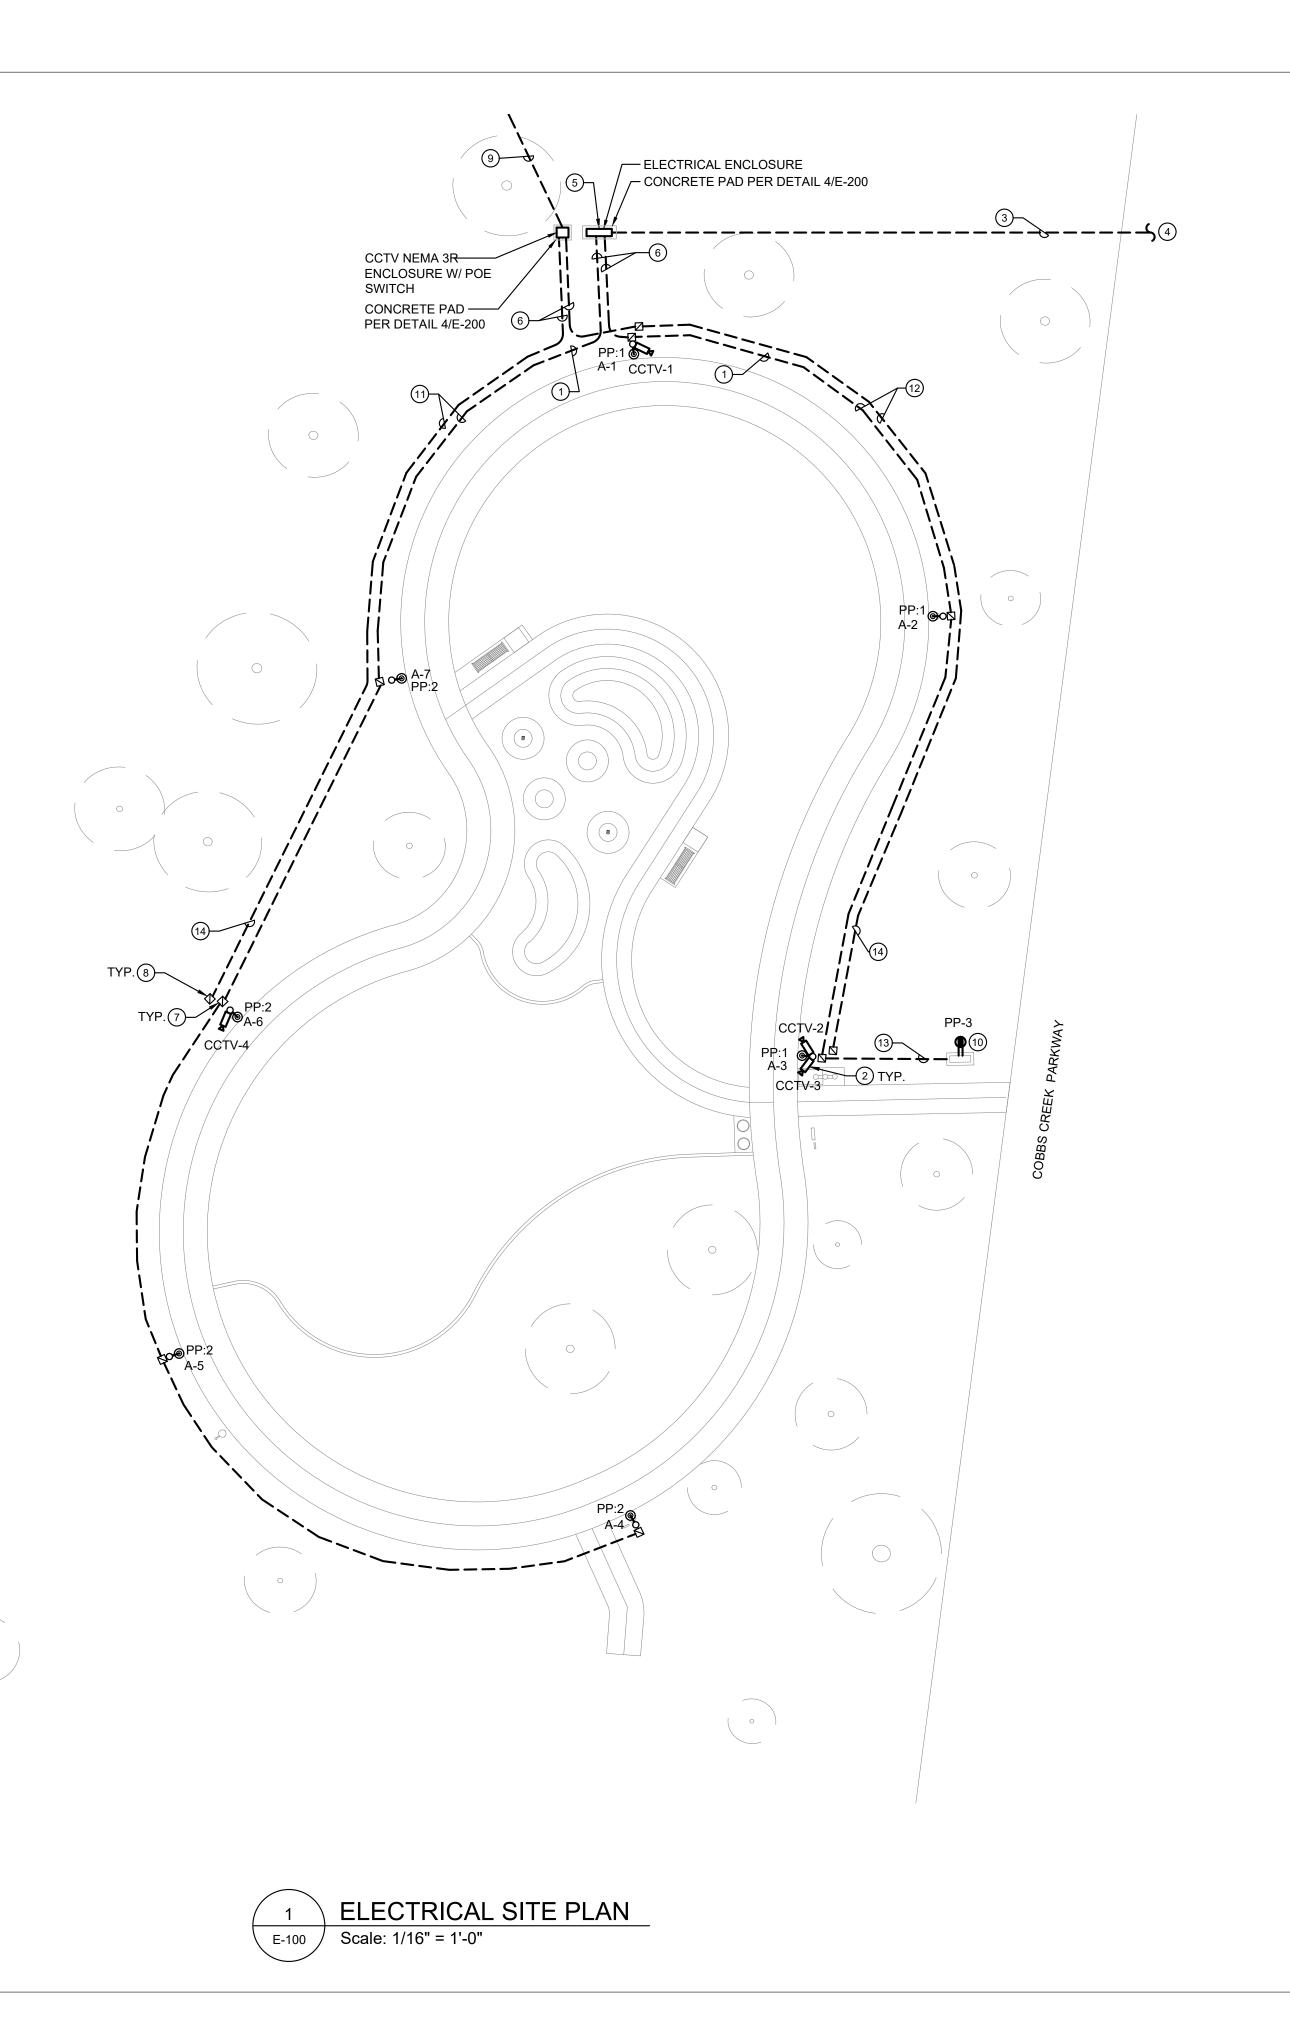


JOB NO: 2131 DATE: 07/22/2022 DRAWN: TM CHECKED: HL **DRAWING TITLE:**

GENERAL NOTES. SYMBOLS AND **ABBREVIATIONS**

DRAWING NO: E-000

SHEET 19 OF 22




GENERAL NOTES:

- 1. REFER TO DRAWING E-000 FOR GENERAL NOTES, SYMBOLS AND ABBREVIATIONS.
- 2. COORDINATE ALL NEW WORK WITH REBUILD/PPR REPRESENTATIVE PRIOR TO START OF WORK.
- 3. REFER TO DRAWING E-200 FOR DETAILS AND E-300 FOR PANEL SCHEDULE.
- 4. ALL CONDUCTORS SHALL BE COLOR-CODED, SINGLE CONDUCTOR, COPPER WIRE OF THE SPECIFIED SIZE, 600V, TYPE XHHW/XHHW-2 INSULATION, UNLESS NOTED OTHERWISE.
- 5. ALL SERVICE RELATED WORK TO BE DONE IN STRICT ACCORDANCE WITH UTILITY COMPANY REQUIREMENTS.
- 6. ALL SERVICE EQUIPMENT SHALL BE LISTED FOR SERVICE ENTRANCE USE.
- 7. COORDINATE ALL SERVICE CHANGES WITH PECO.
- 8. EC SHALL COORDINATE WITH LIGHTING FIXTURE MANUFACTURER FOR CONNECTION REQUIREMENTS OF LIGHTING FIXTURES (IE. QUICK DISCONNECT) AND SHALL MAKE ALL WIRING CONNECTIONS AS REQUIRED.
- 9. COORDINATE FINAL UNDERGROUND CONDUIT ROUTING AND WIRING INSTALLATION FROM ENVIRONMENT CENTER BUILDING TO SECURITY CAMERAS MOUNTED ON LIGHT POLES WITH SECURITY SYSTEM REPRESENTATIVE PRIOR | 1315 Walnut Street, TO COMMENCING WORK.
- 10. COORDINATE WITH SECURITY SYSTEM REPRESENTATIVE FOR FINAL DEVICES/EQUIPMENT SELECTIONS FOR A COMPLETE AND FULLY OPERATIONAL SYSTEM PRIOR TO COMMENCING WORK. VIDEO SURVEILLANCE SYSTEM SHALL BE INTEGRATED WITH EXISTING PPR NETWORK EQUIPMENT.
- 11. INSTALL ALL WIRING IN SCHEDULE 80 PVC CONDUIT. ALL UNDERGROUND INSTALLATION SHALL COMPLY WITH NEC
- 12. CALL BEFORE YOU DIG (PA ONE CALL SYSTEM 1-800-242-1776 OR DIAL 811). ELECTRICAL CONTRACTOR TO HIRE AN INDEPENDENT UTILITY LOCATING COMPANY TO MARK-OUT CUSTOMER OWNED/PRIVATE PROPERTY FACILITIES BEFORE DIGGING AT ELECTRICAL CONTRACTOR'S EXPENSE.

KEYED NOTES:

- 1) FURNISH AND INSTALL 2#10 AND 1#10G IN 1" PVC CONDUIT.
- (2) MOUNT SECURITY CAMERA TO POLE 12' AFG. COORDINATE EXACT PLACEMENT AND ORIENTATION WITH SECURITY SYSTEM REPRESENTATIVE PRIOR TO COMMENCING WORK.
- (3) FURNISH AND INSTALL 3#4/0 IN 2 1/2" PVC CONDUIT. ALL WIRE AND CONDUIT SHALL ROUTE THROUGH UNDERGROUND IN DUCT BANK. REFER TO DETAIL 5/E-200 FOR TYPICAL DUCT BANK DETAIL.
- (4) CONTRACTOR TO COORDINATE FINAL SERVICE REQUIREMENTS WITH PECO. REFER TO DETAIL 1/E-200 FOR MORE INFORMATION.
- (5) FURNISH AND INSTALL STAINLESS STEEL ENCLOSURE. COORDINATE FINAL LOCATION IN FIELD WITH PECO AND REBUILD/PPR REPRESENTATIVE. REFER TO DETAIL 1/E-200 FOR ENCLOSURE, ELECTRICAL EQUIPMENT AND POWER CONNECTIONS.
- (6) REFER TO DETAIL 6/E-200 FOR TYPICAL 2-WAY DUCT
- (7) FURNISH AND INSTALL 16"L X 16"W X 12'D TIER 15 HANDHOLE AT THE LIGHT FIXTURE POLE. PROVIDE TERMINAL BLOCK INSIDE HANDHOLE TO TERMINATE WIRE SIZE FOR LIGHT FIXTURE. MAKE FINAL CONNECTION TO LIGHT FIXTURE. REFER TO DETAIL 3/E-200 FOR MORE INFORMATION.
- (8) FURNISH AND INSTALL 16"L X 16"W X 12"D TIER 15 HANDHOLE AT THE LIGHT FIXTURE POLE. MAKE FINAL CONNECTION TO CAMERAS.
- (9) EXTEND SPARE FIBER FROM CCTV UNDERGROUND PULLBOX BOX TO NEW CCTV ENCLOSURE IN NEW UNDERGROUND 1" CONDUIT. VERIFY IN FIELD EXACT LOCATION OF EXISTING UNDERGROUND PULLBOX WITH SECURITY SYSTEM REPRESENTATIVE.
- (10) PROVIDE GFCI RECEPTACLE WITH WEATHERPROOF ENCLOSURE FOR SELF-REGULATING HEATING CABLE. REFER TO MANUFACTURER INSTALLATION MANUAL FOR RECOMMENDED RECEPTACLE LOCATION. PROVIDE 2 #10 & 1 #10GRD. IN 1" CONDUIT.
- 11) REFER TO DETAIL 7/E-200 FOR TYPICAL 2-WAY ELEC/COMM DUCT BANK.
- (12) REFER TO DETAIL 8/E-200 FOR TYPICAL 3-WAY ELEC/COMM DUCT BANK.
- (13) REFER TO DETAIL 5/E-200 FOR TYPICAL 3-WAY ELEC/COMM DUCT BANK.
- (14) FURNISH AND INSTALL DATA CABLE IN 1" PVC CONDUIT FROM CCTV ENCLOSURE TO CAMERAS. COORDINATE EXACT CABLE TYPE & QUANTITY WITH SECURITY SYSTEM REPRESENTATIVE.

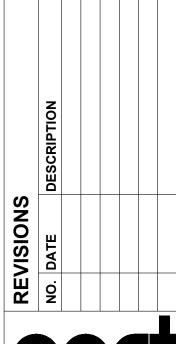

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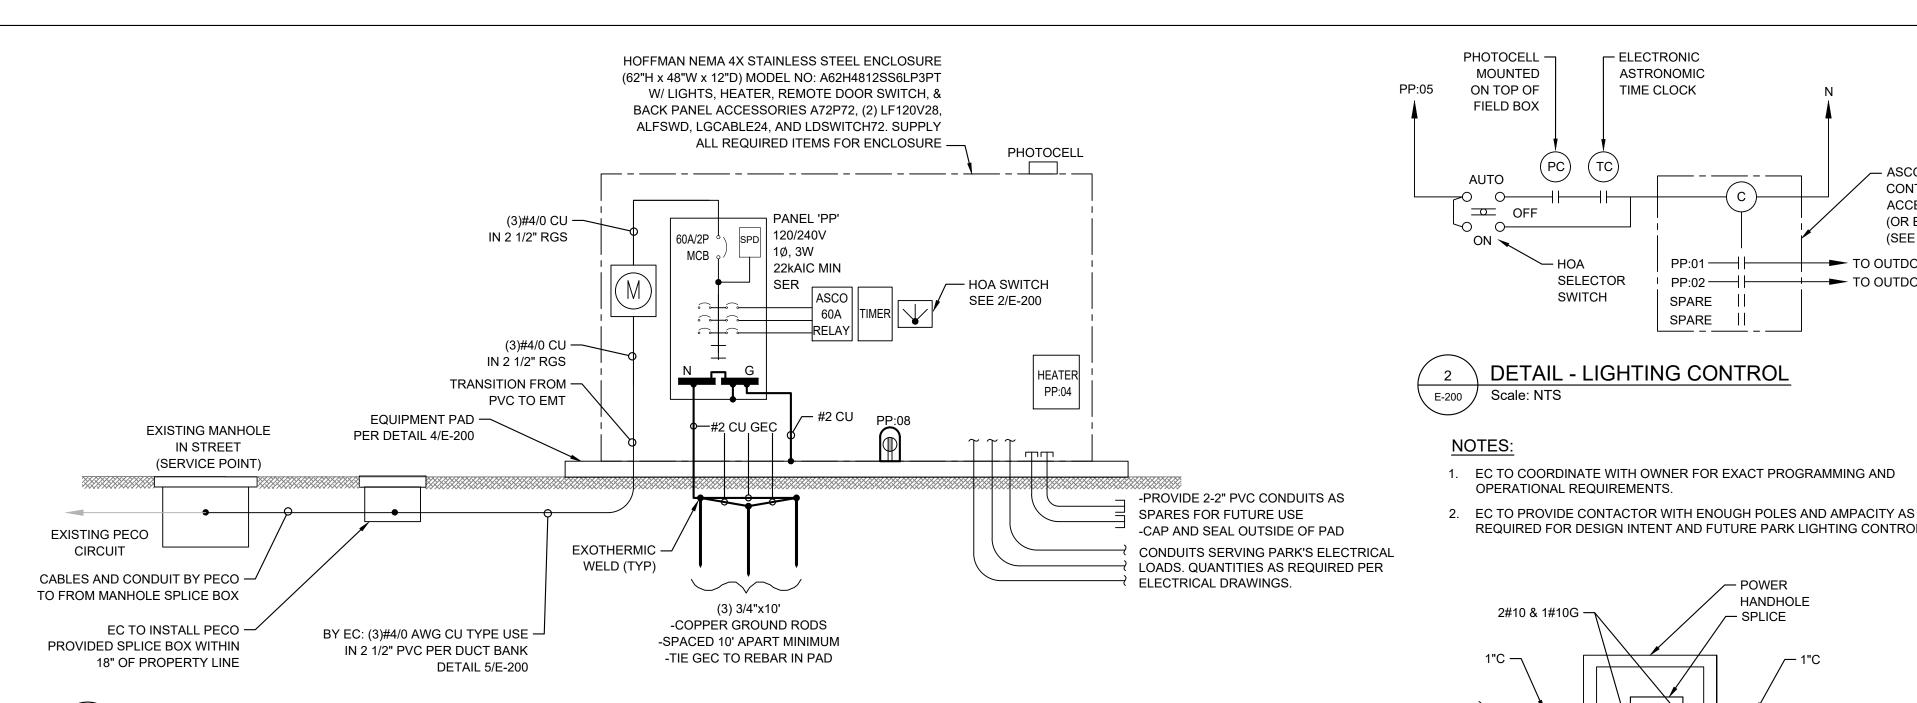


JOB NO: 2131 DATE: 07/22/2022 DRAWN: TM CHECKED: HL DRAWING TITLE:

> ELECTRICAL SITE PLAN


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FIELD BOX ENCLOSURE & SINGLE LINE DIAGRAM Scale: NTS E-200 /

- 1. ALL WORK SHALL BE PERFORMED IN ACCORDANCE WITH THE LATEST ADOPTED EDITION OF THE NEC.
- 2. SERVICE EQUIPMENT TO BE LOCATED AS CLOSE AS POSSIBLE TO SERVICE CONDUCTORS ENTERING THE BUILDING. GROUP EQUIPMENT TOGETHER AS REQUIRED.
- 3. ALL SERVICE RELATED WORK TO BE DONE IN STRICT ACCORDANCE WITH UTILITY COMPANY REQUIREMENTS.
- 4. VERIFY SHORT CIRCUIT REQUIREMENTS WITH UTILITY COMPANY AND MAKE ADJUSTMENTS AS REQUIRED.
- 5. ALL SERVICE EQUIPMENT SHALL BE LISTED FOR SERVICE ENTRANCE USE. 6. COORDINATE ALL SERVICE CHANGES WITH PECO. EC SHALL BE RESPONSIBLE
- FOR SUBMITTING S&M AS REQUIRED.
- 7. THE EC HAS THE FULL RESPONSIBILITY FOR MEETING WITH THE LOCAL ELECTRIC UTILITY AND COORDINATING WITH THE LOCAL ELECTRIC UTILITY COMPANY'S REQUIREMENTS BEFORE INSTALLATION BEGINS.






DUCT BANK NOTES

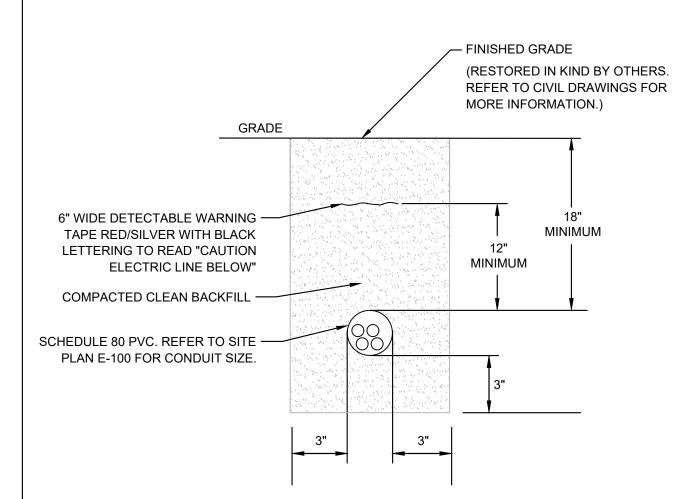- 1. EC SHALL TAKE EXTREME CARE IN EXCAVATING AREA. HAND-DIG IF NECESSARY. MODIFY/RE-ROUTE DUCT BANK AS REQUIRED TO MINIMIZE CONFLICT WITH EXISTING UTILITIES.
- 2. COORDINATE ALL CONDUIT ROUTING WITH EXISTING CONDITIONS AND ROADWAY CUTTING AND TRENCHING.
- 3. ADJUST TRENCH DETAIL FOR MULTIPLE CONDUITS WHEN REQUIRED. OBTAIN ENGINEER'S APPROVAL.
- 4. COORDINATE WITH PECO BLUE BOOK REQUIREMENTS.
- 5. REMOVE ALL SHARP STONES AND OBJECTS FROM COMPACTED BEDDING, SIDE SUPPORTS, AND FILL.

- 8. THE EC IS RESPONSIBLE FOR THE PHYSICAL LAYOUT OF THE SERVICE EQUIPMENT AND ALL DISTRIBUTION EQUIPMENT MEETING WORKING SHALL MEET THE REQUIREMENTS OF NEC ARTICLE 230, AND SHOULD BE REVIEWED WITH THE INSTALLER'S UNDERWRITER BEFORE INSTALLATION
- 9. SEE PANEL SCHEDULE FOR MORE INFORMATION.
- FIELD BOX ENCLOSURE, WHICH MAY CONFLICT WITH PECO REQUIREMENTS. EC SHALL COORDINATE WITH PECO PRIOR TO INSTALLATION. IF PECO WILL INSTALL OUTSIDE PER PECO BLUE BOOK AND ADD PROTECTION FOR THE METER TO HELP WITH VANDALISM PROBLEMS
- 11. ALL CONDUCTORS INCREASED IN SIZE FOR VOLTAGE DROP CONSIDERATION SHALL BE SPLICED TO APPROPRIATE SIZE CONDUCTORS FOR TERMINATING ONTO EQUIPMENT AND DEVICES. SPLICES SHALL BE MADE INSIDE THE EQUIPMENT AS ALLOWED BY THE NEC OR AT THE CLOSEST JUNCTION BOX TO THE EQUIPMENT OR DEVICE. THE SPLICED CONDUCTOR SHALL BE SIZED AS THE LARGEST ACCEPTABLE CONDUCTOR BASE ON THE TERMINATION OF THE

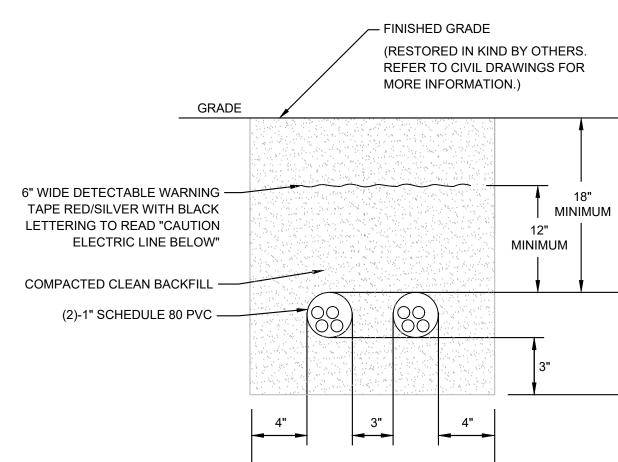




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- 4. COORDINATE WITH PECO BLUE BOOK REQUIREMENTS.
- 5. REMOVE ALL SHARP STONES AND OBJECTS FROM COMPACTED BEDDING, SIDE SUPPORTS, AND FILL.

- CLEARANCES AND ALL OTHER REQUIREMENTS OF THE NEC BASED ON ACTUAL FIELD CONDITIONS. THE LOCATION OF THE SERVICE DISCONNECTING MEANS
- 10. DUE TO VANDALISM CONCERNS, THE PECO METER IS SHOWN WITHIN THE NOT ALLOW THE METER TO BE INSTALLED WITHIN THE ENCLOSURE, EC SHALL

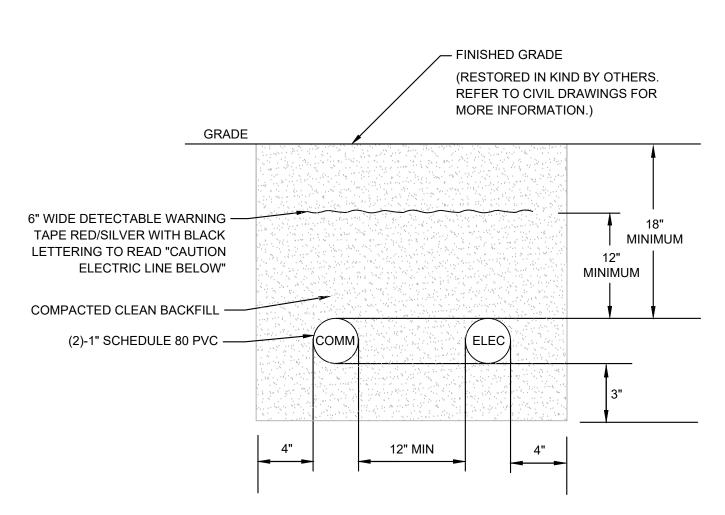

- ELECTRONIC

ASTRONOMIC

TIME CLOCK

PP:01 ———

PP:02 ——

REQUIRED FOR DESIGN INTENT AND FUTURE PARK LIGHTING CONTROLS.

- POWER

- SPLICE

HANDHOLE

- 2#10 & 1#10G

- LIGHT FIXTURE

POLE BASE

SPARE SPARE ASCO 918

── TO OUTDOOR LIGHTING

→ TO OUTDOOR LIGHTING

CONTACTOR W/

ACCESSORY 47

(OR EQUIVALENT)

(SEE NOTE #2)

MOUNTED

FIELD BOX

— НОА

Scale: NTS

SELECTOR

DETAIL - LIGHTING CONTROL

SWITCH

OPERATIONAL REQUIREMENTS.

HANDHOLE DETAIL

Scale: NTS

2#10 & 1#10G -




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- REMOVE ALL SHARP STONES AND OBJECTS FROM COMPACTED BEDDING, SIDE SUPPORTS, AND FILL.


GENERAL NOTES:

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DETAIL - FIELD SERVICE PAD Scale: NTS E-200

- 1. CONCRETE TO HAVE MINIMUM 28 DAY COMPRESSIVE STRENGTH OF 4000 PSI & HAVE AN AIR ENTRAINING ADMIXTURE. AIR CONTENT TO BE 6% + OR - 1%.
- 2. PAD SHALL BE SIZED SO THAT PAD EXTENDS AT LEAST 3" BEYOND SPECIFIED EQUIPMENT IN ALL DIRECTIONS.
- 3. EC SHALL VERIFY THAT PAD DESIGN IS STRUCTURALLY SUFFICIENT FOR INSTALLED EQUIPMENT.

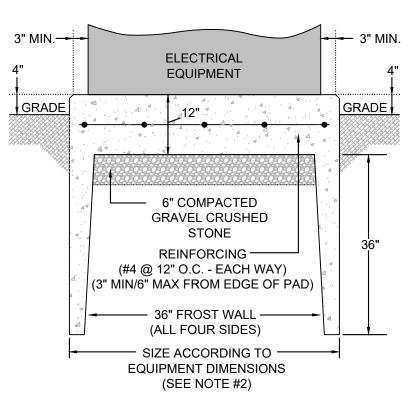

TYPICAL 3-WAY ELEC/COMM DUCT BANK DETAIL E-200 / Scale: NTS

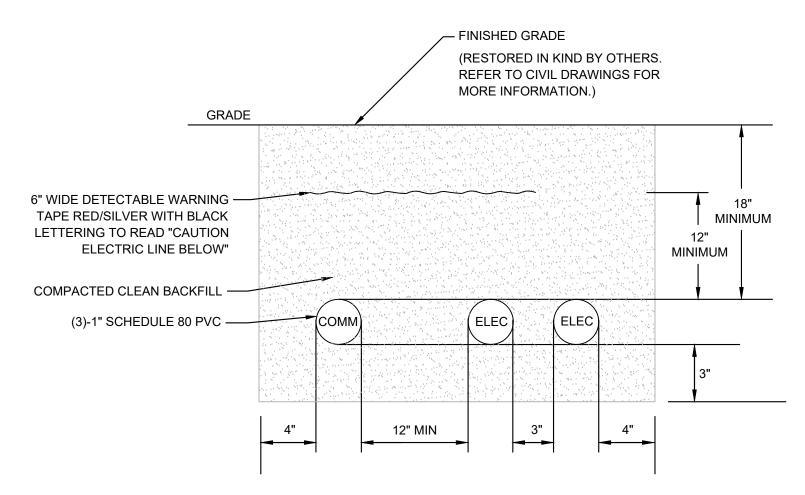DUCT BANK NOTES:

- 1. EC SHALL TAKE EXTREME CARE IN EXCAVATING AREA. HAND-DIG IF NECESSARY. MODIFY/RE-ROUTE DUCT BANK AS REQUIRED TO MINIMIZE CONFLICT WITH EXISTING UTILITIES.
- 2. COORDINATE ALL CONDUIT ROUTING WITH EXISTING CONDITIONS AND ROADWAY CUTTING AND TRENCHING.
- 3. ADJUST TRENCH DETAIL FOR MULTIPLE CONDUITS WHEN REQUIRED. OBTAIN ENGINEER'S APPROVAL.
- 4. COORDINATE WITH PECO BLUE BOOK REQUIREMENTS.
- 5. REMOVE ALL SHARP STONES AND OBJECTS FROM COMPACTED BEDDING, SIDE SUPPORTS, AND FILL.

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DETAILS

DRAWING NO:

E-200

SHEET 21 OF 22

					PAN	EL SCH	HEDULI	E 'PF)'						
PANEL: PP INTERRUPTING RATING: 42 KAIC MOUNTING: SURFACE															
VOLTAGE: 240/120V PHASE: 1						WIRE: 3 BUS AMPS			MPS:	PS: 100A MAIN: 60A MCB					
NEMA 3R NEUTRAL: 100% LOCATION: ELEC ENCLOSURE															
UIT	DESCRIPTION	WIRE	POLES	BKR SIZE	VA	VA / PHASE			SIZE	ES	MIDE	DECODIDATION	TIUX		
CIRCUIT						А	В	VA	BKR	POLE	WIRE	DESCRIPTION	CIRCUIT		
1	POLE LTG 1,2,3	#10	1	20	99	231		132	20	1	#10	POLE LTG 4,5,6,7	2		
3	BACKFLOW PREVENTER HOTBOX	#10	1	20	1200		2925	1725	20	1	#12	FIELD BOX HEATER	4		
5	ASTRONOMIC TIMER CONTROL	#12	1	20	100	200		100	20	1	#12	FIELD BOX LIGHT	6		
7	CCTV ENCLOSURE	#12	1	20	200		380	180	20	1	#12	FIELD BOX RECEPTACLE	8		
9	SPARE	-	1	20	0	0		0	20	1	-	- SPARE			
11	SPARE	-	1	20	0		0	0	20	1	-	- SPARE			
13	SPARE	-	1	20	0	0		0	20	1	-	SPARE	14		
15	SPACE	-	-	-	0		0	0	-	-	-	SPACE	16		
17	SPACE	-	-	-	0	0		0	-	-	-	SPACE	18		
NOTES:				TOTALS											
1. PROVIDE SERVICE ENTRANCE RATED PANELBOARD					431	3305									
		3730	15.57 AMPS												

LUMINAIRE SCHEDULE

SYMBOL	TYPE	DESCRIPTION	MOUNTING	MANUFACTURER	CATALOG NO.	LAMP INFORMATION		·N	REMARKS	
						TYPE	WATTS	VOLTS	LUMENS	
0	Α	LED LIGHT POLE. CONTROL VIA PHOTOCELL AND ASCO RELAY PANEL	POLE	SELUX CORPORTATION	DSC4LX-DG-XX-MP350-30-XX-XX	LED	33	120	3398	MOUNT LUMINAIRE TO POLE 14' AFG.

NOTE:

1. COORDINATE FINAL SELECTIONS, FINISHES, AND COLOR TEMPERATURE WITH REBUILD/PPR REPRESENTATIVE.

GENERAL NOTES:

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SCHEDULES

DRAWING NO: E-300

SHEET 22 OF 22