THE CITY OF PHILADELPHIA



OFFICE OF EMERGENCY MANAGEMENT

PHILADELPHIA PUBLIC SERVICES BUILDING 400 NORTH BROAD STREET, PHILADELPHIA, PA 19130 FLOORS 8, 9 AND 10



PROJECT NO: 10-21-4548-01


VOLUME 1 OF 2

GENERAL NOTES


- CONDITIONS, AND DIMENSIONS BEFORE COMMENCEMENT OF THE WORK.
- PRECEDENCE. CONTRACTOR SHALL NOTIFY ARCHITECT IN WRITING OF ANY CONFLICT BEFORE PROCEEDING WITH THE WORK.


THIS PROJECT IS A TENANT FITOUT IN A COMPLETED, PARTIALLY, OR FULLY OCCUPIED BUILDING.

SYMB	OLS
	EXISTING
	NEW WALL
	CMU WALL
100/1	DOOR IDENTIFICATION
#	KEY NOTE
(#)	EQUIPMENT IDENTIFICATION/ FIXTURE TAG
Name 101	ROOM IDENTIFICATION
A	PARTITION IDENTIFICATION
A	WINDOW IDENTIFICATION
1	REVISION CLOUD & DELTA
MATCH LINE 1 / A101	MATCH LINE W/ VIEW REFERENCE
0	COLUMN IDENTIFICATION
	DRAWING TITLE
1 A101	SECTION CUT MARK FOR PLAN, DETAIL & BUILDING SECTIONS
1 A101 1	ELEVATION MARK FOR INTERIOR ELEVATIONS
- \(\frac{1}{A101} \) SII	M REFERENCE KEY MARK FOR ENLARGED DETAIL
NameElevation	FLOOR/LEVEL INDICATOR

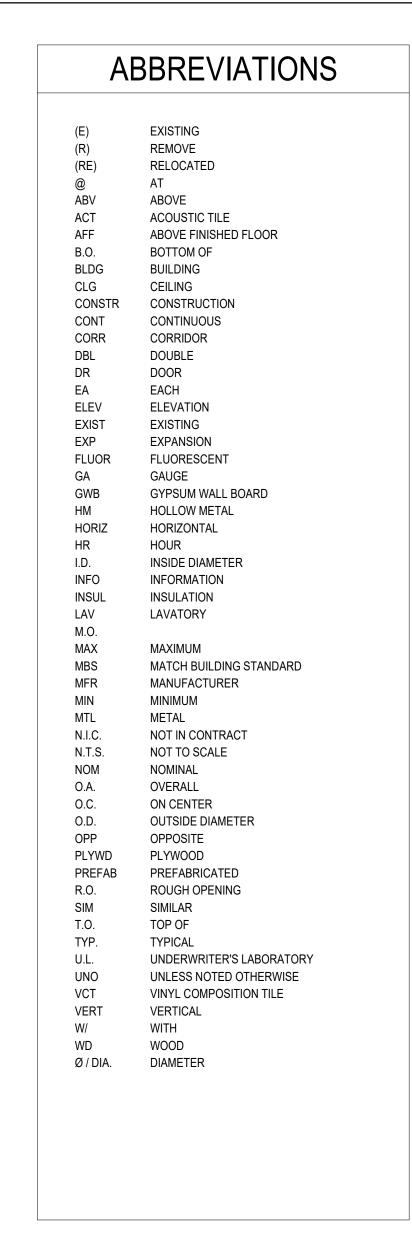

	PROJECT TEAM
<u>AF</u>	RCHITECT CONTRACTOR CO
42 PH PH	I GROUP 8 N. 2ND ST HILADELPHIA, PA 19123 H: (215) 413-3700 (: (215) 413-3773
PH	DNTACT: MARK E. JOHANNESEN, AIA, LEED AP BD+C H: 215.413.3700 MAIL: MJOHANNESEN@IEIGROUP.COM
AF 61 CH	EP / FP / IT / TELECOM / SECURITY RORA ENGINEERS WILMINGTON-WEST CHESTER PIKE HADDS FORD, PA 19317 H: 484.880.4828
	DNTACT: MARK S. PURCELL, AIA, CCM, LEED AP MAIL: MPURCELL@ARORAENGINEERS.COM
O'I 70 Ph	TRUCTURAL DONNELL & NACCARATO 1 MARKET STREET, SUITE 6000 HILADELPHIA, PA 19106 1: 215.925.3788
	DNTACT: JACK DUSCHER, PE MAIL: JDUSCHER@O-N.COM
CL 40 Ph	RAPHICS AND WAYFINDING LOUD GEHSHAN 0 MARKET STREET, SUITE 300 HILADELPHIA, PA 19106 H: 215.829.9414
	DNTACT: VIRGINIA GEHSHAN MAIL: VGEHSHAN@CLOUDGEHSHAN.COM

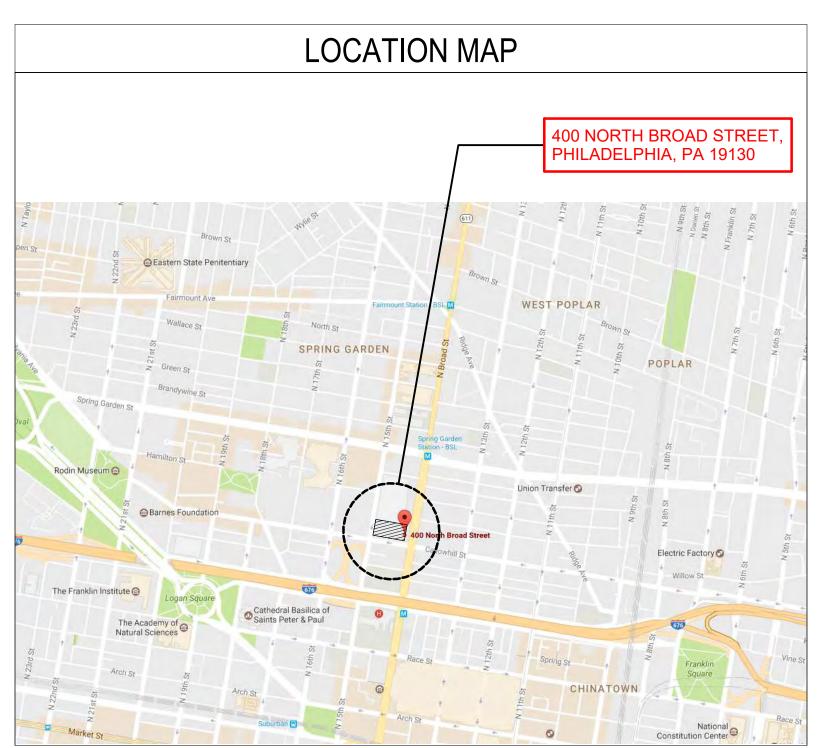

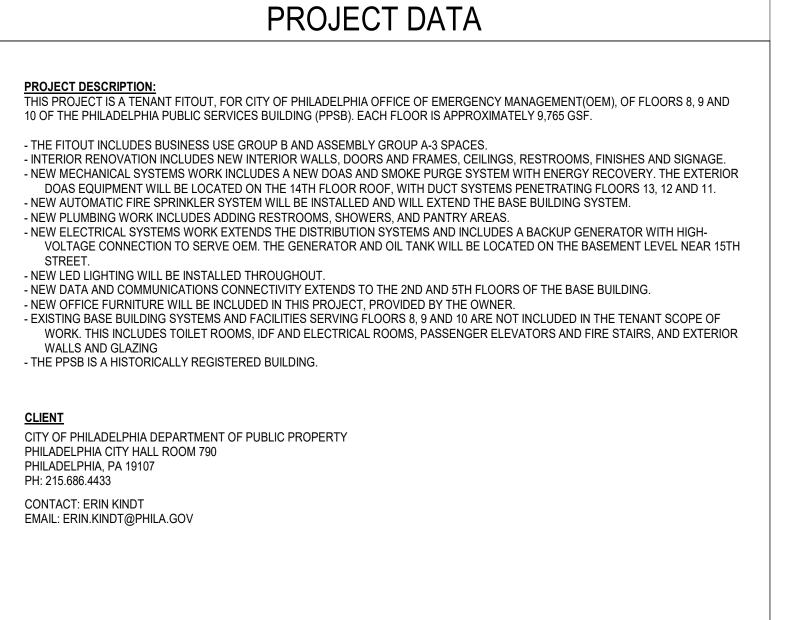


OL. 1 OR PLAN - WEST I - WEST I - WEST N - WEST N - WEST N - WEST - WEST N - W
I - WEST N -
I - WEST N -
N - WEST N -
N WEST N WEST N WEST N WEST N EAST R PLAN N N N N N R PLAN & 14TH FLOOR ROOF PLAN SI SECTED CEILING PLAN LECTED CEILING PLAN SISH PLAN SISH PLAN SITIONS SITTONS SI
N - WEST N -
N - EAST R PLAN N N N N N N N R PLAN & 14TH FLOOR ROOF PLAN IS GER ROOM PLANS LECTED CEILING PLAN LECTED P
N N N N N N N N N N N N N N N N N N N
N IN
IR PLAN & 14TH FLOOR ROOF PLAN IS KER ROOM PLANS LECTED CEILING PLAN LECTED CEILING LECTED LECTE
IS KER ROOM PLANS LECTED CEILING PLAN LECTED CEILING PLAN LECTED CEILING PLAN E SH PLAN SH PLAN SH PLAN SH PLAN ITIONS ITION
LECTED CEILING PLAN LECTED CEILING PLAN LECTED CEILING PLAN LE SH PLAN
EECTED CEILING PLAN EB PLAN SH PLOOR DEMOLITION PLAN SH SH PLOOR DEMOLITION PLAN
E SH PLAN SH PLAN SH PLAN SH PLAN SH PLAN STIONS STIP STIONS STIONS STIP STIONS STIP STIONS STIP STIONS STIP STIONS STIONS STIP STIONS STIP STIP STIP STIP STIP STIP STIP STI
SH PLAN ISH PLAN ISH PLAN ITIONS ITIONS ITIONS ITIONS ITIONS ITIONS ITIONS ITIONS ELEVATIONS S S S S S S S S S S S S S S S S S S
ATIONS ATIONS ATIONS ATIONS ATIONS ATIONS ELEVATIONS B B B B B B B B B B B B B B B B B B B
INTIONS INTION
ATIONS ATIONS ATIONS ATIONS ELEVATIONS S S SILES BILEVATIONS E E ELEVATIONS BIAGE PLAN BIAGE PLANS BIAGE PLAN
INTIONS INTIONS ILEVATIONS ILEVATIONS INTIONS
ELEVATIONS S S S S S S S S S S S S
SINUS SINUS SINUS SINUS SUIPMENT SCHEDULES E LEVATIONS IAGE PLAN IAGE PLANS IG PLANS IG PLANS IG PLANS SIG DETAILS & SECTIONS SIG DETAILS & SECTIONS SIG DETAILS & SECTIONS SIN ABBREVIATIONS AND SYMBOLS SIN GENERAL NOTES ZARD CLASSIFICATION PLANS SIN 8TH FLOOR DEMOLITION PLAN SIN 9TH FLOOR DEMOLITION PLAN SIN 9TH FLOOR DEMOLITION PLAN SIN 9TH FLOOR DEMOLITION PLAN
DUPMENT SCHEDULES E LEVATIONS IAGE PLAN IAGE PLAN IAGE PLAN INAGE PLAN FRAMING PLANS IG PLANS IG PLANS IG PLANS IG PLANS IG PLANS ATOR PAD PLAN S & SCHEDULES STIONS IG DETAILS & SECTIONS DN ABBREVIATIONS AND SYMBOLS DN GENERAL NOTES ZARD CLASSIFICATION PLANS DN 8TH FLOOR DEMOLITION PLAN DN 9TH FLOOR DEMOLITION PLAN DN 9TH FLOOR DEMOLITION PLAN DN 10TH FLOOR DEMOLITION PLAN
E LEVATIONS JAGE PLAN JAGE PLANS
LEVATIONS JAGE PLAN JAGE PLAN JAGE PLAN JAGE PLAN FRAMING PLANS JAGE PLA
IAGE PLAN INAGE PLAN INAGE PLANS IG PLANS IG PLANS IG PLANS ATOR PAD PLAN S & SCHEDULES CTIONS IG DETAILS & SECTIONS ON ABBREVIATIONS AND SYMBOLS ON GENERAL NOTES ZARD CLASSIFICATION PLANS ON 8TH FLOOR DEMOLITION PLAN ON 10TH FLOOR DEMOLITION PLAN
FRAMING PLANS IG PLANS IG PLANS ATOR PAD PLAN S & SCHEDULES CTIONS IG DETAILS & SECTIONS ON ABBREVIATIONS AND SYMBOLS ON GENERAL NOTES ZARD CLASSIFICATION PLANS ON 8TH FLOOR DEMOLITION PLAN ON 9TH FLOOR DEMOLITION PLAN
IG PLANS IG PLANS ATOR PAD PLAN S & SCHEDULES CTIONS IG DETAILS & SECTIONS ON ABBREVIATIONS AND SYMBOLS ON GENERAL NOTES ZARD CLASSIFICATION PLANS ON 8TH FLOOR DEMOLITION PLAN ON 9TH FLOOR DEMOLITION PLAN
IG PLANS IG PLANS ATOR PAD PLAN S & SCHEDULES CTIONS IG DETAILS & SECTIONS ON ABBREVIATIONS AND SYMBOLS ON GENERAL NOTES ZARD CLASSIFICATION PLANS ON 8TH FLOOR DEMOLITION PLAN ON 9TH FLOOR DEMOLITION PLAN
ATOR PAD PLAN S & SCHEDULES STIONS IG DETAILS & SECTIONS ON ABBREVIATIONS AND SYMBOLS ON GENERAL NOTES ZARD CLASSIFICATION PLANS ON 8TH FLOOR DEMOLITION PLAN ON 9TH FLOOR DEMOLITION PLAN ON 10TH FLOOR DEMOLITION PLAN
S & SCHEDULES CTIONS IG DETAILS & SECTIONS ON ABBREVIATIONS AND SYMBOLS ON GENERAL NOTES ZARD CLASSIFICATION PLANS ON 8TH FLOOR DEMOLITION PLAN ON 9TH FLOOR DEMOLITION PLAN ON 10TH FLOOR DEMOLITION PLAN
ON ABBREVIATIONS AND SYMBOLS ON GENERAL NOTES ZARD CLASSIFICATION PLANS ON 8TH FLOOR DEMOLITION PLAN ON 9TH FLOOR DEMOLITION PLAN ON 10TH FLOOR DEMOLITION PLAN
ON ABBREVIATIONS AND SYMBOLS ON GENERAL NOTES ZARD CLASSIFICATION PLANS ON 8TH FLOOR DEMOLITION PLAN ON 9TH FLOOR DEMOLITION PLAN ON 10TH FLOOR DEMOLITION PLAN
ON GENERAL NOTES ZARD CLASSIFICATION PLANS ON 8TH FLOOR DEMOLITION PLAN ON 9TH FLOOR DEMOLITION PLAN ON 10TH FLOOR DEMOLITION PLAN
ZARD CLASSIFICATION PLANS ON 8TH FLOOR DEMOLITION PLAN ON 9TH FLOOR DEMOLITION PLAN ON 10TH FLOOR DEMOLITION PLAN
ON 8TH FLOOR DEMOLITION PLAN ON 9TH FLOOR DEMOLITION PLAN ON 10TH FLOOR DEMOLITION PLAN
N 10TH FLOOR DEMOLITION PLAN
DN 11TH FLOOR DEMOLITION PLAN
ON 8TH FLOOR NEW WORK PLAN ON 9TH FLOOR NEW WORK PLAN
ON 10TH FLOOR NEW WORK PLAN ON 11TH FLOOR NEW WORK PLAN
ON RISER DIAGRAM
ON DETAILS ON SCHEDULES
ERAL NOTES, ABBREVIATIONS & SYMBOLS
FLOOR DEMOLITION PLAN FLOOR DEMOLITION PLAN
FLOOR DEMOLITION PLAN FLOOR NEW WORK PLAN
FLOOR NEW WORK PLAN
FLOOR NEW WORK PLAN FLOOR NEW WORK PLAN
BING RISER DIAGRAM
ESTIC & NATURAL GAS RISER DIAGRAM IILS
DULES
FLO FLO FLO FLO FLO BIII



CONSULTANTS:

Philadelphia, PA 19123 Telephone: 215.413.3700

61 Wilmington-West Chester Pike Chadds Ford, PA 19317 F (610) 459-7950

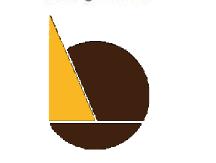

Philadelphia, PA 19106 PH: 215.925.3788

LICENSE NO: <Architect's License #>

EFFECTIVE ONLY AS TO THAT VERSION OF THIS DOCUMENT AS ORIGINALL

PROGRESS SET CLIENT REVIEW

CODE REVIEW SET ☐ ISSUED FOR CONSTRUCTION

(NOT FOR CONSTRUCTION) 1 9/18/2020 ISSUED FOR BIDS

PROJECT NUMBER: SCALE: DATE: 09/18/2020 DRAWN BY: CHECKED BY:

DRAWING TITLE: COVER SHEET

PRINTED ON: 9/22/2020 3:02:06 PM

2018 IBC - TABLE 1004.5 MAX	X. FLOOR AREA AL	LOWANCES PER	OCCUPANT	
OCCUPANCY CALCULATION				
FLOOR 8				
B BUSINESS	SINESS 9,764 SF 150 SF/OC			
FLOOR 8	TOTAL		66 OCC	
FLOOR 9				
A-3 SITUATION ROOM	774 SF	15 SF/OCC	52 OCC	
A-3 E.O.C. + JOINT COMMAND	3,135 SF	ACTUAL	78 OCC	

150 SF/OCC

40 OCC

170 OCC

LOC	DR 10	TOTAL	<u> </u>	145 OCC
В	BUSINESS	7,070 SF	150 SF/OCC	48 OCC
В	BUSINESS STORAGE	870 SF	300 SF/OCC	3 OCC
В	SLEEP	299 SF	ACTUAL	8 OCC
В	LOCKER	347 SF	50 SF/OCC	7 OCC
A-3	MULTI-FUNCTION ROOMS	1,178 SF	15 SF/OCC	79 OCC

5,855 SF

			TOTAL	OCCUPANCY						:	881 OC)
2018 PHILADE	LPHIA PLUMBIN	G CODE	- TABL	.E 403.1 MIN. NU	MBER	OF REC	UIRED	PLUMBI	ING FIX	XTU	RES	
CALCULATED REQU	JIRED FIXTURES											
CLASSIFICATION /	NO OF PERSONS	WATER	CLOSETS	NO OF PERSONS	LAVA	TORIES	SHO	WERS	DRINKING		SERV	/ICE
OCCUPANCY	NO. OF PERSONS	М	F	NO. OF PERSONS	М	F	М	F	WAT	ER	R SIN	
FLOOR 8	77			750		ike -	1750	rii-	- No-			
BUSINESS USE			200 40	200		610 A	1.000	220	- 126 9.0			
33 MEN	1 - 25	1	1	1 - 40	1	1	0	0	1/100		1/FL	1
33 WOMEN	EACH ADDT'L 50	1	1	EACH ADDT'L 80	0	0	0	0	1/100		WEL	1
66 SUBTOTAL		2	2		1	1	0	0		1		1
TOTAL FIXTURES	i.	2	2		1	1	0	0	1		1	į.
FLOOR 9												
BUSINESS USE												
20 MEN	1 - 25	1	1	1 - 40	1	1	0	0	41400		4.051	
20 WOMEN	EACH ADDT'L 50	0	0	EACH ADDT'L 80	0	0	0	0	1/100		1/FL	
40 SUBTOTAL		1	1		1	1	0	0		0		0

FLOOR 9

B BUSINESS

20 MEN	1 - 25	1	1	1 - 40	1	1	.0	0	1/100 1/		4751	
20 WOMEN	EACH ADDT'L 50	0	0	EACH ADDT'L 80	0	0	0	0	1/100		1/FL	
40 SUBTOTAL		1	1		1	1	0	0		0		-
A-3 ASSEMBLY USE	100			580		in	20	37	- SP			
65 MEN	4 / 75			4.1200			0	0	1/500	1	1/FL	
65 WOMEN	1 / 75		10	1 / 200	1	1	0	0	1/500	1	1/FL	
130 SUBTOTAL		1	1		1	1	0	0		1		
TOTAL FIXTURES		2	2		2	2	0	0	1		1	
FLOOR 10												_
BUSINESS USE												_

TOTAL FIXTURES		2	2		2	2	0	0	3	1	1 8	E .
FLOOR 10												
BUSINESS USE												
33 MEN	1 - 25	1	1	1 - 40	1	1	0	0	1/100		1/FL	
33 WOMEN	EACH ADDT'L 50	1	1	EACH ADDT'L 80	0	0	0	0	1/100	IVEL		
66 SUBTOTAL		2	2		1	1	0	0	-)		0
A-3 ASSEMBLY USE				1000			200					915
40 MEN	4176	84		4 / 200	9	40	0	0	4/500		1/FL	-
40 WOMEN	1 / 75	1	1	1 / 200	3.	32	0	0	1/500	1	WEL	
80 SUBTOTAL		1	1		1	1	0	0		1		1
TOTAL FIXTURES	i.	3	3		2	2	0	0	1	l	ľ	1
OTAL FIXTURES -	FLOOR 8, 9 + 10	7	7	Î	5	5	0	0	3	3		3

PROVIDED FIXTURES								
Fixture Type	WATER	CLOSETS	LAVA	TORIES	SHO	WERS	DRINKING WATER	SERVICE SINK
FLOOR 8	2	3	1	2	0	0	2	1
FLOOR 9	2	2	1	1	0	0	2	1
FLOOR 10	4	5	3	4	1	1	2	1

1. PER 403.3.3 LOCATION OF TOILET FACILITIES, REQUIRED TOILET FACILITIES SHALL NOT BE LOCATED MORE THAN ONE STORY ABOVE OR BELOW THE SPACE REQUIRED TO BE PROVIDED WITH TOILET FACILITIES.

5 7 1 1 6 3

2. URINAL COUNT IS INCLUDED IN MEN'S TOILET COUNT, URINALS ARE PROVIDED FOR 1/2 OF MEN'S TOILET COUNT.

8 10

- UNISEX TOILET ROOM FIXTURE COUNTS ARE INCLUDED IN WATER CLOSET AND LAVATORY FIXTURE COUNTS.
- LAVATORIES IN SHOWER ROOMS ARE INCLUDED IN LAVATORY COUNTS.

TOTAL PROVIDED FIXTURES

5. SINKS SHOWN IN PANTRIES, BREAK ROOMS AND LACTATION ROOMS ARE NOT INCLUDED IN PROVIDED LAVATORY COUNT.

CODE INFORMATION **BUILDING CODE REFERENCES** PHILADELPHIA ADMINISTRATIVE CODE 2018 INTERNATIONAL BUILDING CODE WITH AMENDMENTS 2018 INTERNATIONAL MECHANICAL CODE WITH AMENDMENTS 2018 INTERNATIONAL EXISTING BUILDING CODE WITH AMENDMENTS 2017 NATIONAL ELECTRICAL CODE 2018 INTERNATIONAL PERFORMANCE BUILDING CODE 2018 INTERNATIONAL ENERGY CONSERVATION CODE 2018 PHILADELPHIA FIRE CODE 2018 INTERNATIONAL FUEL GAS CODE 2018 INTERNATIONAL PLUMBING CODE ACCESSIBILITY - 2018 INTERNATIONAL BUILDING CODE CH. 11 AND ANSI 117.1 2010 EDITION PROJECT SUMMARY
THIS PROJECT IS A TENANT FITOUT OF FLOORS 8, 9 AND 10 OF THE PHILADELPHIA PUBLIC SERVICES BUILDING (PPSB). EACH FLOOR IS APPROXIMATELY 9,765 GSF. • THE FIT OUT INCLUDES BUSINESS USE GROUP B AND ASSEMBLY GROUP A-3 SPACES. INTERIOR RENOVATION INCLUDES NEW INTERIOR WALLS, DOORS AND FRAMES, CEILINGS, RESTROOMS, FINISHES AND SIGNAGE. • NEW MECHANICAL SYSTEMS WORK INCLUDES A NEW DOAS AND SMOKE PURGE SYSTEM WITH ENERGY RECOVERY. THE EXTERIOR DOAS EQUIPMENT WILL BE LOCATED ON THE 14TH FLOOR ROOF, WITH DUCT SYSTEMS PENETRATING FLOORS 13, 12 AND 11. • NEW AUTOMATIC FIRE SPRINKLER SYSTEM WILL BE INSTALLED AND WILL EXTEND THE BASE BUILDING • NEW PLUMBING WORK INCLUDES ADDING RESTROOMS, SHOWERS, AND PANTRY AREAS. • NEW ELECTRICAL SYSTEMS WORK EXTENDS THE DISTRIBUTION SYSTEMS AND INCLUDES A BACKUP GENERATOR WITH HIGH-VOLTAGE CONNECTION TO SERVE THE OEM. THE GENERATOR AND OIL TANK WILL BE LOCATED ON THE BASEMENT LEVEL NEAR 15TH STREET. A TEMPORARY BACKUP GENERATOR HOOKUP WILL BE LOCATED ON 15TH STREET. • NEW LED LIGHTING WILL BE INSTALLED THROUGHOUT. • NEW DATA AND COMMUNICATIONS CONNECTIVITY EXTENDS TO THE 2ND AND 5TH FLOORS OF THE BASE • NEW OFFICE FURNITURE WILL BE INCLUDED IN THIS PROJECT, PROVIDED BY THE OWNER. • EXISTING BASE BUILDING SYSTEMS AND FACILITIES SERVING FLOORS 8, 9 AND 10 ARE NOT INCLUDED IN THE TENANT SCOPE OF WORK. THIS INCLUDES TOILET ROOMS, IDF AND ELECTRICAL ROOMS, PASSENGER ELEVATORS AND FIRE STAIRS, AND EXTERIOR WALLS AND GLAZING. • THE PPSB IS A HISTORICALLY REGISTERED BUILDING. SECTION 302.2 OCCUPANCY CLASSIFICATION 303.1.1 SMALL BUILDINGS AND TENANT SPACES A BUILDING OR TENANT SPACE USED FOR ASSEMBLY PURPOSES WITH AN OCCUPANT LOAD OF LESS THAN 50 PERSONS SHALL BE CLASSIFIED AS A GROUP B OCCUPANCY. SECTION 304.1 BUSINESS GROUP B (PRIVATE OFFICES AND OPEN OFFICE AREAS, IT / TECH ROOMS, SLEEP ROOM) SECTION 303.4 ASSEMBLY GROUP A-3 (EMERGENCY OPERATIONS CENTER, SITUATION ROOM, MULTI-FUNCTION ROOMS) SECTION 602 CONSTRUCTION CLASSIFICATION BASE BUILDING STRUCTURE IS TYPE "I A" CONSTRUCTION (SPRINKLERED). TABLE 601 FIRE-RESISTANCE RATING REQUIREMENTS FOR BUILDING ELEMENTS TYPE "1 A" CONSTRUCTION STRUCTURAL FRAME.... 3 HRS BEARING WALLS EXTERIOR & INTERIOR... NONBEARING WALLS & PARTITIONS (EXTERIOR).. 0 HRS (TABLE 602) NONBEARING WALLS & PARTITIONS (INTERIOR)... 0 HRS FLOOR CONSTRUCTION... 2 HRS ROOF CONSTRUCTION.... 1 1/2 HRS <u>SECTION 708 SMOKE PARTITIONS (ELEVATOR LOBBIES)</u> 710.3 FIRE-RESISTANCE RATING UNLESS REQUIRED ELSEWHERE IN THE CODE, SMOKE PARTITIONS ARE NOT REQUIRED TO HAVE A FIRE-RESISTANCE RATING. 710.5.2.3 SELF- OR AUTOMATIC-CLOSING DOORS WHERE REQUIRED ELSEWHERE IN THE CODE, DOORS IN SMOKE PARTITIONS SHALL BE SELF-OR AUTOMATIC-CLOSING BY SMOKE DETECTION SECTION 713.4 SHAFT FIRE RESISTANCE RATINGS
SHAFT ENCLOSURES SHALL HAVE A FIRE-RESISTANCE RATING OF NOT LESS THAN 2 HOURS WHERE CONNECTING FOUR STORIES OR MORE, AND NOT LESS THAN 1 HOUR WHERE CONNECTING LESS THAN TABLE 717.3.2.1 OPENING PROTECTIVES
FIRE DAMPER RATING IN LESS THAN 3-HOUR FIRE RESISTANCE-RATED ASSEMBLIES.... 1 1/2 HR. MIN. DAMPER RATING TABLE 803.13 INTERIOR WALL AND CEILING FINISH REQUIREMENTS BY OCCUPANCY INTERIOR EXIT STAIRWAYS & EXIT PASSAGEWAYS....... CORRIDORS & EXIT ENCLOSURES.... ROOMS AND ENCLOSED SPACES... TABLE 1004.5 MAXIMUM FLOOR AREA ALLOWANCES PER OCCUPANT 300 SF GROSS / OCC ACCESSORY STORAGE AREAS, MECH. EQPT ROOM... 15 SF NET / OCC ASSEMBLY WITHOUT FIXED SEATS - UNCONCENTRATED (TABLES & CHAIRS) ASSEMBLY WITHOUT FIXED SEATS - CONCENTRATED (CHAIRS ONLY)....... 7 SF NET / OCC **BUSINESS AREAS....** 150 SF GROSS / OCC INSTITUTIONAL AREAS – SLEEPING AREAS...... 120 SF GROSS / OCC . 50 SF GROSS / OCC SECTION 1005.1 REQUIRED CAPACITY BASED ON OCCUPANT LOAD (SPRINKLERED) 1005.3.1 STAIRWAYS..... 1005.3.2 OTHER EGRESS COMPONENTS..... 0.15/OCC SECTION 1006.2.1 EGRESS BASED ON OCCUPANCY 2 EXITS REQUIRED EXCEPT WHERE NOTED IN TABLE 1006.2.1. SECTION 1006.2 EGRESS THROUGH INTERVENING SPACES EXIT ACCESS THROUGH AN ENCLOSED ELEVATOR LOBBY IS PERMITTED. TABLE 1006.2.1 SPACES WITH ONE EXIT OR EXIT ACCESS DOORWAY (SPRINKLERED) OCCUPANCY MAX. OCC. LOAD MAX. COMMON PATH OF EGRESS DISTANCE ASSEMBLY BUSINESS 100 FT 1010.1.1 SIZE OF DOORS (CLEAR WIDTH) 32" MINIMUM CLEAR OPENING, 48" MAXIMUM. 1010.1.2.1 DIRECTION OF DOOR SWING DOOR SHALL SWING IN THE DIRECTION OF EGRESS TRAVEL WHERE OCCUPANT LOAD IS 50 OR MORE. TABLE 1017.2 EXIT ACCESS TRAVEL DISTANCE (SPRINKLERED) 'A' OCCUPANCY.. 'B' OCCUPANCY... TABLE 1020.1 CORRIDOR FIRE-RESISTANCE RATING (SPRINKLERED) TABLE 1020.2 MINIMUM CORRIDOR WIDTH 44" MINIMUM UNLESS NOTED OTHERWISE. 24" FOR ACCESS TO ELECTRICAL, MECHANICAL OR PLUMBING SYSTEMS OR EQUIPMENT. 36" OCCUPANT LOAD OF 50 OR LESS. 1020.4 DEAD ENDS DEAD END CORRIDORS.... 20'-0" MAXIMUM 'B' OCCUPANCY (SPRINKLERED)..... SECTION 3004.6 ELEVATOR LOBBY MEANS OF EGRESS

ELEVATOR LOBBIES SHALL BE PROVIDED WITH NOT LESS THAN ONE MEANS OF EGRESS. EGRESS THROUGH AN ENCLOSED ELEVATOR LOBBY SHALL BE PERMITTED IN ACCORDANCE WITH ITEM 1




IEI GROUP, LTD. IEI ARCHITECTS, INC.

428 North 2nd Street Philadelphia, PA 19123 Telephone: 215.413.3700

CONSULTANTS:

Arora Engineers, Inc. 61 Wilmington-West Chester Pike Chadds Ford, PA 19317 P (610) 459-7900 F (610) 459-7950 aroraengineers.com

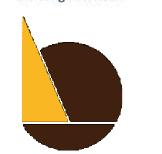

O'Donnell & Naccarato 701 Market Street, Suite 6000 Philadelphia, PA 19106 PH: 215.925.3788 www.o-n.com

LICENSE NO: <Architect's License #>

EFFECTIVE ONLY AS TO THAT VERSION OF THIS DOCUMENT AS ORIGINALLY RESPONSIBLE FOR ANY SUBSEQUENT MODIFICATION, CORRUPTION, OR UNAUTHORIZED USE OF SUCH DOCUMENT. TO VERIFY THE VALIDITY OF APPLICABILITY OF THE SEAL OR SIGNATURE, CONTACT DESIGN PROFESSIONAL

THE CITY OF PHILADELPHIA

OFFICE OF EMERGENCY MANAGEMENT
PHILADELPHIA PUBLIC SERVICES BUILDI
400 NORTH BROAD STREET, PHILADELPH
FLOORS 8, 9 AND 10

PROGRESS SET

CLIENT REVIEW BID SET


CODE REVIEW SET ■ ISSUED FOR CONSTRUCTION


(NOT FOR CONSTRUCTION) ISSUES/REVISIONS: 1 9/18/2020 ISSUED FOR BIDS

PROJECT NUMBER:

CODE INFO

PRINTED ON: 9/22/2020 12:52:32 PM

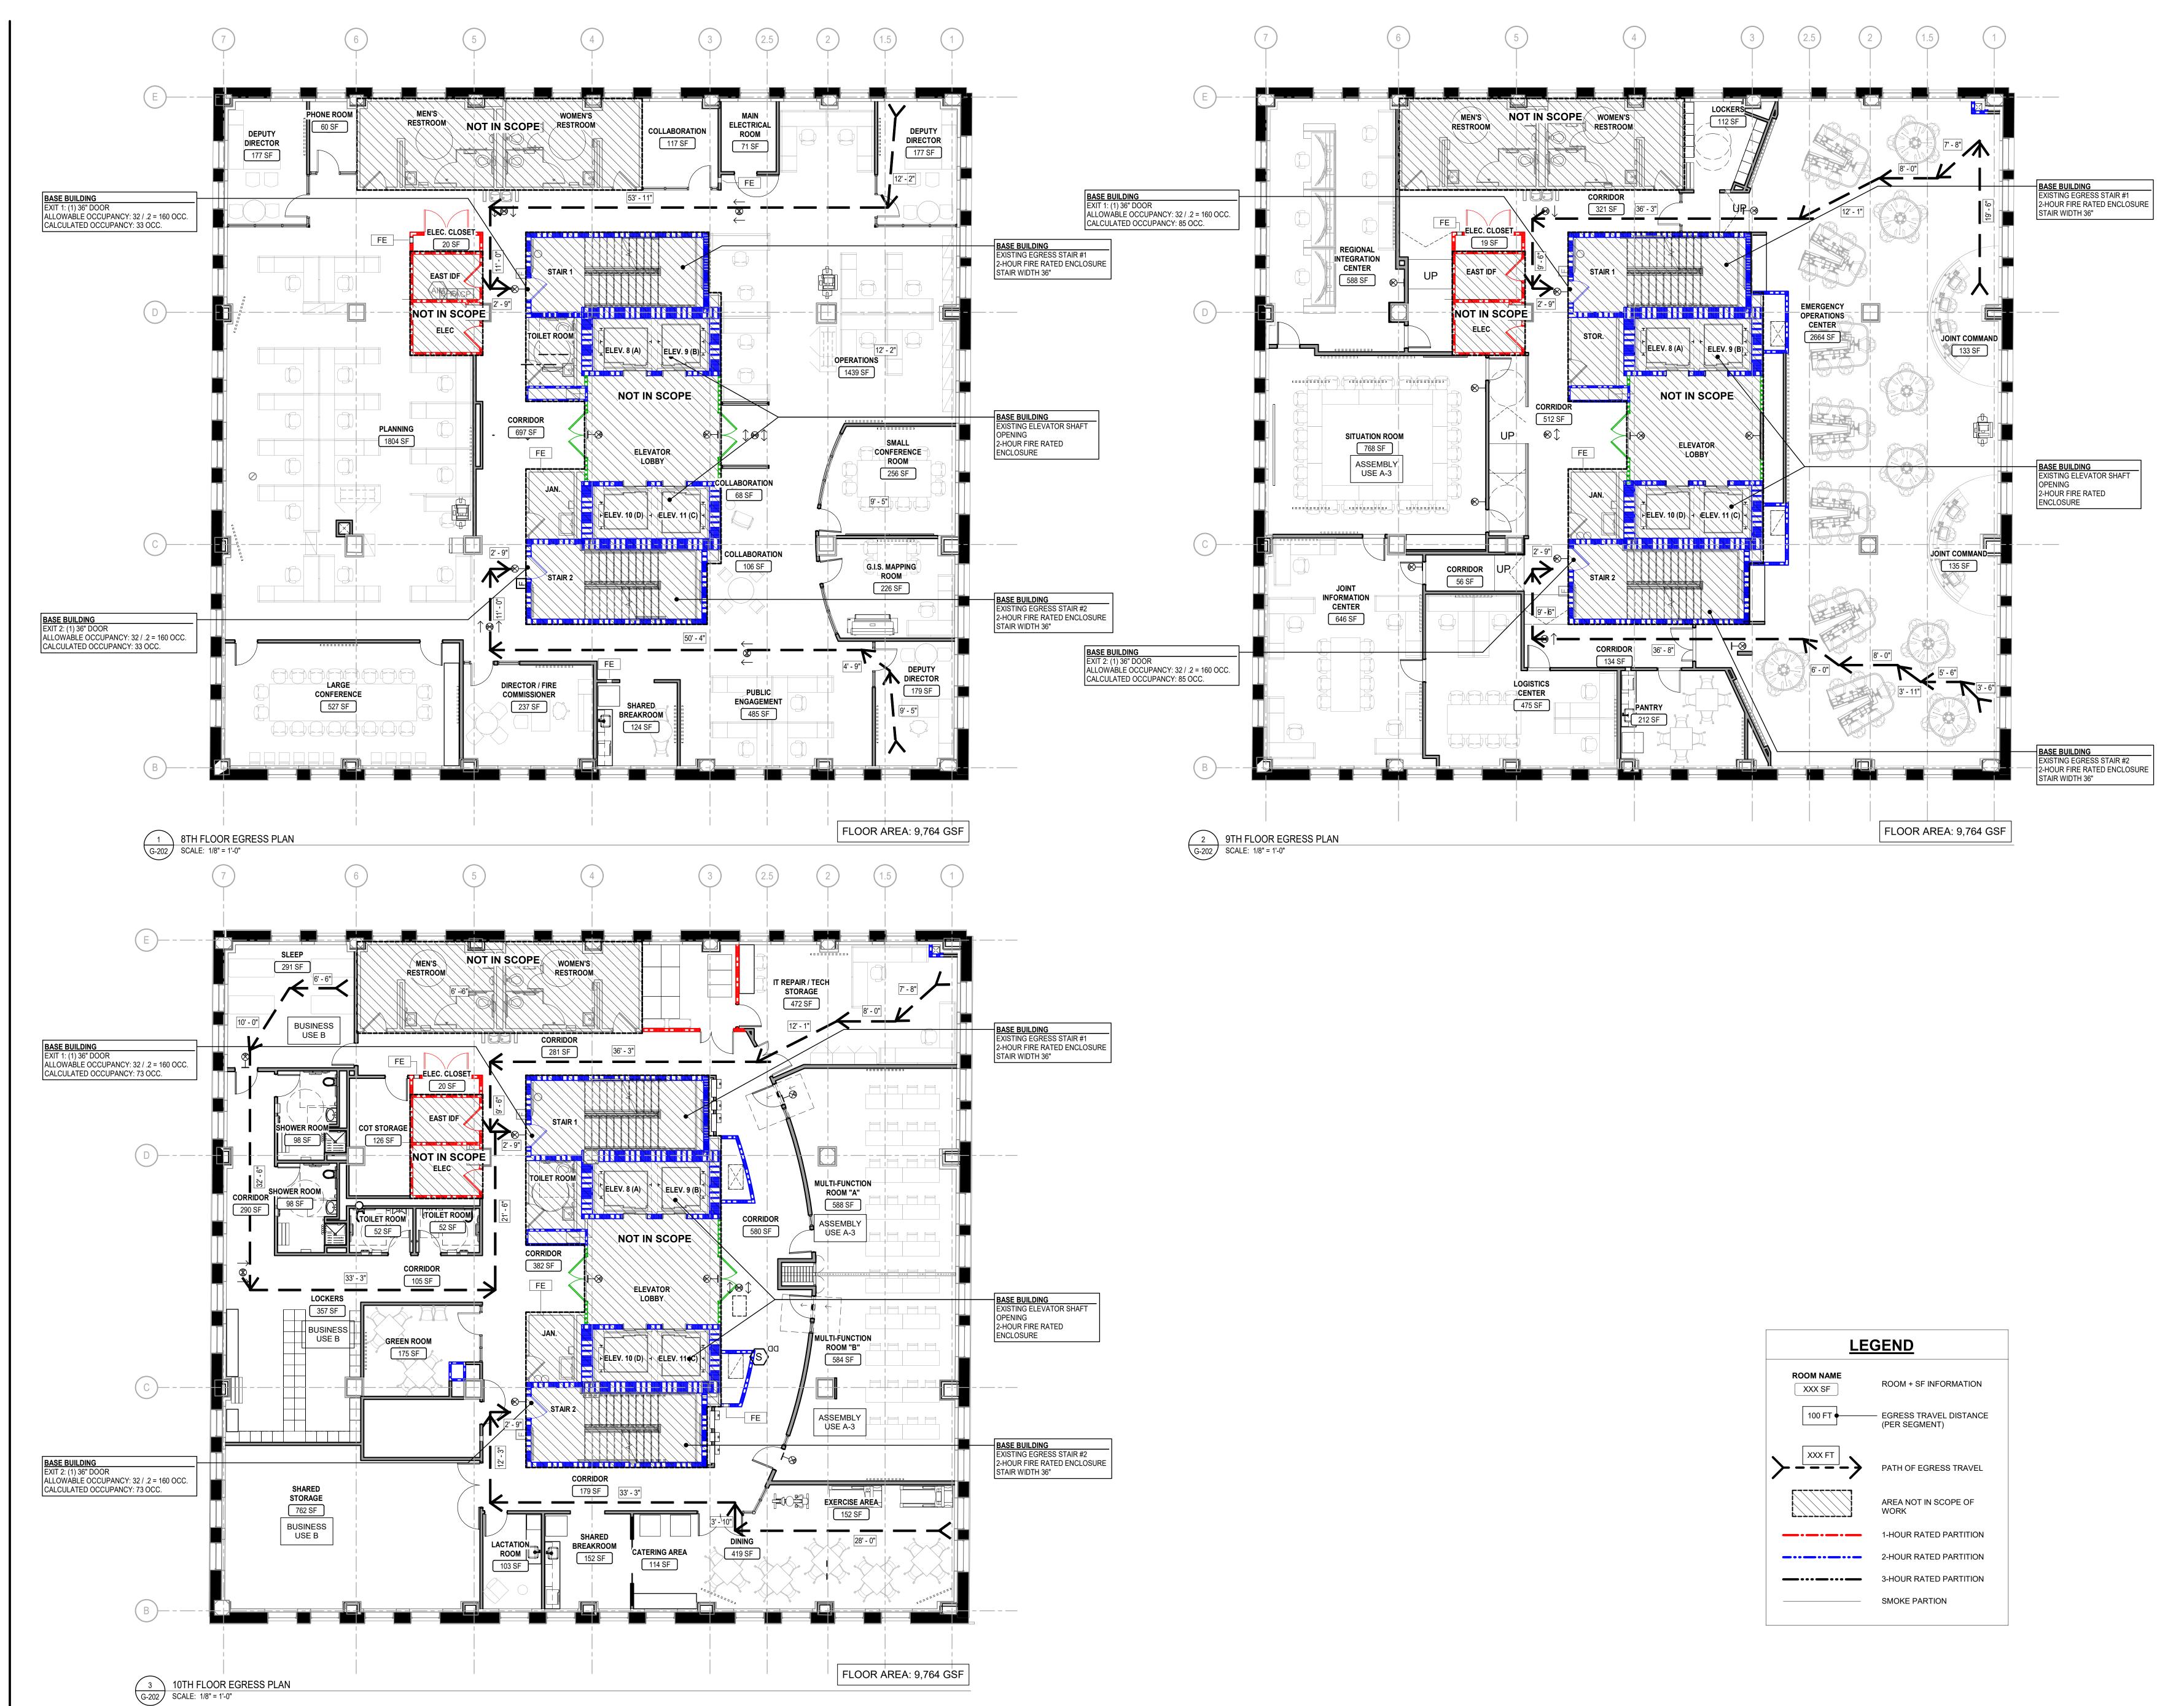

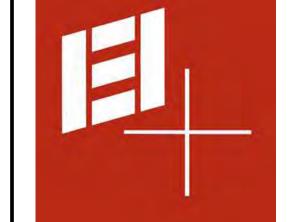

IEI GROUP, LTD. IEI ARCHITECTS, INC. 428 North 2nd Street

Philadelphia, PA 19123

Telephone: 215.413.3700

CONSULTANTS:

ARORA

Arora Engineers, Inc. 61 Wilmington-West Chester Pike Chadds Ford, PA 19317 P (610) 459-7900 F (610) 459-7950 aroraengineers.com



701 Market Street, Suite 6000 Philadelphia, PA 19106 PH: 215.925.3788 www.o-n.com

LICENSE NO: <Architect's License #>

EFFECTIVE ONLY AS TO THAT VERSION OF THIS DOCUMENT AS ORIGINALLY PUBLISHED BY DESIGN PROFESSIONAL DESIGN PROFESSIONAL IS NOT RESPONSIBLE FOR ANY SUBSEQUENT MODIFICATION, CORRUPTION, OR APPLICABILITY OF THE SEAL OR SIGNATURE, CONTACT DESIGN PROFESSIONA

THE CITYOFFICE (OFFICE (AND NOR FLOORS)

PROGRESS SET

CLIENT REVIEW ■ BID SET

CODE REVIEW SET ■ ISSUED FOR CONSTRUCTION

ISSUED FOR BIDS 09/18/2020 (NOT FOR CONSTRUCTION)


ISSUES/REVISIONS: 1 9/18/2020 ISSUED FOR BIDS

PROJECT NUMBER: SCALE: As indicated DATE: 09/18/2020 DRAWN BY: CHECKED BY:

DRAWING TITLE:

EGRESS PLANS

G-202

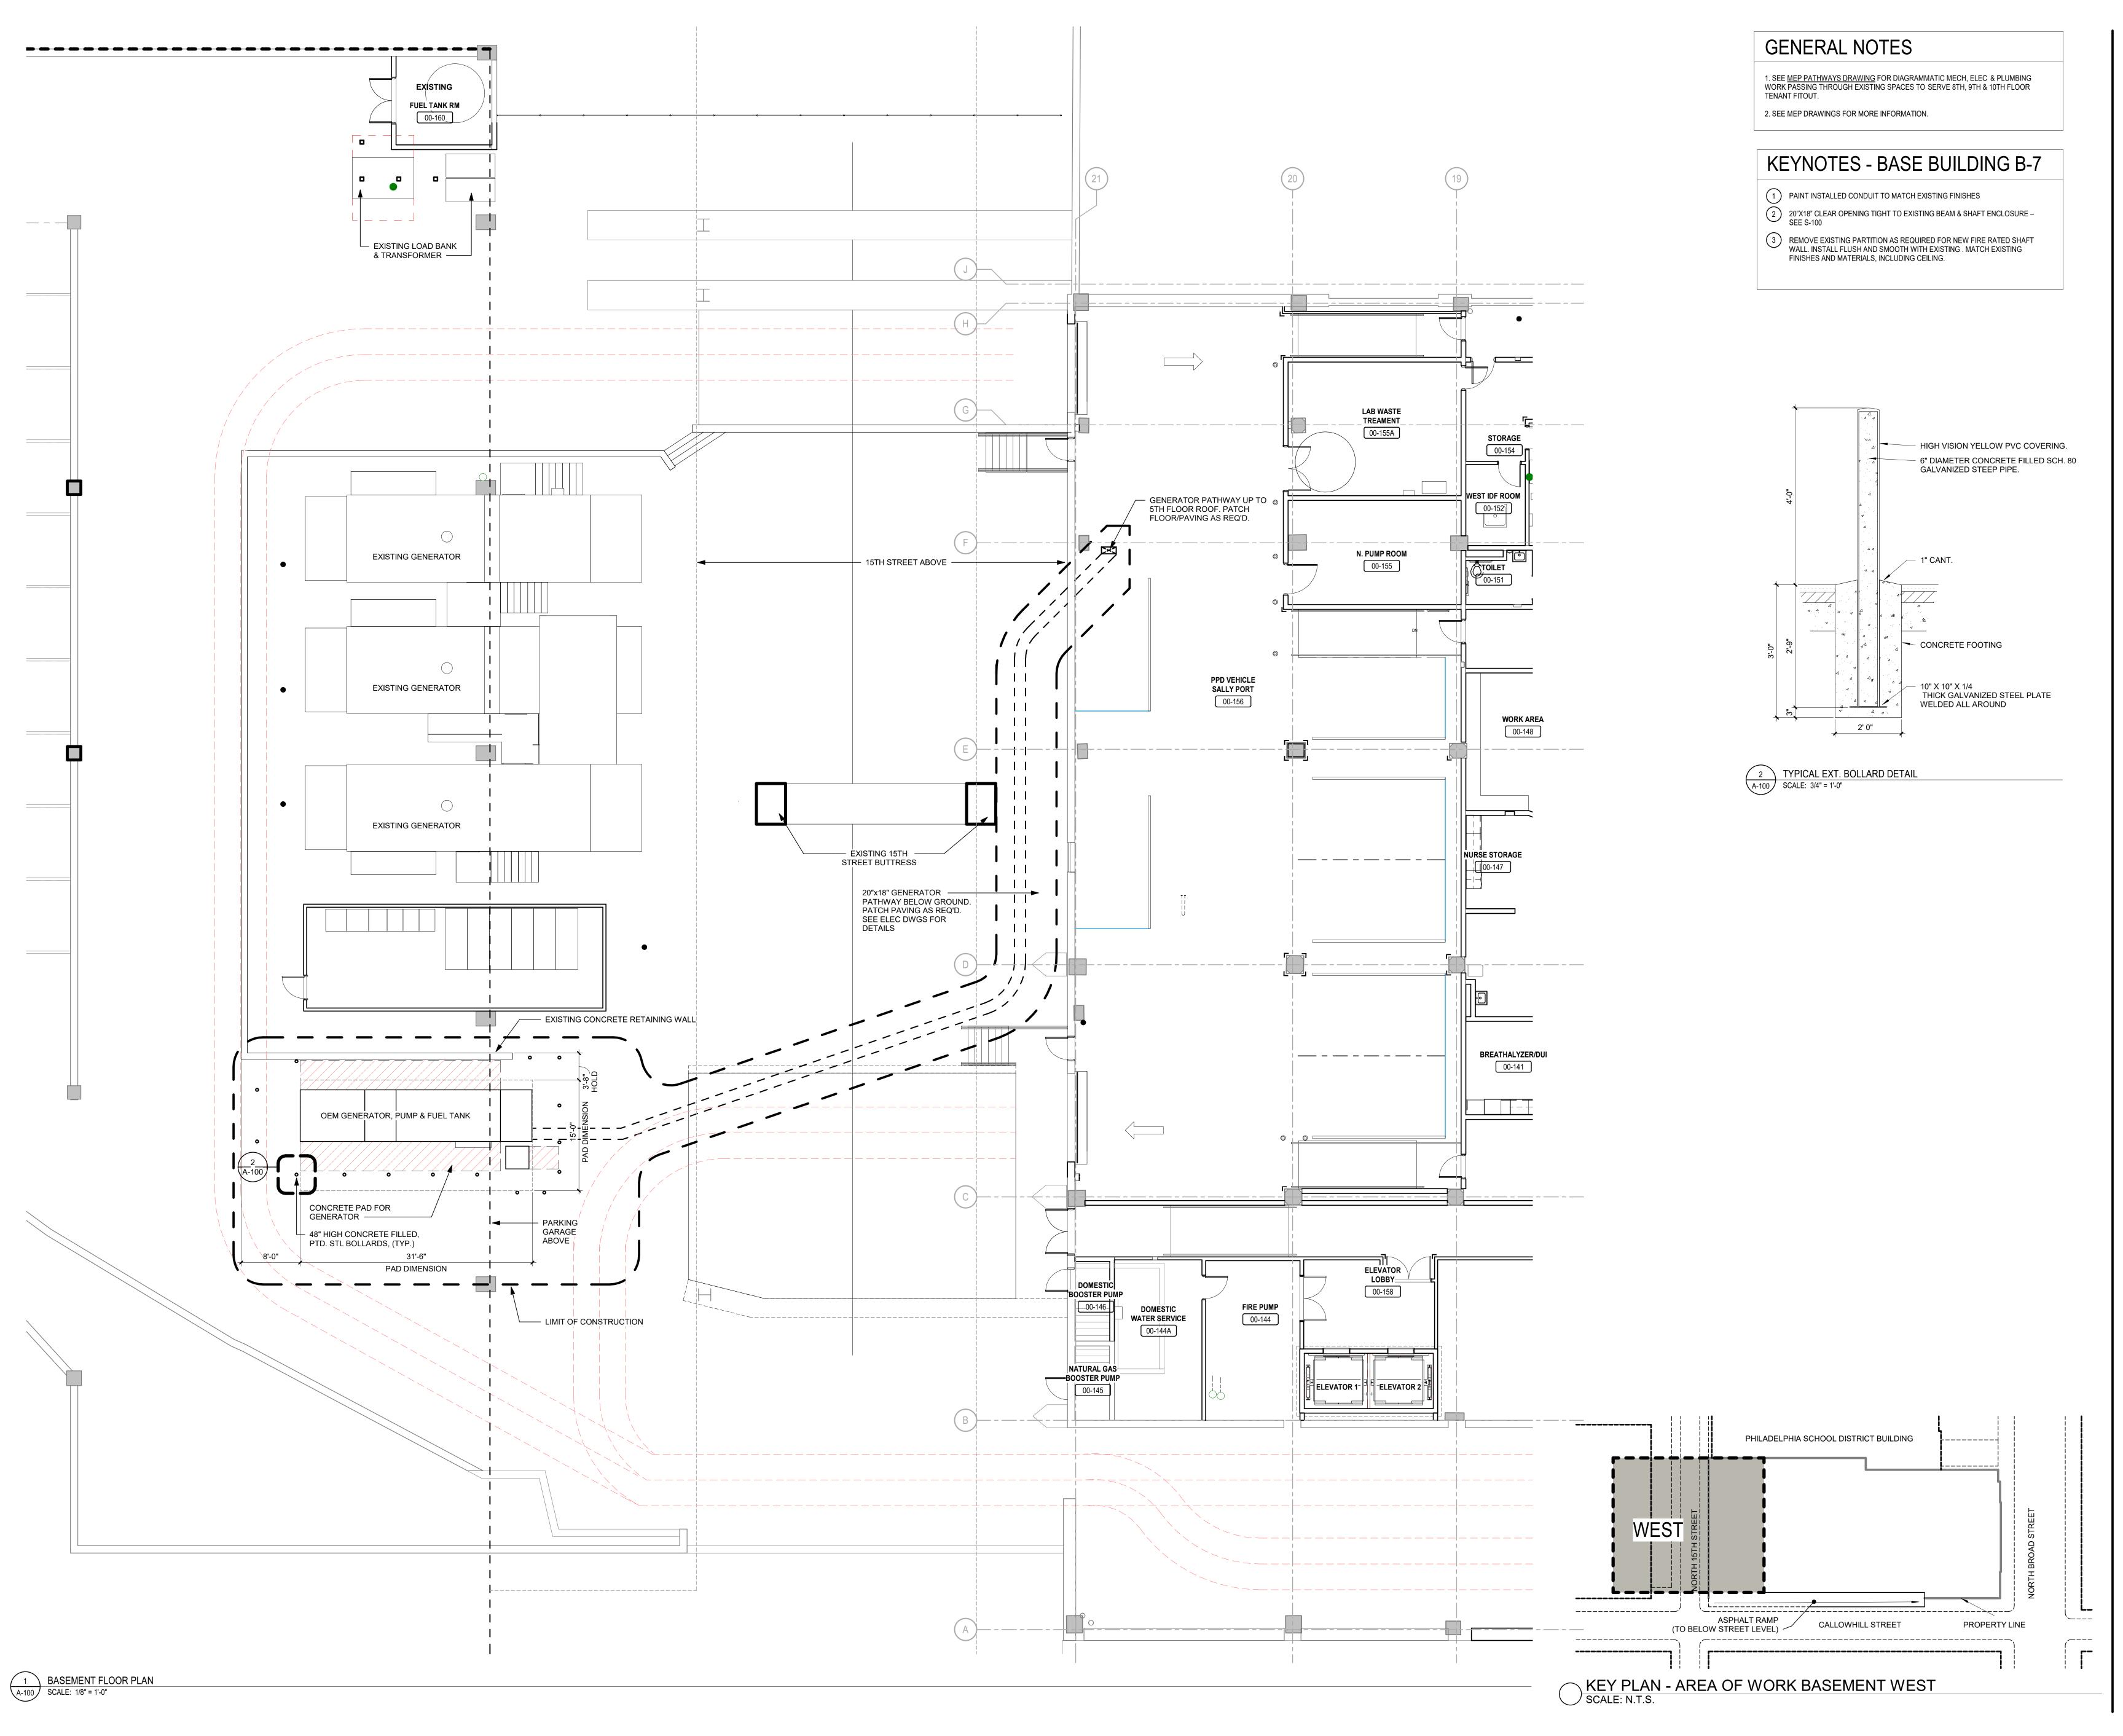

Telephone: 215.413.3700

CONSULTANTS:

Arora Engineers, Inc.
61 Wilmington-West Chester Pike

Chadds Ford, PA 19317 P (610) 459-7900



O'Donnell & Naccarato
701 Market Street, Suite 6000
Philadelphia, PA 19106
PH: 215.925.3788
www.o-n.com

LICENSE NO: <Architect's License #>

DESIGN PROFESSIONAL'S ELECTRONIC OR DIGITAL SEAL OR SIGNATURE IS EFFECTIVE ONLY AS TO THAT VERSION OF THIS DOCUMENT AS ORIGINALLY

LICENSE NO: <Architect's License #>

DESIGN PROFESSIONAL'S ELECTRONIC OR DIGITAL SEAL OR SIGNATURE IS EFFECTIVE ONLY AS TO THAT VERSION OF THIS DOCUMENT AS ORIGINALLY PUBLISHED BY DESIGN PROFESSIONAL. DESIGN PROFESSIONAL IS NOT RESPONSIBLE FOR ANY SUBSEQUENT MODIFICATION, CORRUPTION, OR UNAUTHORIZED USE OF SUCH DOCUMENT. TO VERIFY THE VALIDITY OR APPLICABILITY OF THE SEAL OR SIGNATURE, CONTACT DESIGN PROFESSIONAL.

TE CILY OF PHILADELPHIA

FFICE OF EMERGENCY MANAGEMENT

HILADELPHIA PUBLIC SERVICES BUILDING

NORTH BROAD STREET, PHILADELPHIA, PA

OORS 8, 9 AND 10

□ PROGRESS SET
□ CLIENT REVIEW

■ BID SET
□ CODE REVIEW SET
□ ISSUED FOR CONSTRUCTION

ISSUED FOR BIDS 09/18/2020

(NOT FOR CONSTRUCTION)

ISSUES/REVISIONS:

1 9/18/2020 ISSUED FOR BIDS

PROJECT NUMBER: 304103-120
SCALE: As indicated
DATE: 09/18/2020
DRAWN BY: SM
CHECKED BY: PT


DRAWING TITLE:

BASEMENT FLOOR
PLAN - WEST

SHEET NO:

A-100

PRINTED ON: 9/22/2020 12:49:23 PM

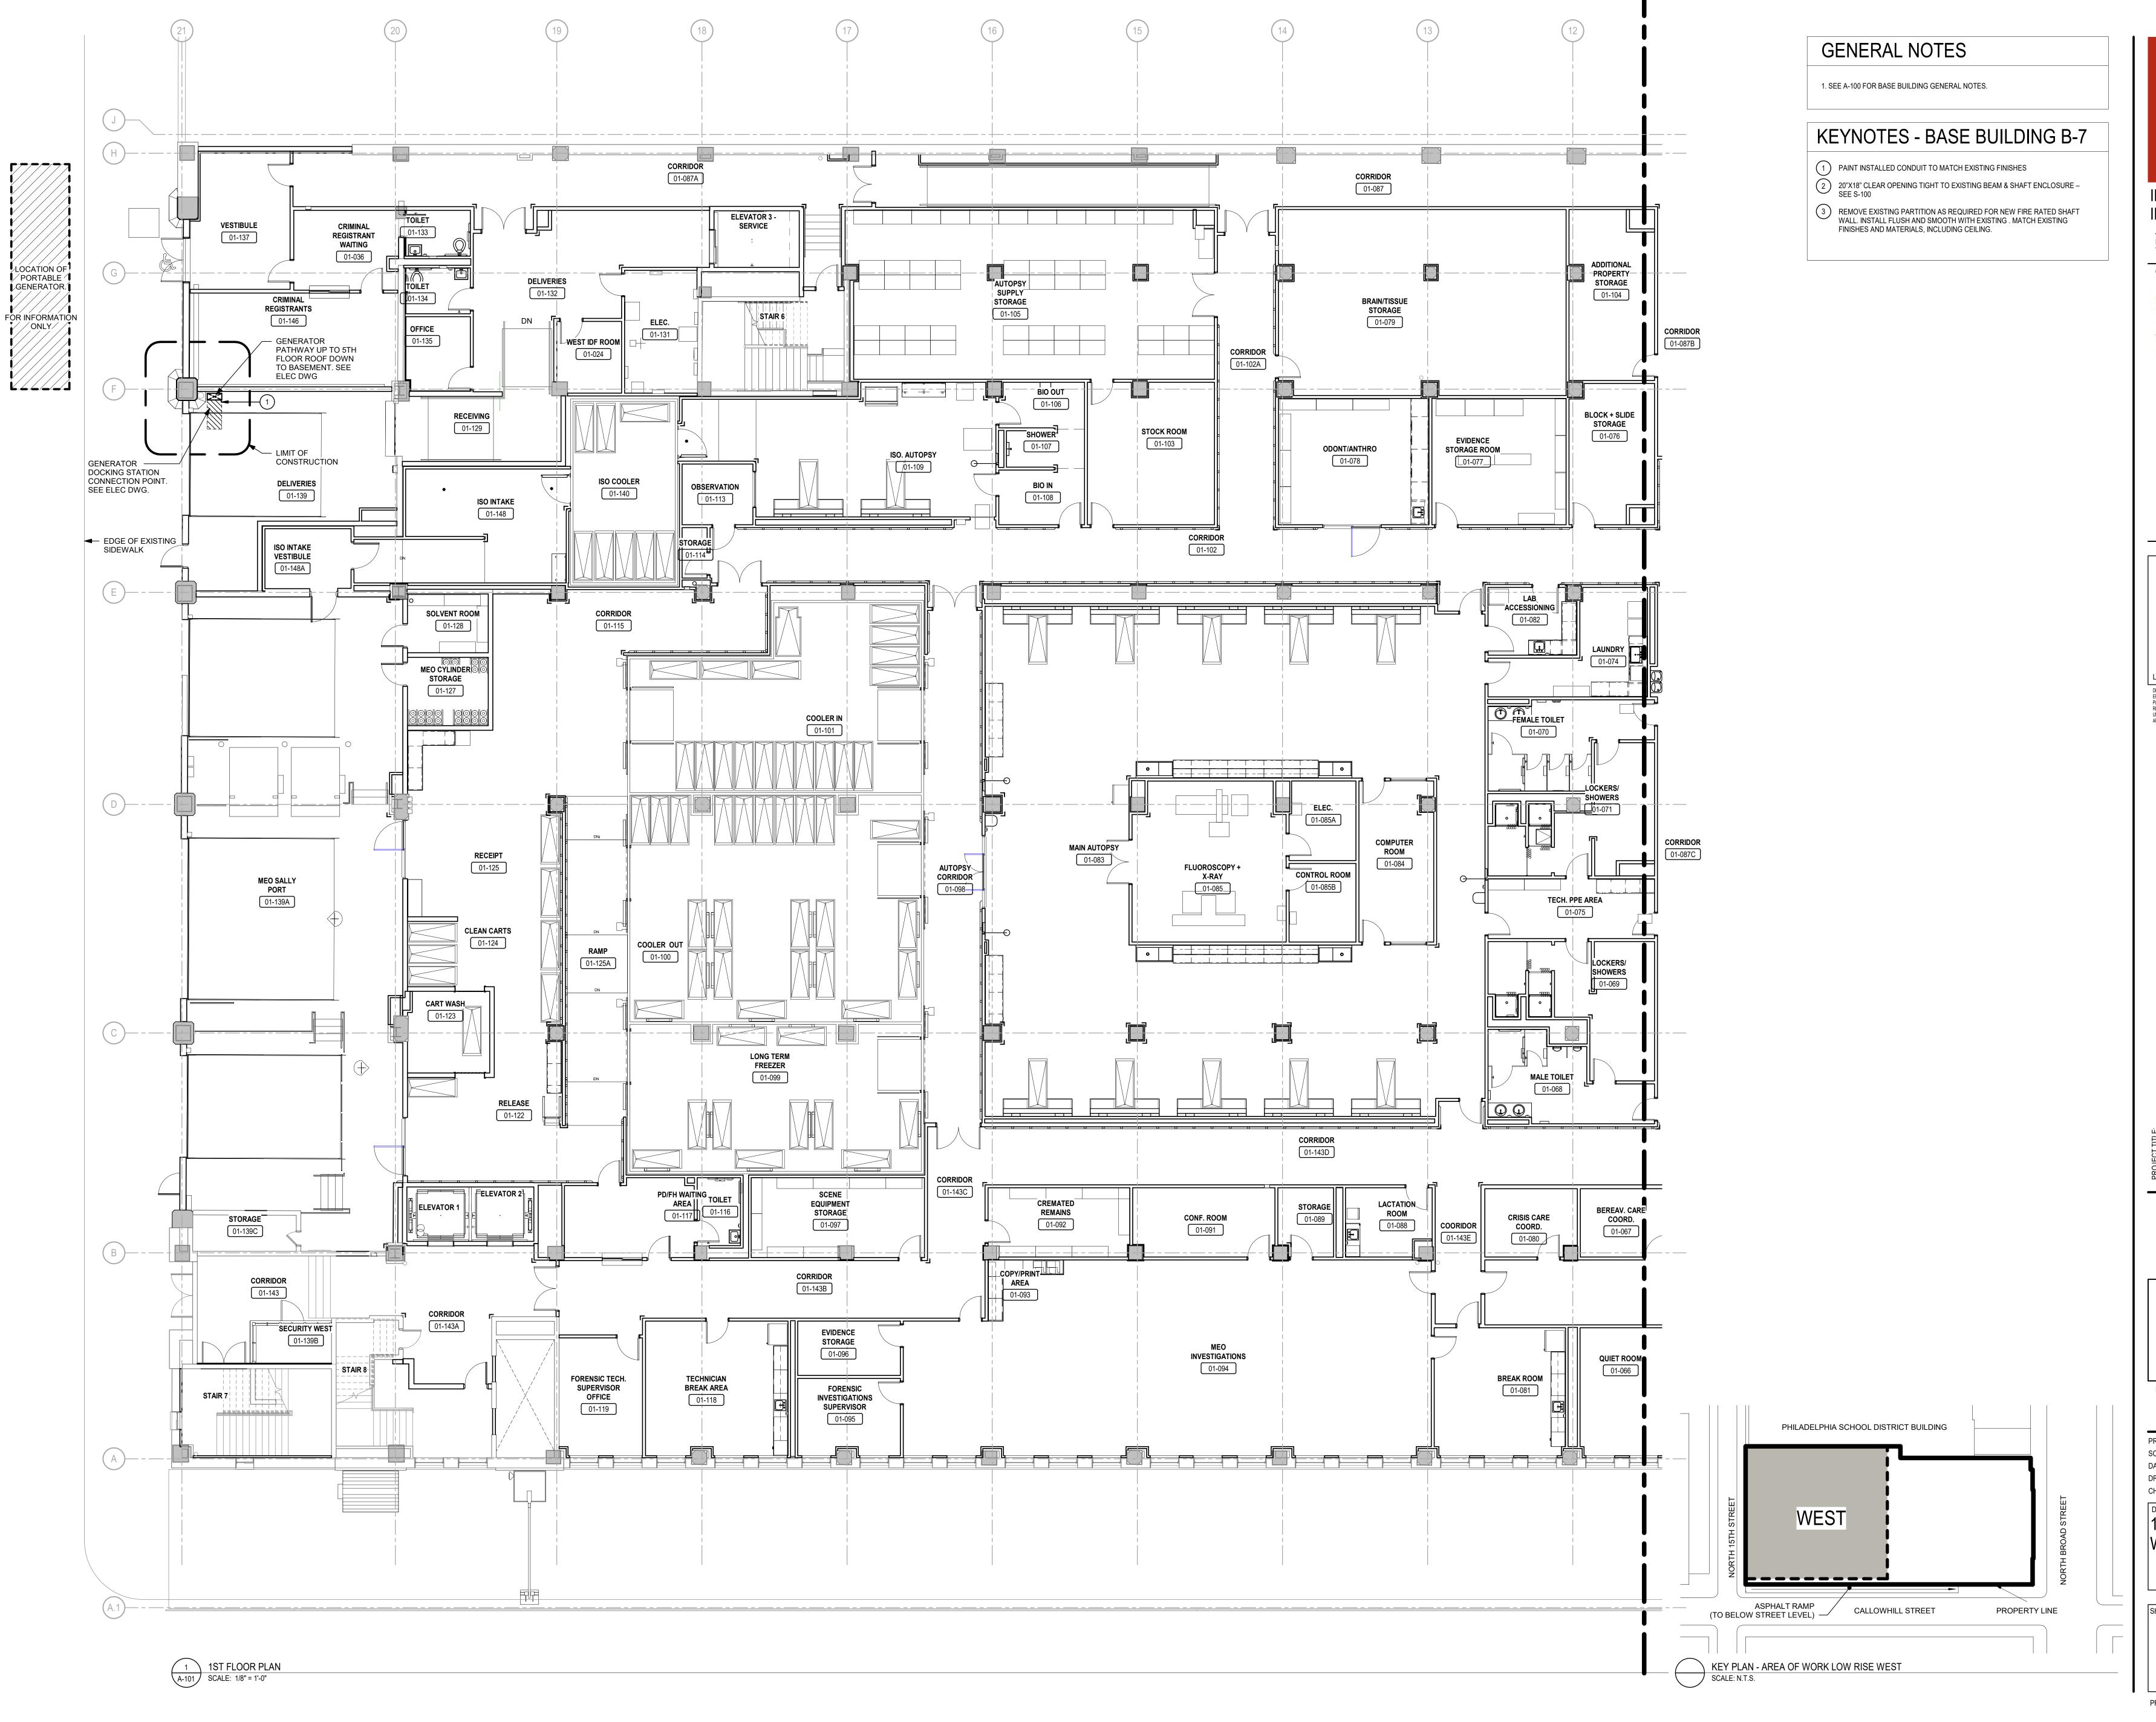

IEI GROUP, LTD. IEI ARCHITECTS, INC.

428 North 2nd Street Philadelphia, PA 19123 Telephone: 215.413.3700

CONSULTANTS: **ARORA**

Arora Engineers, Inc. 61 Wilmington-West Chester Pike Chadds Ford, PA 19317 P (610) 459-7900 F (610) 459-7950

aroraengineers.com



O'Donnell & Naccarato 701 Market Street, Suite 6000 Philadelphia, PA 19106 PH: 215.925.3788 www.o-n.com

LICENSE NO: <Architect's License #> EFFECTIVE ONLY AS TO THAT VERSION OF THIS DOCUMENT AS ORIGINALLY PUBLISHED BY DESIGN PROFESSIONAL. DESIGN PROFESSIONAL IS NOT RESPONSIBLE FOR ANY SUBSEQUENT MODIFICATION, CORRUPTION, OR UNAUTHORIZED USE OF SUCH DOCUMENT. TO VERIEY THE VALIDITY OR

PROGRESS SET □ CLIENT REVIEW

■ BID SET ■ CODE REVIEW SET

■ ISSUED FOR CONSTRUCTION

ISSUED FOR BIDS 09/18/2020 (NOT FOR CONSTRUCTION)

ISSUES/REVISIONS: 1 9/18/2020 ISSUED FOR BIDS


PROJECT NUMBER:

DRAWN BY: DRAWING TITLE:

1ST FLOOR PLAN -

A-101

PRINTED ON: 9/22/2020 12:49:33 PM

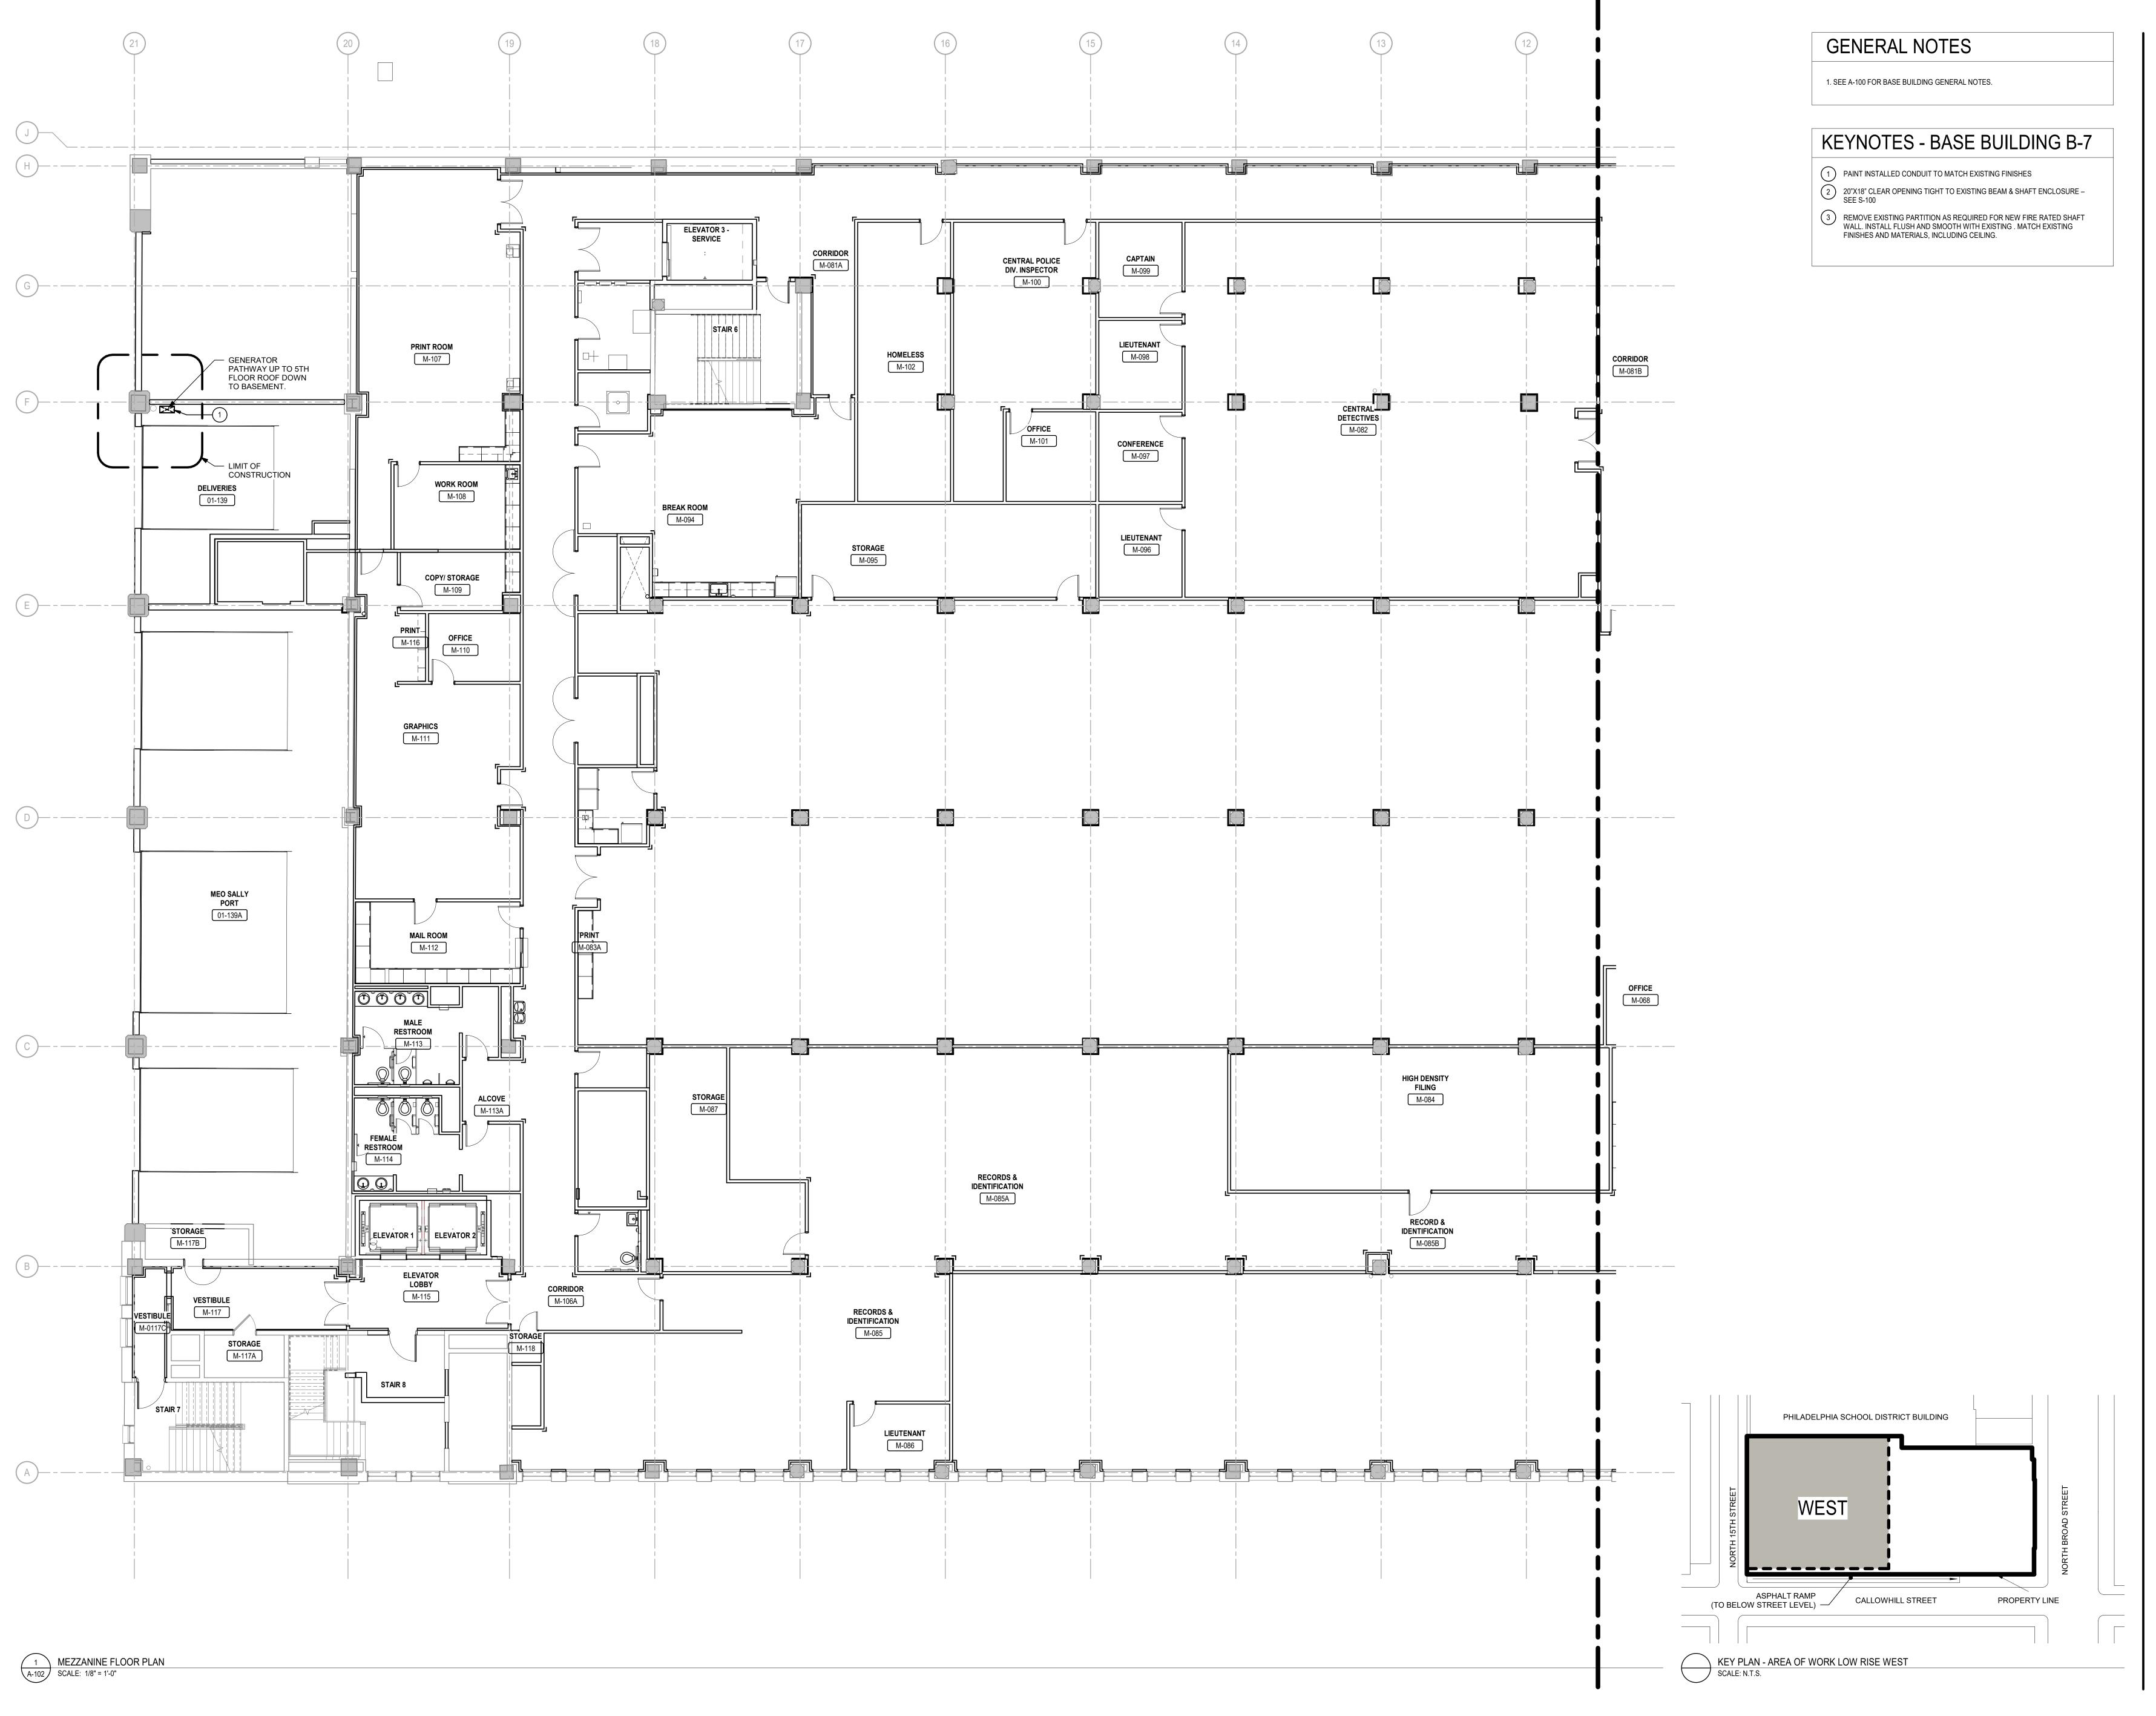

Telephone: 215.413.3700 CONSULTANTS:





PH: 215.925.3788 www.o-n.com

LICENSE NO: <Architect's License #> DESIGN FROE SOLUTE. SELECTIONS OF THIS DOCUMENT AS ORIGINALLY PUBLISHED BY DESIGN PROFESSIONAL. DESIGN PROFESSIONAL IS NOT RESPONSIBLE FOR ANY SUBSEQUENT MODIFICATION, CORRUPTION, OR UNAUTHORIZED USE OF SUCH DOCUMENT. TO VERIETY THE VALIDITY OR

■ PROGRESS SET □ CLIENT REVIEW

■ BID SET CODE REVIEW SET ■ ISSUED FOR CONSTRUCTION

> ISSUED FOR BIDS 09/18/2020


(NOT FOR CONSTRUCTION) ISSUES/REVISIONS: 1 9/18/2020 ISSUED FOR BIDS

PROJECT NUMBER: DATE: DRAWN BY: CHECKED BY: DRAWING TITLE:

MEZZANINE PLAN -

A-102

PRINTED ON: 9/22/2020 12:49:39 PM

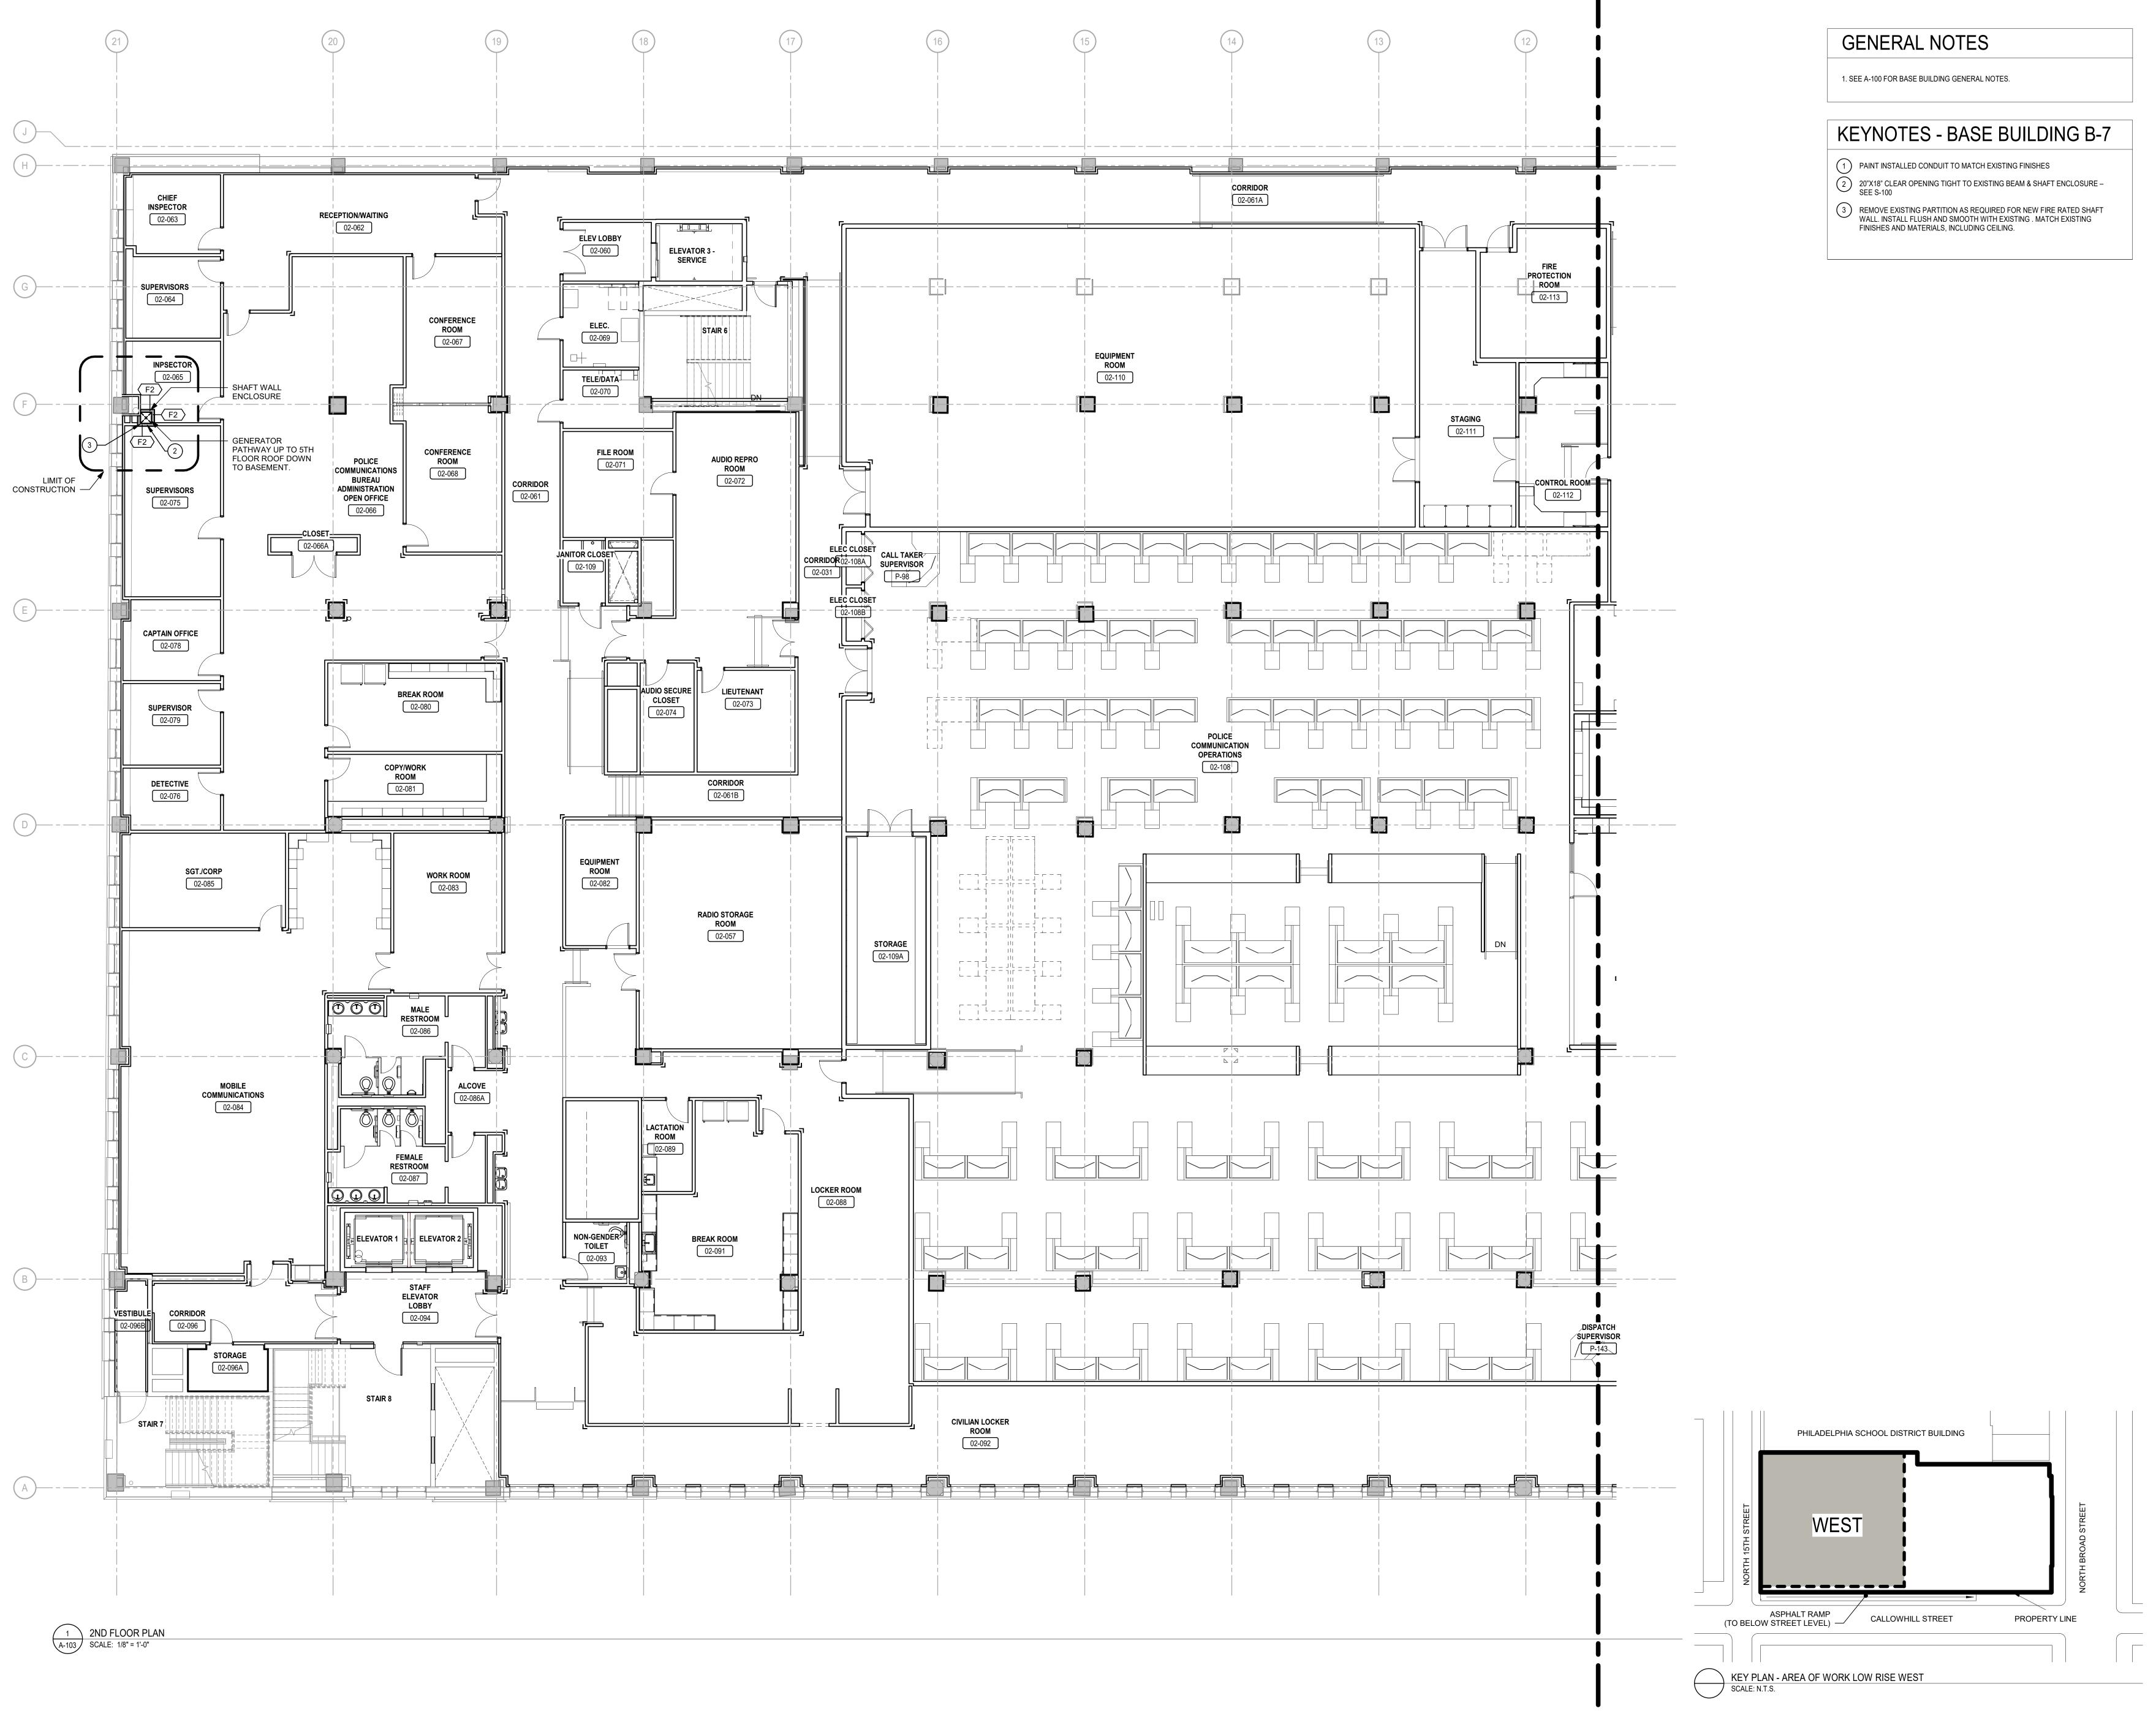

IEI GROUP, LTD. IEI ARCHITECTS, INC.

428 North 2nd Street Philadelphia, PA 19123 Telephone: 215.413.3700

CONSULTANTS:

Arora Engineers, Inc. 61 Wilmington-West Chester Pike Chadds Ford, PA 19317 P (610) 459-7900 F (610) 459-7950 aroraengineers.com



O'Donnell & Naccarato 701 Market Street, Suite 6000 Philadelphia, PA 19106 PH: 215.925.3788 www.o-n.com

LICENSE NO: <Architect's License #> EFFECTIVE ONLY AS TO THAT VERSION OF THIS DOCUMENT AS ORIGINALLY PUBLISHED BY DESIGN PROFESSIONAL. DESIGN PROFESSIONAL IS NOT RESPONSIBLE FOR ANY SUBSEQUENT MODIFICATION, CORRUPTION, OR UNAUTHORIZED USE OF SUCH DOCUMENT. TO VERIEY THE VALIDITY OR

■ PROGRESS SET CLIENT REVIEW

■ BID SET CODE REVIEW SET

☐ ISSUED FOR CONSTRUCTION

ISSUED FOR BIDS 09/18/2020

(NOT FOR CONSTRUCTION)

ISSUES/REVISIONS: 1 9/18/2020 ISSUED FOR BIDS


PROJECT NUMBER: DATE: DRAWN BY: CHECKED BY:

DRAWING TITLE:

2ND FLOOR PLAN -

A-103

PRINTED ON: 9/22/2020 12:49:45 PM

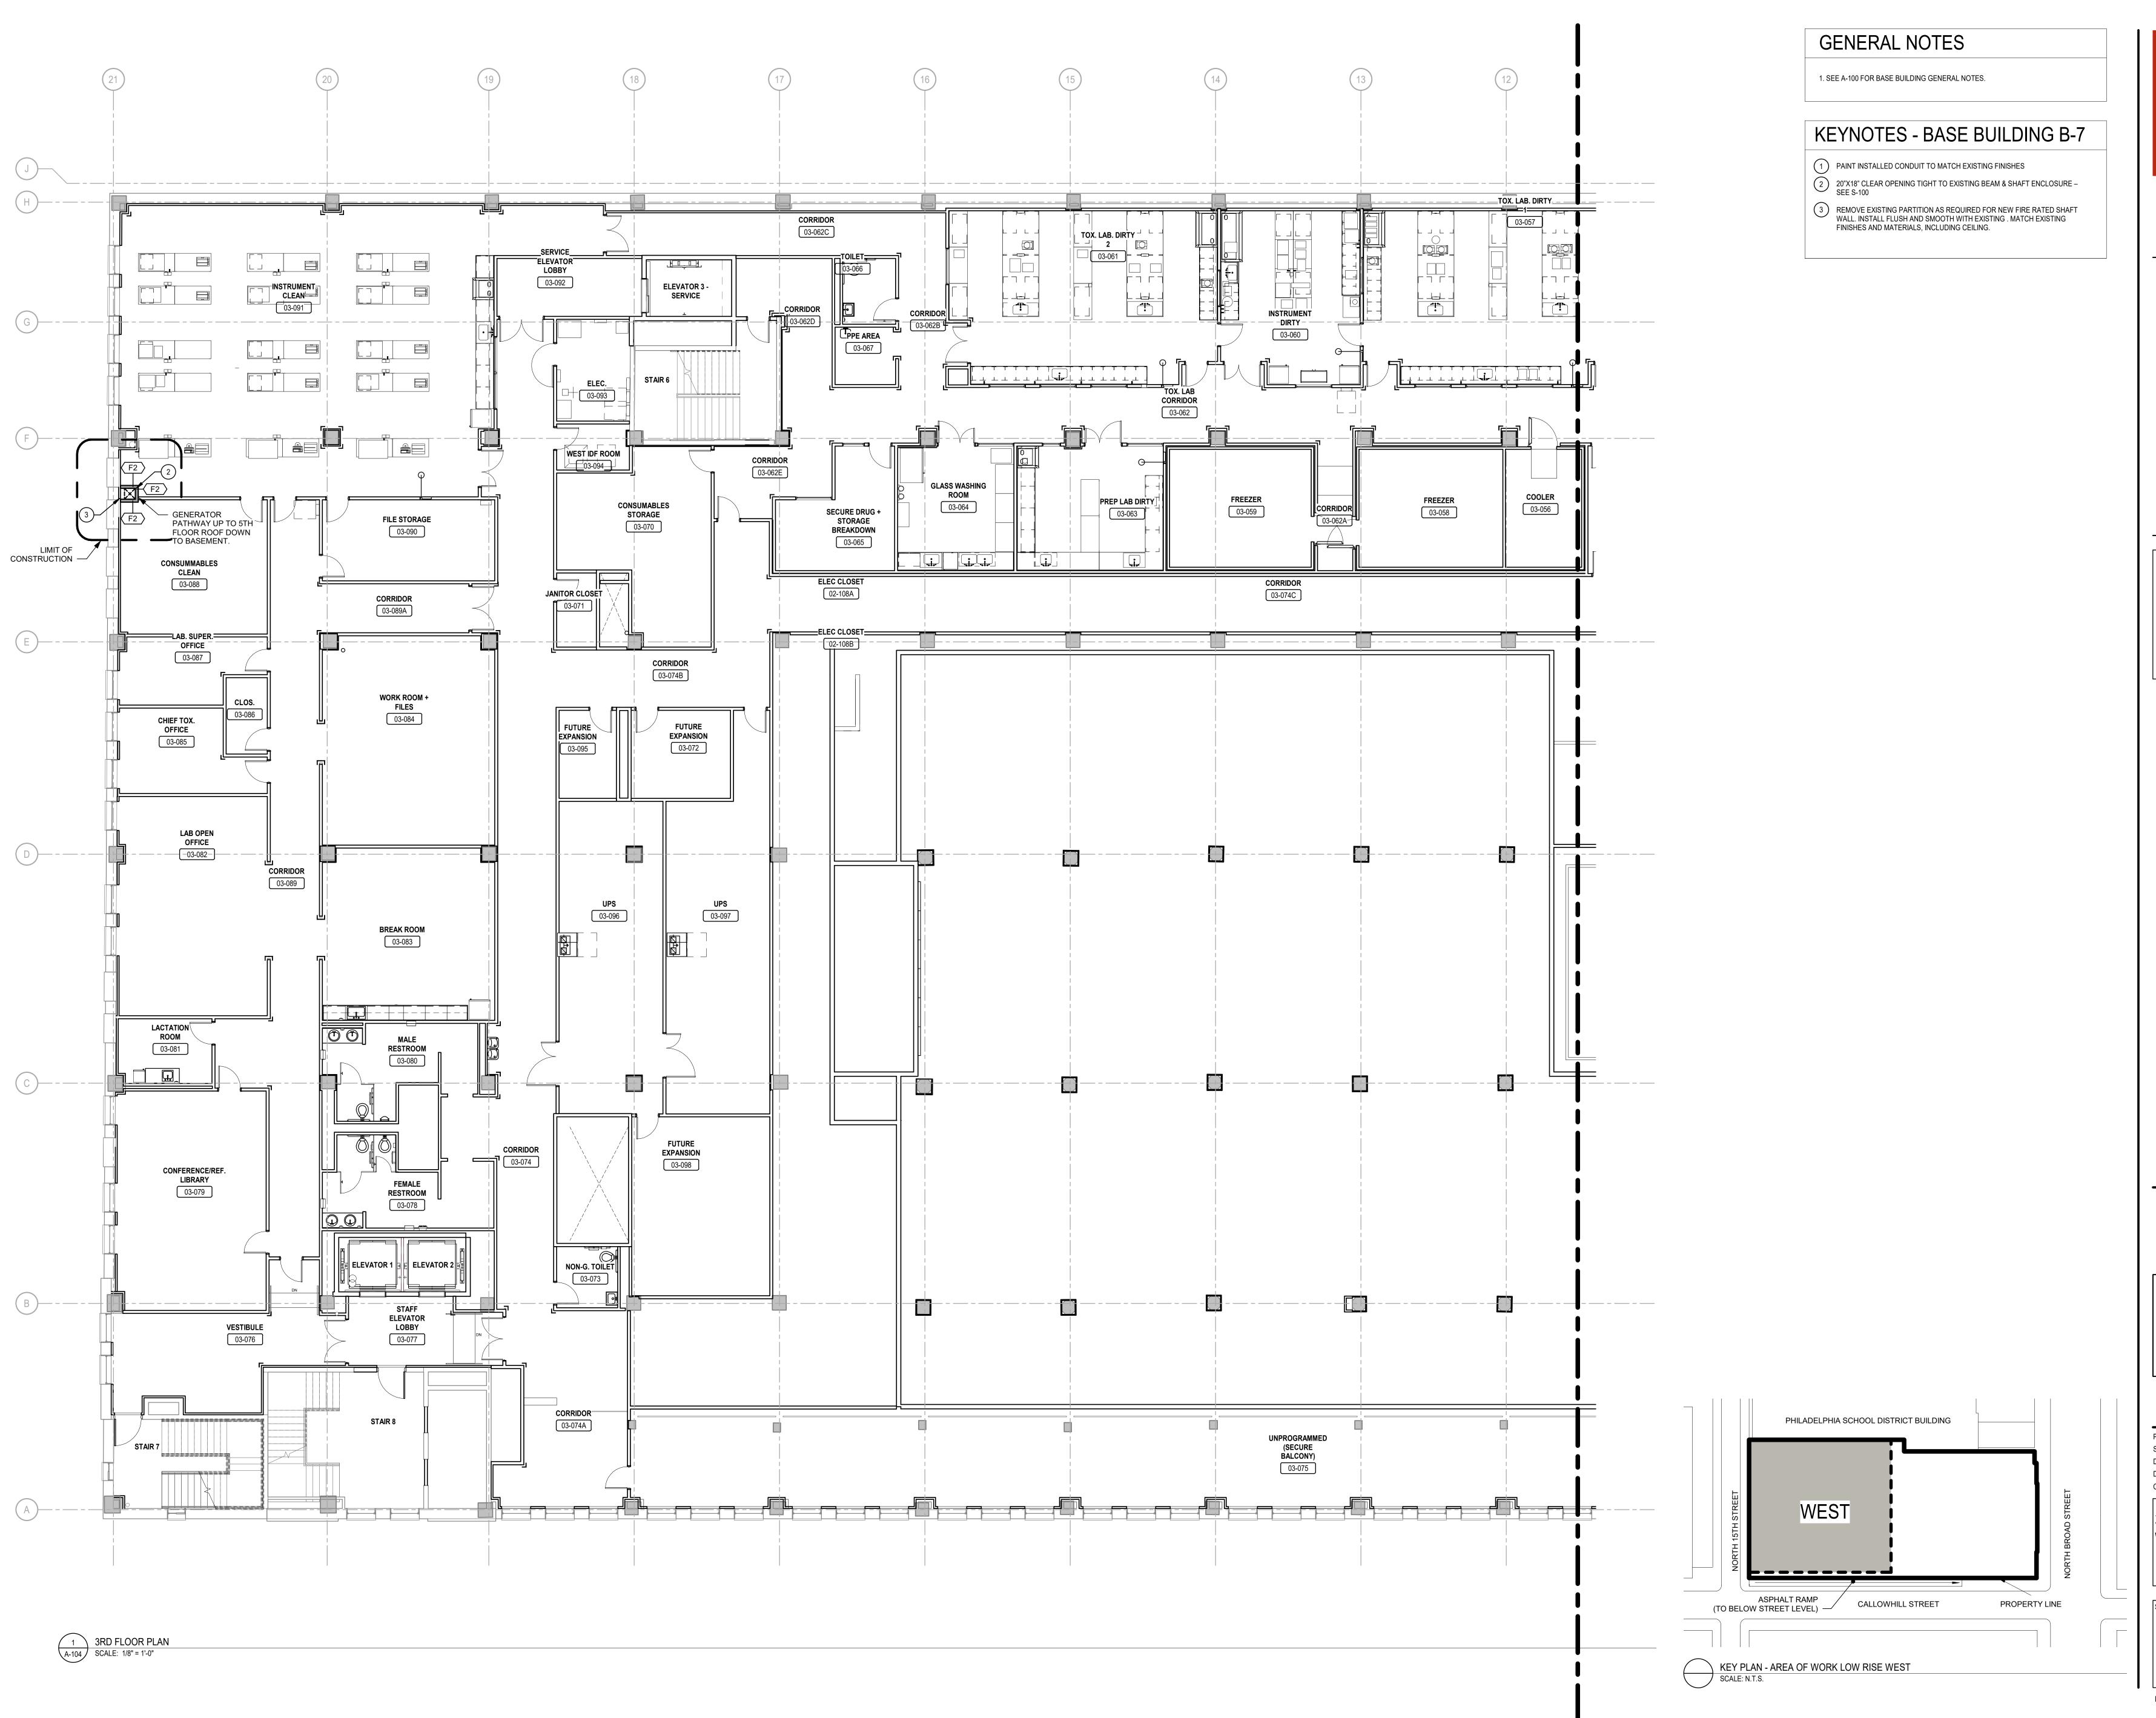

Telephone: 215.413.3700 CONSULTANTS:

Arora Engineers, Inc. 61 Wilmington-West Chester Pike Chadds Ford, PA 19317 P (610) 459-7900 F (610) 459-7950

aroraengineers.com



O'Donnell & Naccarato 701 Market Street, Suite 6000 Philadelphia, PA 19106 PH: 215.925.3788 www.o-n.com

LICENSE NO: <Architect's License #> DESIGN FROE SOLUTE. SELECTIONS OF THIS DOCUMENT AS ORIGINALLY PUBLISHED BY DESIGN PROFESSIONAL. DESIGN PROFESSIONAL IS NOT RESPONSIBLE FOR ANY SUBSEQUENT MODIFICATION, CORRUPTION, OR UNAUTHORIZED USE OF SUCH DOCUMENT. TO VERIETY THE VALIDITY OR

PROGRESS SET CLIENT REVIEW

■ BID SET CODE REVIEW SET ☐ ISSUED FOR CONSTRUCTION

ISSUED

FOR BIDS 09/18/2020 (NOT FOR CONSTRUCTION)

1 9/18/2020 ISSUED FOR BIDS

PROJECT NUMBER: SCALE: DATE: DRAWN BY: CHECKED BY:


DRAWING TITLE:

3RD FLOOR PLAN -

SHEET NO:

A-104


PRINTED ON: 9/22/2020 12:49:52 PM

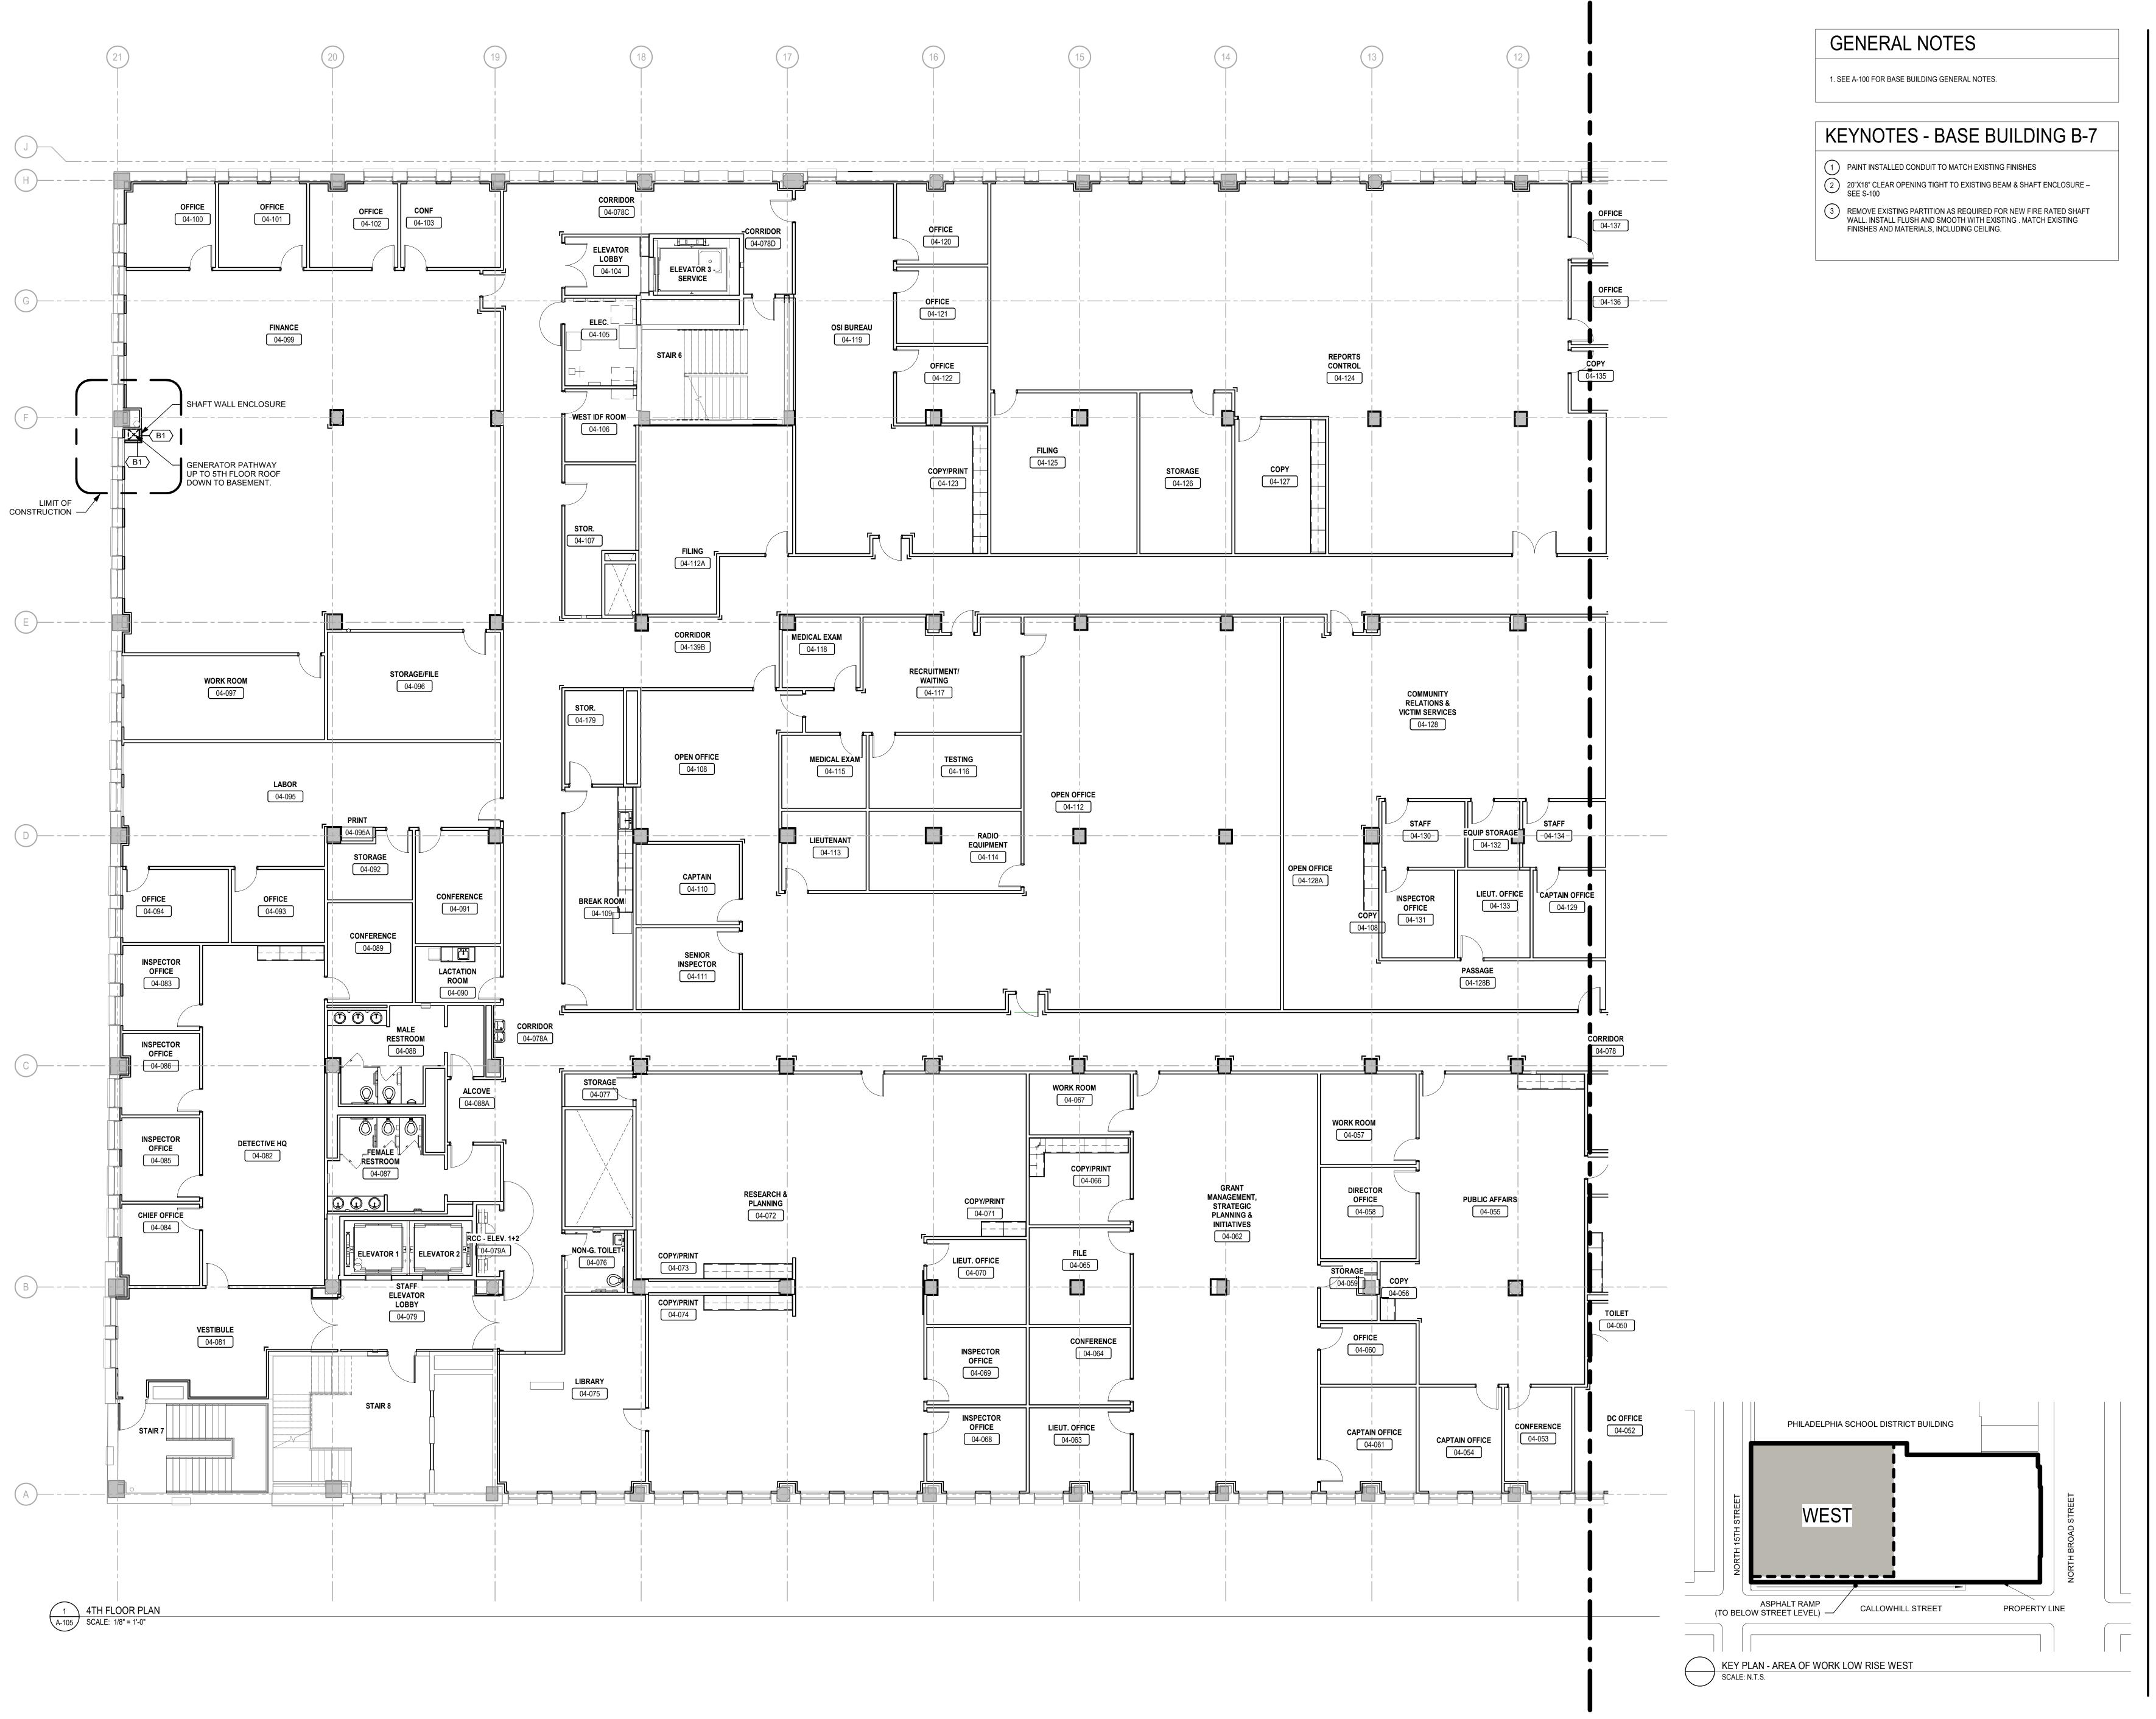

Telephone: 215.413.3700

CONSULTANTS:

Arora Engineers, Inc. 61 Wilmington-West Chester Pike

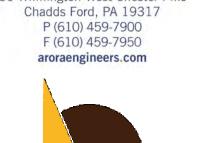

O'Donnell & Naccarato 701 Market Street, Suite 6000 Philadelphia, PA 19106 PH: 215.925.3788 www.o-n.com

LICENSE NO: <Architect's License #>

EFFECTIVE ONLY AS TO THAT VERSION OF THIS DOCUMENT AS ORIGINALLY PUBLISHED BY DESIGN PROFESSIONAL. DESIGN PROFESSIONAL IS NOT RESPONSIBLE FOR ANY SUBSEQUENT MODIFICATION, CORRUPTION, OR

■ PROGRESS SET CLIENT REVIEW

■ BID SET CODE REVIEW SET ■ ISSUED FOR CONSTRUCTION

> **ISSUED** FOR BIDS 09/18/2020

(NOT FOR CONSTRUCTION) ISSUES/REVISIONS: 1 9/18/2020 ISSUED FOR BIDS


PROJECT NUMBER: DATE: DRAWN BY: CHECKED BY:

DRAWING TITLE:

4TH FLOOR PLAN -

A-105

PRINTED ON: 9/22/2020 12:49:58 PM

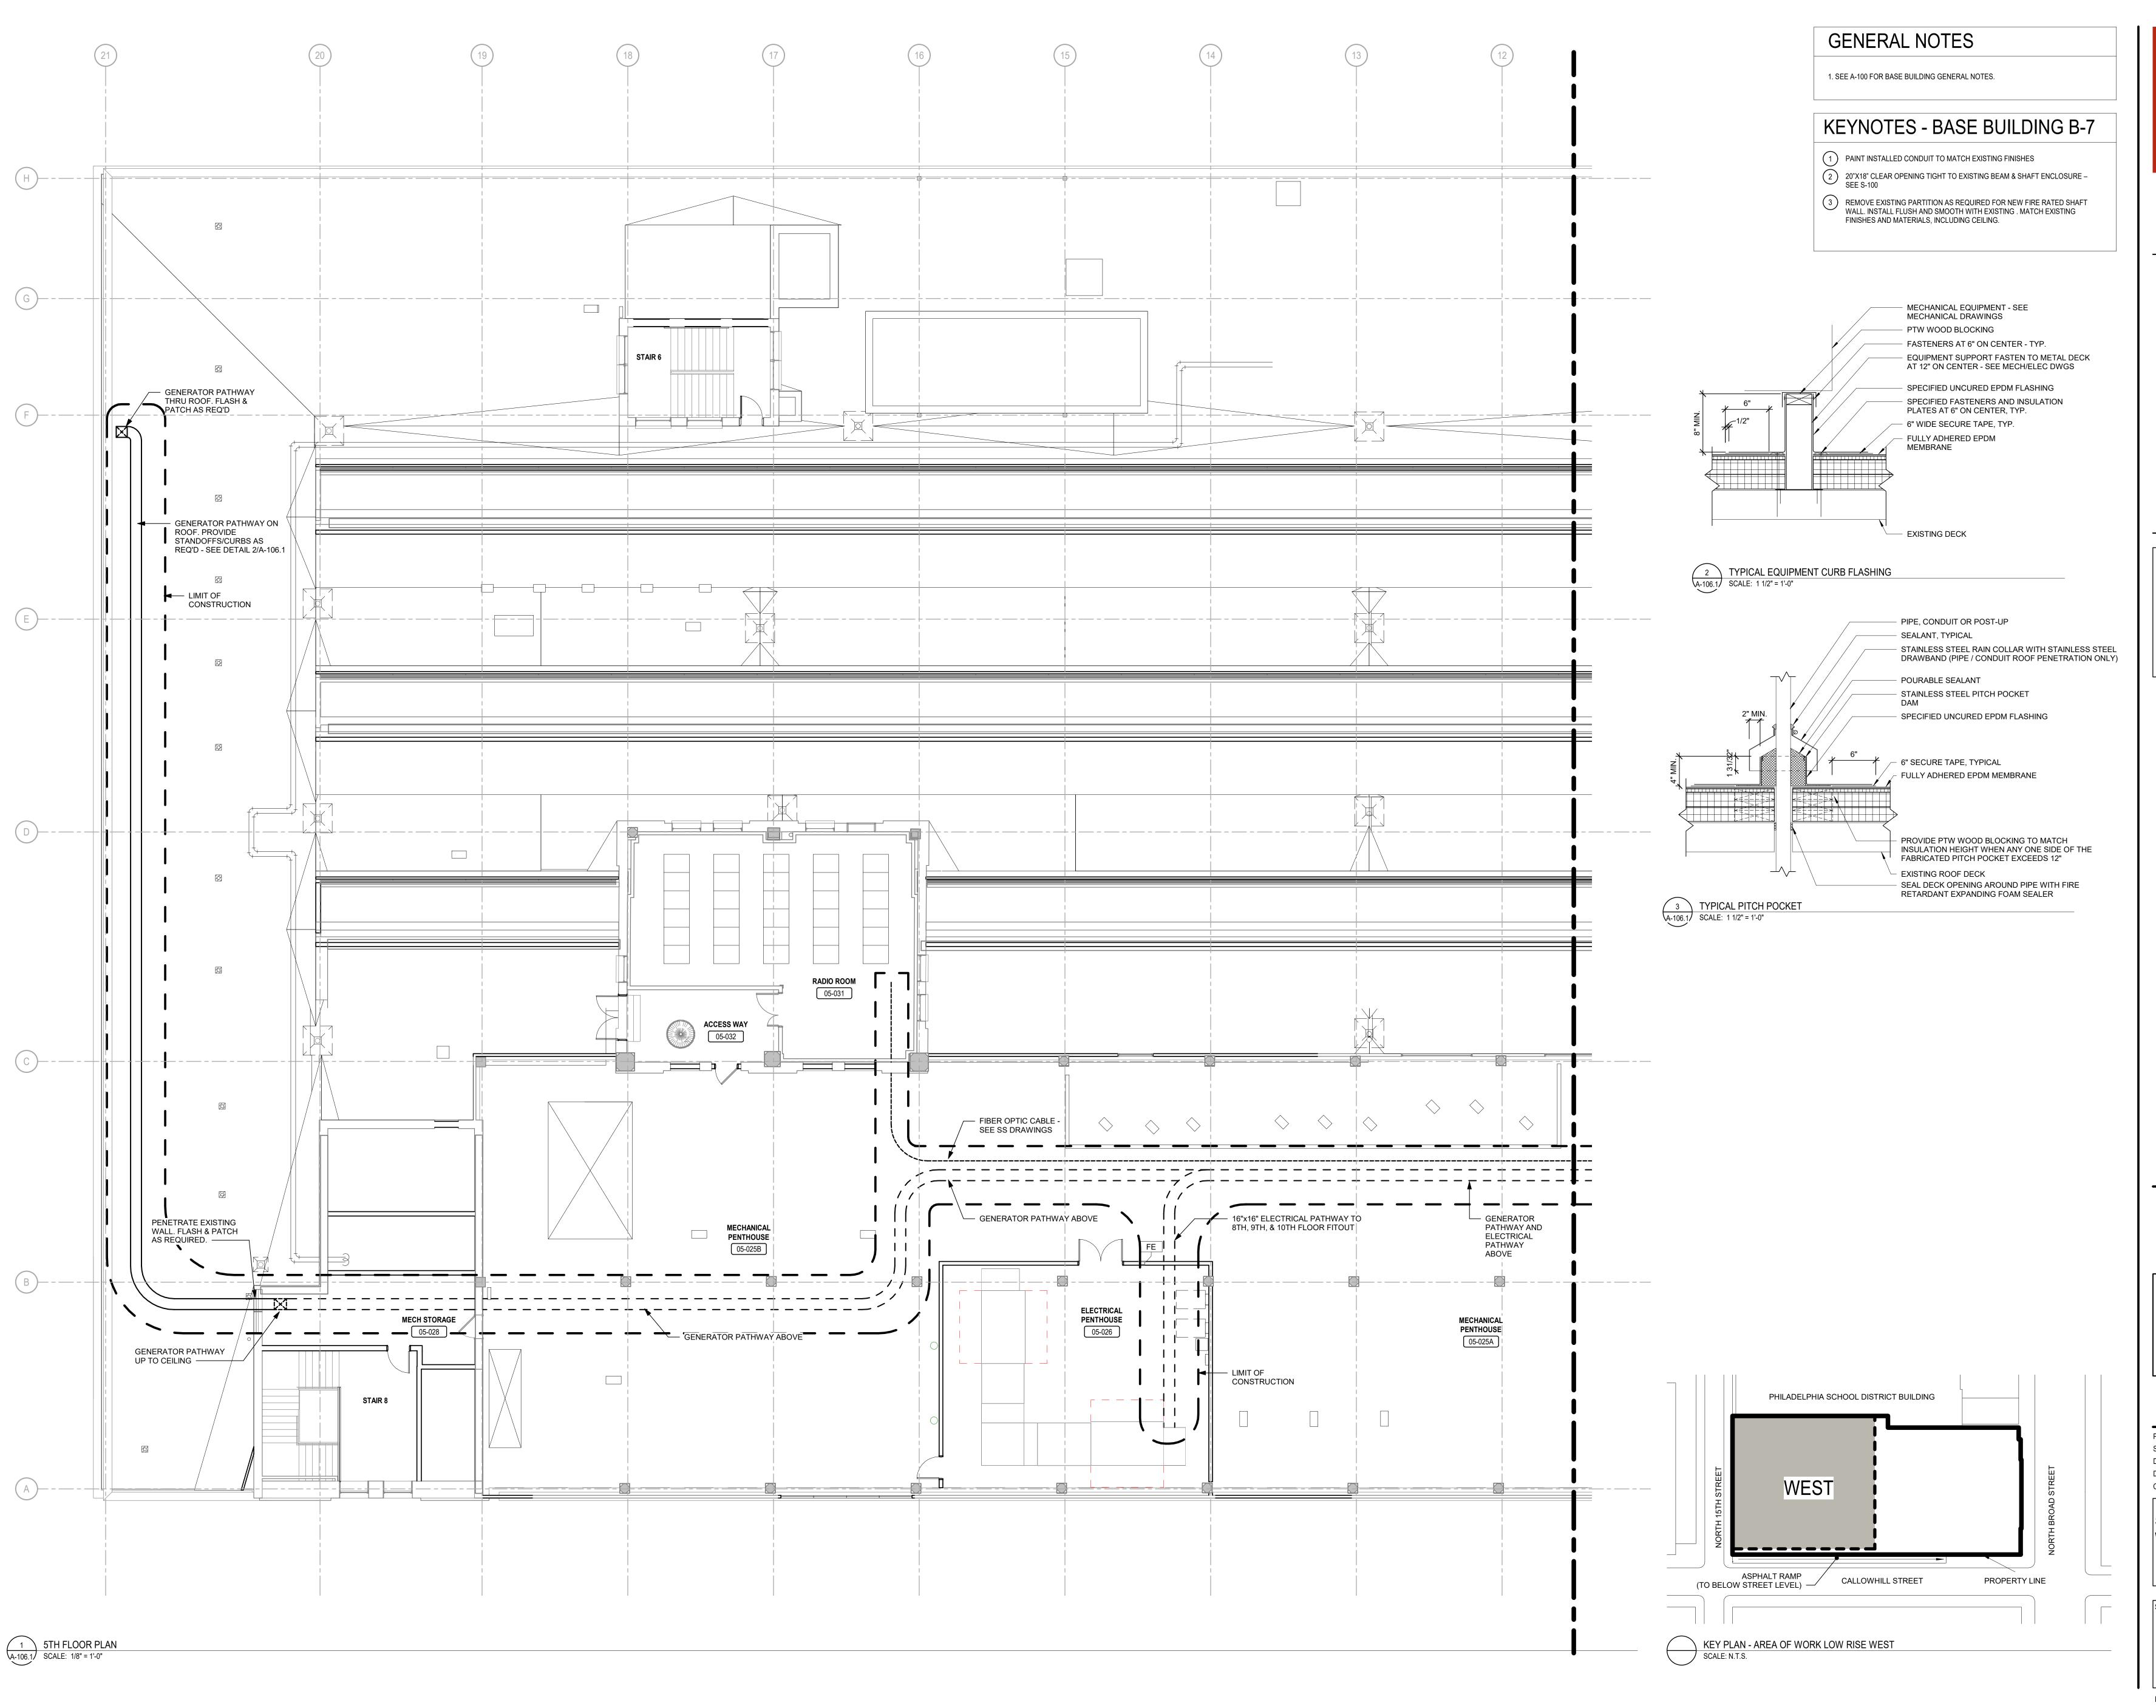



IEI GROUP, LTD.
IEI ARCHITECTS, INC.
428 North 2nd Street

Philadelphia, PA 19123

Telephone: 215.413.3700

CONSULTANTS:

ARORA

Arora Engineers, Inc.

61 Wilmington-West Chester Pike Chadds Ford, PA 19317 P (610) 459-7900 F (610) 459-7950 aroraengineers.com



O'Donnell & Naccarato
701 Market Street, Suite 6000
Philadelphia, PA 19106
PH: 215.925.3788
www.o-n.com

ENSE NO: <Architect's License #>

N PROFESSIONAL'S ELECTRONIC OR DIGITAL SEAL OR SIGNATURE IS TIVE ONLY AS TO THAT VERSION OF THIS DOCUMENT AS ORIGINALLY

LICENSE NO: <Architect's License #>

DESIGN PROFESSIONAL'S ELECTRONIC OR DIGITAL SEAL OR SIGNATURE IS EFFECTIVE ONLY AS TO THAT VERSION OF THIS DOCUMENT AS ORIGINALLY PUBLISHED BY DESIGN PROFESSIONAL. DESIGN PROFESSIONAL IS NOT RESPONSIBLE FOR ANY SUBSEQUENT MODIFICATION, CORRUPTION, OR UNAUTHORIZED USE OF SUCH DOCUMENT. TO VERIFY THE VALIDITY OR APPLICABILITY OF THE SEAL OR SIGNATURE, CONTACT DESIGN PROFESSIONAL.

TY OF PHILADELPHIA E OF EMERGENCY MANAGEMENT DELPHIA PUBLIC SERVICES BUILDING RTH BROAD STREET, PHILADELPHIA, PA 191 S 8, 9 AND 10

□ PROGRESS SET
□ CLIENT REVIEW
■ BID SET

■ BID SET□ CODE REVIEW SET□ ISSUED FOR CONSTRUCTION

ISSUED FOR BIDS 09/18/2020

(NOT FOR CONSTRUCTION)

ISSUES/REVISIONS:

1 9/18/2020 ISSUED FOR BIDS


PROJECT NUMBER: 304103-SCALE: As indica DATE: 09/18/20 DRAWN BY:

DRAWING TITLE:

5TH FLOOR PLAN WEST

A-106.1

PRINTED ON: 9/22/2020 3:01:26 PM

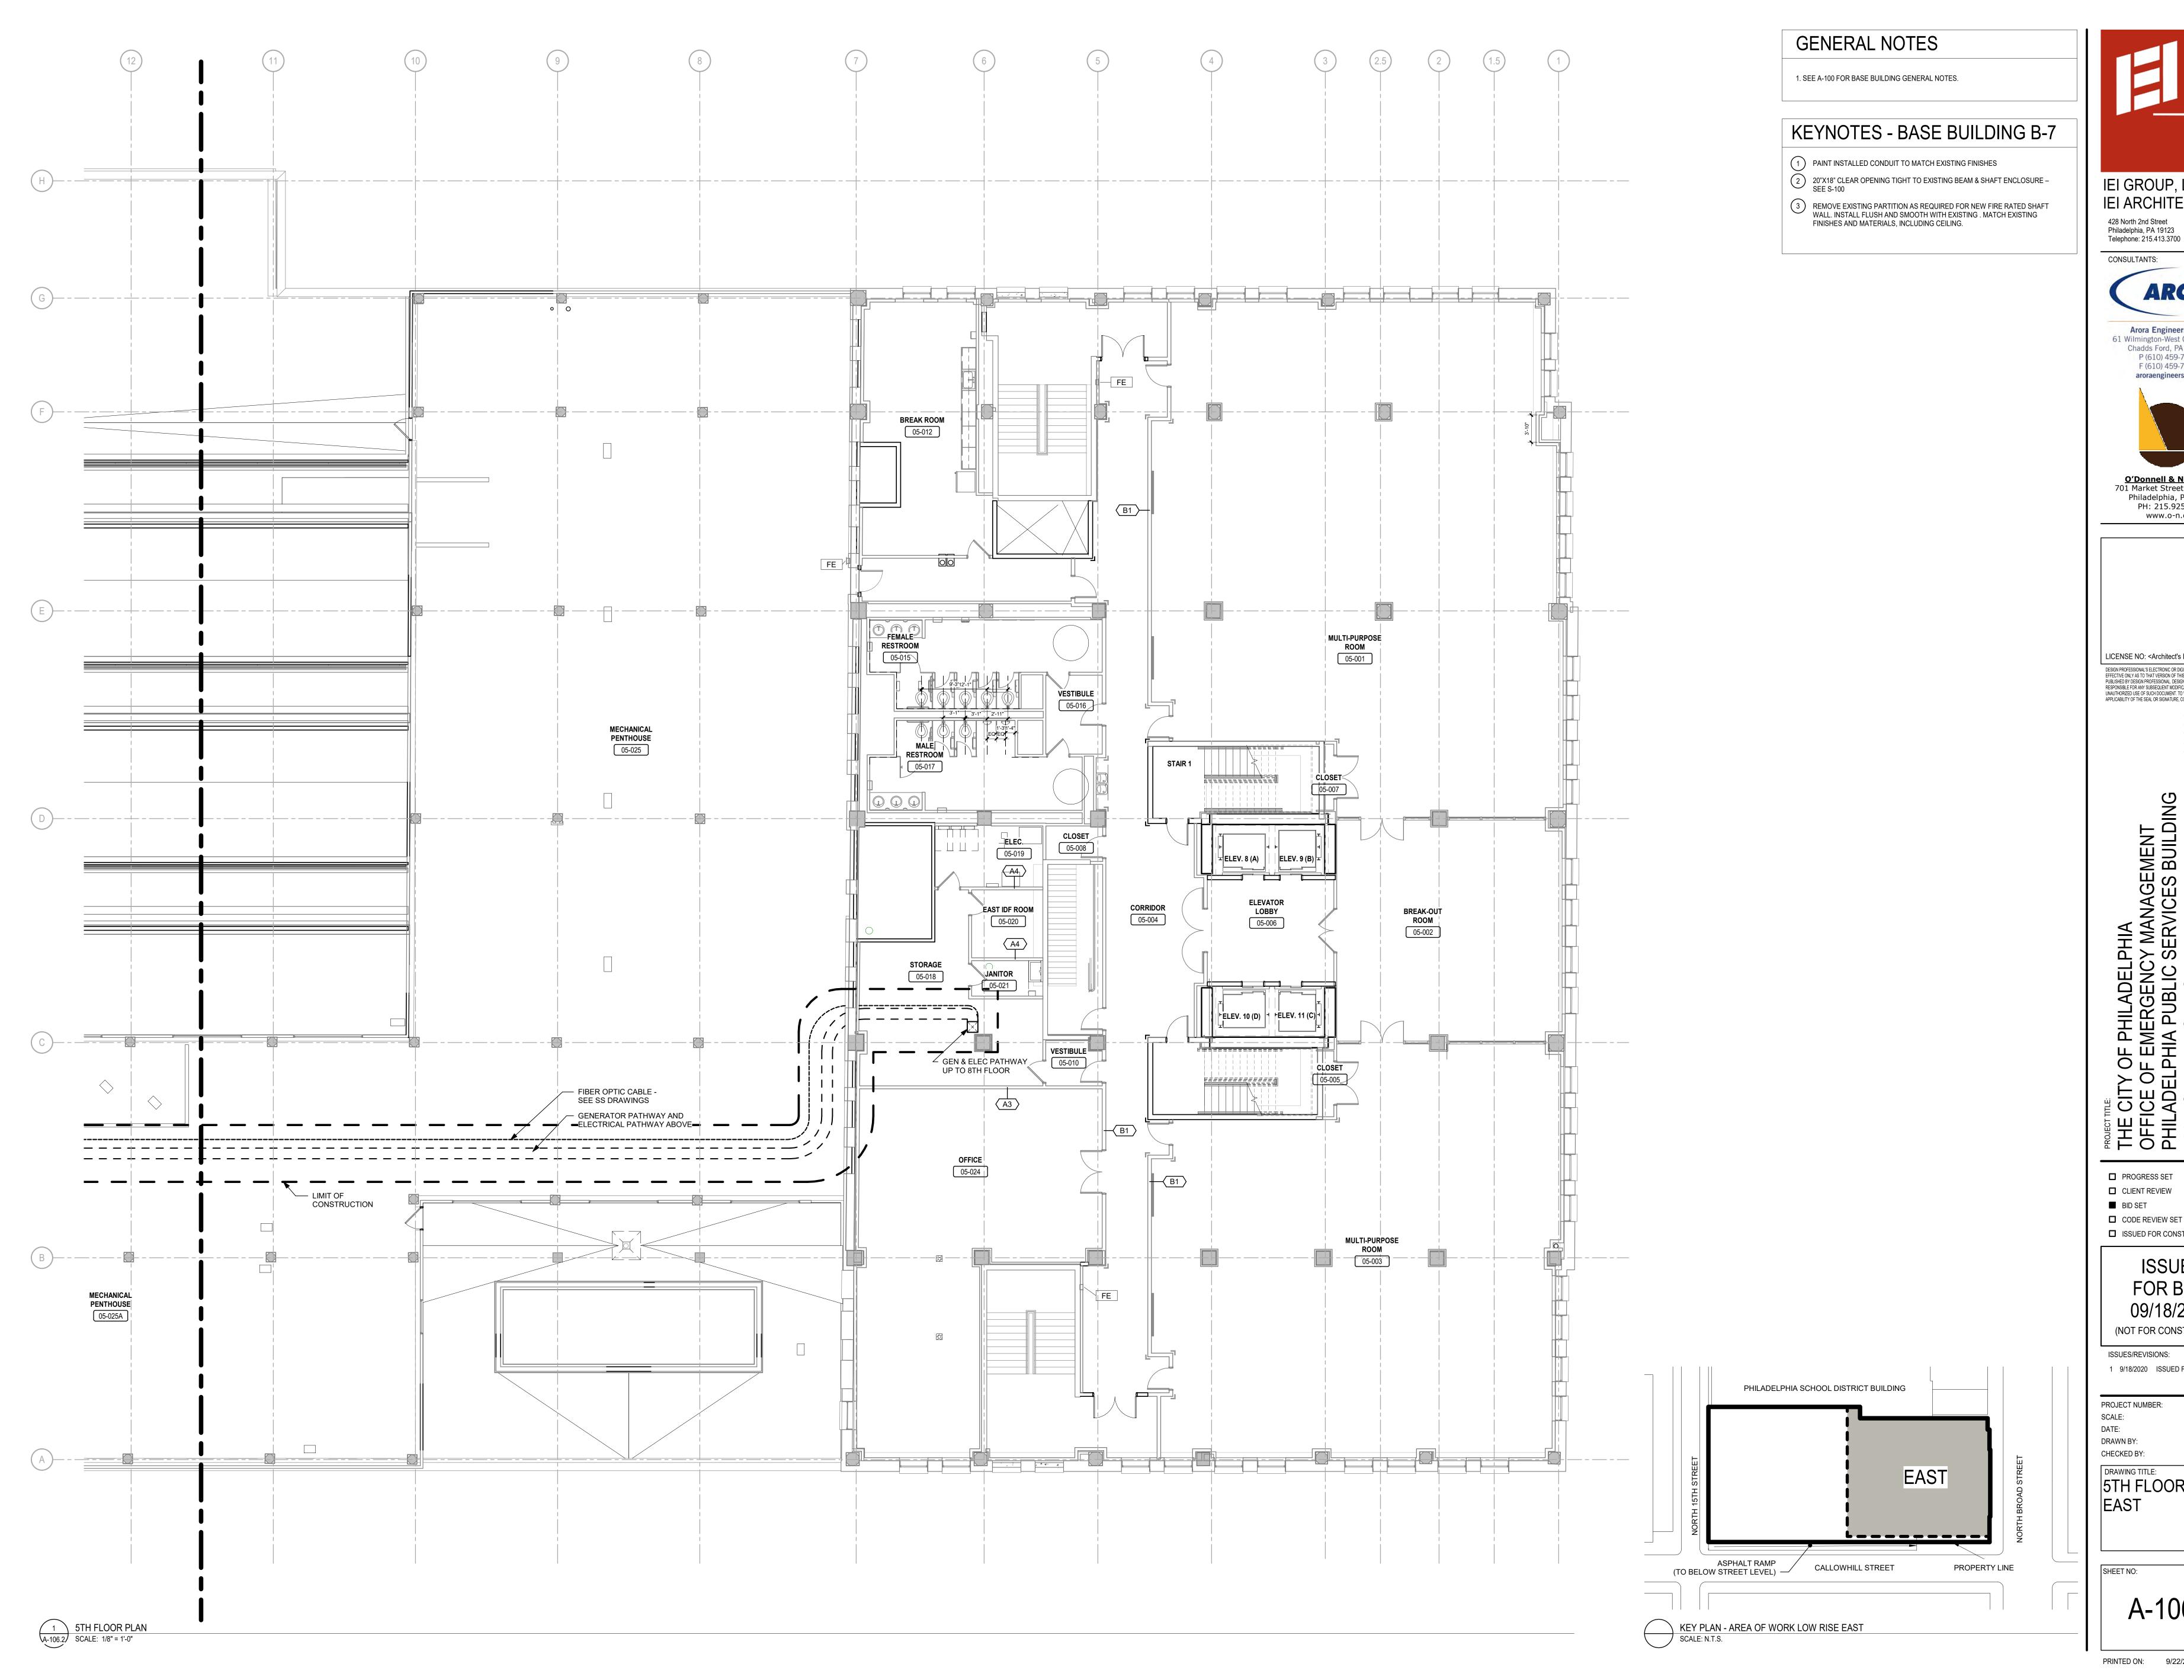

CONSULTANTS:

Arora Engineers, Inc. 61 Wilmington-West Chester Pike Chadds Ford, PA 19317 P (610) 459-7900 F (610) 459-7950

aroraengineers.com



O'Donnell & Naccarato 701 Market Street, Suite 6000 Philadelphia, PA 19106 PH: 215.925.3788 www.o-n.com

LICENSE NO: <Architect's License #> DESIGN PROFESSIONAL'S ELECTRONIC OR DIGITAL SEAL OR SIGNATURE IS EFFECTIVE ONLY AS TO THAT VERSION OF THIS DOCUMENT AS ORIGINALLY PUBLISHED BY DESIGN PROFESSIONAL. DESIGN PROFESSIONAL IS NOT RESPONSIBLE FOR ANY SUBSEQUENT MODIFICATION, CORRUPTION, OR UNAUTHORIZED USE OF SUCH DOCUMENT. TO VERIET THE VALIDITY OF ADDICATOR DESIGN PROFESSIONAL

■ PROGRESS SET □ CLIENT REVIEW

■ BID SET ■ CODE REVIEW SET ☐ ISSUED FOR CONSTRUCTION

> ISSUED FOR BIDS 09/18/2020

(NOT FOR CONSTRUCTION)

1 9/18/2020 ISSUED FOR BIDS PROJECT NUMBER:

DRAWING TITLE: 5TH FLOOR PLAN -


A-106.2


PRINTED ON: 9/22/2020 3:01:32 PM


1. SEE A-100 FOR BASE BUILDING GENERAL NOTES.

KEYNOTES - BASE BUILDING B-7

- 1 PAINT INSTALLED CONDUIT TO MATCH EXISTING FINISHES
- 2) 20"X18" CLEAR OPENING TIGHT TO EXISTING BEAM & SHAFT ENCLOSURE SEE S-100
- REMOVE EXISTING PARTITION AS REQUIRED FOR NEW FIRE RATED SHAFT WALL. INSTALL FLUSH AND SMOOTH WITH EXISTING . MATCH EXISTING FINISHES AND MATERIALS, INCLUDING CEILING.

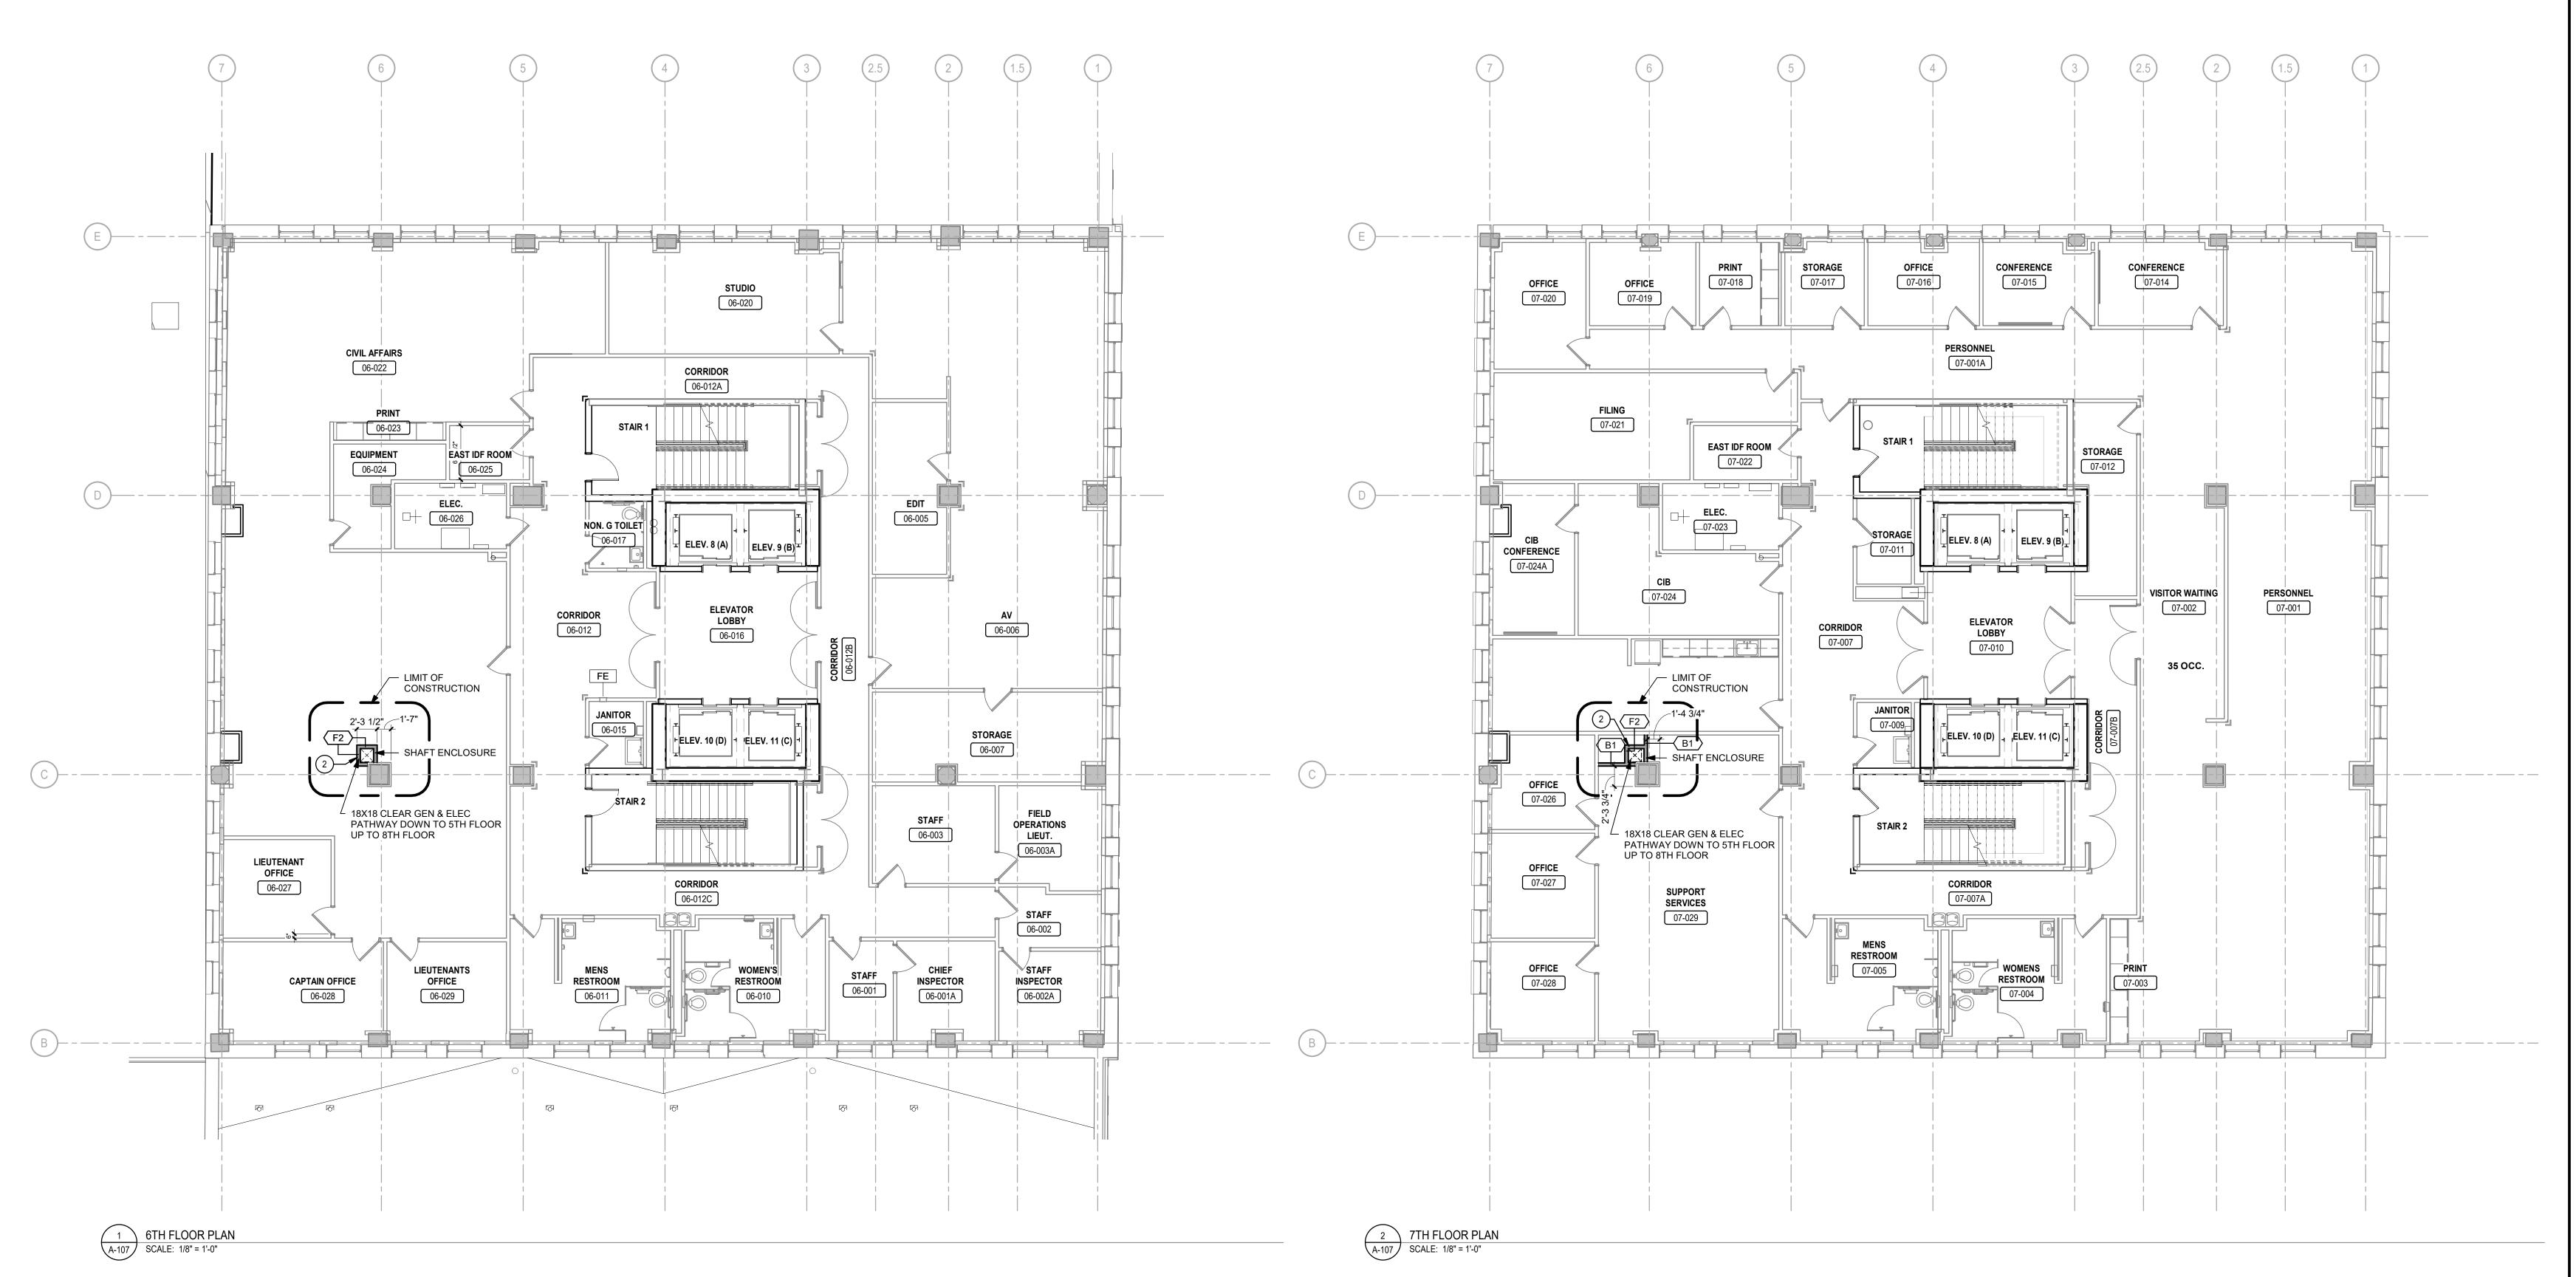

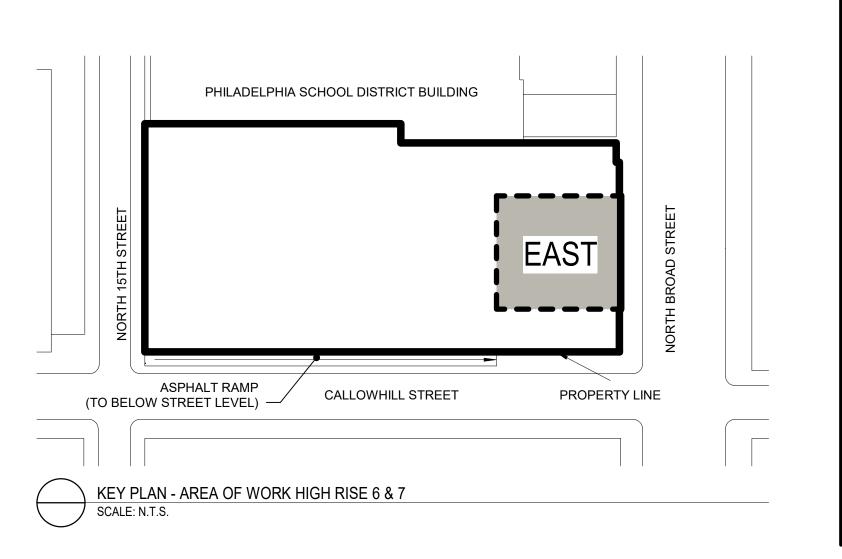

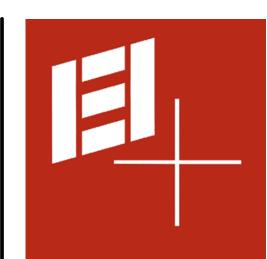

IEI GROUP, LTD.
IEI ARCHITECTS, INC.

428 North 2nd Street
Philadelphia, PA 19123
Telephone: 215.413.3700

CONSULTANTS:

ARORA®

Arora Engineers, Inc.
61 Wilmington-West Chester Pike
Chadds Ford, PA 19317
P (610) 459-7900
F (610) 459-7950



O'Donnell & Naccarato
701 Market Street, Suite 6000
Philadelphia, PA 19106
PH: 215.925.3788
www.o-n.com

ENSE NO: <Architect's License #>

LICENSE NO: <Architect's License #>

DESIGN PROFESSIONAL'S ELECTRONIC OR DIGITAL SEAL OR SIGNATURE IS EFFECTIVE ONLY AS TO THAT VERSION OF THIS DOCUMENT AS ORIGINALLY PUBLISHED BY DESIGN PROFESSIONAL. DESIGN PROFESSIONAL IS NOT RESPONSIBLE FOR ANY SUBSEQUENT MODIFICATION, CORRUPTION, OR UNAUTHORIZED USE OF SUCH DOCUMENT. TO VERIFY THE VALIDITY OR APPLICABILITY OF THE SEAL OR SIGNATURE, CONTACT DESIGN PROFESSIONAL

PHILADELPHIA MERGENCY MANAGEMENT IIA PUBLIC SERVICES BUILDING SROAD STREET, PHILADELPHIA, PA 1913 AND 10

□ PROGRESS SET
□ CLIENT REVIEW

■ BID SET
□ CODE REVIEW SET
□ ISSUED FOR CONSTRUCTION

ISSUED

FOR BIDS 09/18/2020 (NOT FOR CONSTRUCTION)

ISSUES/REVISIONS:
1 9/18/2020 ISSUED FOR BIDS

PROJECT NUMBER: 304103-120
SCALE: As indicated
DATE: 09/18/2020
DRAWN BY: SM
CHECKED BY: PT


DRAWING TITLE:

6TH & 7TH FLOOR
PLAN

HEET NO:

A-107

PRINTED ON: 9/22/2020 12:50:18 PM

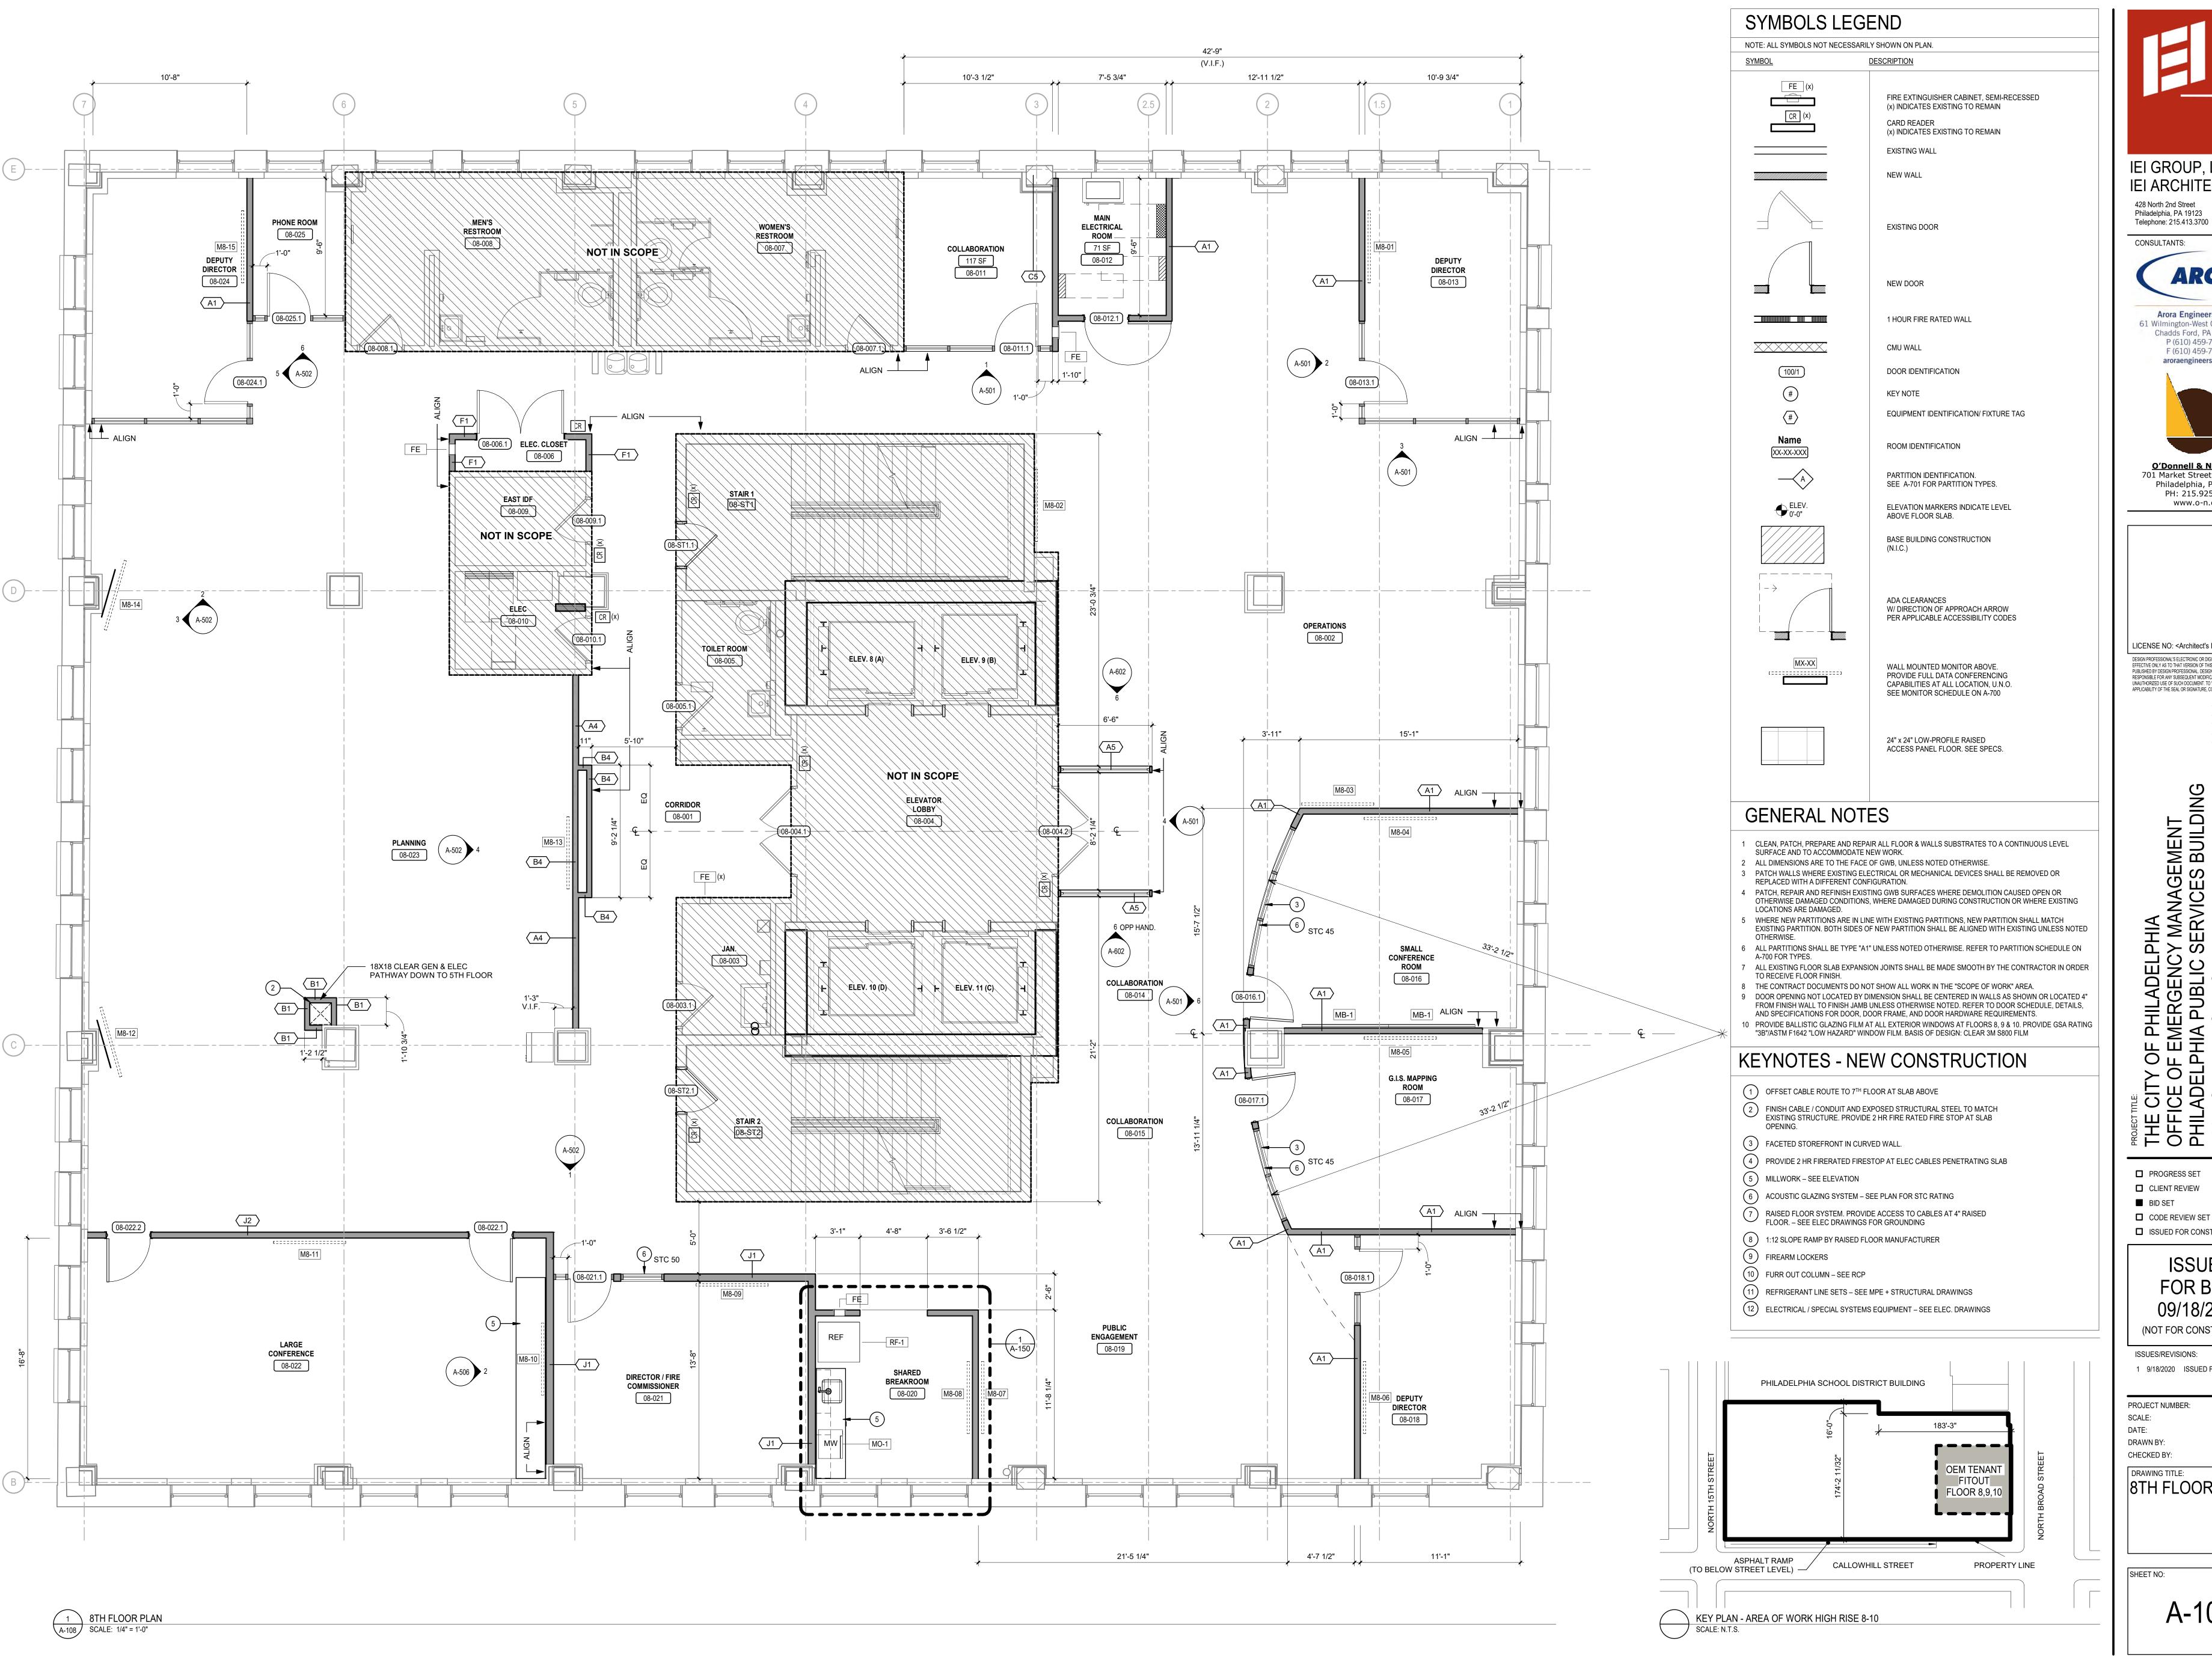



CONSULTANTS:

Arora Engineers, Inc. 61 Wilmington-West Chester Pike Chadds Ford, PA 19317 P (610) 459-7900

F (610) 459-7950



O'Donnell & Naccarato 701 Market Street, Suite 6000 Philadelphia, PA 19106 PH: 215.925.3788 www.o-n.com

LICENSE NO: <Architect's License #> EFFECTIVE ONLY AS TO THAT VERSION OF THIS DOCUMENT AS ORIGINALLY PUBLISHED BY DESIGN PROFESSIONAL. DESIGN PROFESSIONAL IS NOT RESPONSIBLE FOR ANY SUBSEQUENT MODIFICATION, CORRUPTION, OF

CY MANAGEMENT S SERVICES BUILDING REET, PHILADELPHIA,

PROGRESS SET

CLIENT REVIEW BID SET

CODE REVIEW SET ■ ISSUED FOR CONSTRUCTION

> **ISSUED** FOR BIDS 09/18/2020

(NOT FOR CONSTRUCTION) ISSUES/REVISIONS:

1 9/18/2020 ISSUED FOR BIDS

PROJECT NUMBER: SCALE: As indicated DATE: DRAWN BY: CHECKED BY:

DRAWING TITLE:

8TH FLOOR PLAN

SHEET NO:

A-108

PRINTED ON: 9/22/2020 12:50:24 PM

GENERAL NOTES

1. SEE A-108 FOR SYMBOLS LEGEND & GENERAL NOTES.

KEYNOTES - NEW CONSTRUCTION

- 1) OFFSET CABLE ROUTE TO 7TH FLOOR AT SLAB ABOVE
- 2 FINISH CABLE / CONDUIT AND EXPOSED STRUCTURAL STEEL TO MATCH EXISTING STRUCTURE. PROVIDE 2 HR FIRE RATED FIRE STOP AT SLAB
- (3) FACETED STOREFRONT IN CURVED WALL.
- (4) PROVIDE 2 HR FIRERATED FIRESTOP AT ELEC CABLES PENETRATING SLAB
- (5) MILLWORK SEE ELEVATION
- (6) ACOUSTIC GLAZING SYSTEM SEE PLAN FOR STC RATING
- 7 RAISED FLOOR SYSTEM. PROVIDE ACCESS TO CABLES AT 4" RAISED FLOOR. SEE ELEC DRAWINGS FOR GROUNDING
- 8 1:12 SLOPE RAMP BY RAISED FLOOR MANUFACTURER
- (9) FIREARM LOCKERS
- (10) FURR OUT COLUMN SEE RCP
- (11) REFRIGERANT LINE SETS SEE MPE + STRUCTURAL DRAWINGS

PHILADELPHIA SCHOOL DISTRICT BUILDING

CALLOWHILL STREET


OEM TENANT FITOUT

FLOOR 8,9,10

L - - - -

PROPERTY LINE

(12) ELECTRICAL / SPECIAL SYSTEMS EQUIPMENT – SEE ELEC. DRAWINGS

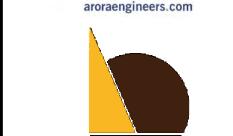

IEI GROUP, LTD.

428 North 2nd Street

CONSULTANTS:

Philadelphia, PA 19123

Telephone: 215.413.3700

IEI ARCHITECTS, INC.

ARORA°

Arora Engineers, Inc.

61 Wilmington-West Chester Pike Chadds Ford, PA 19317

P (610) 459-7900

F (610) 459-7950

O'Donnell & Naccarato 701 Market Street, Suite 6000 Philadelphia, PA 19106 PH: 215.925.3788 www.o-n.com

LICENSE NO: <Architect's License #>

DESIGN FROPESSIONAL SELECTIONIC OF DISTRICT AND STORMATIONS EFFECTIVE ONLY AS TO THAT VERSION OF THIS DOCUMENT AS ORIGINALLY PUBLISHED BY DESIGN PROFESSIONAL. DESIGN PROFESSIONAL IS NOT RESPONSIBLE FOR ANY SUBSEQUENT MODIFICATION, CORRUPTION, OR UNAUTHORIZED USE OF SUCH DOCUMENT. TO VERIFY THE VALIDITY OR

PROGRESS SET CLIENT REVIEW

■ BID SET ■ CODE REVIEW SET

■ ISSUED FOR CONSTRUCTION

ISSUED FOR BIDS 09/18/2020

(NOT FOR CONSTRUCTION) ISSUES/REVISIONS:

1 9/18/2020 ISSUED FOR BIDS

PROJECT NUMBER: DATE: DRAWN BY: CHECKED BY:

DRAWING TITLE: 9TH FLOOR PLAN

As indicated

A-109


PRINTED ON: 9/22/2020 12:50:30 PM

IEI GROUP, LTD. IEI ARCHITECTS, INC. 428 North 2nd Street

Philadelphia, PA 19123 Telephone: 215.413.3700 CONSULTANTS:

ARORA°

Arora Engineers, Inc. 61 Wilmington-West Chester Pike Chadds Ford, PA 19317 P (610) 459-7900 F (610) 459-7950 aroraengineers.com

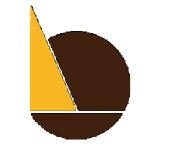

O'Donnell & Naccarato
701 Market Street, Suite 6000 Philadelphia, PA 19106 PH: 215.925.3788 www.o-n.com

LICENSE NO: <Architect's License #> DESIGN FROPESSIONAL SELECTIONIC OF DISTRICT AND STORMATIONS EFFECTIVE ONLY AS TO THAT VERSION OF THIS DOCUMENT AS ORIGINALLY PUBLISHED BY DESIGN PROFESSIONAL. DESIGN PROFESSIONAL IS NOT RESPONSIBLE FOR ANY SUBSEQUENT MODIFICATION, CORRUPTION, OR UNAUTHORIZED USE OF SUCH DOCUMENT. TO VERIFY THE VALIDITY OR

PROGRESS SET CLIENT REVIEW

■ BID SET

■ CODE REVIEW SET ☐ ISSUED FOR CONSTRUCTION

> **ISSUED** FOR BIDS 09/18/2020

(NOT FOR CONSTRUCTION) ISSUES/REVISIONS:

1 9/18/2020 ISSUED FOR BIDS

PROJECT NUMBER: DATE: DRAWN BY: CHECKED BY:


DRAWING TITLE:

10TH FLOOR PLAN

SHEET NO:

A-110

PRINTED ON: 9/22/2020 12:50:36 PM

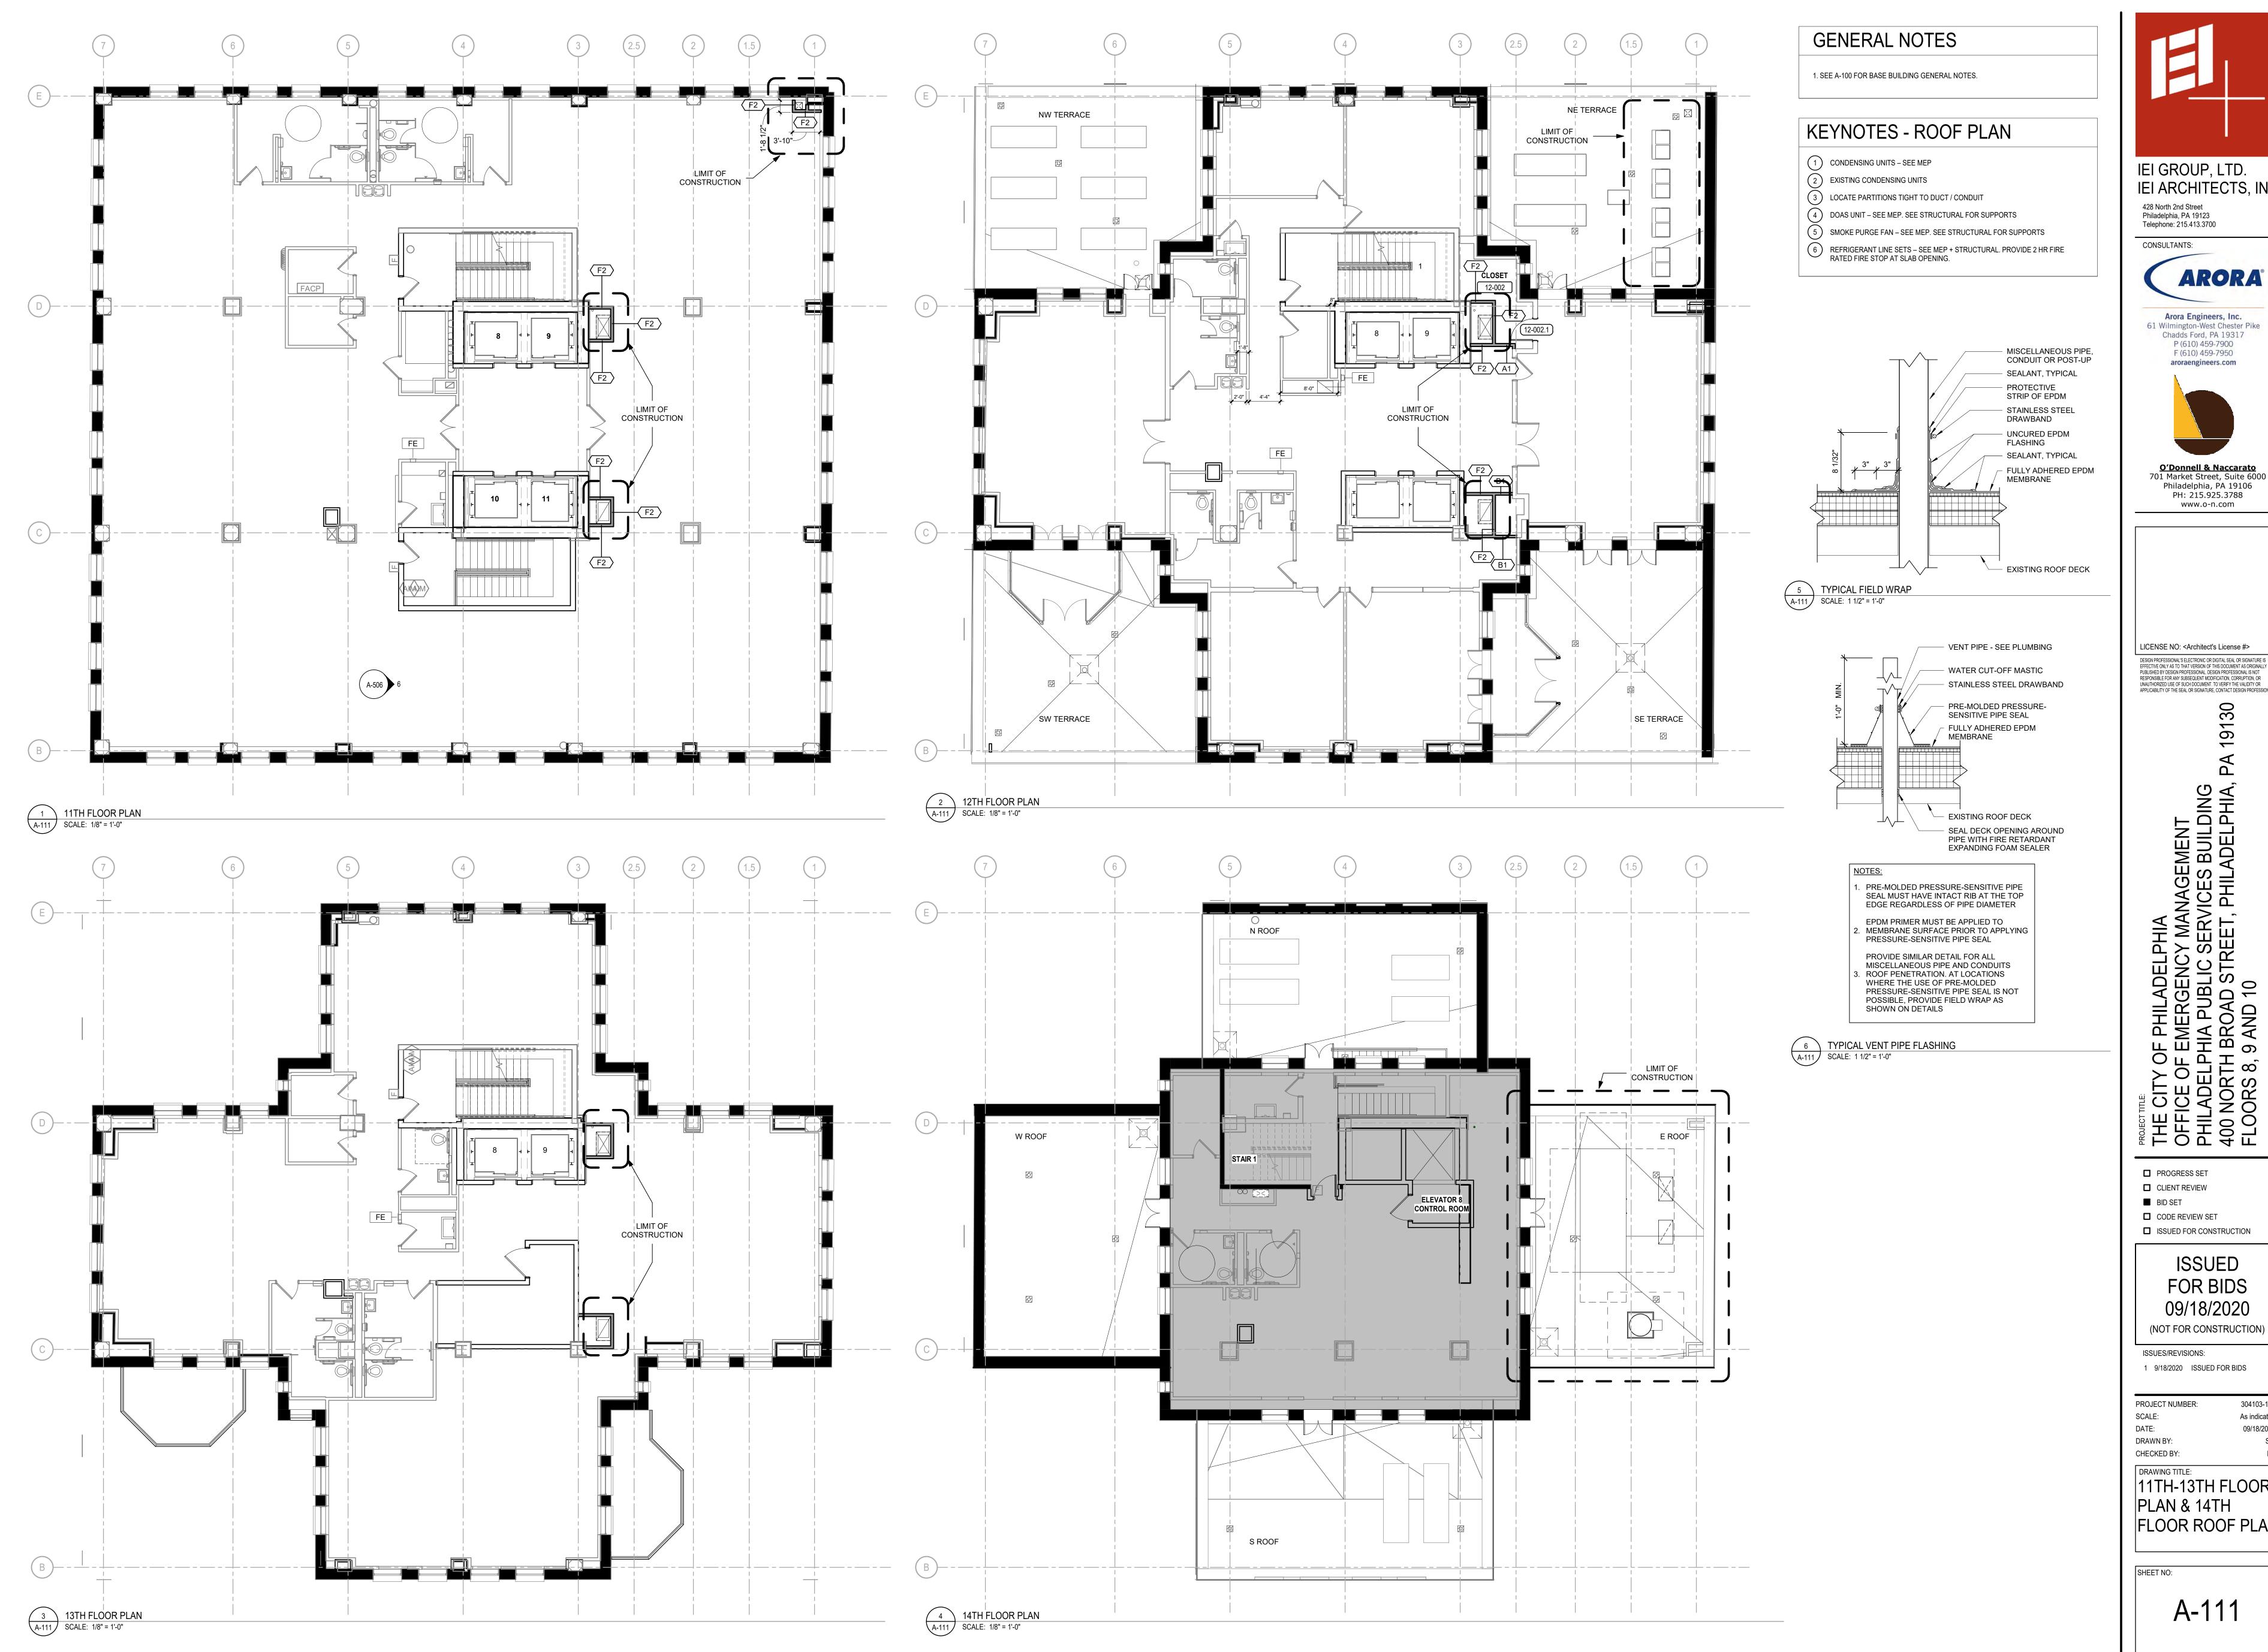



IEI GROUP, LTD. IEI ARCHITECTS, INC. 428 North 2nd Street

CONSULTANTS: **ARORA**°

Arora Engineers, Inc. 61 Wilmington-West Chester Pike Chadds Ford, PA 19317 P (610) 459-7900 F (610) 459-7950 aroraengineers.com



<u>O'Donnell & Naccarato</u> 701 Market Street, Suite 6000 Philadelphia, PA 19106 PH: 215.925.3788 www.o-n.com

LICENSE NO: <Architect's License #> DESIGN FROPESSIONAL SELECTIONIC OF DISTRICT AND STORMATIONS EFFECTIVE ONLY AS TO THAT VERSION OF THIS DOCUMENT AS ORIGINALLY PUBLISHED BY DESIGN PROFESSIONAL. DESIGN PROFESSIONAL IS NOT RESPONSIBLE FOR ANY SUBSEQUENT MODIFICATION, CORRUPTION, OR UNAUTHORIZED USE OF SUCH DOCUMENT. TO VERIFY THE VALIDITY OR APPLICABILITY OF THE SEAL OR SIGNATURE, CONTACT DESIGN PROFESSIONAL

PROGRESS SET CLIENT REVIEW

■ BID SET CODE REVIEW SET ■ ISSUED FOR CONSTRUCTION

> ISSUED FOR BIDS 09/18/2020


ISSUES/REVISIONS:

1 9/18/2020 ISSUED FOR BIDS

PROJECT NUMBER: DRAWN BY:

DRAWING TITLE: 11TH-13TH FLOOR PLAN & 14TH FLOOR ROOF PLAN

PRINTED ON: 9/22/2020 3:12:20 PM

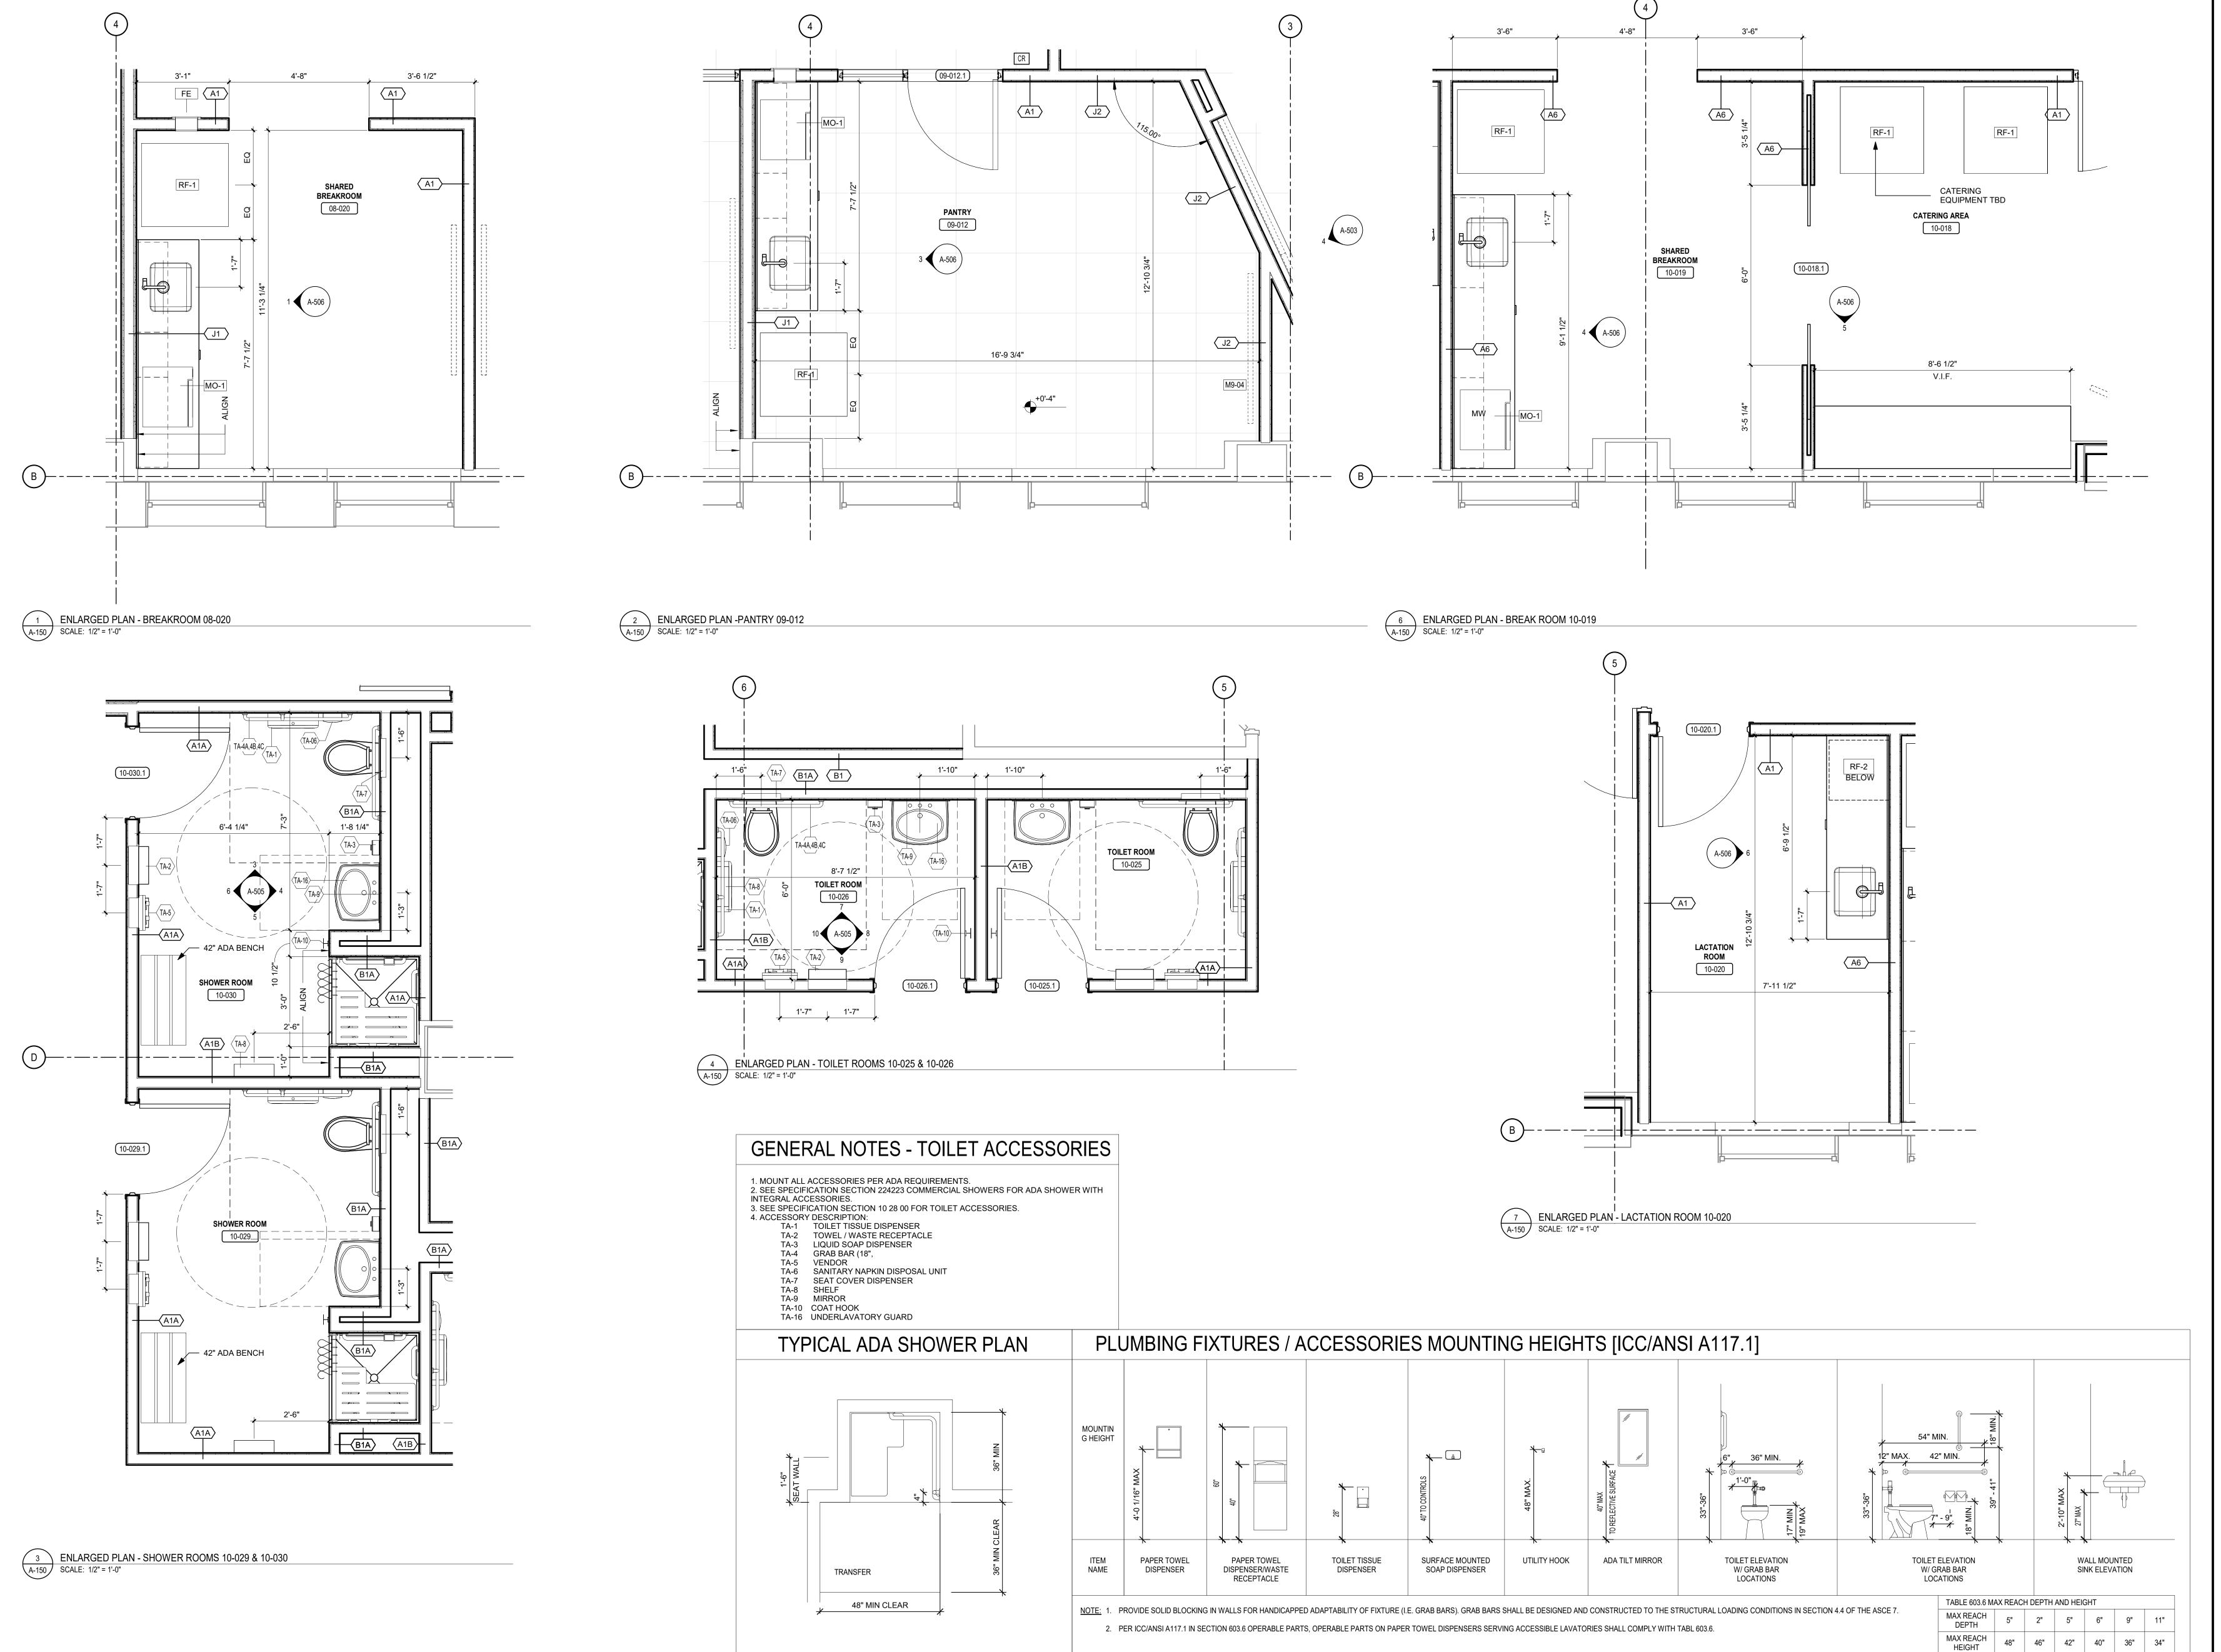

Telephone: 215.413.3700

CONSULTANTS:

Arora Engineers, Inc. 61 Wilmington-West Chester Pike Chadds Ford, PA 19317 P (610) 459-7900

F (610) 459-7950



<u>O'Donnell & Naccarato</u> 701 Market Street, Suite 6000 Philadelphia, PA 19106 PH: 215.925.3788 www.o-n.com

LICENSE NO: <Architect's License #> DESIGN FROPESSIONAL SELECTIONIC OF DISTRICT AND STORMATIONS EFFECTIVE ONLY AS TO THAT VERSION OF THIS DOCUMENT AS ORIGINALLY PUBLISHED BY DESIGN PROFESSIONAL. DESIGN PROFESSIONAL IS NOT RESPONSIBLE FOR ANY SUBSEQUENT MODIFICATION, CORRUPTION, OR UNAUTHORIZED USE OF SUCH DOCUMENT. TO VERIFY THE VALIDITY OR

PROGRESS SET CLIENT REVIEW

CODE REVIEW SET ■ ISSUED FOR CONSTRUCTION

> ISSUED FOR BIDS 09/18/2020


(NOT FOR CONSTRUCTION) ISSUES/REVISIONS: 1 9/18/2020 ISSUED FOR BIDS


PROJECT NUMBER: As indicated DATE: DRAWN BY: CHECKED BY:

DRAWING TITLE: ENLARGED PLANS

SHEET NO:

PRINTED ON: 9/22/2020 12:50:53 PM

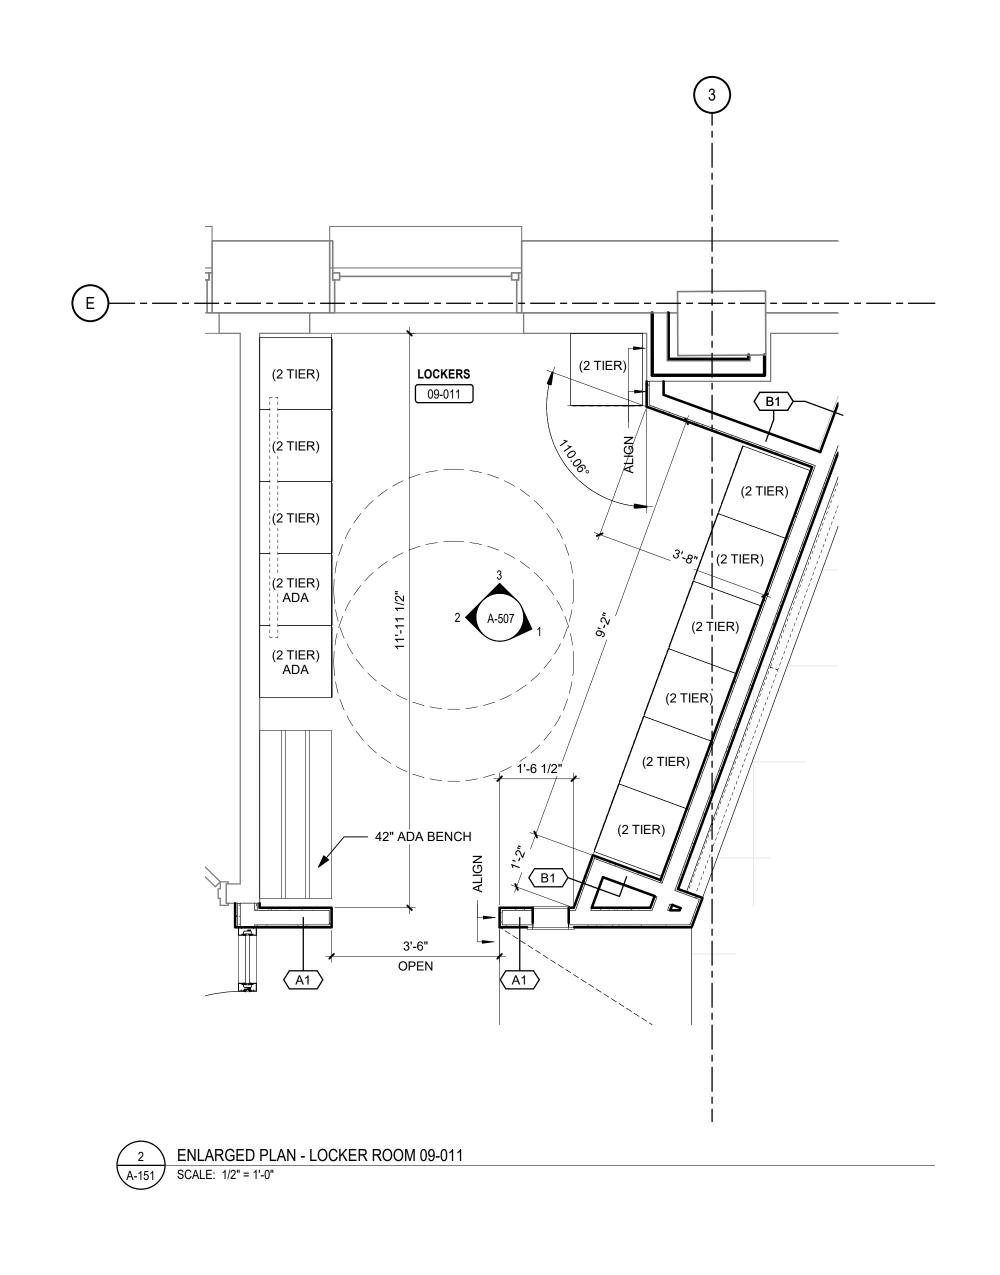

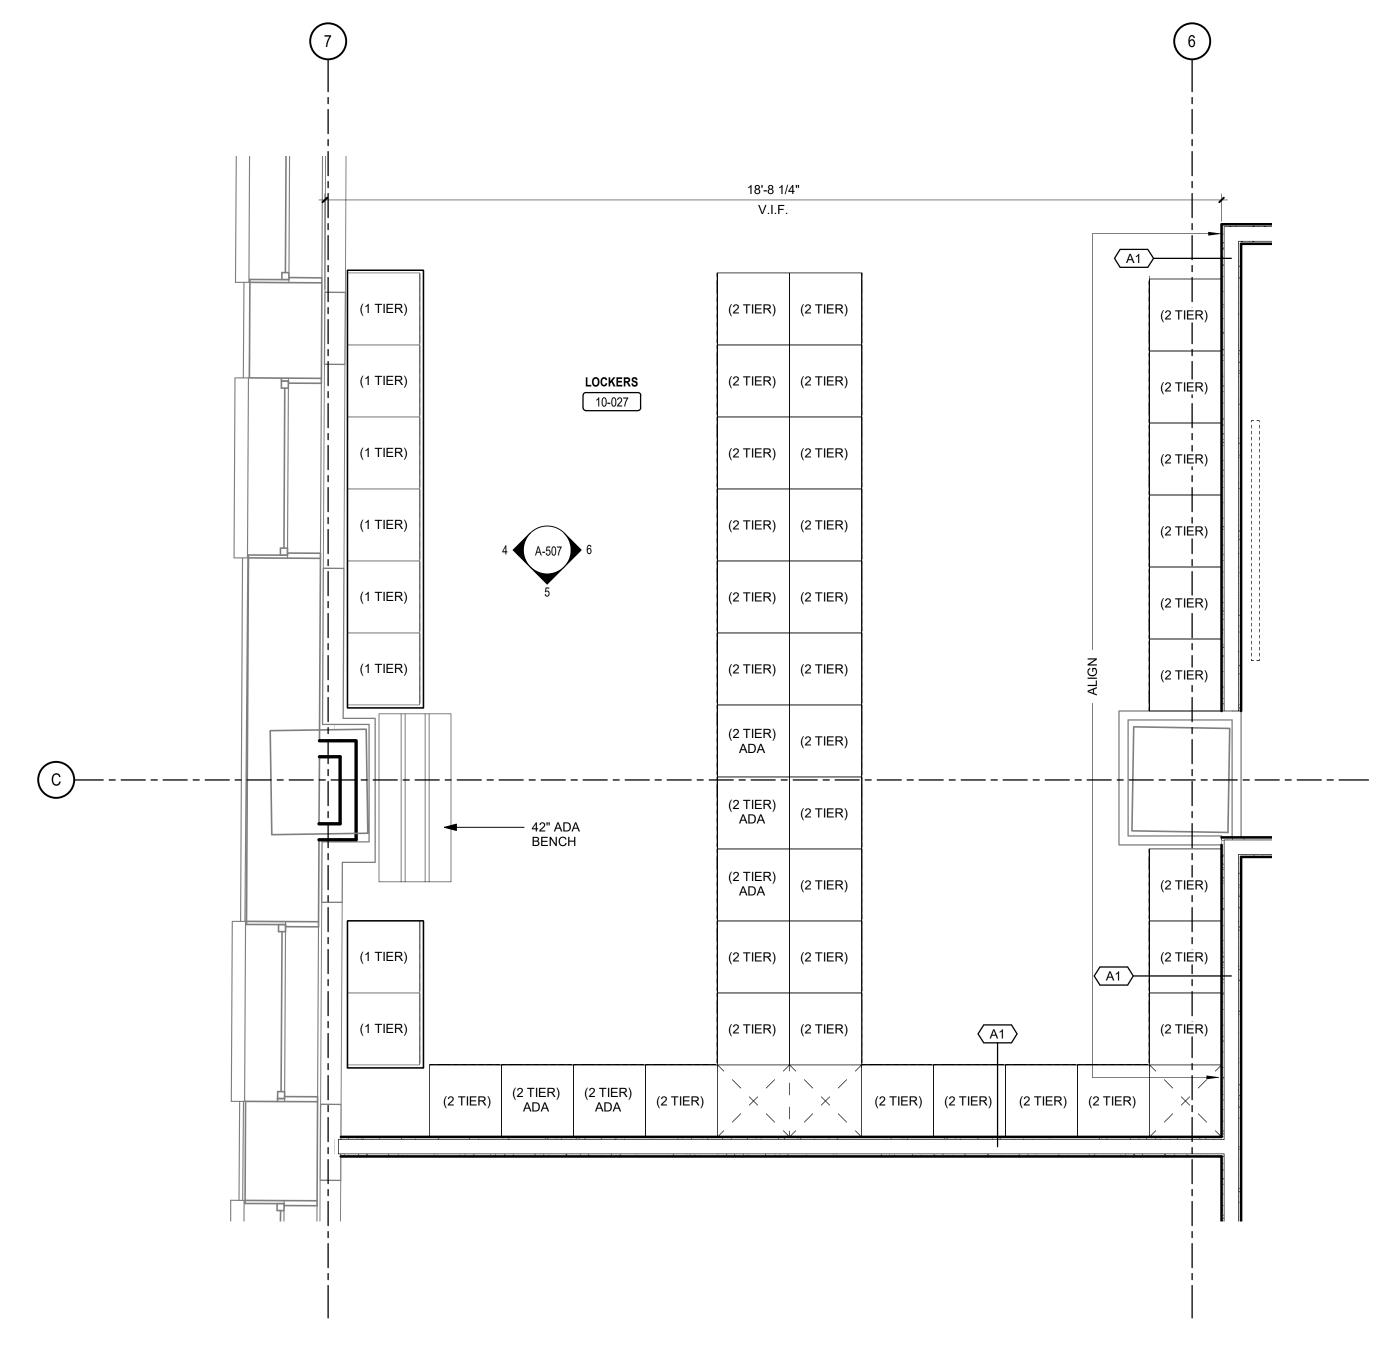

1 ENLARGED PLAN - LOCKER ROOM 10-027

SCALE: 1/2" = 1'-0"




IEI GROUP, LTD.
IEI ARCHITECTS, INC.

428 North 2nd Street
Philadelphia, PA 19123
Telephone: 215.413.3700

CONSULTANTS:

Arora Engineers, Inc.
61 Wilmington-West Chester Pike
Chadds Ford, PA 19317

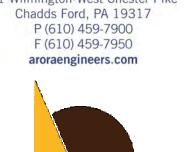

O'Donnell & Naccarato
701 Market Street, Suite 6000
Philadelphia, PA 19106
PH: 215.925.3788
www.o-n.com

LICENSE NO: <Architect's License #>

DESIGN PROFESSIONAL'S ELECTRONIC OR DIGITAL SEAL OR SIGNATURE IS

FEFFORT FOR THE PROFESSIONAL SEAL OR SIGNATURE IS

DESIGN PROFESSIONAL'S ELECTRONIC OR DIGITAL SEAL OR SIGNATURE IS EFFECTIVE ONLY AS TO THAT VERSION OF THIS DOCUMENT AS ORIGINALLY PUBLISHED BY DESIGN PROFESSIONAL DESIGN PROFESSIONAL IS NOT RESPONSIBLE FOR ANY SUBSEQUENT MODIFICATION, CORRUPTION, OR UNAUTHORIZED USE OF SUCH DOCUMENT. TO VERIFY THE VALIDITY OR APPLICABILITY OF THE SEAL OR SIGNATURE, CONTACT DESIGN PROFESSIONAL.

THE CITY OF PHILADELPHIA

OFFICE OF EMERGENCY MANAGEMENT

PHILADELPHIA PUBLIC SERVICES BUILDING

400 NORTH BROAD STREET, PHILADELPHIA, PA
FLOORS 8, 9 AND 10

□ PROGRESS SET
□ CLIENT REVIEW

☐ CLIENT RE
■ BID SET

□ CODE REVIEW SET□ ISSUED FOR CONSTRUCTION

ISSUED FOR BIDS 09/18/2020

(NOT FOR CONSTRUCTION)

ISSUES/REVISIONS:

1 9/18/2020 ISSUED FOR BIDS

PROJECT NUMBER: 304103-120

SCALE: 1/2" = 1'-0"

DATE: 09/18/2020

DRAWN BY: SM

CHECKED BY: PT

DRAWING TITLE:
ENLARGED
LOCKER ROOM
PLANS

A-151

PRINTED ON: 9/22/2020 12:50:58 PM

SYMBOLS LEGEND - RCP

NOTE: ALL SYMBOLS NOT NECESSARILY SHOWN ON PLAN. DESCRIPTION XXX-# 1' - 0" CEILING HEIGHT TAG

CEILING FINISH KEY. SEE FINISH SCHEDULE NEW ACOUSTICAL CEILING TILE & GRID

NEW GWB & SOFFIT

24" x 24" RECESSED TROFFER LIGHT FIXTURE 24" x 48" RECESSED TROFFER LIGHT FIXTURE

RECESSED DOWN LIGHT FIXTURE

LED EXIT SIGN (WALL/CEILING)

SPRINKLER HEAD 24" x 24" RECESSED CEILING HVAC SUPPLY DIFFUSER

24" x 24" RECESSED CEILING HVAC RETURN DIFFUSER

LINEAR RECESSED CEILING DIFFUSER

THERMOSTAT

RWS-2 BLACKOUT SHADES - SEE SPEC

GENERAL NOTES - RCP

- 1 ALL NEW CEILING HEIGHT TO BE (8'-6"), UNLESS OTHERWISE NOTED. 2 ALL WALL MOUNTED DEVICES (IE: THERMOSTATS, LIGHT SWITCHES, ELEC OUTLETS, ETC.) TO BE ALIGNED VERTICALLY ON BOTTOM EDGE AND
- HORIZONTALLY ON CENTER.; GANGED IN ONE PLATE.
- ALL LIGHT FIXTURES SHALL BE NEW AND PROVIDED & INSTALLED BY ELECTRICAL CONTRACTOR. UNLESS OTHERWISE NOTED. 4 ALL EXISTING, NEW AND REUSED LIGHT FIXTURES, CEILING TILE, CEILING
- STAINED AND/OR DENTED SHALL BE REPLACED BY NEW ONES. 5 ALL DOWN LIGHTS FIXTURES WITHIN A 2'x2' OR 2'x4' CEILING TILE SHALL BE CENTERED WITHIN SUCH TILE; UNLESS OTHERWISE NOTED. 6 ALL NEW AND RELOCATED SPRINKLER HEADS WITHIN A 2'x2' OR 2'x4' CEILING TILE SHALL BE CENTERED WITHIN SUCH TILE; UNLESS OTHERWISE
- 7 ALL EXISTING & REUSED LIGHT FIXTURES WITHIN AREA OF WORK SHALL BE RELAMPED. ALL LAMPS SHALL BE NEW.

GRID. REGISTERS, GRILLES & DIFFUSERS THAT ARE DAMAGED AND/OR

- 8 SEE MEP DRAWINGS FOR ADDITIONAL INFORMATION.
- 9 MANUAL ROLLER SHADES TO BE PROVIDED AT ALL WINDOWS BY OTHERS.

KEYNOTES

- 1) EXPOSED CEILING. PAINT VISIBLE SURFACES, NOT INCLUDING DUCTWORK, PIPING AND CONDUIT UNLESS NOTED OTHERWISE (SEE KEYNOTE 7). ARCHITECT TO MAKE COLOR SELECTION.
- PAINT EXPOSED STRUCTURE. ARCHITECT TO MAKE COLOR SELECTION. TBD. ALL FINISHES TO BE SUBMITTED TO ARCHITECT FOR REVIEW & APPROVAL.
- 3 EXPOSED DUCTWORK, PIPING AND CONDUIT SHALL BE PAINTED IN THIS SPACE ACCORDING TO SPECS . ARCHITECT
- TO MAKE COLOR SELECTION TBD.
- (4) APC-2: APC CLOUD SYSEM. B.O. CLOUD = 8'-6" AFF. SEE SPECS
- 5 SPB-1 4" DEEP ACOUSTIC BAFFLES. B.O. BAFFLE = 8'-6" AFF. SEE SPECS
- 6 APPROXIMATE LOCATION OF VAV BOX & DUCT. REMOVE INSULATION FROM VAV AND LOW-PRESSURE DUCT. PREPARE SURFACE. PAINT TO MATCH CEILING.
- (7) INSTALL DATA CABLING IN CABLE TRAY. COLOR WHITE.
- 8 INSTALL CABLE TRAY FOR WIRE / CABLE MANAGEMENT. PAINT TO MATCH CEILING.

IEI GROUP, LTD. IEI ARCHITECTS, INC. 428 North 2nd Street Philadelphia, PA 19123

Telephone: 215.413.3700 CONSULTANTS:

ARORA

Arora Engineers, Inc. 61 Wilmington-West Chester Pike Chadds Ford, PA 19317 P (610) 459-7900 F (610) 459-7950 aroraengineers.com



O'Donnell & Naccarato 701 Market Street, Suite 6000 Philadelphia, PA 19106 PH: 215.925.3788 www.o-n.com

LICENSE NO: <Architect's License #> EFFECTIVE ONLY AS TO THAT VERSION OF THIS DOCUMENT AS ORIGINALLY PUBLISHED BY DESIGN PROFESSIONAL. DESIGN PROFESSIONAL IS NOT RESPONSIBLE FOR ANY SUBSEQUENT MODIFICATION, CORRUPTION, OR

IILADELPHIA FRGENCY MANAGEMENT PUBLIC SERVICES BUILDIN DAD STREET, PHILADELPH ID 10 THE CI OFFICE PHILAE 400 NC FLOOR

PROGRESS SET

CLIENT REVIEW ■ BID SET CODE REVIEW SET

> **ISSUED** FOR BIDS

■ ISSUED FOR CONSTRUCTION

(NOT FOR CONSTRUCTION) ISSUES/REVISIONS:

1 9/18/2020 ISSUED FOR BIDS

09/18/2020


PROJECT NUMBER: DATE: DRAWN BY:

CHECKED BY: DRAWING TITLE: 8TH FLOOR

REFLECTED CEILING PLAN

A-208

PRINTED ON: 9/22/2020 12:51:07 PM

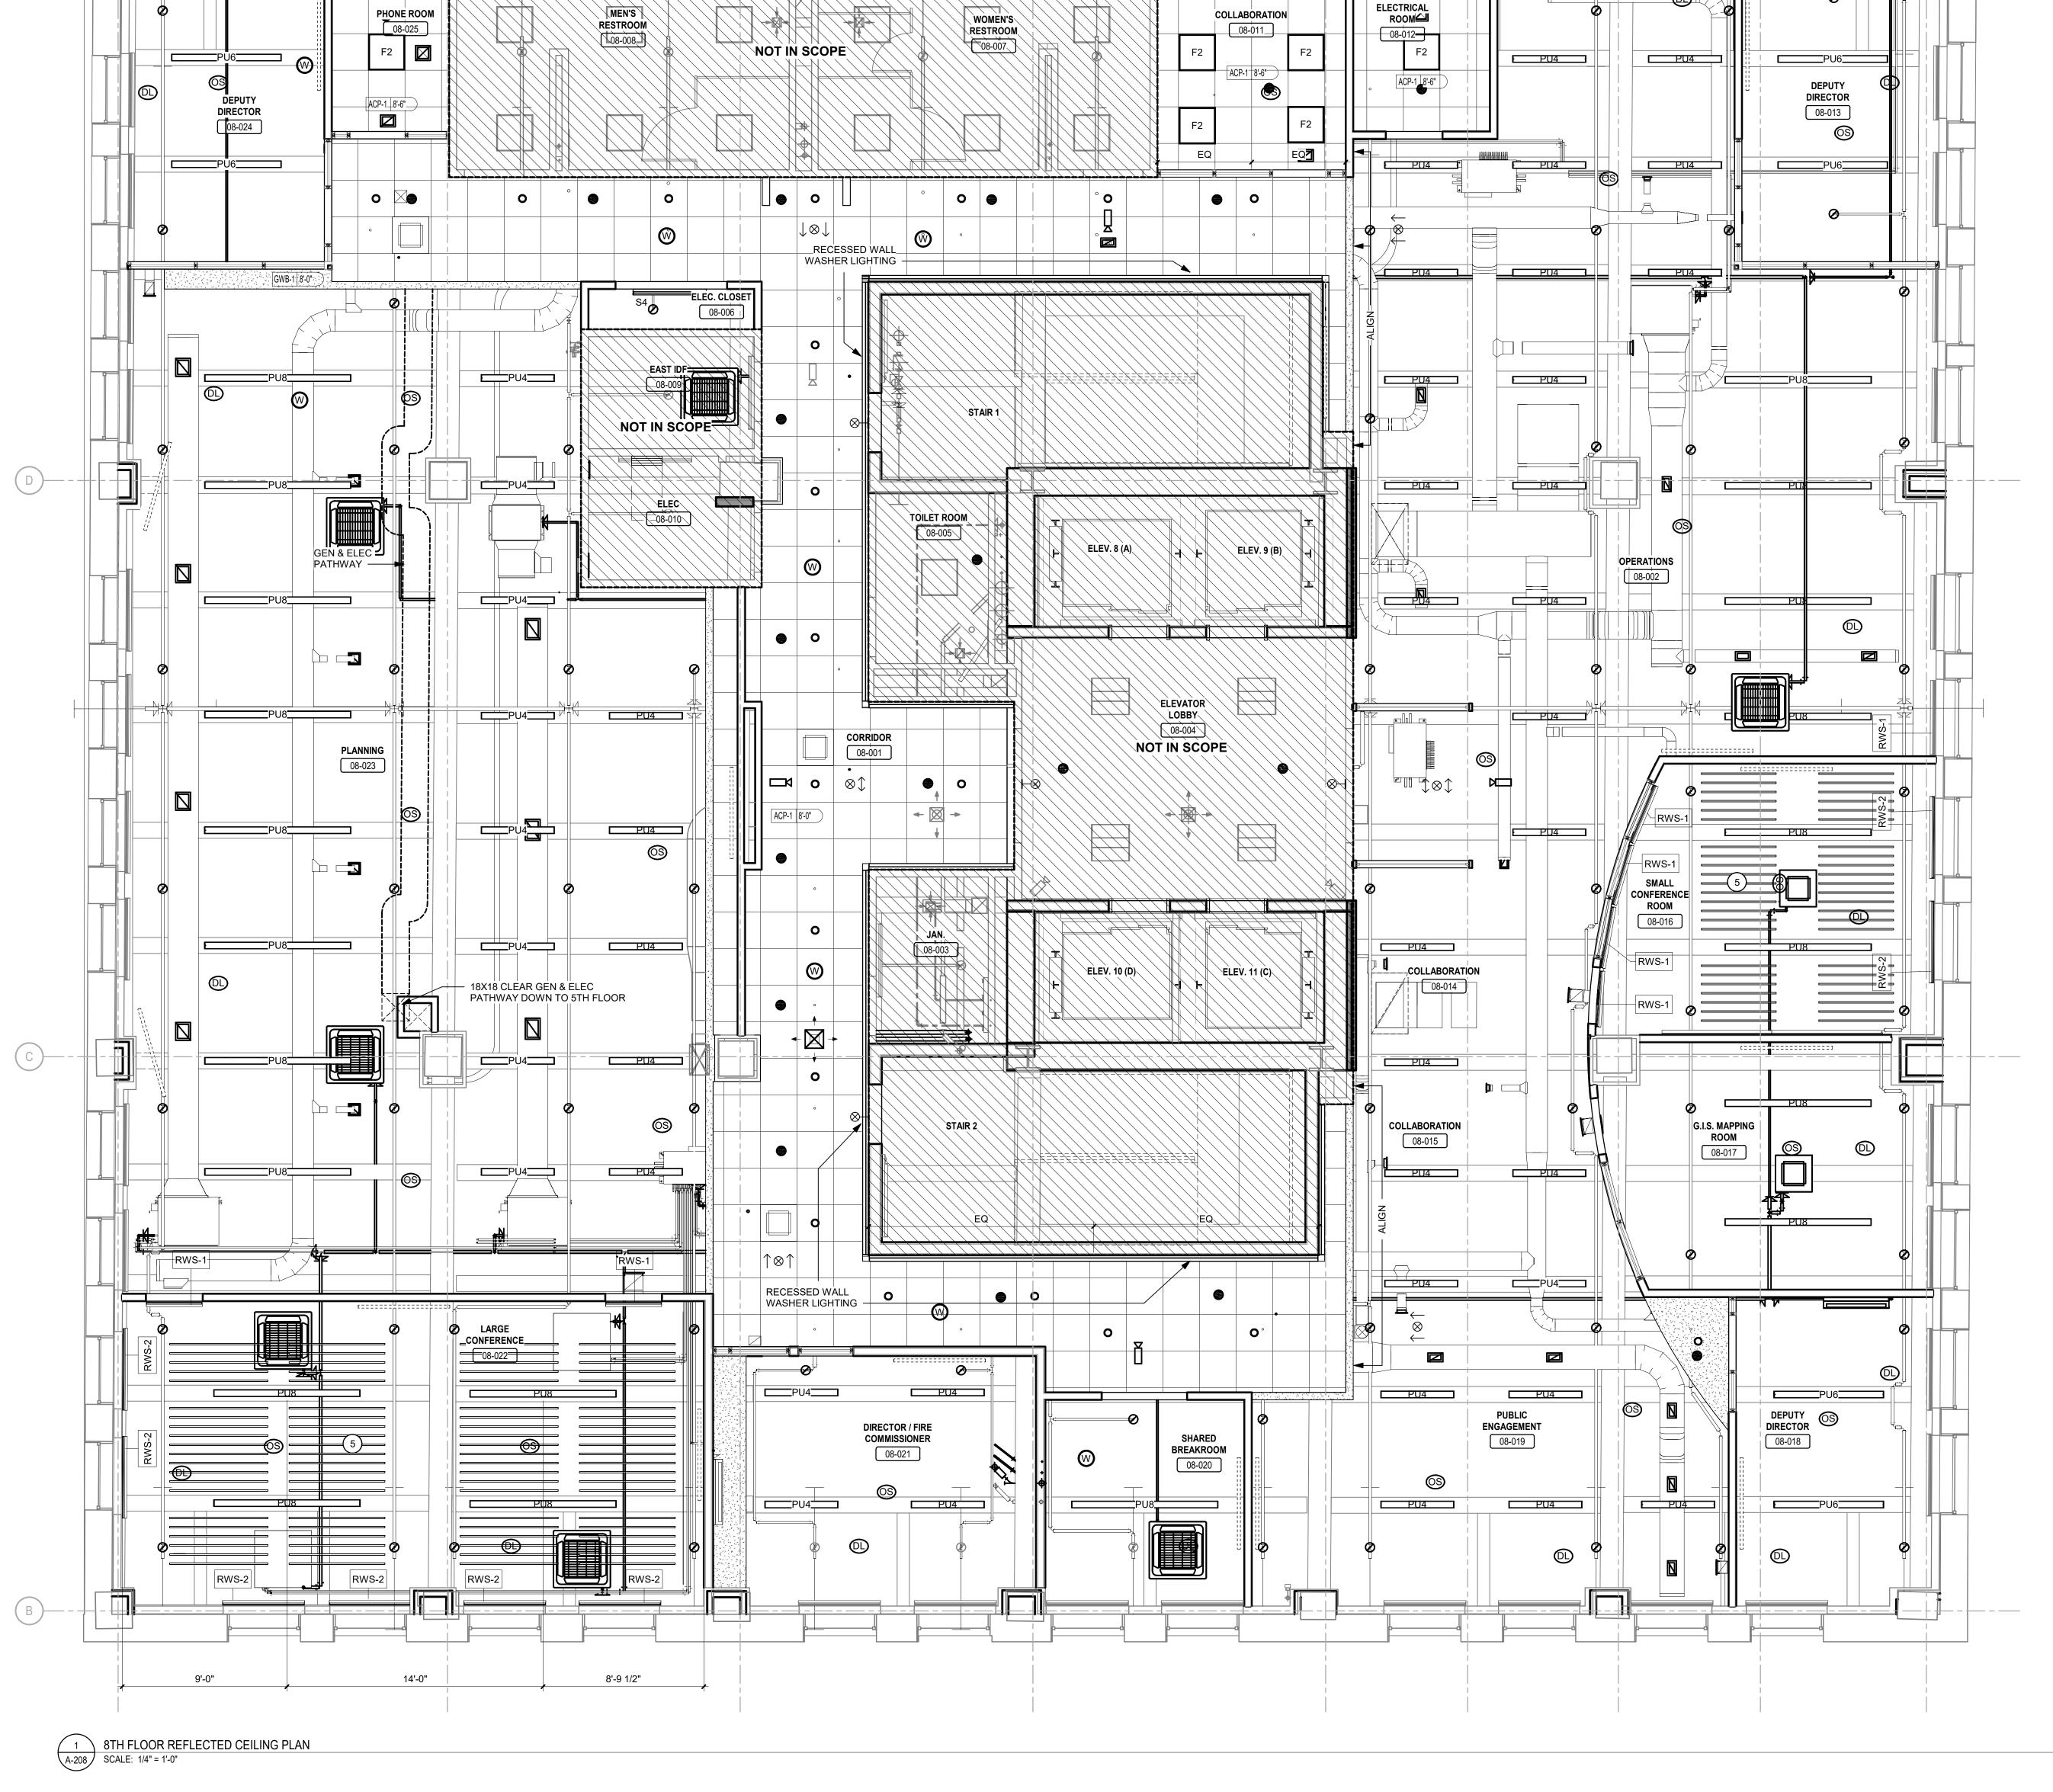

9TH FLOOR REFLECTED CEILING PLAN
SCALE: 1/4" = 1'-0"

GENERAL NOTES - RCP

1. SEE A-208 FOR SYMBOLS LEGEND - RCP & GENERAL NOTES - RCP.



IEI GROUP, LTD. IEI ARCHITECTS, INC. 428 North 2nd Street Philadelphia, PA 19123

Telephone: 215.413.3700

CONSULTANTS: **ARORA**°

Arora Engineers, Inc. 61 Wilmington-West Chester Pike Chadds Ford, PA 19317

P (610) 459-7900

F (610) 459-7950

aroraengineers.com



O'Donnell & Naccarato 701 Market Street, Suite 6000 Philadelphia, PA 19106 PH: 215.925.3788 www.o-n.com

LICENSE NO: <Architect's License #>

DESIGN FROE SOLUTE. SELECTIONS OF THIS DOCUMENT AS ORIGINALLY PUBLISHED BY DESIGN PROFESSIONAL. DESIGN PROFESSIONAL IS NOT RESPONSIBLE FOR ANY SUBSEQUENT MODIFICATION, CORRUPTION, OR UNAUTHORIZED USE OF SUCH DOCUMENT. TO VERIETY THE VALIDITY OR APPLICABILITY OF THE SEAL OR SIGNATURE, CONTACT DESIGN PROFESSIONAL

PROGRESS SET CLIENT REVIEW

■ BID SET ■ CODE REVIEW SET

■ ISSUED FOR CONSTRUCTION

ISSUED FOR BIDS 09/18/2020 (NOT FOR CONSTRUCTION)

ISSUES/REVISIONS: 1 9/18/2020 ISSUED FOR BIDS

PROJECT NUMBER: SCALE: As indicated DATE: 09/18/2020 DRAWN BY: CHECKED BY:

DRAWING TITLE: 9TH FLOOR

REFLECTED CEILING PLAN

A-209

PRINTED ON: 9/22/2020 12:51:16 PM

1. SEE A-208 FOR SYMBOLS LEGEND - RCP & GENERAL NOTES - RCP.



IEI GROUP, LTD.
IEI ARCHITECTS, INC.
428 North 2nd Street
Philadelphia, PA 19123


Telephone: 215.413.3700

CONSULTANTS:

ARORA

Arora Engineers, Inc.
61 Wilmington-West Chester Pike
Chadds Ford, PA 19317
P (610) 459-7900

F (610) 459-7950

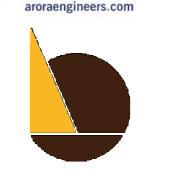

O'Donnell & Naccarato
701 Market Street, Suite 6000
Philadelphia, PA 19106
PH: 215.925.3788
www.o-n.com

LICENSE NO: <Architect's License #>

DESIGN PROFESSIONAL'S ELECTRONIC OR DIGITAL SEAL OR SIGNATURE IS EFFECTIVE ONLY AS TO THAT VERSION OF THIS DOCUMENT AS ORIGINALLY PUBLISHED BY DESIGN PROFESSIONAL. DESIGN PROFESSIONAL IS NOT RESPONSIBLE FOR ANY SUBSEQUENT MODIFICATION, CORRUPTION, OR INSTANTALIZATION OF THE PROFESSIONAL OR SIGNATURE OF THE PROFESSIONAL OR SI

DESIGN PROFESSIONAL'S ELECTRONIC OR DIGITAL SEAL OR SIGNATURE IS EFFECTIVE ONLY AS TO THAT VERSION OF THIS DOCUMENT AS ORIGINALLY PUBLISHED BY DESIGN PROFESSIONAL DESIGN PROFESSIONAL IS NOT RESPONSIBLE FOR ANY SUBSEQUENT MODIFICATION, CORRUPTION, OR UNAUTHORIZED USE OF SUCH DOCUMENT. TO VERIFY THE VALIDITY OR APPLICABILITY OF THE SEAL OR SIGNATURE, CONTACT DESIGN PROFESSIONAL

THE CITY OF PHILADELPHIA
OFFICE OF EMERGENCY MANAGEMENT
PHILADELPHIA PUBLIC SERVICES BUILDING
400 NORTH BROAD STREET, PHILADELPHIA,
FLOORS 8, 9 AND 10

□ PROGRESS SET
□ CLIENT REVIEW

■ BID SET
□ CODE REVIEW SET
□ ISSUED FOR CONSTRUCTION

ISSUED FOR BIDS 09/18/2020

(NOT FOR CONSTRUCTION)

ISSUES/REVISIONS:

1 9/18/2020 ISSUED FOR BIDS

PROJECT NUMBER:
SCALE:
DATE:
DRAWN BY:

As indicated

09/18/2020


DRAWING TITLE:
10TH FLOOR
REFLECTED

REFLECTED CEILING PLAN

SHEET NO:


A-210

PRINTED ON: 9/22/2020 12:51:25 PM

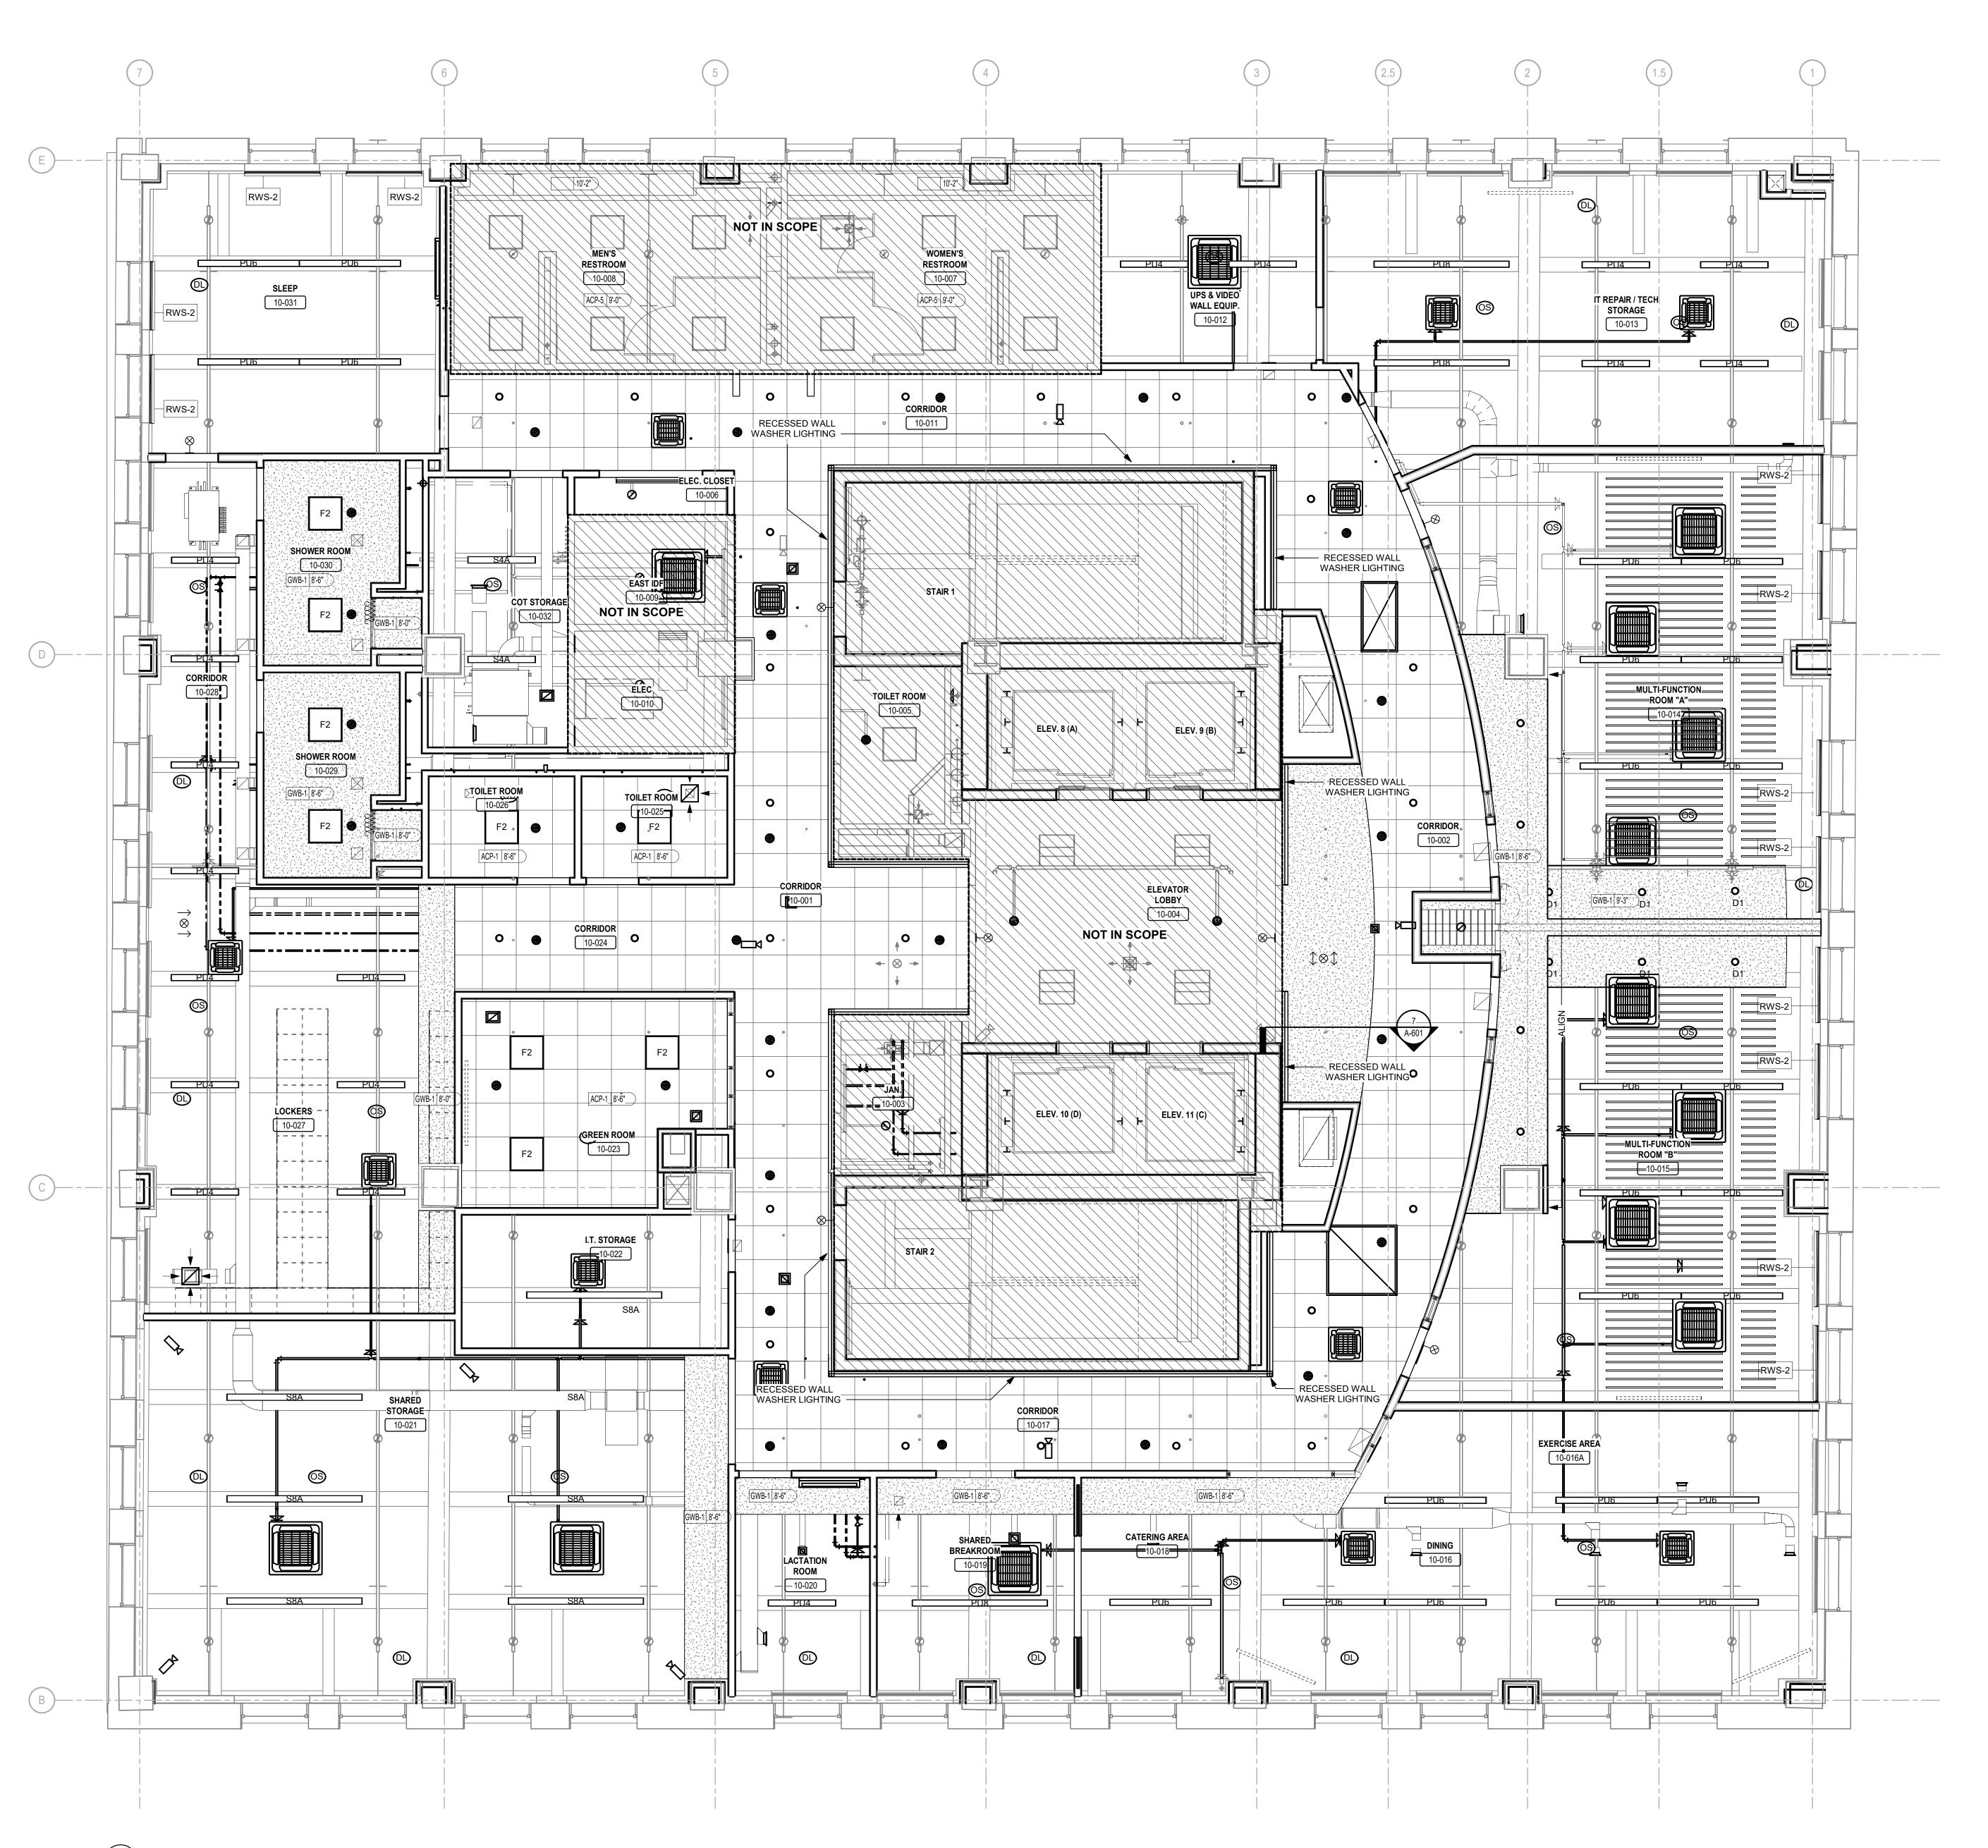

	FINISH GRO	UP S	CHFL	\mathbb{H}		
			_	_		
FINISH GROUP	DESCRIPTION	FLOOR	BASE	WALL	WALL ACCENT	CEILING
FG-1	LOCKERS, DINING, PANTRY, CATERING	LVT-1	B-1	P-1	NONE	SEE RCP
FG-1A	CORRIDORS	LVT-1	B-1	P-1	P-2	SEE RCP
FG-1B	CORRIDORS	LVT-1	B-1	P-1	P-3	SEE RCP
FG-1C	CORRIDORS	LVT-1	B-1	P-1	P-4	SEE RCP
FG-1D	BREAKROOM, PANTRY, EXERCISE	LVT-1	B-1	P-1	P-6	SEE RCP
FG-2	PLANNING	CPT-1	B-1	P-1	NONE	SEE RCP
FG-2A	OPERATIONS, COLLAB., ENGAGEMENT	CPT-1	B-1	P-1	P-2	SEE RCP
FG-2B	LACTATION	CPT-1	B-1	P-1	P-5	SEE RCP
FG-3	DIRECTORS, PHONE, SLEEP	CPT-3	B-1	P-1	NONE	SEE RCP
FG-3A	CONFERENCE, COLLAB.,C MULTI-FUNCT., GREEN	CPT-3	B-1	P-1	P-5	SEE RCP
FG-4	SITUATION, JCP, CORRIDORS	CPT-2	B-1	P-1	NONE	SEE RCP
FG-4A	EOC, CORRIDORS	CPT-2	B-1	P-1	P-3	SEE RCP
FG-4B	LOGISTICS,JIC, RIC	CPT-2	B-1	P-1	P-5	SEE RCP
FG-5	STORAGE, ELECTRICAL	VCT-1	B-1	P-1	NONE	SEE RCP
FG-5A	IT/TECH STORAGE	VCT-1	B-1	P-1	P-5	SEE RCP
FG-5B	COT STORGE	VCT-1	B-1	P-1	WC-1	SEE RCP
FG-6	SHOWER, TOILET	CT-1	CT-1	P-1	CT-2	SEE RCP

			FINISH	SCHEDULE			
TAG	MATERIAL	MANUFACTURER	PRODUCT	COLOR	SIZE	INSTALLATION METHOD	REMARKS
FLOOR							
CPT-1	CARPET TILE	ATLAS	HANGOUT, T7996 SETTLE IN	99602 STORMY NIGHT	12"x36"	PLANK	
CPT-2	CARPET TILE	STATICWORX	SHADOWFX CHENILE	100216 RETROSPECTIVE	2'x2'	TILE	
CPT-3	CARPET TILE	ATLAS	HANGOUT, T7995 STAY AWHILE	99602 STORMY NIGHT	12"x36"	PLANK	
CT-1	CERAMIC TILE	DALTILE	LINDEN POINT	LP21 GRIGIO	12"x24"	TILE	
LVT-1	LUXURY VINYL TILE	INTERFACE	VINYL FLOORING	A00308 LIGHT CONCRETE	2'x2'	TILE	
VCT-1	VINYL COMPOSITION TILE	ARMSTRONG	STANDARD EXCELON, IMPERIAL TEXTURE	51915 CHARCOAL	12"x12"	TILE	
WALL							
CT-2	CERAMIC TILE	DALTILE	MODERN DIMENSION	0190 ARTIC WHITE	4.25"X8"	TILE	
MPP-1	MINERAL PROFILE PANELLING	MODULAR ARTS	ACCENT WALL	SANDSTONE F01			PAINT WITH GENERAL WALL PAINT COLOR P-1
P-1	PAINT	BENJAMIN MOORE	GENERAL WALL PAINT	OC-68 DISTANT GREY		PAINT	EGGSHELL FINISH, GENERAL WALL PAINT COLOR U.N.O.
P-2	PAINT	BENJAMIN MOORE	ACCENT WALL PAINT	2066-10 BLUE		PAINT	EGGSHELL FINISH, ACCENT PAINT COLOR
P-3	PAINT	BENJAMIN MOORE	ACCENT WALL PAINT	2067-40 BLUE LAPIS		PAINT	EGGSHELL FINISH, ACCENT PAINT COLOR
P-4	PAINT	BENJAMIN MOORE	ACCENT WALL PAINT	2067-50 SUMMER BLUE		PAINT	EGGSHELL FINISH, ACCENT PAINT COLOR
P-5	PAINT	BENJAMIN MOORE	ACCENT WALL PAINT	HC-178 CHARCOAL SLATE		PAINT	EGGSHELL FINISH, ACCENT PAINT COLOR
P-6	PAINT	BENJAMIN MOORE	ACCENT WALL PAINT	TBD		PAINT	EGGSHELL FINISH, ACCENT PAINT COLOR
WA-1	DECORATIVE WALL PANELS	3FORM	ECORESIN 3/8", ASTRO	LID-1007269			ASTRO, SCALE B, MYTHICAL B60, OPACITY IV
CEILING							
APC-1	ACOUSTIC PANEL CEILING	USG	ACOUSTICAL CEILING TILES		2'x2'	TILE	
APC-2	ACOUSTIC PANEL CEILING	ARMSTRONG	CLOUD SYSTEM				
P-7	PAINTED CEILING	BENJAMIN MOORE	CEILING PAINT	2132-10 BLACK		PAINT	FLAT FINISH, CEILING PAINT COLOR
SBP-1	ACOUSTIC BAFFLE CEILING	DECOUSTICS	ACOUSTICAL FABRIC BAFFLES		2" WIDTH		
BASE							
B-1	RUBBER BASE	ROPPE	4" RUBBER COVE BASE	123 CHARCOAL	4"		
B-2	RUBBER BASE	ROPPE	4" RUBBER STRAIGHT BASE	123 CHARCOAL	4"		
CT-1	PORCELAIN BASE TILE	DALTILE	LINDEN POINT	LP21 GRIGIO	6"x12"	TILE	CUT TILE WITH RONDEC-RB SCHLUDER STRIF ON TOP
T-1	TRANSITION STRIP	SCHLUDER	SCHLUDER-RONDEC-RB	SATIN ANODIZED			TOP CUT BASE TILE
T-2	TRANSITION STRIP	SCHLUTER	SCHLUDER-RENO-U	STAINLESS STEEL V2A			BETWEEN LVT-1 AND CT-1
T-3	TRANSITION STRIP	ROPPE	TRANSITION	123 CHARCOAL			USE APPROPRIATE SIZE BETWEEN LVT-1 AND VCT-1
MISCELLA							
FRP	FIBRE REINFORCED PLASTIC						SEE SPEC
N-1	RUBBER NOSING						SEE SPEC
PL-1	PLASTIC LAMINATE	NEVAMAR	PLASTIC LAMINATE	RECON OAK WZ0005N HI-LUSTER			
RWS-2	ROLLING WINDOW SHADES						
SS-1	SOLID SURFACE	CORIAN	CORIAN SOLID SURFACE	EVEREST			
WC-1	WALL SHEET PROTECTION	ACROVYN	ABUSE RESISTENT WC	GALVESTON GRAY #315	O.06.0"		

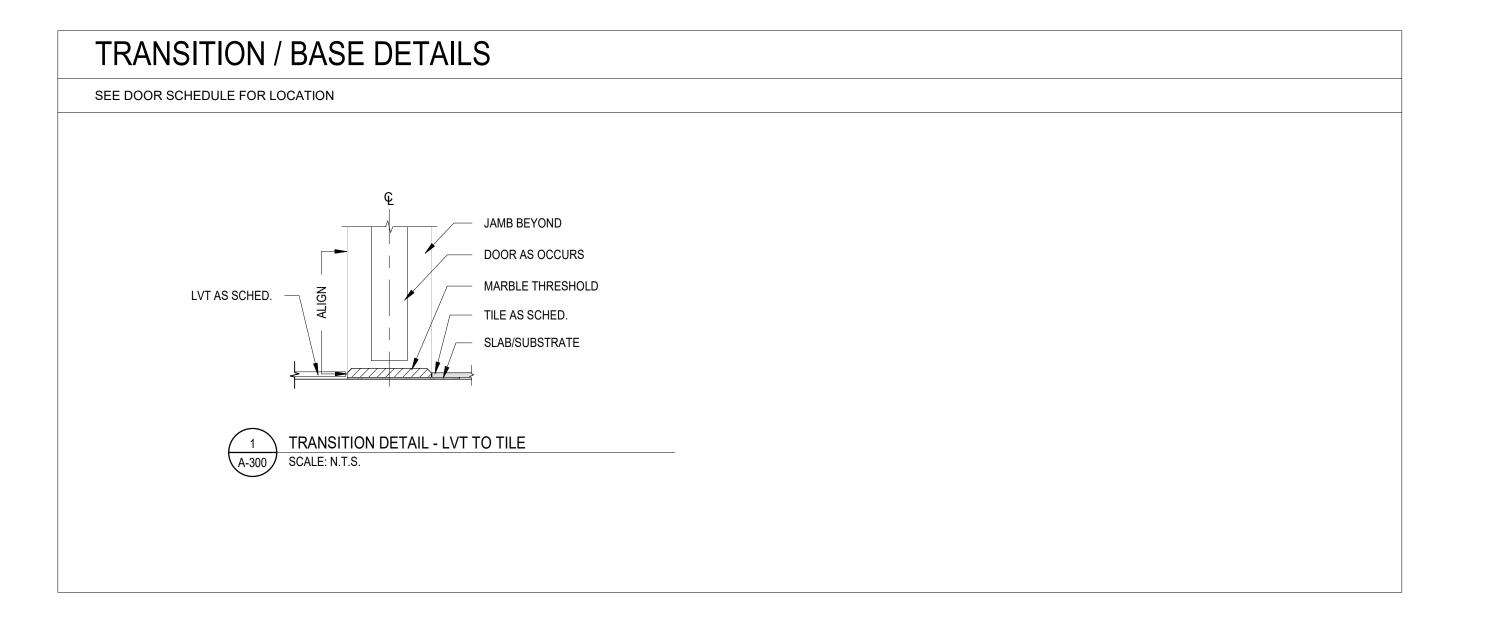




IEI GROUP, LTD. IEI ARCHITECTS, INC.

428 North 2nd Street Philadelphia, PA 19123 Telephone: 215.413.3700

CONSULTANTS:

Arora Engineers, Inc. 61 Wilmington-West Chester Pike Chadds Ford, PA 19317 P (610) 459-7900 F (610) 459-7950 aroraengineers.com

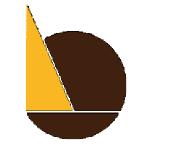

<u>O'Donnell & Naccarato</u> 701 Market Street, Suite 6000 Philadelphia, PA 19106 PH: 215.925.3788 www.o-n.com

LICENSE NO: <Architect's License #>

DESIGN PROFESSIONAL'S ELECTRONIC OR DIGITAL SEAL OR SIGNATURE IS EFFECTIVE ONLY AS TO THAT VERSION OF THIS DOCUMENT AS ORIGINALLY PUBLISHED BY DESIGN PROFESSIONAL. DESIGN PROFESSIONAL IS NOT RESPONSIBLE FOR ANY SUBSEQUENT MODIFICATION, CORRUPTION, OR UNAUTHORIZED USE OF SUCH DOCUMENT. TO VERIFY THE VALIDITY OR APPLICABILITY OF THE SEAL OR SIGNATURE CONTACT DESIGN PROFESSIONAL APPLICABILITY OF THE SEAL OR SIGNATURE, CONTACT DESIGN PROFESSIONAL.

■ PROGRESS SET

□ CLIENT REVIEW ■ BID SET

■ CODE REVIEW SET ☐ ISSUED FOR CONSTRUCTION

> **ISSUED** FOR BIDS 09/18/2020

(NOT FOR CONSTRUCTION) ISSUES/REVISIONS:

1 9/18/2020 ISSUED FOR BIDS

PROJECT NUMBER:


DRAWING TITLE:
FINISH SCHEDULE

PRINTED ON: 9/22/2020 3:15:28 PM

1 8TH FLOOR PLAN A-308 SCALE: 1/4" = 1'-0"

GENERAL NOTES - FINISH


- 1 CONTRACTOR TO FLASH PATCH AND LEVEL ALL DAMAGED CONCRETE FLOOR 2 PROVIDE ALL FLOORING IN ACCORDANCE WITH MANUFACTURERS' INSTRUCTIONS.
- 3 NO SUBSTITUTIONS ALLOWED WITHOUT WRITTEN APPROVAL BY IEI.
- 4 SEE SPECIFICATIONS FOR LEVEL OF GWB FINISH.
- 5 PAINT ALL INTERIOR WALLS IN OFFICES AND CONFERENCE ROOMS P-1, UNLESS
- NOTED OTHERWISE. 6 ALL DOORS AND FRAMES ARE SHALL BE PAINTED TO MATCH ADJACENT WALL UNLESS NOTED OTHERWISE.
- 7 COORDINATE WAYFINDING GRAPHICS PER SIGNAGE PLANS.

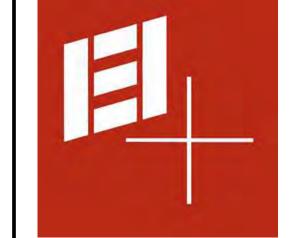

IEI GROUP, LTD. IEI ARCHITECTS, INC. 428 North 2nd Street

Philadelphia, PA 19123 Telephone: 215.413.3700 CONSULTANTS:

Arora Engineers, Inc. 61 Wilmington-West Chester Pike Chadds Ford, PA 19317 P (610) 459-7900 F (610) 459-7950 aroraengineers.com

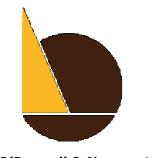

<u>O'Donnell & Naccarato</u> 701 Market Street, Suite 6000 Philadelphia, PA 19106 PH: 215.925.3788 www.o-n.com

LICENSE NO: <Architect's License #> DESIGN PROFESSIONAL'S ELECTRONIC OR DIGITAL SEAL OR SIGNATURE IS EFFECTIVE ONLY AS TO THAT VERSION OF THIS DOCUMENT AS ORIGINALLY PUBLISHED BY DESIGN PROFESSIONAL. DESIGN PROFESSIONAL IS NOT RESPONSIBLE FOR ANY SUBSEQUENT MODIFICATION, CORRUPTION, OR UNAUTHORIZED USE OF SUCH DOCUMENT. TO VERIFY THE VALIDITY OR

- PROGRESS SET
- □ CLIENT REVIEW ■ BID SET
- ☐ CODE REVIEW SET

☐ ISSUED FOR CONSTRUCTION

ISSUED FOR BIDS 09/18/2020

(NOT FOR CONSTRUCTION)

ISSUES/REVISIONS: 1 9/18/2020 ISSUED FOR BIDS

PROJECT NUMBER: DATE: DRAWN BY: CHECKED BY:

DRAWING TITLE: 8TH FLOOR FINISH

A-308

PRINTED ON: 9/22/2020 3:01:54 PM

1. SEE A-308 FOR TYPICAL FINISH NOTES.

09-011

FG-1

ELEV. 9 (B)
EXISTING

ELEV. 11 (C)

EXISTING

LVT-1 CPT-2

+0'-4"

WOMEN'S

RESTROOM

09-007

EXISTING

CORRIDOR 09-019 FG-1B

STAIR 1

ELEV. 8 (A)

EXISTING

EXISTING

09-012 FG-1D

ELEVATOR LOBBY 09-004 EXISTING

09-ST1

EXISTING

09-005

EXISTING

09-003

EXISTING

STAIR 2 09-ST2 EXISTING

09-020 FG-4A

09-001 FG-1B

+0'-0"

LOGISTICS CENTER 09-013 FG-4B

09-001 FG-4

CORRIDOR
09-014

FG-4

P CPT-2

LVT-1

+0'-4"

MEN'S RESTROOM

09-008

EXISTING

ELEC. CLOSET 09-006

FG-1

EAST IDF

09-009
EXISTING

09-010 EXISTING

CPT-2

CORRIDOR

09-019

FG-4

REGIONAL

INTEGRATION

CENTER

09-017 FG-4B


+0'-4"

SITUATION ROOM

09-016 FG-4

JOINT INFORMATION CENTER

09-015 FG-4B

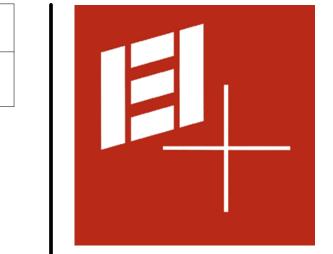

IEI GROUP, LTD. IEI ARCHITECTS, INC. 428 North 2nd Street Philadelphia, PA 19123 Telephone: 215.413.3700

CONSULTANTS:

ARORA°

Arora Engineers, Inc. 61 Wilmington-West Chester Pike Chadds Ford, PA 19317 P (610) 459-7900 F (610) 459-7950 aroraengineers.com



O'Donnell & Naccarato 701 Market Street, Suite 6000 Philadelphia, PA 19106 PH: 215.925.3788 www.o-n.com

LICENSE NO: <Architect's License #> DESIGN PROFESSIONAL'S ELECTRONIC OR DIGITAL SEAL OR SIGNATURE IS EFFECTIVE ONLY AS TO THAT VERSION OF THIS DOCUMENT AS ORIGINALLY PUBLISHED BY DESIGN PROFESSIONAL. DESIGN PROFESSIONAL IS NOT RESPONSIBLE FOR ANY SUBSEQUENT MODIFICATION, CORRUPTION, OR UNAUTHORIZED USE OF SUCH DOCUMENT. TO VERIFY THE VALIDITY OR APPLICABLE TO SECRET OR SUBJECT SOCIAL PROFESSIONAL.

APPLICABILITY OF THE SEAL OR SIGNATURE, CONTACT DESIGN PROFESSIONAL.

■ PROGRESS SET □ CLIENT REVIEW

■ BID SET ■ CODE REVIEW SET ■ ISSUED FOR CONSTRUCTION

> ISSUED FOR BIDS 09/18/2020

(NOT FOR CONSTRUCTION) ISSUES/REVISIONS:

1 9/18/2020 ISSUED FOR BIDS

PROJECT NUMBER: DATE: DRAWN BY: CHECKED BY:

DRAWING TITLE: 9TH FLOOR FINISH

PLAN

A-309



JOINT COMMAND

09-002A FG-4

JOINT COMMAND

FG-4

EMERGENCY OPERATIONS CENTER

09-002 FG-4A

+0'-4"

PRINTED ON: 9/22/2020 12:51:36 PM

1. SEE A-308 FOR TYPICAL FINISH NOTES.


IT REPAIR / TECH

STORAGE

10-013

FG-5A

MULTI-FUNCTION ROOM "A" 10-014

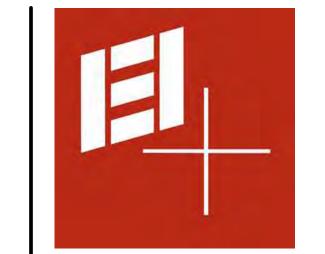

IEI GROUP, LTD. IEI ARCHITECTS, INC. 428 North 2nd Street Philadelphia, PA 19123

Telephone: 215.413.3700 CONSULTANTS:

ARORA°

Arora Engineers, Inc. 61 Wilmington-West Chester Pike Chadds Ford, PA 19317 P (610) 459-7900 F (610) 459-7950 aroraengineers.com



O'Donnell & Naccarato 701 Market Street, Suite 6000 Philadelphia, PA 19106 PH: 215.925.3788 www.o-n.com

LICENSE NO: <Architect's License #> DESIGN PROFESSIONAL'S ELECTRONIC OR DIGITAL SEAL OR SIGNATURE IS EFFECTIVE ONLY AS TO THAT VERSION OF THIS DOCUMENT AS ORIGINALLY PUBLISHED BY DESIGN PROFESSIONAL. DESIGN PROFESSIONAL IS NOT RESPONSIBLE FOR ANY SUBSEQUENT MODIFICATION, CORRUPTION, OR UNAUTHORIZED USE OF SUCH DOCUMENT. TO VERIFY THE VALIDITY OR APPLICABLE TO SECRET OR SUBJECT SOCIAL PROFESSIONAL.

■ PROGRESS SET ☐ CLIENT REVIEW

■ BID SET ☐ CODE REVIEW SET ☐ ISSUED FOR CONSTRUCTION

> **ISSUED** FOR BIDS 09/18/2020


(NOT FOR CONSTRUCTION) ISSUES/REVISIONS:

1 9/18/2020 ISSUED FOR BIDS PROJECT NUMBER: As indicated

DATE: DRAWN BY: CHECKED BY: DRAWING TITLE:

10TH FLOOR FINISH PLAN

A-310

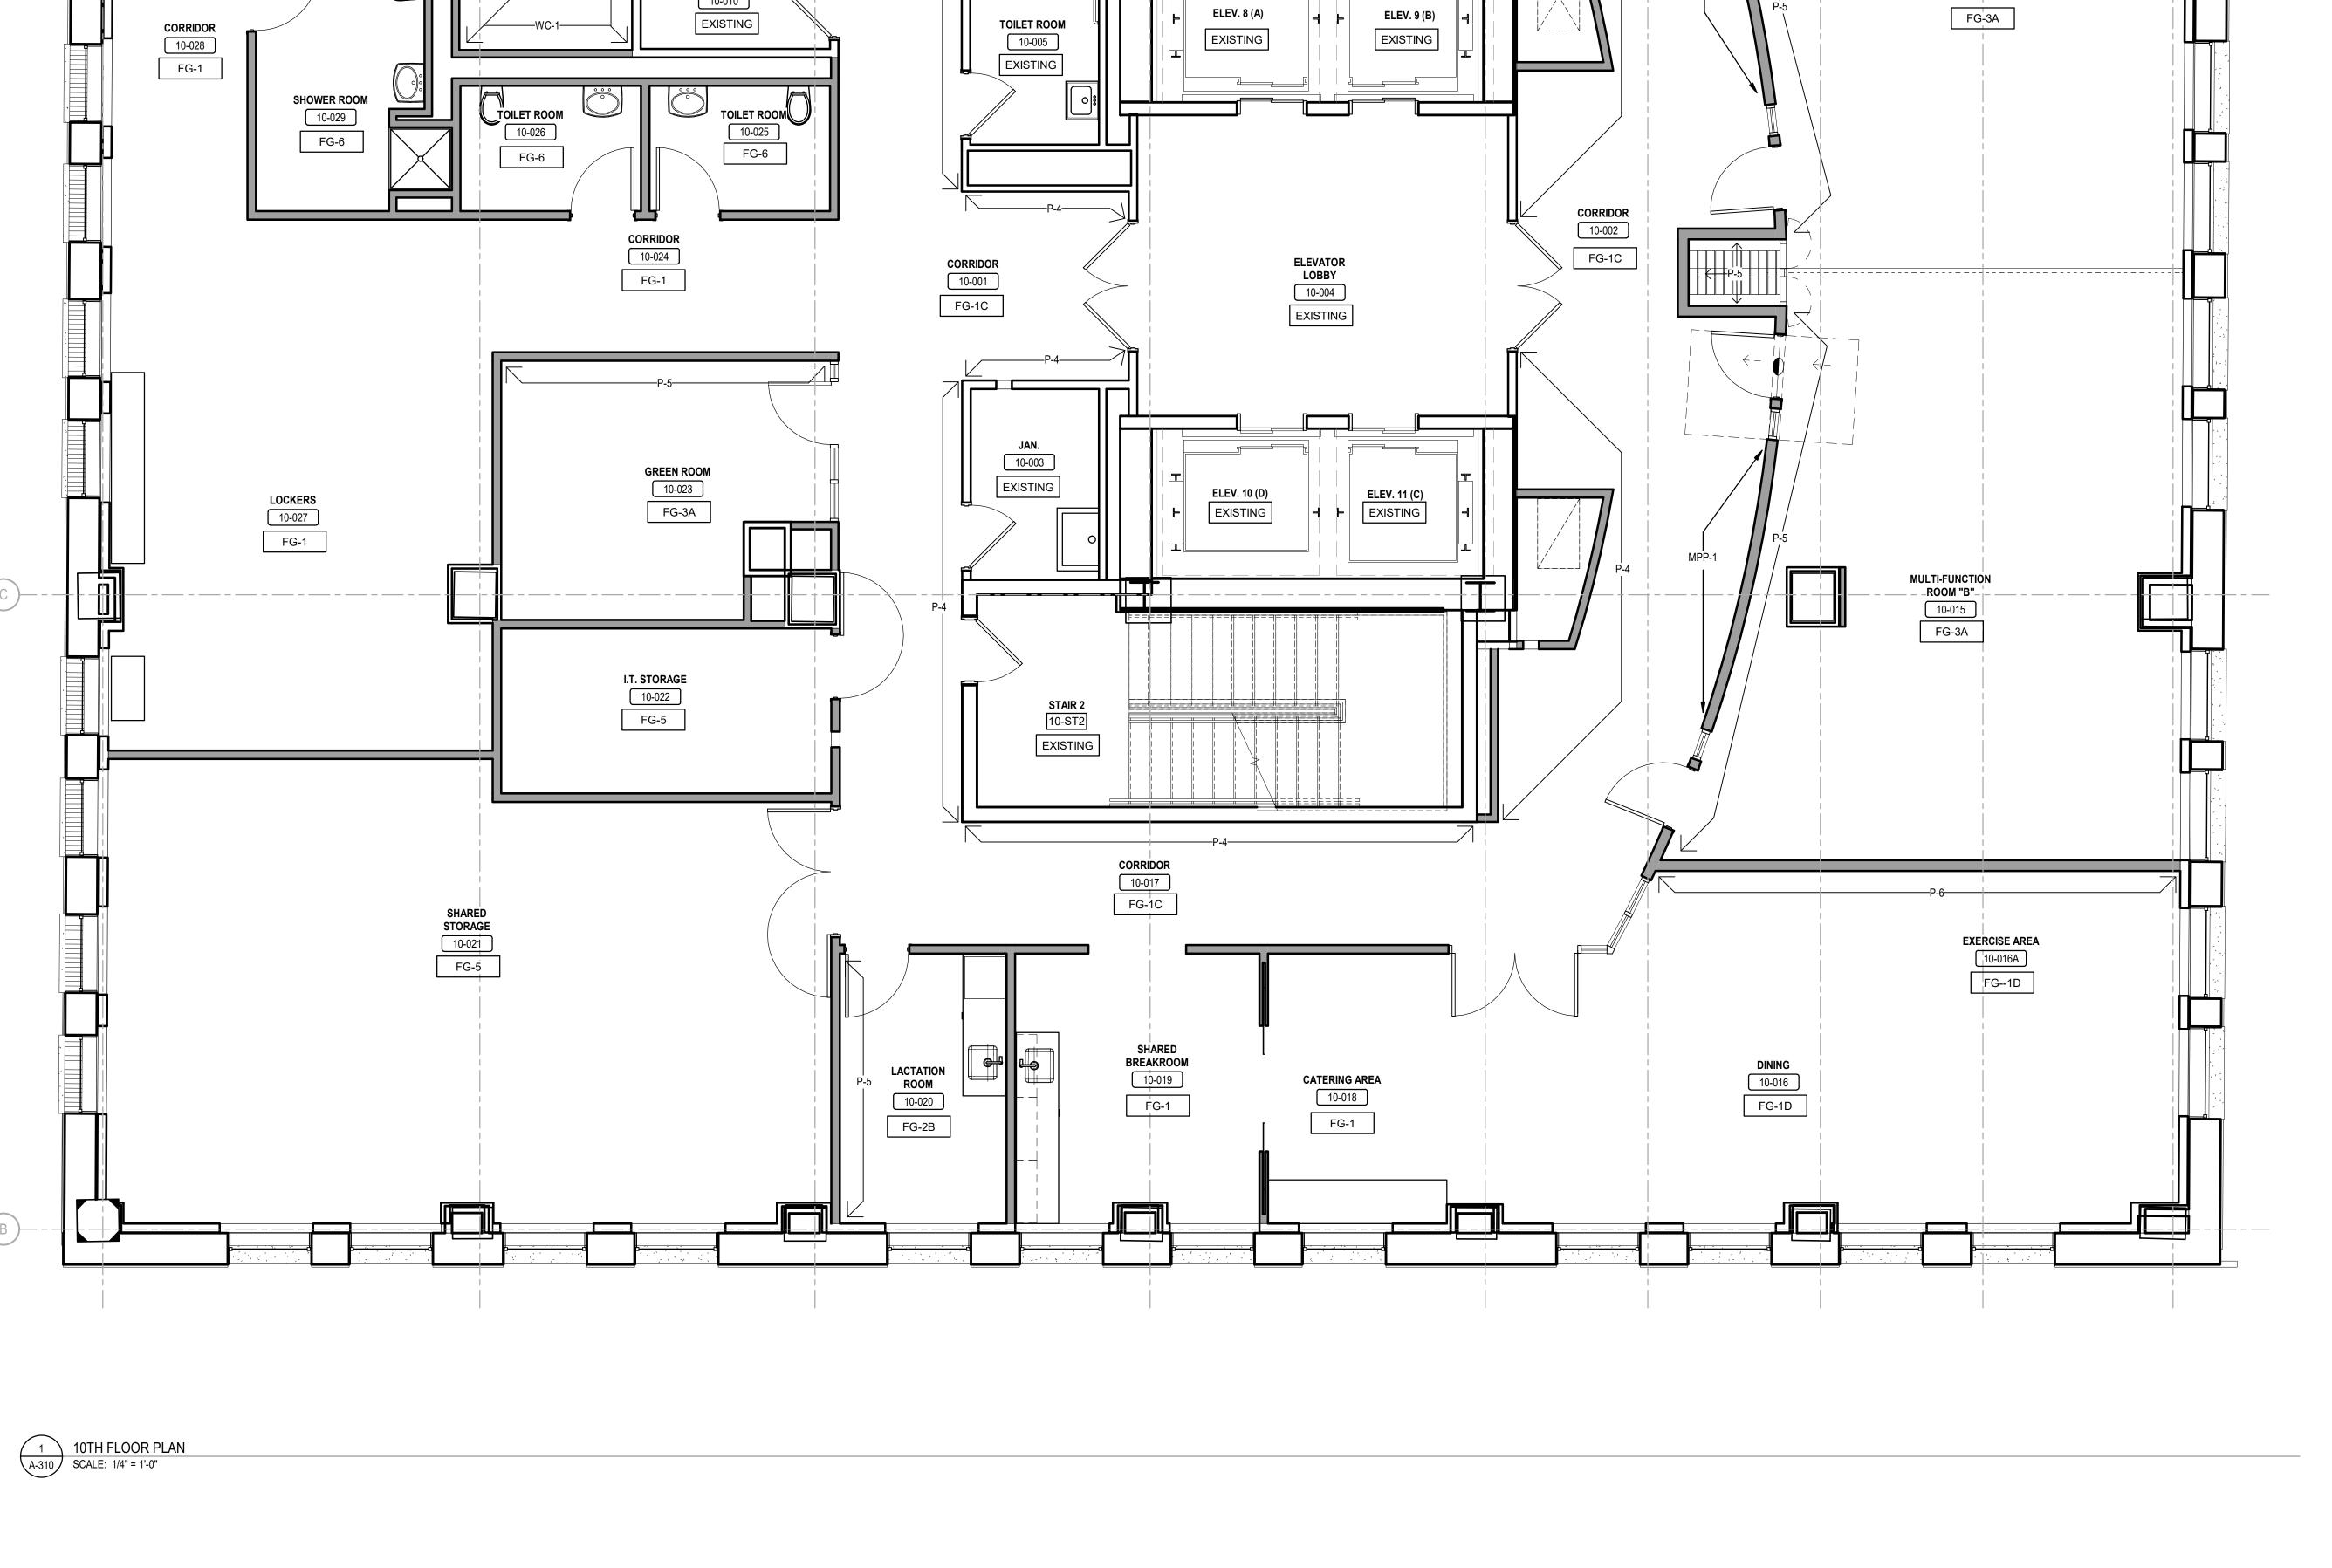

RESTROOM

EXISTING

CORRIDOR 10-011 FG-1C

10-ST1

EXISTING

WALL EQUIP.

10-012

FG-5

RESTROOM

EXISTING

COT STORAGE

10-032

FG-5B

10-006 FG-1

10-009


EXISTING

10-031 FG-3

SHOWER ROOM

10-030

FG-6

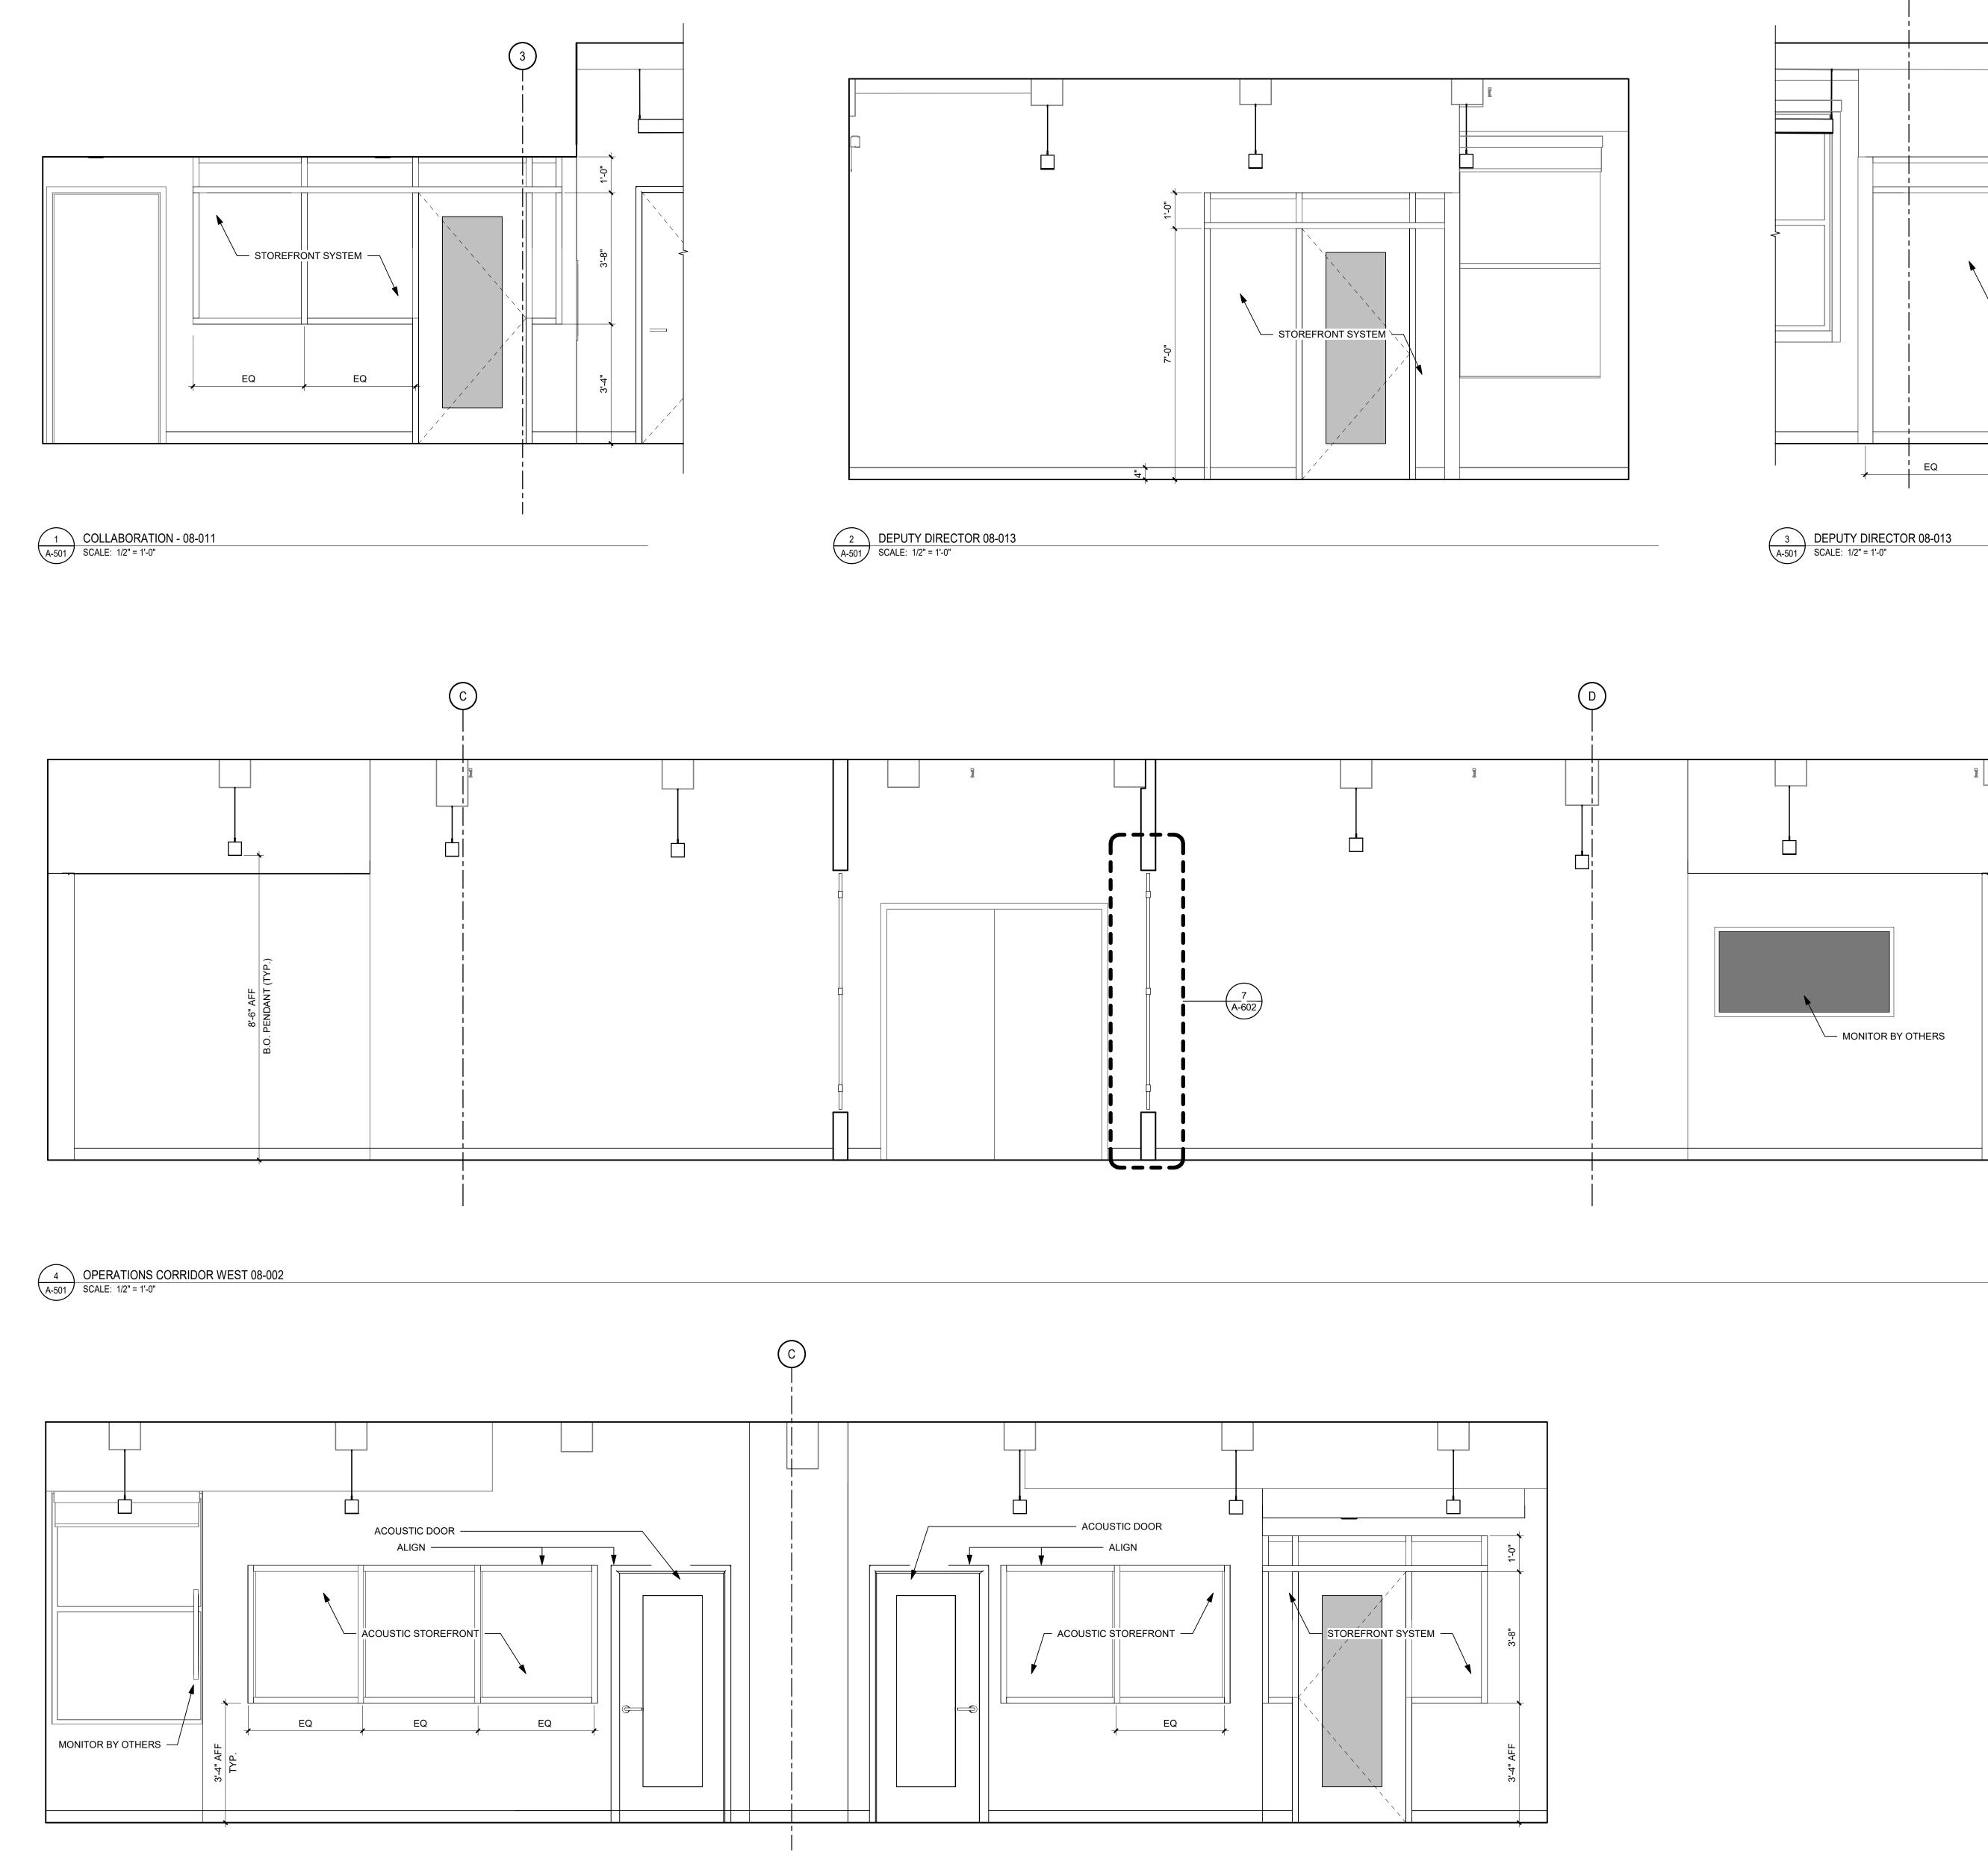

6 SMALL CONFERENCE 08-016 & G.I.S. MAPPING ROOM 08-017 SCALE: 1/2" = 1'-0"

STOREFRONT SYSTEM + EQ

LICENSE NO: <Architect's License #> DESIGN PROFESSIONAL'S ELECTRONIC OR DIGITAL SEAL OR SIGNATURE IS EFFECTIVE ONLY AS TO THAT VERSION OF THIS DOCUMENT AS ORIGINALLY PUBLISHED BY DESIGN PROFESSIONAL. DESIGN PROFESSIONAL IS NOT RESPONSIBLE FOR ANY SUBSEQUENT MODIFICATION, CORRUPTION, OR UNAUTHORIZED USE OF SUCH DOCUMENT. TO VERIFY THE VALIDITY OR ADDICATOR TO SECONDAL PROFESSIONAL.

IEI GROUP, LTD.

428 North 2nd Street Philadelphia, PA 19123 Telephone: 215.413.3700

CONSULTANTS:

IEI ARCHITECTS, INC.

Arora Engineers, Inc.

61 Wilmington-West Chester Pike Chadds Ford, PA 19317

P (610) 459-7900 F (610) 459-7950

aroraengineers.com

<u>O'Donnell & Naccarato</u> 701 Market Street, Suite 6000

Philadelphia, PA 19106 PH: 215.925.3788 www.o-n.com

APPLICABILITY OF THE SEAL OR SIGNATURE, CONTACT DESIGN PROFESSIONAL.

■ PROGRESS SET CLIENT REVIEW

■ BID SET

■ CODE REVIEW SET ■ ISSUED FOR CONSTRUCTION

> ISSUED FOR BIDS 09/18/2020

(NOT FOR CONSTRUCTION) ISSUES/REVISIONS:

1 9/18/2020 ISSUED FOR BIDS


PROJECT NUMBER: SCALE: DATE: 1/2" = 1'-0" 09/18/2020 DRAWN BY: CHECKED BY:

DRAWING TITLE:

ELEVATIONS

A-501

PRINTED ON: 9/22/2020 12:51:41 PM

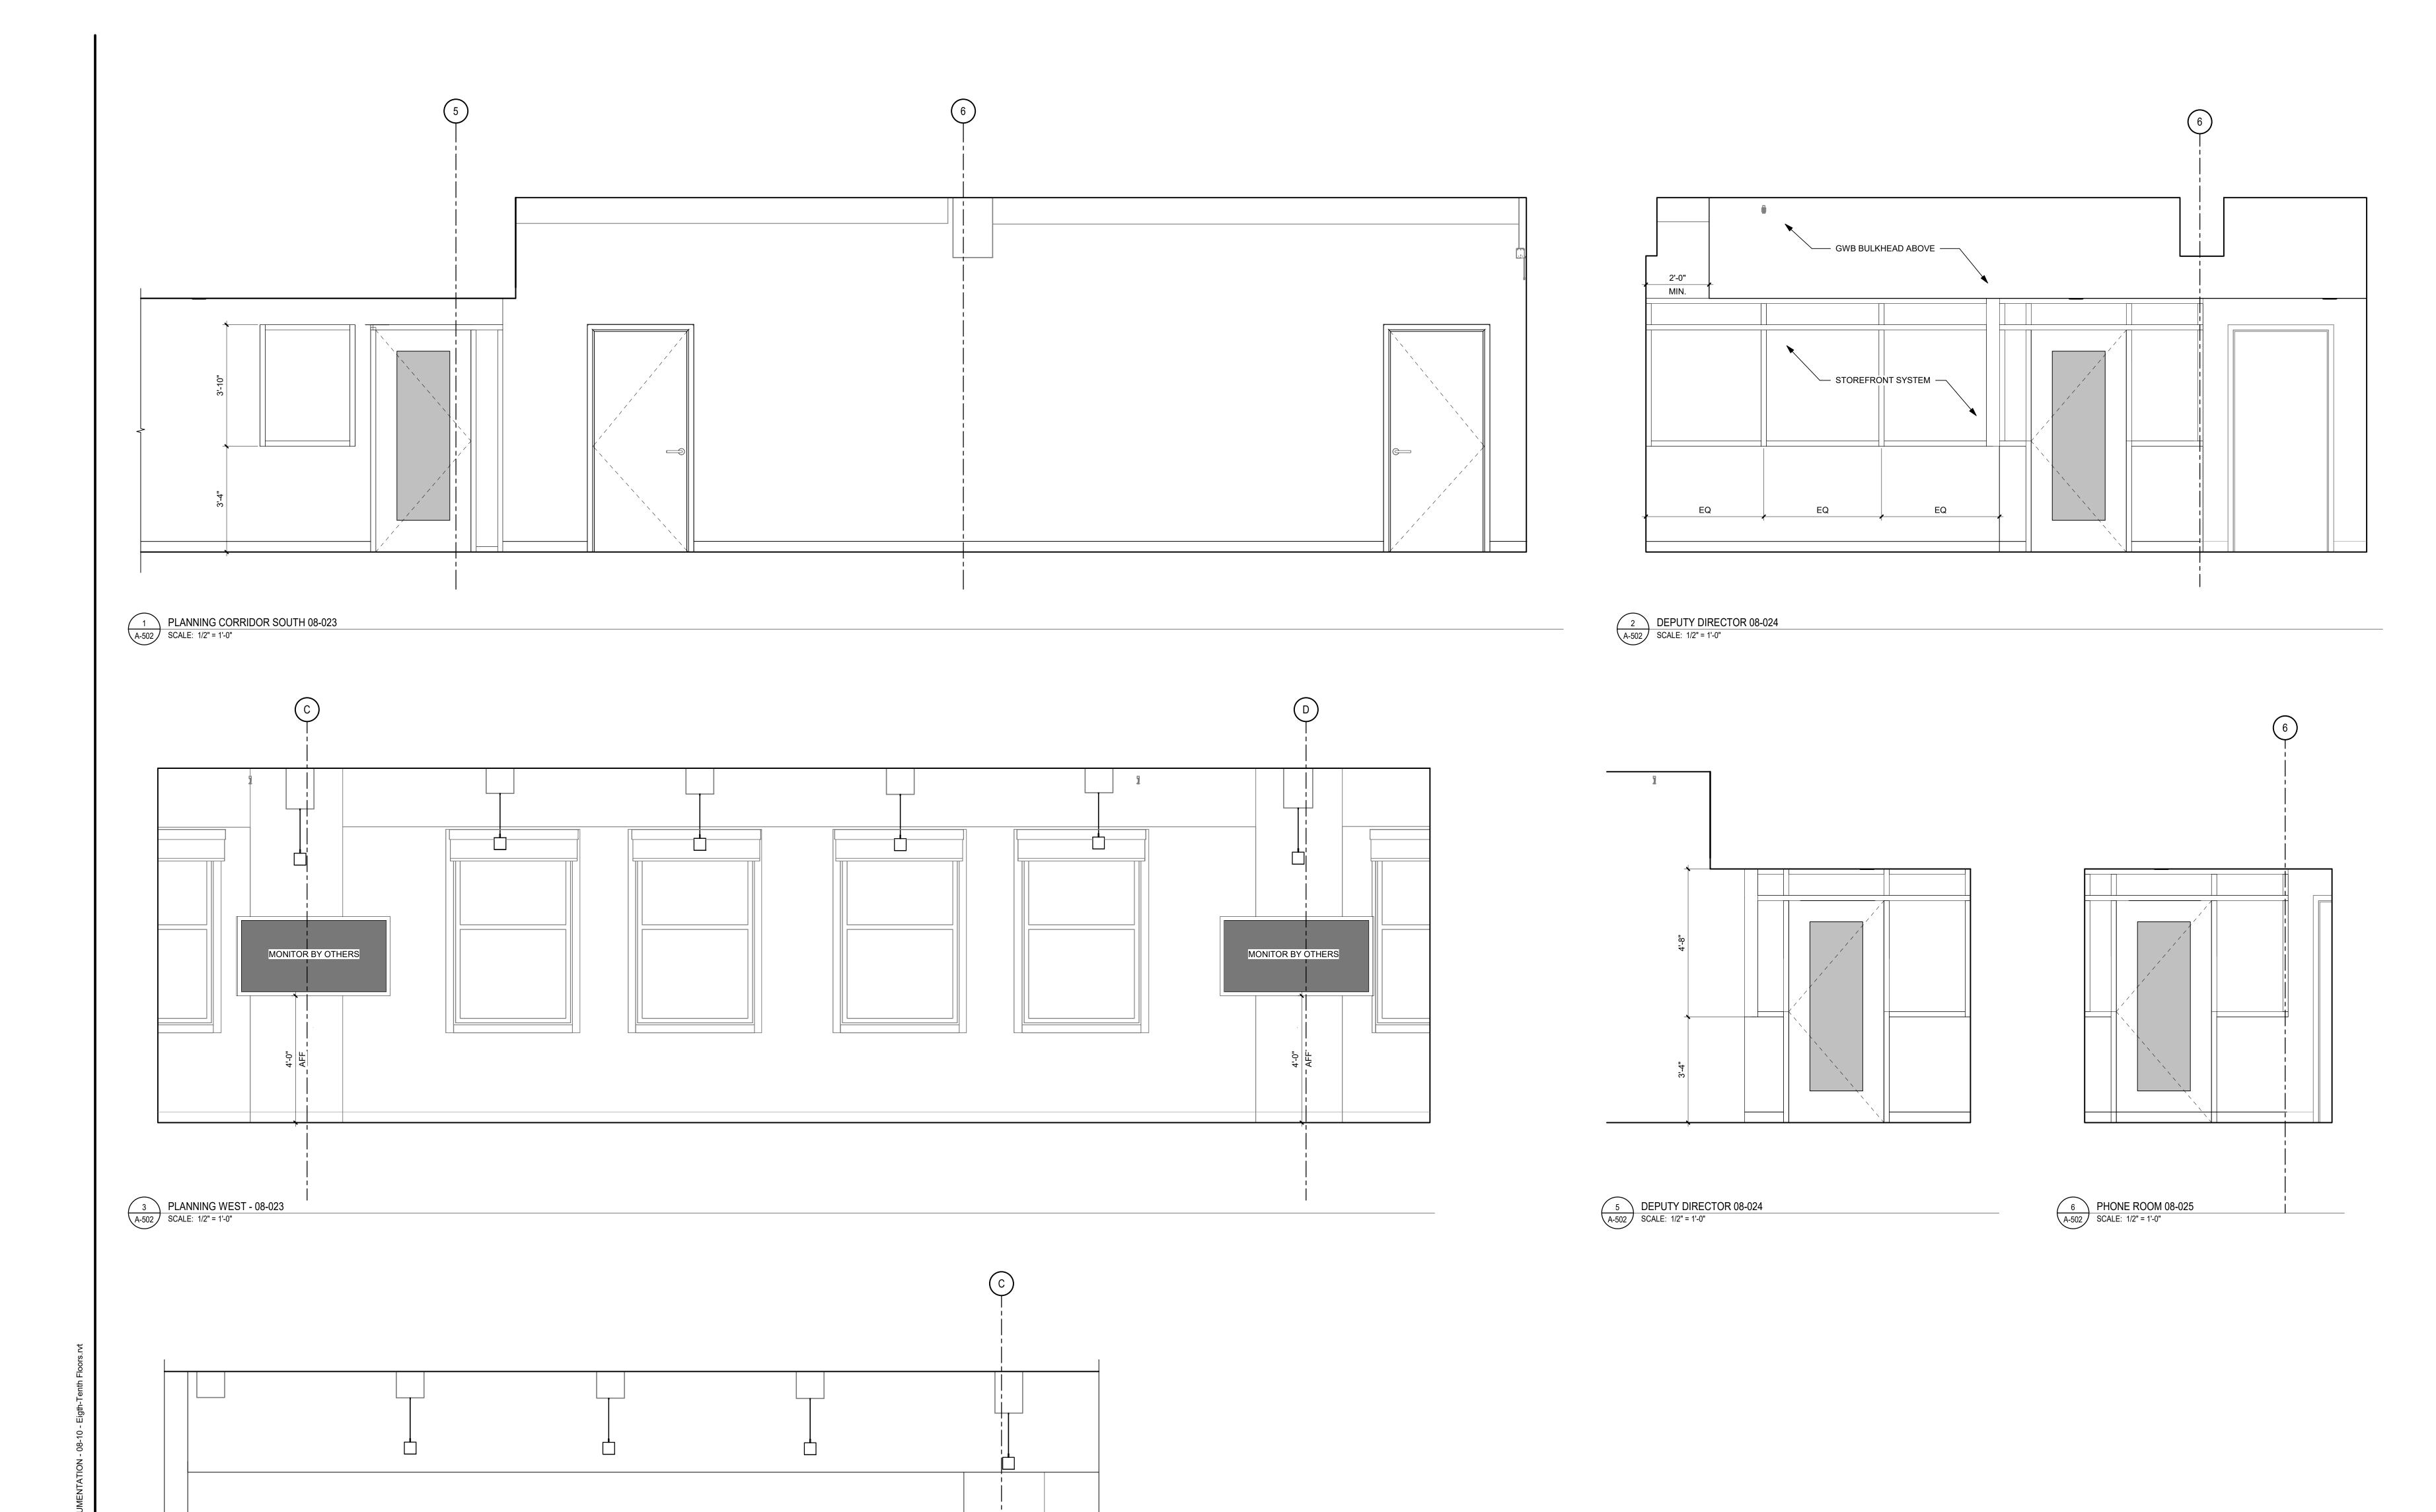

MONITOR BY OTHERS

4 PLANNING EAST 08-023 SCALE: 1/2" = 1'-0"



IEI GROUP, LTD. IEI ARCHITECTS, INC. 428 North 2nd Street Philadelphia, PA 19123

Telephone: 215.413.3700


CONSULTANTS:

ARORA°





O'Donnell & Naccarato 701 Market Street, Suite 6000 Philadelphia, PA 19106 PH: 215.925.3788 www.o-n.com

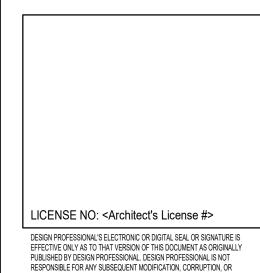

DESIGN PROFESSIONAL'S ELECTRONIC OR DIGITAL SEAL OR SIGNATURE IS EFFECTIVE ONLY AS TO THAT VERSION OF THIS DOCUMENT AS ORIGINALLY PUBLISHED BY DESIGN PROFESSIONAL. DESIGN PROFESSIONAL IS NOT RESPONSIBLE FOR ANY SUBSEQUENT MODIFICATION, CORRUPTION, OR UNAUTHORIZED USE OF SUCH DOCUMENT. TO VERIFY THE VALIDITY OR ADDICATOR TO SECONDAL PROFESSIONAL. APPLICABILITY OF THE SEAL OR SIGNATURE, CONTACT DESIGN PROFESSIONAL.

THE CITY OF PHILADELPHIA

THE CITY OF PHILADELPHIA

OFFICE OF EMERGENCY MANAGEMENT

PHILADELPHIA PUBLIC SERVICES BUILDING

400 NORTH BROAD STREET, PHILADELPHIA, P,

FLOORS 8, 9 AND 10

■ PROGRESS SET □ CLIENT REVIEW ■ BID SET

☐ CODE REVIEW SET ■ ISSUED FOR CONSTRUCTION

> **ISSUED** FOR BIDS 09/18/2020


(NOT FOR CONSTRUCTION) ISSUES/REVISIONS: 1 9/18/2020 ISSUED FOR BIDS

304103-120 PROJECT NUMBER: 1/2" = 1'-0" SCALE: 09/18/2020 DATE: DRAWN BY: CHECKED BY:

DRAWING TITLE: ELEVATIONS

A-502

PRINTED ON: 9/22/2020 1:05:06 PM

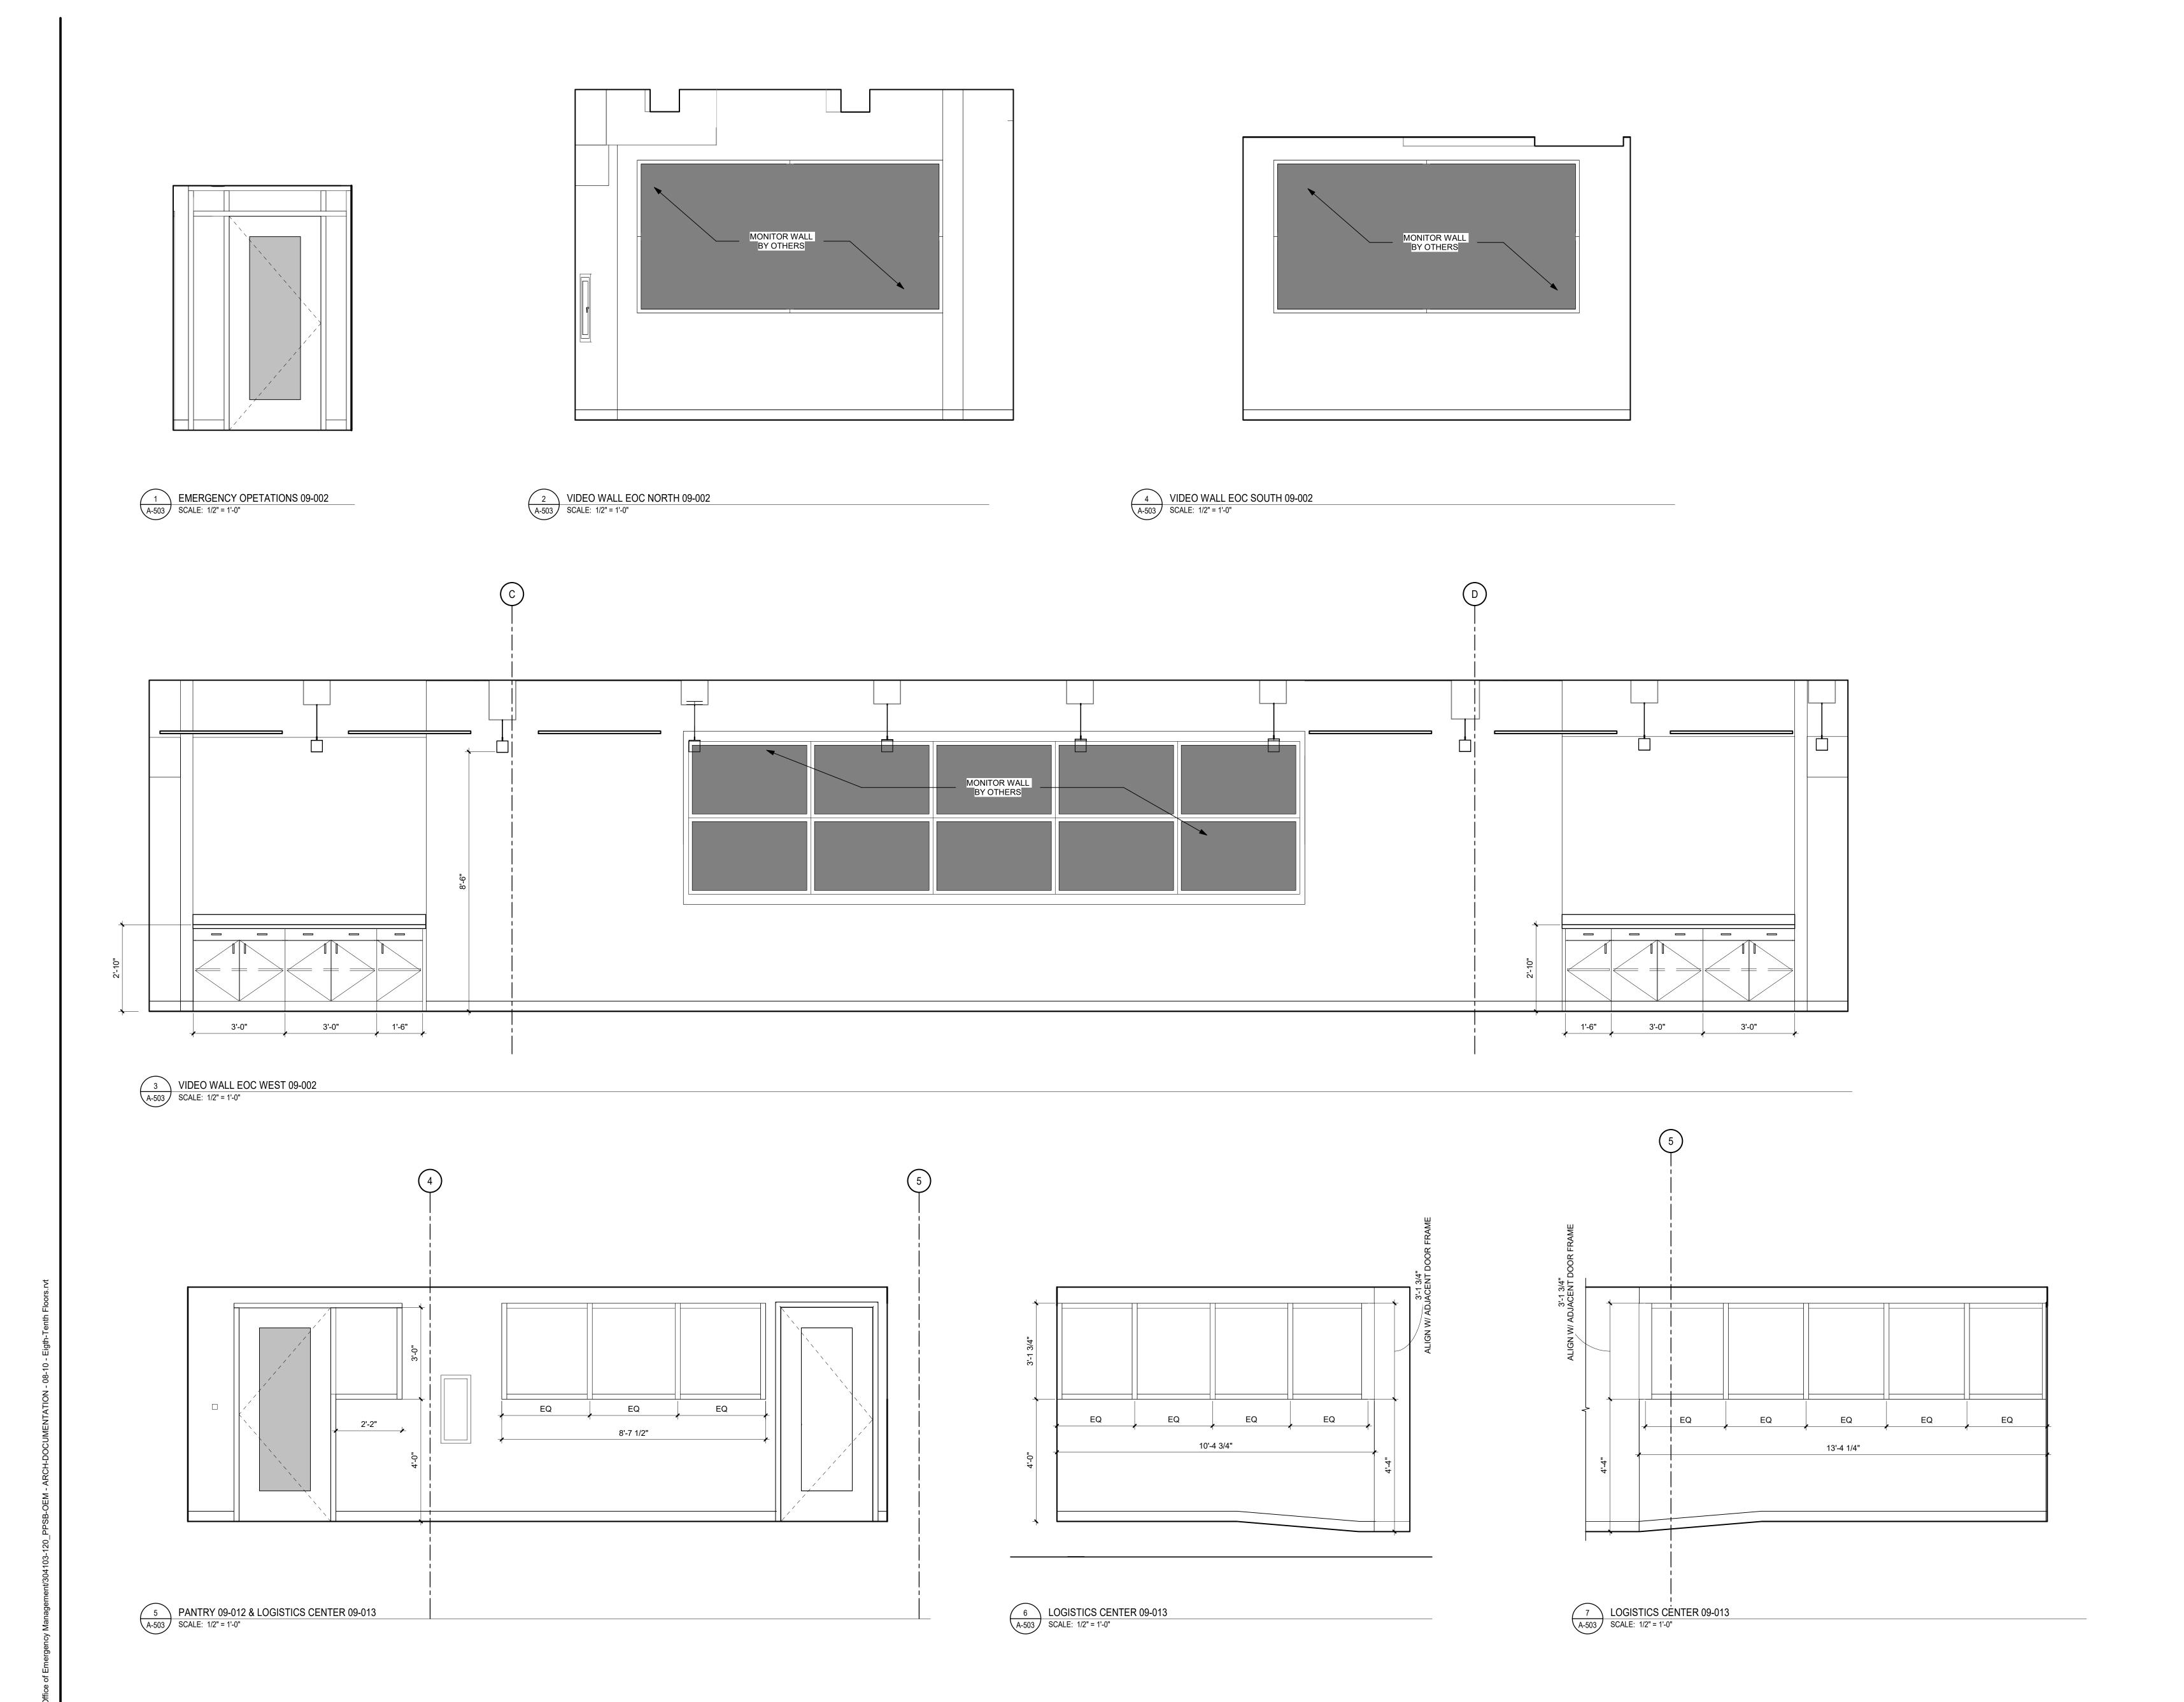



Telephone: 215.413.3700

CONSULTANTS:

Arora Engineers, Inc. 61 Wilmington-West Chester Pike Chadds Ford, PA 19317 P (610) 459-7900 F (610) 459-7950 aroraengineers.com



<u>O'Donnell & Naccarato</u> 701 Market Street, Suite 6000 Philadelphia, PA 19106 PH: 215.925.3788 www.o-n.com

LICENSE NO: <Architect's License #>

DESIGN PROFESSIONAL'S ELECTRONIC OR DIGITAL SEAL OR SIGNATURE IS EFFECTIVE ONLY AS TO THAT VERSION OF THIS DOCUMENT AS ORIGINALLY PUBLISHED BY DESIGN PROFESSIONAL. DESIGN PROFESSIONAL IS NOT RESPONSIBLE FOR ANY SUBSEQUENT MODIFICATION, CORRUPTION, OR UNAUTHORIZED USE OF SUCH DOCUMENT. TO VERIFY THE VALIDITY OR APPLICABILITY OF THE SEAL OR SIGNATURE CONTACT DESIGN PROFESSIONAL APPLICABILITY OF THE SEAL OR SIGNATURE, CONTACT DESIGN PROFESSIONAL.

■ PROGRESS SET ■ CLIENT REVIEW ■ BID SET

□ CODE REVIEW SET ■ ISSUED FOR CONSTRUCTION

ISSUED

FOR BIDS 09/18/2020 (NOT FOR CONSTRUCTION)


ISSUES/REVISIONS: 1 9/18/2020 ISSUED FOR BIDS


PROJECT NUMBER: SCALE: DATE: 1/2" = 1'-0" 09/18/2020 DRAWN BY: CHECKED BY:


DRAWING TITLE:
INTERIOR
ELEVATIONS


A-503


PRINTED ON: 9/22/2020 12:51:43 PM

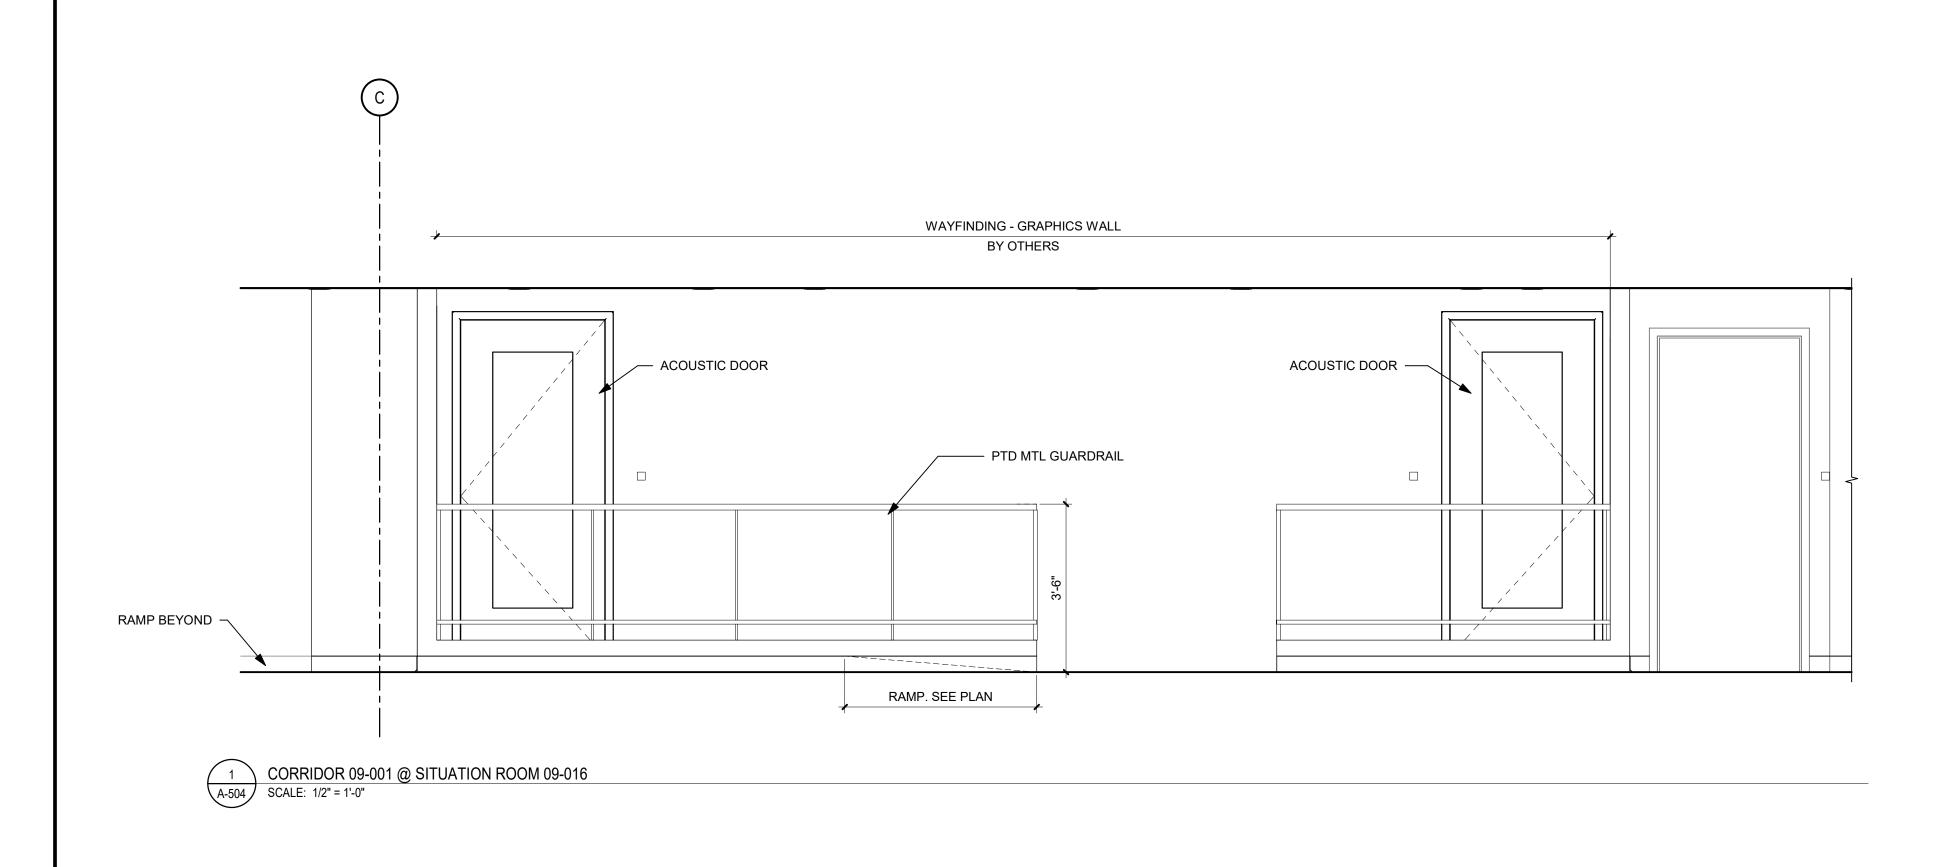


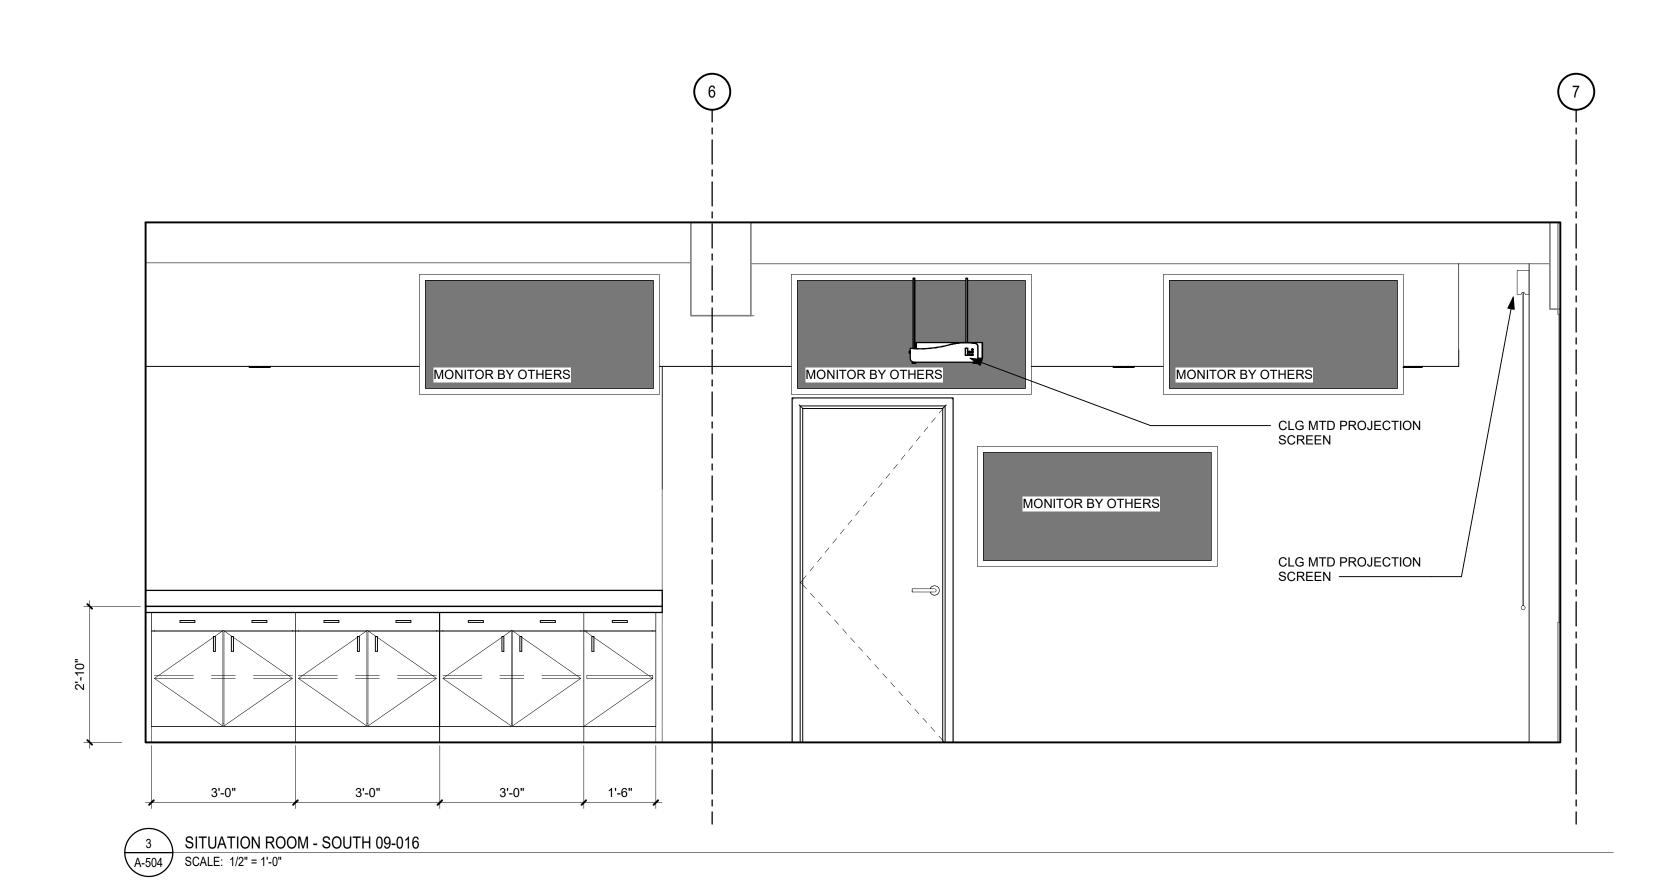

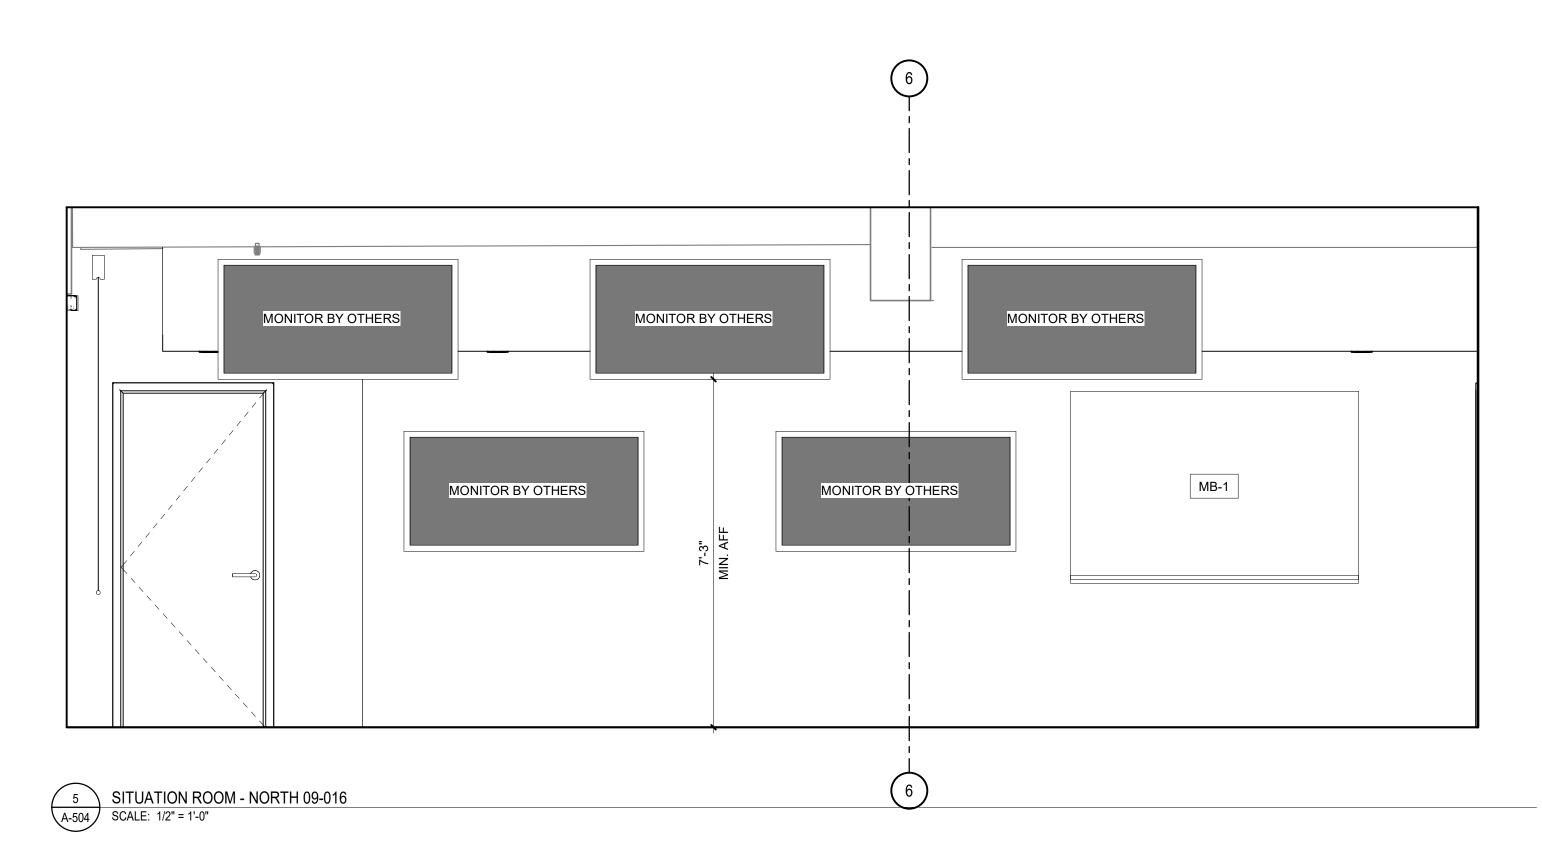

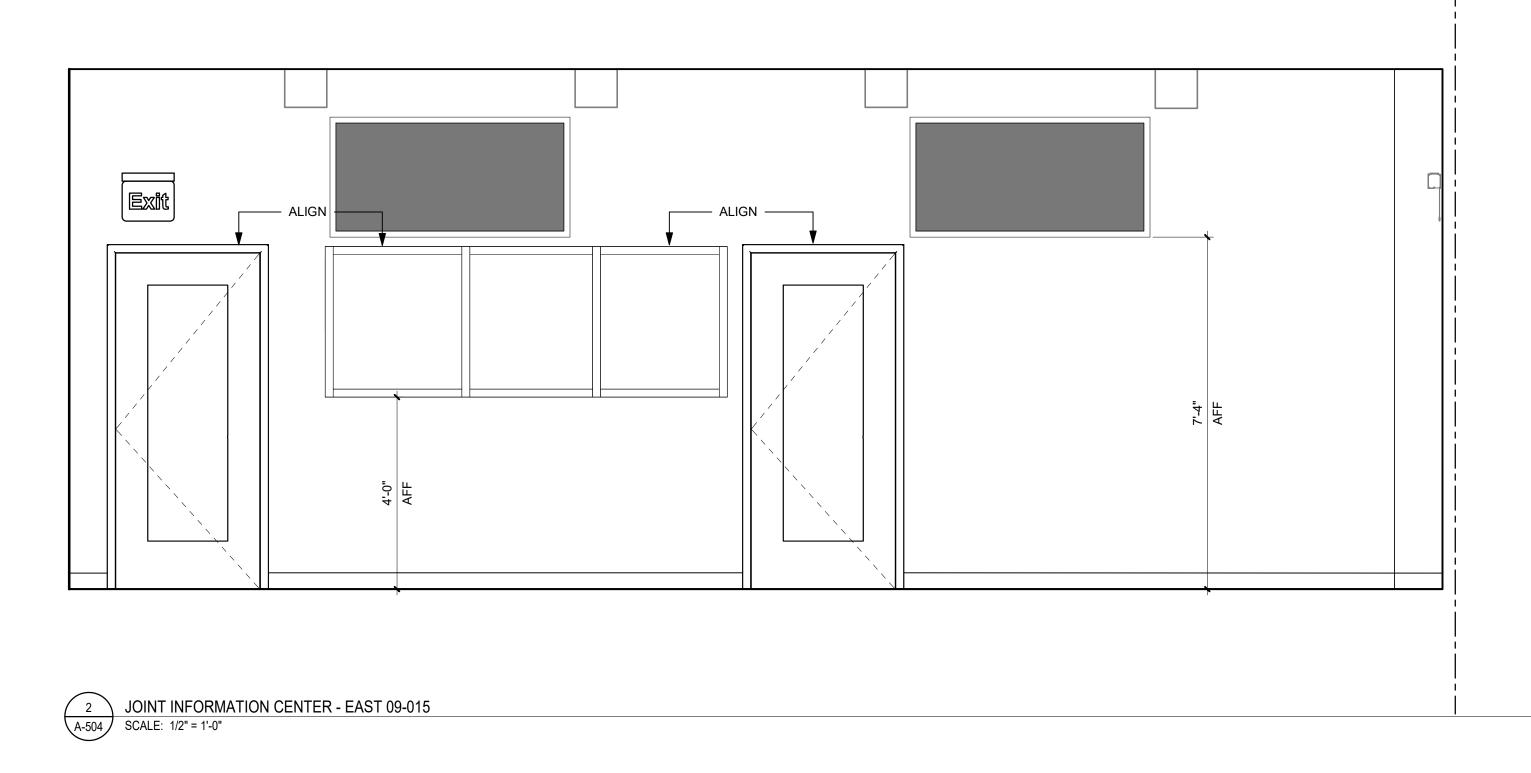

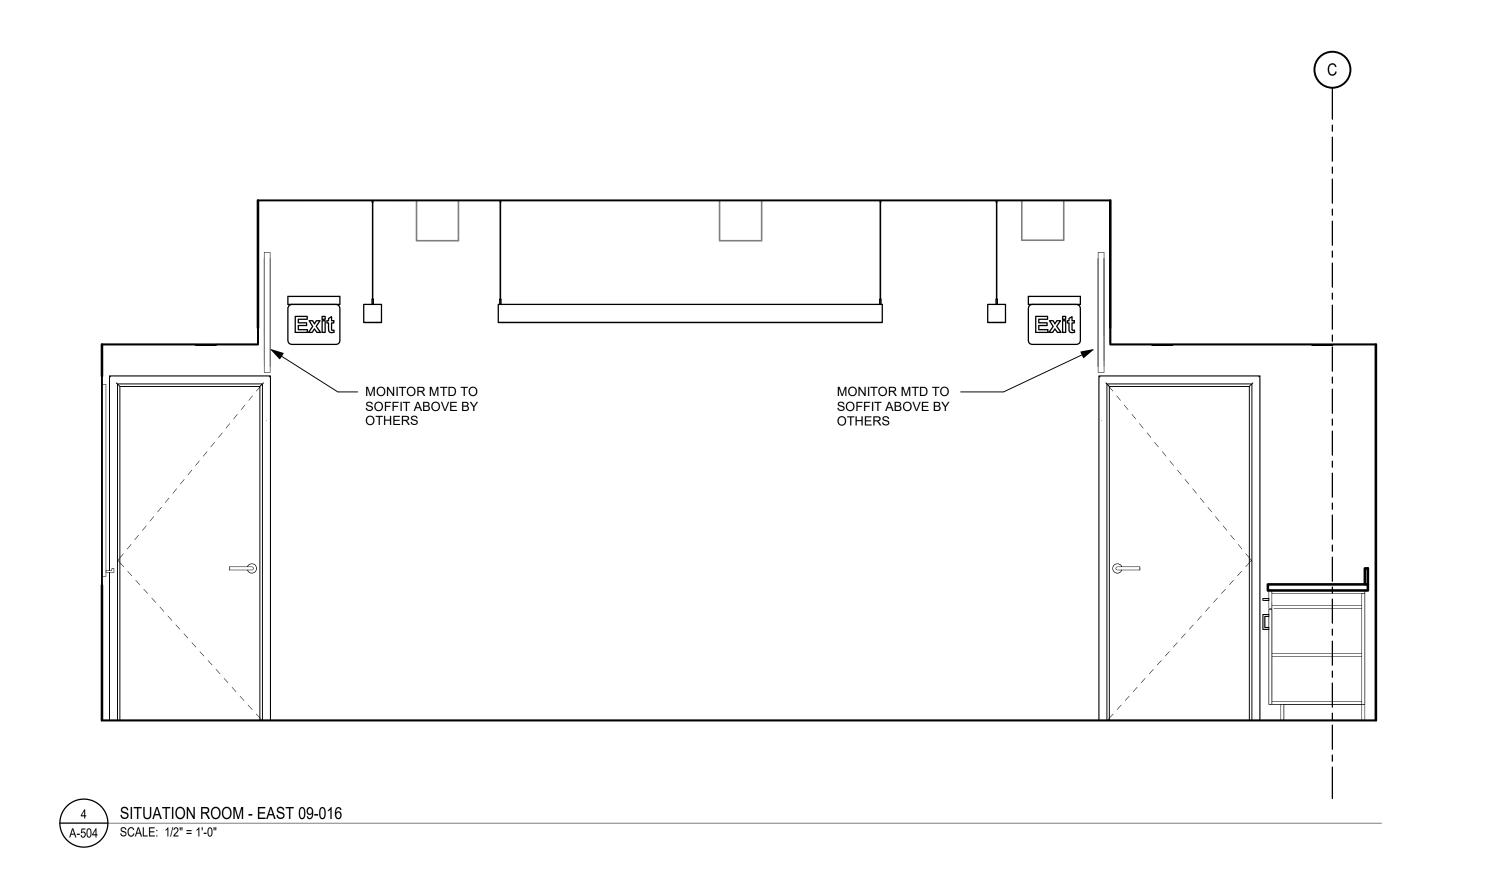

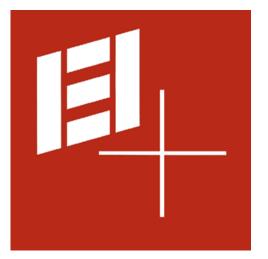

Telephone: 215.413.3700

CONSULTANTS:

ARORA°

Arora Engineers, Inc.
61 Wilmington-West Chester Pike
Chadds Ford, PA 19317



O'Donnell & Naccarato
701 Market Street, Suite 6000
Philadelphia, PA 19106
PH: 215.925.3788
www.o-n.com

LICENSE NO: <Architect's License #>

DESIGN PROFESSIONAL'S ELECTRONIC OR DIGITAL SEAL OR SIGNATURE IS EFFECTIVE ONLY AS TO THAT VERSION OF THIS DOCUMENT AS ORIGINALLY PUBLISHED BY DESIGN PROFESSIONAL. DESIGN PROFESSIONAL IS NOT RESPONSIBLE FOR ANY SUBSEQUENT MODIFICATION, CORRUPTION, OR UNAUTHORIZED USE OF SUICH DOCUMENT. TO VERIETY THE VALIDITY OF APPLICABILITY OF THE SEAL OR SIGNATURE CONTACT DESIGN ADPRESSIONAL

APPLICABILITY OF THE SEAL OR SIGNATURE, CONTACT DESIGN PROFESSIONAL.

CITY OF PHILADELPHIA
ICE OF EMERGENCY MANAGEMENT
ADELPHIA PUBLIC SERVICES BUILDING
NORTH BROAD STREET, PHILADELPHIA, PA 19

□ PROGRESS SET
□ CLIENT REVIEW

■ BID SET
■ CODE REVIEW SET

☐ ISSUED FOR CONSTRUCTION

ISSUED FOR BIDS 09/18/2020 (NOT FOR CONSTRUCTION)

ISSUES/REVISIONS:

1 9/18/2020 ISSUED FOR BIDS

PROJECT NUMBER: 304103-120 SCALE: 1/2" = 1'-0" DATE: 09/18/2020


DRAWN BY:
CHECKED BY:
DRAWING TITLE:
INTERIOR

ELEVATIONS

SHEET NO:

A-504

PRINTED ON: 9/22/2020 12:51:44 PM

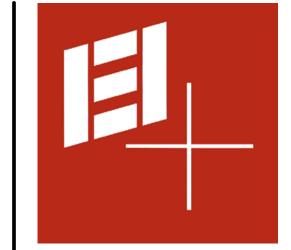

Telephone: 215.413.3700

CONSULTANTS:

ARORA°

Arora Engineers, Inc. 61 Wilmington-West Chester Pike Chadds Ford, PA 19317 P (610) 459-7900 F (610) 459-7950 aroraengineers.com



<u>O'Donnell & Naccarato</u> 701 Market Street, Suite 6000 Philadelphia, PA 19106 PH: 215.925.3788 www.o-n.com

LICENSE NO: <Architect's License #>

DESIGN PROFESSIONAL'S ELECTRONIC OR DIGITAL SEAL OR SIGNATURE IS EFFECTIVE ONLY AS TO THAT VERSION OF THIS DOCUMENT AS ORIGINALLY PUBLISHED BY DESIGN PROFESSIONAL. DESIGN PROFESSIONAL IS NOT RESPONSIBLE FOR ANY SUBSEQUENT MODIFICATION, CORRUPTION, OR UNAUTHORIZED USE OF SUCH DOCUMENT. TO VERIFY THE VALIDITY OR APPLICABILITY OF THE SEAL OR SIGNATURE CONTACT DESIGN PROFESSIONAL APPLICABILITY OF THE SEAL OR SIGNATURE, CONTACT DESIGN PROFESSIONAL.

■ PROGRESS SET □ CLIENT REVIEW ■ BID SET

☐ CODE REVIEW SET ■ ISSUED FOR CONSTRUCTION

> ISSUED FOR BIDS 09/18/2020

(NOT FOR CONSTRUCTION) ISSUES/REVISIONS: 1 9/18/2020 ISSUED FOR BIDS


PROJECT NUMBER: SCALE: DATE: DRAWN BY: CHECKED BY:


1/2" = 1'-0" 09/18/2020


DRAWING TITLE: ELEVATIONS


A-505


PRINTED ON: 9/22/2020 12:51:46 PM

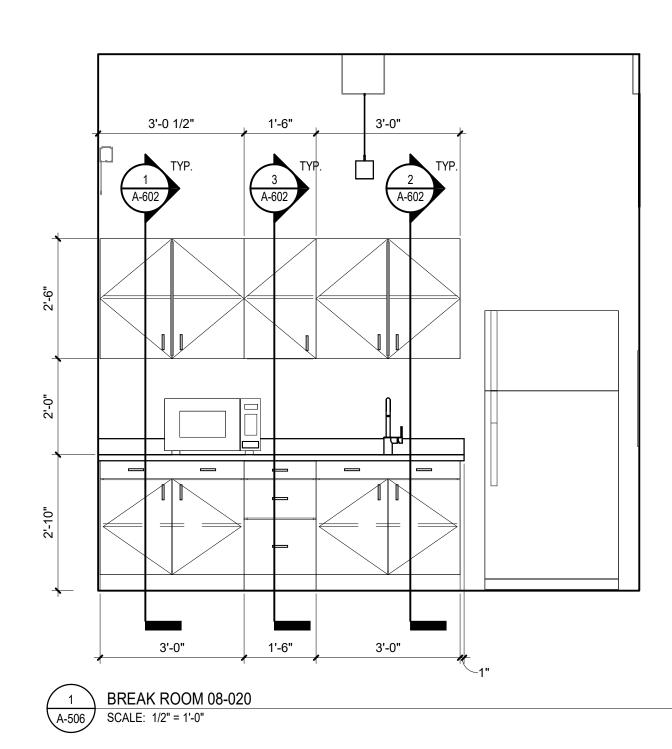


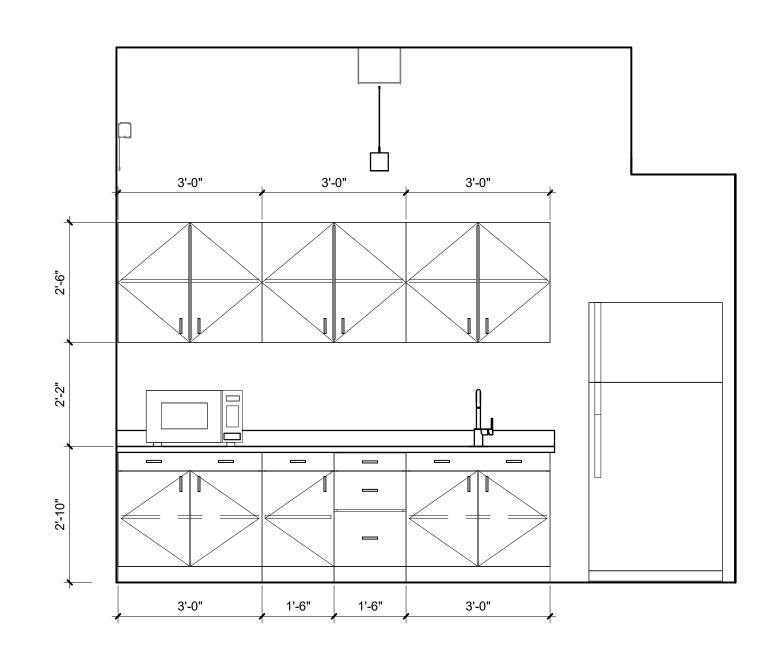


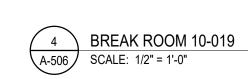

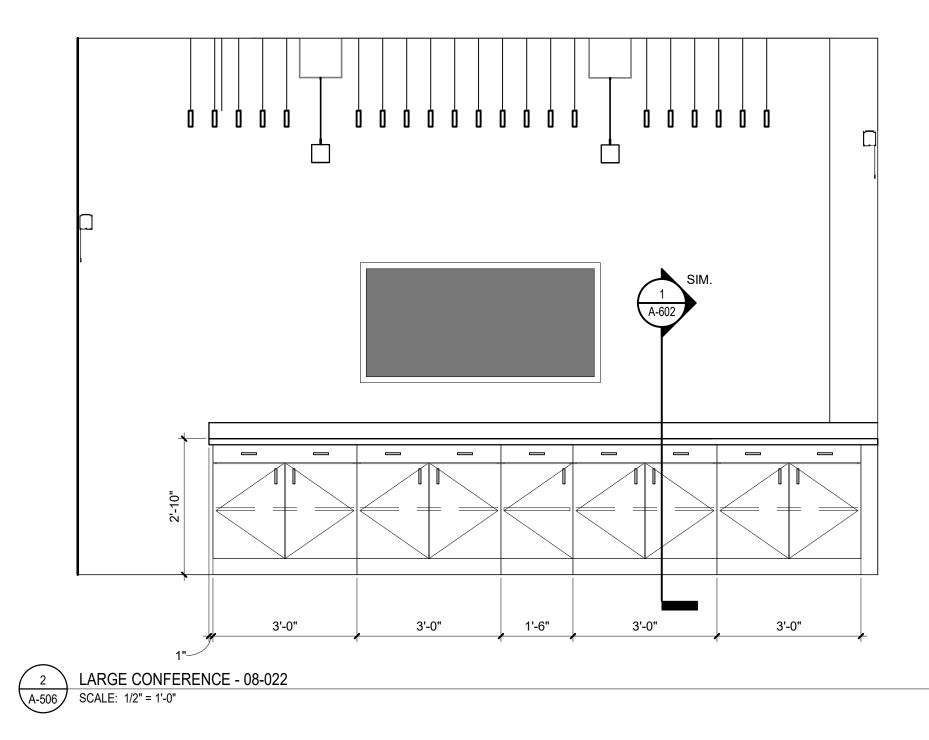

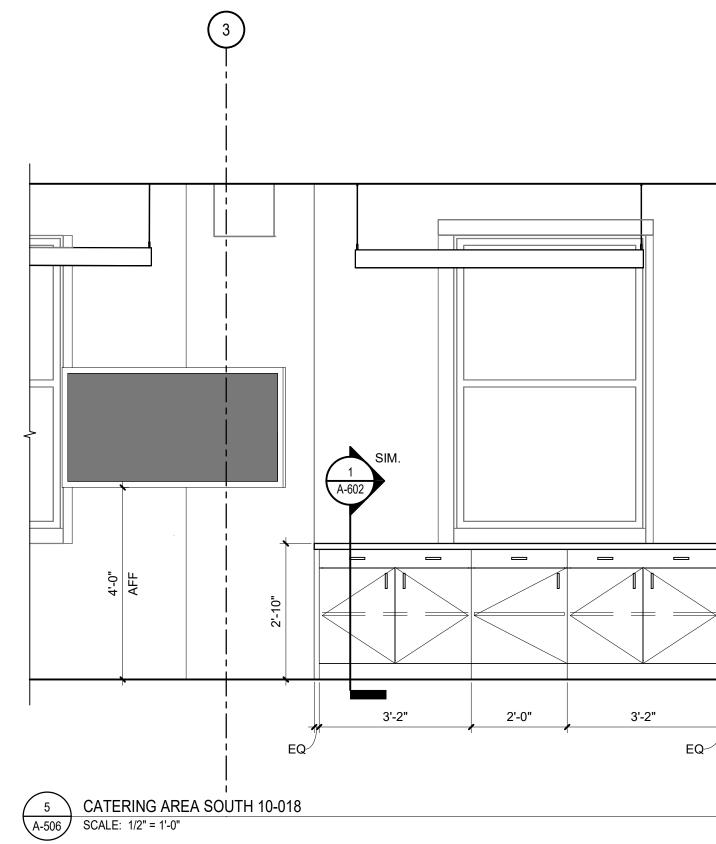

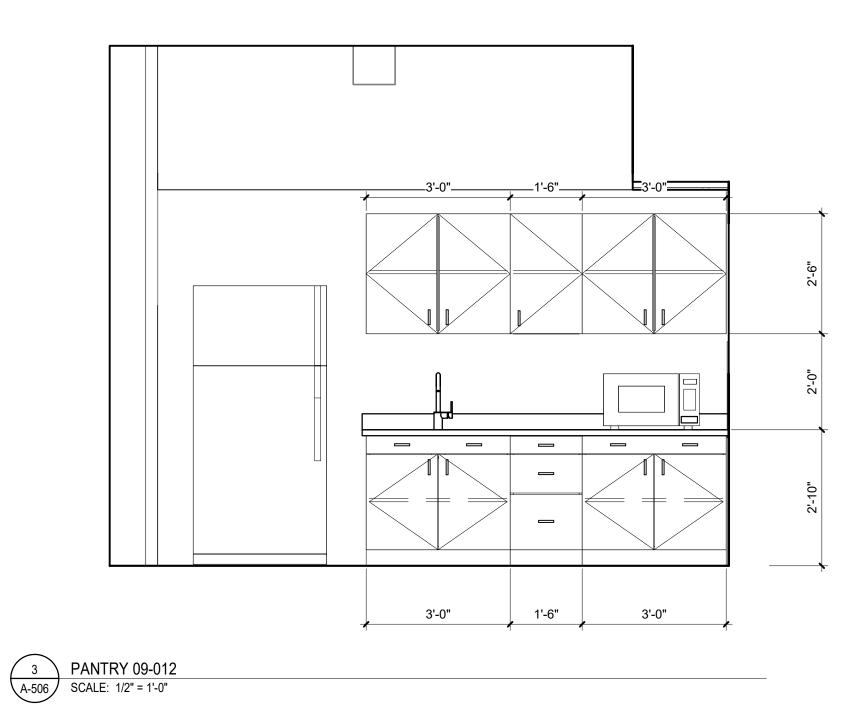

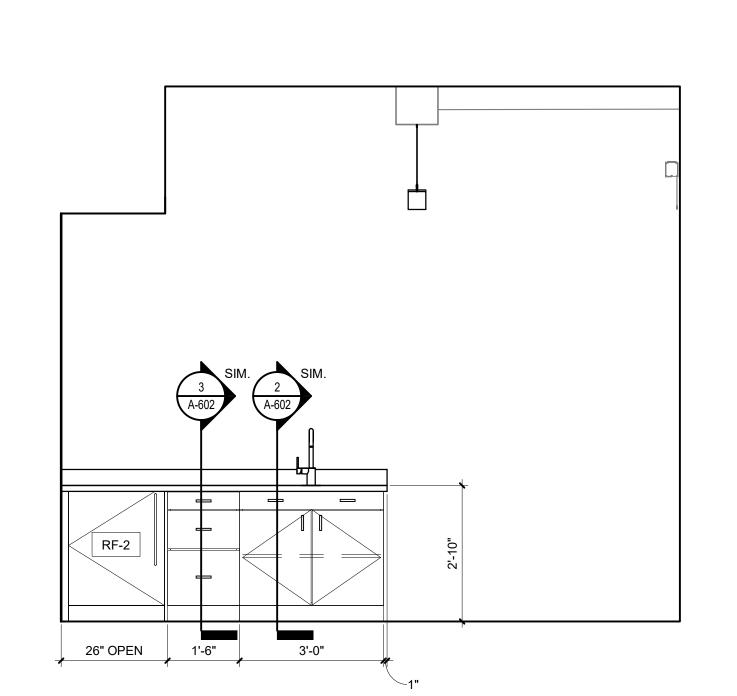

6 LACTATION ROOM 10-020 SCALE: 1/2" = 1'-0"



IEI GROUP, LTD. IEI ARCHITECTS, INC. 428 North 2nd Street Philadelphia, PA 19123 Telephone: 215.413.3700

CONSULTANTS: **ARORA**°

Arora Engineers, Inc. 61 Wilmington-West Chester Pike Chadds Ford, PA 19317 P (610) 459-7900 F (610) 459-7950 aroraengineers.com



<u>O'Donnell & Naccarato</u> 701 Market Street, Suite 6000 Philadelphia, PA 19106 PH: 215.925.3788 www.o-n.com

LICENSE NO: <Architect's License #>

DESIGN PROFESSIONAL'S ELECTRONIC OR DIGITAL SEAL OR SIGNATURE IS EFFECTIVE ONLY AS TO THAT VERSION OF THIS DOCUMENT AS ORIGINALLY PUBLISHED BY DESIGN PROFESSIONAL. DESIGN PROFESSIONAL IS NOT RESPONSIBLE FOR ANY SUBSEQUENT MODIFICATION, CORRUPTION, OR UNAUTHORIZED USE OF SUCH DOCUMENT. TO VERIFY THE VALIDITY OR APPLICABILITY OF THE SEAL OR SIGNATURE CONTACT DESIGN PROFESSIONAL APPLICABILITY OF THE SEAL OR SIGNATURE, CONTACT DESIGN PROFESSIONAL.

■ PROGRESS SET □ CLIENT REVIEW

■ BID SET ☐ CODE REVIEW SET ■ ISSUED FOR CONSTRUCTION


> ISSUED FOR BIDS 09/18/2020

(NOT FOR CONSTRUCTION) ISSUES/REVISIONS: 1 9/18/2020 ISSUED FOR BIDS

PROJECT NUMBER: 304103-120 SCALE: DATE: 1/2" = 1'-0" 09/18/2020 DRAWN BY: CHECKED BY:

DRAWING TITLE: ELEVATIONS

PRINTED ON: 9/22/2020 12:51:47 PM

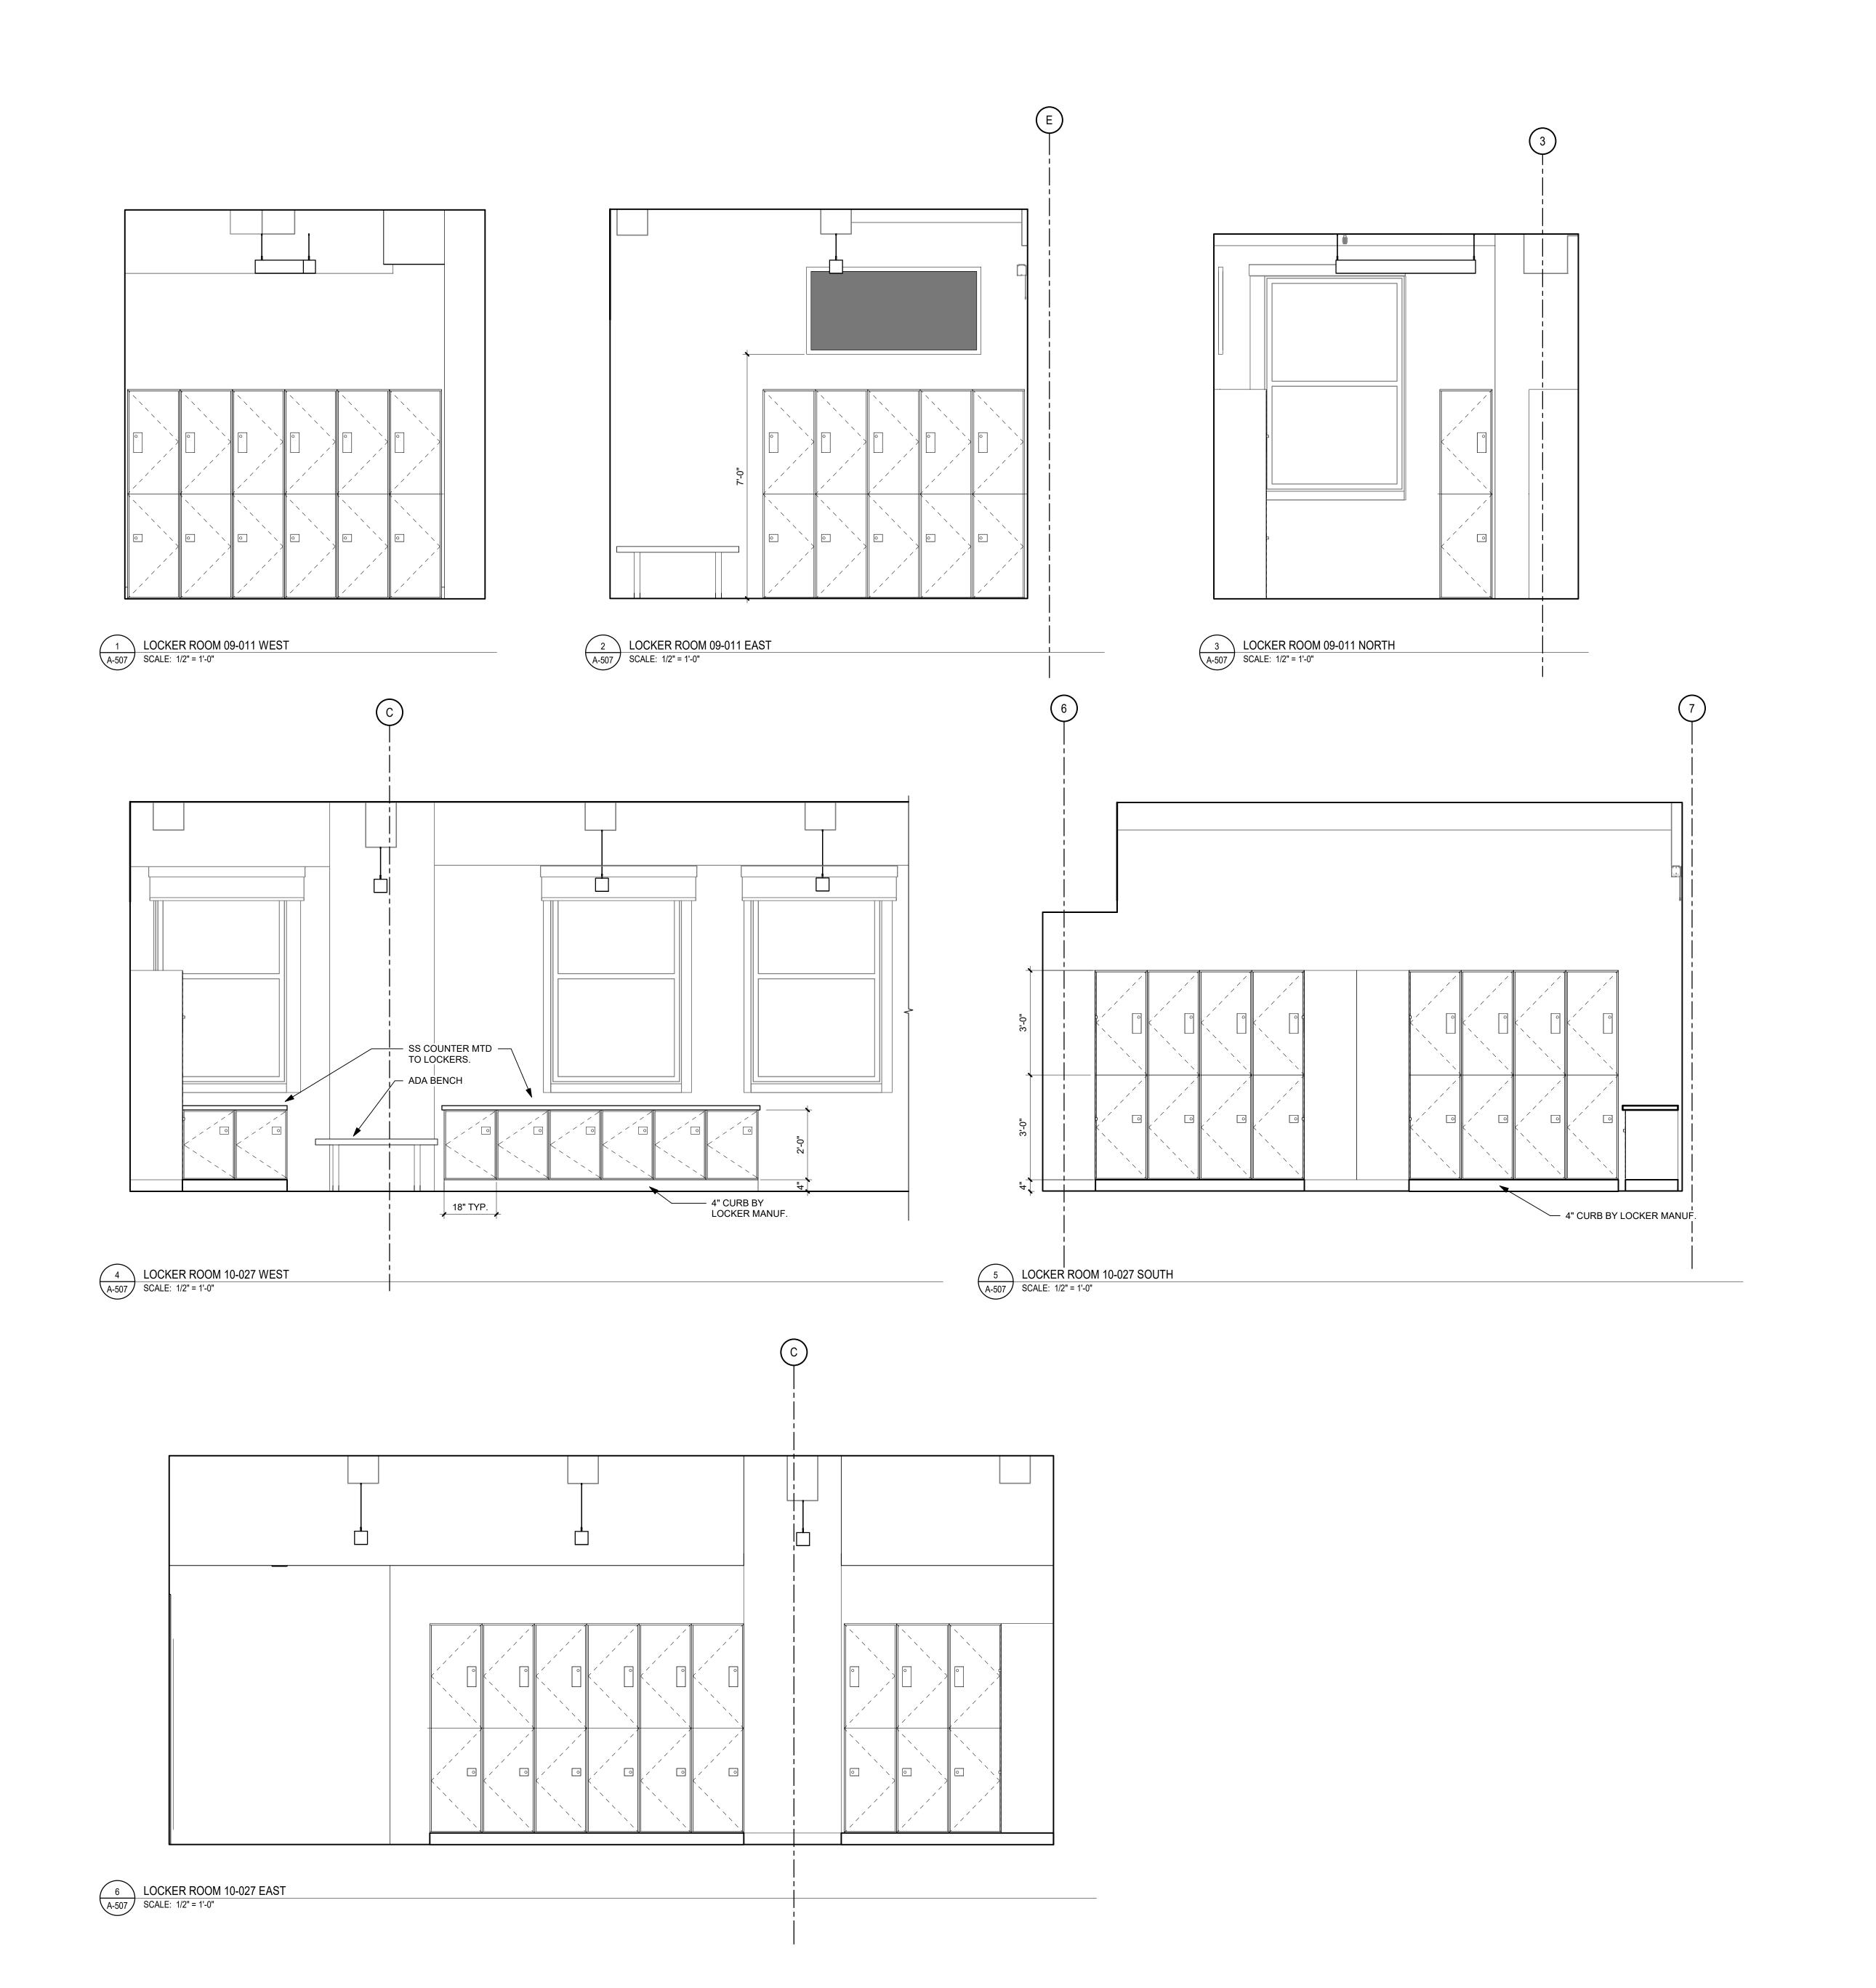



Telephone: 215.413.3700 CONSULTANTS:

Arora Engineers, Inc. 61 Wilmington-West Chester Pike Chadds Ford, PA 19317 P (610) 459-7900 F (610) 459-7950 aroraengineers.com



<u>O'Donnell & Naccarato</u> 701 Market Street, Suite 6000 Philadelphia, PA 19106 PH: 215.925.3788 www.o-n.com

LICENSE NO: <Architect's License #>

DESIGN PROFESSIONAL'S ELECTRONIC OR DIGITAL SEAL OR SIGNATURE IS EFFECTIVE ONLY AS TO THAT VERSION OF THIS DOCUMENT AS ORIGINALLY PUBLISHED BY DESIGN PROFESSIONAL. DESIGN PROFESSIONAL IS NOT RESPONSIBLE FOR ANY SUBSEQUENT MODIFICATION, CORRUPTION, OR UNAUTHORIZED USE OF SUCH DOCUMENT. TO VERIFY THE VALIDITY OR ADDICATOR TO SECONDAL PROFESSIONAL. APPLICABILITY OF THE SEAL OR SIGNATURE, CONTACT DESIGN PROFESSIONAL.

THE CITY OF PHILADELPHIA

OFFICE OF EMERGENCY MANAGEMENT

PHILADELPHIA PUBLIC SERVICES BUILDING

400 NORTH BROAD STREET, PHILADELPHIA, P.
FLOORS 8, 9 AND 10

■ PROGRESS SET □ CLIENT REVIEW

■ BID SET ☐ CODE REVIEW SET ■ ISSUED FOR CONSTRUCTION

ISSUED FOR BIDS

09/18/2020 (NOT FOR CONSTRUCTION)

ISSUES/REVISIONS: 1 9/18/2020 ISSUED FOR BIDS

PROJECT NUMBER: SCALE: DATE: 1/2" = 1'-0" 09/18/2020 DRAWN BY: CHECKED BY:

DRAWING TITLE:


LOCKER ROOM ELEVATIONS


A-507


PRINTED ON: 9/22/2020 12:52:00 PM

EXPOSED CEILING DETAIL @ EXTERIOR WINDOW - TYP. (APPROVED 11.23.19 SUBMISSION)

SCALE: 1 1/2" = 1'-0"

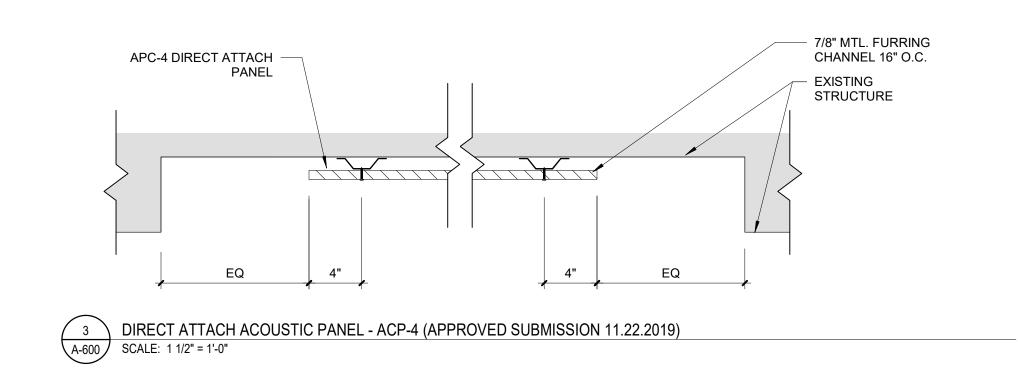


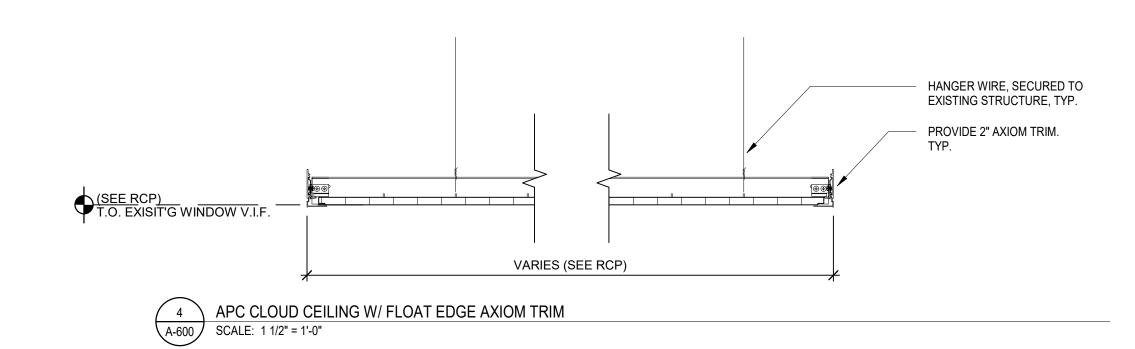


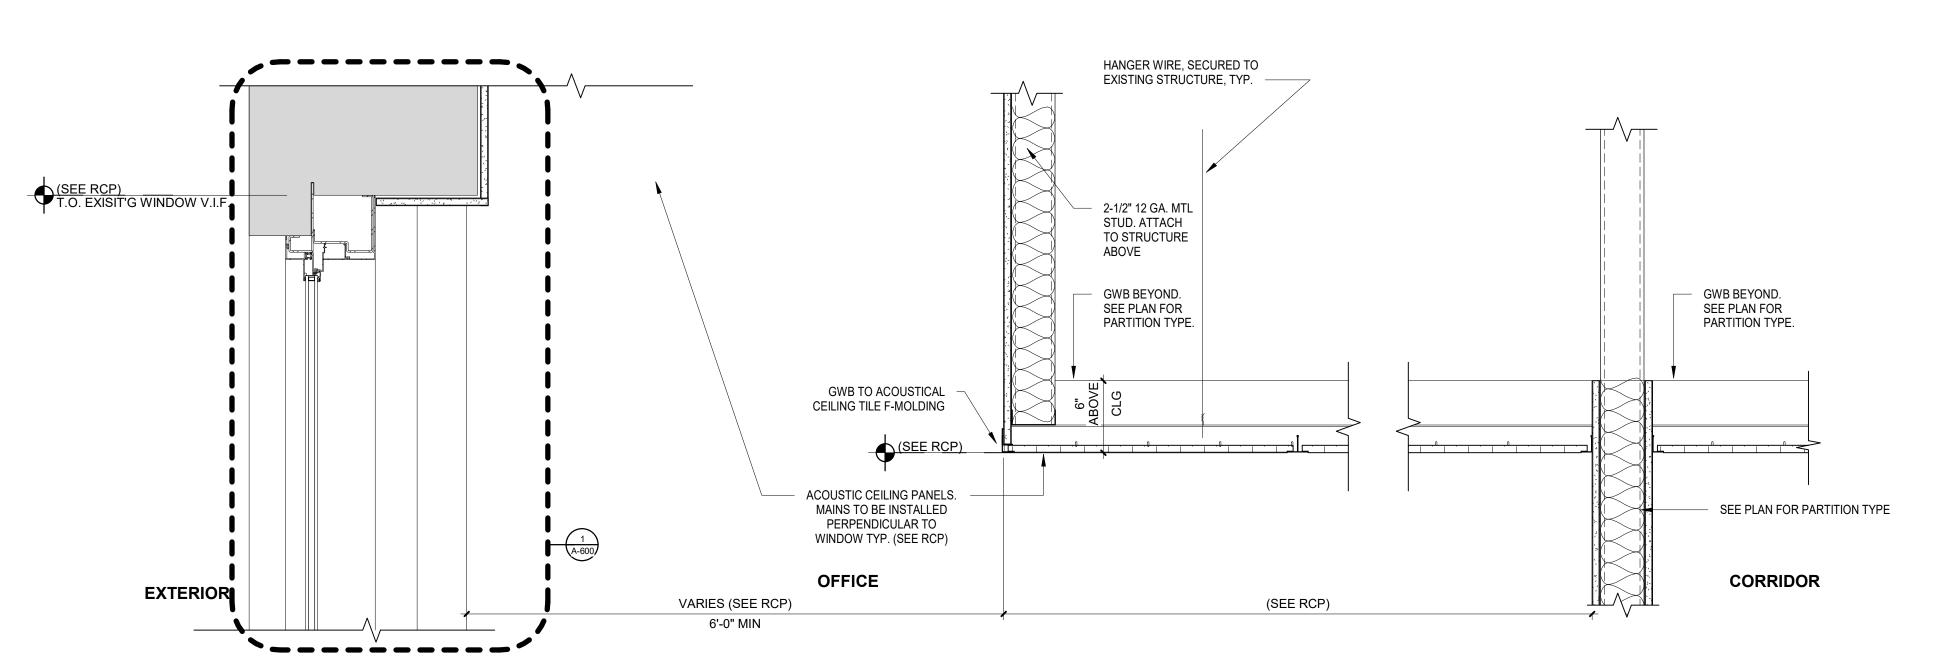



APC TO EXPOSED CEILING BULKHEAD @ EXTERIOR WINDOW - TYP. (APPROVED SUBMISSION 11.22.2019)


SCALE: 1 1/2" = 1'-0"

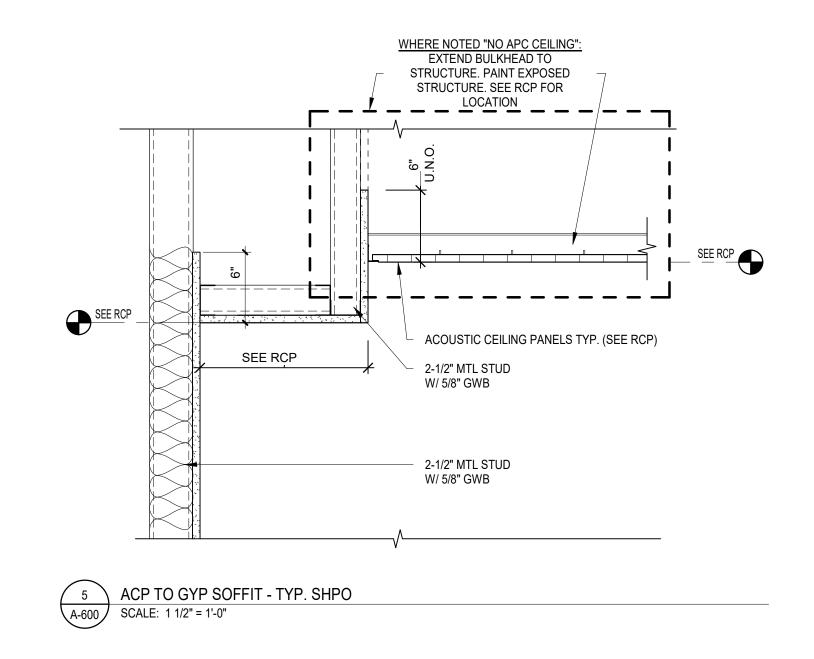

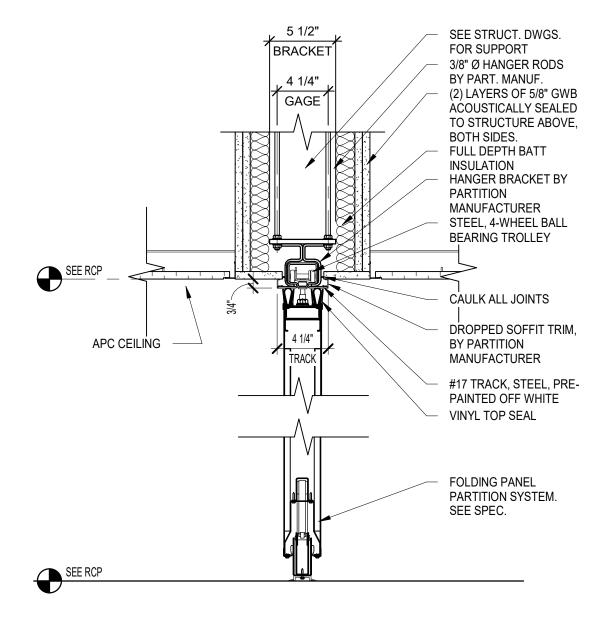

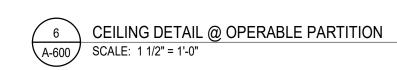

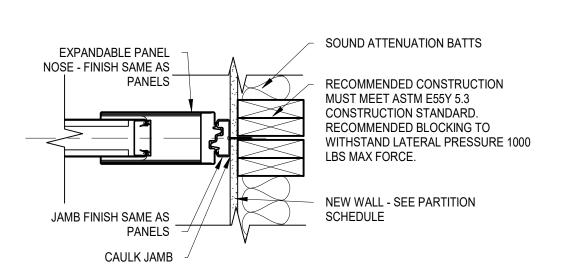

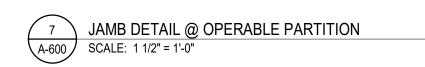



IEI GROUP, LTD.
IEI ARCHITECTS, INC.

428 North 2nd Street
Philadelphia, PA 19123
Telephone: 215.413.3700

CONSULTANTS:

ARORA®

Arora Engineers, Inc.
61 Wilmington-West Chester Pike
Chadds Ford, PA 19317
P (610) 459-7900
F (610) 459-7950



O'Donnell & Naccarato
701 Market Street, Suite 6000
Philadelphia, PA 19106
PH: 215.925.3788
www.o-n.com

LICENSE NO: <Architect's License #>

DESIGN PROFESSIONAL'S ELECTRONIC OR DIGITAL SEAL OR SIGNATURE IS EFFECTIVE ONLY AS TO THAT VERSION OF THIS DOCUMENT AS ORIGINALLY PUBLISHED BY DESIGN PROFESSIONAL. DESIGN PROFESSIONAL IS NOT RESPONSIBLE FOR ANY SUBSCULENT MODIFICATION, CORRUPTION, OR RUMALITED FOR ANY SUBSCULENT MODIFICATION, CORRUPTION, OR

DESIGN PROFESSIONAL'S ELECTRONIC OR DIGITAL SEAL OR SIGNATURE IS EFFECTIVE ONLY AS TO THAT VERSION OF THIS DOCUMENT AS ORIGINALLY PUBLISHED BY DESIGN PROFESSIONAL DESIGN PROFESSIONAL IS NOT RESPONSIBLE FOR ANY SUBSEQUENT MODIFICATION, CORRUPTION, OR UNAUTHORIZED USE OF SUCH DOCUMENT. TO VERIFY THE VALIDITY OR APPLICABILITY OF THE SEAL OR SIGNATURE, CONTACT DESIGN PROFESSIONAL.

THE CITY OF PHILADELPHIA
OFFICE OF EMERGENCY MANAGEMENT
PHILADELPHIA PUBLIC SERVICES BUILDING
400 NORTH BROAD STREET, PHILADELPHIA, P.
FLOORS 8, 9 AND 10

□ PROGRESS SET
□ CLIENT REVIEW

■ BID SET
■ CODE REVIEW SET

ISSUED FOR BIDS 09/18/2020

☐ ISSUED FOR CONSTRUCTION

(NOT FOR CONSTRUCTION)

ISSUES/REVISIONS:


1 9/18/2020 ISSUED FOR BIDS

PROJECT NUMBER: 304103-120
SCALE: 1 1/2" = 1'-0"
DATE: 09/18/2020
DRAWN BY: SM
CHECKED BY: PT

DRAWING TITLE:
CEILING DETAILS

A-600


PRINTED ON: 9/22/2020 3:02:00 PM

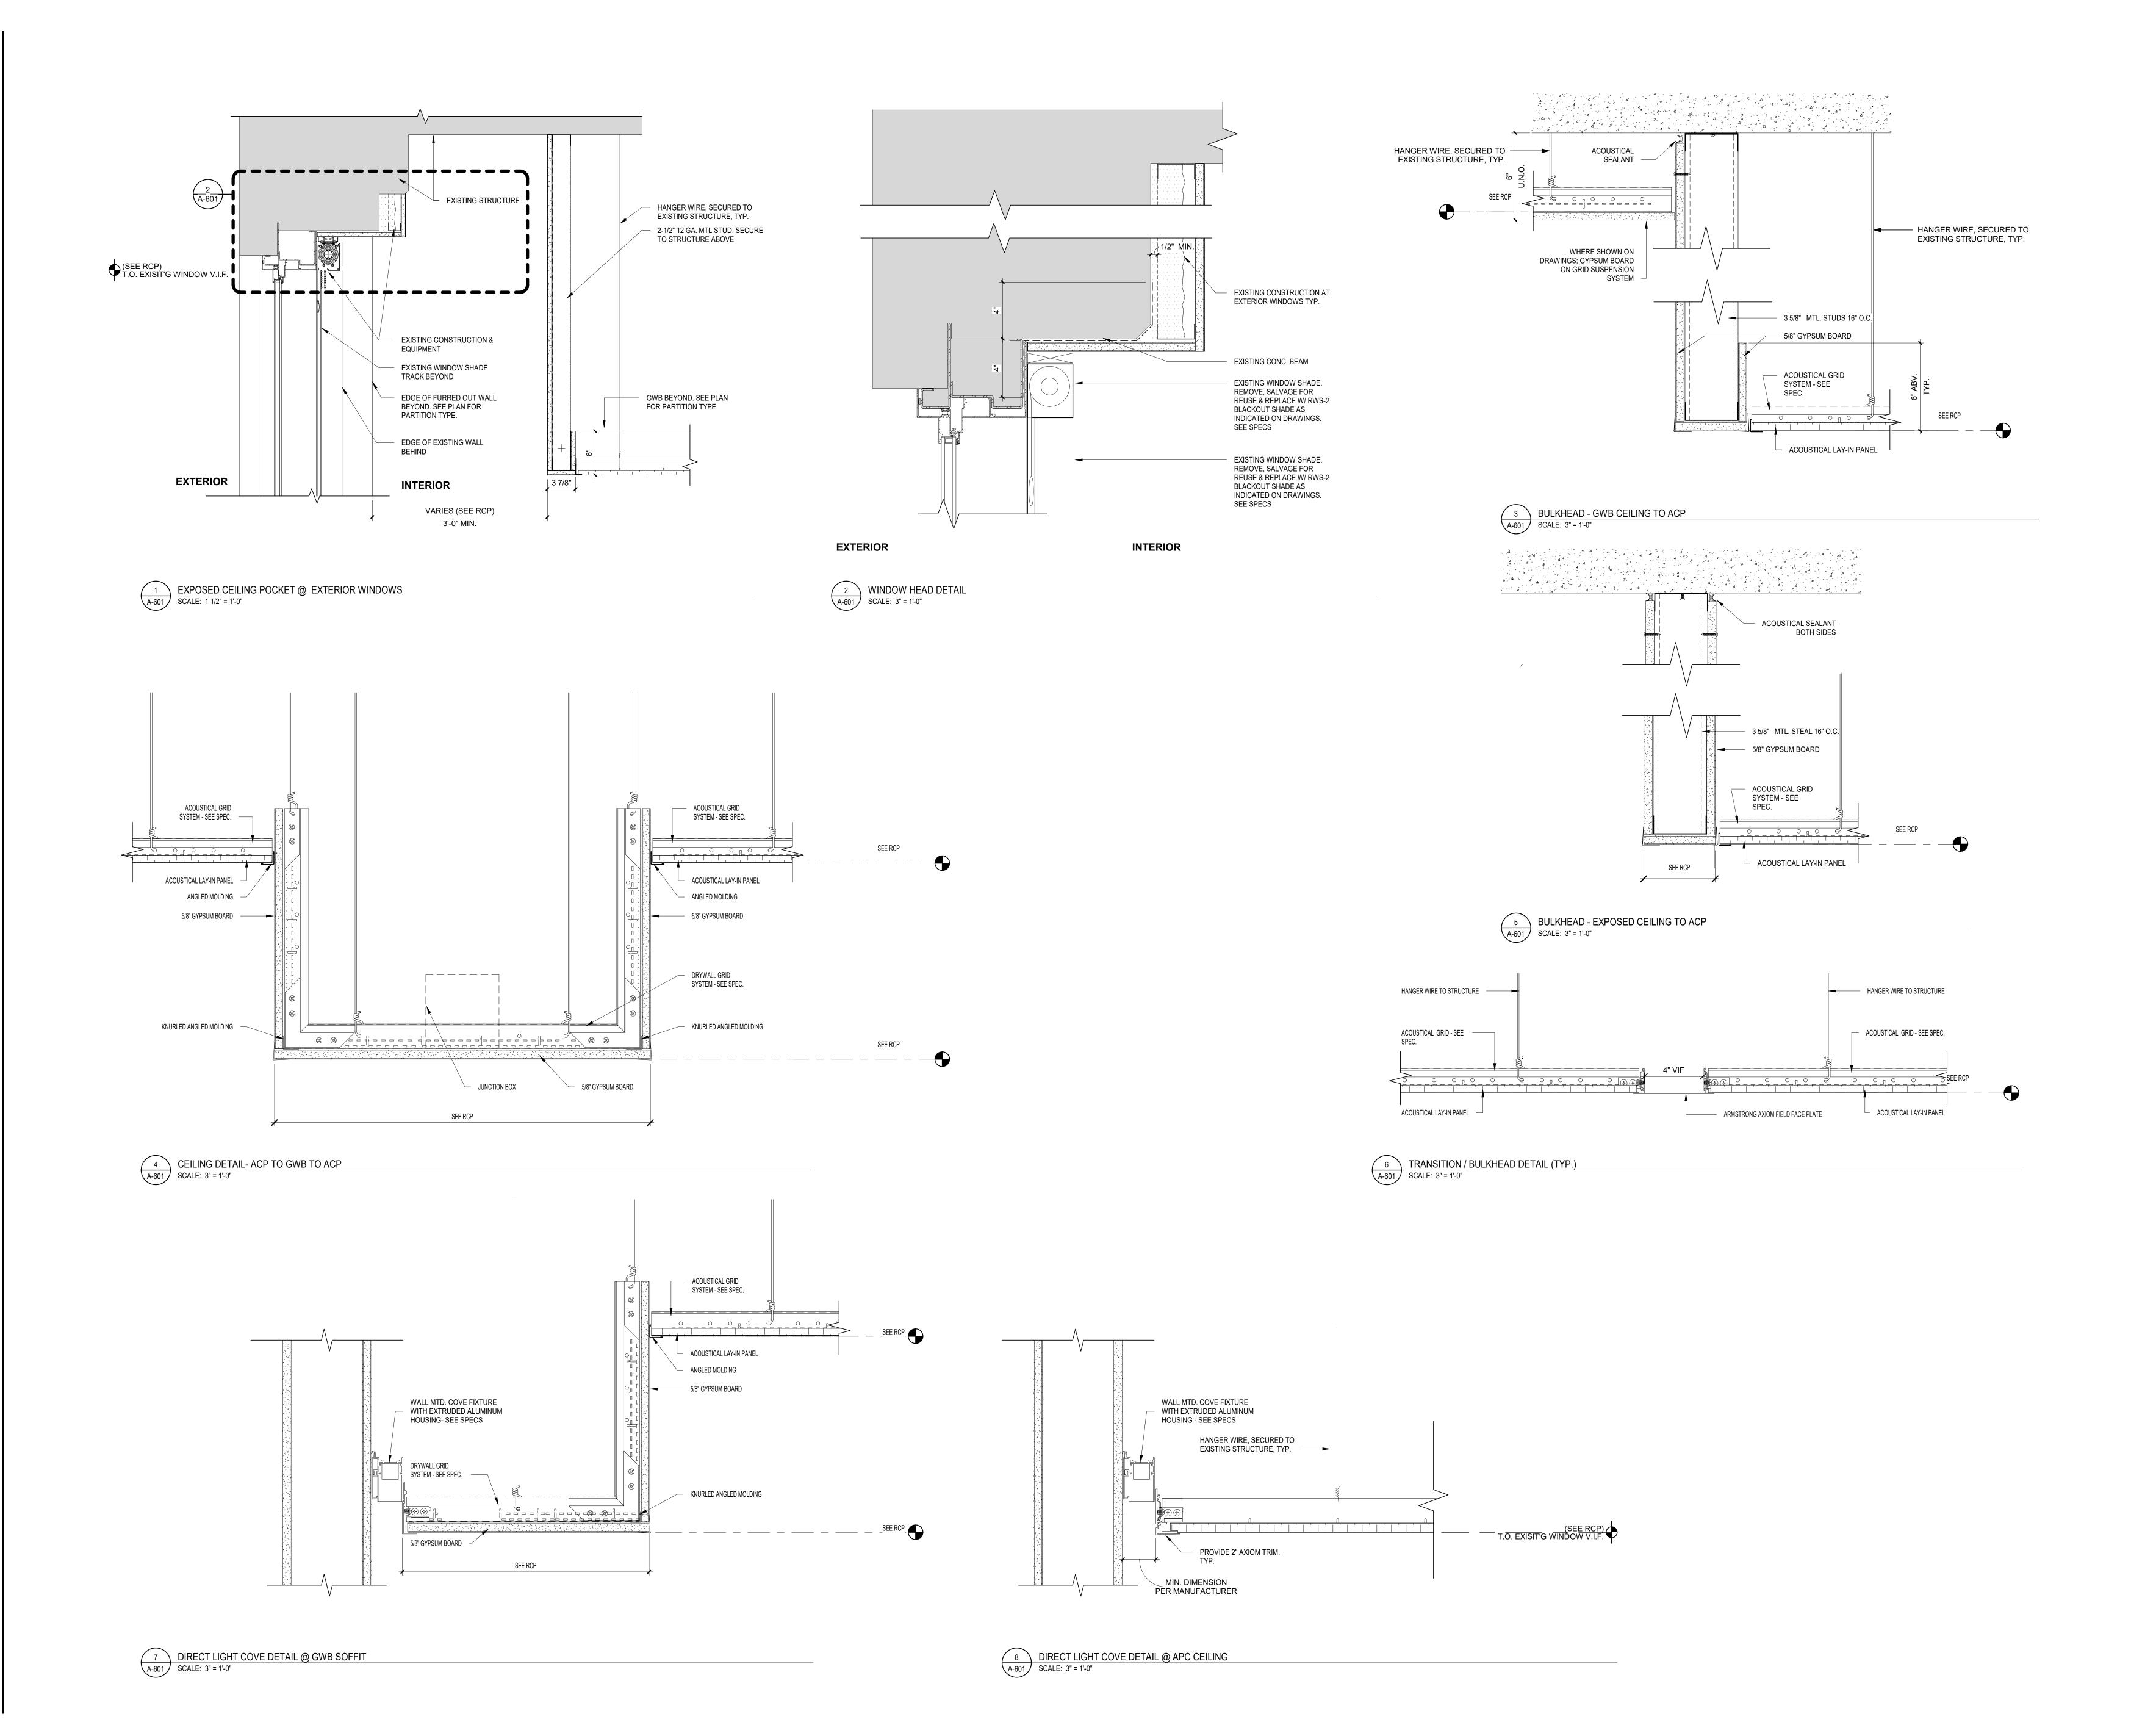

Telephone: 215.413.3700

CONSULTANTS:



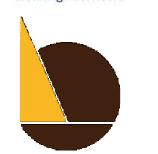

O'Donnell & Naccarato 701 Market Street, Suite 6000 Philadelphia, PA 19106 PH: 215.925.3788 www.o-n.com

LICENSE NO: <Architect's License #>

DESIGN FROE SOLUTE. SELECTIONS OF THIS DOCUMENT AS ORIGINALLY PUBLISHED BY DESIGN PROFESSIONAL. DESIGN PROFESSIONAL IS NOT RESPONSIBLE FOR ANY SUBSEQUENT MODIFICATION, CORRUPTION, OR UNAUTHORIZED USE OF SUCH DOCUMENT. TO VERIETY THE VALIDITY OR APPLICABILITY OF THE SEAL OR SIGNATURE, CONTACT DESIGN PROFESSIONAL.

PROGRESS SET CLIENT REVIEW

■ BID SET CODE REVIEW SET ☐ ISSUED FOR CONSTRUCTION

> ISSUED FOR BIDS 09/18/2020


(NOT FOR CONSTRUCTION) ISSUES/REVISIONS: 1 9/18/2020 ISSUED FOR BIDS

PROJECT NUMBER: SCALE: As indicated DATE: DRAWN BY: CHECKED BY:

DRAWING TITLE: CEILING DETAILS

A-601

PRINTED ON: 9/22/2020 3:02:02 PM

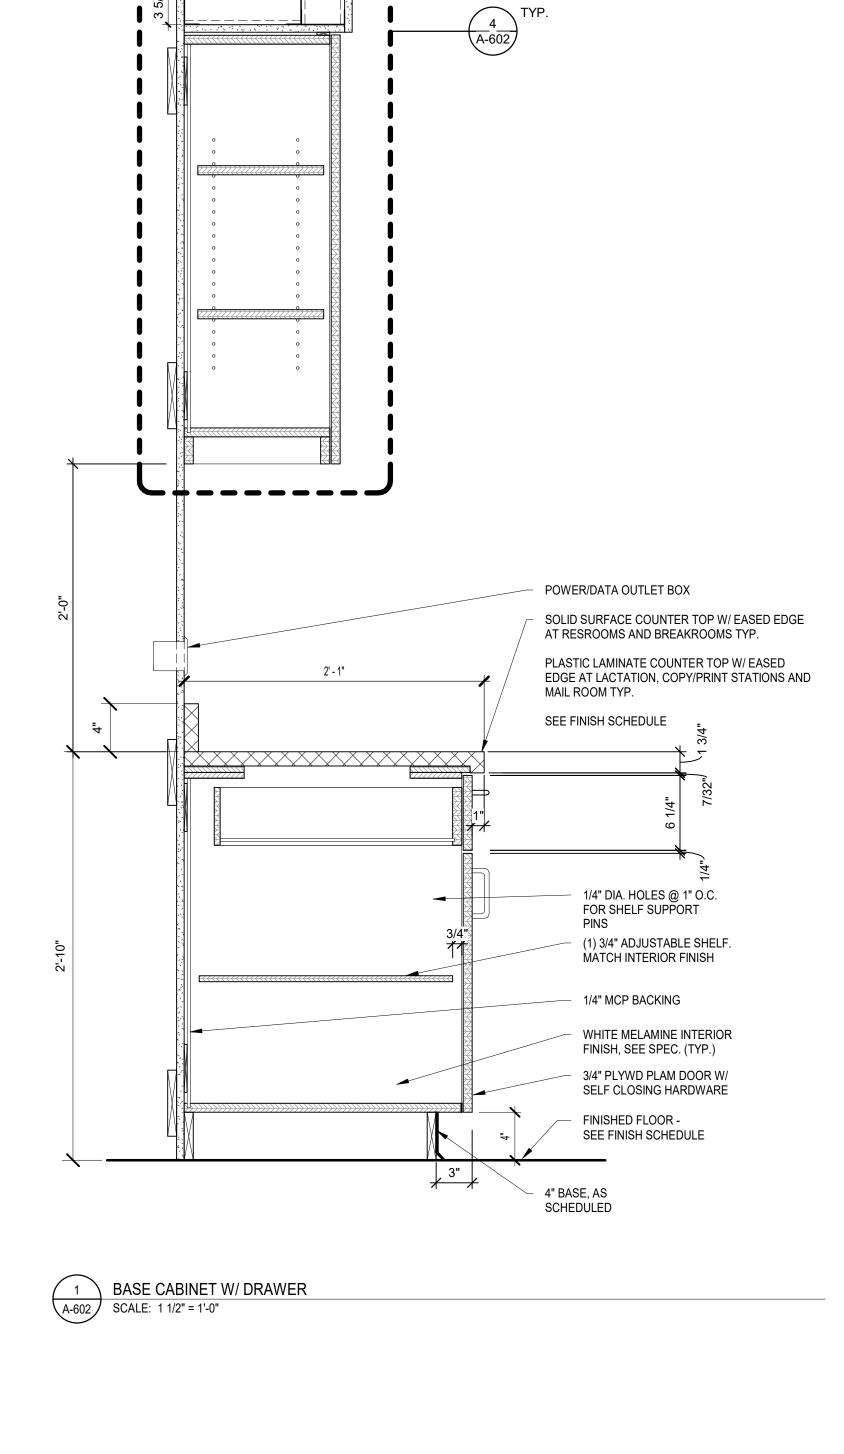

WHERE NOTED "NO ACP CEILING": EXTEND BULKHEAD TO

STRUCTURE. PAINT EXPOSED

STRUCTURE. SEE RCP FOR LOCATION

ACP CEILING

GWB SOFFIT

BLOCKING

SUPPORT PINS

- 1/4" MCP BACKING

- 1/4" PTD WD REVEAL

PROVIDE CONTINUOUS SOLID WOOD

WHITE MELAMINE INTERIOR FINISH (TYP.)

PROVIDE (2) 3/4" ADJUSTABLE SHELVES.
MATCH INTERIOR FINISH.

1/4" DIA. HOLES @ 1" O.C. FOR SHELF

CABINET SIDE PANEL BEYOUND

INTEGRATED PULL SEE SPEC.


1'-2" SOFFIT OR AS NEEDED


11 3/4" CLR[°]

INTERIOR °


1'-1" CASEWORK

4 WALL HUNG CABINET W/ SOFFIT
SCALE: 1 1/2" = 1'-0"

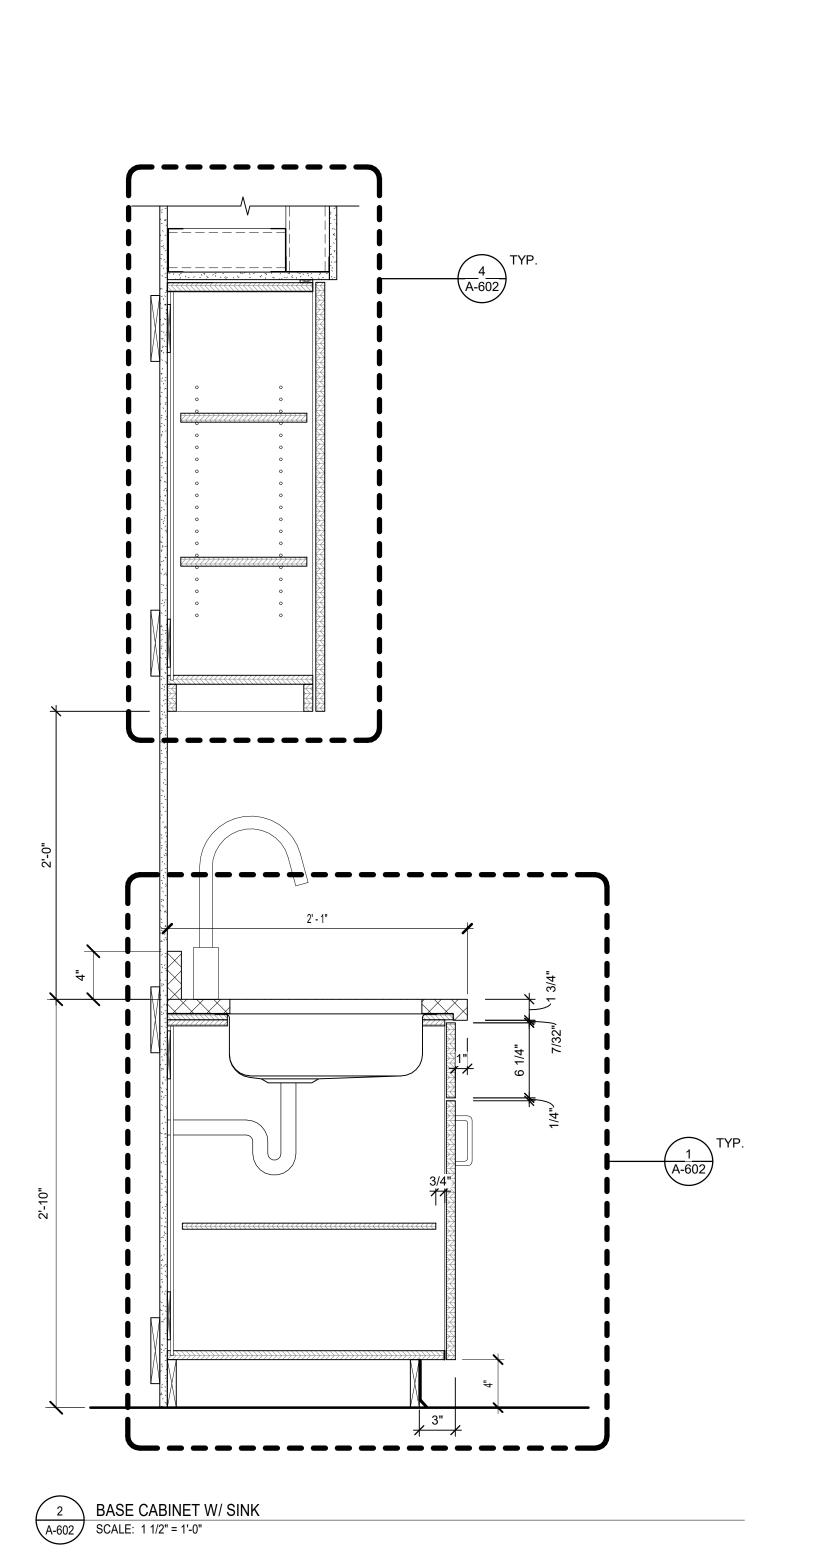

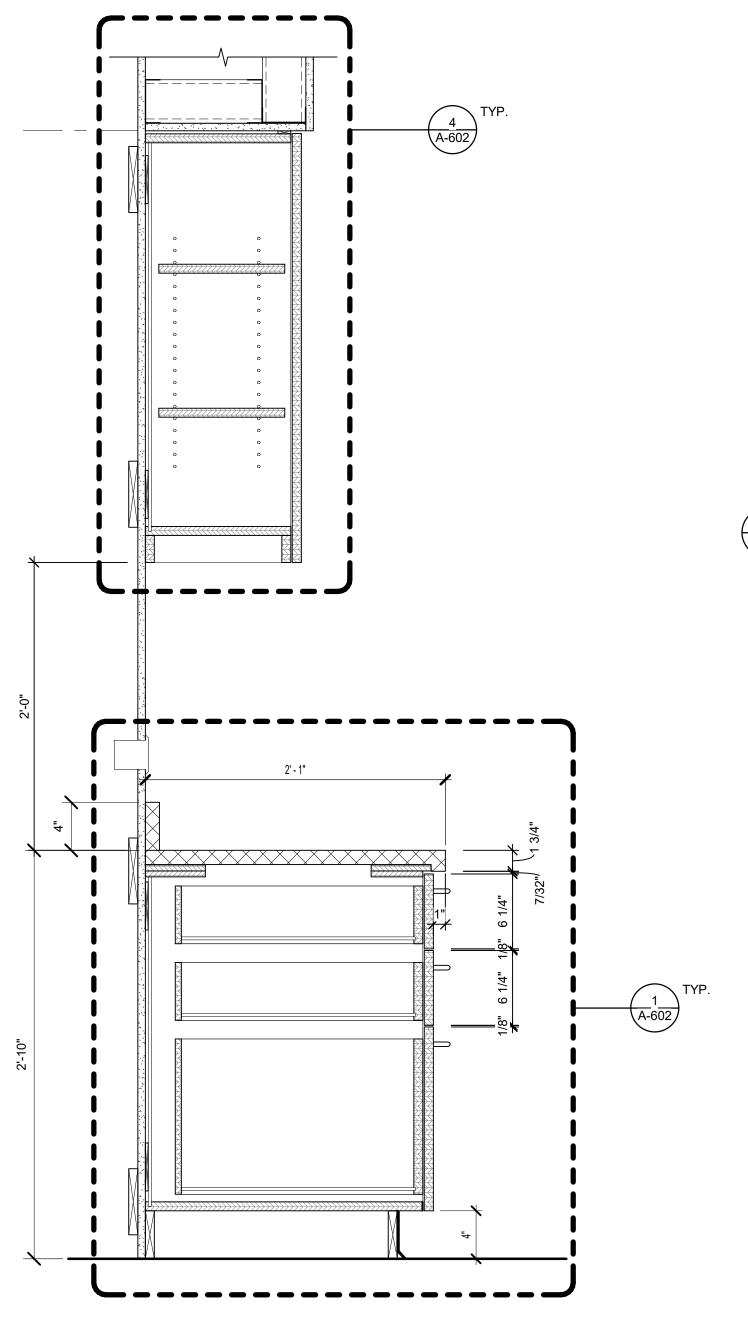



3 BASE CABINET W/ 3 DRAWERS
A-602 SCALE: 1 1/2" = 1'-0"

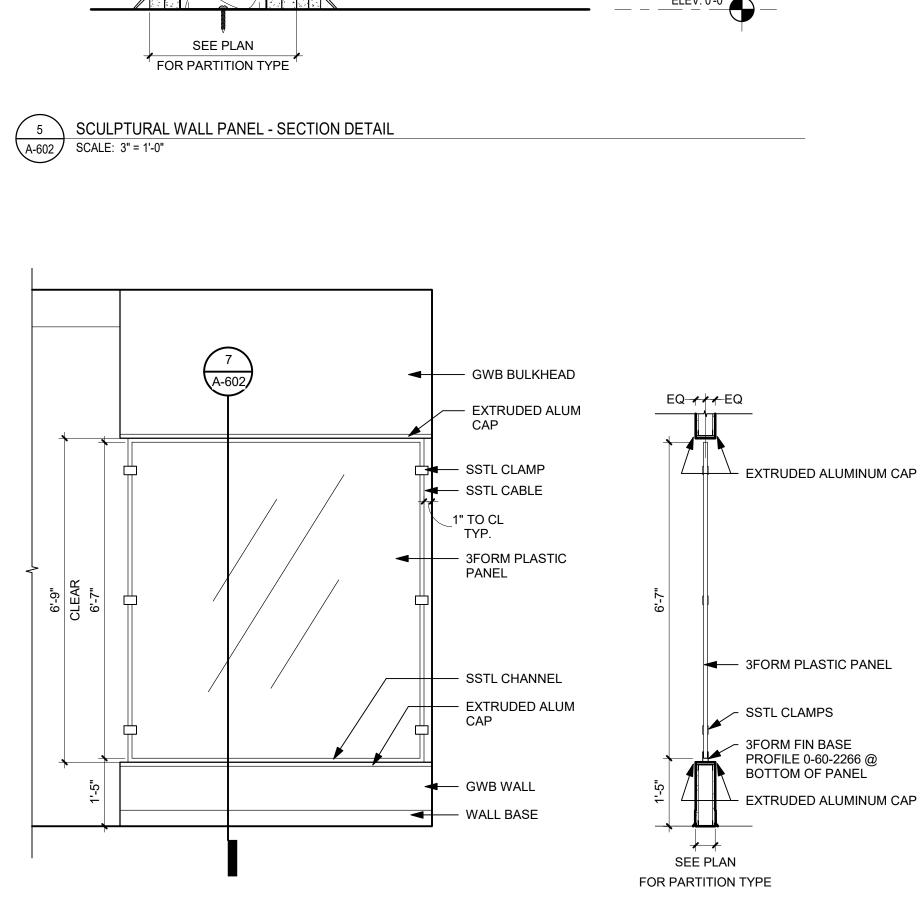

7 3FORM PANEL SECTION
A-602 SCALE: 1/2" = 1'-0"

6 3FORM PANEL ELEVATION
SCALE: 1/2" = 1'-0"

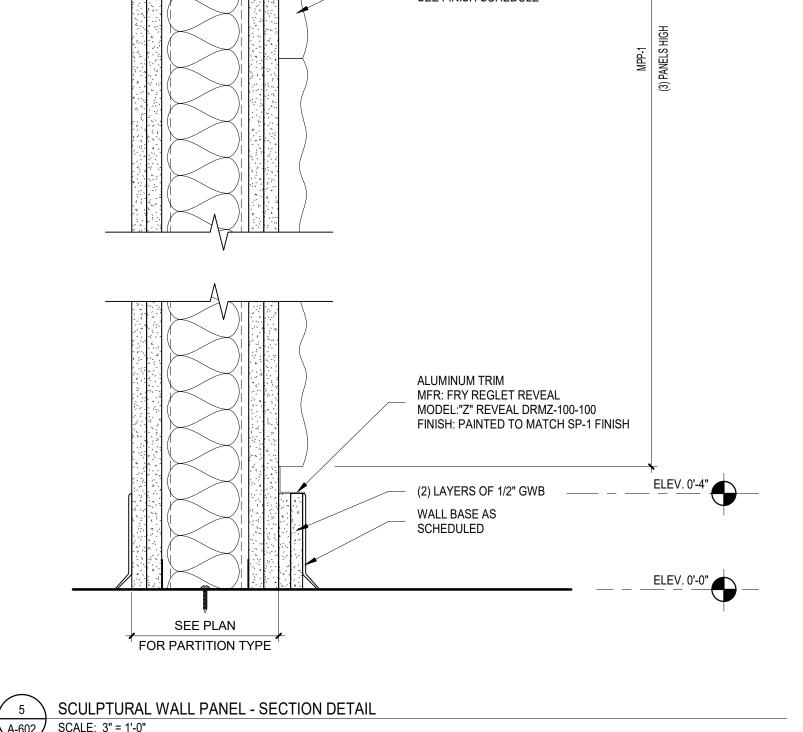

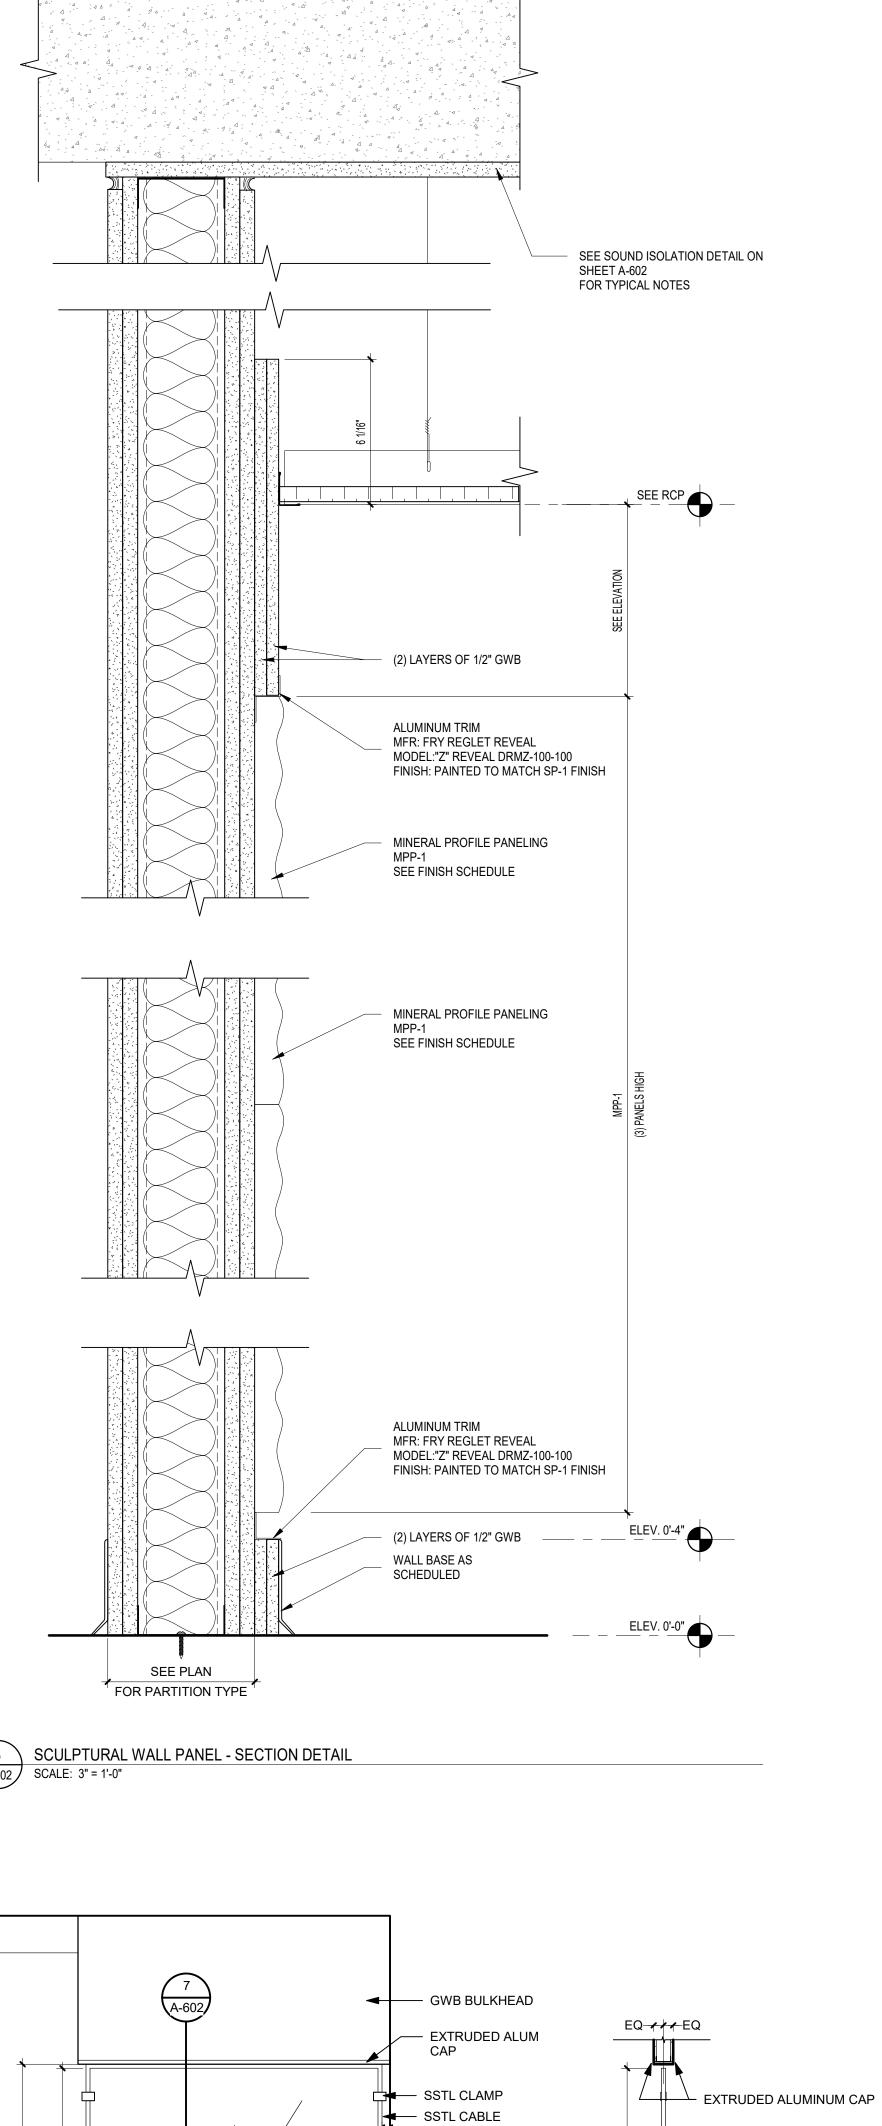



IEI GROUP, LTD. IEI ARCHITECTS, INC. 428 North 2nd Street

Philadelphia, PA 19123 Telephone: 215.413.3700

CONSULTANTS:

Arora Engineers, Inc.

Chadds Ford, PA 19317 P (610) 459-7900

61 Wilmington-West Chester Pike F (610) 459-7950









PH: 215.925.3788 www.o-n.com

O'Donnell & Naccarato 701 Market Street, Suite 6000 Philadelphia, PA 19106



PROGRESS SET CLIENT REVIEW ■ BID SET ■ CODE REVIEW SET ■ ISSUED FOR CONSTRUCTION

ISSUED FOR BIDS 09/18/2020

(NOT FOR CONSTRUCTION)

ISSUES/REVISIONS: 1 9/18/2020 ISSUED FOR BIDS


PROJECT NUMBER:

SCALE: As indicated DATE: 09/18/2020 DRAWN BY: CHECKED BY: DRAWING TITLE:

MILLWORK DETAILS

SHEET NO: A-602

PRINTED ON: 9/22/2020 12:52:08 PM

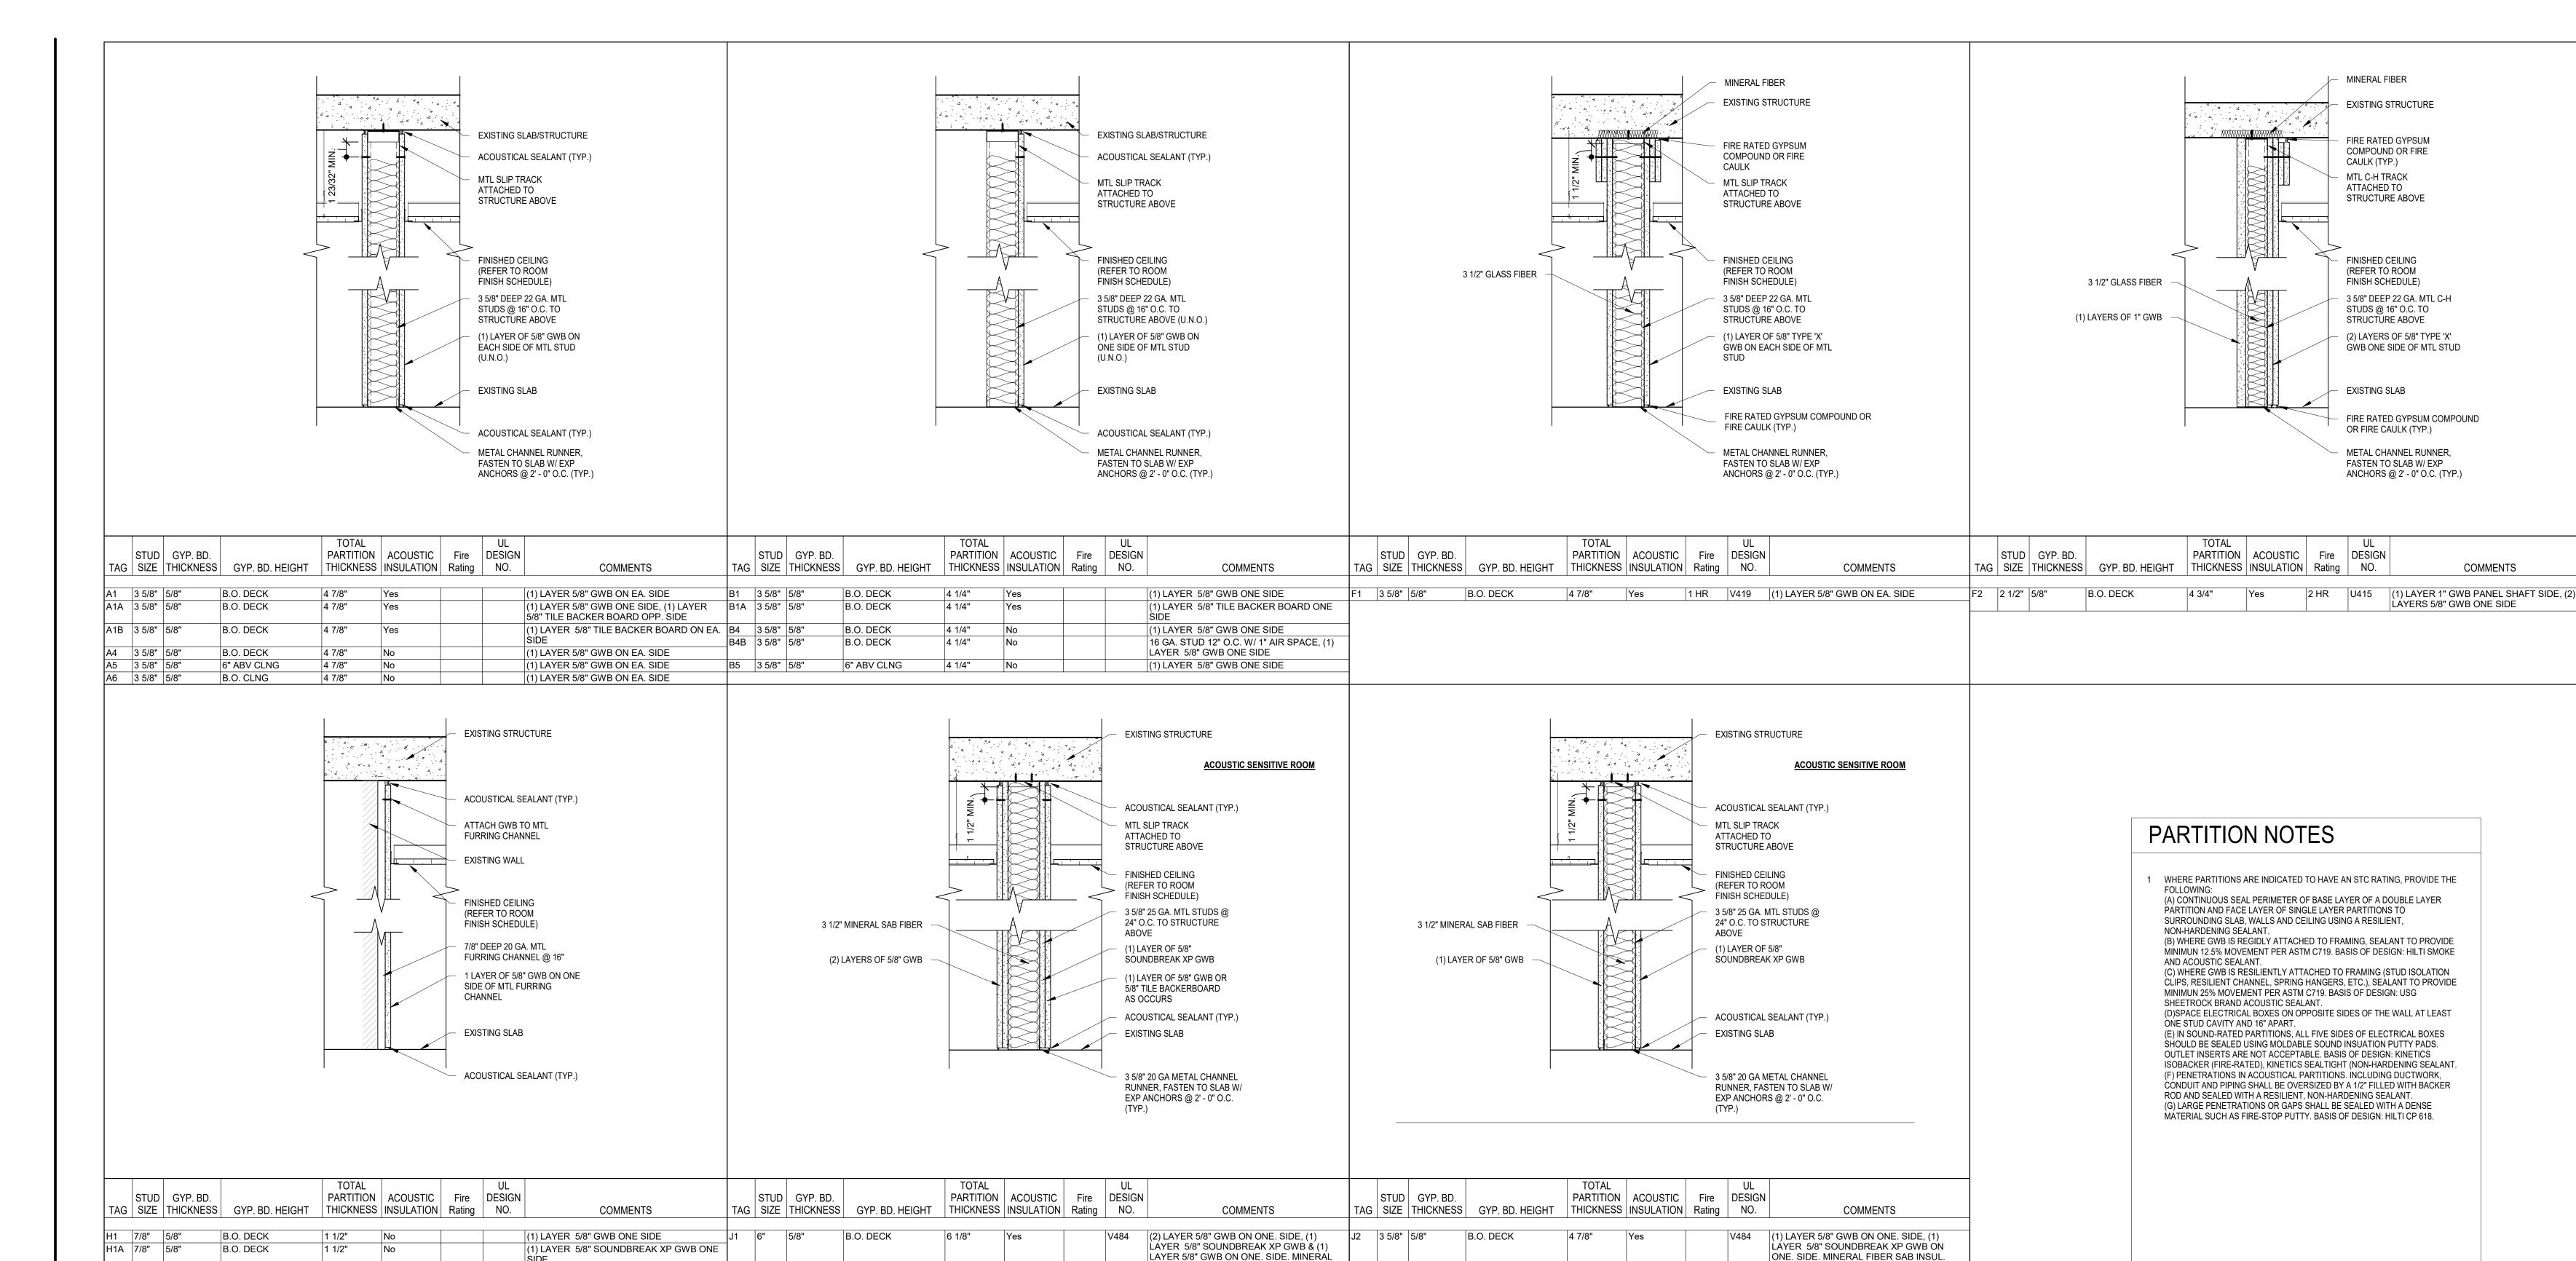

FIBER SAB INSUL. STC 60 MIN.





428 North 2nd Street Philadelphia, PA 19123 Telephone: 215.413.3700 CONSULTANTS:

Arora Engineers, Inc. 61 Wilmington-West Chester Pike Chadds Ford, PA 19317 P (610) 459-7900 F (610) 459-7950 aroraengineers.com



O'Donnell & Naccarato 701 Market Street, Suite 6000 Philadelphia, PA 19106 PH: 215.925.3788 www.o-n.com

LICENSE NO: <Architect's License #>

EFFECTIVE ONLY AS TO THAT VERSION OF THIS DOCUMENT AS ORIGINALLY RESPONSIBLE FOR ANY SUBSEQUENT MODIFICATION, CORRUPTION, OF

OF PHILADELPHIA F EMERGENCY MANAGEMENT PHIA PUBLIC SERVICES BUILDING TH BROAD STREET, PHILADELPHIA, F 3, 9 AND 10 THE CITY OF OF EPHILADELPH 400 NORTH PLOORS 8, 9

■ PROGRESS SET CLIENT REVIEW

■ BID SET ■ CODE REVIEW SET

■ ISSUED FOR CONSTRUCTION

ISSUED FOR BIDS 09/18/2020

(NOT FOR CONSTRUCTION) ISSUES/REVISIONS: 1 9/18/2020 ISSUED FOR BIDS

PROJECT NUMBER: SCALE: As indicated DATE: 09/18/2020 DRAWN BY: CHECKED BY:

DRAWING TITLE: PARTITION & **EQUIPMENT**

SCHEDULES

PRINTED ON: 9/22/2020 12:52:13 PM

DOOR	SCHE	DULE -	08												
			DOOR					FRAME			DETAILS				
NUMBER	WIDTH	HEIGHT	TYPE	MATERIAL	FINISH	GLAZING	TYPE	MATERIAL	FINISH	HEAD	JAMB	SILL	FIRE RATING	HARDWARE	REMARKS
												•			
08-006.1	(2) 3'-0"	7' - 0"	FF	WD			A	HM		H1		-	45 MIN	0001	SEE NOTE #4
08-011.1	3'-0"	7' - 0"	A	WD			-	ALUM		-		-		0005	
08-012.1	3'-0"	7' - 0"	F	WD			A	HM		H1		-		0006	
08-013.1	3'-0"	7' - 0"	A	WD			-	ALUM		-	J2	-		0002	
08-016.1	3'-0"	7' - 0"	A	WD			A	HM		H1	J2	-		0005	SEE NOTE #6
08-017.1	3'-0"	7' - 0"	Α	WD			A	HM		H1	J2	-		0004	SEE NOTE #6
08-018.1	3'-0"	7' - 0"	A	WD			A	HM		-	J2	-		0032	SEE NOTE #6
08-021.1	3'-0"	7' - 0"	A	WD			A	HM		-	J2	-		0003	SEE NOTE #7
08-022.1	3'-0"	7' - 0"	A	WD			A	HM		H1	J2	-		0033	SEE NOTE #7
08-022.2	3'-0"	7' - 0"	A	WD			A	HM		H1	J2	-		0033	SEE NOTE #7
08-024.1	3'-0"	7' - 0"	A	WD			-	ALUM		-		-		0002	
08-025.1	3'-0"	7' - 0"	A	WD			-	ALUM		-		-		0006	

			DOO	R				FRAME			DETAILS				
NUMBER	WIDTH	HEIGHT	TYPE	MATERIAL	FINISH	GLAZING	TYPE	MATERIAL	FINISH	HEAD	JAMB	SILL	FIRE RATING	HARDWARE	REMARKS
09-002.1	3'-0"	7' - 0"	Α	WD			-	ALUM		-	-	-		0007	SEE NOTE #4
09-002.2	1'-6" & 3'-0"	7' - 0"	AA	WD			A	HM		H1	J1	-		0008	SEE NOTE #4
9-006.1	(2) 3'-0"	7' - 0"	FF	WD			A	HM		H1	J1	-	45 MIN	0001	SEE NOTE #4
9-012.1	3'-0"	7' - 0"	А	WD			-	ALUM		-	-	-		0016	
9-013.1	3'-0"	7' - 0"	А	WD			A	HM		H1	J2	-		0009	SEE NOTE #4
9-013.2	3'-0"	7' - 0"	Α	WD			A	HM		H1	J2	-		0010	
9-015.1	3'-0"	7' - 0"	А	WD			A	HM		H1	J2	-		0011	SEE NOTE #4
9-015.2	3'-0"	7' - 0"	Α	WD			A	HM		H1	J2	-		0014	SEE NOTE #8
9-016.1	3'-0"	7' - 0"	Α	WD			A	HM		H1	J2	-		0012	SEE NOTE #4 & #7
9-016.2	3'-0"	7' - 0"	Α	WD			A	HM		H1	J2	-		0012	SEE NOTE #4 & #7
9-017.1	3'-0"	7' - 0"	А	WD			A	HM		H1	J1	-		0013	SEE NOTE #4
9-017.2	3'-0"	7' - 0"	Α	WD			A	HM		H1	J2	-		0015	SEE NOTE #8

		DOOR							FRAME		DETAILS				
NUMBER	WIDTH	HEIGHT	TYPE	MATERIAL	FINISH	GLAZING	TYPE	MATERIAL	FINISH	HEAD	JAMB	SILL	FIRE RATING	HARDWARE	REMARKS
10-006.1	(2) 3'-0"	7' - 0"	FF	WD			Δ	НМ		H1	11		45 MIN	0001	SEE NOTE #4
10-000.1	1'-6" & 3'-0"	7' - 0"	AA	WD			Δ	HM		H1	J1		45 WIIIV	0017	SEE NOTE #4
10-012.1	3'-0"	7' - 0"	E	WD			Λ	HM		I I I	J1	-		0034	OLL NOTE #4
10-012.2	1'-6" & 3'-0"	7' - 0"	AA	WD			^	HM		П I	J1	-		0034	SEE NOTE #4
10-013.1	3'-0"	7' - 0"		WD			^	HM		П1	J2	-		0019	SEE NOTE #8
	3'-0"	7' - 0"		WD			Λ	HM		H1	J2 J2	-		0019	SEE NOTE #8
10-014.2	3'-0"	7' - 0"					Α			H1		-			
10-015.1	3'-0"			WD			A	HM HM		H1	J2	-		0019	SEE NOTE #8
10-015.2		7' - 0"		WD			A .			П	J2	-		0023	SEE NOTE #8
10-016.1	(2) 3'-0"	7' - 0"	AA	ALUM			A	ALUM		-	-	-		0020	DOOL/ET DOODO
10-018.1	(2) 3'-0"	7' - 0"	AA	WD			-	WD		-	-	-		0021	POCKET DOORS
10-020.1	3'-0"	7' - 0"	 	WD			A	HM		H1	J1	-		0022	
10-021.1	(2) 3'-0"	7' - 0"	FF	HM			A	HM		H1	J1	-		0030	SEE NOTE #4
10-022.1	3'-0"	7' - 0"	F	WD			A	HM		H1	J1	-		0024	SEE NOTE #4
10-023.1	3'-0"	7' - 0"	Α	WD			-	ALUM		-	-	-		0025	
10-025.1	3'-0"	7' - 0"	F	WD			A	HM		H1	J1	-		0025	
10-026.1	3'-0"	7' - 0"	F	WD			Α	HM		H1	J1	-		0026	
10-029.1	3'-0"	7' - 0"	F	WD			A	HM		H1	J1	-		0026	
10-030.1	3'-0"	7' - 0"	F	WD			A	НМ		H1	J1	-		0027	
10-031.1	3'-0"	7' - 0"	F	WD			A	НМ		H1	J2	-		0028	SEE NOTE #8
10-031.2	3'-0"	7' - 0"	F	WD			A	HM		H1	J2	-		0029	SEE NOTE #8
10-032.1	3'-0"	7' - 0"	F	WD			A	НМ		H1	J1	-		0031	


DOOR	SCHE	DULE -	12												
			DOOR					FRAME			DETAILS				
NUMBER	WIDTH	HEIGHT	TYPE	MATERIAL	FINISH	GLAZING	TYPE	MATERIAL	FINISH	HEAD	JAMB	SILL	FIRE RATING	HARDWARE	REMARKS
			·												
12-002.1	3'-0"	7' - 0"	F	WD			Α	HM		H1	J1	-			

DOOR SCHEDULE NOTES


DOOR SCHEDULE LEGEND

- 1 ALL NEW DOORS AND FRAMES TO MATCH BUILDING STANDARD UNLESS NOTED OTHERWISE. 2 ALL HARDWARE TO BE ADA COMPLIANT, PER APPLICABLE CODES. 3 EACH DOOR TO RECEIVE THREE (3) SILENCERS EACH.
- 4 PROVIDE CARD READER WHERE NOTED ON PLANS.
- 5 STC 40 ACOUSTIC RATED DOOR 6 STC 45 ACOUSTIC RATED DOOR
- 7 STC 50 ACOUSTIC RATED DOOR 8 STC 52 ACOUSTIC RATED DOOR


MATERIAL HM HOLLOW METAL WD WOOD VENEER TEMP TEMPERED GLASS ALUM ALUMINUM <u>FINISH</u> FACT FACTORY FINISH PT PAINT

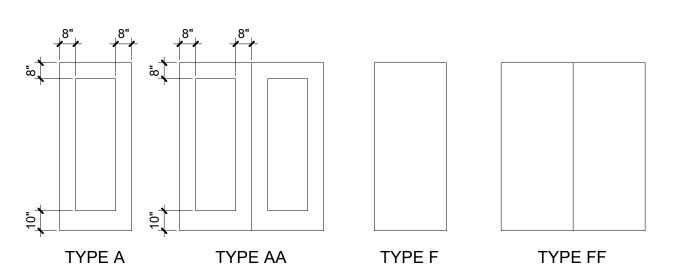



1 DOOR TYPES
A-701 SCALE: 1/4" = 1'-0"

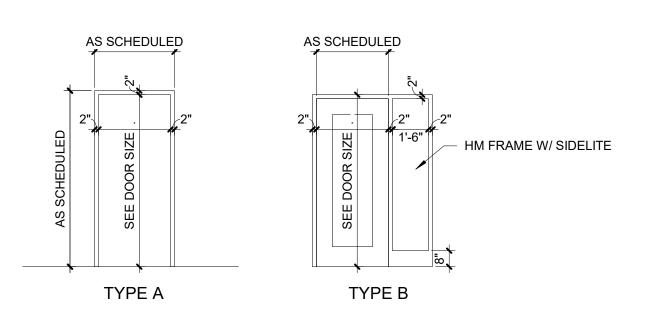


2 FRAME ELEVATIONS
A-701 SCALE: 1/4" = 1'-0"

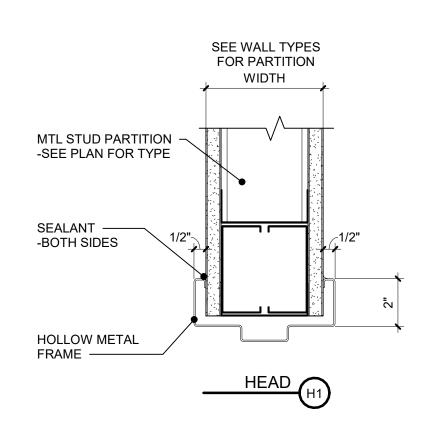

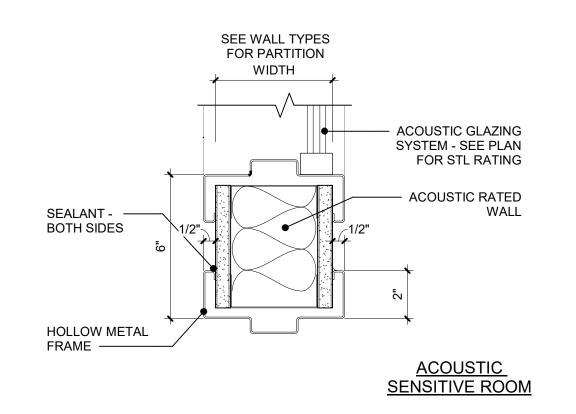

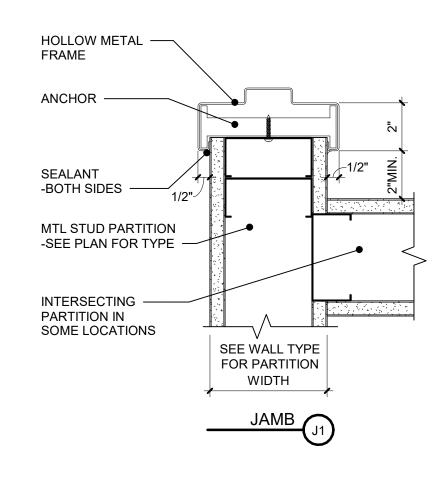

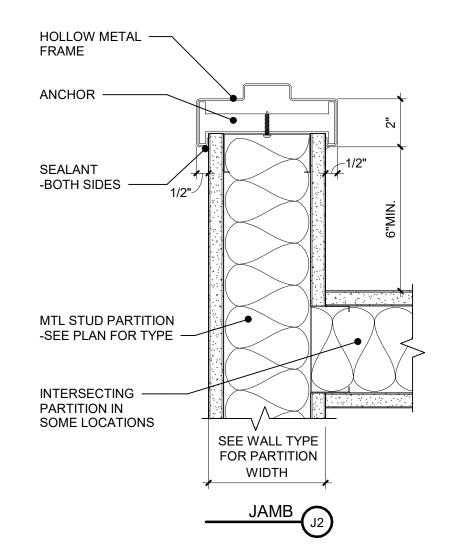

3 DOOR HEAD/JAMB DETAIL
A-701 SCALE: 3" = 1'-0"



IEI GROUP, LTD. IEI ARCHITECTS, INC. 428 North 2nd Street

Philadelphia, PA 19123 Telephone: 215.413.3700 CONSULTANTS:

Arora Engineers, Inc. 61 Wilmington-West Chester Pike Chadds Ford, PA 19317 P (610) 459-7900 F (610) 459-7950 aroraengineers.com



<u>O'Donnell & Naccarato</u> 701 Market Street, Suite 6000 Philadelphia, PA 19106 PH: 215.925.3788 www.o-n.com



DESIGN PROFESSIONAL'S ELECTRONIC OR DIGITAL SEAL OR SIGNATURE IS EFFECTIVE ONLY AS TO THAT VERSION OF THIS DOCUMENT AS ORIGINALLY PUBLISHED BY DESIGN PROFESSIONAL. DESIGN PROFESSIONAL IS NOT RESPONSIBLE FOR ANY SUBSEQUENT MODIFICATION, CORRUPTION, OR UNAUTHORIZED USE OF SUCH DOCUMENT. TO VERIFY THE VALIDITY OR APPLICABILITY OF THE SEAL OR SIGNATURE CONTACT DESIGN PROFESSIONAL

■ PROGRESS SET ■ CLIENT REVIEW

■ BID SET ■ CODE REVIEW SET ☐ ISSUED FOR CONSTRUCTION

> ISSUED FOR BIDS 09/18/2020


(NOT FOR CONSTRUCTION) ISSUES/REVISIONS: 1 9/18/2020 ISSUED FOR BIDS

PROJECT NUMBER: SCALE: DATE:

DRAWN BY: CHECKED BY:

DOOR SCHEDULE

PRINTED ON: 9/22/2020 3:02:02 PM

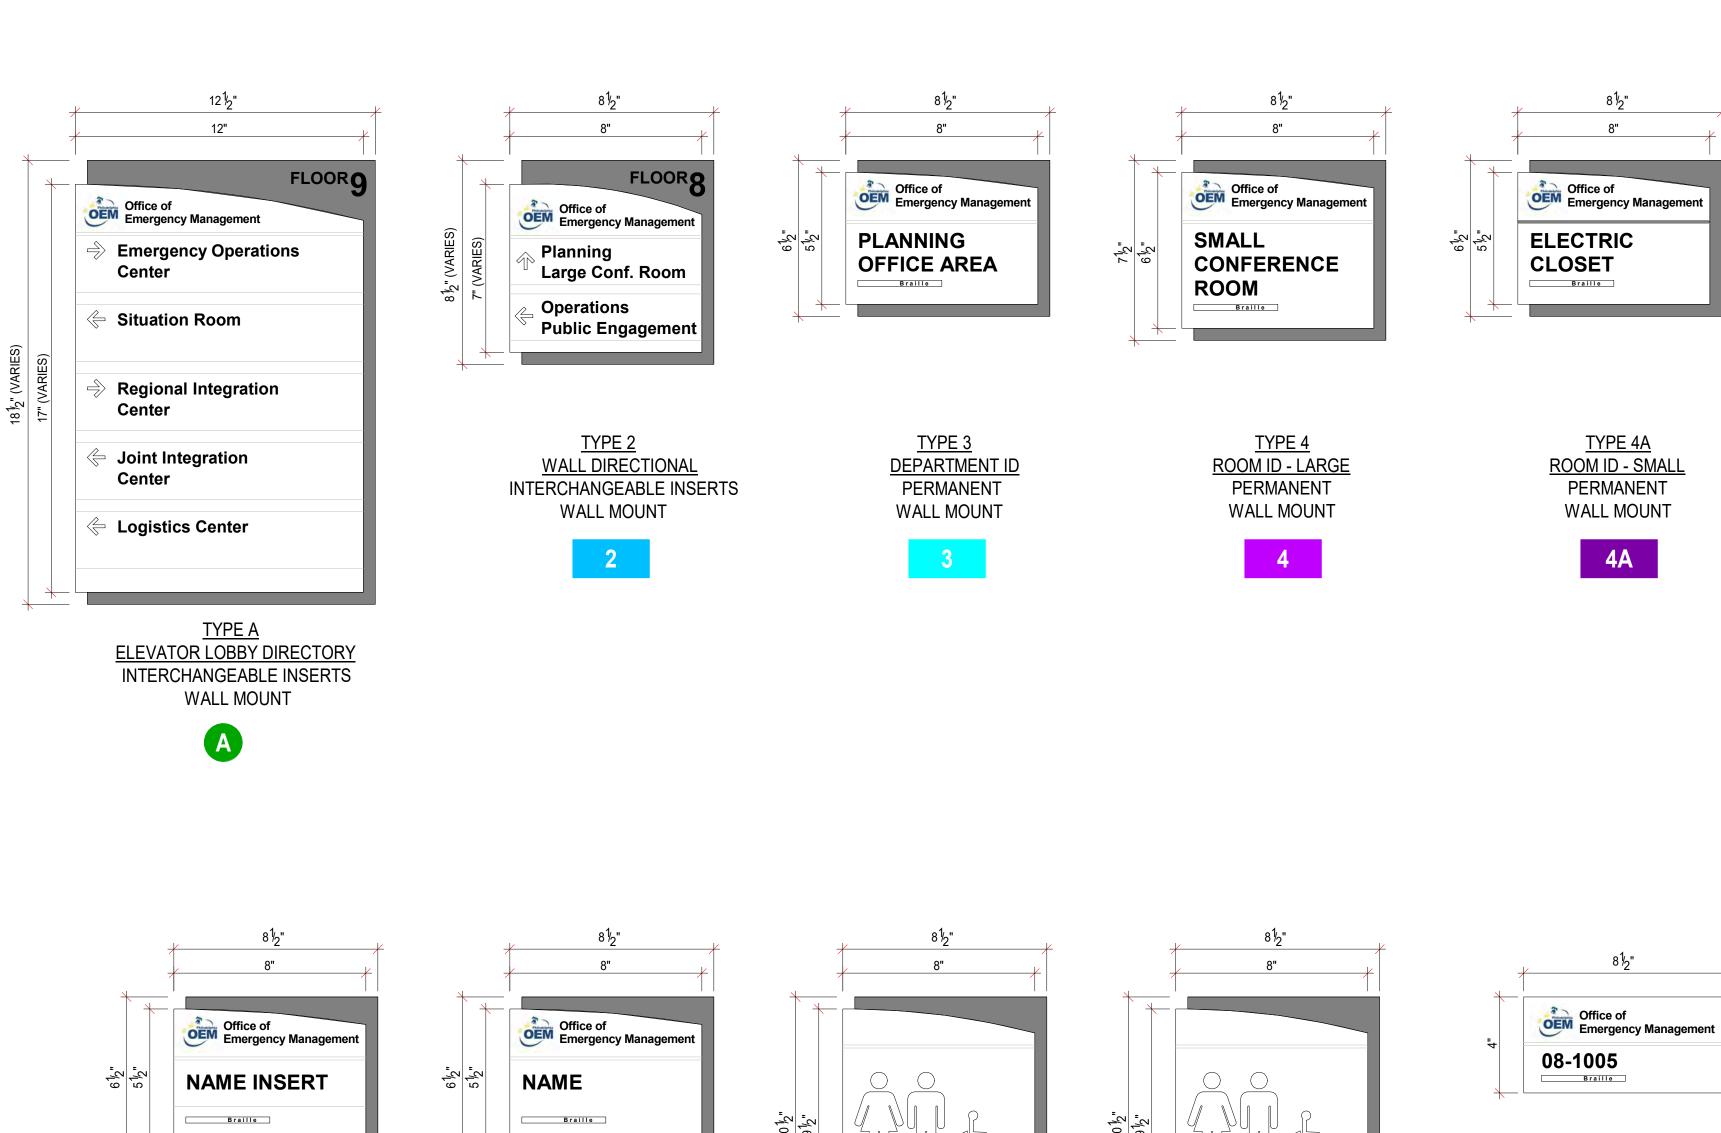

RESTROOM

TYPE 5

ROOM ID - RESTROOM

PERMANENT

WALL MOUNT

5A

Braille

TYPE 4E

ROOM ID - OFFICE

PERMANENT

WALL MOUNT

4E

TYPE 4D

ROOM ID - OFFICE

INTERCHANGEABLE INSERT

WALL MOUNT

4D

SHOWER ROOM

TYPE 5

ROOM ID - RESTROOM

PERMANENT

WALL MOUNT

5D

<u>TYPE 16</u> WORKSTATION ID

WORKSTATION NUMBER

WORKSTATION MOUNT

Braille



2 DIRECTIONAL

3 DEPARTMENT ID

4 ROOM ID

4A ROOM ID - SMALL

4D 4D ROOM ID - OFFICE

4E ROOM ID - OFFICE

5A ROOM ID - UNISEX RESTROOM

5D ROOM ID - UNISEX SHOWER ROOM

16 WORKSTATION ID

A A ELEVATOR LOBBY DIRECTORY

GENERAL NOTES

SIGNS TO BE ONE-PIECE SIGN PANEL. SEE SPECIFICATIONS SECTIONS FOR ADDITIONAL INFORMATION.

2. SIGNAGE FONTS TO COMPLY WITH CITY OF PHILADELPHIA DIGITAL STANDARDS - TYPOGRAPHY.

TYPICAL SIGN FONT = OPEN SANS SEMI BOLD


3. LOGO IMAGE = CITY OF PHILADELPHIA OFFICE OF EMERGENCY

MANAGEMENT LOGO. FINAL IMAGE TO BE CONFIRMED DURING SUBMITTAL REVIEW.

4. SIGN DESIGN, COLORS AND LAYOUT SHOWN IN THESE

DRAWINGS REPRESENT THE DESIGN INTENTION.

5. SEE SIGN TYPE 4A FOR TYPICAL SIGN INFORMATION.

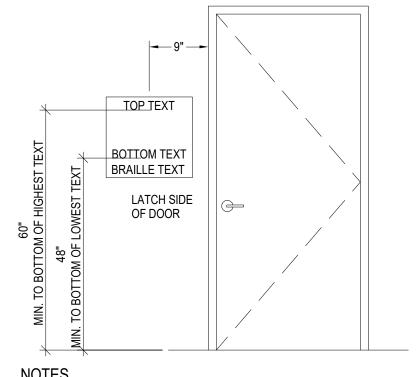

NOTES

1. WHERE THERE IS NO WALL SPACE ON THE LATCH SIDE OF A SINGLE DOOR, OR TO THE RIGHT SIDE OF DOUBLE DOORS, SIGNS SHALL BE ON THE NEAREST ADJACENT WALL.

 DOOR-MOUNTED SIGNS SHALL BE PERMITTED ON THE PUSH SIDE OF DOORS WITH CLOSERS AND WITHOUT HOLD-OPEN DEVICES.

3. ACCESSIBILITY SIGNS () ARE REQUIRED ON UNISEX TOILET ROOMS WITH TACTILE CHARACTERS THAT SHALL BE DUPLICATED IN BRAILLE.

4. SIGNAGE RQUIREMENTS ARE TO COMPLY WITH ANSI A117.1-2010, SECTION 703 AND ADA ACCESSIBILITY REGULATIONS.

IEI GROUP, LTD.
IEI ARCHITECTS, INC.
428 North 2nd Street

Philadelphia, PA 19123
Telephone: 215.413.3700

CONSULTANTS:

(ARORA°

Arora Engineers, Inc.
61 Wilmington-West Chester Pike
Chadds Ford, PA 19317
P (610) 459-7900
F (610) 459-7950
aroraengineers.com



701 Market Street, Suite 6000 Philadelphia, PA 19106 PH: 215.925.3788 www.o-n.com

LICENSE NO: <Architect's License #>

DESIGN PROFESSIONAL'S ELECTRONIC OR DIGITAL SEAL OR SIGNATURE IS EFFECTIVE ONLY AS TO THAT VERSION OF THIS DOCUMENT AS ORIGINALLY PUBLISHED BY DESIGN PROFESSIONAL. DESIGN PROFESSIONAL IS NOT

DESIGN PROFESSIONAL'S ELECTRONIC OR DIGITAL SEAL OR SIGNATURE IS EFFECTIVE ONLY AS TO THAT VERSION OF THIS DOCUMENT AS ORIGINALLY PUBLISHED BY DESIGN PROFESSIONAL. DESIGN PROFESSIONAL IS NOT RESPONSIBLE FOR ANY SUBSEQUENT MODIFICATION, CORRUPTION, OR UNAUTHORIZED USE OF SUCH DOCUMENT. TO VERIFY THE VALIDITY OR APPLICABILITY OF THE SEAL OR SIGNATURE, CONTACT DESIGN PROFESSIONAL.

F PHILADELPHIA EMERGENCY MANAGEMENT HIA PUBLIC SERVICES BUILDING BROAD STREET, PHILADELPHIA, PA 19 AND 10

□ PROGRESS SET

☐ CLIENT REVIEW
☐ BID SET

CODE REVIEW SETISSUED FOR CONSTRUCTION

ISSUED FOR BIDS 09/18/2020

(NOT FOR CONSTRUCTION)

ISSUES/REVISIONS:


PROJECT NUMBER: 304103-SCALE: As indica DATE: 09/18/2 DRAWN BY: CHECKED BY:

SIGN TYPES & ELEVATIONS

....

AI-900


PRINTED ON: 9/22/2020 12:52:18 PM

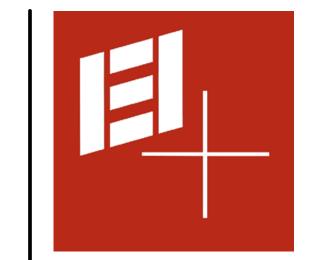

Telephone: 215.413.3700 CONSULTANTS:

ARORA°

Arora Engineers, Inc. 61 Wilmington-West Chester Pike Chadds Ford, PA 19317 P (610) 459-7900 F (610) 459-7950 aroraengineers.com

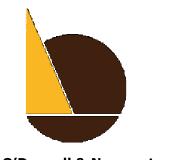

O'Donnell & Naccarato 701 Market Street, Suite 6000 Philadelphia, PA 19106 PH: 215.925.3788 www.o-n.com

LICENSE NO: <Architect's License #> DESIGN PROFESSIONAL'S ELECTRONIC OR DIGITAL SEAL OR SIGNATURE IS EFFECTIVE ONLY AS TO THAT VERSION OF THIS DOCUMENT AS ORIGINALLY PUBLISHED BY DESIGN PROFESSIONAL. DESIGN PROFESSIONAL IS NOT RESPONSIBLE FOR ANY SUBSEQUENT MODIFICATION, CORRUPTION, OR UNAUTHORIZED USE OF SUCH DOCUMENT. TO VERIFY THE VALIDITY OR APPLICABLE TO SECRET OR SUBJECT SOCIAL PROFESSIONAL.

■ PROGRESS SET □ CLIENT REVIEW

■ BID SET ☐ CODE REVIEW SET ☐ ISSUED FOR CONSTRUCTION

> ISSUED FOR BIDS 09/18/2020

(NOT FOR CONSTRUCTION) ISSUES/REVISIONS:


PROJECT NUMBER: SCALE: As indicated DATE: DRAWN BY:


DRAWING TITLE: 8TH FLOOR


SIGNAGE PLAN

CHECKED BY:

AI-908

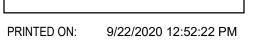

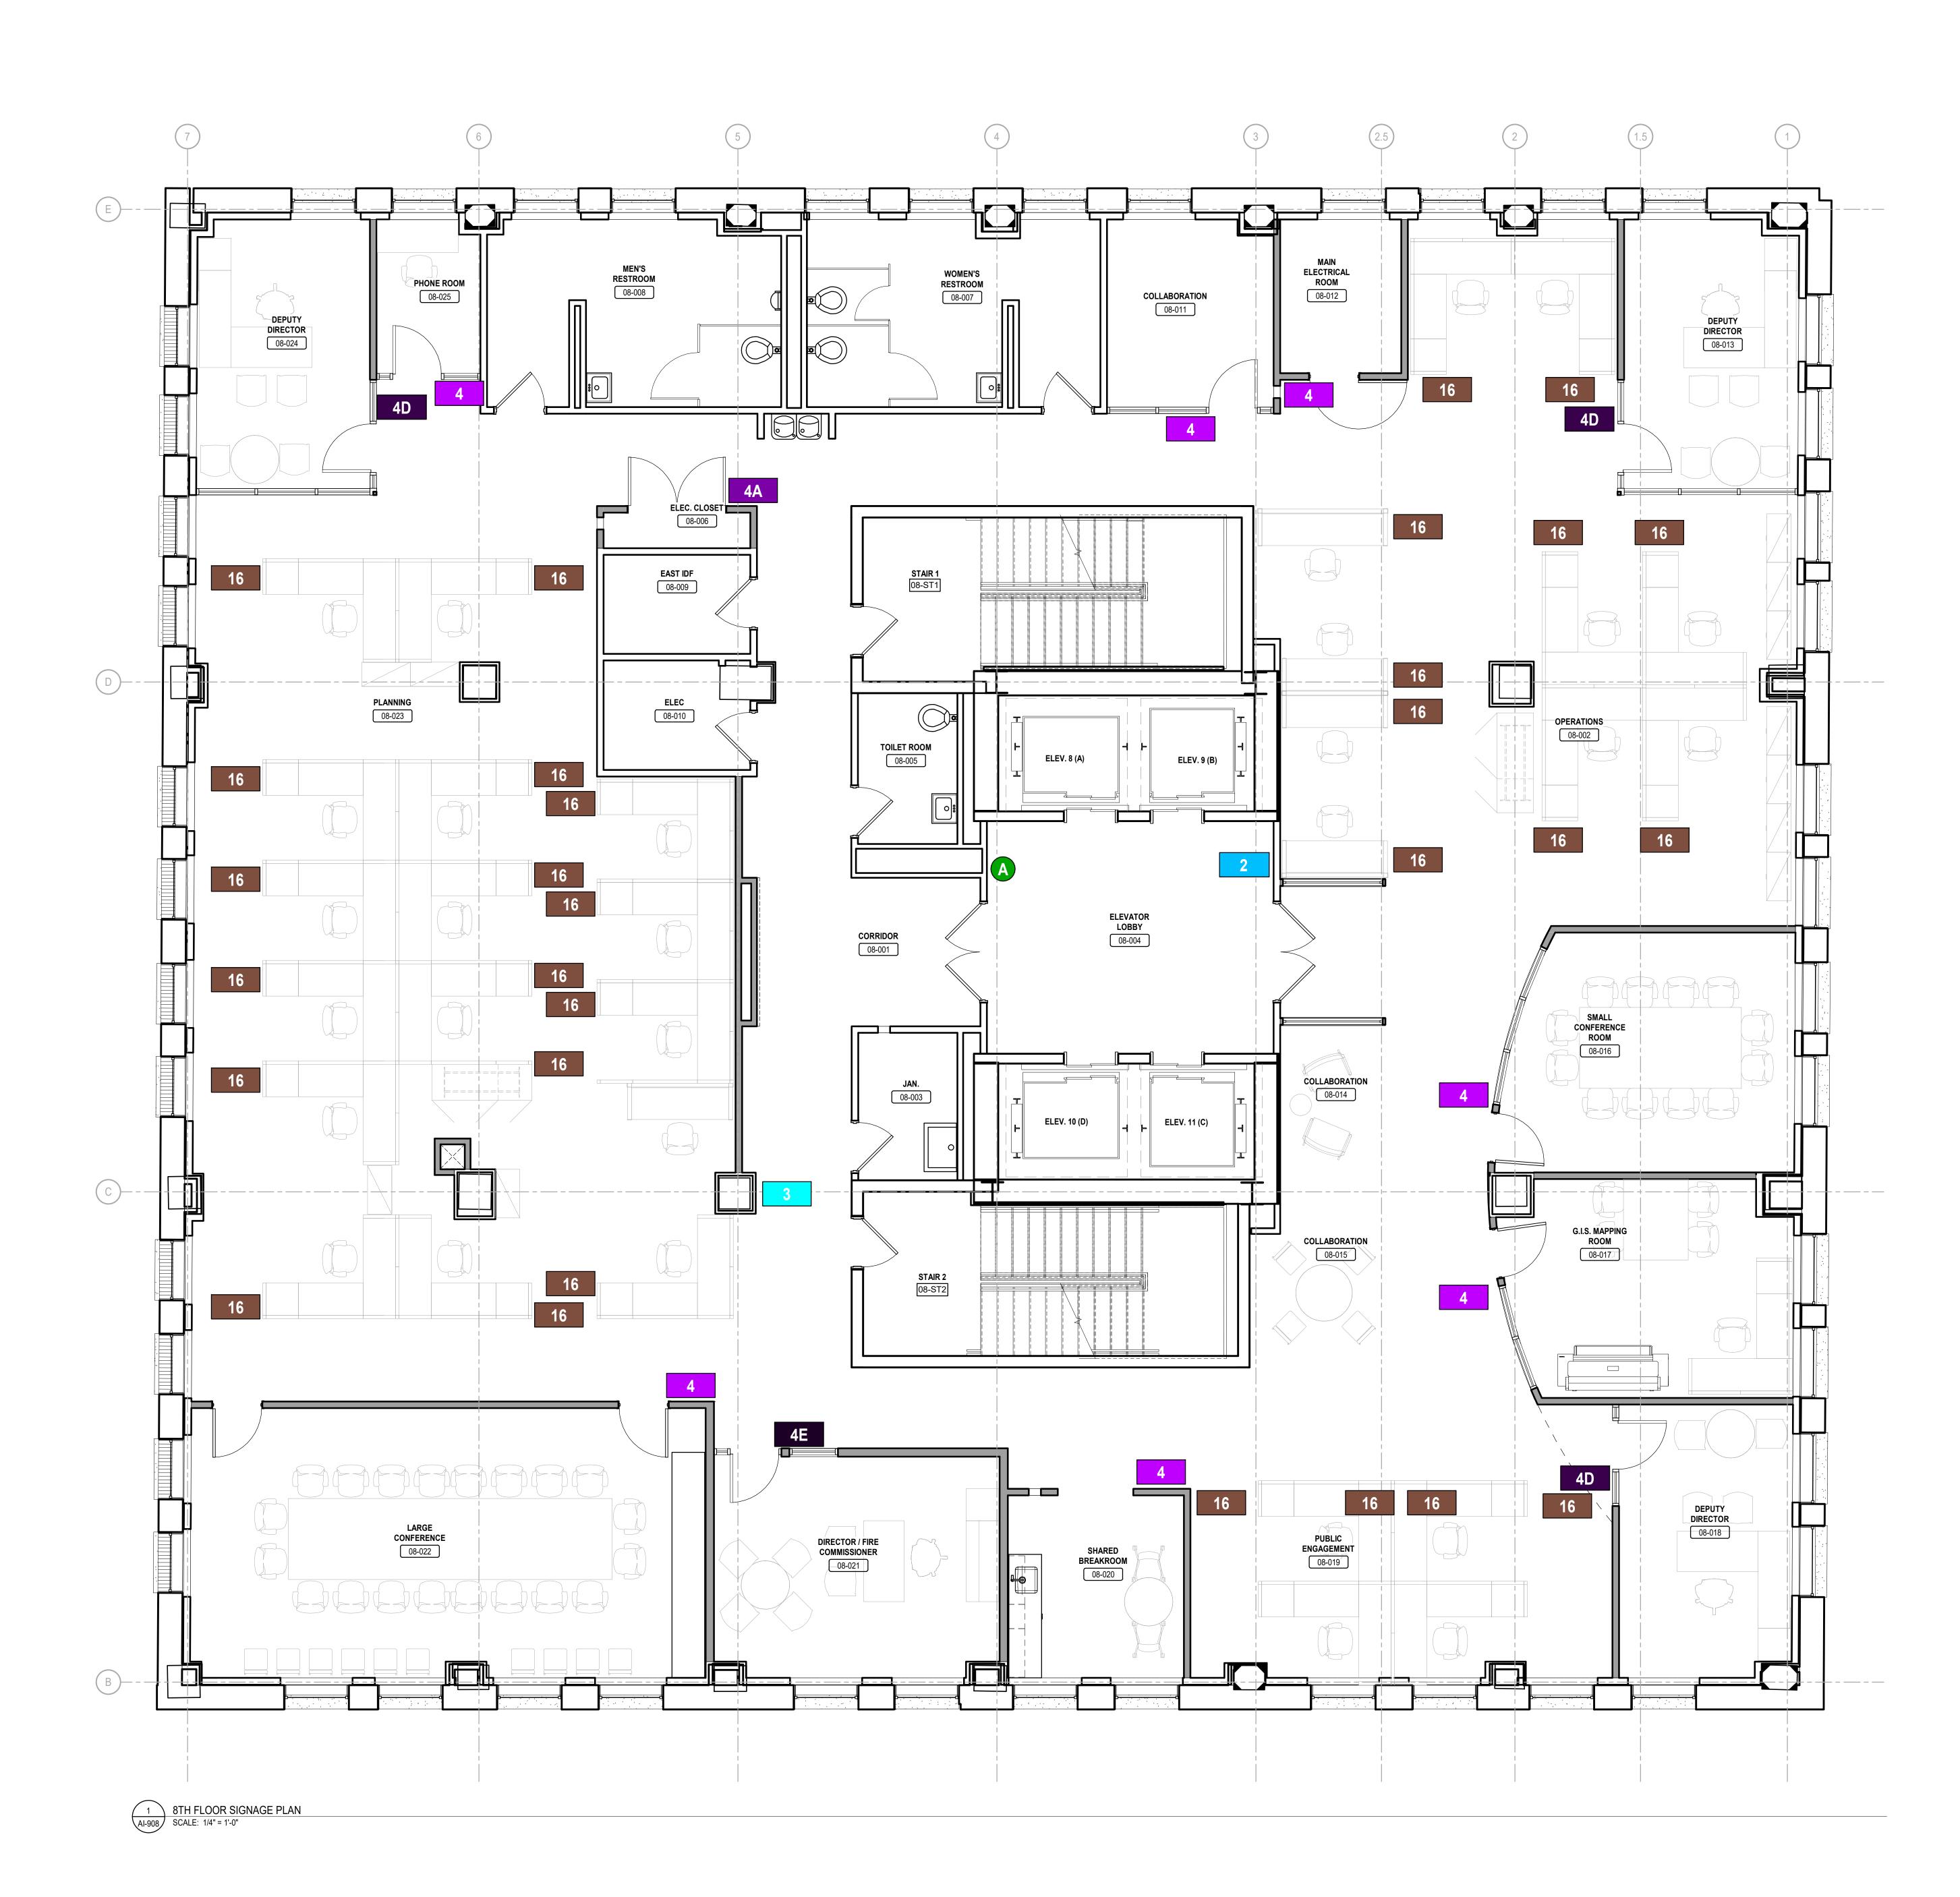

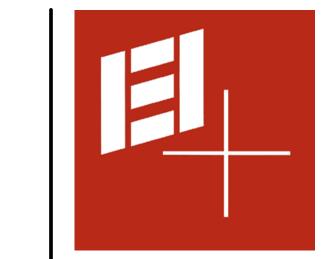

Telephone: 215.413.3700

CONSULTANTS:

ARORA

Arora Engineers, Inc.
61 Wilmington-West Chester Pike
Chadds Ford, PA 19317
P (610) 459-7900
F (610) 459-7950
aroraengineers.com



O'Donnell & Naccarato
701 Market Street, Suite 6000
Philadelphia, PA 19106
PH: 215.925.3788
www.o-n.com

LICENSE NO: <Architect's License #>

DESIGN PROFESSIONAL'S ELECTRONIC OR DIGITAL SEAL OR SIGNATURE IS EFFECTIVE ONLY AS TO THAT VERSION OF THIS DOCUMENT AS ORIGINALLY PUBLISHED BY DESIGN PROFESSIONAL DESIGN PROFESSIONAL IS NOT RESPONSIBLE FOR ANY SUBSEQUENT MODIFICATION, CORRUPTION, OR UNAUTHORIZED USE OF SUCH ORIGINATURE CONTACT DESIGNATION OF ADDICATED TO THE SEAL OR SCHAMBLES CONTACT DESIGNATION OF SURVEY OF THE SEAL OR SCHAMBLES CONTACT DESIGNATION OF SURVEY OF THE SEAL OR SCHAMBLES CONTACT DESIGNATION OF SURVEY OF THE SEAL OR SCHAMBLES CONTACT DESIGNATION OF SURVEY OF SURVEY

CITY OF PHILADELPHIA
ICE OF EMERGENCY MANAGEMENT
ADELPHIA PUBLIC SERVICES BUILDING
NORTH BROAD STREET, PHILADELPHIA, PA

□ PROGRESS SET
□ CLIENT REVIEW


■ BID SET
□ CODE REVIEW SET
□ ISSUED FOR CONSTRUCTION

ISSUED FOR BIDS 09/18/2020

(NOT FOR CONSTRUCTION)

ISSUES/REVISIONS:



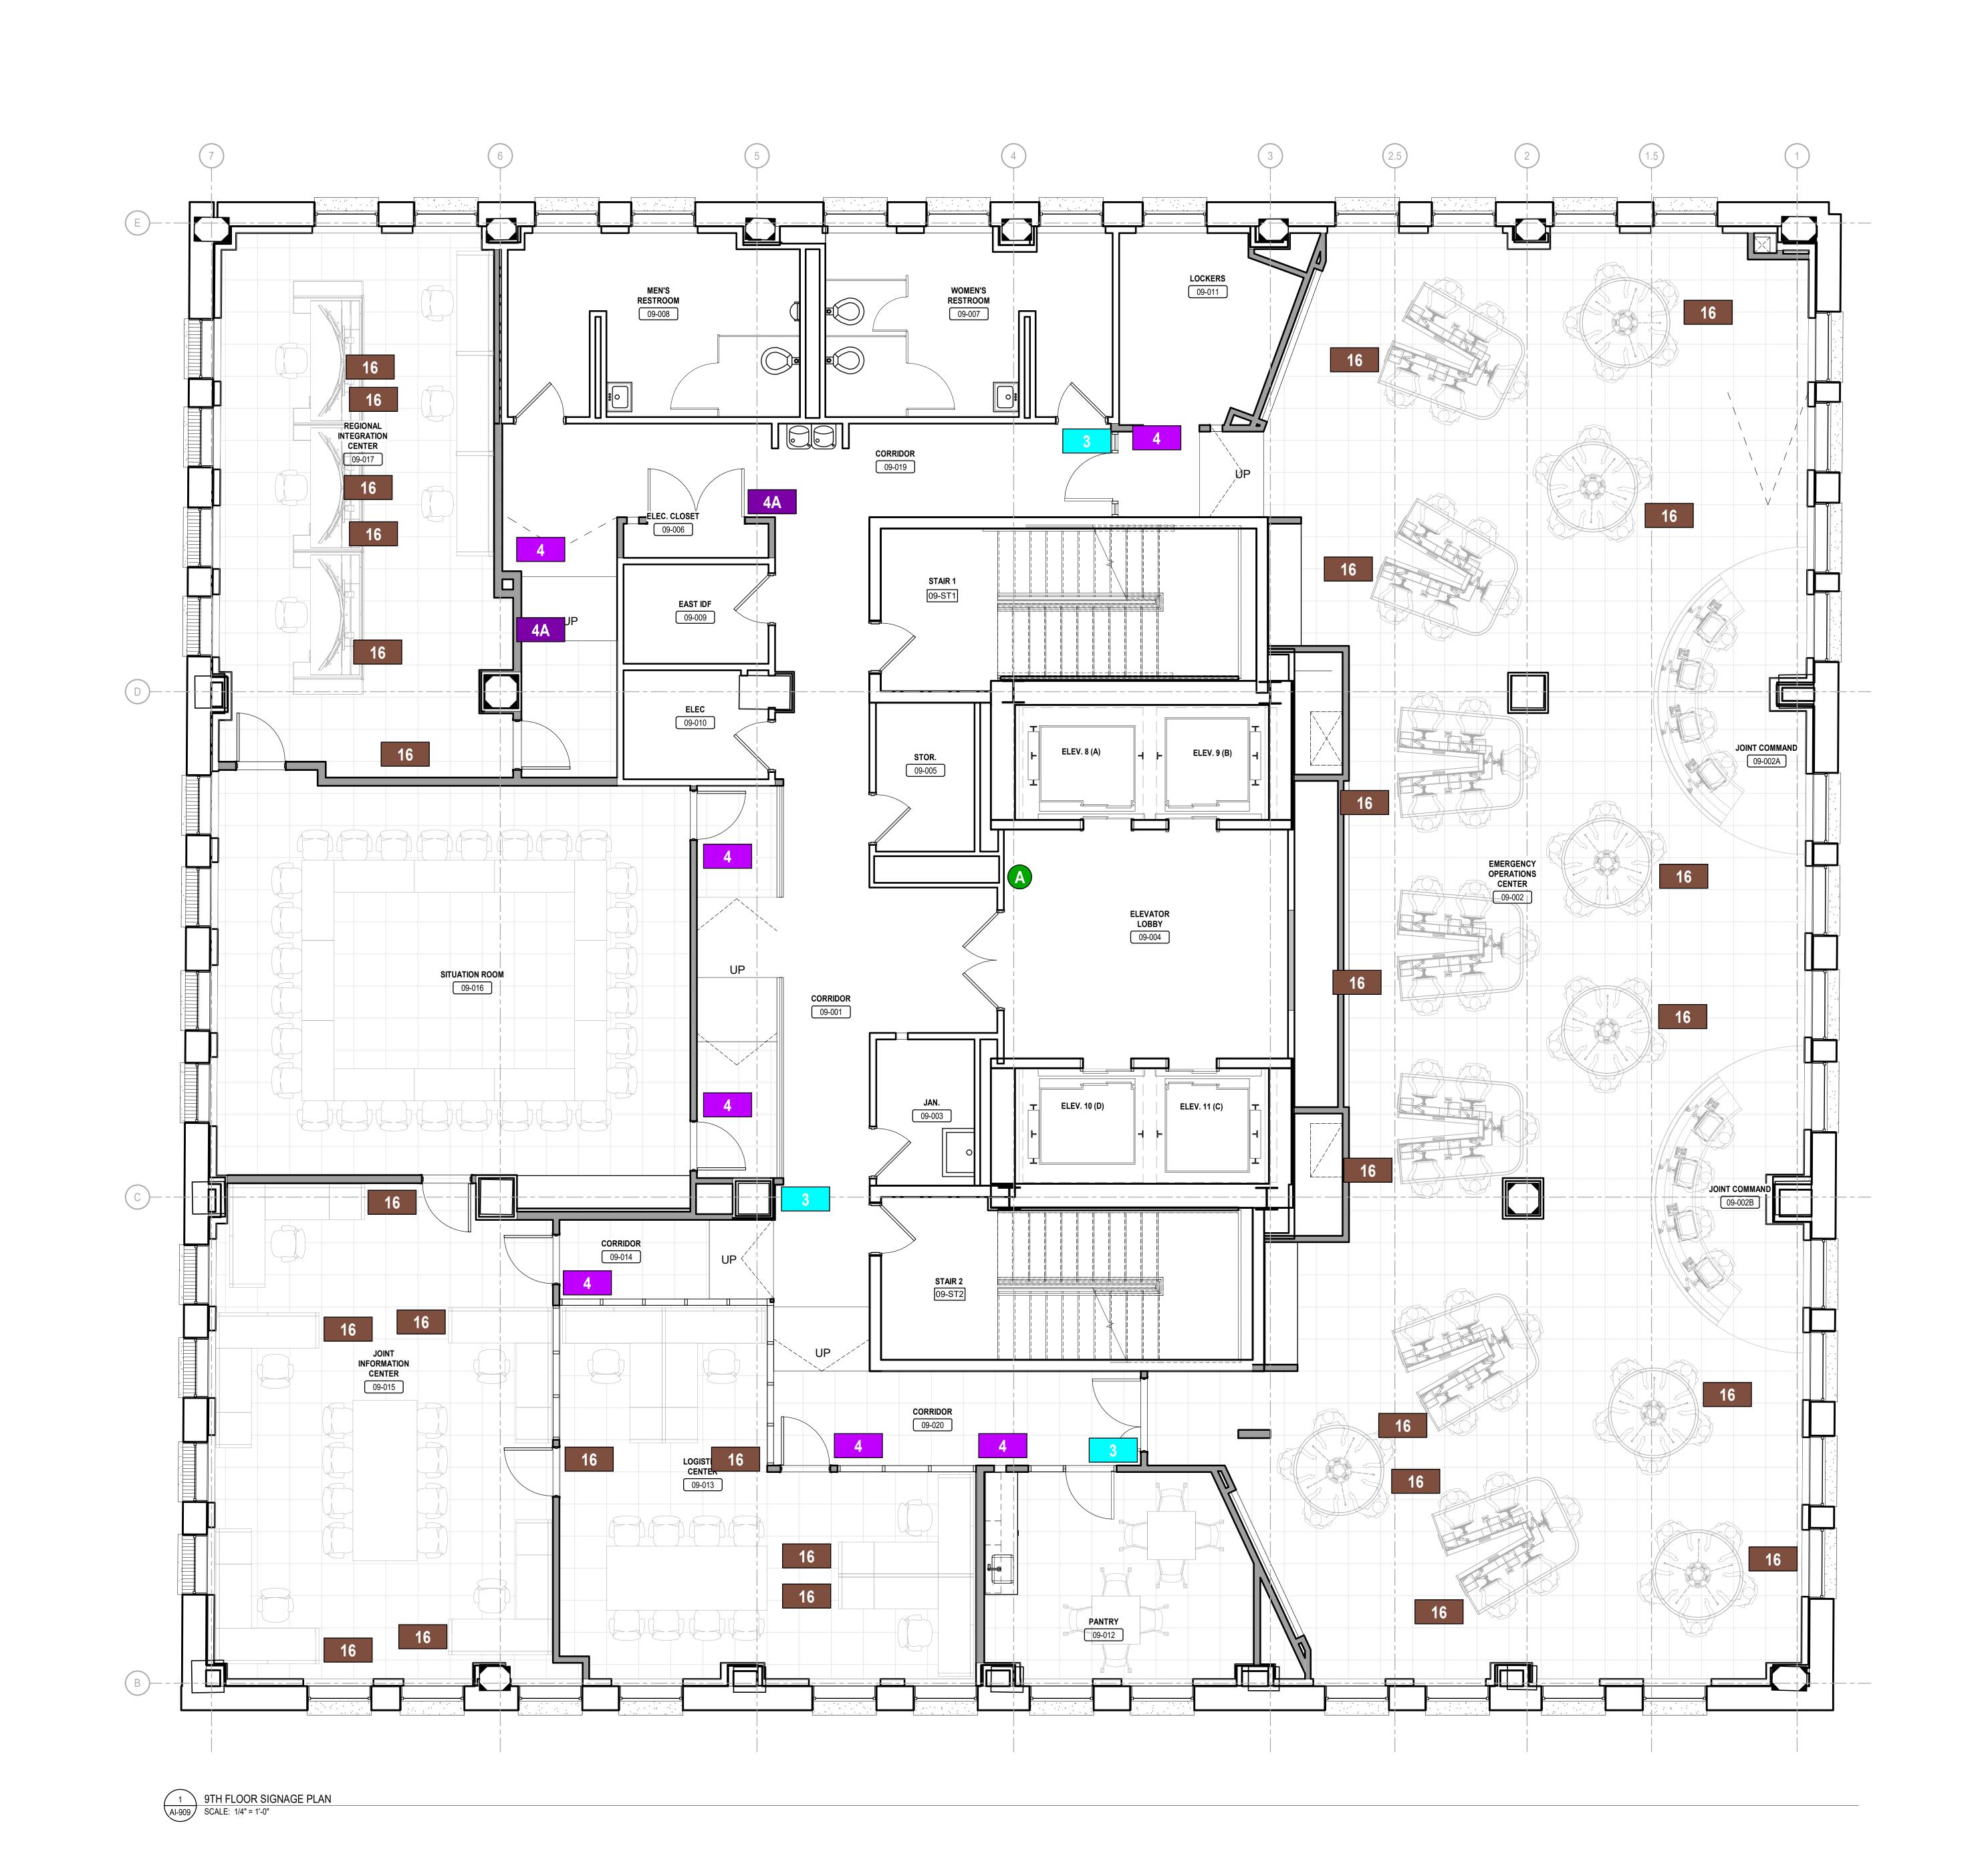



Telephone: 215.413.3700 CONSULTANTS:

ARORA°

Arora Engineers, Inc. 61 Wilmington-West Chester Pike Chadds Ford, PA 19317 P (610) 459-7900 F (610) 459-7950 aroraengineers.com



O'Donnell & Naccarato 701 Market Street, Suite 6000 Philadelphia, PA 19106 PH: 215.925.3788 www.o-n.com

LICENSE NO: <Architect's License #> DESIGN PROFESSIONAL'S ELECTRONIC OR DIGITAL SEAL OR SIGNATURE IS EFFECTIVE ONLY AS TO THAT VERSION OF THIS DOCUMENT AS ORIGINALLY PUBLISHED BY DESIGN PROFESSIONAL. DESIGN PROFESSIONAL IS NOT RESPONSIBLE FOR ANY SUBSEQUENT MODIFICATION, CORRUPTION, OR UNAUTHORIZED USE OF SUCH DOCUMENT. TO VERIFY THE VALIDITY OR APPLICABLE TO SECRET OR SUBJECT SOCIAL PROFESSIONAL.

■ PROGRESS SET ■ CLIENT REVIEW

■ BID SET ☐ CODE REVIEW SET ■ ISSUED FOR CONSTRUCTION

> ISSUED FOR BIDS 09/18/2020


(NOT FOR CONSTRUCTION) ISSUES/REVISIONS:


PROJECT NUMBER: DATE: DRAWN BY: CHECKED BY:

DRAWING TITLE: 10TH FLOOR


SIGNAGE PLAN

AI-910

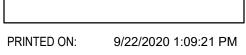


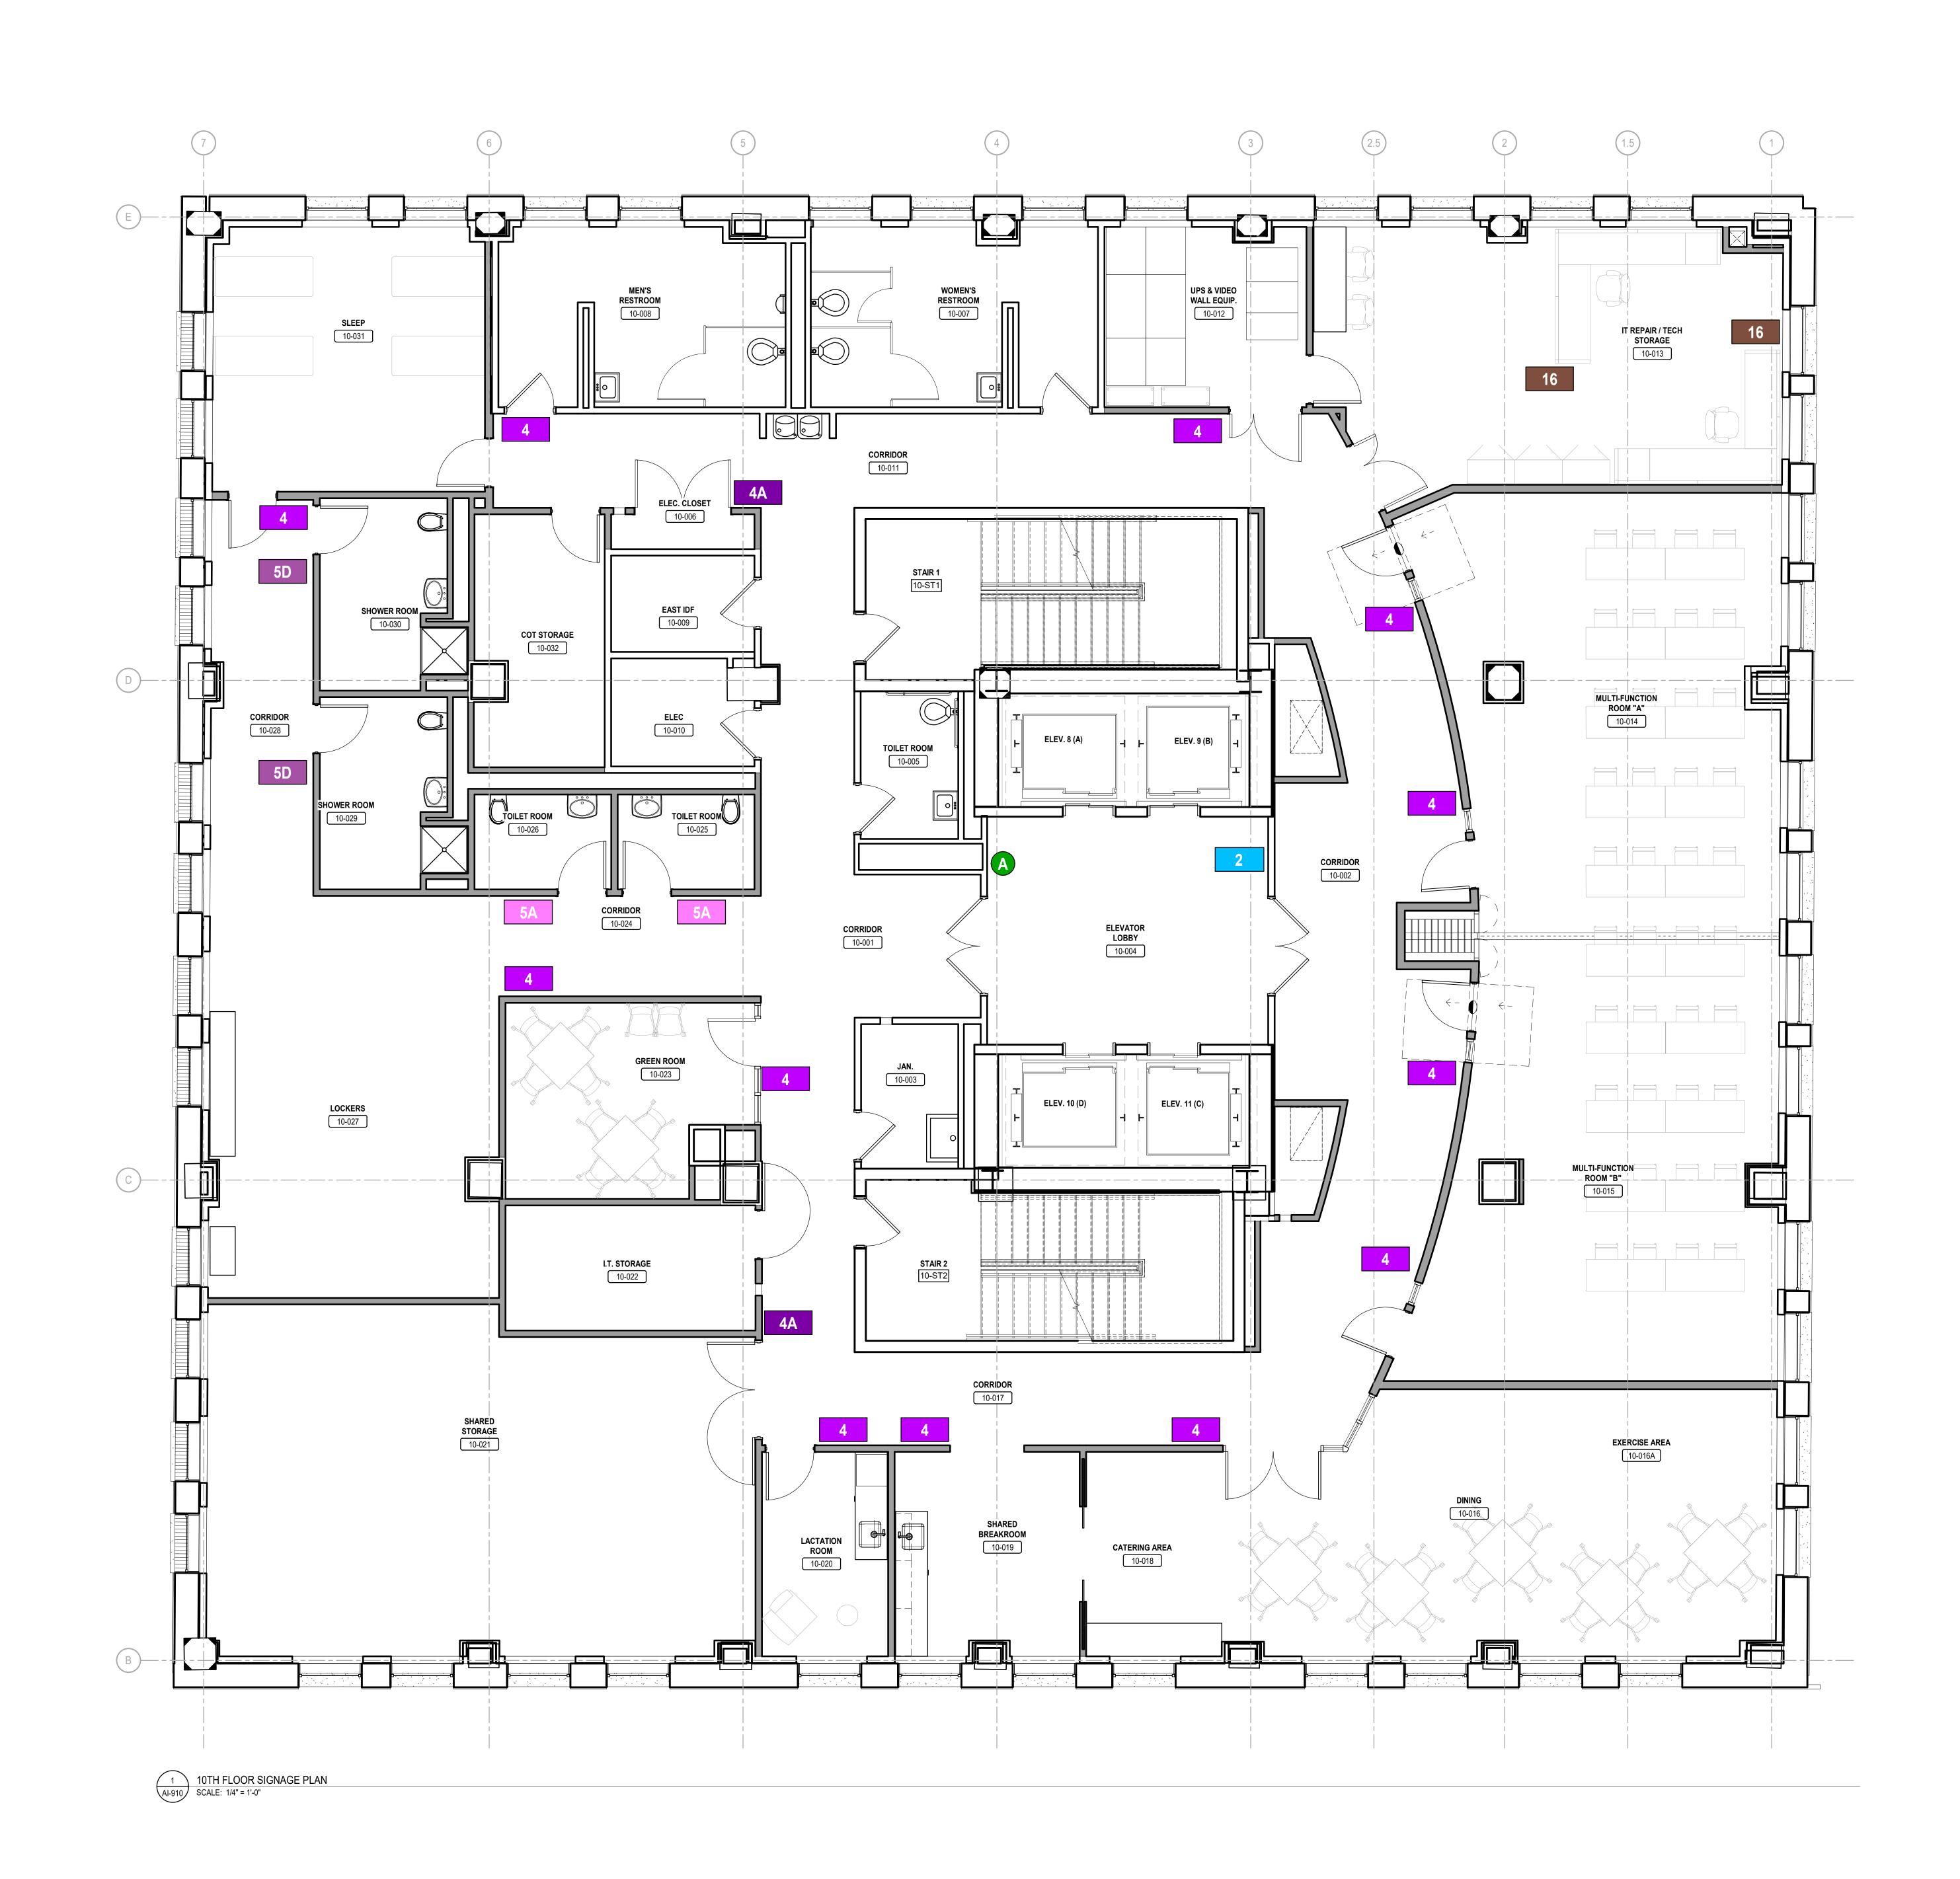


PARTIAL 1ST FLOOR LEVEL FRAMING PLAN - WEST

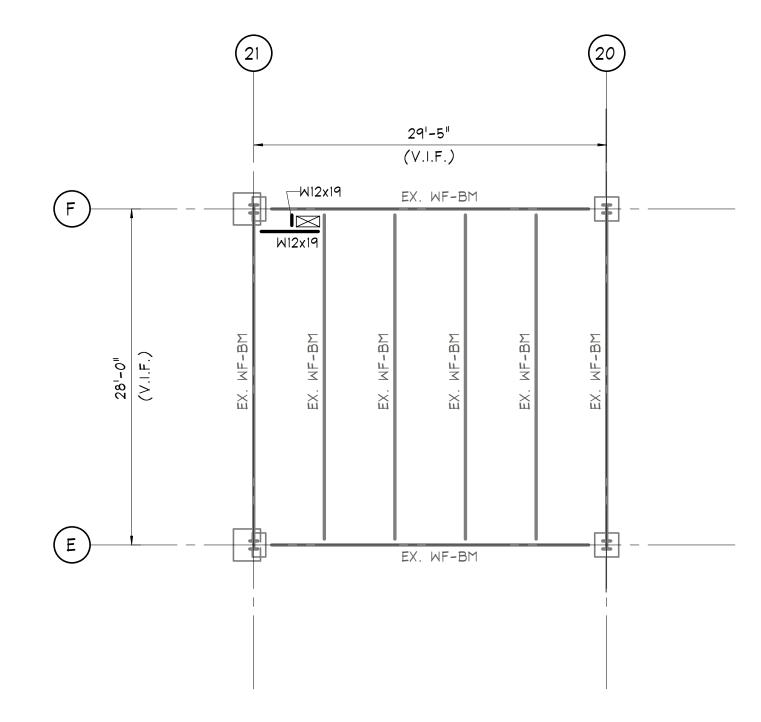


PARTIAL MEZZANINE LEVEL FRAMING PLAN - WEST

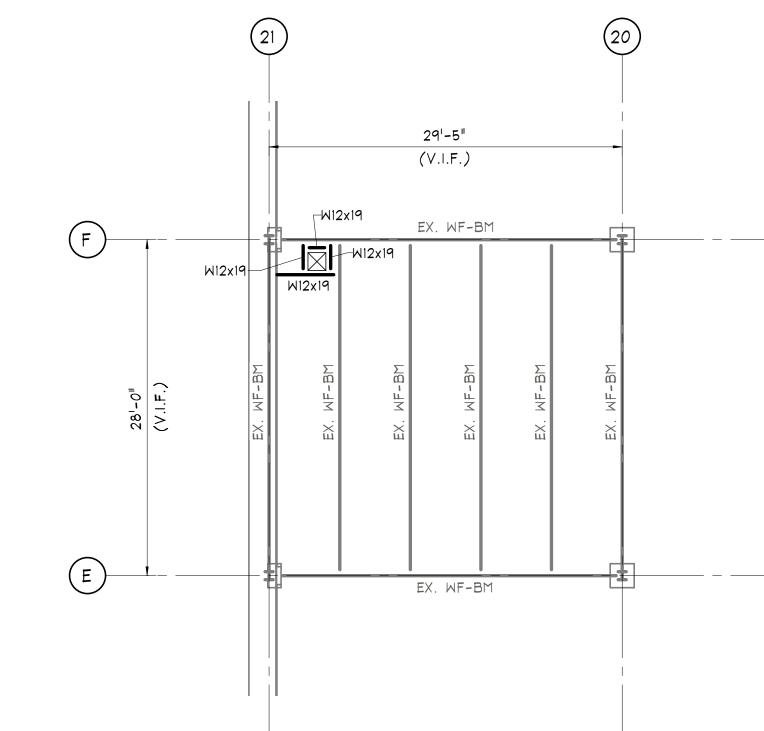

PARTIAL SECOND FLOOR LEVEL FRAMING PLAN - WEST

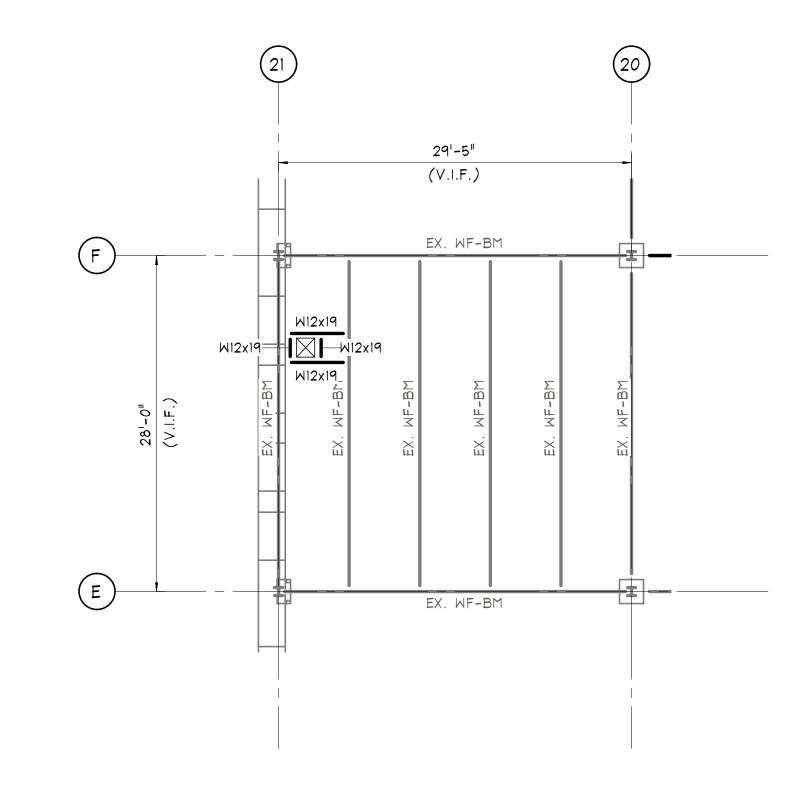


PARTIAL THIRD FLOOR LEVEL FRAMING PLAN - WEST SCALE: 1/8" = 1'-0"

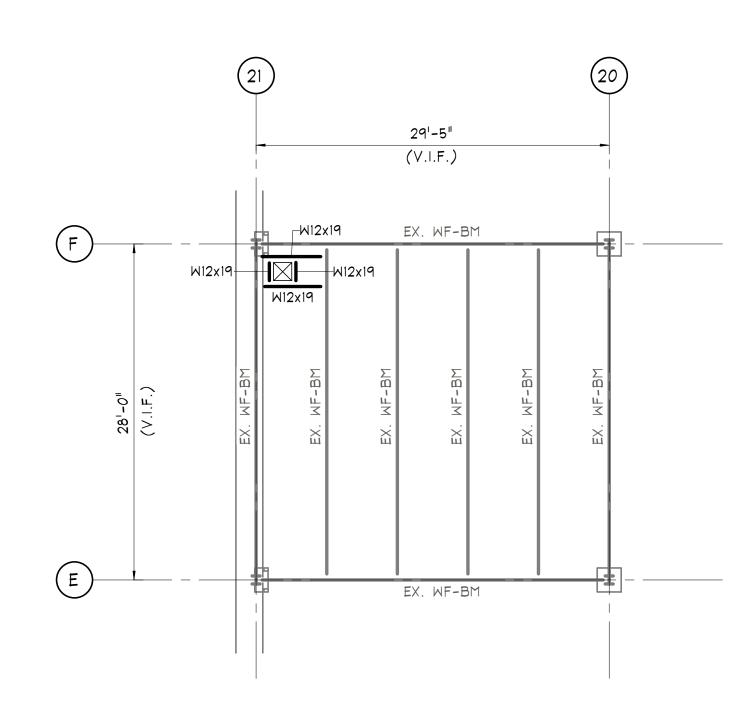


FOURTH FLOOR LEVEL FRAMING PLAN - WEST


SCALE: 1/8" = 1'-0"

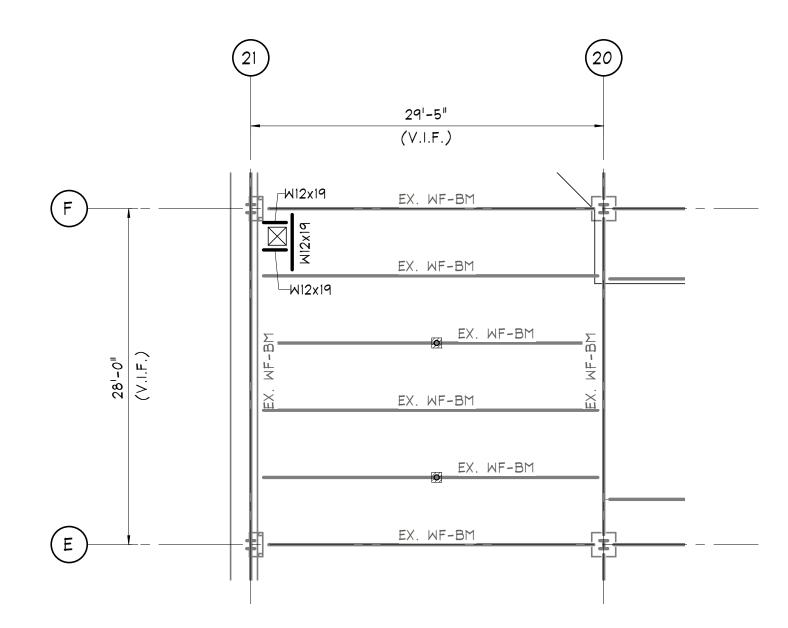

FIFTH FLOOR LEVEL FRAMING PLAN - WEST

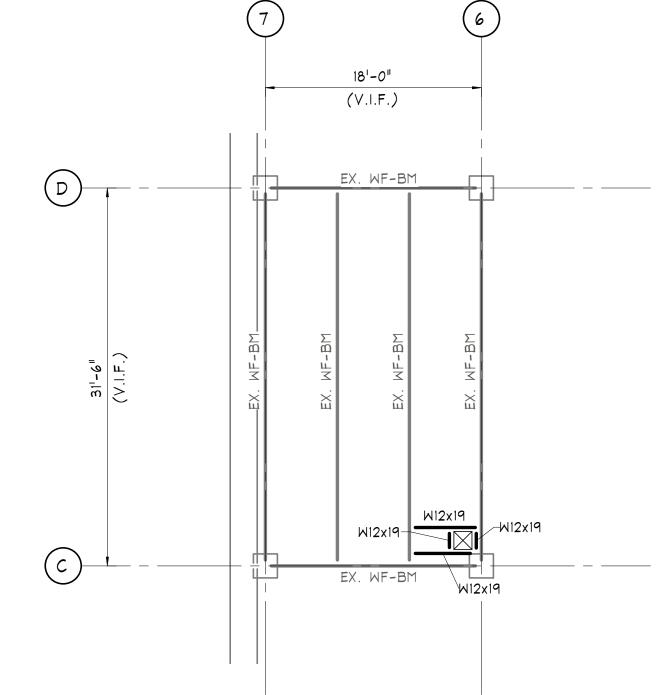

PARTIAL SIXTH, SEVENTH & EIGHT FLOOR FRAMING PLAN - EAST SCALE: 1/8" = 1'-0"

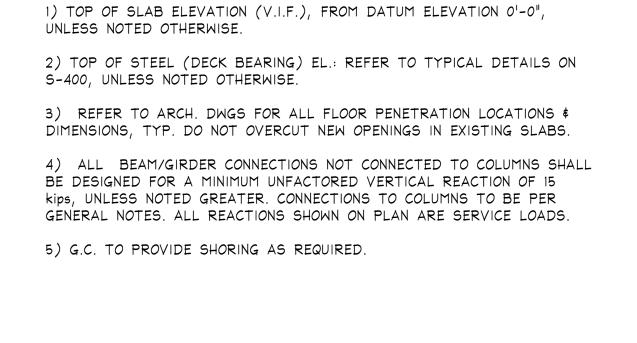



☐ PROGRESS SET ☐ CLIENT REVIEW

☐ CODE REVIEW SET

ISSUES/REVISIONS:

PROJECT NUMBER:

SCALE: DATE: DRAWN BY:

1 09/18/20 ISSUED FOR BID

DRAWING TITLE:
PARTIAL FLOOR

FRAMING PLANS

☐ ISSUED FOR CONSTRUCTION

ISSUED FOR

BIDS

9/18/2020

(NOT FOR CONSTRUCTION)

■ BID SET

IEI GROUP, LTD.

428 North 2nd Street Philadelphia, PA 19123

CONSULTANTS:

Telephone: 215.413.3700

IEI ARCHITECTS, INC.

ARORA°

Arora Engineers, Inc.


61 Wilmington-West Chester Pike Chadds Ford, PA 19317 P (610) 459-7900 F (610) 459-7950


aroraengineers.com


<u>O'Donnell & Naccarato</u> 701 Market Street, Suite 6000 Philadelphia, PA 19106 PH: 215.925.3788

www.o-n.com

3006.0009.00

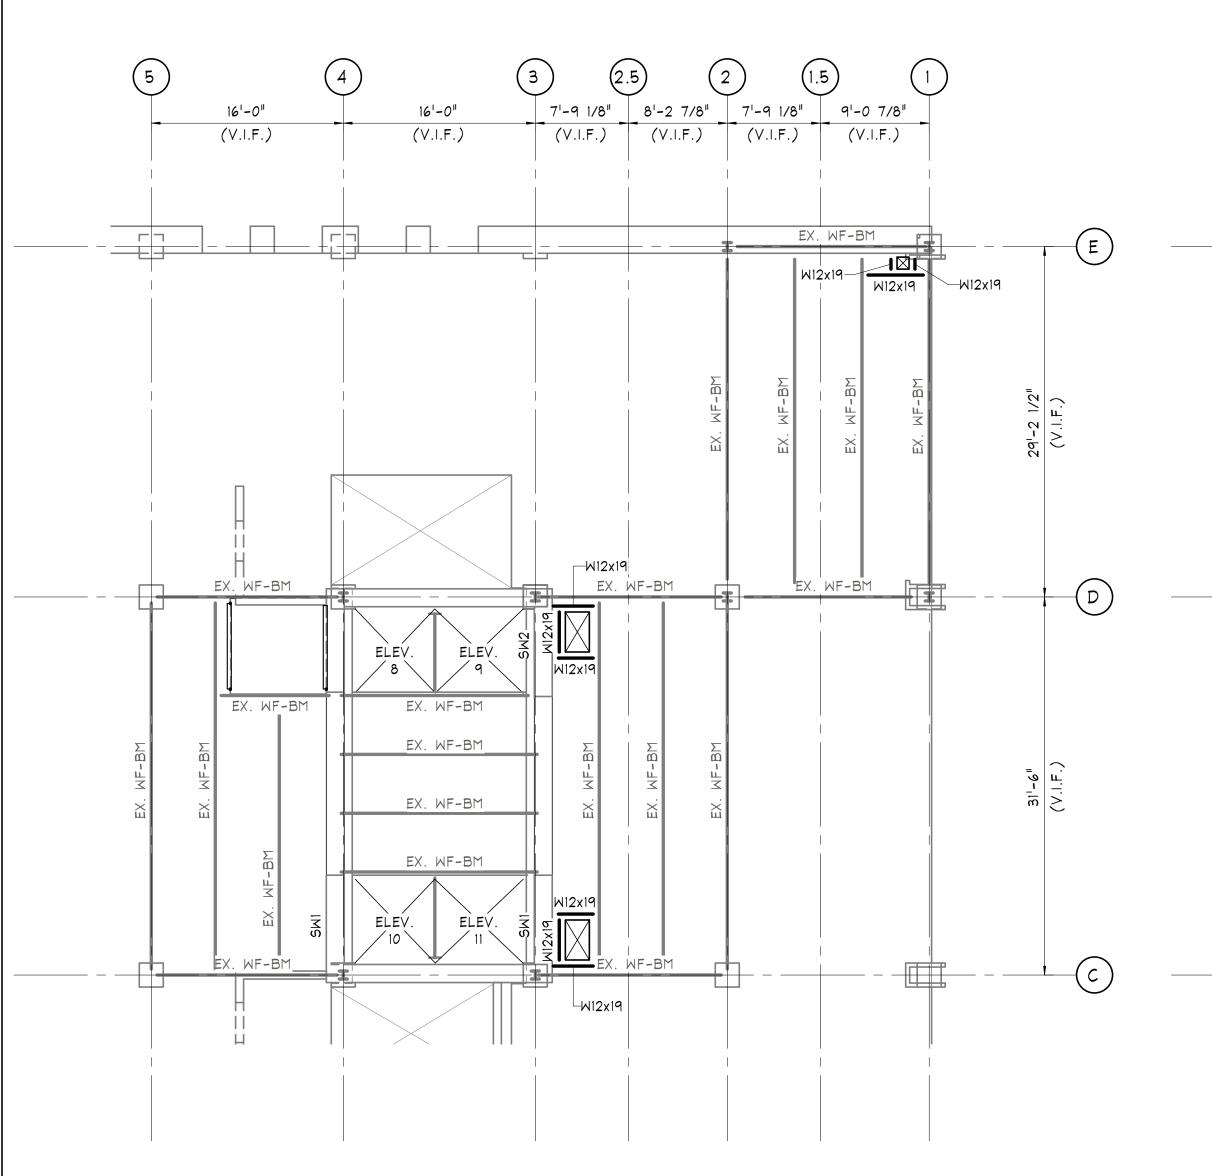

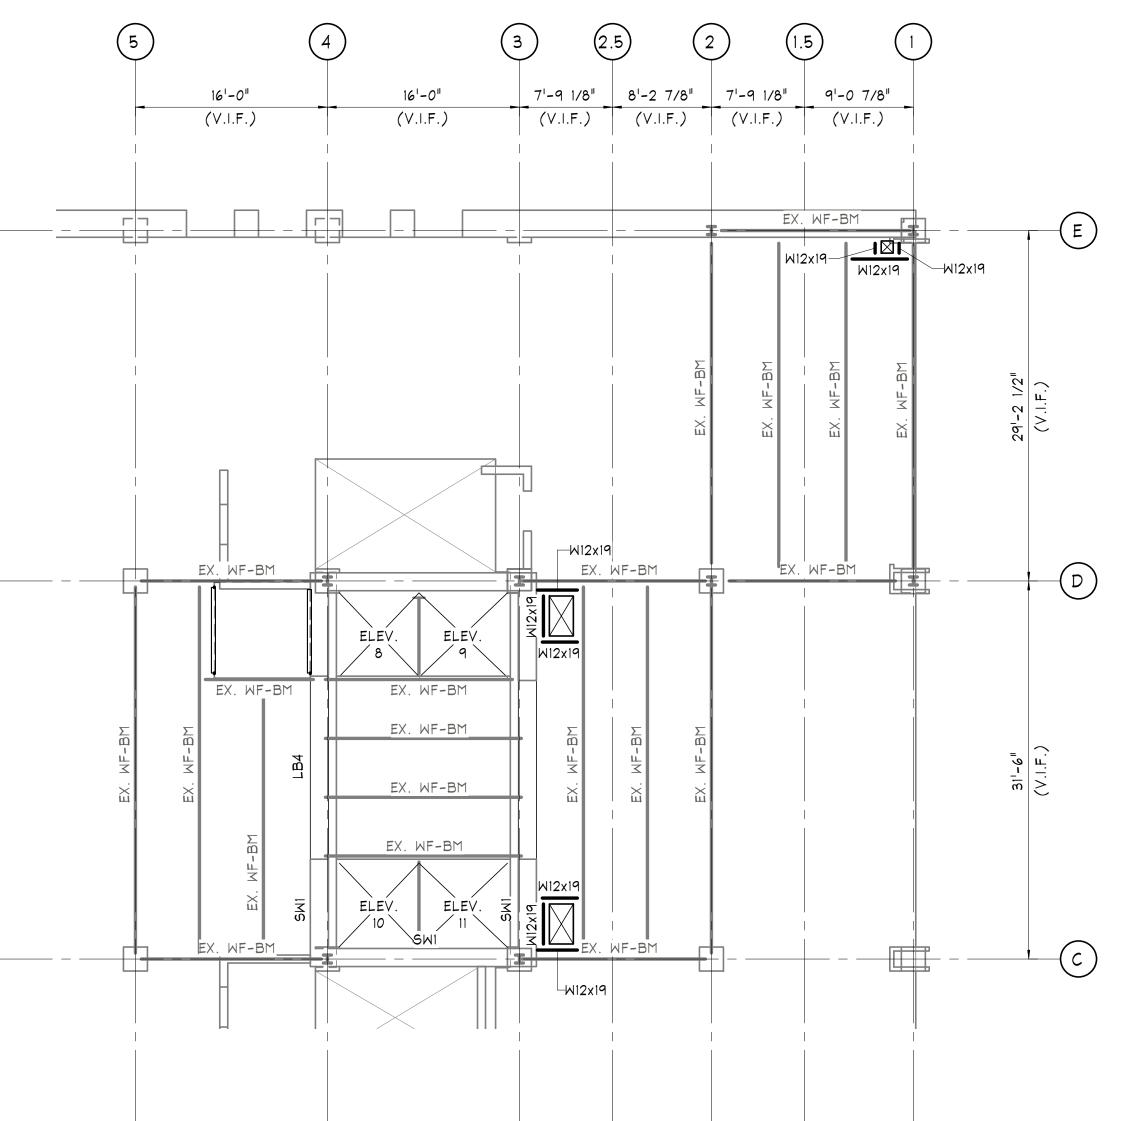

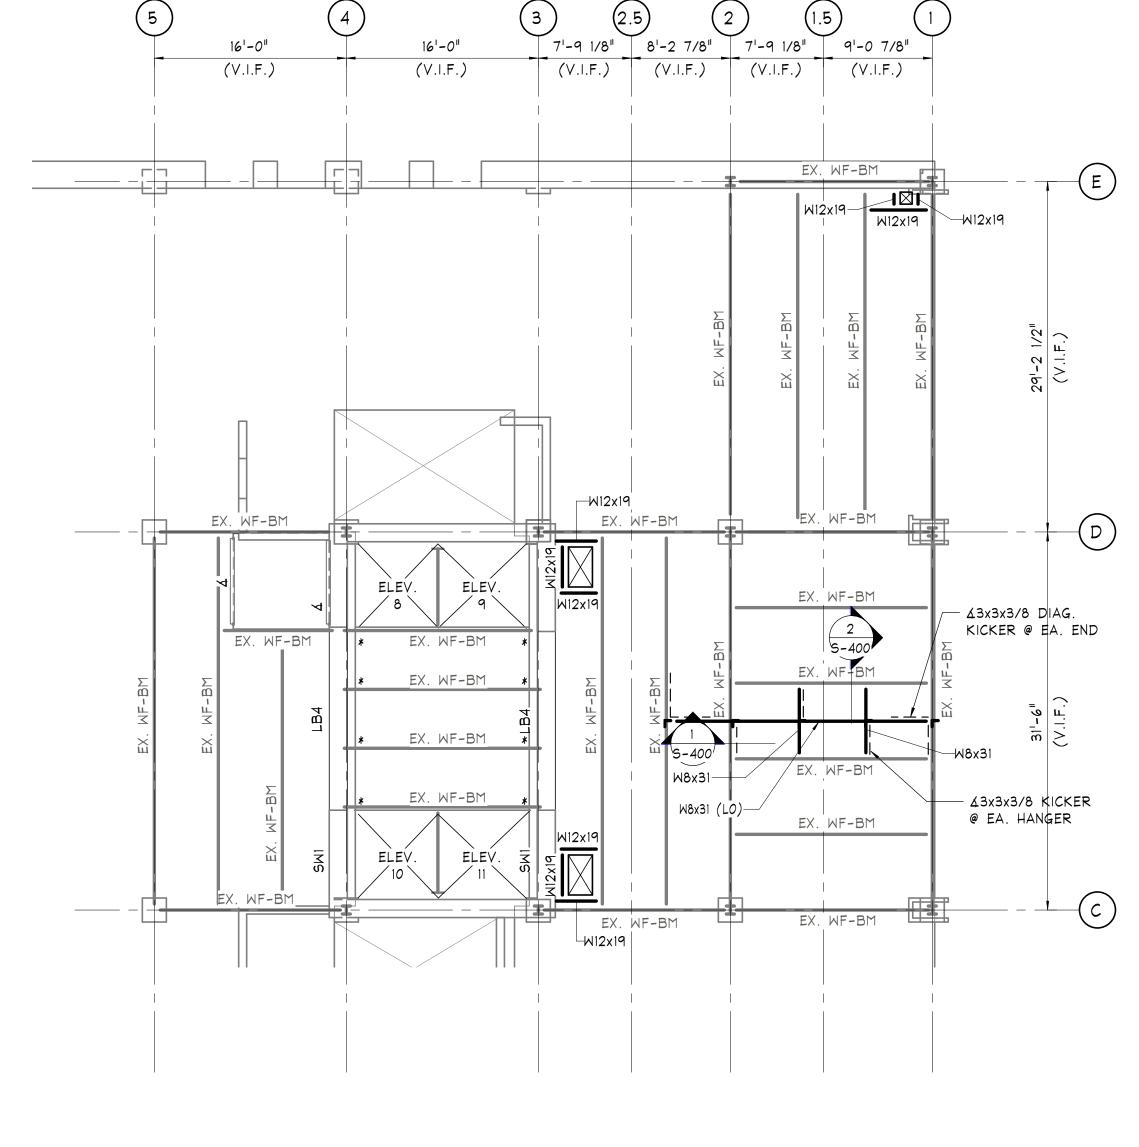

NINTH FLOOR FRAMING PLAN EAST

SCALE: 1/8" = 1'-0" NOTES:

1) TOP OF SLAB ELEVATION +114'-1" (V.I.F.), FROM DATUM ELEVATION 0'-0", UNLESS NOTED OTHERWISE.

2) TOP OF STEEL (DECK BEARING) EL .: REFER TO TYPICAL DETAILS ON S-400, UNLESS NOTED OTHERWISE.

3) REFER TO ARCH. DWGS FOR ALL FLOOR PENETRATION LOCATIONS \$ DIMENSIONS, TYP. DO NOT OVERCUT NEW OPENINGS IN EXISTING SLABS.

4) ALL BEAM/GIRDER CONNECTIONS NOT CONNECTED TO COLUMNS SHALL BE DESIGNED FOR A MINIMUM UNFACTORED VERTICAL REACTION OF 15 kips, UNLESS NOTED GREATER. CONNECTIONS TO COLUMNS TO BE PER GENERAL NOTES. ALL REACTIONS SHOWN ON PLAN ARE SERVICE LOADS.

5) G.C. TO PROVIDE SHORING AS REQUIRED.

TENTH FLOOR FRAMING PLAN EAST

SCALE: 1/8" = 1'-0" NOTES:

1) TOP OF SLAB ELEVATION +126'-1" (V.I.F.), FROM DATUM ELEVATION 0'-0", UNLESS NOTED OTHERWISE.

2) TOP OF STEEL (DECK BEARING) EL .: REFER TO TYPICAL DETAILS ON S-400, UNLESS NOTED OTHERWISE.

3) REFER TO ARCH. DWGS FOR ALL FLOOR PENETRATION LOCATIONS \$ DIMENSIONS, TYP. DO NOT OVERCUT NEW OPENINGS IN EXISTING SLABS.

4) ALL BEAM/GIRDER CONNECTIONS NOT CONNECTED TO COLUMNS SHALL BE DESIGNED FOR A MINIMUM UNFACTORED VERTICAL REACTION OF 15 kips, UNLESS NOTED GREATER. CONNECTIONS TO COLUMNS TO BE PER GENERAL NOTES. ALL

REACTIONS SHOWN ON PLAN ARE SERVICE LOADS. 5) G.C. TO PROVIDE SHORING AS REQUIRED.

ELEVENTH FLOOR FRAMING PLAN EAST

SCALE: 1/8" = 1'-0" NOTES:

1) TOP OF SLAB ELEVATION +138'-1" (V.I.F.), FROM DATUM ELEVATION 0'-O", UNLESS NOTED OTHERWISE.

2) TOP OF STEEL (DECK BEARING) EL .: REFER TO TYPICAL DETAILS ON S-400, UNLESS NOTED OTHERWISE.

3) REFER TO ARCH. DWGS FOR ALL FLOOR PENETRATION LOCATIONS \$ DIMENSIONS, TYP. DO NOT OVERCUT NEW OPENINGS IN EXISTING SLABS.

4) ALL BEAM/GIRDER CONNECTIONS NOT CONNECTED TO COLUMNS SHALL

BE DESIGNED FOR A MINIMUM UNFACTORED VERTICAL REACTION OF 15 kips, UNLESS NOTED GREATER. CONNECTIONS TO COLUMNS TO BE PER GENERAL NOTES. ALL REACTIONS SHOWN ON PLAN ARE SERVICE LOADS.

5) G.C. TO PROVIDE SHORING AS REQUIRED.



IEI GROUP, LTD. IEI ARCHITECTS, INC. 428 North 2nd Street Philadelphia, PA 19123


Telephone: 215.413.3700 CONSULTANTS:

ARORA

Arora Engineers, Inc. 61 Wilmington-West Chester Pike Chadds Ford, PA 19317 P (610) 459-7900 F (610) 459-7950 aroraengineers.com



<u>O'Donnell & Naccarato</u> 701 Market Street, Suite 6000 Philadelphia, PA 19106 PH: 215.925.3788 www.o-n.com 3006.0009.00

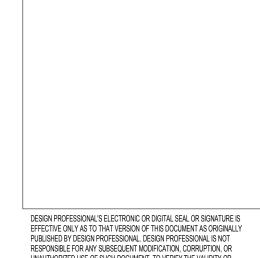

EFFECTIVE ONLY AS TO THAT VERSION OF THIS DOCUMENT AS ORIGINALLY PUBLISHED BY DESIGN PROFESSIONAL DESIGN PROFESSIONAL IS NOT RESPONSIBLE FOR ANY SUBSEQUENT MODIFICATION, CORRUPTION, OR UNAUTHORIZED USE OF SUCH DOCUMENT. TO VERIFY THE VALIDITY OR

ADELPHIA, PROJECTITUE:
400 N. BROAD PARTNERS, L.P.
400 NORTH BROAD STREET PHIL ☐ PROGRESS SET

☐ CLIENT REVIEW

■ BID SET ☐ CODE REVIEW SET ☐ ISSUED FOR CONSTRUCTION

> ISSUED FOR 9/18/2020


(NOT FOR CONSTRUCTION)

ISSUES/REVISIONS: 1 09/18/20 ISSUED FOR BID

PROJECT NUMBER:

DRAWING TITLE: PARTIAL FRAMING **PLANS**

PRINTED ON: 9/21/2020 1:23:48 PM

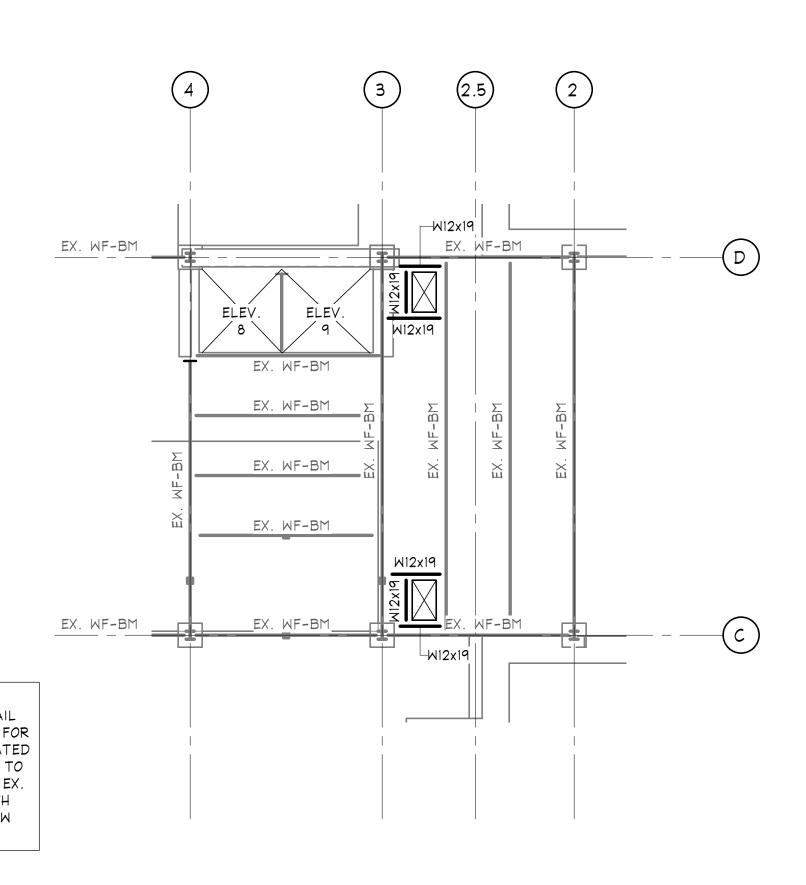

TWELFTH FLOOR FRAMING PLAN EAST SCALE: $1/8^{\parallel} = 1^{1}-0^{\parallel}$

NOTES:

1) TOP OF SLAB ELEVATION +150'-7" (V.I.F.), FROM DATUM ELEVATION 0'-0", UNLESS NOTED OTHERWISE.

2) TOP OF STEEL (DECK BEARING) EL .: REFER TO TYPICAL DETAILS ON S-400, UNLESS NOTED OTHERWISE.

3) REFER TO ARCH. DWGS FOR ALL FLOOR PENETRATION LOCATIONS \$ DIMENSIONS, TYP. DO NOT OVERCUT NEW OPENINGS IN EXISTING SLABS.

4) ALL BEAM/GIRDER CONNECTIONS NOT CONNECTED TO COLUMNS SHALL BE DESIGNED FOR A MINIMUM UNFACTORED VERTICAL REACTION OF 15 kips, UNLESS NOTED GREATER. CONNECTIONS TO COLUMNS TO BE PER GENERAL NOTES. ALL

REACTIONS SHOWN ON PLAN ARE SERVICE LOADS. 5) G.C. TO PROVIDE SHORING AS REQUIRED.

THIRTEENTH FLOOR FRAMING PLAN EAST SCALE: $1/8^{"} = 1^{"} - 0^{"}$


1) TOP OF SLAB ELEVATION +163'-1" (V.I.F.), FROM DATUM ELEVATION 0'-0", UNLESS NOTED OTHERWISE.

2) TOP OF STEEL (DECK BEARING) EL .: REFER TO TYPICAL DETAILS ON S-400, UNLESS NOTED OTHERWISE.

3) REFER TO ARCH. DWGS FOR ALL FLOOR PENETRATION LOCATIONS \$ DIMENSIONS, TYP. DO NOT OVERCUT NEW OPENINGS IN EXISTING SLABS.

4) ALL BEAM/GIRDER CONNECTIONS NOT CONNECTED TO COLUMNS SHALL BE DESIGNED FOR A MINIMUM UNFACTORED VERTICAL REACTION OF 15 kips, UNLESS NOTED GREATER. CONNECTIONS TO COLUMNS TO BE PER GENERAL NOTES. ALL REACTIONS SHOWN ON PLAN ARE SERVICE LOADS.

5) G.C. TO PROVIDE SHORING AS REQUIRED.

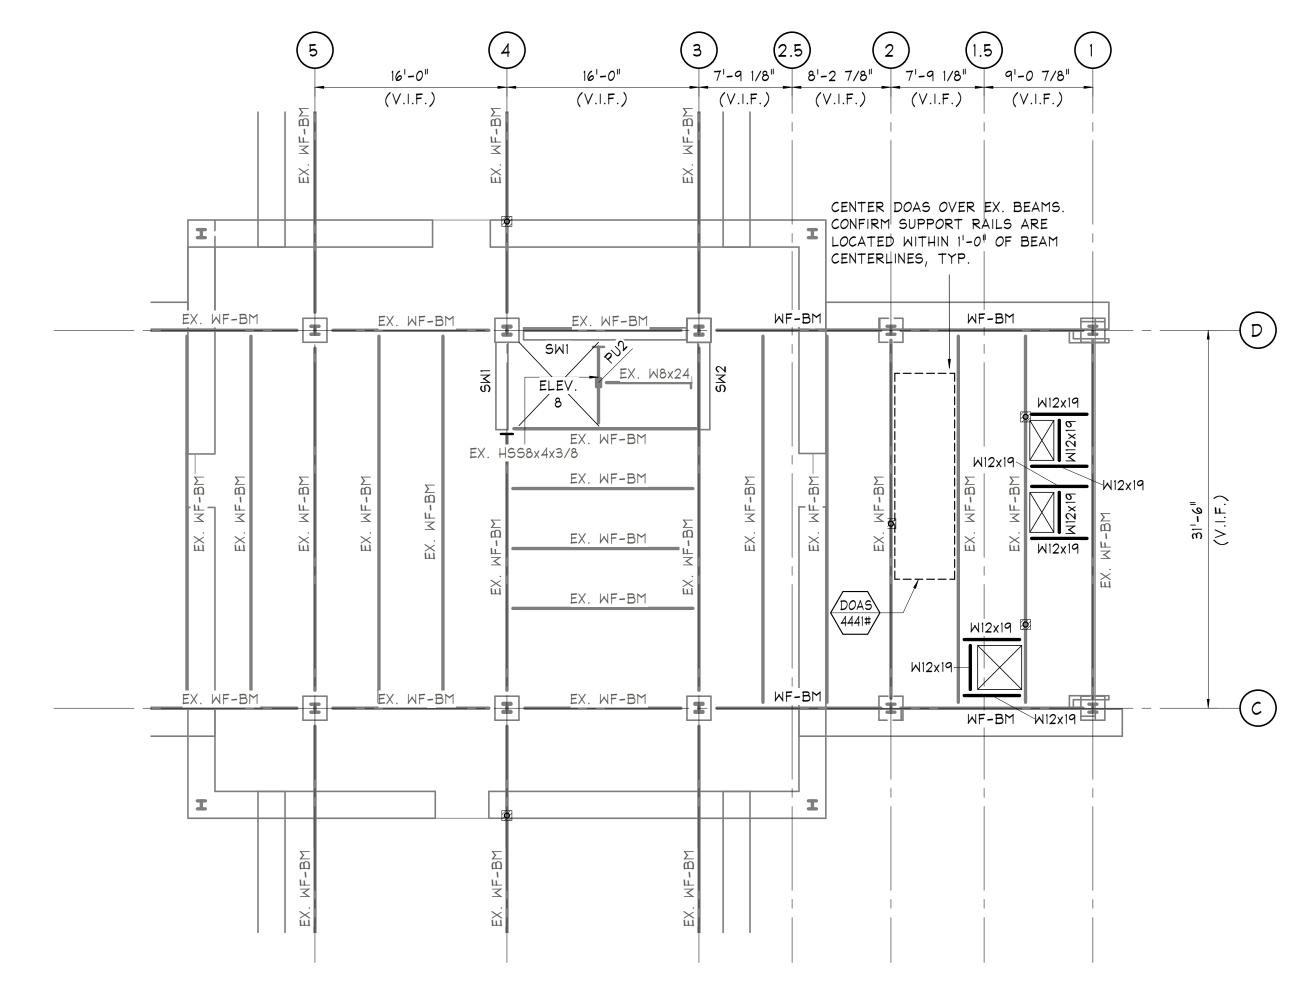

FOURTEENTH FLOOR FRAMING PLAN EAST

SCALE: 1/8" = 1'-0"

NOTES: 1) TOP OF SLAB ELEVATION +175'-7" (V.I.F.), FROM DATUM ELEVATION 0'-0",

UNLESS NOTED OTHERWISE. 2) TOP OF STEEL (DECK BEARING) EL .: REFER TO TYPICAL DETAILS ON S-400,

UNLESS NOTED OTHERWISE.

3) REFER TO ARCH. DWGS FOR ALL FLOOR PENETRATION LOCATIONS \$ DIMENSIONS, TYP. DO NOT OVERCUT NEW OPENINGS IN EXISTING SLABS.

4) ALL BEAM/GIRDER CONNECTIONS NOT CONNECTED TO COLUMNS SHALL BE DESIGNED FOR A MINIMUM UNFACTORED VERTICAL REACTION OF 15 kips, UNLESS NOTED GREATER. CONNECTIONS TO COLUMNS TO BE PER GENERAL NOTES. ALL REACTIONS SHOWN ON PLAN ARE SERVICE LOADS.

5) G.C. TO PROVIDE SHORING AS REQUIRED.



IEI GROUP, LTD. IEI ARCHITECTS, INC. 428 North 2nd Street


Philadelphia, PA 19123 Telephone: 215.413.3700 CONSULTANTS:

ARORA°

Arora Engineers, Inc. 61 Wilmington-West Chester Pike Chadds Ford, PA 19317 P (610) 459-7900 F (610) 459-7950



O'Donnell & Naccarato 701 Market Street, Suite 6000 Philadelphia, PA 19106 PH: 215.925.3788 www.o-n.com 3006.0009.00

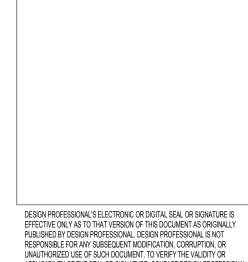

DESIGN PROFESSIONAL SELECTRONIC OR DIGITAL SEAL OR SIGNAL IDEA EFFECTIVE ONLY AS TO THAT VERSION OF THIS DOCUMENT AS ORIGINALLY PUBLISHED BY DESIGN PROFESSIONAL. DESIGN PROFESSIONAL IS NOT RESPONSIBLE FOR ANY SUBSEQUENT MODIFICATION, CORRUPTION, OR UNAUTHORIZED USE OF SUCH DOCUMENT. TO VERIFY THE VALIDITY OR

N. BROAD PARTNERS, L.P. NORTH BROAD STREET PHILADELPHIA, 400 400 400 ☐ PROGRESS SET

☐ CLIENT REVIEW

BID SET

☐ CODE REVIEW SET ☐ ISSUED FOR CONSTRUCTION

> ISSUED FOR 9/18/2020

(NOT FOR CONSTRUCTION) ISSUES/REVISIONS:

1 09/18/20 ISSUED FOR BID

PROJECT NUMBER:

DRAWING TITLE: PARTIAL FRAMING **PLANS**

PRINTED ON: 9/21/2020 1:23:49 PM

GENERATOR PAD PLAN SCALE: 1/8" = 1'-0"

NOTES

1) COORDINATE EQUIPMENT PAD LOCATIONS & EXTENTS ω / ARCH/MEP/CIVIL DRAWINGS & EQUIPMENT MFR. REQUIREMENTS.

2) COORDINATE ALL EQUIPMENT LOCATIONS W/ ARCH./MEP DRAWINGS.

3) ALL EQUIPMENT/MOUNTING REQUIREMENTS TO PRIMARY STRUCTURE TO BE PER MANUFACTURER REQUIREMENTS.

4) COORDINATE VIBRATION ISOLATION REQUIREMENTS WITH M.E.P. DWGS. AND SPECIFICATIONS AND WITH EQUIPMENT MFR.

4) SEE ARCHITECTURAL DRAWINGS FOR DIMENSIONS NOT INDICATED.



IEI GROUP, LTD. IEI ARCHITECTS, INC. 428 North 2nd Street Philadelphia, PA 19123

Telephone: 215.413.3700

CONSULTANTS:

Arora Engineers, Inc. 61 Wilmington-West Chester Pike Chadds Ford, PA 19317 P (610) 459-7900 F (610) 459-7950



O'Donnell & Naccarato 701 Market Street, Suite 6000 Philadelphia, PA 19106 PH: 215.925.3788 www.o-n.com 3006.0009.00



APPLICABILITY OF THE SEAL OR SIGNATURE, CONTACT DESIGN PROFESSIONAL.

400 N. BROAD PARTNERS, L.P. 400 NORTH BROAD STREET PHILADELPHIA, □ PROGRESS SET

☐ CLIENT REVIEW

■ BID SET ☐ CODE REVIEW SET ☐ ISSUED FOR CONSTRUCTION

> ISSUED FOR 9/18/2020

(NOT FOR CONSTRUCTION) ISSUES/REVISIONS: 1 09/18/20 ISSUED FOR BID

PROJECT NUMBER: CHECKED BY:

DRAWING TITLE:
PARTIAL GENERATOR PAD PLAN

PRINTED ON: 9/21/2020 1:23:50 PM

GENERAL CONSTRUCTION

NOTES, TYPICAL DETAILS, AND SCHEDULES APPLY TO ALL STRUCTURAL WORK UNLESS NOTED OTHERWISE. TYPICAL DETAILS ARE TO BE USED FOR ALL CONDITIONS WHERE THE DETAIL IS APPLICABLE, WHETHER OR NOT NOTED ON PLAN. TYPICAL DETAILS MAY BE SLIGHTLY ALTERED IF REQUIRED DUE TO PROJECT CONDITIONS, ONLY WHEN SUBMITTED AND THE ENGINEER'S APPROVAL IS OBTAINED PRIOR TO PERFORMING THE WORK.
 ALL DIMENSIONS AND ELEVATIONS SHOWN ON STRUCTURAL DRAWINGS, WITH THE EXCEPTION OF STRUCTURAL MEMBER SIZES, ARE GENERATED BY OTHER DISCIPLINES. ANY DIMENSIONS OR ELEVATIONS OMITTED OR NOT SHOWN ON THE STRUCTURAL DRAWINGS SHOULD BE OBTAINED FROM THE DRAWINGS OF THE OTHER DISCIPLINES. STRUCTURAL DRAWINGS ARE NOT "STAND-ALONE" DOCUMENTS AND SHOULD BE USED IN CONJUNCTION WITH, AND COORDINATED WITH THE SPECIFICATIONS, ARCHITECTURAL DRAWINGS AND ALL OTHER DISCIPLINE'S DRAWINGS. IF THERE IS A DISCREPANCY BETWEEN DRAWINGS, IT IS THE CONTRACTOR'S RESPONSIBILITY TO NOTIFY THE ENGINEER AND ARCHITECT PRIOR TO PERFORMING THE WORK

3. IF DIFFERENCES OCCUR WITHIN OR BETWEEN DRAWINGS AND SPECIFICATIONS REGARDING MATERIALS, STRENGTHS OR QUANTITIES, THE BETTER MATERIAL, HIGHER STRENGTH, AND GREATER QUANTITY INDICATED, SPECIFIED OR NOTED SHALL BE PROVIDED.

- 4. REPRODUCTIONS OF STRUCTURAL DRAWINGS FOR SUBMITTAL AS SHOP DRAWINGS IS PROHIBITED, UNLESS WRITTEN APPROVAL IS REQUESTED BY THE CONTRACTOR AND IT IS GRANTED BY O'DONNELL & NACCARATO, INC.
- 5. DO NOT SCALE DRAWINGS TO OBTAIN DIMENSIONAL INFORMATION.

SUBCONTRACTORS SEE DETAIL FOR ROOF FRAME REQUIREMENTS

6. THESE DRAWINGS DO NOT DEFINE SCOPE OF CONTRACTOR OR SUBCONTRACTOR CONTRACTS.

7. AT ALL TIMES, THE CONTRACTOR SHALL BE SOLELY RESPONSIBLE FOR THE CONDITIONS OF THE JOBSITE INCLUDING MEANS AND METHODS OF CONSTRUCTION AND SAFETY OF PERSONS AND PROPERTY. THE ENGINEER'S PRESENCE OR REVIEW OF WORK AT THE JOBSITE IS FOR GENERAL COMPLIANCE WITH THE DESIGN INTENT ONLY AND IS NOT EVER TO BE CONSTRUED AS A REVIEW OF MEANS AND METHODS OF CONSTRUCTION AND SAFETY METHODS.

8. THE CONTRACTOR IS RESPONSIBLE FOR DETERMINING ALLOWABLE CONSTRUCTION LOADS AND FOR PROTECTING THE COMPLETED OR INCOMPLETED STRUCTURAL FRAMING FROM DAMAGE DUE TO TEMPORARY CONSTRUCTION LOADINGS.

COSTS OF INVESTIGATION AND/OR REDESIGN DUE TO CONTRACTOR ERRORS WILL BE AT THE CONTRACTOR'S EXPENSE.
 ANY APPROVED CONTRACTOR REQUESTED CHANGES TO THESE DRAWINGS WILL BE DONE AT NO COST TO THE OWNER. APPROVAL OF CONTRACTOR REQUESTED CHANGES IN NO WAY STATES OR IMPLIES APPROVAL OF A CHANGE IN SCOPE OR CHANGE IN CONTRACT COST.

11. UNLESS EXPLICITLY NOTED AS "ISSUED FOR BID", THESE DRAWINGS ARE NOT SUITABLE FOR OBTAINING BIDS FROM GENERAL OR SUBCONTRACTORS. BIDDING OF DRAWINGS PRIOR TO DESIGN COMPLETION AND "ISSUED FOR BID" IS DONE AT THE SOLE RISK OF THE BIDDING CONTRACTOR. ADDITIONS OR CORRECTIONS TO DRAWINGS THAT ARE BID PRIOR TO DESIGN COMPLETION AND "ISSUED FOR BID" WILL NOT BE CONSIDERED AS DESIGN ERRORS OR OMISSIONS. STRUCTURAL DESIGN, BY NATURE, CANNOT BE COMPLETE PRIOR TO COMPLETION OF ARCHITECTURAL AND MECHANICAL DRAWINGS.

12. ALL REFERENCES TO WATER/DAMPROOFING, FIREPROOFING, AND UTILITIES ON THE STRUCTURAL DRAWINGS ARE FOR REFERENCE ONLY. SEE ARCHITECTURAL DRAWINGS, SPECIFICATIONS, AND OTHER DOCUMENTS FOR ALL WATER/DAMPROOFING, FIREPROOFING AND UTILITIY DETAILS AND REQUIREMENTS. COORDINATE ALL UNDERGROUND UTILITY REQUIREMENTS WITH THE CIVIL/MEP DRAWINGS. ALL UTILITES SHALL BE ABOVE/BELOW FOOTING AND NOT LOCATED WITHIN THE FOOTINGS. NOTIFY ENGINEER OF RECORD IF OTHERWISE

13. IF THE EXISTING FIELD CONDITIONS DO NOT PERMIT THE INSTALLATION OF THE WORK IN ACCORDANCE WITH THE DETAILS SHOWN, THE CONTRACTOR SHALL NOTIFY THE ARCHITECT/ENGINEER IMMEDIATELY. THE CONTRACTOR MUST PROVIDE A SKETCH OF THE CONDITION WITH HIS PROPOSED MODIFICATION OF THE DETAILS GIVEN ON THE CONTRACT DOCUMENTS. THIS SKETCH MUST BE SUBMITTED TO AND APPROVAL MUST BE GRANTED BY THE ENGINEER PRIOR TO PERFORMING THE WORK.

14. SUBMIT SHOP DRAWINGS SUCH THAT BY THE TIME THEY ARE RECEIVED BY O'DONNELL & NACCARATO, INC., THERE WILL BE AT LEAST 14 DAYS BEFORE REVIEWED SUBMITTALS WILL BE NEEDED. ANY REVIEW THAT IS REQUIRED MORE EXPEDIENTLY WILL BE AT THE CONTRACTOR'S EXPENSE. SHOP DRAWINGS SHALL BEAR THE CONTRACTOR'S STAMP OF APPROVAL CERTIFYING THAT HE HAS VERIFIED ALL FIELD MEASUREMENTS, CONSTRUCTION CRITERIA, MATERIALS AND SIMILAR DATA AND HAS CHECKED EACH DRAWING FOR COMPLETENESS, COORDINATION AND COMPLIANCE WITH THE CONTRACT DOCUMENTS. IF REVIEW OF AN INCOMPLETE SHOP DRAWING IS REQUIRED, THAT SHOP DRAWING SHALL BE CLEARLY MARKED AS INCOMPLETE. THE AREA THAT NEEDS TO BE REVIEWED SHALL BE CLEARLY NOTED WITH AN EXPLANATION FOR THE REASON FOR PARTIAL APPROVAL.

15. IN NO CASE SHALL HEAVY EQUIPMENT BE PERMITTED CLOSER THAN 8'-0" FROM ANY FOUNDATION/BASEMENT WALL. IF THE CONTRACTOR DEEMS IT NECESSARY TO OPERATE SUCH EQUIPMENT CLOSER THEN 8'-0", THE CONTRACTOR SHALL BE SOLELY RESPONSIBLE AND, AT HIS OWN EXPENSE, PROVIDE ADEQUATE SUPPORTS OR WALL BRACES TO WITHSTAND THE ADDITIONAL LOADS SUPERIMPOSED FROM SUCH EQUIPMENT.

16. SIZE AND/OR LOCATION OF OPENINGS, SLEEVES, CONCRETE HOUSEKEEPING PADS, INSERTS, DEPRESSIONS, ETC. SHOWN ON THE STRUCTURAL DOCUMENTS ARE FOR THE CONTRACTOR'S CONVENIENCE ONLY. THE CONTRACTOR IS SOLELY RESPONSIBLE TO COORDINATE ALL CONTRACT DOCUMENTS TO DETERMINE THE SIZE AND/OR LOCATION OF OPENINGS, SLEEVES, CONCRETE HOUSEKEEPING PADS, INSERTS, DEPRESSIONS, ETC.

17. SIZE AND/OR LOCATION OF EXISTING STRUCTURES AND UTILITIES SHOWN ON THE STRUCTURAL DOCUMENTS ARE FOR THE CONTRACTOR'S CONVENIENCE ONLY. THE CONTRACTOR IS SOLELY RESPONSIBLE TO VERIFY BY FIELD MEASUREMENTS/INVESTIGATION THE SIZE AND/OR LOCATION OF ALL EXISTING STRUCTURES AND UTILITIES.

18. THE CONTRACTOR SHALL SUBMIT SIGNED AND SEALED CALCULATIONS AND SHOP DRAWINGS BY A STRUCTURAL ENGINEER REGISTERED IN THE STATE IN WHICH THE PROJECT IS LOCATED SHOWING DESIGNS OF METAL STAIRS, METAL RAILINGS AND CONNECTIONS TO STRUCTURE TAKING INTO ACCOUNT THE VERTICAL AND LATERAL LOADS STATED IN THE GOVERNING CODES. WHERE HEADERS OR OTHER TYPES OF STRUCTURAL MEMBERS HAVE BEEN DESIGNATED ON THE STRUCTURAL CONTRACT DOCUMENTS TO SUPPORT THE STAIRS, THE CONNECTIONS FROM THE STAIRS SHALL BE DESIGNED SO THAT NO ECCENTRIC OR TORSIONAL FORCES ARE IMPOSED ON THESE STRUCTURAL MEMBERS. IF ECCENTRIC CONNECTIONS ARE USED, CONTRACTOR SHALL PROVIDE BRACING ELEMENTS FOR ALL SUPPORTING STEEL TO ELIMINATE THE TORSIONAL EFFECTS OF THE ECCENTRIC CONNECTIONS. THE CONTRACTOR SHALL BE RESPONSIBLE FOR FURNISHING AND INSTALLING ALL EMBEDDED ITEMS AND HARDWARE AS REQUIRED PER THE STAIR DESIGN.

STRUCTURAL COMPONENTS ARE NOT DESIGNED FOR VIBRATING EQUIPMENT. MOUNT VIBRATING EQUIPMENT ON VIBRATION ISOLATORS, INERTIA PADS, ETC.
 EXACT LOCATIONS OF ROOF PENETRATIONS TO BE COORDINATED BY THE GENERAL CONTRACTOR BETWEEN STEEL/JOIST/DECK/HVAC

21. ALL MISCELLANEOUS ELEVATOR COMPONENTS, SUCH AS GUARDING OF COUNTERWEIGHTS, SHAFT WALL MOUNTED EQUIPMENT/TRACK SUPPORTS, CONNECTION OF GUIDE RAILS TO PRIMARY STRUCTURE, ETC. ARE TO BE PROVIDED BY / COORDINATED WITH THE ELEVATOR MANUFACTURER. PROVIDED ALLOWANCE FOR ADDITIONAL SUPPLEMENTAL STEEL SUPPORTS, SUCH AS LOW BEAMS FOR BRACING OF ELEVATOR DOOR HEADERS, FINAL HOIST BEAM / MACHINE BEAM CONFIGURATIONS, GUIDE RAIL SUPPORT POSTS, ETC. AS APPROPRIATE UNTIL FINAL SITE SPECIFIC ELEVATOR SHOP DRAWINGS ARE RECEIVED.

EXISTING CONDITIONS/DEMOLITION

1. SHORING, BRACING, PROTECTION, AND UNDERPINNING OF EXISTING AND ADJACENT STRUCTURES DURING CONSTRUCTION, INCLUDING ALL DESIGN RESPONSIBILITIES, IS THE SOLE RESPONSIBILITY OF THE CONTRACTOR. PROVIDE SIGNED AND SEALED CALCULATIONS AND DRAWINGS TO OWNER. PROTECT AND MAINTAIN THE INTEGRITY OF EXISTING AND ADJACENT STRUCTURES, BUILDINGS AND STREETS,

2. ALL EXISTING DIMENSIONS, ELEVATIONS, AND LOCATIONS OF EXISTING STRUCTURES, OR RELATIVE TO EXISTING STRUCTURES, THAT ARE SHOWN ON THE STRUCTURAL DOCUMENTS WILL BE VERIFIED BY FIELD MEASUREMENTS PERFORMED BY THE CONTRACTOR. ANY DISCREPANCIES

SHALL BE REPORTED TO THE ARCHITECT AND ENGINEER.

3. THE STRUCTURAL DOCUMENTS HAVE BEEN PREPARED BASED ON AVAILABLE KNOWLEDGE OF EXISTING CONDITIONS. IF, DURING DEMOLITION, EXCAVATION OR CONSTRUCTION, ACTUAL CONDITIONS ARE DISCOVERED TO DIFFER FROM THOSE INDICATED ON THE DOCUMENTS, THE ARCHITECT

ALL STRUCTURAL DEMOLITION MUST BE COORDINATED WITH THE ARCHITECTURAL, MECHANICAL, ELECTRICAL, AND PLUMBING DRAWINGS.
 SELECTIVELY DEMOLISH STRUCTURAL COMPONENTS AS REQUIRED TO CONSTRUCT NEW WORK. PRIOR TO ANY DEMOLITION WORK, AN ENGINEERING SURVEY REPORT OF THE STRUCTURE SHALL BE PREPARED BY THE CONTRACTOR TO DOCUMENT THE CONDITION OF THE FRAMING, FLOORS, AND WALLS. ANY ADJACENT STRUCTURE WHERE OCCUPANTS MAY BE EXPOSED SHALL BE SIMILARLY REVIEWED.

6. WHERE NEW FRAMING IS TO BE CONNECTED TO AN EXISTING STRUCTURE WITH BRICK OR CMU VENEER, THE VENEER SHALL BE REMOVED SUFFICIENTLY TO PERMIT CONNECTION OF THE NEW FRAMING DIRECTLY TO THE BUILDING SUPERSTRUCTURE. NEW BRICK OR CMU SHALL BE INSTALLED TO MATCH THE EXISTING ADJACENT SURFACES. MAINTAIN A 1/2" SEPARATION BETWEEN THE BRICK OR CMU AND THE NEW FRAMING, UNLESS NOTED OTHERWISE ON DRAWINGS. FILL GAPS WITH BACKER RODS AND SEALANTS.

7. CONTRACTOR TO FIELD VERIFY ALL EXISTING FINISHED FLOOR ELEVATIONS PRIOR TO FABRICATION OF STEEL BEGINS. PROVIDE ALLOWANCE FOR ADDITIONAL LEVELING MATERIAL IN AREAS OF BREAK THROUGH TO THE EXISTING STRUCTURE TO ENSURE FINISHED FLOOR ELEVATION OF NEW MATCHES EXISTING.

8. CONTRACTOR SHALL RETAIN INDIVIDUAL TO PERFORM SITE SAFETY DEMOLITION PLAN, ENGINEERING STUDY AND ALL OTHER SERVICES RELATED TO DEMOLITION IN ACCORDANCE WITH LOCAL JURISDICTION REQUIREMENTS.

STRUCTURAL SPECIAL INSPECTIONS

1. THE QUALIFIED AGENCY RETAINED BY THE OWNER FOR THESE SPECIAL INSPECTION SERVICES SHALL BE APPROVED BY THE OWNER, THE ARCHITECT, AND THE ENGINEER OF RECORD PRIOR TO START OF CONSTRUCTION. AN OUTLINE OF THE SCOPE OF SERVICES TO BE PERFORMED BY THE INSPECTING AGENCY IS TO BE SUBMITTED PRIOR TO THE START OF CONSTRUCTION.

2. IN ACCORDANCE WITH SECTION 1704 OF THE INTERNATIONAL BUILDING CODE, AND ALL APPLICABLE STATE AND LOCAL REQUIREMENTS, AN INDEPENDENT APPROVED AGENCY SHALL MAKE PERIODIC AND/OR CONTINUOUS INSPECTIONS OF THE CONSTRUCTION PROGRESS IN ACCORDANCE WITH THE FOLLOWING REQUIREMENTS:

STEEL CONSTRUCTION SECTION 1704.3. TABLE 1704.3

SECTION 1704.4, TABLE 1704.4

SECTION 1704.7. TABLE 1704.7

SECTION 1704.8. TABLE 1704.8

SECTION 1704 5 1 TABLE 1704 5 1- 3

PILE FOUNDATIONS

CONCRETE CONSTRUCTION

MASONRY CONSTRUCTION

FOUNDATIONS

1. PERFORM ALL SITE PREPARATION AND EXCAVATION WORK IN STRICT ACCORDANCE WITH THE GEOTECHNICAL REPORT PREPARED BY PENNONI ASSOCIATES, INC., #USAT 1701.GE002, DATED MARCH 27, 2018.

2. EXCAVATE THE BUILDING SITE TO THE DEPTH AND EXTENT INDICATED IN THE SOILS REPORT. ALL SUBGRADES SHALL BE APPROVED IN WRITING BY THE SOILS ENGINEER PRIOR TO BACKELLING

WRITING BY THE SOILS ENGINEER PRIOR TO BACKFILLING.

3. BOTTOM OF FOOTINGS SHALL BEAR ON SUBGRADE CAPABLE OF SAFELY SUPPORTING 4,000 PSF PER THE GEOTECHNICAL REPORT.

SUBGRADE OF ALL FOOTINGS MUST BE INSPECTED UNDER THE SUPERVISION OF AND APPROVED BY A REGISTERED SOILS ENGINEER BEFORE PLACING ANY CONCRETE. APPROVAL IN WRITING MUST INDICATE THE SOIL IS ADEQUATE TO SAFELY SUSTAIN SPECIFIED SOIL BEARING PRESSURE.
 BOTTOM OF ALL EXTERIOR FOOTINGS SHALL BE A MINIMUM OF THREE FEET BELOW EXTERIOR FINISH GRADE. ALL FOOTING ELEVATIONS SHOWN ON PLAN ARE THE BEST APPROXIMATIONS BASED ON AVAILABLE DATA. GENERAL CONTRACTOR MAY ALTER FOOTING ELEVATIONS FOR REASONS INCLUDING, BUT NOT LIMITED TO, REVISED GEOTECHNICAL OR CIVIL INFORMATION, UNFORESEEN CONDITIONS, ACTUAL INVERT ELEVATIONS, CONSTRUCTABILITY, ETC. CONTRACTOR SHALL NOTIFY ARCHITECT AND OBTAIN WRITTEN APPROVAL PRIOR TO ANY MODIFICATIONS.

6. ALL STEEL PILES SHALL BE AS SPECIFIED IN THE SOILS REPORT AND SHALL HAVE A CAPACITY TO SUPPORT A NET DESIGN DOWNWARD LOAD OF 275 TONS, A NET DESIGN UPLIFT LOAD OF 220 TONS AND A DESIGN LATERAL LOAD OF 5.5 TONS.

7. INSTALL PILES IN ACCORDANCE WITH A SUITABLE DYNAMIC FORMULA TO BE SELECTED BY THE SOILS ENGINEER.

8. THE INSPECTION OF THE INSTALLATION OF PILES SHALL BE SUPERVISED AND CERTIFIED BY A REGISTERED SOILS ENGINEER.
9. PILING CONTRACTOR SHALL PERFORM A PILE LOAD TEST IN ACCORDANCE WITH THE SOILS REPORT.

10. GENERAL CONTRACTOR SHALL PROVIDE A FINAL REPORT CONSISTING OF THE FOLLOWING ITEMS: COMPLETE DRIVING RECORDS, CERTIFIED PILE LOCATION PLAN PREPARED BY A REGISTERED LAND SURVEYOR, TIP ELEVATIONS, PILE OUT OF PLUMB, BLOW COUNTS, AND A COMMENTARY ON DRIVING PROBLEMS SUCH AS SUSPECTED BENDING, TWISTING AND OUT-OF-PLUMB. REPORT SHALL BE SUBMITTED TO THE ENGINEER FOR REVIEW PRIOR TO CONCRETE PLACEMENT FOR PILE CAPS AND GRADE BEAMS.

DO NOT BACKFILL ANY BASEMENT WALLS WITH AN UNBALANCED HEIGHT OF SOIL GREATER THAN THREE FEET UNTIL ELEVATED FLOOR IS IN-PLACE AND THE WALL HAS REACHED ITS DESIGN STRENGTH OR THE WALLS ARE ADEQUATELY BRACED.
 EXPOSED CONCRETE/CMU WALLS SHALL HAVE CONTROL JOINTS AT 30 FEET MAXIMUM ON CENTER UNLESS NOTED OTHERWISE. WALLS WITH

INTEGRAL COLUMN PIERS OR PILASTERS SHALL BE POURED MONOLITHICALLY AND SHALL HAVE A FORMED CONTROL JOINT ON ONE SIDE OF EACH PIER ON THE EXPOSED FACE OF THE WALL. JOINTS SHALL BE FILLED WITH AN APPROVED SEALANT.

LIGHTGAGE METAL FRAMING

1. LIGHTGAGE METAL STUD DESIGNATION SHOWN ON STRUCTURAL DRAWINGS ASSUME MARINO WARE AS A DESIGN BASIS. MANUFACTURER MUST SUBMIT LITERATURE INDICATING THAT THE MEMBERS SUPPLIED PROVIDE EQUIVALENT STRENGTH AND STIFFNESS. MANUFACTURER AND/OR SUPPLIER TO PREPARE INFORMATION INDICATING CAPACITY OF MEMBERS, FRAMING DETAILS, CONNECTIONS, BRACING, BRIDGING AND ALL OTHER APPURTENANCES OF MEMBERS TO CONFORM TO LOAD CRITERIA AS DIRECTED BY CONTRACTOR/CONSTRUCTION MANAGER.

2. ALL LINTELS INDICATED ON DRAWINGS AS METAL STUD LINTELS ARE TO BE PROVIDED BY STUD MANUFACTURER/SUPPLIER.

3. ALL STEEL STUDS SHALL BE HOT-DIPPED GALVANIZED (G 60) IN ACCORDANCE WITH ASTM A924. STEEL STUDS SHALL BE DESIGNED, MANUFACTURED AND INSTALLED IN ACCORDANCE WITH THE LATEST AISC SPECIFICATIONS AND SHALL COMPLY WITH ASTM A653 & C955. ALL STUDS, JOISTS, AND ACCESSORIES SHALL HAVE THE FOLLOWING MATERIAL STRENGTHS:

54 MILS (16 GAGE) AND HEAVIER - FY = 50KSI. 33 MILS, 43 MILS (20 GAGE, 18 GAGE RESPECTIVELY) - FY = 33KSI.

4. ALL WELDING OF LIGHT GAGE STEEL FRAMING MUST BE DONE BY CERTIFIED WELDERS IN ACCORDANCE WITH AWS D1.3, SPECIFICATION FOR WELDING SHEET STEEL IN STRUCTURES.
 5. MAKE CONNECTIONS WITH SELF-TAPPING SCREWS OR WELDING SO THAT THE CONNECTIONS MEET OR EXCEED THE DESIGN LOADS. ALWAYS

USE WELDS WHERE SHOWN ON DRAWINGS.

6. CUT ALL LIGHT GAGE STEEL FRAMING MEMBERS WITH SAWS OR SHEARS. FLAME CUTTING IS NOT PERMITTED.

7. THE LIGHT GAGE STEEL FRAMING SUPPLIER AND ERECTOR SHALL HAVE A MINIMUM 5 YEARS EXPERIENCE IN THE FABRICATION AND ERECTION OF LIGHT GAGE STEEL FRAMING SYSTEMS.

8. THE CONTRACTOR SHALL DELIVER TO THE ENGINEER, AT THE END OF THE JOB, ONE (1) ELECTRONIC VERSION OF THE FINAL FIELD COPIES OF ALL TRUSS LAYOUT SHOP DRAWINGS.

1. ALL STRUCTURAL STEEL SHALL BE FABRICATED AND ERECTED IN ACCORDANCE WITH THE LATEST AISC CODE. ALL CONNECTIONS, INCLUDING AT HSS SECTIONS, SHALL BE DESIGNED AND DETAILED IN ACCORDANCE WITH THE LATEST AISC CODE. UNLESS INDICATED OTHERWISE ON CONTRACT DOCUMENTS, IN ADDITION TO THE SHEAR CONNECTION, INCLUDE AS A MINIMUM, 4X4X3/8 ANGLES TOP AND BOTTOM OR ENDPLATE AT ALL HSS BEAMS/GIRDERS TO COLUMN CONNECTIONS. ALL WIDE FLANGE SHAPES SHALL BE ASTM A992. ALL OTHER STRUCTURAL STEEL SHALL BE ASTM A36 UNLESS NOTED OTHERWISE. ALL STEEL RECTANGULAR/SQUARE HOLLOW STRUCTURAL SECTIONS SHALL BE ASTM A500 GRADE C, FY = 50 KSI. ALL STEEL SHALL HAVE A SHOP COAT OF RUST INHIBITIVE PAINT. DELETE PAINT ON ALL STEEL TO RECEIVE SPRAYED-ON FIREPROOFING OR CONCRETE ENCASEMENT, AS NOTED ON ARCHITECTURAL DOCUMENTS. ORIENT ALL MILL CAMBER UPWARD DURING FABRICATION AND ERECTION. ALL STEEL SHALL BE THOROUGHLY CLEANED IN ACCORDANCE WITH SSPC- SP3 PRIOR TO

2. ALL SHOP AND FIELD WELDING SHALL BE PERFORMED BY CERTIFIED WELDERS, AS DESCRIBED IN "AMERICAN WELDING SOCIETY'S STANDARD QUALIFICATION PROCEDURE", AWS D1.1 LATEST EDITION, TO PERFORM THE TYPE OF WORK REQUIRED.

3. UNLESS OTHERWISE NOTED, ALL CONNECTIONS SHALL BE BOLTED WITH MINIMUM 3/4-INCH DIAMETER A325 OR A490 HIGH STRENGTH BEARING TYPE BOLTS OR WELDED. THE FABRICATOR IS RESPONSIBLE FOR THE SELECTION, DESIGN, AND DETAILING OF ALL CONNECTIONS, INCLUDING BUT NOT LIMITED TO MOMENT CONNECTIONS, BRACED FRAME CONNECTIONS, AND TRUSS CONNECTIONS, NOT FULLY DETAILED ON THE CONTRACT DRAWINGS. THIS INCLUDES TO DESIGN, DETAIL, FURNISH, AND INSTALL STIFFENERS, CONTINUITY PLATES, DOUBLER PLATES, OR OTHER NECESSARY ADDITIONAL LOCAL STRENGTHENING MEASURES AS REQUIRED. MEMBER SIZES INDICATED ON THE DRAWINGS ARE BASED ON MEMBER BEHAVIOR AWAY FROM CONNECTIONS. USE FULL DEPTH DOUBLE ANGLE CONNECTIONS ON ALL GIRDER AND BEAM CONNECTIONS TO COLUMNS. BOLTS SHALL BE AT 3 INCH O/C VERTICALLY. INFILL BEAM CONNECTIONS MAY BE ONE-SIDED CONNECTIONS, UNLESS NOTED OTHERWISE. ALL GRAVITY MOMENT CONNECTIONS SHALL BE BOLTED WITH MINIMUM 3/4-INCH DIAMETER A325 OR A490 HIGH STRENGTH SLIP CRITICAL BOLTS OR WELDED.

UNLESS OTHERWISE NOTED, DETAILS INDICATED ON DRAWINGS INDICATE GENERAL CRITERIA FOR DESIGN AND DETAILING OF CONNECTIONS. DETAILS INDICATED ON DRAWINGS ARE NOT INTENDED TO CONVEY COMPLETE CONNECTOR SIZES, PLATE SIZES, WELD SIZES, NUMBER OF BOLTS, OR ANY OTHER SPECIFIC INFORMATION THAT IS OBTAINED THROUGH DESIGNING OF AN INDIVIDUAL CONNECTION FOR A GIVEN SET OF LOADS. THESE DETAILS DO NOT SHOW ERECTION AIDS. PROVIDE ERECTION AIDS AS REQUIRED AND REMOVE THEM AFTER WORK IS COMPLETE.

4. ALL ANCHOR RODS TO BE ASTM F1554 GRADE 36, UNLESS NOTED OTHERWISE.

TO THE LOCATION, ELEVATION, AND DIMENSIONS OF EXISTING WALLS AND FRAMING.

FABRICATION AND ERECTION ARE BY THE GENERAL CONTRACTOR)

5. ALL ALUMINUM AND STEEL MEMBERS SHALL BE TREATED OR PROPERLY SEPARATED TO PREVENT GALVANIC AND CORROSIVE EFFECTS.
 6. ALL STEEL WELDING RODS SHALL BE E70XX.

7. SUBMIT ALL STEEL SHOP DRAWINGS FOR REVIEW PRIOR TO ANY FABRICATION. SHOP DRAWINGS SHALL SHOW COMPLETE BOLTING AND WELDING INFORMATION, BOTH SHOP AND FIELD. ALL WELDING INFORMATION SHALL USE AMERICAN WELDING SOCIETY SYMBOLS. SHOP OR FIELD SPLICING OF ANY STRUCTURAL STEEL SECTION WHERE NOT DETAILED ON THE CONTRACT DOCUMENTS IS STRICTLY PROHIBITED WITHOUT PRIOR WRITTEN APPROVAL BY THE STRUCTURAL ENGINEER OF RECORD.

8. CONNECTIONS FOR ALL NON-COMPOSITE AND COMPOSITE BEAM/GIRDERS NOT CONNECTED TO COLUMNS SHALL BE DESIGNED FOR A MINIMUM UNFACTORED REACTION OF 15 KIPS, UNLESS NOTED GREATER ON DRAWINGS.
 9. STEEL FABRICATOR IS SOLELY RESPONSIBLE FOR SURVEYING AND VERIFICATION OF EXISTING CONDITIONS INCLUDING BUT NOT LIMITED

10. IF UNISTRUT FRAMING DIFFERS FROM DOCUMENTS, IT SHALL BE DESIGNED, FABRICATED AND ERECTED BY PREFABRICATED FRAMING MANUFACTURER, I.E. UNISTRUT, POWERSTRUT OR APPROVED EQUAL. MANUFACTURER IS RESPONSIBLE FOR COORDINATION AND COMPLIANCE WITH ARCHITECTURAL AND EQUIPMENT REQUIREMENTS/PARAMETERS INCLUDING STRENGTH AND DEFLECTION AND SHALL SUBMIT SEALED CALCULATIONS AND SHOP DRAWINGS WHICH COMPLY WITH ALL APPLICABLE CODES FOR REVIEW BY ENGINEER. UNISTRUT REQUIREMENTS FOR THE FIT-OUT ARE TO BE COORDINATED WITH THE ARCHITECTURAL DOCUMENTS AND MANUFACTURER FOR PATIENT LIFTS, LIGHTS, ETC. (DESIGN,

11. ALL LINTELS AND SHELF ANGLES WITHIN EXTERIOR WALLS SHALL BE HOT DIP GALVANIZED. ANY POINTS OF WELDING SHALL BE TOUCHED UP IN THE FIELD WITH A ZINC-RICH PAINT BY THE STEEL ERECTOR.

ALL EXPOSED STEEL (INCLUDING BUT NOT LIMITED TO DUNNAGE FRAMING, SCREEN WALL FRAMING, CANOPY FRAMING, ETC.) SHALL BE

HOT DIP GALVANIZED. ANY POINTS OF WELDING SHALL BE TOUCHED UP IN THE FIELD WITH A ZINC-RICH PAINT BY THE STEEL ERECTOR.

13. SPANDREL ANGLE AT PERIMETER EDGE OF FLOOR SLAB/ROOF SHALL BE ADJUSTABLE. SHIP ANGLE LOOSE AND SET WITH STRING LINE IN FIELD FOR VERTICAL AND HORIZONTAL ALIGNMENT AFTER STEEL IS FULLY ERECTED TO A MAXIMUM TOLERANCE OF 1/4 INCH HORIZONTAL PER BAY/PER FLOOR AND MUST BE SET PLUMB BY STEEL ERECTOR PRIOR TO STUD ERECTION. ANGLE MUST BE INSTALLED IN ONE LENGTH PER BAY.

14. PROVIDE WELDED STIFFENER PLATES ON BOTH SIDES OF THE WEB OF BEAMS AT POINTS OF CONCENTRATED LOADS INCLUDING BEAMS SUPPORTING COLUMNS OR RUNNING OVER THE TOPS OF COLUMNS, OR OTHER BEAMS. MINIMUM STIFFENER PLATE THICKNESS SHALL BE 3/8 INCH OR FLANGE THICKNESS OF COLUMN ABOVE OR BELOW OR BEAM WEB THICKNESS ABOVE OR BELOW, WHICHEVER IS GREATER.

15. ALL POST-INSTALLED EXPANSION ANCHORS FASTENED INTO CONCRETE SHALL BE HILTI KWIK BOLT TZ WITH MATERIAL TYPE, DIAMETER, AND EMBEDMENT PER DOCUMENTS, UNLESS NOTED OTHERWISE. ALL POST-INSTALLED ADHESIVE ANCHORS FASTENED INTO CONCRETE AND REINFORCING BAR DOWELING INTO CONCRETE SHALL USE HILTI HIT-RE 500/3 EPOXY ADHESIVE ANCHORING SYSTEM IN HAMMER-DRILLED HOLES WITH ROD TYPE, DIAMETER, EMBEDMENT AND SPACING/EDGE DISTANCE PER DOCUMENTS, UNLESS NOTED OTHERWISE.

16. ALL PIPING RUNS LARGER THAN 4" DIAMETER SHALL BE HUNG DIRECTLY FROM STEEL BEAMS AND NOT THE CONCRETE SLAB/METAL DECK SYSTEM. ANY SUPPLEMENTAL STEEL REQUIRED FOR BUILDING SYSTEMS (MECHANICAL, ELECTRICAL, PLUMBING, ETC.) IS NOT BY O'DONNELL &

17. THE CONTRACTOR SHALL DELIVER TO THE ENGINEER, AT THE END OF THE JOB, ONE (1) ELECTRONIC VERSION OF THE FINAL FIELD COPIES OF ALL STEEL ERECTION DRAWINGS SHOP DRAWINGS.

18. THE NEW AND EXISTING STEEL STRUCTURE IS TO BE CONSIDERED RESTRAINED FOR FIRE PROOFING PURPOSES.

CONCRETE

1. REINFORCING STEEL SHALL BE WITHIN TOLERANCES SET FORTH IN ACI 117, AND HAVE THE SPECIFIED CLEAR COVER, UNLESS NOTED OTHERWISE ON DRAWINGS:

CONCRETE POURED AGAINST EARTH

3"

CONCRETE EXPOSED TO EARTH OR WEATHER:
#5 OR SMALLER
#6 OR LARGER

CONCRETE NOT EXPOSED TO WEATHER OR IN CONTACT WITH GROUND:
COLUMNS (TIES AND MAIN REINFORCING)
SLABS, WALLS, JOISTS:
#14 OR #18 BARS
1 1/2"
#11 OR SMALLER
3/4"

BEAMS (STIRRUPS AND MAIN REINFORCING)

CLEAR COVER SHALL BE CLEARLY SHOWN ON ALL REINFORCING BAR DETAIL DRAWINGS.

ALL CONCRETE SHALL BE READY-MIX AND HAVE A MINIMUM COMPRESSIVE STRENGTH AT 28 DAYS OF:

A. SPREAD FOOTINGS/WALL FOOTINGS/FOUNDATION WALL
BASEMENT WALLS/RETAINING WALLS
B. GRADE BEAMS/PILE CAPS
C. PIERS-MATCH WALL STRENGTH
D. SLAB-ON-GRADE

A,000 PSI
(MINIMUM OF 3,000 PSI)
3,500 PSI

E. STRUCTURAL SLABS
5,000 PSI
F. STRUCTURAL SLAB ON PILES
5,000 PSI
G. CONCRETE SLABS ON METAL DECK
3,500 PSI

OR AS SHOWN ON DRAWINGS. HAVE A MINIMUM OF 500 LBS. OF CEMENT PER CUBIC YARD. SLUMP (AT POINT OF CONCRETE PLACEMENT) SHALL BE 3
INCH MINIMUM AND 6 INCH MAXIMUM. CONCRETE EXPOSED TO WEATHER SHALL HAVE 5 PERCENT AIR ENTRAINMENT. CONCRETE NOT EXPOSED TO
WEATHER SHALL NOT CONTAIN AN AIR-ENTRAINING AGENT. SUBMIT MIX DESIGNS FOR REVIEW. NORMAL-WEIGHT CONCRETE TO BE GIVEN A HARD-

POINT OF CONCRETE PLACEMENT). ALL CONCRETE WORK SHALL COMPLY WITH THE REQUIREMENTS OF THE LATEST ACI BUILDING CODE (ACI 318), THE ACI DETAILING MANUAL (ACI 315), AND THE SPECIFICATIONS FOR STRUCTURAL CONCRETE FOR BUILDINGS (ACI 301).

3. ALL REINFORCING STEEL SHALL BE MANUFACTURED FROM HIGH STRENGTH BILLET STEEL CONFORMING TO ASTM DESIGNATION A615 GRADE 60. EXCEPT #14 BARS AND LARGER WHICH SHALL CONFORM TO ASTM A615 GRADE 75. WWF SHALL COMPLY WITH ASTM A185.

4. DEVELOPMENT LENGTHS, NOTED AS Ld ON DRAWINGS, AND SPLICE/LAP LENGTHS OF ALL REINFORCING STEEL TO BE PER DETAIL WITH NOTES ENTITLED "TABLE OF DEVELOPMENT AND LAP SPLICE LENGTH". LAP SPLICES OF #14 BARS AND LARGER ARE NOT PERMITTED. THESE BARS MUST BE

MECHANICALLY COUPLED WITH DEVICES RATED TO DEVELOP 125% OF Fy OF THE BAR. SUBMIT PRODUCT DATA FOR ENGINEERING APPROVAL. LAP

TROWELED FINISH SHALL NOT CONTAIN AN AIR-ENTRAINING AGENT. TOTAL AIR CONTENT FOR THIS CONCRETE SHOULD NOT EXCEED 3 PERCENT (AT

ALL WWF A MINIMUM OF SIX INCHES.

5. ALL INSERTS AND SLEEVES SHALL BE CAST-IN-PLACE. THE CONTRACTOR SHALL VERIFY THE DIMENSIONS AND LOCATIONS OF ALL OPENINGS, PIPE SLEEVES, ETC. AS REQUIRED BY ALL TRADES BEFORE THE CONCRETE IS POURED. THE CONTRACTOR SHALL CONSULT THE ARCHITECTURAL, MECHANICAL, AND ELECTRICAL DRAWINGS, AS WELL AS THE STRUCTURAL DRAWINGS FOR THE LOCATION, NUMBER, AND SIZE OF ALL OPENINGS, SLEEVES, ETC. HOWEVER, OPENINGS NOT SHOWN ON THE STRUCTURAL DRAWINGS SHALL BE INSTALLED ONLY AFTER APPROVAL BY THE STRUCTURAL ENGINEER IS OBTAINED. DRAWINGS SHALL BE SUBMITTED FOR REVIEW SHOWING LOCATIONS AND DIMENSIONS OF ALL OPENINGS, SLEEVES, ETC. IN CAST-IN-PLACE CONCRETE SLARS, REAMS, WALLS, COLUMNS, AND FOLINDATIONS. THESE DRAWINGS SHALL BE COORDINATED BY

SLEEVES, ETC. HOWEVER, OPENINGS NOT SHOWN ON THE STRUCTURAL DRAWINGS SHALL BE INSTALLED ONLY AFTER APPROVAL BY THE STRUCTURAL ENGINEER IS OBTAINED. DRAWINGS SHALL BE SUBMITTED FOR REVIEW SHOWING LOCATIONS AND DIMENSIONS OF ALL OPENINGS, SLEEVES, ETC. IN CAST-IN-PLACE CONCRETE SLABS, BEAMS, WALLS, COLUMNS, AND FOUNDATIONS. THESE DRAWINGS SHALL BE COORDINATED BY THE CONTRACTOR. OPENINGS AND SLEEVES THROUGH CAST-IN-PLACE CONCRETE FRAMING IS PROHIBITED EXCEPT WHERE THOSE SLEEVES AND OPENINGS ARE SHOWN ON THE STRUCTURAL DRAWINGS ON WHERE THEY ARE SHOWN ON THE APPROVED SLEEVE AND OPENING THROUGH PREVIOUSLY CAST CONCRETE IS NOT PERMITTED EXCEPT WHERE SPECIFICALLY REVIEWED AND APPROVED BY THE STRUCTURAL ENGINEER.

THERE SHALL BE NO CONSTRUCTION JOINTS IN THE STRUCTURAL MAT.
 LIGHTWEIGHT CONCRETE SHALL BE USED FOR FRAMED FLOORS AS NOTED ON THE DRAWINGS. TOTAL AIR CONTENT AT POINT OF CONCRETE PLACEMENT SHALL BE LIMITED TO 5.5 PERCENT (PLUS OR MINUS 1.5 PERCENT) FOR HARD TROWELED FINISHED AREAS. THIS CONCRETE IS TO HAVE A MINIMUM 28 DAY COMPRESSIVE STRENGTH OF 3,500 PSI AND AN IN-PLACE DRY DENSITY OF 107 - 113 POUNDS PER CUBIC FOOT OR PER THE

REQUIREMENTS SET FORTH IN THE FIRE RATING SPECIFICATIONS.

8. SUBMIT ALL REINFORCING SHOP DRAWINGS FOR REVIEW PRIOR TO ANY FABRICATION.

9. FOR CONCRETE SLABS ON METAL DECK, FLOORS SHALL BE POURED TO THE THICKNESS SHOWN ON DOCUMENTS, NOT TO A LEVEL LINE.
 10. THE CONTRACTOR SHALL INSTALL FLOOR LEVELING MATERIAL AND PERFORM OTHER CORRECTIVE MEASURES IN ALL AREAS, INCLUDING BUT

NOT LIMITED TO, AREAS WHERE FLOOR FINISH PROVISIONS DO NOT COMPLY WITH THE FLATNESS AND LEVELNESS REQUIREMENTS.

11. CONTRACTOR TO ENGAGE AN ENGINEER, REGISTERED IN THE PROJECT'S JURISDICTION, TO DEVELOP ALL FORMWORK, SHORING, AND RESHORING DESIGNS AND PROCEDURES AND SUBMIT SIGNED AND SEALED DRAWINGS AND CALCULATIONS. ALL SHORING AND RESHORING MUST REMAIN IN PLACE FOR A MINIMUM OF 28 DAYS AFTER CONCRETE PLACEMENT, OR WHEN FULL STRENGTH IS ACHIEVED FROM FIELD CURED CYLINDERS.

12. THE CONTRACTOR SHALL DELIVER TO THE ENGINEER, AT THE END OF THE JOB, ONE (1) ELECTRONIC VERSION OF THE FINAL FIELD COPIES OF

ALL STEEL REINFORCING SHOP DRAWINGS.

13. RIGID INSULATION USED AS FLOOR FILL SHALL BE STYROFOAM HIGHLOAD 40 EXTRUDED POLYSTYRENE INSULATION (40 PSI COMPRESSIVE STRENGTH) ASTM C578, TYPE VI MANUFACTURED BY DOW CHEMICAL COMPANY, OR APPROVED EQUAL.

A.B.			
A.D.	ANCHOR BOLT	L.P.	LOW POINT
A.F.F.	ABOVE FINISH FLOOR	L.W.	LIGHT WEIGHT
ADDL.	ADDITIONAL	LLH	LONG LEG HORIZONTAL
ALT.	ALTERNATE	LLV	LONG LEG VERTICAL
ARCH.	ARCHITECT	LWB	LONG WAY BOTTOM
B.C.E.	BOTTOM CHORD EXTENSION	M.E.P.	MECHANICAL ELECTRICAL PLUMBING
B. <i>O</i> .	BOTTOM OF	M.S.T.	METAL STUD TRUSS
BLDG.	BUILDING	MAX.	MAXIMUM
 BM.	BEAM	MECH.	MECHANICAL
BOTT.	ВОТТОМ	MEZZ.	MEZZANINE
BRG.	BEARING	MFR.	MANUFACTURER
BSMT.	BASEMENT	MIN.	MINIMUM
BP_	BEARING PLATE	MISC.	MISCELLANEOUS
BTWN.	BETWEEN	MP_	MASONRY PIER
	CENTERLINE	NBL	NON BEARING LINTEL
<u>⊈</u> CANT.		N.T.S.	NOT TO SCALE
	CANTILEVER		
CMU	CONCRETE MASONRY UNIT	N.W.	NORMAL WEIGHT
COL.	COLUMN	o/c	ON CENTER
CONC.	CONCRETE	P.A.F.	POWDER ACTUATED FASTENER
CONN.	CONNECTION	P.	PLATE
CONT.	CONTINUOUS	PC	PILE CAP
CTRD.	CENTERED	P/C	PRECAST
Ø	DIAMETER	PSF	POUNDS PER SQUARE FOOT
DWG.	DRAWING	PSI	POUNDS PER SQUARE INCH
E.F.	EACH FACE	PTN.	PARTITON
E.O.D.	EDGE OF DECK	REINF.	REINFORCEMENT
E.O.S.	EDGE OF SLAB	REQ'D.	REQUIRED
E.W.	EACH WAY	RET'G.	RETAINING
EA.	EACH	S.F.	STEP FOOTING
EL.	ELEVATION	S.O.G.	SLAB ON GRADE
ELEV.	ELEVATOR	SCHED.	SCHEDULE
EMBED.	EMBEDMENT	SECT.	SECTION
EQ.	EQUAL	SIM.	SIMILAR
EQUIP.	EQUIPMENT	SPECS.	SPECIFICATIONS
	EACH WAY BOTTOM	STIFF.	STIFFENER
EWB EWT	EACH WAY BOTTOM EACH WAY TOP	STIFF. STRUCT.	STIFFENER STRUCTURAL
EWB EWT			
EWB EWT Ex.	EACH WAY TOP	STRUCT.	STRUCTURAL
EWB EWT Ex. EXIST.	EACH WAY TOP EXISTING	STRUCT.	STRUCTURAL SHORT WAY BOTTOM
EWB EWT Ex. EXIST. EXP.	EACH WAY TOP EXISTING EXISTING	STRUCT. SWB T#B	STRUCTURAL SHORT WAY BOTTOM TOP AND BOTTOM
EWB EWT Ex. EXIST. EXP. EXT.	EACH WAY TOP EXISTING EXISTING EXPANSION	STRUCT. SWB T#B T.	STRUCTURAL SHORT WAY BOTTOM TOP AND BOTTOM TOP
EWB EWT Ex. EXIST. EXP. EXT. FDN.	EACH WAY TOP EXISTING EXISTING EXPANSION EXTERIOR FOUNDATION	STRUCT. SWB T\$B T. T.O. T.O.C.	STRUCTURAL SHORT WAY BOTTOM TOP AND BOTTOM TOP TOP OF TOP OF CONCRETE
EWB EWT Ex. EXIST. EXP. EXT. FDN.	EACH WAY TOP EXISTING EXISTING EXPANSION EXTERIOR FOUNDATION FINISH	STRUCT. SWB T\$B T. T.O. T.O.C. T.O.S.	STRUCTURAL SHORT WAY BOTTOM TOP AND BOTTOM TOP TOP OF TOP OF TOP OF CONCRETE TOP OF STEEL
EWB EWT Ex. EXIST. EXP. EXT. FDN. FIN.	EACH WAY TOP EXISTING EXISTING EXPANSION EXTERIOR FOUNDATION FINISH FLOOR	STRUCT. SWB T#B T. T.O. T.O.C. T.O.S. T.S.	STRUCTURAL SHORT WAY BOTTOM TOP AND BOTTOM TOP TOP OF TOP OF TOP OF CONCRETE TOP OF STEEL THICKENED SLAB
EWB EWT Ex. EXIST. EXP. EXT. FDN. FIN. FLR.	EACH WAY TOP EXISTING EXISTING EXPANSION EXTERIOR FOUNDATION FINISH FLOOR FEET	STRUCT. SWB T\$B T. T.O. T.O.C. T.O.S. T.S. TCELE	STRUCTURAL SHORT WAY BOTTOM TOP AND BOTTOM TOP TOP OF TOP OF TOP OF CONCRETE TOP OF STEEL THICKENED SLAB TOP CHORD EXTENSION LEFT END
EWB EWT Ex. EXIST. EXP. EXT. FDN. FIN. FLR. FTG.	EACH WAY TOP EXISTING EXISTING EXPANSION EXTERIOR FOUNDATION FINISH FLOOR FEET FOOTING	STRUCT. SWB T&B T. T.O. T.O.C. T.O.S. T.S. TCELE TCERE	STRUCTURAL SHORT WAY BOTTOM TOP AND BOTTOM TOP TOP OF TOP OF TOP OF CONCRETE TOP OF STEEL THICKENED SLAB TOP CHORD EXTENSION LEFT END TOP CHORD EXTENSION RIGHT END
EWB EWT Ex. EXIST. EXP. EXT. FDN. FIN. FLR. FT. FTG.	EACH WAY TOP EXISTING EXISTING EXPANSION EXTERIOR FOUNDATION FINISH FLOOR FEET FOOTING GAGE	STRUCT. SWB T#B T. T.O. T.O.C. T.O.S. T.S. TCELE TCERE TDS	STRUCTURAL SHORT WAY BOTTOM TOP AND BOTTOM TOP TOP OF TOP OF TOP OF CONCRETE TOP OF STEEL THICKENED SLAB TOP CHORD EXTENSION LEFT END TOP CHORD EXTENSION RIGHT END TURN DOWN SLAB
EWB EWT Ex. EXIST. EXP. EXT. FDN. FIN. FIR. FT. GA. GALV.	EACH WAY TOP EXISTING EXISTING EXPANSION EXTERIOR FOUNDATION FINISH FLOOR FEET FOOTING GAGE GALVANIZED	STRUCT. SWB T&B T. T.O. T.O.C. T.O.S. T.S. TCELE TCERE TDS THK.	STRUCTURAL SHORT WAY BOTTOM TOP AND BOTTOM TOP TOP OF TOP OF TOP OF CONCRETE TOP OF STEEL THICKENED SLAB TOP CHORD EXTENSION LEFT END TOP CHORD EXTENSION RIGHT END TURN DOWN SLAB THICK OR THICKENED
EWB EWT EX. EXIST. EXP. EXT. FDN. FIN. FIR. FT. GA. GALV. GB_	EACH WAY TOP EXISTING EXISTING EXPANSION EXTERIOR FOUNDATION FINISH FLOOR FEET FOOTING GAGE GALVANIZED GRADE BEAM	STRUCT. SWB T&B T. T.O. T.O.C. T.O.S. T.S. TCELE TCERE TDS THK. TYP.	STRUCTURAL SHORT WAY BOTTOM TOP AND BOTTOM TOP TOP OF TOP OF TOP OF CONCRETE TOP OF STEEL THICKENED SLAB TOP CHORD EXTENSION LEFT END TOP CHORD EXTENSION RIGHT END TURN DOWN SLAB THICK OR THICKENED TYPICAL
EWB EWT EX. EXIST. EXP. EXT. FDN. FIN. FIR. FTG. GA. GALV. GB_ H.P.	EACH WAY TOP EXISTING EXISTING EXPANSION EXTERIOR FOUNDATION FINISH FLOOR FEET FOOTING GAGE GALVANIZED GRADE BEAM HIGH POINT	STRUCT. SWB T\$B T. T.O. T.O.C. T.O.S. T.S. TCELE TCERE TDS THK. TYP. U.N.O.	STRUCTURAL SHORT WAY BOTTOM TOP AND BOTTOM TOP TOP OF TOP OF TOP OF CONCRETE TOP OF STEEL THICKENED SLAB TOP CHORD EXTENSION LEFT END TOP CHORD EXTENSION RIGHT END TURN DOWN SLAB THICK OR THICKENED TYPICAL UNLESS NOTED OTHERWISE
EWB EWT EX. EXIST. EXP. EXT. FDN. FIN. FIR. FTG. GA. GALV. GB_ H.P. HORIZ.	EACH WAY TOP EXISTING EXISTING EXPANSION EXTERIOR FOUNDATION FINISH FLOOR FEET FOOTING GAGE GALVANIZED GRADE BEAM HIGH POINT HORIZONTAL	STRUCT. SWB T\$B T. T.O. T.O.C. T.O.S. T.S. TCELE TCERE TDS THK. TYP. U.N.O. V.I.F.	STRUCTURAL SHORT WAY BOTTOM TOP AND BOTTOM TOP TOP OF TOP OF TOP OF CONCRETE TOP OF STEEL THICKENED SLAB TOP CHORD EXTENSION LEFT END TOP CHORD EXTENSION RIGHT END TURN DOWN SLAB THICK OR THICKENED TYPICAL UNLESS NOTED OTHERWISE VERIFY IN FIELD
EWB EWT EX. EXIST. EXP. EXT. FDN. FIN. FIR. FT. GA. GALV. GB_ H.P. HORIZ.	EACH WAY TOP EXISTING EXISTING EXPANSION EXTERIOR FOUNDATION FINISH FLOOR FEET FOOTING GAGE GALVANIZED GRADE BEAM HIGH POINT HORIZONTAL INSIDE FACE	STRUCT. SWB T\$B T. T.O. T.O.C. T.O.S. T.S. TCELE TCERE TDS THK. TYP. U.N.O. V.I.F. VERT.	STRUCTURAL SHORT WAY BOTTOM TOP AND BOTTOM TOP TOP OF TOP OF TOP OF CONCRETE TOP OF STEEL THICKENED SLAB TOP CHORD EXTENSION LEFT END TOP CHORD EXTENSION RIGHT END TURN DOWN SLAB THICK OR THICKENED TYPICAL UNLESS NOTED OTHERWISE VERIFY IN FIELD VERTICAL
EMB EMT EX. EXIST. EXP. EXT. FDN. FIN. FLR. FT. GA. GALV. GB_ H.P. HORIZ. I.F.	EACH WAY TOP EXISTING EXISTING EXPANSION EXTERIOR FOUNDATION FINISH FLOOR FEET FOOTING GAGE GALVANIZED GRADE BEAM HIGH POINT HORIZONTAL	STRUCT. SWB T\$B T. T.O. T.O.C. T.O.S. T.S. TCELE TCERE TDS THK. TYP. U.N.O. V.I.F.	STRUCTURAL SHORT WAY BOTTOM TOP AND BOTTOM TOP TOP OF TOP OF TOP OF CONCRETE TOP OF STEEL THICKENED SLAB TOP CHORD EXTENSION LEFT END TOP CHORD EXTENSION RIGHT END TURN DOWN SLAB THICK OR THICKENED TYPICAL UNLESS NOTED OTHERWISE VERIFY IN FIELD
EMB EMT EX. EXIST. EXP. EXT. FDN. FIN. FLR. FT. GA. GALV. GB_ H.P. HORIZ. I.F.	EACH WAY TOP EXISTING EXISTING EXPANSION EXTERIOR FOUNDATION FINISH FLOOR FEET FOOTING GAGE GALVANIZED GRADE BEAM HIGH POINT HORIZONTAL INSIDE FACE	STRUCT. SWB T\$B T. T.O. T.O.C. T.O.S. T.S. TCELE TCERE TDS THK. TYP. U.N.O. V.I.F. VERT.	STRUCTURAL SHORT WAY BOTTOM TOP AND BOTTOM TOP TOP OF TOP OF TOP OF CONCRETE TOP OF STEEL THICKENED SLAB TOP CHORD EXTENSION LEFT END TOP CHORD EXTENSION RIGHT END TURN DOWN SLAB THICK OR THICKENED TYPICAL UNLESS NOTED OTHERWISE VERIFY IN FIELD VERTICAL
EWB EWT EX. EXIST. EXP. EXT. FDN. FIN. FLR. FT. GA. GALV. GB_ H.P. HORIZ. I.F. IN.	EACH WAY TOP EXISTING EXISTING EXPANSION EXTERIOR FOUNDATION FINISH FLOOR FEET FOOTING GAGE GALVANIZED GRADE BEAM HIGH POINT HORIZONTAL INSIDE FACE INCHES	STRUCT. SWB T\$B T. T.O. T.O.C. T.O.S. T.S. TCELE TCERE TDS THK. TYP. U.N.O. V.I.F. VERT. W.R.T.	STRUCTURAL SHORT WAY BOTTOM TOP AND BOTTOM TOP TOP OF TOP OF TOP OF CONCRETE TOP OF STEEL THICKENED SLAB TOP CHORD EXTENSION LEFT END TOP CHORD EXTENSION RIGHT END TURN DOWN SLAB THICK OR THICKENED TYPICAL UNLESS NOTED OTHERWISE VERIFY IN FIELD VERTICAL WOOD ROOF TRUSS
EWB EWT EX. EXIST. EXP. EXT. FDN. FIN. FLR. FTG. GA. GALV. GB_ H.P. HORIZ. I.F. IN.	EACH WAY TOP EXISTING EXISTING EXPANSION EXTERIOR FOUNDATION FINISH FLOOR FEET FOOTING GAGE GALVANIZED GRADE BEAM HIGH POINT HORIZONTAL INSIDE FACE INCHES INFORMATION	STRUCT. SWB T\$B T. T.O. T.O.C. T.O.S. T.S. TCELE TCERE TDS THK. TYP. U.N.O. V.I.F. VERT. W/	STRUCTURAL SHORT WAY BOTTOM TOP AND BOTTOM TOP TOP OF TOP OF TOP OF CONCRETE TOP OF STEEL THICKENED SLAB TOP CHORD EXTENSION LEFT END TOP CHORD EXTENSION RIGHT END TURN DOWN SLAB THICK OR THICKENED TYPICAL UNLESS NOTED OTHERWISE VERIFY IN FIELD VERTICAL WOOD ROOF TRUSS WITH
EWB	EACH WAY TOP EXISTING EXISTING EXPANSION EXTERIOR FOUNDATION FINISH FLOOR FEET FOOTING GAGE GALVANIZED GRADE BEAM HIGH POINT HORIZONTAL INSIDE FACE INCHES INFORMATION INTERIOR	STRUCT. SWB T\$B T. T.O. T.O.C. T.O.S. T.S. TCELE TCERE TDS THK. TYP. U.N.O. V.I.F. VERT. W.R.T. W/ WC	STRUCTURAL SHORT WAY BOTTOM TOP AND BOTTOM TOP TOP OF TOP OF TOP OF CONCRETE TOP OF STEEL THICKENED SLAB TOP CHORD EXTENSION LEFT END TOP CHORD EXTENSION RIGHT END TURN DOWN SLAB THICK OR THICKENED TYPICAL UNLESS NOTED OTHERWISE VERIFY IN FIELD VERTICAL WOOD ROOF TRUSS WITH WET COLUMN

TYPICAL ABBREVIATIONS

DESIGN LOA (ALL LOADS SHOWN ARE	D S	SCHI POUND	EDU S PE	LE R SQ	. FT.)
LNANOAMO	TYP. FLOOR	TYP. FLOOR + 6" PAD	ROOF			
ROOF \$ INSULATION			&			
6" NW CONC.		75				
4 1/4" NW CONC. ON 2" DEC	K 68	68				
STEEL	8	8	7			
COLLATERAL	5	5	ъ			
CEILING	2	2	2			
MEP	2	2	3			
TOTAL DEAD LOAD	85	160	25			
TOTAL LIVE LOAD	100	100	30			
TOTAL LOAD	185	260	55			



IEI GROUP, LTD.
IEI ARCHITECTS, INC
428 North 2nd Street

Philadelphia, PA 19123 Telephone: 215.413.3700

CONSULTANTS:

Arora Engineers, Inc.
61 Wilmington-West Chester Pike
Chadds Ford, PA 19317
P (610) 459-7900

F (610) 459-7950



O'Donnell & Naccarato
701 Market Street, Suite 6000
Philadelphia, PA 19106
PH: 215.925.3788
www.o-n.com
3006.0009.00

DESIGN PROFESSIONAL'S ELECTRONIC OR DIGITAL SEAL OR SIGNATURE IS EFFECTIVE ONLY AS TO THAT VERSION OF THIS DOCUMENT AS ORIGINALLY PUBLISHED BY DESIGN PROFESSIONAL DESIGN PROFESSIONAL IS NOT RESPONSIBLE FOR ANY SUBSEQUENT MODIFICATION, CORRUPTION, OR INAUTHORIZED LISE OF SIGNED PROFESSIONAL TO VERDEY THE VALUE OF A

PUBLISHED BY DESIGN PROFESSIONAL. DESIGN PROFESSIONAL IS NOT RESPONSIBLE FOR ANY SUBSEQUENT MODIFICATION, CORRUPTION, OR UNAUTHORIZED USE OF SUCH DOCUMENT. TO VERIFY THE VALIDITY OR APPLICABILITY OF THE SEAL OR SIGNATURE, CONTACT DESIGN PROFESSIONAL.

400 N. BROAD PARTNERS, L.P.
400 NORTH BROAD STREET PHILADELPHIA, P

□ PROGRESS SET□ CLIENT REVIEW

■ BID SET
□ CODE REVIEW SET

ISSUED FOR BIDS 9/18/2020

(NOT FOR CONSTRUCTION)

☐ ISSUED FOR CONSTRUCTION

ISSUES/REVISIONS:
1 09/18/20 ISSUED FOR BID

PROJECT NUMBER: 304103-120
SCALE: As indicated
DATE: 09/18/2020
DRAWN BY: CH
CHECKED BY: JJD

GENERAL NOTES & SCHEDULES

SHEET NO:

S-201

PRINTED ON: 9/21/2020 1:23:51 PM

a - WHERE APPLICABLE, SEE SECTION 1705.12, SPECIAL INSPECTIONS FOR SEISMIC RESISTANCE.	
b - SPECIFIC REQUIREMENTS FOR SPECIAL INSPECTION SHALL BE INCLUDED IN THE RESEARCH REPORT FOR THE ANCHOR ISS	UE
AN APPROVED SOURCE IN ACCORDANCE WITH 17.8.2 IN ACI 318, OR OTHER QUALIFICATION PROCEDURES. WHERE SPECIFIC	
REQUIREMENTS ARE NOT PROVIDED, SPECIAL INSPECTION REQUIREMENTS SHALL BE SPECIFIED BY THE REGISTERED DESIGN	
PROFESSIONAL AND SHALL BE APPROVED BY THE BUILDING OFFICIAL PRIOR TO THE COMMENCEMENT OF THE WORK.	

INSPECTION TASKS PRIOR TO WE	ELDING - TAB	LE N5.4-1
INSPECTION TASKS PRIOR TO WELDING	QC	QA
WELDER QUALIFICATION RECORDS AND CONTINUITY RECORDS	P	0
WPS AVAILABLE	Р	P
MANUFACTURER CERTIFICATIONS FOR WELDING CONSUMABLES AVAILABLE	Р	Р
MATERIAL IDENTIFICATION (TYPE/GRADE)	0	0
WELDER IDENTIFICATION SYSTEM a	0	0
FIT-UP OF GROOVE WELDS (INCLUDE JOINT GEOMETRY) JOINT PREPARATIONS DIMENSIONS (ALIGNMENT, ROOT OPENING, ROOT FACE, BEVEL) CLEANLINESS (CONDITION OF STEEL SURFACES) TACKING (TACK WELD QUALITY \$ LOCATION) BACKING TYPE AND FIT (IF APPLICABLE)	0	0
FIT-UP OF CJP GROOVE WELDS OF HSS T-, Y- AND K-JOINTS WITHOUT BACKING (INCLUDING JOINT GEOMETRY) • JOINT PREPARATIONS • DIMENSIONS (ALIGNMENT, ROOT OPENING, ROOT FACE, BEVEL) • CLEANLINESS (CONDITION OF STEEL SURFACES) • TACKING (TACK WELD QUALITY \$ LOCATION)	Р	0
CONFIGURATION AND FINISH OF ACCESS HOLES	0	0
FIT-UP OF FILLET WELDS DIMENSIONS (ALIGNMENT, GAPS AT ROOT) CLEANLINESS (CONDITION OF STEEL SURFACES) TACKING (TACK WELD QUALITY \$ LOCATION)	0	0
CHECK WELDING EQUIPMENT	0	-
a - THE FABRICATOR OR ERECTOR, AS APPLICABLE, SHALL MAINTAIN A SYS	TEM BY WHICH A WELDER WI	HO HAS WELDED A

- a THE FABRICATOR OR ERECTOR, AS APPLICABLE, SHALL MAINTAIN A SYSTEM BY WHICH A WELDER WHO HAS WELDED A JOINT OR MEMBER CAN BE IDENTIFIED. STAMPS, IF USED, SHALL BE THE LOW-STRESS TYPE.
- O OBSERVE THESE ITEMS ON A RANDOM BASIS. OPERATIONS NEED NOT BE DELAYED PENDING THESE INSPECTIONS.
- P PERFORM THESE TASKS FOR EACH WELDED JOINT OR MEMBER.

INSPECTION TASKS DURING W	IELDING - TABL	E N5.4-2
INSPECTION TASKS DURING WELDING	QC	QA
CONTROL AND HANDLING OF WELDING CONSUMABLES PACKAGING EXPOSURE CONTROL	0	0
NO WELDING OVER CRACKED TACK WELDS	0	0
ENVIRONMENTAL CONDITIONS • WIND SPEED WITHIN LIMITS • PRECIPITATION AND TEMPERATURE	0	0
WPS FOLLOWED SETTINGS ON WELDING EQUIPMENT TRAVEL SPEED SELECTED WELDING MATERIALS SHIELDING GAS TYPE/FLOW RATE PREHEAT APPLIED INTERPASS TEMPERATURE MAINTAINED (MIN./MAX.) PROPER POSITION (F, V, H, OH)	O	0
WELDING TECHNIQUES INTERPASS AND FINAL CLEANING EACH PASS WITHIN PROFILE LIMITATIONS EACH PASS MEETS QUALITY REQUIREMENTS	0	0
PLACEMENT AND INSTALLATION OF STEEL HEADED STUD ANCHORS	Р	P

- O OBSERVE THESE ITEMS ON A RANDOM BASIS. OPERATIONS NEED NOT BE DELAYED PENDING THESE INSPECTIONS.
- P PERFORM THESE TASKS FOR EACH WELDED JOINT OR MEMBER.

REQUIRED SPECIAL INSPECTIONS AN TABLE 1705.6	D TESTS OF	SOILS -
TYPE	CONTINUOUS SPECIAL INSPECTION	PERIODIC SPECIAL INSPECTION
1. VERIFY MATERIALS BELOW SHALLOW FOUNDATIONS ARE ADEQUATE TO ACHIEVE THE DESIGN BEARING CAPACITY.	-	X
2. VERIFY EXCAVATIONS ARE EXTENDED TO PROPER DEPTH AND HAVE REACHED PROPER MATERIAL.	-	Х
3. PERFORM CLASSIFICATION AND TESTING OF COMPACTED FILL MATERIALS.	-	Х
4. VERIFY USE OF PROPER MATERIALS, DENSITIES AND LIFT THICKNESSES DURING PLACEMENT AND COMPACTION OF COMPACTED FILL.	Х	-
5. PRIOR TO PLACEMENT OF COMPACTED FILL, INSPECT SUBGRADE AND VERIFY THAT SITE HAS BEEN PREPARED PROPERLY.	-	Х

INSPECTION TASKS AFTER WELDING	QC	QA
WELDS CLEANED	0	0
SIZE, LENGTH AND LOCATION OF WELDS	Р	Р
WELDS MEET VISUAL ACCEPTANCE CRITERIA CRACK PROHIBITION WELD/BASE-METAL FUSION CRATER CROSS SECTION WELD PROFILES WELD SIZE UNDERCUT POROSITY	P	P
ARC STRIKES	Р	P
k-AREA ^a	Р	Р
WELD ACCESS HOLES IN ROLLED HEAVY SHAPES AND BUILT-UP HEAVY SHAPES ^b	P	P
BACKING REMOVED AND WELD TABS REMOVED (IF REQUIRED)	P	P
REPAIR ACTIVITIES	Р	Р
DOCUMENT ACCEPTANCE OR REJECTION OF WELDED JOINT OR MEMBER	Р	P
NO PROHIBITED WELDS HAVE BEEN ADDED WITHOUT THE APPROVAL OF THE EOR.	0	0

- a WHEN WELDING OF DOUBLER PLATES, CONTINUITY PLATES OR STIFFENERS HAS BEEN PERFORMED IN THE k-AREA, VISUALLY INSPECT THE WEB k-AREA FOR CRACKS WITHIN 3 IN. (75 mm) OF THE WELD.

 b - AFTER ROLLED HEAVY SHAPES (SEE SECTION A3.1c) AND BUILT-UP HEAVY SHAPES (SEE SECTION A3.1d) ARE WELDED,
- VISUALLY INSPECT THE WELD ACCESS HOLES FOR CRACKS. O - OBSERVE THESE ITEMS ON A RANDOM BASIS. OPERATIONS NEED NOT BE DELAYED PENDING THESE INSPECTIONS. P - PERFORM THESE TASKS FOR EACH WELDED JOINT OR MEMBER.

INSPECTION TASKS PRIOR TO BOLTING	QC	QA									
MANUFACTURER'S CERTIFICATIONS AVAILABLE FOR FASTENER MATERIALS	O	Р									
FASTENERS MARKED IN ACCORDANCE WITH ASTM REQUIREMENTS	0	0									
CORRECT FASTENERS SELECTED FOR THE JOINT DETAIL (GRADE, TYPE, BOLT LENGTH IF THREADS ARE TO BE EXCLUDED FROM THE SHEAR PLANE)	0	0									
CORRECT BOLTING PROCEDURE SELECTED FOR JOINT DETAIL	0	0									
CONNECTING ELEMENTS, INCLUDING THE APPROPRIATE FAYING SURFACE CONDITION AND HOLE PREPARATION, IF SPECIFIED, MEET APPLICABLE REQUIREMENTS	0	0									
PRE-INSTALLATION VERIFICATION TESTING BY INSTALLATION PERSONNEL OBSERVED AND DOCUMENTED FOR FASTENER ASSEMBLIES AND METHODS USED	P	0									
PROPER STORAGE PROVIDED FOR BOLTS, NUTS, WASHERS AND OTHER FASTENER COMPONENTS	0	0									

INSPECTION TASKS DURING BO	DLTING - TABL	E N5.6-2
INSPECTION TASKS DURING BOLTING	QC	QA
FASTENER ASSEMBLIES PLACED IN ALL HOLES AND WASHERS AND NUTS ARE POSITIONED AS REQUIRED.	0	0
JOINT BROUGHT TO THE SNUG-TIGHT CONDITION PRIOR TO THE PRETENSIONING OPERATION	0	0
FASTENER COMPONENT NOT TURNED BY THE WRENCH PREVENTED FROM ROTATING	0	0
FASTENERS ARE PRETENSIONED IN ACCORDANCE WITH THE RCSC SPECIFICATION, PROGRESSING SYSTEMATICALLY FROM THE MOST RIGID POINT TOWARD THE FREE EDGES	0	0

O - OBSERVE THESE ITEMS ON A RANDOM BASIS. OPERATIONS NEED NOT BE DELAYED PENDING THESE INSPECTIONS. P - PERFORM THESE TASKS FOR EACH BOLTED CONNECTION.

O - OBSERVE THESE ITEMS ON A RANDOM BASIS. OPERATIONS NEED NOT BE DELAYED PENDING THESE INSPECTIONS.

P - PERFORM THESE TASKS FOR EACH BOLTED CONNECTION.

INSPECTION TASKS AFTER BO	LTING - TABLE	E N5.6-3
INSPECTION TASKS AFTER BOLTING	QC	QA
DOCUMENT ACCEPTANCE OR REJECTION OF BOLTED CONNECTIONS	Р	Р

O - OBSERVE THESE ITEMS ON A RANDOM BASIS. OPERATIONS NEED NOT BE DELAYED PENDING THESE INSPECTIONS. P - PERFORM THESE TASKS FOR EACH BOLTED CONNECTION.

INSPECTION OR EXECUTION TASKS PRIOR TO WELDING - ANSI/SDI TABLE 1.3							
TASK QC QA							
WELDING PROCEDURE SPECIFICATIONS (WPS) AVAILABLE.	0	0					
MANUFACTURER CERTIFICATIONS FOR WELDING CONSUMABLES AVAILABLE.	0	0					
MATERIAL IDENTIFICATION (TYPE/GRADE).	0	0					
CHECK WELDING EQUIPMENT.	0	0					

O - INSPECT THESE ITEMS ON AN INTERMITTENT BASIS. OPERATIONS NEED NOT BE DELAYED PENDING THESE INSPECTIONS. FREQUENCY OF OBSERVATIONS SHALL BE ADEQUATE TO CONFIRM THAT THE WORK HAS BEEN PERFORMED IN ACCORDANCE WITH THE APPLICABLE DOCUMENTS. P - PERFORM THESE TASKS PRIOR TO FINAL ACCEPTANCE FOR EACH ITEM OR ELEMENT.

INSPECTION OR EXECUTION TASKS DURING WELDING - ANSI/SDI TABLE 1.4							
TASK QC QA							
USE OF QUALIFIED WELDERS.	0	0					
CONTROL AND HANDLING OF WELDING CONSUMABLES.	0	0					
ENVIORNMENTAL CONDITIONS (WIND SPEED, MOISTURE, TEMPERATURE).	0	0					
WPS FOLLOWED.	0	0					

O - INSPECT THESE ITEMS ON AN INTERMITTENT BASIS. OPERATIONS NEED NOT BE DELAYED PENDING THESE INSPECTIONS. FREQUENCY OF OBSERVATIONS SHALL BE ADEQUATE TO CONFIRM THAT THE WORK HAS BEEN PERFORMED IN ACCORDANCE WITH THE APPLICABLE DOCUMENTS.

P - PEPEOPM THESE TASKS PRIOR TO SINAL ACCEPTANCE FOR SACH ITEM OR SI EMENT

P - PERFORM THESE TASKS PRIOR TO FINAL ACCEPTANCE FOR EACH ITEM OR ELEMENT.							
INSPECTION OR EXECUTION TASKS AFTER WELDING - ANSI/SDI TABLE 1.5							
TASK QC QA							
VERIFY SIZE AND LOCATION OF WELDS, INCLUDING SUPPORT, SIDELAP, AND PERIMETER WELDS.	Р	Р					
WELDS MEET VISUAL ACCEPTANCE CRITERIA.	P	P					
VERIFY REPAIR ACTIVIES.	Р	Р					
DOCUMENT ACCEPTANCE OR REJECTION OF WELDS.							

- O INSPECT THESE ITEMS ON AN INTERMITTENT BASIS. OPERATIONS NEED NOT BE DELAYED PENDING THESE INSPECTIONS. FREQUENCY OF OBSERVATIONS SHALL BE ADEQUATE TO CONFIRM THAT THE WORK HAS BEEN PERFORMED IN ACCORDANCE
- WITH THE APPLICABLE DOCUMENTS. P - PERFORM THESE TASKS PRIOR TO FINAL ACCEPTANCE FOR EACH ITEM OR ELEMENT.

INSPECTION OR EXECUTION TASKS PRIOR TO MECHANICAL FASTENING - ANSI/SDI TABLE 1.6							
TASK QC QA							
MANUFACTURER INSTALLATION INSTRUCTIONS AVAILABLE FOR MECHANICAL FASTENERS.	0	0					
PROPER TOOLS AVAILABLE FOR FASTENER INSTALLATION.	0	0					
PROPER STORAGE FOR MECHANICAL FASTENERS.	0	0					

- O INSPECT THESE ITEMS ON AN INTERMITTENT BASIS. OPERATIONS NEED NOT BE DELAYED PENDING THESE INSPECTIONS. FREQUENCY OF OBSERVATIONS SHALL BE ADEQUATE TO CONFIRM THAT THE WORK HAS BEEN PERFORMED IN ACCORDANCE
- WITH THE APPLICABLE DOCUMENTS. P - PERFORM THESE TASKS PRIOR TO FINAL ACCEPTANCE FOR EACH ITEM OR ELEMENT.

INSPECTION OR EXECUTION TASKS DURING MECHANICAL FASTENING - ANSI/SDI TABLE 1.7						
TASK QC QA						
FASTENERS ARE POSITIONED AS REQUIRED.	0	0				
FASTENERS ARE INSTALLED IN ACCORDANCE WITH MANUFACTURER'S INSTRUCTIONS.	0	0				

- O INSPECT THESE ITEMS ON AN INTERMITTENT BASIS. OPERATIONS NEED NOT BE DELAYED PENDING THESE INSPECTIONS. FREQUENCY OF OBSERVATIONS SHALL BE ADEQUATE TO CONFIRM THAT THE WORK HAS BEEN PERFORMED IN ACCORDANCE
- WITH THE APPLICABLE DOCUMENTS. P - PERFORM THESE TASKS PRIOR TO FINAL ACCEPTANCE FOR EACH ITEM OR ELEMENT.

NSPECTION OR EXECUTION TASKS AFTER MECHANICAL FASTENING - ANSI/SDI TABLE 1.8								
TASK QC QA								
CHECK SPACING, TYPE, AND INSTALLATION OF SUPPORT FASTENERS.	Р	Р						
CHECK SPACING, TYPE, AND INSTALLATION OF SIDELAP FASTENERS.	Р	Р						
CHECK SPACING, TYPE, AND INSTALLATION OF PERIMETER FASTENERS.	Р	Р						
VERIFY REPAIR ACTIVITIES.	Р	Р						
DOCUMENT ACCEPTANCE OR REJECTION OF MECHANICAL FASTENERS.	Р	Р						

- O INSPECT THESE ITEMS ON AN INTERMITTENT BASIS. OPERATIONS NEED NOT BE DELAYED PENDING THESE INSPECTIONS. FREQUENCY OF OBSERVATIONS SHALL BE ADEQUATE TO CONFIRM THAT THE WORK HAS BEEN PERFORMED IN ACCORDANCE
- WITH THE APPLICABLE DOCUMENTS. P - PERFORM THESE TASKS PRIOR TO FINAL ACCEPTANCE FOR EACH ITEM OR ELEMENT.

SPECIAL INSPECTION REQUIREMENTS - IBC 2018 EDITION

1. THE QUALIFIED AGENCY AND PERSONNEL RETAINED FOR THESE SPECIAL INSPECTION SERVICES SHALL BE APPROVED BY THE OWNER, THE ARCHITECT AND THE ENGINEER OF RECORD PRIOR TO START OF CONSTRUCTION, AN OUTLINE OF THE SCOPE OF SERVICES TO BE PERFORMED BY THE INSPECTING AGENCY IS TO BE SUBMITTED PRIOR TO START OF CONSTRUCTION.

2. IN ACCORDANCE WITH SECTION 1705 OF THE INTERNATIONAL BUILDING CODE 2018 EDITION, PERIODIC AND/OR CONTINUOUS INSPECTIONS OF THE CONSTRUCTION PROGRESS SHALL BE MADE BY AN INDEPENDENT APPROVED AGENCY IN ACCORDANCE WITH THE FOLLOWING REQUIREMENTS;

STEEL CONSTRUCTION CONCRETE CONSTRUCTION SOILS SECTION 1705.2, TABLE1705.2.3 SECTION 1705.3, TABLE 1705.3 SECTION 1705.6, TABLE 1705.6

UNDERPINNING SECTION 1705 CHAPTER 17 DEMOLITION

IEI GROUP, LTD. IEI ARCHITECTS, INC. 428 North 2nd Street Philadelphia, PA 19123 Telephone: 215.413.3700

CONSULTANTS:

Arora Engineers, Inc. 61 Wilmington-West Chester Pike Chadds Ford, PA 19317



P (610) 459-7900

O'Donnell & Naccarato 701 Market Street, Suite 6000 Philadelphia, PA 19106 PH: 215.925.3788 www.o-n.com 3006.0009.00

EFFECTIVE ONLY AS TO THAT VERSION OF THIS DOCUMENT AS ORIGINALLY

RESPONSIBLE FOR ANY SUBSEQUENT MODIFICATION, CORRUPTION, OR UNAUTHORIZED USE OF SUCH DOCUMENT. TO VERIFY THE VALIDITY OF APPLICABILITY OF THE SEAL OR SIGNATURE, CONTACT DESIGN PROFESSIONAL.

400 400 400

- ☐ PROGRESS SET
- ☐ CLIENT REVIEW BID SET
- ☐ CODE REVIEW SET ☐ ISSUED FOR CONSTRUCTION

ISSUED FOR

(NOT FOR CONSTRUCTION) ISSUES/REVISIONS:

1 09/18/20 ISSUED FOR BID


9/18/2020

PROJECT NUMBER: SCALE: 1/4" = 1'-0" DATE: 09/18/2020 DRAWN BY:


DRAWING TITLE: SPECIAL INSPECTIONS

CHECKED BY:

TYPICAL CONNECTION DETAIL FOR NEW BEAM TO EXISTING COLUMN

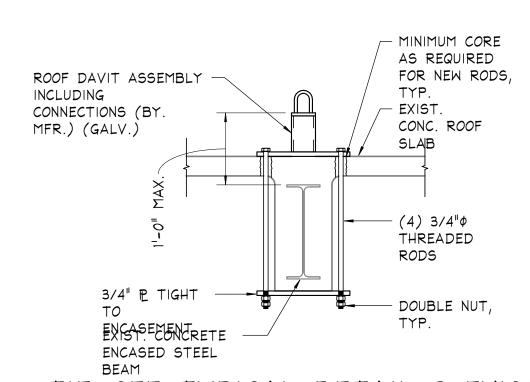


TIE-OFF TYPICAL DETAIL @ EXIST. CONCRETE-ENCASED STEEL BEAM (COORDINATE LOCATION WITH ARCH. PLANS.)

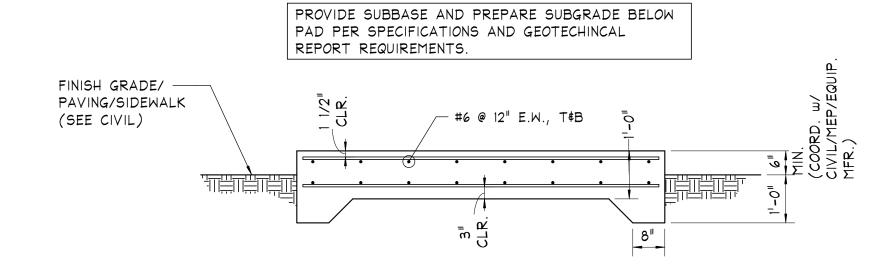


CONCRETE BASE FOR EXTERIOR EQUIPMENT TYPICAL DETAIL


1) COORDINATE LOCATIONS AND DIMENSIONS OF EQUIPMENT SUPPORT PADS WITH M.E.P. DWGS., MECHANICAL CONTRACTOR AND WITH EQUIPMENT MFR. 2) COORDINATE VIBRATION ISOLATION REQUIREMENTS WITH M.E.P. DWGS. AND SPECIFICATIONS AND WITH EQUIPMENT MFR.

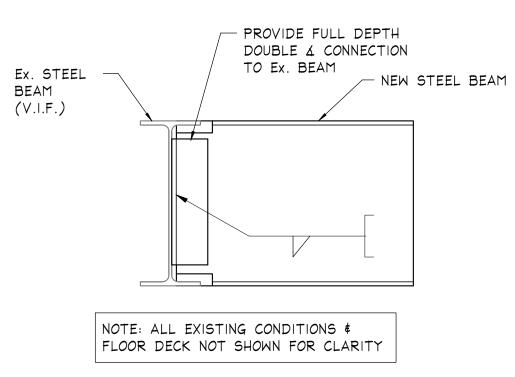



TYPICAL CONNECTION DETAIL FOR NEW BEAM TO EXISTING BEAM

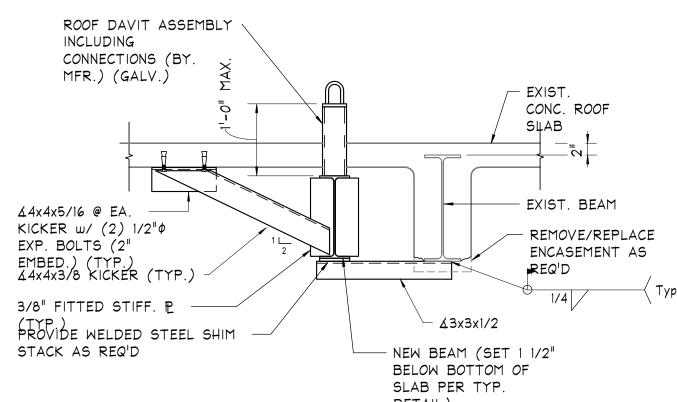


TIE-OFF TYPICAL DETAIL @ NEW BEAM BENEATH EXIST. CONC. SLAB ADJACENT TO EXIST. BEAM (COORDINATE LOCATION WITH ARCH. PLANS. \$ V.I.F))

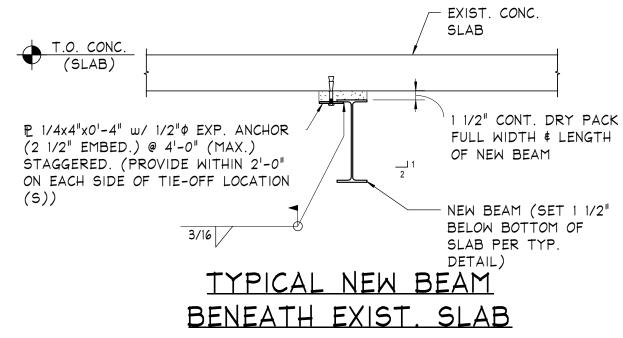


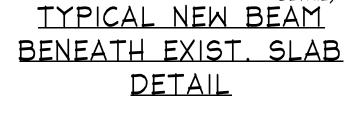

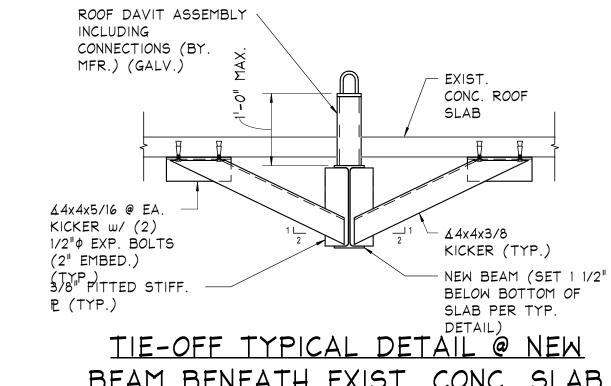



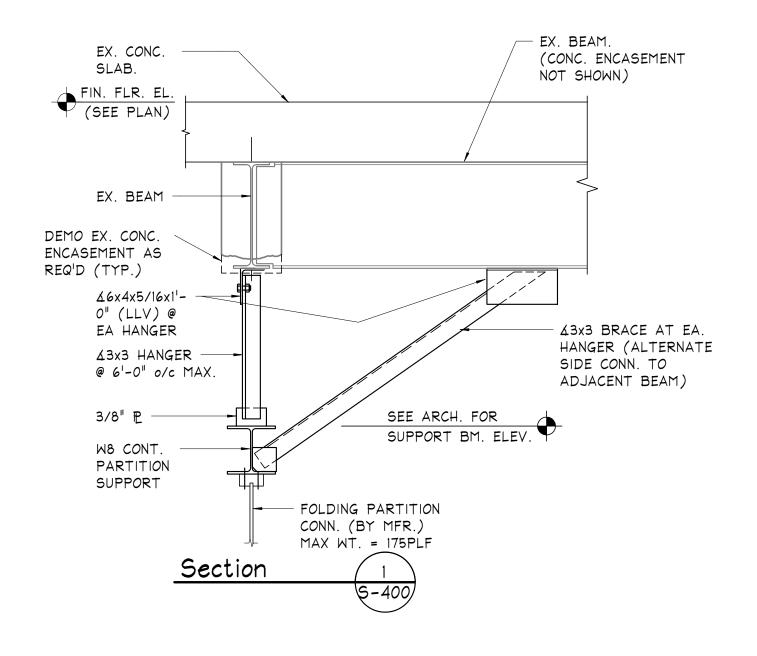

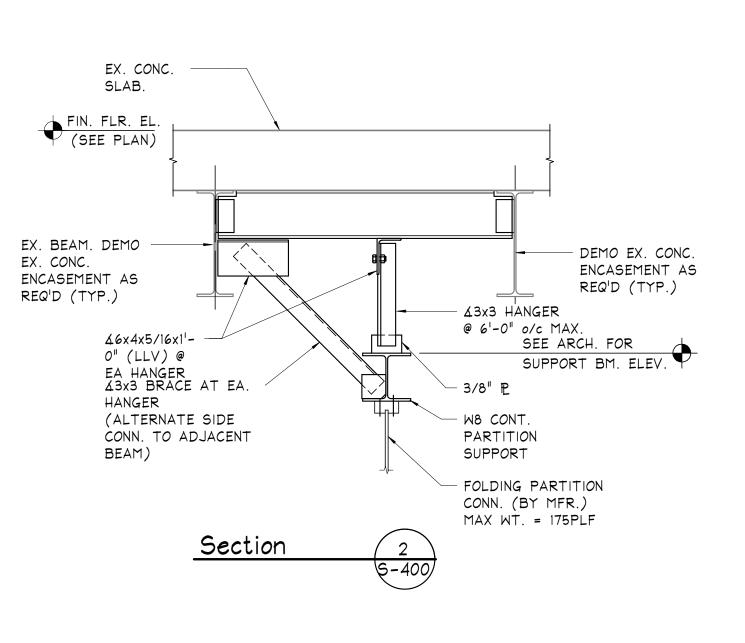



IEI GROUP, LTD. IEI ARCHITECTS, INC. 428 North 2nd Street Philadelphia, PA 19123


CONSULTANTS: **ARORA**

Telephone: 215.413.3700

Arora Engineers, Inc. 61 Wilmington-West Chester Pike Chadds Ford, PA 19317 P (610) 459-7900 F (610) 459-7950



O'Donnell & Naccarato 701 Market Street, Suite 6000 Philadelphia, PA 19106 PH: 215.925.3788 www.o-n.com 3006.0009.00

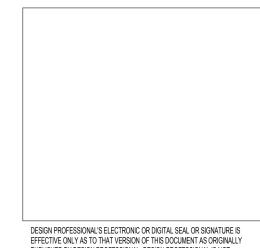

EFFECTIVE ONLY AS TO THAT VERSION OF THIS DOCUMENT AS ORIGINALLY PUBLISHED BY DESIGN PROFESSIONAL. DESIGN PROFESSIONAL IS NOT RESPONSIBLE FOR ANY SUBSEQUENT MODIFICATION, CORRUPTION, OF

PROJECTITILE:
400 N. BROAD PARTNERS, L.P.
400 NORTH BROAD STREET PHILADELPHIA,

☐ PROGRESS SET ☐ CLIENT REVIEW

■ BID SET ☐ CODE REVIEW SET ☐ ISSUED FOR CONSTRUCTION

ISSUED FOR 9/18/2020

(NOT FOR CONSTRUCTION) ISSUES/REVISIONS:

1 09/18/20 ISSUED FOR BID

PROJECT NUMBER:

DRAWING TITLE: TYPICAL FRAMING DETAILS & SECTIONS

PRINTED ON: 9/21/2020 1:23:52 PM

FIRE PROTECTION ABBREVIATIONS

ACOUSTICAL CEILING TILE AREA DRAIN ABOVE FINISHED FLOOR ABOVE FINISHED GRADE **AUTHORITY HAVING JURISDICTION** AUXILIARY

BACKFLOW PREVENTER EXISTING TO BE DEMOLISHED/REMOVED

DIAMETER DOWN DRAWING EXISTING TO REMAIN

ELEVATION EXISTING TO BE RELOCATED DEGREE FAHRENHEIT

FIRE ALARM FDC FIRE DEPARTMENT CONNECTION

FIRE HOSE VALVE FIRE PROTECTION

FEET GENERAL CONTRACTOR GALLONS PER MINUTE GYPSUM WALL BOARD INTERNATIONAL BUILDING CODE

INTERNATIONAL FIRE CODE

LOW POINT DRAIN

INCHES INSPECTORS TEST VALVE

NEW/PROPOSED NFPA NATIONAL FIRE PROTECTION ASSOCIATION

NOT IN CONTRACT NOT IN SCOPE NOT TO SCALE OUTSIDE STEM AND YOKE

POST INDICATOR VALVE POINT OF CONNECTION (NEED TO DEFINE)

POD POINT OF DEMOLITION PRESSURE REGULATING VALVE PRESSURE REDUCING VALVE PRESSURE SWITCH POUNDS PER SQUARE INCH QUICK RESPONSE

SCHEDULE SCH SQFT SQUARE FEET TAMPER SWITCH UNDERGROUND

UNDERWRITERS LABORATORIES UNLESS OTHERWISE NOTED

FIRE PUMP TEST HEADER 2-INLET FIRE DEPARTMENT CONNECTION 3-INLET FIRE DEPARTMENT CONNECTION STANDPIPE HOSE VALVE STANDPIPE HOSE VALVE IN CABINET

FIRE PROTECTION SYMBOLS

CHECK VALVE WET SPRINKLER VALVE

DRY SPRINKLER VALVE ZONE ZONE CONTROL ASSEMBLY INSPECTORS TEST VALVE

TEST AND DRAIN VALVE ASSEMBLY **AUXILIARY DRAIN** AIR COMPRESSOR

WATER FLOW SWITCH PRESSURE SWITCH - WATER FLOW PRESSURE SWITCH - LOW AIR TS TAMPER SWITCH

BUTTERFLY CONTROL VALVE W/ TAMPER

OS&Y CONTROL VALVE

BACKFLOW PREVENTER FIRE PUMP FP-CON FIRE PUMP CONTROLLER JOCKEY PUMP

JOCKEY PUMP CONTROLLER PRESSURE GAUGE PIPE CAP

VERTICAL PIPE VERTICAL PIPE ON ELBOW VERTICAL PIPE ON TEE

PIPE PENETRATION

POINT OF CONNECTION OF NEW WORK TO EXISTING

TERMINATION POINT OF DEMOLITION

FIRE PROTECTION LINETYPE LEGEND

EXISTING PROPOSED* DESCRIPTION FIRE PROTECTION MAIN —— F —— F —— FIRE PROTECTION MAIN - DEDICATED STANDPIPE ——STP———STP—— FIRE PROTECTION MAIN - DEDICATED SPRINKLER ——SPK————SPK—— SPRINKLER SYSTEM PIPING - WET ——WET—— — —WET— —

*HEAVY LINEWEIGHTS SHALL REPRESENT NEW WORK/NEW EQUIPMENT. **LIGHT/LIGHTER LINEWEIGHTS SHALL REPRESENT EXISTING EQUIPMENT.

FIRE PROTECTION SPRINKLER SYMBOLS

SYMBOL DESCRIPTION PENDENT SPRINKLER UPRIGHT SPRINKLER CONCEALED PENDENT SPRINKLER EXTENDED COVERAGE CONCEALED PENDENT SPRINKLER



IEI GROUP, LTD. IEI ARCHITECTS, INC. 428 North 2nd Street Philadelphia, PA 19123

Telephone: 215.413.3700 CONSULTANTS:

ARORA Arora Engineers, Inc.



O'Donnell & Naccarato 701 Market Street, Suite 6000 Philadelphia, PA 19106 PH: 215.925.3788 www.o-n.com



EFFECTIVE ONLY AS TO THAT VERSION OF THIS DOCUMENT AS ORIGINALLY PUBLISHED BY DESIGN PROFESSIONAL. DESIGN PROFESSIONAL IS NOT RESPONSIBLE FOR ANY SUBSEQUENT MODIFICATION, CORRUPTION, OR APPLICABILITY OF THE SEAL OR SIGNATURE, CONTACT DESIGN PROFESSIONAL.

30

☐ PROGRESS SET ☐ CLIENT REVIEW

■ BID SET ☐ CODE REVIEW SET ☐ ISSUED FOR CONSTRUCTION

9/18/20

(NOT FOR CONSTRUCTION) ISSUES/REVISIONS:

1 2020-09-18 ISSUED FOR BIDS

PROJECT NUMBER: SCALE: DATE: DRAWN BY: CHECKED BY:

DRAWING TITLE: FIRE PROTECTION ABBREVIATIONS AND SYMBOLS

FP-001

REQUIREMENT SHALL GOVERN.

- 1. CONTRACTOR SHALL COMPLY WITH ALL REGULATIONS & LAWS OF AUTHORITIES HAVING
- 2. ALL MATERIALS, MEANS AND METHODS SHALL COMPLY WITH APPLICABLE CODES, ORDINANCES, REGULATIONS AND STANDARDS.
- 3. CONTRACTOR SHALL PERFORM A SITE SURVEY TO VERIFY ALL EXISTING CONDITIONS AND NOTIFY THE ENGINEER AT ONCE OF ANY DISCREPANCIES.
- 4. EACH CONTRACTOR SHALL REVIEW ALL PROJECT DOCUMENTS OF ALL TRADES FOR A THOROUGH UNDERSTANDING OF PROJECT AND ANY CROSS REFERENCING OF WORK. REVIEW ALL PROJECT
- 5. ALL CONSTRUCTION TRAFFIC SHALL ENTER AND EXIT THE PROJECT AREA THROUGH DESIGNATED ACCESS POINTS AS DETERMINED BY THE OWNER OR THEIR DESIGNATED REPRESENTATIVE.
- 6. THE CONTRACTOR SHALL NOT BE ALLOWED ANY STORAGE AREA OTHER THAN THAT AVAILABLE

REQUIREMENTS PRIOR TO BIDDING. DISCREPANCIES BETWEEN DOCUMENTS SHALL BE REPORTED TO THE ENGINEER PRIOR TO BIDDING. IN THE CASE OF ANY DISCREPANCIES, THE MOST STRINGENT

- WITHIN THE LIMITS OF THE STAGING AREA OR CONFINES OF THE WORK AREA. 7. CONTRACTOR SHALL BE RESPONSIBLE FOR REMOVAL AND DISPOSAL OF CONSTRUCTION DEBRIS
- AND REFUSE ON A DAILY BASIS. 8. A COPY OF THE CURRENT SET OF CONTRACT DOCUMENTS (WITH AS-BUILT INFORMATION) SHALL BE
- KEPT AT THE JOB SITE AT ALL TIMES BY THE CONTRACTOR. 9. ALL PENETRATIONS, THROUGH DESIGNATED FIRE RATED WALLS, CEILINGS AND FLOOR SLABS SHALL
- BE PROPERLY SEALED WITH AN APPROVED RATED FIRE STOPPING MATERIAL. ALL FIRE STOPPING MATERIAL SHALL BE SUPPLIED AND WORK PERFORMED AS PER PROJECT SPECIFICATIONS.
- 10. CONTRACTOR SHALL REPLACE IN-KIND ANY EQUIPMENT OR ARCHITECTURAL ELEMENTS DAMAGED BY WORK OF THIS PROJECT AT NO ADDITIONAL COSTS TO THE OWNER.

11. CONTRACTOR SHALL COMPLETE ALL CUTTING AND PATCHING REQUIRED FOR THE INSTALLATION OF

THE WORK, CUTTING AND PATCHING SHALL BE COMPLETED IN A NEAT AND WORKMAN LIKE MANNER.

- PATCHING MATERIALS SHALL MATCH EXISTING MATERIALS TO THE GREATEST EXTENT POSSIBLE. PROVIDE TOUCH UP PAINT AS REQUIRED TO MATCH PAINT FINISH AND COLOR OF EXISTING ADJACENT AREAS. CONTRACTOR SHALL SALVAGE MATERIALS FOR RE-USE IN AREAS WHERE SUBSTRATES/SURFACES ARE TO BE PATCHED/REPAIRED (I.E. TILES, WALLS, CEILING TILE). 12. THE CONTRACTOR SHALL GUARANTEE THE ENTIRE INSTALLATION FOR A PERIOD OF ONE YEAR (EXCEPT WHERE EXTENSIONS OF THIS ONE YEAR PERIOD ARE NOTED) FROM THE DATE OF
- MALFUNCTION OF EQUIPMENT OR UNSATISFACTORY PERFORMANCE, AND ALL OTHER WORK OR PARTS OF THE BUILDING DAMAGED THEREBY, AS A RESULT OF WORK OF THE PROJECT BY THE CONTRACTOR, SHALL BE THE RESPONSIBILITY OF THE CONTRACTOR. CONTRACTOR SHALL PAY ALL REPAIR COSTS ACCORDINGLY WITHOUT ADDITIONAL COSTS TO THE OWNER.

ACCEPTANCE OF THE SYSTEM AS A WHOLE. ANY DEFECTS IN WORKMANSHIP, MATERIALS,

- 13. IN ADDITION TO SPECIFICATIONS, AS MAY BE DEFINED HEREAFTER, THE CONTRACTOR SHALL PROTECT THE WORK SITE AND ALL HIS OR HER WORK AGAINST ANY DAMAGE UNTIL FINAL COMPLETION AND ACCEPTANCE BY THE OWNER.
- 14. CONTRACTOR SHALL, UPON COMPLETION OF THE WORK, SUBMIT AS-BUILT RECORD DRAWINGS SHOWING ALL CHANGES FROM THE CONTRACT DRAWING MADE IN THE INSTALLATION, AND SHOWING DIMENSION LOCATIONS OF CONCEALED EQUIPMENT.
- 15. PRIOR TO DELIVERY OF ANY MATERIALS TO THE SITE, THE CONTRACTOR SHALL PROVIDE MATERIAL SAFETY DATA SHEETS FOR ALL ITEMS AND MATERIALS USED IN THE WORK.
- 16. PRIOR TO ACCEPTANCE OF THE SPACE, ALL SYSTEMS SHALL BE INSPECTED, TESTED AND OPERATED TO DEMONSTRATE TO THE OWNER, OR HIS DESIGNATED REPRESENTATIVE, THAT THE INSTALLATION AND PERFORMANCE OF THESE SYSTEMS AND/OR PARTS THEREOF CONFORM TO THE DESIGN INTENT.
- 17. THE BUILDING IS A WORK OF A COMPLEX NATURE WHICH WILL REQUIRE ACCURATE PLANNING, CAREFUL PREPARATION AND EXECUTION, ATTENTION TO DETAIL AND CLOSE SUPERVISION BY THE CONTRACTOR. THE CONTRACTOR SHALL BE REQUIRED TO DO THIS WORK IN FULL COOPERATION WITH ALL CONSTRUCTION TRADES AND SUBJECT TO SCHEDULING ARRANGED TO MINIMIZE DISRUPTION OF NORMAL ACTIVITIES OF THE BUILDING.
- 18. PRIOR TO ANY CORE DRILLING, THE CONTRACTOR SHALL OBTAIN THE SERVICES OF A UTILITY LOCATOR FIRM WITH ABILITY TO LOCATE CONDUIT IN CONCRETE SLABS. CONTRACTOR SHALL IDENTIFY THE LOCATION OF CONDUITS IN SLAB, THEN PRESENT THE FINDINGS TO THE ENGINEER FOR REVIEW PRIOR TO CORE DRILLING. ALL PENETRATIONS THROUGH DESIGNATED FIRE RATED WALLS, CEILINGS AND FLOOR SLABS SHALL BE PROPERLY SEALED WITH AN APPROVED RATED FIRE STOPPING MATERIAL. ALL FIRE STOPPING MATERIAL SHALL BE SUPPLIED AND WORK PERFORMED AS PER PROJECT SPECIFICATIONS.
- 19. JUNCTION BOXES, VALVES, DAMPERS, OR ANY CONCEALED EQUIPMENT REQUIRING ACCESS SHALL ONLY BE PERMITTED/LOCATED IN ACCESSIBLE TYPE AREAS (I.E. LAY-IN TYPE CEILING, ETC.) OR SHALL BE PROVIDED WITH ACCESS PANELS.
- 20. WHERE UTILITIES AND/OR SERVICES REQUIRE SHUTDOWN FOR THE WORK TO BE PERFORMED. NOTIFY THE PORT AUTHORITY PROJECT ENGINEER. REQUESTS FOR UTILITY AND/OR SERVICES SHUTDOWNS SHALL BE SUBMITTED TO THE PORT AUTHORITY PROJECT ENGINEER, IN WRITING, A MINIMUM OF ONE WEEK PRIOR TO THE SCHEDULED SHUTDOWN.
- 21. ALL SYSTEMS SHALL BE RETURNED TO SERVICE PRIOR TO COMPLETION OF APPROVED SHIFT AND AT THE END OF EACH WORK DAY. IN THE EVENT A SYSTEM CANNOT BE RETURNED TO SERVICE THE CONTRACTOR SHALL PROVIDE A FIRE WATCH.
- PAINT PROCESS SHALL MEET ENVIRONMENTAL STANDARDS FOR VENTILATION AS ESTABLISHED BY OSHA. ALL PAINTS, SOLVENTS, RAGS AND OTHER PAINTING REFUSE SHALL BE DISPOSED OF PROPERLY OFF SITE ACCORDING TO STATE AND FEDERAL ENVIRONMENTAL REGULATIONS. EVIDENCE OF SUCH COMPLIANCE SHALL BE FURNISHED TO THE OWNER PRIOR TO THE START OF

22. ALL PAINT SHALL MEET THE REQUIREMENTS OF THE NFPA FOR FLAME SPREAD AND SMOKE DENSITY.

- 23. PRIOR TO THE APPLICATION OF PAINT, CONTRACTOR SHALL PROPERLY PREPARE AND CLEAN PIPING AND EQUIPMENT PER PAINT MANUFACTURES' GUIDELINES.
- 24. THE CONTRACTOR SHALL TAKE ANY/ALL PREVENTIVE MEASURES TO CURTAIL THE NOISE LEVEL AT ALL TIMES. THE OWNER RESERVES THE RIGHT TO CURTAIL ANY ACTIVITY IT DEEMS OBTRUSIVE TO OPERATIONS.

FIRE PROTECTION NOTES

- THE SCOPE OF WORK INCLUDES FURNISHING MATERIALS AND LABOR FOR ALL INSTALLATION. PHASING, TESTING AND ACCEPTANCE OF THE FIRE PROTECTION SYSTEM(S) AS SHOWN IN THE CONTRACT DOCUMENTS. THE PROJECT SCOPE INCLUDES:
 - THESE DOCUMENTS PROVIDE FIRE SUPPRESSION DOCUMENTS FOR A RETRO-FIT. CONTRACTOR SHALL PROVIDE WET TYPE SPRINKLER SYSTEMS.
- THE PROJECT SHALL BE BASED ON THE REQUIREMENTS OF THE FOLLOWING CODES, STANDARDS, TESTING LABORATORIES AND UNDERWRITING AGENCIES:
- PHILADELPHIA BUILDING CODE (INTERNATIONAL BUILDING CODE 2018) PHILADELPHIA BULLETINS AND L&I PUBLICATIONS
- PHILADELPHIA FIRE CODE (2018 INTERNATIONAL FIRE CODE) PHILADELPHIA MECHANICAL CODE
- (2018 INTERNATIONAL MECHANICAL CODE)
- PENNSYLVANIA UNIFORM CONSTRUCTION CODE PENNSYLVANIA FIRE CODE
- NFPA 13 STANDARD FOR THE INSTALLATION OF SPRINKLER SYSTEMS 2016 EDITION NFPA 14 STANDARD FOR THE INSTALLATION OF STANDPIPE AND HOSE SYSTEMS 2016
- EDITION NFPA 70, NATIONAL ELECTRIC CODE, 2016 EDITION
- NFPA 72, NATIONAL FIRE ALARM CODE, 2016 EDITION ADAAG, ADA ACCESSIBILITY GUIDELINES FOR BUILDINGS AND FACILITIES, 2002 EDITION UL LISTED PRODUCTS FOR FIRE PROTECTION USE CONSIDERING ENVIRONMENTAL
- CONDITIONS MANUFACTURERS PRINTED UL LISTED INSTALLATION INSTRUCTIONS
- ALL MATERIALS TO BE FM GLOBAL APPROVED AND INSTALLED TO MEET FM GLOBAL
- STANDARDS APPLICABLE FM GLOBAL DATA SHEETS PROJECT SPECIFICATIONS
- THE CONTRACTOR'S SCOPE OF WORK SHALL INCLUDE BUT NOT BE LIMITED TO THE PREPARATION AND SUBMISSION OF SEALED SHOP DRAWINGS AND HYDRAULIC CALCULATIONS ACCOMPANIED BY COMPLETE PRODUCT DATA. PARTIAL SUBMISSIONS WILL BE REJECTED.
- CONTRACTOR SHALL PERFORM/OBTAIN HYDRANT FLOW TEST AND SUBMIT RESULTS FOR REVIEW. CONTRACTOR SHALL BE RESPONSIBLE FOR ALL COSTS AND FEES ASSOCIATED WITH TESTS. HYDRANTS TESTED SHALL BE LOCATED AS CLOSE AS POSSIBLE TO POINT OF FIRE SERVICE CONNECTION TO THE CITY MAIN. TEST DATA SHALL INDICATE LOCATIONS OF THE HYDRANTS TESTED, STATIC PRESSURE, RESIDUAL PRESSURE AT THE TEST FLOW (MINIMUM 500 GPM) AND GRADE ELEVATION AT THE HYDRANT TESTED.
- THE CONTRACTOR SHALL SHOW ALL FINAL LOCATIONS ON THE SHOP DRAWINGS THAT ARE COORDINATED WITH THE OTHER TRADES, PRIOR TO SUBMISSION TO THE ENGINEER FOR
- PIPE AND VALVE LOCATIONS ARE DIAGRAMMATIC AND ARE SHOWN FOR GENERAL REFERENCE ONLY. COORDINATE ALL PIPING, VALVES, DRAINS, TEST CONNECTION LOCATIONS WITH ARCHITECTURAL AND STRUCTURAL ELEMENTS, LIGHTING FIXTURES AND ELECTRICAL EQUIPMENT, HVAC EQUIPMENT, ETC. PROPER COORDINATION SHALL BE PERFORMED WITH ALL OTHER CONTRACTORS PRIOR TO SHOP DRAWING SUBMISSION.
- PIPE SHALL BE STANDARD-WEIGHT SCHEDULE 40, ASTM A120/53 STEEL PIPE FOR WET-PIPE AND DRY-PIPE FIRE PROTECTION SYSTEMS. PIPING SHALL BE IN COMPLIANCE WITH NFPA 13.
- SCHEDULE 10 PIPING IS NOT PERMITTED.
- 9. 2" PIPING AND SMALLER SHALL BE THREADED OR MECHANICAL FITTINGS.
- 10. 2-1/2" PIPING AND LARGER SHALL BE MECHANICAL FITTINGS.
- STANDARD PRESSURE PIPING COMPONENTS AND FITTINGS SHALL BE RATED FOR A MINIMUM 175
- HIGH PRESSURE PIPING COMPONENTS AND FITTINGS SHALL BE RATED FOR A MINIMUM 300 PSIG.
- PIPING SHALL BE INSTALLED TIGHT TO SLABS, BEAMS, JOISTS, COLUMNS, WALLS, AND OTHER BUILDING ELEMENTS. INSTALL SLEEVES FOR PIPES PASSING THROUGH CONCRETE AND MASONRY WALLS, GYPSUM BOARD PARTITIONS, AND CONCRETE FLOOR AND ROOF SLABS
- 14. HANGARS AND SUPPORTS SHALL COMPLY WITH NFPA 13, FM GLOBAL STANDARDS, AND ALL LOCAL AMENDMENTS.
- PROVIDE SEISMIC RESTRAINTS AND BRACING IN ACCORDANCE WITH FM GLOBAL AND NFPA 13 FIRE PROTECTION PIPING.
- PERFORM HYDROSTATIC TESTS FOR ALL SECTIONS OF THE PIPING SYSTEMS INSTALL AT NOT LESS THAN 200 PSI PRESSURE OR 50 PSI IN EXCESS OF THE SYSTEM WORKING PRESSURE FOR TWO HOURS. ALL TESTING SHALL CONFORM TO FM GLOBAL STANDARDS AND NFPA 13.
- 17. FIRE PROTECTION PIPING SHALL HAVE LABELS, TAGS OR PIPE MARKERS ON EQUIPMENT AND PIPING IN ACCORDANCE WITH FM GLOBAL STANDARDS, NFPA 13, AND PACKAGE SPECIFICATIONS.
- WHEN REQUIRED, EXPOSED FIRE PROTECTION PIPING SHALL BE PAINTED IN ACCORDANCE WITH AHJ REQUIREMENTS. WHERE ALLOWABLE PIPING SHALL BE PAINTED TO MATCH ARCHITECTURAL FINISHES/COLORS. PRIOR TO THE APPLICATION OF PAINT, CONTRACTOR SHALL PROPERLY PREPARE AND CLEAN PIPING PER PAINT MANUFACTURES GUIDELINES. PROVIDE PAINT SAMPLES TO OWNER'S REPRESENTATIVE FOR APPROVAL.
- CONTRACTOR IS RESPONSIBLE FOR COORDINATION WITH ALL WORK, INCLUDING LIGHTS, GRIDS, HVAC EQUIPMENT ETC. NOTIFY ENGINEER OF CEILING ELEMENT CONFLICTS PRIOR TO CONTINUING WORK. ROUTING OF ALL PIPING SHALL BE COORDINATED WITH THE STRUCTURE, ARCHITECTURAL FINISHES, AND EQUIPMENT OF OTHER TRADES.
- THE CONTRACTOR SHALL BE RESPONSIBLE FOR ANY AND ALL CEILING REPLACEMENT OR RECONSTRUCTION ASSOCIATED WITH THE FIRE PROTECTION SYSTEM SCOPE OF WORK.
- THE CONTRACTOR SHALL PROVIDE DETAILED AS-BUILT DRAWINGS UPON COMPLETION OF WORK.
- THE CONTRACTOR SHALL UTILIZE FLEXIBLE STYLE SPRINKLER HEAD IN ALL ACOUSTICAL TILES. HARD PIPED ARMOVERS SHALL NOT BE ACCEPTABLE.
- THE CONTRACTOR SHALL PROVIDE A SPRINKLER SYSTEM LOOP ON ALL WET-PIPE SPRINKLER SYSTEM FLOORS FOR FUTURE FIT-OUT FLEXIBLE.
- BUILDING SHALL BE FULLY SPRINKLERED. ALL UNFINISHED / SHELL SPACES SHALL BE FURNISHED WITH BRANCHLINES WITH UPRIGHT HEADS ON 1" OUTLETS MINIMUM FOR FUTURE FIT-OUTS OF SPACES. KEEP BRANCHLINES AS HIGH AS POSSIBLE TO ACCOMMODATE FUTURE CEILINGS.

SCHEDULE AND PHASING NOTES

CONTRACTOR SHALL BE RESPONSIBLE FOR COORDINATING SCHEDULE WITH THE MASTER PROJECT SCHEDULE. THE SCHEDULE SHALL BE COORDINATED WITH ALL OTHER TRADES AND SUBMITTED TO THE OWNER EVERY TWO WEEKS. ALL CONTRACTORS SHALL BEAR THE COST OF ANY SCOPE IMPACTS CAUSED BY CHANGES TO THE MASTER PROJECT SCHEDULE. PRIOR TO THE START OF INSTALLATION, A MASTER SCHEDULE SHALL BE SUBMITTED FOR OWNER APPROVAL. ALL WORK SHALL BE COMPLETE (INCLUDING TESTING AND FINAL APPROVAL BY AHJ) IN ACCORDANCE WITH MASTER SCHEDULE.

FIRE PROTECTION WORK SHALL COMMENCE IN THE FOLLOWING 4 PHASES:

- FIELD SURVEY AND SHOP DRAWING SUBMITTAL: DEVELOP COORDINATED SHOP DRAWINGS FOR APPROVAL BY OWNER AND OWNER'S REPRESENTATIVE.
- SYSTEM INSTALLATION: UPON APPROVAL OF SHOP DRAWINGS PERFORM INSTALLATION IN ACCORDANCE WITH MASTER SCHEDULE AND COORDINATE INSTALLATION WITH ALL OTHER
 - ACCEPTANCE TESTING/OPERATIONAL DEMONSTRATION TO OWNER: PRIOR TO SUBMITTING A REQUEST FOR FINAL INSPECTION THE CONTRACTOR SHALL TEST AND OPERATE ALL EQUIPMENT AND DEVICES TO VERIFY THE PROPER OPERATION AND INSTALLATION OF THE SYSTEM. ANY AND ALL ISSUES SHALL BE CORRECTED AND ADDITIONAL TESTING SHALL BE REPEATED AS NECESSARY AT NO ADDITIONAL COST TO THE OWNER. SATISFACTORILY DEMONSTRATE TO OWNER'S REPRESENTATIVE THE PROPER OPERATION AND FUNCTION OF
- FINAL INSPECTION: UPON COMPLETION OF ACCEPTANCE TESTING CONTRACTOR SHALL REQUEST, COORDINATE AND PERFORM ALL NECESSARY INSPECTIONS WITH THE AHJ AND ALL OTHER TRADES NECESSARY FOR A SUCCESSFUL INSPECTION. ADDITIONAL INSPECTIONS DUE TO CONTRACTOR ERROR SHALL BE PERFORMED AT NO ADDITIONAL COST TO OWNER.



428 North 2nd Street Philadelphia, PA 19123

Telephone: 215.413.3700 CONSULTANTS:

Arora Engineers, Inc. 61 Wilmington-West Chester Pike



O'Donnell & Naccarato 701 Market Street, Suite 6000 Philadelphia, PA 19106 PH: 215.925.3788 www.o-n.com

EFFECTIVE ONLY AS TO THAT VERSION OF THIS DOCUMENT AS ORIGINALL RESPONSIBLE FOR ANY SUBSEQUENT MODIFICATION, CORRUPTION, OF APPLICABILITY OF THE SEAL OR SIGNATURE, CONTACT DESIGN PROFESSIONAL

- ☐ PROGRESS SET
- CLIENT REVIEW BID SET
- ☐ CODE REVIEW SET ☐ ISSUED FOR CONSTRUCTION

(NOT FOR CONSTRUCTION) ISSUES/REVISIONS:

1 2020-09-18 ISSUED FOR BIDS


PROJECT NUMBER: SCALE:

DRAWING TITLE: FIRE PROTECTION

GENERAL NOTES

FP-002



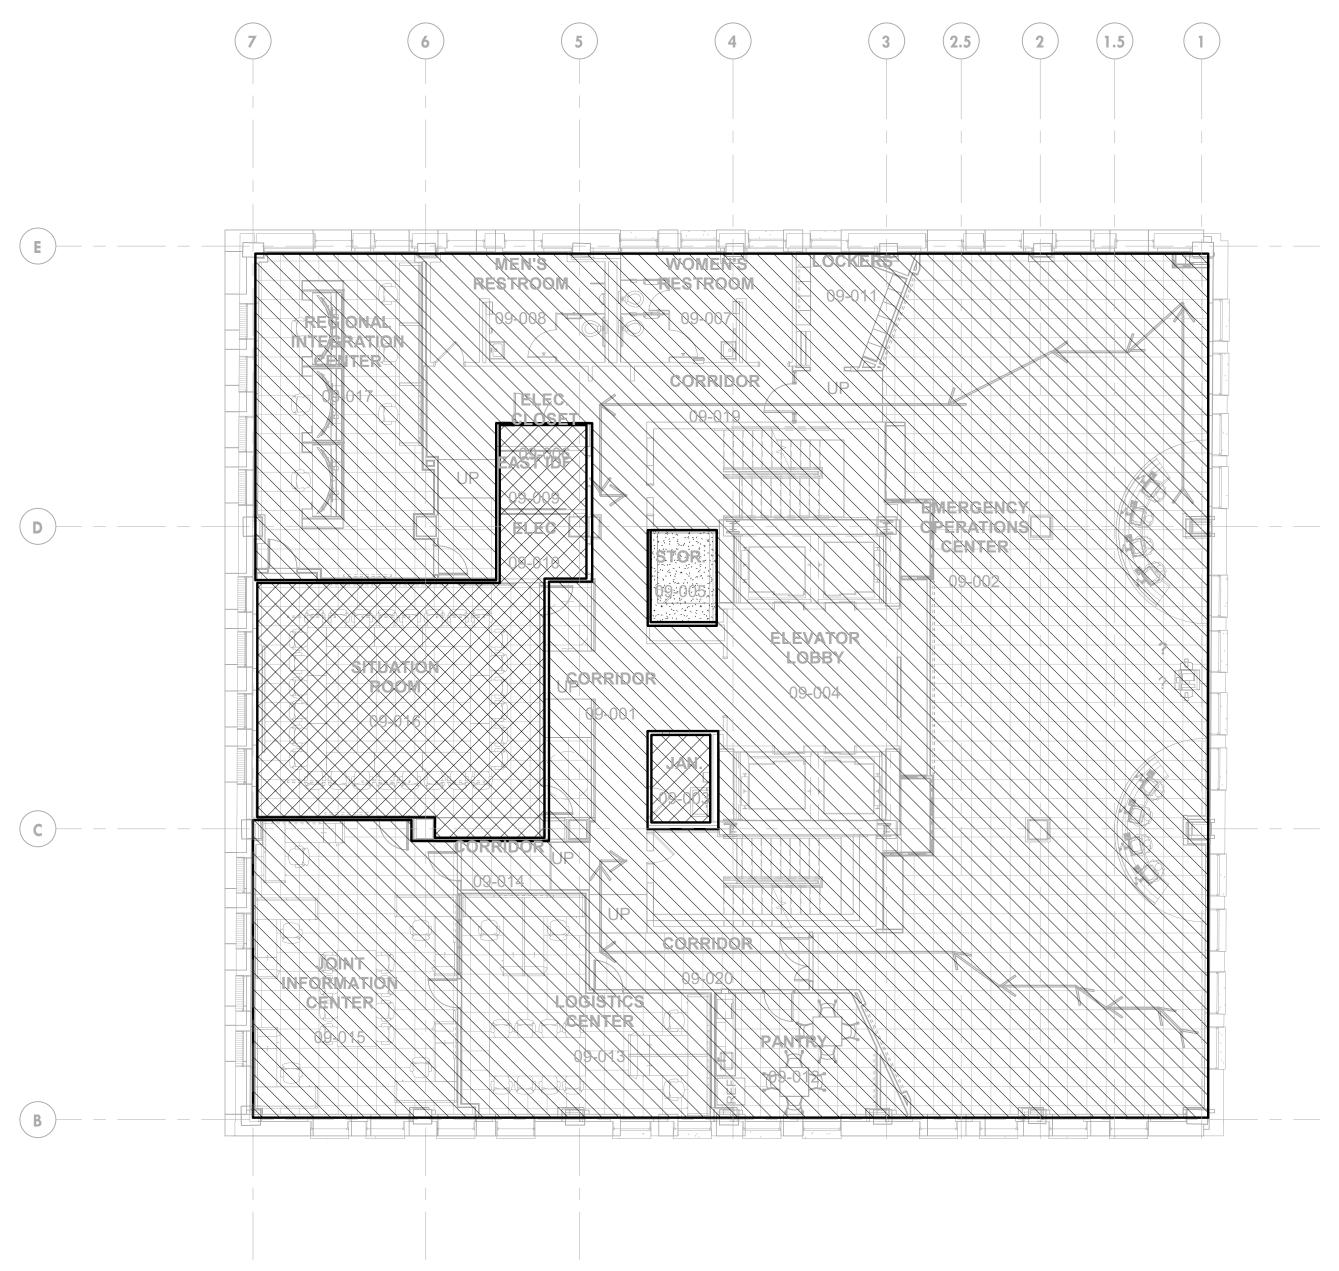

LIGHT HAZARD: 0.10 GPM/FT² OVER 1500 SQ. FT

ORDINARY HAZARD GROUP 1: 0.15 GPM/FT² OVER 1500 SQ. FT

OCCUPANCY HAZARD CLASSIFICATION KEY

ORDINARY HAZARD GROUP 2: 0.20 GPM/FT² OVER 1500 SQ. FT

IEI GROUP, LTD. IEI ARCHITECTS, INC.

428 North 2nd Street Philadelphia, PA 19123 Telephone: 215.413.3700 CONSULTANTS:

ARORA

Arora Engineers, Inc. 61 Wilmington-West Chester Pike Chadds Ford, PA 19317 P (610) 459-7900 F (610) 459-7950 aroraengineers.com



O'Donnell & Naccarato
701 Market Street, Suite 6000
Philadelphia, PA 19106
PH: 215.925.3788 www.o-n.com



EFFECTIVE ONLY AS TO THAT VERSION OF THIS DOCUMENT AS ORIGINALLY PUBLISHED BY DESIGN PROFESSIONAL. DESIGN PROFESSIONAL IS NOT RESPONSIBLE FOR ANY SUBSEQUENT MODIFICATION, CORRUPTION, OR UNAUTHORIZED USE OF SUCH DOCUMENT. TO VERIFY THE VALIDITY OR ADDITIONAL DESIGN PROFESSIONAL SUBSEQUENT MODIFICATION, CORRUPTION, OR UNAUTHORIZED USE OF SUCH DOCUMENT. TO VERIFY THE VALIDITY OR APPLICABILITY OF THE SEAL OR SIGNATURE, CONTACT DESIGN PROFESSIONAL.

☐ PROGRESS SET

☐ CLIENT REVIEW ■ BID SET

☐ CODE REVIEW SET ☐ ISSUED FOR CONSTRUCTION

> ISSUED FOR 9/18/20


(NOT FOR CONSTRUCTION) ISSUES/REVISIONS:

1 2020-09-18 ISSUED FOR BIDS

PROJECT NUMBER: SCALE: As indicated DATE: 07/07/2020 DRAWN BY: CHECKED BY:

DRAWING TITLE: OCCUPANCY HAZARD CLASSIFICATION **PLANS**

FP-003

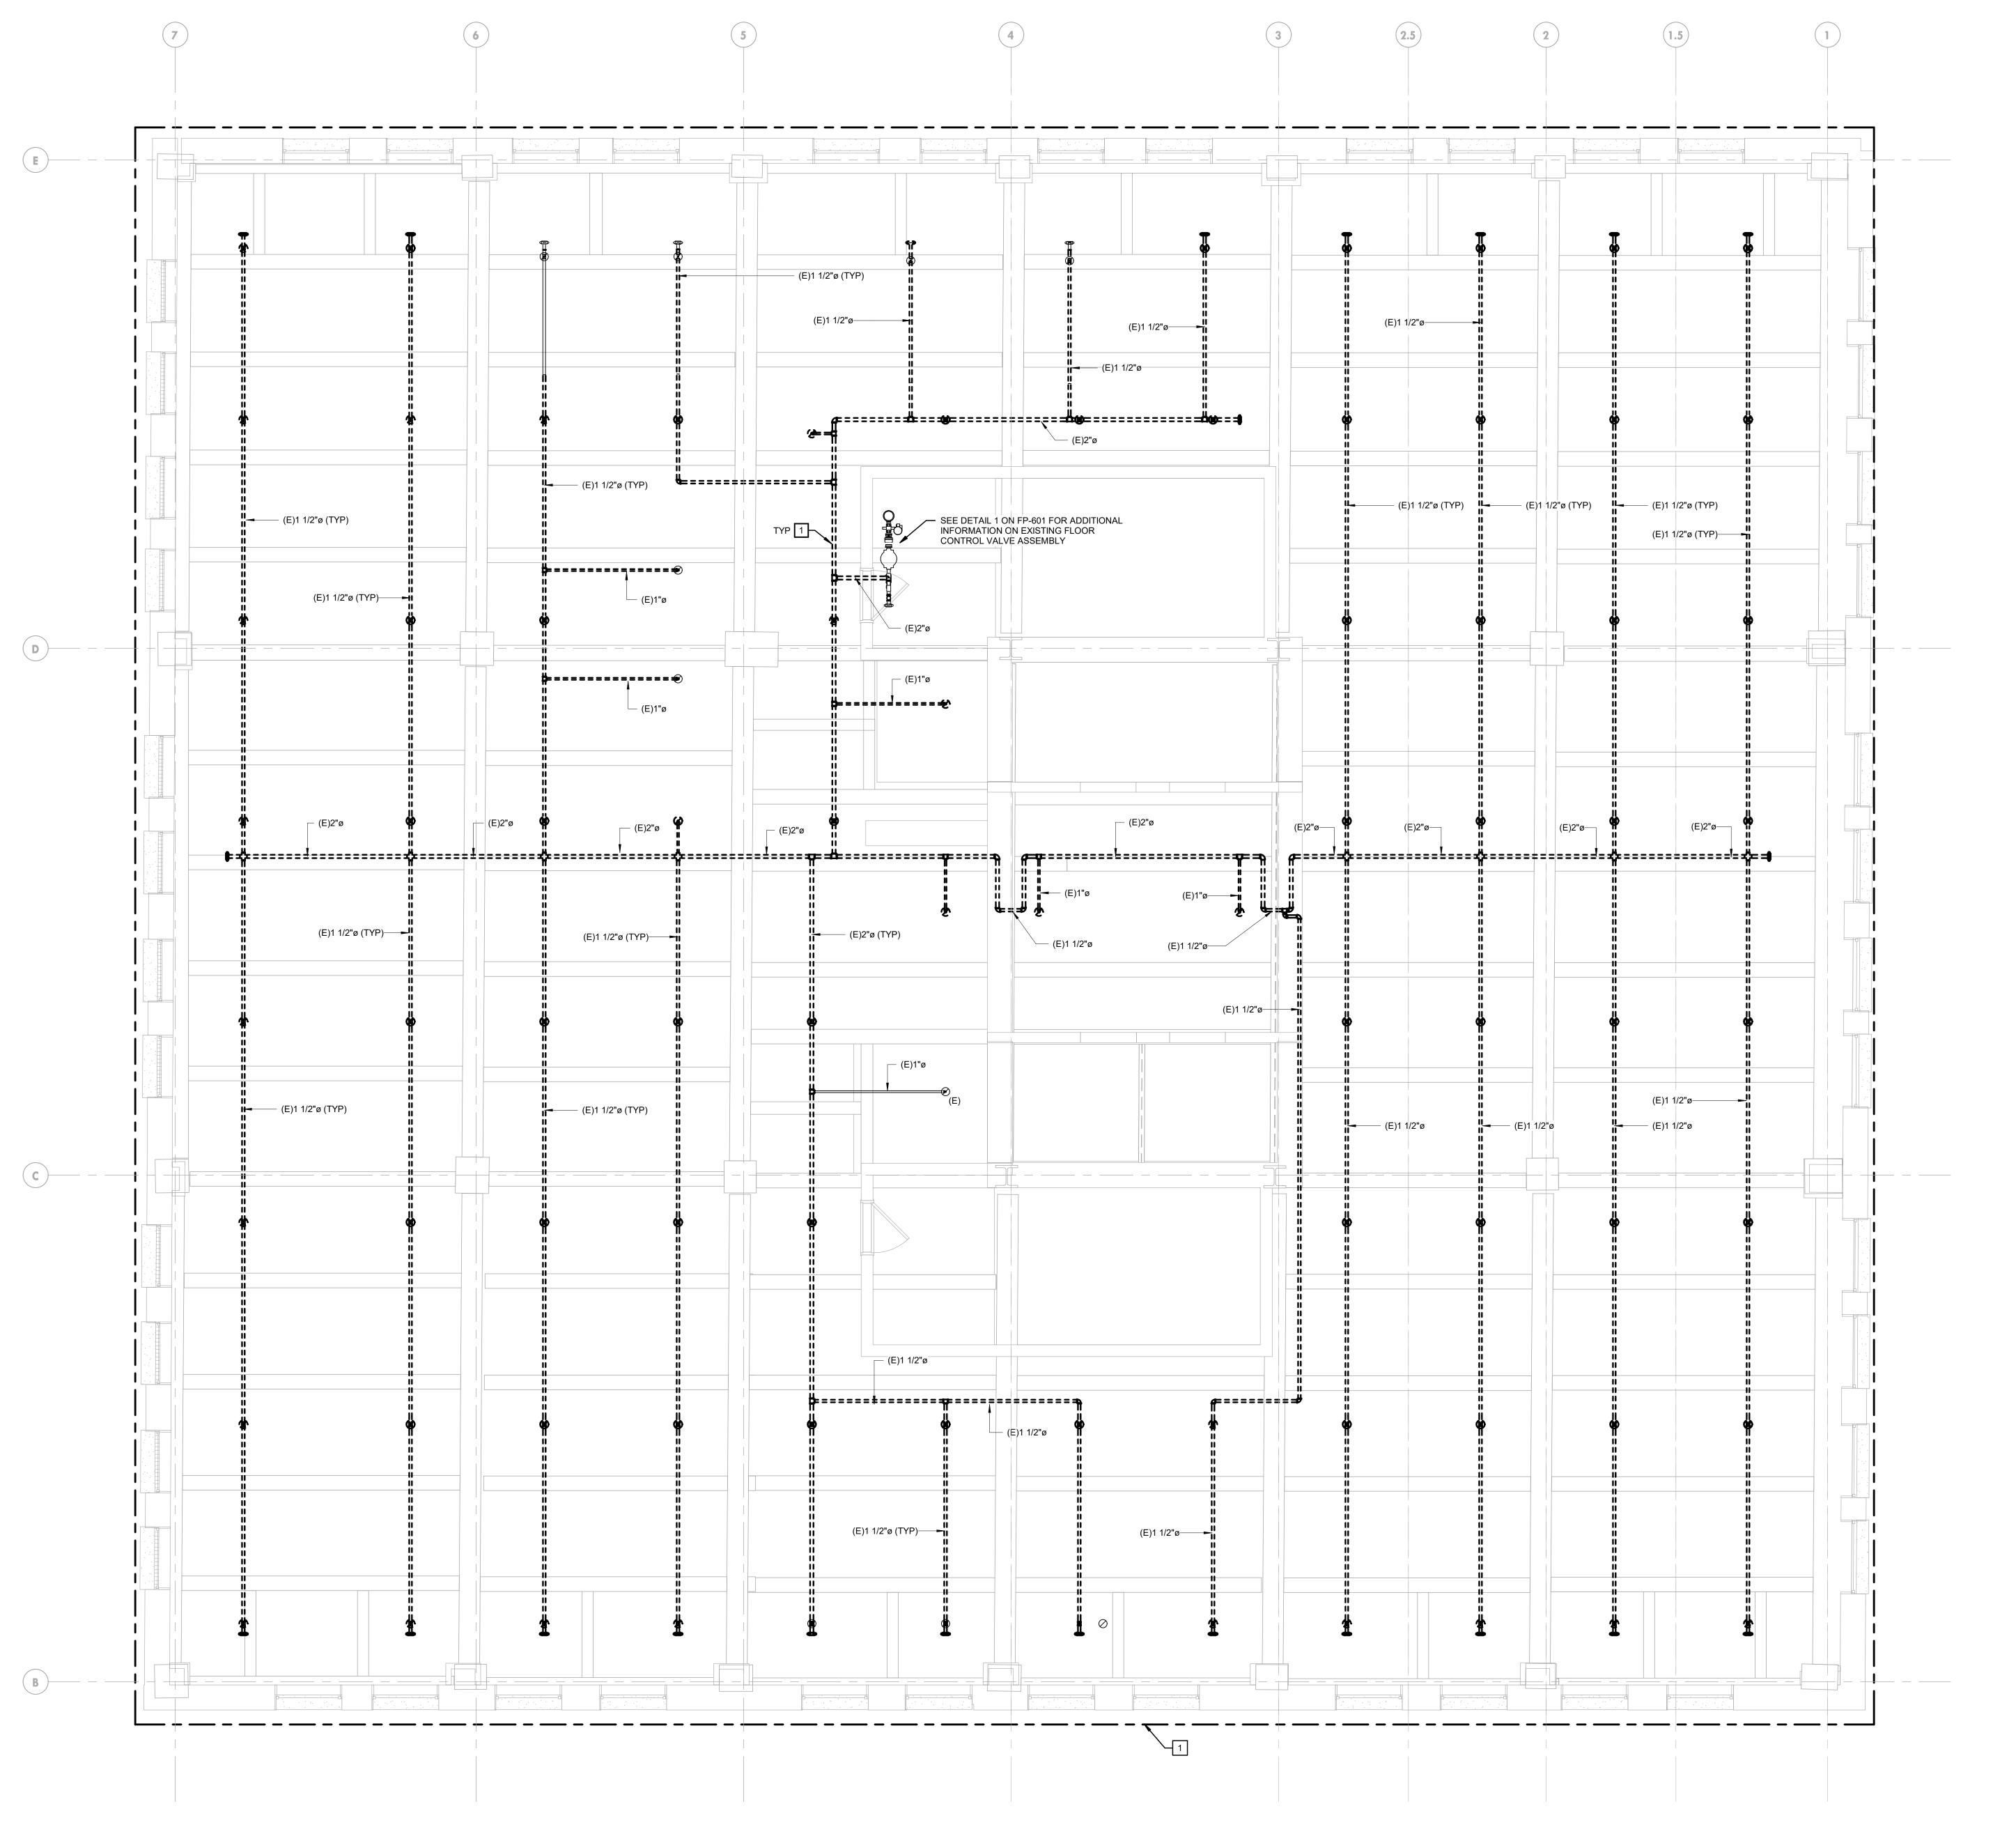

1) FIRE PROTECTION DEMOLITION PLAN - EIGHTH FLOOR

GENERAL NOTES:

- 1. REFER TO FP-001 FOR GENERAL NOTES, SYMBOLS, AND ABBREVIATIONS.
- 2. EXISTING FITTINGS AND ARMOVER/RISER NIPPLE PIPING SHALL BE REMOVED BACK TO THE NEAREST BRANCHLINE OR MAIN PIPE FITTING TO REMAIN.
- 3. ALL SPRINKLER HEADS WITHIN FINISHED CEILINGS ARE TO BE NEW WHITE CONCEALED PENDENT TYPE SPRINKLER HEADS, UNLESS OTHERWISE NOTED. ALL NEW SPRINKLER HEADS SHALL BE LOCATED IN THE CENTER OF TILE AND COORDINATED WITH LIGHTS, DIFFUSERS AND ANY ARCHITECTURAL CEILING ELEMENTS.
- FIRE SPRINKLER PIPING AND SPRINKLERS SHALL NOT BE ROUTED OR LOCATED OVER ELECTRICAL EQUIPMENT AND RACKS, TO PREVENT DAMAGE CAUSED BY POTENTIAL LEAKS.

KEYED NOTES:

1 DASHED PIPING AND FITTINGS SHALL BE DISCONNECTED FROM SYSTEM AND RAISED UP DURING CONSTRUCTION TO ACCOMODATE NEW CEILING SYSTEMS. DASHED SPRIGS, DROPS, AND SPRINKLERS SHALL BE REMOVED.



IEI GROUP, LTD. IEI ARCHITECTS, INC. 428 North 2nd Street

Philadelphia, PA 19123 Telephone: 215.413.3700

CONSULTANTS: ARORA

Arora Engineers, Inc. 61 Wilmington-West Chester Pike Chadds Ford, PA 19317 P (610) 459-7900 F (610) 459-7950 aroraengineers.com



<u>O'Donnell & Naccarato</u> 701 Market Street, Suite 6000 Philadelphia, PA 19106 PH: 215.925.3788 www.o-n.com

EFFECTIVE ONLY AS TO THAT VERSION OF THIS DOCUMENT AS ORIGINALLY PUBLISHED BY DESIGN PROFESSIONAL. DESIGN PROFESSIONAL IS NOT RESPONSIBLE FOR ANY SUBSEQUENT MODIFICATION, CORRUPTION, OR UNAUTHORIZED USE OF SUCH DOCUMENT. TO VERIFY THE VALIDITY OR ADDITIONAL DESIGN PROFESSIONAL SUBSEQUENT MODIFICATION, CORRUPTION, OR UNAUTHORIZED USE OF SUCH DOCUMENT. TO VERIFY THE VALIDITY OR

☐ PROGRESS SET

☐ CLIENT REVIEW ■ BID SET

☐ CODE REVIEW SET ☐ ISSUED FOR CONSTRUCTION

> ISSUED FOR 9/18/20


(NOT FOR CONSTRUCTION) ISSUES/REVISIONS:

1 2020-09-18 ISSUED FOR BIDS

PROJECT NUMBER: SCALE: DATE: DRAWN BY: CHECKED BY:

DRAWING TITLE: FIRE PROTECTION 8TH FLOOR DEMO PLAN

FPD-108

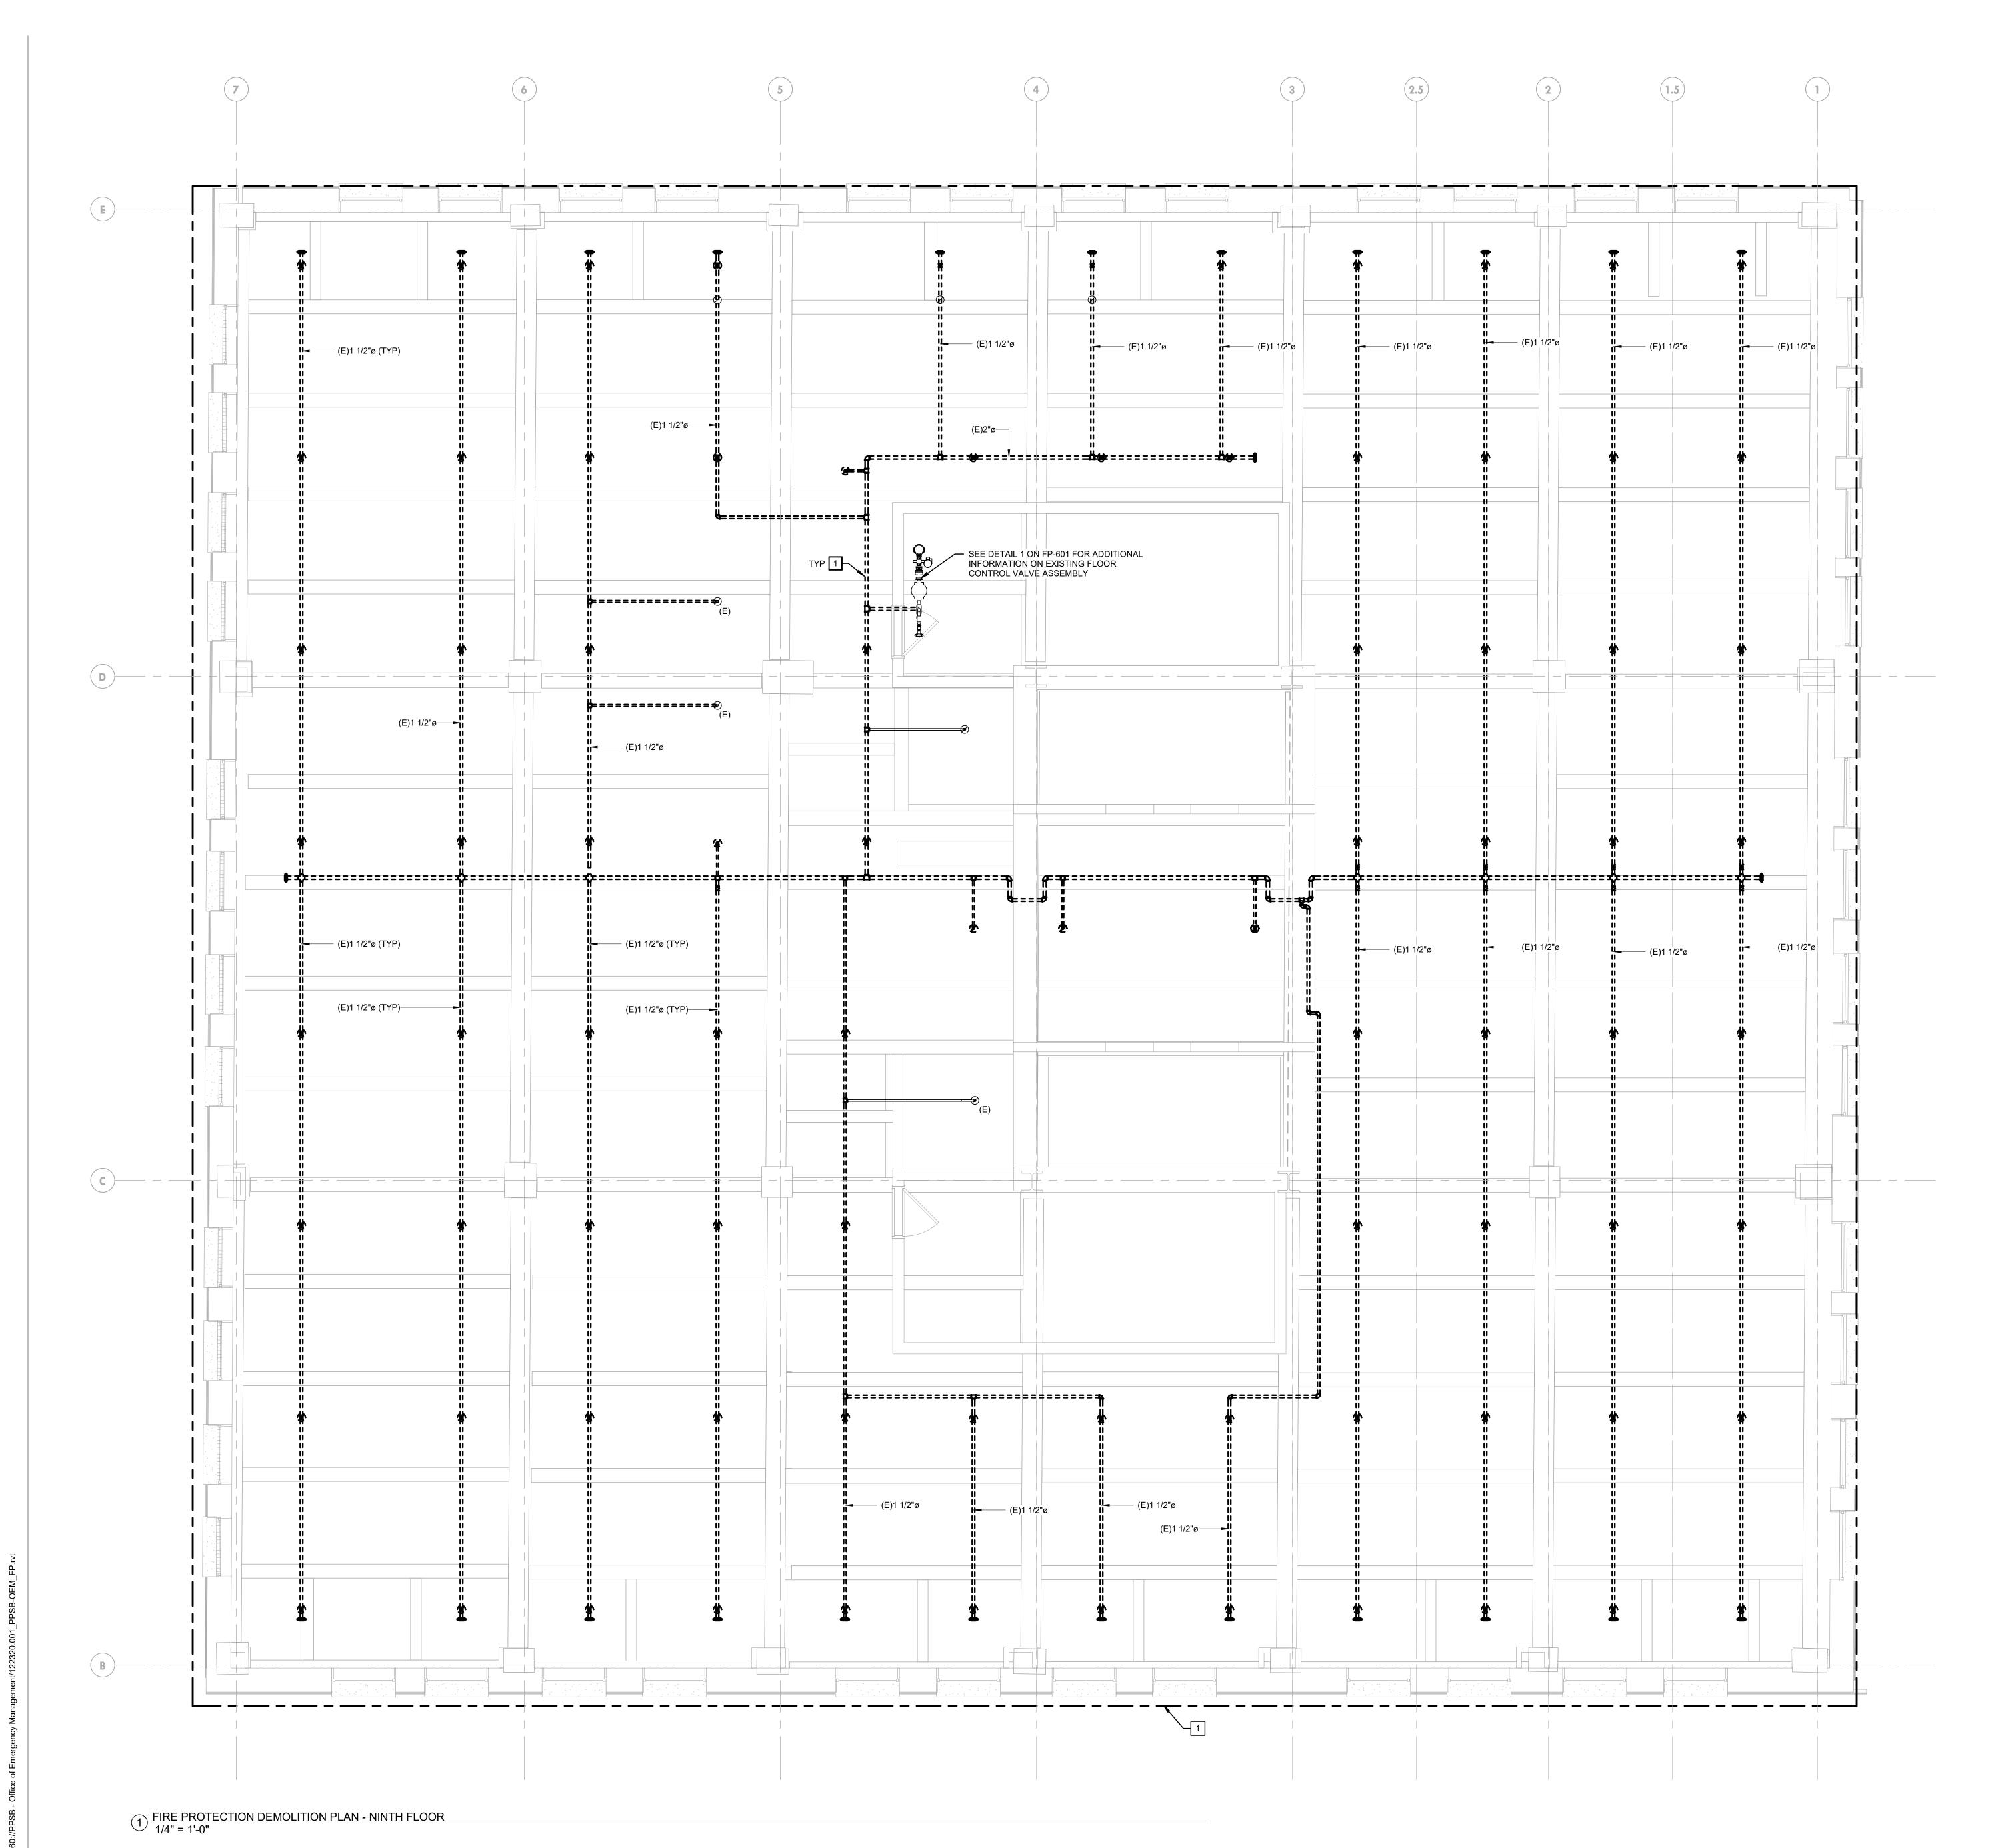

- 1. REFER TO FP-001 FOR GENERAL NOTES, SYMBOLS, AND ABBREVIATIONS.
 - 2. EXISTING FITTINGS AND ARMOVER/RISER NIPPLE PIPING SHALL BE REMOVED BACK TO THE NEAREST BRANCHLINE OR MAIN PIPE FITTING TO REMAIN.
- 3. ALL SPRINKLER HEADS WITHIN FINISHED CEILINGS ARE TO BE NEW WHITE CONCEALED PENDENT TYPE SPRINKLER HEADS, UNLESS OTHERWISE NOTED. ALL NEW SPRINKLER HEADS SHALL BE LOCATED IN THE CENTER OF TILE AND COORDINATED WITH LIGHTS, DIFFUSERS AND ANY ARCHITECTURAL CEILING ELEMENTS.
- 4. FIRE SPRINKLER PIPING AND SPRINKLERS SHALL NOT BE ROUTED OR LOCATED OVER ELECTRICAL EQUIPMENT AND RACKS, TO PREVENT DAMAGE CAUSED BY POTENTIAL LEAKS.

KEYED NOTES:

DASHED PIPING AND FITTINGS SHALL BE DISCONNECTED FROM SYSTEM AND RAISED UP DURING CONSTRUCTION TO ACCOMODATE NEW CEILING SYSTEMS. DASHED SPRIGS, DROPS, AND SPRINKLERS SHALL BE REMOVED.




IEI GROUP, LTD.

428 North 2nd Street Philadelphia, PA 19123 Telephone: 215.413.3700

CONSULTANTS:

Arora Engineers, Inc. 61 Wilmington-West Chester Pike Chadds Ford, PA 19317 P (610) 459-7900 F (610) 459-7950 aroraengineers.com

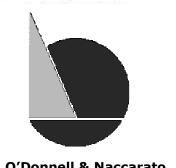

<u>O'Donnell & Naccarato</u> 701 Market Street, Suite 6000 Philadelphia, PA 19106 PH: 215.925.3788 www.o-n.com

EFFECTIVE ONLY AS TO THAT VERSION OF THIS DOCUMENT AS ORIGINALLY PUBLISHED BY DESIGN PROFESSIONAL. DESIGN PROFESSIONAL IS NOT RESPONSIBLE FOR ANY SUBSEQUENT MODIFICATION, CORRUPTION, OR UNAUTHORIZED USE OF SUCH DOCUMENT. TO VERIFY THE VALIDITY OR ADDITIONAL DESIGN PROFESSIONAL SUBSEQUENT MODIFICATION, CORRUPTION, OR UNAUTHORIZED USE OF SUCH DOCUMENT. TO VERIFY THE VALIDITY OR APPLICABILITY OF THE SEAL OR SIGNATURE, CONTACT DESIGN PROFESSIONAL.

- ☐ PROGRESS SET
- ☐ CLIENT REVIEW ■ BID SET
- ☐ CODE REVIEW SET ☐ ISSUED FOR CONSTRUCTION

ISSUED FOR 9/18/20


(NOT FOR CONSTRUCTION) ISSUES/REVISIONS:

1 2020-09-18 ISSUED FOR BIDS PROJECT NUMBER: SCALE:

DATE: DRAWN BY: CHECKED BY:

DRAWING TITLE: FIRE PROTECTION 9TH FLOOR DEMO PLAN


FPD-109

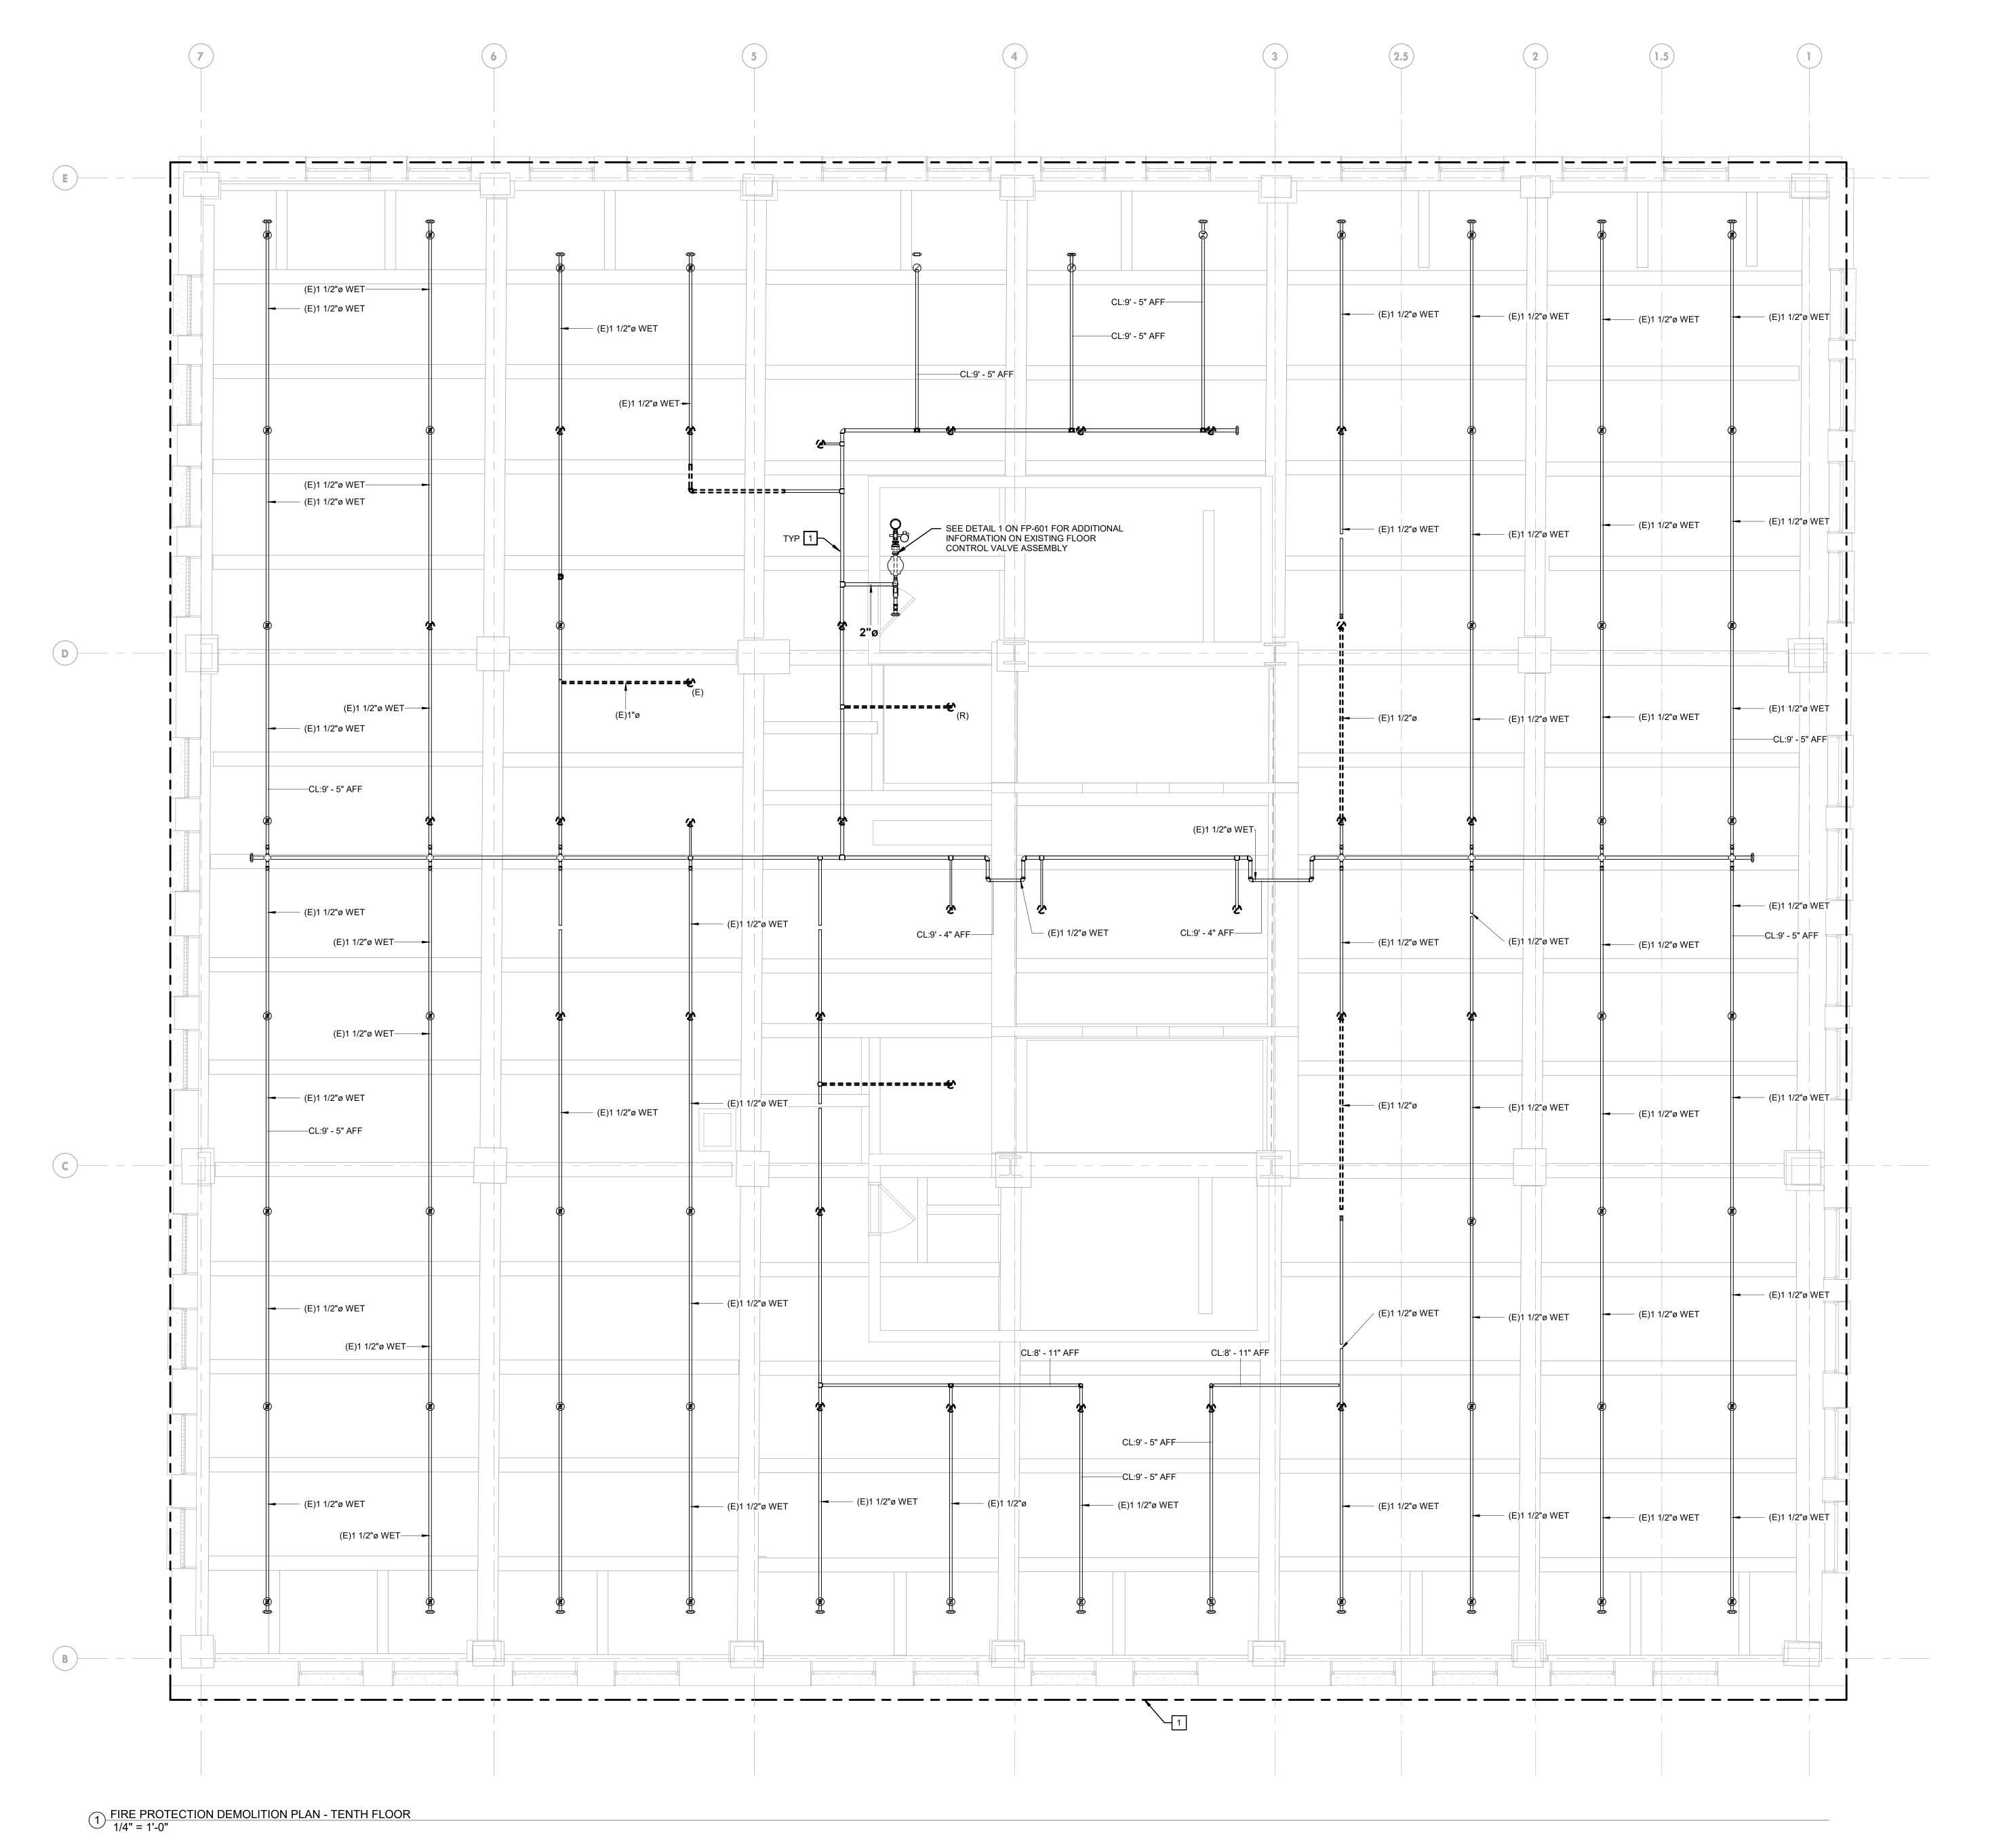

- 1. REFER TO FP-001 FOR GENERAL NOTES, SYMBOLS, AND ABBREVIATIONS.
- 2. EXISTING FITTINGS AND ARMOVER/RISER NIPPLE PIPING SHALL BE REMOVED BACK TO THE NEAREST BRANCHLINE OR MAIN PIPE FITTING TO REMAIN.
- 3. ALL SPRINKLER HEADS WITHIN FINISHED CEILINGS ARE TO BE NEW WHITE CONCEALED PENDENT TYPE SPRINKLER HEADS, UNLESS OTHERWISE NOTED. ALL NEW SPRINKLER HEADS SHALL BE LOCATED IN THE CENTER OF TILE AND COORDINATED WITH LIGHTS, DIFFUSERS AND ANY ARCHITECTURAL CEILING ELEMENTS.
- FIRE SPRINKLER PIPING AND SPRINKLERS SHALL NOT BE ROUTED OR LOCATED OVER ELECTRICAL EQUIPMENT AND RACKS, TO PREVENT DAMAGE CAUSED BY POTENTIAL LEAKS.

KEYED NOTES:

DASHED PIPING AND FITTINGS SHALL BE DISCONNECTED FROM SYSTEM AND RAISED UP DURING CONSTRUCTION TO ACCOMODATE NEW CEILING SYSTEMS. DASHED SPRIGS, DROPS, AND SPRINKLERS SHALL BE REMOVED.

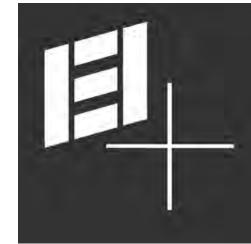

IEI GROUP, LTD.
IEI ARCHITECTS, I
428 North 2nd Street

Philadelphia, PA 19123
Telephone: 215.413.3700

CONSULTANTS:

ARORA*

Arora Engineers, Inc.
61 Wilmington-West Chester Pike
Chadds Ford, PA 19317
P (610) 459-7900
F (610) 459-7950
aroraengineers.com



01 Market Street, Suite 6000 Philadelphia, PA 19106 PH: 215.925.3788 www.o-n.com



DESIGN PROFESSIONAL'S ELECTRONIC OR DIGITAL SEAL OR SIGNATURE IS EFFECTIVE ONLY AS TO THAT VERSION OF THIS DOCUMENT AS ORIGINALLY PUBLISHED BY DESIGN PROFESSIONAL. DESIGN PROFESSIONAL IS NOT RESPONSIBLE FOR ANY SUBSEQUENT MODIFICATION, CORRUPTION, OR UNAUTHORIZED USE OF SUCH DOCUMENT. TO VERIFY THE VALIDITY OR APPLICABILITY OF THE SEAL OR SIGNATURE, CONTACT DESIGN PROFESSIONAL.

THE CITY OF PHILADELPHIA
OFFICE OF EMEGENCY MANAGEMENT
PHILADELPHIA PUBLIC SERVICES BUILDING
400 NORTH BROAD STREET, PHILADELPHIA, PA
FLOORS 8, 9 AND 10

- □ PROGRESS SET□ CLIENT REVIEW
- □ CLIENT REVIEW■ BID SET
- ☐ CODE REVIEW SET☐ ISSUED FOR CONSTRUCTION

ISSUED FOR BIDS 9/18/20

(NOT FOR CONSTRUCTION)

ISSUES/REVISIONS:

1 2020-09-18 ISSUED FOR BIDS

PROJECT NUMBER: 304103-120 PROJECT NUMBER: 304103-120 PROJECT NUMBER: As indicated a part of the project of the

FIRE PROTECTION
10TH FLOOR DEMO
PLAN

FPD-110

- 1. REFER TO FP-001 FOR GENERAL NOTES, SYMBOLS, AND ABBREVIATIONS.
 - 2. EXISTING FITTINGS AND ARMOVER/RISER NIPPLE PIPING SHALL BE REMOVED BACK TO THE NEAREST BRANCHLINE OR MAIN PIPE FITTING TO REMAIN.
- 3. ALL SPRINKLER HEADS WITHIN FINISHED CEILINGS ARE TO BE NEW WHITE CONCEALED PENDENT TYPE SPRINKLER HEADS, UNLESS OTHERWISE NOTED. ALL NEW SPRINKLER HEADS SHALL BE LOCATED IN THE CENTER OF TILE AND COORDINATED WITH LIGHTS, DIFFUSERS AND ANY ARCHITECTURAL CEILING ELEMENTS.
- FIRE SPRINKLER PIPING AND SPRINKLERS SHALL NOT BE ROUTED OR LOCATED OVER ELECTRICAL EQUIPMENT AND RACKS, TO PREVENT DAMAGE CAUSED BY POTENTIAL LEAKS.




IEI GROUP, LTD. IEI ARCHITECTS, INC.

428 North 2nd Street Philadelphia, PA 19123 Telephone: 215.413.3700


CONSULTANTS:

Arora Engineers, Inc. 61 Wilmington-West Chester Pike Chadds Ford, PA 19317 P (610) 459-7900

F (610) 459-7950

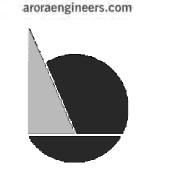

<u>O'Donnell & Naccarato</u> 701 Market Street, Suite 6000 Philadelphia, PA 19106 PH: 215.925.3788 www.o-n.com

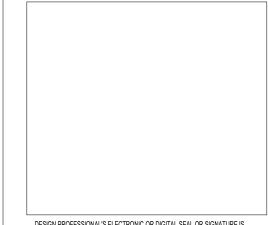

EFFECTIVE ONLY AS TO THAT VERSION OF THIS DECLINENT AS ORIGINALLY PUBLISHED BY DESIGN PROFESSIONAL. DESIGN PROFESSIONAL IS NOT RESPONSIBLE FOR ANY SUBSEQUENT MODIFICATION, CORRUPTION, OR UNAUTHORIZED USE OF SUCH DOCUMENT. TO VERIEY THE VALIDITY OF A DRICE ADDITION.

APPLICABILITY OF THE SEAL OR SIGNATURE, CONTACT DESIGN PROFESSIONAL.

☐ PROGRESS SET

☐ CLIENT REVIEW ■ BID SET

☐ CODE REVIEW SET ☐ ISSUED FOR CONSTRUCTION

9/18/20

(NOT FOR CONSTRUCTION) ISSUES/REVISIONS:

1 2020-09-18 ISSUED FOR BIDS

PROJECT NUMBER: SCALE: DRAWN BY:

DRAWING TITLE: FIRE PROTECTION 11TH FLOOR DEMO PLAN

FPD-111

1/4" = 1'-0"

GENERAL NOTES:

- 1. REFER TO FP-001 FOR GENERAL NOTES, SYMBOLS, AND ABBREVIATIONS.
- 2. EXISTING FITTINGS AND ARMOVER/RISER NIPPLE PIPING SHALL BE REMOVED BACK TO THE NEAREST BRANCHLINE OR MAIN PIPE FITTING TO REMAIN.
- 3. ALL SPRINKLER HEADS WITHIN FINISHED CEILINGS ARE TO BE NEW WHITE CONCEALED PENDENT TYPE SPRINKLER HEADS, UNLESS OTHERWISE NOTED. ALL NEW SPRINKLER HEADS SHALL BE LOCATED IN THE CENTER OF TILE AND COORDINATED WITH LIGHTS, DIFFUSERS AND ANY ARCHITECTURAL CEILING ELEMENTS.
- 4. FIRE SPRINKLER PIPING AND SPRINKLERS SHALL NOT BE ROUTED OR LOCATED OVER ELECTRICAL EQUIPMENT AND RACKS, TO PREVENT DAMAGE CAUSED BY POTENTIAL LEAKS.

KEYED NOTES:

- 1 SEAL PENETRATION IN SMOKE PARTITION.
- 2 PROVIDE NEW PENETRATION THROUGH FIRE RATED PARTITION FOR RAISED SPRINKLER MAIN.
- MODIFY 2" SPRINKLER MAIN, AND ASSOCIATED BRANCH LINES FROM THIS POINT TO ACCOMMODATE NEW ARCHITECTURAL LAYOUT. 4 ELEVATOR LOBBY PIPING SHALL BE RISEN TO ACCOMMODATE NEW GYPSUM CEILING.
- 5 PROVIDE NEW EXTENDED COVERAGE CONCEALED PENDENT TYPE SPRINKLER HEAD.
- 6 PROVIDE SPRINKLER HEAD GUARD PROTECTION.



IEI GROUP, LTD. IEI ARCHITECTS, INC.

428 North 2nd Street Philadelphia, PA 19123 Telephone: 215.413.3700

CONSULTANTS:

Arora Engineers, Inc. 61 Wilmington-West Chester Pike Chadds Ford, PA 19317 P (610) 459-7900 F (610) 459-7950

aroraengineers.com



O'Donnell & Naccarato 701 Market Street, Suite 6000 Philadelphia, PA 19106 PH: 215.925.3788 www.o-n.com

DESIGN FROPESSIONAL SELECTIONS OF THIS DOCUMENT AS ORIGINALLY
PUBLISHED BY DESIGN PROFESSIONAL. DESIGN PROFESSIONAL IS NOT
RESPONSIBLE FOR ANY SUBSEQUENT MODIFICATION, CORRUPTION, OR
UNAUTHORIZED USE OF SUCH DOCUMENT. TO VERIEY THE VALIDITY OR

- ☐ PROGRESS SET
- ☐ CLIENT REVIEW ■ BID SET
- ☐ CODE REVIEW SET ☐ ISSUED FOR CONSTRUCTION

ISSUED FOR 9/18/20

(NOT FOR CONSTRUCTION) ISSUES/REVISIONS:

1 2020-09-18 ISSUED FOR BIDS PROJECT NUMBER:


SCALE: DATE: DRAWN BY: CHECKED BY:

DRAWING TITLE: FIRE PROTECTION 8TH FLOOR NEW WORK PLAN

FP-108

PRINTED ON:

2020-09-21 12:28:54

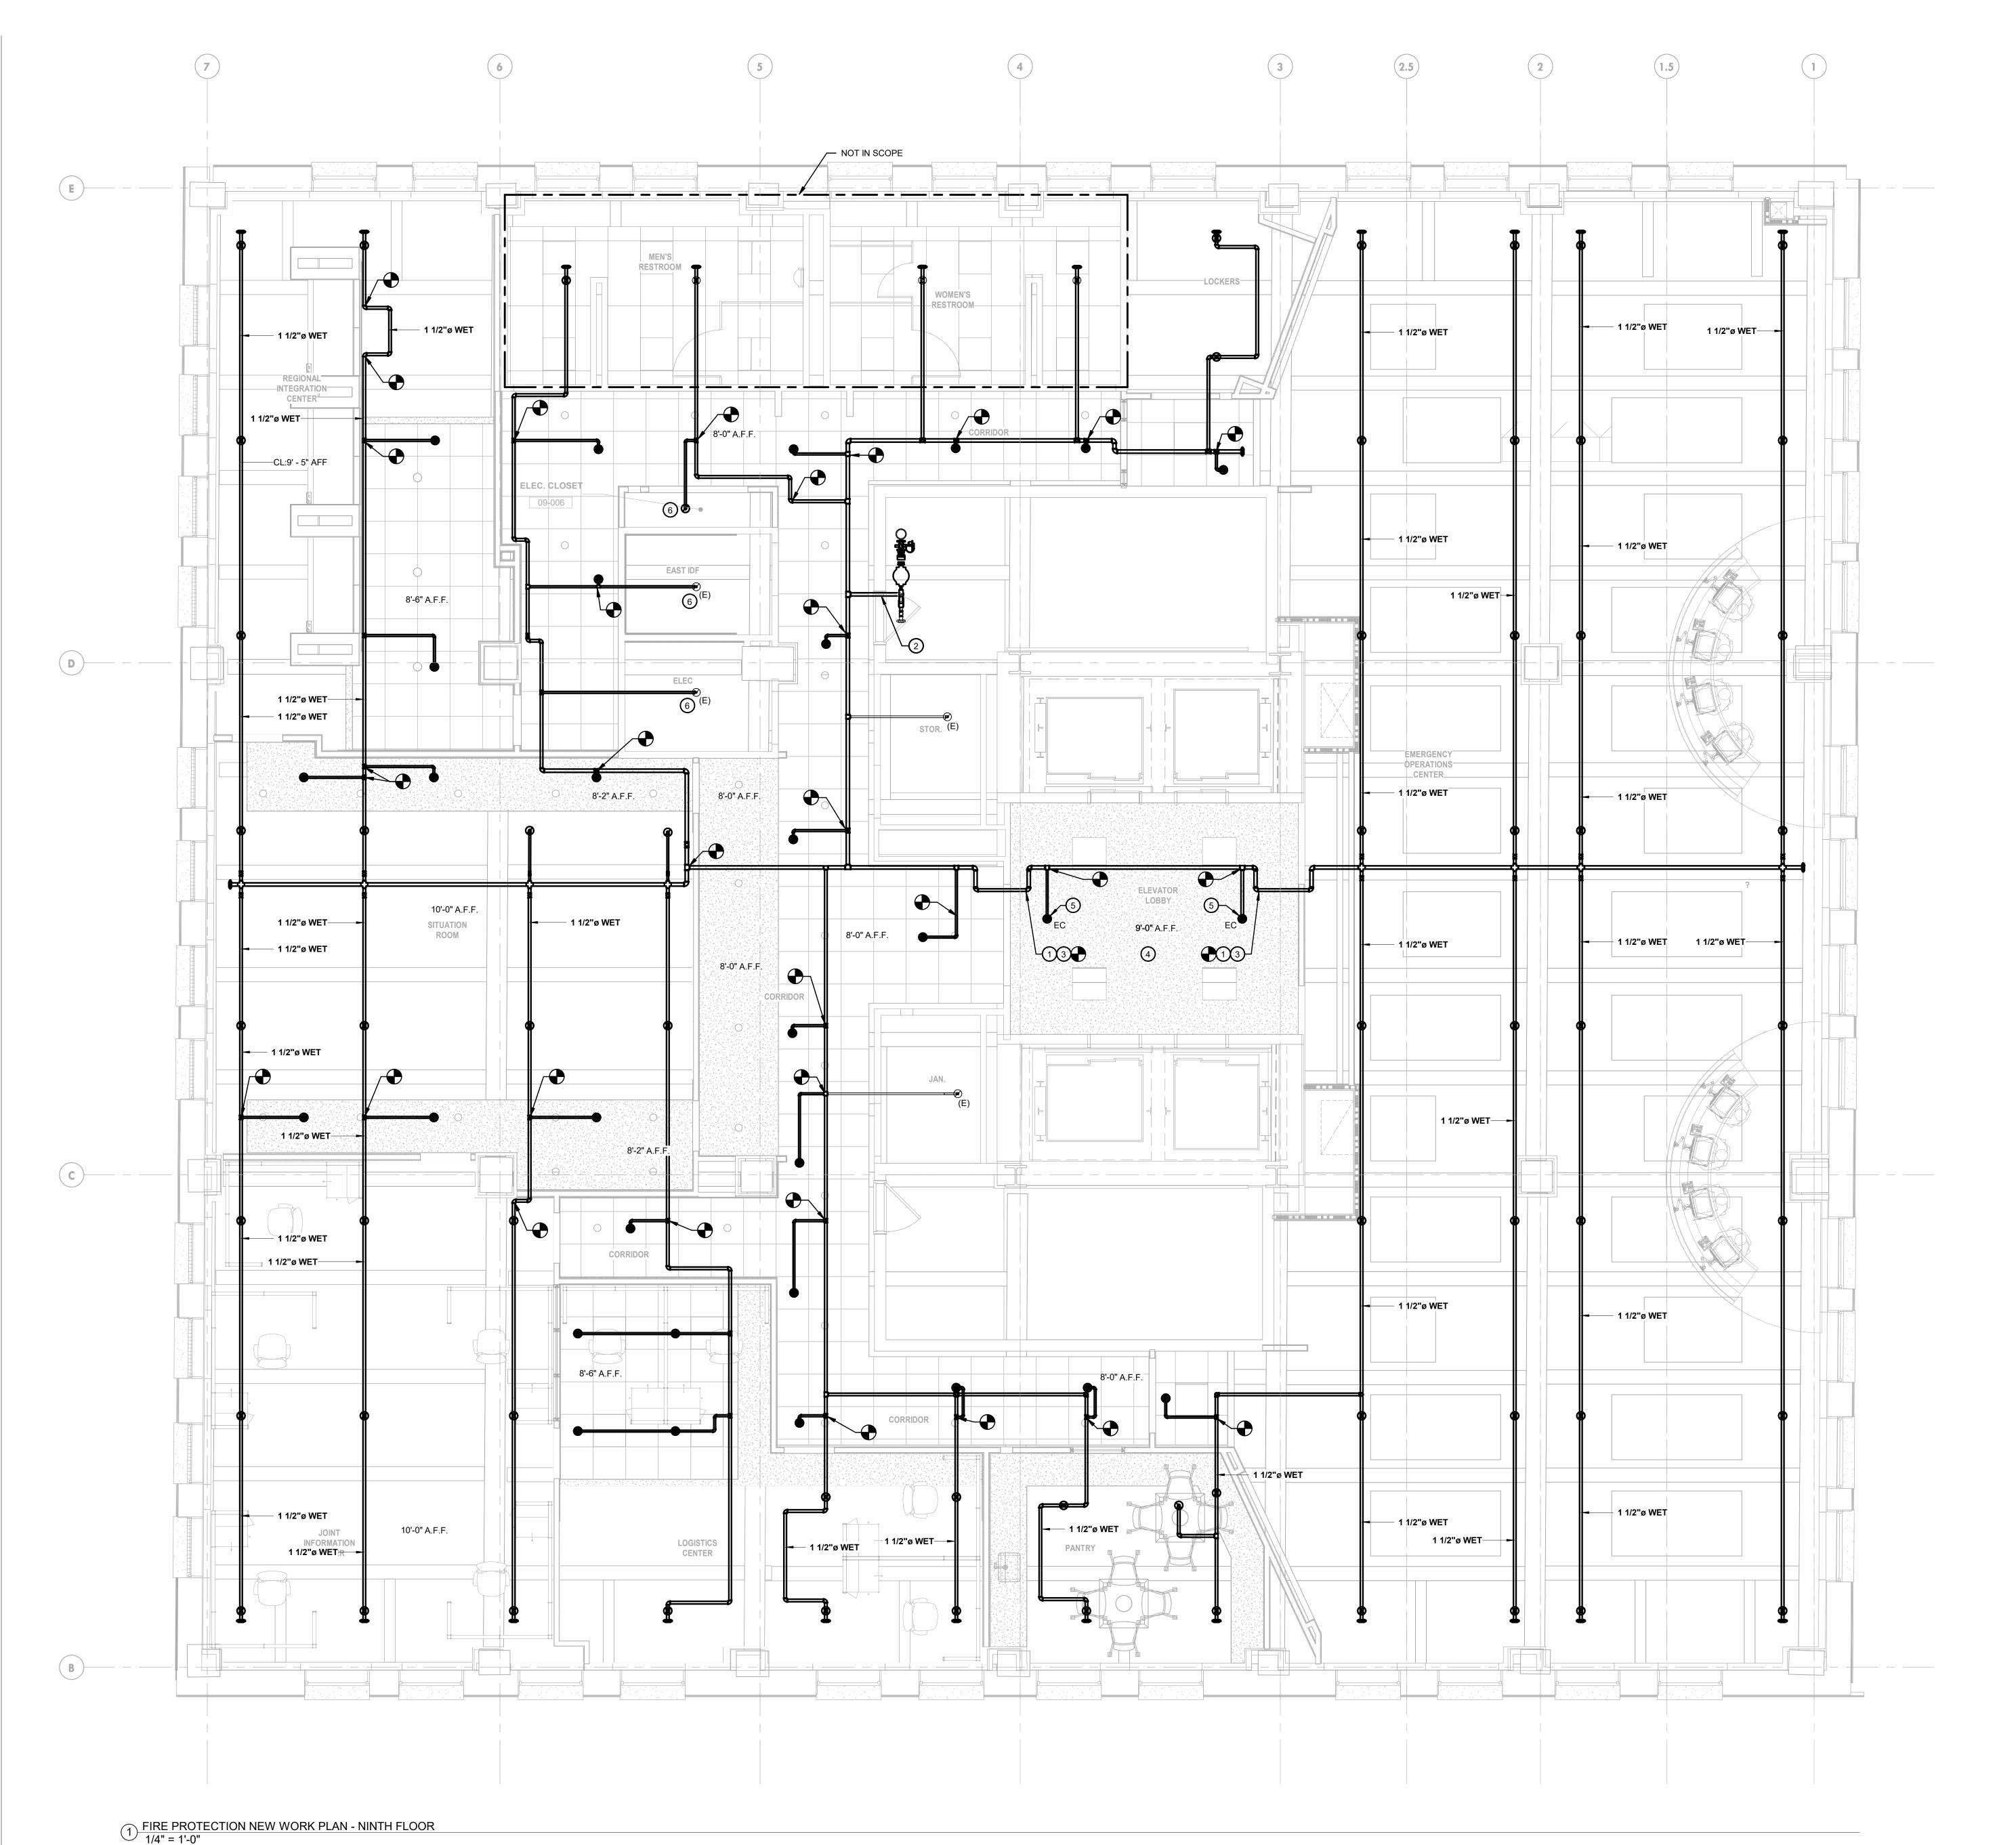

- 1. REFER TO FP-001 FOR GENERAL NOTES, SYMBOLS, AND ABBREVIATIONS.
- 2. EXISTING FITTINGS AND ARMOVER/RISER NIPPLE PIPING SHALL BE REMOVED BACK TO THE NEAREST BRANCHLINE OR MAIN PIPE FITTING TO REMAIN.
- 3. ALL SPRINKLER HEADS WITHIN FINISHED CEILINGS ARE TO BE NEW WHITE CONCEALED PENDENT TYPE SPRINKLER HEADS, UNLESS OTHERWISE NOTED. ALL NEW SPRINKLER HEADS SHALL BE LOCATED IN THE CENTER OF TILE AND COORDINATED WITH LIGHTS, DIFFUSERS AND ANY ARCHITECTURAL CEILING ELEMENTS.
- FIRE SPRINKLER PIPING AND SPRINKLERS SHALL NOT BE ROUTED OR LOCATED OVER ELECTRICAL EQUIPMENT AND RACKS, TO PREVENT DAMAGE CAUSED BY POTENTIAL LEAKS.

KEYED NOTES:

- 1) SEAL PENETRATION IN SMOKE PARTITION.
- 2 PROVIDE NEW PENETRATION THROUGH FIRE RATED PARTITION FOR RAISED SPRINKLER MAIN.
- MODIFY 2" SPRINKLER MAIN, AND ASSOCIATED BRANCH LINES FROM THIS POINT TO ACCOMODATE NEW ARCHITECTUREAL LAYOUT.
- 4 ELEVATOR LOBBY PIPING SHALL BE RISEN TO ACCOMADATE NEW GYPSUM CEILING.
- 5 PROVIDE NEW EXTENDED COVERAGE CONCEALED PENDENT TYPE SPRINKLER HEAD.
- 6 PROVIDE SPRINKLER HEAD GUARD PROTECTION.




IEI GROUP, LTD.
IEI ARCHITECTS, INC.
428 North 2nd Street

428 North 2nd Street Philadelphia, PA 19123 Telephone: 215.413.3700

CONSULTANTS:

ARORA

Arora Engineers, Inc.
61 Wilmington-West Chester Pike
Chadds Ford, PA 19317
P (610) 459-7900
F (610) 459-7950
aroraengineers.com

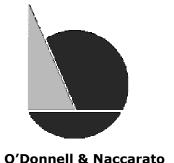

O'Donnell & Naccarato
701 Market Street, Suite 6000
Philadelphia, PA 19106
PH: 215.925.3788
www.o-n.com

N PROFESSIONAL'S ELECTRONIC OR DIGITAL SEAL OR SIGNATURE IS TIVE ONLY AS TO THAT VERSION OF THIS DOCUMENT AS ORIGINALLY SHED BY DESIGN PROFESSIONAL. DESIGN PROFESSIONAL IS NOT

DESIGN PROFESSIONAL'S ELECTRONIC OR DIGITAL SEAL OR SIGNATURE IS EFFECTIVE ONLY AS TO THAT VERSION OF THIS DOCUMENT AS ORIGINALLY PUBLISHED BY DESIGN PROFESSIONAL. DESIGN PROFESSIONAL IS NOT RESPONSIBLE FOR ANY SUBSEQUENT MODIFICATION, CORRUPTION, OR UNAUTHORIZED USE OF SUCH DOCUMENT. TO VERIFY THE VALIDITY OR APPLICABILITY OF THE SEAL OR SIGNATURE, CONTACT DESIGN PROFESSIONAL

E CITY OF PHILADELPHIA
FICE OF EMEGENCY MANAGEMENT
LADELPHIA PUBLIC SERVICES BUILDING
NORTH BROAD STREET, PHILADELPHIA, PA 19
ORS 8, 9 AND 10

- □ PROGRESS SET□ CLIENT REVIEW
- □ CLIENT REVIEW■ BID SET
- ☐ CODE REVIEW SET☐ ISSUED FOR CONSTRUCTION

ISSUED FOR BIDS 9/18/20

(NOT FOR CONSTRUCTION)


ISSUES/REVISIONS:

1 2020-09-18 ISSUED FOR BIDS

PROJECT NUMBER: 304103-120
SCALE: As indicated and the second of the sec

FIRE PROTECTION
9TH FLOOR NEW
WORK PLAN

FP-109

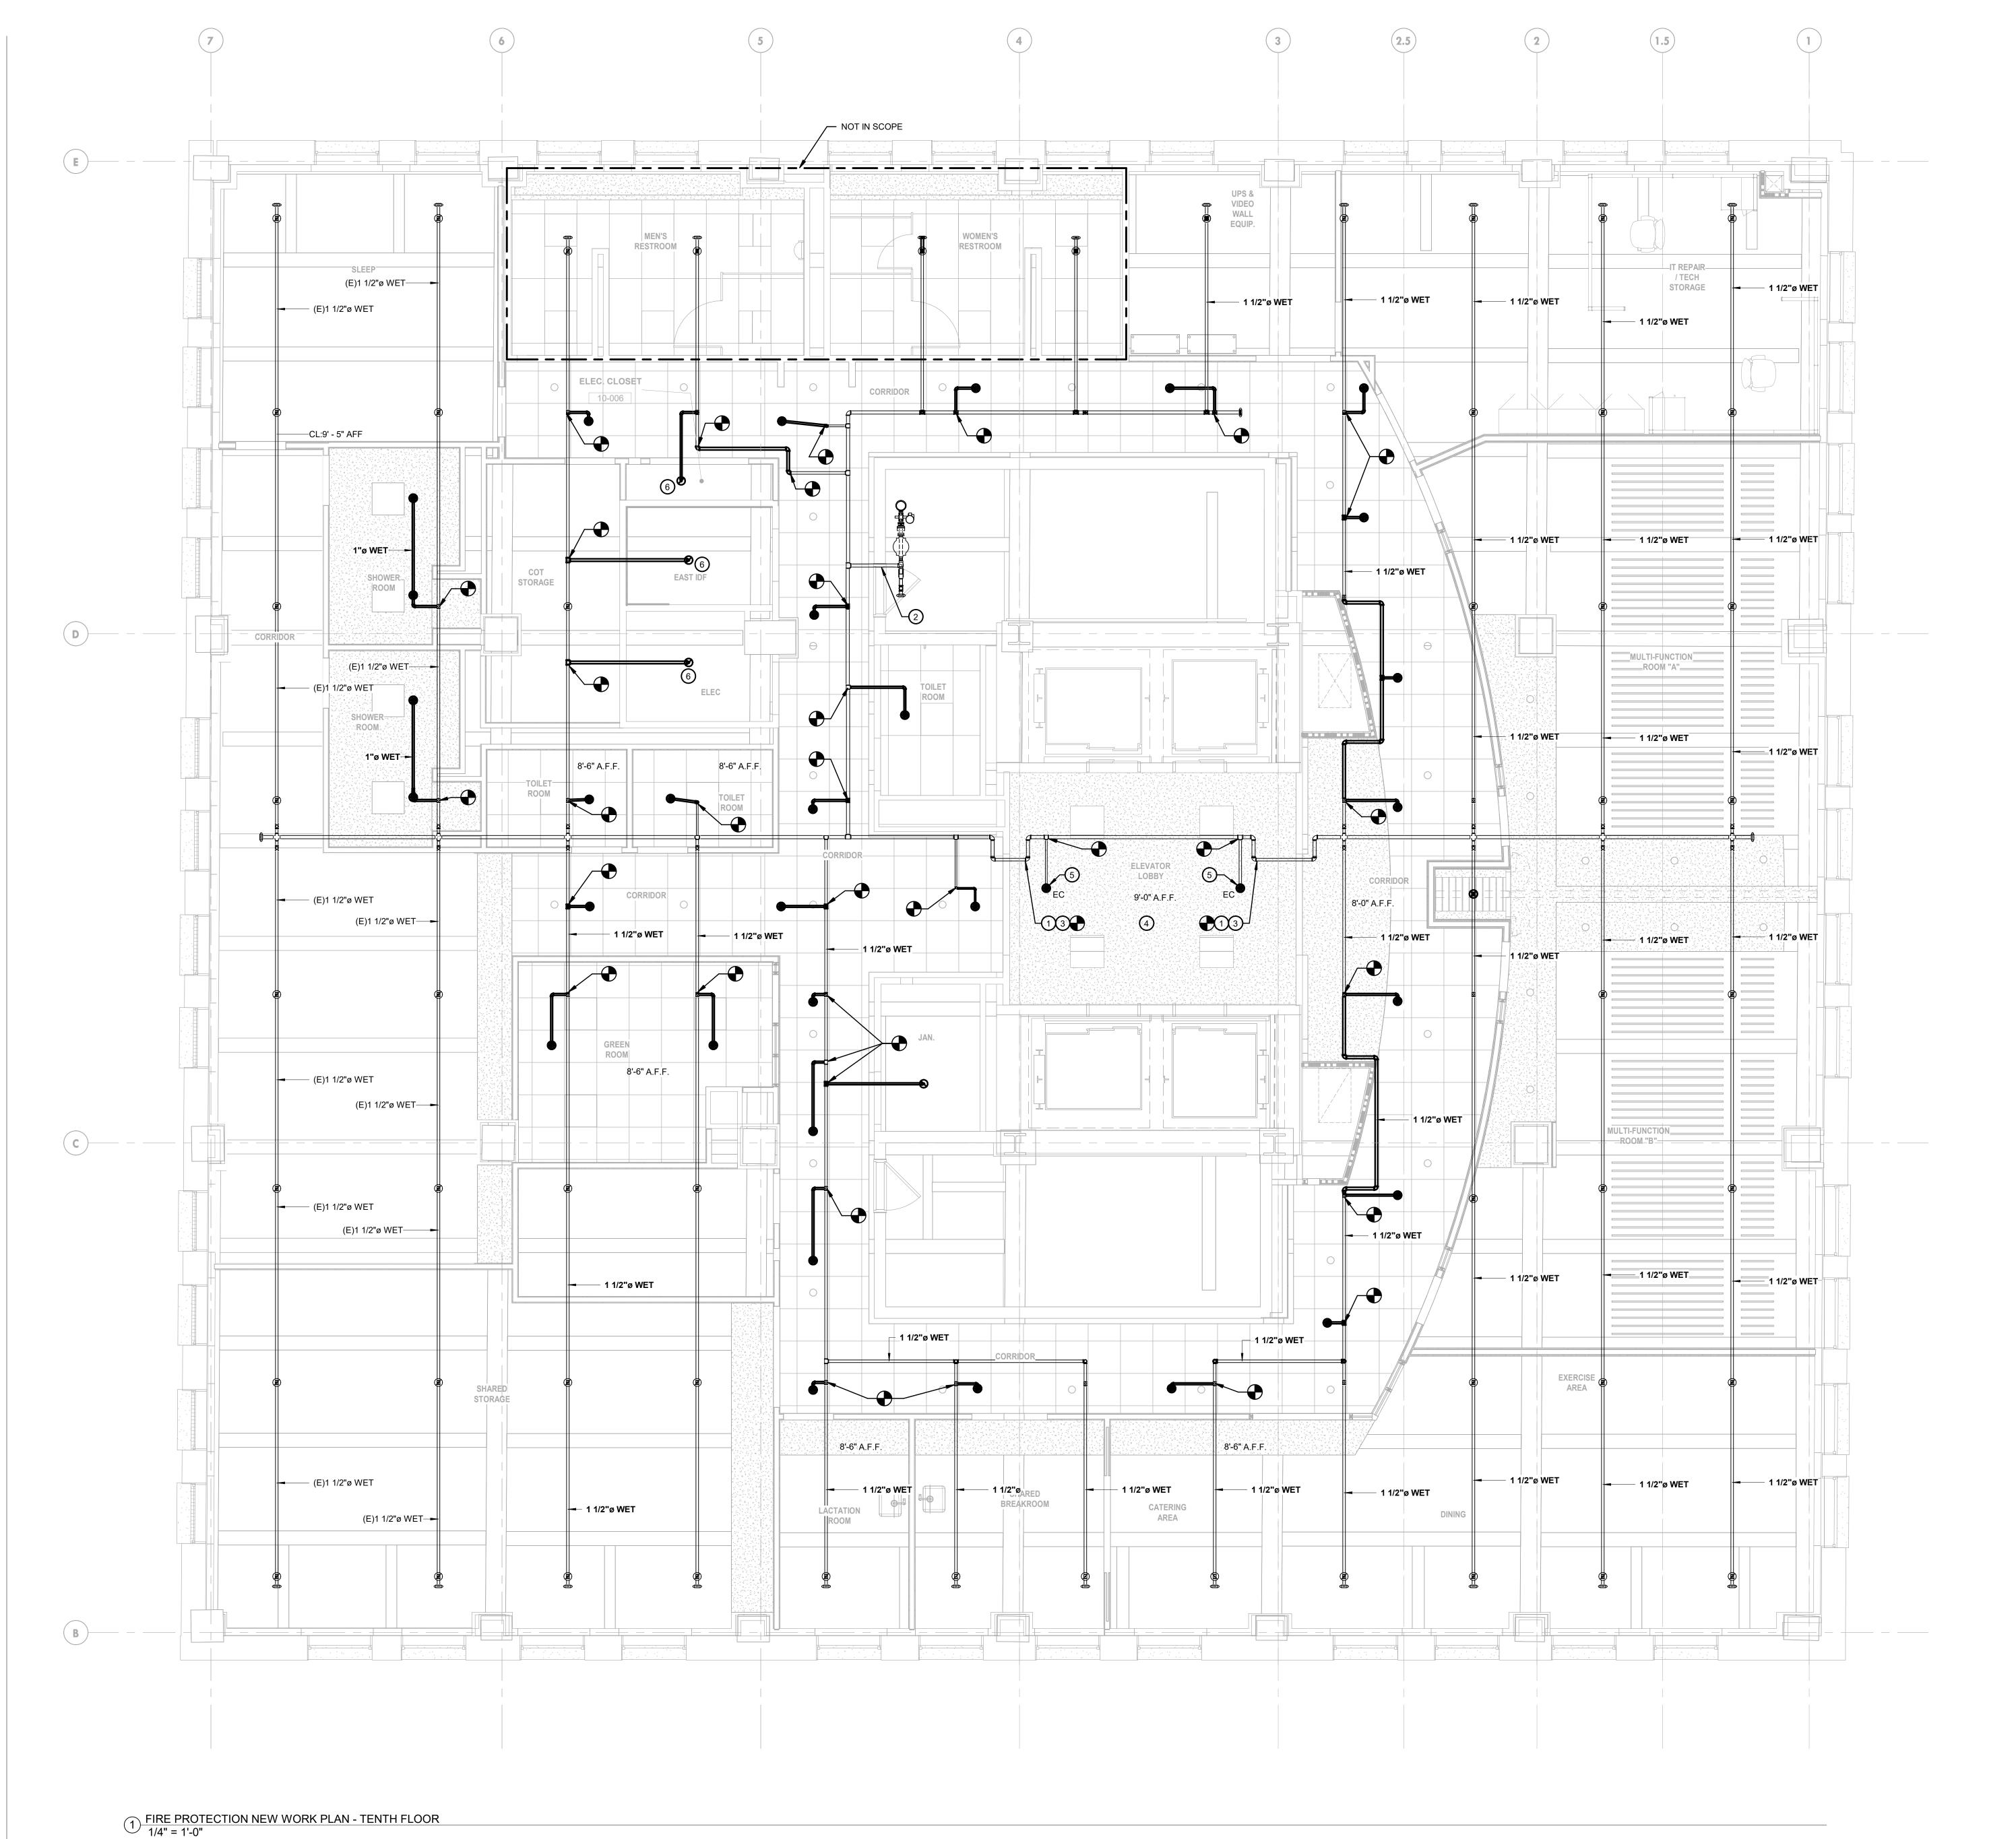

- 1. REFER TO FP-001 FOR GENERAL NOTES, SYMBOLS, AND ABBREVIATIONS.
- 2. EXISTING FITTINGS AND ARMOVER/RISER NIPPLE PIPING SHALL BE REMOVED BACK TO THE NEAREST BRANCHLINE OR MAIN PIPE FITTING TO REMAIN.
- 3. ALL SPRINKLER HEADS WITHIN FINISHED CEILINGS ARE TO BE NEW WHITE CONCEALED PENDENT TYPE SPRINKLER HEADS, UNLESS OTHERWISE NOTED. ALL NEW SPRINKLER HEADS SHALL BE LOCATED IN THE CENTER OF TILE AND COORDINATED WITH LIGHTS, DIFFUSERS AND ANY ARCHITECTURAL CEILING ELEMENTS.
- 4. FIRE SPRINKLER PIPING AND SPRINKLERS SHALL NOT BE ROUTED OR LOCATED OVER ELECTRICAL EQUIPMENT AND RACKS, TO PREVENT DAMAGE CAUSED BY POTENTIAL LEAKS.

KEYED NOTES:

- 1 SEAL PENETRATION IN SMOKE PARTITION.
- 2 PROVIDE NEW PENETRATION THROUGH FIRE RATED PARTITION FOR RAISED SPRINKLER MAIN.
- MODIFY 2" SPRINKLER MAIN, AND ASSOCIATED BRANCH LINES FROM THIS POINT TO ACCOMODATE NEW ARCHITECTUREAL LAYOUT.
- 4 ELEVATOR LOBBY PIPING SHALL BE RISEN TO ACCOMADATE NEW GYPSUM CEILING.
- 5 PROVIDE NEW EXTENDED COVERAGE CONCEALED PENDENT TYPE SPRINKLER HEAD.
- 6 PROVIDE SPRINKLER HEAD GUARD PROTECTION.




IEI GROUP, LTD. IEI ARCHITECTS, INC.

428 North 2nd Street Philadelphia, PA 19123 Telephone: 215.413.3700

CONSULTANTS:

Arora Engineers, Inc. 61 Wilmington-West Chester Pike Chadds Ford, PA 19317 P (610) 459-7900 F (610) 459-7950 aroraengineers.com

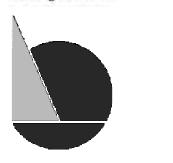

O'Donnell & Naccarato 701 Market Street, Suite 6000 Philadelphia, PA 19106 PH: 215.925.3788 www.o-n.com

DESIGN FRO/ESSIONAL SELECT ROUNC OR DIGITAL SEAL OF SIGNATURE DE-EFFECTIVE ONLY AS TO THAT VERSION OF THIS DOCUMENT AS ORIGINALLY PUBLISHED BY DESIGN PROFESSIONAL DESIGN PROFESSIONAL IS NOT RESPONSIBLE FOR ANY SUBSEQUENT MODIFICATION, CORRUPTION, OR UNAUTHORIZED USE OF SUCH DOCUMENT. TO VERIFY THE VALIDITY OR UNAUTHORIZED USE OF SUCH DOCUMENT. TO VERIFY THE VALIDITY OR APPLICABILITY OF THE SEAL OR SIGNATURE, CONTACT DESIGN PROFESSIONAL.

- ☐ PROGRESS SET
- ☐ CLIENT REVIEW ■ BID SET
- ☐ CODE REVIEW SET ☐ ISSUED FOR CONSTRUCTION

ISSUED FOR 9/18/20

ISSUES/REVISIONS:

(NOT FOR CONSTRUCTION)

1 2020-09-18 ISSUED FOR BIDS


PROJECT NUMBER: SCALE: DATE: DRAWN BY: CHECKED BY:

DRAWING TITLE: FIRE PROTECTION 10TH FLOOR NEW WORK PLAN

FP-110

PRINTED ON:

2020-09-21 12:29:31

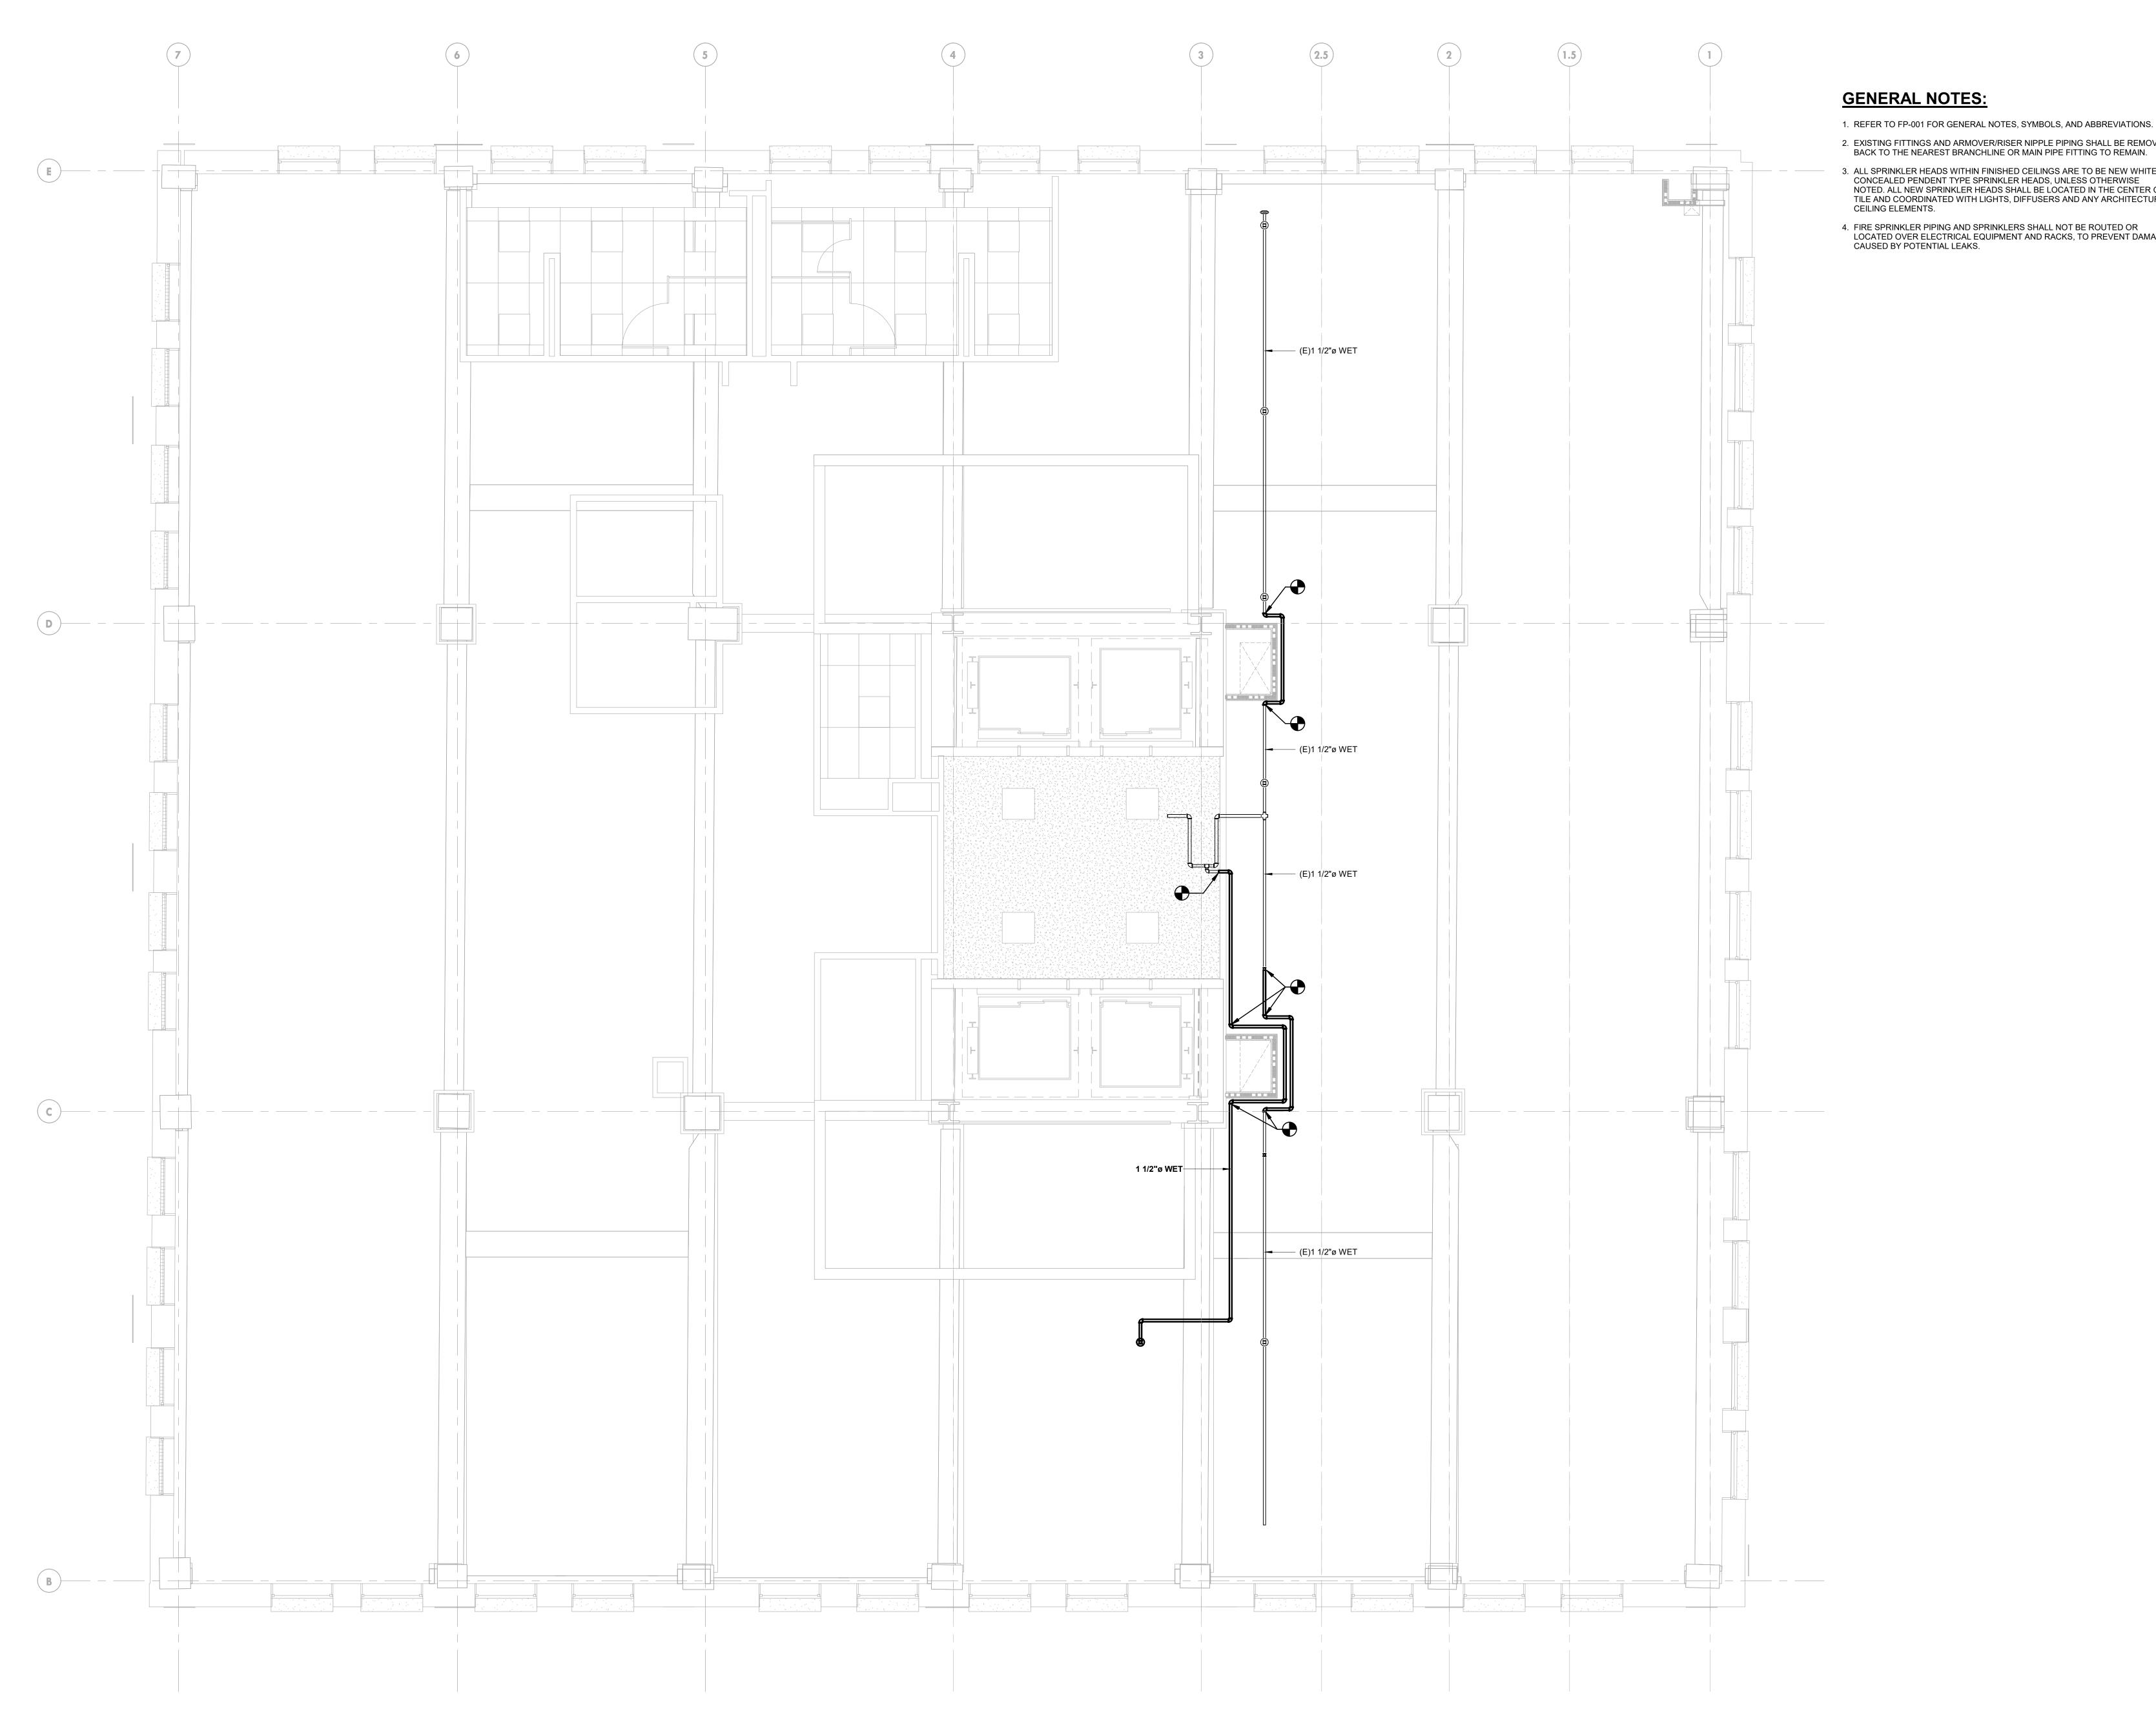

1) FIRE PROTECTION NEW WORK PLAN - ELEVENTH FLOOR 1/4" = 1'-0"

GENERAL NOTES:

- 1. REFER TO FP-001 FOR GENERAL NOTES, SYMBOLS, AND ABBREVIATIONS. 2. EXISTING FITTINGS AND ARMOVER/RISER NIPPLE PIPING SHALL BE REMOVED
- 3. ALL SPRINKLER HEADS WITHIN FINISHED CEILINGS ARE TO BE NEW WHITE CONCEALED PENDENT TYPE SPRINKLER HEADS, UNLESS OTHERWISE NOTED. ALL NEW SPRINKLER HEADS SHALL BE LOCATED IN THE CENTER OF TILE AND COORDINATED WITH LIGHTS, DIFFUSERS AND ANY ARCHITECTURAL CEILING ELEMENTS.
- 4. FIRE SPRINKLER PIPING AND SPRINKLERS SHALL NOT BE ROUTED OR LOCATED OVER ELECTRICAL EQUIPMENT AND RACKS, TO PREVENT DAMAGE CAUSED BY POTENTIAL LEAKS.



IEI GROUP, LTD. IEI ARCHITECTS, INC.

428 North 2nd Street Philadelphia, PA 19123 Telephone: 215.413.3700

CONSULTANTS:

Arora Engineers, Inc. 61 Wilmington-West Chester Pike Chadds Ford, PA 19317 P (610) 459-7900 F (610) 459-7950 aroraengineers.com



<u>O'Donnell & Naccarato</u> 701 Market Street, Suite 6000 Philadelphia, PA 19106 PH: 215.925.3788 www.o-n.com

DESIGN PROFESSIONAL SELECT INVINIO OR DIGITAL SEAL OR SIGNATURE IS EFFECTIVE ONLY AS TO THAT VERSION OF THIS DOCUMENT AS ORIGINALLY PUBLISHED BY DESIGN PROFESSIONAL. DESIGN PROFESSIONAL IS NOT RESPONSIBLE FOR ANY SUBSEQUENT MODIFICATION, CORRUPTION, OR UNAUTHORIZED USE OF SUCH DOCUMENT. TO VERIFY THE VALIDITY OR

□ PROGRESS SET

☐ CLIENT REVIEW ■ BID SET

☐ CODE REVIEW SET ☐ ISSUED FOR CONSTRUCTION

> ISSUED FOR 9/18/20

(NOT FOR CONSTRUCTION)

ISSUES/REVISIONS: 1 2020-09-18 ISSUED FOR BIDS

PROJECT NUMBER: SCALE: DATE: DRAWN BY: CHECKED BY:

DRAWING TITLE: FIRE PROTECTION 11TH FLOOR NEW WORK PLAN

FP-111

2020-09-21 12:29:43 PRINTED ON:

IEI GROUP, LTD. IEI ARCHITECTS, INC. 428 North 2nd Street

Philadelphia, PA 19123 Telephone: 215.413.3700



Arora Engineers, Inc. 61 Wilmington-West Chester Pike Chadds Ford, PA 19317 P (610) 459-7900 F (610) 459-7950 aroraengineers.com



<u>O'Donnell & Naccarato</u> 701 Market Street, Suite 6000 Philadelphia, PA 19106 PH: 215.925.3788 www.o-n.com



DESIGN PROFESSIONAL'S ELECTRONIC OR DIGITAL SEAL OR SIGNATURE IS EFFECTIVE ONLY AS TO THAT VERSION OF THIS DOCUMENT AS ORIGINALLY PUBLISHED BY DESIGN PROFESSIONAL. DESIGN PROFESSIONAL IS NOT RESPONSIBLE FOR ANY SUBSEQUENT MODIFICATION, CORRUPTION, OR UNAUTHORIZED USE OF SUCH DOCUMENT. TO VERIFY THE VALIDITY OR APPLICABILITY OF THE SEAL OR SIGNATURE. CONTACT DESIGN PROFESSIONAL APPLICABILITY OF THE SEAL OR SIGNATURE, CONTACT DESIGN PROFESSIONAL.

☐ PROGRESS SET CLIENT REVIEW

■ BID SET ☐ CODE REVIEW SET

☐ ISSUED FOR CONSTRUCTION ISSUED FOR


> 9/18/20 (NOT FOR CONSTRUCTION)


ISSUES/REVISIONS: 1 2020-09-18 ISSUED FOR BIDS


PROJECT NUMBER: SCALE: 1/8" = 1'-0" DATE: DRAWN BY: CHECKED BY:


FIRE PROTECTION RISER DIAGRAM


FP-501

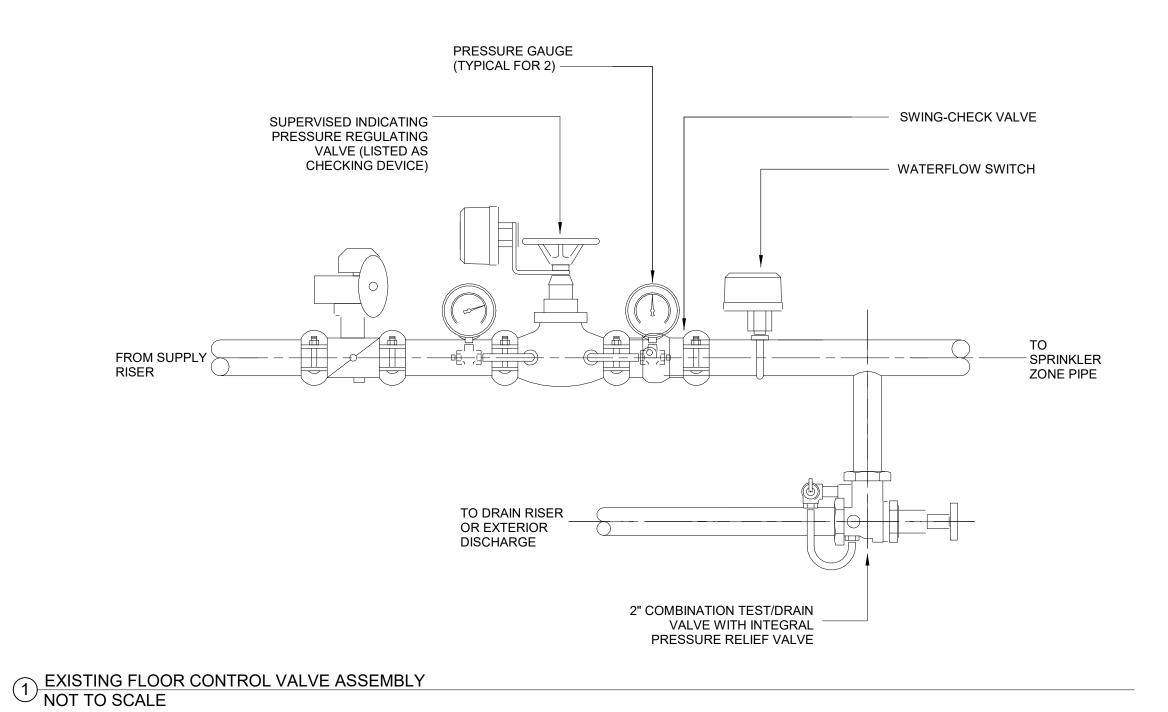


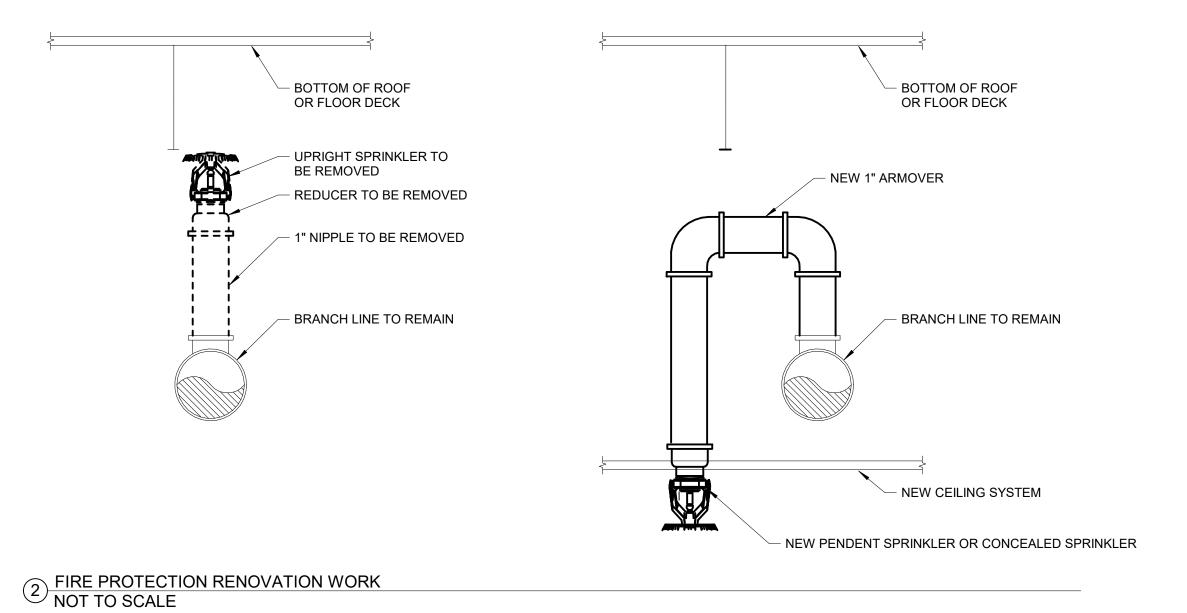

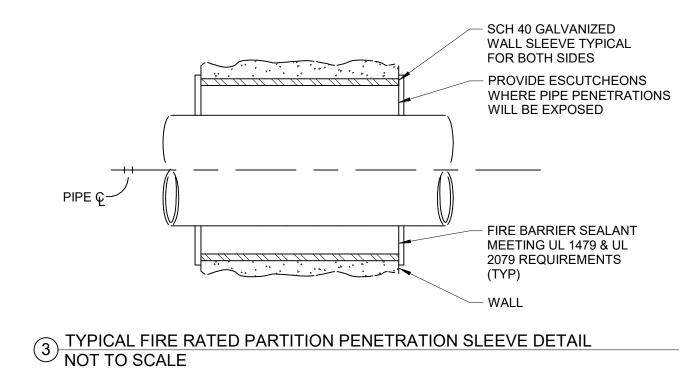

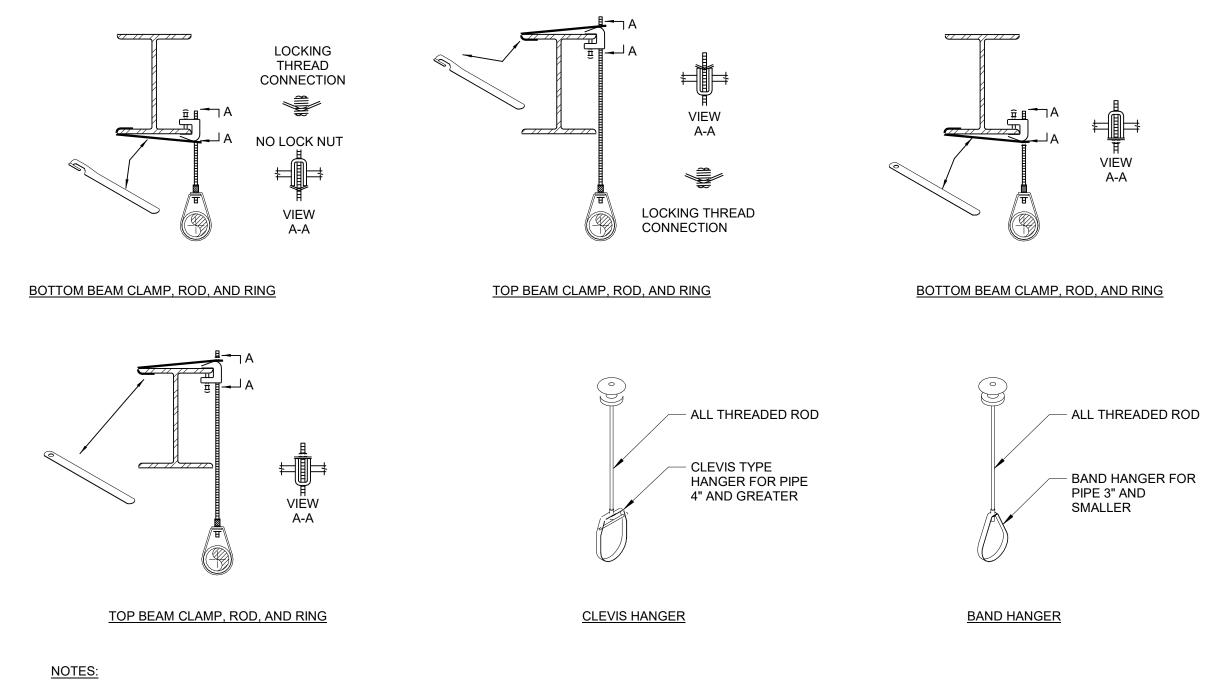

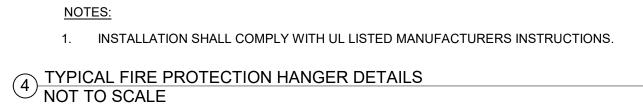

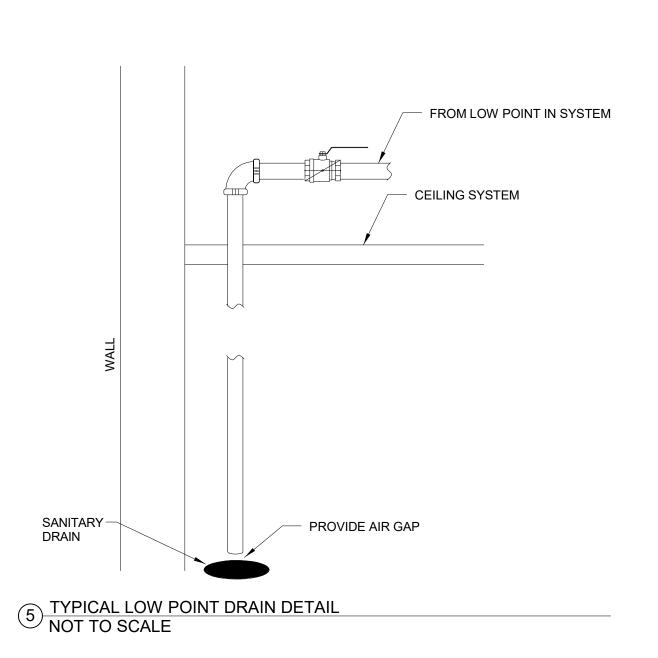




Telephone: 215.413.3700



Arora Engineers, Inc. 61 Wilmington-West Chester Pike Chadds Ford, PA 19317 P (610) 459-7900 F (610) 459-7950

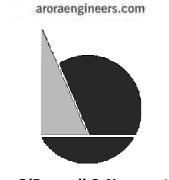

<u>O'Donnell & Naccarato</u> 701 Market Street, Suite 6000 Philadelphia, PA 19106 PH: 215.925.3788 www.o-n.com



EFFECTIVE ONLY AS TO THAT VERSION OF THIS DOCUMENT AS ORIGINALLY PUBLISHED BY DESIGN PROFESSIONAL. DESIGN PROFESSIONAL IS NOT RESPONSIBLE FOR ANY SUBSEQUENT MODIFICATION, CORRUPTION, OR UNAUTHORIZED USE OF SUCH DOCUMENT. TO VERIFY THE VALIDITY OR ADDITIONAL DESIGN PROFESSIONAL SUBSEQUENT MODIFICATION, CORRUPTION, OR UNAUTHORIZED USE OF SUCH DOCUMENT. TO VERIFY THE VALIDITY OR APPLICABILITY OF THE SEAL OR SIGNATURE, CONTACT DESIGN PROFESSIONAL.

□ PROGRESS SET ☐ CLIENT REVIEW

■ BID SET ☐ CODE REVIEW SET

☐ ISSUED FOR CONSTRUCTION

ISSUED FOR 9/18/20

(NOT FOR CONSTRUCTION) ISSUES/REVISIONS:

1 2020-09-18 ISSUED FOR BIDS PROJECT NUMBER:

304103-120 OC SCALE: NOT TO SCALE DRAWN BY: CHECKED BY:

DRAWING TITLE: FIRE PROTECTION DETAILS


FP-601

PIPE HANGER SCHEDULE									
NOMINAL PIPES SIZE (in.)	1"	1 1/4"	1 1/2"	2"	2 1/2"	3"	3 1/2"	4"	6"
MAXIMUM DISTANCE BETWEEN HANGERS FOR STEEL PIPE EXCEPT THREADED LIGHTWALL	12-0	12-0	15-0	15-0	15-0	15-0	15-0	15-0	15-0

PIPE PENETRATION SCHEDUL

NOMINAL PIPE SIZE	PIPE SCHEDULE	OUTSIDE DIAMETER OF PIPE (IN)	MINIMUM CLEARANCE AROUND PIPE (IN)	MINIMUM DIAMETER OF PIPE PENETRATION (IN) (NOMINAL DIAMETER)(IN)
1"	40	1.315	1	3.315 (4)
1 1/4"	40	1.660	1	3.66 (4)
1 1/2"	40	1.900	1	3.9 (4)
2"	40	2.375	1	4.375 (6)
2 1/2"	40	2.875	1	4.875 (6)
3"	40	3.5	1	5.5 (6)
4"	40	4.5	2	8.5 (10)
6"	40	6.625	2	10.625 (11)

SPRINKLER APPLI	SPRINKLER APPLICATION SCHEDULE								
SYMBOL	SPRINKLER TYPE	COVERAGE TYPE	RESPONSE TYPE	K-FACTOR	ORIFICE SIZE (IN)	TEMPERATURE RATING (°F)	SPRINKLER FINISH	ESCUTCHEON TYPE	ESCUTCHEON FINISH
	UPRIGHT SPRINKLER	STANDARD	QUICK	5.6	1/2"	155	BRASS	N/A	N/A
© EC	CONCEALED PENDENT SPRINKLER	EXTENDED	QUICK	5.6	1/2"	155	BRASS	FLAT PLATE CONCEALED COVER	WHITE
	CONCEALED PENDENT SPRINKLER	STANDARD	QUICK	5.6	1/2"	155	WHITE FINISH	FLAT PLATE CONCEALED COVER	WHITE

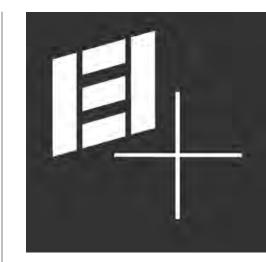

IEI GROUP, LTD.
IEI ARCHITECTS, INC.

428 North 2nd Street Philadelphia, PA 19123 Telephone: 215.413.3700

CONSULTANTS:

ARORA

Arora Engineers, Inc.
61 Wilmington-West Chester Pike
Chadds Ford, PA 19317
P (610) 459-7900
F (610) 459-7950
aroraengineers.com



701 Market Street, Suite 6000 Philadelphia, PA 19106 PH: 215.925.3788 www.o-n.com

DESIGN PROFESSIONAL'S ELECTRONIC OR DIGITAL SEAL OR SIGNATURE IS EFFECTIVE ONLY AS TO THAT VERSION OF THIS DOCUMENT AS ORIGINALLY PUBLISHED BY DESIGN PROFESSIONAL. DESIGN PROFESSIONAL IS NOT RESPONSIBLE FOR ANY SUBSEQUENT MODIFICATION, CORRUPTION, OR UNAUTHORIZED USE OF SUCH DOCUMENT. TO VERIFY THE VALIDITY OR APPLICABILITY OF THE SEAL OR SIGNATURE, CONTACT DESIGN PROFESSIONAL.

ECTITIE.

JE CITY OF PHILADELPHIA

FFICE OF EMEGENCY MANAGEMENT

FILADELPHIA PUBLIC SERVICES BUILDING

O NORTH BROAD STREET, PHILADELPHIA, PA 19

□ PROGRESS SET□ CLIENT REVIEW

■ BID SET
□ CODE REVIEW SE

□ CODE REVIEW SET□ ISSUED FOR CONSTRUCTION

ISSUED FOR BIDS 9/18/20

(NOT FOR CONSTRUCTION)

ISSUES/REVISIONS:

1 2020-09-18 ISSUED FOR BIDS

 PROJECT NUMBER:
 304103-120 OC

 SCALE:
 12" = 1'-0"

 DATE:
 07/07/2020

 DRAWN BY:
 WAB

 CHECKED BY:
 SMF

FIRE PROTECTION
SCHEDULES

SHEET NO:

FP-701

- ALL SYMBOLS AND ABBREVIATIONS MAY NOT APPLY TO THIS PROJECT
- BOUNDARY LINES SHOWN ON THE DRAWINGS DO NOT LIMIT THE SCOPE OF WORK FOR THE PROJECT. CONTRACTOR SHALL BE RESPONSIBLE FOR ALL WORK NOTED ON THE DRAWINGS.
- CONTRACTOR SHALL COMPLY WITH ALL REGULATIONS AND LAWS OF AUTHORITIES HAVING JURISDICTION.
- CONTRACTOR SHALL VERIFY ALL EXISTING CONDITIONS AND NOTIFY THE ENGINEER AT ONCE OF ANY DISCREPANCIES.
- ALL PENETRATIONS THROUGH DESIGNATED FIRE RATED WALLS, CEILINGS AND FLOOR SLABS (WHICH ARE 2-HOUR RATED) SHALL BE PROPERLY SEALED WITH AN APPROVED RATED FIRE AND SMOKE STOPPING MATERIAL. ALL FIRE AND SMOKE STOPPING MATERIAL SHALL BE SUPPLIED AND WORK PERFORMED AS PER PROJECT SPECIFICATIONS. CONTRACTOR SHALL SUBMIT MANUFACTURER'S CATALOG DATA AND INSTALLATION DETAIL AS PER SPECIFICATIONS FOR FIRE AND SMOKE STOPPING TO THE ENGINEER FOR REVIEW AND APPROVAL PRIOR INSTALLATION.
- THE CONTRACTOR SHALL NOT BE ALLOWED ANY STORAGE AREA OTHER THAN THAT AVAILABLE WITHIN THE LIMITS OF THE STAGING AREA, CONFINES OF THE WORK AREA, OR AS DESIGNATED BY THE OWNER.
- ALL WORK AND MATERIALS SHALL COMPLY WITH APPLICABLE CODES, ORDINANCES AND REGULATIONS.
- A COPY OF THE CURRENT SET OF CONTRACT DOCUMENTS (WITH AS-BUILT INFORMATION) SHALL BE KEPT AT THE JOB SITE AT ALL TIMES BY THE CONTRACTOR.
- EACH CONTRACTOR SHALL REVIEW ALL PROJECT DOCUMENTS OF ALL TRADES FOR A THOROUGH UNDERSTANDING OF PROJECT AND ANY CROSS REFERENCING OF WORK. REVIEW ALL PROJECT REQUIREMENTS PRIOR TO BIDDING. IN CASE OF DISCREPANCIES, THE MOST STRINGENT SHALL GOVERN.
- THE CONTRACTOR SHALL GUARANTEE THE ENTIRE INSTALLATION FOR A PERIOD OF ONE YEAR (EXCEPT WHERE EXTENSIONS OF THIS ONE YEAR PERIOD ARE NOTED) FROM THE DATE OF ACCEPTANCE OF THE SYSTEM AS A WHOLE. ANY DEFECTS, IN WORKMANSHIP, MATERIALS, MALFUNCTION OF EQUIPMENT OR UNSATISFACTORY PERFORMANCE, AND ALL OTHER WORK OR PARTS OF THE BUILDING DAMAGED THEREBY, AS A RESULT OF THE WORK OF THE CONTRACTOR, SHALL BE THE RESPONSIBILITY OF THE CONTRACTOR. CONTRACTOR SHALL PAY ALL REPAIR COSTS ACCORDINGLY WITHOUT ADDITIONAL COSTS TO OWNER.
- IN ADDITION TO SPECIFICATIONS, AS MAY BE DEFINED HEREAFTER, THE CONTRACTOR SHALL PROTECT THE WORK SITE AND ALL HIS OR HER WORK AGAINST ANY DAMAGE (INCLUDING BUT NOT LIMITED TO WATER, DUST, HEAT, FREEZING, ETC.) UNTIL FINAL COMPLETION AND ACCEPTANCE BY THE
- CONTRACTOR SHALL, UPON COMPLETION OF THE WORK, SUBMIT AS-BUILT RECORD DRAWINGS SHOWING ALL CHANGES FROM THE CONTRACT DRAWINGS MADE IN THE INSTALLATION, AND SHOWING DIMENSION LOCATIONS OF CONCEALED EQUIPMENT.
- PRIOR TO DELIVERY OF ANY MATERIALS TO THE SITE, THE CONTRACTOR SHALL PROVIDE MATERIAL SAFETY DATA SHEETS FOR ALL ITEMS AND MATERIALS USED IN THIS WORK.
- DRAWINGS ARE DIAGRAMMATIC AND INDICATE THE GENERAL CAPACITIES AND LOCATIONS OF EQUIPMENT.
- 15. CONTRACTOR SHALL OBTAIN AND PAY FOR ALL REQUIRED PERMITS, COORDINATE ALL REQUIRED EQUIPMENT AND SYSTEMS SHUTDOWN WITH

OWNER, AND PROVIDE OWNER TWO WEEKS NOTICE OF THE SAME.

- COORDINATE WORK WITH ALL OTHER TRADES. PHASE WORK IN CONJUNCTION WITH OTHER TRADE PHASING AND PHASING DRAWINGS.
- CONTRACTOR SHALL FIELD VERIFY OTHER EQUIPMENT/UTILITIES NOT ASSOCIATED WITH THIS WORK BUT LYING WITHIN THE WORK AREA, AND WILL NOT DISTURB THOSE EQUIPMENT/UTILITIES. THOSE EQUIPMENT/UTILITIES SHALL BE PROTECTED SO THAT THE SERVICE IS NOT INTERRUPTED. CONTRACTOR SHALL REPAIR ANY DAMAGE DONE TO THE EQUIPMENT/UTILITIES IN PERFORMANCE OF THE WORK.
- CONTRACTOR SHALL KEEP WORK AREA CLEAN, ORDERLY, AND WORKMAN LIKE, AND REMOVE ALL DEMOLISHED TRASH/ RUBBLE/CONSTRUCTION DEBRIS ON A DAILY BASIS FROM THE WORK AREA AND OFF OWNERS PROPERTY. ALL TRASH/RUBBLE/CONSTRUCTION DEBRIS DEEMED AS HAZARDOUS WASTE/MATERIAL SHALL BE DISPOSED OF IN ACCORDANCE WITH EPA OR ANY OTHER PERTINENT GOVERNING AGENCY AND DISPOSED OF ACCORDINGLY AT AN APPROVED HAZARDOUS WASTE DUMPSITE WITH ALL OF THE APPROVED/REQUIRED DOCUMENTATION.
- DURING CONSTRUCTION, THE CONTRACTOR SHALL BE RESPONSIBLE FOR PROVIDING ALL HIS EMPLOYEES WITH SAFE AND HEALTHY WORKING CONDITIONS AS PRESCRIBED IN THE "SAFETY AND HEALTH REGULATIONS FOR CONSTRUCTION" OF THE OCCUPATIONAL SAFETY AND HEALTH ADMINISTRATION OF THE U.S. DEPARTMENT OF LABOR.
- SECURE AND DELIVER TO THE OWNER'S REPRESENTATIVE ALL CERTIFICATES OF COMPLIANCE REQUIRED BY LOCAL AUTHORITIES.
- THE ALTERATION OF THE EXISTING BUILDING IS WORK OF A COMPLEX NATURE WHICH WILL REQUIRE ACCURATE PLANNING, CAREFUL PREPARATION AND EXECUTION, ATTENTION TO DETAIL AND CLOSE SUPERVISION BY THE CONTRACTOR. THE CONTRACTOR SHALL BE REQUIRED TO DO THIS WORK IN FULL COOPERATION WITH ALL CONSTRUCTION TRADES AND SUBJECT TO SCHEDULING ARRANGED TO MINIMIZE DISRUPTION OF NORMAL ACTIVITIES OF THE BUILDING. PHASING OF ALL WORK SHALL BE FULLY COORDINATED WITH THE ARCHITECTURAL PHASING PLAN.
- JUNCTION BOXES OR ANY EQUIPMENT REQUIRING CEILING ACCESS SHALL ONLY BE PERMITTED/LOCATED IN ACCESSIBLE TYPE CEILING AREAS (I.E. LAY-IN TYPE CEILING) OR WHERE ACCESS PANELS HAVE BEEN LOCATED. REFER TO ARCHITECTURAL DRAWINGS.

GENERAL DEMOLITION NOTES:

- CONTRACTOR SHALL BECOME FAMILIAR WITH EXISTING CONDITIONS AFFECTING THIS PROJECT & COORDINATE WITH ALL OTHER DISCIPLINES.
- CONTRACTOR SHALL OBTAIN AND PAY FOR ALL REQUIRED PERMITS, COORDINATE ALL REQUIRED EQUIPMENT & SYSTEMS SHUTDOWN WITH OWNER, AND PROVIDE OWNER TWO WEEKS NOTICE OF SAME.
- CONTRACTOR SHALL COMPLETE ALL CUTTING & PATCHING REQUIRED FOR THE INSTALLATION OF THE WORK, CUTTING & PATCHING SHALL BE COMPLETED IN A NEAT & WORKMAN LIKE MANNER. PATCHING MATERIALS SHALL MATCH EXISTING MATERIALS TO THE GREATEST EXTENT POSSIBLE PROVIDE TOUCH UP PAINT AS REQUIRED TO MATCH PAINT FINISH & COLOR OF EXISTING ADJACENT AREAS. ANY/ALL CEILING TILES REMOVED OR DAMAGED AS PART OF OR RESULTING FROM THIS WORK SHALL BE REPLACED WITH NEW (MATCH EXISTING) BY CONTRACTOR, AT NO ADDITIONAL COST TO THE OWNER.
- SAW CUT FLOOR SLAB TO MINIMIZE DISTURBANCE OF EXISTING SURFACES. PROVIDE CLEAN FULL FOR RESTORATION. PATCH TO MATCH EXISTING FLOOR SURFACE AND CONSTRUCTION. TRANSITION PATCH INTO ORIGINAL SURFACE NEATLY. THERE SHALL BE NO VISUAL IMPERFECTIONS OR UNEVEN
- PROVIDE TEMPORARY COVERING OF OPENINGS WHEN NOT IN USE TO PREVENT TRIPPING HAZARD.
- COORDINATE DEMOLITION WORK WITH ALL OTHER TRADES. PHASE WORK IN CONJUNCTION WITH OTHER TRADE PHASING & PHASING DRAWINGS.
- THE DEMOLITION/REMOVAL OF ITEMS BY CONTRACTOR SHALL BE AS FOLLOWS: UNLESS SPECIFICALLY NOTED OTHERWISE, ITEMS SHOWN IN HEAVY LINEWEIGHT ON DEMOLITION SHEETS ARE EXISTING ITEMS TO BE REMOVED; LIGHT LINEWEIGHT ITEMS ARE EXISTING ITEMS TO REMAIN.
- DEMOLISHED EQUIPMENT/SERVICES WILL BE REMOVED BACK TO THE LIMIT OF DEMOLITION AS INDICATED ON DRAWINGS, OR TO THE NEAREST HEADER OR JUNCTION. CAP AND VALVE AS NECESSARY.
- CONTRACTOR SHALL FIELD VERIFY OTHER EQUIPMENT / UTILITIES NOT ASSOCIATED WITH THIS WORK BUT LYING WITHIN THE WORK AREA, AND WILL NOT DISTURB THAT EQUIPMENT / UTILITIES. THOSE EQUIPMENT/UTILITIES SHALL BE PROTECTED SO THAT THE SERVICE IS NOT INTERRUPTED. CONTRACTOR SHALL REPAIR ANY DAMAGE DONE TO THE EQUIPMENT/UTILITIES IN PERFORMANCE OF THE WORK.
- ALL ITEMS BEING REMOVED SHALL BE TURNED OVER TO APPROPRIATE OWNER OR REMOVED FROM SITE AS DIRECTED, UNLESS OTHERWISE DESIGNATED.
- CONTRACTOR SHALL KEEP WORK AREA CLEAN, ORDERLY AND IN A WORKMAN LIKE MANNER. REMOVE ALL DEMOLISHED TRASH / RUBBLE / CONSTRUCTION DEBRIS FROM SITE DAILY. CONTRACTOR SHALL DISPOSE OF TRASH/RUBBLE/CONSTRUCTION DEBRIS ON A DAILY BASIS FROM THE WORK AREA AND OFF AIRPORT PROPERTY.
- ALL TRASH / RUBBLE / CONSTRUCTION DEBRIS DEEMED AS HAZARDOUS WASTE/MATERIAL SHALL BE DISPOSED OF IN ACCORDANCE WITH EPA OR ANY OTHER PERTINENT GOVERNING AGENCY AND DISPOSED OF ACCORDINGLY AT AN APPROVED HAZARDOUS WASTE DUMPSITE WITH ALL OF THE APPROVED/REQUIRED DOCUMENTATION.
- CONTRACTOR SHALL PROVIDE TEMPORARY UTILITY SERVICES, INCLUDING BUT NOT LIMITED TO DOMESTIC WATER, GAS, SANITARY AND STORM DURING DEMOLITION AND ANY DISRUPTIONS TO MAINTAIN THE INTEGRITY. CONTINUITY AND OPERATION OF THE EXISTING BUILDING.

GENERAL PLUMBING NOTES:

- CONTRACTOR SHALL FURNISH ALL LABOR, MATERIAL, & EQUIPMENT REQUIRED FOR THE COMPLETION & OPERATION OF ALL SYSTEMS IN THIS SECTION OF WORK IN ACCORDANCE WITH ALL STATE AND LOCAL APPLICABLE CODES.
- 2. PROJECT IS LOCATED IN PHILADELPHIA. REFER TO APPLICABLE CODES.
- CONTRACTOR SHALL FURNISH & INSTALL A COMPLETE PIPING SYSTEM TO ALL FIXTURES AND/OR EQUIPMENT REQUIRING SUCH. VERIFY ALL ROUGH-IN LOCATIONS & COORDINATE PIPING LOCATIONS WITH WORK UNDER OTHER DIVISIONS OF THE SPECIFICATIONS TO AVOID CONFLICTS.
- CONTRACTOR SHALL SECURE & PAY FOR ALL PERMITS, INSPECTION CERTIFICATES, ETC. REQUIRED UNDER THE PROJECT SCOPE.
- CONTRACTOR SHALL FIELD VERIFY EXISTING CONDITIONS & DIMENSIONS PRIOR TO CONSTRUCTION, AND NOTIFY ENGINEER OF RECORD OF ANY DISCREPANCIES BETWEEN THE PLANS & EXISTING CONDITIONS AND/OR POTENTIAL PROBLEMS OBSERVED PRIOR TO CONTINUING WORK.
- DO NOT SCALE THE PLANS. SEE ARCHITECTURAL PLANS FOR EXACT LOCATION OF DOORS, WINDOWS, FIXTURES, WALL DIMENSIONS, ETC.
- CONTRACTOR SHALL GIVE SUITABLE NOTICE TO OWNER PRIOR TO PERFORMING WORK INVOLVING BUILDING UTILITIES.
- CONTRACTOR SHALL BECOME FAMILIAR WITH ALL CONDITIONS AFFECTING THIS PROJECT AND COORDINATE WITH ALL OTHER DISCIPLINES.
- ALL EQUIPMENT SHALL BE HANDLED, STORED, & PROTECTED TO PREVENT DAMAGE BEFORE & DURING INSTALLATION IN ACCORDANCE WITH MANUFACTURER'S
- ALL EQUIPMENT, ETC., SHALL BE SO LOCATED & INSTALLED IN A READILY ACCESSIBLE LOCATION SO AS TO PERMIT ACCESS FOR SERVICE WITHOUT DAMAGE TO BUILDING OR FINISHED MATERIALS, PER MANUFACTURER'S INSTRUCTIONS & APPLICABLE CODES.
- CONTRACTOR SHALL SUPPLY ACCESS DOORS FOR ACCESS TO EACH CONCEALED VALVE, PIECE OF EQUIPMENT, ETC. ACCESS DOORS SHALL BE HANDED OVER TO THE GC FOR INSTALLATION.
- 12. ALL MATERIALS SHALL BE NEW & SHALL FIT THE SPACE AVAILABLE. VERIFY DIMENSIONS
- ALL PIPING, APPARATUS, EQUIPMENT, ETC. SHALL BE PROPERLY SUPPORTED. BRACED VERTICALLY & HORIZONTALLY IN ACCORDANCE WITH APPLICABLE CODES & AS REQUIRED TO PREVENT EXCESSIVE MOVEMENT.
- 14. SHUT-OFF VALVES SHALL BE TWO PIECE BRONZE BALL VALVES, FULL PORT. 15. VALVES & FITTINGS SHALL BE OF THE SAME SIZE AS THE PIPING FOR WHICH THEY ARE
- INSTALLED, UNLESS OTHERWISE NOTED. DOMESTIC WATER PIPING SHALL BE WROUGHT SEAMLESS COPPER, TYPE 'L' WITH
- 17. STERILIZE DOMESTIC WATER PIPING IN ACCORDANCE WITH HEALTH DEPARTMENT
- PLUMBING CODE. 19. COPPER PIPING SHALL BE PROTECTED AGAINST CONTACT WITH DISSIMILAR METALS. ALL HANGARS, SUPPORTS, ANCHORS, & CLIPS SHALL BE COPPER OR COPPER PLATED. WHERE COPPER PIPING IS CARRIED ON IRON TRAPEZE HANGERS WITH OTHER PIPING.

SATISFACTORY & PERMANENT ELECTROLYTIC ISOLATION MATERIAL SHALL PREVENT

ENAMEL & 15# ASPHALT SATURATED FELT BETWEEN PIPE & MASONRY PARTITION.

WATER PIPING SHALL NOT BE RUN IN AREAS SUBJECT TO FREEZING TEMPERATURES

ALL SANITARY PIPING SHALL BE PITCHED IN ACCORDANCE WITH PHILADELPHIA

- CONTACT WITH OTHER METALS. PIPING SHALL BE PROTECTED AGAINST CONTACT WITH ALL MASONRY. WHERE COPPER IS SLEEVED THROUGH MASONRY, COPPER OR RED BRASS SLEEVES SHALL BE USED. WHERE COPPER MUST BE CONCEALED IN OR AGAINST MASONRY PARTITIONS, CONTACT SHALL BE PREVENTED BY COATING THE COPPER HEAVILY WITH ASPHALTIC
- ALL WATER PIPING ABOVE GRADE SHALL BE INSULATED WITH 1" RIGID FIBERGLASS IN AN ALL-SERVICE JACKET WITH ALL JOINTS & SEAMS SEALED WITH A VAPOR BARRIER MASTIC, OR SHALL BE INSULATED WITH 1" FLEXIBLE FOAM INSULATION. FLEXIBLE FOAM INSULATION SHALL <u>NOT</u> BE SPLIT & SHALL BE TAPED AT ALL THE BUTT JOINTS.
- UNLESS OTHERWISE NOTED. WATER PIPING IN EXTERIOR WALLS SHALL BE RUN ON THE SIDE OF THE WALL INSULATION THAT BORDERS THE CONDITIONED SPACE.
- PROVIDE DRAIN VALVES AT ALL LOW POINTS OF DOMESTIC WATER PIPING SYSTEMS FOR COMPLETE DRAINAGE & INDICATE LOCATION OF SAME ON RECORD DRAWINGS.
- PROVIDE VACUUM BREAKERS AND WATER HAMMER ARRESTORS AS REQUIRED BY
- CONTRACTOR SHALL VERIFY & CORRECT SYSTEMS AS REQUIRED, TO MEET ALL CODES & REGULATIONS AND VERIFY & CORRECT ANY/ALL POSSIBLE DISCREPANCIES BETWEEN TYPE & SIZE OF CONNECTIONS SPECIFIED IN THE EQUIPMENT SCHEDULES & EQUIPMENT ACTUALLY INSTALLED.
- 26. ALL PIPING SHALL BE ROUTED SO AS TO BE CONCEALED ABOVE CEILINGS, WITHIN WALLS, OR IN CHASES, EXCEPT FINAL CONNECTIONS TO FIXTURES, OR IN MECHANICAL ROOMS, UNLESS SPECIFICALLY NOTED OTHERWISE.
- TO WHICH NEW PIPING IS TO BE CONNECTED BEFORE INSTALLATION OF NEW PIPING.

CONTRACTOR SHALL VERIFY EXACT INVERT ELEVATIONS OF EXISTING SANITARY PIPING

- PROVIDE SLEEVES & FIRE STOP SEALANTS AT ALL PENETRATIONS OF PIPE THROUGH FIRE RATED FLOORS & WALLS AS REQUIRED. COMPLY WITH ASTM E-814 & UL 1479.
- DOMESTIC COLD WATER PIPING SHALL BE ABOVE THE CEILING UNLESS OTHERWISE

INTERNATIONAL FUEL GAS CODE.

FROM BRANCH PIPE TO GAS FIRED EQUIPMENT.

PROVIDE GAS REGULATOR TO MEET EQUIPMENT OPERATION PRESSURES, WHETHER

GAS PIPE MATERIAL AND INSTALLATION SHALL BE IN ACCORDANCE WITH

- INDICATED ON DRAWINGS OR NOT. CONTRACTOR SHALL PROVIDE ALL TRANSITIONS, SHUT OFF VALVE AND DRIP LEG
- CONTRACTOR IS RESPONSIBLE FOR COORDINATING INSTALLATION OF ALL EQUIPMENT SHOWN ON PLANS, INCLUDING COORDINATION OF ANY EQUIPMENT OF ALTERNATE MANUFACTURER. CONTRACTOR SHALL PROVIDE COMPOSITE DRAWINGS AS REQUIRED FOR INSTALLATION OF EQUIPMENT SHOWN ON PLAN FOR APPROVAL BY ENGINEER.
- CONTRACTOR SHALL CORE DRILL/SAW CUT OPENINGS THROUGH FLOORS FOR NEW PIPING AS REQUIRED. OPENINGS SHALL BE SLEEVED AND SEALED WITH FIREPROOF MATERIAL. CONTRACTOR SHALL CORE DRILL 1/4"Ø PILOT HOLE PRIOR TO CORE
- ALL PENETRATIONS, BOTH NEW AND EXISTING, THROUGH DESIGNATED FIRE RATED WALLS, CEILINGS AND FLOOR SLABS (WHICH ARE 2-HOUR RATED) SHALL BE PROPERLY SEALED WITH AN APPROVED RATED FIRE STOPPING MATERIAL. ALL FIRE STOPPING MATERIAL SHALL BE SUPPLIED AND WORK PERFORMED AS PER PROJECT SPECIFICATIONS. CONTRACTOR SHALL SUBMIT COPIES OF MANUFACTURER'S CATALOG DATA AND INSTALLATION DETAILS FOR FIRESTOPPING TO THE ENGINEER FOR REVIEW AND APPROVAL PRIOR TO INSTALLATION.
- REPLACE ANY/ALL CEILING TILES THAT ARE REMOVED/DAMAGED DUE TO WORK. CONTRACTOR SHALL CLEAN AREA AFTER INSTALLATION.
- CONTRACTOR SHALL REPAIR/PATCH ALL SURFACES/WALLS DAMAGED BY CONSTRUCTION.

APPLICABLE CODES:

- 2018 INTERNATIONAL PLUMBING CODE, PHILADELPHIA EDITION
- 2018 INTERNATIONAL ENERGY CONSERVATION CODE (2018 IECC).
- 2018 INTERNATIONAL FUEL GAS CODE.

ABBREVIATIONS:

ABV	ABOVE	IN	INCH
ADA	AMERICANS WITH DISABILITIES ACT	INV EL	INVER
AFF	ABOVE FINISHED FLOOR	JAN	JANITO
AG	AIR GAP	LAV	LAVAT
AHJ	AUTHORITIES HAVING JURISDICTION	MC	MECHA
AP	ACCESS PANEL	MFR	MANUF
ASPE	AMERICAN SOCIETY OF PLUMBING	MR	MOP R
AOI L	ENGINEERS	(N)	NEW
BFP	BACK FLOW PREVENTER	NC	NORMA
BFF	BELOW FINISHED FLOOR	NIC	NOT IN
BHP	BRAKE HORSE POWER	NO	NORMA
BLW	BELOW	NPW	NON-P
BOP	BOTTOM OF PIPE	NTS	NOT TO
BTU	BRITISH THERMAL UNIT(S)	OC	ON CEI
CD	CONDENSATE DRAIN	OD	OUTSI
CI	CAST IRON	Р	PUMP
CL	CENTERLINE	PC	PLUMB
СМ	CONSTRUCTION MANAGER	PD	PUMP I
CO	CLEANOUT	PG	PRESS
COND	CONDENSATE	POC	POINT
CONT	CONTINUED	PRV	PRESS

CONT. CONTINUED CP CONDENSATE PUMP DOMESTIC COLD WATER COLD WATER FIXTURE UNITS (D) DEMOLITION

DIAMETER DOWN

EMERGEMCY SHOWER EXPANSION TANK

EXISTING TO REMAIN FLOOR CLEANOUT

FIXTURE UNITS NATURAL GAS

GREASE TRAP

HORSEPOWER

HOT WATER RETURN HOT WATER SUPPLY

INTERNATIONAL BUILDING CODE INSIDE DIAMETER INTERNATIONAL MECHANICAL CODE

INVERT ELEVATION

KILOWATTS ΚW HEATING

RT ELEVATION

OR'S IANICAL CONTRACTOR FACTURER RECEPTOR

IALLY CLOSED N CONTRACT IALLY OPEN (FAIL SAFE OPEN) POTABLE WATER

RECIRCULATION PUMP

SUPPLY FIXTURE UNITS

THERMOSTATIC MIXING VALVE

AUTOMATIC TRAP PRIMER

UNLESS OTHERWISE NOTED

TSFU TOTAL SUPPLY FIXTURE UNITS

SHOCK ABSORBER

SANITARY

SHOWER

SPECS SPECIFICATIONS

TYPICAL

VENT

W WASTE

UNDER FLOOR

V/Ø/HZ VOLTS/PHASE/HERTZ

VENT STACK

WITHOUT

WCO WALL CLEANOUT

WATER CLOSET

WATER COLUMN

WALL HYDRANT

WASTE STACK

WATER HAMMER ARRESTOR

VACUUM BREAKER

VENT THROUGH ROOF

STANDARD

SK

TYP

UON

STORM DRAIN

SUMP PUMP

STAINLESS STEEI

O SCALE ENTER IDE DIAMETER

BING CONTRACTOR DISCHARGE SURE GAUGE OF CONNECTION

SURE REDUCING VALVE PRZ PRESSURE REDUCING ZONE POTABLE WATER RELOCATED EXISTING RUN ABOVE CEILING

DRINKING FOUNTAIN RUN BELOW FLOOR DRAINAGE FIXTURE UNITS **ROOF DRAIN** ROOF DRAIN LEADER ROOF LEADER

EXISTING ELECTIRCAL CONTRACTOR

ELECTRIC WATER COOLER ELECTRIC WATER HEATER EMERGENCY WASH STATION

FLLOR DRAIN FLA FULL LOAD AMPS

GALLONS GALLONS PER MINUTE HOT AND COLD WATER

DOMESTIC HOT WATER HOT WATER FIXTURE UNITS

INTERNATIONAL PLUMBING CODE INDIRECT WASTE

HOT WATER RETURN

PLUMBING SYMBOLS

BACK FLOW PREVENTOR BALANCING VALVE WITH TEST PORTS BLIND FLANGE BOTTOM CONNECTION CAPPED PIPE CHECK VALVE CLEAN OUT CONCENTRIC REDUCER DIRECTION OF FLOW **EXPANSION COMPENSATOR** FLANGED CONNECTION FLOW MEASURING DEVICE FLOW METER FLOOR DRAIN FLOOR CLEAN OUT -GLOBE VALVE GATE VALVE BALL VALVE PIPE TURNING UP PIPE TURNING DOWN —> PITCH ->>-PRESSURE REDUCING VALVE PRESSURE RELIEF VALVE RECIRCULATION PUMP STRAINER STRAINER AND DRAIN VALVE W/ HOSE CONN. THERMOMETER TOP CONNECTION ——⊢ WALL CLEANOU1 REDUCER

PIPE RISER DESIGNATIONS:

TEE CONNECTION


DOMESTIC WATER RISER

90° ELBOW

SANITARY RISEF

VENT RISER

GENERAL SYMBOLS

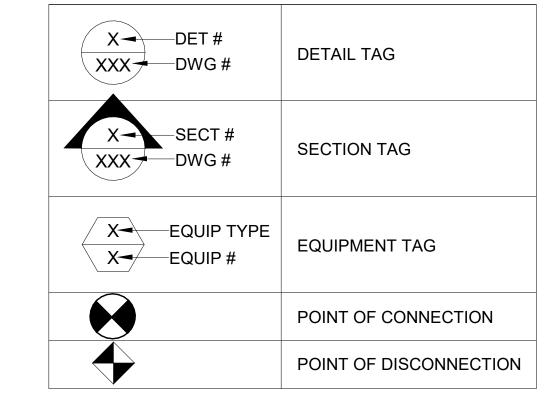

PIPING LEGEND:

DOMESTIC COLD WATER
DOMESTIC HOT WATER
DOMESTIC HOT WATER RETURN
SANITARY
VENT
NATURAL GAS



IEI GROUP, LTD. IEI ARCHITECTS, INC 428 North 2nd Street

Philadelphia, PA 19123 Telephone: 215.413.3700 CONSULTANTS:

Arora Engineers, Inc.



O'Donnell & Naccarato 701 Market Street, Suite 6000 Philadelphia, PA 19106 PH: 215.925.3788 www.o-n.com

FEFECTIVE ONLY AS TO THAT VERSION OF THIS DOCUMENT AS ORIGINALL

RESPONSIBLE FOR ANY SUBSEQUENT MODIFICATION, CORRUPTION, OF JNAUTHORIZED USE OF SUCH DOCUMENT. TO VERIFY THE VALIDITY OF APPLICABILITY OF THE SEAL OR SIGNATURE, CONTACT DESIGN PROFESSIONAL

IILADI GENC JUBLI JAD S' D 10

☐ PROGRESS SET

☐ CLIENT REVIEW

BID SET ☐ CODE REVIEW SET ☐ ISSUED FOR CONSTRUCTION **ISSUED FOR**


9/18/20 (NOT FOR CONSTRUCTION)

ISSUES/REVISIONS: 1 2020-09-18 ISSUED FOR BIDS

PROJECT NUMBER: NOT TO SCALE SCALE: DRAWN BY: CHECKED BY:

DRAWING TITLE: PLUMBING GENERAL NOTES **ABBREVIATIONS** AND SYMBOLS

P-001

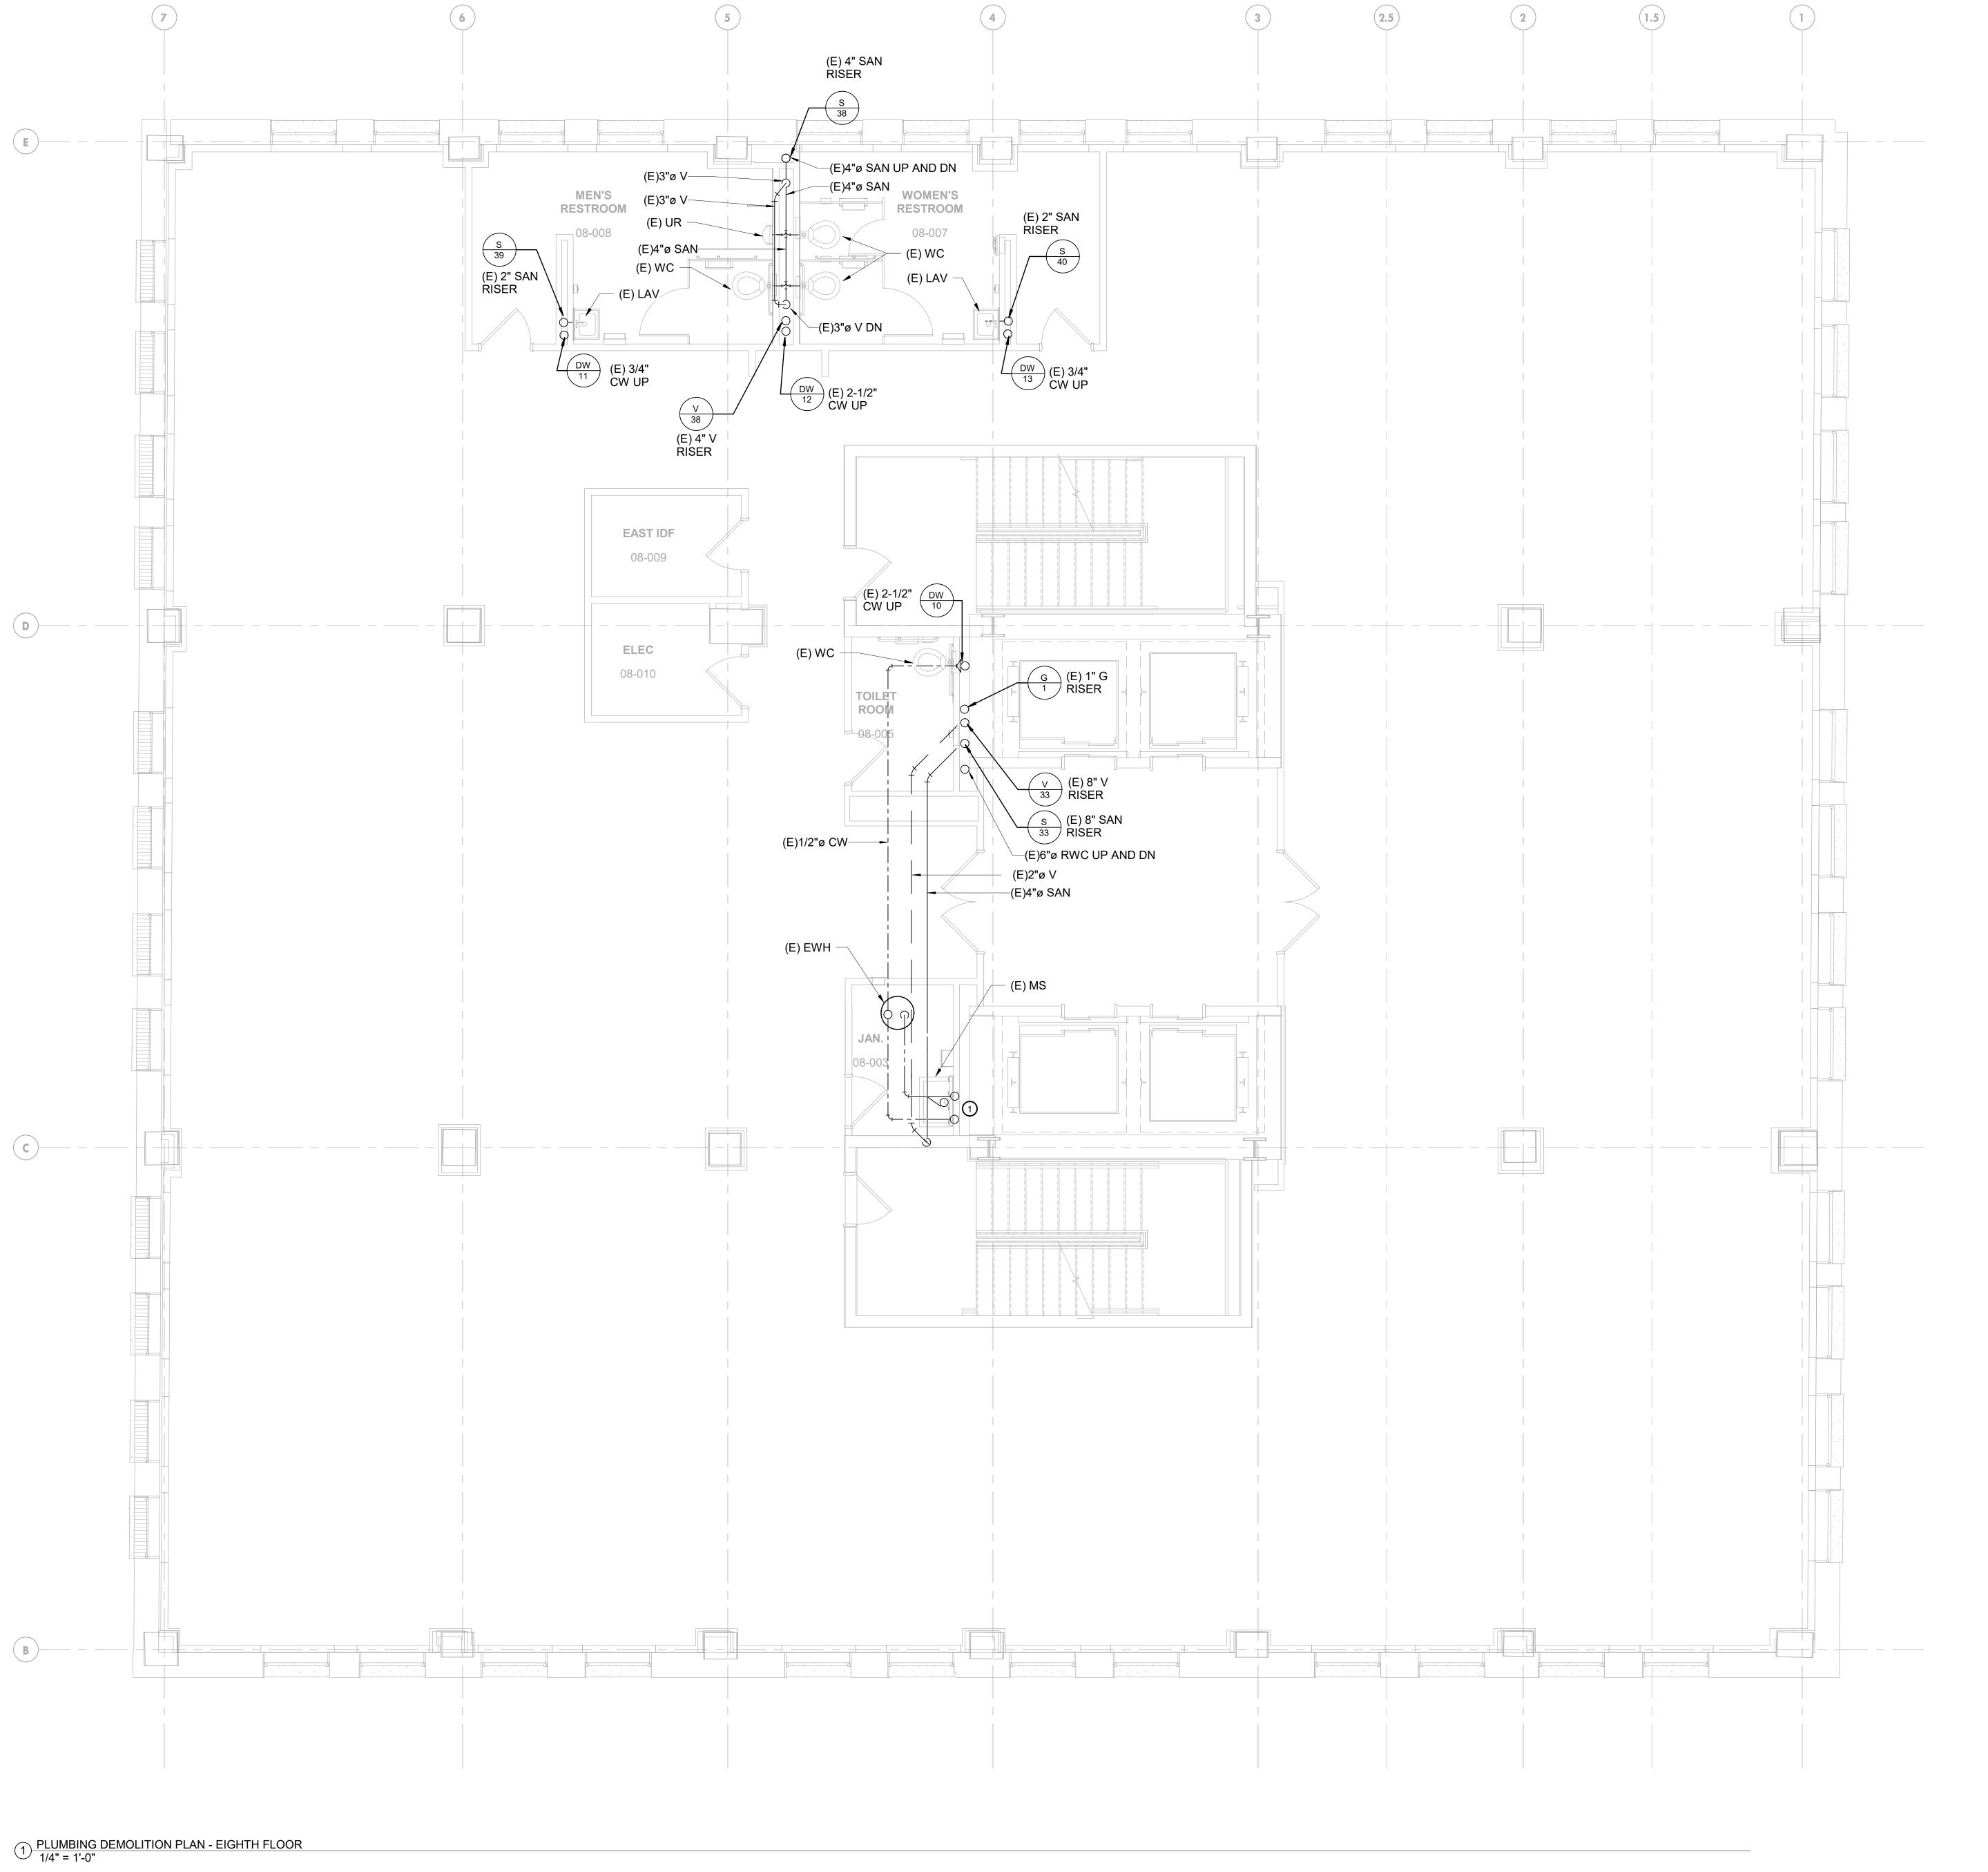



- 1. REFER TO DRAWING P-001 FOR PLUMBING SYMBOLS, ABBREVIATIONS, GENERAL NOTES, PLUMBING DEMOLITION NOTES AND PLUMBING NOTES.
- 2. REFER TO DRAWINGS PD-108, PD-109 AND PD-110 FOR PLUMBING DEMOLITION WORK.
- REFER TO DRAWINGS P-108, P-109 AND P-110 FOR PLUMBING NEW WORK.
- 4. REFER TO DRAWING P-501 FOR SANITARY AND VENT RISER DIAGRAM.
- REFER TO DRAWING P-502 FOR DOMESTIC WATER AND NATURAL GAS RISER DIAGRAM.
- 6. REFER TO DRAWING P-601 FOR PLUMBING DETAILS.
- 7. REFER TO DRAWING P-701 FOR PLUMBING SCHEDULES.
- 8. PIPE SHOWN IN PLAN IS LOCATED FROM THE FLOOR TO DECK ABOVE. DOMESTIC WATER AND VENT ARE FOR FIXTURES ON THE INDICATED LEVEL. SANITARY PIPE SERVES FIXTURES FROM LEVEL ABOVE.
- 9. PIPE LOCATION SHOWN IN PLAN IS DIAGRAMATIC.
 COORDINATE PIPE IN CORRIDOR WITH MECHANICAL
 DUCTWORK, FIRE PROTECTION PIPE AND ELECTRICAL
 COMPONENTS.

KEYED NOTES:

SANITARY PIPE FOR LEVEL 8 IS IN CEILING OF LEVEL 7 AND NOT SHOWN ON PLAN. REFER TO RISER DIAGRAM FOR EXISTING PIPE INFORMATION.



IEI GROUP, LTD.
IEI ARCHITECTS, INC.

428 North 2nd Street Philadelphia, PA 19123 Telephone: 215.413.3700

CONSULTANTS:

ARORA*

Arora Engineers, Inc.
61 Wilmington-West Chester Pike
Chadds Ford, PA 19317



O'Donnell & Naccarato
701 Market Street, Suite 6000
Philadelphia, PA 19106
PH: 215.925.3788



www.o-n.com

DESIGN PROFESSIONAL'S ELECTRONIC OR DIGITAL SEAL OR SIGNATURE IS EFFECTIVE ONLY AS TO THAT VERSION OF THIS DOCUMENT AS ORIGINALLY PUBLISHED BY DESIGN PROFESSIONAL. DESIGN PROFESSIONAL IS NOT RESPONSIBLE FOR ANY SUBSEQUENT MODIFICATION, CORRUPTION, OR UNAUTHORIZED USE OF SUCH DOCUMENT. TO VERIFY THE VALIDITY OR APPLICABILITY OF THE SEAL OR SIGNATURE, CONTACT DESIGN PROFESSIONAL.

CITY OF PHILADELPHIA

SE OF EMEGENCY MANAGEMENT

ADELPHIA PUBLIC SERVICES BUILDING

IORTH BROAD STREET, PHILADELPHIA, PA 19

RS 8, 9 AND 10

□ PROGRESS SET□ CLIENT REVIEW

■ BID SET

□ CODE REVIEW SET

□ ISSUED FOR CONSTRUCTION

ISSUED FOR


9/18/20
(NOT FOR CONSTRUCTION)

ISSUES/REVISIONS:
1 2020-09-18 ISSUED FOR BIDS

PROJECT NUMBER: 304103-120 OC SCALE: As indicated DATE: 07/07/2020 DRAWN BY: DG CHECKED BY: DJM

PLUMBING 8TH
FLOOR
DEMOLITION PLAN

PD-108

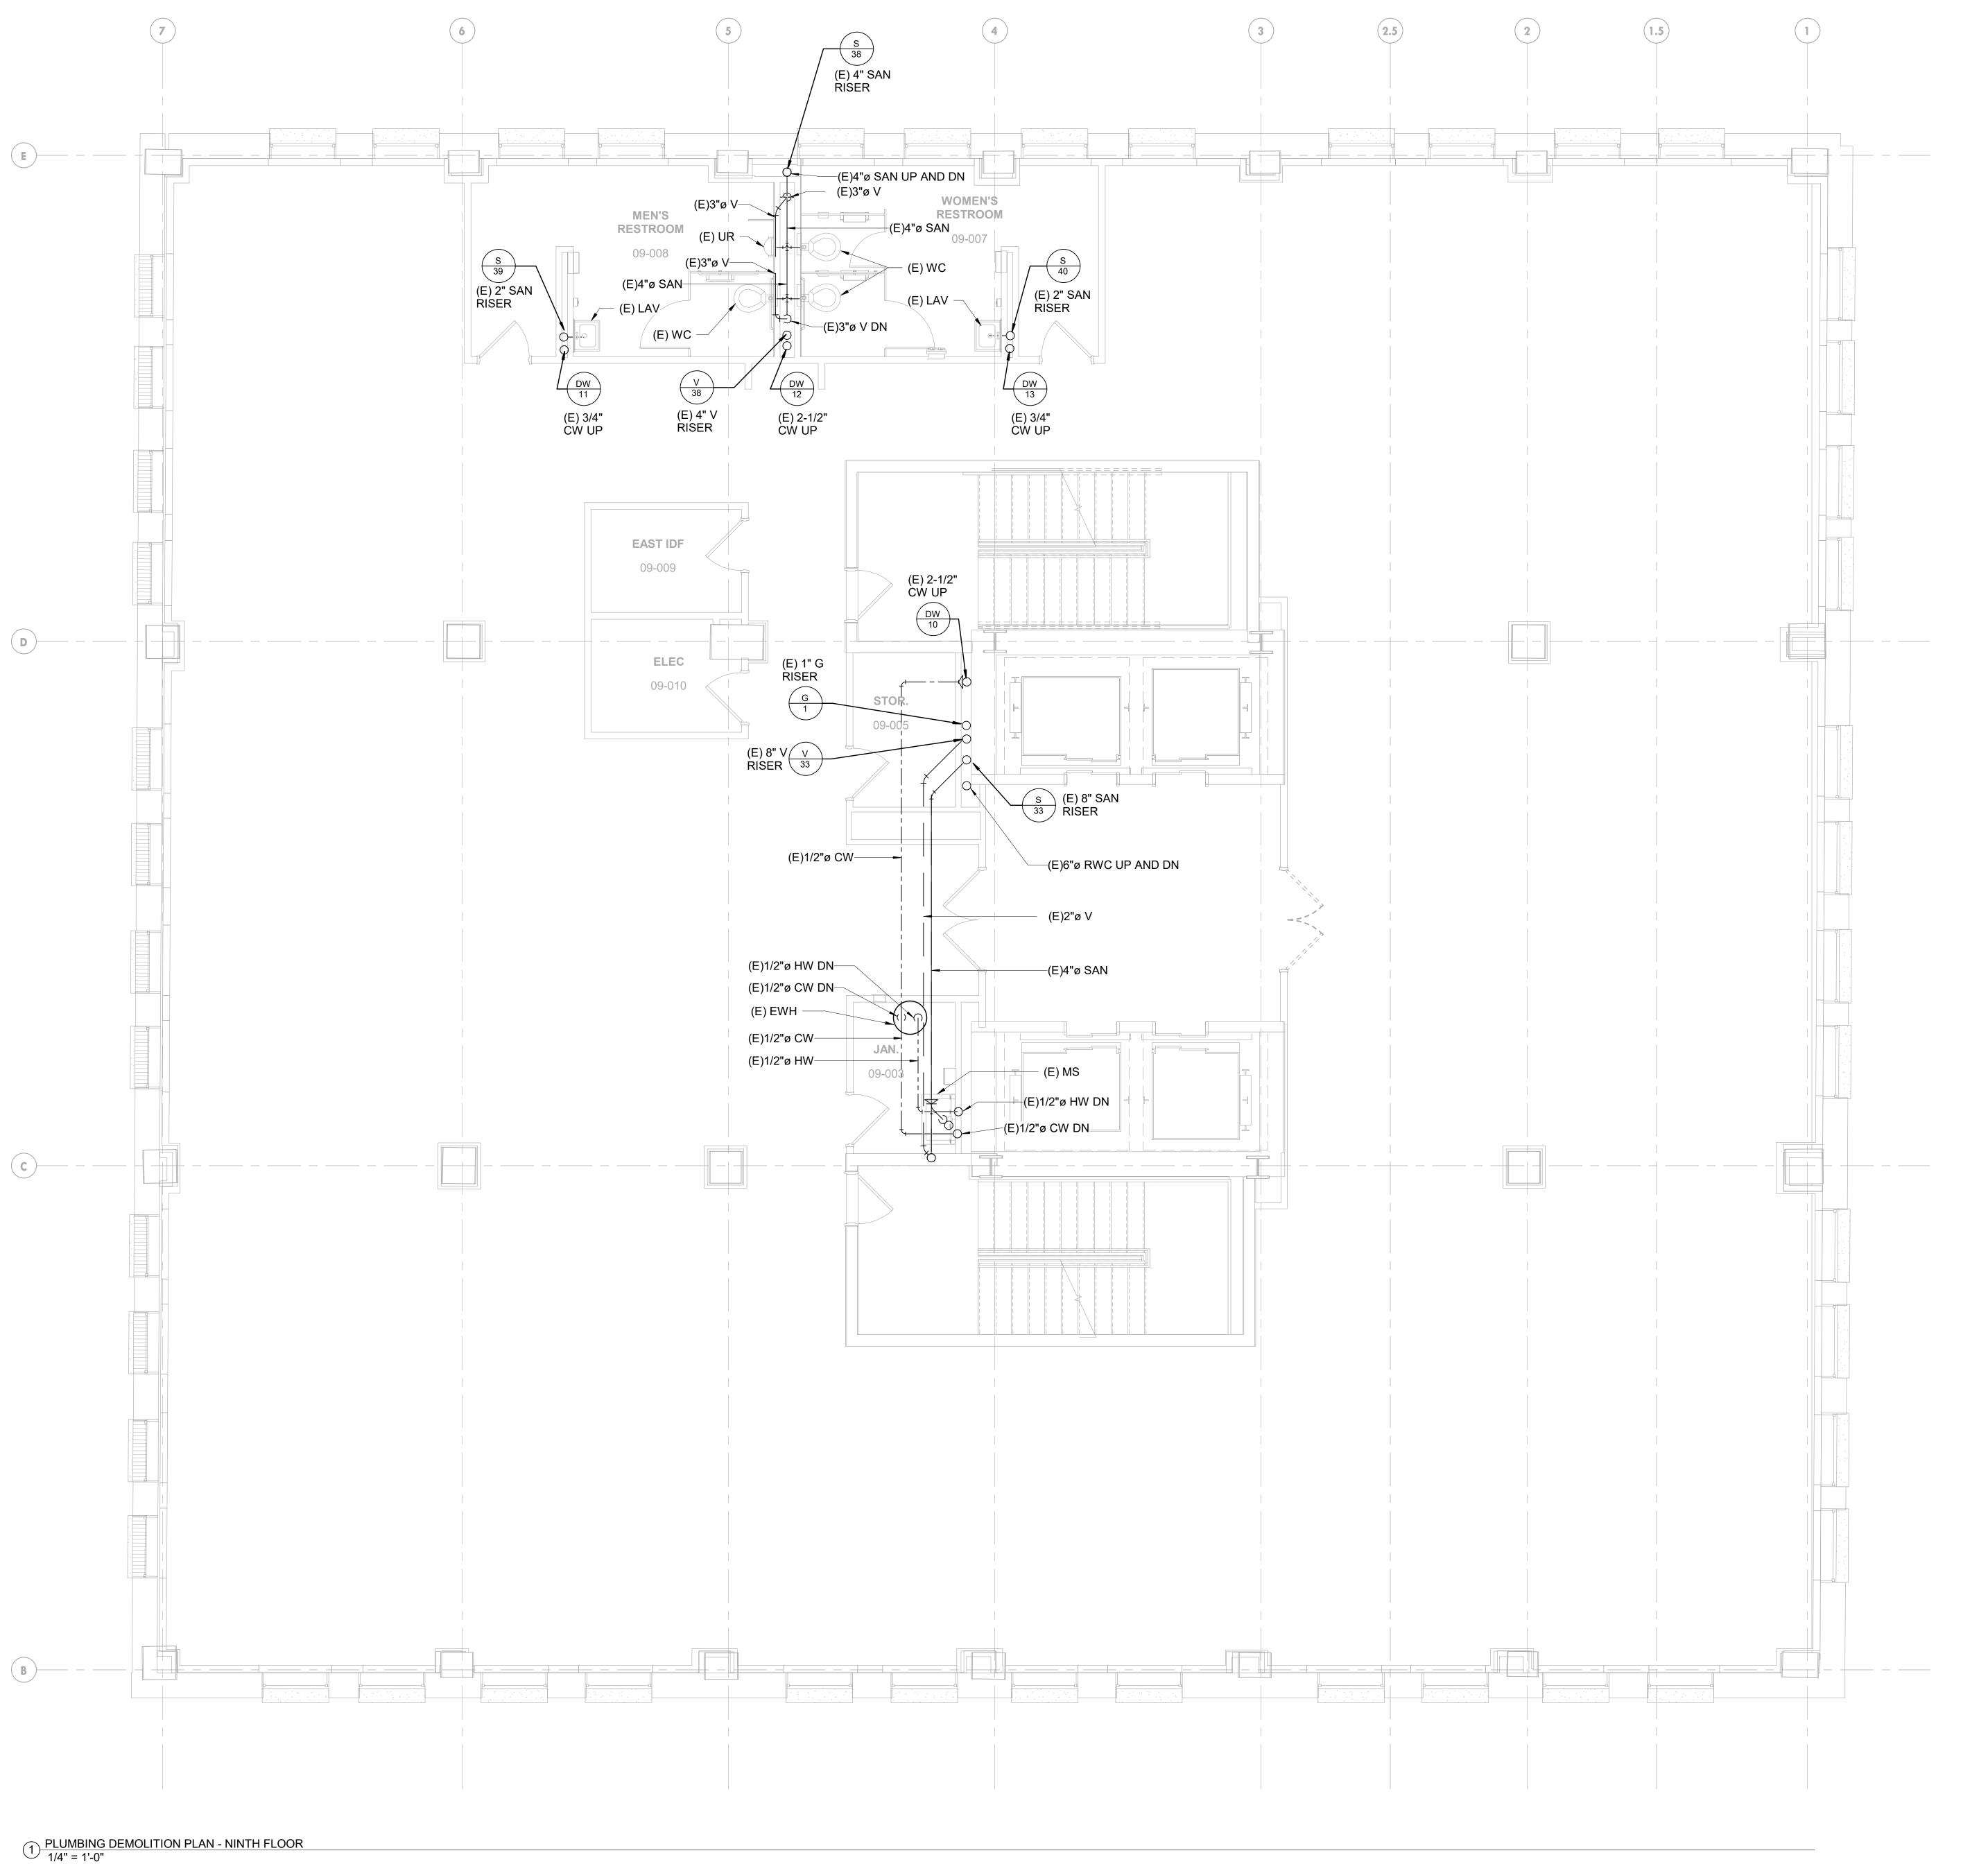



- REFER TO DRAWING P-001 FOR PLUMBING SYMBOLS, ABBREVIATIONS, GENERAL NOTES, PLUMBING DEMOLITION NOTES AND PLUMBING NOTES.
- REFER TO DRAWINGS PD-108, PD-109 AND PD-110 FOR PLUMBING DEMOLITION WORK.
- REFER TO DRAWINGS P-108, P-109 AND P-110 FOR PLUMBING NEW WORK.
- REFER TO DRAWING P-501 FOR SANITARY AND VENT RISER DIAGRAM.
- REFER TO DRAWING P-502 FOR DOMESTIC WATER AND NATURAL GAS RISER DIAGRAM.
- REFER TO DRAWING P-601 FOR PLUMBING DETAILS.
- REFER TO DRAWING P-701 FOR PLUMBING SCHEDULES.
- PIPE SHOWN IN PLAN IS LOCATED FROM THE FLOOR TO DECK ABOVE. DOMESTIC WATER AND VENT ARE FOR FIXTURES ON THE INDICATED LEVEL. SANITARY PIPE SERVES FIXTURES FROM LEVEL ABOVE.
- PIPE LOCATION SHOWN IN PLAN IS DIAGRAMATIC. COORDINATE PIPE IN CORRIDOR WITH MECHANICAL DUCTWORK, FIRE PROTECTION PIPE AND ELECTRICAL COMPONENTS.




IEI GROUP, LTD. IEI ARCHITECTS, INC.


428 North 2nd Street Philadelphia, PA 19123 Telephone: 215.413.3700

CONSULTANTS: ARORA

Arora Engineers, Inc. 61 Wilmington-West Chester Pike Chadds Ford, PA 19317 P (610) 459-7900 F (610) 459-7950

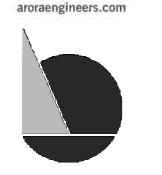

<u>O'Donnell & Naccarato</u> 701 Market Street, Suite 6000 Philadelphia, PA 19106 PH: 215.925.3788 www.o-n.com

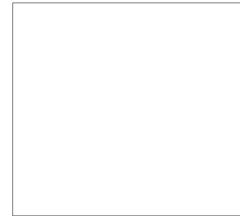

DESIGN PROFESSIONAL SELECT INVINIO OR DIGITAL SEAL OR SIGNATURE IS EFFECTIVE ONLY AS TO THAT VERSION OF THIS DOCUMENT AS ORIGINALLY PUBLISHED BY DESIGN PROFESSIONAL. DESIGN PROFESSIONAL IS NOT RESPONSIBLE FOR ANY SUBSEQUENT MODIFICATION, CORRUPTION, OR UNAUTHORIZED USE OF SUCH DOCUMENT. TO VERIFY THE VALIDITY OR

APPLICABILITY OF THE SEAL OR SIGNATURE, CONTACT DESIGN PROFESSIONAL.

☐ PROGRESS SET ☐ CLIENT REVIEW

■ BID SET ☐ CODE REVIEW SET

☐ ISSUED FOR CONSTRUCTION

ISSUED FOR 9/18/20

(NOT FOR CONSTRUCTION) ISSUES/REVISIONS:


PROJECT NUMBER: SCALE: As indicated DATE: DRAWN BY:

1 2020-09-18 ISSUED FOR BIDS

CHECKED BY: DRAWING TITLE: PLUMBING 9TH

FLOOR **DEMOLITION PLAN**

PD-109

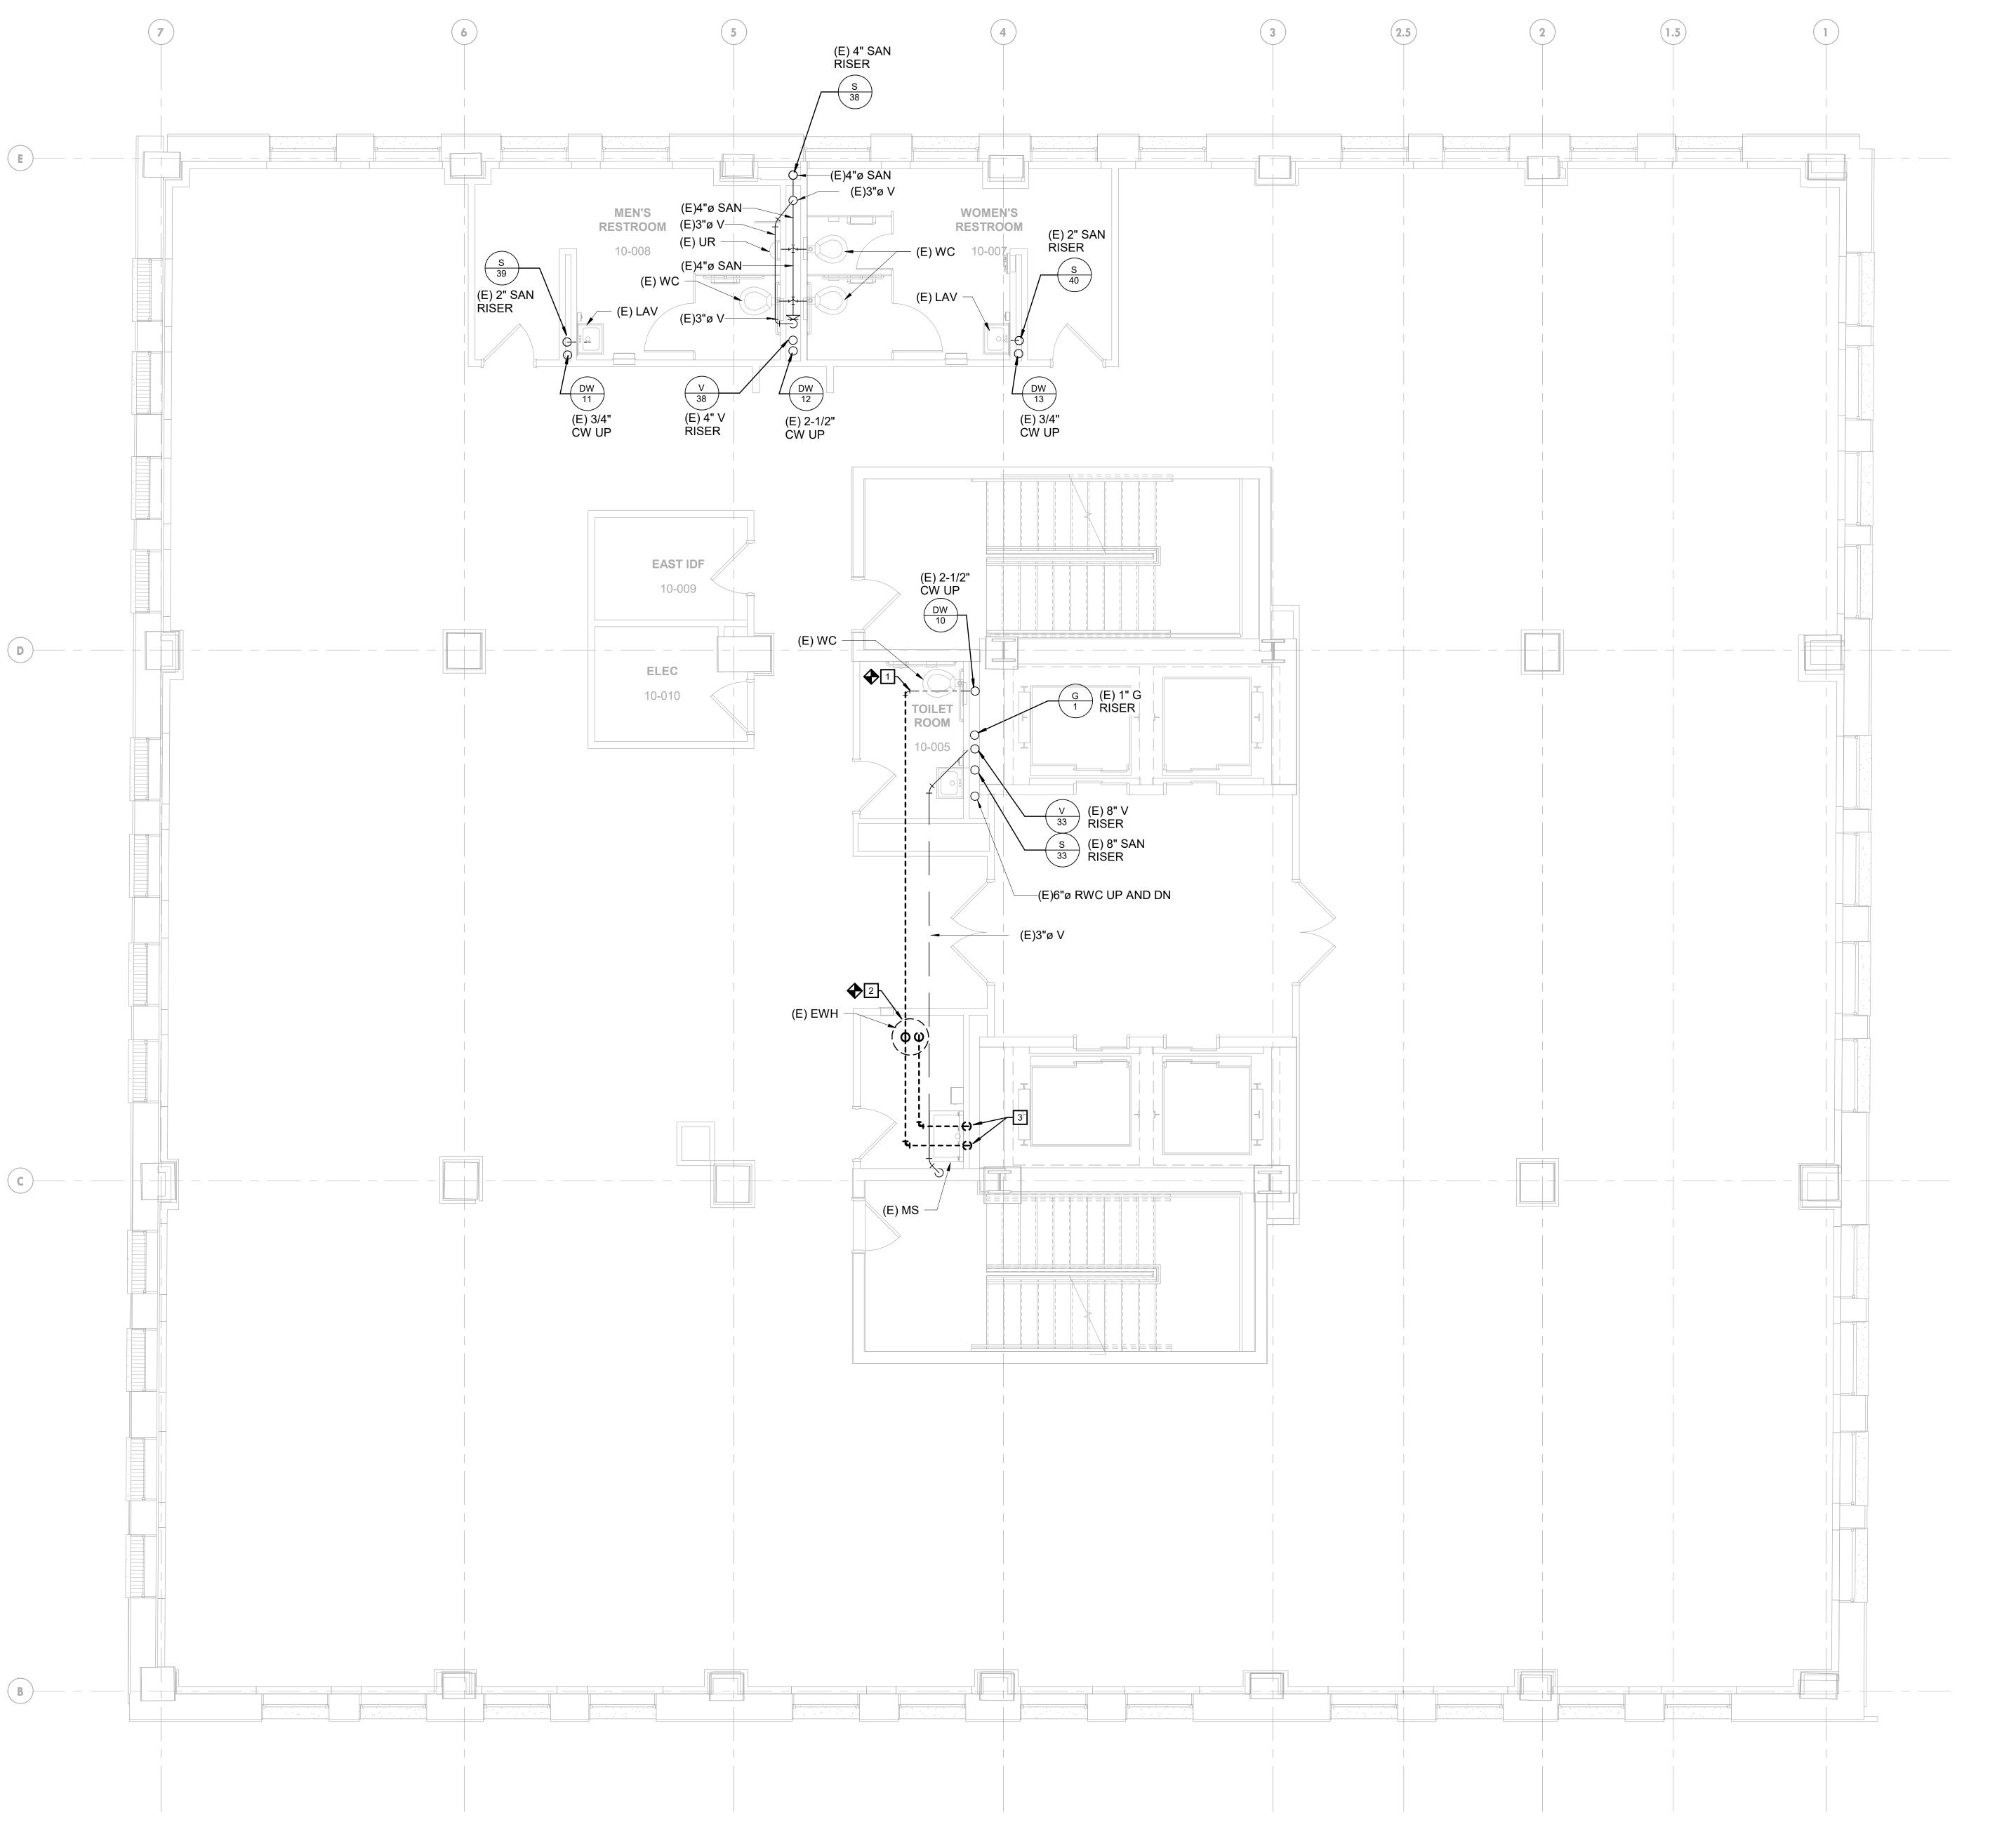

1 PLUMBING DEMOLITION PLAN - TENTH FLOOR 1/4" = 1'-0"



- REFER TO DRAWING P-001 FOR PLUMBING SYMBOLS, ABBREVIATIONS, GENERAL NOTES, PLUMBING DEMOLITION NOTES AND PLUMBING NOTES.
- 2. REFER TO DRAWINGS PD-108, PD-109 AND PD-110 FOR PLUMBING DEMOLITION WORK.
- REFER TO DRAWINGS P-108, P-109 AND P-110 FOR PLUMBING NEW WORK.
- 4. REFER TO DRAWING P-501 FOR SANITARY AND VENT RISER DIAGRAM.
- REFER TO DRAWING P-502 FOR DOMESTIC WATER AND NATURAL GAS RISER DIAGRAM.
- 6. REFER TO DRAWING P-601 FOR PLUMBING DETAILS.
- 7. REFER TO DRAWING P-701 FOR PLUMBING SCHEDULES.
- PIPE SHOWN IN PLAN IS LOCATED FROM THE FLOOR TO DECK ABOVE. DOMESTIC WATER AND VENT ARE FOR FIXTURES ON THE INDICATED LEVEL. SANITARY PIPE SERVES FIXTURES FROM LEVEL ABOVE.
- PIPE LOCATION SHOWN IN PLAN IS DIAGRAMATIC. COORDINATE PIPE IN CORRIDOR WITH MECHANICAL DUCTWORK, FIRE PROTECTION PIPE AND ELECTRICAL COMPONENTS.

KEYED NOTES:

- REMOVE EXISTING WATER SERVICE TO TENTH FLOOR JANITOR CLOSET. CONNECTIONS FOR EXISTING SINGLE OCCUPANT TOILET ROOM TO REMAIN.
- REMOVE EXISTING WATER HEATER AND ALL PIPING. PREPARE JANITOR'S CLOSET FOR INSTALLATION OF NEW WATER HEATER TO SERVE NEW FIXTURES ON TENTH FLOOR. REFER TO NEW WORK PLAN.
- REMOVE COLD WATER AND HOT WATER PIPE IN CEILING TO EXISTING MOP SINK. EXISTING MOP SINK AND PIPE DOWN WALL TO FAUCET TO REMAIN. PIPE TO BE RECONNECTED IN CEILING UNDER NEW WORK.




IEI GROUP, LTD. IEI ARCHITECTS, INC. 428 North 2nd Street

Philadelphia, PA 19123 Telephone: 215.413.3700

CONSULTANTS: ARORA

Arora Engineers, Inc. 61 Wilmington-West Chester Pike Chadds Ford, PA 19317 P (610) 459-7900 F (610) 459-7950

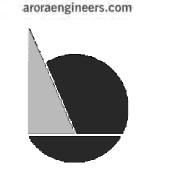

O'Donnell & Naccarato 701 Market Street, Suite 6000 Philadelphia, PA 19106 PH: 215.925.3788 www.o-n.com

EFFECTIVE ONLY AS TO THAT VERSION OF THIS DOCUMENT AS ORIGINALLY PUBLISHED BY DESIGN PROFESSIONAL. DESIGN PROFESSIONAL IS NOT RESPONSIBLE FOR ANY SUBSEQUENT MODIFICATION, CORRUPTION, OR UNAUTHORIZED USE OF SUCH DOCUMENT. TO VERIFY THE VALIDITY OR

APPLICABILITY OF THE SEAL OR SIGNATURE, CONTACT DESIGN PROFESSIONAL

☐ PROGRESS SET ☐ CLIENT REVIEW

■ BID SET

☐ CODE REVIEW SET ☐ ISSUED FOR CONSTRUCTION

> ISSUED FOR 9/18/20


(NOT FOR CONSTRUCTION) ISSUES/REVISIONS:

1 2020-09-18 ISSUED FOR BIDS PROJECT NUMBER: SCALE: As indicated DATE: 07/07/2020

DRAWN BY: CHECKED BY: DRAWING TITLE: PLUMBING 10TH

FLOOR **DEMOLITION PLAN**

PD-110

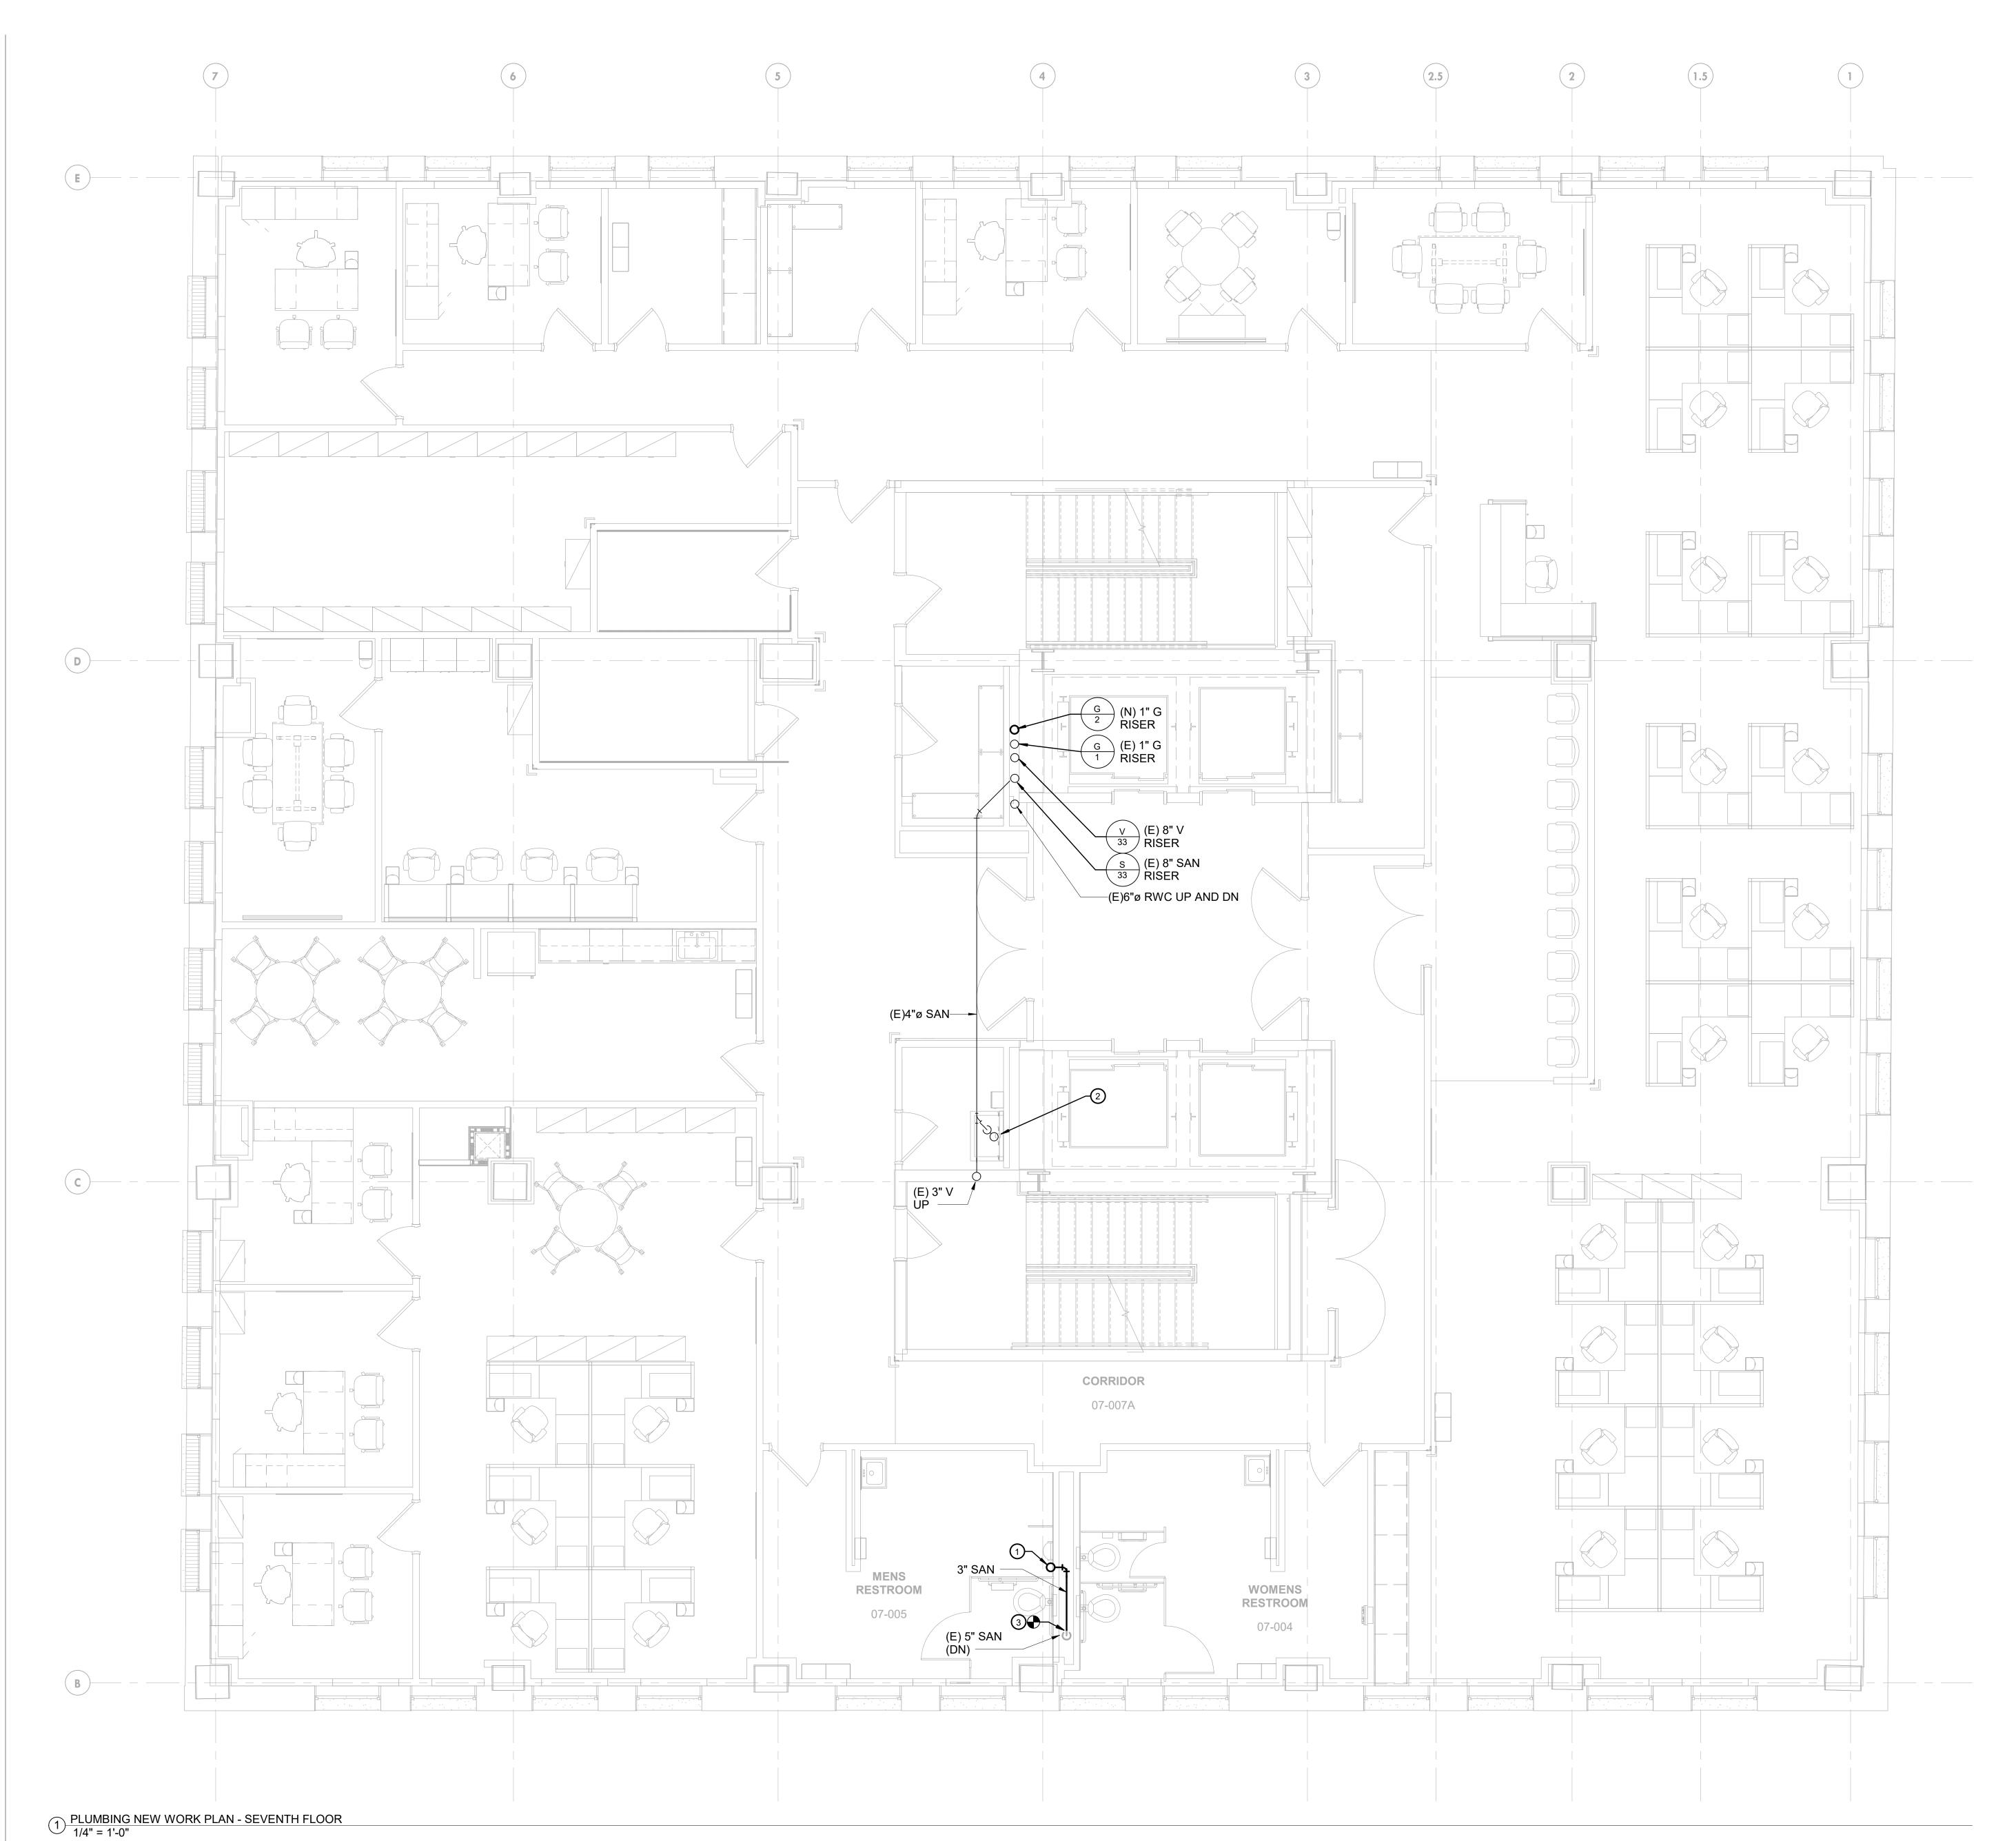

- REFER TO DRAWING P-001 FOR PLUMBING SYMBOLS, ABBREVIATIONS, GENERAL NOTES, PLUMBING DEMOLITION NOTES AND PLUMBING NOTES.
- REFER TO DRAWINGS PD-108, PD-109 AND PD-110 FOR PLUMBING DEMOLITION WORK.
- REFER TO DRAWINGS P-108, P-109 AND P-110 FOR PLUMBING NEW WORK.
- 4. REFER TO DRAWING P-501 FOR SANITARY AND VENT RISER DIAGRAM.
- REFER TO DRAWING P-502 FOR DOMESTIC WATER AND NATURAL GAS RISER DIAGRAM.
- REFER TO DRAWING P-601 FOR PLUMBING DETAILS.
- REFER TO DRAWING P-701 FOR PLUMBING SCHEDULES.
- PIPE SHOWN IN PLAN IS LOCATED FROM THE FLOOR TO
- DECK ABOVE. DOMESTIC WATER AND VENT ARE FOR FIXTURES ON THE INDICATED LEVEL. SANITARY PIPE SERVES FIXTURES FROM LEVEL ABOVE.
- PIPE LOCATION SHOWN IN PLAN IS DIAGRAMATIC. COORDINATE PIPE IN CORRIDOR WITH MECHANICAL DUCTWORK, FIRE PROTECTION PIPE AND ELECTRICAL COMPONENTS.

KEYED NOTES:

- SANITARY PIPE DOWN FROM SK-1 ON LEVEL 8.
- SANITARY PIPE DOWN FROM EXISTING MOP SINK ON LEVEL 8.
- LEVEL 7 SHOWN FOR COORDINATION OF SANITARY PIPE FROM BREAK ROOM SINKS ON ABOVE LEVELS. REFER TO RISER FOR PIPE SIZES. COORDINATE SANITARY TIE IN TO EXISTING PIPE RISER IN REST



IEI GROUP, LTD. IEI ARCHITECTS, INC.


> 428 North 2nd Street Philadelphia, PA 19123 Telephone: 215.413.3700

CONSULTANTS: ARORA





O'Donnell & Naccarato 701 Market Street, Suite 6000 Philadelphia, PA 19106 PH: 215.925.3788 www.o-n.com

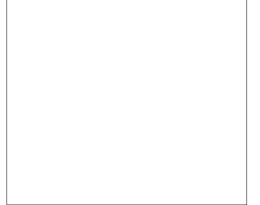

DESIGN FROPESSIONAL SELECTIONS OF THIS DOCUMENT AS ORIGINALLY
PUBLISHED BY DESIGN PROFESSIONAL. DESIGN PROFESSIONAL IS NOT
RESPONSIBLE FOR ANY SUBSEQUENT MODIFICATION, CORRUPTION, OR
UNAUTHORIZED USE OF SUCH DOCUMENT. TO VERIEY THE VALIDITY OR

□ PROGRESS SET

☐ CLIENT REVIEW ■ BID SET

☐ CODE REVIEW SET ☐ ISSUED FOR CONSTRUCTION

> ISSUED FOR BIDS 9/18/20

(NOT FOR CONSTRUCTION)

ISSUES/REVISIONS: 1 2020-09-18 ISSUED FOR BIDS


PROJECT NUMBER: SCALE: DATE: DRAWN BY: CHECKED BY:

DRAWING TITLE: PLUMBING 7TH FLOOR NEW WORK PLAN

P-107

PRINTED ON:

2020-09-21 12:24:47

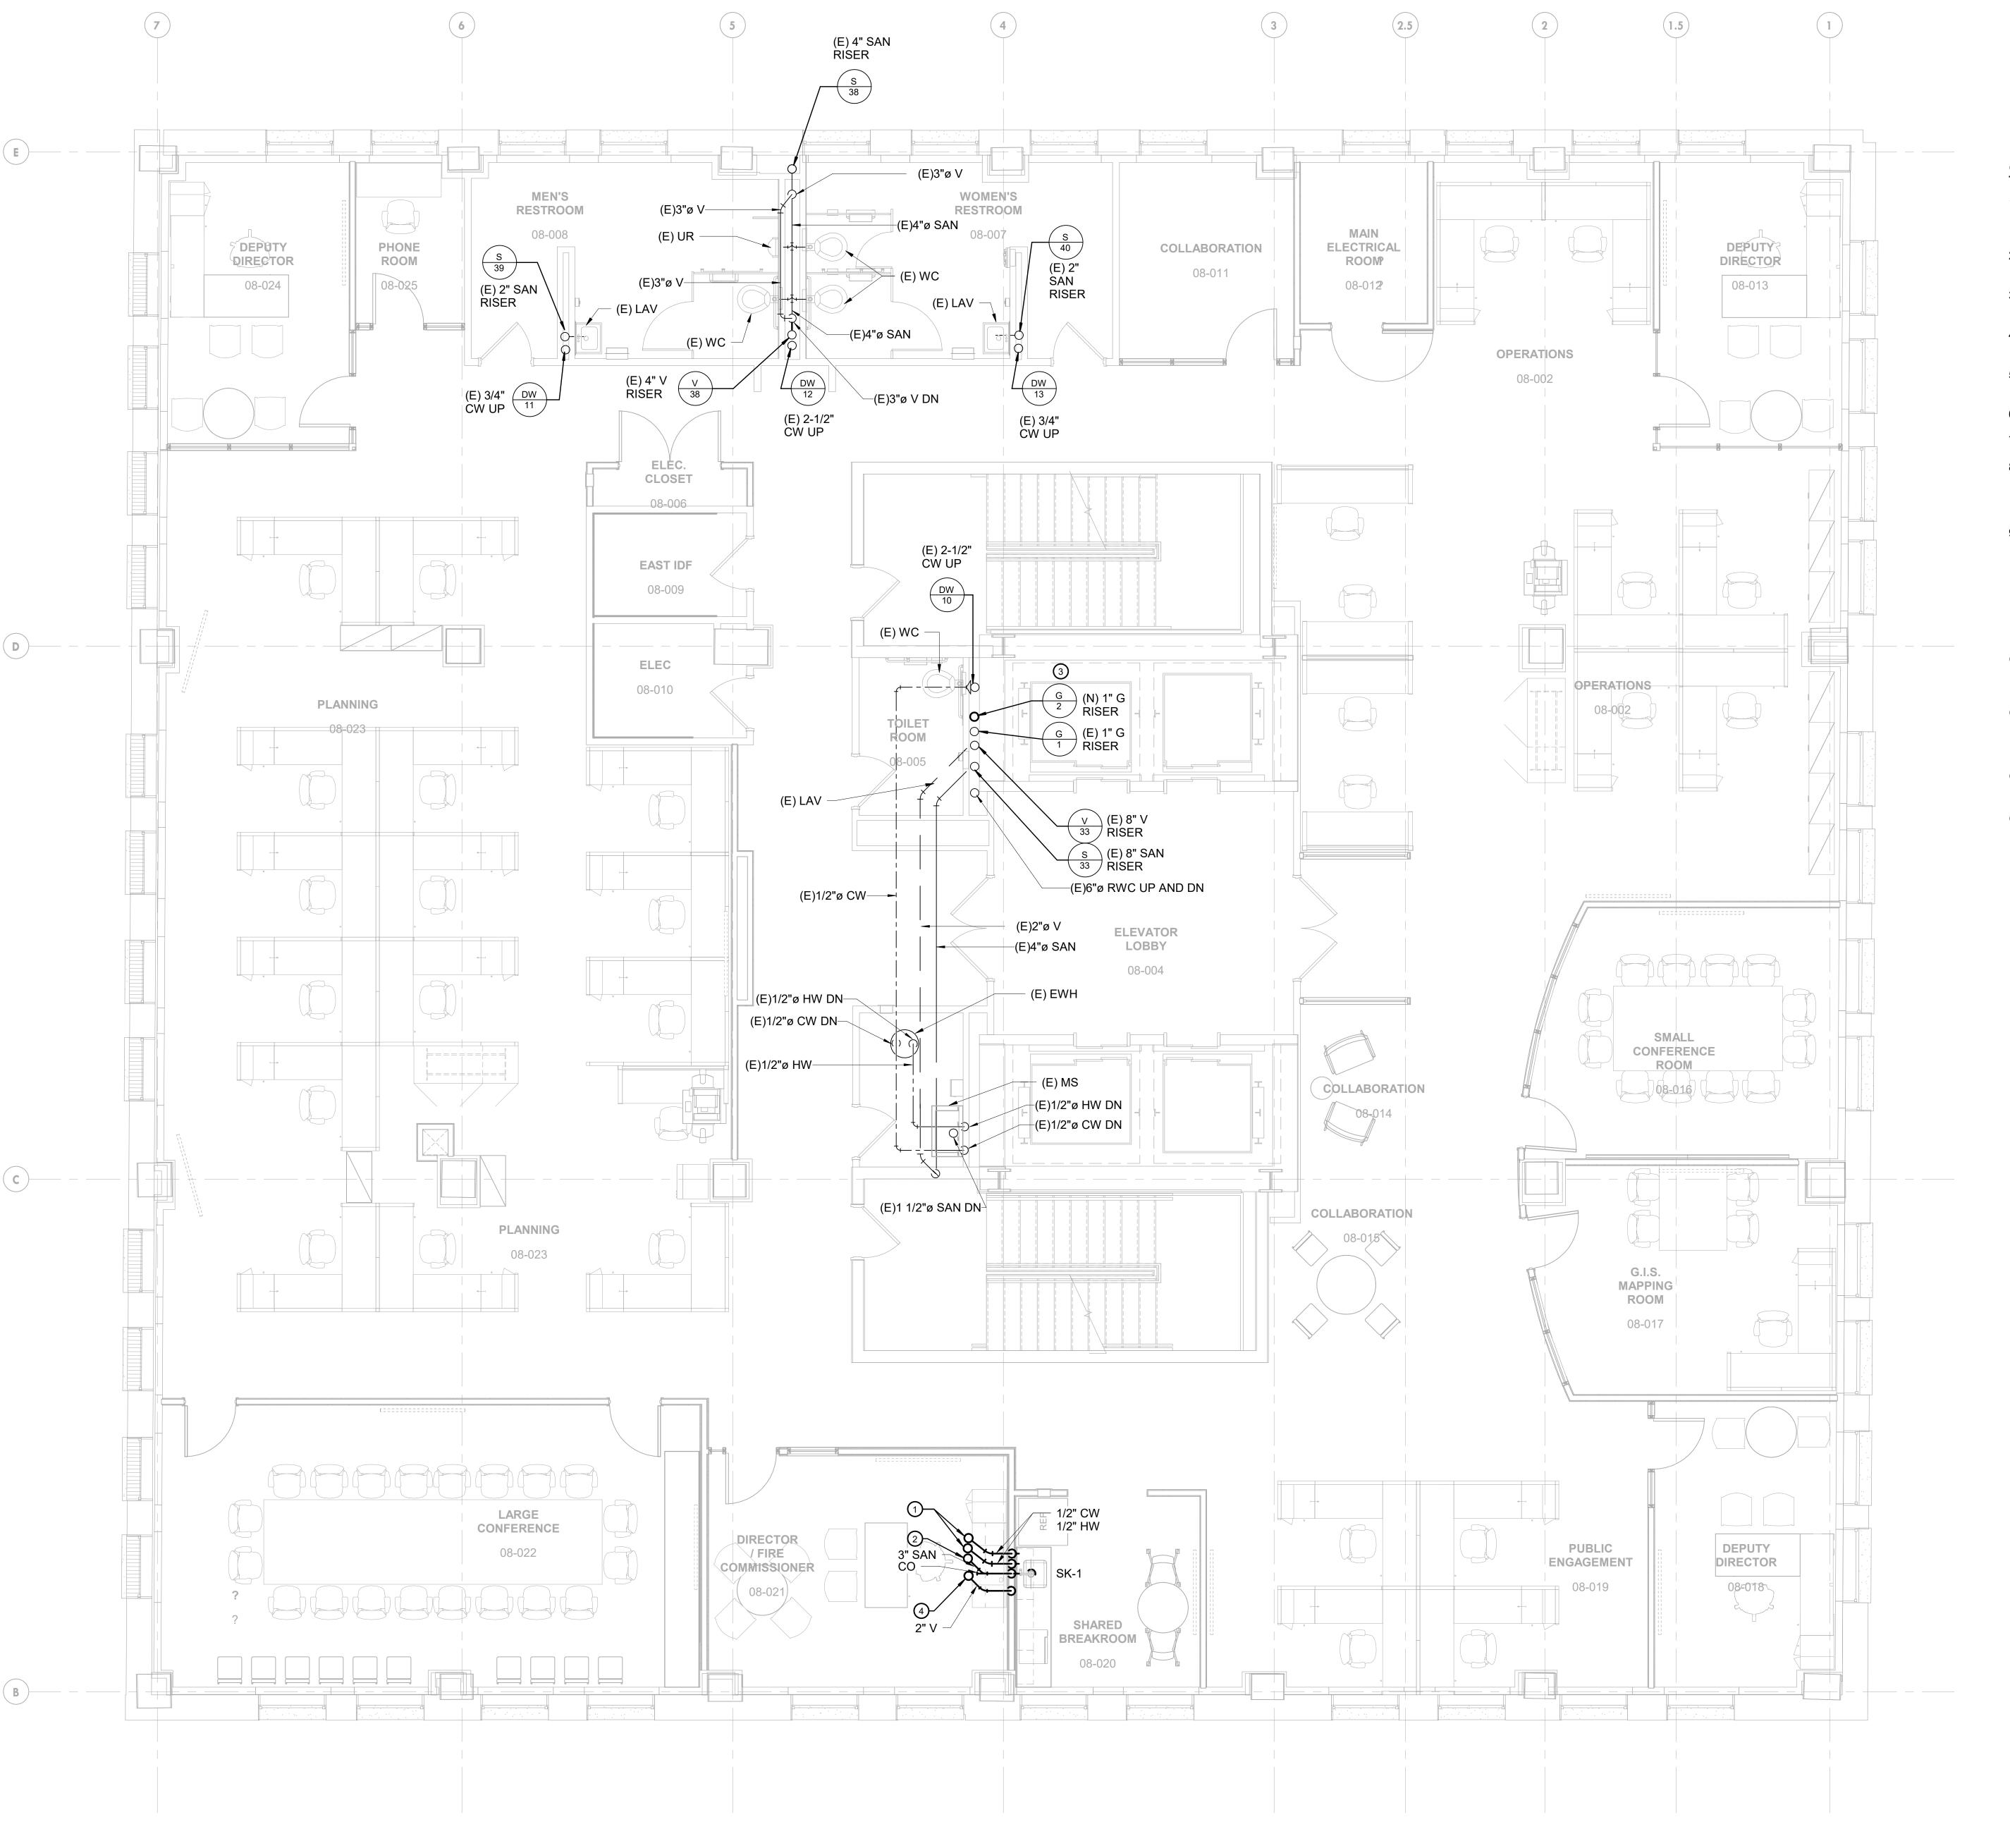

1) PLUMBING NEW WORK PLAN - EIGHTH FLOOR 1/4" = 1'-0"

GENERAL NOTES:

- 1. REFER TO DRAWING P-001 FOR PLUMBING SYMBOLS, ABBREVIATIONS, GENERAL NOTES, PLUMBING DEMOLITION NOTES AND PLUMBING NOTES.
- REFER TO DRAWINGS PD-108, PD-109 AND PD-110 FOR PLUMBING DEMOLITION WORK.
- 3. REFER TO DRAWINGS P-108, P-109 AND P-110 FOR PLUMBING NEW WORK.
- 4. REFER TO DRAWING P-501 FOR SANITARY AND VENT RISER DIAGRAM.
- 5. REFER TO DRAWING P-502 FOR DOMESTIC WATER AND NATURAL GAS RISER DIAGRAM.
- REFER TO DRAWING P-601 FOR PLUMBING DETAILS.
- 7. REFER TO DRAWING P-701 FOR PLUMBING SCHEDULES.
- 8. PIPE SHOWN IN PLAN IS LOCATED FROM THE FLOOR TO DECK ABOVE. DOMESTIC WATER AND VENT ARE FOR FIXTURES ON THE INDICATED LEVEL. SANITARY PIPE SERVES FIXTURES FROM LEVEL ABOVE.
- 9. PIPE LOCATION SHOWN IN PLAN IS DIAGRAMATIC. COORDINATE PIPE IN CORRIDOR WITH MECHANICAL DUCTWORK, FIRE PROTECTION PIPE AND ELECTRICAL COMPONENTS.

KEYED NOTES:

- DOMESTIC COLD WATER AND HOT WATER TO BE SUPPLIED FROM LEVEL 10. REFER TO RISER FOR PIPE SIZE. OFFSET PIPE FOR BREAK ROOM SINK INTO WALL.
- 2 SANITARY PIPE DOWN FROM SK-1 ON LEVEL 9. REFER TO RISER FOR SIZE. SANITARY PIPE SHALL BE OFFSET TO WALL AT LEVEL 8 BREAK ROOM AND RUN TO TOILET ROOM RISER IN CHASE ON LEVEL 7.
- REFER TO GAS RISER FOR PIPE SIZING AND NOTES FOR NEW SERVICE TO NEW HVAC EQUIPMENT.
- VENT PIPE FROM SK-1 RUN IN WALL. REFER TO RISER DIAGRAM FOR SIZE. VENT PIPE SHALL BE OFFSET AND CONTINUE UP TO LEVEL 9.




IEI GROUP, LTD.
IEI ARCHITECTS, INC.

428 North 2nd Street Philadelphia, PA 19123 Telephone: 215.413.3700

CONSULTANTS:

ARORA

Arora Engineers, Inc. 61 Wilmington-West Chester Pike Chadds Ford, PA 19317 P (610) 459-7900

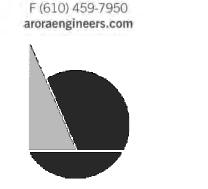

O'Donnell & Naccarato
701 Market Street, Suite 6000
Philadelphia, PA 19106
PH: 215.925.3788
www.o-n.com

PROFESSIONAL'S ELECTRONIC OR DIGITAL SEAL OR SIGNATURE IS VE ONLY AS TO THAT VERSION OF THIS DOCUMENT AS ORIGINALLY

DESIGN PROFESSIONAL'S ELECTRONIC OR DIGITAL SEAL OR SIGNATURE IS EFFECTIVE ONLY AS TO THAT VERSION OF THIS DOCUMENT AS ORIGINALLY PUBLISHED BY DESIGN PROFESSIONAL. DESIGN PROFESSIONAL IS NOT RESPONSIBLE FOR ANY SUBSEQUENT MODIFICATION, CORRUPTION, OR UNAUTHORIZED USE OF SUCH DOCUMENT. TO VERIFY THE VALIDITY OR

THE CITY OF PHILADELPHIA

OFFICE OF EMEGENCY MANAGEMENT

PHILADELPHIA PUBLIC SERVICES BUILDING

400 NORTH BROAD STREET, PHILADELPHIA, PA 19

FLOORS 8, 9 AND 10

□ PROGRESS SET

☐ CLIENT REVIEW
■ BID SET

□ CODE REVIEW SET□ ISSUED FOR CONSTRUCTION

ISSUED FOR BIDS 9/18/20

(NOT FOR CONSTRUCTION)


ISSUES/REVISIONS:

1 2020-09-18 ISSUED FOR BIDS
PROJECT NUMBER: 304103

PROJECT NUMBER: 304103-120
SCALE: As indicated and the second of the sec

PLUMBING 8TH
FLOOR NEW WORK
PLAN

P-108

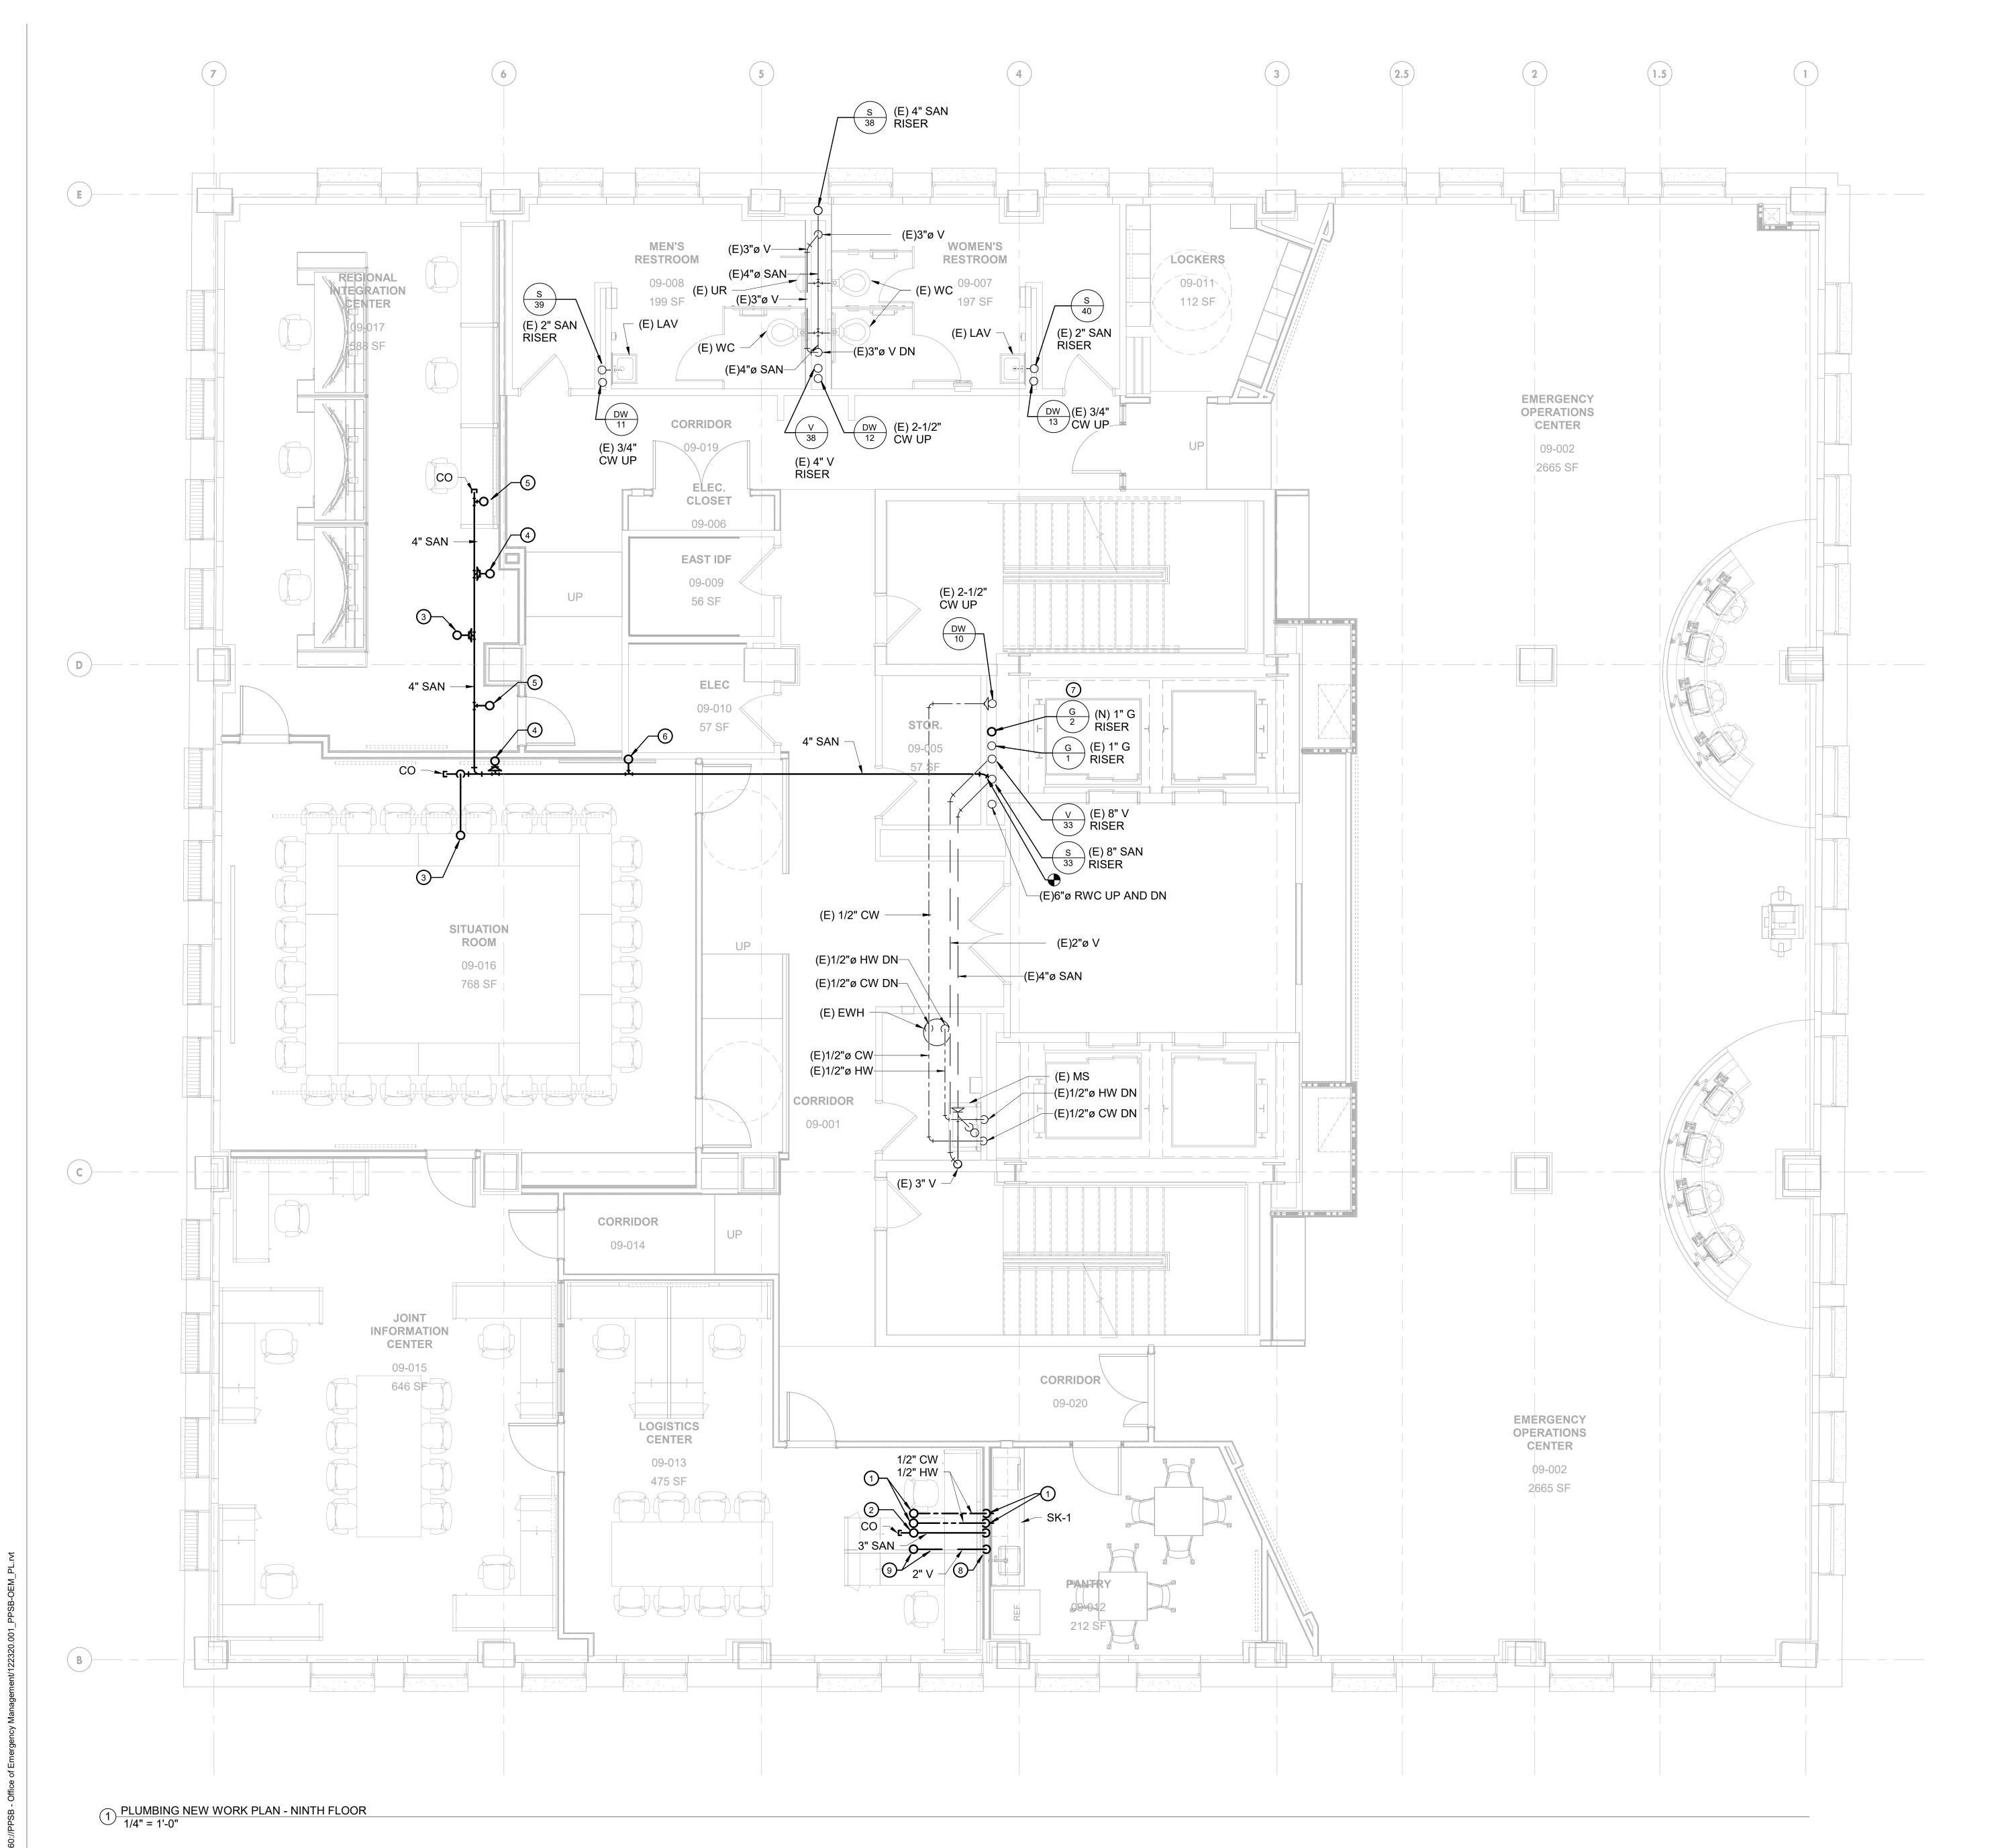

- 1. REFER TO DRAWING P-001 FOR PLUMBING SYMBOLS, ABBREVIATIONS, GENERAL NOTES, PLUMBING DEMOLITION NOTES AND PLUMBING NOTES.
 - 2. REFER TO DRAWINGS PD-108, PD-109 AND PD-110 FOR PLUMBING DEMOLITION WORK.
 - REFER TO DRAWINGS P-108, P-109 AND P-110 FOR PLUMBING NEW WORK.
- 4. REFER TO DRAWING P-501 FOR SANITARY AND VENT RISER DIAGRAM.
- REFER TO DRAWING P-502 FOR DOMESTIC WATER AND NATURAL GAS RISER DIAGRAM.
- 6. REFER TO DRAWING P-601 FOR PLUMBING DETAILS.
- REFER TO DRAWING P-701 FOR PLUMBING SCHEDULES.
- 8. PIPE SHOWN IN PLAN IS LOCATED FROM THE FLOOR TO DECK ABOVE. DOMESTIC WATER AND VENT ARE FOR FIXTURES ON THE INDICATED LEVEL. SANITARY PIPE SERVES FIXTURES FROM LEVEL ABOVE.
- 9. PIPE LOCATION SHOWN IN PLAN IS DIAGRAMATIC.
 COORDINATE PIPE IN CORRIDOR WITH MECHANICAL
 DUCTWORK, FIRE PROTECTION PIPE AND ELECTRICAL
 COMPONENTS.

KEYED NOTES:

- DOMESTIC COLD WATER AND HOT WATER TO BE SUPPLIED FROM LEVEL 10. REFER TO RISER FOR PIPE SIZE. OFFSET PIPE FOR BREAK ROOM SINK INTO WALL.
- 2 COMMON DRAIN DOWN FROM LEVEL 10 SK-1 SINK IN LACTATION ROOM AND SK-1 SINK IN BREAK ROOM. OFFSET SANITARY PIPE INTO WALL OF LEVEL 9 BREAK ROOM. REFER TO RISER FOR SANITARY PIPE SIZE.
- 3 DRAIN DOWN FROM LEVEL 10 SH-1 IN SHOWER ROOM.
- drain down from Level 10 Lav-1 in Shower Room.
- DRAIN DOWN FROM LEVEL 10 WC-1 IN SHOWER ROOM.
- DRAIN DOWN FROM LEVEL 10 SINGLE OCCUPANT TOILET ROOM CHASE.
- REFER TO GAS RISER FOR PIPE SIZING AND NOTES FOR NEW SERVICE TO NEW HVAC EQUIPMENT.
- 8 VENT PIPE FROM SK-1 RUN IN WALL. REFER TO RISER DIAGRAM FOR SIZE.
- OFFSET VENT PIPE AND CONTINUE UP TO LEVEL 10.



IEI GROUP, LTD.
IEI ARCHITECTS, INC.

428 North 2nd Street Philadelphia, PA 19123 Telephone: 215.413.3700

CONSULTANTS:


ARORA

Arora Engineers, Inc.
61 Wilmington-West Chester Pike
Chadds Ford, PA 19317





O'Donnell & Naccarato
01 Market Street, Suite 6000
Philadelphia, PA 19106
PH: 215.925.3788
www.o-n.com

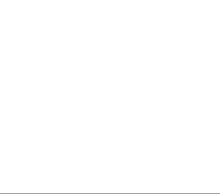

DESIGN PROFESSIONAL'S ELECTRONIC OR DIGITAL SEAL OR SIGNATURE IS EFFECTIVE ONLY AS TO THAT VERSION OF THIS DOCUMENT AS ORIGINALLY PUBLISHED BY DESIGN PROFESSIONAL. DESIGN PROFESSIONAL IS NOT RESPONSIBLE FOR ANY SUBSEQUENT MODIFICATION, CORRUPTION, OR UNAUTHORIZED USE OF SUCH DOCUMENT. TO VERIFY THE VALIDITY OR

ITY OF PHILADELPHIA E OF EMEGENCY MANAGEMENT DELPHIA PUBLIC SERVICES BUILDING ORTH BROAD STREET, PHILADELPHIA, F RS 8, 9 AND 10

- □ PROGRESS SET
- □ CLIENT REVIEW■ BID SET

□ CODE REVIEW SET□ ISSUED FOR CONSTRUCTION

ISSUED FOR BIDS 9/18/20

(NOT FOR CONSTRUCTION)


ISSUES/REVISIONS:
1 2020-09-18 ISSUED FOR BIDS

PROJECT NUMBER: 304103-120 OC SCALE: As indicated DATE: 07/07/2020 DRAWN BY: DG CHECKED BY: DJM

PLUMBING 9TH
FLOOR NEW WORK
PLAN

LAIN

P-109

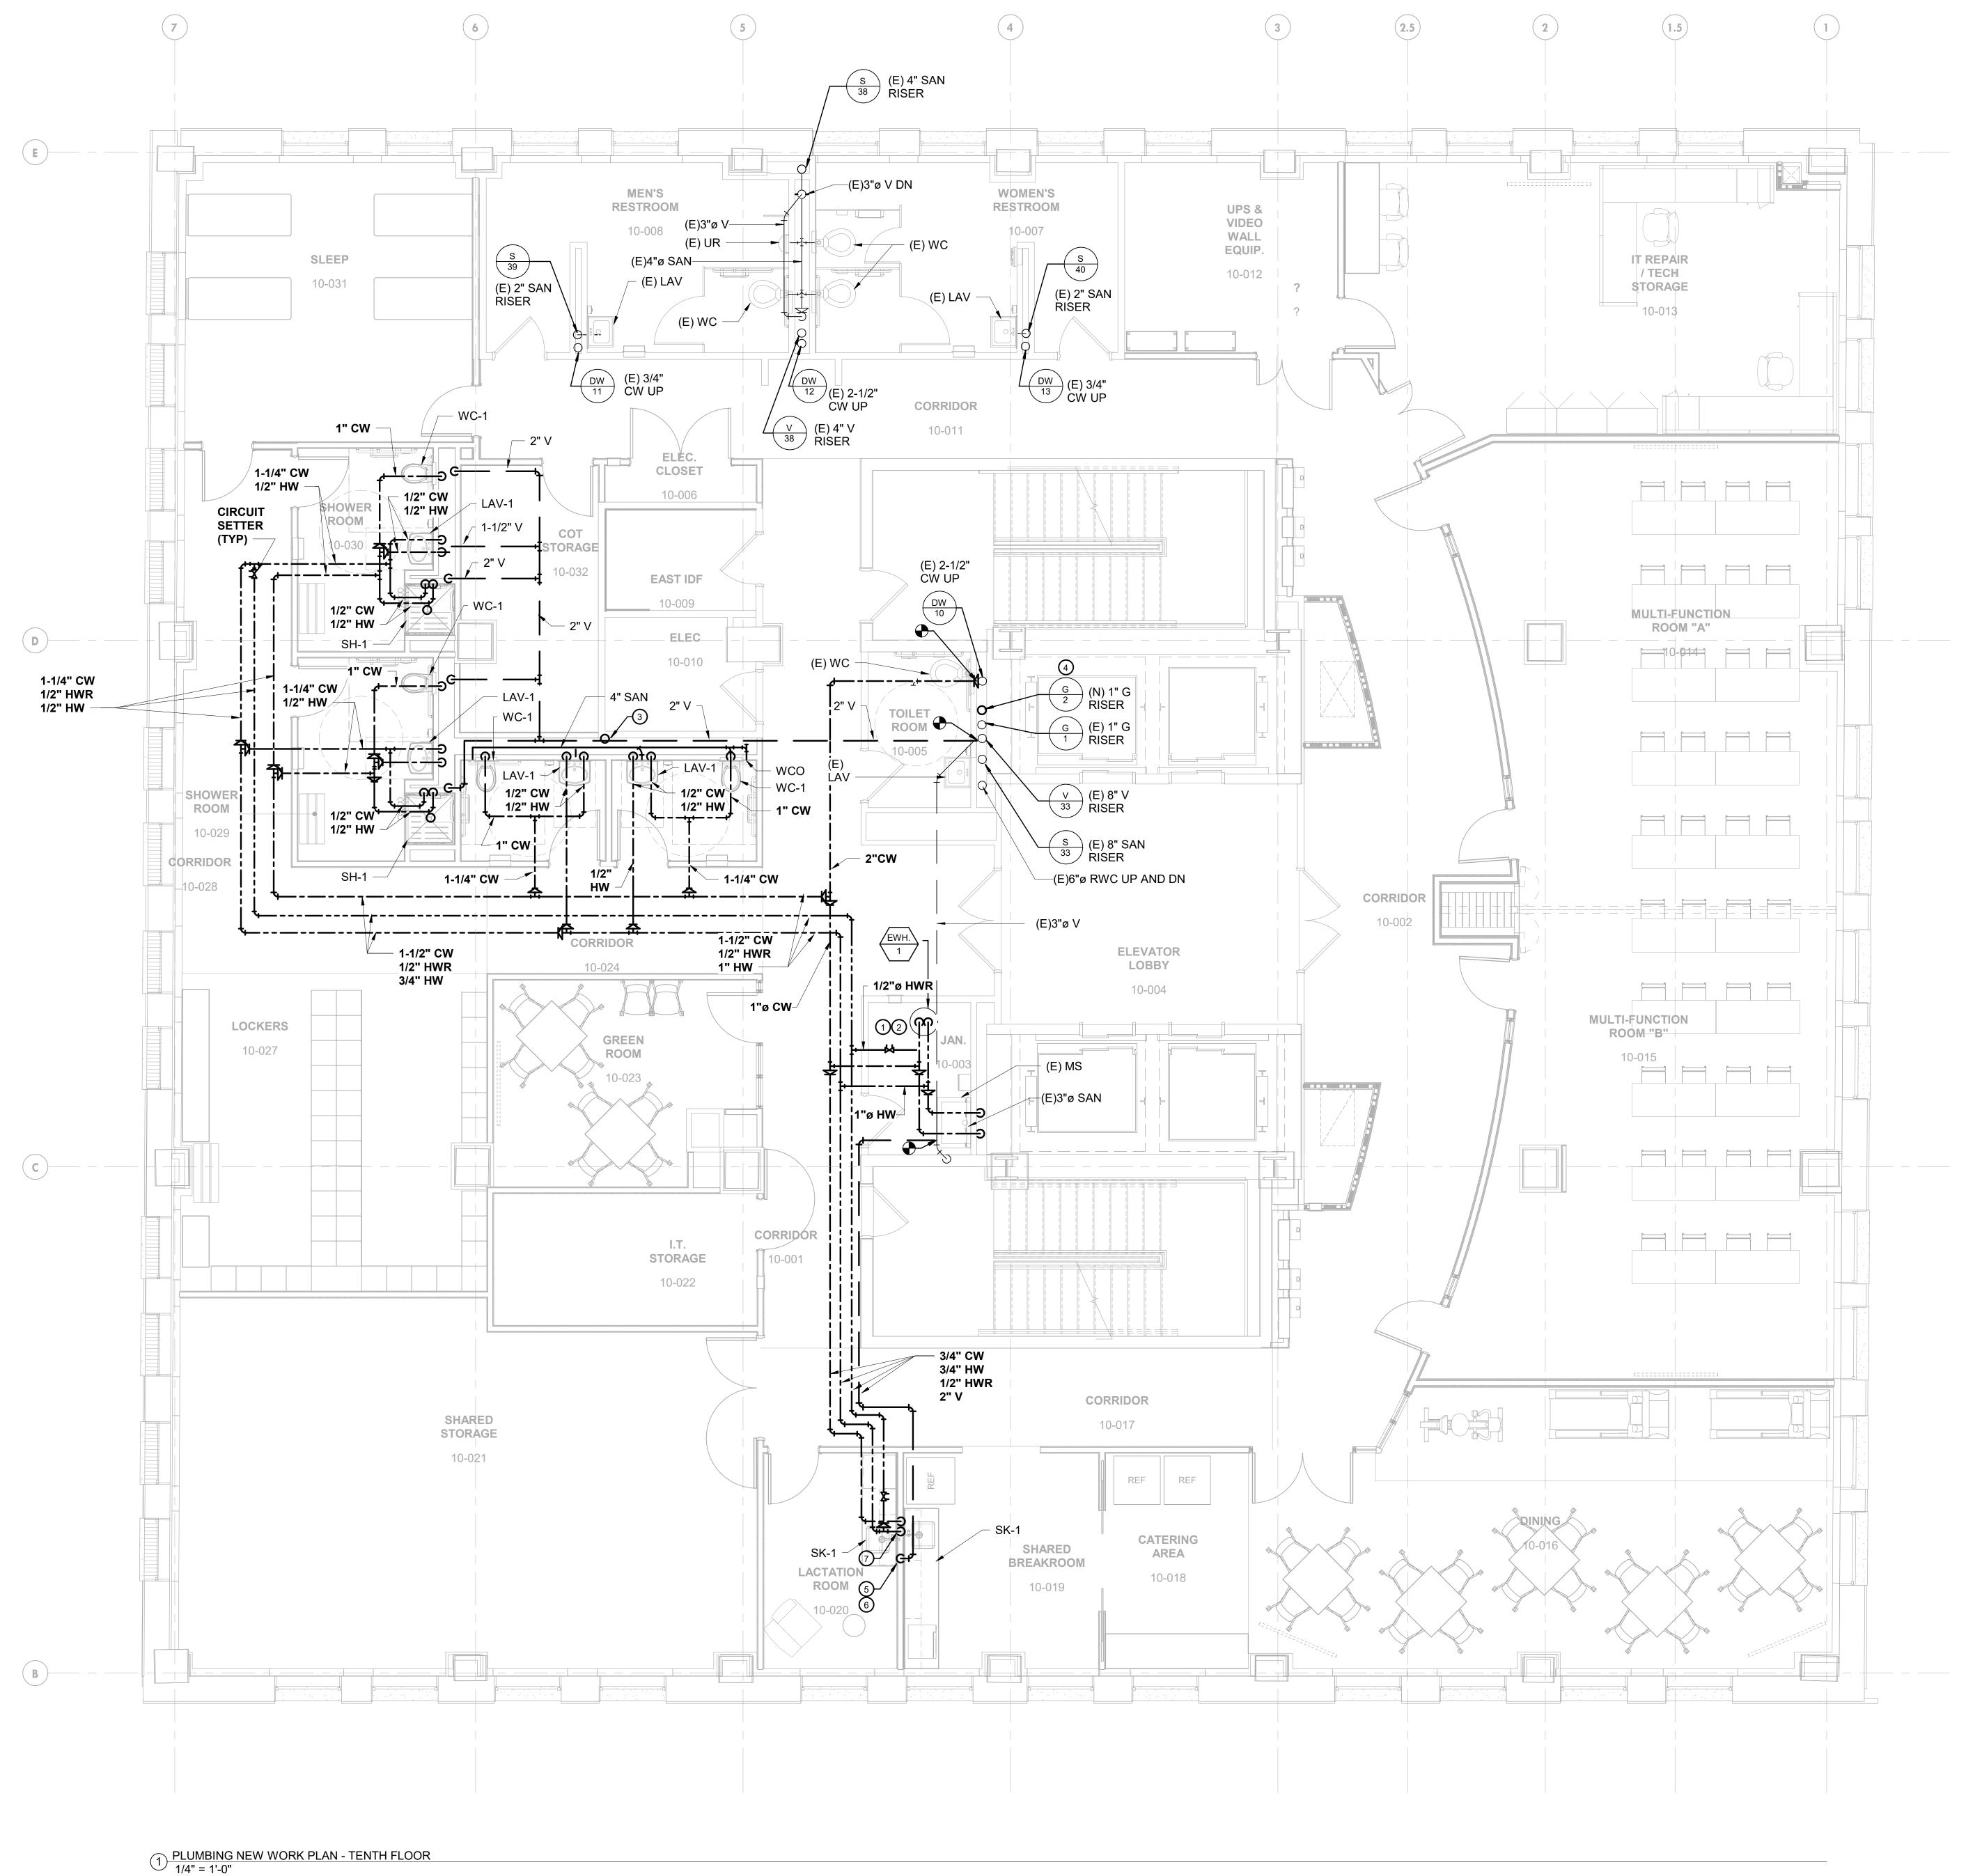



- REFER TO DRAWING P-001 FOR PLUMBING SYMBOLS, ABBREVIATIONS, GENERAL NOTES, PLUMBING DEMOLITION NOTES AND PLUMBING NOTES.
- REFER TO DRAWINGS PD-108, PD-109 AND PD-110 FOR PLUMBING DEMOLITION WORK.
- REFER TO DRAWINGS P-108, P-109 AND P-110 FOR PLUMBING NEW WORK.
- REFER TO DRAWING P-501 FOR SANITARY AND VENT RISER DIAGRAM.
- REFER TO DRAWING P-502 FOR DOMESTIC WATER AND NATURAL GAS RISER DIAGRAM.
- REFER TO DRAWING P-601 FOR PLUMBING DETAILS.
- REFER TO DRAWING P-701 FOR PLUMBING SCHEDULES.
- PIPE SHOWN IN PLAN IS LOCATED FROM THE FLOOR TO DECK ABOVE. DOMESTIC WATER AND VENT ARE FOR FIXTURES ON THE INDICATED LEVEL. SANITARY PIPE SERVES FIXTURES FROM LEVEL ABOVE.
- PIPE LOCATION SHOWN IN PLAN IS DIAGRAMATIC. COORDINATE PIPE IN CORRIDOR WITH MECHANICAL DUCTWORK, FIRE PROTECTION PIPE AND ELECTRICAL COMPONENTS.

KEYED NOTES:

- PROVIDE RECIRCULATION PUMP RP-1 FOR HOT WATER RETURN TO ELECTRIC WATER HEATER EWH-2.
- NEW EWH-1 SHALL BE PLACED ON A CONCRETE PAD PER DETAIL 4, DRAWING P-601.
- CONNECT FIXTURES TO PIPE IN CHASE. DROP TO FLOOR BELOW.
- REFER TO GAS RISER FOR PIPE SIZING AND NOTES FOR NEW SERVICE TO NEW HVAC EQUIPMENT.
- VENT PIPE FROM SK-1 RUN IN WALL. REFER TO RISER

DIAGRAM FOR SIZE.

- COMMON DRAIN FROM LACTATION ROOM AND BREAK ROOM SINK CONTINUED TO LEVEL 9. REFER TO RISER FOR PIPE SIZE.
- DOMESTIC COLD WATER AND HOT WATER SHALL RUN DOWN IN WALL AND OFFSET TO LEVELS BELOW.




IEI GROUP, LTD. IEI ARCHITECTS, INC.

428 North 2nd Street Philadelphia, PA 19123 Telephone: 215.413.3700

CONSULTANTS: ARORA

Arora Engineers, Inc. 61 Wilmington-West Chester Pike Chadds Ford, PA 19317 P (610) 459-7900 F (610) 459-7950

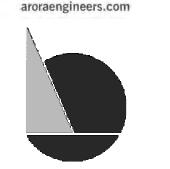

O'Donnell & Naccarato 701 Market Street, Suite 6000 Philadelphia, PA 19106 PH: 215.925.3788 www.o-n.com

EFFECTIVE ONLY AS TO THAT VERSION OF THIS DOCUMENT AS ORIGINALLY PUBLISHED BY DESIGN PROFESSIONAL. DESIGN PROFESSIONAL IS NOT RESPONSIBLE FOR ANY SUBSEQUENT MODIFICATION, CORRUPTION, OR UNAUTHORIZED USE OF SUCH DOCUMENT. TO VERIFY THE VALIDITY OR

☐ PROGRESS SET ☐ CLIENT REVIEW

■ BID SET ☐ CODE REVIEW SET ☐ ISSUED FOR CONSTRUCTION

ISSUED FOR BIDS 9/18/20

(NOT FOR CONSTRUCTION) ISSUES/REVISIONS:

1 2020-09-18 ISSUED FOR BIDS PROJECT NUMBER: SCALE: DATE:

DRAWN BY: CHECKED BY: DRAWING TITLE:

PLUMBING 10TH FLOOR NEW WORK PLAN

P-110

PRINTED ON:

2020-09-21 12:25:29

LEAVES

2620 FU

IEI GROUP, LTD. IEI ARCHITECTS, INC. 428 North 2nd Street


Philadelphia, PA 19123 Telephone: 215.413.3700

CONSULTANTS:

Arora Engineers, Inc. 61 Wilmington-West Chester Pike Chadds Ford, PA 19317 P (610) 459-7900 F (610) 459-7950 aroraengineers.com



O'Donnell & Naccarato 701 Market Street, Suite 6000 Philadelphia, PA 19106 PH: 215.925.3788 www.o-n.com

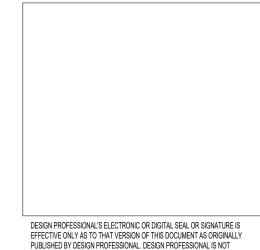

DESIGN FROPESSIONAL SELECTIONS OF THIS DOCUMENT AS ORIGINALLY
PUBLISHED BY DESIGN PROFESSIONAL. DESIGN PROFESSIONAL IS NOT
RESPONSIBLE FOR ANY SUBSEQUENT MODIFICATION, CORRUPTION, OR
UNAUTHORIZED USE OF SUCH DOCUMENT. TO VERIEY THE VALIDITY OR APPLICABILITY OF THE SEAL OR SIGNATURE, CONTACT DESIGN PROFESSIONAL.

THE CITY OFFICE COFFICE COFFICE COFFICE COFFICE COORS

☐ PROGRESS SET ☐ CLIENT REVIEW

■ BID SET ☐ CODE REVIEW SET

☐ ISSUED FOR CONSTRUCTION ISSUED FOR

BIDS 9/18/20 (NOT FOR CONSTRUCTION)

ISSUES/REVISIONS:

1 2020-09-18 ISSUED FOR BIDS


PROJECT NUMBER: SCALE: NOT TO SCALE DATE: 07/07/2020 DRAWN BY: CHECKED BY:

DRAWING TITLE: SANITARY PLUMBING RISER

DIAGRAM

SHEET NO:

P-501

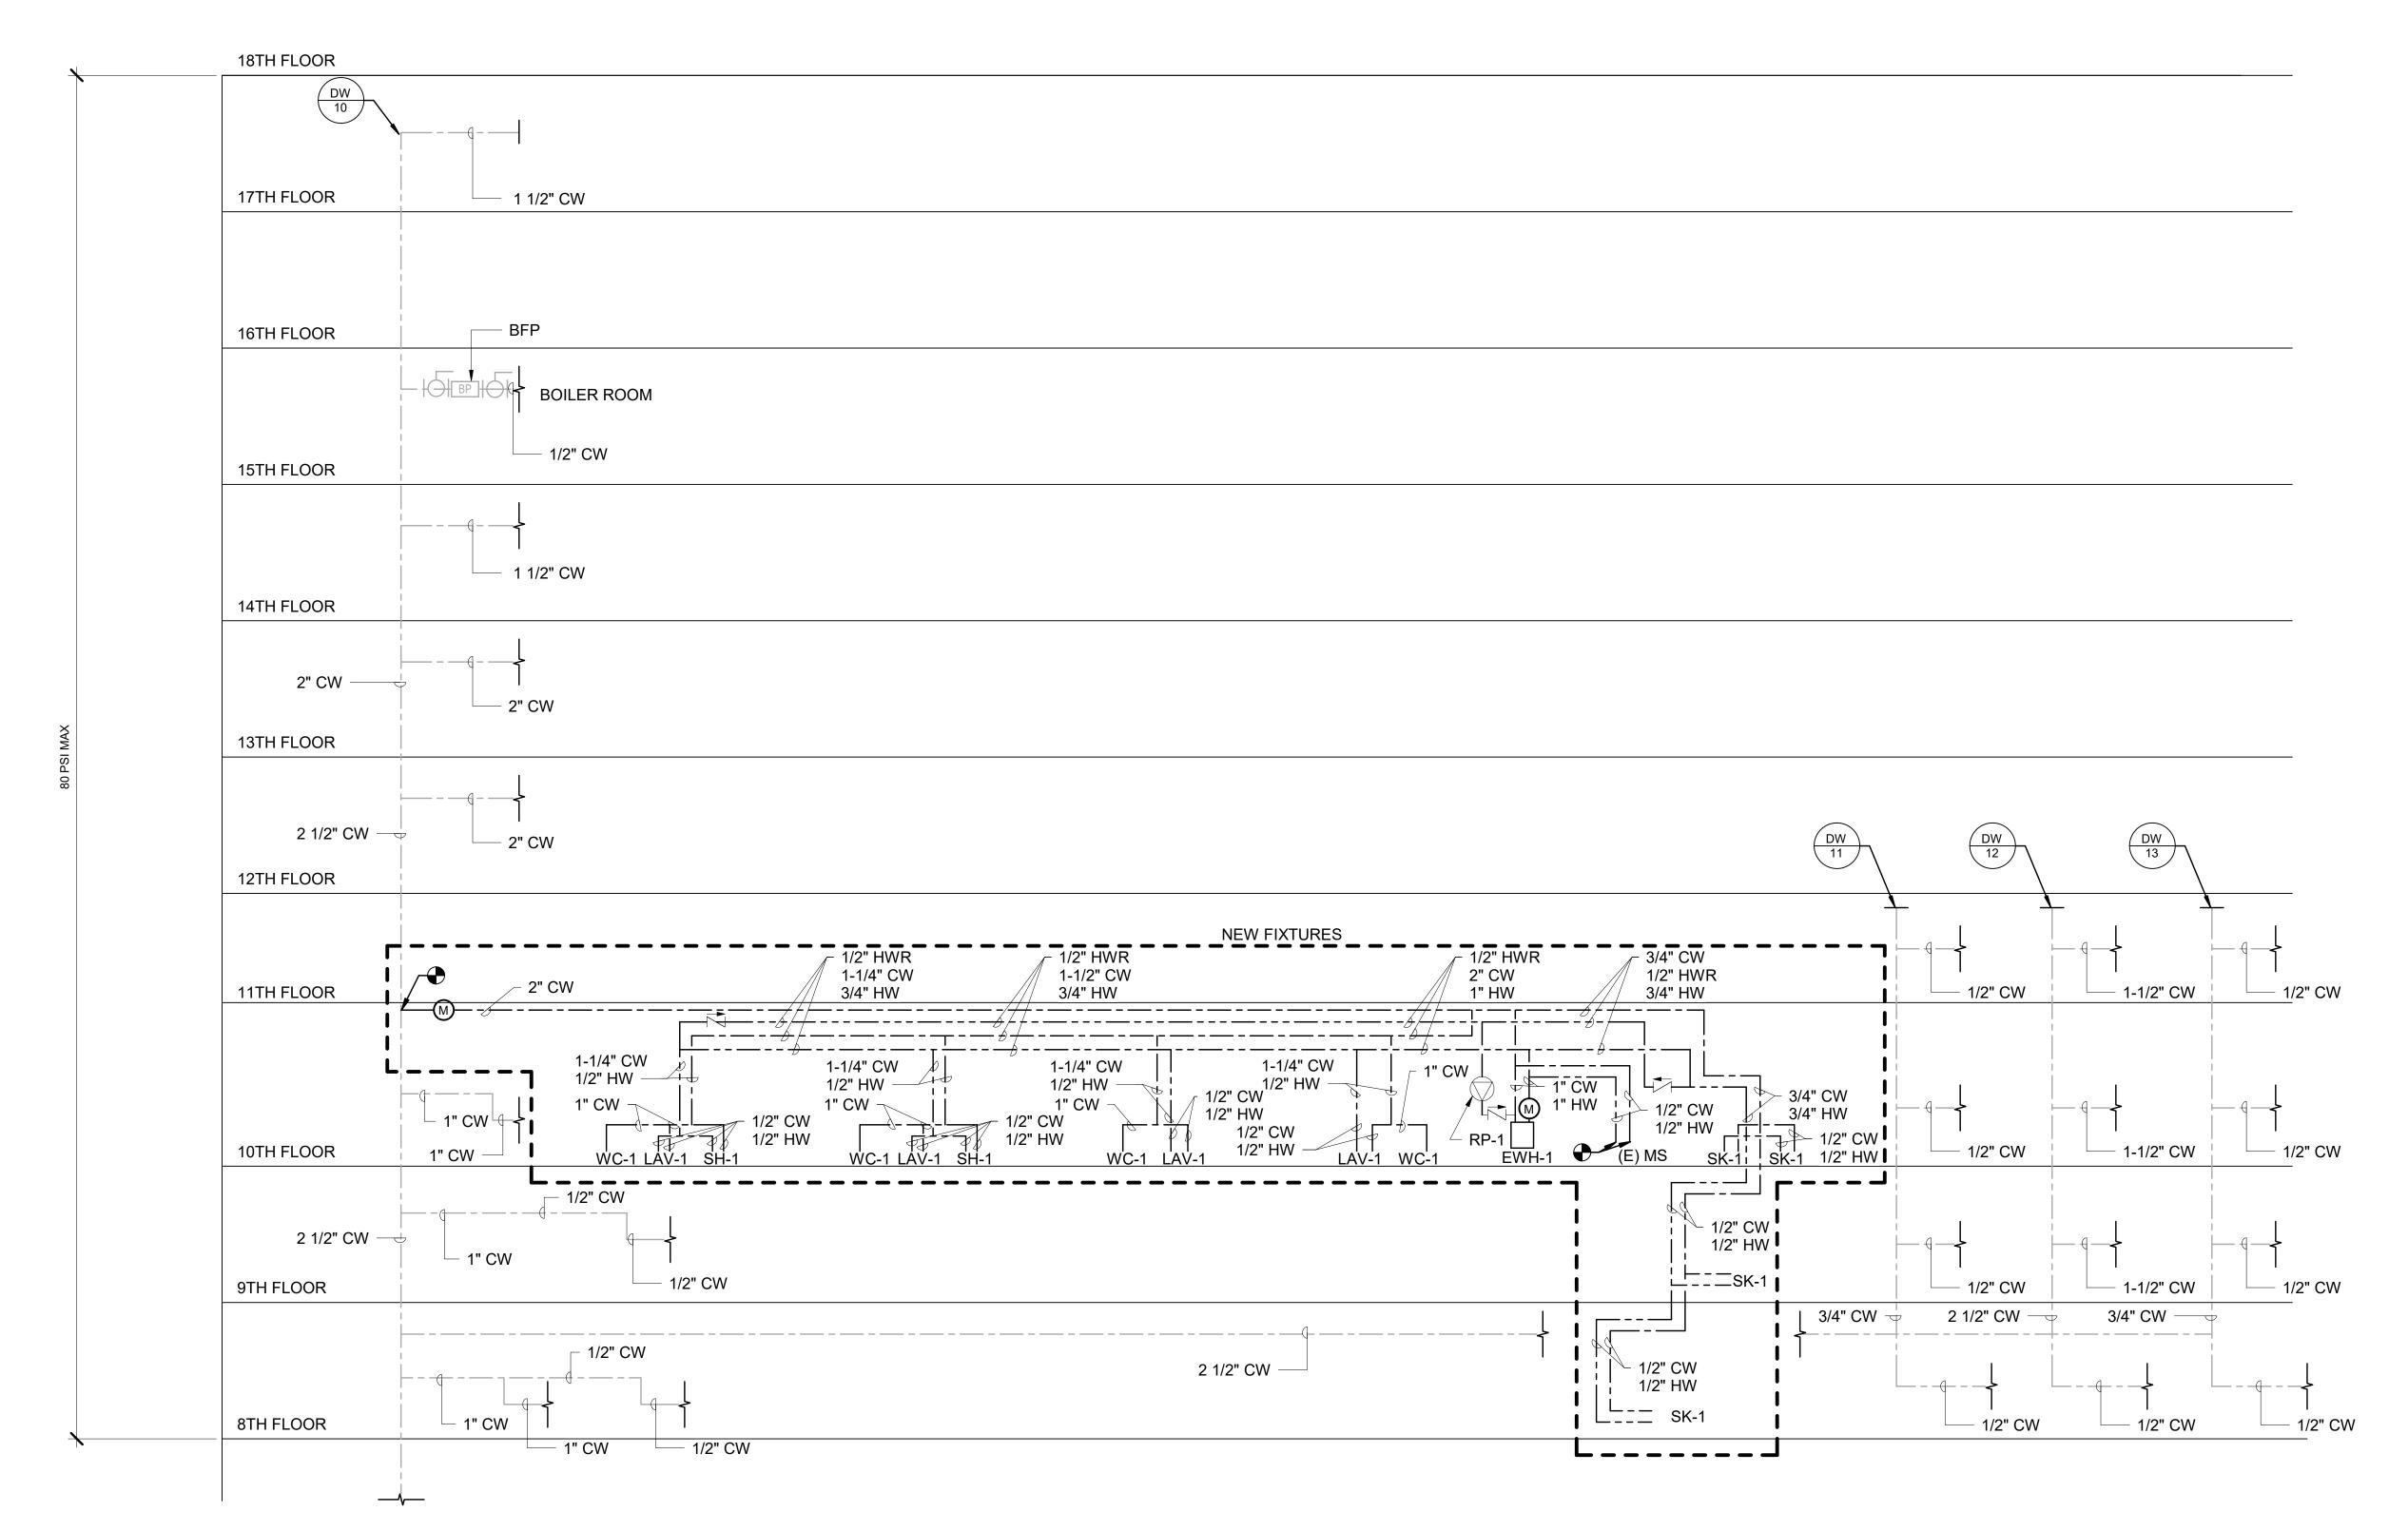

- CONTRACTOR SHALL PROVIDE SHUT OFF VALVES AT EACH FIXTURE LOCATION AND AT BRANCH TAKE-OFFS.
- 2. CONTRACTOR SHALL PROVIDE WATER HAMMER ARRESTORS PER PLUMBING DRAINAGE INSTITUTE GUIDELINES.

1 DOMESTIC WATER RISER DIAGRAM NOT TO SCALE

18TH FLOOR 17TH FLOOR PRESSURE (E) BOILER REGULATOR 400 MBH -2 PSI TO 7" W.C. 16TH FLOOR **EXISTING** DEVELOPED LENGTH = 750 FEET - 1" G 15TH FLOOR **NEW HVAC** @ 2 PSI DEVELOPED LENGTH = 725 FEET PRESSURE REGULATOR 2 PSI TO 10" W.C. — (N) DOAS 300 MBH 14TH FLOOR @ 2 PSI SEE DETAIL 9, P-601 FOR PGW DRIP LEG REQUIREMENTS (E) 1" G @ 2 PSI -- (N) 1" G @ 2 PSI 13TH FLOOR 12TH FLOOR 11TH FLOOR 10TH FLOOR 9TH FLOOR - (N) 1" G @ 2 PSI (E) 1" G @ 2 PSI 8TH FLOOR 9100 MBH FOR CONNECTED EQUIPMENT LOCATED IN BASEMENT THROUGH LOW ROOF

2 PLUMBING GAS RISER DIAGRAM NOT TO SCALE

(EXISTING) GAS PIPING CALCULATION NEW									
GAS TYPE	INLET PRESSURE	PRESSURE DROP	SPECIFIC GRAVITY	LENGTH	TOTAL CONNECTED LOAD	PIPE SIZE	NEW DOAS LOAD	LENGTH	
NATURAL	2 PSI	1 PSI	0.60	750 FT	9500 MBH	3"	300 MBH @ 7" TO 14" W.C.	725 FT	

SIZED PER 2018 IFGC TABLE 402.4(5) FOR SCHEDULE 40 METALLIC PIPE.

ASSUMED DEVELOPED LENGTH OF PIPE FOR DOAS IS 25 FEET LESS THAN FOR BOILER LOCATED ON 16TH FLOOR.

BASED ON TABLE NOTED ABOVE, THE CONNECTED LOAD AND NEW LOAD FOR PROPOSED DOAS, THE EXISTING 1" GAS SERVICE RISER IS NOT ADEQUATE TO PROVIDE REQUIRED CUBIC FEET PER HOUR FOR BOTH THE BOILER ON THE 15TH FLOOR AND NEW DOAS LOCATED ON THE 14TH FLOOR.

KEEP EXISTING 1" GAS SERVICE RISER (AT 2 PSI) AND RUN A SECOND 1" GAS SERVICE RISER TO THE 14TH FLOOR FOR NEW DOAS SYSTEM.


PER FIELD SURVEY, EXISTING GAS METER HAS CAPACITY FOR 11,000 CUBIC FEET PER HOUR.




IEI GROUP, LTD. IEI ARCHITECTS, INC. 428 North 2nd Street

Philadelphia, PA 19123 Telephone: 215.413.3700 CONSULTANTS:

Arora Engineers, Inc. 61 Wilmington-West Chester Pike Chadds Ford, PA 19317 P (610) 459-7900 F (610) 459-7950

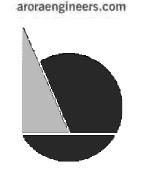

<u>O'Donnell & Naccarato</u> 701 Market Street, Suite 6000 Philadelphia, PA 19106 PH: 215.925.3788 www.o-n.com

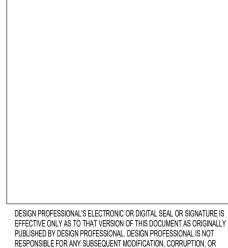

RESPONSIBLE FOR ANY SUBSEQUENT MODIFICATION, CORRUPTION, OR UNAUTHORIZED USE OF SUCH DOCUMENT. TO VERIFY THE VALIDITY OR APPLICABILITY OF THE SEAL OR SIGNATURE, CONTACT DESIGN PROFESSIONAL

☐ PROGRESS SET ☐ CLIENT REVIEW

■ BID SET ☐ CODE REVIEW SET ☐ ISSUED FOR CONSTRUCTION

> ISSUED FOR 9/18/20

ISSUES/REVISIONS:

(NOT FOR CONSTRUCTION)

1 2020-09-18 ISSUED FOR BIDS

PROJECT NUMBER: SCALE: NOT TO SCALE DATE: 07/07/2020 DRAWN BY: CHECKED BY:


DRAWING TITLE: **PLUMBING** DOMESTIC AND NATURAL GAS RISER DIAGRAM

SHEET NO:


P-502

SANITARY WASTE PIPE FERRULE SLOTTED HEAD TAPPED PLUG POLISHED STAINLESS-STEEL COVER ON PLANS) FINISHED WALL NO-HUB" CLAMP ASSEMBLY (TYPICAL)

SANITARY TEE (SIZE AS NOTED WALL CLEANOUT DETAIL NOT TO SCALE

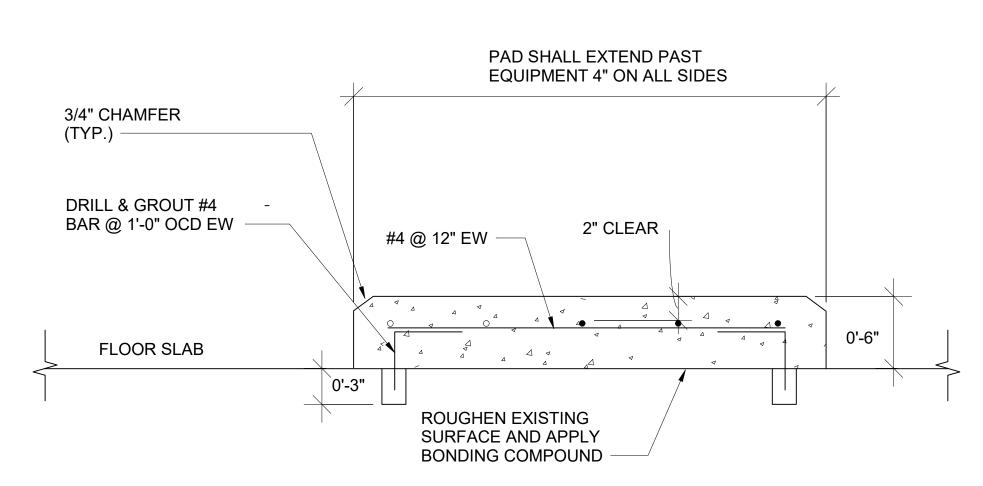


4 CONCRETE PAD DETAIL NOT TO SCALE

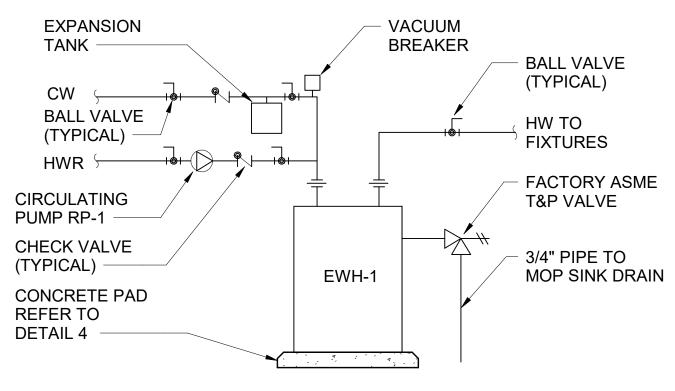


ALL PIPING TO BE RUN TO PREVENT TRIPPING HAZARD. PROVIDE HOUSEKEEPING PAD FOR WATER HEATERS MOUNTED ON FLOOR.

EWH-1 SHALL HAVE RP-1 FOR HOT WATER RECIRCULATION. SECURE WATER HEATER PER MANUFACTURER'S INSTALLATION INSTRUCTIONS.

7 WATER HEATER PIPING DETAIL NOT TO SCALE

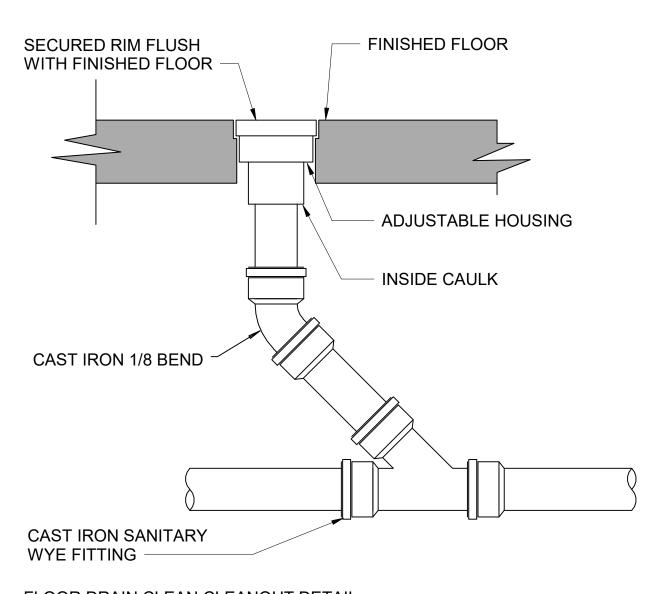

5 FLOOR DRAIN CLEAN CLEANOUT DETAIL NOT TO SCALE

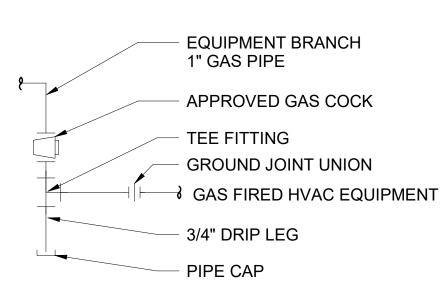



NOTE:

- 1. PROVIDE DRIP LEG IN GAS PIPING AT EACH EQUIPMENT CONNECTION.
- 2. DRIP LEG MUST BE ACCESSIBLE FOR MAINTENANCE.
- MINIMUM LENGTH OF DRIP LEG SHALL BE 3".
- 4. PROVIDE DRIP LEG / SEDIMENT TRAP AT EQUIPMENT. A. DOWNSTREAM OF EQUIPMENT SHUTOFF VALVE, AND CLOSE TO EQUIPMENT INLET.
 - TRAP MAY BE TEE FITTING WITH CAPPED NIPPLE IN THE BOTTOM OPENING OF THE RUN OF THE TEE.

EQUIPMENT CONN PIPE SIZE (DIAMET	
UNDER 3/4"	FULL SIZE
3/4" TO 1"	3/4"
2"	1"
3"	1-1/2" OR 3"
4"	2" OR 4"
	INSTALLATION MANUAL E 1, SECTION 1.5 DRIPS

8 GAS CONNECTION DETAIL NOT TO SCALE

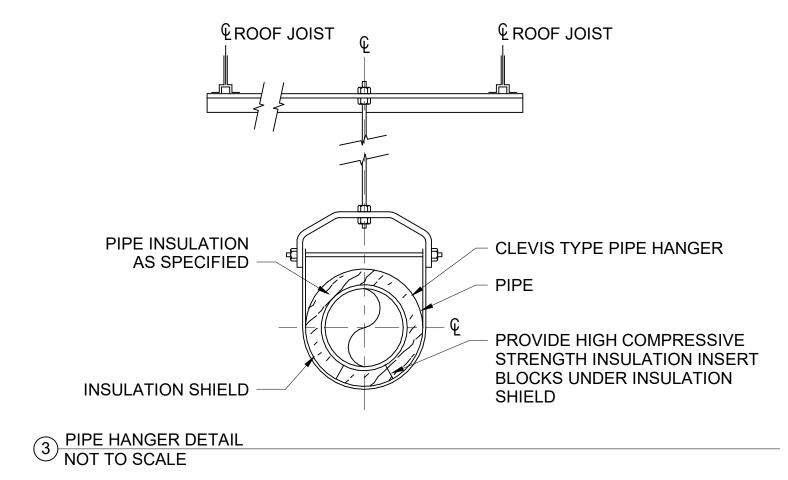

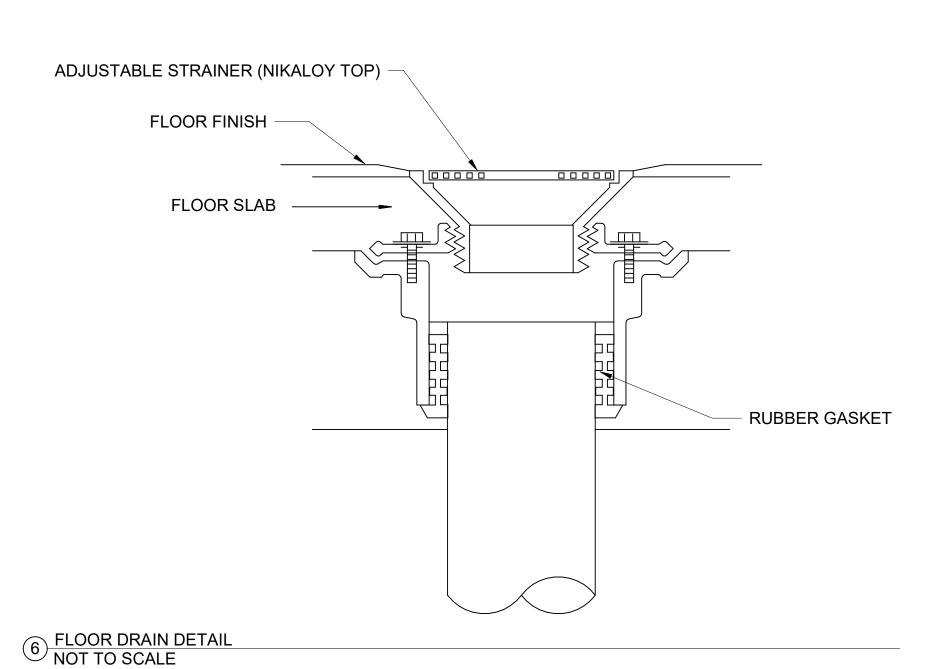

IEI GROUP, LTD. IEI ARCHITECTS, INC. 428 North 2nd Street Philadelphia, PA 19123

Telephone: 215.413.3700

CONSULTANTS:

Arora Engineers, Inc. 61 Wilmington-West Chester Pike Chadds Ford, PA 19317 P (610) 459-7900 F (610) 459-7950



<u>O'Donnell & Naccarato</u> 701 Market Street, Suite 6000 Philadelphia, PA 19106 PH: 215.925.3788 www.o-n.com

EFFECTIVE ONLY AS TO THAT VERSION OF THIS DOCUMENT AS ORIGINALLY PUBLISHED BY DESIGN PROFESSIONAL. DESIGN PROFESSIONAL IS NOT RESPONSIBLE FOR ANY SUBSEQUENT MODIFICATION, CORRUPTION, OR UNAUTHORIZED USE OF SUCH DOCUMENT. TO VERIEY THE VALIDITY OR

☐ PROGRESS SET

☐ CLIENT REVIEW ■ BID SET

☐ CODE REVIEW SET ☐ ISSUED FOR CONSTRUCTION

> ISSUED FOR 9/18/20

(NOT FOR CONSTRUCTION)

ISSUES/REVISIONS: 1 2020-09-18 ISSUED FOR BIDS

PROJECT NUMBER: SCALE: As indicated DATE: 07/07/2020 DRAWN BY: CHECKED BY:

DRAWING TITLE: **PLUMBING** DETAILS

SHEET NO:

P-601

			PLUM	BING F	FIXTUF	RES AI	ND SP	ECIALTIES	SSCHEDULE	
TAG	DESCRIPTION	LOCATION	MANUFACTURER MODEL NUMBER BASIS OF DESIGN	COLD WATER	HOT WATER	SAN	VENT	CAPACITY	ELECTRICAL REQUIREMENTS	NOTES
FD-1	FLOOR DRAIN	SHOWER ROOM	JAY R. SMITH 2010C ROUND TOP	N/A	N/A	3"	2"	N/A	N/A	PROVIDE NICKEL BRONZE HEEL PROOF GRATE AND BARRIER TYPE TRAP SEAL JAY R. SMITH 2692 OR SIMILAR THAT MEETS ASSE #1072.
WC-1	WATER CLOSET	SINGLE OCCUPANT TOILET ROOM	AMERICAN STANDARD AFWALL 2257.101	1"	N/A	4"	2"	1.28 GPF	EL - 154 120 VAC INPUT/24 VAC OUTPUT TRANSFORMER (HARD WIRED)	WALL MOUNTED WATER CLOSET, WITH SLOAN 111-1.28 OPTIMA DBF ESS TMO, HANDS FREE FLUSHOMETER PROVIDE PROFLO COMMERCIAL HEAVY DUTY TOILET SEAT PFTSCOF2000 WH.
LAV-1	WALL MOUNTED LAVATORY	SINGLE OCCUPANT TOILET ROOM AND SHOWER ROOM	AMERICAN STANDARD MURRO 0954.004EC	1/2"	1/2"	2"	1-1/2"	0.35 GPM	EL - 154 120 VAC INPUT/24 VAC OUTPUT TRANSFORMER (HARD WIRED)	WALL MOUNTED LAVATORY WITH SLOAN ETF-600-HLT-TEE-CP-0.35 GPM MLM IR FCT.
SH-1	SHOWER	SHOWER ROOM	FREEDOM ADA TRANSFER SHOWER MODEL APF3682BF75 ACRYLIC SHOWER, THREE WALLS, LESS CEILING	1/2"	1/2"	2"	1-1/2"	1.5 GPM	N/A	LEONARD 7600 SHOWER MASTER 76-3A H14 LOW FLOW SHOWER HEAD AND 501PG HAND SHOWER WITH SLIDE BAR. DIVERTER SHALL BE D2L FOR SWITCH FROM SHOWER HEAD TO HAND SHOWER. SHOWER SHALL BE PROVIDED WITH FOLDING SHOWER SEAT, GRAB BARS, SHOWER ROD, WEIGHTED CURTAIN, COLLAPSIBLE WATER RETAINER TO MEET ADA. SHOWER SHALL HAVE CAULKLESS DRAIN.
SK-1	SINK	BREAK ROOM, LACTATION ROOM	ELKAY ELUHAD211555, SINGLE BOWL UNDER MOUNT	1/2"	1/2"	2"	1-1/2"	1.5 GPM	N/A	18 GAUGE / 304 STAINLESS STEEL SINK, BOWL DEPTH TO MEET ADA. PROVIDE WITH PROFLOW BASKET STRAINER PF1432SS. BASIS OF DESIGN FAUCET SHALL BE HANDS FREE, KOHLER K22068. FAUCET SHALL BE HARD WIRED, ADA WITH SINGLE LEVER TEMPERATURE CONTROL. MAXIMUM FLOW RATE IS 1.5 GPM.

N	\cap	т	ᆮ	
1 1	\smile		ᆫ	

1. BASIS OF DESIGN CARRIERS INDICATED ABOVE DESCRIBE GENERAL REQUIREMENTS, ASSUMING SINGLE FIXTURES. ACTUAL SELECTION OF CARRIERS SHALL BE BY CONTRACTOR AS REQUIRED BY ACTUAL CONDITIONS, INCLUDING BACK TO BACK ARRANGEMENT, ETC.

- 2. TOILET ROOM FIXTURES WHERE NOTED BY ARCHITECT SHALL BE MOUNTED TO MEET ACCESSIBILITY REQUIREMENTS. FAUCETS AND FLUSH VALVES SHALL MEET ADA.
- 3. SHOWER BALANCE VALVE, SHOWER HEAD AND HAND HELD SHOWER WITH GLIDE BAR SHALL MEET ADA.
- 4. BREAK ROOM SINK AND LACTATION ROOM SINK SHALL MEET ADA DEPTH REQUIREMENTS. MANUAL FAUCET SHALL MEET ADA.

	WATER HEATER SCHEDULE											
TAG	DESCRIPTION	MANUFACTURER MODEL NUMBER BASIS OF DESIGN	COLD WATER	HOT WATER	STORAGE CAPACITY	ELECTRICAL REQUIREMENTS	NOTES					
EWH-1	ELECTRIC WATER HEATER	AO SMITH DEN-80	1"	1"	80 GAL	480 V/ 60 HZ / 3 PHASE, 12 KW	80 GAL TANK W/ 49 GPH RECOVERY @ 100° RISE. PROVIDE WITH WESSELS T-12 EXPANSION TANK AND RECIRCULATING PUMP RP-1 FOR HOT WATER RETURN.					

HOT WATER RECIRCULATING PUMP SCHEDULE											
TAG SERVICE	SEDVICE	GPM	HEAD		ELECTRIC	CAL CHARAC	TERISTICS		MANUFACTURER MODEL NUMBER	REMARKS	
	SERVICE	SERVICE GPIVI	SERVICE GPINI ((FT.)	RPM	ВНР	FLA	VOLTS	PHASE	BASIS OF DESIGN	REWARKS
RP-1	HOT WATER	3	10	3250	1/25	1	115	1	TACO 008	SEE NOTES	
NOTES:	1. PROVIDE WITH	H BRONZE	CONNECTI	ONS.							
	2. PROVIDE WITI	H TEMPERA	ATURE AQI	JASTAT 95 °I	F ON / 115 °	F OFF.					



IEI GROUP, LTD. IEI ARCHITECTS, INC. 428 North 2nd Street

Philadelphia, PA 19123 Telephone: 215.413.3700

CONSULTANTS:

Arora Engineers, Inc. 61 Wilmington-West Chester Pike Chadds Ford, PA 19317 P (610) 459-7900 F (610) 459-7950 aroraengineers.com



<u>O'Donnell & Naccarato</u> 701 Market Street, Suite 6000 Philadelphia, PA 19106 PH: 215.925.3788 www.o-n.com

DESIGN PROFESSIONAL'S ELECTRONIC OR DIGITAL SEAL OR SIGNATURE IS EFFECTIVE ONLY AS TO THAT VERSION OF THIS DOCUMENT AS ORIGINALLY PUBLISHED BY DESIGN PROFESSIONAL. DESIGN PROFESSIONAL IS NOT RESPONSIBLE FOR ANY SUBSEQUENT MODIFICATION, CORRUPTION, OR UNAUTHORIZED USE OF SUCH DOCUMENT. TO VERIFY THE VALIDITY OR APPLICABILITY OF THE SEAL OR SIGNATURE. CONTACT DESIGN PROFESSIONAL APPLICABILITY OF THE SEAL OR SIGNATURE, CONTACT DESIGN PROFESSIONAL.

☐ PROGRESS SET ☐ CLIENT REVIEW

■ BID SET

☐ CODE REVIEW SET $\ \square$ ISSUED FOR CONSTRUCTION

9/18/20

(NOT FOR CONSTRUCTION) ISSUES/REVISIONS:

1 2020-09-18 ISSUED FOR BIDS

PROJECT NUMBER: SCALE: DATE:

DRAWN BY: CHECKED BY:

DRAWING TITLE:
PLUMBING SCHEDULES

P-701